



University of Toronto



33 URSULA FRANKLIN MATH  
OFFICE RENOVATION

33 URSULA FRANKLIN ST.  
P164-24-165

ISSUED FOR TENDER  
2026-04-22

SHEET LIST

ARCHITECTURAL		STRUCTURAL		MECHANICAL		ELECTRICAL	
SHEET NUMBER	SHEET NAME	SHEET NUMBER	SHEET NAME	SHEET NUMBER	SHEET NAME	SHEET NUMBER	SHEET NAME
A000	COVER SHEET	S001	GENERAL NOTES	M101	MECHANICAL LEGEND, DRAWING LIST, KEY PLANS & CAMPUS MAP	E101	ELECTRICAL LEGEND, DRAWING LIST, KEY PLANS & CAMPUS MAP
A001	ORC MATRIX, GENERAL NOTES, SYMBOLS & ABBREVIATIONS	S010	TYPICAL DETAILS	M102	MECHANICAL SPECIFICATIONS (1 OF 4)	E102	ELECTRICAL & COMMUNICATIONS SPECIFICATION
A002	LIFE SAFETY	S001	LEVEL 3 RCP	M103	MECHANICAL SPECIFICATIONS (2 OF 4)	E201	SECOND FLOOR PLAN - ELECTRICAL DEMOLITION LAYOUT
A102	LEVEL 2 DEMOLITION PLAN	S202	ROOF PLAN	M104	MECHANICAL SPECIFICATIONS (3 OF 4)	E202	THIRD FLOOR PLAN - ELECTRICAL DEMOLITION LAYOUT
A103	LEVEL 3 DEMOLITION PLAN	S400	SECTIONS AND DETAILS	M105	MECHANICAL SPECIFICATIONS (4 OF 4)	E301	SECOND FLOOR PLAN - NEW ELECTRICAL & LIGHTING LAYOUTS
A112	LEVEL 2 DEMOLITION RCP			M110	MECHANICAL SCHEDULES	E302	THIRD FLOOR PLAN - NEW ELECTRICAL & LIGHTING LAYOUTS
A113	LEVEL 3 DEMOLITION RCP			M220	SECOND FLOOR PLAN - PLUMBING & DRAINAGE, EXISTING AND REMOVAL	E303	THIRD FLOOR PLAN - NEW LIGHTING LAYOUT
A202	LEVEL 2 CONSTRUCTION PLAN			M221	SECOND FLOOR PLAN - PLUMBING & DRAINAGE NEW WORK	E401	SINGLE LINE DIAGRAMS & PANEL SCHEDULES
A203	LEVEL 3 CONSTRUCTION PLAN			M230	THIRD FLOOR PLAN - PLUMBING & DRAINAGE, EXISTING AND REMOVAL	E402	COMMUNICATION MAIN CONDUIT LAYOUT & ELECTRICAL DETAILS
A204	ROOF PLANS			M231	THIRD FLOOR PLAN - PLUMBING & DRAINAGE NEW WORK	E501	LIGHTING CONTROL DETAILS & LUMINAIRE SCHEDULE
A212	LEVEL 2 CONSTRUCTION RCP			M320	SECOND FLOOR PLAN - HVAC EXISTING AND REMOVAL		
A213	LEVEL 3 CONSTRUCTION RCP			M321	SECOND FLOOR PLAN - HVAC NEW WORK		
A222	LEVEL 2 FLOORING FINISH PLAN			M330	THIRD FLOOR PLAN SOUTH - HVAC EXISTING AND REMOVAL		
A223	LEVEL 3 FLOORING FINISH PLAN			M331	THIRD FLOOR PLAN - HVAC NEW WORK		
A224	LEVEL 2 & 3 WALL FINISH PLANS			M341	ROOF PLAN - HVAC NEW WORK		
A226	LEVEL 2 & 3 FURNITURE PLANS (REFERENCE ONLY)			M401	MECHANICAL DETAILS		
A230	LEVEL 2 & 3 WASHROOM PLANS & ELEVATIONS						
A231	LEVEL 3 WASHROOM PLANS & ELEVATIONS						
A801	INTERIOR ELEVATIONS						
A700	DETAILS						
A801	MILLWORK						
A801	ROOM, DOOR & SCREEN SCHEDULES						
A850	LEVEL 2 RENDERINGS						
A851	LEVEL 3 RENDERINGS						

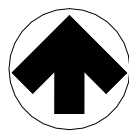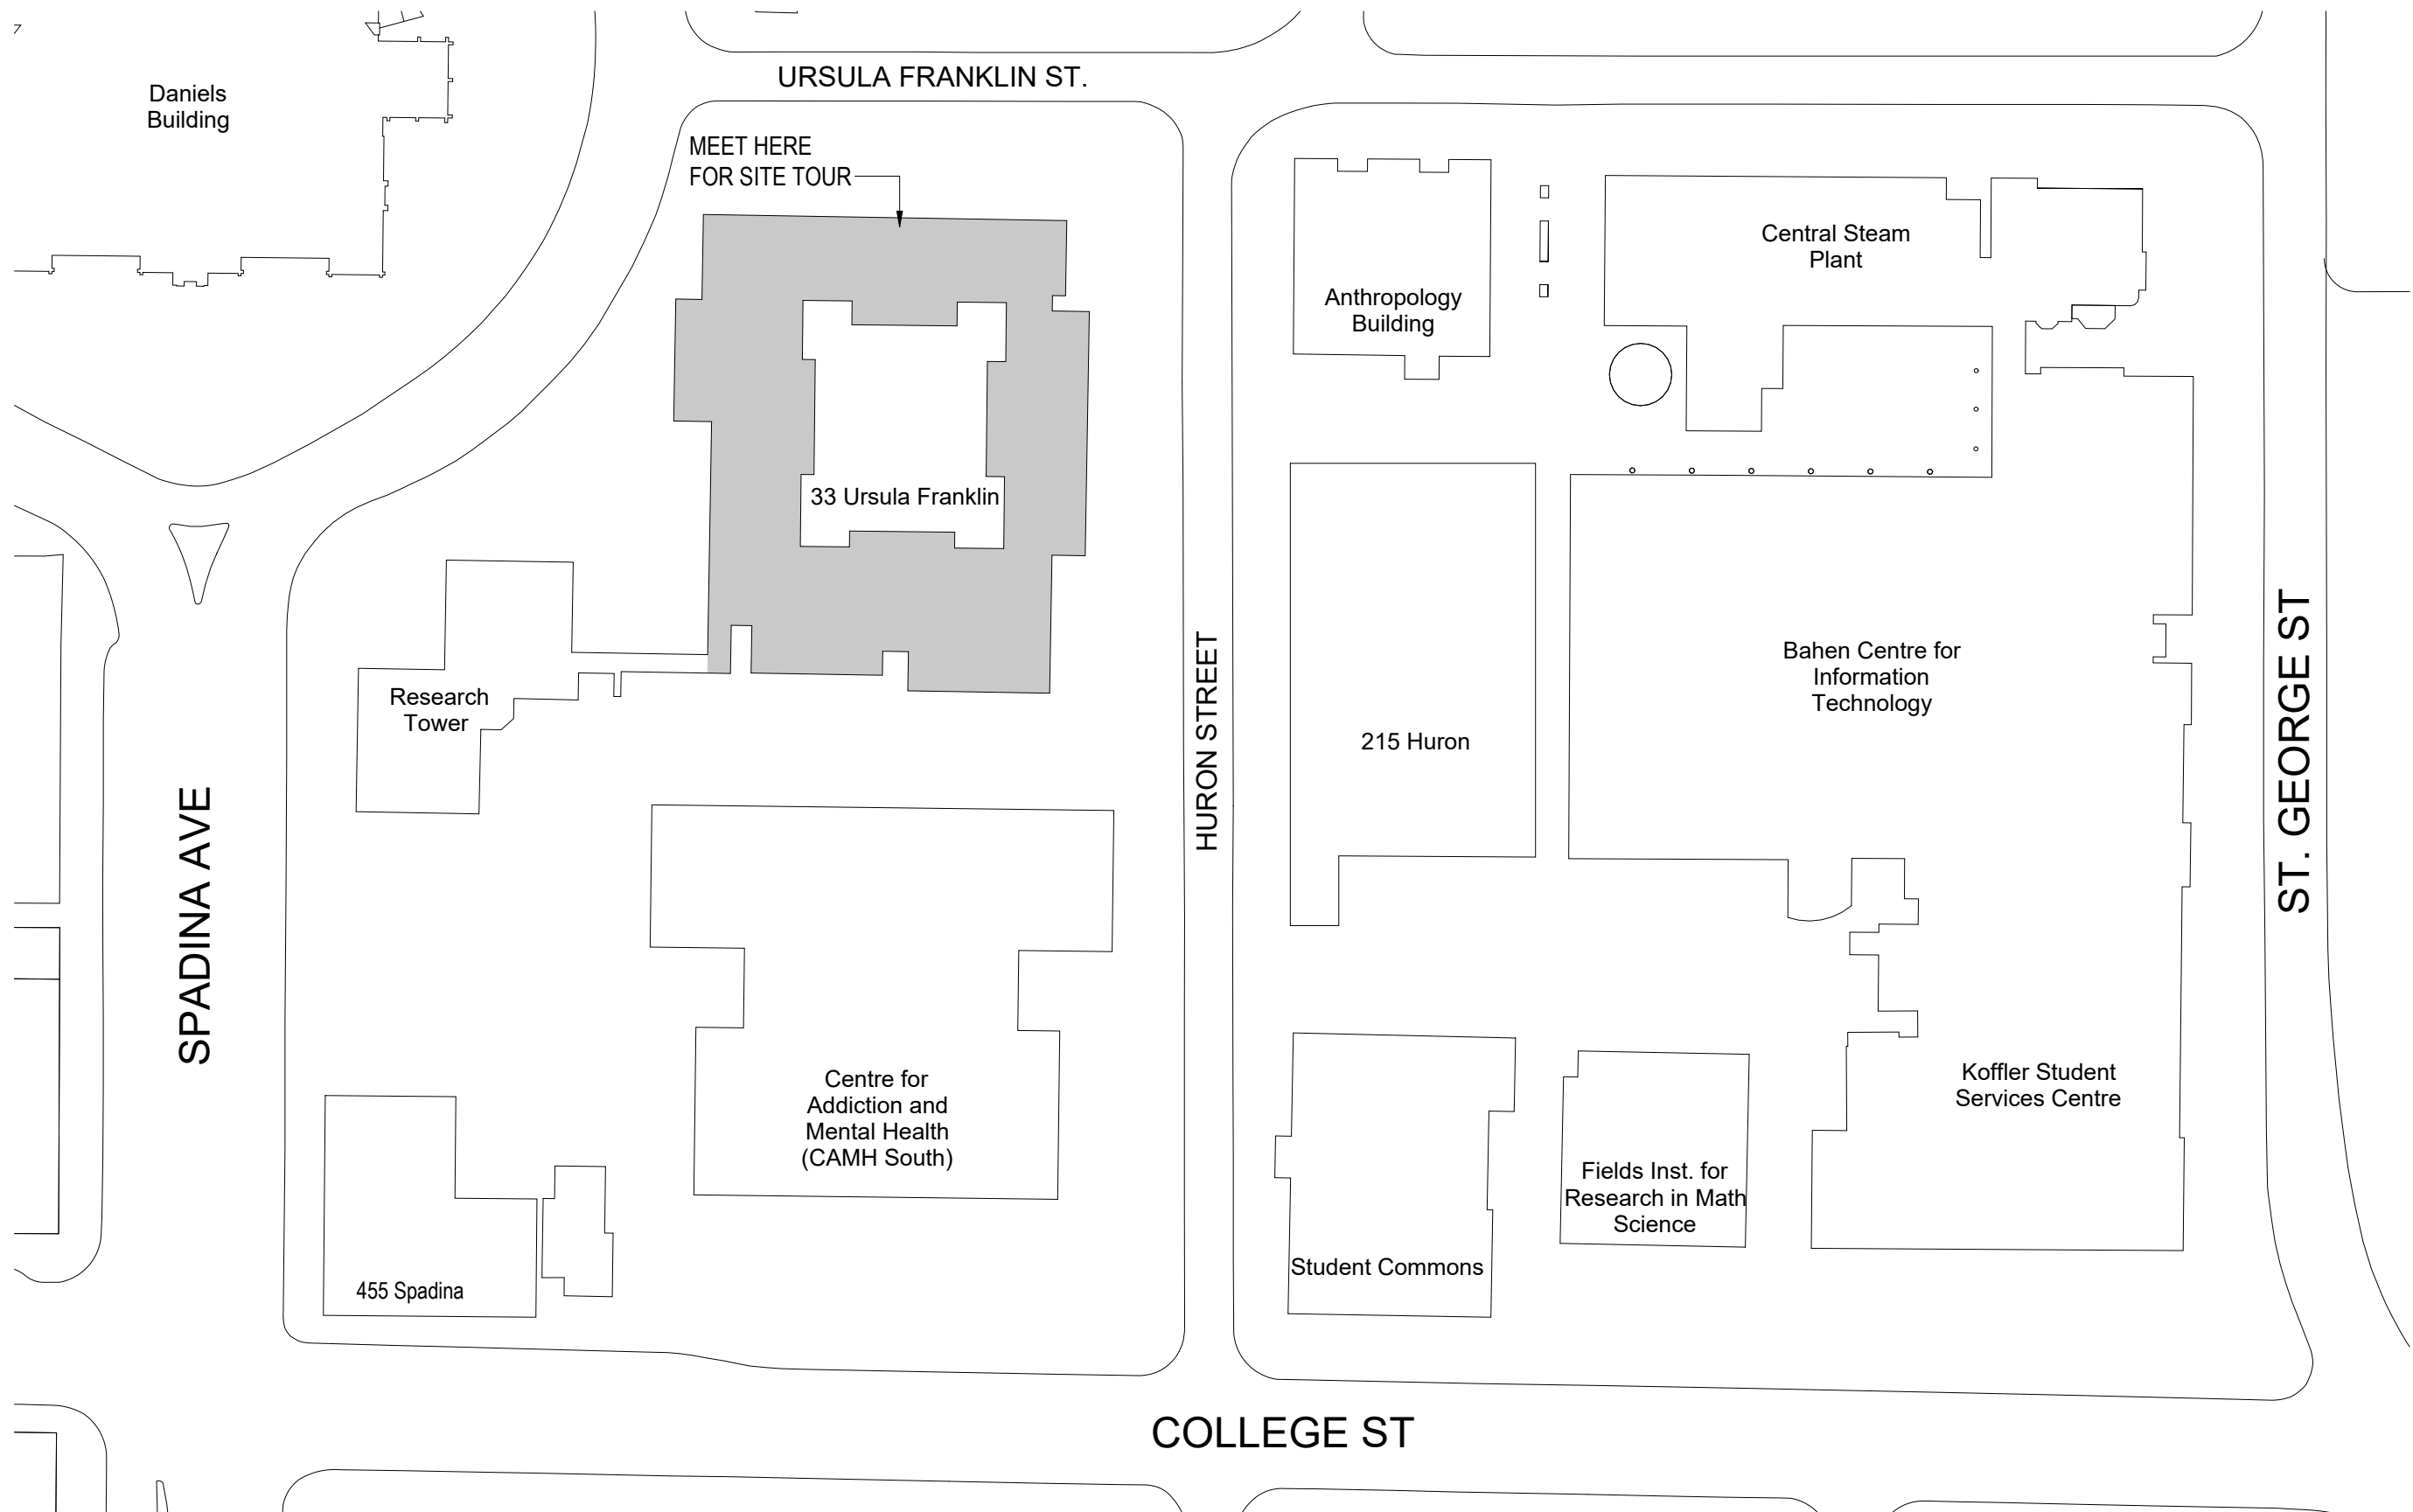

CONTEXT PLAN

AREA OF WORK PLANS

PROJECT TEAM

Architect:  
U of T Design & Engineering

Structural Engineer:  
Entuitive

Mechanical Engineer:  
U of T Design & Engineering

Electrical Engineer:  
U of T Design & Engineering

SEAL

DRAWING NUMBER

A000



[illegible]

**GENERAL NOTES - PARTITIONS:**

**1. GYPSUM BOARD PARTITIONS AND FURRING:**

- 1.1 EXTEND GYPSUM BOARD PARTITIONS FULL HEIGHT TO US OF FLOOR OR ROOF SLAB ABOVE, UNLESS OTHERWISE INDICATED.
- 1.2 AT NON-RATED FIRE SEPARATIONS, ACUSTIC/FIRE RATED PARTITIONS. PROVIDE JOINT SEALANT AT ALL PARTITION JOINTS, AND PENETRATIONS THROUGH GYPSUM BOARD.
- 1.3 PROVIDE BACKER PLATE FOR HANDRAIL SUPPORT, BUMPER RAILS, WALL MOUNTED MILLWORK ETC. TO BE INSTALLED TO THE FACE OF THE PARTITION.
- 1.4 AT PARTITIONS TO RECEIVE CERAMIC TILE, WALL FINISH PROVIDE THE BACKER BOARD IN LIEU OF GYPSUM BOARD BEHIND TILES. BACKER BOARD TO BE FIRE RATED TYPE AT FIRE RATED PARTITIONS.
- 1.5 AT STAGGERED PARTITION JOINTS, PROVIDE JOINTS ON OPPOSITE SIDES OF PARTITION TO STAGGERED MAXIMUM 800mm.
- 1.6 ROOM FINISH SHALL BE THE SAME FOR INTERIOR FINISHES.
- 1.7 HEIGHT OF FURRING WALLS TO BE 150mm ABOVE FINISHED CEILING UNLESS OTHERWISE NOTED.
- 1.8 ALL DIMENSIONS PROVIDED ARE TO FACE UNLESS OTHERWISE NOTED.
- 1.9 APPROVED MANUFACTURER SPECIFIC UCL LISTINGS FOR REVIEW AS REQUIRED IN THE SPECIFICATIONS.

**2. CONCRETE MASONRY UNIT WALLS AND PARTITIONS:**

- 2.1 ALL CONCRETE MASONRY UNIT WALLS AND PARTITIONS TO EXTEND TO US OF FLOOR OR ROOF SLAB ABOVE, UNLESS NOTED OTHERWISE.
- 2.2 PROVIDE PRECAST CONCRETE JOINTS CONTINUOUS AT TOP OF ALL CMU WALLS AND PARTITIONS, SEE JOINTS WHERE EXPOSED. PROVIDE FIRESTOPPING AND SMOKE SEALS AT PERIMETER JOINTS, AND JOINTS IN FLOOR.
- 2.3 PROVIDE LATERAL BRACING AT TOP OF CMU WALLS AND PARTITIONS, REFER TO STRUCTURAL FOR DETAILS.
- 2.4 PROVIDE REINFORCEMENT OF CMU WALLS AND PARTITIONS AS REQUIRED BY STRUCTURAL.


**3. FIRE SEPARATIONS:**

- 3.1 REFER TO FIRE SEPARATION PLANS - FIRE SEPARATION REQUIREMENTS.
- 3.2 PROVIDE FIRE RATED PARTITIONS BEHIND AND ABOVE CONTINUOUS FIRESTOPPING AND SMOKE SEALS AT ALL PERIMETER JOINTS AND PENETRATIONS.
- 3.3 AT RECESSED PANEL INSTALLATIONS (E.G. ELECTRICAL PANELS) WITHIN RATED WALLS, PROVIDE CONTINUITY OF THE RECURRING BEHIND AND ABOVE THE PANEL.


[illegible]

DRAWING NUMBER	REV. NUMBER
<b>A001</b>	<b>2</b>



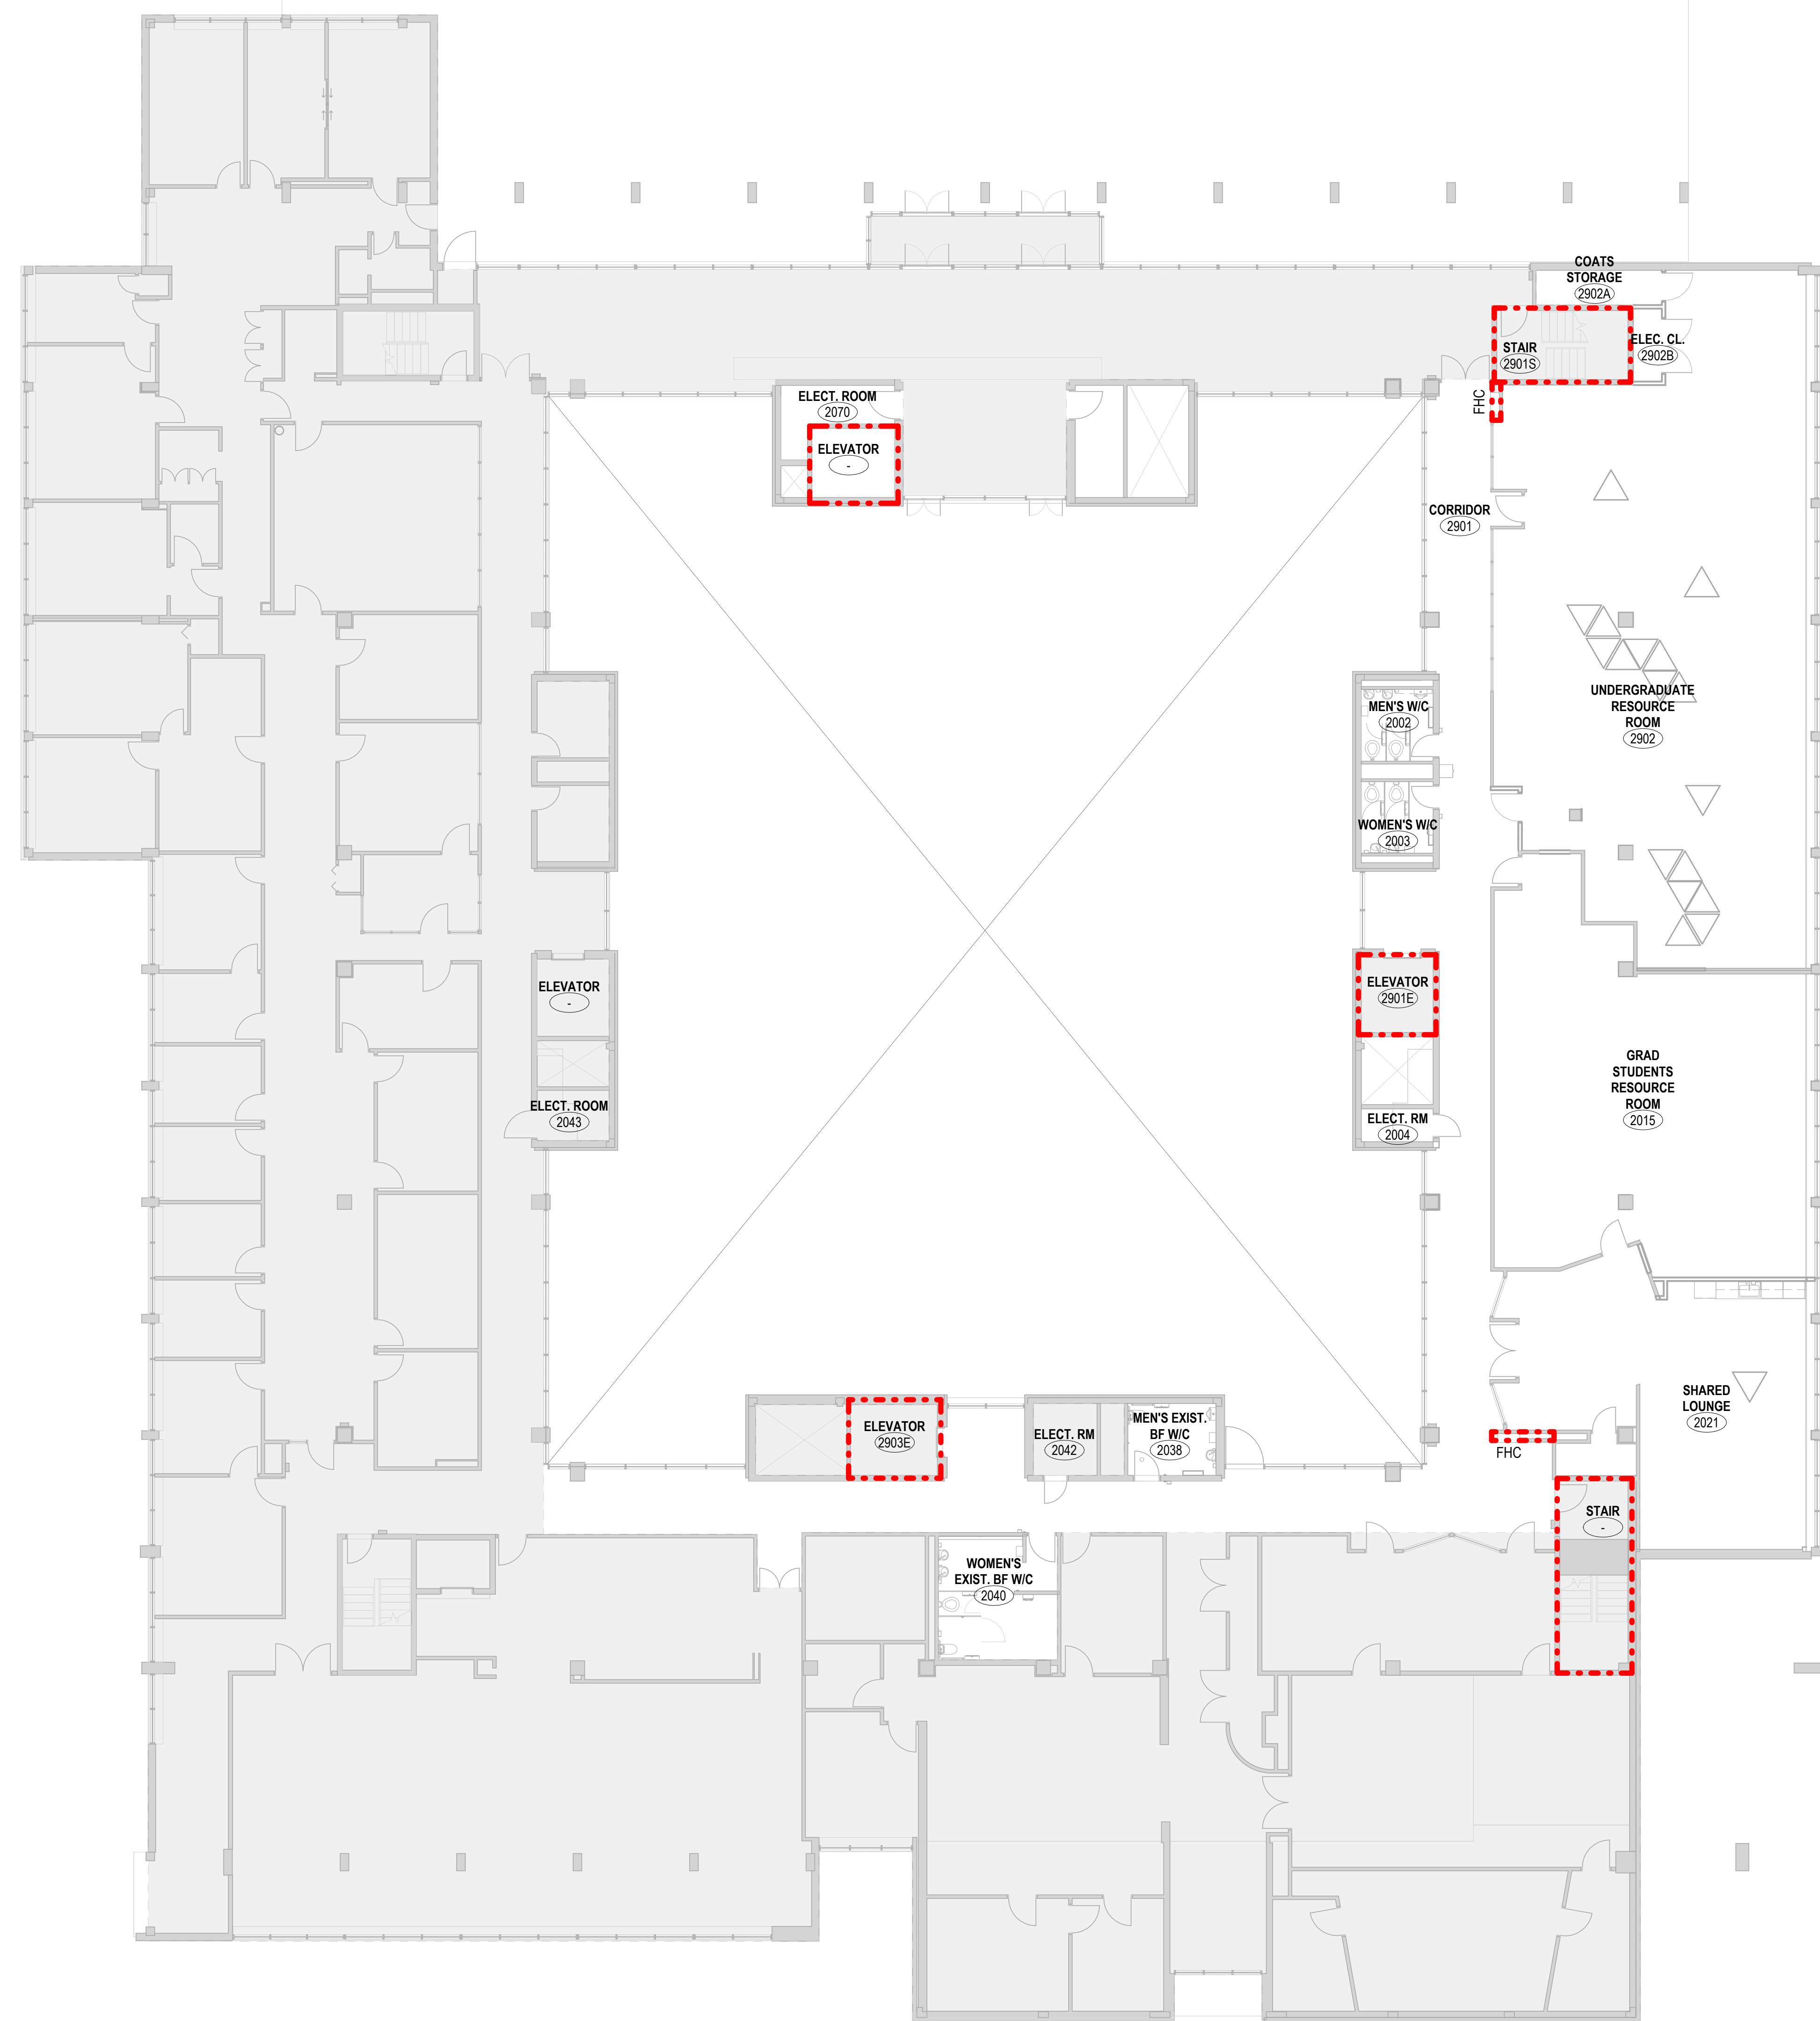



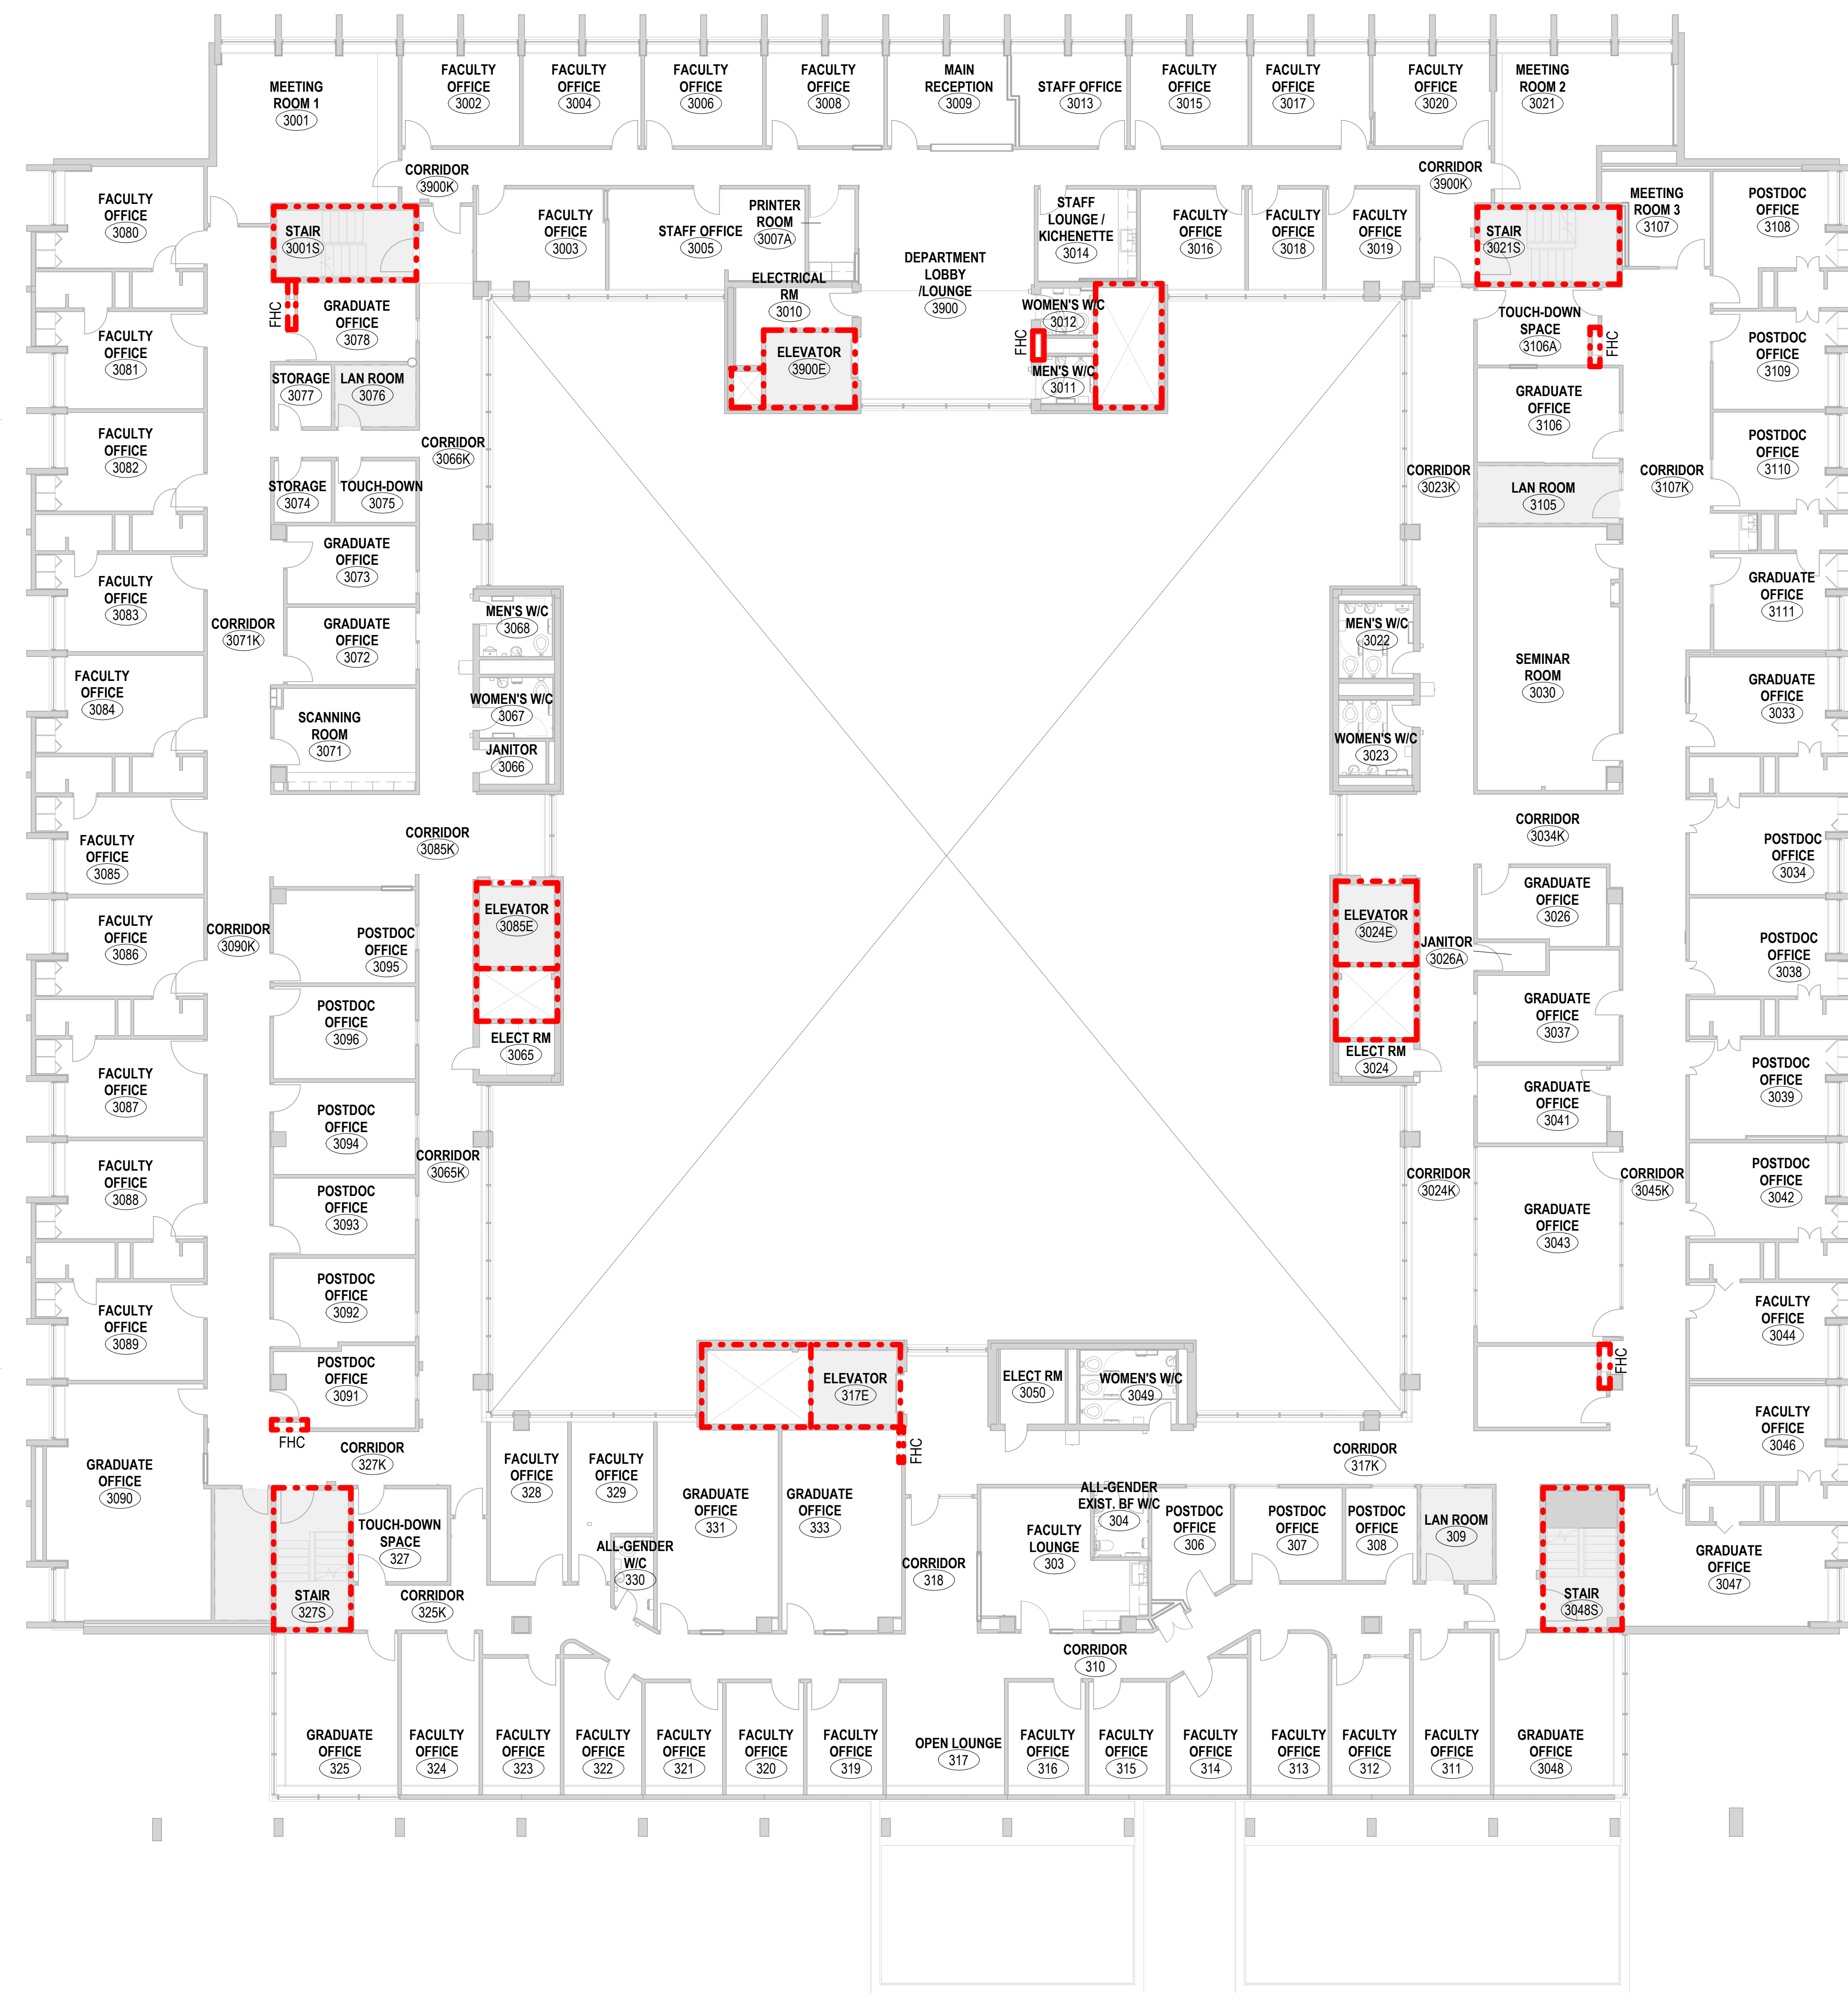



2 LIFE SAFETY - PARTIAL LEVEL 2  
A002 1:125



1 LIFE SAFETY - LEVEL 3  
A002 1:125

- GENERAL NOTES - FIRE SEPARATIONS:
1. ALL CLOSURES TO HAVE LABELLED RATINGS (C/W LABELLED FRAMES AND CLOSURES). PROVIDE FIRE DAMPERS AS PER MECHANICAL DRAWINGS.
  2. DRAWINGS INTENDED TO BE PRINTED IN COLOUR FOR LEGIBILITY.

- LEGEND - LIFE SAFETY PLAN**
- |   |                                  |
|---|----------------------------------|
|  | EXISTING FIRE SEPARATION UNKNOWN |
|  | EXISTING PATH OF TRAVEL          |
|  | NEW FIRE HOSE PATH               |
|  | EXISTING FIRE HOSE CABINET       |
|  | EXISTING EXIT                    |
|  | NOT IN SCOPE (N.I.C.)            |

3	ISSUED FOR TENDER	2026-04-22
2	ISSUED FOR PERMIT	2026-03-04
1	ISSUED FOR CLASS A COSTING	2026-02-18
REV.	DESCRIPTION	DATE

KEY PLAN (NTS)

SEAL
------

PROJECT TITLE:  
UNIVERSITY OF TORONTO  
**33 URSULA FRANKLIN**  
**MATH OFFICE**  
**RENOVATION**

33 URSULA FRANKLIN ST.  
DRAWING SHEET TITLE  
**LIFE SAFETY**

DRAWN BY: AS	SCALE: As indicated
REVIEWED BY: SC	DATE CREATED: 2026/02/11
UNIVERSITY PROJECT NUMBER	NORTH POINT

DRAWING NUMBER	REV. NUMBER
<b>A002</b>	<b>3</b>





C:\Users\songanit\Documents\IP164-25-165\_A\_26\_anita.song.rvt 2026-04-22 11:50:56 AM


DEMOLITION NOTES


No.	DESCRIPTION
1	REMOVE EXISTING FLOOR MOUNTED OR WALL MOUNTED MIRRORS, DISPENSERS AND OTHER ACCESSORIES. MAKE GOOD FLOOR AND WALLS TO ACCEPT NEW FINISHES. REMOVE ALSO PLUMBING FIXTURES (SEE MECHANICAL).
2	REMEDIATION OF GWS ON 25% OF WALLS TO REMOVE MOLD. REMOVE EXISTING CARPET, BASEBOARD AND UNDERLAY. IF VCT OR VAT IS PRESENT UNDER CARPET DO NOT REMOVE. MAKE GOOD FLOOR SURFACE TO ACCEPT NEW CARPET FINISH. REFER TO FLOOR FINISH PLAN.
3	REMOVE DEMOUNTABLE PARTITIONS INCLUDING DOORS AND GLAZING.
4	REMOVE EXISTING LOCKSET FROM CORRIDOR DOOR. PREPARE DOOR TO ACCEPT NEW LOCKSET (SEE DOOR SCHEDULE).
5	REMOVE EXISTING DOOR AND FRAME.
6	REMOVE EXISTING PLUM WINDOW SILLS. GRILLES ALSO TO BE REMOVED (SEE MECHANICAL).
7	REMOVE EXISTING KITCHEN CABINETS (SEE MECH. DWG'S FOR PLUMBING WORK).
8	REMOVE EXISTING DOOR AND FRAME. SALVAGE DOOR AND REMOVE LOCKSET FROM CORRIDOR DOOR. PREPARE DOOR TO ACCEPT NEW LOCKSET AND REINSTALLED WITH NEW FRAME. (SEE DOOR SCHEDULE).
9	REMOVE EXISTING DEMOUNTABLE PARTITION ONLY TO THE PANEL JOINT - LEAVE REMAINING PANEL INTACT.
10	REMOVE WALL COVERING FROM ROOM & WHERE NOTED ON PLAN & WHEREVER PRESENT WITHIN PROJECT SCOPE AREA. ENSURE WALL PARTITION IS IN GOOD CONDITION TO ACCEPT NEW FINISHES.
11	REMOVE EXISTING RECESSED DRINKING FOUNTAIN (SEE MECH. DWG'S).
12	EXISTING DEMOUNTABLE PARTITION W/ GLAZING TO REMAIN.
13	REMOVE EXISTING VINYL FLOORING AND BASEBOARDS. MAKE GOOD EXISTING SLAB TO ACCEPT NEW FLOOR FINISHES. (REFER TO FLOORING PLAN - REFER ALSO TO DSSR).
14	REMOVE EXISTING PRINTED FILM FROM ELEVATOR DOOR PANELS. MAKE GOOD AND CLEAN SURFACES TO ACHIEVE UNIFORM FINISH FREE OF ADHESIVE RESIDUE TO RECEIVE NEW PAINT.
15	REMOVE ALL WALL ATTACHED ITEMS, INCL. BUT NOT LIMITED TO: SCONES, PANELS, AND ACCESSORIES. CLEAN, PATCH, AND REPAIR SURFACES AS REQUIRED TO ACHIEVE A SMOOTH, UNIFORM FINISH. FASTENER HOLES, DAMAGE, OR IRREGULARITIES.
16	REMOVE PORTION OF DEMOUNTABLE PARTITION - DO NOT CUT PANEL, BUT REMOVE SECTIONS OF WALL REQUIRED TO ALLOW FOR NEW CONSTRUCTION.

LEGEND - DEMOLITION

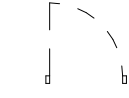 DOOR TO BE DEMOLISHED

 WALLS TO BE DEMOLISHED

 WALL TO REMAIN

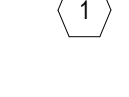
 DEMOLITION NOTES

Room name  
101

EXISTING ROOM NAME & NUMBER

± 2382

EXISTING DIMENSION (SITE VERIFY)

 OUT OF SCOPE AREA

GENERAL NOTES - DEMOLITION:

1. THIS DRAWING IS TO BE READ IN CONJUNCTION WITH THE MECHANICAL AND ELECTRICAL DRAWINGS.

2. ROOM NUMBERS SHOWN ARE EXISTING ROOM NUMBERS. REFER TO NEW WORK DRAWING FOR NEW ROOM NUMBERS.

3. FOR ALL HAZARDOUS MATERIALS REMOVAL PROCEDURES, REFER TO GENERAL SPECIFICATION FOR HAZARDOUS MATERIALS REPORT AND SCOPE OF WORK. CONTRACTOR IS RESPONSIBLE FOR DEMOLITION OF DESIGNATED SUBSTANCES AS NOTED IN THE SCOPE OF WORK AND FOR MATERIALS NOTED IN THE HAZARDOUS MATERIALS REPORT WHERE AFFECTED BY CONSTRUCTION INCLUDING BUT NOT LIMITED TO MECHANICAL AND ELECTRICAL WORK.

4. DUST PROOF TEMPORARY HOARDING MUST BE IN PLACE PRIOR TO ANY REMOVALS WORK. TEMPORARY HOARDING TO BE FACED ON PUBLIC SIDE BY IMPACT RESISTANT DRYWALL, TAPED, FILLED, PAINTED TO COMPLETELY SEPARATE THE WORK AREA FROM THE PUBLIC AREA. UPON COMPLETION OF THE WORK, REMOVE HOARDING, PATCH AND MAKE GOOD ALL DISTURBED AREAS TO MATCH EXISTING. HOARDING MUST MAINTAIN ACCESS TO EENTS AND MUST NOT REDUCE THE CORRIDOR WIDTH TO LESS THAN THAT PERMITTED BY THE OBC.

5. REMOVE ALL WALLS, SCREWS, WALL PLUGS, WALL CLIPS, STAPLES FROM EXISTING WALLS. PATCH, REPAIR, AND MAKE GOOD WALL SURFACES.

6. REMOVE ALL AFFECTED MILLWORK & OTHER EXISTING WALL MOUNTED ITEMS SUCH AS: BULLETIN BOARDS, PEGBOARDS, CHALKBOARDS AND ACCESSORIES AS NOTED ON THE DRAWINGS. CONTRACTOR SHALL ASK APPROVAL FROM U OF T REPRESENTATIVE BEFORE DISPOSING OF REMOVED ITEMS. MATERIALS & ITEMS THAT WILL NOT BE DISPOSED OF SHALL BE TAKEN BY THE CONTRACTOR TO A STORAGE AREA DESIGNATED BY THE U OF T REPRESENTATIVE.

7. REMOVE AND RETAIN ALL LOCKSETS/CYLINDERS AND ELECTRIC STRIKES, CLOSERS AND DOOR OPERATORS FROM DOORS TO BE SALVAGED AS NOTED ON THE DRAWINGS AND HAND OVER TO U OF T.

8. REMOVE AND RETAIN ALL LOCKSETS/CYLINDERS AND ELECTRIC STRIKES, CLOSERS AND DOOR OPERATORS FROM DOORS TO BE SALVAGED AS NOTED ON THE DRAWINGS AND HAND OVER TO U OF T.

9. REMOVE AND SALVAGE EXISTING DOORS AND FRAMES AS NOTED ON THE DRAWINGS.

10. REMOVE EXISTING WALL BASE WITHIN THE CONSTRUCTION AREA UNLESS NOTED OTHERWISE AND MAKE GOOD WALLS AS REQUIRED TO RECEIVE NEW BASE.

11. REMOVE ALL EXISTING FLOOR FINISH WITHIN THE CONSTRUCTION AREA. BACK TO CONCRETE SUBSURFACE UNLESS NOTED OTHERWISE. REMOVE ALL ADHESIVE AND PATCH AND REPAIR SUBSURFACE TO RECEIVE NEW FLOOR FINISH TO PROVIDE SMOOTH FINISH.

12. WHERE CONCRETE PARTITION WALLS ARE BEING REMOVED, ENSURE CLEAN SAWCUT AT NEAREST CONCRETE JOINT. PATCH AND REPAIR ENDSFACE OF REMAINING BLOCKS TYP.

13. WHERE WALLS AND FLOORING ARE REMOVED, LOCALLY PATCH AND LEVEL ANY AREAS OF DAMAGED FLOOR/CONCRETE SUBSURFACE TO PROVIDE SMOOTH SURFACE READY TO RECEIVE NEW FINISHES. ALLOW FOR 25mm THICK SELF-LEVELING UNDERLAYMENT WHERE REQUIRED.

14. REFER TO GENERAL NOTES FOR ADDITIONAL DEMOLITION INFORMATION.

The plan shows a large rectangular building footprint with a complex internal layout. The main lobby (2903) is a large open space in the upper right. To its right are several offices (2907, 2908, 2905, 2906, 2909, 2910, 2911, 2912, 2913, 2914, 2915, 2918, 2920) and a reception area (2921). A corridor (2901) runs vertically through the center. To the left of the corridor are several rooms, including a women's washroom (2904), a men's washroom (2902), and an elevator (2904). The plan is overlaid with a grid of dimensions and room numbers. The grid lines are labeled with numbers 1 through 27 horizontally and letters B through R vertically. The plan includes various symbols for doors to be demolished, walls to be demolished, and walls to remain. The plan also includes a legend for demolition notes and a key plan (NTS) in the bottom right corner.

9 ISSUED FOR TENDER 2026-04-22

8 ISSUED FOR 80% CD 2026-03-09

7 ISSUED FOR PERMIT 2026-03-04

6 ISSUED FOR CLASS A COSTING 2026-02-18

5 ISSUED FOR 100% DD 2026-01-23

4 ISSUED FOR CLASS B COSTING 2026-01-16

3 ISSUED FOR 50% DD 2025-11-28

2 ISSUED FOR 100% SD 2025-09-16

1 ISSUED FOR CLASS C COSTING 2025-09-03

REV. DESCRIPTION DATE

KEY PLAN (NTS) SEAL

PROJECT TITLE:  
UNIVERSITY OF TORONTO  
**33 URSULA FRANKLIN  
MATH OFFICE  
RENOVATION**

33 URSULA FRANKLIN ST.  
DRAWING SHEET TITLE:  
**LEVEL 2 DEMOLITION  
PLAN**

DRAWN BY: JR SCALE: As indicated

REVIEWED BY: SC DATE CREATED: 2026/02/11

UNIVERSITY PROJECT NUMBER: NORTH POINT

P164-24-165

DRAWING NUMBER  
**A102**

REV. NUMBER  
**9**

1 DEMO LEVEL 2 FULL

A102 1:100



C:\Users\songanit\Documents\P164-25-165\_A\_26\_anita\_song.rvt2026-04-22 11:51:06 AM

DEMOLITION NOTES

No.	DESCRIPTION
1	REMOVE EXISTING CARPET, BASEBOARD AND UNDERLAY - IF VOT OR VAT IS PRESENT UNDER CARPET DO NOT REMOVE. MAKE GOOD FLOOR SURFACE TO ACCEPT NEW CARPET FINISH. REFER TO FLOOR FINISH PLAN.
2	REMOVE EXISTING LOCKSET FROM CORRIDOR DOOR. PREPARE DOOR TO ACCEPT NEW LOCKSET (SEE DOOR SCHEDULE).
3	REMOVE EXISTING ITEMS FROM WALL INCL. SHELVING, CORKBOARDS, ETC.
3A	REMOVE EXISTING MOP HOLDERS FROM WALL AND SALVAGE TO REINSTALL.
3B	REMOVE EXISTING METAL SHELF AND MOP HOLDERS FROM WALL AND SALVAGE TO REINSTALL.
4	REMOVE EXISTING LOCKSETS FROM WR DOORS.
5	PATCH, REPAIR AND MAKE GOOD EXISTING WALLS/ PARTITIONS WHERE DIVIDING PARTITIONS HAVE BEEN REMOVED.
6	REMOVE EXISTING DOOR AND FRAME.
7	CUT NEW OPENING IN EXISTING PARTITION FOR NEW DOOR.
8	REMOVE EXISTING KITCHEN CABINETS, AND WALL TILE. MAKE PARTITIONS GOOD TO ACCEPT NEW FINISHES (SEE MECH. DWGS FOR PLUMBING WORK).
9	REMOVE EXISTING FLOOR MOUNTED OR WALL MOUNTED MIRRORS, DISPENSERS AND OTHER ACCESSORIES. MAKE GOOD FLOOR AND WALLS TO ACCEPT NEW FINISHES. REMOVE ALSO PLUMBING FIXTURES (SEE MECHANICAL).
10	REMOVE GWS, PLASTER, PYVO AND ANY WALL FINISHES PRESENT ON WALL USING U of T EHS LEVEL 1 MOULD PROCEDURES.
11	REMOVE PLASTER/LATHIE FROM DAMAGED PORTION OF WALL. PREPARE WALL FOR NEW PLASTER FINISH.
12	REMOVE WALL COVERING FROM ROOM A WHERE NOTED ON PLAN & WHEREVER PRESENT WITHIN PROJECT SCOPE AREA. ENSURE WALL/ PARTITION IS IN GOOD CONDITION TO ACCEPT NEW FINISHES.
13	REMOVE EXISTING COUNTER.
14	REMOVE EXISTING FILM FROM GLAZING.
15	EXISTING MILLWORK TO REMAIN.
16	REMOVE EXISTING WALL-EMBEDDED WASHROOM ACCESSORIES.
17	CLEAN AND SAND EXISTING FLOORING TO ACCEPT NEW EPOXY COATING.
18	REMOVE EXISTING RECESSED DRINKING FOUNTAIN (SEE MECH. DWGS).
19	REMOVE EXISTING VINYL FLOORING AND BASEBOARDS. MAKE GOOD EXISTING SLAB TO ACCEPT NEW FLOOR FINISHES. (REFER TO FLOORING PLAN - REFER ALSO TO D856).
20	REMOVE ALL WALL ATTACHED ITEMS, INCL. BUT NOT LIMITED TO SIGAGE, PANELS, AND ACCESSORIES. CLEAN, PATCH, AND REPAIR SURFACES AS REQUIRED TO ACHIEVE A SMOOTH, UNIFORM FINISH. FASTENER HOLES, DAMAGE, OR IRREGULARITIES.
21	REMOVE EXISTING FILM FROM ELEVATOR DOOR PANELS. MAKE GOOD AND CLEAN SURFACES TO ACHIEVE UNIFORM FINISH FREE OF ADHESIVE RESIDUE. REFER TO FLOORING PLAN.
22	REMOVE EXISTING WINDOW COMPONENTS FROM EXISTING OPENING.
23	TEMPORARILY UNATTACH WALL MOUNTED ELECTRICAL RADIATORS AS REQUIRED TO FACILITATE RE-FINISHING OF ROOM. DO NOT DISCONNECT POWER SUPPLY TO RADIATOR. RE-ATTACH AFTER FLOORING AND PAINTING IS COMPLETE.

LEGEND - DEMOLITION

DOOR TO BE DEMOLISHED

WALLS TO BE DEMOLISHED

WALL TO REMAIN

DEMOLITION NOTES

Room name  
101  
EXISTING ROOM NAME & NUMBER

± 2382  
EXISTING DIMENSION (SITE VERIFY)

OUT OF SCOPE AREA

GENERAL NOTES - DEMOLITION:

1. THIS DRAWING IS TO BE READ IN CONJUNCTION WITH THE MECHANICAL AND ELECTRICAL DRAWINGS.

2. ROOM NUMBERS SHOWN ARE EXISTING ROOM NUMBERS. REFER TO NEW WORK DRAWING FOR NEW ROOM NUMBERS.

3. FOR ALL HAZARDOUS MATERIALS REMOVAL PROCEDURES, REFER TO GENERAL SPECIFICATION FOR HAZARDOUS MATERIALS REPORT AND SCOPE OF WORK. CONTRACTOR IS RESPONSIBLE FOR DEMOLITION OF DESIGNATED SUBSTANCES AS NOTED IN THE SCOPE OF WORK AND FOR MATERIALS NOTED IN THE HAZARDOUS MATERIALS REPORT WHERE AFFECTED BY CONSTRUCTION INCLUDING BUT NOT LIMITED TO MECHANICAL, AND ELECTRICAL WORK.

4. DUST PROOF TEMPORARY HOARDING MUST BE IN PLACE PRIOR TO ANY REMOVALS WORK. TEMPORARY HOARDING TO BE FACED ON PUBLIC SIDE BY IMPACT RESISTANT DRYWALL, TAPED, FILLED, PAINTED TO COMPLETELY SEPARATE THE WORK AREA FROM THE PUBLIC AREA. UPON COMPLETION OF THE WORK, REMOVE HOARDING, PATCH AND MAKE GOOD ALL DISTURBED AREAS TO MATCH EXISTING. HOARDING MUST MAINTAIN ACCESS TO EXITS AND MUST NOT REDUCE THE CORRIDOR WIDTH TO LESS THAN THAT PERMITTED BY THE CBC.

5. REMOVE ALL NAILS, SCREWS, WALL PLUGS, WALL CLIPS, STAPLES FROM EXISTING WALLS. PATCH, REPAIR, AND MAKE GOOD WALL SURFACES.

6. REMOVE ALL AFFECTED MILLWORK & OTHER EXISTING WALL MOUNTED ITEMS SUCH AS BULLETIN BOARDS, PEGBOARDS, CHALKBOARDS AND ACCESSORIES AS NOTED ON THE DRAWINGS. CONTRACTOR SHALL ASK APPROVAL FROM U OF T REPRESENTATIVE BEFORE DISPOSING OF REMOVED ITEMS. MATERIALS & ITEMS THAT WILL NOT BE DISPOSED OF SHALL BE TAKEN BY THE CONTRACTOR TO A STORAGE AREA DESIGNATED BY THE U OF T REPRESENTATIVE.

7. REMOVE AND RETAIN ALL LOCKSETS/CYLINDERS AND ELECTRIC STRIKES, CLOSERS AND DOOR OPERATORS. FROM DOORS TO BE SALVAGED AS NOTED ON THE DRAWINGS AND HAND OVER TO U OF T.

8. REMOVE AND RETAIN ALL LOCKSETS/CYLINDERS AND ELECTRIC STRIKES, CLOSERS AND DOOR OPERATORS. FROM DOORS TO BE SALVAGED AS NOTED ON THE DRAWINGS AND HAND OVER TO U OF T.

9. REMOVE AND SALVAGE EXISTING DOORS AND FRAMES AS NOTED ON THE DRAWINGS.


10. REMOVE EXISTING WALL BASE WITHIN THE CONSTRUCTION AREA (UNLESS NOTED OTHERWISE AND MAKE GOOD WALLS AS REQUIRED TO RECEIVE NEW BASE).

11. REMOVE ALL EXISTING FLOOR FINISH WITHIN THE CONSTRUCTION AREA. BACK TO CONCRETE SUBSURFACE UNLESS NOTED OTHERWISE. REMOVE ALL ADHESIVE AND PATCH AND REPAIR SUBSURFACE TO RECEIVE NEW FLOOR FINISH TO PROVIDE SMOOTH FINISH.

12. WHERE CONCRETE PARTITION WALLS ARE BEING REMOVED, ENSURE CLEAN SAWCUT AT NEAREST CONCRETE JOINT. PATCH AND REPAIR ENDSURFACE OF REMAINING BLOCKS TYP.

13. WHERE WALLS AND FLOORING ARE REMOVED, LOCALLY PATCH AND LEVEL ANY AREAS OF DAMAGED FLOOR CONCRETE SUBSURFACE TO PROVIDE SMOOTH SURFACE READY TO RECEIVE NEW FINISHES. ALLOW FOR 20mm THICK SELF-LEVELING UNDERLAYMENT WHERE REQUIRED.

14. REFER TO GENERAL NOTES FOR ADDITIONAL DEMOLITION INFORMATION.

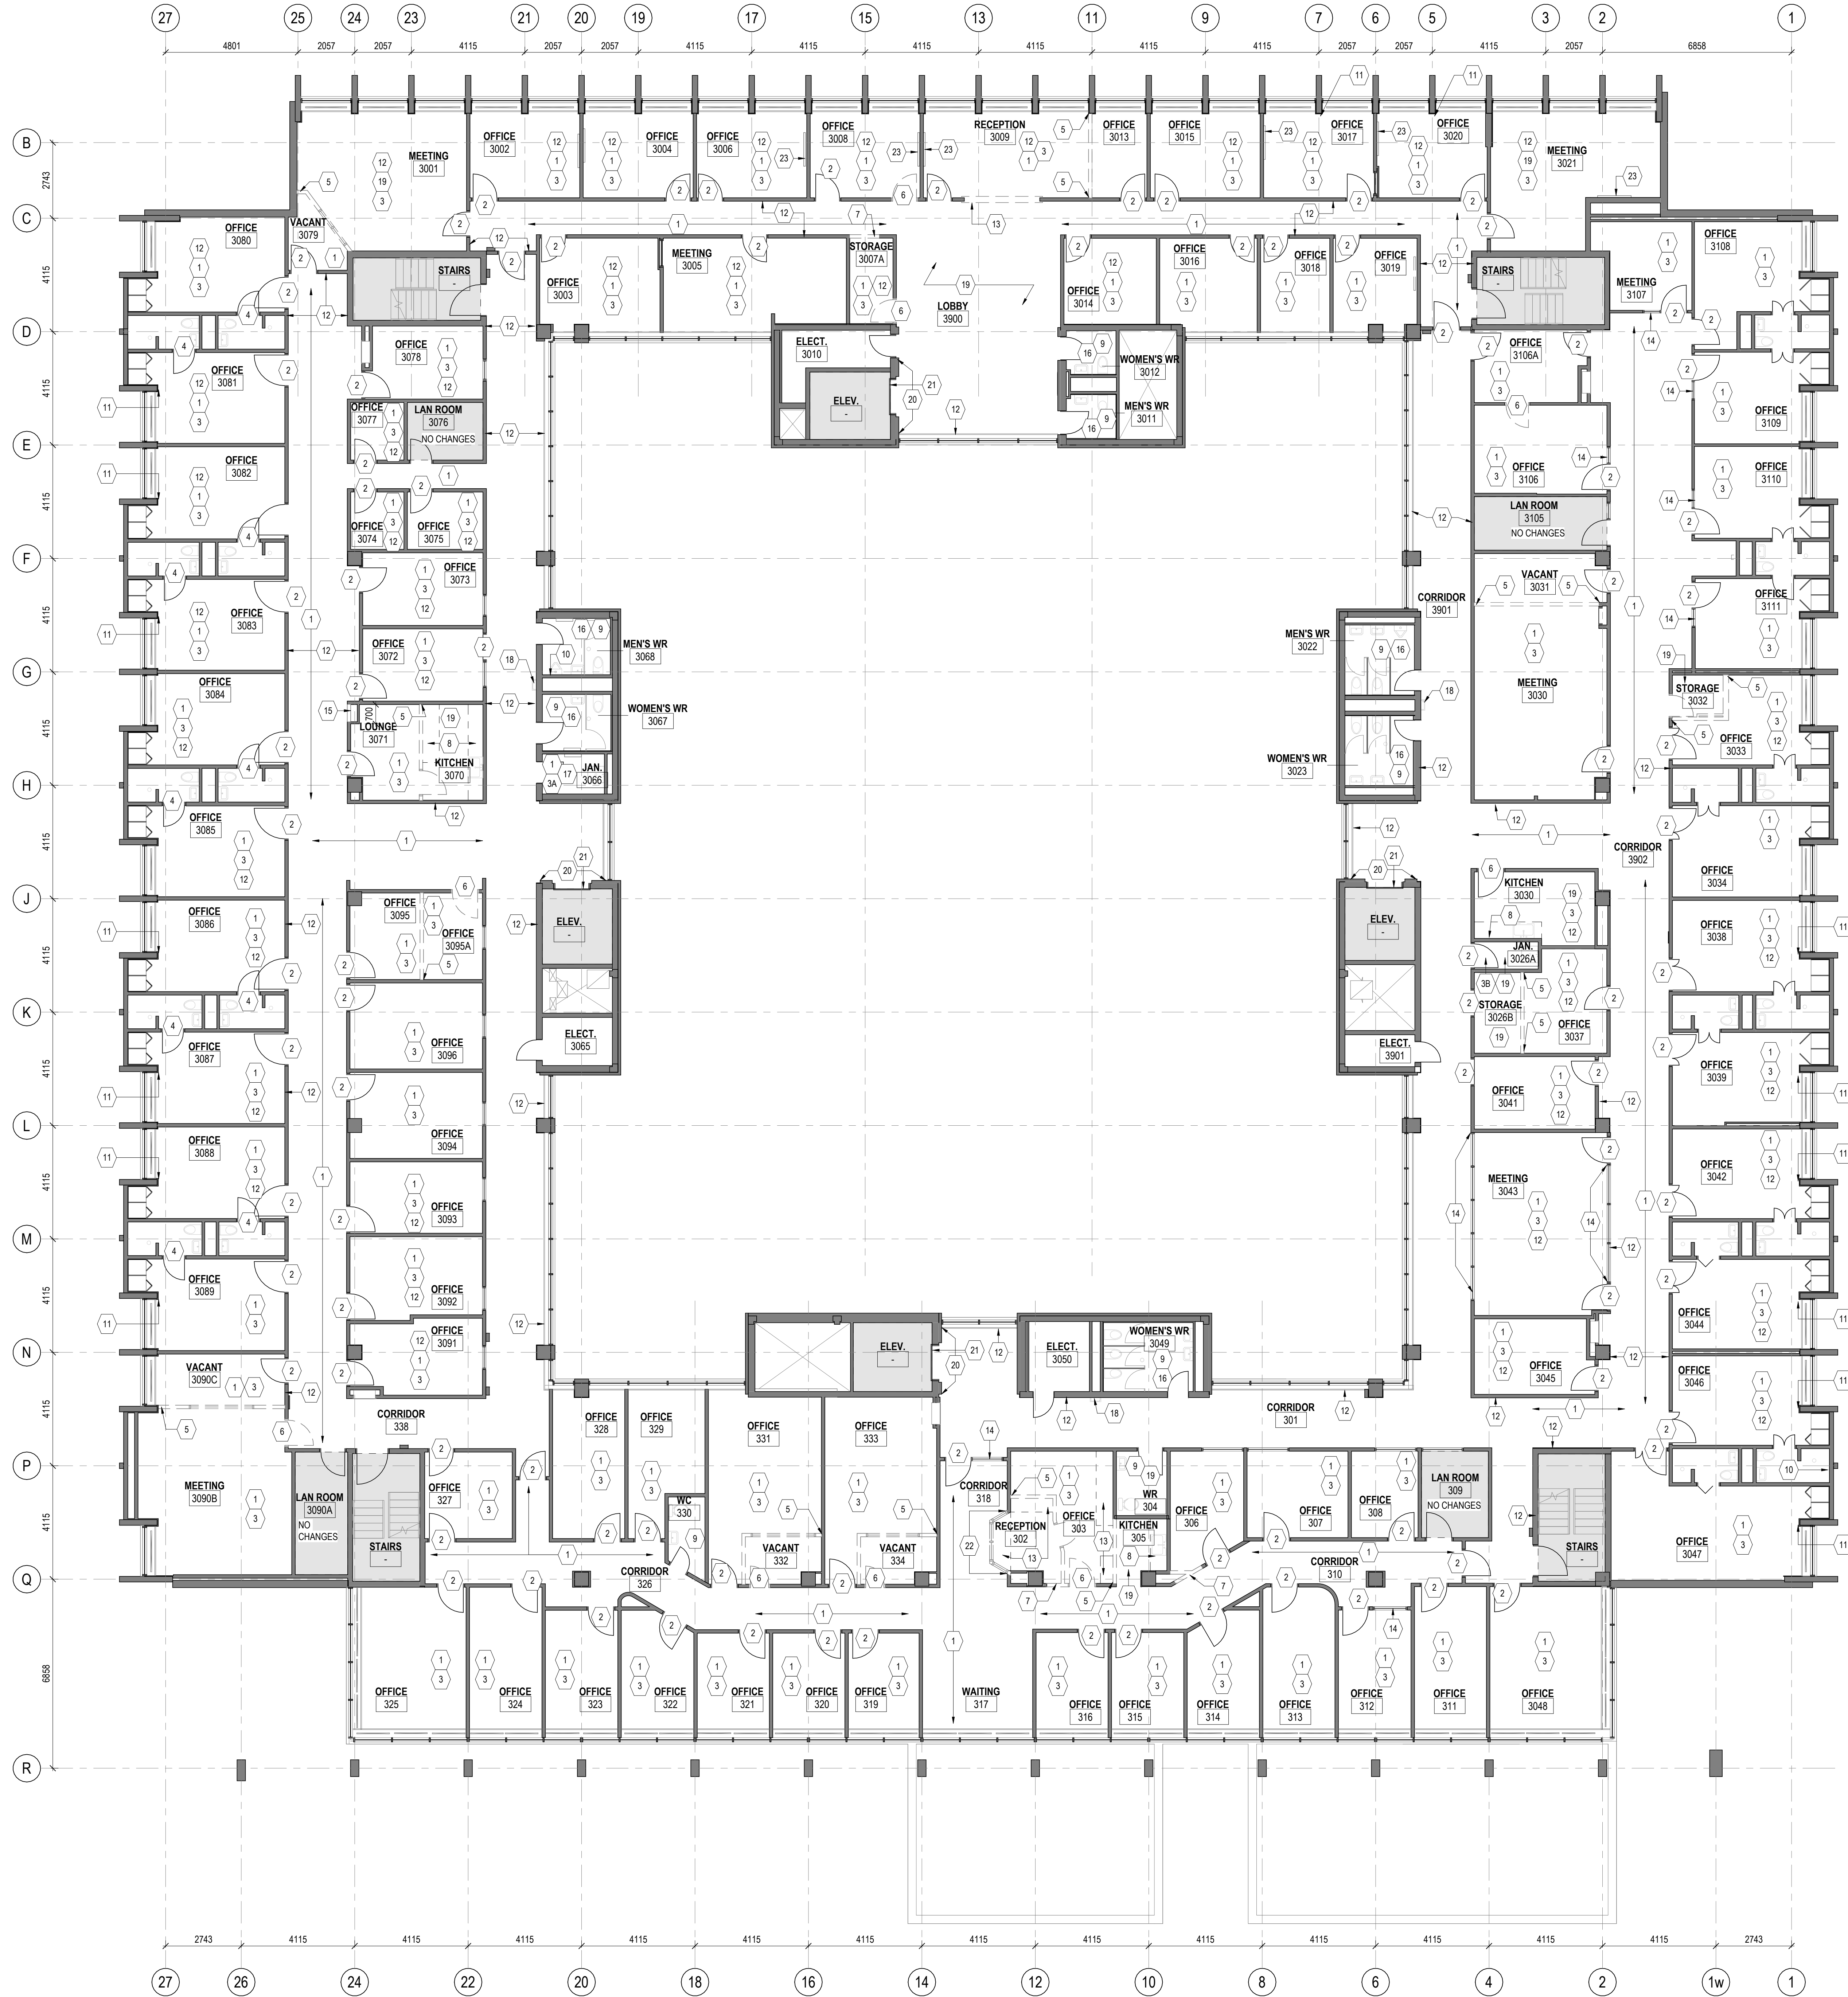

1  
A103 1:100

University of Toronto  
UNIVERSITY PLANNING,  
DESIGN & CONSTRUCTION

Design & Engineering  
255 McCaul Street, 4th Floor, Toronto, Ontario M5T 1W7

This drawing is the property of the University of Toronto, and must be returned upon completion of the work. All information shown on this drawing is for use on this specific project. Contractor must verify all dimensions on the job and report any discrepancies to the Architect before proceeding with the work.

REV. DESCRIPTION DATE

9 ISSUED FOR TENDER 2026-04-22

8 ISSUED FOR BMS CD 2026-03-09

7 ISSUED FOR PERMIT 2026-03-04

6 ISSUED FOR CLASS A COSTING 2026-02-18

5 ISSUED FOR 100% DD 2026-01-23

4 ISSUED FOR CLASS B COSTING 2026-01-16

3 ISSUED FOR 50% DD 2025-11-28

2 ISSUED FOR 100% SD 2025-09-16

1 ISSUED FOR CLASS C COSTING 2025-09-02

KEY PLAN (NTS)

SCALE

PROJECT TITLE  
UNIVERSITY OF TORONTO  
33 URSULA FRANKLIN  
MATH OFFICE  
RENOVATION


DRAWING SHEET TITLE  
LEVEL 3 DEMOLITION  
PLAN

DRAWN BY: JR SCALE: As indicated  
REVIEWED BY: SC DATE CREATED: 2026/02/11  
UNIVERSITY PROJECT NUMBER, NORTH POINT  
P164-24-165


DRAWING NUMBER  
A103  
REV. NUMBER  
9



DEMOLITION NOTES	
No.	DESCRIPTION
1	EXISTING CAT SYSTEM TO REMAIN. REPLACE ANY DAMAGED MATERIAL WITH NEW TIE TO MATCH WORK.
2	EXISTING GYM CEILING TO REMAIN.
3	REMOVE EXISTING GYM CEILING
4	REMOVE EXISTING GYM CEILING, REMAIN EDGE OF FRAME TO MAINTAIN WORK AREA TO MATCH WORK.
5	REMOVE PLASTIC COVER LEAVE FRAME IN PLACE
6	PATCH REPAIR AND MAKE GOOD EXISTING GUERIN IN PLACE
7	REMOVE EXISTING GUERIN IN PLACE
8	REMOVE EXISTING MANUAL ROLLER SHADE
9	REMOVE EXISTING AUTOMATED ROLLER SHADES
10	REMOVE PORTION OF EXISTING TIE ON GYM CEILING
11	REMOVE EXISTING SYSTEM TO MAINTAIN WORK AREA AS REQUIRED TO MAINTAIN SUPPORT FOR ADJACENT CEILINGS AND WALLS - REFER TO STRUCTURAL DETAILS FOR TEMPORARY SUPPORT
12	REMOVE EXISTING PLAST CEILING INCLUDING ALL TRACK, CLIPS AND HANGERS - REMOVE ALSO SUSPENDED LIGHT FIXTURES AND DIFFUSERS - (SEE MECH AND ELEC)
13	REMOVE BLOWN FINISH AND EXISTING FRAMING TO REMAIN TO MATCH WORKING CONDITIONS
14	EXISTING SLOPED GYM CEILING TO REMAIN (TYP.)
15	EXISTING METAL CEILING ACCESS PANEL TO REMAIN
16	EXISTING METAL CEILING SIGNED DIRECTIONAL, SIGNAGE

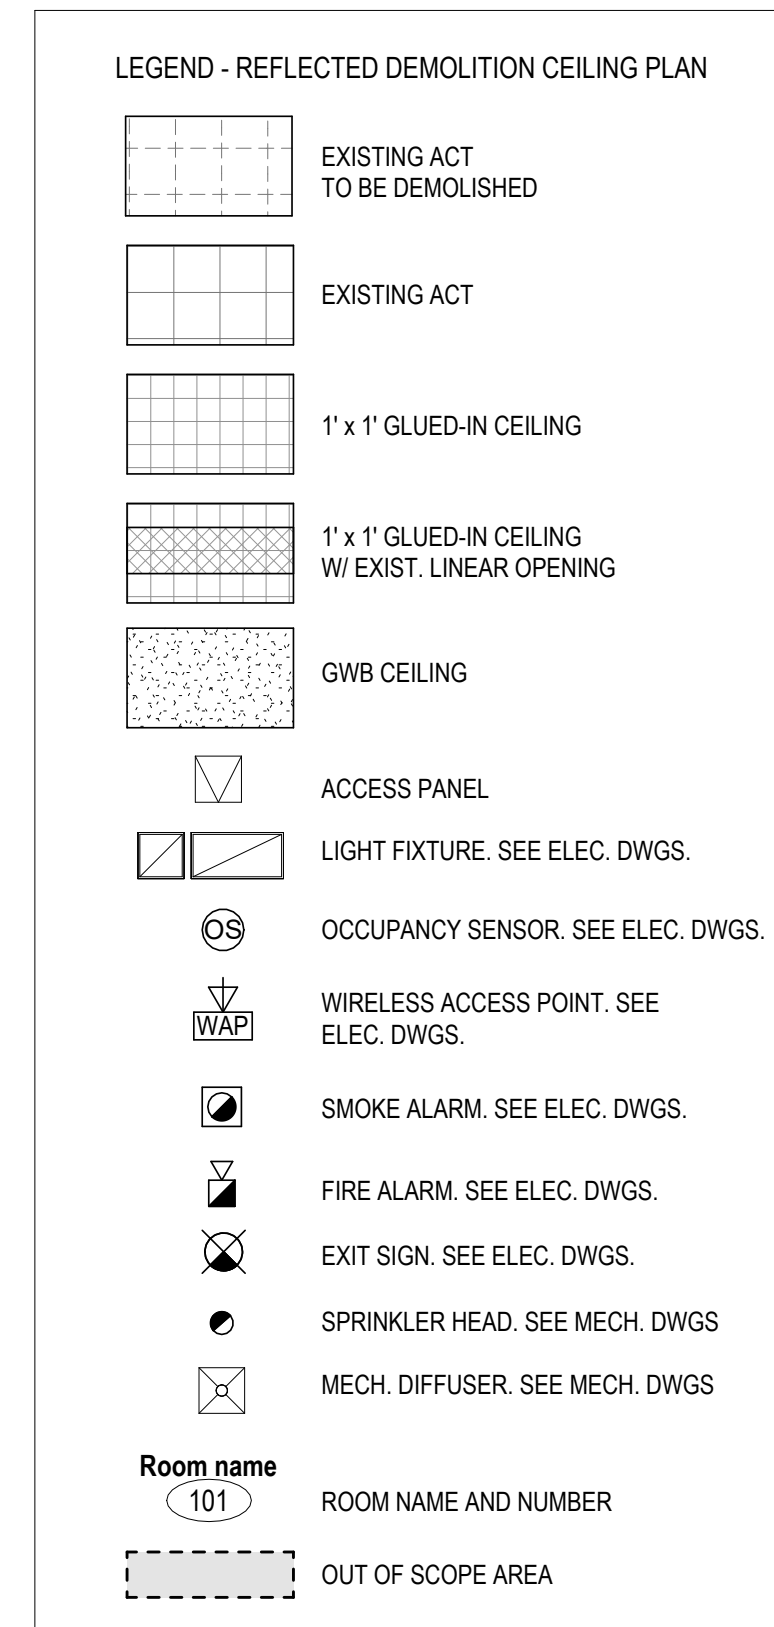

- GENERAL NOTES - DEMOLITION:**
- THIS DRAWING IS TO BE READ IN CONJUNCTION WITH THE MECHANICAL AND ELECTRICAL DRAWINGS.
  - ROOM NUMBERS SHOWN ARE EXISTING ROOM NUMBERS. REFER TO THE MECHANICAL AND ELECTRICAL DRAWINGS FOR THE CORRECT ROOM NUMBERS.
  - FOR ALL HAZARDOUS MATERIALS REMOVAL PROCEDURES, REFER TO THE MECHANICAL AND ELECTRICAL DRAWINGS FOR THE CORRECT SCOPE OF WORK. CONTRACTOR IS RESPONSIBLE FOR DEMOLITION OF DESIGNATED SUBSTANCES AS NOTED IN THE SCOPE OF WORK AND HAZARDOUS MATERIALS NOTED IN THE HAZARDOUS MATERIALS REPORT WERE AFFECTED BY CONSTRUCTION INCLUDING BUT NOT LIMITED TO MECHANICAL AND ELECTRICAL.
  - DO NOT PROOF TRAFFIC/PEDESTRIAN MOVEMENT BEING IN PLACE PRIOR TO THE DEMOLITION OF THE EXISTING WORK. CONTRACTOR SHALL PROVIDE PUBLIC SIGNS BY IMPACT RESISTANT ORYLLW, TAPE, FILLED, PLOTTED, TO COMPLETELY SEPARATE THE WORK AREA FROM THE PUBLIC AREA. NON COMPLIANCE WITH THIS REQUIREMENT MAY REQUIRE HOPKING, PATCH AND MAKE GOOD ALL DISTURBED AREAS TO THE ORIGINAL FINISH. CONTRACTOR SHALL BE RESPONSIBLE TO MAINTAIN AND NOT MAKE THE CORRIDOR WIDER TO LESS THAN THAT.
  - REMOVE ALL METALS, SCREWS, WALL PLUGS, WALL CHIPS, STAPLES FROM EXISTING WALLS, PAPER, WARE AND MAKE GOOD WALL SURFACES.
  - REMOVE ALL AFFECTED MILL LAMINATE & OTHER EXISTING WALL SURFACES WHICH ARE IN CONTACT WITH OR ADJACENT TO THE CHALKBOARDS AND ACCESSORIES AS NOTED ON THE DRAWINGS. CONTRACTOR SHALL ASK APPROVAL FROM ALL OF THE PERSONS BEFORE DISPOSING OF REMOVED ITEMS. MATERIALS & ITEMS THAT WILL NOT BE DISPOSSED OF SHALL BE TAKEN BY THE CONTRACTOR TO A STORAGE AREA DESIGNATED BY THE UO/F REPRESENTATIVE.
  - REMOVE AND RETAIN ALL LOCKSETS/DOORKNOBLES AND ELECTRIC SWITCHES, CLOSERS AND DOOR OPERATORS. FROM DOORS TO BE SALVAGED AS NOTED ON THE DRAWINGS AND HAND OVER TO UO/F REPRESENTATIVE.
  - REMOVE ALL EXISTING DOOR AND DOOR OPERATORS FROM DOORS TO BE SALVAGED AS NOTED ON THE DRAWINGS AND HAND OVER TO UO/F REPRESENTATIVE.
  - REMOVE AND SALVAGE EXISTING DOORS AND FRAMES AS NOTED ON THE DRAWINGS.
  - REMOVE EXISTING WALL BASE WITHIN THE CONSTRUCTION AREA UNLESS NOTED OTHERWISE AND MAKE GOOD WALLS AS REQUIRED BY THE UO/F REPRESENTATIVE.
  - REMOVE ALL EXISTING FLOOR FINISH WITHIN THE CONSTRUCTION AREA UNLESS NOTED OTHERWISE AND MAKE GOOD FLOORS AS REQUIRED BY THE UO/F REPRESENTATIVE.
  - REMOVE ALL ADHESIVE AND PATCH AND REPAIR SUBSTRATE TO RECEIVE NEW FLOOR FINISH TO PROVIDE SMOOTH SURFACE.
  - WHERE CONCRETE PARTITION WALLS ARE BEING REMOVED ENSURE THE REMOVAL OF THE WALLS AT NEAREST CORNER JOINT TO PROVIDE AN ENDFACE OF REMAINING BLOCKS TYP.
  - WHERE WALLS AND FLOORING ARE BEING REMOVED, LOCALLY PATCH AND LEVEL ANY AREAS OF DAMAGED FLOOR CONCRETE SUBSURFACE TO PROVIDE SMOOTH SURFACE READY TO RECEIVE NEW FINISHES.
  - REMOVE ALL EXISTING FLOOR FINISHES AND MAKE GOOD FLOORS AS REQUIRED.
  - FOR ALL GENERAL NOTES FOR ADDITIONAL DEMOLITION INFORMATION.

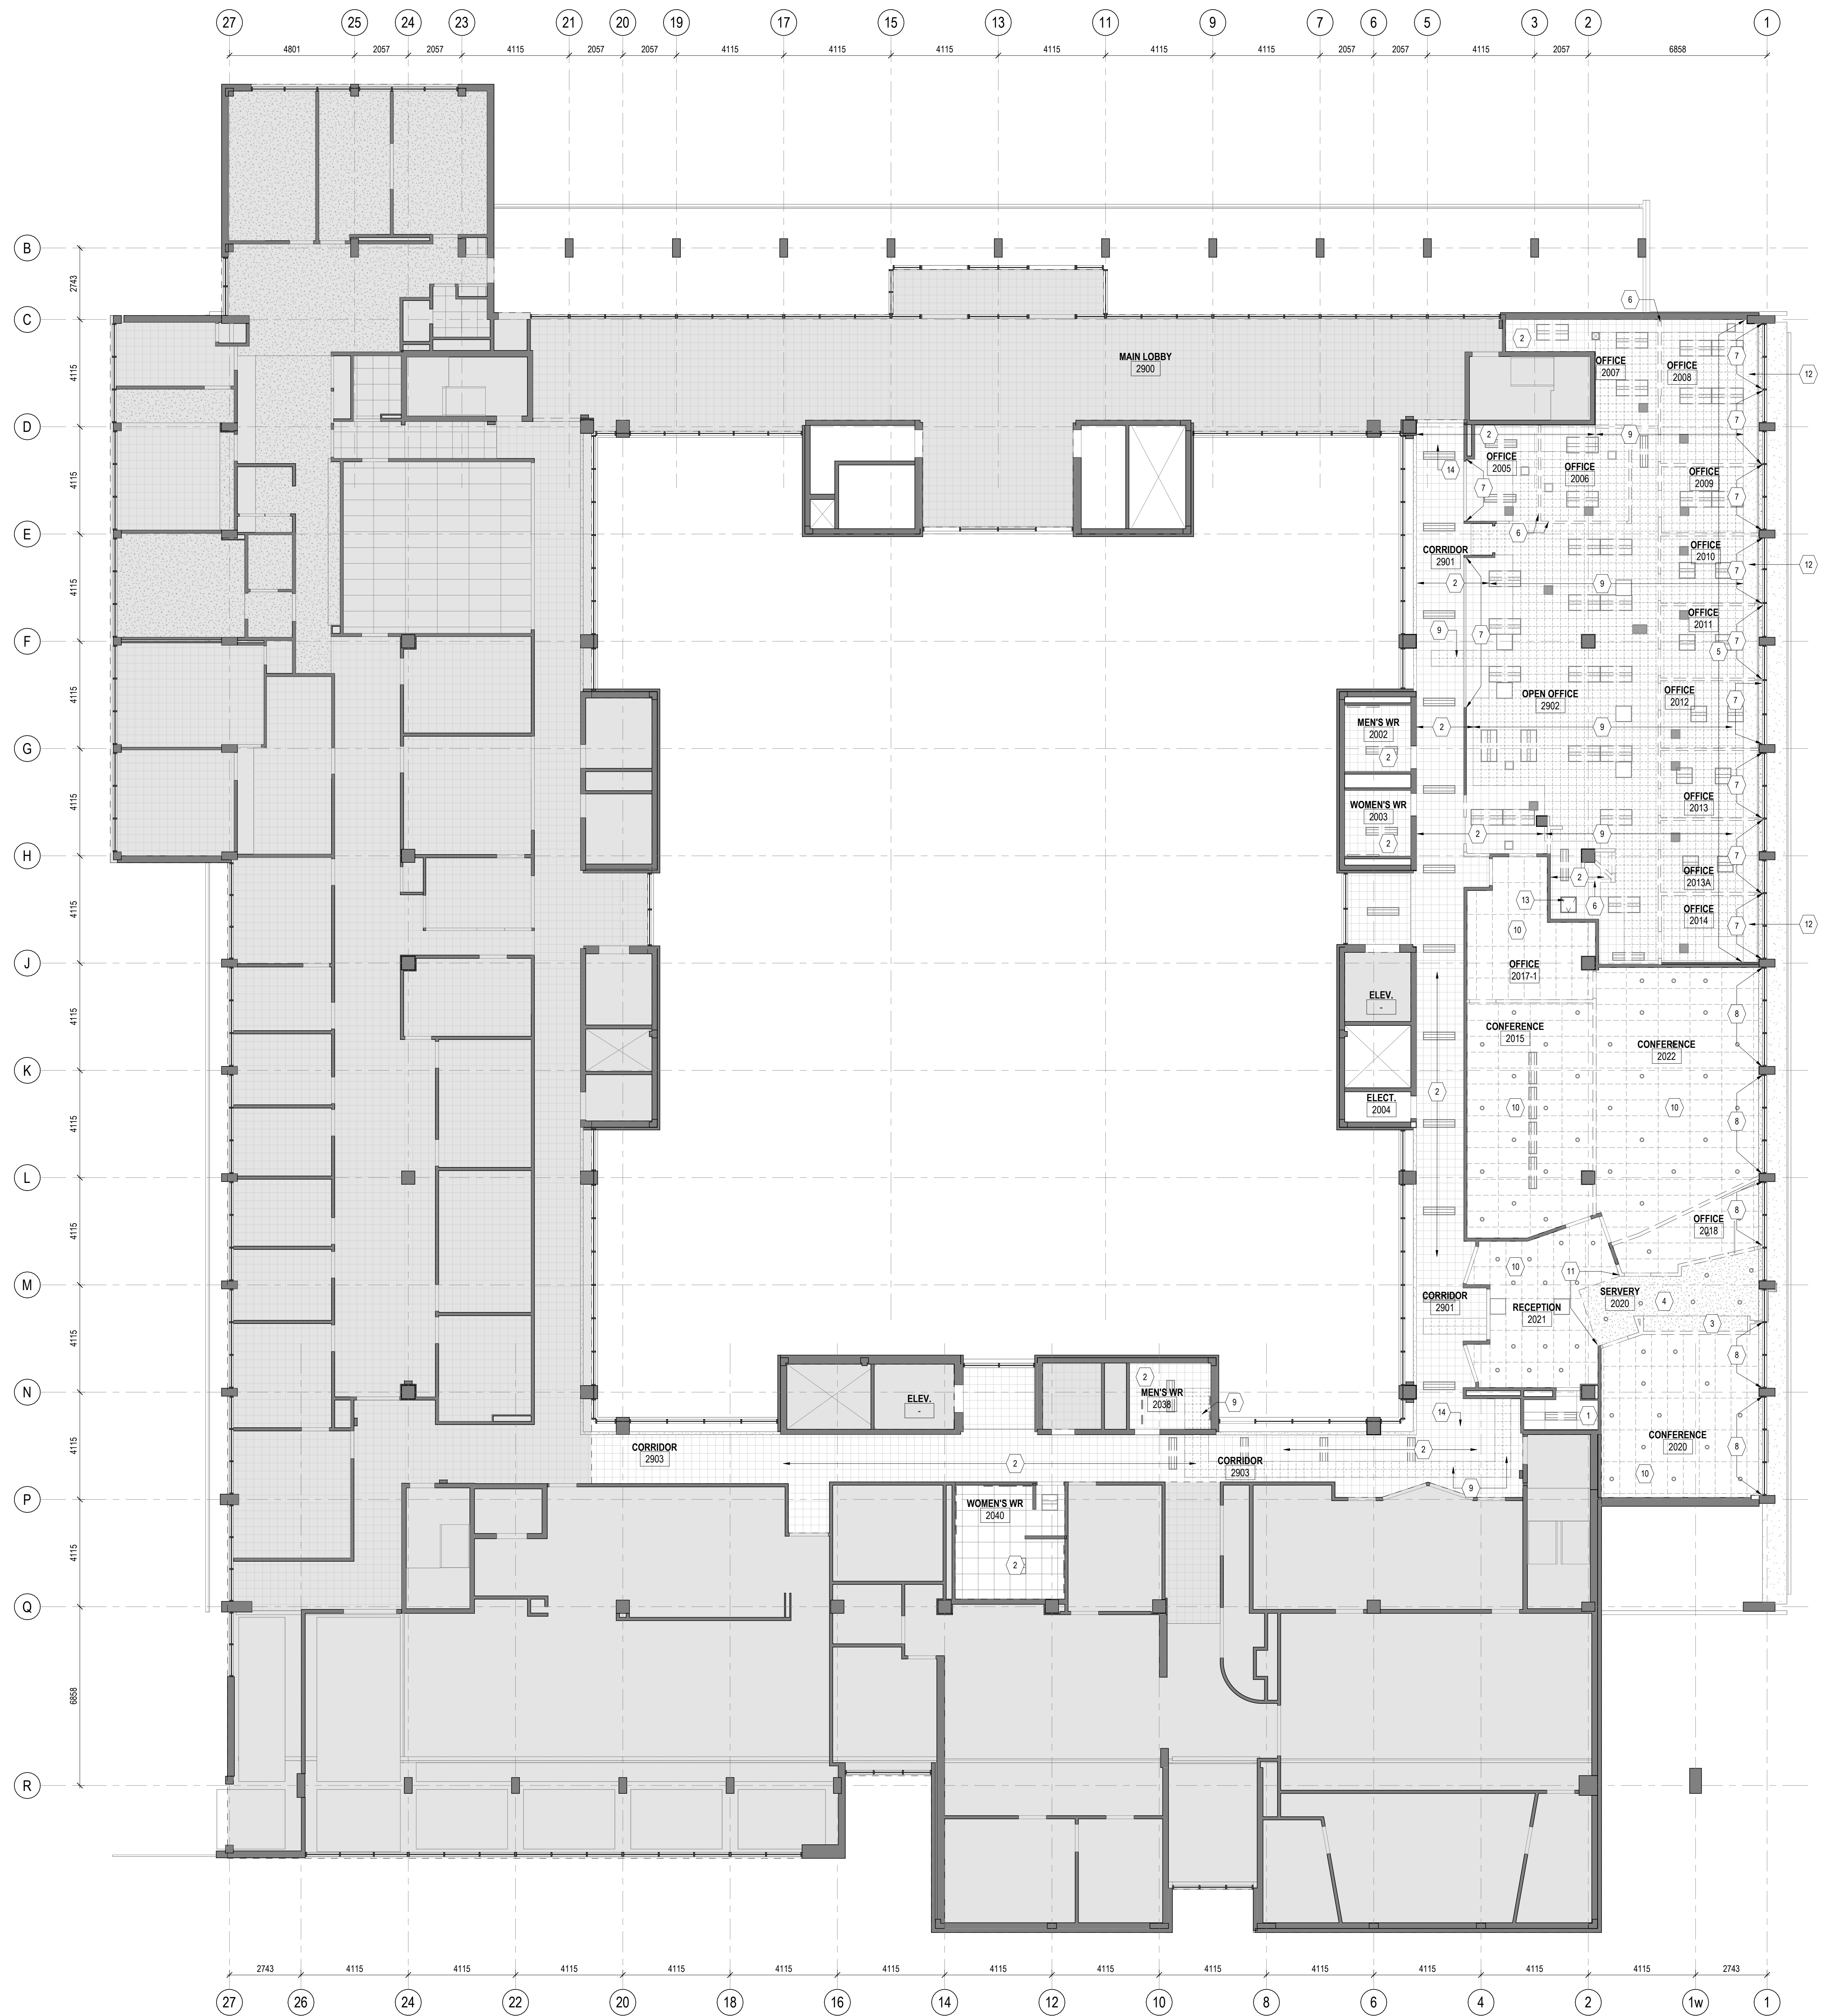

1 LEVEL 2 DEMOLITION RCP  
A112 1 : 100


7	ISSUED FOR TENDER	2026-04-22
6	ISSUED FOR 80% CD	2026-03-09
5	ISSUED FOR PERMIT	2026-03-04
4	ISSUED FOR CLASS A COSTING	2026-02-18
3	ISSUED FOR 100% DD	2026-01-23
2	ISSUED FOR CLASS B COSTING	2026-01-16
1	ISSUED FOR 50% DD	2025-11-28
REV.	DESCRIPTION	DATE

KEY PLAN (NTS)	SEAL
----------------	------

PROJECT TITLE:  
UNIVERSITY OF TORONTO  
**33 URSULA FRANKLIN  
MATH OFFICE  
RENOVATION**

33 URSULA FRANKLIN ST.  
DRAWING SHEET TITLE  
**LEVEL 2 DEMOLITION**  
**RCP**


DRAWN BY: JR	SCALE: As indicated
REVIEWED BY: SC	DATE CREATED: 2026/02/11

UNIVERSITY PROJECT NUMBER	NORTH POINT
P164-24-165	

DRAWING NUMBER	REV. NUMBER
<b>A112</b>	<b>7</b>





C:\Users\songanit\Documents\IP164-25-165\_A\_26\_anita\_song.rvt 2026-04-22 11:51:19 AM

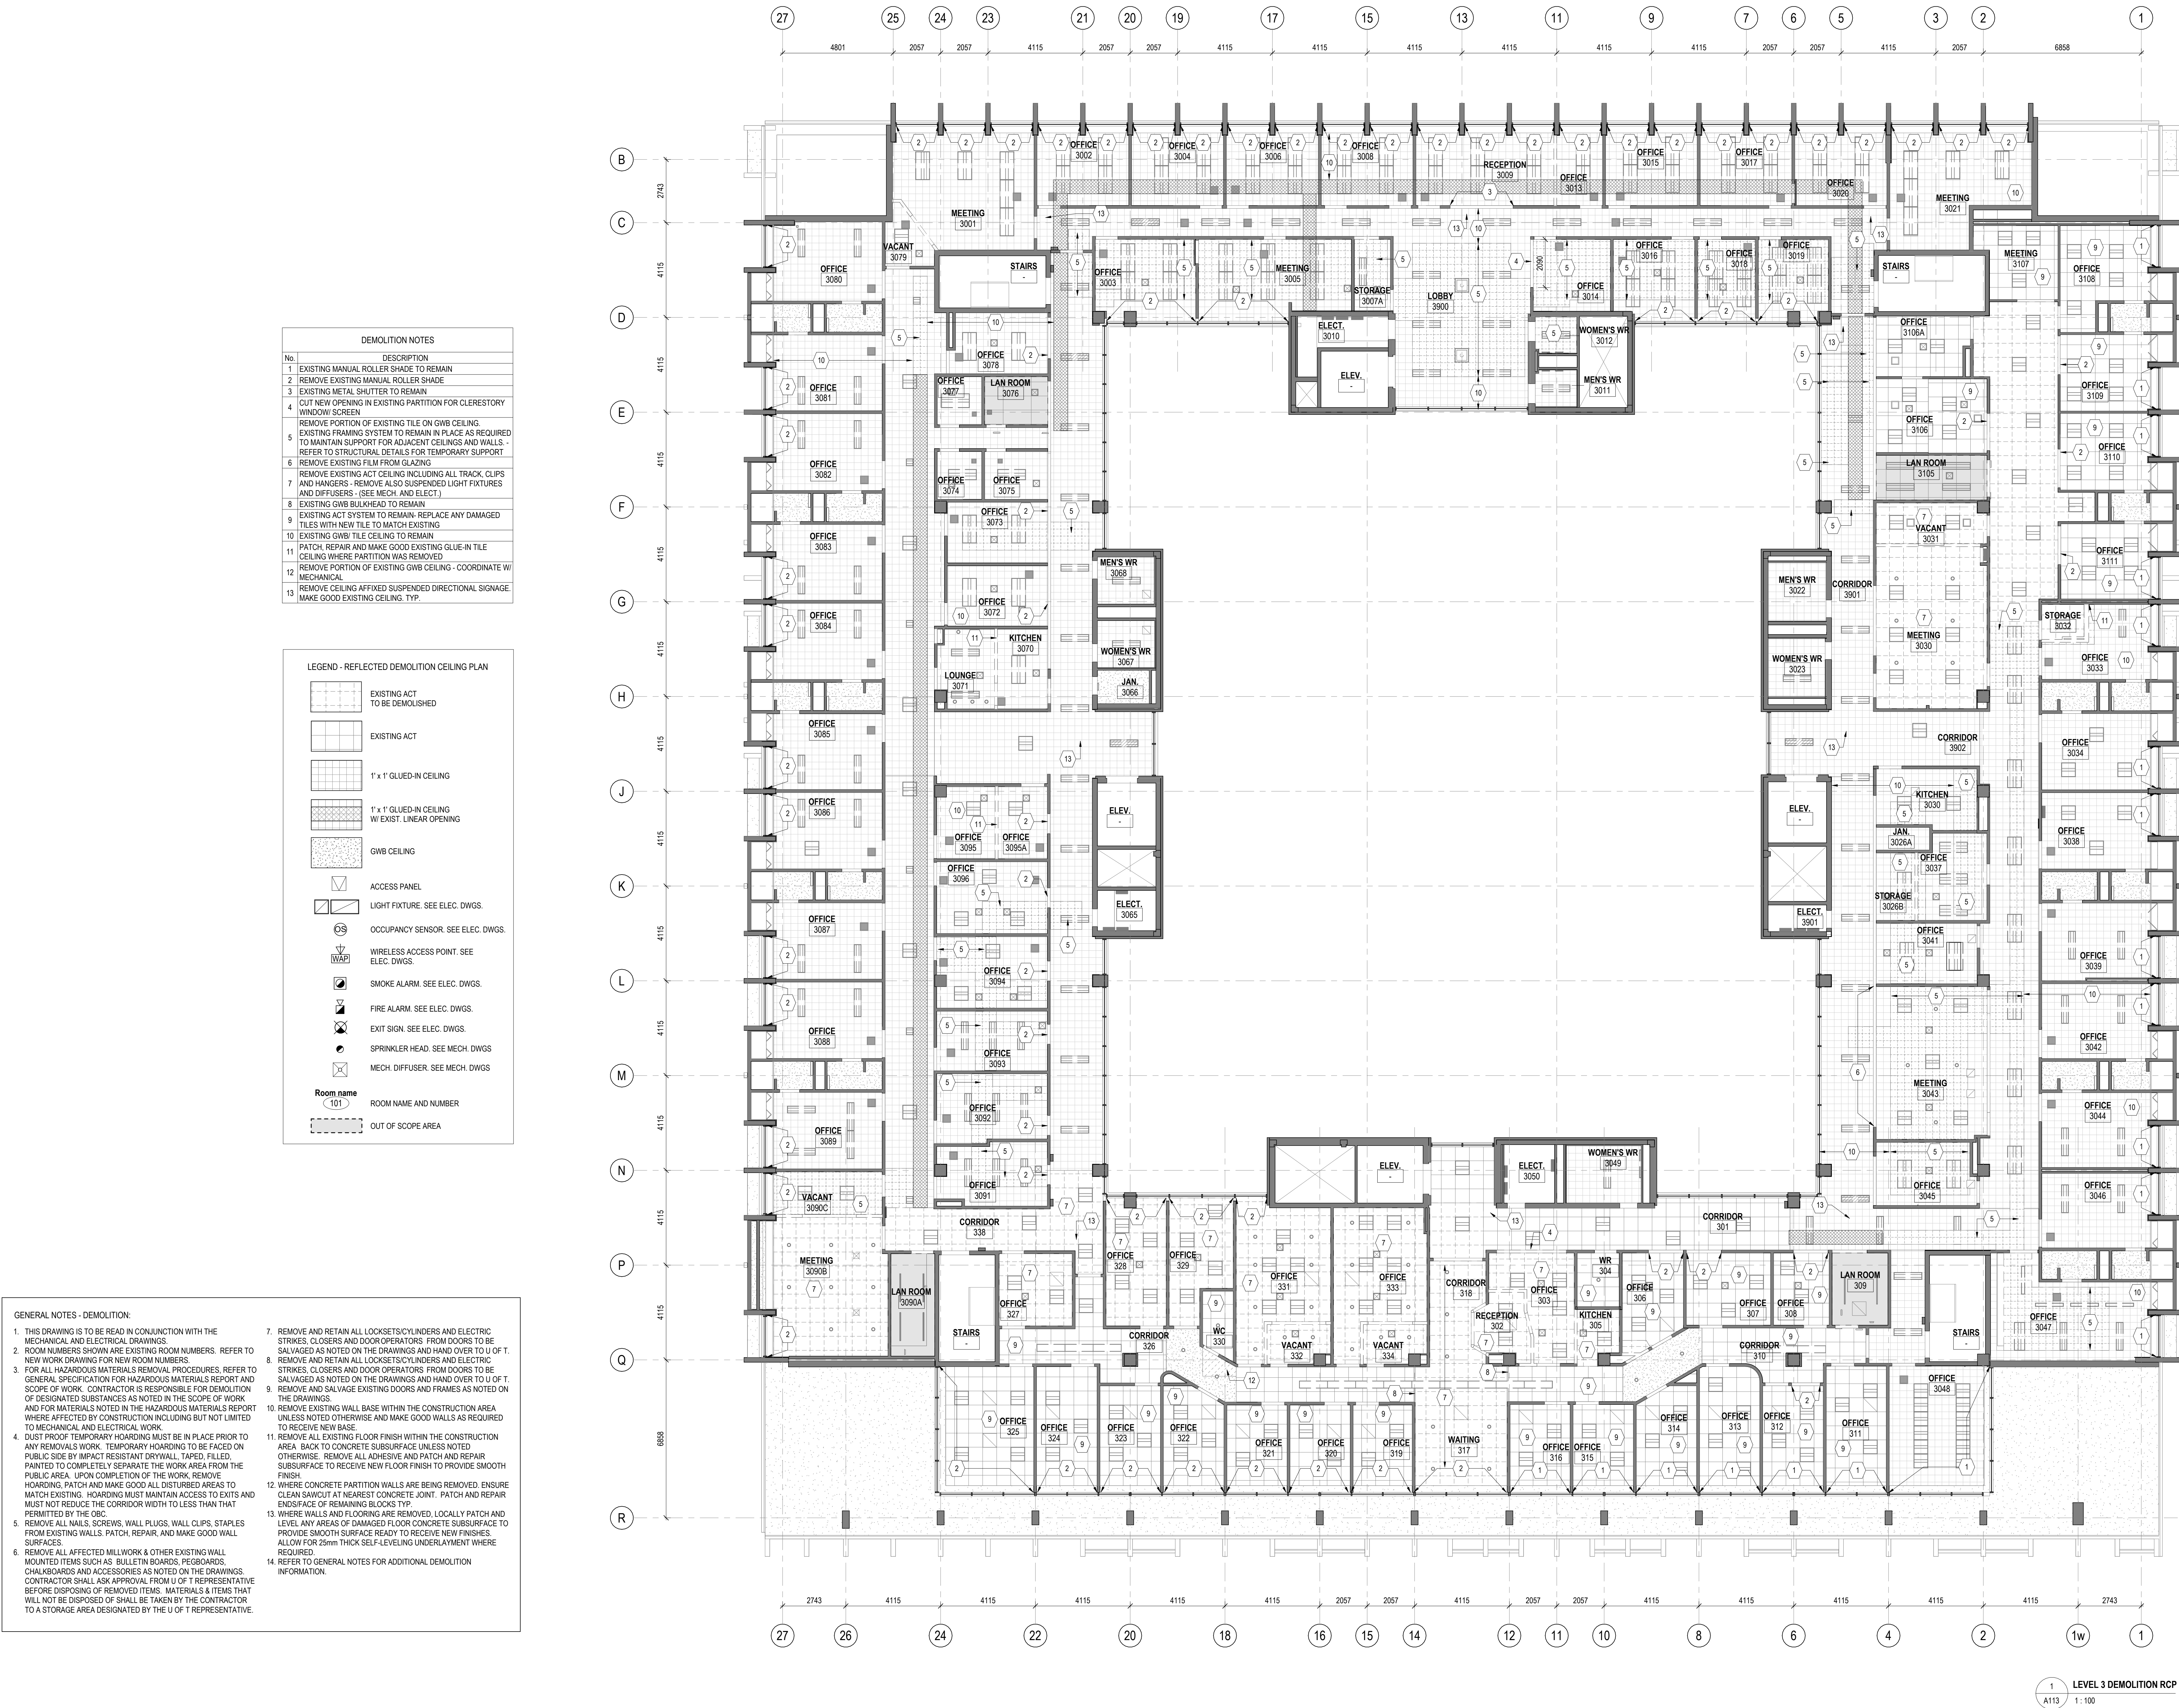



C:\Users\songanit\Documents\P164-25-165\_A\_26\_anita\_song.rvt 2026-04-22 11:51:23 AM

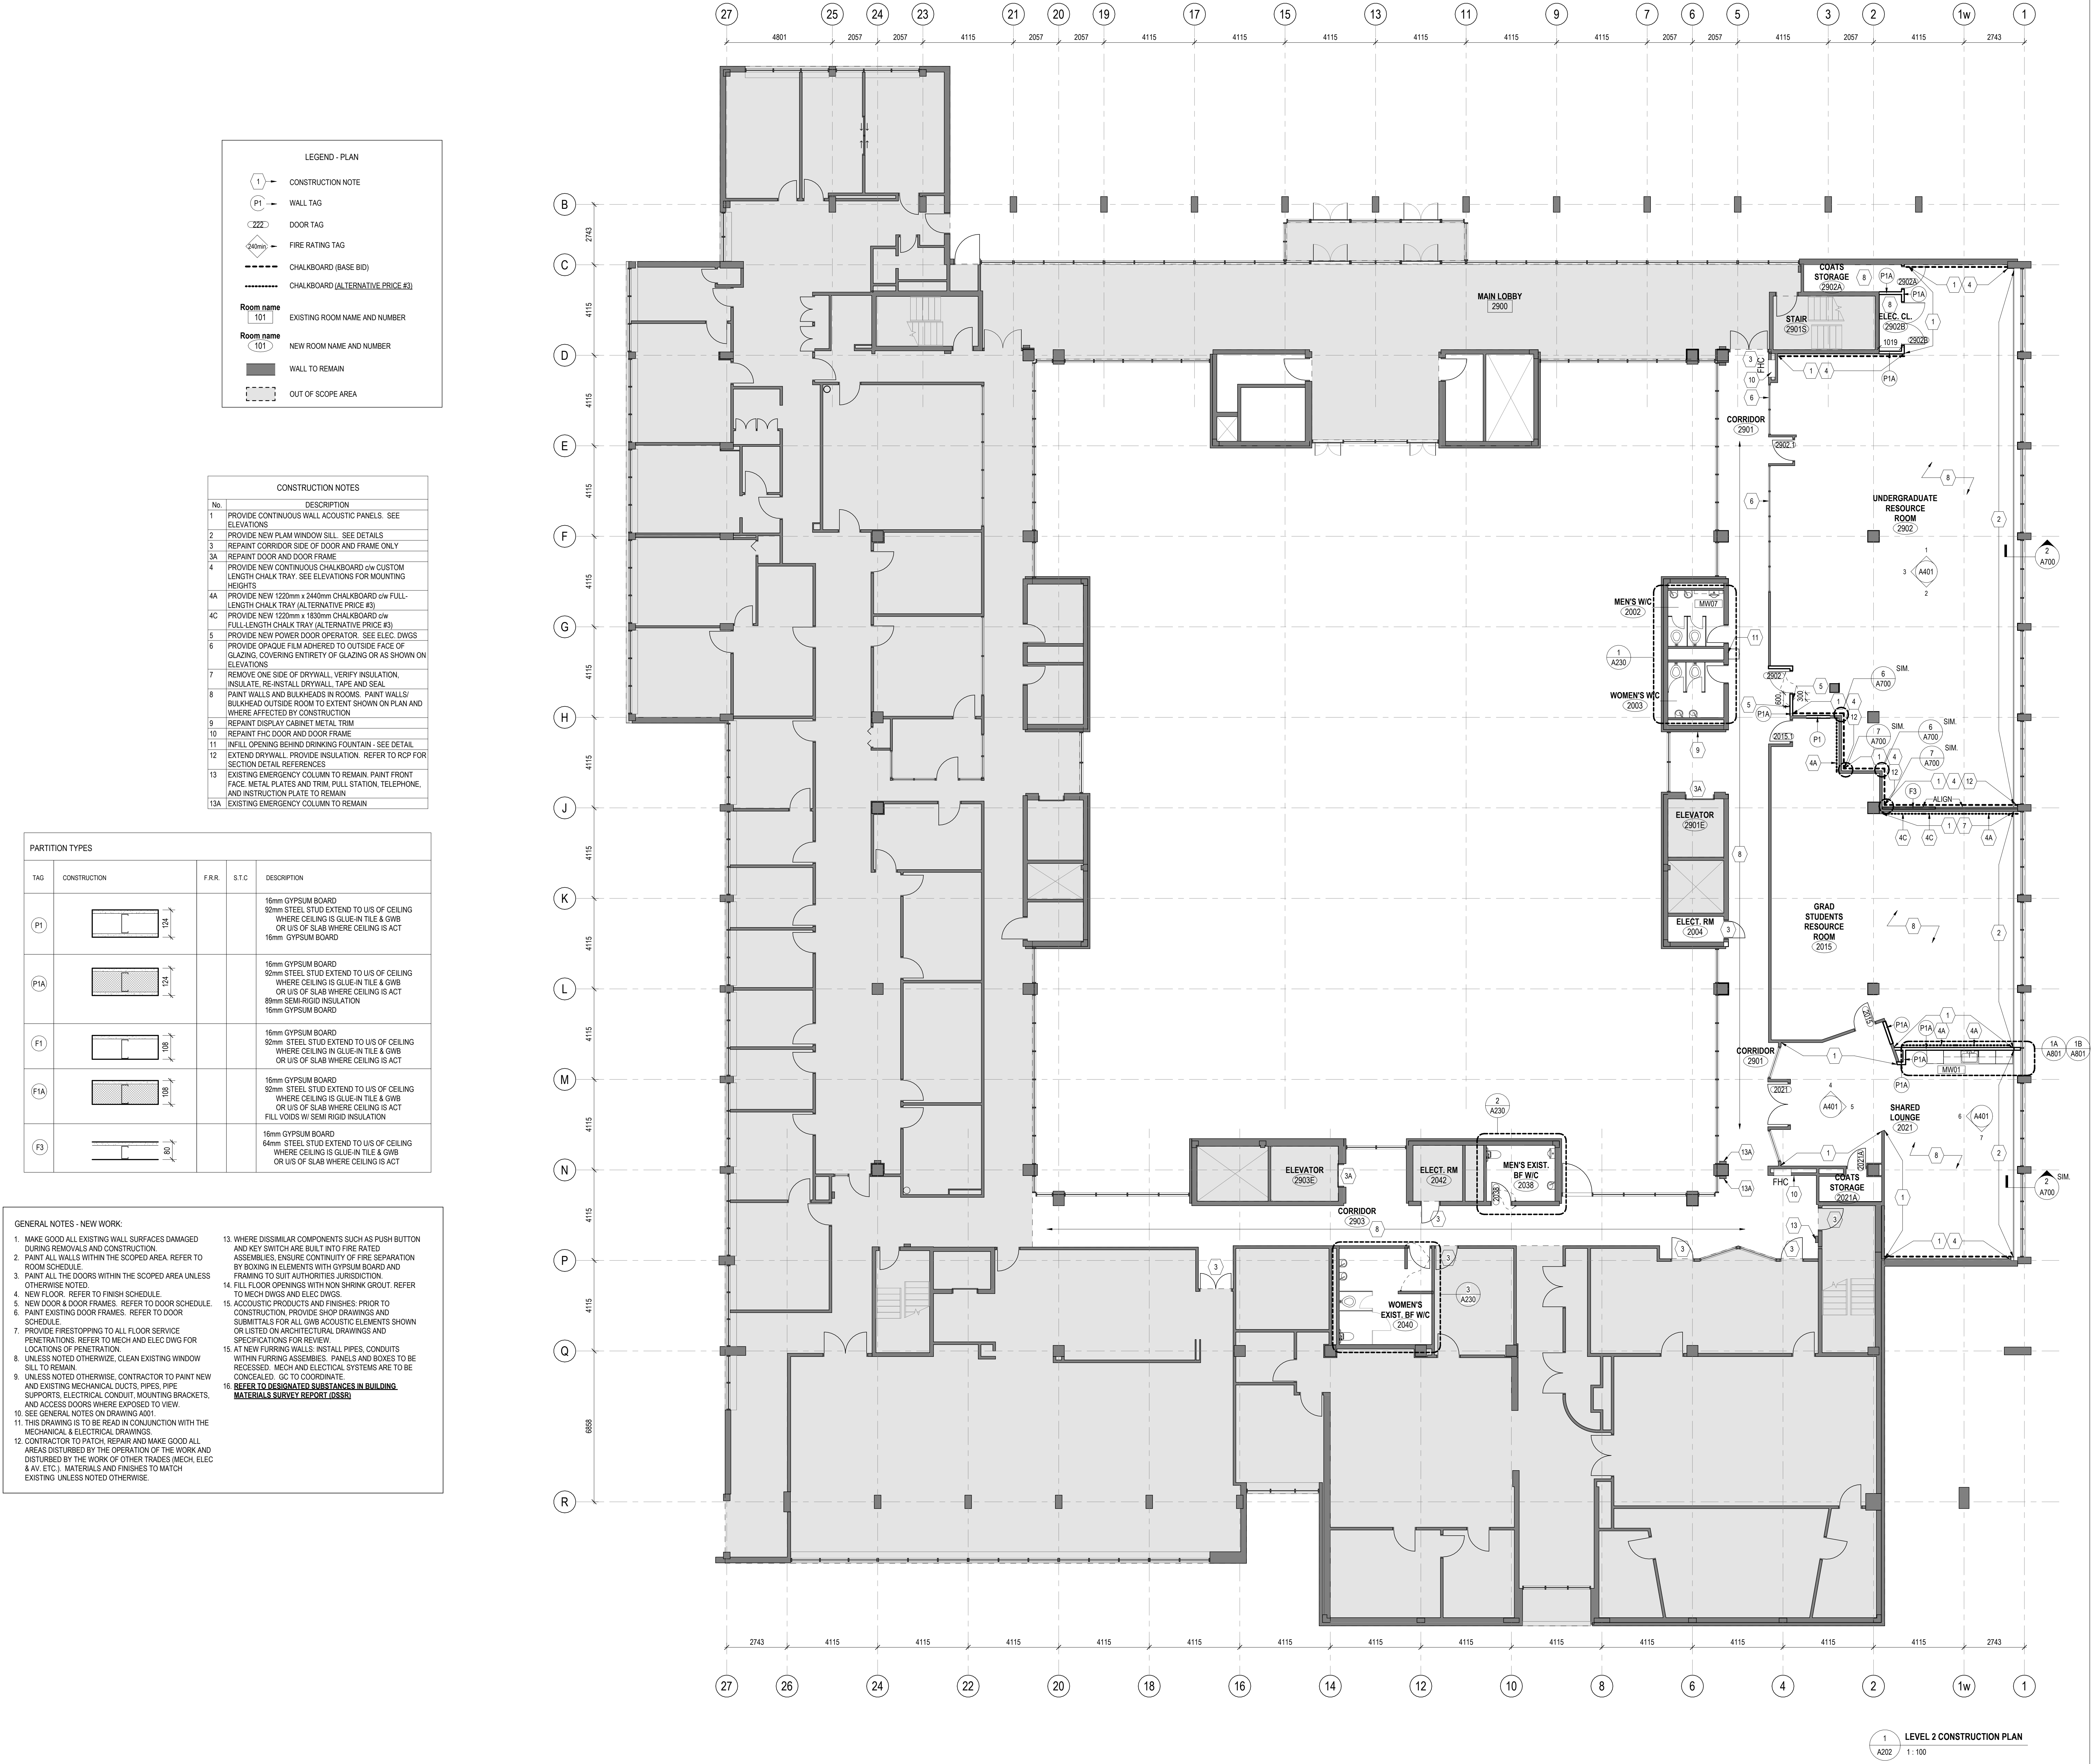



University of Toronto

UNIVERSITY PLANNING,  
DESIGN & CONSTRUCTION

Design & Engineering

255 McCaul Street, 4th Floor, Toronto, Ontario M5T 1W7

This drawing is the property of the University of Toronto, and must be returned upon completion of the work. All information shown on this drawing is for use on this specific project. Contractor must verify all dimensions on the job and report any discrepancies to the Architect before proceeding with the work.

1

LEVEL 2 CONSTRUCTION PLAN

1:100

1

2026

9

ISSUED FOR TENDER

2026-04-22

8

ISSUED FOR 80% CD

2026-03-09

7

ISSUED FOR PERMIT

2026-03-04

6

ISSUED FOR CLASS A COSTING

2026-02-18

5

ISSUED FOR 100% DD

2026-01-23

4

ISSUED FOR CLASS B COSTING

2026-01-16

3

ISSUED FOR 50% DD

2025-11-28

2

ISSUED FOR 100% SD

2025-09-16

1

ISSUED FOR CLASS C COSTING

2025-09-03

REV.

DESCRIPTION

DATE

KEY PLAN (NTS)

SCALE

PROJECT TITLE

UNIVERSITY OF TORONTO

33 URSULA FRANKLIN

MATH OFFICE

RENOVATION

33 URSULA FRANKLIN ST.

DRAWING SHEET TITLE

LEVEL 2 CONSTRUCTION

PLAN

DRAWN BY: JRV AS

SCALE: As indicated


REVIEWED BY: SC

DATE CREATED: 2026/02/11

UNIVERSITY PROJECT NUMBER

NORTH POINT

P164-24-165

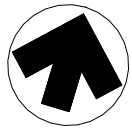

DRAWING NUMBER

A202


REV. NUMBER

9



C:\Users\songant\Documents\164-25-165\_A\_26\_anita\_song.rvt 2026-04-22 11:51:34 AM

This drawing is the property of the University of Toronto, and must be returned upon completion of the work. All information shown on this drawing is for use on the specific project. Contractor must verify all dimensions on the job and report any discrepancies to the Architect before proceeding with the work.

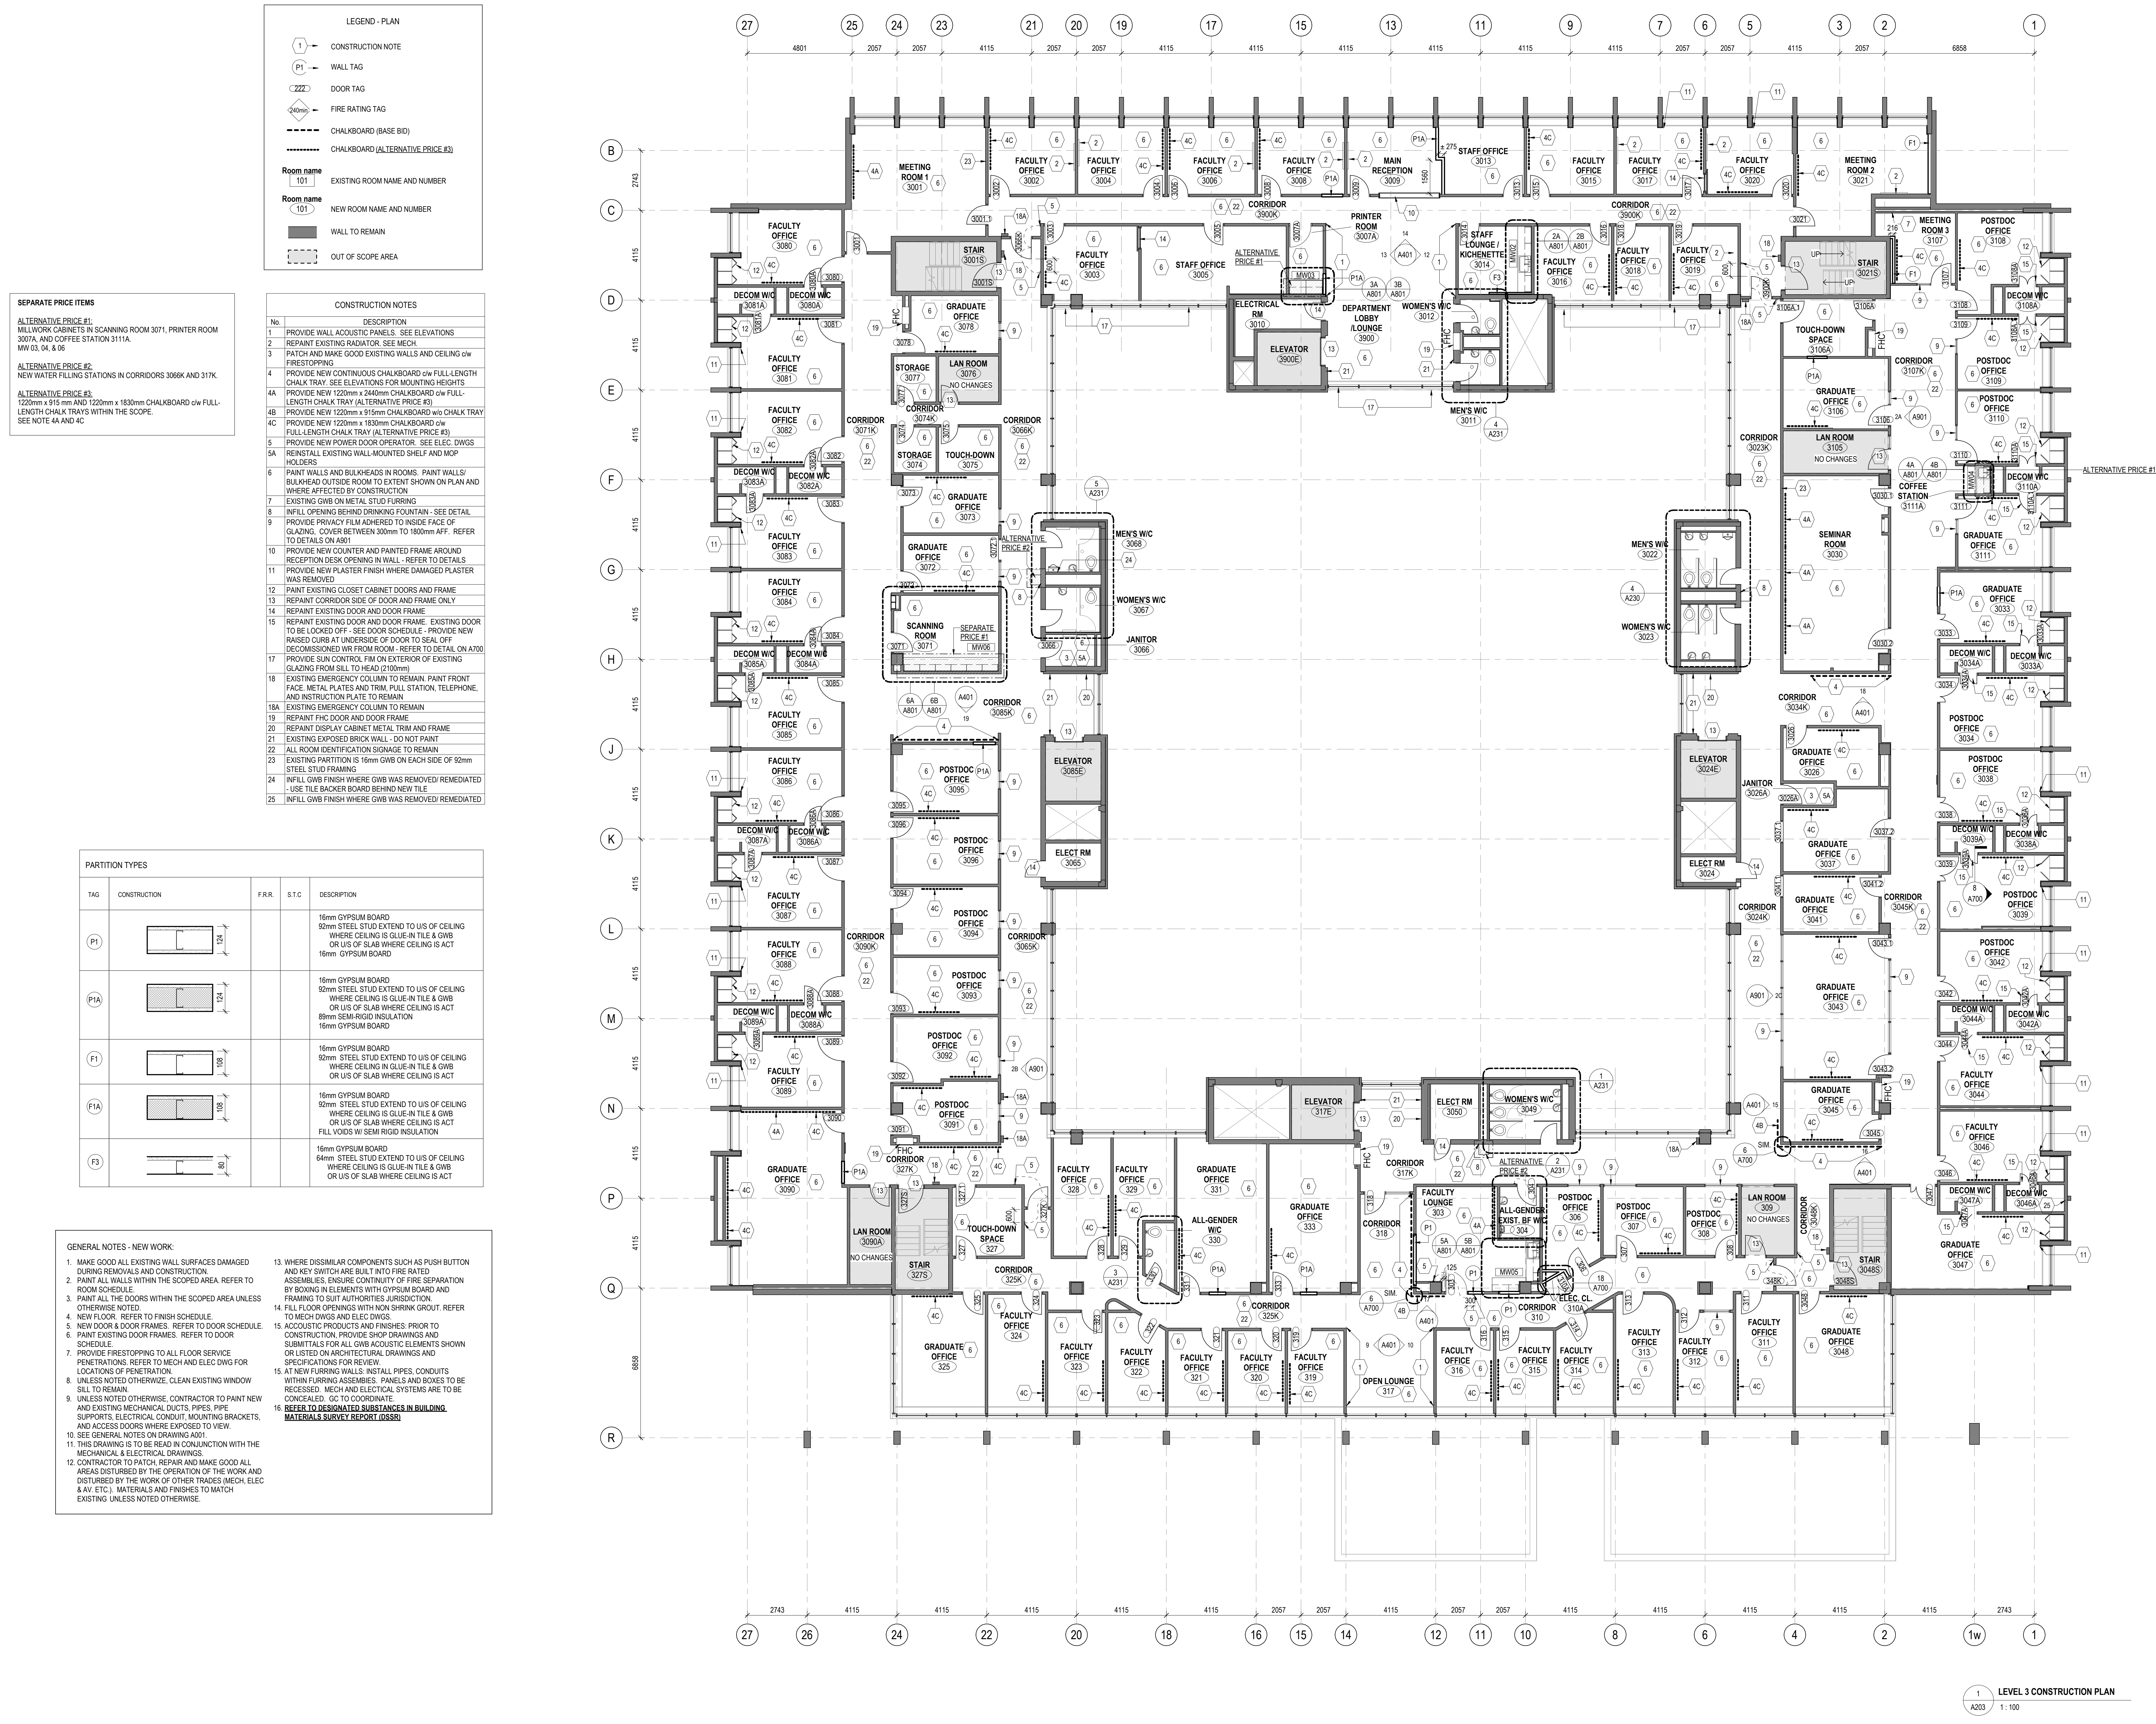

9	ISSUED FOR TENDER	2026-04-22
8	ISSUED FOR BPA, CD	2026-03-09
7	ISSUED FOR PERMIT	2026-03-04
6	ISSUED FOR CLASS A COSTING	2026-02-18
5	ISSUED FOR 100% ID	2026-01-23
4	ISSUED FOR CLASS B COSTING	2026-01-16
3	ISSUED FOR 50% ID	2025-11-28
2	ISSUED FOR 100% SD	2025-09-16
1	ISSUED FOR CLASS C COSTING	2025-08-02
REV.	DESCRIPTION	DATE

KEY PLAN (N/T) SEAL



PROJECT TITLE  
UNIVERSITY OF TORONTO  
**33 URSULA FRANKLIN  
MATH OFFICE  
RENOVATION**

33 URSULA FRANKLIN ST.  
DRAWING SHEET TITLE  
**LEVEL 3 CONSTRUCTION  
PLAN**

DRAWN BY: JRV AS	SCALE: As indicated
REVIEWED BY: SC	DATE CREATED: 2026/02/11
UNIVERSITY PROJECT NUMBER: NORTH POINT	
P164-24-165	
DRAWING NUMBER <b>A203</b>	REV. NUMBER <b>9</b>



C:\Users\songanit\Documents\IP164-25-165\_A\_26\_anita\_song.rvt2026-04-22 11:51:35 AM

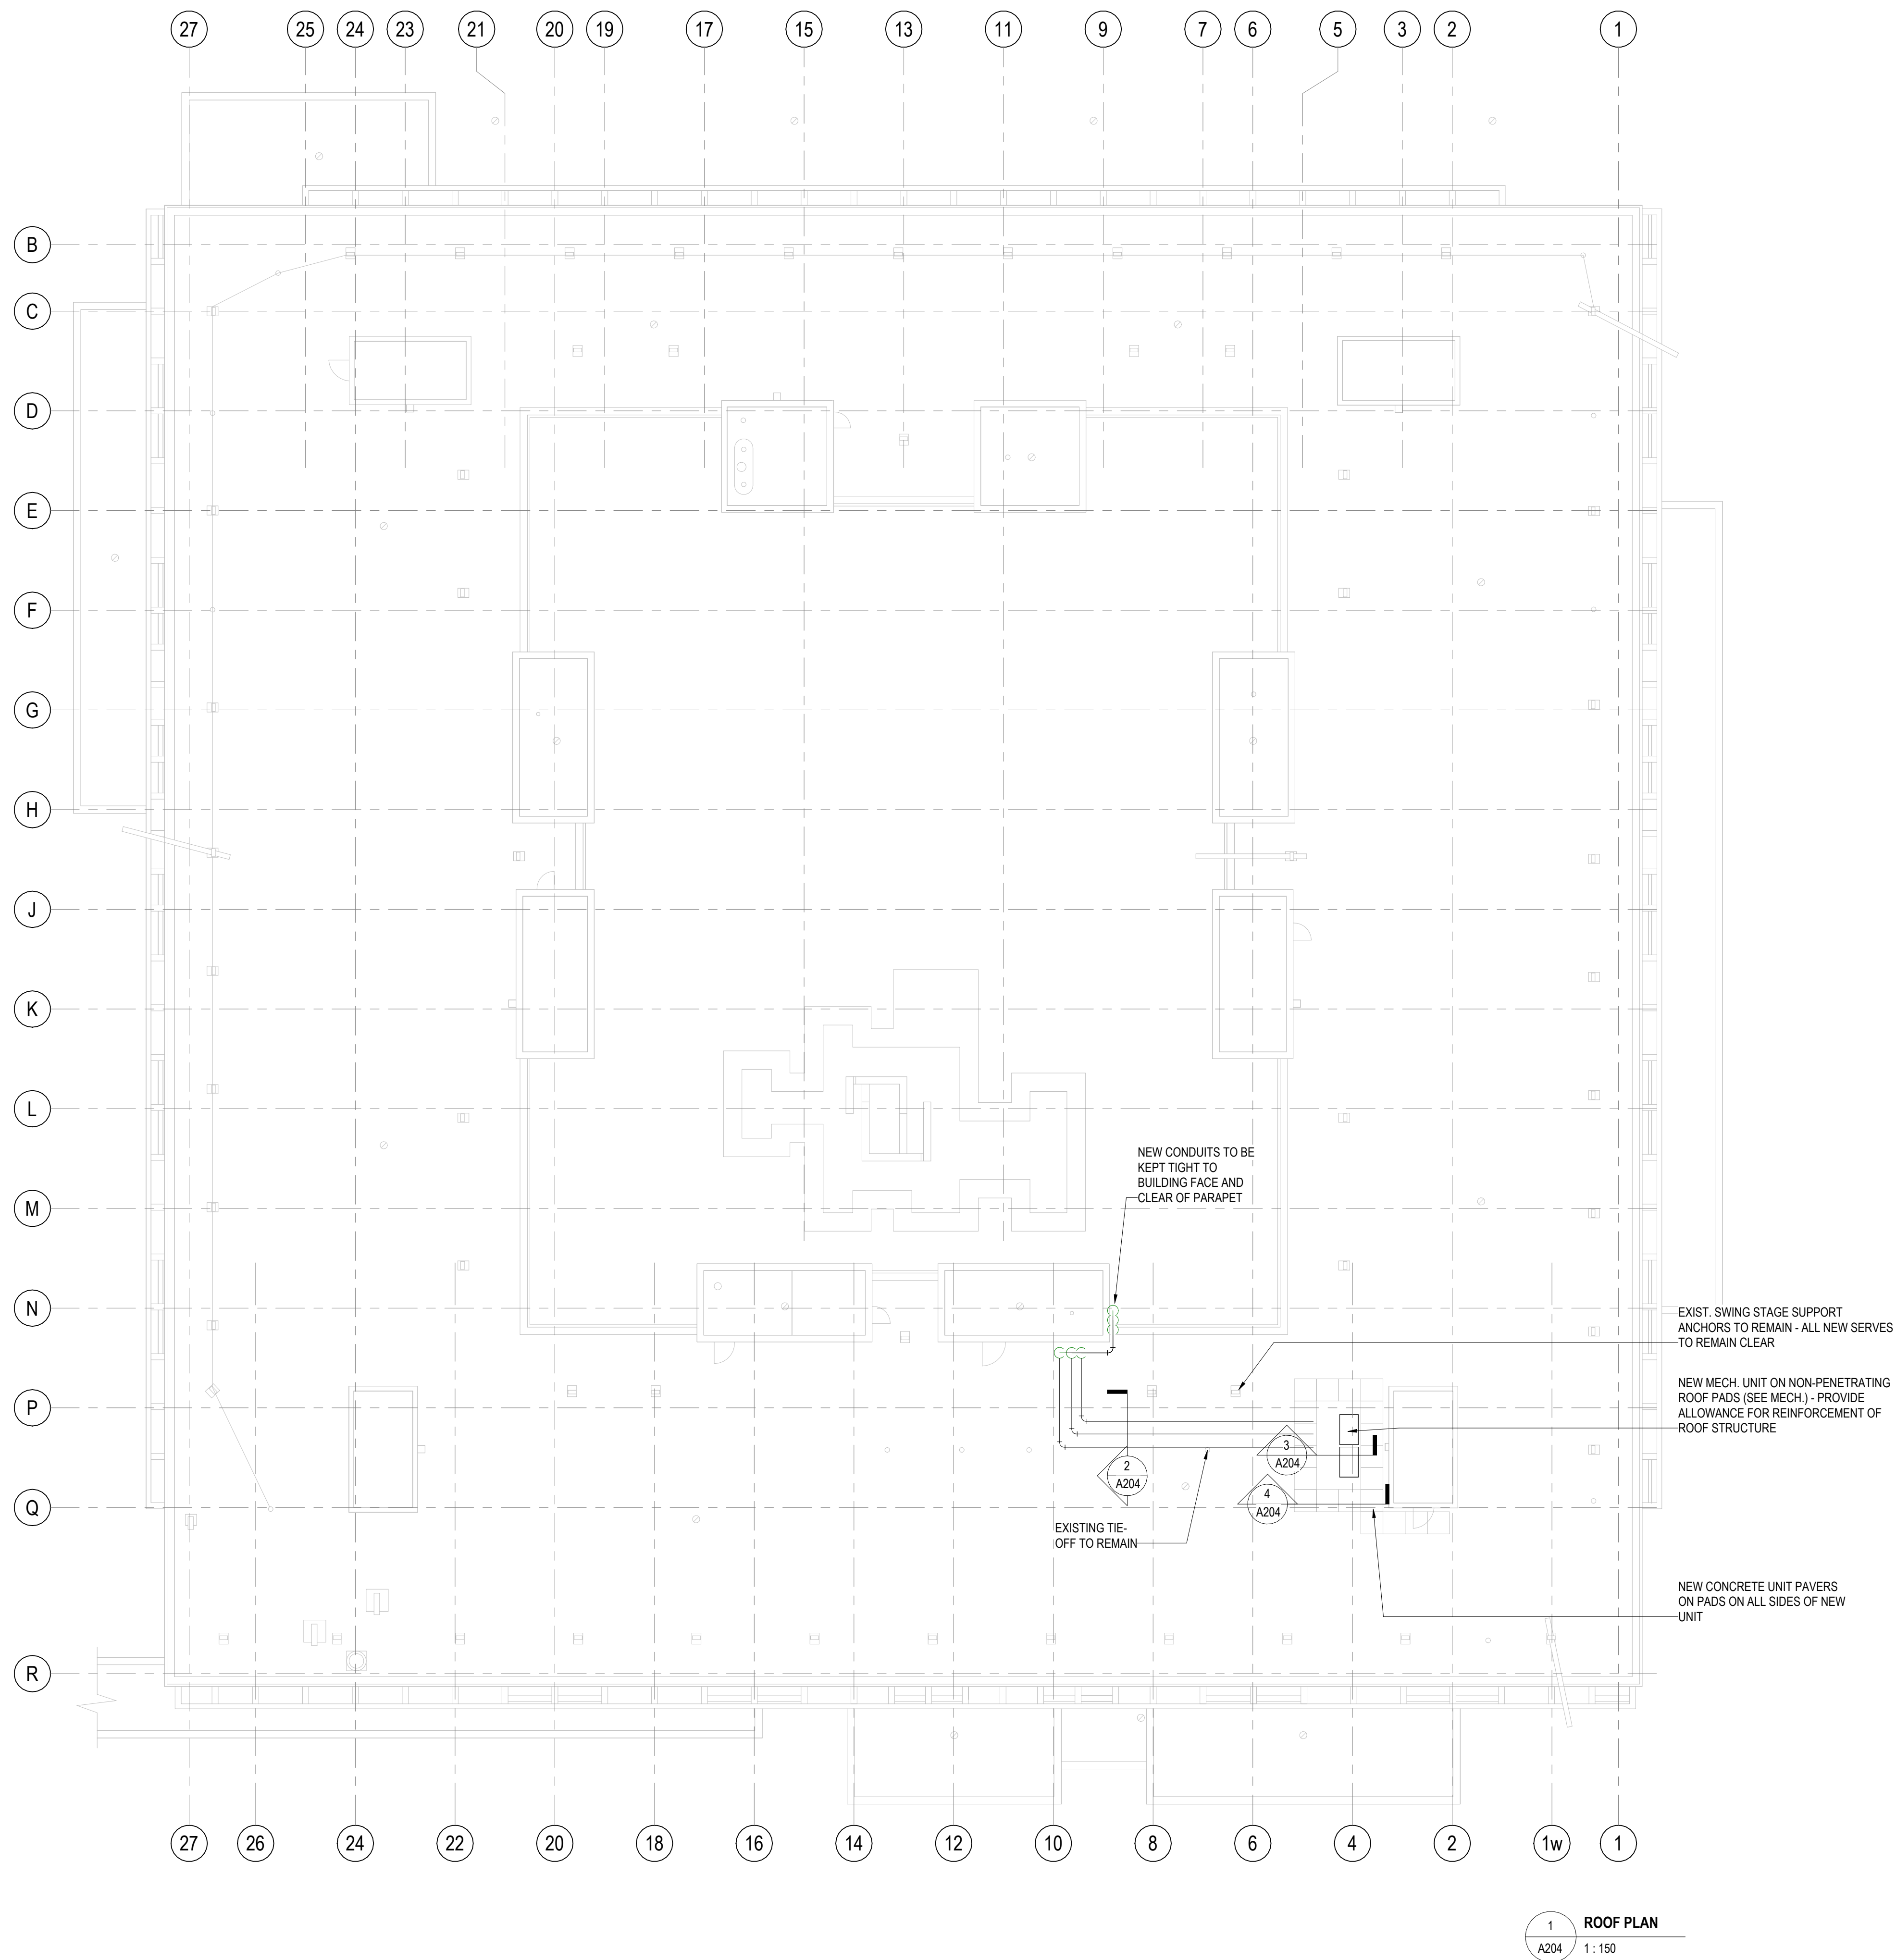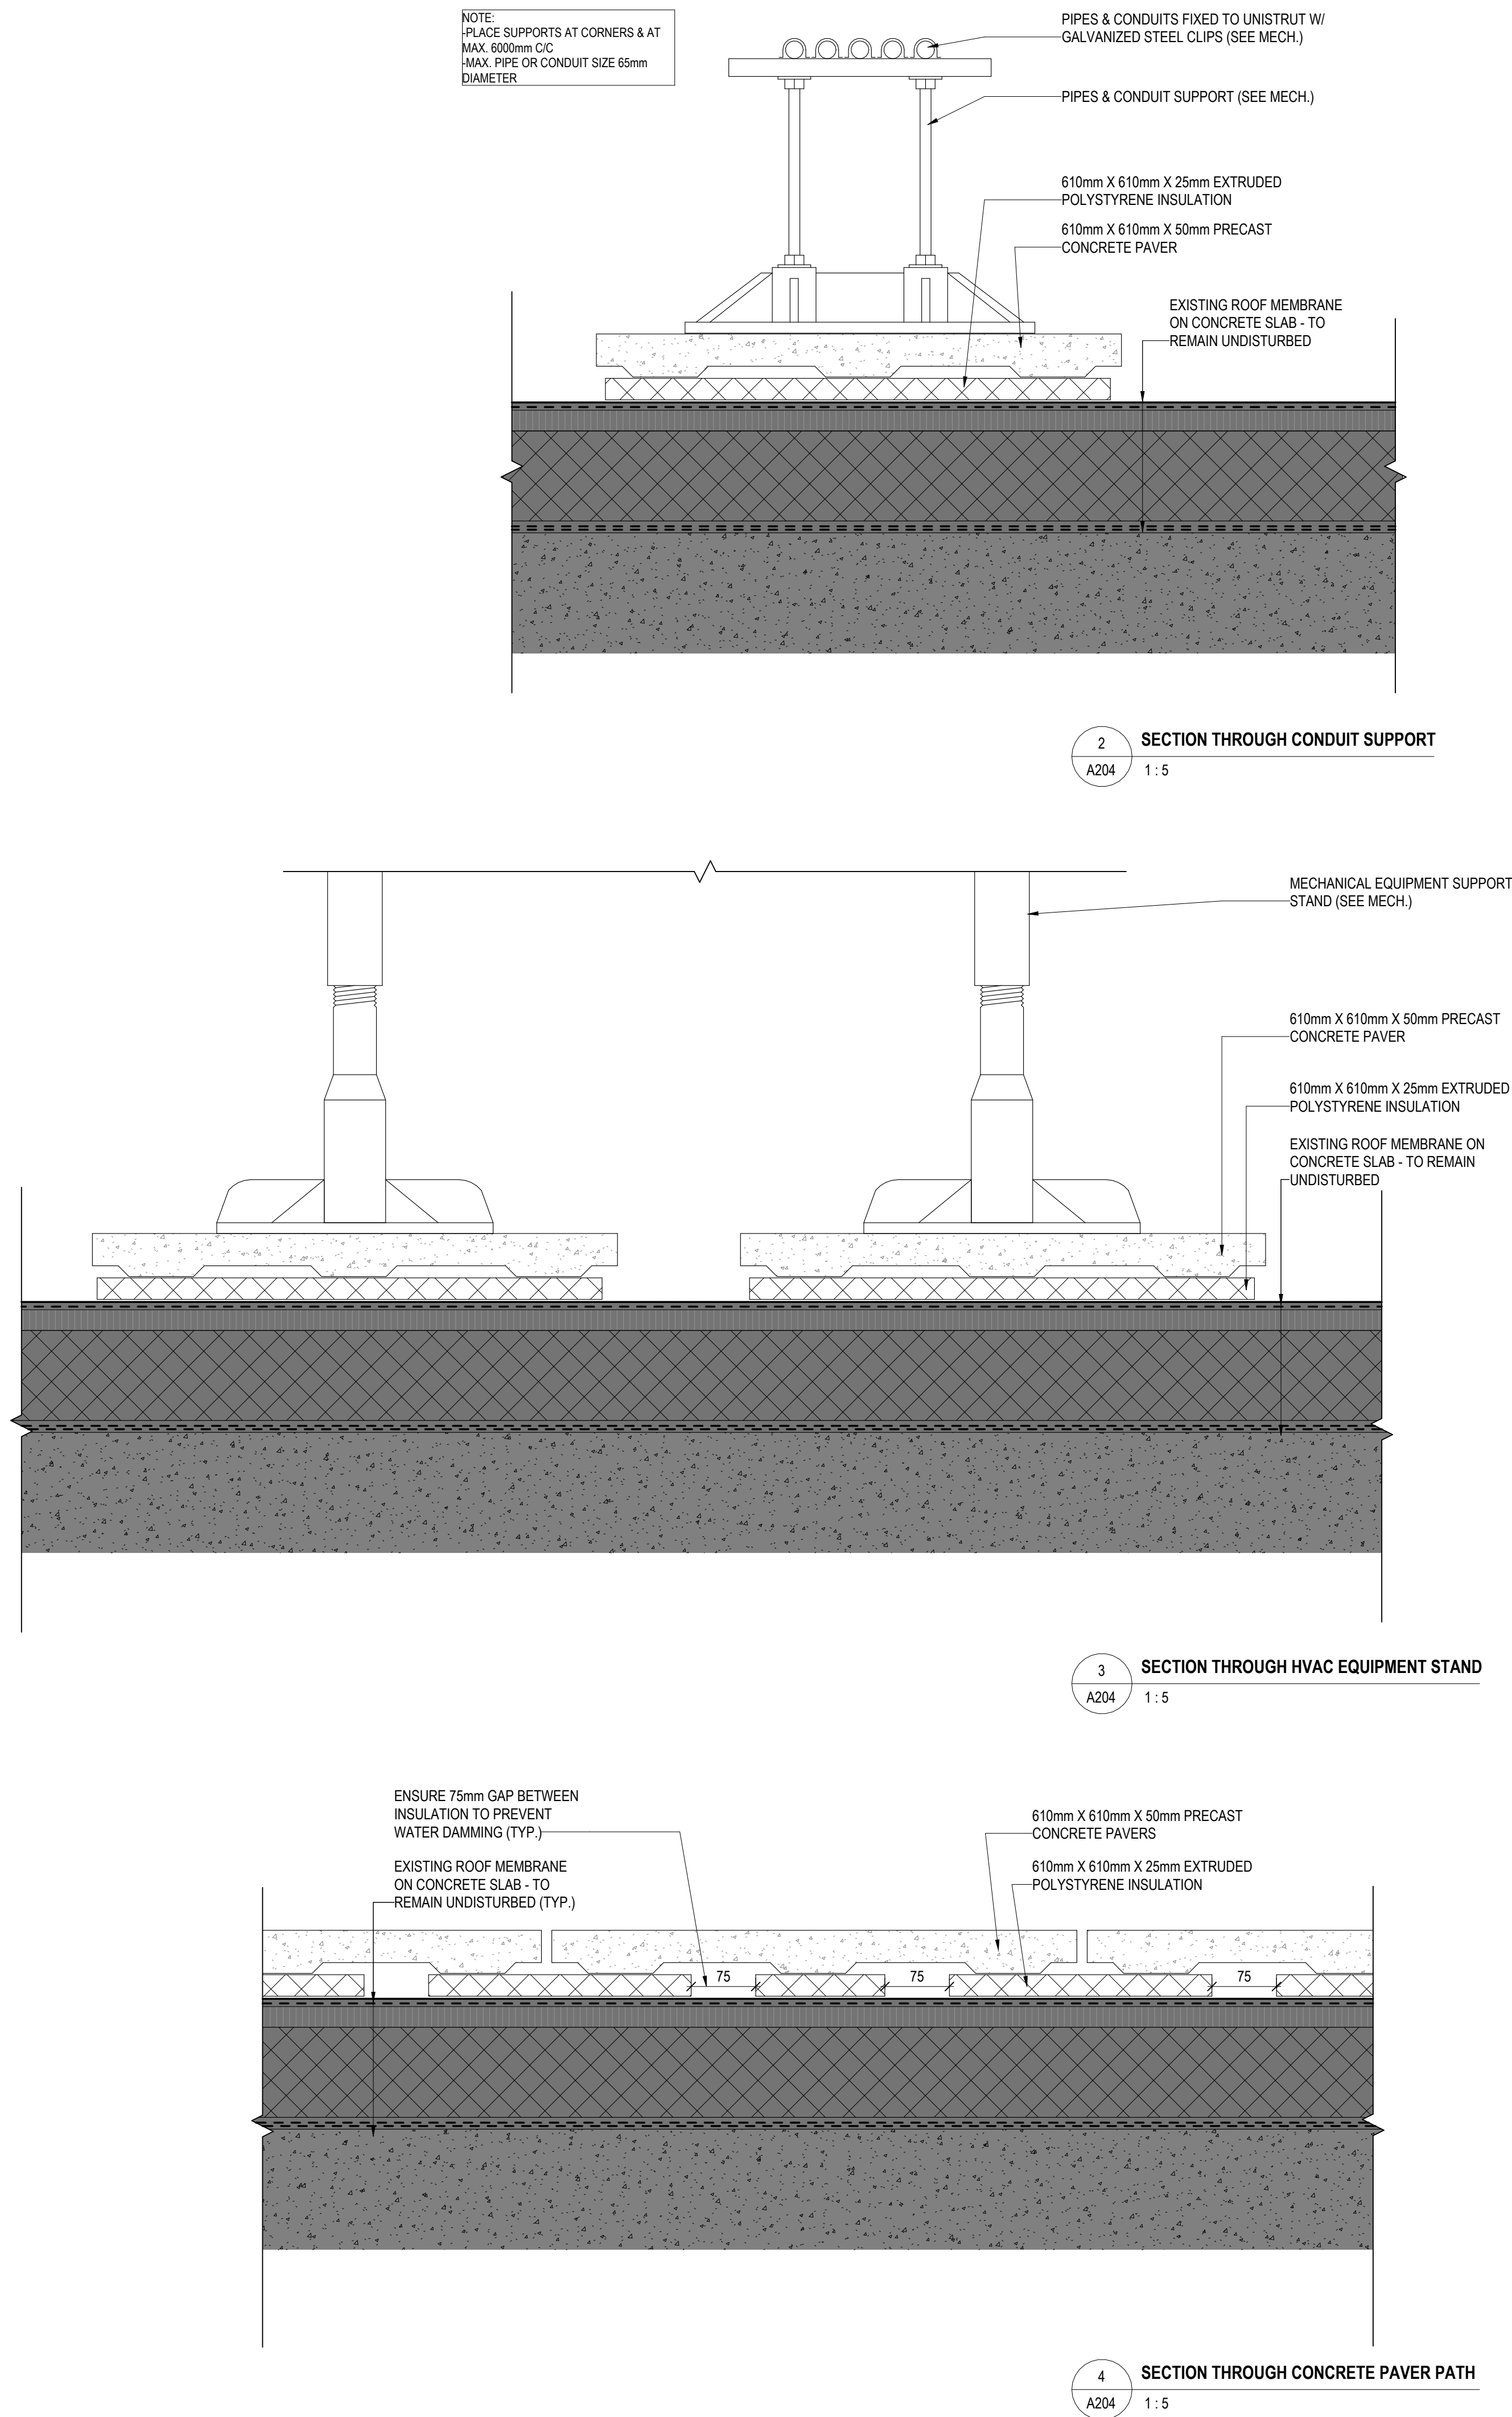

6	ISSUED FOR TENDER	2026-04-22
5	ISSUED FOR 80% CD	2026-03-09
4	ISSUED FOR PERMIT	2026-03-04
3	ISSUED FOR CLASS A COSTING	2026-02-18
2	ISSUED FOR 100% DC	2026-01-23
1	ISSUED FOR CLASS B COSTING	2026-01-16
REV.	DESCRIPTION	DATE

KEY PLAN (NTS)	SEAL


PROJECT TITLE  
UNIVERSITY OF TORONTO  
**33 URSULA FRANKLIN  
MATH OFFICE  
RENOVATION**

33 URSULA FRANKLIN ST.  
DRAWING SHEET TITLE  
**ROOF PLANS**

DRAWN BY: JR	SCALE: As indicated
REVIEWED BY: SC	DATE CREATED: 2026/02/11
UNIVERSITY PROJECT NUMBER NORTH POINT	
P164-24-165	
DRAWING NUMBER <b>A204</b>	REV. NUMBER <b>6</b>



C:\Users\songanit\Documents\164-25-165\_A\_26\_anita\_song.rvt 2026-04-22 11:51:41 AM

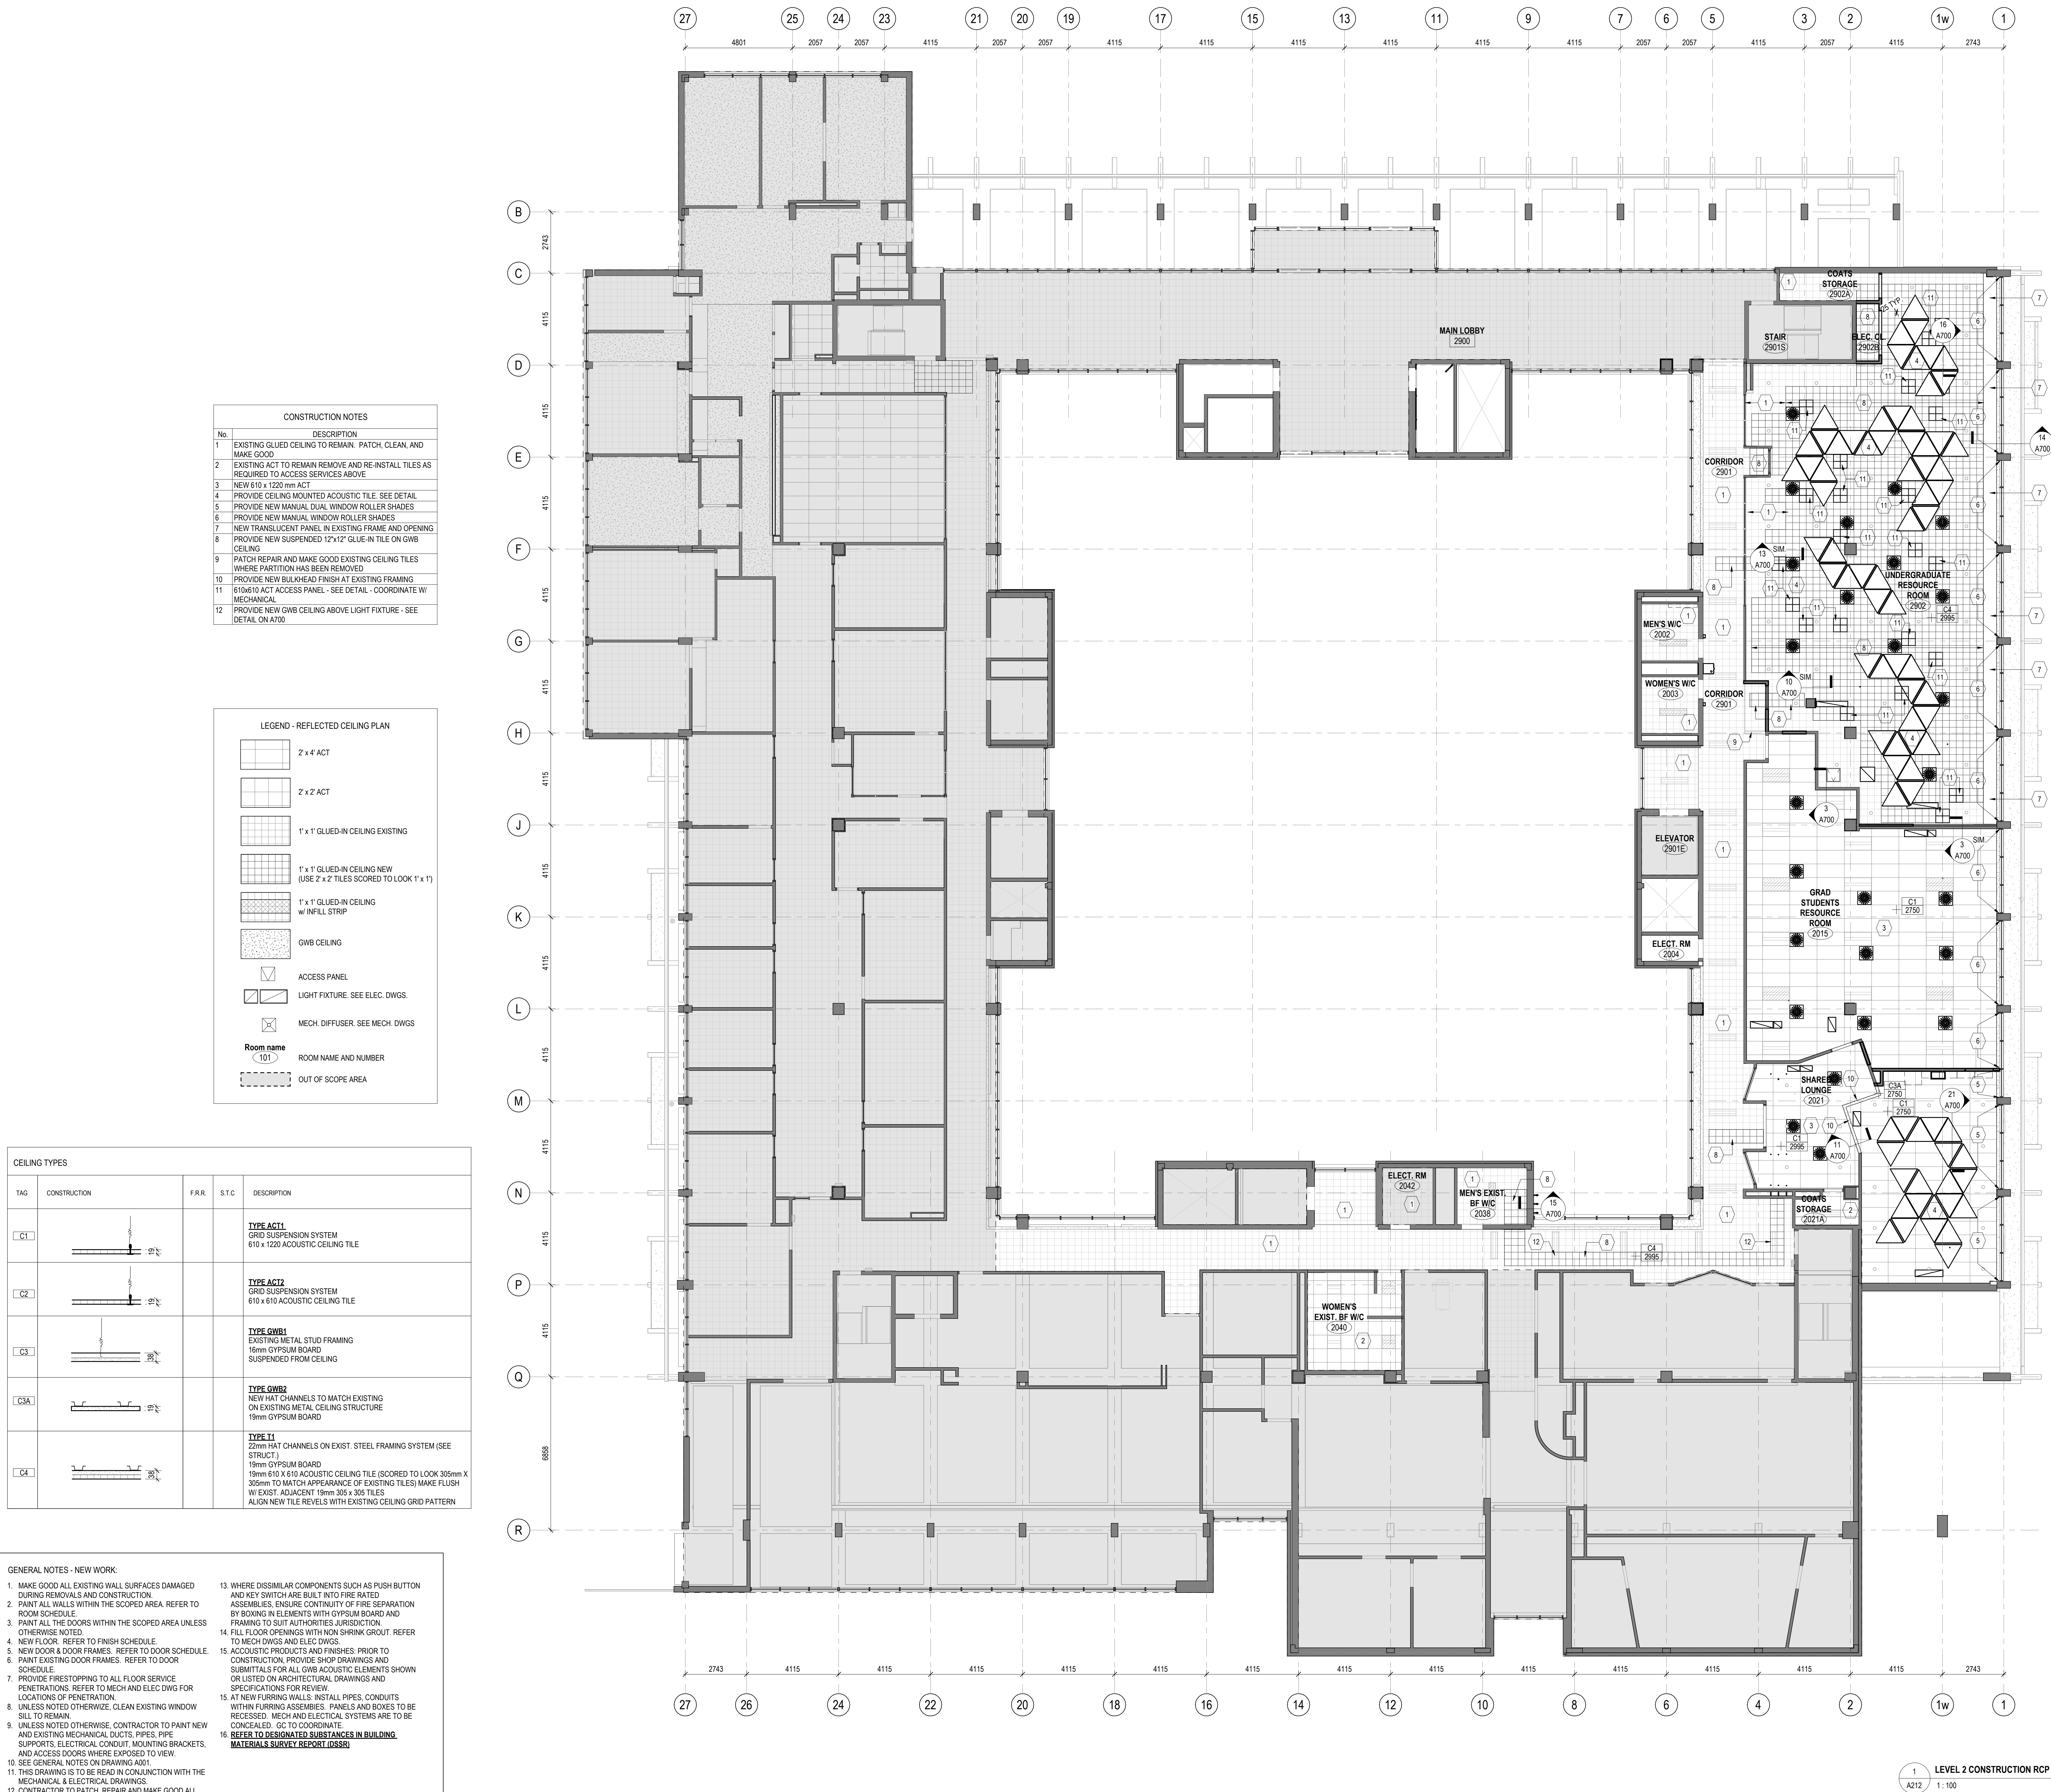

1

LEVEL 2 CONSTRUCTION RCP

A212 1:100



C:\Users\songant\Documents\IP164-25-165\_A\_26\_anita\_song.rvt 2026-04-22 11:51:51 AM




This drawing is the property of the University of Toronto, and must be returned upon completion of the work. All information shown on this drawing is for use on the specific project. Contractor must verify all dimensions on the job and report any discrepancies to the Architect before proceeding with the work.

CONSTRUCTION NOTES	
No.	DESCRIPTION
1	EXISTING GULFED CEILING TO REMAIN. PATCH, CLEAN, AND MAKE GOOD.
2	EXISTING ACT TO REMAIN REMOVE AND RE-INSTALL TILES AS REQUIRED TO ACCESS SERVICES ABOVE
3	EXISTING GULFED CEILING TO REMAIN
2A	EXISTING GULFED CEILING TO REMAIN
3	PATCH EXISTING BULKHEAD. PATCH, REPAIR, AND MAKE GOOD
4	PROVIDE NEW GWB BELONG ABOVE LIGHT FIXTURE - SEE DETAIL ON A700
5	NEW 610 x 610 mm ACT
6	600mm WIDE STRIP OF EXISTING OPEN CEILING TO BE INFILLED W/ NEW SUSPENDED 12"x12" GLUE-IN TILE ON GWB. EXACT POSITION OF STRIP TO BE CONFIRMED ON SITE. PROVIDE 24"x24" ACCESS HATCH EVERY 3600mm
7	PROVIDE CEILING MOUNTED ACOUSTIC TILE. SEE DETAIL ON A700
8	EXPOSED CEILING
9	PROVIDE NEW MANUAL WINDOW ROLLER SHADES
10	EXISTING WINDOW SHADE TO REMAIN
11	PROVIDE NEW GLAZING IN HM FRAME (SEE SPECIFICATIONS) - SEE DETAIL ON A801
12	PROVIDE NEW MANUAL DUAL WINDOW ROLLER SHADES
13	PROVIDE NEW SUSPENDED 12"x12" GLUE-IN TILE ON GWB CEILING
14	INFILL OPENING IN CEILING WHERE RECESSED LIGHT FIXTURE IS REMOVED AND NOT REPLACED - TYP. - SEE DETAIL
15	REMOVE ACT ACCESS PANEL - SEE DETAIL - COORDINATE W/ MECHANICAL
16	NEW SUSPENDED GWB CEILING
17	EXISTING GWB BULKHEAD TO REMAIN

LEGEND - REFLECTED CEILING PLAN	
	2' x 4' ACT
	2' x 2' ACT
	1' x 1' GLUED-IN CEILING EXISTING
	1' x 1' GLUED-IN CEILING NEW (USE 2' x 2' TILES SCORED TO LOOK 1' x 1')
	1' x 1' GLUED-IN CEILING W/ INFILL STRIP
	GWB CEILING
	ACCESS PANEL
	LIGHT FIXTURE. SEE ELEC DWGS.
	MECH. DIFFUSER. SEE MECH DWGS
	Room name 101
	ROOM NAME AND NUMBER
	OUT OF SCOPE AREA

CEILING TYPES				
TAG	CONSTRUCTION	F.R.	S.T.C.	DESCRIPTION
C1				<b>TYPE ACT1</b> GRID SUSPENSION SYSTEM 610 x 1220 ACOUSTIC CEILING TILE
C2				<b>TYPE ACT2</b> GRID SUSPENSION SYSTEM 610 x 610 ACOUSTIC CEILING TILE
C3				<b>TYPE GWB1</b> EXISTING METAL STUD FRAMING 16mm GYPSUM BOARD SUSPENDED FROM CEILING
C3A				<b>TYPE GWB2</b> NEW HAT CHANNELS TO MATCH EXISTING ON EXISTING METAL CEILING STRUCTURE 19mm GYPSUM BOARD
C4				<b>TYPE T1</b> 25mm HAT CHANNELS ON EXIST. STEEL FRAMING SYSTEM (SEE STRUCT) 19mm GYPSUM BOARD 19mm 610 x 610 ACOUSTIC CEILING TILE (SCORED TO LOOK 305mm X 305mm) TO MATCH APPEARANCE OF EXISTING TILES) MAKE FLUSH W/ EXIST. ADJACENT 19mm 305 x 305 TILES ALIGN NEW TILE REVELS WITH EXISTING CEILING GRID PATTERN

GENERAL NOTES - NEW WORK:	
1. MAKE GOOD ALL EXISTING WALL SURFACES DAMAGED DURING REMOVALS AND CONSTRUCTION.	13. WHERE DISSIMILAR COMPONENTS SUCH AS PUSH BUTTON AND KEY SWITCH ARE BUILT INTO FIRE RATED ASSEMBLIES, ENSURE CONTINUITY OF FIRE SEPARATION BY BOWING IN ELEMENTS WITH GYPSUM BOARD AND FRAMING TO SUIT AUTHORITIES JURISDICTION.
2. PAINT ALL WALLS WITHIN THE SCOPED AREA. REFER TO ROOM SCHEDULE.	14. FILL FLOOR OPENINGS WITH NON SHRINK GROUT. REFER TO MECH DWGS AND ELEC DWGS.
3. PAINT ALL THE DOORS WITHIN THE SCOPED AREA UNLESS OTHERWISE NOTED.	15. ACOUSTIC PRODUCTS AND FINISHES, PRIOR TO CONSTRUCTION, PROVIDE SHOP DRAWINGS AND SUBMITTALS FOR ALL GWB ACOUSTIC ELEMENTS SHOWN OR LISTED ON ARCHITECTURAL DRAWINGS AND SPECIFICATIONS FOR REVIEW.
4. NEW FLOOR, REFER TO FINISH SCHEDULE.	16. AT NEW FLOORING WALLS, INSTALL PIPES, CONDUITS WITHIN FLOORING ASSEMBLIES. PANELS AND BOXES TO BE RECESSED. MECH AND ELECTRICAL SYSTEMS ARE TO BE CONCEALED. GC TO COORDINATE.
5. NEW DOOR & DOOR FRAMES. REFER TO DOOR SCHEDULE.	17. REFER TO DESIGNATED SUBSTANCES IN BUILDING MATERIALS SURVEY REPORT (DSR).
6. PAINT EXISTING DOOR FRAMES. REFER TO DOOR SCHEDULE.	
7. PROVIDE FIRESTOPPING TO ALL FLOOR SERVICE PENETRATIONS. REFER TO MECH AND ELEC DWG FOR LOCATIONS OF PENETRATION.	
8. UNLESS NOTED OTHERWISE, CLEAN EXISTING WINDOW SILL TO REMAIN.	
9. UNLESS NOTED OTHERWISE, CONTRACTOR TO PAINT NEW AND EXISTING MECHANICAL DUCTS, PIPES, PIPE SUPPORTS, ELECTRICAL CONDUIT, MOUNTING BRACKETS, AND ACCESS DOORS WHERE EXPOSED TO VIEW.	
10. SEE GENERAL NOTES ON DRAWING A001.	
11. THIS DRAWING IS TO BE READ IN CONJUNCTION WITH THE MECHANICAL & ELECTRICAL DRAWINGS.	
12. CONTRACTOR TO PATCH, REPAIR AND MAKE GOOD ALL AREAS DISTURBED BY THE OPERATION OF THE WORK AND DISTURBED BY THE WORK OF OTHER TRADES (MECH, ELEC & AV, ETC.). MATERIALS AND FINISHES TO MATCH EXISTING, UNLESS NOTED OTHERWISE.	

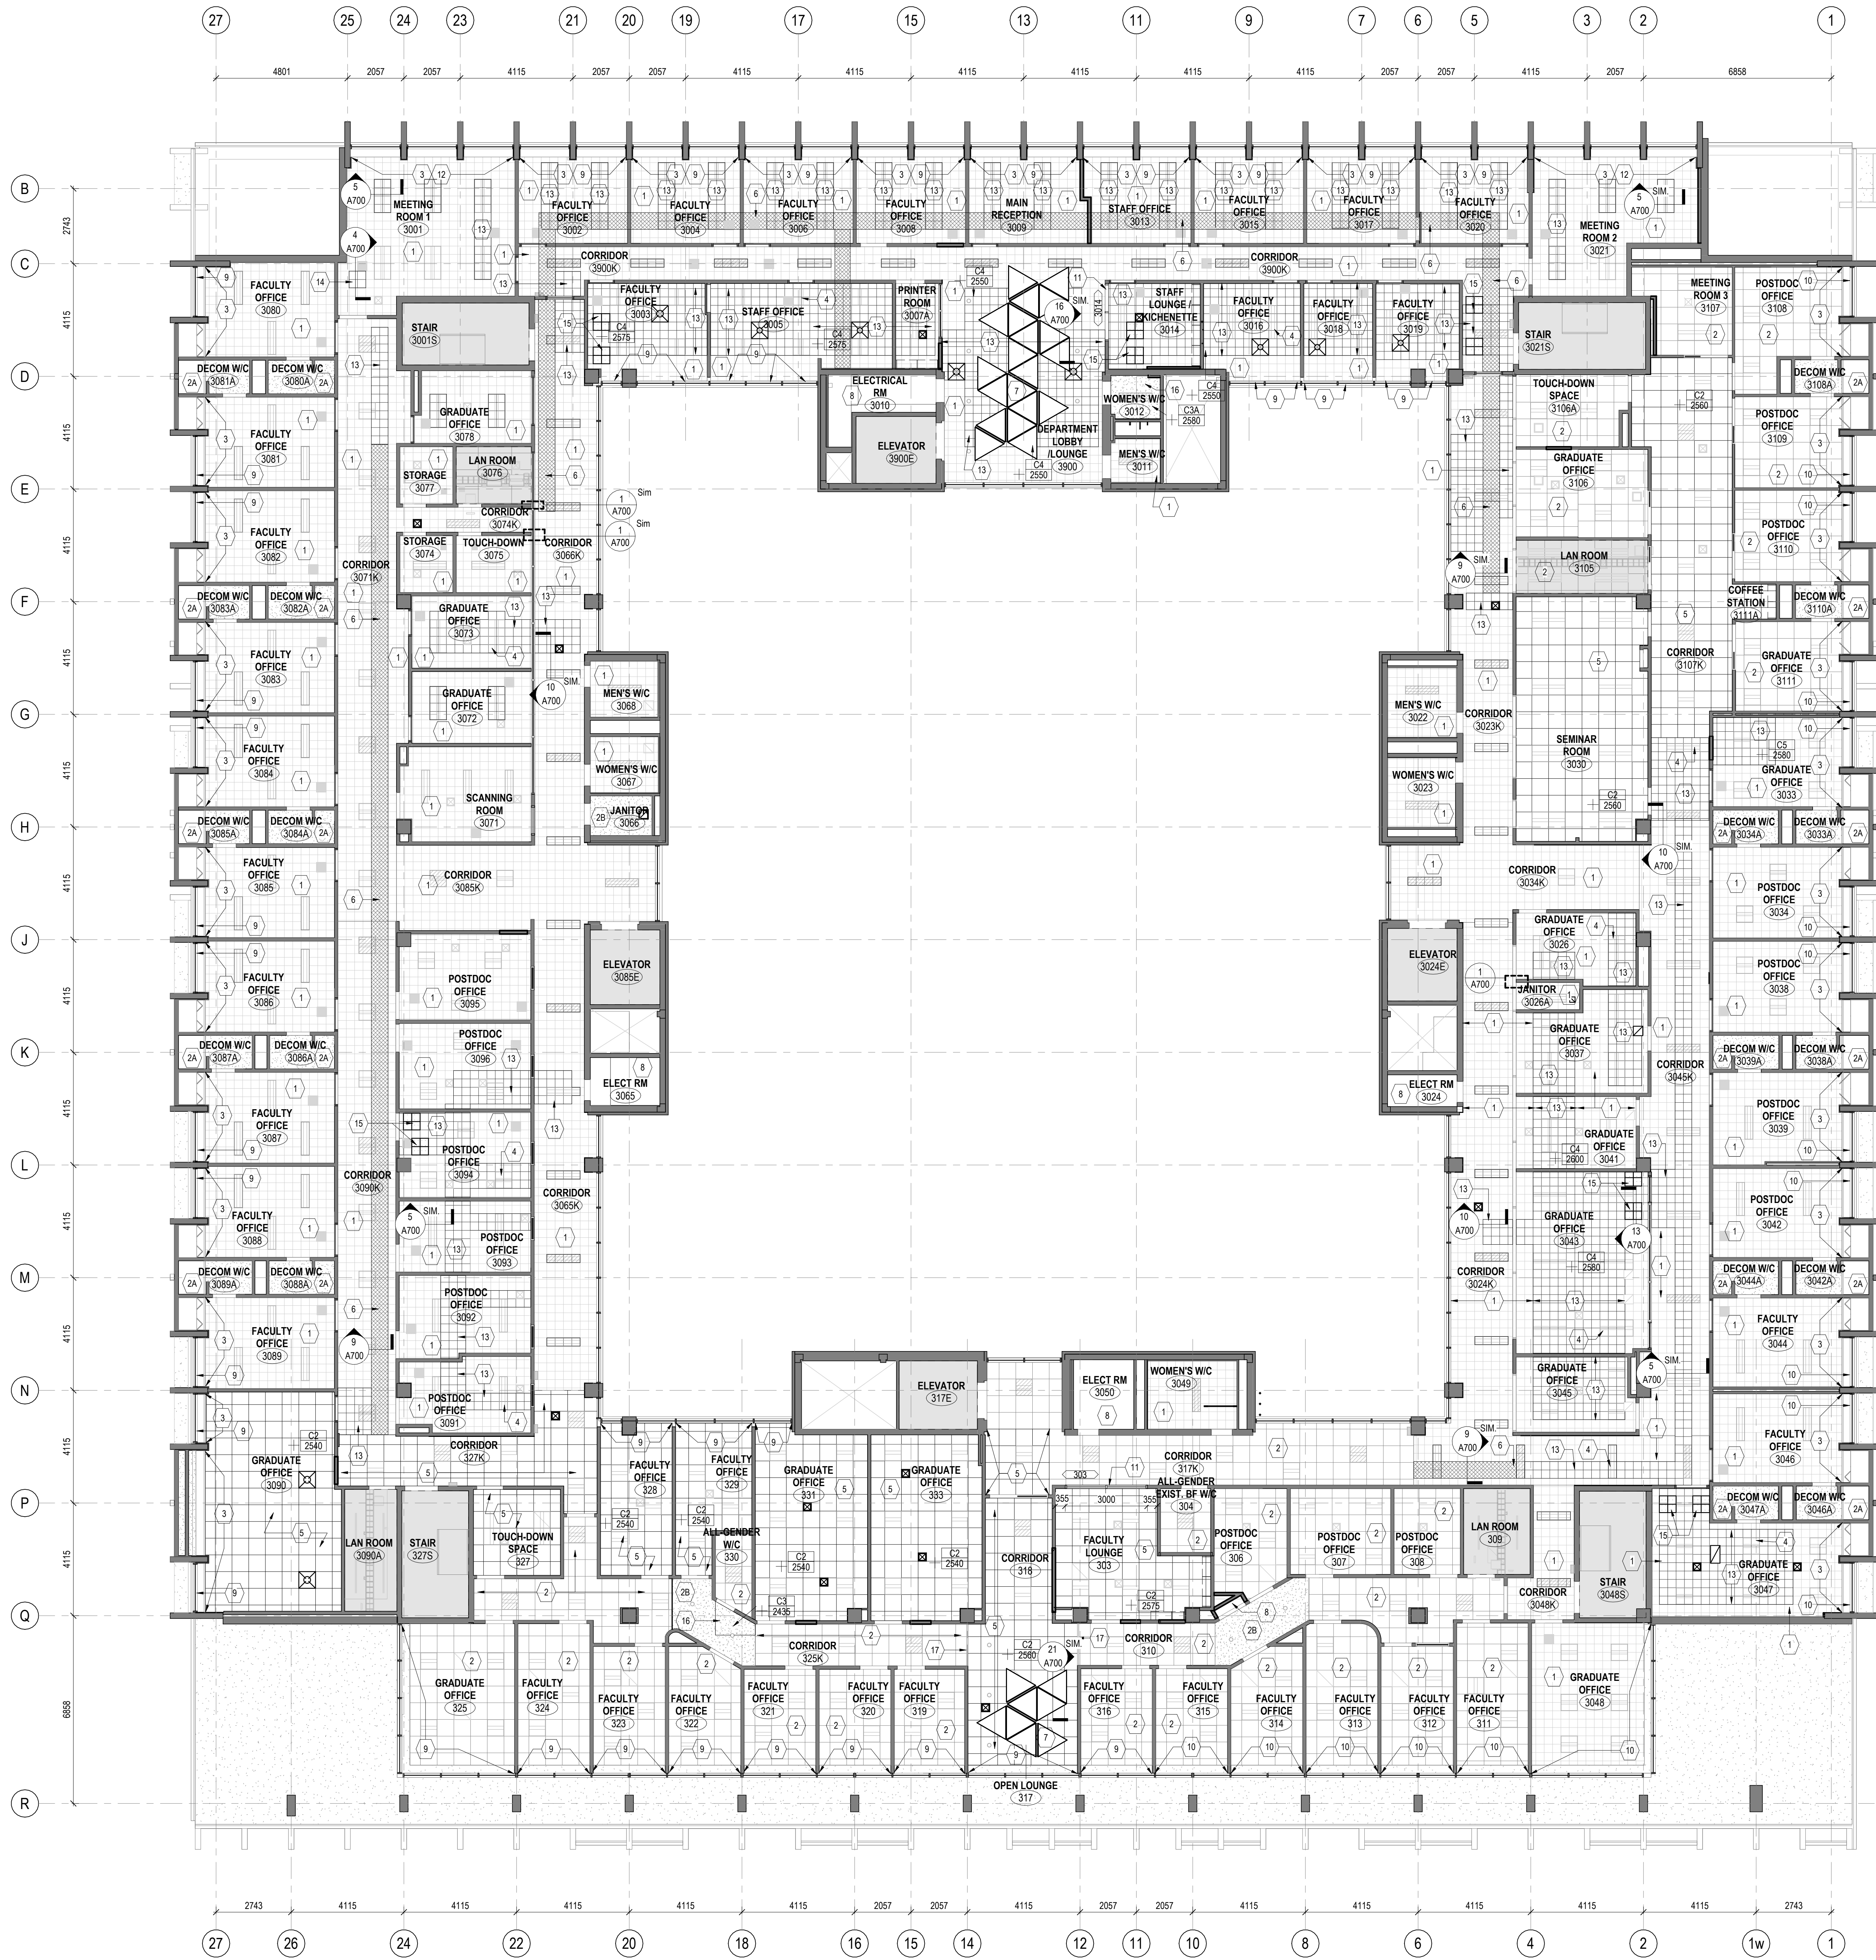

1 LEVEL 3 CONSTRUCTION RCP  
A213 1:100

9	ISSUED FOR TENDER	2026-04-22
8	ISSUED FOR RFP, CD	2026-03-09
7	ISSUED FOR PERMIT	2026-03-04
6	ISSUED FOR CLASS A COSTING	2026-02-18
5	ISSUED FOR 100% DD	2026-01-23
4	ISSUED FOR CLASS B COSTING	2026-01-16
3	ISSUED FOR 50% DD	2025-11-28
2	ISSUED FOR 100% SD	2025-09-16
1	ISSUED FOR CLASS C COSTING	2025-08-02
REV.	DESCRIPTION	DATE

KEY PLAN (NTS) SEAL

PROJECT TITLE  
UNIVERSITY OF TORONTO  
**33 URSULA FRANKLIN  
MATH OFFICE  
RENOVATION**

33 URSULA FRANKLIN ST.  
DRAWING SHEET TITLE  
**LEVEL 3 CONSTRUCTION  
RCP**

DRAWN BY: JRV AS  
REVIEWED BY: SC  
UNIVERSITY PROJECT NUMBER: NORTH POINT  
P164-24-165


DRAWING NUMBER  
**A213**  
REV. NUMBER  
**9**








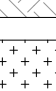

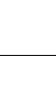
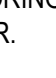

C:\Users\songanit\Documents\164-25-165\_A\_26\_anita\_song.rvt 2026-04-22 11:51:54 AM

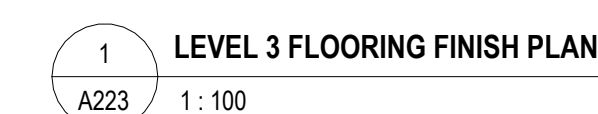





**LEGEND - FLOORING FINISH**

	<p>EXISTING VINYL TILE TO REMAIN AND BE CLEANED AND RESTORED</p> <p>INSTALL NEW BASEBOARD</p>
	<p>INSTALL NEW RESILIENT FLOORING (RF1) PROVIDE NEW BASEBOARD</p>
	<p>INSTALL NEW VINYL TILE (VC1) PROVIDE NEW BASEBOARD</p>
	<p>INSTALL NEW VINYL TILE (VC2) PROVIDE NEW BASEBOARD</p>
	<p>INSTALL NEW VINYL TILE (VC3) PROVIDE NEW BASEBOARD</p>
	<p>INSTALL NEW VINYL TILE (VC4) PROVIDE NEW BASEBOARD</p>
	<p>INSTALL NEW VINYL TILE (VC5) PROVIDE NEW BASEBOARD</p>
	<p>INSTALL NEW CARPET (CP1) PROVIDE NEW BASEBOARD</p>
	<p>PROVIDE NEW EPOXY COATING ON EXISTING FLOOR AND COVER BASE</p>
	<p>NOT IN SCOPE</p>

**FLOORING TO ALIGN FLUSH W/ FACE OF PUSH-SIDE  
DOOR.**


KEY PLAN (NTS)	SEAL
----------------	------

33 URSULA FRANKLIN ST.  
DRAWING SHEET TITLE  
**LEVEL 3 FLOORING  
FINISH PLAN**

P164-24-165	
-------------	---

DRAWING NUMBER	REV. NUMBER
<b>A223</b>	<b>7</b>



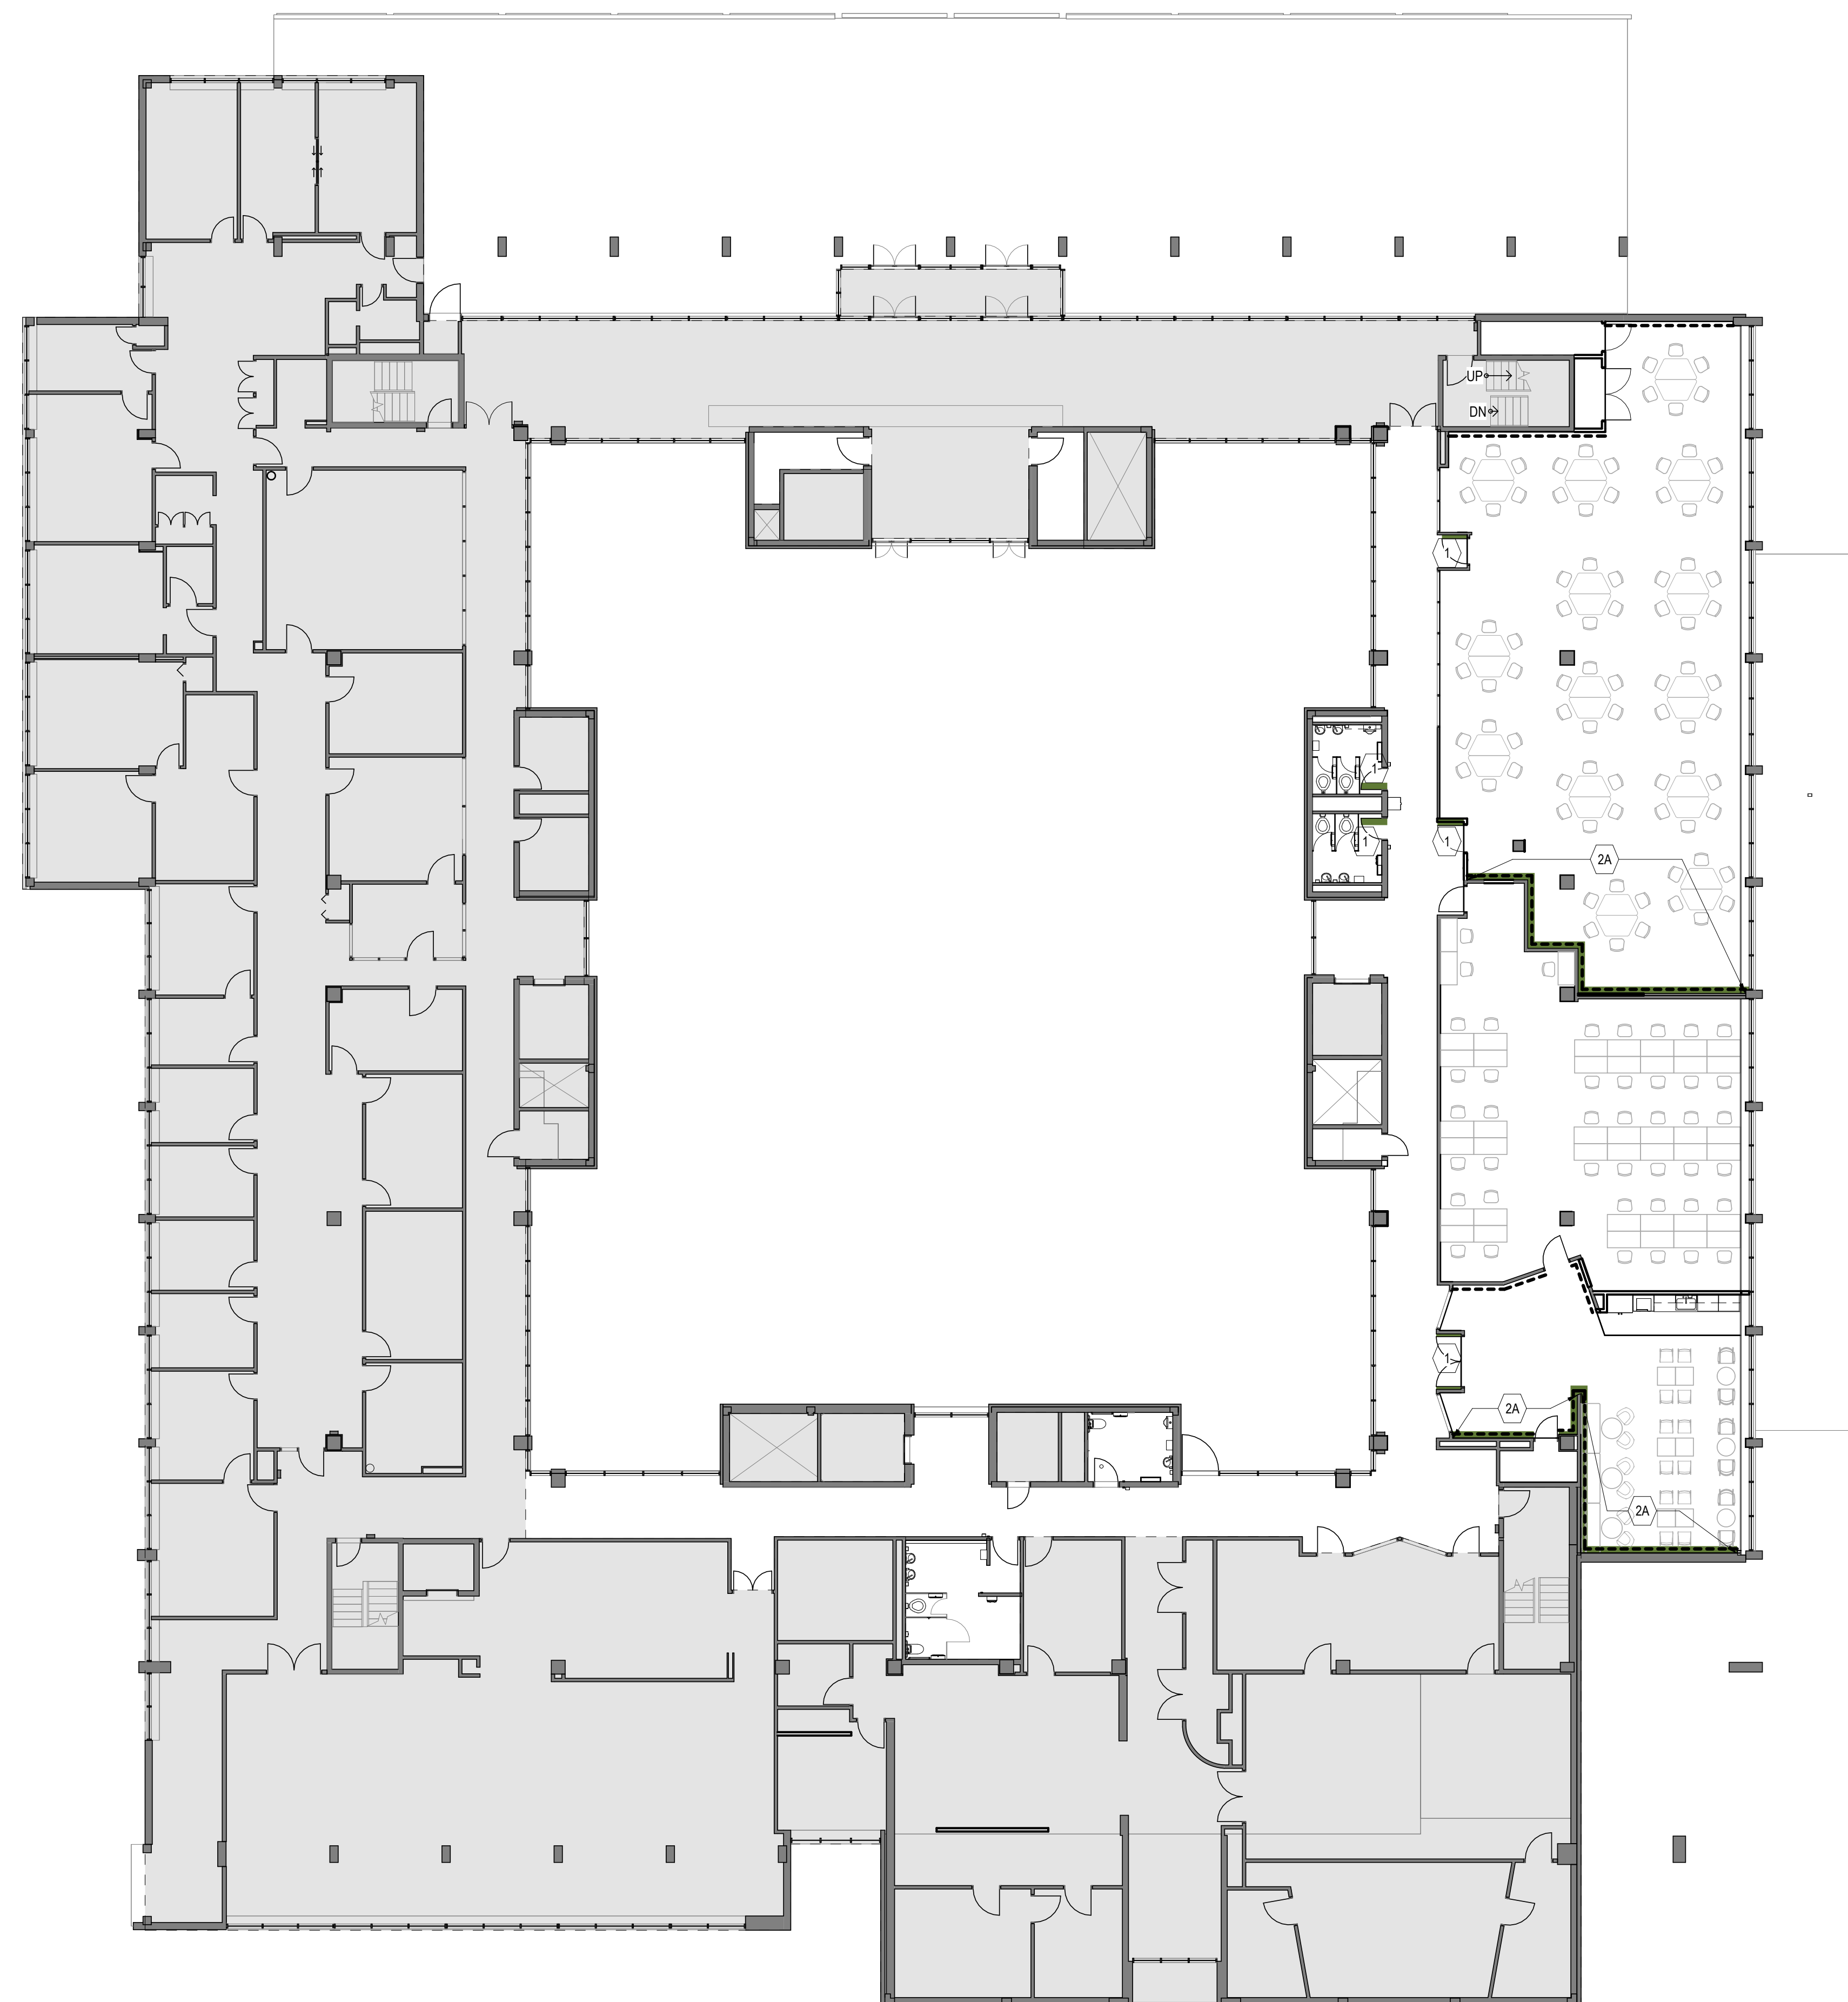









2 LEVEL 2 WALL FINISH COLOUR PLAN  
A224 1 : 150



1 LEVEL 3 WALL FINISH COLOUR PLAN  
A224 1 : 150

CONSTRUCTION NOTES	
No.	DESCRIPTION
1	PAINT DOOR AND DOOR FRAME CORRIDOR SIDE AND WALL ABOVE w/ HIGHLIGHTED COLOUR AND ROOM SIDE w/ PT6
2	PAINT WALLS w/ HIGHLIGHTED COLOUR.
2A	PAINT WALLS w/ HIGHLIGHTED COLOUR. PROVIDE WALL PANELS IN MATCHING COLOURS. SEE ELEVATIONS FOR WALL PANEL HEIGHTS.

**LEGEND - WALL FINISH**

	PT1: ALL WALLS IN SCOPE UNLESS OTHERWISE NOTED
	PT2
	PT3
	PT4
	PT5
	PT6: ALL DOORS, DOOR FRAMES, SCREEN FRAMES, FHC, AND DISPLAY CABINETS, UNLESS OTHERWISE NOTED
	OUT OF SCOPE
	WALL PANELS: PROVIDE IN WHITE UNLESS OTHERWISE NOTED

1	ISSUED FOR TENDER	2026-04-22
REV.	DESCRIPTION	DATE


KEY PLAN (NTS)	SEAL
----------------	------

PROJECT TITLE:  
UNIVERSITY OF TORONTO  
**33 URSULA FRANKLIN  
MATH OFFICE  
RENOVATION**

33 URSULA FRANKLIN ST.  
DRAWING SHEET TITLE  
**LEVEL 2 & 3 WALL FINISH  
PLANS**


DRAWN BY: AS	SCALE: As indicated
--------------	---------------------

UNIVERSITY PROJECT NUMBER	NORTH POINT
---------------------------	-------------

P164-24-165	
-------------	---

DRAWING NUMBER	REV. NUMBER
<b>A224</b>	<b>1</b>



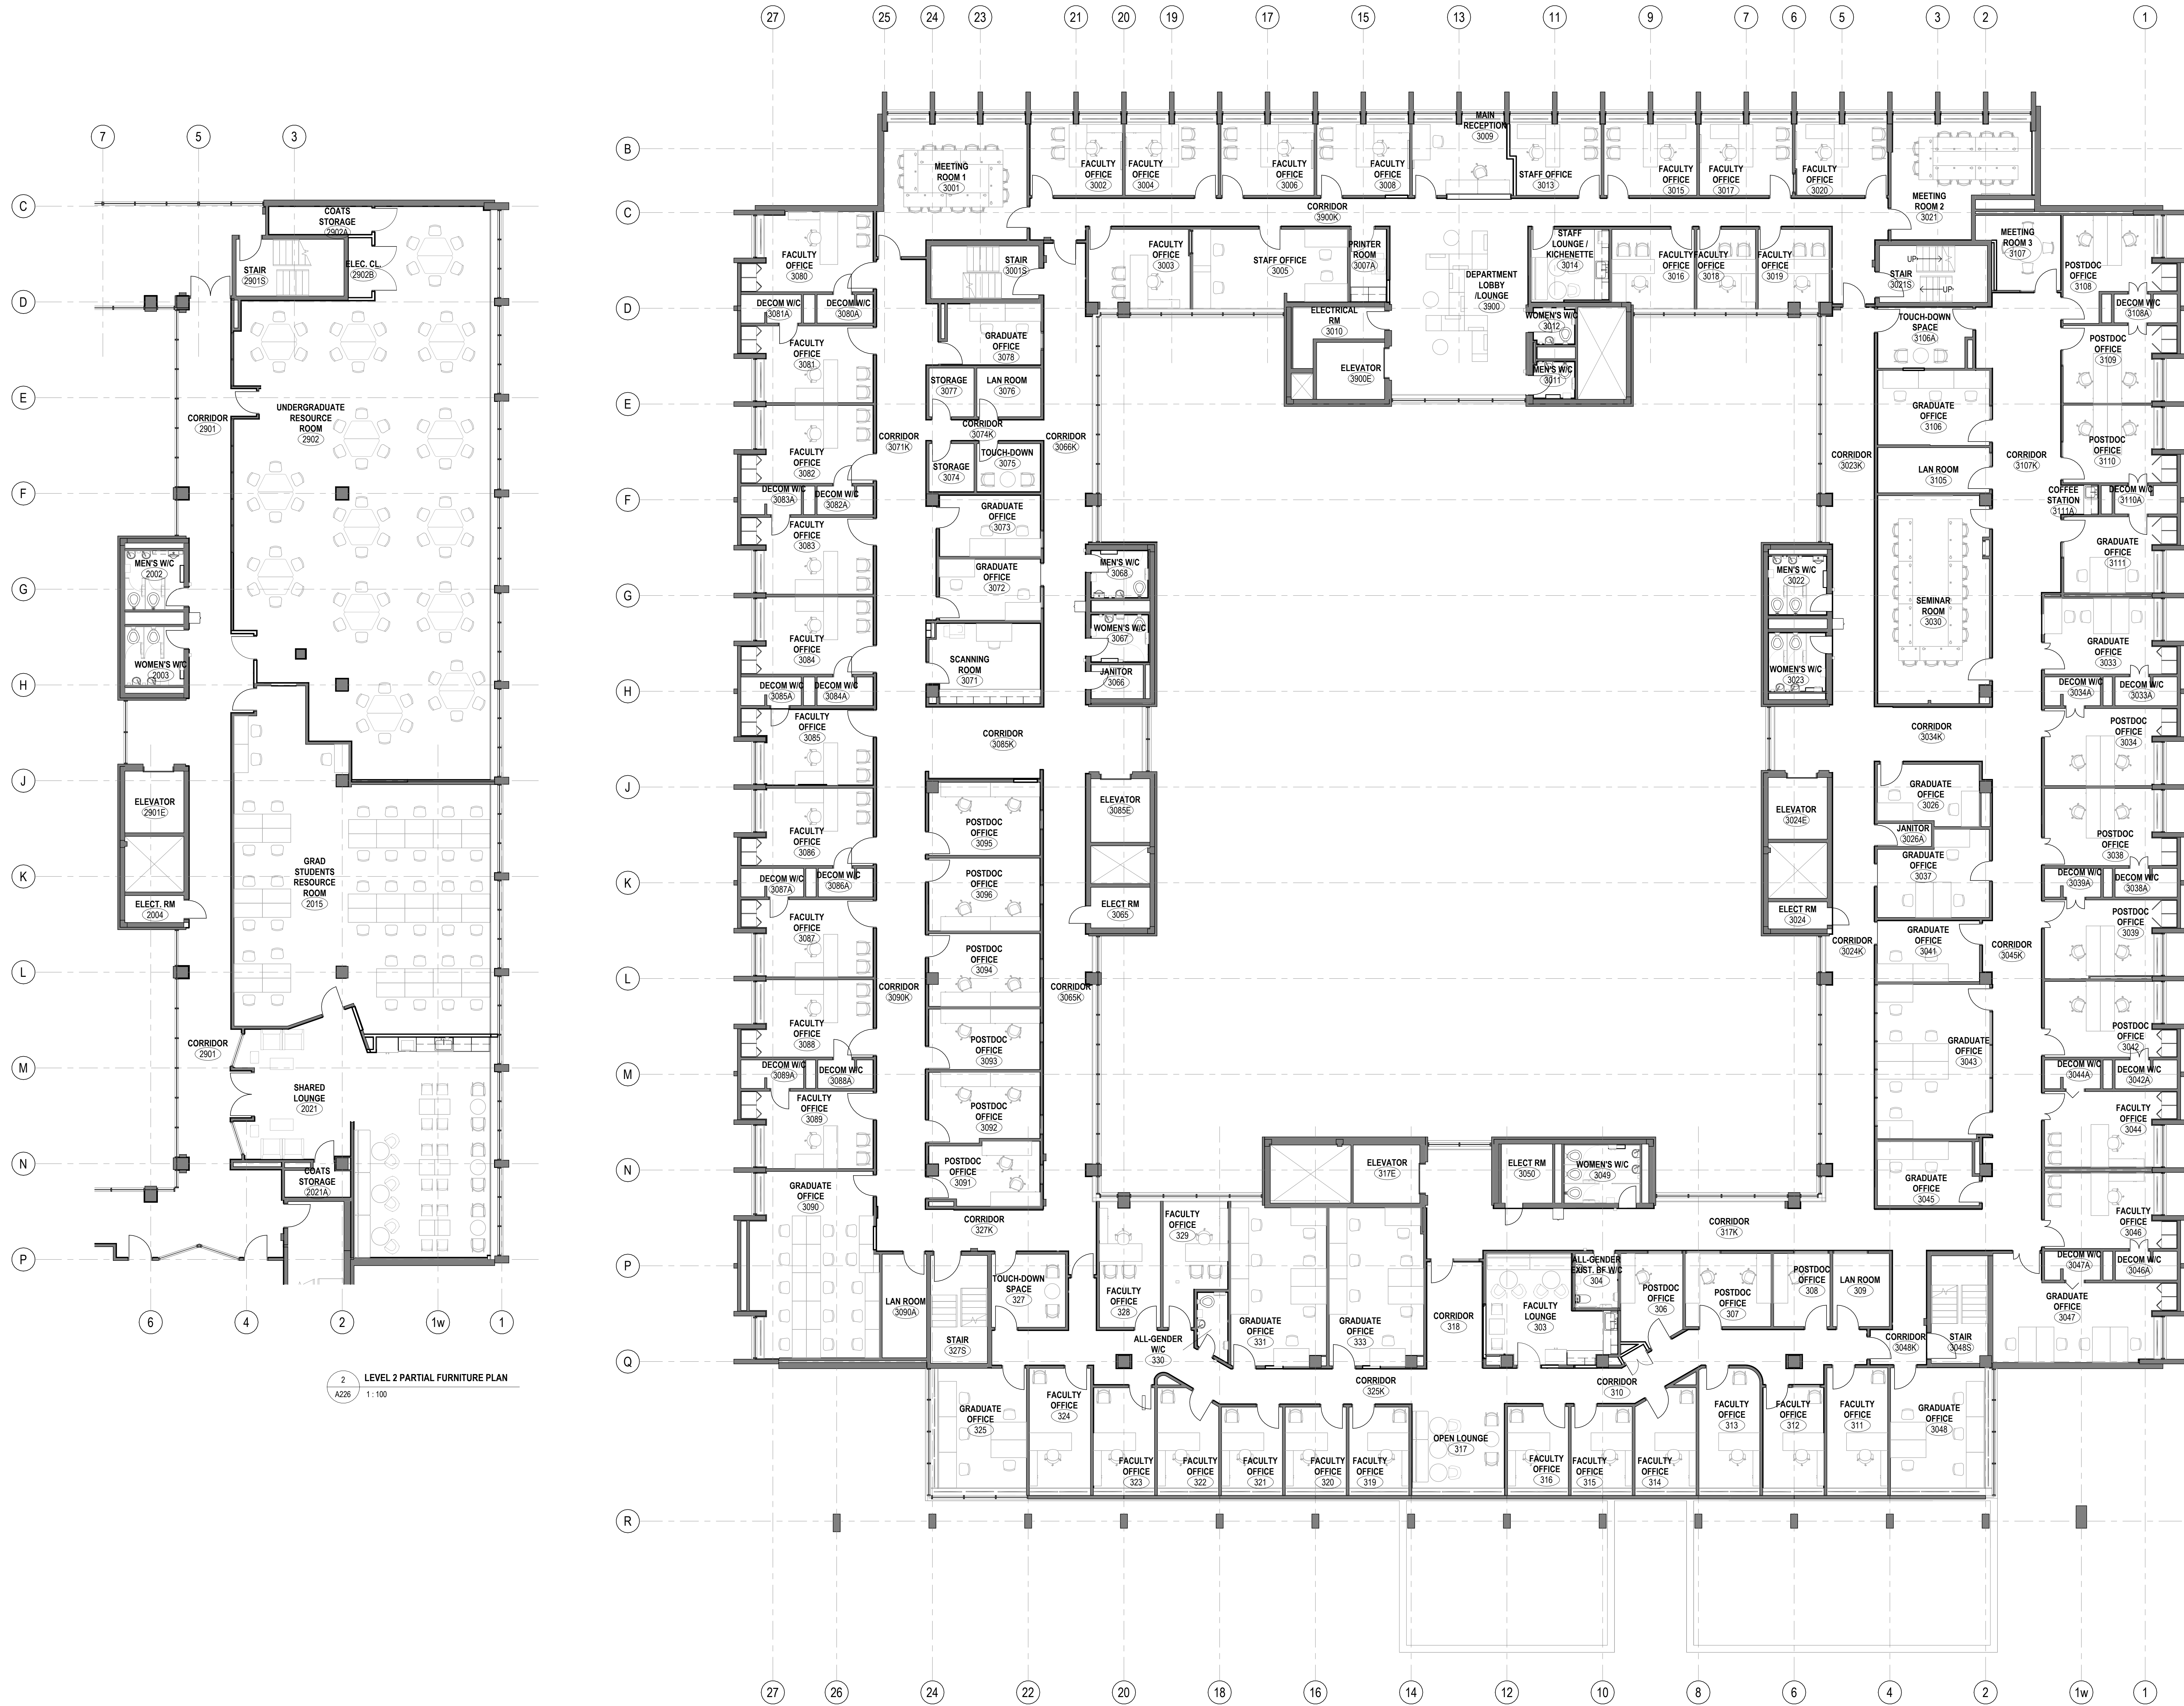

6	ISSUED FOR TENDER	2026-04-22
5	ISSUED FOR RFP, C3	2026-03-09
4	ISSUED FOR CLASS A COSTING	2026-02-18
3	ISSUED FOR 100% DD	2026-01-23
2	ISSUED FOR CLASS B COSTING	2026-01-16
1	ISSUED FOR RFP, D3	2025-11-08
REV.	DESCRIPTION	DATE

KEY PLAN (NTS) SEAL

PROJECT TITLE  
UNIVERSITY OF TORONTO  
**33 URSULA FRANKLIN  
MATH OFFICE  
RENOVATION**


33 URSULA FRANKLIN ST.  
DRAWING SHEET TITLE  
**LEVEL 2 & 3 FURNITURE  
PLANS (REFERENCE  
ONLY)**

DRAWN BY: AS  
REVIEWED BY: SC  
UNIVERSITY PROJECT NUMBER: NORTH POINT  
**P164-24-165**


DRAWING NUMBER  
**A226**  
REV. NUMBER  
**6**




C:\Users\songant\Documents\IP164-25-165\_A\_26\_anita\_song.rvt 2026-04-22 11:52:21 AM

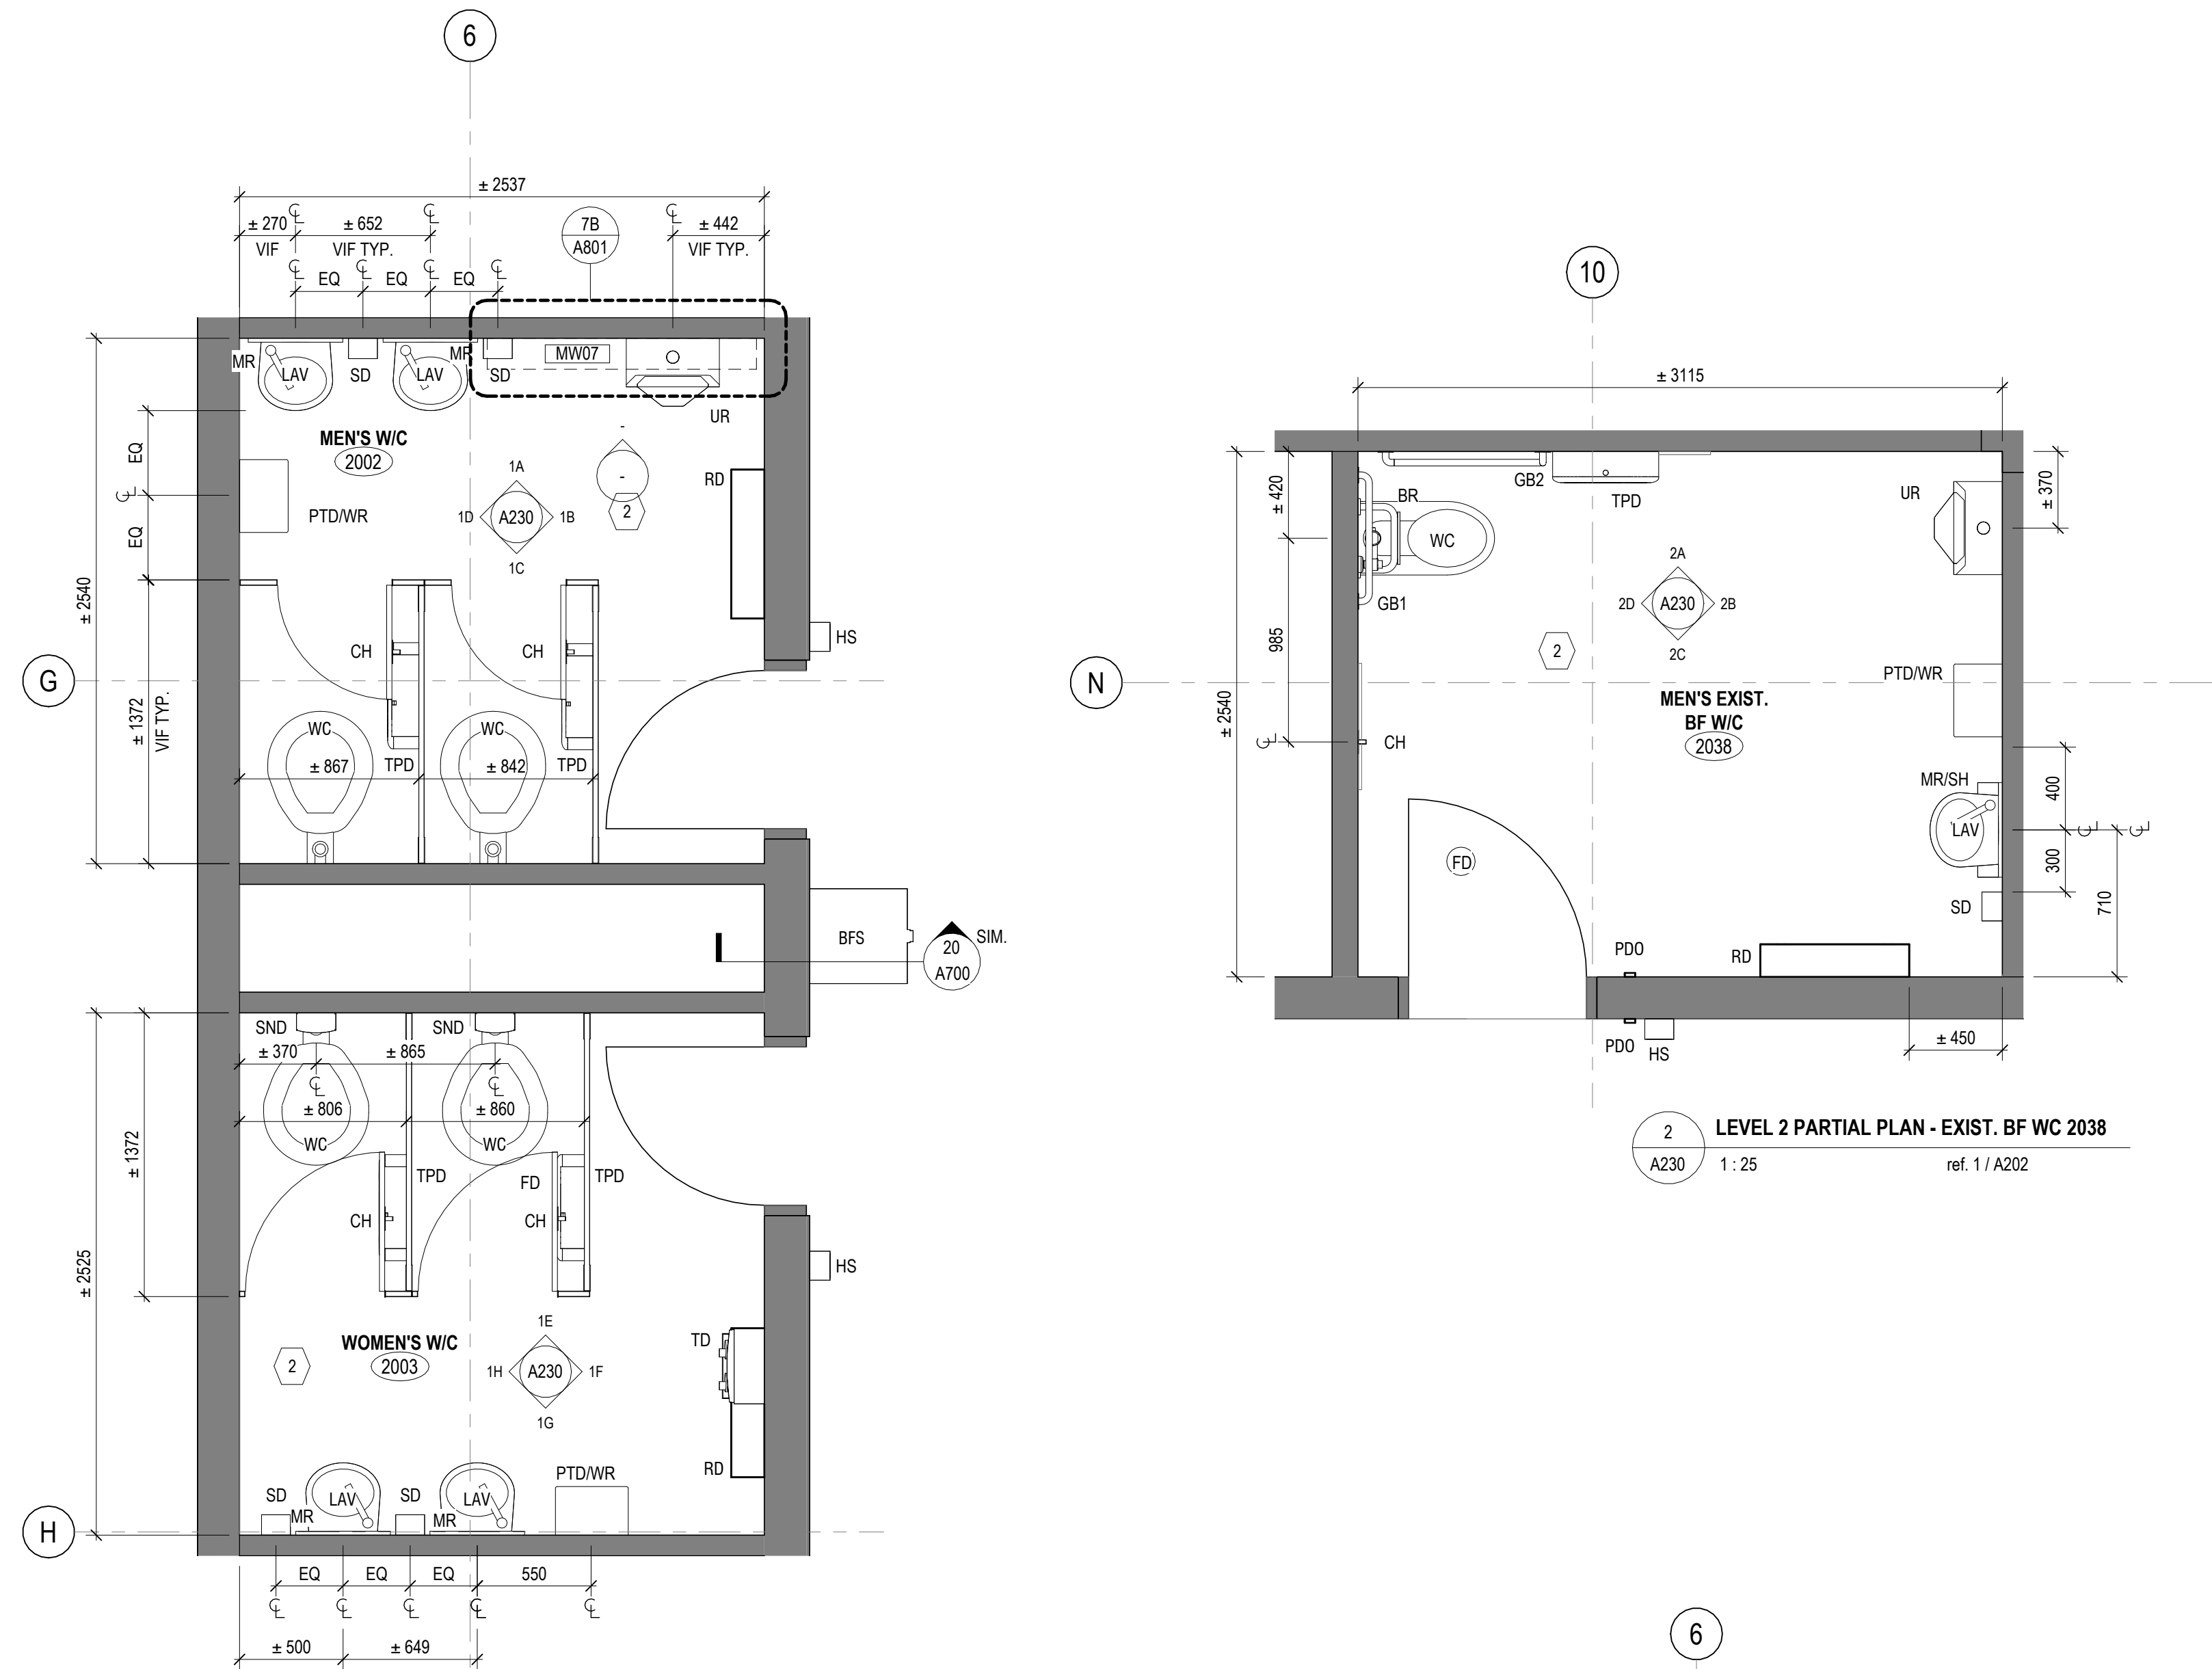


1 LEVEL 2 PARTIAL PLAN - WC 2002 & 2003  
A230 1:25 ref. 1/A202

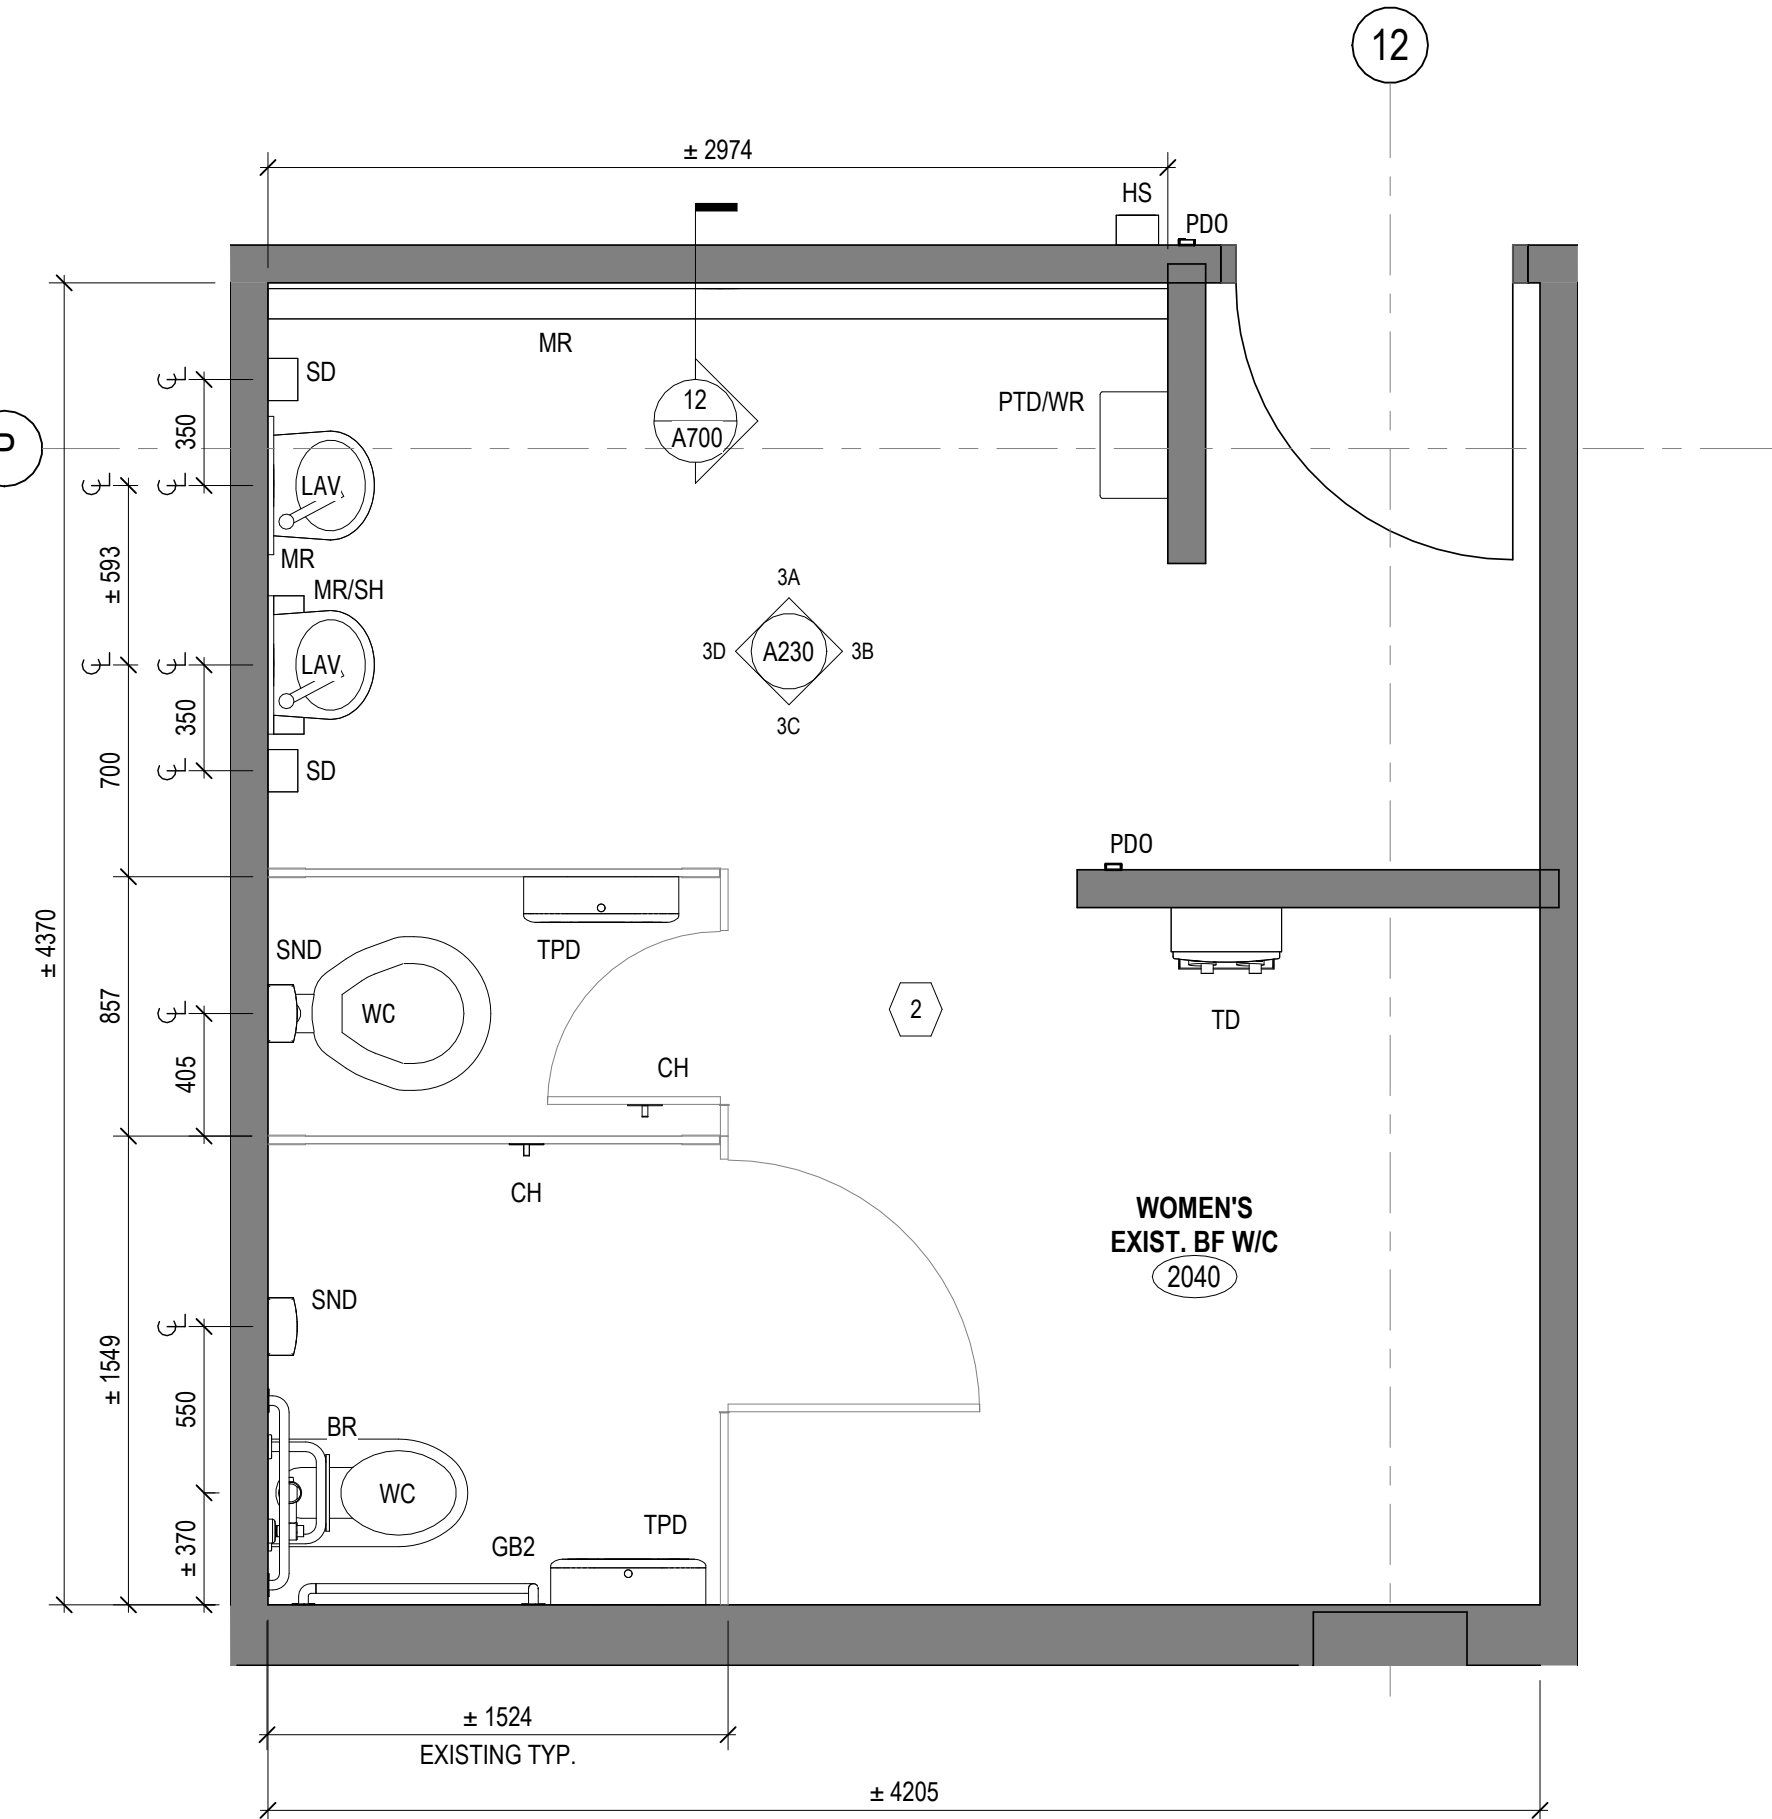


3 LEVEL 2 PARTIAL PLAN - EXIST. BF WC 2040  
A230 1:25 ref. 1/A202

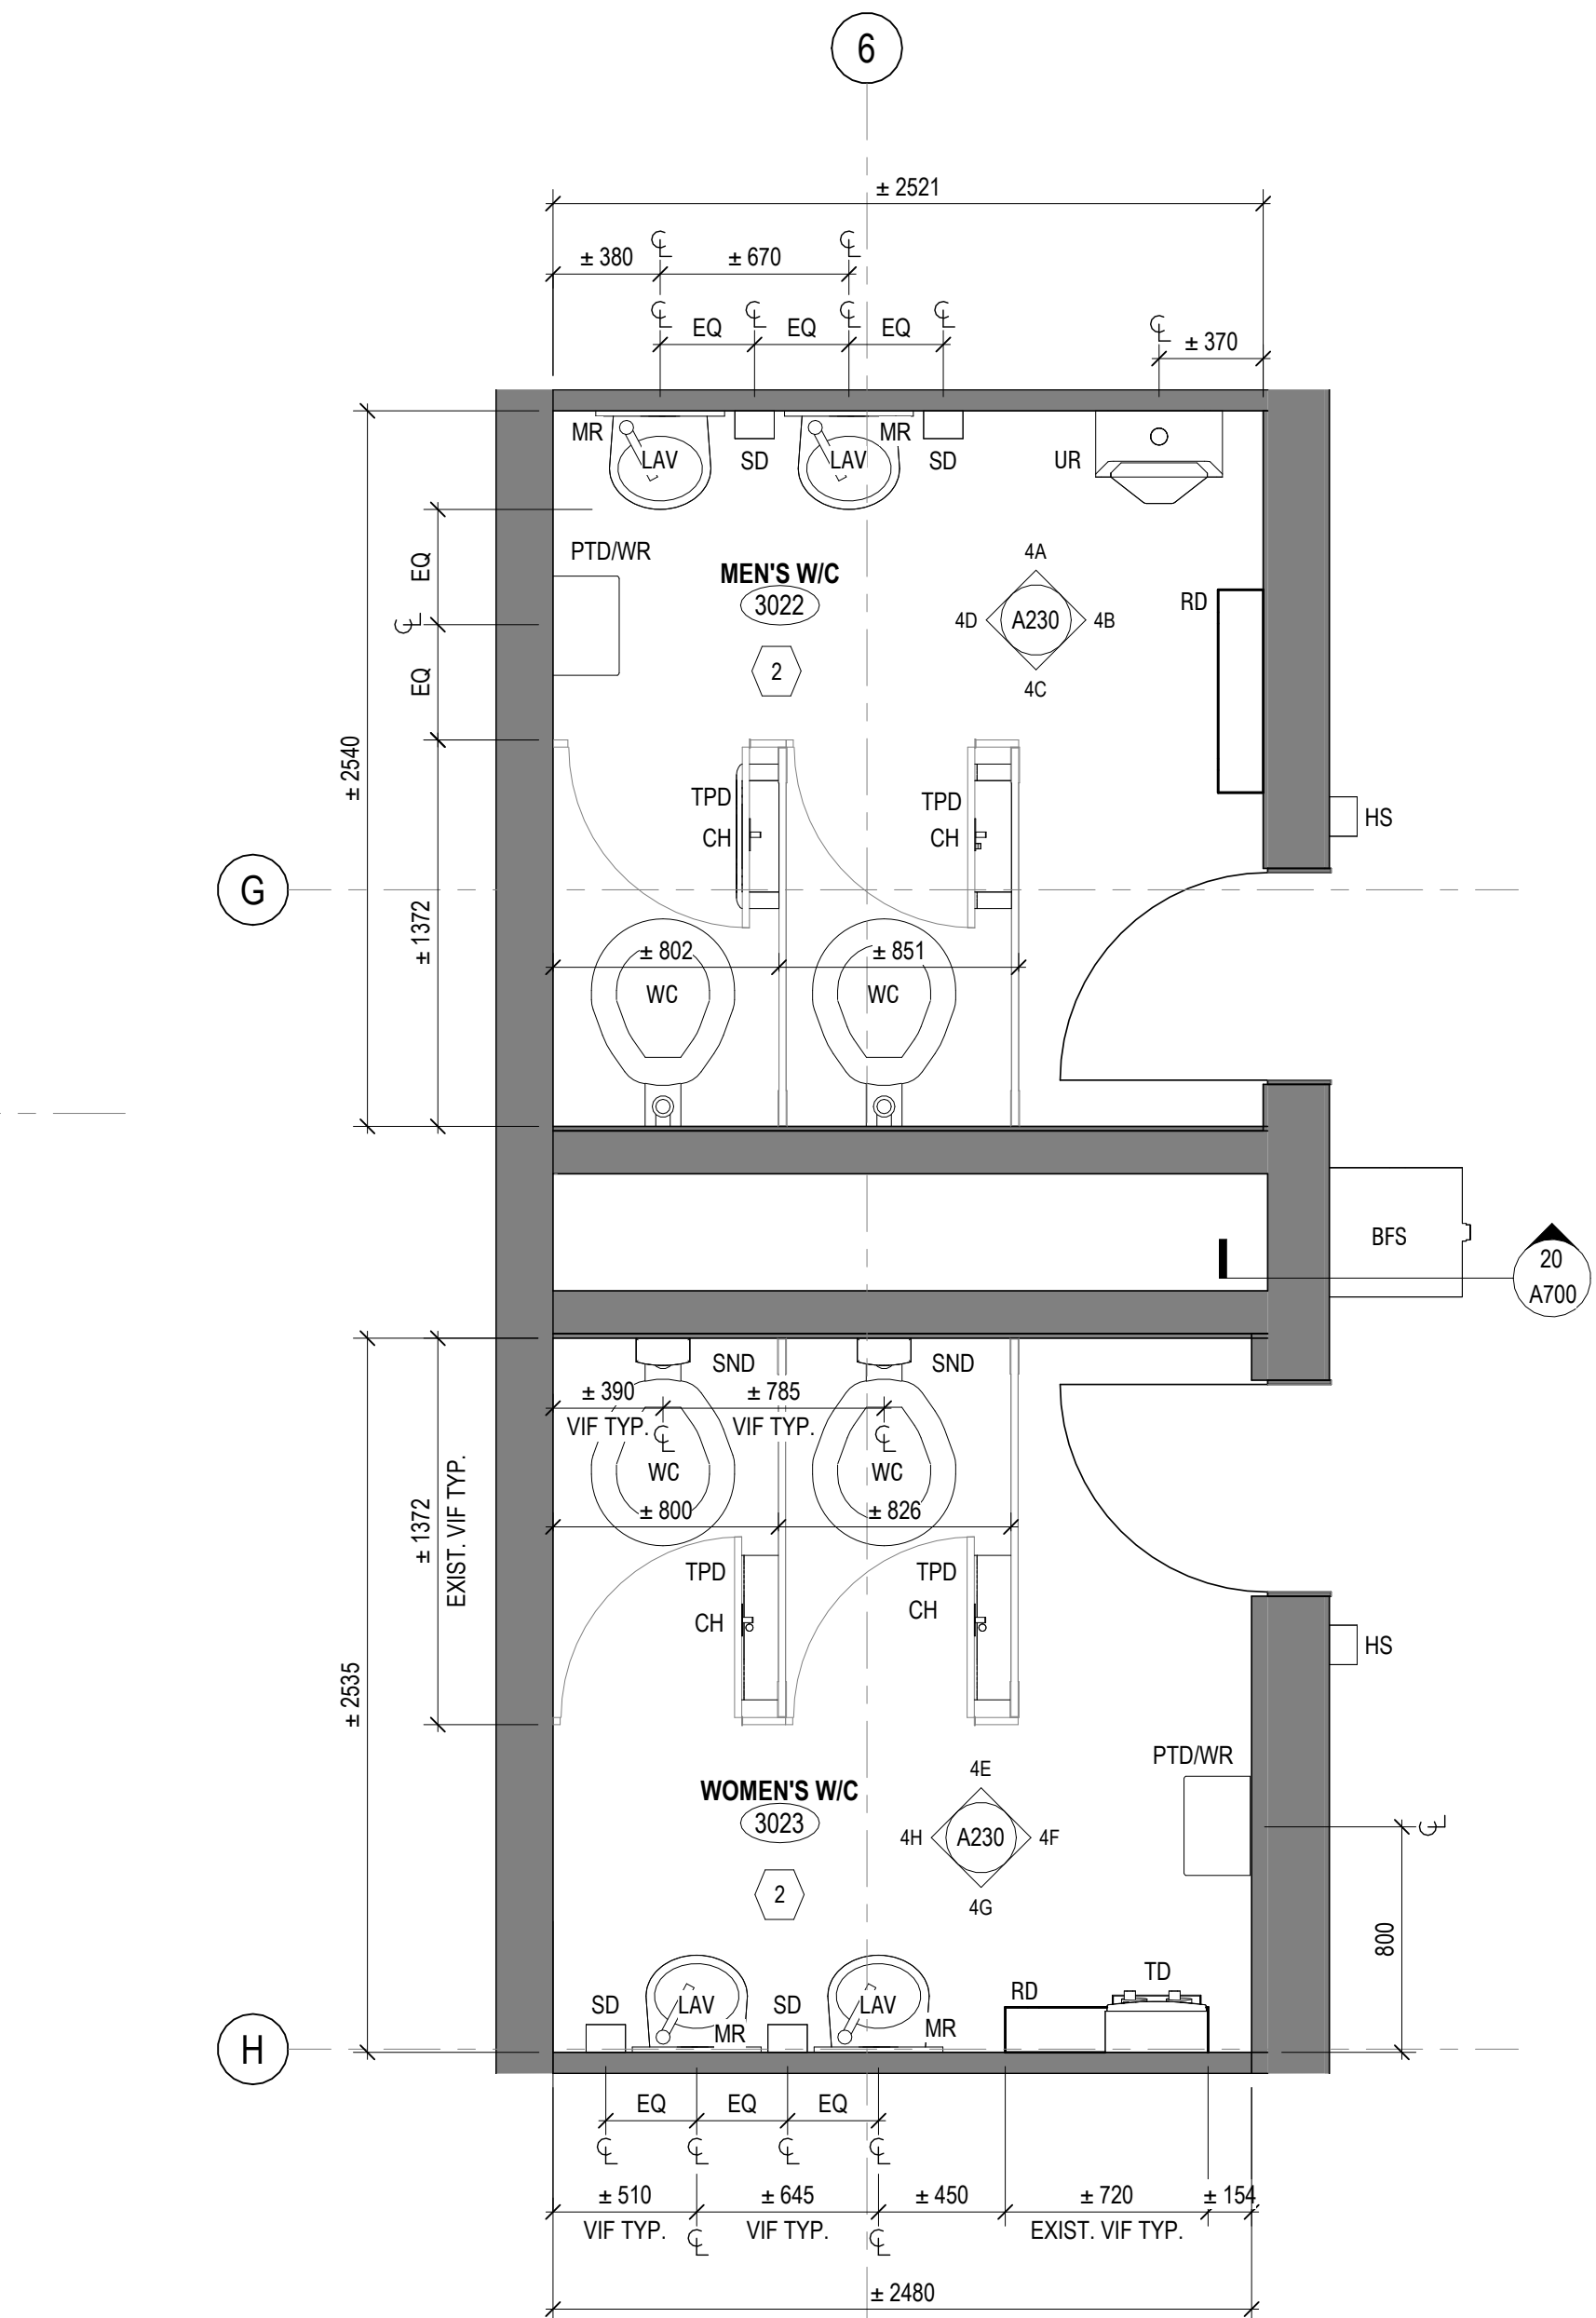


4 LEVEL 3 PARTIAL PLAN - WC 3022 & 3023  
A230 1:25 ref. 1/A203

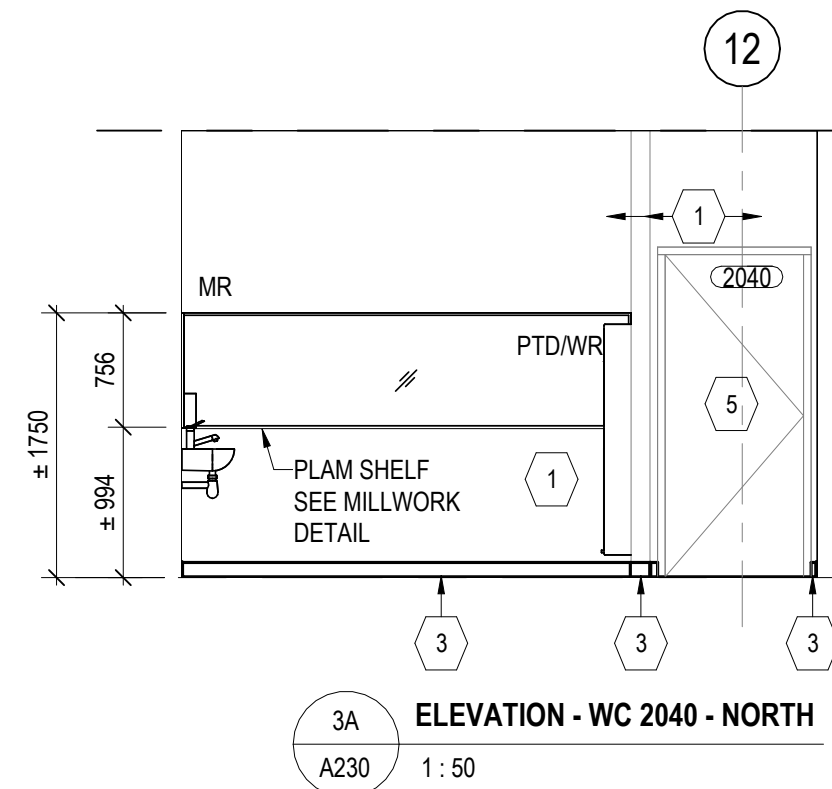


3A ELEVATION - WC 2040 - NORTH  
A230 1:50

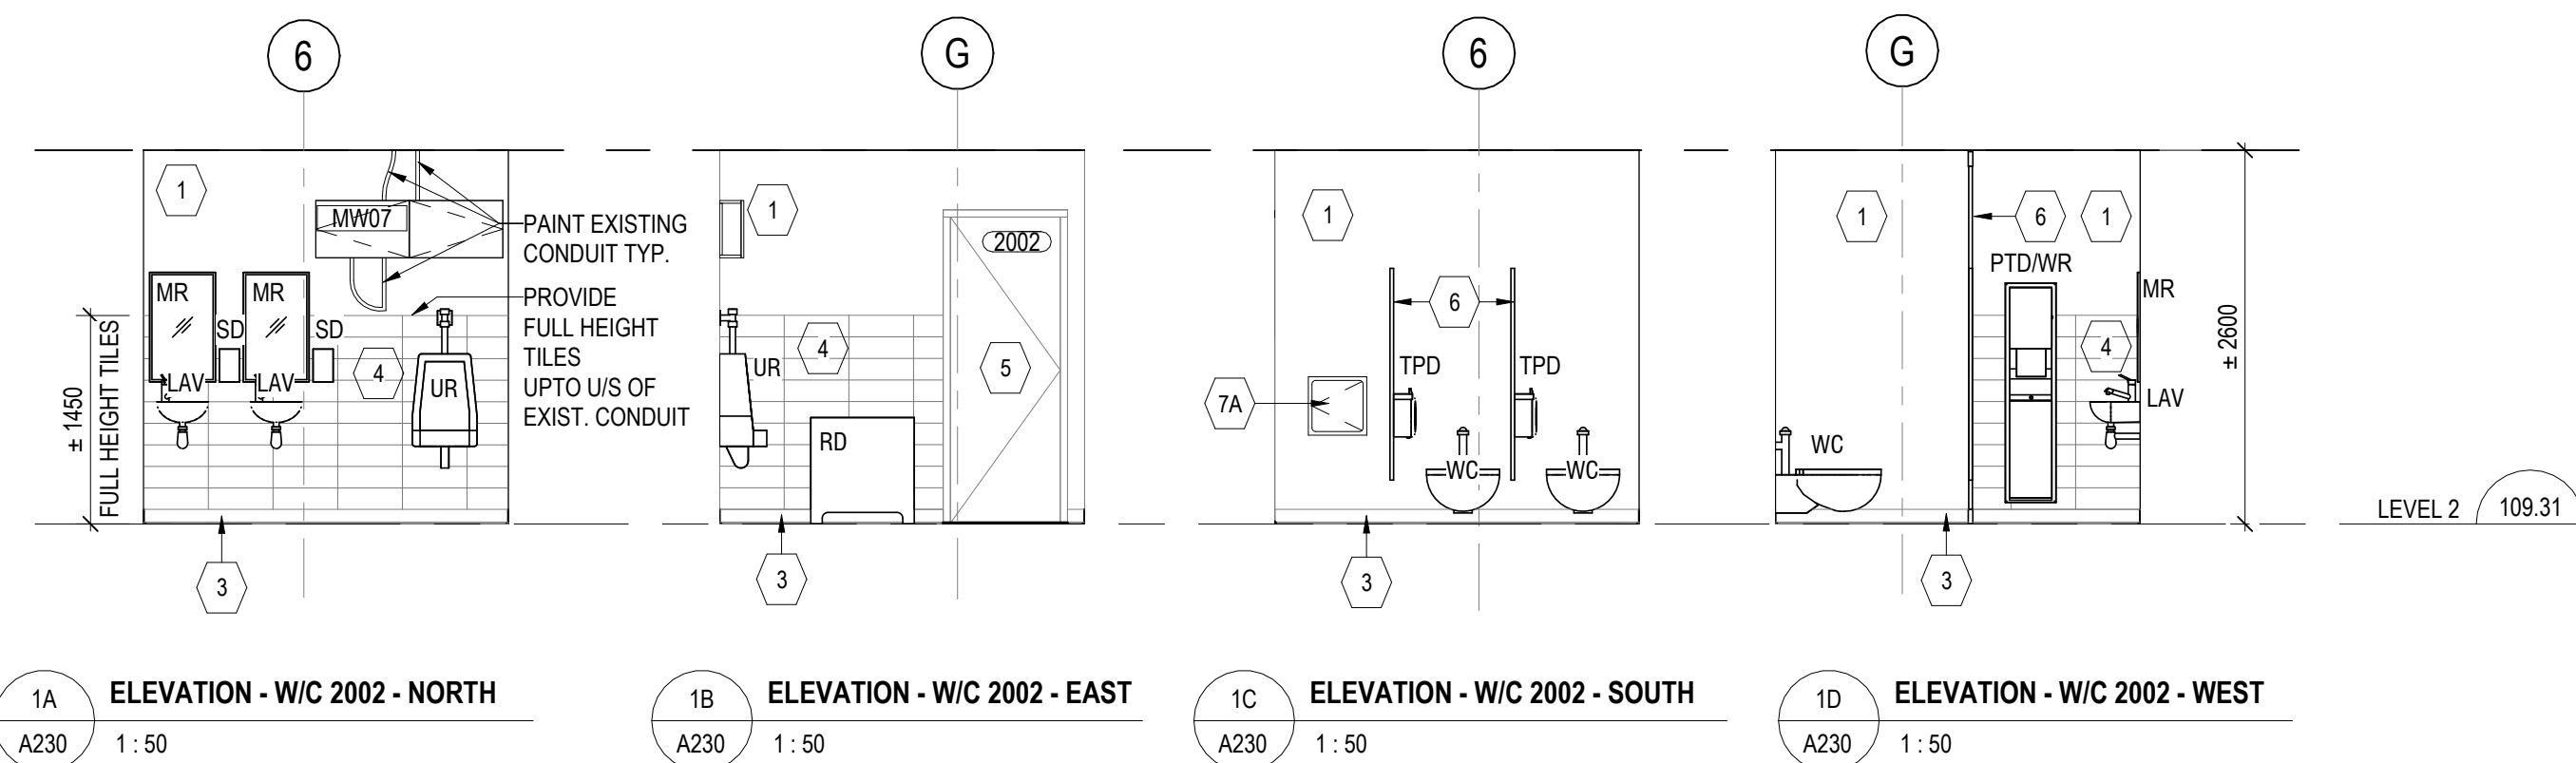


1A ELEVATION - WIC 2002 - NORTH  
A230 1:50  
1B ELEVATION - WIC 2002 - EAST  
A230 1:50  
1C ELEVATION - WIC 2002 - SOUTH  
A230 1:50  
1D ELEVATION - WIC 2002 - WEST  
A230 1:50

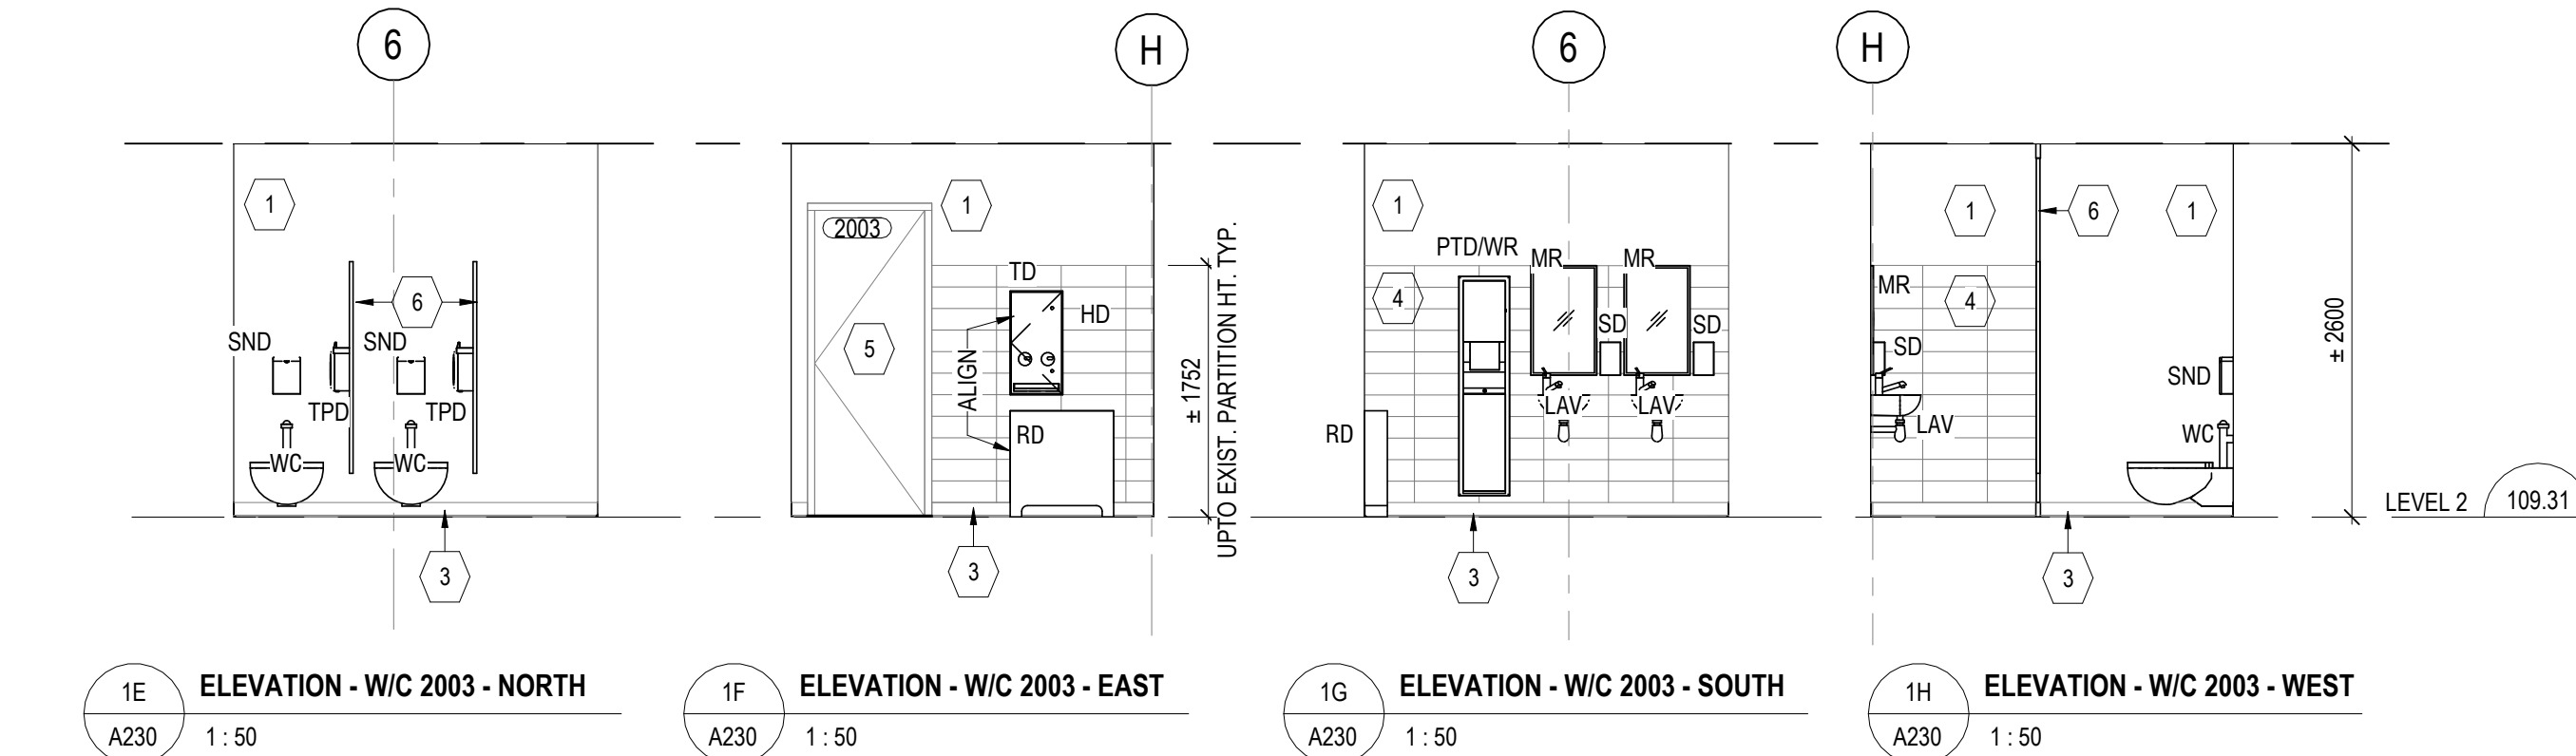


1E ELEVATION - WIC 2003 - NORTH  
A230 1:50  
1F ELEVATION - WIC 2003 - EAST  
A230 1:50  
1G ELEVATION - WIC 2003 - SOUTH  
A230 1:50  
1H ELEVATION - WIC 2003 - WEST  
A230 1:50

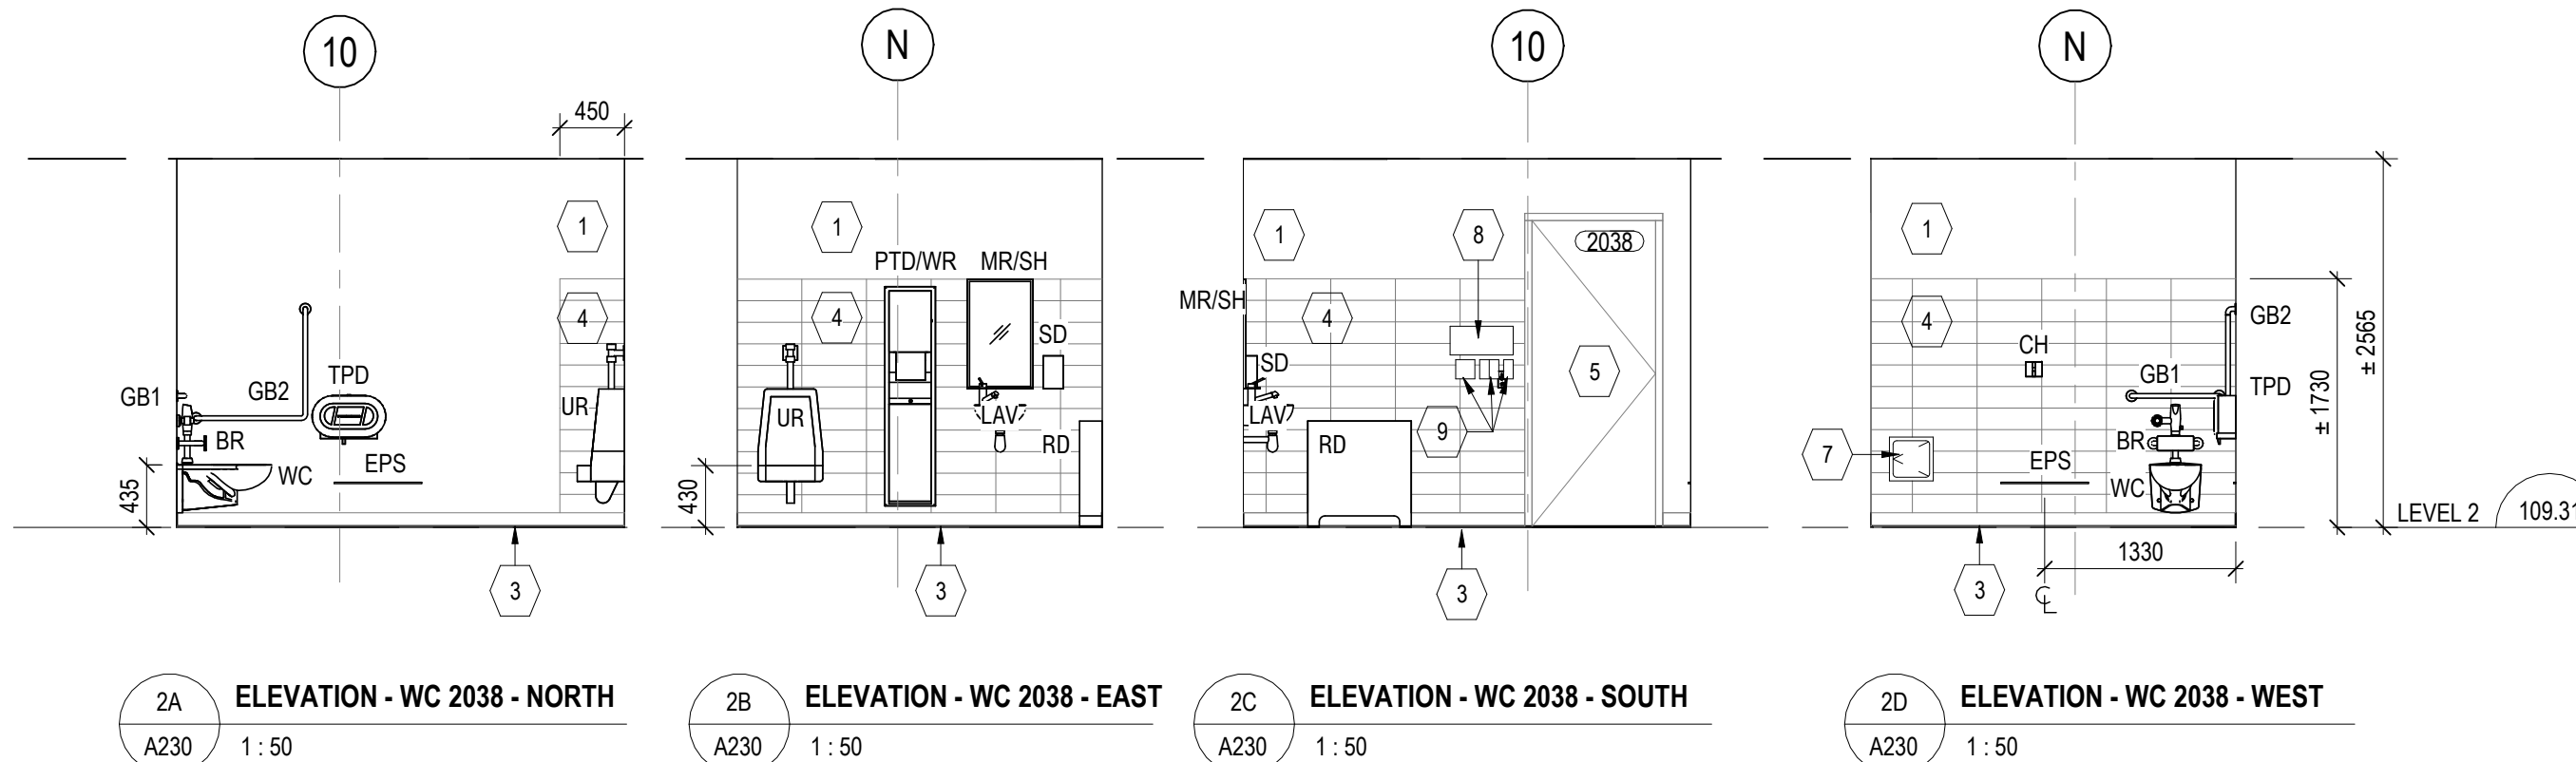


2A ELEVATION - WC 2038 - NORTH  
A230 1:50  
2B ELEVATION - WC 2038 - EAST  
A230 1:50  
2C ELEVATION - WC 2038 - SOUTH  
A230 1:50  
2D ELEVATION - WC 2038 - WEST  
A230 1:50

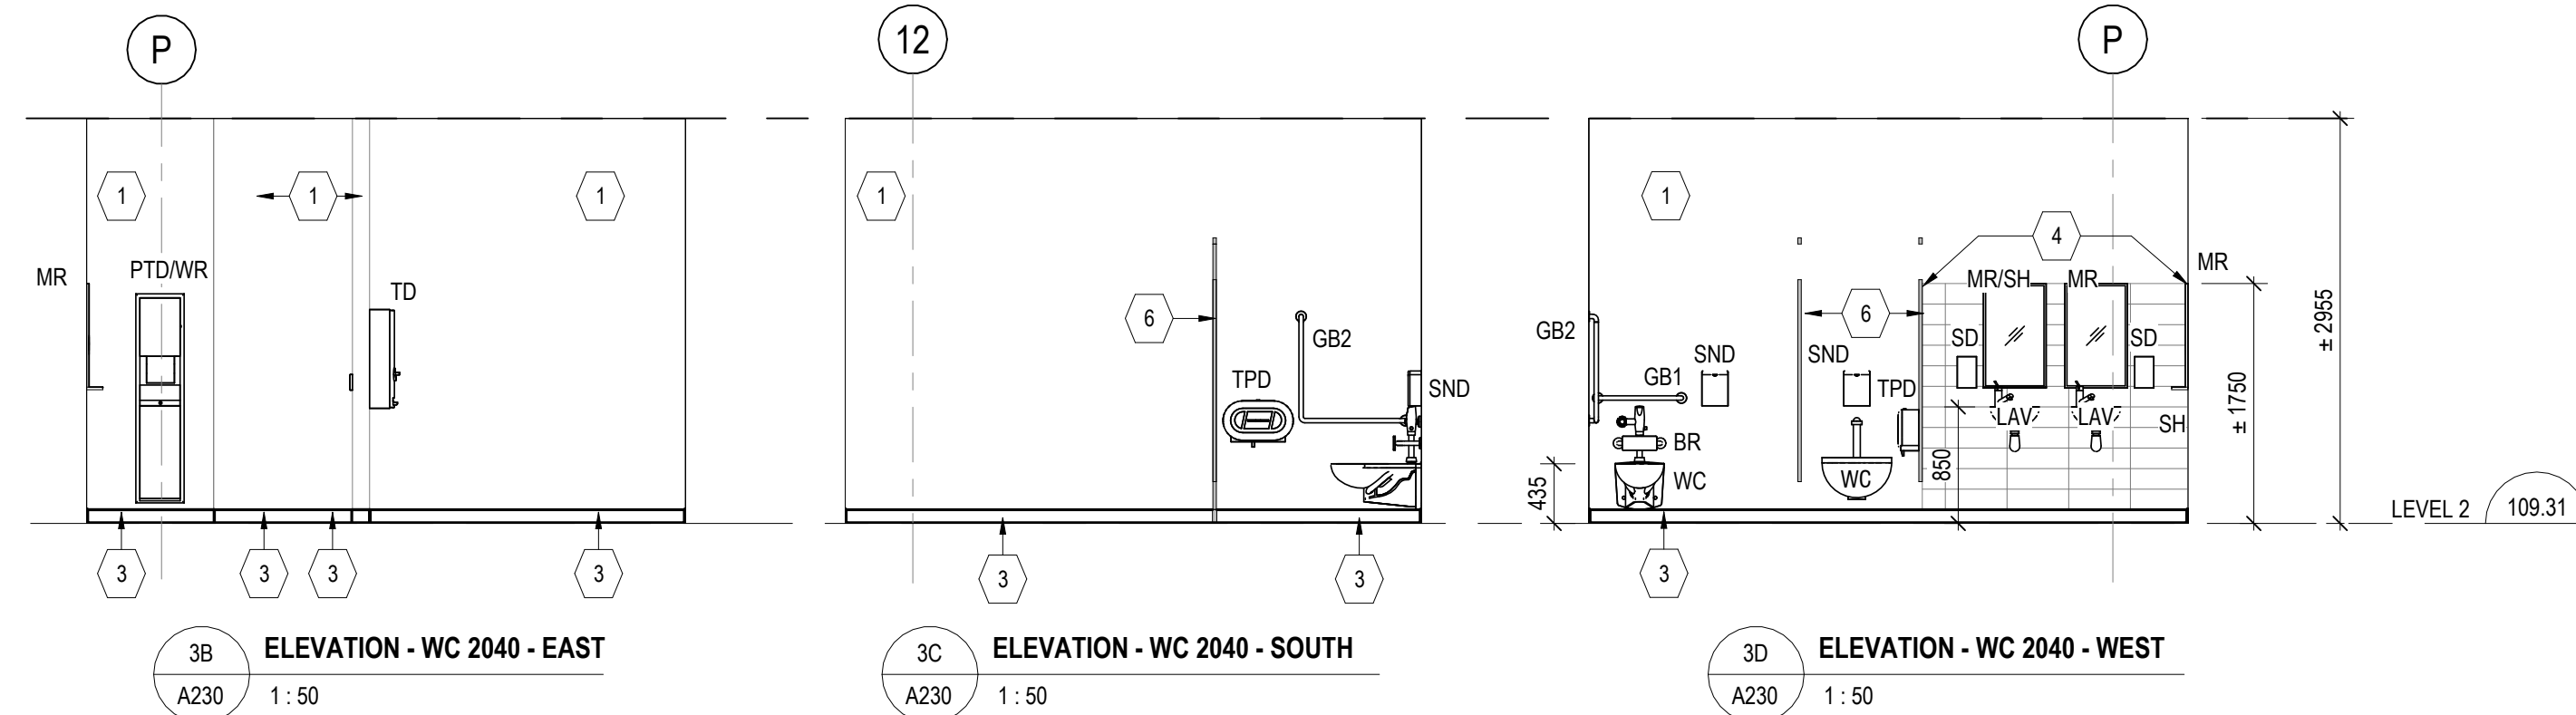


3B ELEVATION - WC 2040 - EAST  
A230 1:50  
3C ELEVATION - WC 2040 - SOUTH  
A230 1:50  
3D ELEVATION - WC 2040 - WEST  
A230 1:50

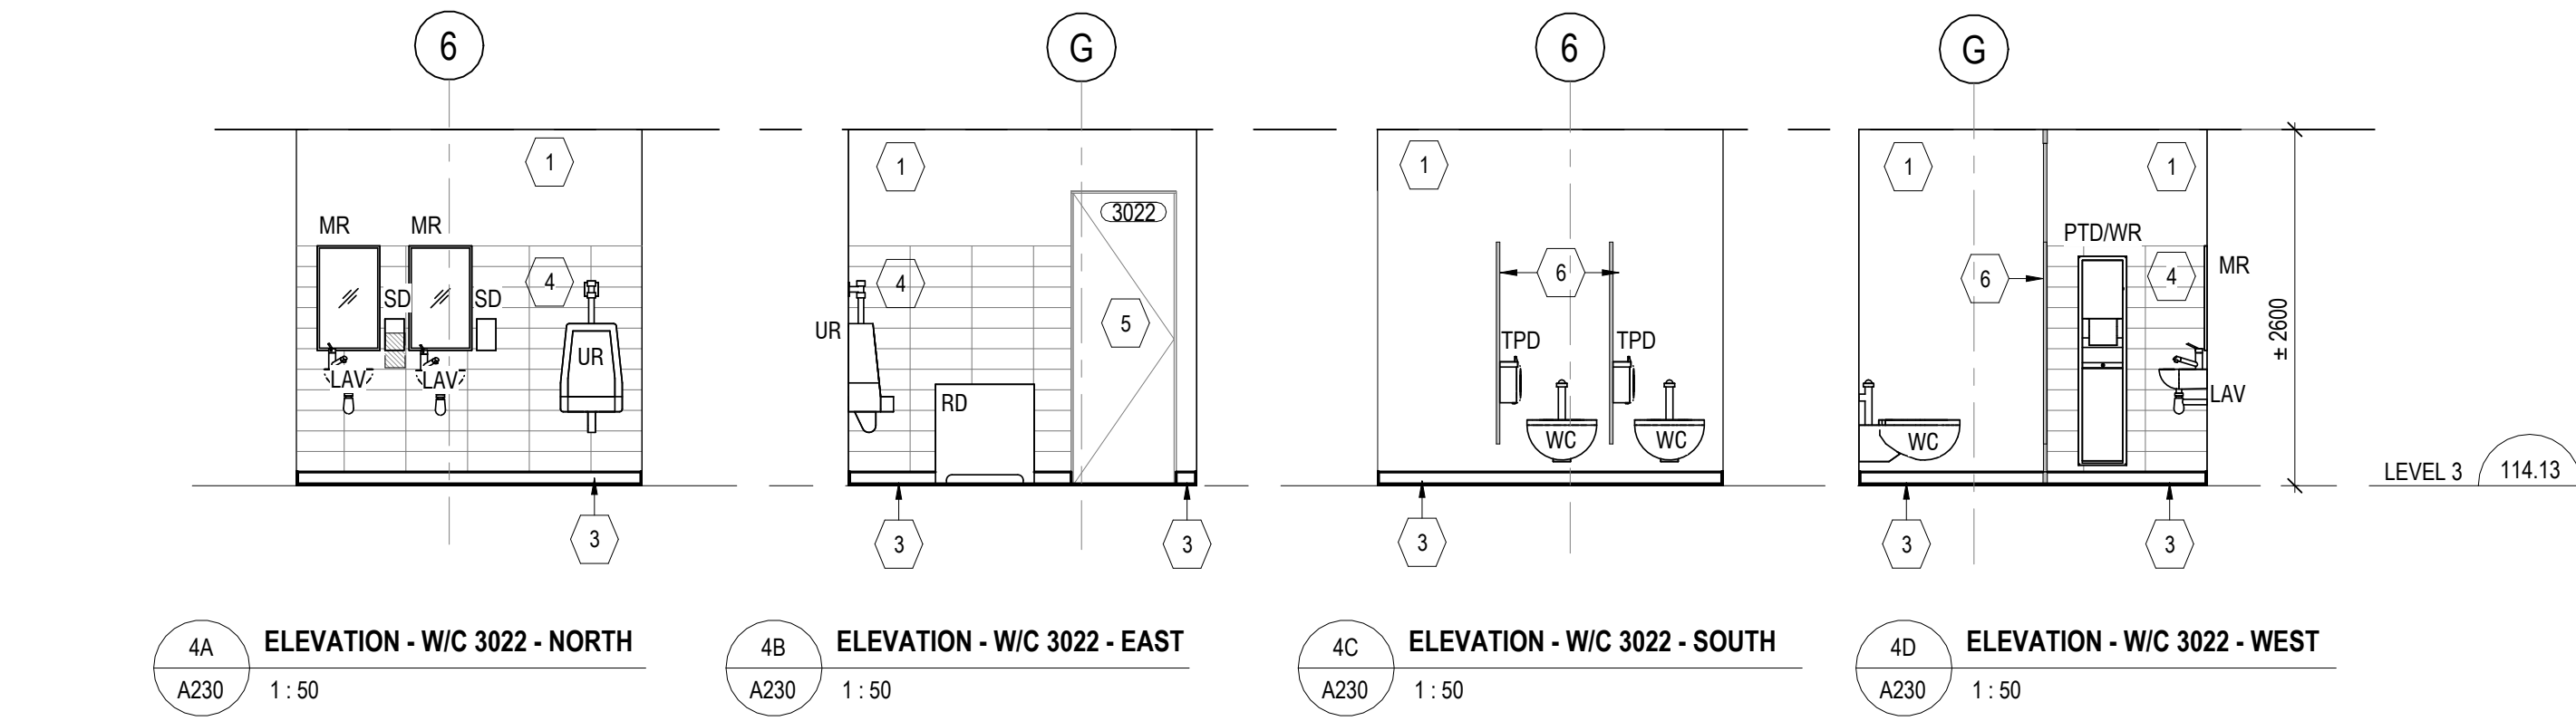


4A ELEVATION - WIC 3022 - NORTH  
A230 1:50  
4B ELEVATION - WIC 3022 - EAST  
A230 1:50  
4C ELEVATION - WIC 3022 - SOUTH  
A230 1:50  
4D ELEVATION - WIC 3022 - WEST  
A230 1:50

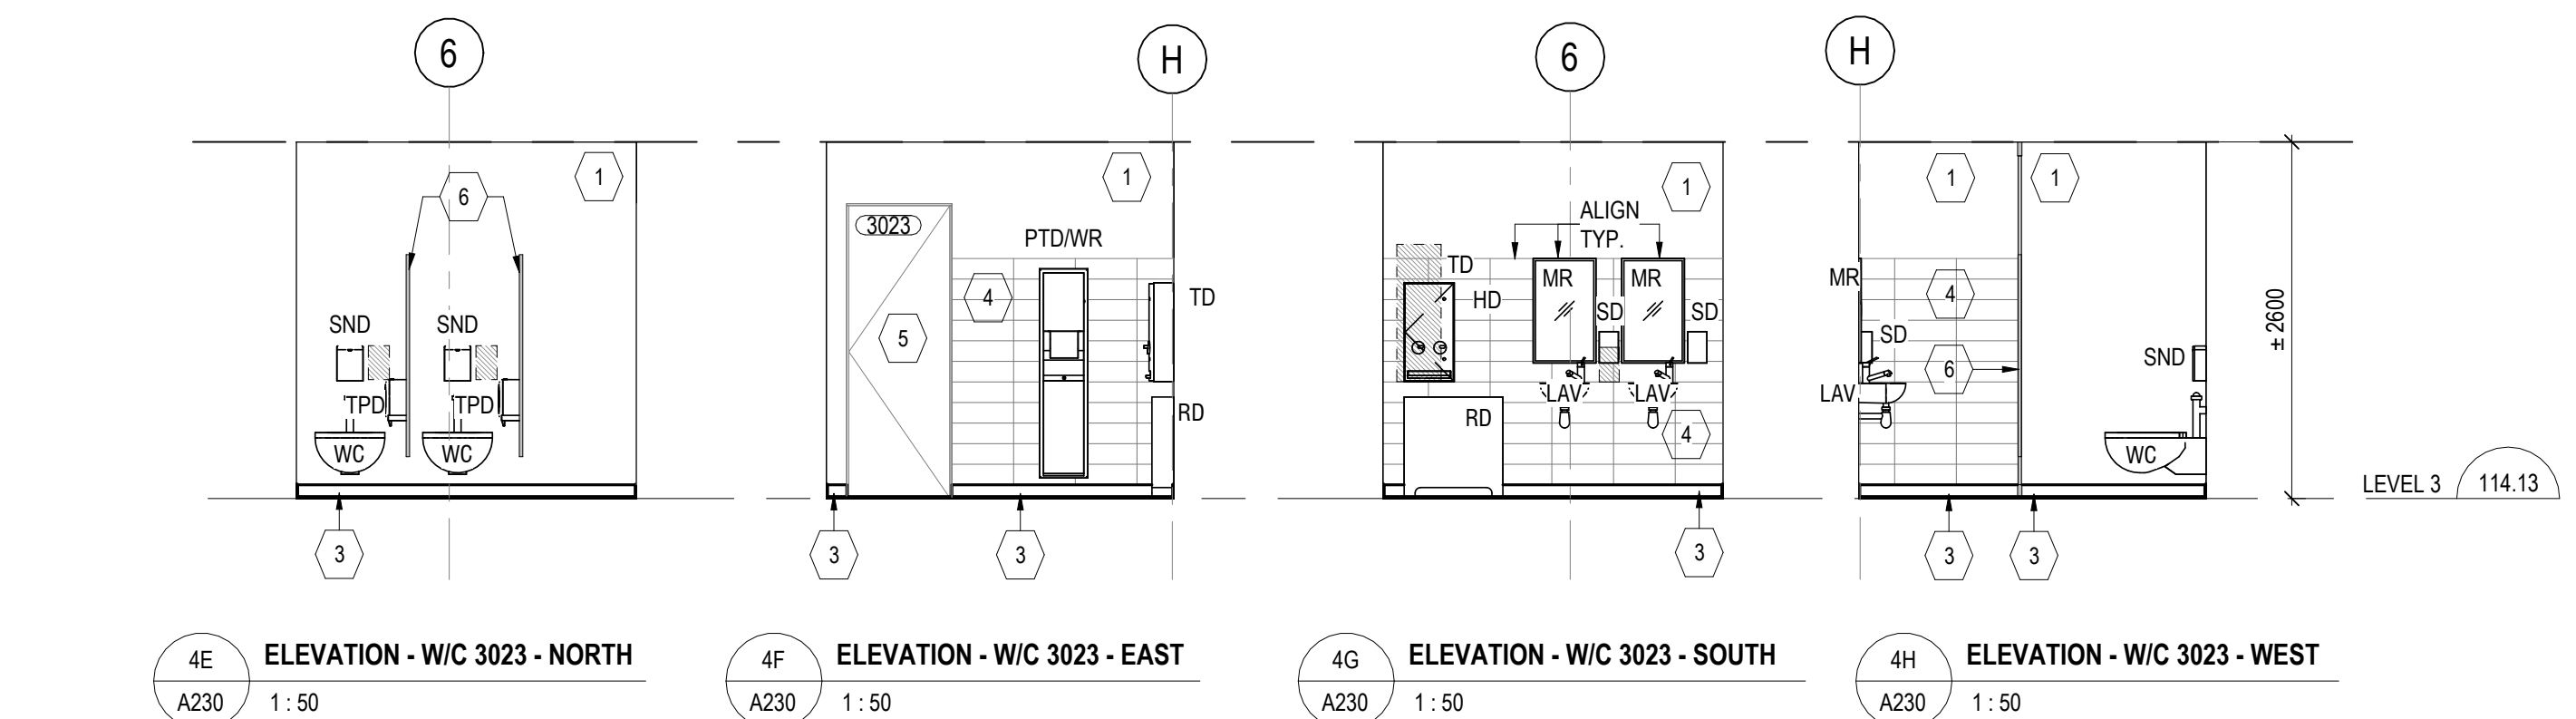

4E ELEVATION - WIC 3023 - NORTH  
A230 1:50  
4F ELEVATION - WIC 3023 - EAST  
A230 1:50  
4G ELEVATION - WIC 3023 - SOUTH  
A230 1:50  
4H ELEVATION - WIC 3023 - WEST  
A230 1:50

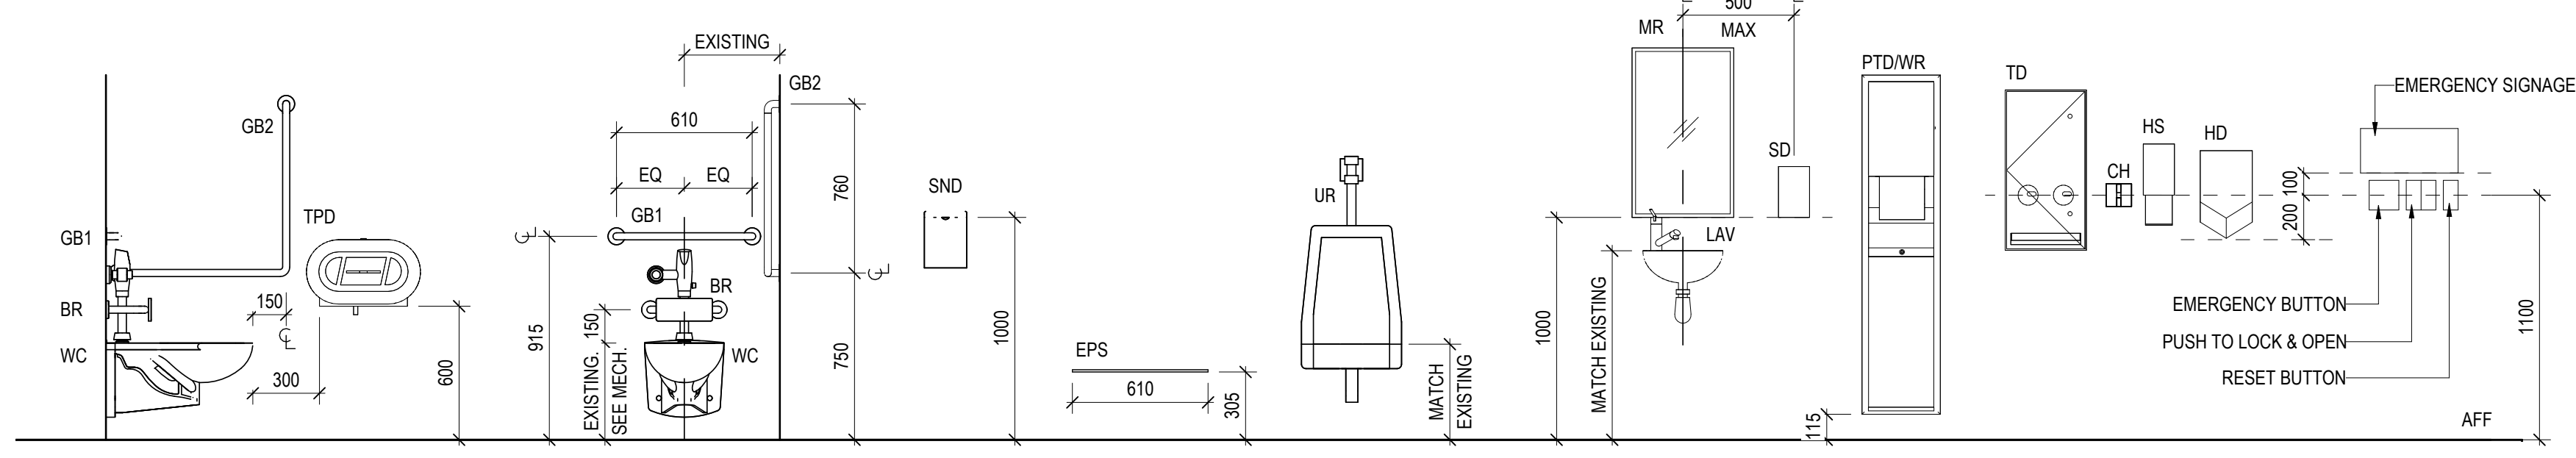

5 TYPICAL WASHROOM ACCESSORIES  
A230 1:25

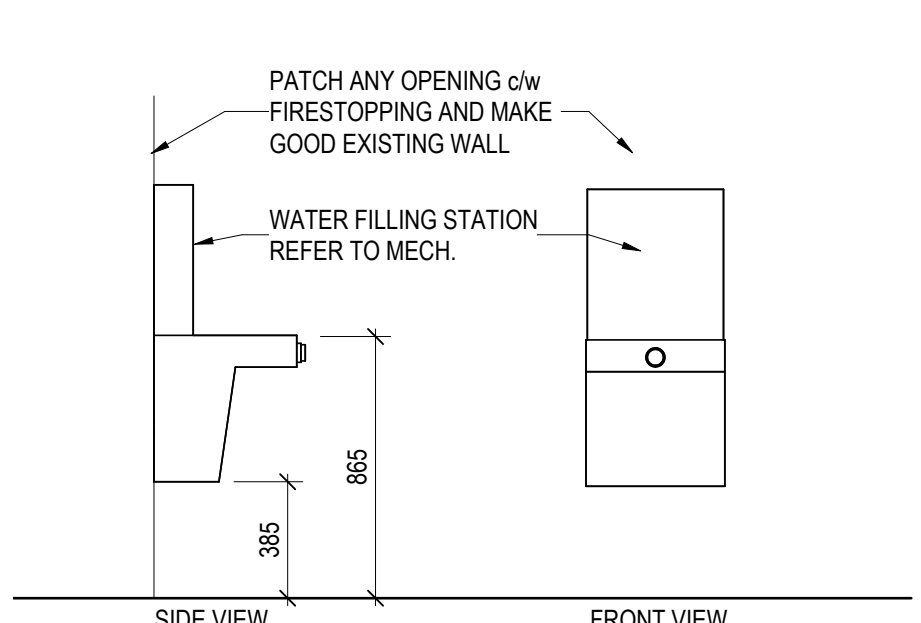

6 ELEVATION - TYPICAL WATER FILLING STATION  
A230 1:25

CONSTRUCTION NOTES	
No.	DESCRIPTION
1	PAINT EXISTING WALLS
2	PROVIDE NEW EPOXY COATING ON THE EXISTING EPOXY FLOORING
3	PROVIDE NEW EPOXY COATING ON THE EXISTING COVE BASE
4	PATCH WALL OPENING AND PROVIDE NEW FULL-HEIGHT WALL TILES. PROVIDE METAL EDGE TRIMS AT ALL EXPOSED TILE EDGES
5	REPAINT EXISTING DOOR AND DOOR FRAME
6	EXISTING WASHROOM PARTITIONS TO REMAIN - PROVIDE NEW TRIM PIECES AS REQUIRED
7	PAINT EXISTING ACCESS HATCH. CUT AND FIT NEW WALL TILES AROUND THE EXISTING ACCESS HATCH. PROVIDE METAL EDGE TRIMS AT ALL EXPOSED TILE EDGES AT THE PERIMETER OF THE OPENING
7A	PAINT EXISTING ACCESS HATCH
8	EMERGENCY SIGNAGE
9	SWITCHES. SEE ELEC. & DOOR HARDWARE SCHEDULE

- GENERAL NOTES - NEW WORK: WASHROOM
- MAKE GOOD ALL EXISTING WALL SURFACES DAMAGED DURING REMOVALS AND CONSTRUCTION
  - PAINT EXISTING DOOR AND DOOR FRAMES
  - PROVIDE FIRESTOPPING TO ALL FLOOR SERVICE PENETRATIONS. REFER TO MECH AND ELEC DWG FOR LOCATIONS OF PENETRATION
  - SEE GENERAL NOTES ON DRAWING A001
  - CONTRACTOR TO PATCH, REPAIR AND MAKE GOOD ALL AREAS DISTURBED BY THE OPERATION OF THE WORK AND DISTURBED BY THE WORK OF OTHER TRADES (MECH, ELEC & A/E, ETC.). MATERIALS AND FINISHES TO MATCH EXISTING UNLESS NOTED OTHERWISE
  - WHERE DISSIMILAR COMPONENTS SUCH AS PUSH BUTTON AND KEY SWITCH ARE BUILT INTO FIRE RATED ASSEMBLIES, ENSURE CONTINUITY OF FIRE SEPARATION BY BOXING ELEMENTS WITH GYPSUM BOARD AND FRAMING TO SUIT AUTHORITIES JURISDICTION
  - FILL FLOOR OPENINGS WITH NON SHRINK GROUT. REFER TO MECH DWGS AND ELEC DWGS.
  - ACOUSTIC PRODUCTS AND FINISHES: PRIOR TO CONSTRUCTION, PROVIDE SHOP DRAWINGS AND SUBMITTALS FOR ALL GWB ACOUSTIC ELEMENTS SHOWN OR LISTED ON ARCHITECTURAL DRAWINGS AND SPECIFICATIONS FOR REVIEW
  - COAT HOOK: PROVIDE ONE COAT HOOK IN THE MIDDLE OF DOOR INSIDE STALL AT EACH STALL, UNLESS OTHERWISE NOTED.
  - RE-INSTALL RE-PAINTED PARTITIONS.
  - RE-INSTALL WALL MOUNTED PTDWR.
  - REFER TO DESIGNATED SUBSTANCES IN BUILDING MATERIALS SURVEY REPORT (SSSR)

LEGEND - WASHROOM	
BR	NEW BACK REST
BFS	NEW WATER FILLING STATION
CH	NEW COAT HOOK
FD	NEW/EXIST. FLOOR DRAIN. SEE MECH DWGS.
GB	NEW GRAB BAR
HD	NEW HAND DRYER
HS	NEW HAND SANITIZER
LAV	NEW LAVATORY. SEE MECH DWGS.
MR	NEW MIRROR
MRSH	NEW MIRROR <i>on</i> SHELF
PDO	NEW/EXIST. POWER DOOR OPERATOR. SEE HARDWARE SCHEDULE & ELEC.
PTDWR	EXIST. PAPER TOWEL DISPENSER & WASTE RECEPTACLE
RD	EXIST. RADIATOR TO REMAIN. SEE MECH DWGS.
SD	NEW SOAP DISPENSER
SH	NEW SHELF
SND	NEW SANITARY NAPKIN DISPOSAL
TD	NEW TEMPONAPKIN DISPENSER
TPD	NEW TOILET PAPER DISPENSER
UR	NEW URINAL. SEE MECH DWGS.
WC	NEW WATER CLOSET. SEE MECH DWGS.
WT	NEW WALL TILE
	INFILL OPENING - SEE DETAIL 19A700

ISSUED FOR	DATE
1	ISSUED FOR TENDER 2026-04-22
2	ISSUED FOR 80% CD 2026-03-09
3	ISSUED FOR PERMIT 2026-03-04
4	ISSUED FOR CLASS A COSTING 2026-02-18
5	ISSUED FOR 100% DD 2026-01-23
6	ISSUED FOR CLASS B COSTING 2026-01-18
7	ISSUED FOR 90% DD 2025-11-08
REV.	DESCRIPTION DATE

KEY PLAN (NTS) SEAL  
PROJECT TITLE  
UNIVERSITY OF TORONTO  
**33 URSULA FRANKLIN  
MATH OFFICE  
RENOVATION**












33 URSULA FRANKLIN ST.  
DRAWING SHEET TITLE  
**LEVEL 2 & 3 WASHROOM  
PLANS & ELEVATIONS**

DRAWN BY: AS SCALE: As indicated  
REVIEWED BY: SC DATE CREATED: 2026/02/11  
UNIVERSITY PROJECT NUMBER: NORTH POINT

P164-24-165  
DRAWING NUMBER  
**A230**  
REV. NUMBER  
**7**



C:\Users\songanit\Documents\P164-25-165\_A\_26\_anita\_song.rvt 2026-04-22 11:52:32 AM

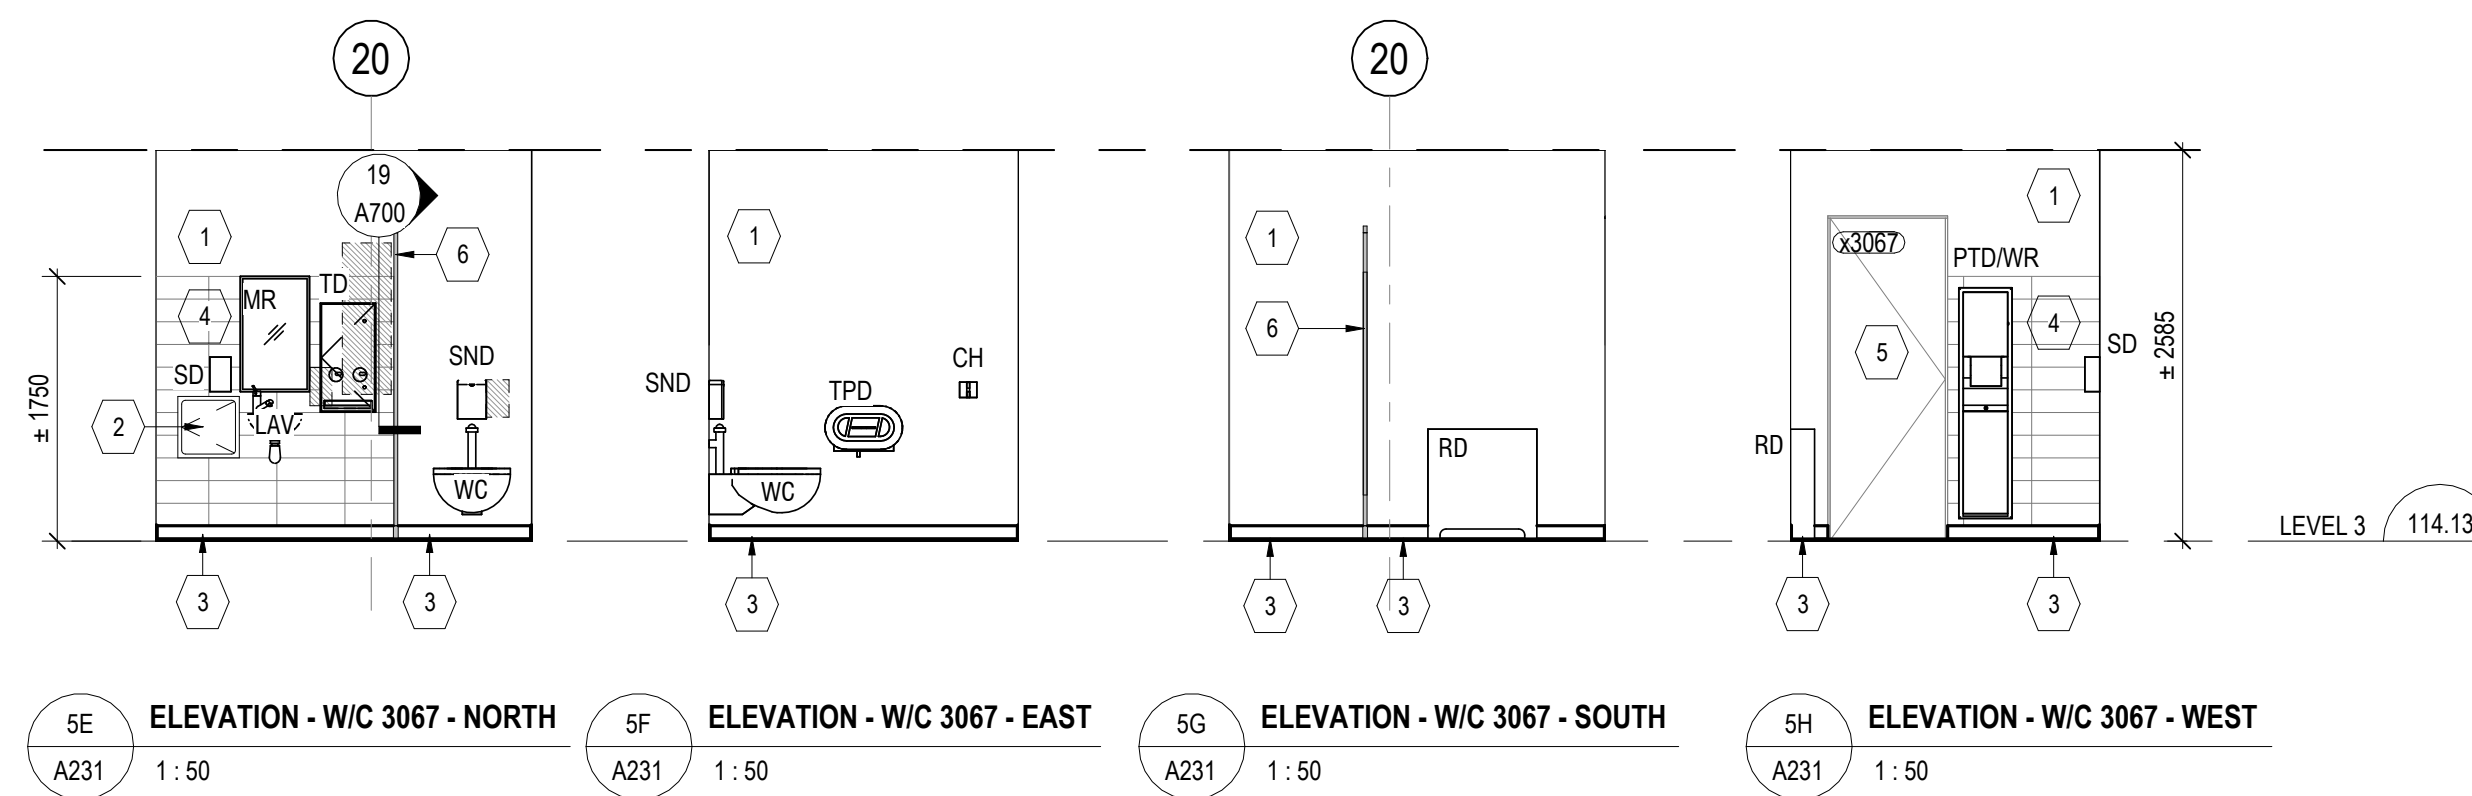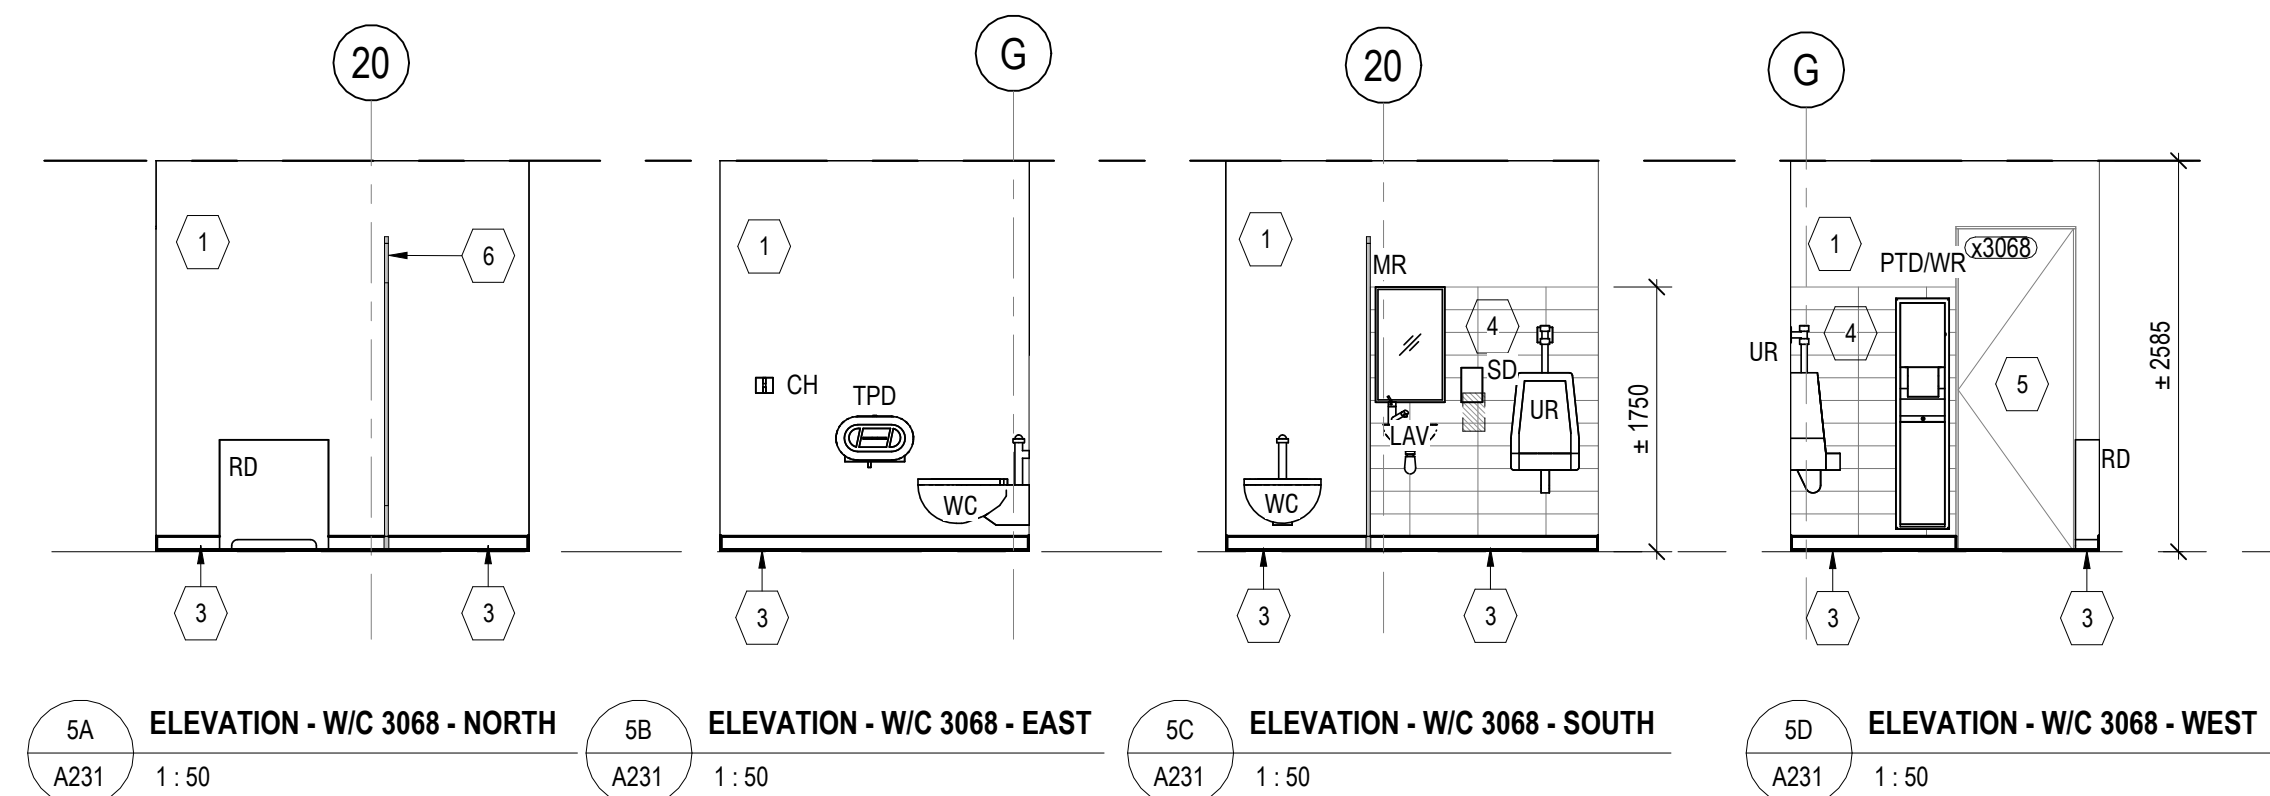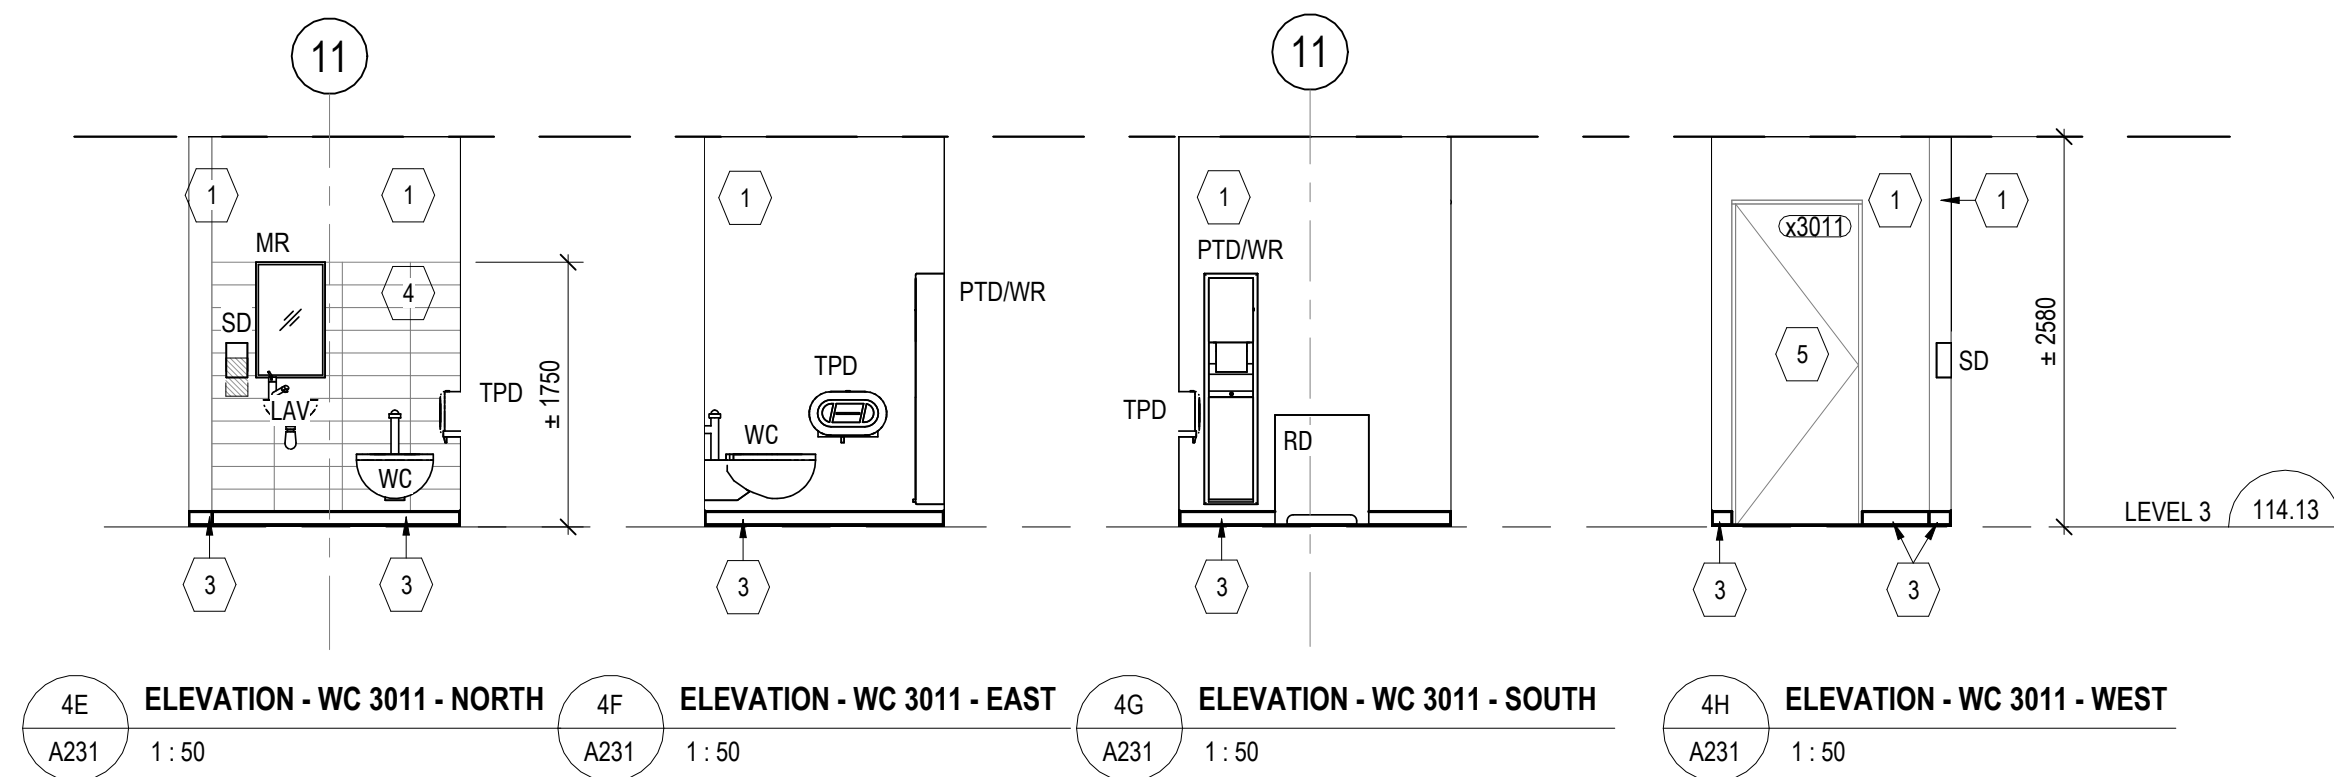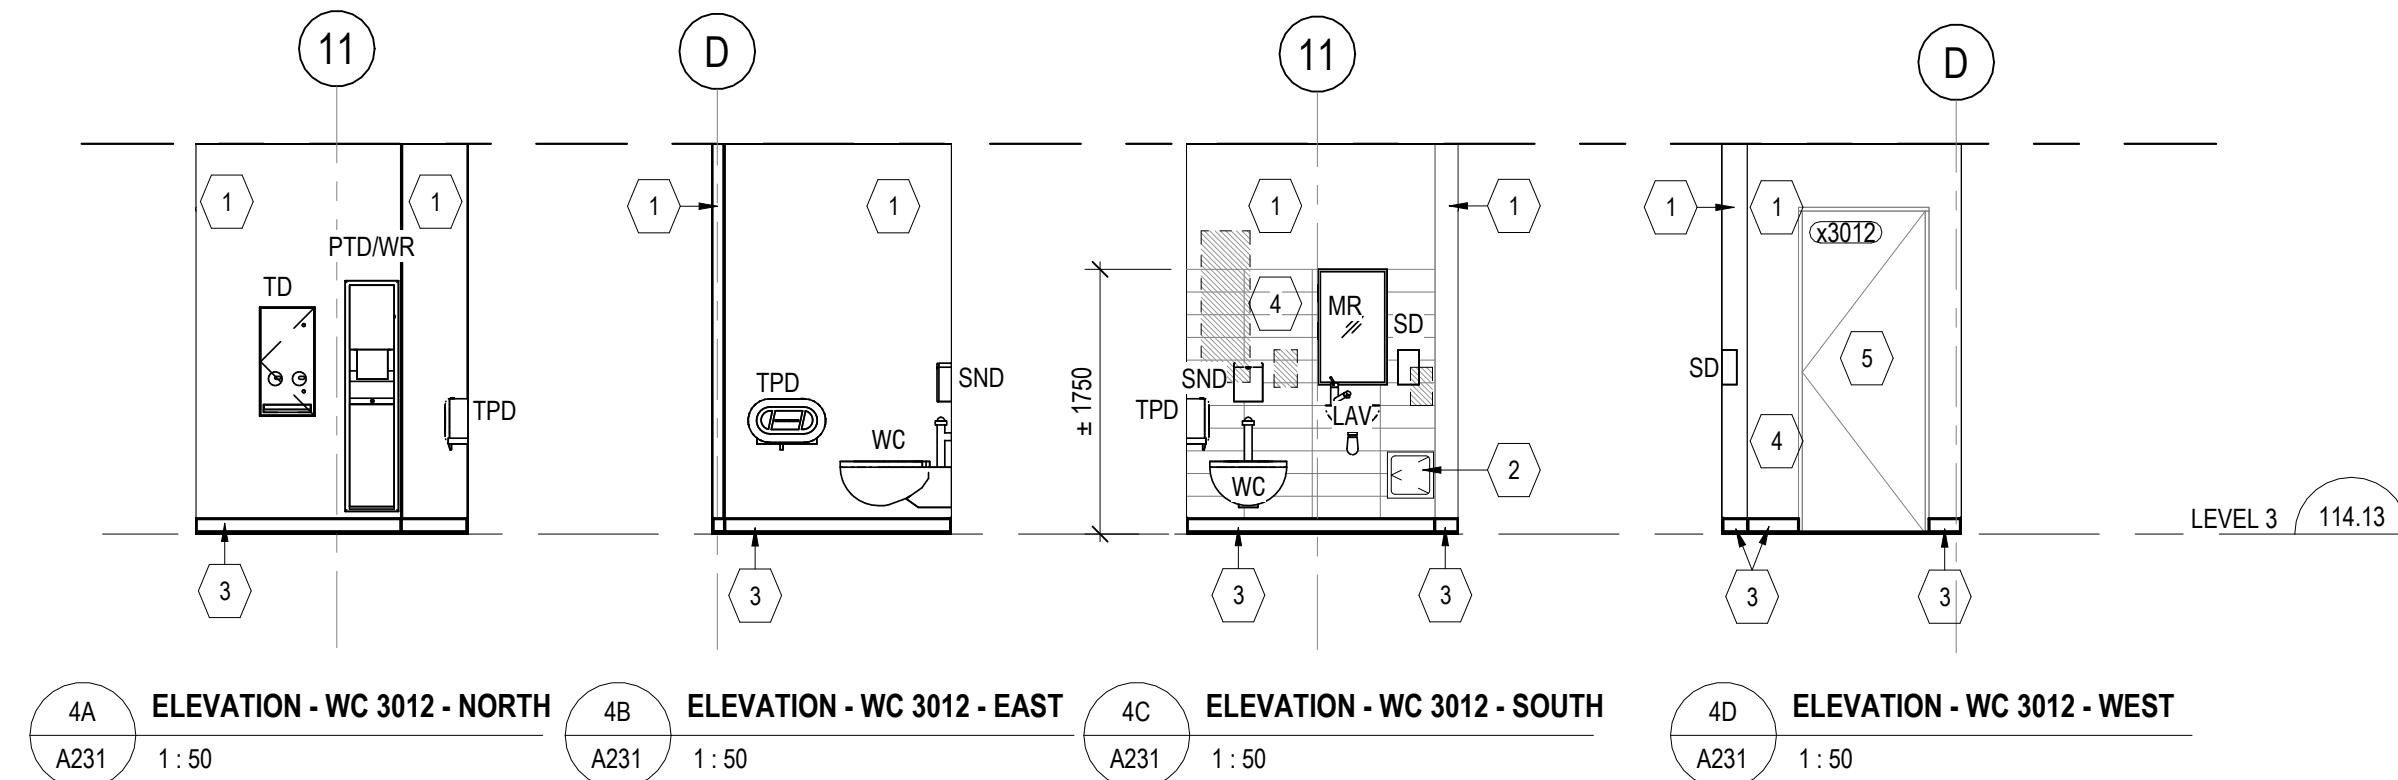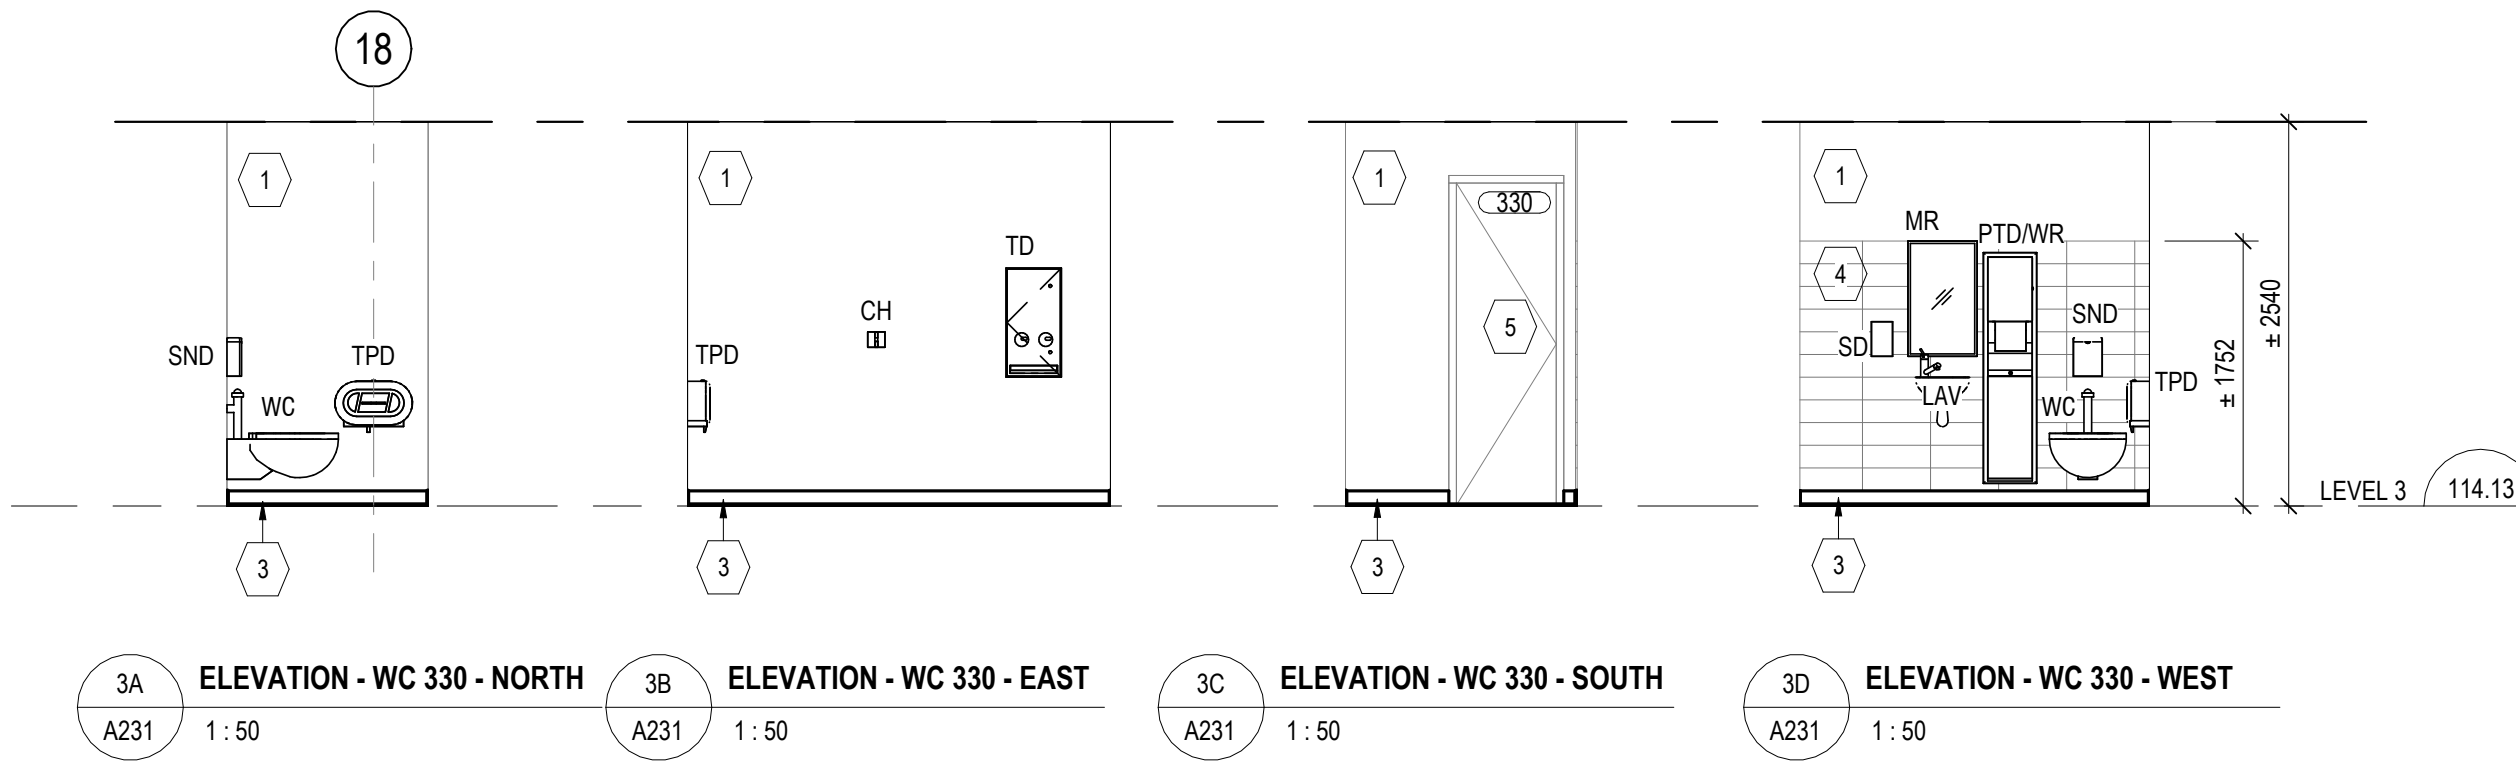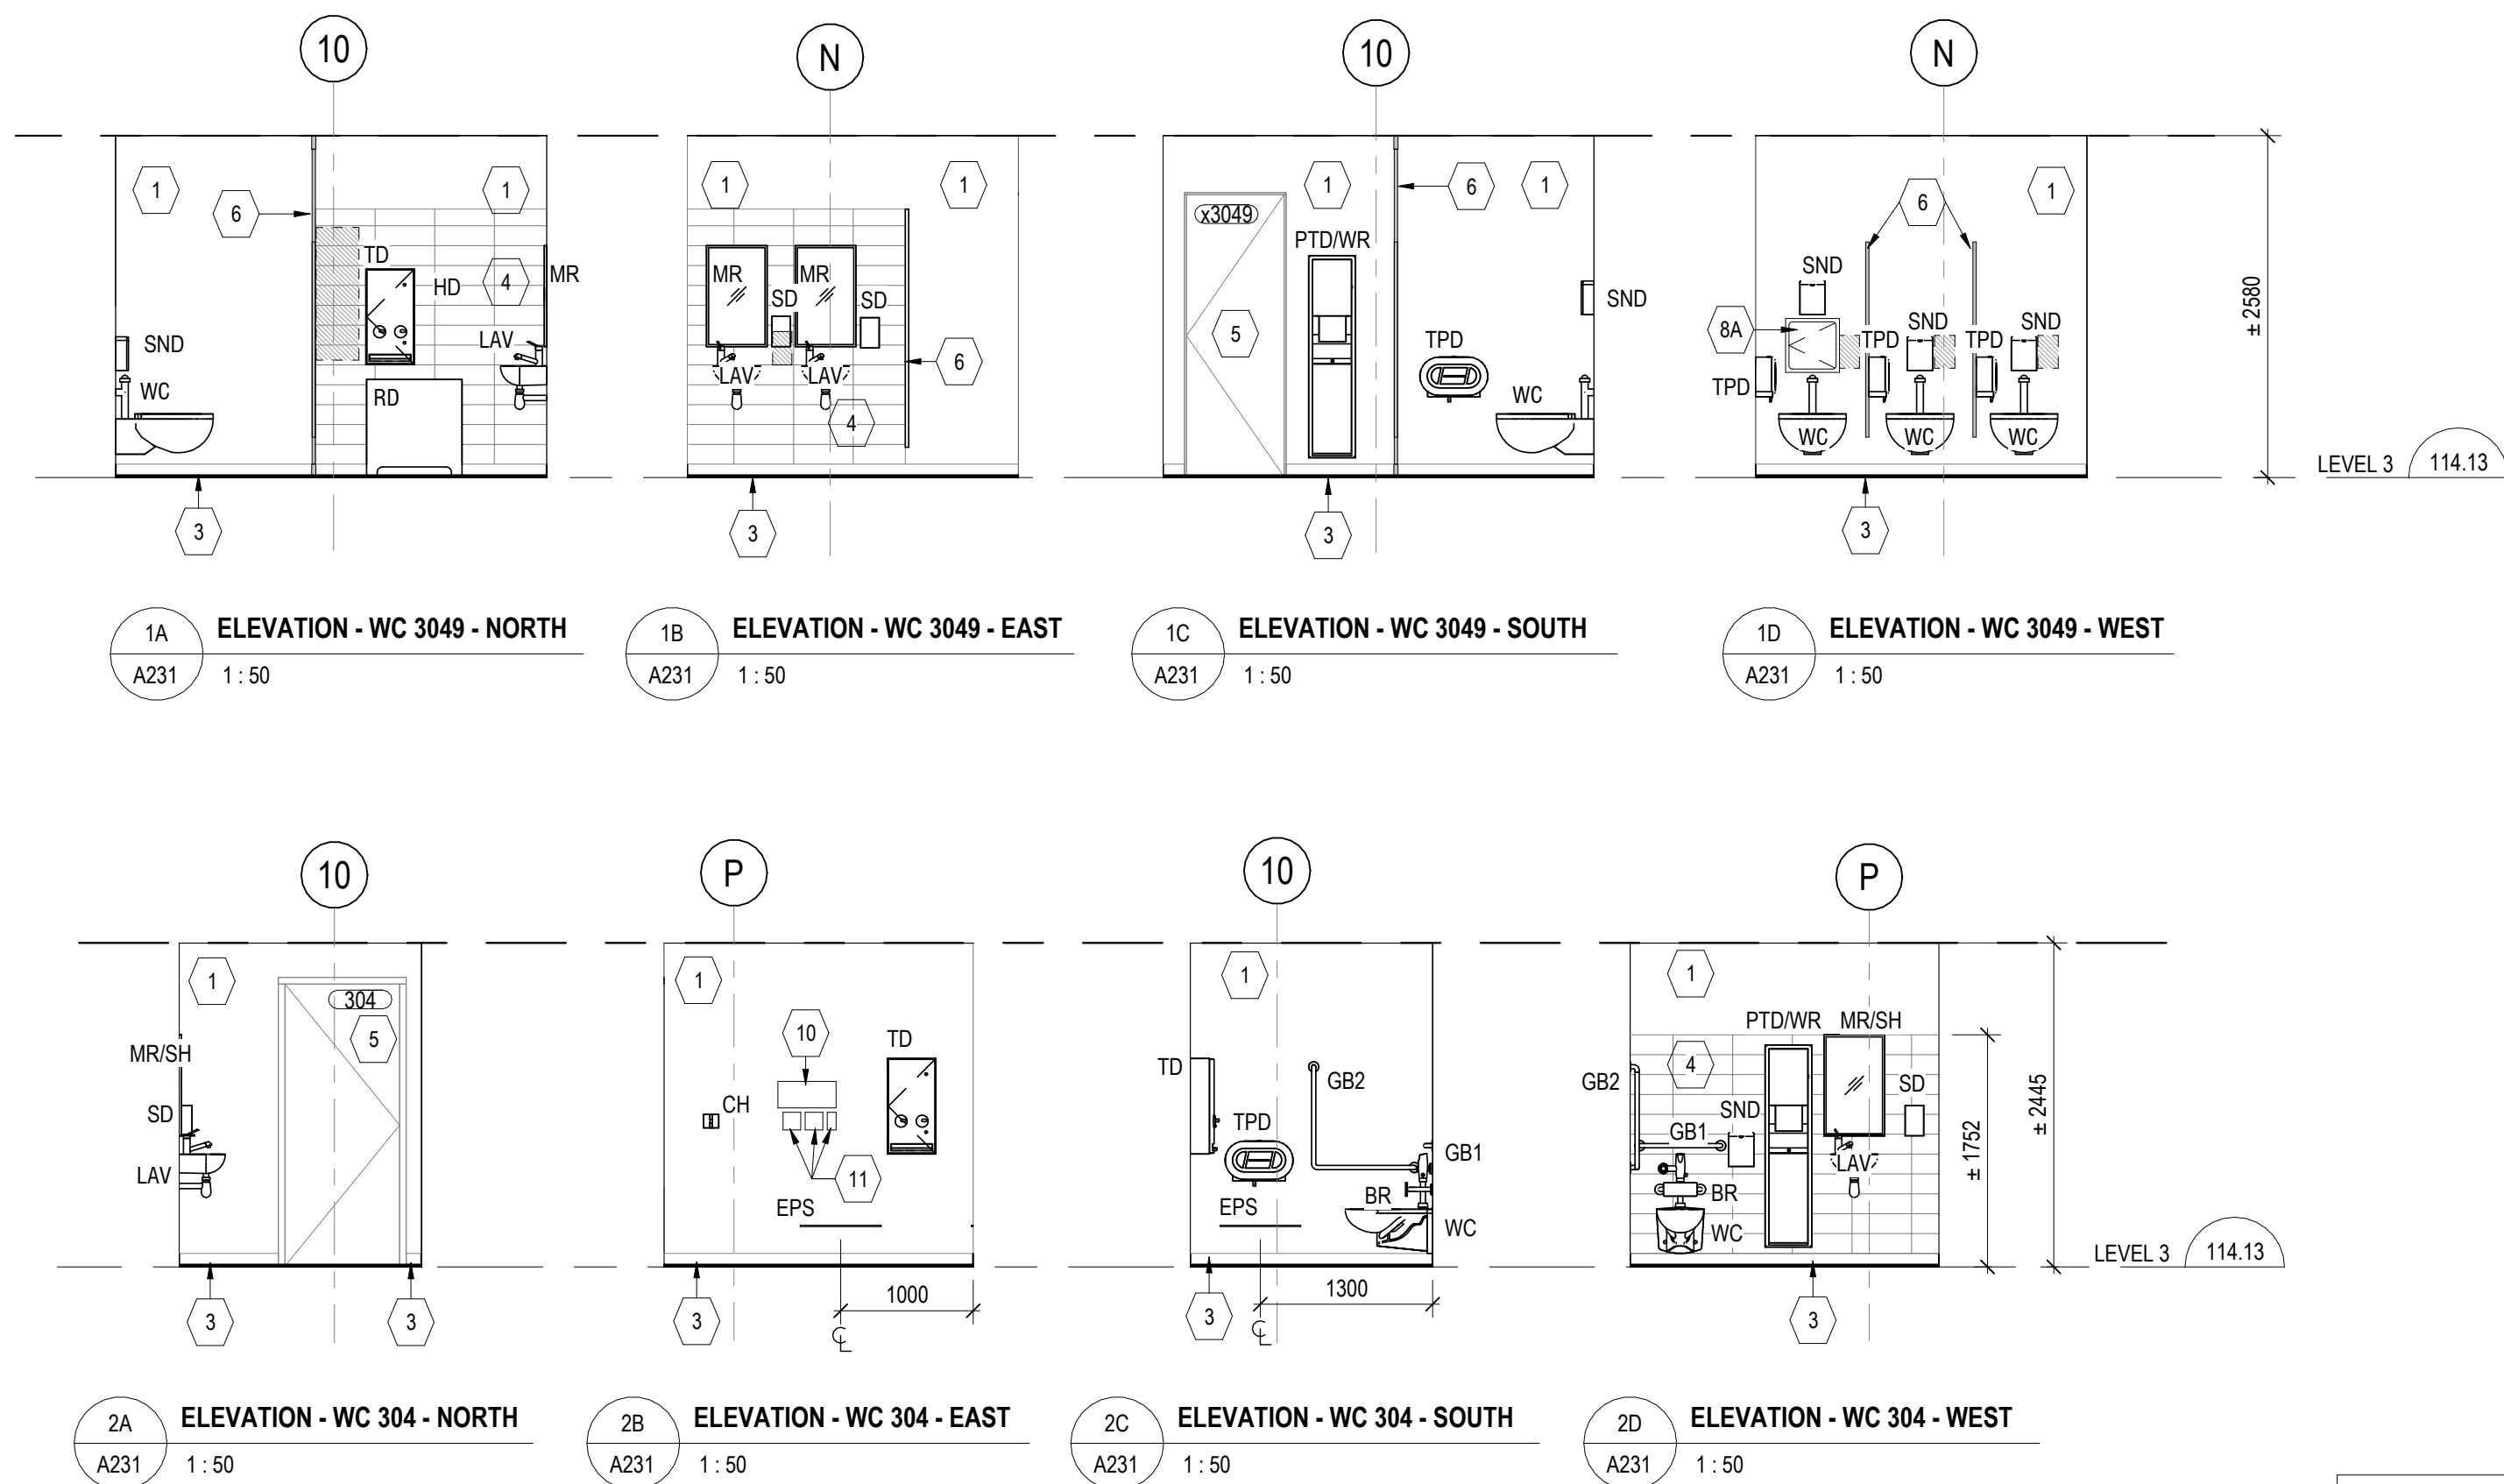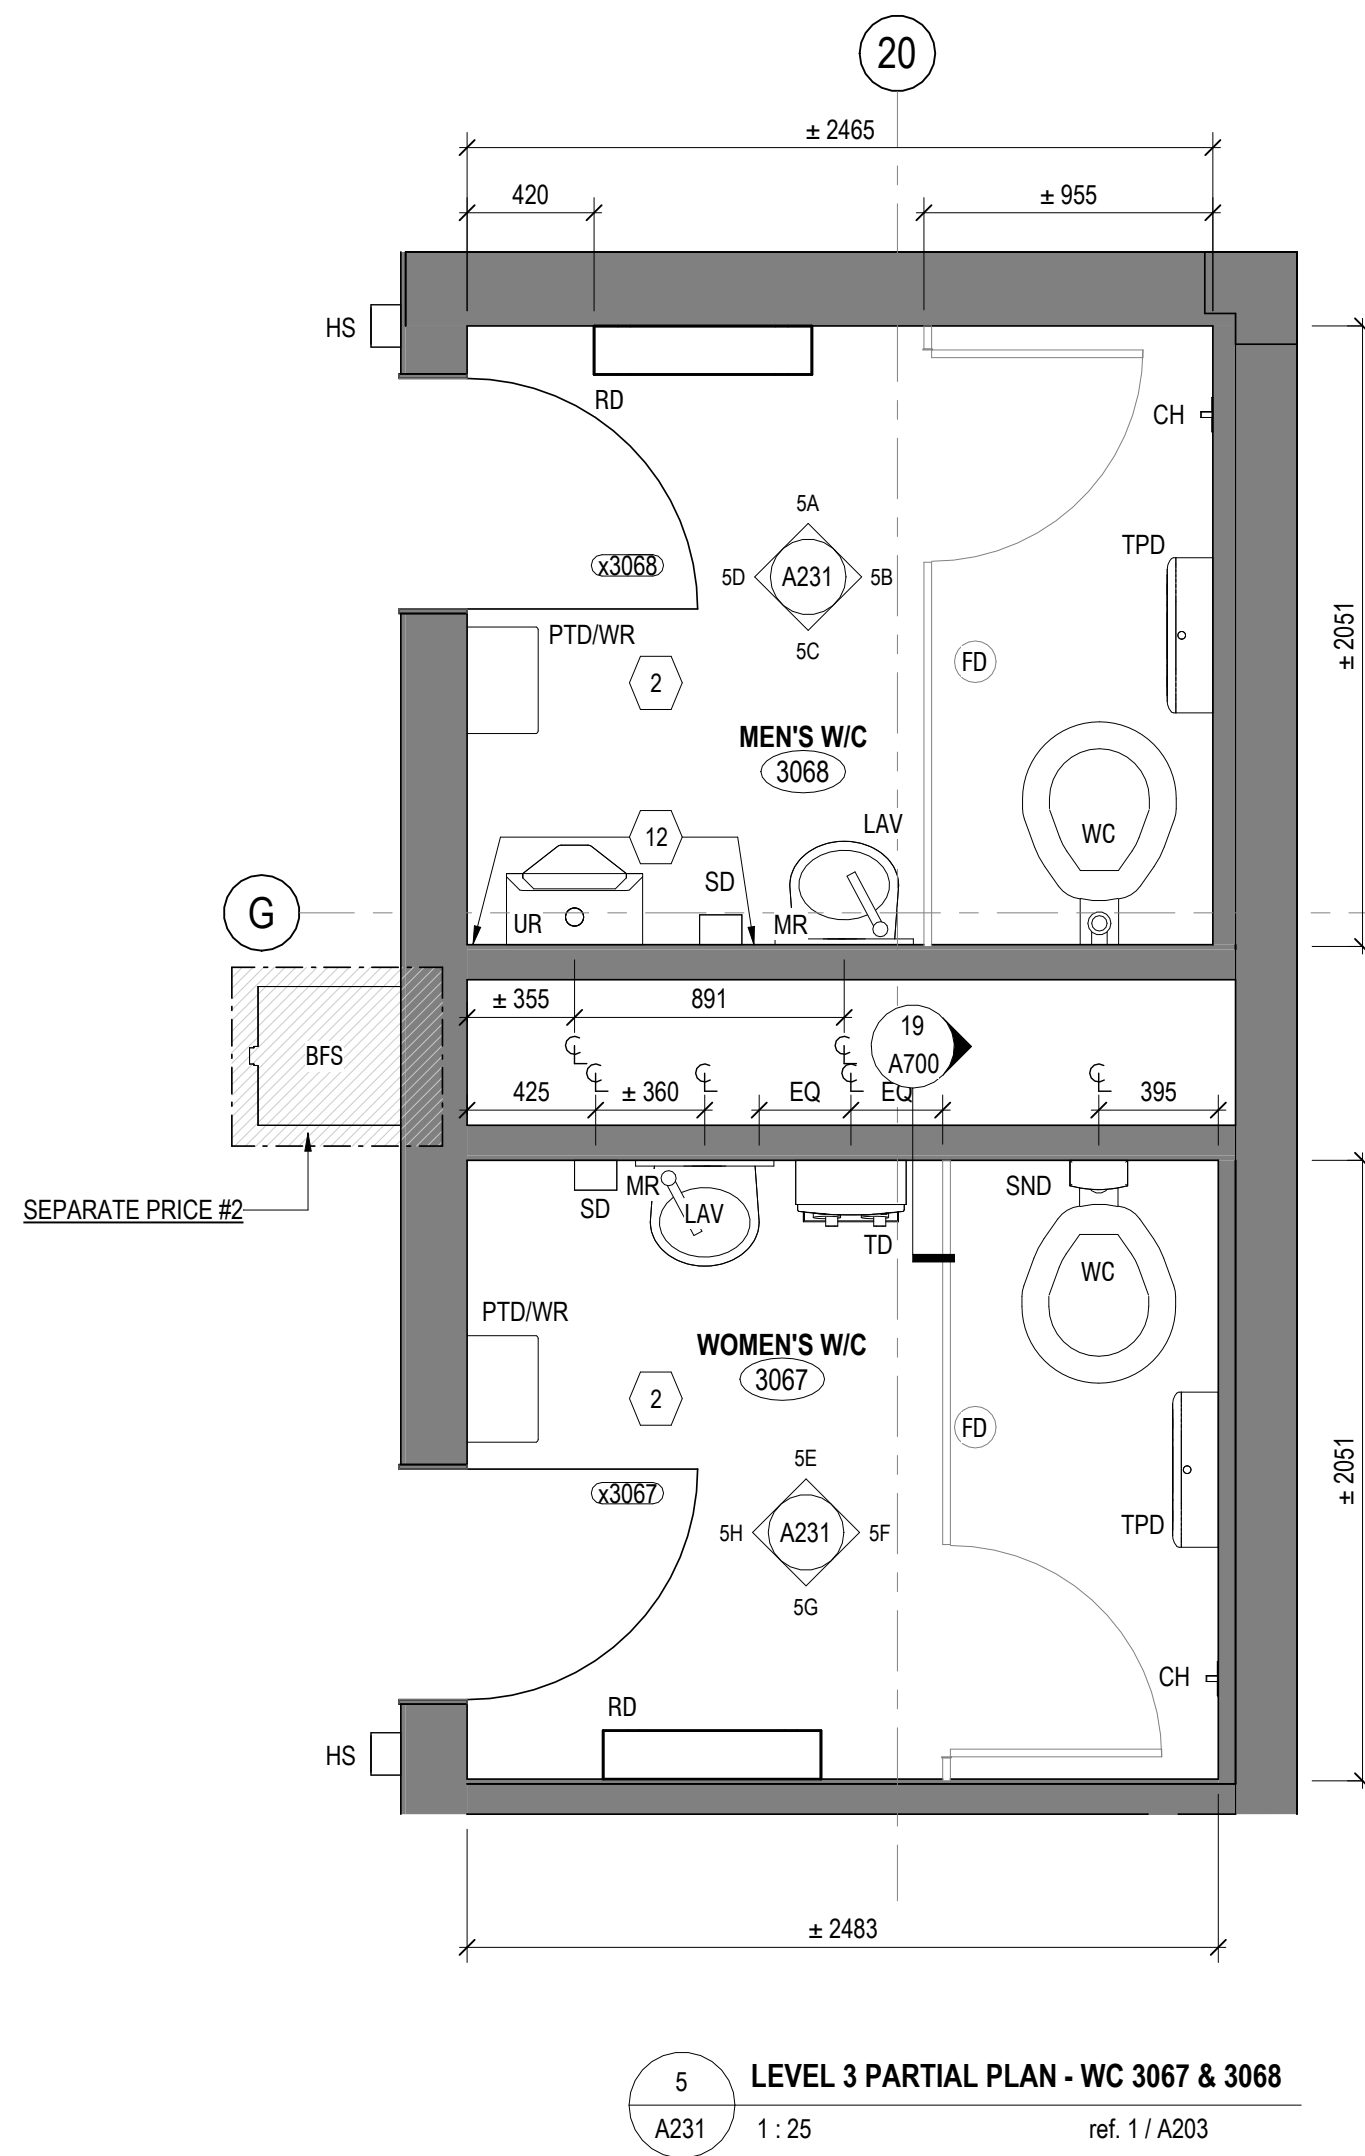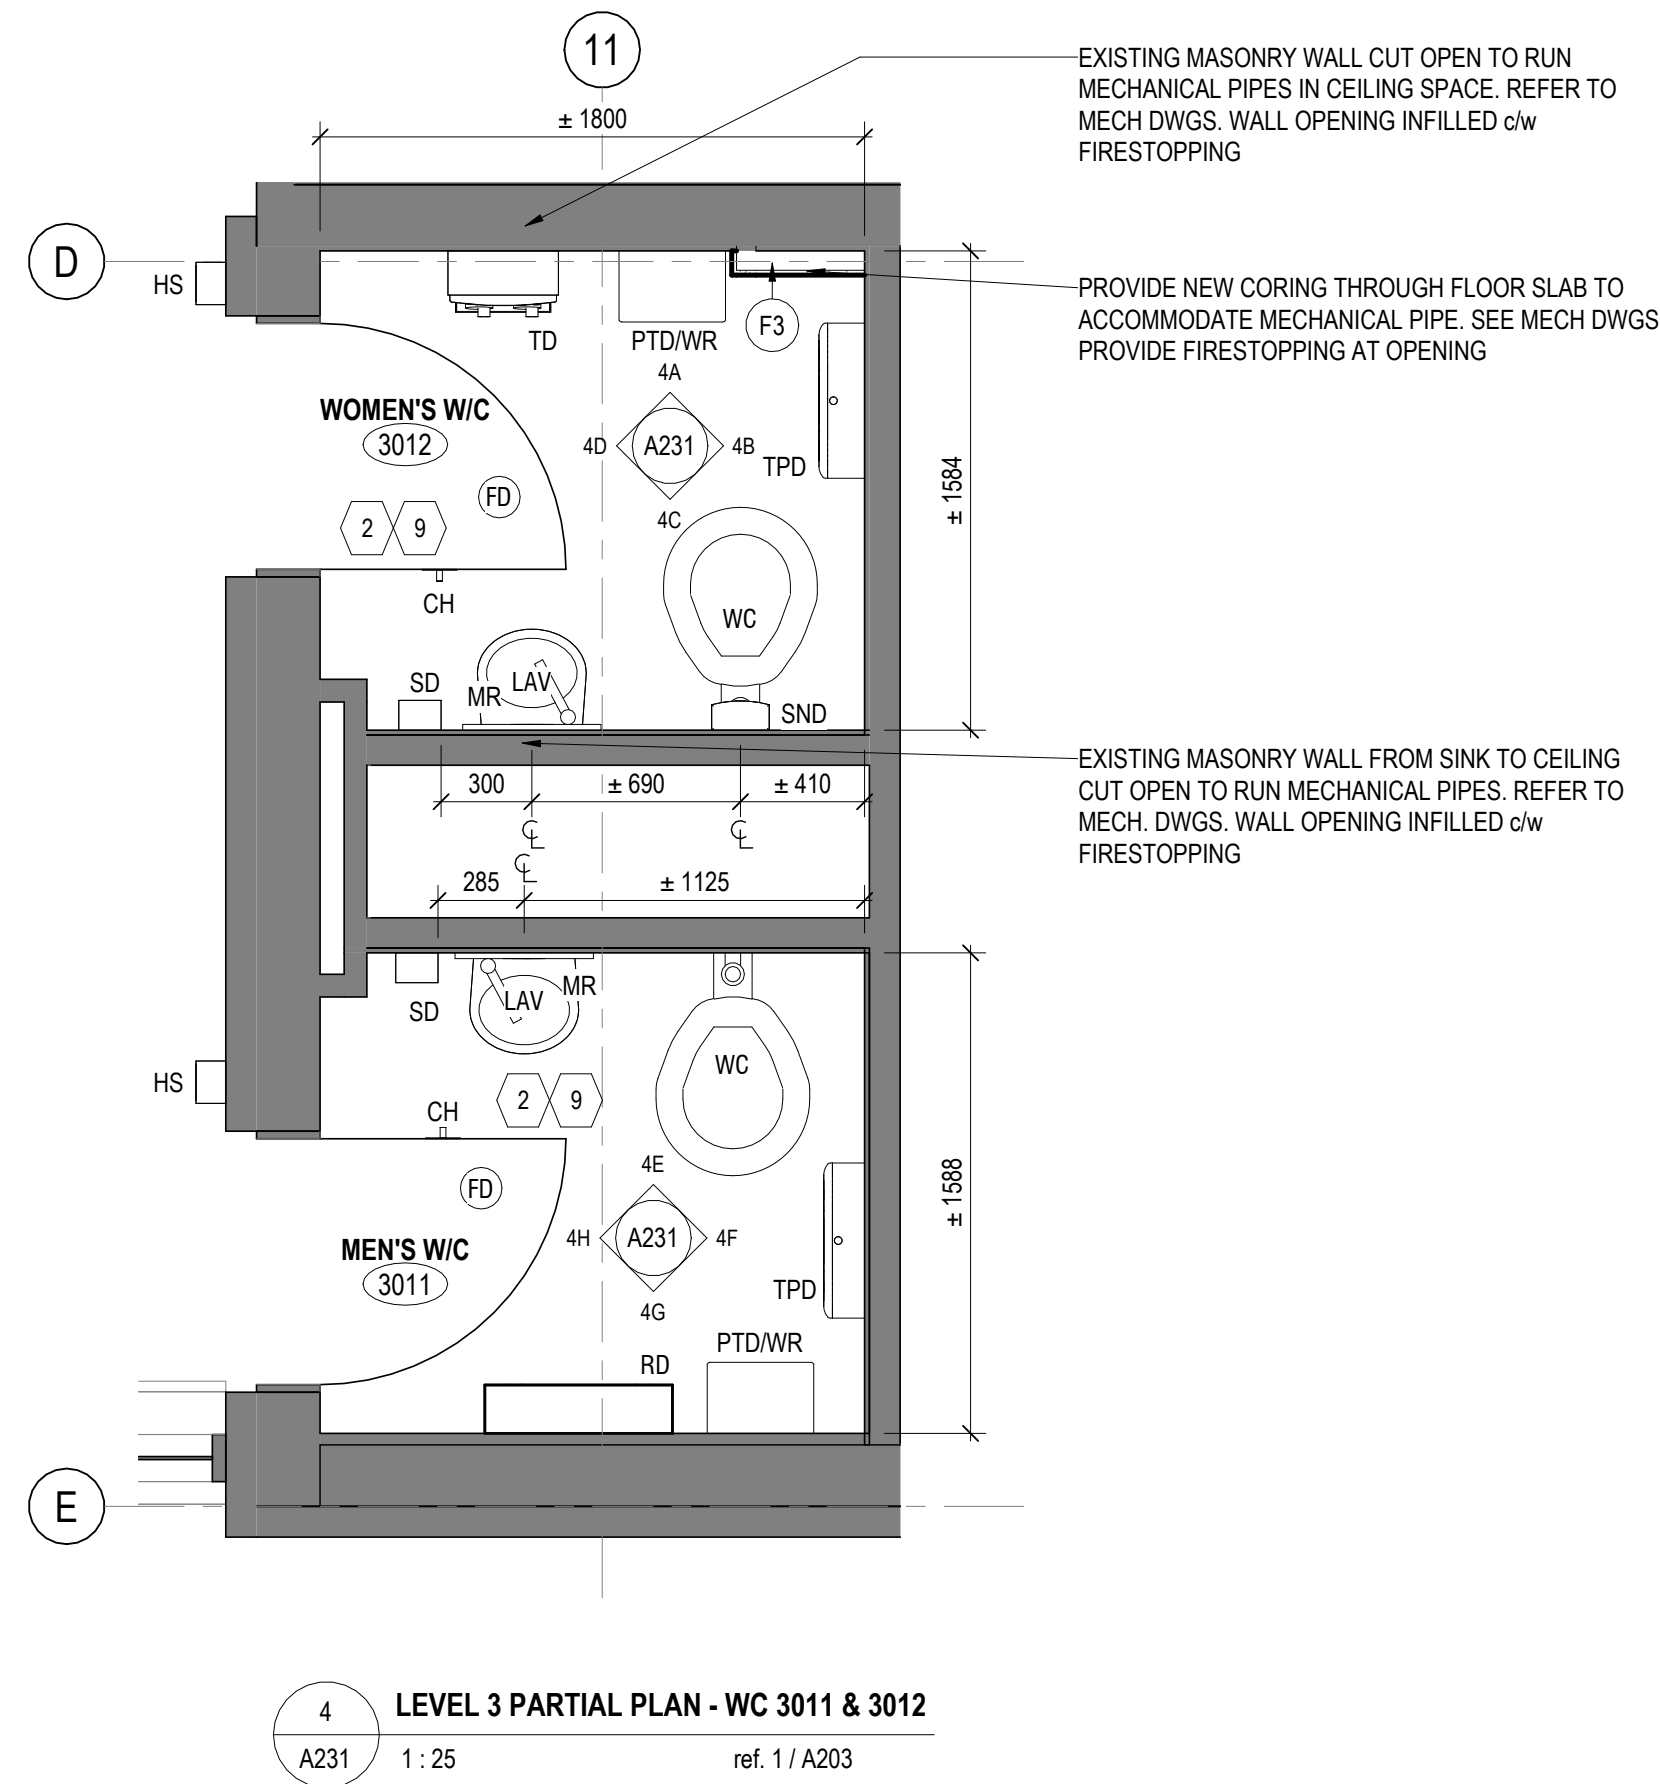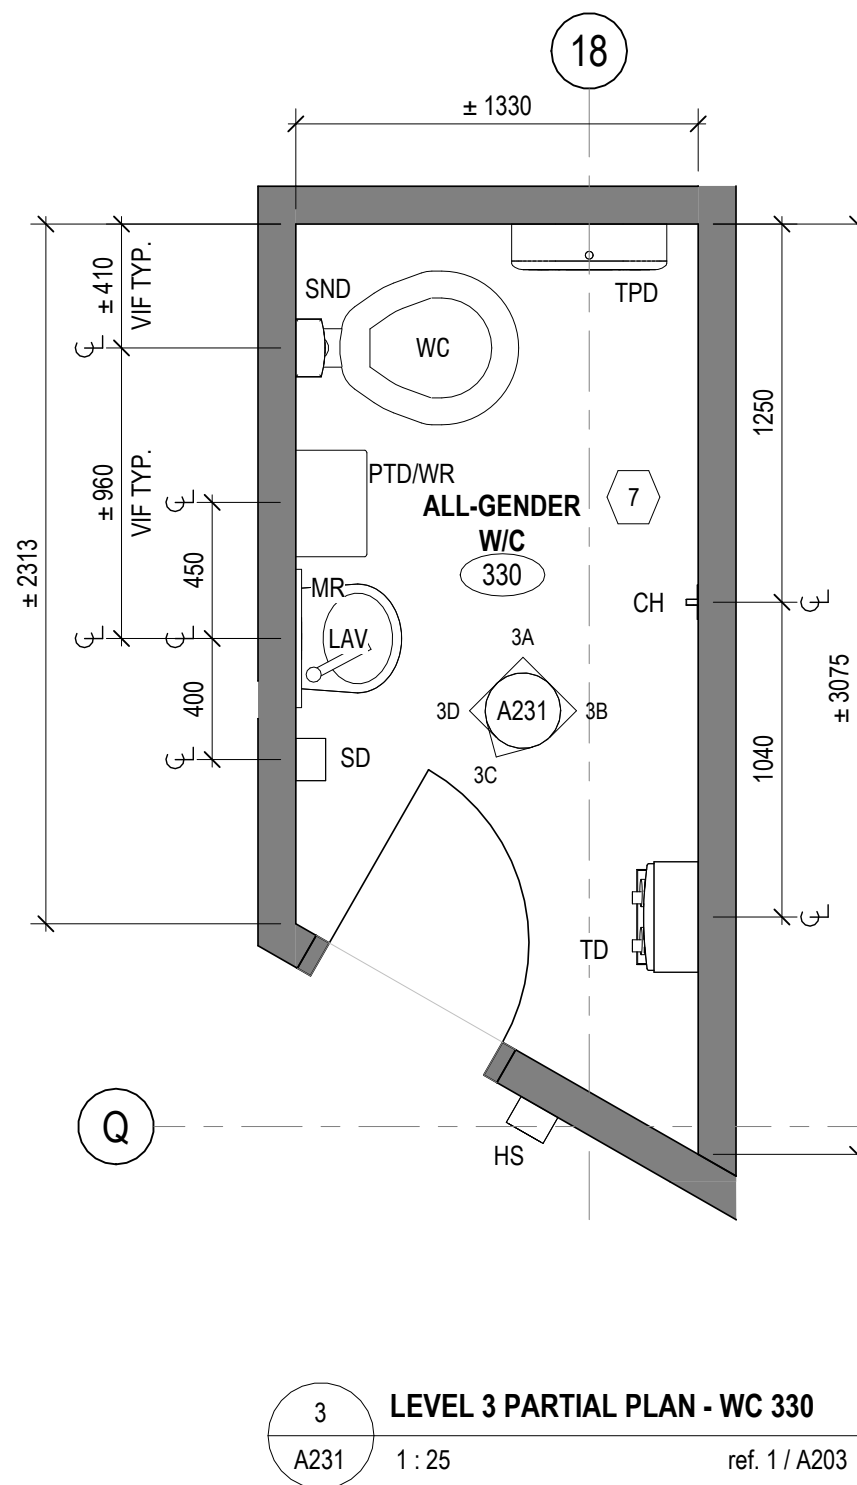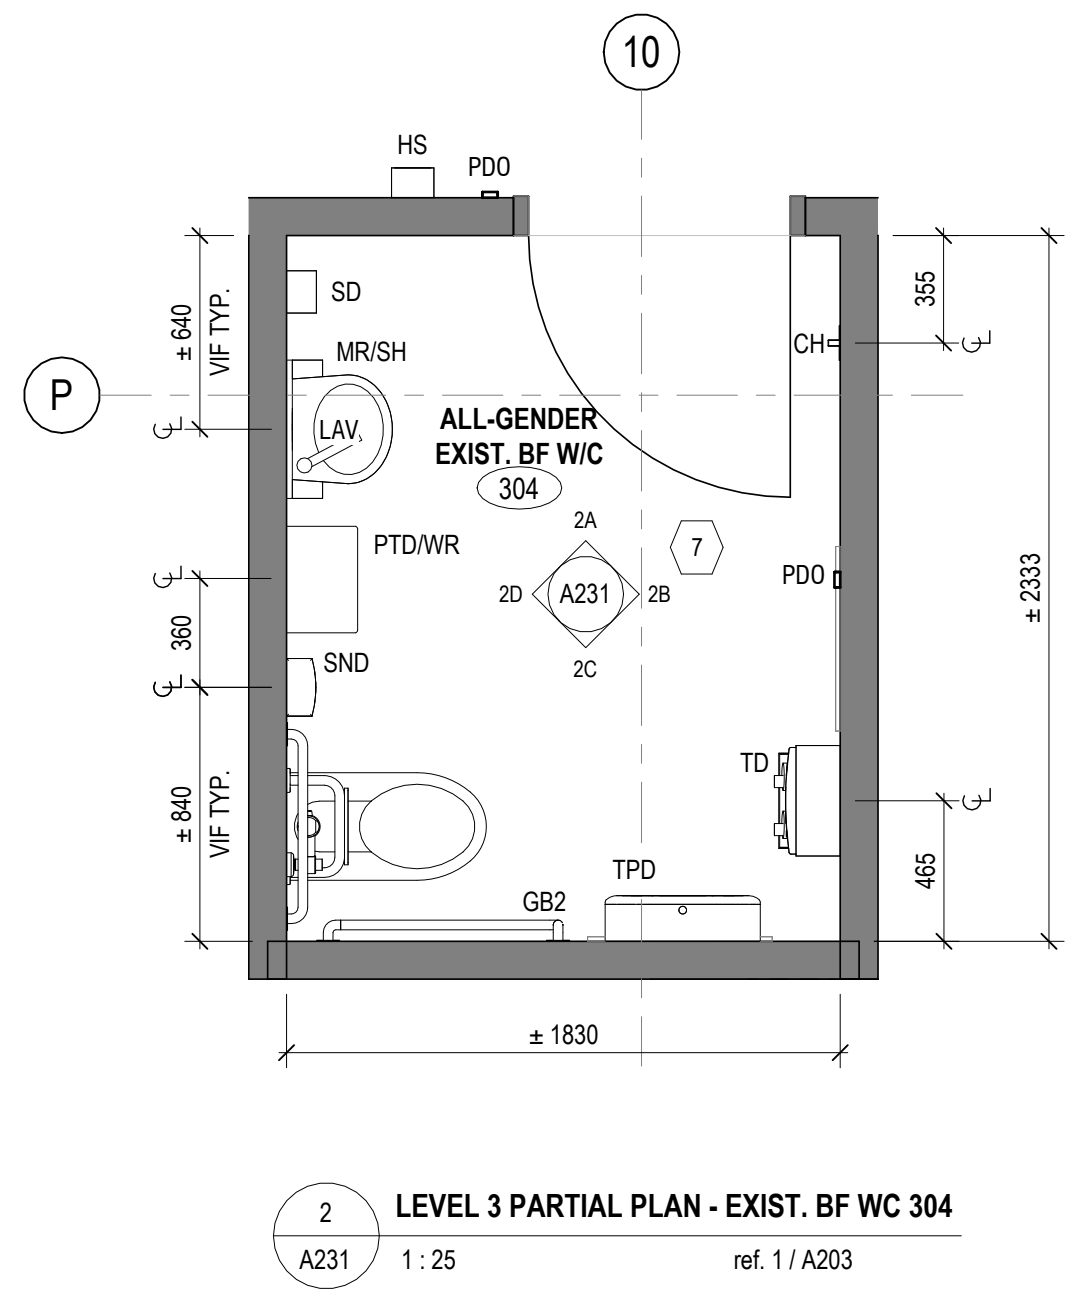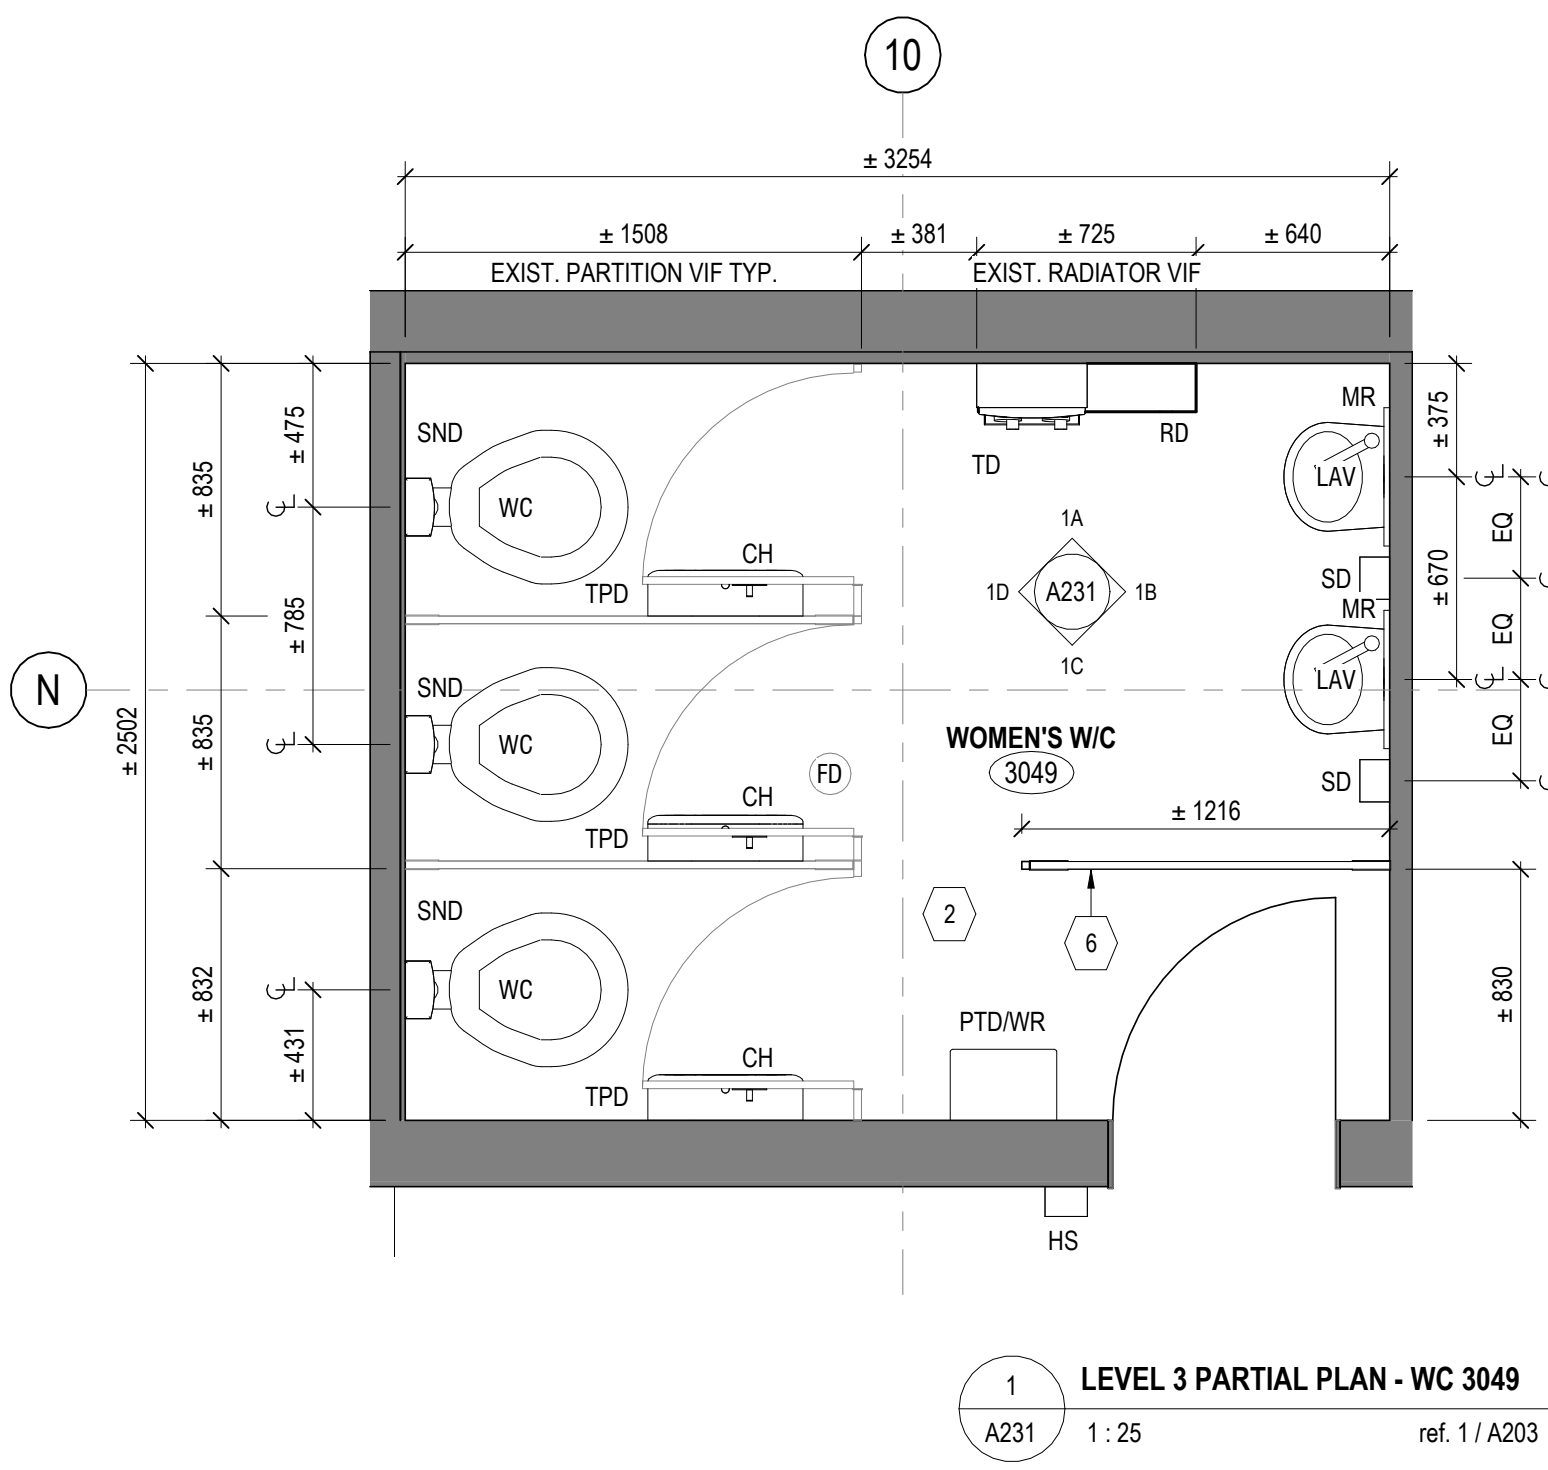

CONSTRUCTION NOTES	
No.	DESCRIPTION
1	PAINT EXISTING WALLS
2	PAINT EXISTING ACCESS HATCH. CUT AND FIT NEW WALL TILES AROUND THE EXISTING ACCESS HATCH. PROVIDE METAL EDGE TRIMS AT ALL EXPOSED TILE EDGES AT THE PERIMETER OF THE OPENING
3	PROVIDE NEW EPOXY COATING ON THE EXISTING EPOXY FLOORING
4	PROVIDE NEW EPOXY COATING ON THE EXISTING COVE BASE
5	PATCH WALL OPENING AND PROVIDE NEW FULL-HEIGHT WALL TILES. PROVIDE METAL EDGE TRIMS AT ALL EXPOSED TILE EDGES
6	REPAINT EXISTING DOOR AND DOOR FRAME
7	EXISTING WASHROOM PARTITIONS TO REMAIN - PROVIDE NEW TRIM PIECES AS REQUIRED
8A	PROVIDE NEW RESILIENT FLOORING. REFER TO FLOORING FINISH PLAN
9	PAINT EXISTING ACCESS HATCH
10	PROVIDE NEW CORING THROUGH FLOOR SLAB TO ACCOMMODATE INSTALLATION OF NEW DRAINAGE. REFER TO MECH DWGS
11	EMERGENCY SIGNAGE
12	SWITCHES. SEE ELEC. & DOOR HARDWARE SCHEDULE
13	INFILL GWB FINISH WHERE GWB WAS REMOVED/REMEDIATED - USE TILE BACKER BOARD BEHIND NEW TILE

GENERAL NOTES - NEW WORK: WASHROOM	
1.	MAKE GOOD ALL EXISTING WALL SURFACES DAMAGED DURING REMOVALS AND CONSTRUCTION
2.	PAINT EXISTING DOOR AND DOOR FRAMES
3.	PROVIDE FIRESTOPPING TO ALL FLOOR SERVICE PENETRATIONS. REFER TO MECH AND ELEC DWG FOR LOCATIONS OF PENETRATION
4.	SEE GENERAL NOTES ON DRAWING A001
5.	CONTRACTOR TO PATCH, REPAIR AND MAKE GOOD ALL AREAS DISTURBED BY THE OPERATION OF THE WORK AND DISTURBED BY THE WORK OF OTHER TRADES (MECH, ELEC & A.V. ETC.). MATERIALS AND FINISHES TO MATCH EXISTING UNLESS NOTED OTHERWISE
6.	WHERE DISSIMILAR COMPONENTS SUCH AS PUSH BUTTON AND KEY SWITCH ARE BUILT INTO FIRE RATED ASSEMBLIES, ENSURE CONTINUITY OF FIRE SEPARATION BY BOXING IN ELEMENTS WITH GYPSUM BOARD AND FRAMING TO SUIT AUTHORITIES' JURISDICTION
7.	FILL FLOOR OPENINGS WITH NON SHRINK GROUT. REFER TO MECH DWGS AND ELEC DWGS
8.	ACOUSTIC PRODUCTS AND FINISHES: PRIOR TO CONSTRUCTION, PROVIDE SHOP DRAWINGS AND SUBMITTALS FOR ALL GWB ACOUSTIC ELEMENTS SHOWN OR LISTED ON ARCHITECTURAL DRAWINGS AND SPECIFICATIONS FOR REVIEW
9.	COAT HOOK: PROVIDE ONE COAT HOOK IN THE MIDDLE OF DOOR INSIDE STALL AT EACH STALL, UNLESS OTHERWISE NOTED
10.	RE-INSTALL RE-PAINTED PARTITIONS
11.	RE-INSTALL WALL MOUNTED PTDWR
12.	REFER TO DESIGNATED SUBSTANCES IN BUILDING MATERIALS SURVEY REPORT (GS55)

LEGEND - WASHROOM	
BR	NEW BACK REST
BFS	NEW WATER FILLING STATION
CH	NEW COAT HOOK
FD	NEW/EXIST. FLOOR DRAIN. SEE MECH DWGS.
GB	NEW GRAB BAR
HD	NEW HAND DRYER
HS	NEW HAND SANITIZER
LAV	NEW LAVATORY. SEE MECH DWGS.
MR	NEW MIRROR
MRSH	NEW MIRROR c/w SHELF
PDO	NEW/EXIST. POWER DOOR OPERATOR. SEE MECH DWGS.
PTDWR	EXIST. PAPER TOWEL DISPENSER & WASTE RECEPTACLE
RD	EXIST. RADIATOR TO REMAIN. SEE MECH DWGS.
SD	NEW SOAP DISPENSER
SH	NEW SHELF
SN	NEW SANITARY NAPKIN DISPOSAL
TD	NEW TOWEL DISPENSER
TPD	NEW TOWEL PAPER DISPENSER
UR	NEW URINAL. SEE MECH DWGS.
WC	NEW WATER CLOSET. SEE MECH DWGS.
WT	NEW WALL TILE
	INFILL OPENING - SEE DETAIL 19A700

No.	DESCRIPTION	DATE
1	ISSUED FOR TENDER	2026-04-22
2	ISSUED FOR 80% CD	2026-03-09
3	ISSUED FOR PERMIT	2026-03-04
4	ISSUED FOR CLASS A COSTING	2026-02-18
5	ISSUED FOR 100% DD	2026-01-23
6	ISSUED FOR CLASS B COSTING	2026-01-16
7	ISSUED FOR 90% DD	2025-11-08
REV.	DESCRIPTION	DATE

KEY PLAN (NTS)	SEAL
----------------	------

PROJECT TITLE  
UNIVERSITY OF TORONTO  
**33 URSULA FRANKLIN  
MATH OFFICE  
RENOVATION**

33 URSULA FRANKLIN ST.  
DRAWING SHEET TITLE  
**LEVEL 3 WASHROOM  
PLANS & ELEVATIONS**

















DRAWN BY: AS	SCALE: As indicated
REVIEWED BY: SC	DATE CREATED: 2026/02/11
UNIVERSITY PROJECT NUMBER: NORTH POINT	

P164-24-165

DRAWING NUMBER <b>A231</b>	REV. NUMBER <b>7</b>
-------------------------------	-------------------------



C:\Users\songanit\Documents\IP164-25-165\_A\_26\_anita.song.rvt 2026-04-22 11:52:40 AM

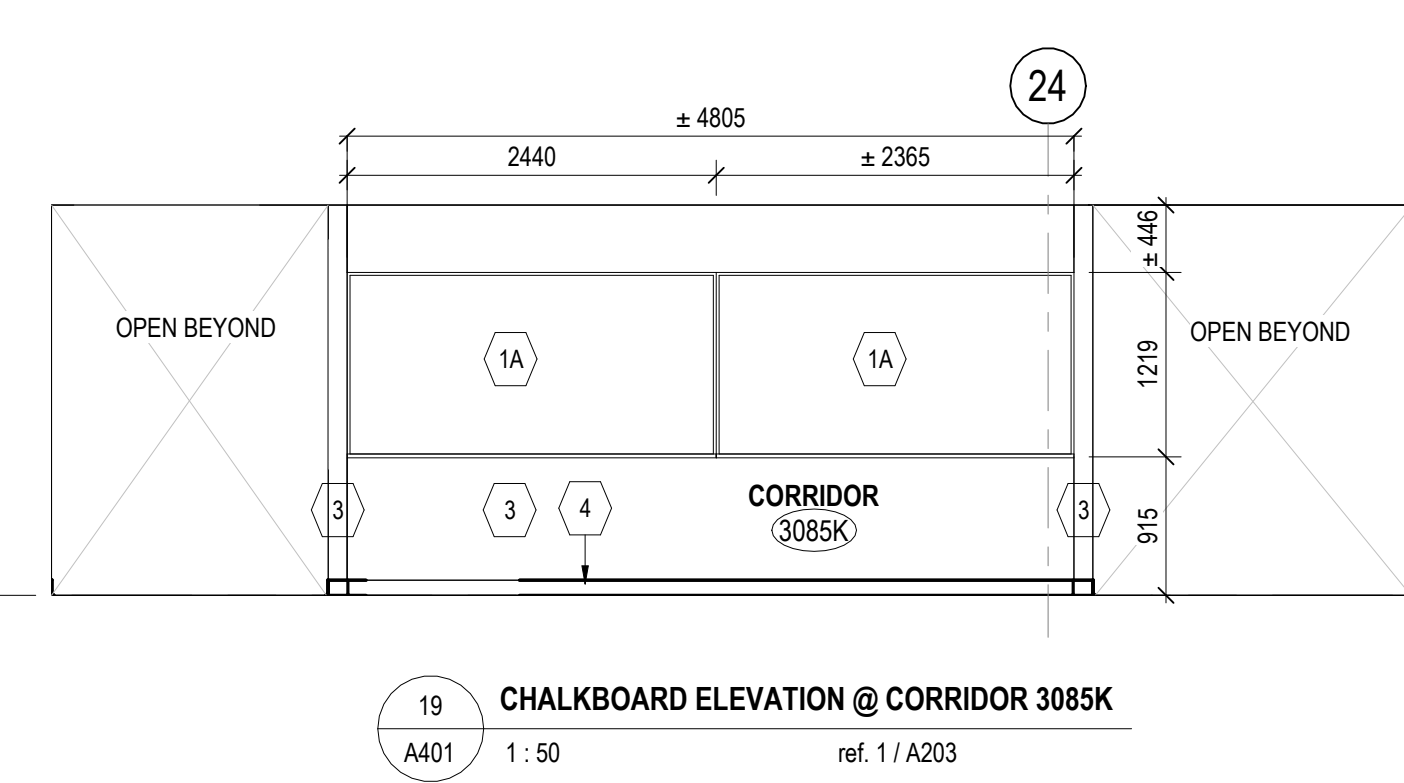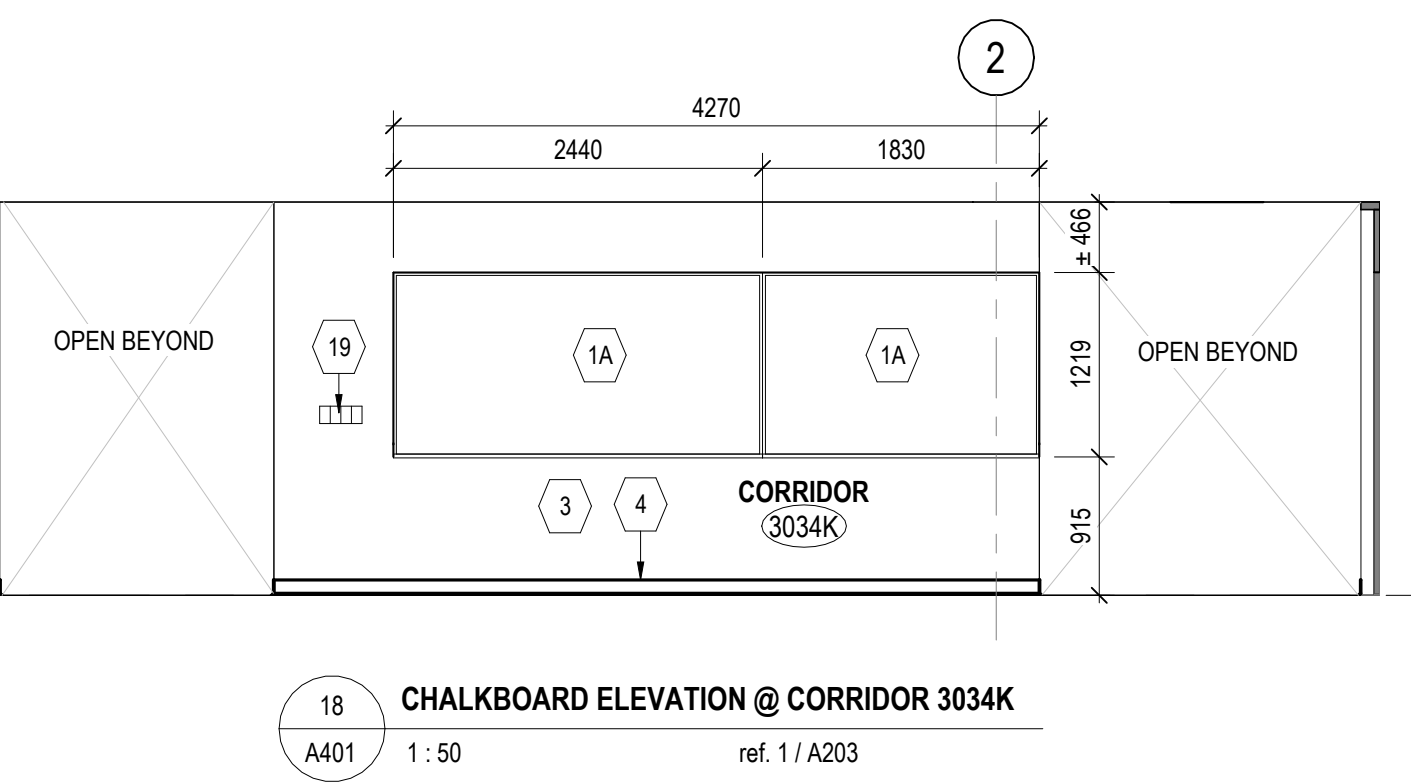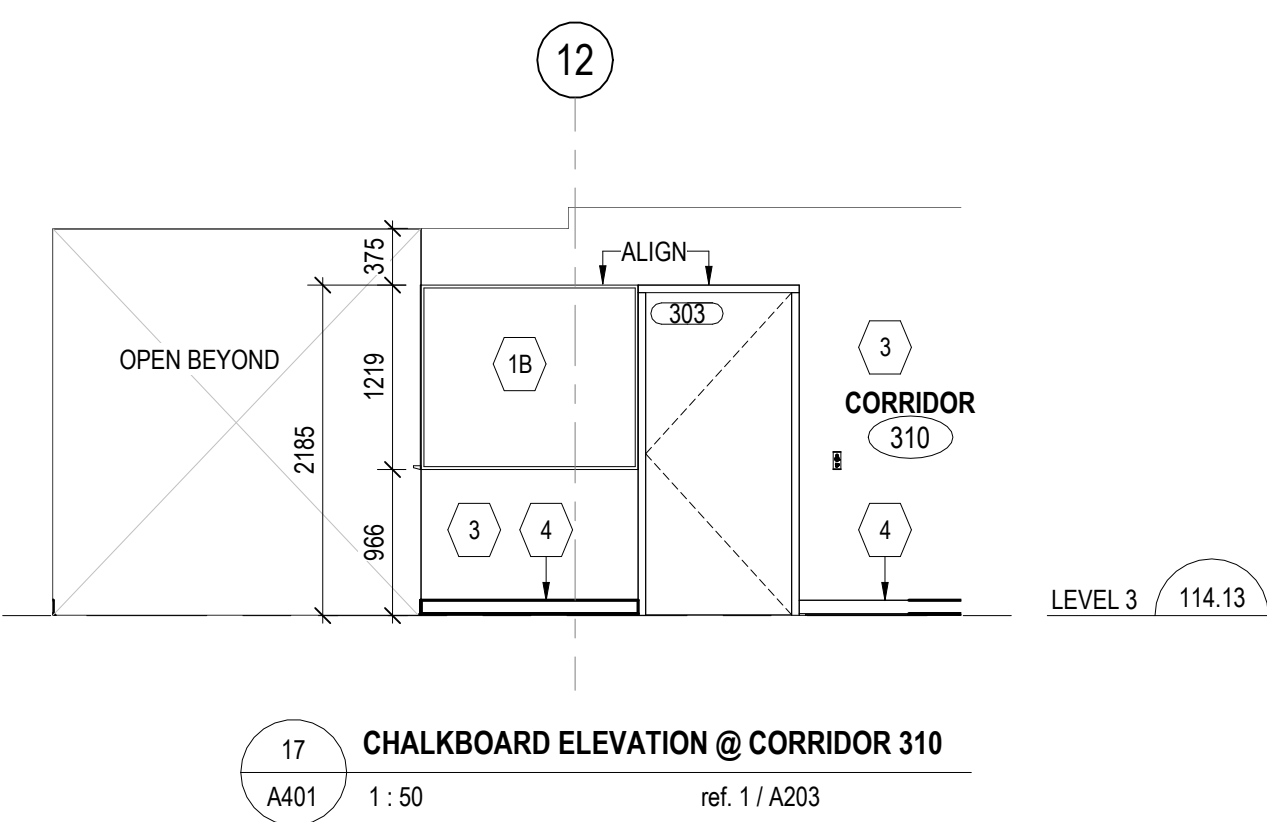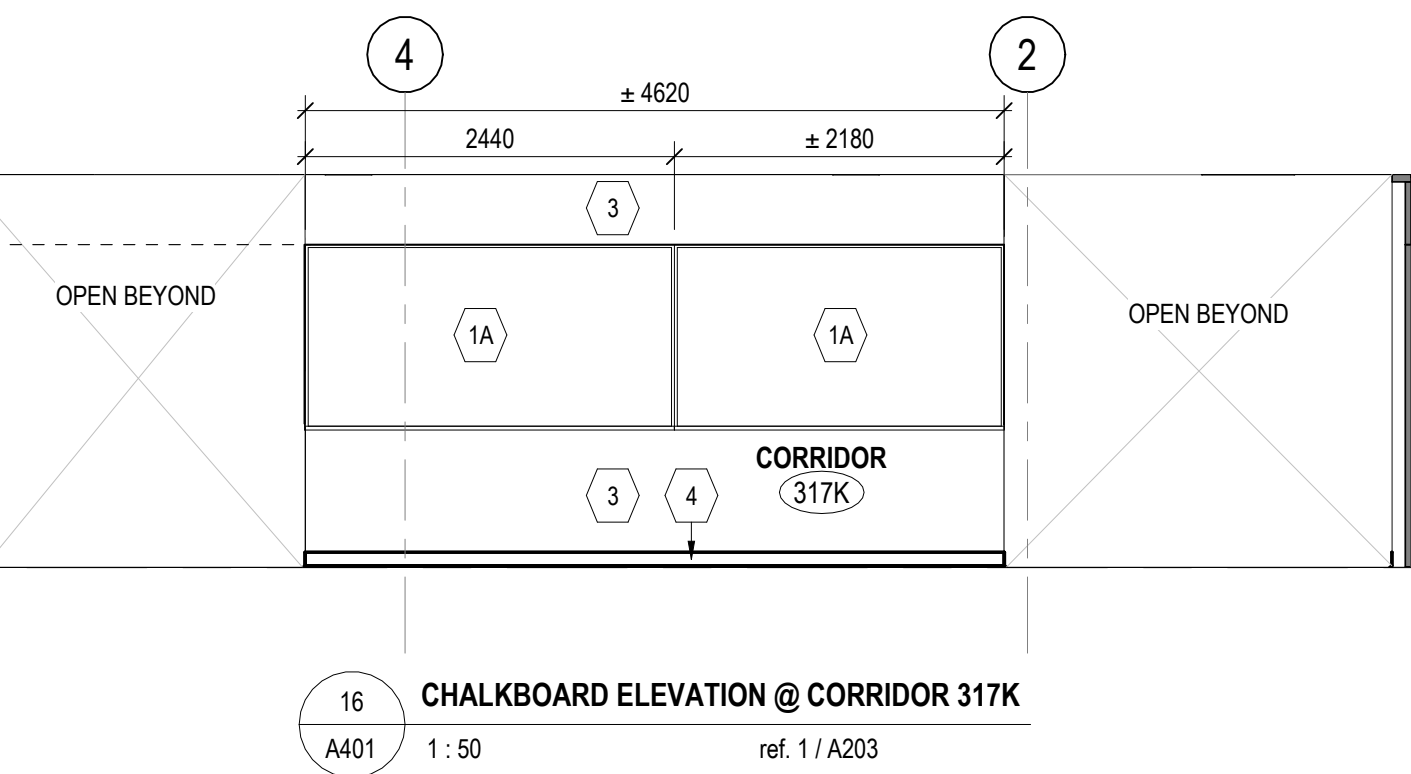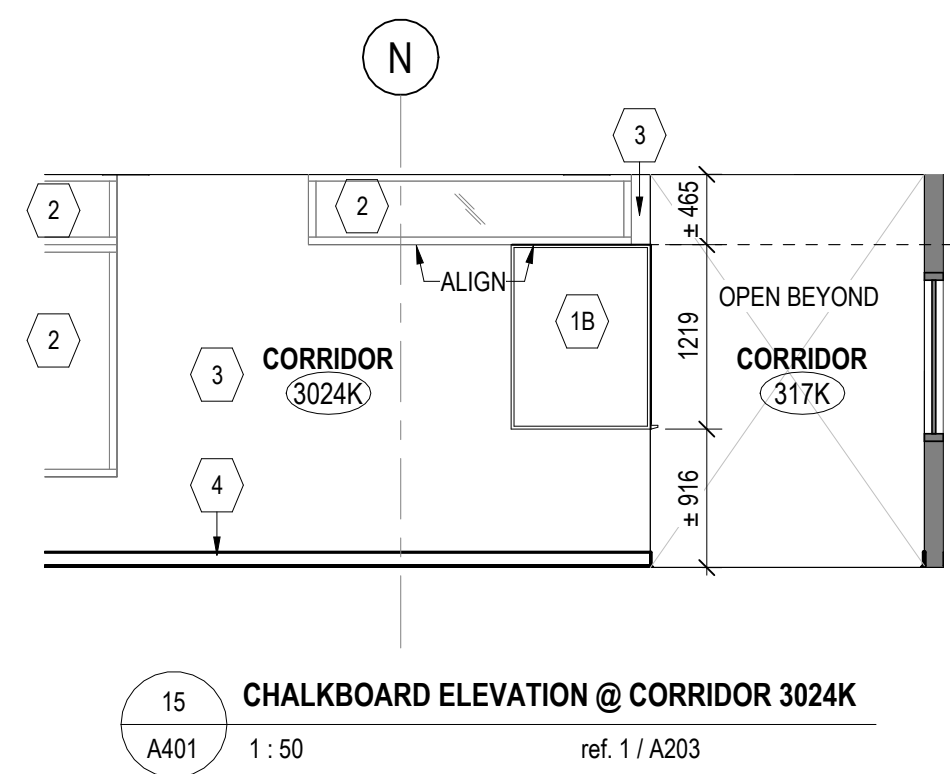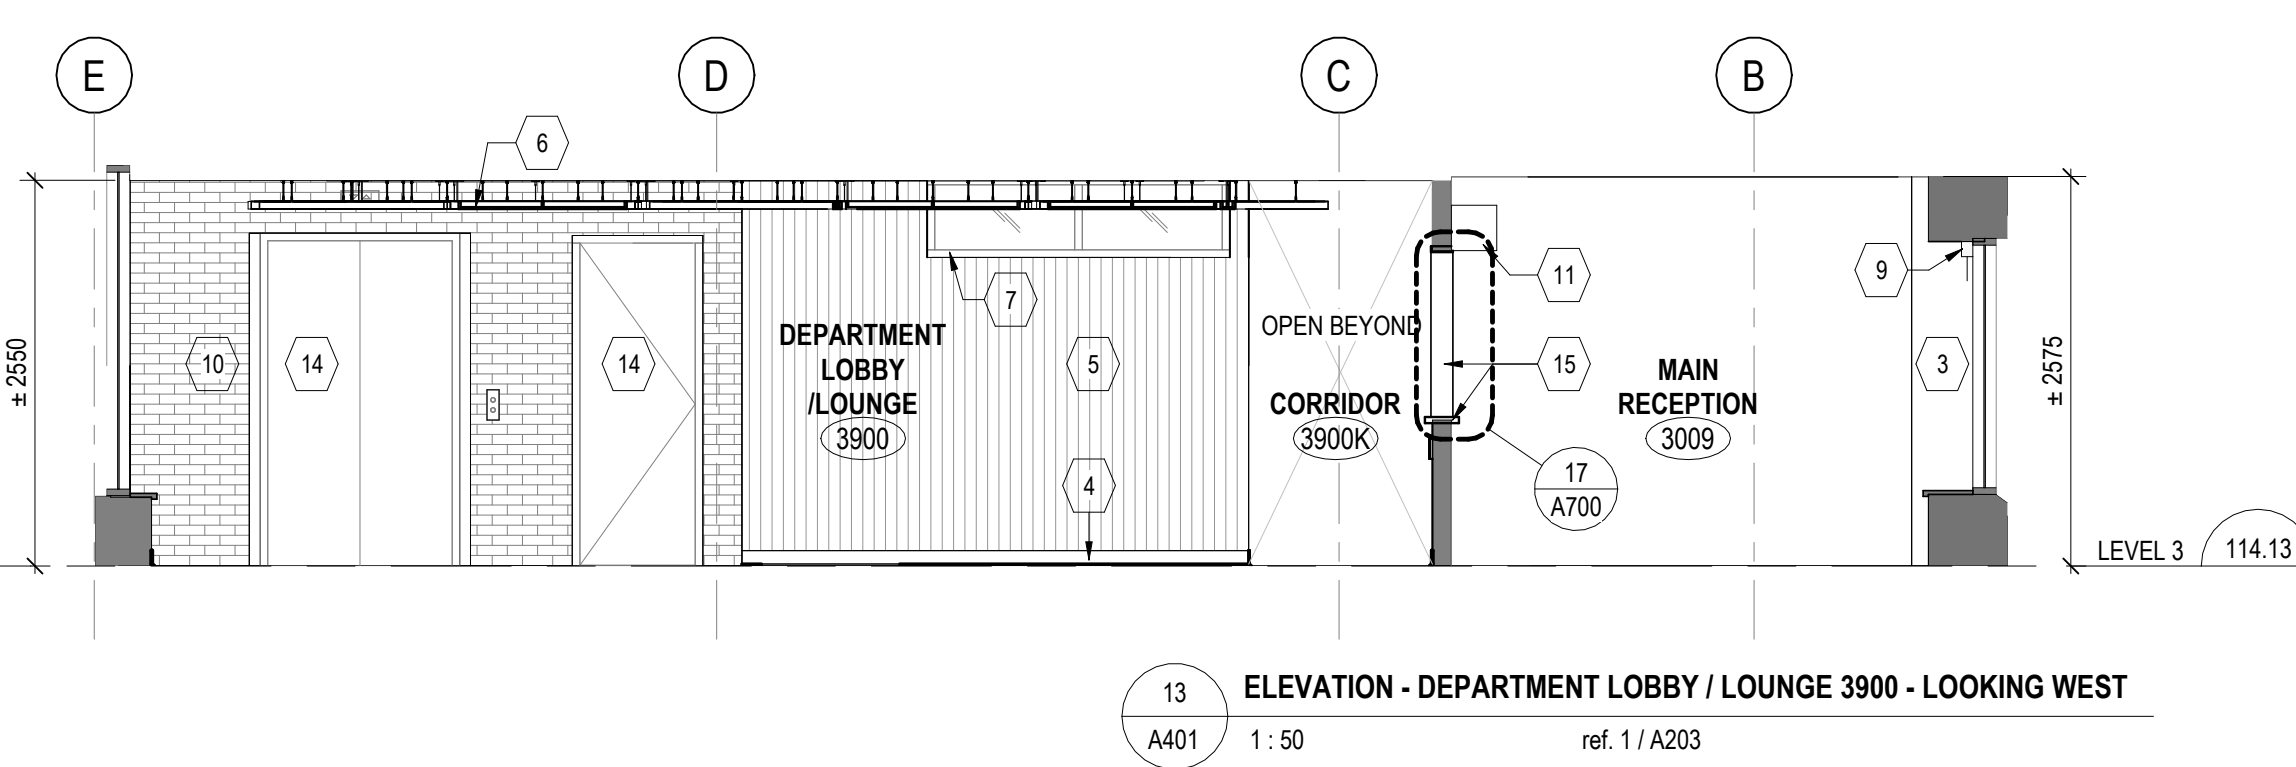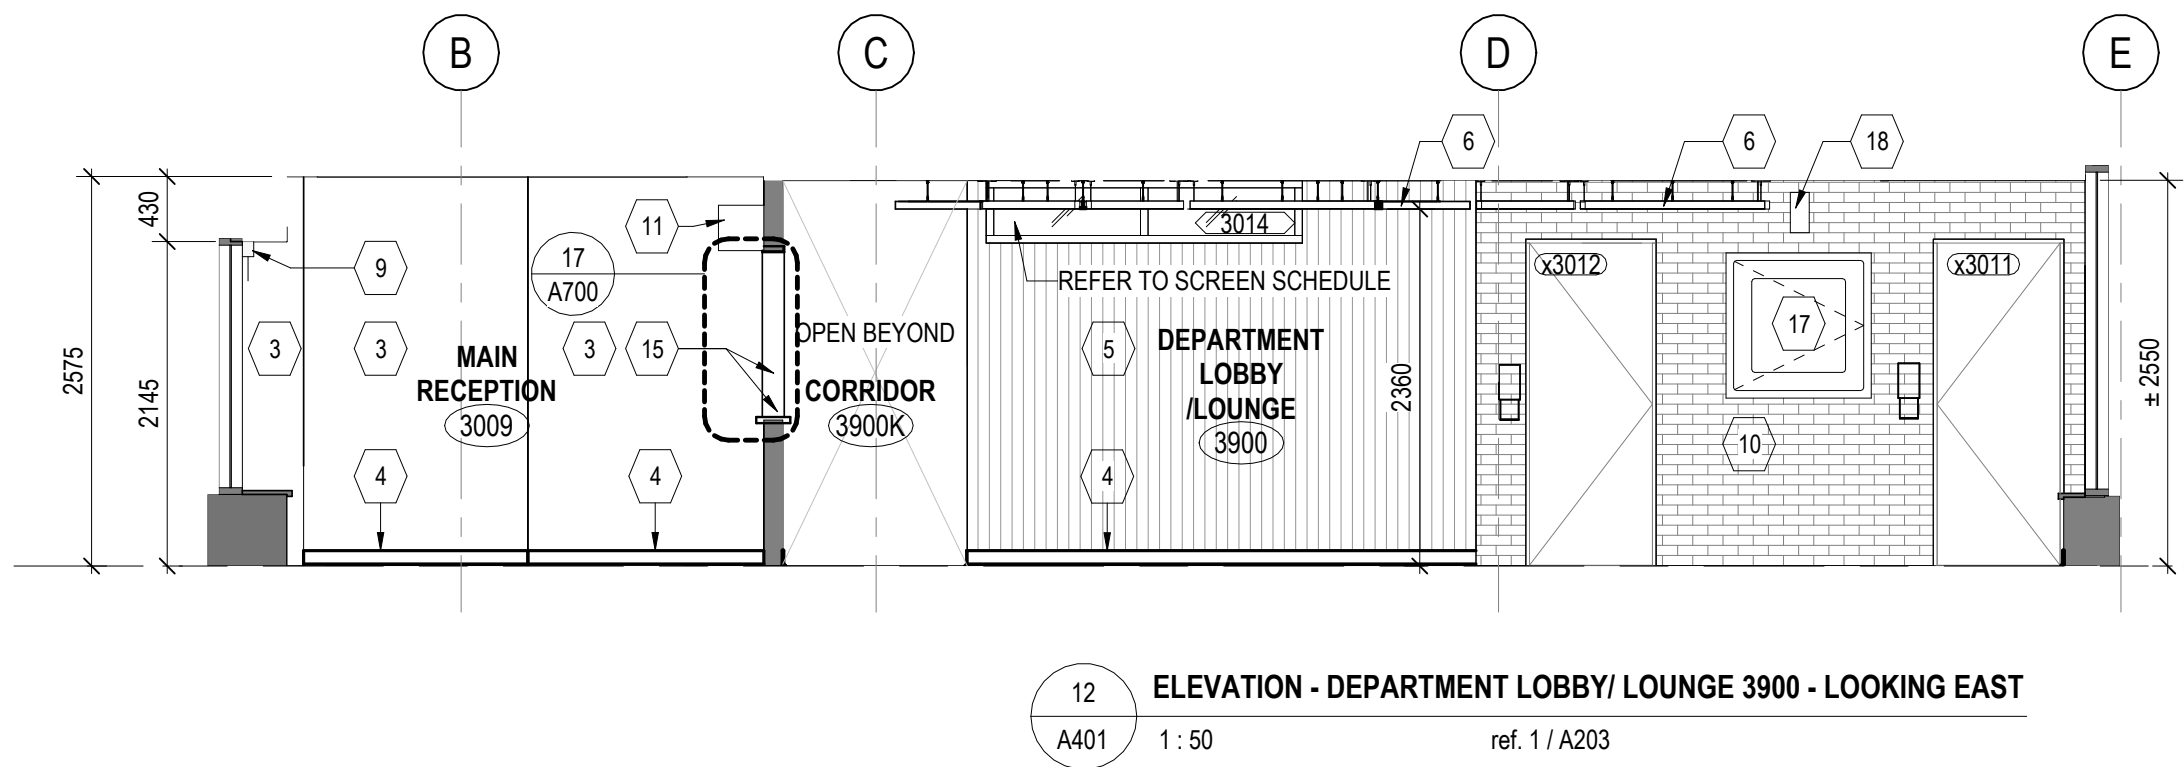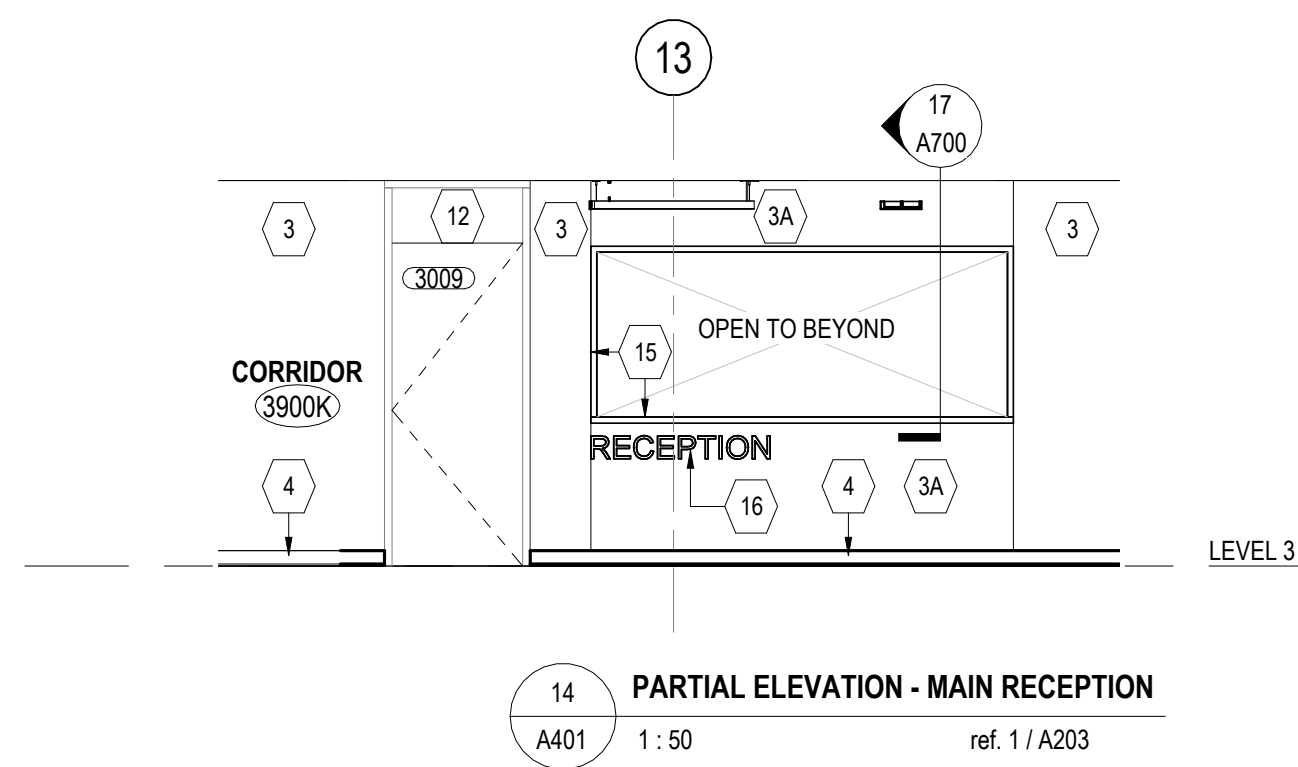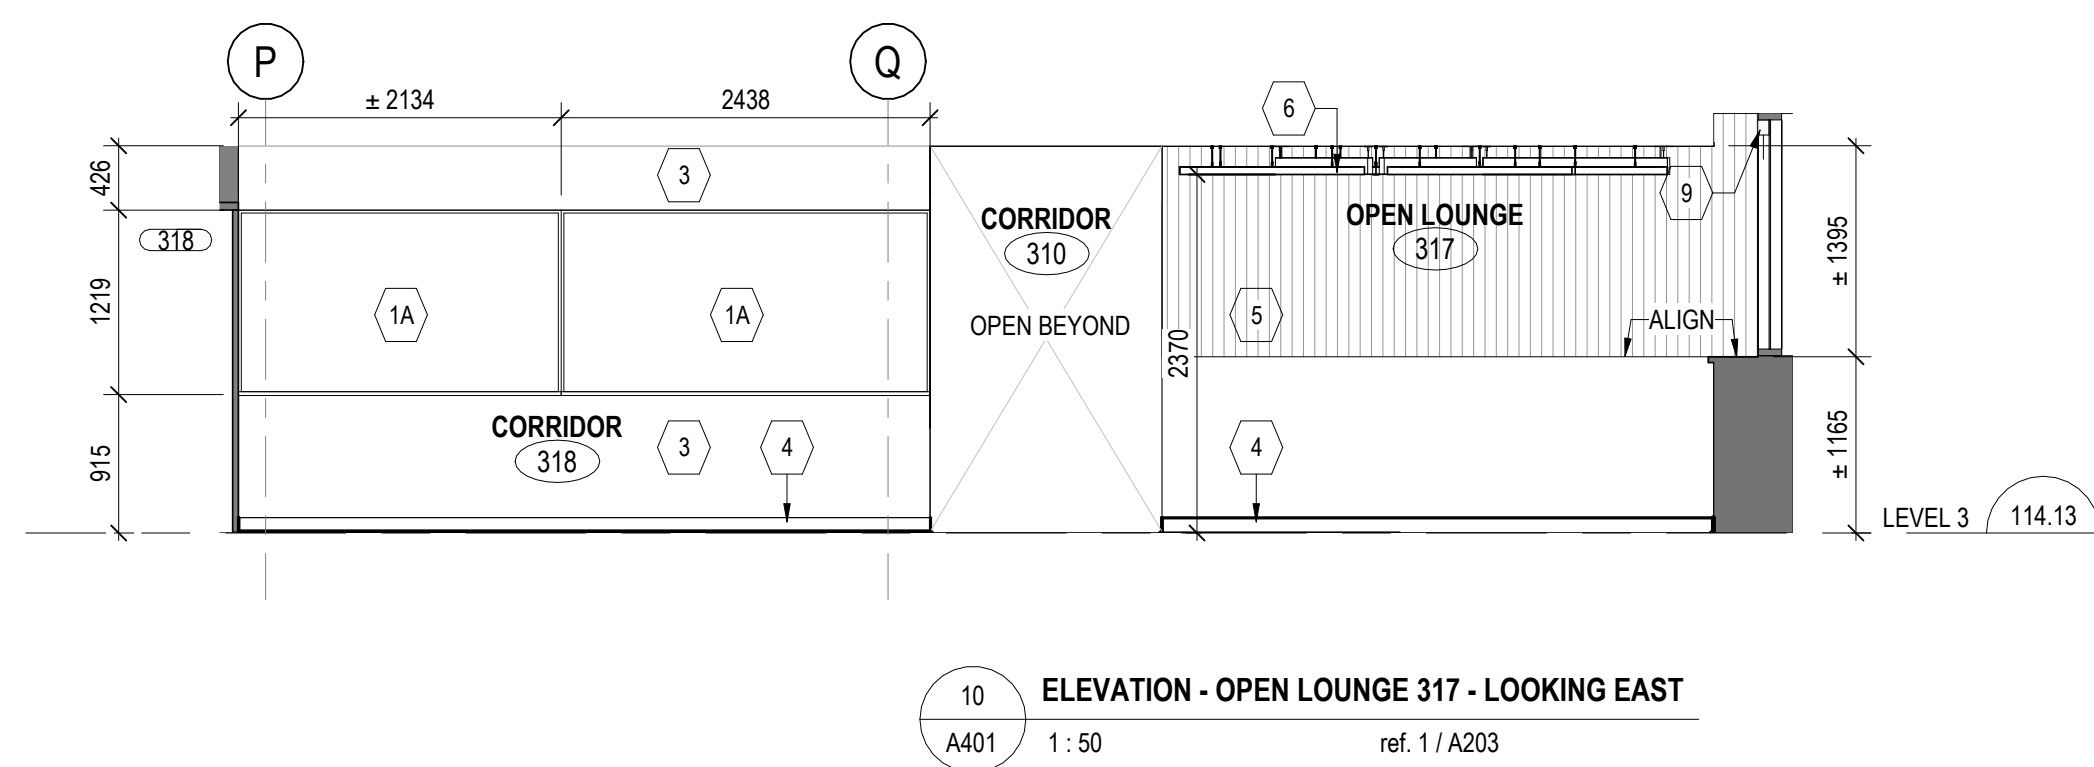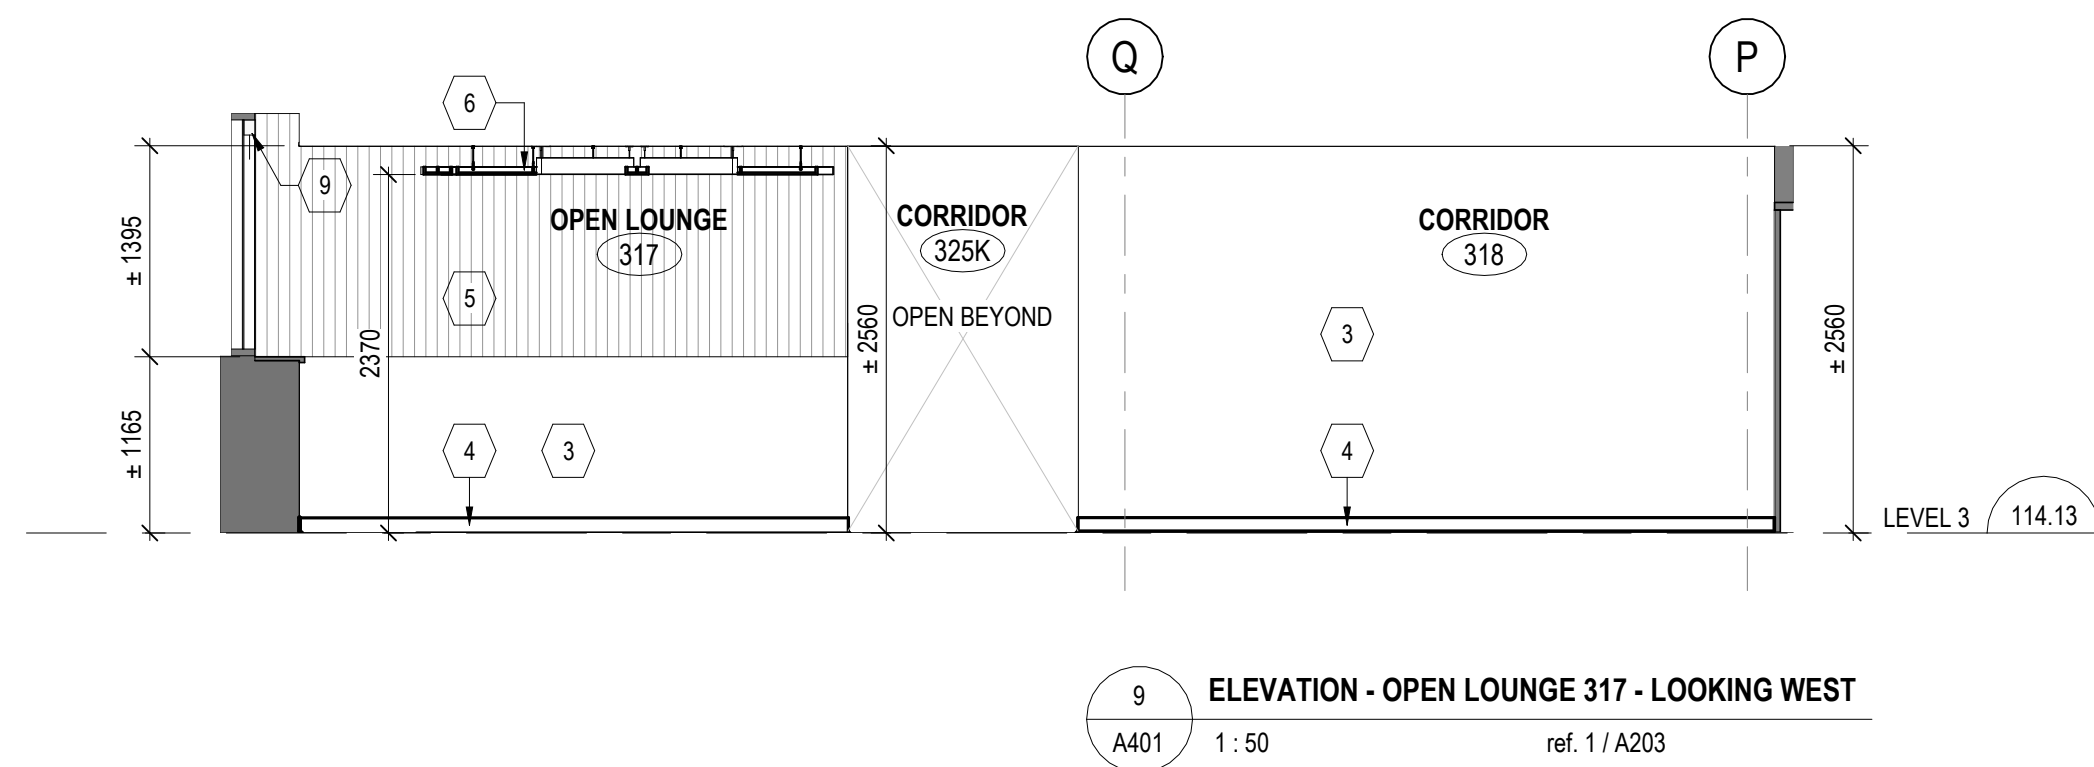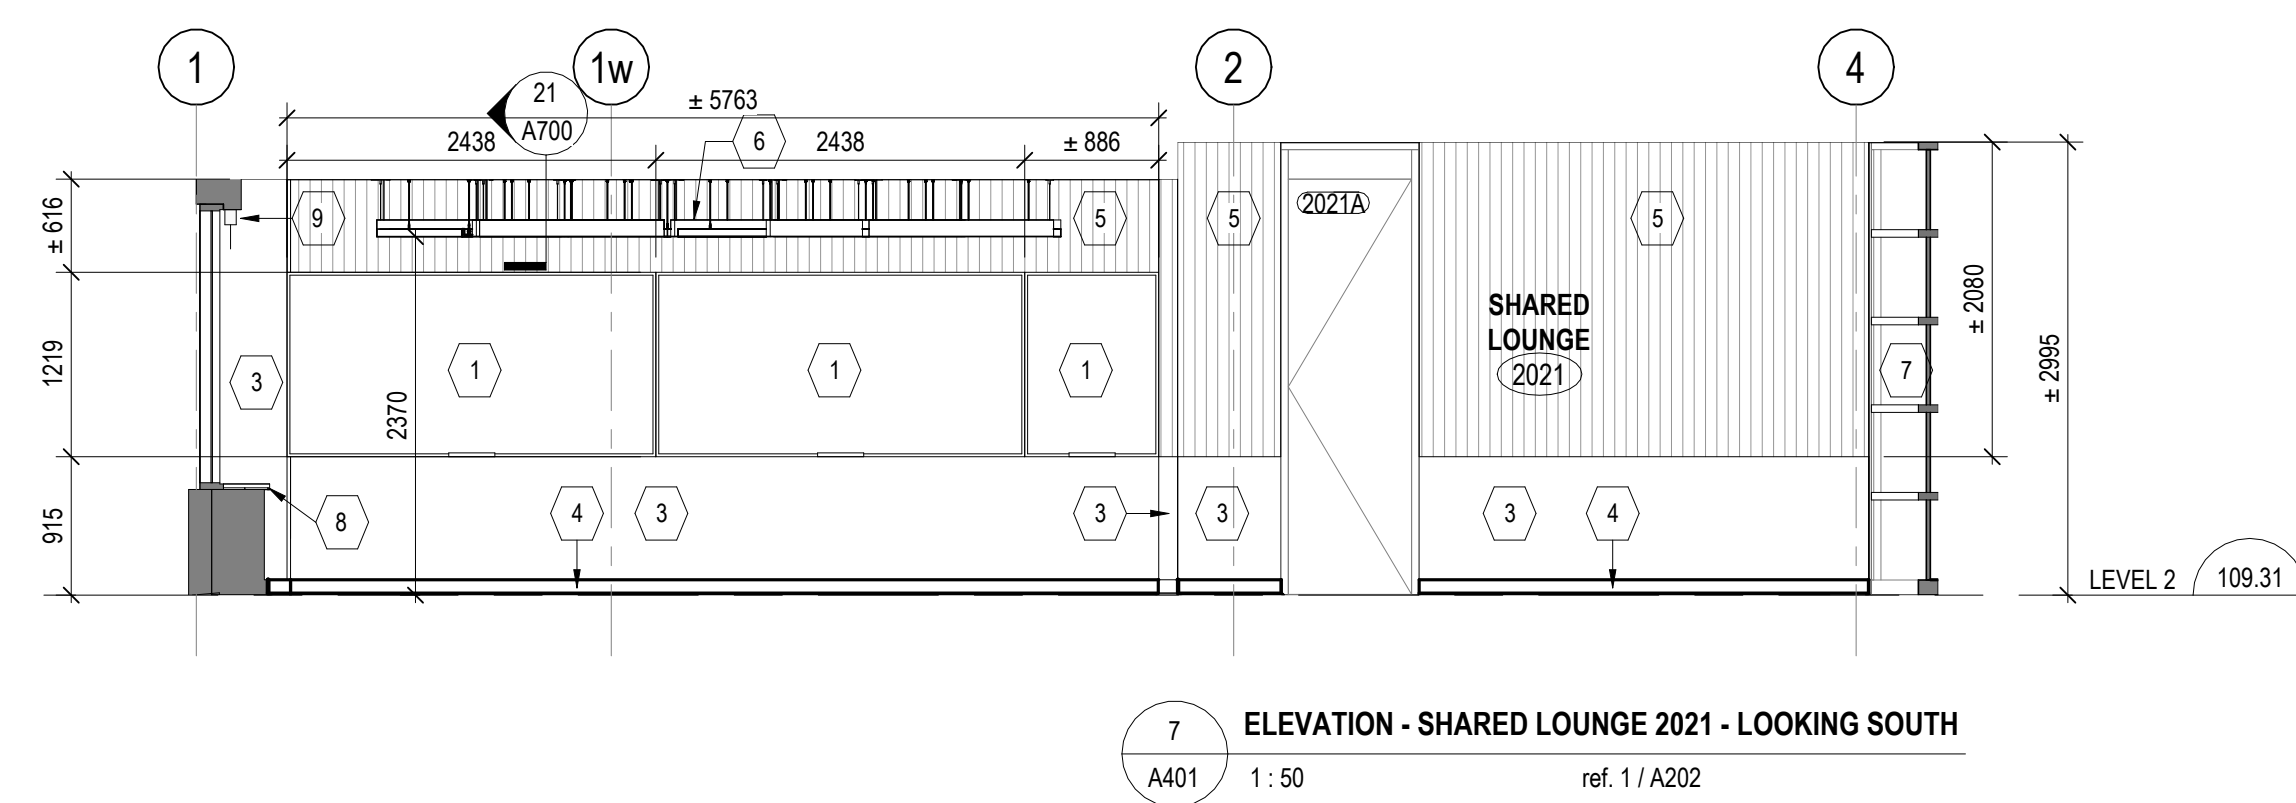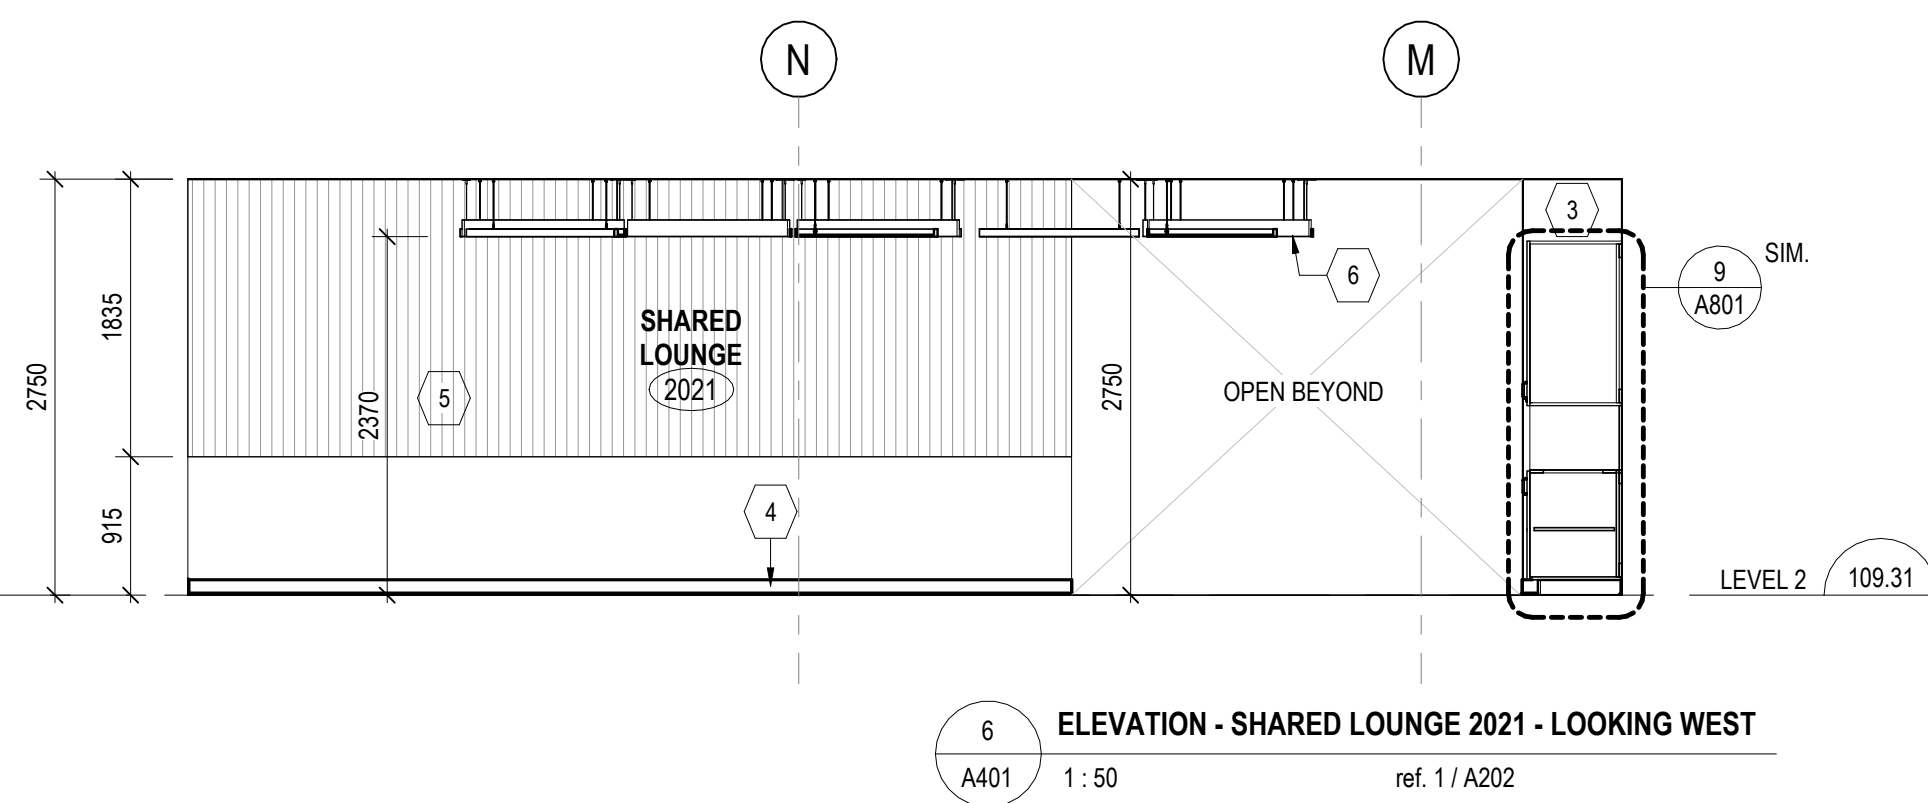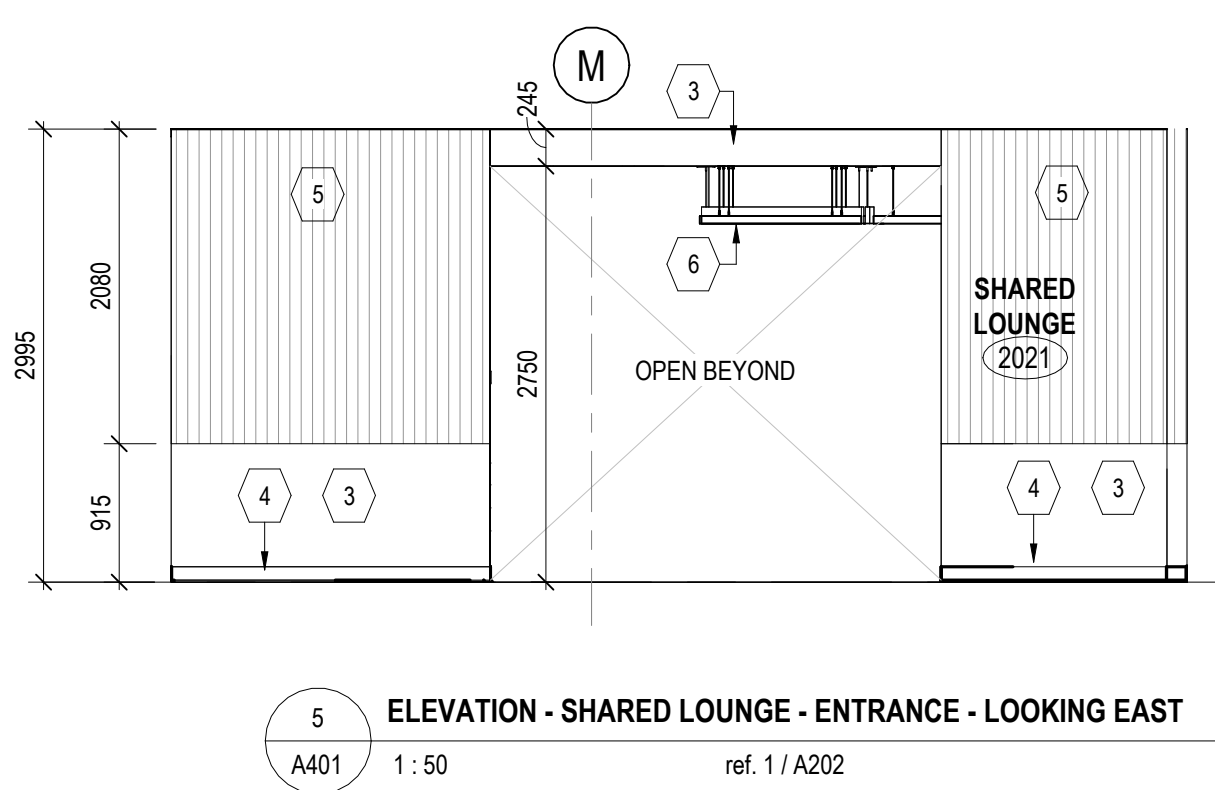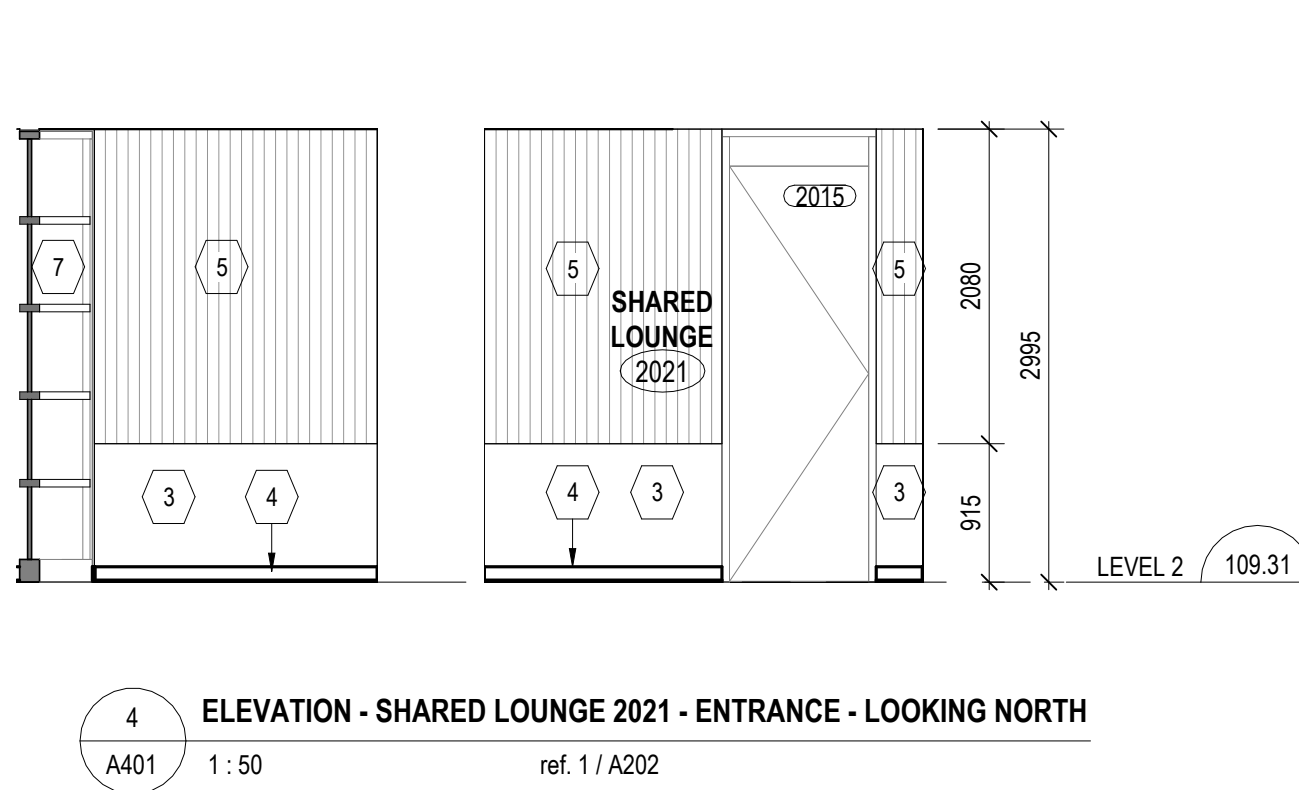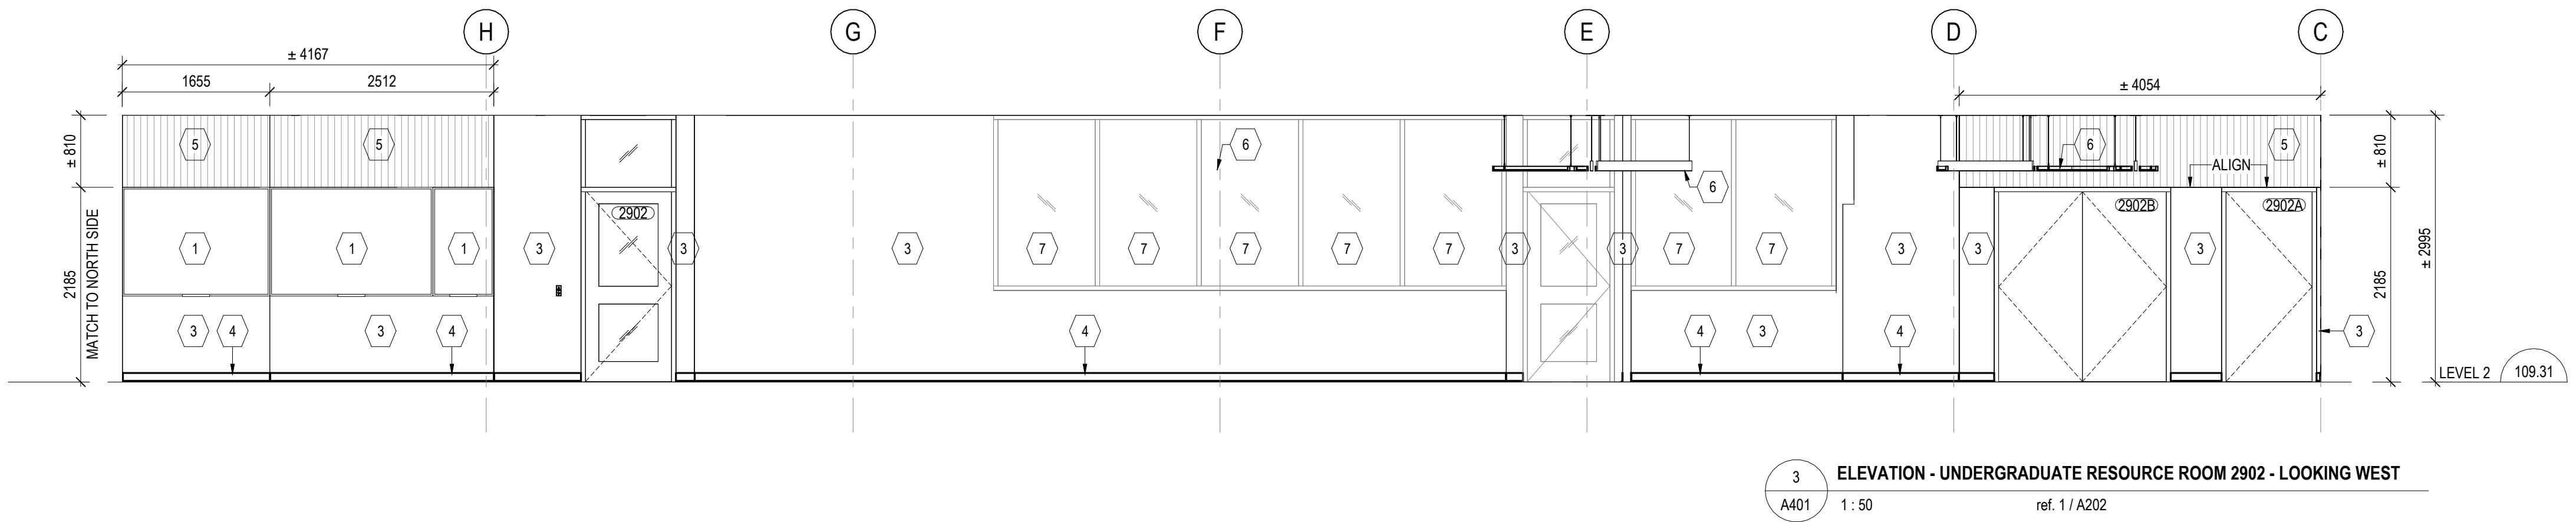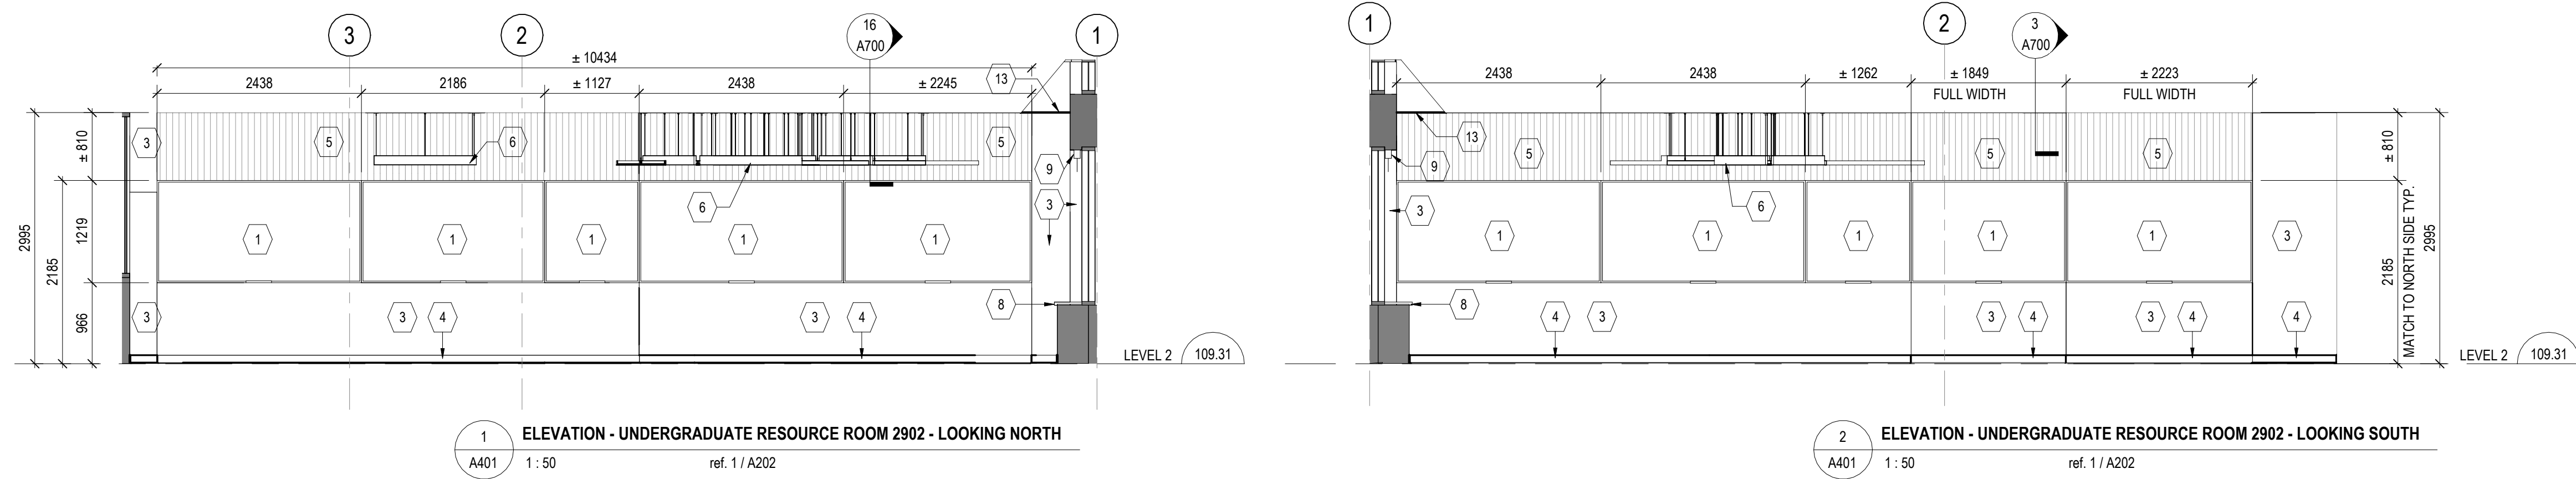

CONSTRUCTION NOTES	
No.	DESCRIPTION
1	PROVIDE NEW CHALKBOARD ON CUSTOM LENGTH CHALK TRAY
1A	PROVIDE NEW CHALKBOARD ON FULL LENGTH CHALK TRAY
1B	PROVIDE NEW CHALKBOARD w/o CHALK TRAY
2	PAINT EXISTING WINDOW FRAME
3	PAINT EXISTING AND NEW DWS PARTITIONS
3A	PAINT WALLS W/ HIGHLIGHTED COLOUR
4	WALL BASE. REFER TO ROOM FINISH SCHEDULE
5	ACOUSTIC WALL PANELS
6	CEILING MOUNTED ACOUSTIC TILES AND LIGHT FIXTURES. SEE RCPs AND ELEC. DWGS
7	EXISTING INTERIOR SCREEN TO REMAIN. PAINT SCREEN FRAME
8	PROVIDE NEW PLAM WINDOW SILL. SEE DETAILS
9	NEW WINDOW SHADE
10	EXISTING BRICK MASONRY TO REMAIN
11	EXISTING WINDOW SHUTTER TO REMAIN
12	PAINT EXISTING TRANSOM TO MATCH NEW DOOR AND DOOR FRAME COLOUR
13	PROVIDE NEW PLASTIC COVER C/W TRIM. SEE RCP DWG
14	REPAINT EXISTING DOOR AND DOOR FRAME
15	PROVIDE NEW COUNTER AND PAINTED FRAME AROUND RECEPTION DESK OPENING IN WALL - SEE DETAIL
16	RECEPTION SIGNAGE (N.I.C.)
17	REPAINT THE DOOR AND DOOR FRAME
18	PROVIDE METAL COVER ON FIRESTOPPING AS REQUIRED. PAINT TO MATCH DOOR AND DOOR FRAME COLOUR
19	EXISTING LIGHT SWITCH TO REMAIN. SEE ELEC. DWGS

7	ISSUED FOR TENDER	2026-04-22
6	ISSUED FOR 80% CD	2026-03-09
5	ISSUED FOR PERMIT	2026-03-04
4	ISSUED FOR CLASS A COSTING	2026-02-18
3	ISSUED FOR 100% DD	2026-01-23
2	ISSUED FOR CLASS B COSTING	2026-01-16
1	ISSUED FOR 80% DD	2025-11-08
REV.	DESCRIPTION	DATE

KEY PLAN (NTS)

SEAL

PROJECT TITLE  
UNIVERSITY OF TORONTO  
**33 URSULA FRANKLIN  
MATH OFFICE  
RENOVATION**

33 URSULA FRANKLIN ST.  
DRAWING SHEET TITLE  
**INTERIOR ELEVATIONS**

DRAWN BY: AS  
REVIEWED BY: SC  
UNIVERSITY PROJECT NUMBER: NORTH POINT


P164-24-165

DRAWING NUMBER  
**A401**

REV. NUMBER  
**7**



C:\Users\songant\Documents\P164-25-165\_A\_26\_anita.song.rvt 2026-04-22 11:52:46 AM

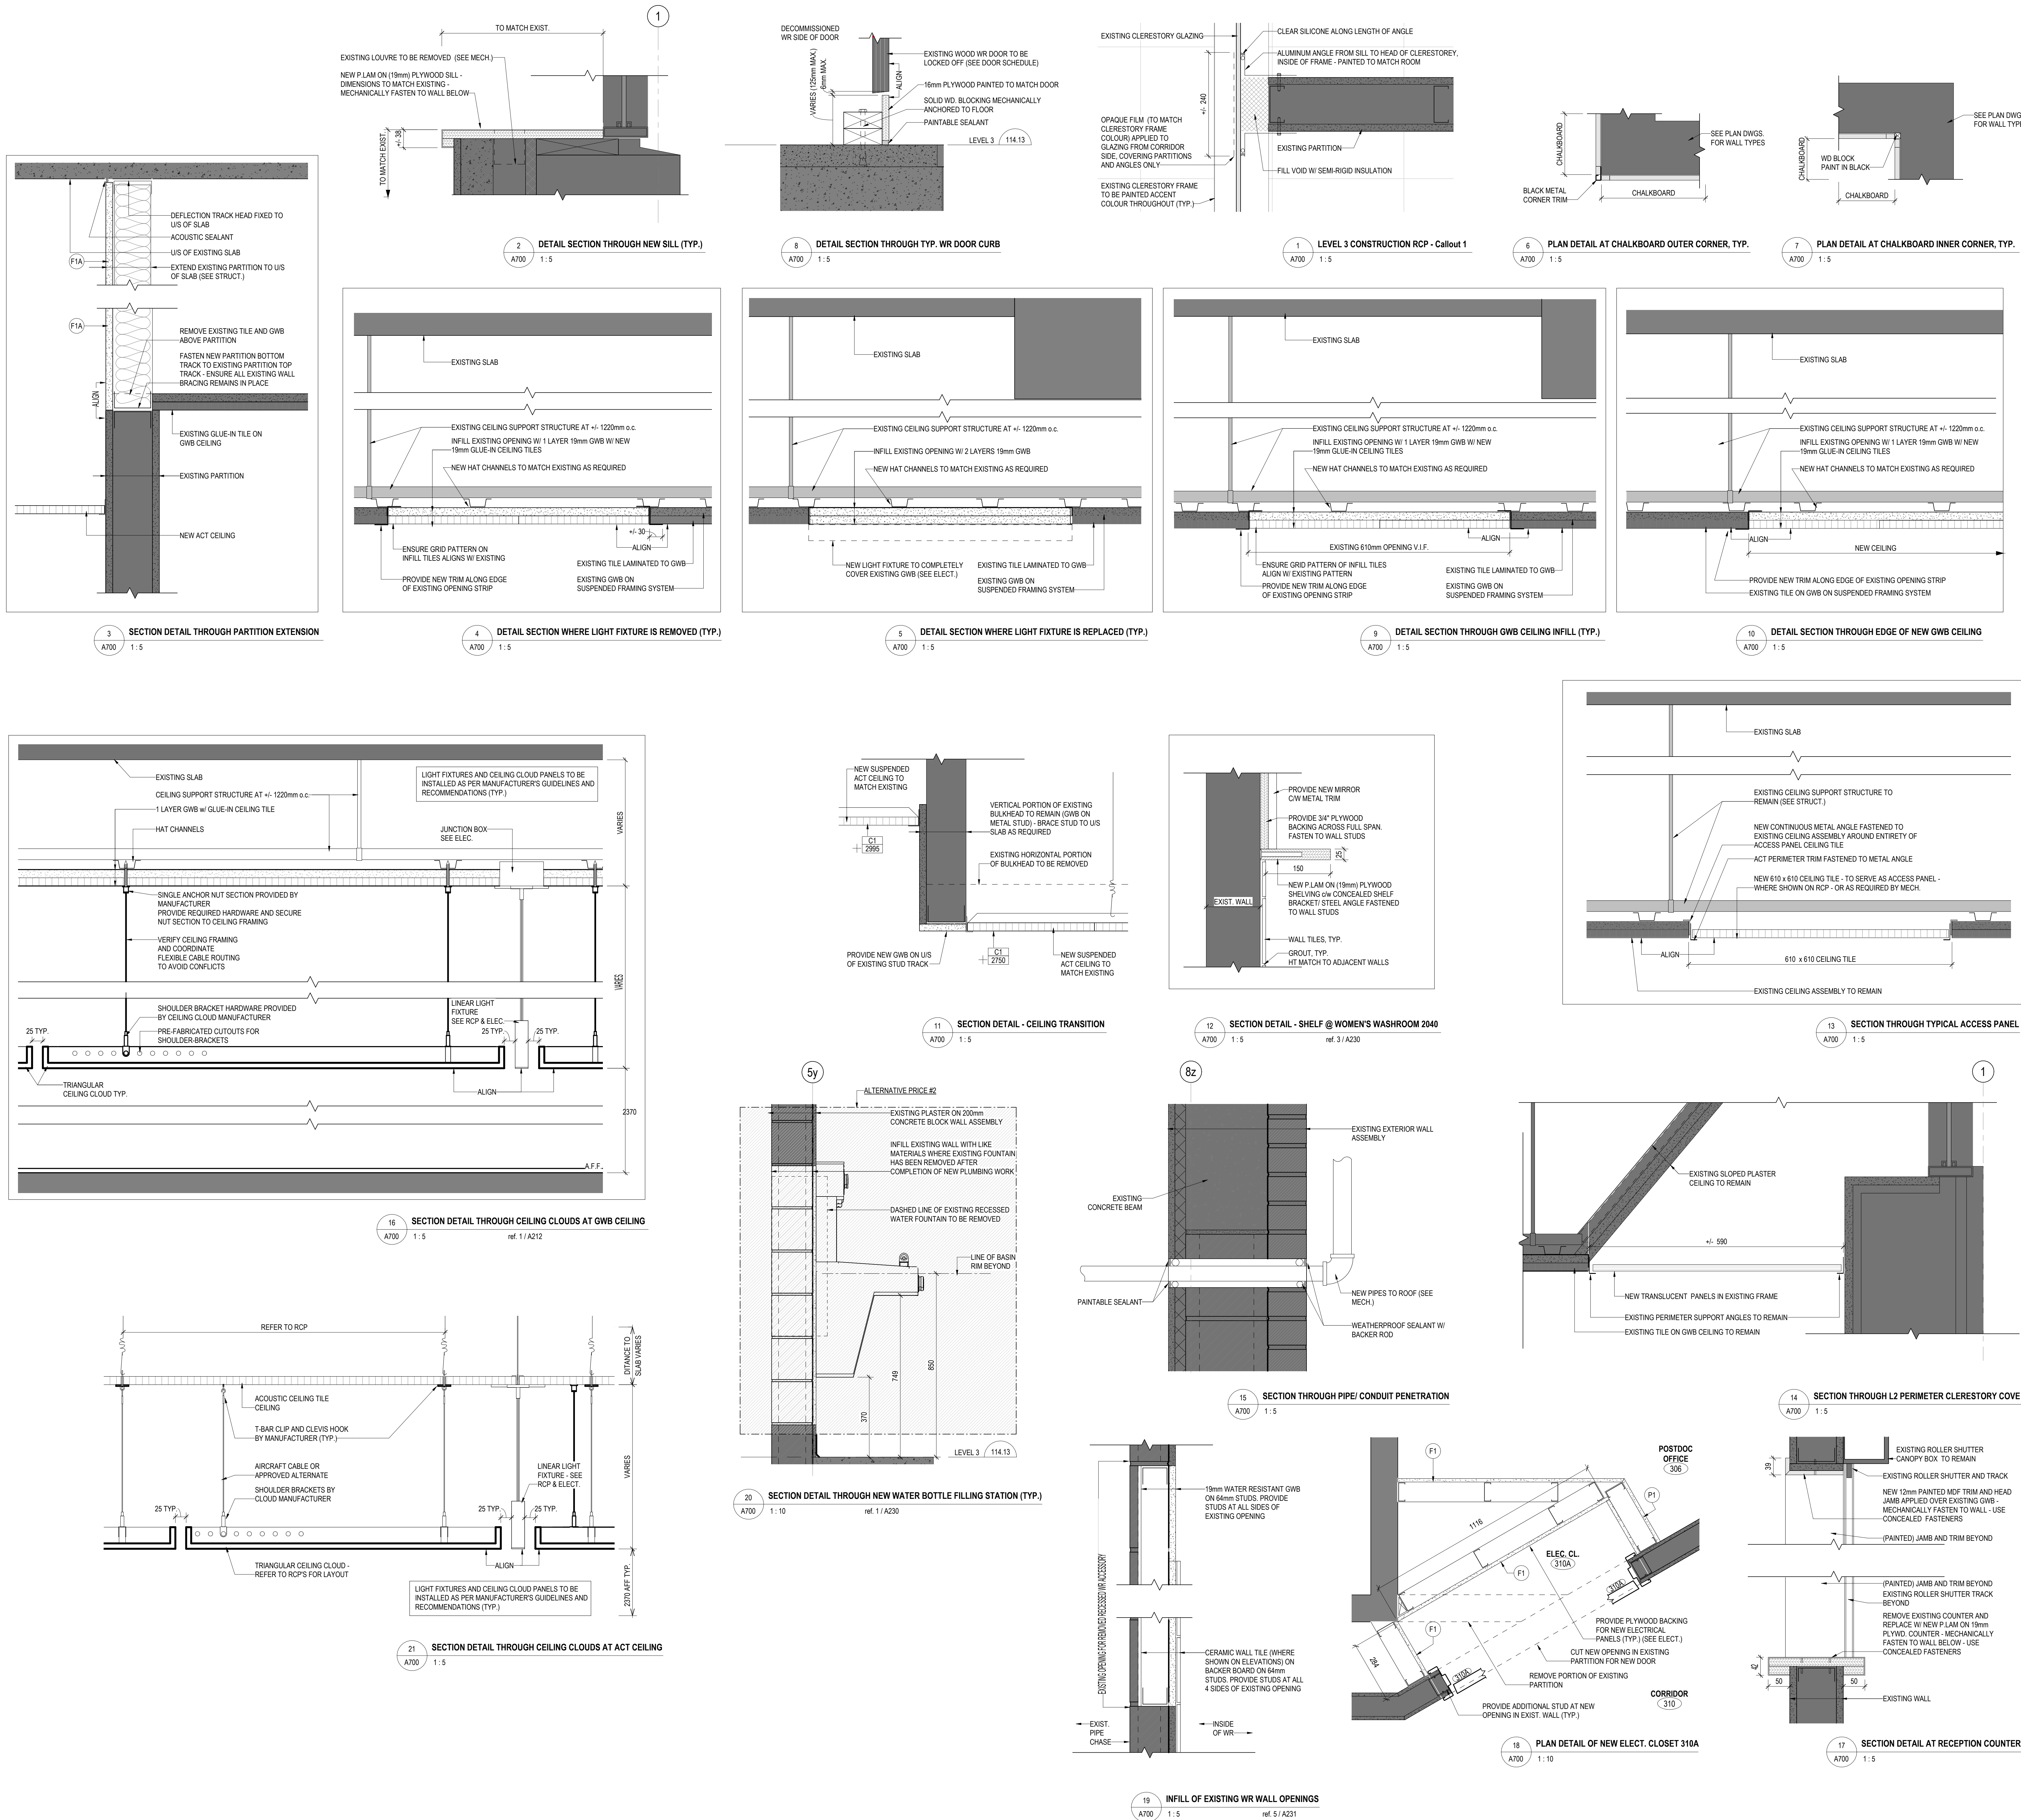

6	ISSUED FOR TENDER	2026-04-22
5	ISSUED FOR 80% CD	2026-03-09
4	ISSUED FOR PERMIT	2026-03-04
3	ISSUED FOR CLASS A COSTING	2026-02-18
2	ISSUED FOR 100% DC	2026-01-23
1	ISSUED FOR CLASS B COSTING	2026-01-16
REV.	DESCRIPTION	DATE

KEY PLAN (NTS)	SEAL
PROJECT TITLE	UNIVERSITY OF TORONTO
33 URSULA FRANKLIN	MATH OFFICE
RENOVATION	







33 URSULA FRANKLIN ST.  
DRAWING SHEET TITLE  
**DETAILS**

DRAWN BY: JRV AS	SCALE: As indicated
REVIEWED BY: SC	DATE CREATED: 2026/02/11
UNIVERSITY PROJECT NUMBER: NORTH POINT	

P164-24-165

DRAWING NUMBER	REV. NUMBER
<b>A700</b>	<b>6</b>



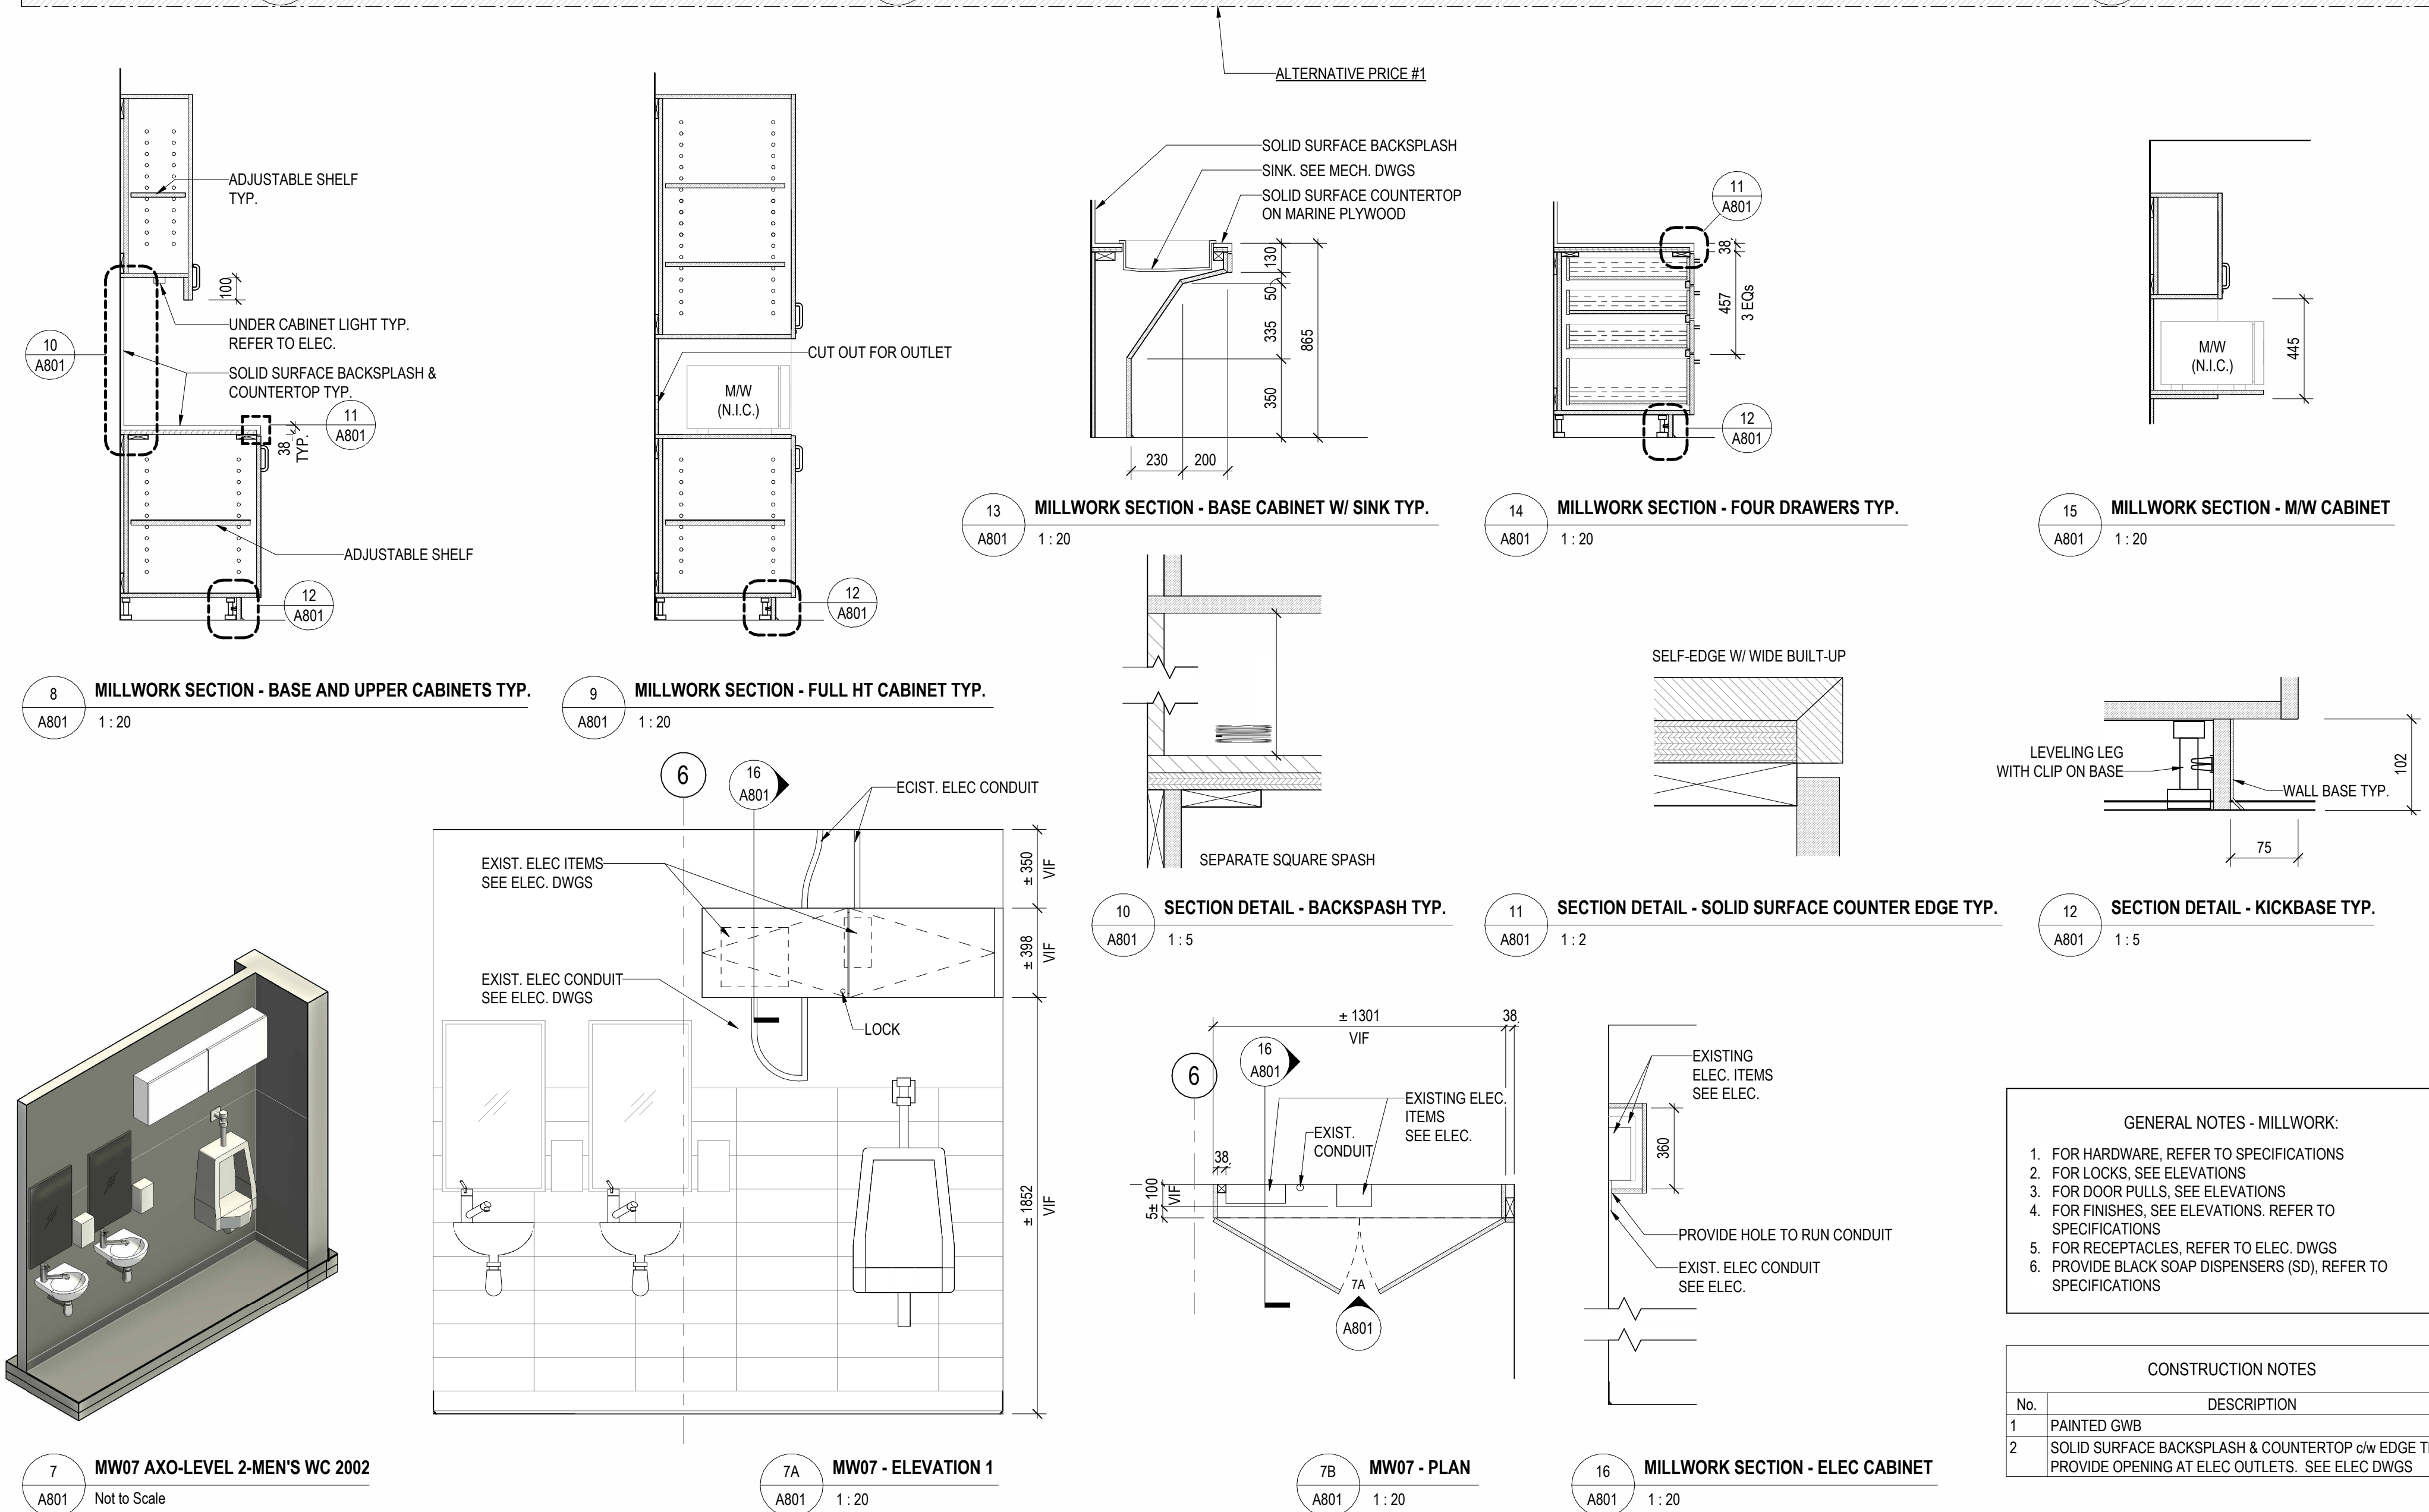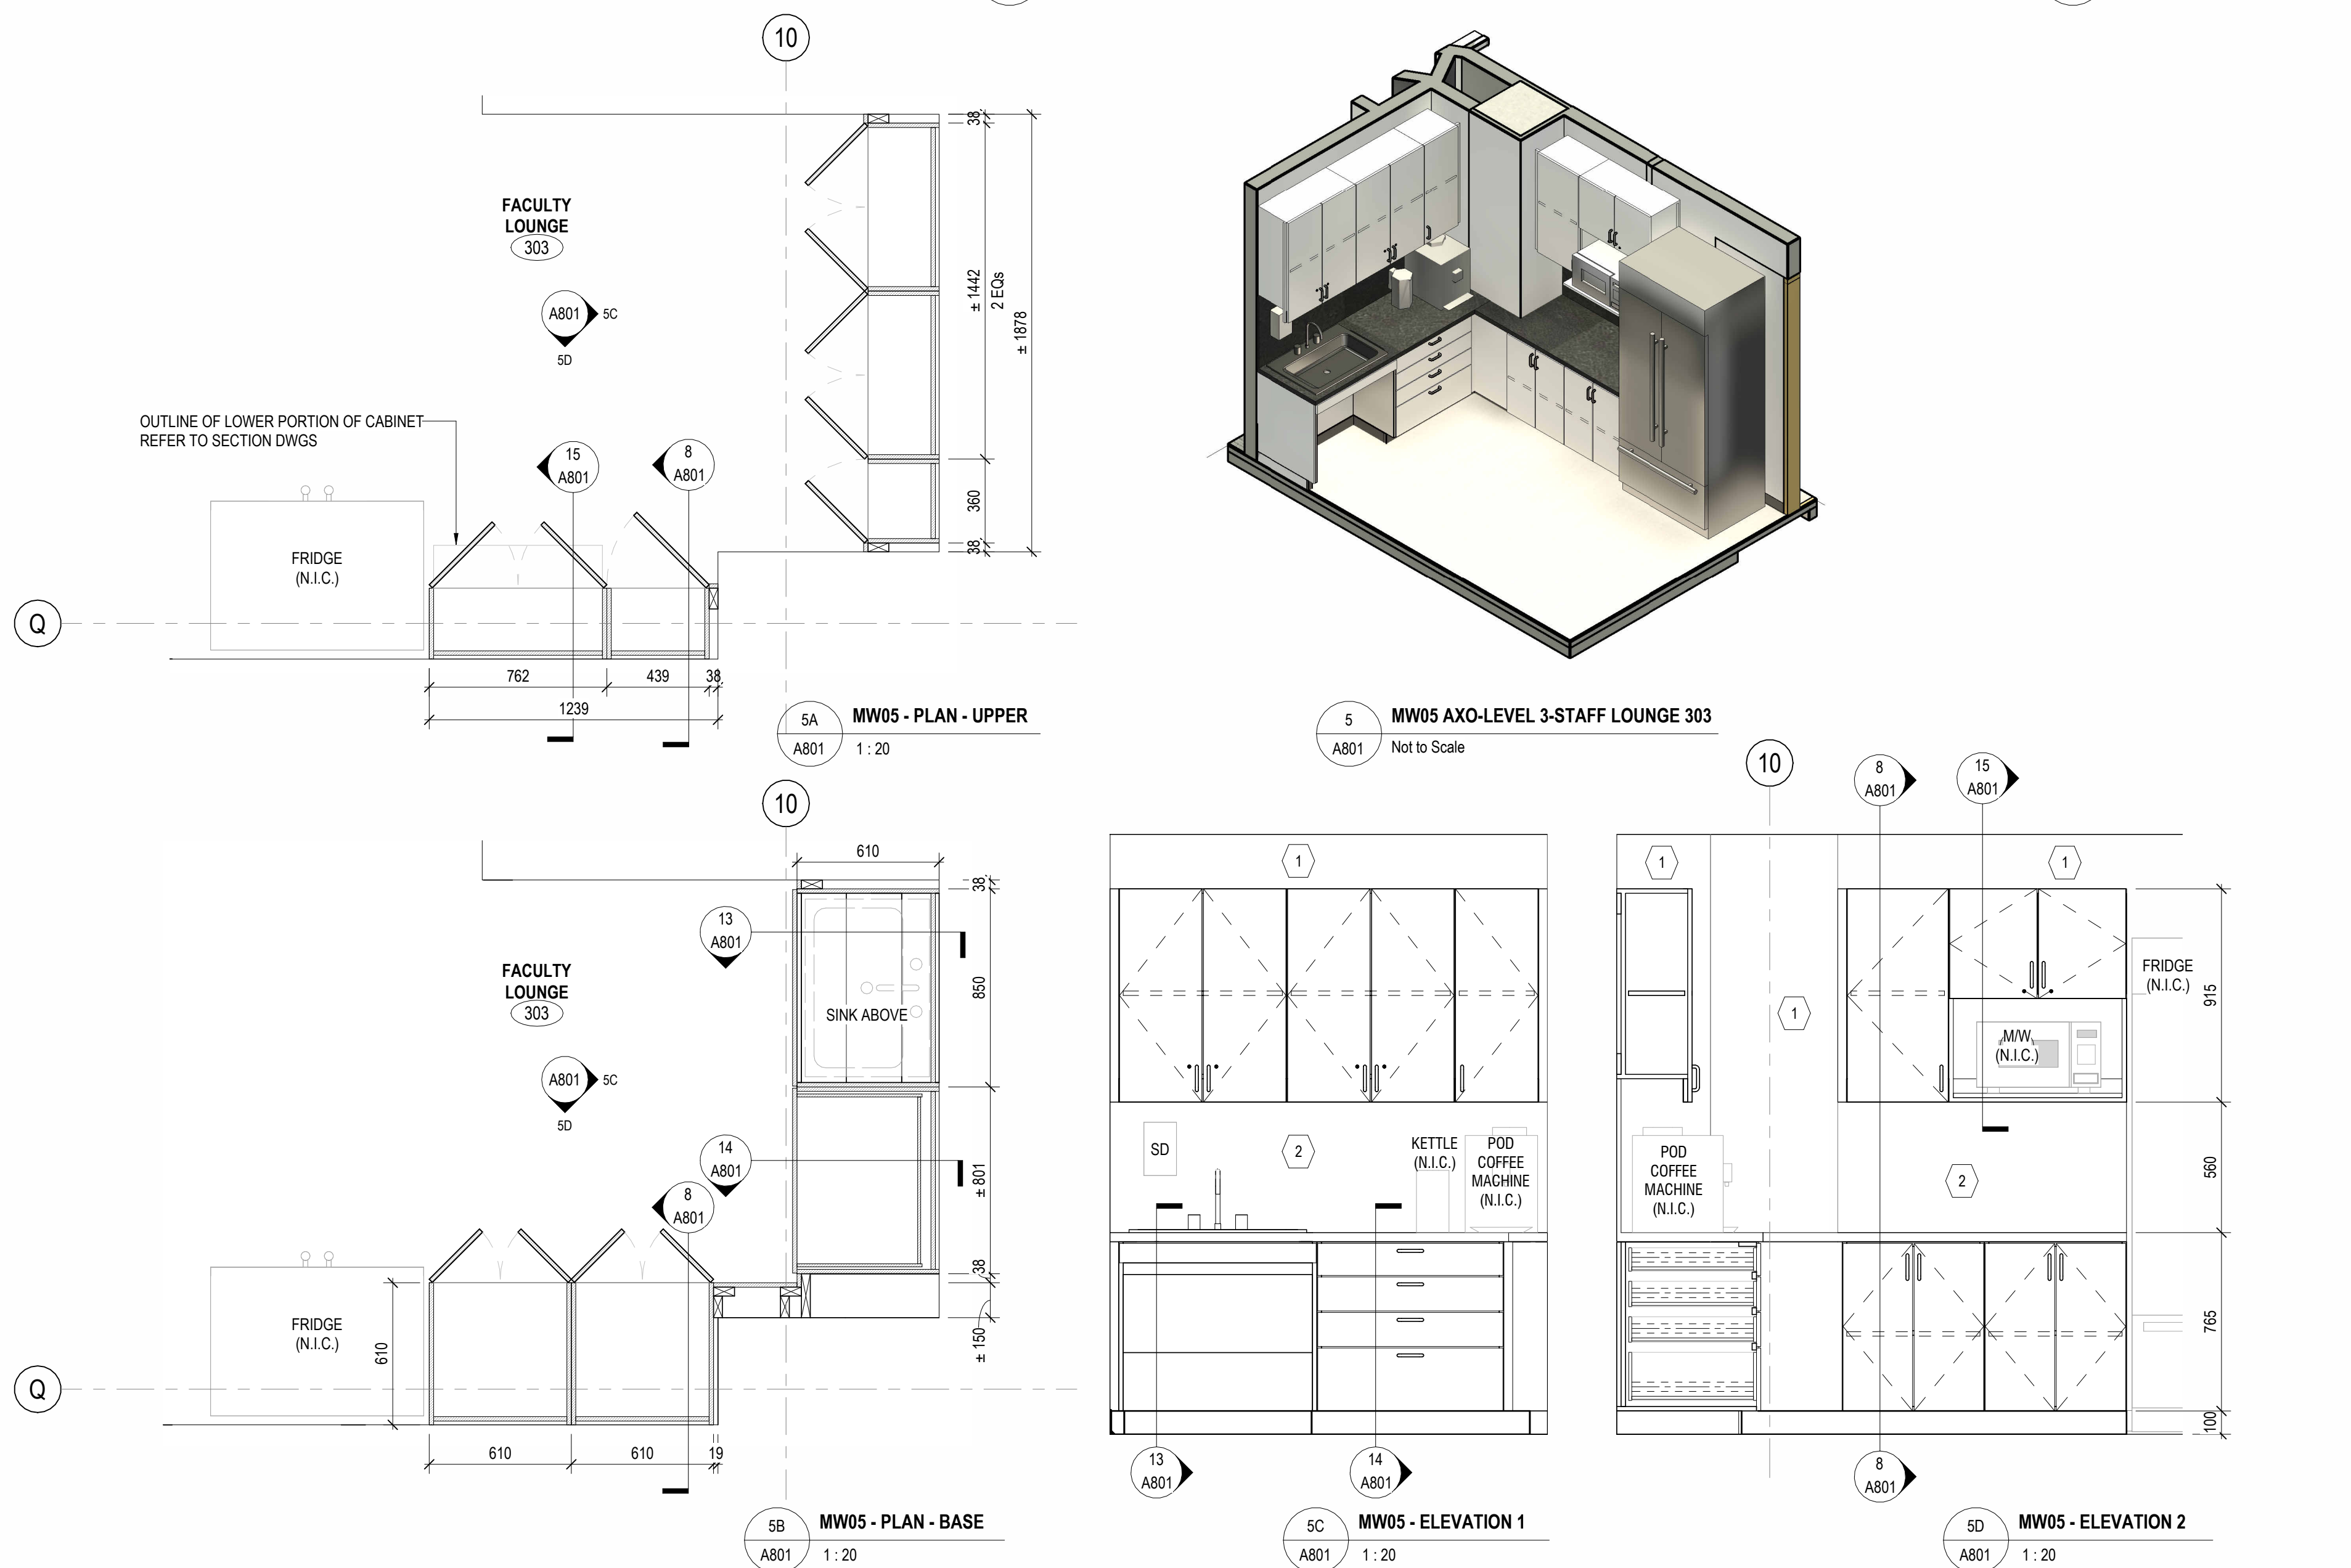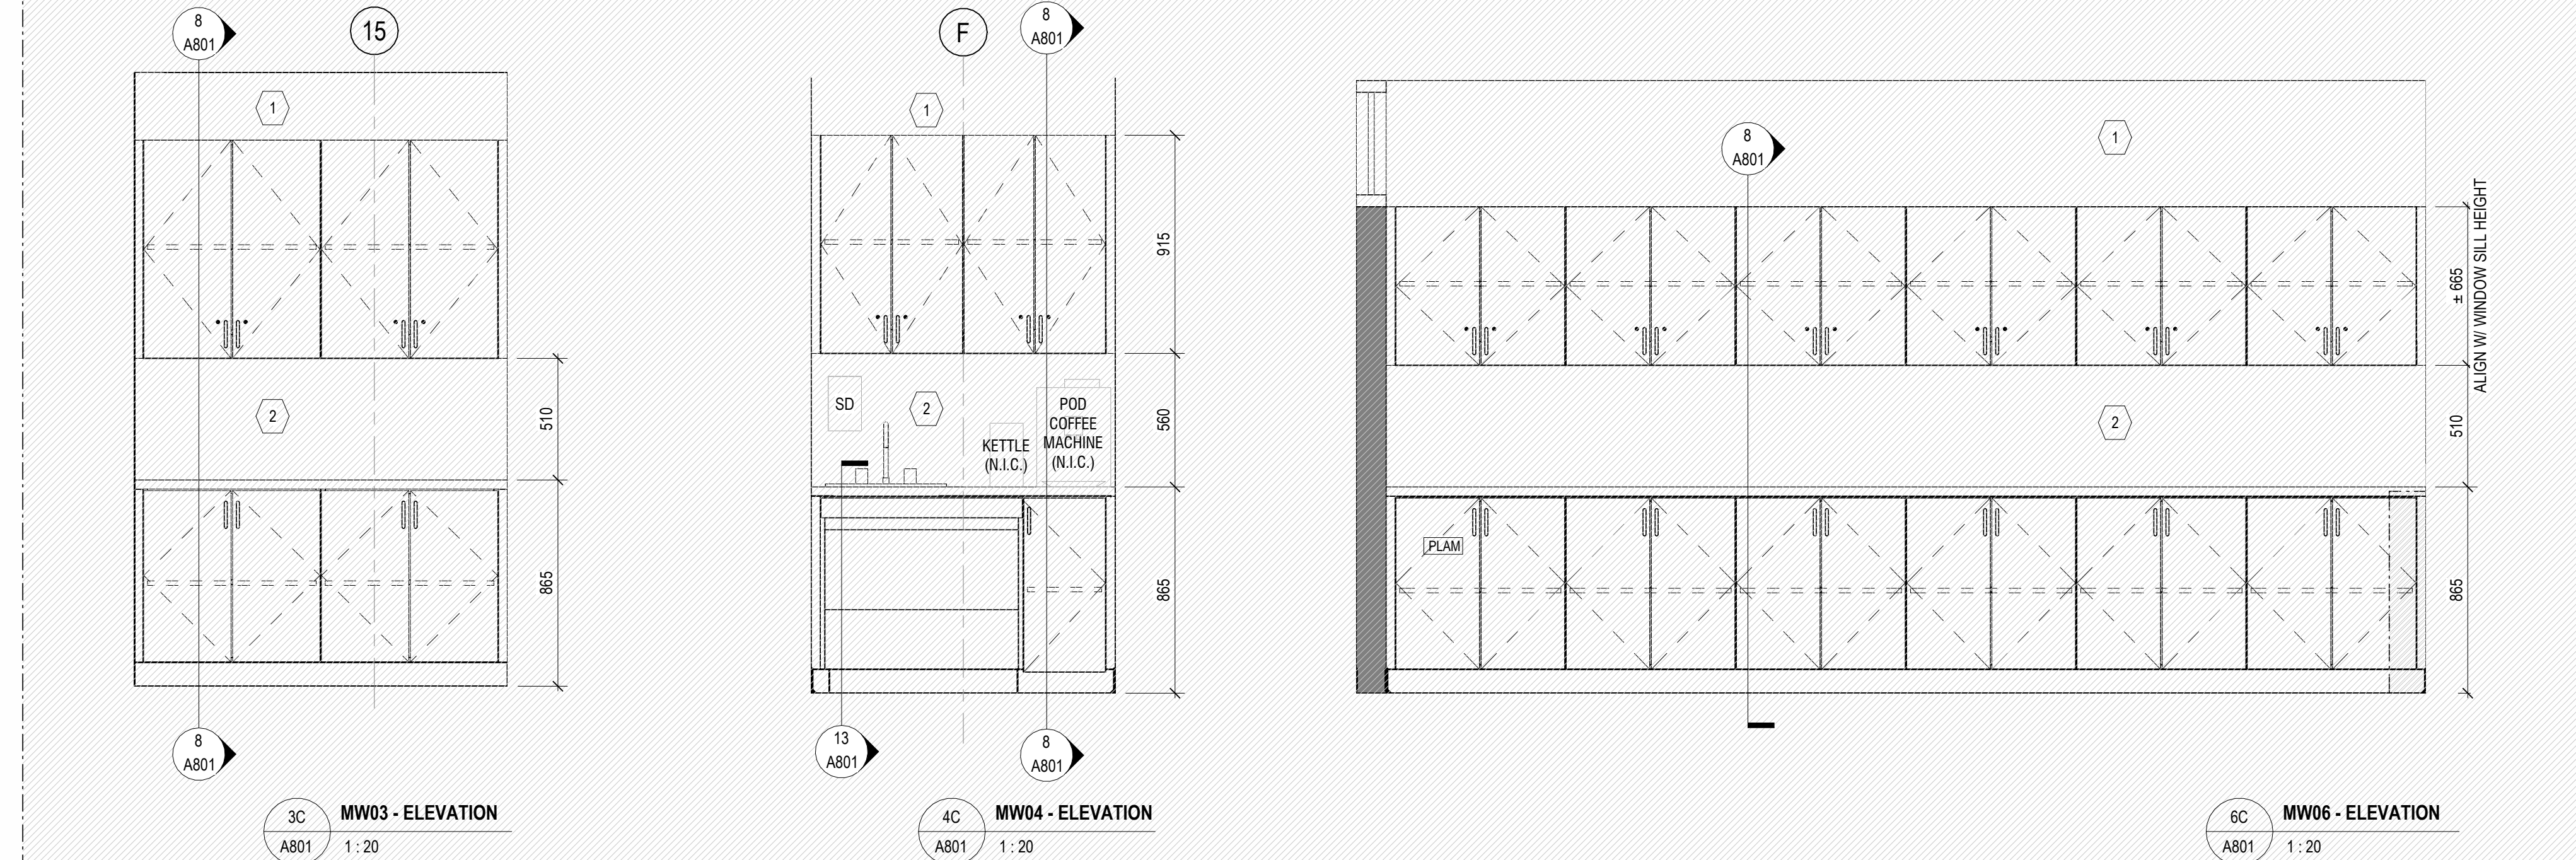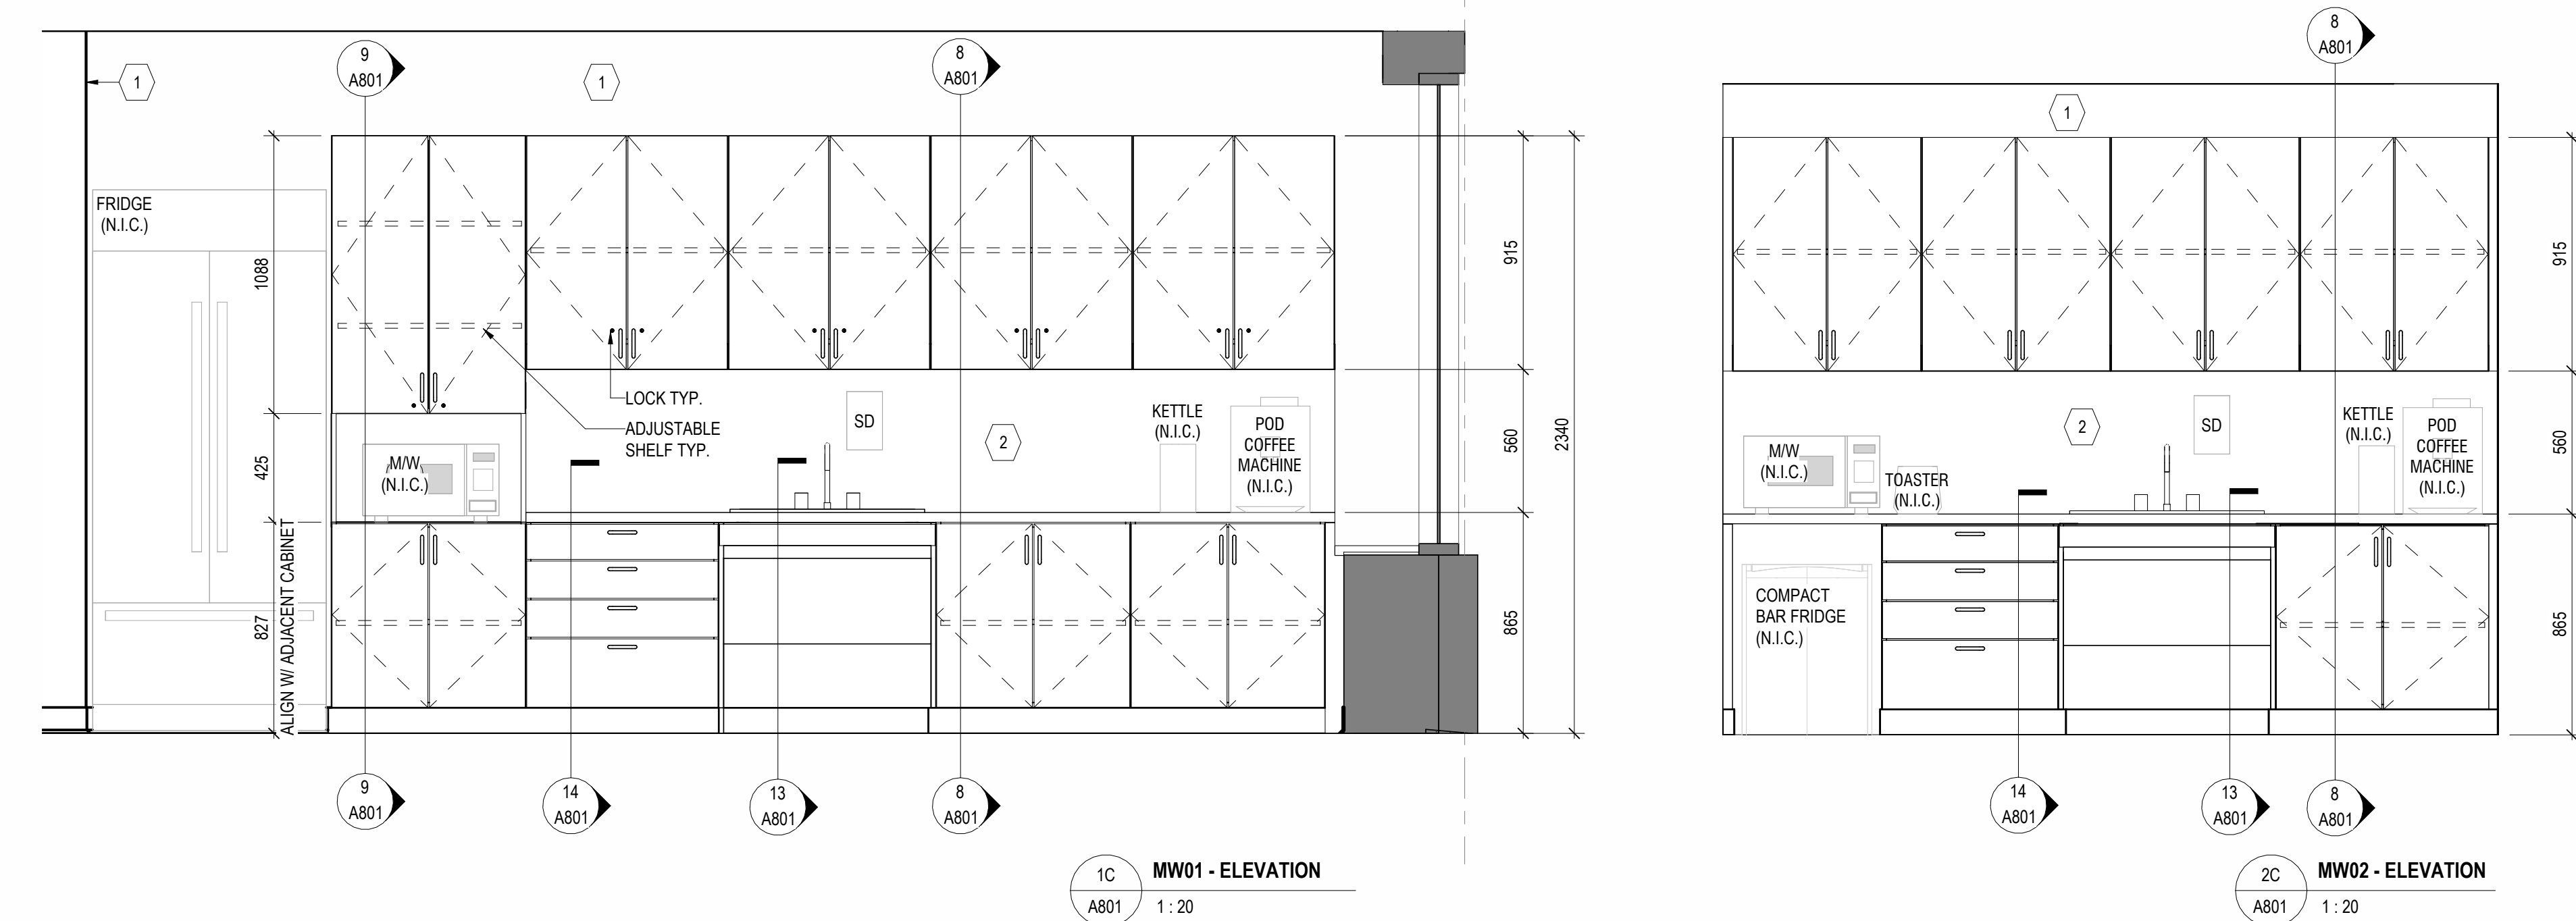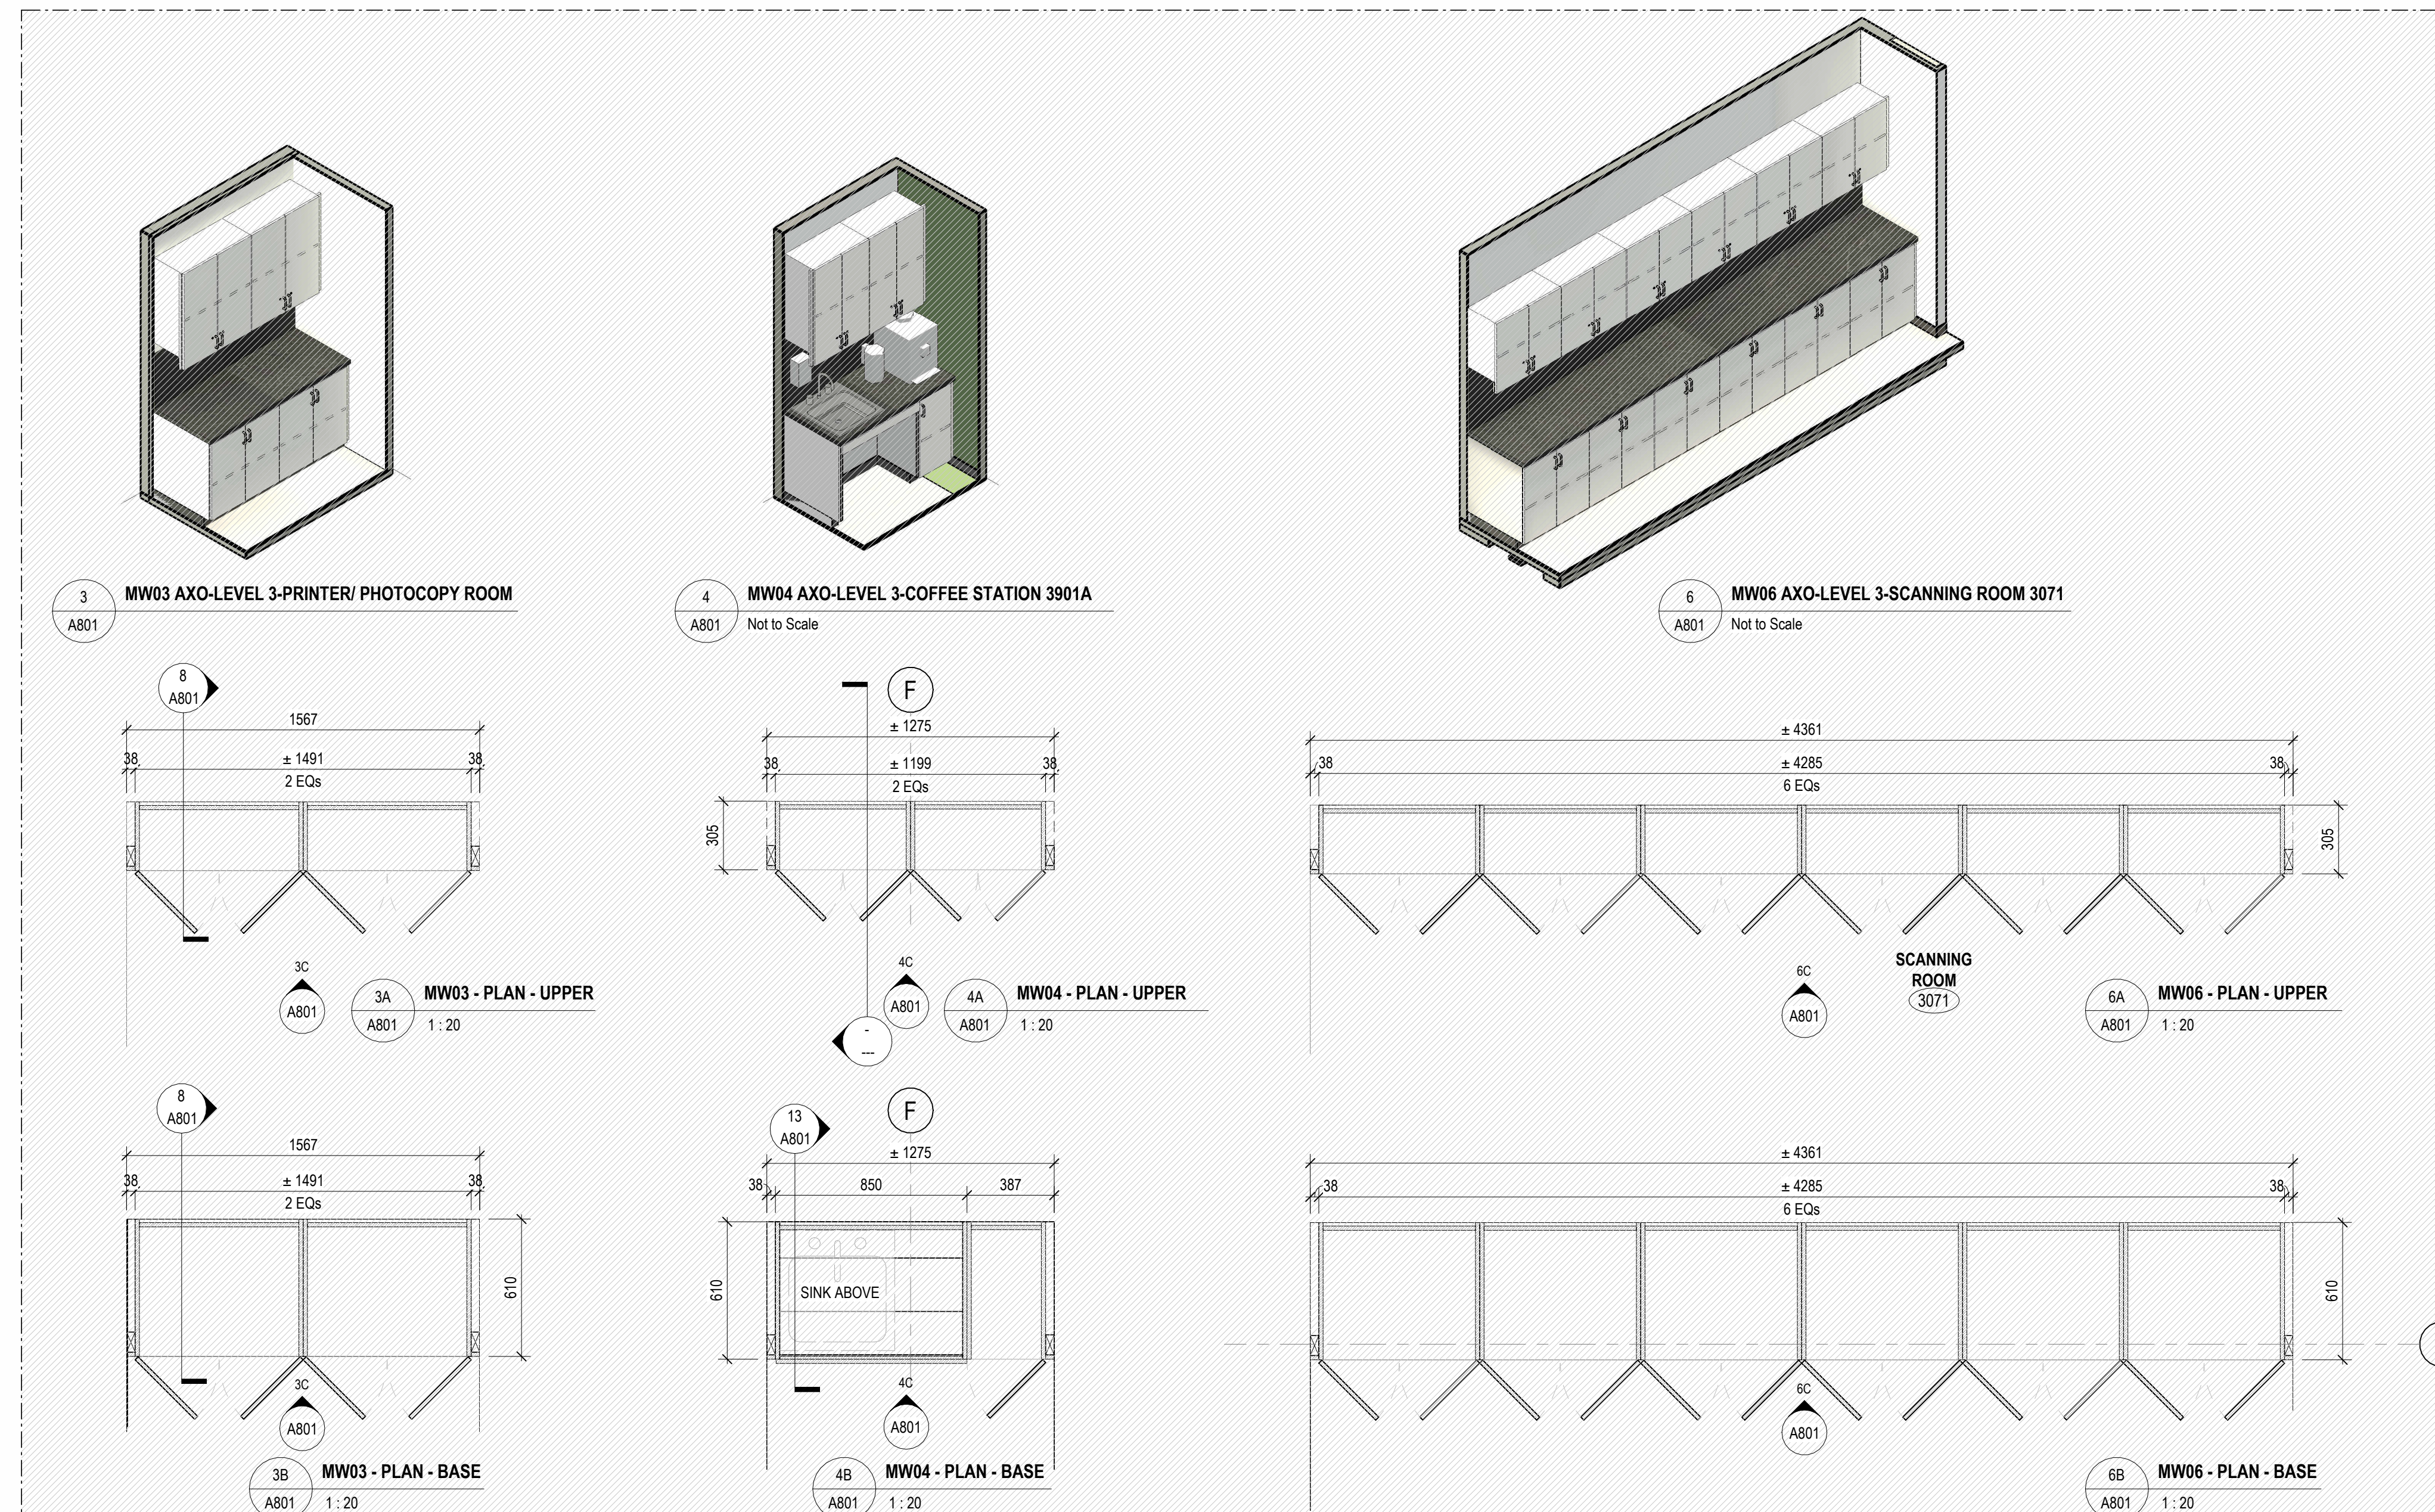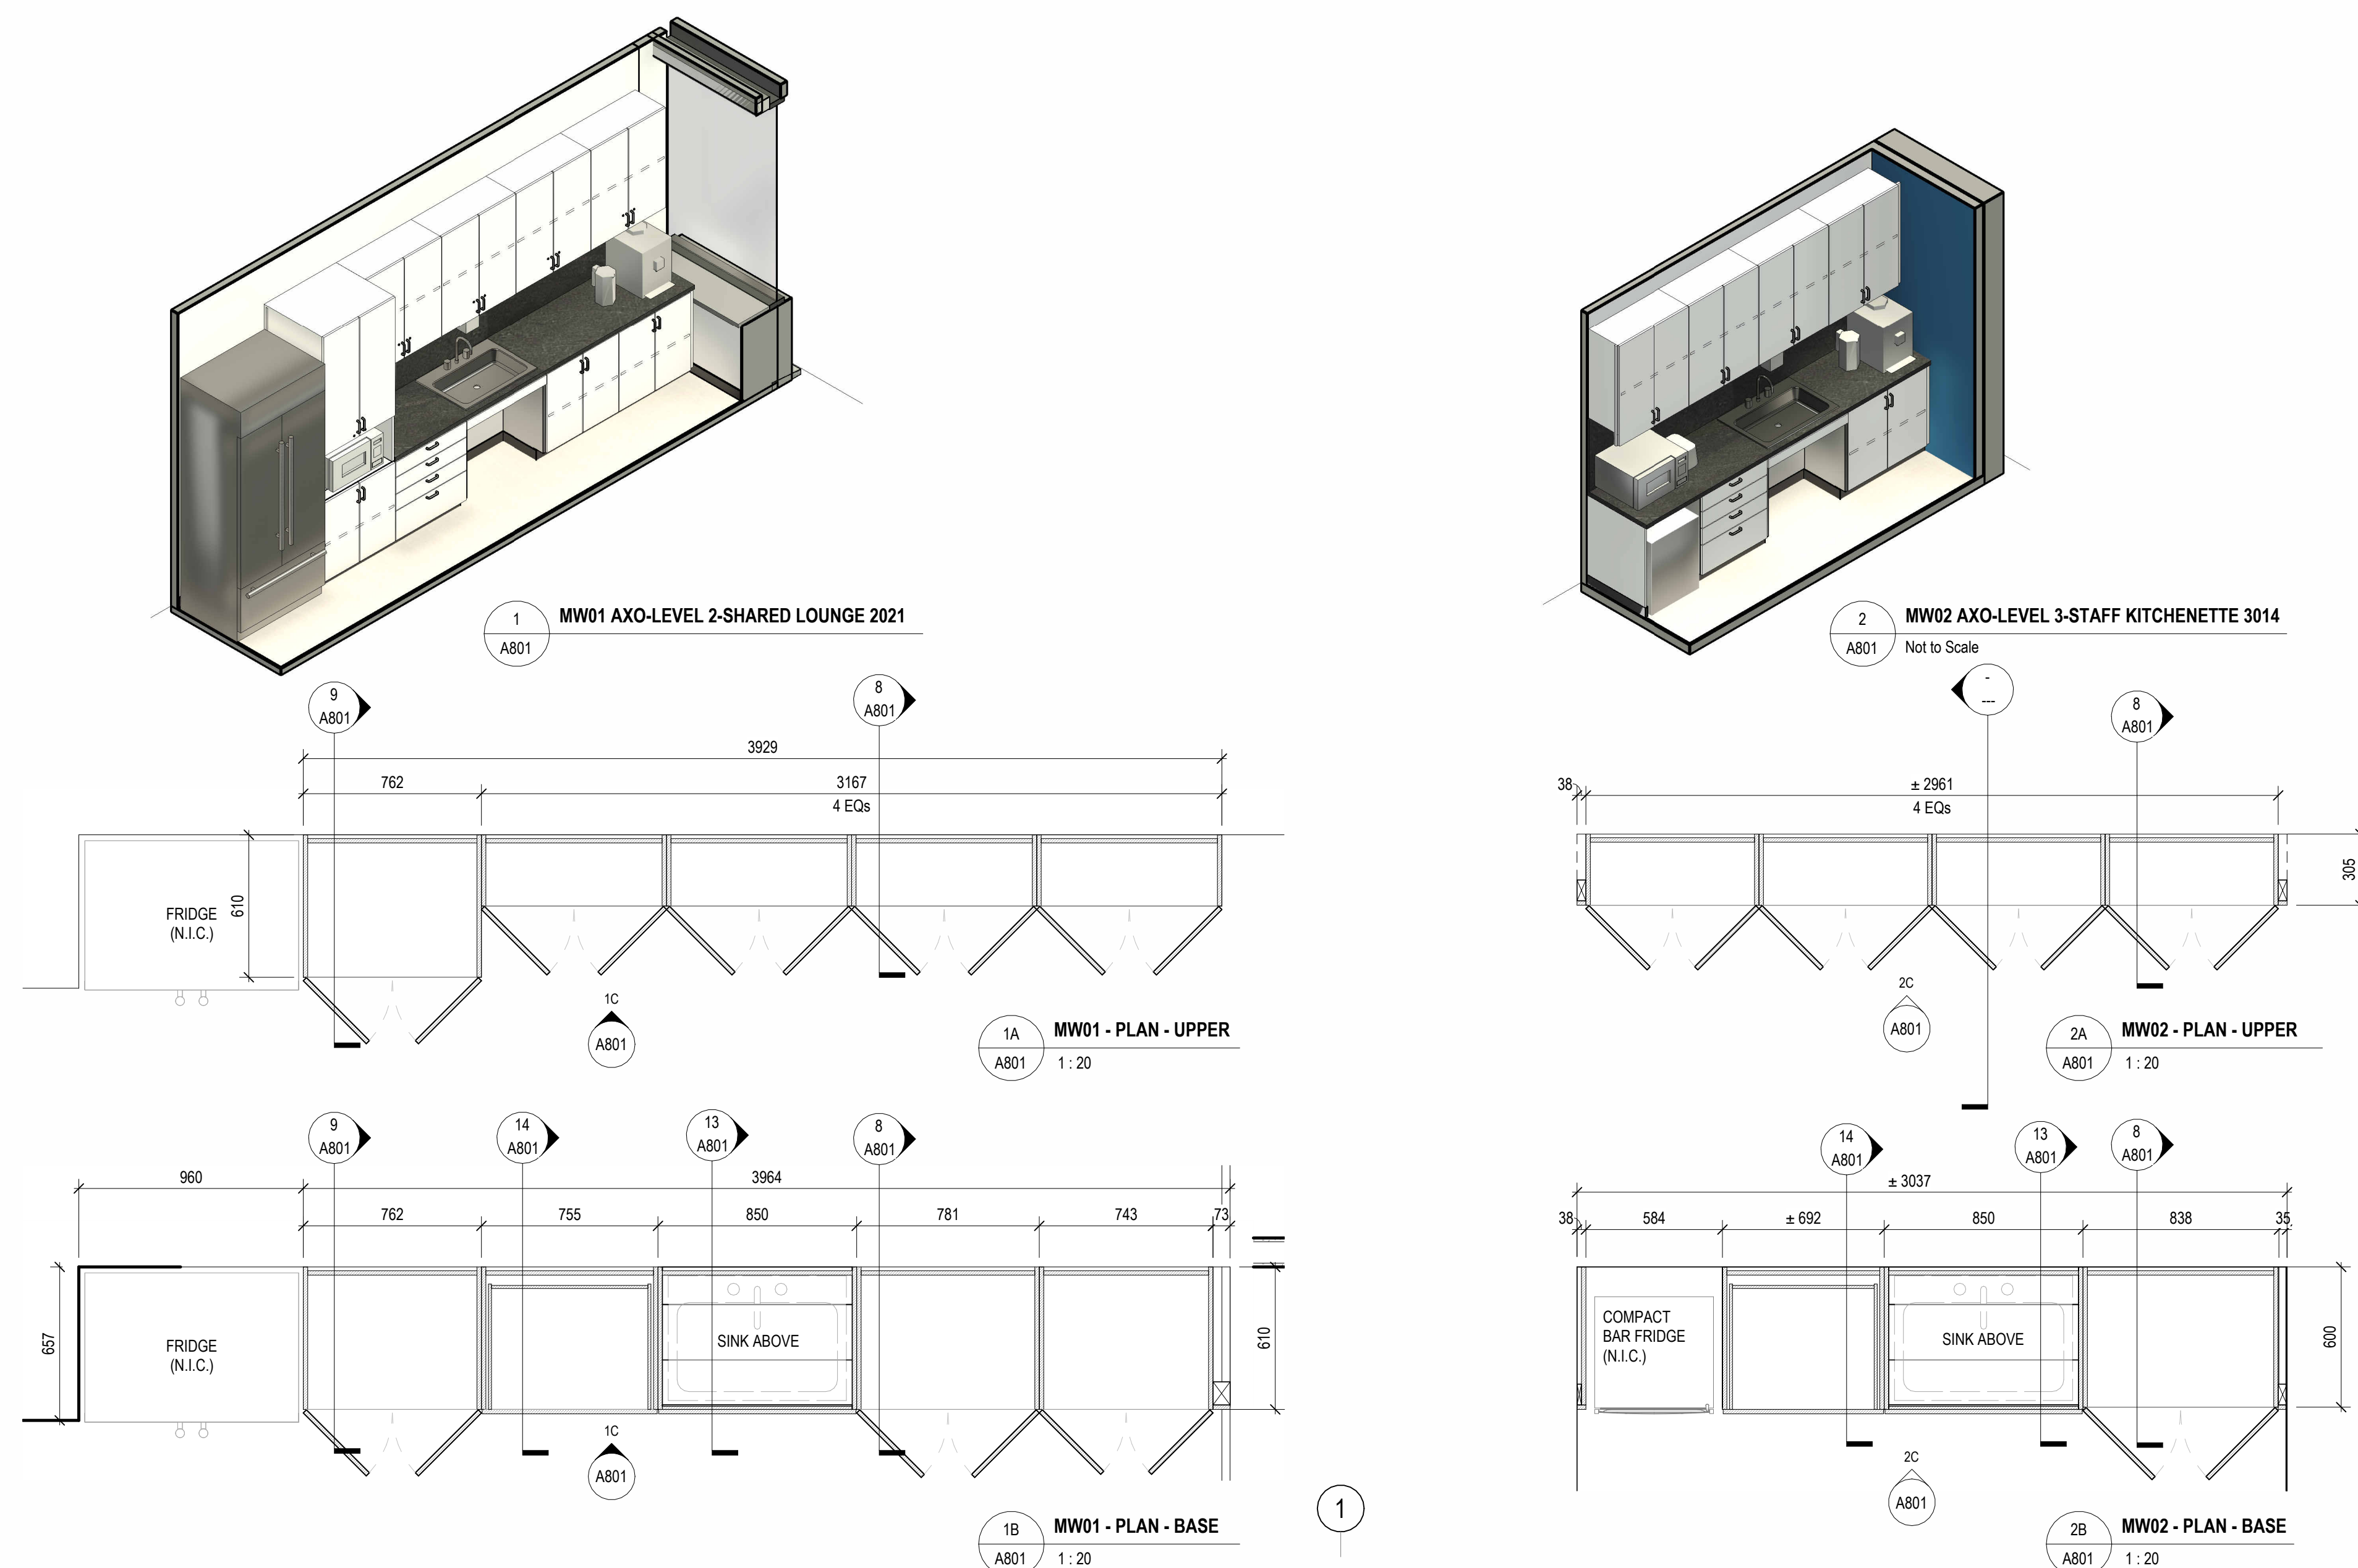



C:\Users\songanin\Documents\P164-25-165\_A\_26\_anita.song.rvt

2026-04-22 11:55:01 AM

ROOM FINISH SCHEDULE											
DL	Level	ROOM NAME	FLOORING	WALL	CEILING	REMARKS					
			FLOORING	WALL	CEILING						
2002	LEVEL 2	MENS WC	EX. EPOXY	EX. COVE	EX. GLUE-IN	SEE WR DETAILS A230 & A231					
2015	LEVEL 2	WOMEN'S WC	EX. EPOXY	EX. COVE	EX. GLUE-IN	SEE WR DETAILS A230 & A231					
2021	LEVEL 2	GRAD STUDENTS RESOURCE ROOM	CP11	WVNL 1	EXIST.	SEE WR DETAILS A230 & A231					
2021	LEVEL 2	SHARED LOUNGE	CP11	WVNL 1	EXIST.	SEE WR DETAILS A230 & A231					
2021A	LEVEL 2	COATS STORAGE	RF 1	WVNL 1	EXIST.	SEE WR DETAILS A230 & A231					
2038	LEVEL 2	MENS EXIST. BF W/C	EX. EPOXY	EX. COVE	EX. GLUE-IN	SEE WR DETAILS A230 & A231					
2040	LEVEL 2	WOMEN'S EXIST. BF W/C	EX. EPOXY	EX. COVE	EX. GLUE-IN	SEE WR DETAILS A230 & A231					
2901	LEVEL 2	CORRIDOR	EXIST.	EXIST.	EXIST.	SEE WR DETAILS A230 & A231					
2902	LEVEL 2	UNDERGRADUATE RESOURCE ROOM	CP11	WVNL 1	EXIST.	SEE WR DETAILS A230 & A231					
2902A	LEVEL 2	COATS STORAGE	RF 1	WVNL 1	EXIST.	SEE WR DETAILS A230 & A231					
2902B	LEVEL 2	ELEC. CL.	EXIST.	EXIST.	EXIST.	SEE WR DETAILS A230 & A231					
2903	LEVEL 2	CORRIDOR	EXIST.	EXIST.	EXIST.	SEE WR DETAILS A230 & A231					
12											
303	LEVEL 3	FACULTY LOUNGE	RF 2	WVNL 1	EXIST.						
304	LEVEL 3	ALL-GENDER EXIST. BF W/C	RF 1	WVNL 1	EXIST.						
306	LEVEL 3	POSTDOC OFFICE	CP11	WVNL 1	EXIST.						
307	LEVEL 3	POSTDOC OFFICE	CP11	WVNL 1	EXIST.						
308	LEVEL 3	POSTDOC OFFICE	CP11	WVNL 1	EXIST.						
310	LEVEL 3	CORRIDOR	RF 1	WVNL 1	EXIST.						
310A	LEVEL 3	ELEC. CL.	WVNL 1	EXIST.	PAINT						
311	LEVEL 3	FACULTY OFFICE	CP11	WVNL 1	EXIST.						
312	LEVEL 3	FACULTY OFFICE	CP11	WVNL 1	EXIST.						
313	LEVEL 3	FACULTY OFFICE	CP11	WVNL 1	EXIST.						
314	LEVEL 3	FACULTY OFFICE	CP11	WVNL 1	EXIST.						
315	LEVEL 3	FACULTY OFFICE	CP11	WVNL 1	EXIST.						
316	LEVEL 3	FACULTY OFFICE	CP11	WVNL 1	EXIST.						
317	LEVEL 3	OPEN LOUNGE	WVNL 1	EXIST.	PAINT						
317K	LEVEL 3	CORRIDOR	EXIST. VCT	WVNL 1	EXIST.						
318	LEVEL 3	CORRIDOR	RF 1	WVNL 1	EXIST.						
319	LEVEL 3	FACULTY OFFICE	CP11	WVNL 1	EXIST.						
320	LEVEL 3	FACULTY OFFICE	CP11	WVNL 1	EXIST.						
321	LEVEL 3	FACULTY OFFICE	CP11	WVNL 1	EXIST.						
322	LEVEL 3	FACULTY OFFICE	CP11	WVNL 1	EXIST.						
323	LEVEL 3	FACULTY OFFICE	CP11	WVNL 1	EXIST.						
324	LEVEL 3	FACULTY OFFICE	CP11	WVNL 1	EXIST.						
325	LEVEL 3	GRADUATE OFFICE	CP11	WVNL 1	EXIST.						
326K	LEVEL 3	CORRIDOR	WVNL 1	EXIST.	PAINT						
327	LEVEL 3	TOUCH-DOWN SPACE	CP11	WVNL 1	EXIST.						
327K	LEVEL 3	CORRIDOR	EXIST. VCT	WVNL 1	EXIST.						
328	LEVEL 3	FACULTY OFFICE	CP11	WVNL 1	EXIST.						
329	LEVEL 3	FACULTY OFFICE	CP11	WVNL 1	EXIST.						
330	LEVEL 3	ALL-GENDER W/C	RF 1	WVNL 1	EXIST.						
331	LEVEL 3	GRADUATE OFFICE	CP11	WVNL 1	EXIST.						
332	LEVEL 3	GRADUATE OFFICE	CP11	WVNL 1	EXIST.						
3001	LEVEL 3	MEETING ROOM 1	CP11	WVNL 1	EXIST.						
3002	LEVEL 3	FACULTY OFFICE	CP11	WVNL 1	EXIST.						
3003	LEVEL 3	FACULTY OFFICE	CP11	WVNL 1	EXIST.						
3004	LEVEL 3	FACULTY OFFICE	CP11	WVNL 1	EXIST.						
3005	LEVEL 3	STAFF OFFICE	CP11	WVNL 1	EXIST.						
3006	LEVEL 3	FACULTY OFFICE	CP11	WVNL 1	EXIST.						
3007A	LEVEL 3	PRINTER ROOM	RF 2	WVNL 1	EXIST.						
3008	LEVEL 3	FACULTY OFFICE	CP11	WVNL 1	EXIST.						
3009	LEVEL 3	MAIN RECEPTION	CP11	WVNL 1	EXIST.						
3011	LEVEL 3	MENS W/C	EX. EPOXY	EX. COVE	EX. GLUE-IN						
3012	LEVEL 3	WOMEN'S W/C	EX. EPOXY	EX. COVE	EX. GLUE-IN						
3013	LEVEL 3	STAFF OFFICE	CP11	WVNL 1	EXIST.						
3014	LEVEL 3	STAFF LOUNGE / KITCHENETTE	RF 2	WVNL 1	EXIST.						
3015	LEVEL 3	FACULTY OFFICE	CP11	WVNL 1	EXIST.						
3016	LEVEL 3	FACULTY OFFICE	CP11	WVNL 1	EXIST.						
3017	LEVEL 3	FACULTY OFFICE	CP11	WVNL 1	EXIST.						
3018	LEVEL 3	FACULTY OFFICE	CP11	WVNL 1	EXIST.						
3019	LEVEL 3	FACULTY OFFICE	CP11	WVNL 1	EXIST.						
3020	LEVEL 3	FACULTY OFFICE	CP11	WVNL 1	EXIST.						
3021	LEVEL 3	MEETING ROOM 2	CP11	WVNL 1	EXIST.						
3022	LEVEL 3	MENS W/C	EX. EPOXY	EX. COVE	EX. GLUE-IN						
3023	LEVEL 3	WOMEN'S W/C	EX. EPOXY	EX. COVE	EX. GLUE-IN						
3023K	LEVEL 3	CORRIDOR	EXIST. VCT	WVNL 1	EXIST.						
3024K	LEVEL 3	CORRIDOR	EXIST. VCT	WVNL 1	EXIST.						
3025	LEVEL 3	GRADUATE OFFICE	CP11	WVNL 1	EXIST.						
3026A	LEVEL 3	JANITOR	RF 1	WVNL 1	EXIST.						
3030	LEVEL 3	SEMINAR ROOM	CP11	WVNL 1	EXIST.						
3033	LEVEL 3	GRADUATE OFFICE	CP11	WVNL 1	EXIST.						
3034	LEVEL 3	POSTDOC OFFICE	CP11	WVNL 1	EXIST.						
3034K	LEVEL 3	CORRIDOR	EXIST. VCT	WVNL 1	EXIST.						
3035	LEVEL 3	GRADUATE OFFICE	CP11	WVNL 1	EXIST.						
3036	LEVEL 3	POSTDOC OFFICE	CP11	WVNL 1	EXIST.						
3039	LEVEL 3	POSTDOC OFFICE	CP11	WVNL 1	EXIST.						
3041	LEVEL 3	GRADUATE OFFICE	CP11	WVNL 1	EXIST.						
3042	LEVEL 3	POSTDOC OFFICE	CP11	WVNL 1	EXIST.						
3043	LEVEL 3	GRADUATE OFFICE	CP11	WVNL 1	EXIST.						
3044	LEVEL 3	GRADUATE OFFICE	CP11	WVNL 1	EXIST.						
3045	LEVEL 3	GRADUATE OFFICE	CP11	WVNL 1	EXIST.						
3045K	LEVEL 3	CORRIDOR	RF 1	WVNL 1	EXIST.						
3046	LEVEL 3	FACULTY OFFICE	CP11	WVNL 1	EXIST.						
3047	LEVEL 3	GRADUATE OFFICE	CP11	WVNL 1	EXIST.						
3048	LEVEL 3	CORRIDOR	EXIST. VCT	WVNL 1	EXIST.						
3049	LEVEL 3	WOMEN'S W/C	EX. EPOXY	EX. COVE	EX. GLUE-IN						
3049K	LEVEL 3	CORRIDOR	EXIST. VCT	WVNL 1	EXIST.						
3056	LEVEL 3	JANITOR	EX. EPOXY	WVNL 1	EXIST.						
306K	LEVEL 3	CORRIDOR	EXIST. VCT	WVNL 1	EXIST.						
3067	LEVEL 3	WOMEN'S W/C	EX. EPOXY	EX. COVE	EX. GLUE-IN						
3068	LEVEL 3	MENS W/C	EX. EPOXY	EX. COVE	EX. GLUE-IN						
3071	LEVEL 3	SCANNING ROOM	RF 2	WVNL 1	EXIST.						
3071K	LEVEL 3	CORRIDOR	RF 2	WVNL 1	EXIST.						
3072	LEVEL 3	GRADUATE OFFICE	CP11	WVNL 1	EXIST.						
3073	LEVEL 3	GRADUATE OFFICE	CP11	WVNL 1	EXIST.						
3074	LEVEL 3	STORAGE	CP11	WVNL 1	EXIST.						
3074K	LEVEL 3	CORRIDOR	RF 1	WVNL 1	EXIST.						
3075	LEVEL 3	TOUCH-DOWN	WVNL 1	EXIST.	PAINT						
3077	LEVEL 3	STORAGE	CP11	WVNL 1	EXIST.						
3078	LEVEL 3	GRADUATE OFFICE	CP11	WVNL 1	EXIST.						
3080	LEVEL 3	FACULTY OFFICE	CP11	WVNL 1	EXIST.						
3081	LEVEL 3	FACULTY OFFICE	CP11	WVNL 1	EXIST.						
3082	LEVEL 3	FACULTY OFFICE	CP11	WVNL 1	EXIST.						
3083	LEVEL 3	FACULTY OFFICE	CP11	WVNL 1	EXIST.						
3084	LEVEL 3	FACULTY OFFICE	CP11	WVNL 1	EXIST.						
3086	LEVEL 3	FACULTY OFFICE	CP11	WVNL 1	EXIST.						
3086K	LEVEL 3	CORRIDOR	RF 2	WVNL 1	EXIST.						
3088	LEVEL 3	FACULTY OFFICE	CP11	WVNL 1	EXIST.						
3089	LEVEL 3	FACULTY OFFICE	CP11	WVNL 1	EXIST.						
3090	LEVEL 3	GRADUATE OFFICE	CP11	WVNL 1	EXIST.						
3090K	LEVEL 3	CORRIDOR	RF 2	WVNL 1	EXIST.						
3091	LEVEL 3	POSTDOC OFFICE	CP11	WVNL 1	EXIST.						
3092	LEVEL 3	POSTDOC OFFICE	CP11	WVNL 1	EXIST.						
3093	LEVEL 3	POSTDOC OFFICE	CP11	WVNL 1	EXIST.						
3094	LEVEL 3	POSTDOC OFFICE	CP11	WVNL 1	EXIST.						
3096	LEVEL 3	POSTDOC OFFICE	CP11	WVNL 1	EXIST.						
3096	LEVEL 3	POSTDOC OFFICE	CP11	WVNL 1	EXIST.						
3106	LEVEL 3	GRADUATE OFFICE	CP11	WVNL 1	EXIST.						
3106A	LEVEL 3	TOUCH-DOWN SPACE	CP11	WVNL 1	EXIST.						
3107	LEVEL 3	MEETING ROOM 3	CP11	WVNL 1	EXIST.						
3107K	LEVEL 3	CORRIDOR	RF 1	WVNL 1	EXIST.						
3108	LEVEL 3	POSTDOC OFFICE	CP11	WVNL 1	EXIST.						
3109	LEVEL 3	POSTDOC OFFICE	CP11	WVNL 1	EXIST.						
3110	LEVEL 3	POSTDOC OFFICE	CP11	WVNL 1	EXIST.						
3111	LEVEL 3	GRADUATE OFFICE	CP11	WVNL 1	EXIST.						
3111A	LEVEL 3	OFFICE STATION	RF 1	WVNL 1	EXIST.						
3900	LEVEL 3	DEPARTMENT LOBBY LOUNGE	RF 2	WVNL 1	EXIST.						
3900K	LEVEL 3	CORRIDOR	RF 1	WVNL 1	EXIST.						
119											
Grand total: 131											


DOOR SCHEDULE																		
DOOR				DOOR				FRAME			DOOR AND FRAME							
Level	DOOR NO.	LOCATION	CONDITION	TYPE	WIDTH	HEIGHT	THICK NESS	MATERIA L	FINISH	FRAME TYPE	FRAME MATERIAL	FRAME FINISH	FIRE RATING	ACCESS CONTROL	CLOSER	DOOR OPERATOR	PANIC HARDWARE	REMARKS
LEVEL 2	2902	UNDERGRADUATE RESOURCE ROOM	New Construction	TYPE E	965	2135	45	HM	PT	1A	HM	PT	-	SALTO	-	-	-	NEW DOOR W TRANSOM
LEVEL 2	2902A	COATS STORAGE	New Construction	TYPE B	1880	2135	45	HM	PT	-	HM	PT	-	KEYED	-	-	-	-
LEVEL 2	2915	GRAD STUDENTS RESOURCE ROOM	Existing	TYPE A	920	2750	EXIST.	EXIST.	PT	EXIST.	EXIST.	PT	-	SALTO	-	-	-	-
LEVEL 2	2915.1	GRAD STUDENTS RESOURCE ROOM	Existing	TYPE A	920	2135	EXIST.	EXIST.	PT	EXIST.	EXIST.	PT	-	SALTO	Y	-	-	-
LEVEL 2	2921	SHARED LOUNGE	Existing	TYPE B	1830	2990	EXIST.	EXIST.	PT	EXIST.	EXIST.	PT	-	SALTO	Y	-	-	-
LEVEL 2	2921A	COATS STORAGE	Existing	TYPE A	815	2750	EXIST.	EXIST.	PT	EXIST.	EXIST.	PT	-	SALTO	-	-	-	-
LEVEL 2	2938	MENS EXIST. BF W/C	Existing	TYPE A	860	2135	EXIST.	EXIST.	PT	EXIST.	EXIST.	PT	-	SALTO	-	Y	-	CONNECT W NEW EMERGENCY CALL SYSTEM EXIST. ALUM. DOOR TO HAVE SALTO ONLY NO KEYED OVERLIE
LEVEL 2	2902.1	UNDERGRADUATE RESOURCE ROOM	Existing	TYPE E	925	2135	EXIST.	EXIST.	ANOD	EXIST.	EXIST. PLASTIC	PT	-	SALTO	Y	-	-	-
LEVEL 2	9																	
LEVEL 3	303	FACULTY LOUNGE	New Construction	TYPE A	965	2135	45	HM	PT	1	HM	PT	-	SALTO	Y	-	-	-
LEVEL 3	310A	ELEC. CL.	New Construction	TYPE B	1016	2135	45	HM	PT	-	HM	PT	-	KEYED	-	-	-	-
LEVEL 3	3007A	PRINTER ROOM	New Construction	TYPE A	965	2135	45	HM	PT	-	1	HM	PT	-	SALTO	-	-	-
LEVEL 3	304	ALL-GENDER EXIST. BF W/C	Existing	TYPE A	865	2135	EXIST.	EXIST.	PT	PT	EXIST.	EXIST.	PT	-	-	-	-	CONNECT W NEW EMERGENCY CALL SYSTEM
LEVEL 3	306	POSTDOC OFFICE	Existing	TYPE A	915	2135	EXIST.	EXIST.	PT	EXIST.	EXIST.	PT	-	SALTO	-	-	-	-
LEVEL 3	307	POSTDOC OFFICE	Existing	TYPE A	914	2135	EXIST.	EXIST.	PT	EXIST.	EXIST.	PT	-	SALTO	-	-	-	-
LEVEL 3	308	POSTDOC OFFICE	Existing	TYPE A	914	2135	EXIST.	EXIST.	PT	EXIST.	EXIST.	PT	-	SALTO	-	-	-	-
LEVEL 3	312	FACULTY OFFICE	Existing	TYPE A	915	2135	EXIST.	EXIST.	PT	EXIST.	EXIST.	PT	-	SALTO	-	-	-	-
LEVEL 3	313	FACULTY OFFICE	Existing	TYPE A	915	2135	EXIST.	EXIST.	PT	EXIST.	EXIST.	PT	-	SALTO	-	-	-	-
LEVEL 3	314	FACULTY OFFICE	Existing	TYPE A	915	2135	EXIST.	EXIST.	PT	EXIST.	EXIST.	PT	-	SALTO	-	-	-	-
LEVEL 3	315	FACULTY OFFICE	Existing	TYPE A	915	2135	EXIST.	EXIST.	PT	EXIST.	EXIST.	PT	-	SALTO	-	-	-	-
LEVEL 3	316	FACULTY OFFICE	Existing	TYPE A	915	2135	EXIST.	EXIST.	PT	EXIST.	EXIST.	PT	-	SALTO	-	-	-	-
LEVEL 3	318	CORRIDOR	Existing	TYPE A	914	2135	EXIST.	EXIST.	PT	EXIST.	EXIST.	PT	-	SALTO	Y	-	-	-
LEVEL 3	319	FACULTY OFFICE	Existing	TYPE A	915	2135	EXIST.	EXIST.	PT	EXIST.	EXIST.	PT	-	SALTO	-	-	-	REMOVE FILM FROM DOOR GLAZING
LEVEL 3	320	FACULTY OFFICE	Existing	TYPE A	915	2135	EXIST.	EXIST.	PT	EXIST.	EXIST.	PT	-	SALTO	-	-	-	-
LEVEL 3	321	FACULTY OFFICE	Existing	TYPE A	915	2135	EXIST.	EXIST.	PT	EXIST.	EXIST.	PT	-	SALTO	-	-	-	-
LEVEL 3	322	FACULTY OFFICE	Existing	TYPE A	915	2135	EXIST.	EXIST.	PT	EXIST.	EXIST.	PT	-	SALTO	-	-	-	-
LEVEL 3	323	FACULTY OFFICE	Existing	TYPE A	915	2135	EXIST.	EXIST.	PT	EXIST.	EXIST.	PT	-	SALTO	-	-	-	-
LEVEL 3	324	FACULTY OFFICE	Existing	TYPE A	915	2135	EXIST.	EXIST.	PT	EXIST.	EXIST.	PT	-	SALTO	-	-	-	-
LEVEL 3	325	GRADUATE OFFICE	Existing	TYPE A	915	2135	EXIST.	EXIST.	PT	EXIST.	EXIST.	PT	-	SALTO	-	-	-	-
LEVEL 3	327	TOUCHDOWN SPACE	Existing	TYPE A	914	2135	EXIST.	EXIST.	PT	EXIST.	EXIST.	PT	-	SALTO	-	-	-	-
LEVEL 3	327.1	TOUCHDOWN SPACE	Existing	TYPE A	865	2135	EXIST.	EXIST.	PT	EXIST.	EXIST.	PT	-	SALTO	-	-	-	-
LEVEL 3	327K	CORRIDOR	Existing	TYPE F	915	2135	EXIST.	EXIST.	PT	EXIST.	EXIST.	PT	-	SALTO	Y	Y	-	REMOVE FILM FROM DOOR GLAZING PAINT CORRIDOR SIDE OF DOOR AND FRAME ONLY
LEVEL 3	327S	STAR	Existing	TYPE A	1118	2135	EXIST.	EXIST.	PT	EXIST.	EXIST.	PT	-	EXIST.	SALTO	-	EXIST.	-
LEVEL 3	328	FACULTY OFFICE	Existing	TYPE A	915	2135	EXIST.	EXIST.	PT	EXIST.	EXIST.	PT	-	SALTO	-	-	-	-
LEVEL 3	329	GRAD-SERVICES	Existing	TYPE A	915	2135	EXIST.	EXIST.	PT	EXIST.	EXIST.	PT	-	SALTO	-	-	-	-
LEVEL 3	331	GRADUATE OFFICE	Existing	TYPE A	864	2135	EXIST.	EXIST.	PT	EXIST.	EXIST.	PT	-	SALTO	-	-	-	EXIST. HWDR. TO REMAIN
LEVEL 3	333	GRADUATE OFFICE	Existing	TYPE A	915	2135	EXIST.	EXIST.	PT	EXIST.	EXIST.	PT	-	SALTO	-	-	-	-
LEVEL 3	334	GRADUATE OFFICE	Existing	TYPE F	914	2135	EXIST.	EXIST.	PT	EXIST.	EXIST.	PT	-	SALTO	-	-	-	-
LEVEL 3	3001	MEETING ROOM 1	Existing	TYPE A	915	2135	EXIST.	EXIST.	PT	EXIST.	EXIST.	PT	-	SALTO	-	-	-	REMOVE FILM FROM DOOR GLAZING
LEVEL 3	3001.1	MEETING ROOM 1	Existing	TYPE A	864	2135	EXIST.	EXIST.	PT	EXIST.	EXIST.	PT	-	SALTO	-	-	-	-
LEVEL 3	3015	STAR	Existing	TYPE A	1118	2135	EXIST.	EXIST.	PT	EXIST.	EXIST.	PT	-	EXIST.	SALTO	Y	-	PAINT CORRIDOR SIDE OF DOOR AND FRAME ONLY
LEVEL 3	3002	FACULTY OFFICE	Existing	TYPE A	864	2135	EXIST.	EXIST.	PT	EXIST.	EXIST.	PT	-	SALTO	-	-	-	-
LEVEL 3	3003	FACULTY OFFICE	Existing	TYPE A	864	2135	EXIST.	EXIST.	PT	EXIST.	EXIST.	PT	-	SALTO	-	-	-	-
LEVEL 3	3004	FACULTY OFFICE	Existing	TYPE A	864	2135	EXIST.	EXIST.	PT	EXIST.	EXIST.	PT	-	SALTO	-	-	-	-
LEVEL 3	3005	STAFF OFFICE	Existing	TYPE A	864	2135	EXIST.	EXIST.	PT	EXIST.	EXIST.	PT	-	SALTO	-	-	-	-
LEVEL 3	3006	FACULTY OFFICE	Existing	TYPE A	864	2135	EXIST.	EXIST.	PT	EXIST.	EXIST.	PT	-	SALTO	-	-	-	-
LEVEL 3	3008	FACULTY OFFICE	Existing	TYPE A	864	2135	EXIST.	EXIST.	PT	EXIST.	EXIST.	PT	-	SALTO	-	-	-	-
LEVEL 3	3009	MAN RECEPTION	Existing	TYPE A	864	2135	EXIST.	EXIST.	PT	EXIST.	EXIST.	PT	-	SALTO	-	-	-	-
LEVEL 3	3013	STAFF OFFICE	Existing	TYPE A	864	2135	EXIST.	EXIST.	PT	EXIST.	EXIST.	PT	-	SALTO	-	-	-	-
LEVEL 3	3014	STAFF LOUNGE / KITCHENETTE	Existing	TYPE A	864	2135	EXIST.	EXIST.	PT	EXIST.	EXIST.	PT	-	SALTO	-	-	-	-
LEVEL 3	3015	FACULTY OFFICE	Existing	TYPE A	864	2135	EXIST.	EXIST.	PT	EXIST.	EXIST.	PT	-	SALTO	-	-	-	-
LEVEL 3	3016	FACULTY OFFICE	Existing	TYPE A	864	2135	EXIST.	EXIST.	PT	EXIST.	EXIST.	PT	-	SALTO	-	-	-	-
LEVEL 3	3017	FACULTY OFFICE	Existing	TYPE A	864	2135	EXIST.	EXIST.	PT	EXIST.	EXIST.	PT	-	SALTO	-	-	-	-
LEVEL 3	3018	FACULTY OFFICE	Existing	TYPE A	864	2135	EXIST.	EXIST.	PT	EXIST.	EXIST.	PT	-	SALTO	-	-	-	-
LEVEL 3	3019	FACULTY OFFICE	Existing	TYPE A	864	2135	EXIST.	EXIST.	PT	EXIST.	EXIST.	PT	-	SALTO	-	-	-	-
LEVEL 3	3020	FACULTY OFFICE	Existing	TYPE A	864	2135	EXIST.	EXIST.	PT	EXIST.	EXIST.	PT	-	SALTO	-	-	-	-
LEVEL 3	3021	MEETING ROOM 2	Existing	TYPE A	864	2135	EXIST.	EXIST.	PT	EXIST.	EXIST.	PT	-	SALTO	-	-	-	-
LEVEL 3	3021S	STAR	Existing	TYPE A	1041	2135	EXIST.	EXIST.	PT	EXIST.	EXIST.	PT	-	EXIST.	SALTO	Y	-	PAINT CORRIDOR SIDE OF DOOR AND FRAME ONLY
LEVEL 3	3022	MENS W/C	Existing	TYPE A	737	2135	EXIST.	EXIST.	PT	EXIST.	EXIST.	PT	-	SALTO	-	-	-	-
LEVEL 3	3023	WOMENS W/C	Existing	TYPE A	737	2135	EXIST.	EXIST.	PT	EXIST.	EXIST.	PT	-	SALTO	-	-	-	-
LEVEL 3	3026	GRADUATE OFFICE	Existing	TYPE A	914	2135	EXIST.	EXIST.	PT	EXIST.	EXIST.	PT	-	SALTO	-	-	-	-
LEVEL 3	3027	JAN. OFFICE	Existing	TYPE A	864	2135	EXIST.	EXIST.	PT	EXIST.	EXIST.	PT	-	EXIST.	SALTO	-	-	-
LEVEL 3	3030.1	SEMINAR ROOM	Existing	TYPE A	813	2135	EXIST.	EXIST.	PT	EXIST.	EXIST.	PT	-	SALTO	-	-	-	-
LEVEL 3	3030.2	SEMINAR ROOM	Existing	TYPE A	910	2135	EXIST.	EXIST.	PT	EXIST.	EXIST.	PT	-	SALTO	-	-	-	-
LEVEL 3	3033	GRADUATE OFFICE	Existing	TYPE D	1110	2135	EXIST.	EXIST.	PT	EXIST.	EXIST.	PT	-	SALTO	-	-	-	DOOR TO BE LOCKED OFF
LEVEL 3	3033A	DECOM W/C	Existing	TYPE B	762	2135	EXIST.	EXIST.	PT	EXIST.	EXIST.	PT	-	SALTO	-	-	-	-
LEVEL 3	3034	POSTDOC OFFICE	Existing	TYPE D	1110	2135	EXIST.	EXIST.	PT	EXIST.	EXIST.	PT	-	SALTO	-	-	-	DOOR TO BE LOCKED OFF
LEVEL 3	3034A	DECOM W/C	Existing	TYPE B	762	2135	EXIST.	EXIST.	PT	EXIST.	EXIST.	PT	-	SALTO	-	-	-	DOOR TO BE LOCKED OFF
LEVEL 3	3037	GRADUATE OFFICE	Existing	TYPE A	914	2135	EXIST.	EXIST.	PT	EXIST.	EXIST.	PT	-	SALTO	-	-	-	-
LEVEL 3	3037.2	GRADUATE OFFICE	Existing	TYPE A	815	2135	EXIST.	EXIST.	PT	EXIST.	EXIST.	PT	-	SALTO	-	-	-	DOOR TO BE LOCKED OFF
LEVEL 3	3038	POSTDOC OFFICE	Existing	TYPE D	1110	2135	EXIST.	EXIST.	PT	EXIST.	EXIST.	PT	-	SALTO	-	-	-	-
LEVEL 3	3038A	DECOM W/C	Existing	TYPE B	762	2135	EXIST.	EXIST.	PT	EXIST.	EXIST.	PT	-	SALTO	-	-	-	DOOR TO BE LOCKED OFF
LEVEL 3	3039	POSTDOC OFFICE	Existing	TYPE D	1110	2135	EXIST.	EXIST.	PT	EXIST.	EXIST.	PT	-	SALTO	-	-	-	DOOR TO BE LOCKED OFF
LEVEL 3	3039A	DECOM W/C	Existing	TYPE B	762	2135	EXIST.	EXIST.	PT	EXIST.	EXIST.	PT	-	SALTO	-	-	-	DOOR TO BE LOCKED OFF
LEVEL 3	3041	GRADUATE OFFICE	Existing	TYPE A	914	2135	EXIST.	EXIST.	PT	EXIST.	EXIST.	PT	-	SALTO	-	-	-	-
LEVEL 3	3041.2	GRADUATE OFFICE	Existing	TYPE A	864	2135	EXIST.	EXIST.	PT	EXIST.	EXIST.	PT	-	SALTO	-	-	-	-
LEVEL 3	3042	POSTDOC OFFICE	Existing	TYPE D	1110	2135	EXIST.	EXIST.	PT	EXIST.	EXIST.	PT	-	SALTO	-	-	-	-
LEVEL 3	3042A	DECOM W/C	Existing	TYPE B	762	2135	EXIST.	EXIST.	PT	EXIST.	EXIST.	PT	-	SALTO	-	-	-	DOOR TO BE LOCKED OFF
LEVEL 3	3043	GRADUATE OFFICE	Existing	TYPE A	914	2135	EXIST.	EXIST.	PT	EXIST.	EXIST.	PT	-	SALTO	-	-	-	-
LEVEL 3	3043.2	GRADUATE OFFICE	Existing	TYPE A	914	2135	EXIST.	EXIST.	PT	EXIST.	EXIST.	PT	-	SALTO	-	-	-	-
LEVEL 3	3044	FACULTY OFFICE	Existing	TYPE D	1110	2135	EXIST.	EXIST.	PT	EXIST.	EXIST.	PT	-	SALTO	-	-	-	DOOR TO BE LOCKED OFF
LEVEL 3	3044A	DECOM W/C	Existing	TYPE C	762	2135	EXIST.	EXIST.	PT	EXIST.	EXIST.	PT	-	SALTO	-	-	-	-
LEVEL 3	3045	FACULTY OFFICE	Existing	TYPE A	864	2135	EXIST.	EXIST.	PT	EXIST.	EXIST.	PT	-	SALTO	-	-	-	-
LEVEL 3	3046	FACULTY OFFICE	Existing	TYPE D	1110	2135	EXIST.	EXIST.	PT	EXIST.	EXIST.	PT	-	SALTO	-	-	-	DOOR TO BE LOCKED OFF
LEVEL 3	3046A	DECOM W/C	Existing	TYPE B	762	2135	EXIST.	EXIST.	PT	EXIST.	EXIST.	PT	-	SALTO	-	-	-	DOOR TO BE LOCKED OFF
LEVEL 3	3047	GRADUATE OFFICE	Existing	TYPE A	914	2135	EXIST.	EXIST.	PT	EXIST.	EXIST.	PT	-	SALTO	-	-	-	-
LEVEL 3	3047A	DECOM W/C	Existing	TYPE C	762	2135	EXIST.	EXIST.	PT	EXIST.	EXIST.	PT	-	SALTO	-	-	-	DOOR TO BE LOCKED OFF
LEVEL 3	3048	GRADUATE OFFICE	Existing	TYPE A	915	2135	EXIST.	EXIST.	PT	EXIST.	EXIST.	PT	-	SALTO	-	-	-	-
LEVEL 3	3048S	STAR	Existing	TYPE A	1067	2135	EXIST.	EXIST.	PT	EXIST.	EXIST.	PT	-	EXIST.	SALTO	Y	-	PAINT CORRIDOR SIDE OF DOOR AND FRAME ONLY
LEVEL 3	3066	JANITOR	Existing	TYPE A	762	2135	EXIST.	EXIST.	PT	EXIST.	EXIST.	PT	-	EXIST.	KEYED	-	-	-
LEVEL 3	3066K	CORRIDOR	Existing	TYPE F	914	2135	EXIST.	EXIST.	PT	EXIST.	EXIST.	PT	-	SALTO	-	Y	Y	-
LEVEL 3	3071	SCANNING ROOM	Existing	TYPE A	865	2135	EXIST.	EXIST.	PT	EXIST.	EXIST.	PT	-	SALTO	-	-	-	-
LEVEL 3	3072	GRADUATE OFFICE	Existing	TYPE A	865	2135	EXIST.	EXIST.	PT	EXIST.	EXIST.	PT	-	SALTO	-	-	-</	





255 McCaul Street, 4th Floor, Toronto, Ontario M5T 1W7

This drawing is the property of the University of Toronto, and must be returned upon completion of the work. All information shown on this drawing is for use on this specific project. Contractor must verify all dimensions on the job and report any discrepancies to the Architect before proceeding with the work.

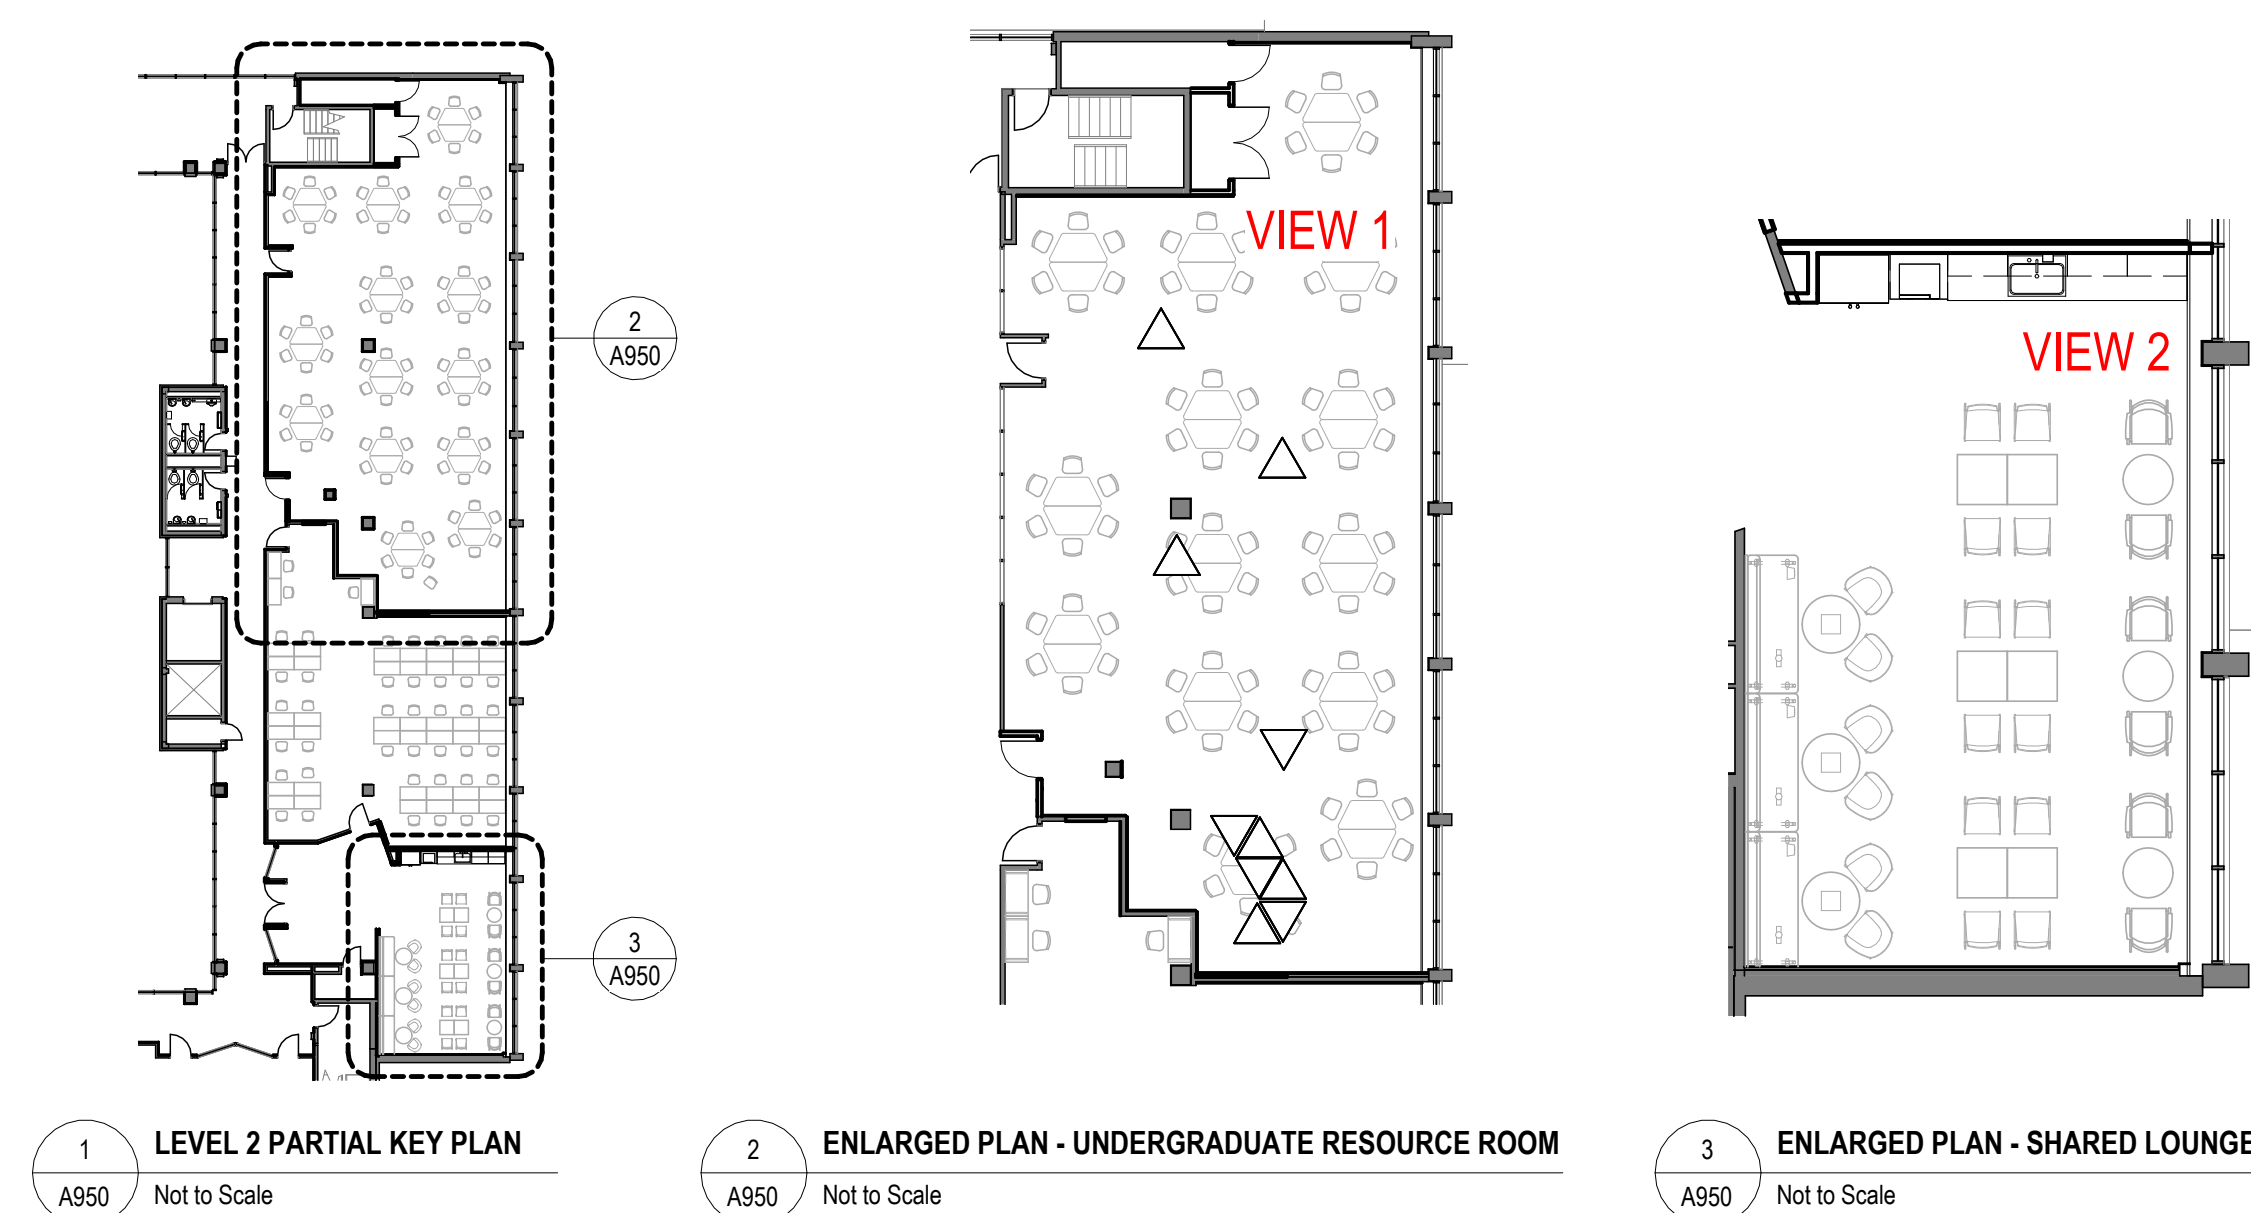

### VIEW 1: Undergraduate Resource Room



### VIEW 2: Shared Lounge



6	ISSUED FOR TENDER	2026-04-22
5	ISSUED FOR 80% CD	2026-03-09
4	ISSUED FOR CLASS A COSTING	2026-02-18
3	ISSUED FOR 100% DD	2026-01-23
2	ISSUED FOR CLASS B COSTING	2026-01-16
1	ISSUED FOR 50% DD	2025-11-28
REV.	DESCRIPTION	DATE

KEY PLAN (NTS)	SEAL
----------------	------

PROJECT TITLE:  
UNIVERSITY OF TORONTO  
**33 URSULA FRANKLIN  
MATH OFFICE  
RENOVATION**




33 URSULA FRANKLIN ST.  
DRAWING SHEET TITLE  
**LEVEL 2 RENDERINGS**

DRAWN BY: Author	SCALE: As indicated
REVIEWED BY: Checker	DATE CREATED: 2026/02/11
UNIVERSITY PROJECT NUMBER	NORTH POINT

DRAWING NUMBER	REV. NUMBER
<b>A950</b>	<b>6</b>



C:\Users\songanin\Documents\IP164-25-165\_A\_26\_anita\_song.rvt 2026-04-22 11:55:14 AM

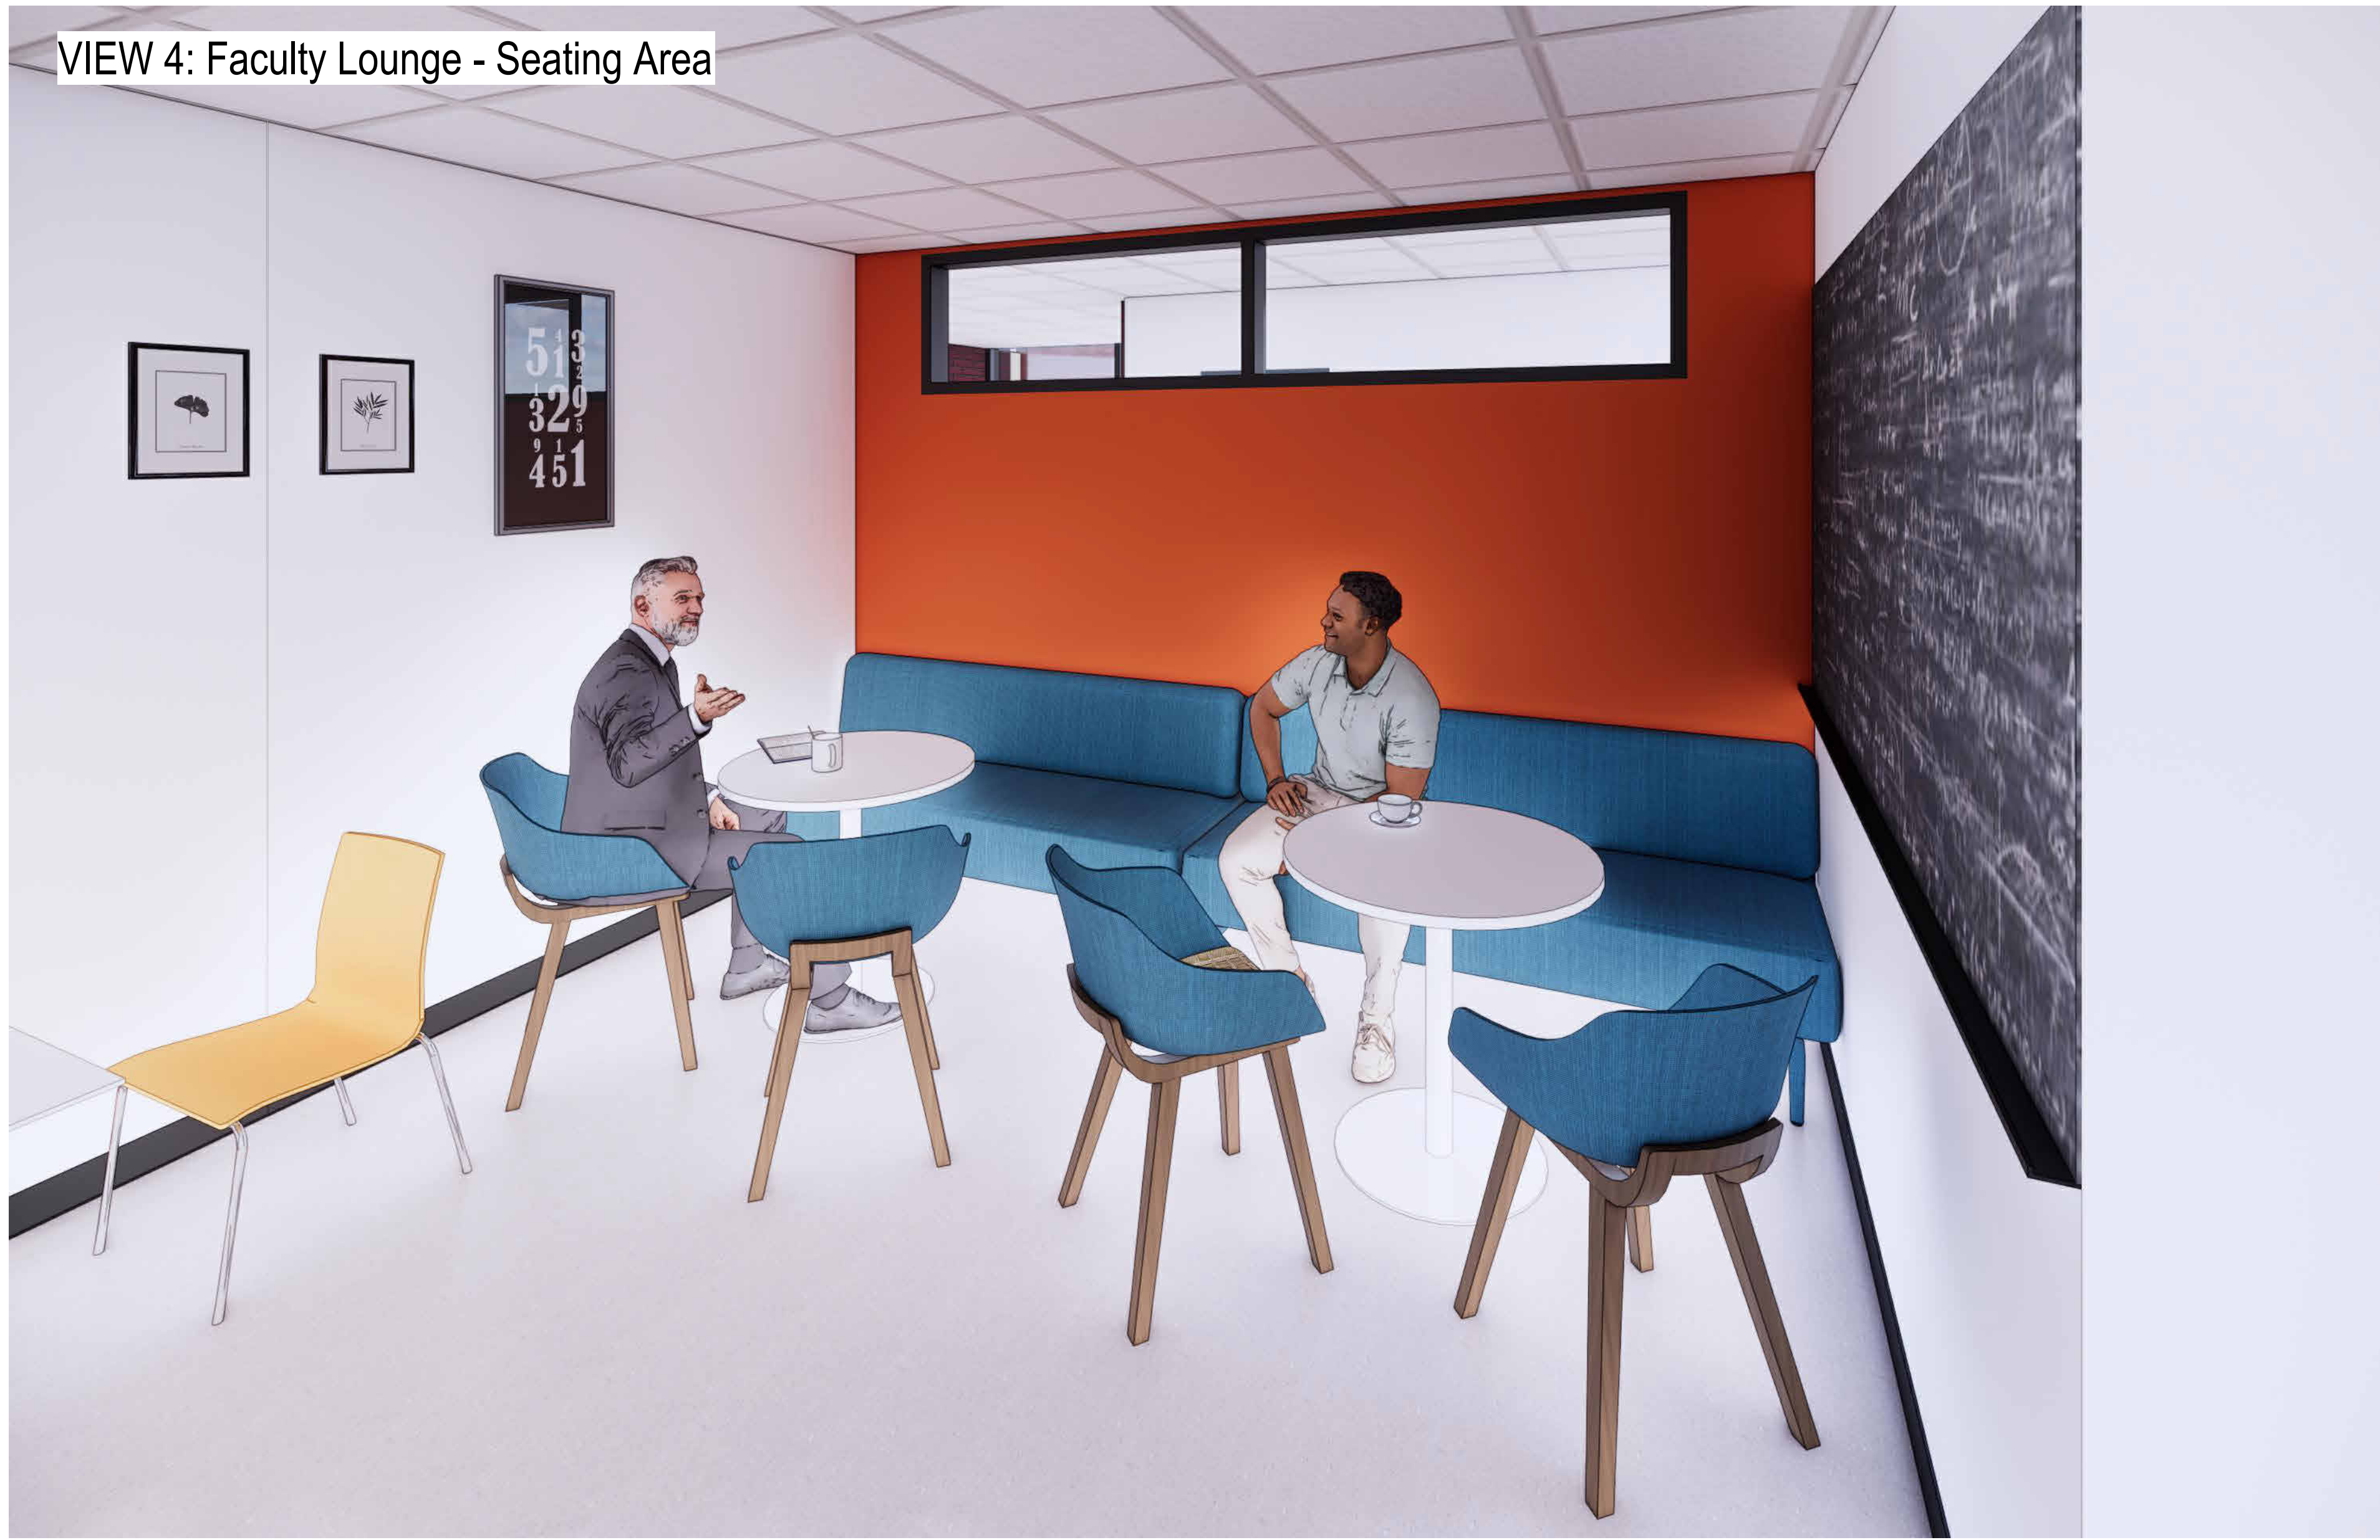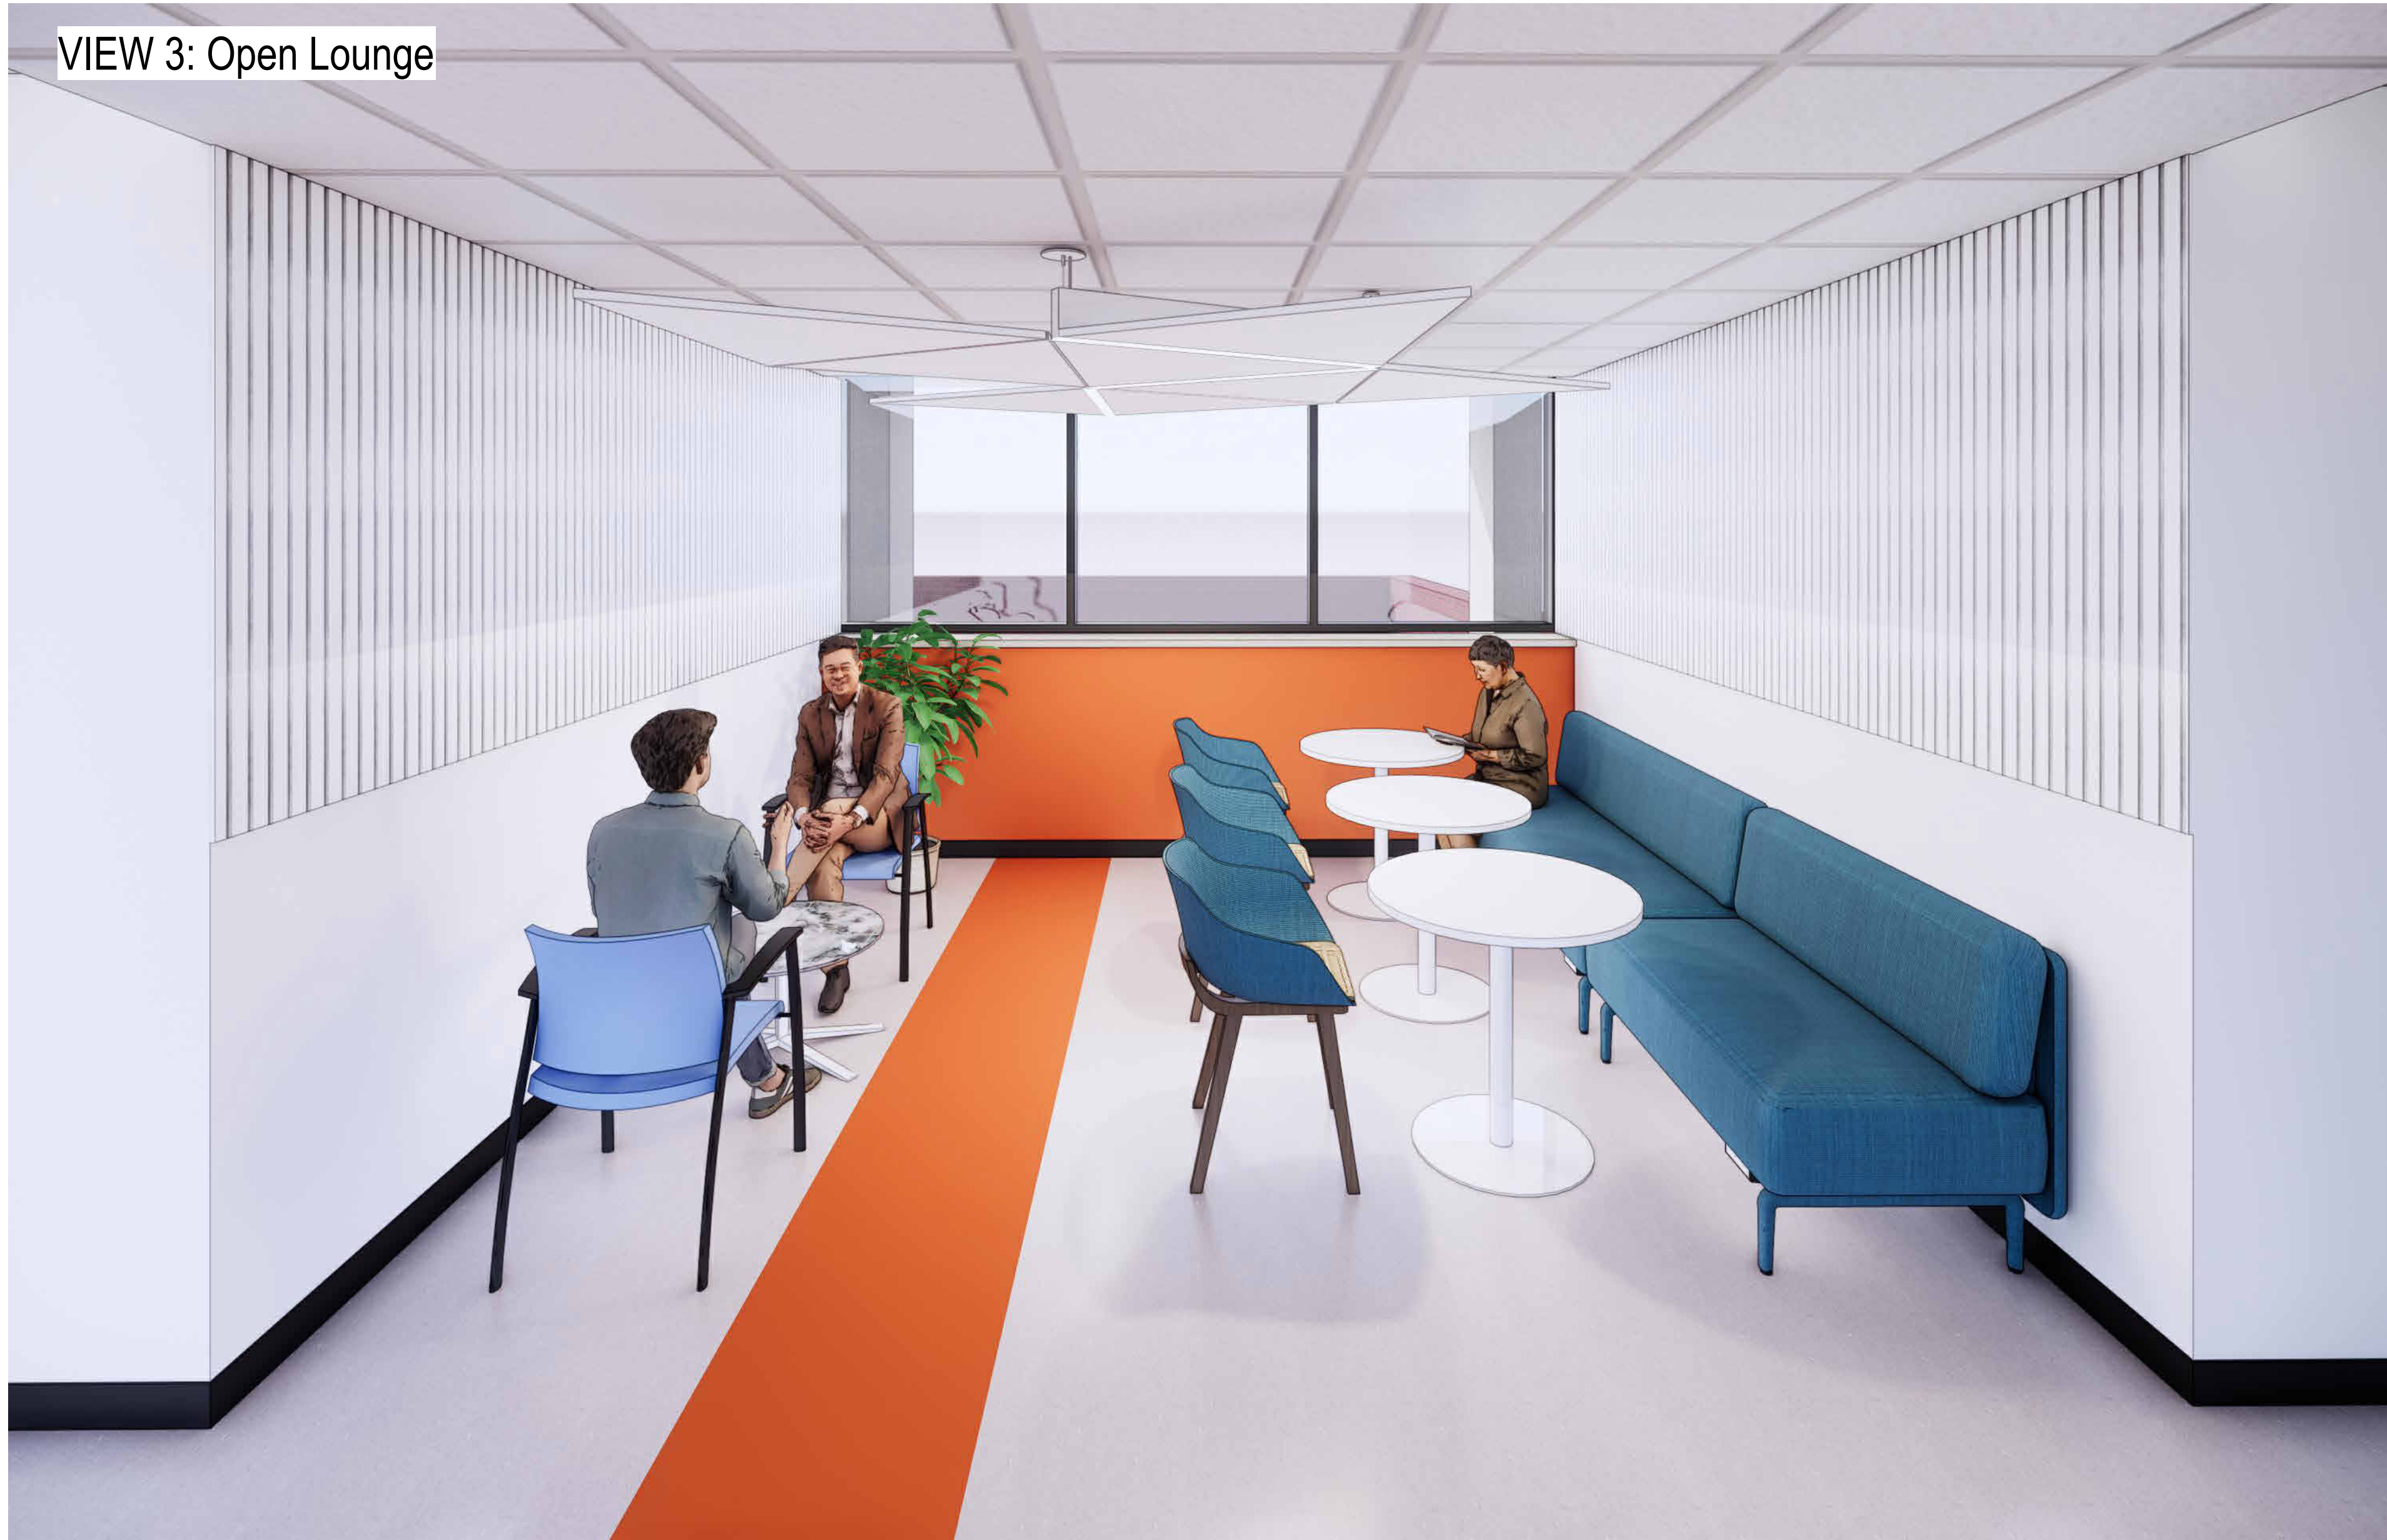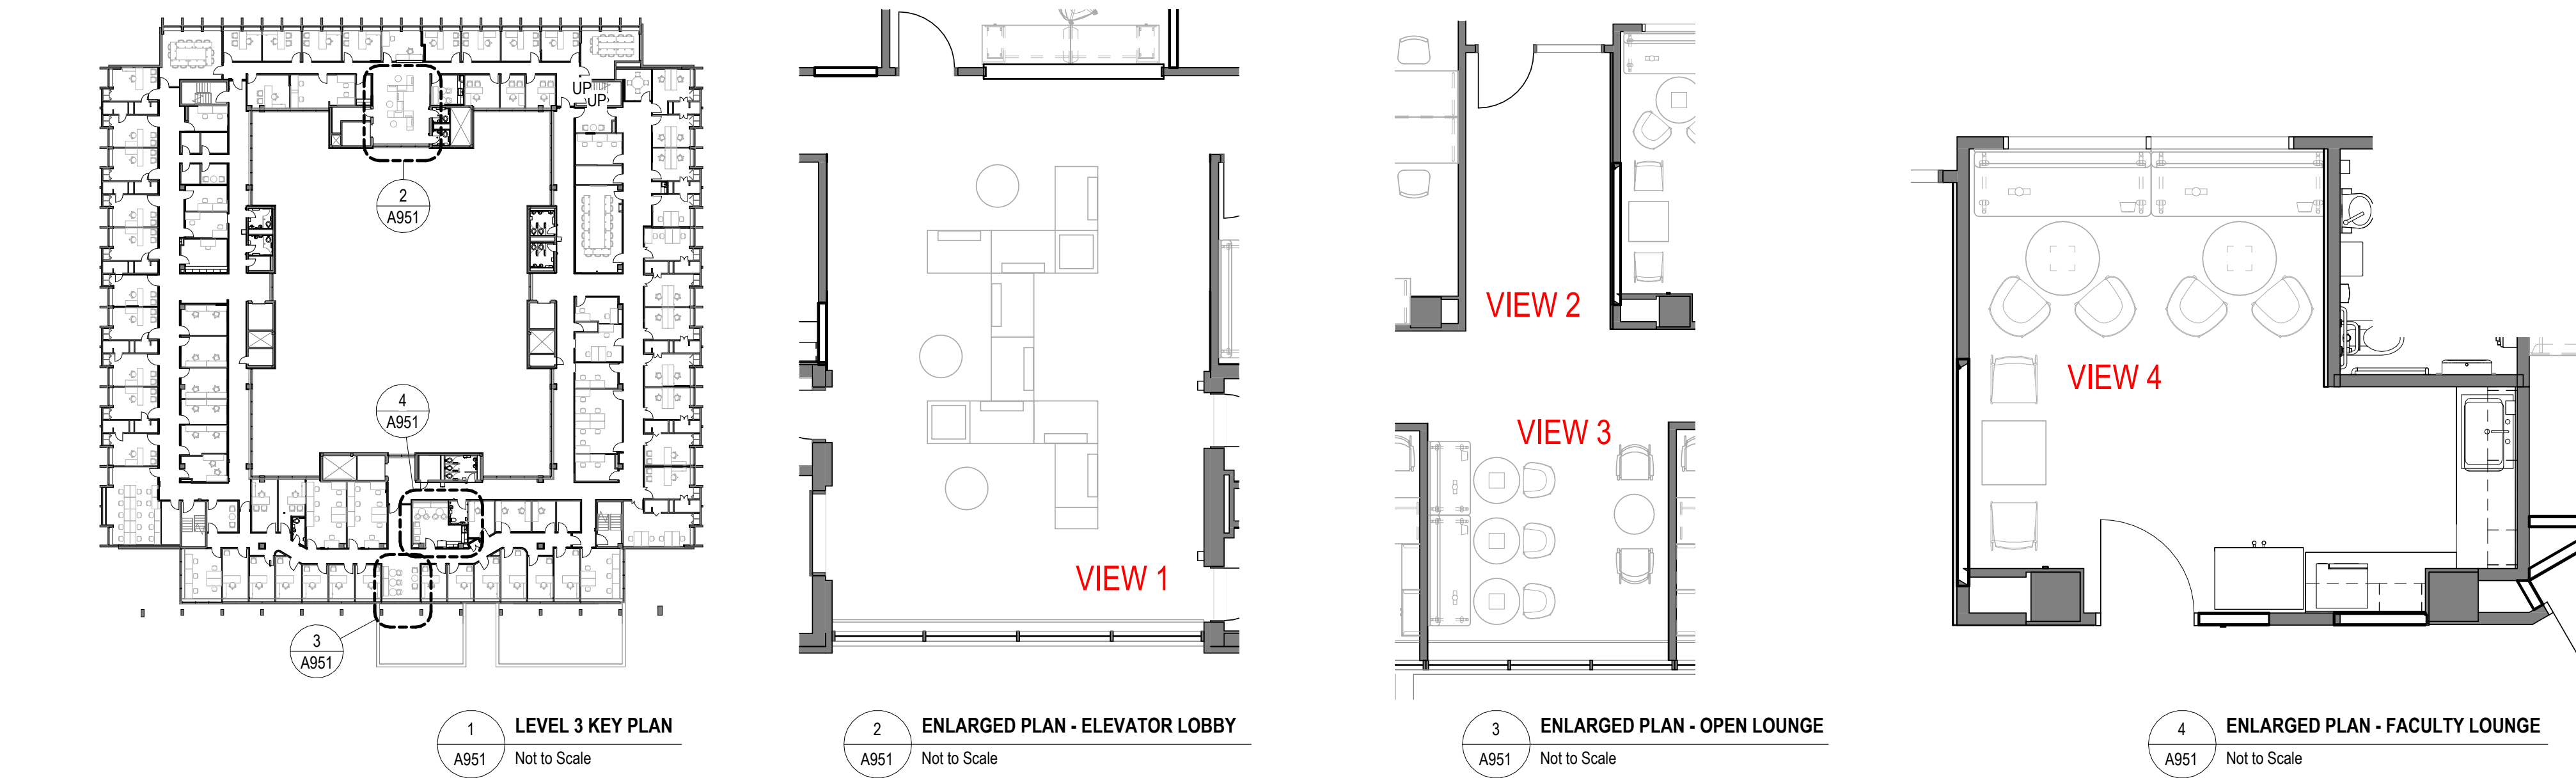

5	ISSUED FOR TENDER	2026-04-22
4	ISSUED FOR CLASS A COSTING	2026-02-18
3	ISSUED FOR 100% DD	2026-01-23
2	ISSUED FOR CLASS B COSTING	2026-01-18
1	ISSUED FOR 90% DD	2025-11-08
REV.	DESCRIPTION	DATE

KEY PLAN (NTS)	SEAL
----------------	------

PROJECT TITLE  
UNIVERSITY OF TORONTO  
**33 URSULA FRANKLIN  
MATH OFFICE  
RENOVATION**

33 URSULA FRANKLIN ST.  
DRAWING SHEET TITLE  
**LEVEL 3 RENDERINGS**

DRAWN BY: Author  
REVIEWED BY: Checker  
UNIVERSITY PROJECT NUMBER NORTH POINT  
P164-24-165

DRAWING NUMBER  
**A951**  
REV. NUMBER  
**5**