

CITY OF TORONTO

ACCESSIBILITY UPGRADES

GROUP 5

9119- 19- 0162 / Arcadis 30279056

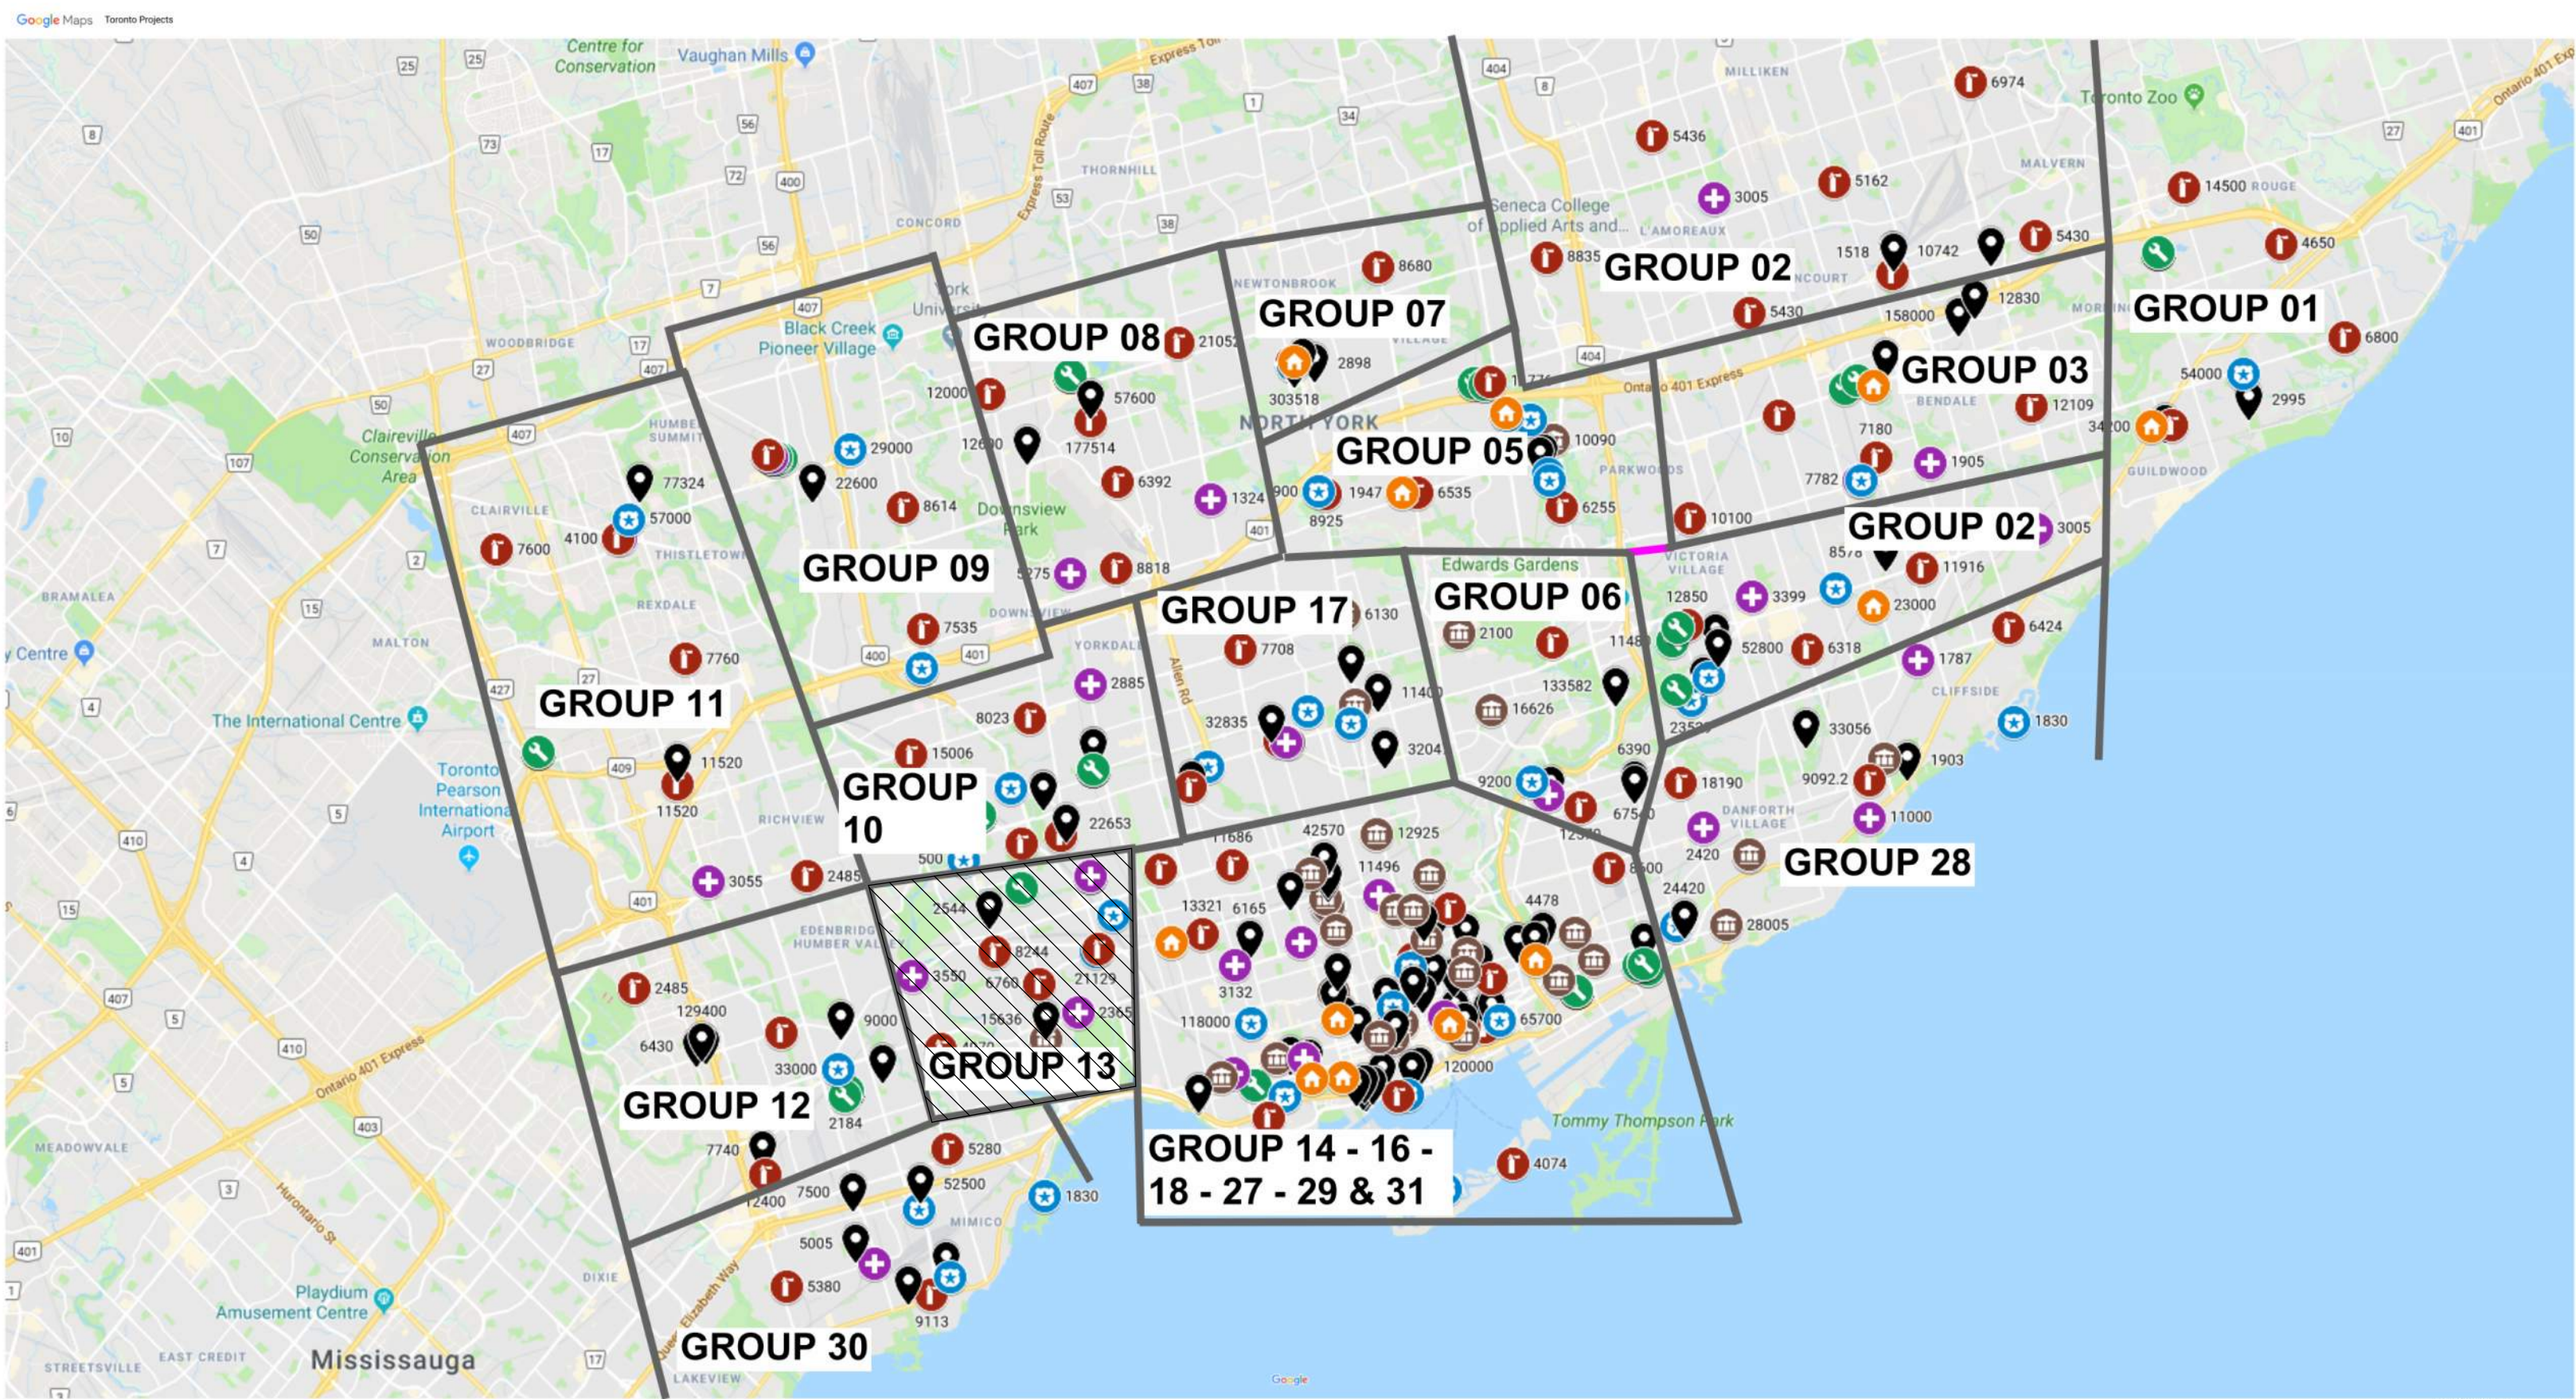


IMAGE SOURCES: GOOGLE MAPS

COVER PAGE GROUP 05	
SHEET #	SHEET TITLE
G05-GAL-G1001	COVER PAGE, GENERAL DRAWING LIST, BUILDING LIST

GENERAL LAYOUTS GROUP 05	
SHEET #	SHEET TITLE
G05-GAL-G1002	ARCHITECTURAL GENERAL NOTES, ABBREVIATIONS & REFERENCE SYMBOLS
G05-GAL-G1003	WALL TYPES
G05-GAL-G1004	DOOR TYPES
G05-GAL-G2001	STRUCTURAL GENERAL NOTES
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G05-GAL-G3002	MECHANICAL LEGEND SHEET 2 OF 2
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GROUP 05 BUILDING INDEX		
SERIAL #	BUILDING ADDRESS	BUILDING DESCRIPTION
1	10 WILLIAM CARSON CRESCENT	FIRE HALL NO. 121
10	1026 FINCH AVE. W	FINCH YARD BLDG A
30	125 MOATFIELD DR	DAVID DUNCAN HOUSE - RESTAURANT
48	14 DYAS RD	CITY CLERK'S RECORDS CENTRE
59	143 BOND AVE.	FIRE HALL NO. 123
83	160 DUNCAN MILL RD.	BUILDING
143	2545 BAYVIEW AVE.	FIRE HALL NO. 122
175	300 LESMILL RD.	BUILDING
249	50 UPJOHN RD.	POLICE NO. 33 DIVISION

TOUCH AND FEEL BOOKLET

TYPICAL DETAILS BOOKLET

NOT FOR CONSTRUCTION

ISSUED FOR TENDER

CITY OF TORONTO



55 John ST.
TORONTO, ON
M5V 3C6

ISSUES		
No.	DESCRIPTION	DATE
A	50% SUBMISSION	2022-01-20
B	90% SUBMISSION	2022-02-22
C	ISSUED FOR PERMIT	2022-03-18
D	ISSUED FOR TENDER	2025-04-11

PRIME CONSULTANT

ARCADIS

100 - 175 Galaxy Blvd,
Toronto, ON M9W 0C9, Canada
tel 416 679 1930
www.arcadis.com


PROJECT NO: 9119- 19- 0162 / Arcadis 30279056	
DATE: 2025-04-11	
SHEET NUMBER G05-GAL-G0001	ISSUE D

ABBREVIATIONS


@	AT	ECB	EMERGENCY CALL BUTTON	LNS	LINOLEUM SHEET	RS	RUBBER SHEET FLOORING
A	ANGLE	ECF	EMERGENCY CALL SIGNAGE	LNT	LINOLEUM TILE	RST	RUBBER STAIR TREADS
A/C	AIR CONDITIONER / CONDITIONING	EF	EACH FREE	LP	LOW POINT	RSTR	RUBBER STAIR TREADS & RISERS
ABV	ABOVE	EIFS	EXTERIOR INSULATION AND FINISH SYSTEM	LT	LIGHT	RT	RUBBER TILE
ACCS	ACCESSORIES	EJ	EXPANSION JOINT	LVR	LOUVER	RWB	RUBBER WALL BASE
ACSDR	ACCESS DOOR	EL	ELEVATION	LWT	LIGHT WEIGHT	RWD	REDWOOD
ACSF/LR	ACCESS FLOOR	ELEC	ELECTRICAL	MACH	MACHINE	RWL	RAIN WATER LEADER
ACST / ACOUS	ACOUSTICAL	ELEV	ELEVATOR	MAINT	MAINTENANCE		
ACT	ACOUSTICAL CEILING TILE	EMER	EMERGENCY	MAT	ANTI-FATIGUE MATTING	S	SOUTH
AD	AREA DRAIN	EMF	ENGINEERED WOOD FLOORING	MATL	MATERIAL	SC	SOLID CORE
ADA	AMERICANS WITH DISABILITIES ACT	ENCL	ENCLOSED / ENCLOSURE	MAX	MAXIMUM	SCD	SEAT COVER DISPENSER
ADDL	ADDITIONAL	ENG	ENGINEER	MC	MEDICINE CABINET	SCHED	SCHEDULE
ADDM	ADDENDUM	EOD	EDGE OF DECK	ME	MECHANICAL EQUIPMENT	SCN	SCREEN
ADJ	ADJUSTABLE / ADJACENT	EOS	EDGE OF SLAB	MCH	MECHANICAL	SCT	STAINED CONCRETE
ADMIN	ADMINISTRATION	EQ	EQUAL(LY)	MEZZ	MEZZANINE	SD	SOAP DISPENSER / STORM DRAIN
AFC	ABOVE FINISHED COUNTER	EQPT	EQUIPMENT	MFR	MANUFACTURE(R)	SDC	SEALED CONCRETE
AFG	ABOVE FINISHED FLOOR	EST	ESTIMATE	MH	MANHOLE	SECT	SECTION
AFG	ABOVE FINISHED GRADE	EWC	ELECTRIC WATER COOLER	MIN	MINIMUM	SF	SQUARE FEET
AFS	ABOVE FINISHED SLAB	EXIST	EXISTING	MIR	MIRROR	SHLF	SHELF
AGGR	AGGREGATE	EXP	EXPANSION	MISC	MISCELLANEOUS	SHT	SHEET
AHR	ANCHOR	EXT	EXTERIOR	MLD / MLDG	MOULDING	SHTG	SHEATHING
AHU	AIR HANDLING UNIT			MO	MASONRY OPENING	SHWC	SHOWER CURTAIN AND ROD
AL / ALUM	ALUMINUM	FA	FIRE ALARM	MR	MOISTURE RESISTANT	SHWR	SHOWER
ALUM	ALUMINUM	FAST	FASTENER	MTD	MOUNTED	SHWS	SHOUR SEAT
ALNMT	ALIGNMENT	FOO	FLOOR CLEAN OUT	MTL	METAL	SIM	SIMILAR
ALT	ALTERNATE	FD	FLOOR DRAIN	MUL	MULLION	SND	SANITARY NAPKIN DISPENSER
ANOD	ANODIZED	FE	FIRE EXTINGUISHER	MW	MICROWAVE	SNR	SANITARY NAPKIN RECEPTACLE
ANUN	ASSISTANCE REQUIRED INDICATOR/ALARM	FEC	FIRE EXTINGUISHER CABINET			SOG	SLAB ON GRADE
AP	ACCESS PANEL	FEC (R)	FIRE EXTINGUISHER CABINET, RECESSED	N	NORTH	SPD	SOAP DISPENSER WITH COLLECTOR
APC	ACOUSTICAL PANEL CEILING	FEC (SR)	FIRE EXTINGUISHER CABINET, SEMI-RECESSED	NA OR N/A	NOT AVAILABLE / APPLICABLE	SPEC	SPECIFY / SPECIFICATION
APPROX	APPROXIMATELY			ND	FEMININE NAPKIN WASTE BIN	SPK	SPEAKER
APPVD	APPROVED			NFPA	NATIONAL FIRE PROTECTION ASSOCIATION	SQ	SQUARE
AR-LED	DOOR LOCK INDICATOR	FEW	FIRE EXTINGUISHER, WALL MOUNTED			SQFT	SQUARE FEET
ARCH	ARCHITECT(URAL)					SQIN	SQUARE INCH(ES)
ASPH	ASPHALT	FF	FINISHED FLOOR	NIC	NOT IN CONTRACT	SS	STAINLESS STEEL
ASTM	AMERICAN SOCIETY FOR TESTING MATERIALS	FFL	FINISH FLOOR LEVEL	NO / #	NUMBER	ST	STONE
AUTO	AUTOMATIC	FGL	FIBERGLASS	NOM	NOMINAL	STA	STATION
AVG	AVERAGE	FIN	FINISHED	NTS	NOT TO SCALE	STC	SOUND TRANSMISSION CLASS
s	AND	FIXT	FIXTURE			STD	STANDARD
		FL	FLOOR	OA	OVERALL	STDS	STUDS
		FLASH	FLASH(ING)	OBS	OBSCURE	STIFF	STIFFENER
BD	BOARD	FLUOR	FLUORESCENT	OC	ON CENTER	STL	STEEL
BET	BETWEEN	FOC	FACE OF CONCRETE	OCI	OCCUPIED INDICATOR	STN	STAINED
BFACT	BARRIER FREE ADULT CHANGE TABLE	FOF	FACE OF FINISH	OD	OUTSIDE DIAMETER	STOR	STORAGE
		FOM	FACE OF MASONRY	OFCI	OWNER FURNISHED CONTRACTOR INSTALLED	STRUCT	STRUCTURE / STRUCTURAL
BFAO	BARRIER FREE AUTOMATIC OPENER	FOV	FACE OF STUDS			SUSP	SUSPENDED
BFPB	BARRIER FREE PUSH BUTTON	FOW	FACE OF WALL	OFF	OFFICE	SV	STOVE
BFWO	BARRIER FREE WAVE TO OPEN	FP	FIREPROOF	OPG / OPNG	OPENING	SW	SWITCH
BG	BUMPER GUARD	FPL	FIREPLACE	OPP	OPPOSITE	SYM	SYMMETRICAL
BITUM	BITUMINOUS	FR	FRAME	OZ	OUNCE	SYN	SYNTHETIC
BL	BLACK	FRC	FIBER REINFORCED CONCRETE			SYS	SYSTEM
BLDG	BUILDING	FRG	FIRE RATED GLASS	PART	PARTIAL	T&B	TOP AND BOTTOM
BLK	BLOCK	FRGP	FIBER REINFORCED GYPSUM PLASTER	PAT	PATTERN	T&G	TONGUE AND GROOVE
BLKG	BLOCKING			PB	PORCELAIN BASE	TB	TOWEL BAR
BM	BEAM	FRT	FIRE RETARDANT TREATED	PBD	PARTICLE BOARD	TBD	TO BE DETERMINED
BMS	BALANCE MAGNETIC SWITCH	FS	FLOOR SINK	PC / PCC	PRECAST CONCRETE	TC	TOP OF CURB
BOS	BOTTOM OF STEEL	FTG	FOOTING	PC / PCC	PRECAST CONCRETE	TEL	TELEPHONE
BOT	BOTTOM	FURR	FURRING	PED	PEDESTAL	TEMP	TEMPORARY / TEMPERATURE
BR	BACKREST	FUT	FUTURE	PER	PERIMETER	TER	TERRAZZO
BS	BOTH SIDES			PERF	PERFORATED	TGL	TEMPERED GLASS
		GA	GAUGE	PERP	PERPENDICULAR	THK	THICK
CAB	CABINET	GALV	GALVANIZE(D)	PF	PRE-FINISHED	THRU	THROUGH
CAS	CASEWORK	GB	GRAB BAR	PFT	PORCELAIN FLOOR TILE	TOC	TOP OF CONCRETE
CB	CATCH BASIN	GBFD	GRAB BAR FOLD DOWN	PIP	POURED-IN-PLACE	TOS	TOP OF SLAB
CEM	CEMENT	GC	GENERAL CONTRACTOR	PL	PLATE	TOW	TOP OF WALL
CER	CERAMIC	GND	GLASS / GLAZING	PLAM	PLASTIC LAMINATE	TPD	TOILET PAPER DISPENSER
CF	CUBIC FOOT	GR	GRADE	PLAS	PLASTER	TPTN	TOILET PARTITION
CG	CORNER GUARD	GRV	GRAVEL	PLYWD	PLYWOOD	TV	TELEVISION
CH	CEILING HEIGHT	GT	CHAMFER	PMP	PRESSED METAL FRAMES	TYP	TYPICAL
CHAM	CHAMFER	GWB	GYPSUM WALL BOARD	POP	POINT OF PRESENCE		
CHBD	CHALKBOARD	GWG	GEORGIAN WIRED GLASS	PR	PAIR	UC	UNDERCUT
CI	CAST IRON	GYP	GYPSUM	PRCST	PRE-CAST	UG	UNDERGROUND
CI	CONTRACTOR INSTALLED			PRFAB	PREFABRICATED	UL	UNDERWRITER'S LABORATORY
CIP	CAST IN PLACE			PROP	PROPERTY	UNF / UNFIN	UNFINISHED
CJ	CONTROL JOINT	HB	HOSE BIB	PRT	PORCELAIN TILE	UON	UNLESS OTHERWISE NOTED
CL	CENTER LINE	HCP	HANDICAPPED	PSF	POUNDS PER SQUARE FOOT	UPS	UNINTERRUPTIBLE POWER SUPPLY
CLG	CEILING	HD	HEAVY DUTY	PT	PAINT	UR	URINAL
CLO	CLOSET	HDR	HEADER	PTD	PAPER TOWEL DISPENSER		
CLR	CLEAR	HOWR	HARDWARE	PTDWR	PAPER TOWEL DISPENSER & WASTE RECEPTACLE	V	VOLT
CMU	CONCRETE MASONRY UNIT	HI	HIGH	PTDF	PRESSURE TREATED DOUGLAS FIR	VAC	VACUUM
CO	CLEAN/CLEAR OUT	HM	HOLLOW METAL	PTLB	PUSH TO LOCK BUTTON	VB	VAPOR BARRIER
COL	COLUMN	HMI	HOLLOW METAL INSULATED	PTN	PARTITION	VCT	VINYL COMPOSITION TILE
CONC	CONCRETE	HNDR	HAND DRYER	PTOB	PUSH TO OPEN BUTTON	VENT	VENTILATE
CONST	CONSTRUCTION	HOR / HORIZ	HORIZONTAL	PTR	PAPER TOWEL RECEPTACLE	VERT	VERTICAL
CONT	CONTINUOUS	HP	HIGH POINT	PVC	POLYVINYL CHLORIDE	VEST	VESTIBULE
CORR	CORRIDOR	HR	HANDRAIL			VIF	VERIFY IN FIELD
CP	CONCRETE PAVER	HT	HEIGHT	Q	QUARTZ	VNR	VENEER
CPR	COPPER	HVAC	HEATING / VENTILATION / AIR CONDITIONING	QT	QUARRY TILE	VST	VINYL STAIR TREADS
CPT	CARPET(ED)(ING)	HW	HARDWARE	QTY	QUANTITY	VSTR	VINYLY STAIR TREADS & RISERS
CT	CERAMIC TILE	HYD	HYDRANT			VTR	VENT THRU ROOF
CTH	COAT HOOK			R	RISER	VWC	VINYL WALLCOVERING
CTR	COUNTER			RAD	RADIUS	W	WEST
		ID	INSIDE DIAMETER	RB	RUBBER BASE	WI	WITH
DBL	DOUBLE	INCL	INCH / INCHES	RCP	REFLECTED CEILING PLAN	WO	WITHOUT
DEFS	DIRECT APPLIED EXTERIOR FINISH SYSTEM	INCL	INCLUDE(D) / INCLUDING	REF	REFERENCE	WC	WATER CLOSET
DEG	DEGREE	INSUL	INSULATE / INSULATION	REFR	REFRIGERATOR	WCV	WALLCOVERING
DEMO	DEMOLISH	INT	INTERIOR	REG	REGISTER	WD	WOOD
DEP	DEPRESSION	ITGL	INSULATED TEMPERED GLASS	REINF	REINFORCE(D)	WF	WIDE FLANGE
DET	DETAIL	JAN	JANITOR	REQ	REQUIRED	WH	WALL HOSE / HYDRANT
DF	DRINKING FOUNTAIN	JT	JOINT	RESIL	RESILIENT	WI	WROUGHT IRON
DIA	DIAMETER	KIT	KITCHEN	RESS	RESILIENT SHEET	WIN	WINDOW
DIAG	DIAGONAL	LAB	LABORATORY	REST	RESILIENT TILE	WK	WORK
DIM	DIMENSION	LAM	LAMINATE(D)	RET	RETAINING	WNSCT	WAINSCOT
DISP	DISPENSER	LAV	LAVATORY	REV	REVISE / REVISION	WP	WATERPROOF(ING)
DIV	DIVISION	LB(S)	POUND(S)	RFG	ROOFING	WPT	WORK POINT
DN	DOWN	LH	LEFT HAND	RFL	REFLECTED	WR	WATER RESISTANT
DR	DOOR	LIB	LIBRARY	RH	RIGHT HAND	WRR	WOOD RISER
DS	DOWNSPOUT	LKR	LOCKER	RM	ROOM		
DW	DISHWASHER			RO	ROUGH OPENING		
DWG	DRAWING						
E	EAST						
EA	EACH						

REFERENCE SYMBOLS


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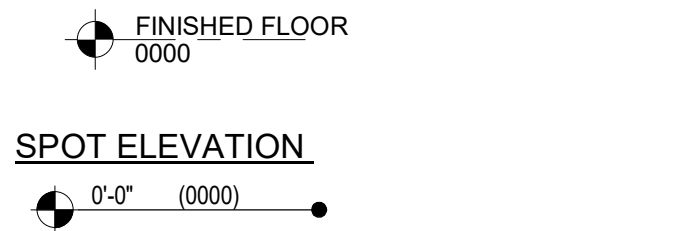
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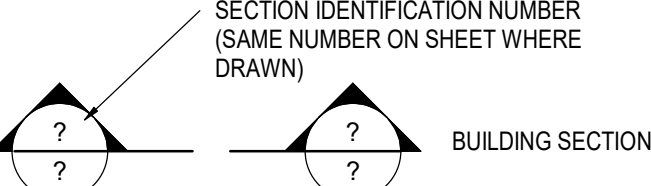
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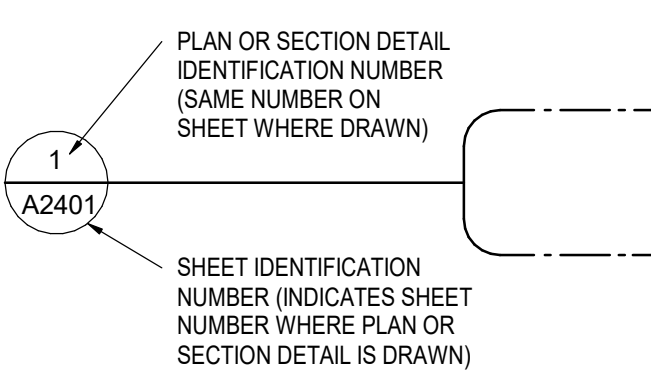
ELEVATION INDICATION - (FLOORS, ETC...)

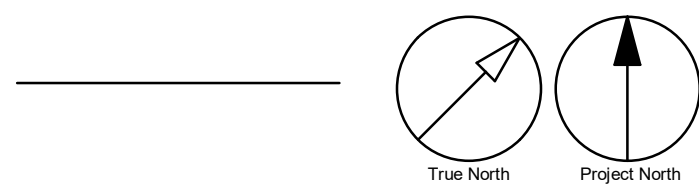

SECTION LOCATION IDENTIFICATION

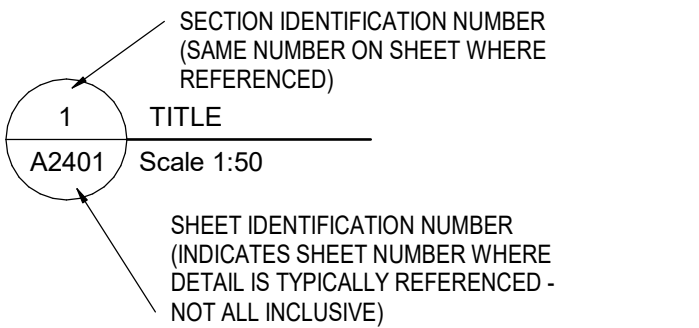


DETAIL LOCATION IDENTIFICATION

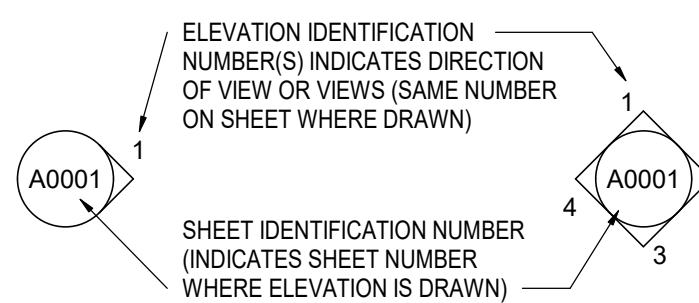


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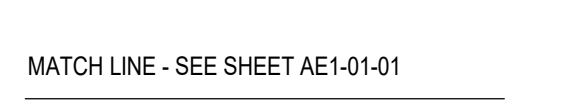
PARTITION TYPE INDICATION




MATERIAL OR WORK DIVISION INDICATION

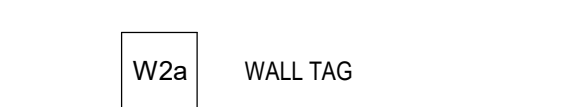


MATCH LINE INDICATION

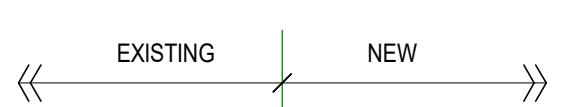


COLUMN INDICATION

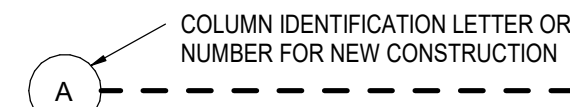


ROOM NAME AND NUMBER INDICATION

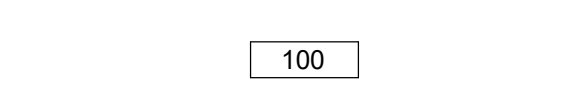


NEW DOOR NUMBER INDICATION

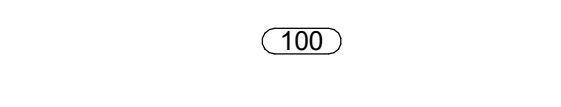

WINDOW NUMBER INDICATION

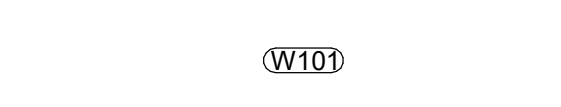


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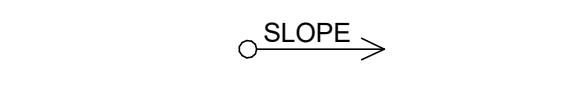
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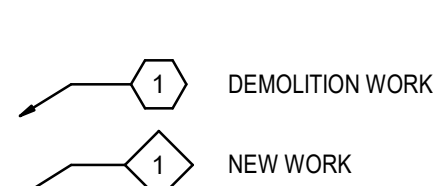
ROOF OR RAMP PITCH INDICATION

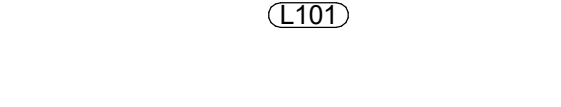

ROOF OR RAMP SLOPE INDICATION



KEYED NOTE SYMBOLS

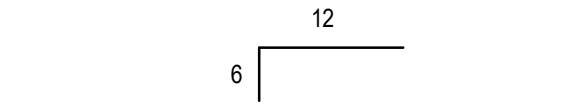


FLOOR FINISH TAG



REVISION INDICATION



CAMERA VIEW

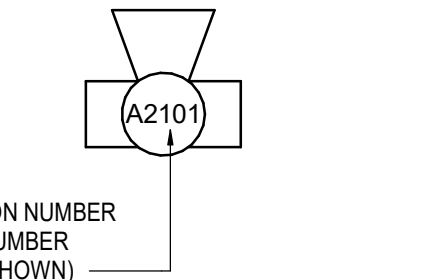

CITY OF TORONTO
Corporate Real Estate Management
Project Management Office
Metro Hall Toronto, ON
M5V 3C6

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ISSUES		
No.	DESCRIPTION	DATE
A	50% SUBMISSION	2022-01-20
B	90% SUBMISSION	2022-02-22
C	ISSUED FOR PERMIT	2022-03-18
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CONSULTANTS

SEAL

PRIME CONSULTANT

100 - 175 Galaxy Blvd.
Toronto, ON M9W 0C9, Canada
tel 416 679 1930
www.arcadis.com

PROJECT TITLE
CITY OF TORONTO
ACCESSIBILITY UPGRADES

PROJECT ADDRESS

PROJECT NO:
9119- 19- 0162 / Arcadis 30279056

DRAWN BY:
A. BOYNARIAN

PROJECT MGR:
F. BOLOURIAN

CHECKED BY:
L. BANDIERA






APPROVED BY:
E. FENUTA

SHEET TITLE
GENERAL NOTES,
ABBREVIATIONS &
REFERENCE SYMBOLS

SHEET NUMBER
G05-GAL-G0002









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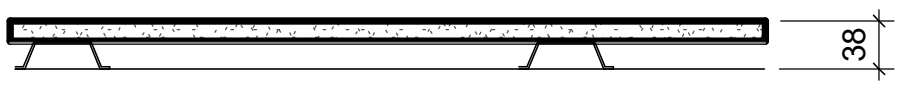
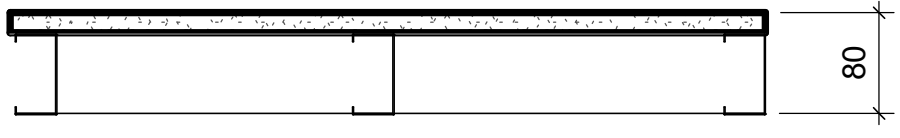
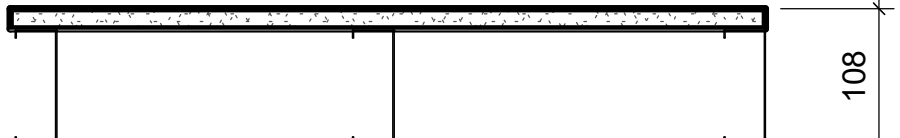
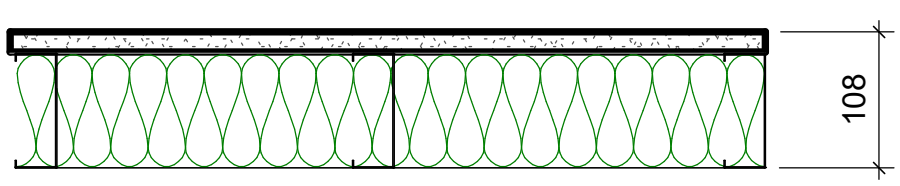
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1/10
SCALE CHECK
1/10



CONCRETE BLOCK				
TYPE NO.	ASSEMBLY	DESCRIPTION	FRR	STC
W1a		- 90mm CONCRETE BLOCK NORMAL WEIGHT TO U/S OF DECK/ SLAB ABOVE		44
W1b		- 140mm CONCRETE BLOCK NORMAL WEIGHT TO U/S OF DECK/ SLAB ABOVE	1.0 HR OBC SB-2	46
W1c		- 190mm CONCRETE BLOCK NORMAL WEIGHT TO U/S OF DECK/ SLAB ABOVE	2.0 HR OBC SB-2	48
W1d		- 240mm CONCRETE BLOCK LIGHT WEIGHT TO U/S OF DECK/ SLAB ABOVE		49
W1e		- 305mm CONCRETE BLOCK NORMAL WEIGHT TO U/S OF DECK/ SLAB ABOVE		51

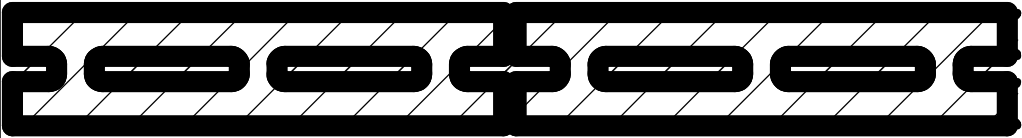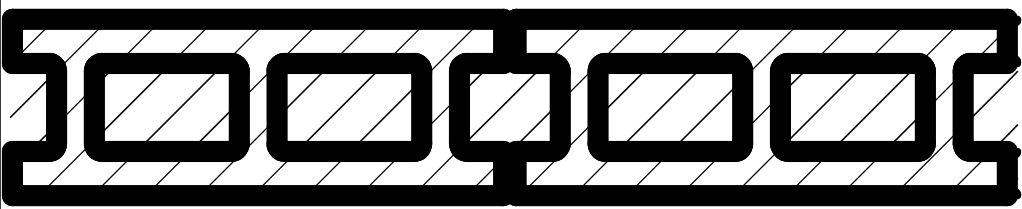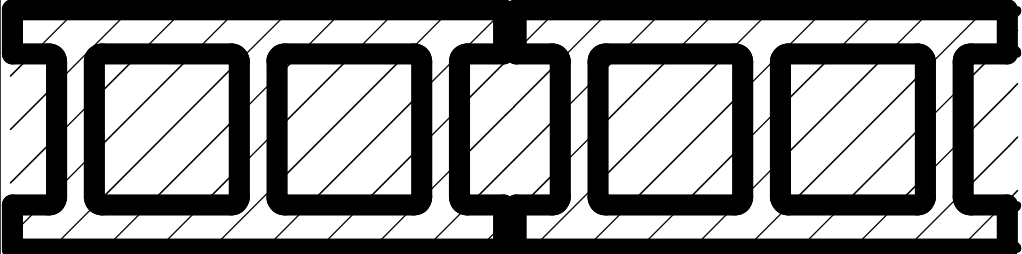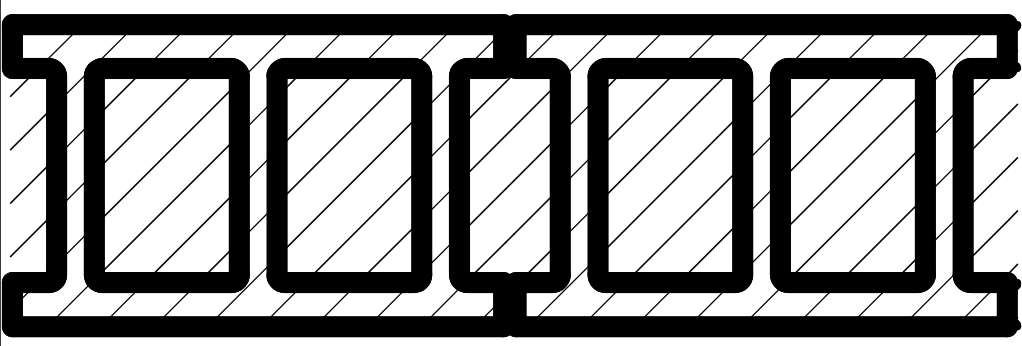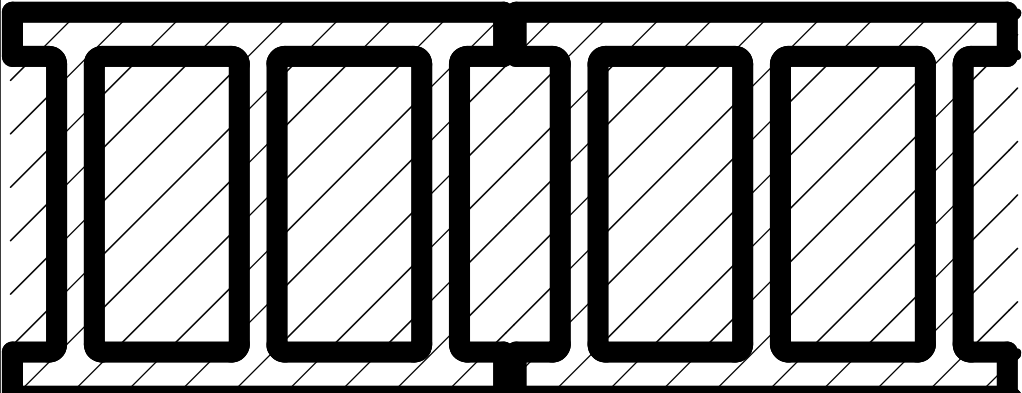WALL TYPE NOTES:

- ACOUSTIC BATT INSULATION TO EXTEND FULL HEIGHT OF WALL ASSEMBLIES UNLESS NOTED OTHERWISE.
- PROVIDE MOISTURE RESISTANT GYPSUM BOARD ON ALL WALLS OF WASHROOMS, KITCHEN AREAS AND BEHIND DRINKING FOUNTAINS.
- PROVIDE TILE BACKER BOARD BEHIND ALL CERAMIC TILE APPLICATIONS.
- ANY PENETRATIONS THROUGH FIRE RATED WALLS SHOULD BE PROTECTED WITH ULC LISTED FIRE STOPPING.
- AT FIRE RATED WALLS AND SMOKE BARRIERS ABOVE ACCESSIBLE CEILING, PROVIDE IDENTIFICATION SIGNAGE, SPACED AT NOT MORE THAN 9 METRE MEASURED HORIZONTALLY, INDICATING "FIRE AND/OR SMOKE BARRIER - PROTECT OPENINGS AS PER OBC 3.1.9".
- PROVIDE FIRE BLOCKING IN CONCEALED SPACES OF STUD WALLS AND PARTITIONS VERTICALLY AT THE CEILING AND FLOOR LEVELS AND HORIZONTALLY.
- FURRING WALLS AROUND COLUMNS, SHAFTS AND PIPING THAT ARE ALSO DEMISING WALLS BETWEEN ROOMS SHALL GO TO U/S OF DECK/ SLAB ABOVE AND CARRY ACOUSTIC INSULATION CONTINUITY FROM ADJACENT WALLS.

METAL STUD - DRYWALL				
TYPE NO.	ASSEMBLY	DESCRIPTION	FRR	STC
W2		- 16mm FIRE RATED GYPSUM BOARD - 92mm METAL STUDS @ 400 O.C. - 16mm FIRE RATED GYPSUM BOARD - EXTEND WALL TO U/S OF DECK	1.0 HR ULC W407	38 (OBC S4C)
W2a		- 16mm GYPSUM BOARD - 92mm METAL STUDS @ 400 O.C. - 16mm GYPSUM BOARD		
W2b		- 16mm FIRE RATED GYPSUM BOARD - 92mm METAL STUDS @ 400 O.C. MAXIMUM - 92mm ACOUSTIC / THERMAL NON COMBUSTIBLE BATT INSULATION - 16mm FIRE RATED GYPSUM BOARD - EXTEND WALL TO U/S OF DECK	1.0 HR ULC W407	45
W2c		- 16mm GYPSUM BOARD - 92mm METAL STUDS @ 400 O.C. - 92mm ACOUSTIC / THERMAL NON COMBUSTIBLE BATT INSULATION - 16mm GYPSUM BOARD - EXTEND WALL TO U/S OF DECK		45
W2d		- 2 LAYERS OF 16mm FIRE RATED GYPSUM BOARD - 92mm METAL STUDS @ 400 O.C. MAXIMUM - 92mm ACOUSTIC / THERMAL NON COMBUSTIBLE BATT INSULATION - 2 LAYERS OF 16mm FIRE RATED GYPSUM BOARD - EXTEND WALL TO U/S OF DECK	2.0 HR ULC W414	55
W2e		- 16mm GYPSUM BOARD - 152mm METAL STUDS @ 400 O.C. - 152mm ACOUSTIC / THERMAL NON COMBUSTIBLE BATT INSULATION - 16mm GYPSUM BOARD - EXTEND WALL TO U/S OF DECK		51 (OBC S7A)
W2f		- 16mm GYPSUM BOARD - 152mm METAL STUDS @ 400 O.C. - 16mm GYPSUM BOARD		
W2g		- 2 LAYERS OF 16MM GYPSUM BOARD - 92mm METAL STUDS @ 400 O.C. - 92mm ACOUSTIC / THERMAL NON COMBUSTIBLE BATT INSULATION - 16mm GYPSUM BOARD - EXTEND WALL TO U/S OF DECK		50 (OBC S5B)

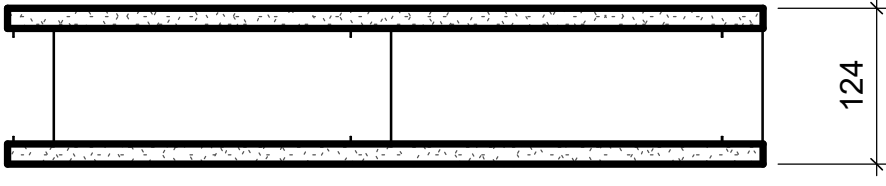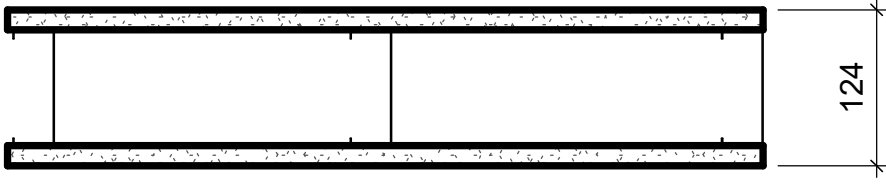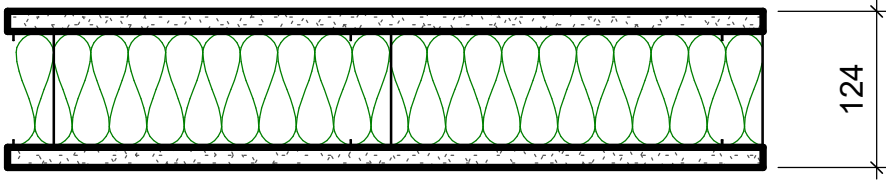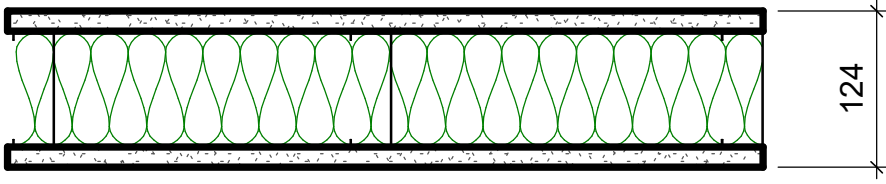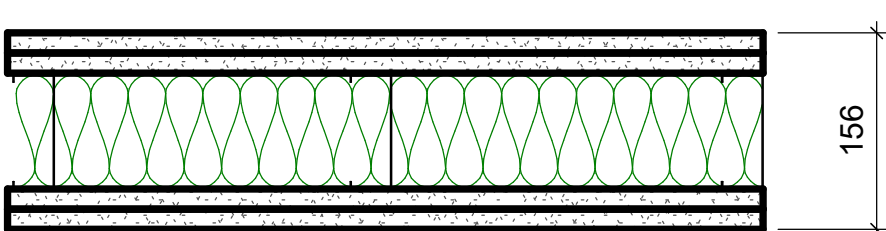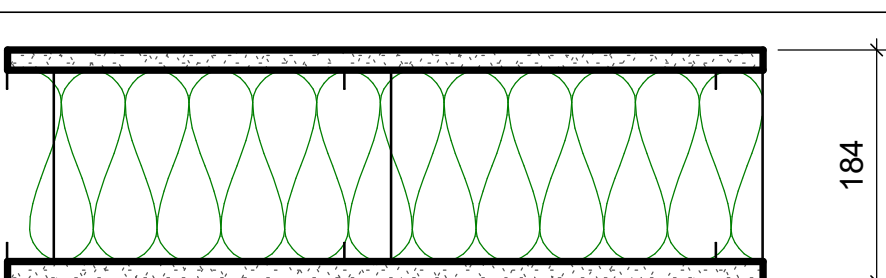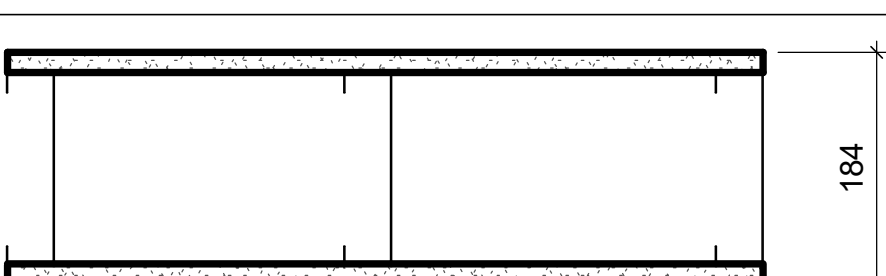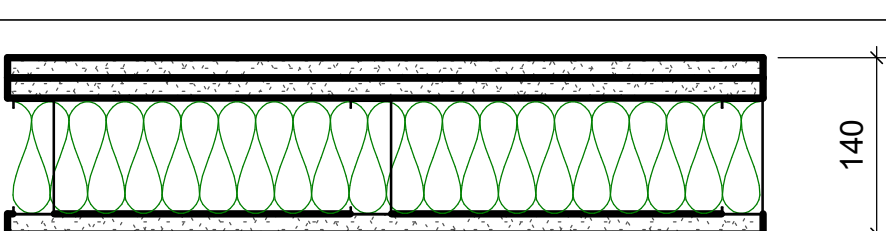FURRING WALL TYPES - INTERNAL			
TYPE NO.	ASSEMBLY	DESCRIPTION	FRR
W3a		38mm FURRING - TO 150mm ABOVE FIN. CEILING - 16mm GYPSUM BOARD - 22mm MIN HAT CHANNEL @ 400 O.C.	
W3b		80mm FURRING - TO 150mm ABOVE FIN. CEILING - 16mm GYPSUM BOARD - 64mm MIN STEEL STUDS @ 400 O.C.	
W3c		108mm FURRING - TO 150mm ABOVE FIN. CEILING UNLESS OTHERWISE NOTED - 16mm GYPSUM BOARD - 92mm MIN STEEL STUDS @ 400 O.C.	
W3d		108mm FURRING - TO 150mm ABOVE FIN. CEILING UNLESS OTHERWISE NOTED - 16mm GYPSUM BOARD - 92mm MIN STEEL STUDS @ 400 O.C. - 92mm ACOUSTIC NON COMBUSTIBLE BATT INSULATION	

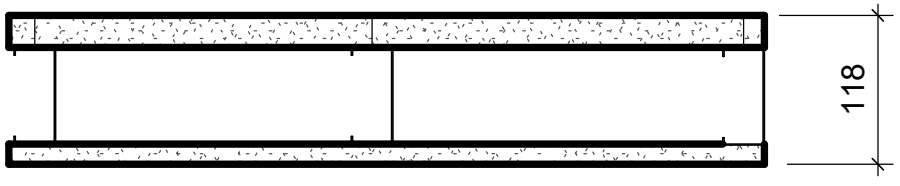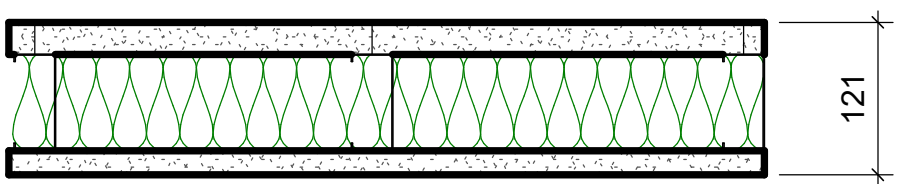SHAFT WALL TYPES - INTERNAL				
TYPE NO.	ASSEMBLY	DESCRIPTION	FRR	STC
W4a		-25.4mm FIRE RATED GYPSUM BOARD -102mm "C-H" SHAPED STUD @600 O.C. - 16mm FIRE RATED GYPSUM BOARD TO U/S OF DECK/ SLAB ABOVE	1.0 HR ULC W452	
W4b		-25.4mm FIRE RATED GYPSUM BOARD -102mm "C-H" SHAPED STUD @600 O.C. - 102mm ACOUSTIC / THERMAL NON COMBUSTIBLE BATT INSULATION - 19.1mm FIRE RATED GYPSUM BOARD TO U/S OF DECK/ SLAB ABOVE	2.0 HR ULC W508	52

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No.	DESCRIPTION	DATE
A	50% SUBMISSION	2022-01-20
B	90% SUBMISSION	2022-02-22
C	ISSUED FOR PERMIT	2022-03-18
D	ISSUED FOR TENDER	2025-04-11

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tel 416 679 1930
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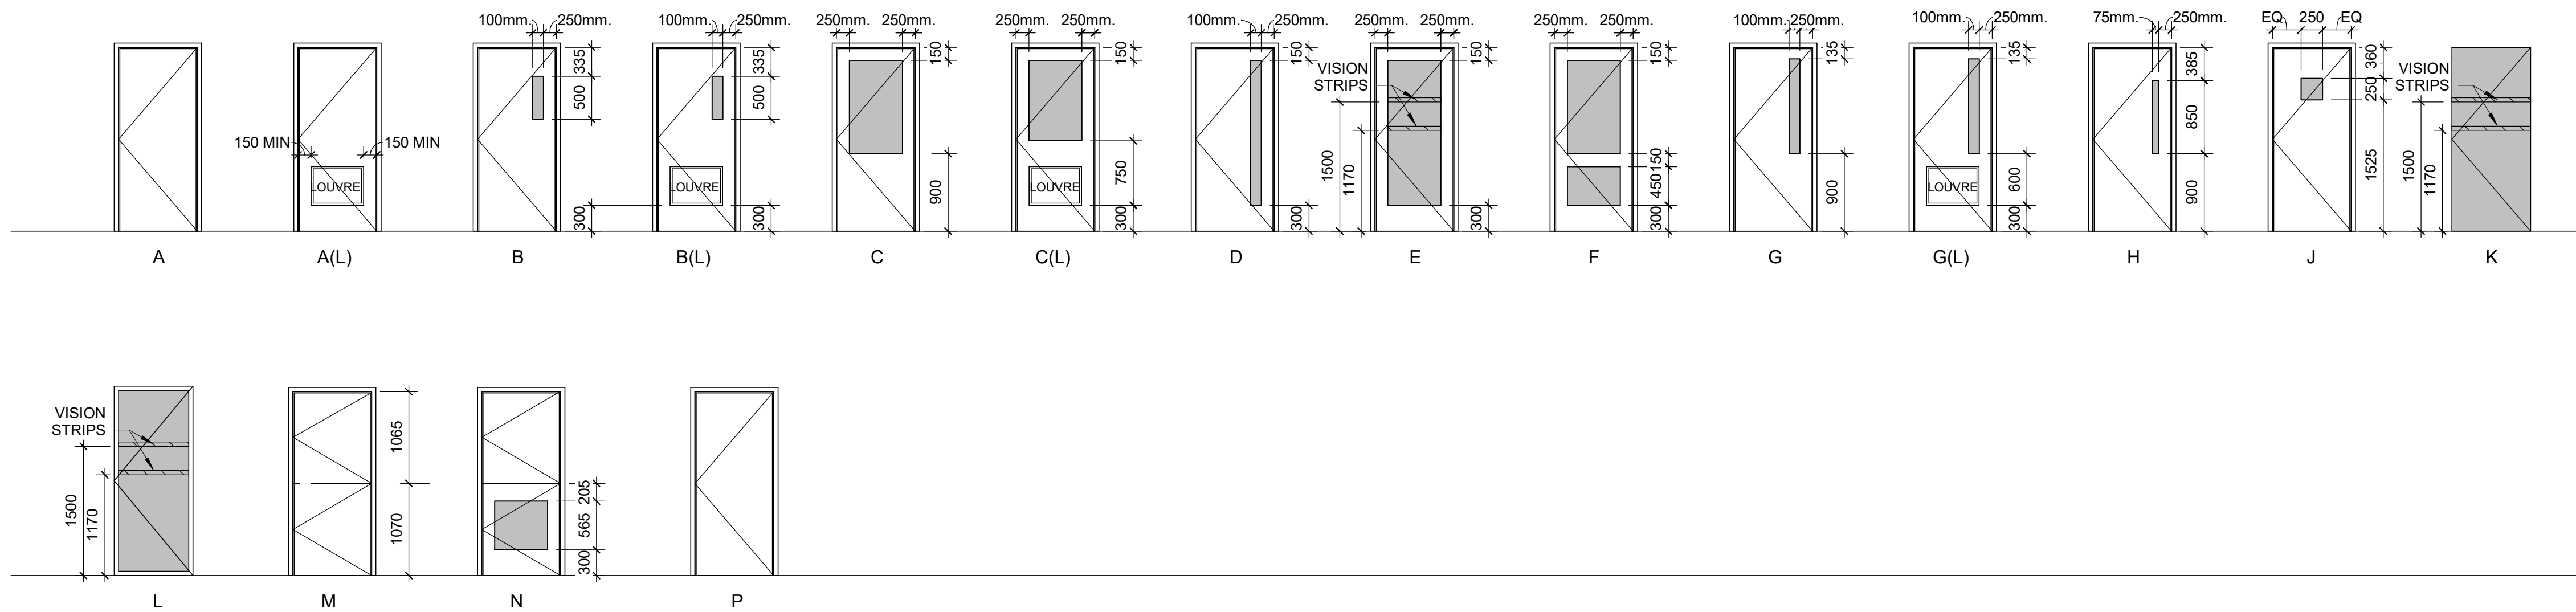
PROJECT ADDRESS

PROJECT NO: 9119- 19- 0162 / Arcadis 30279056	
DRAWN BY: A. BOYNARIAN	CHECKED BY: L. BANDIERA
PROJECT MGR: F.BOLOURIAN	APPROVED BY: E. FENUTA


SHEET TITLE
WALL TYPES

SHEET NUMBER G05--GAL-G0003	ISSUE D
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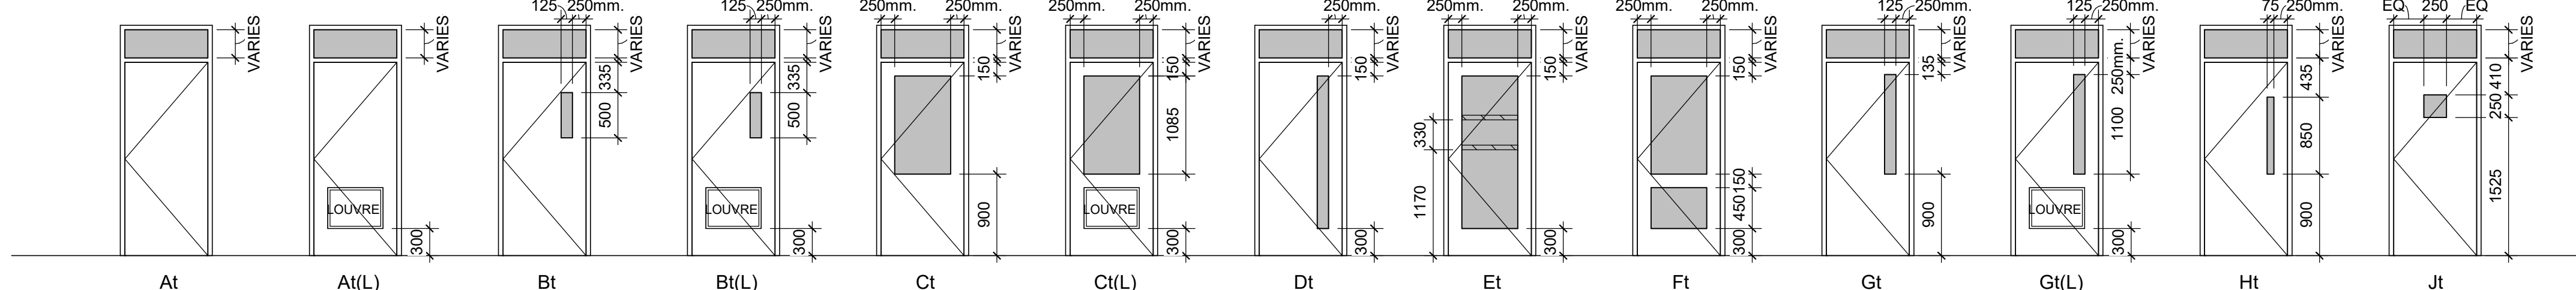
SINGLE DOOR TYPES




SINGLE DOOR WITH SIDELIGHT TYPES

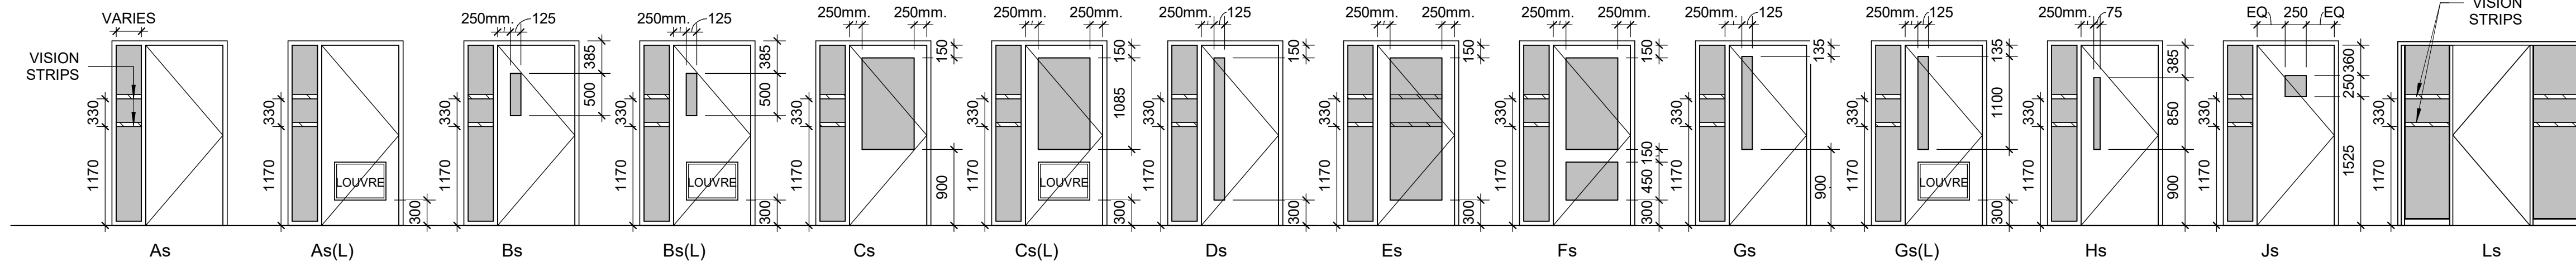


SINGLE DOOR WITH TRANSOM TYPES




SINGLE SLIDING DOOR TYPE

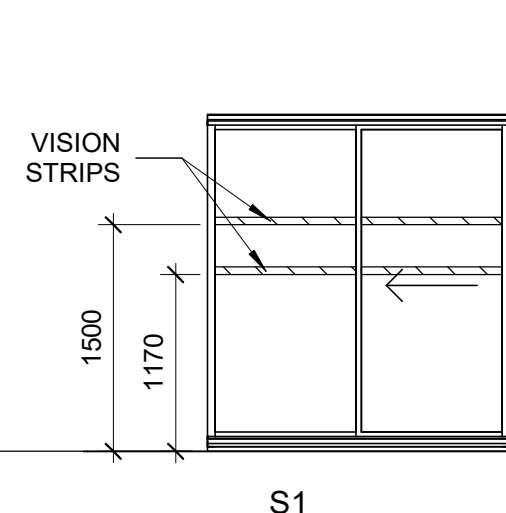


SINGLE DOOR WITH SIDELIGHT & TRANSOM TYPES

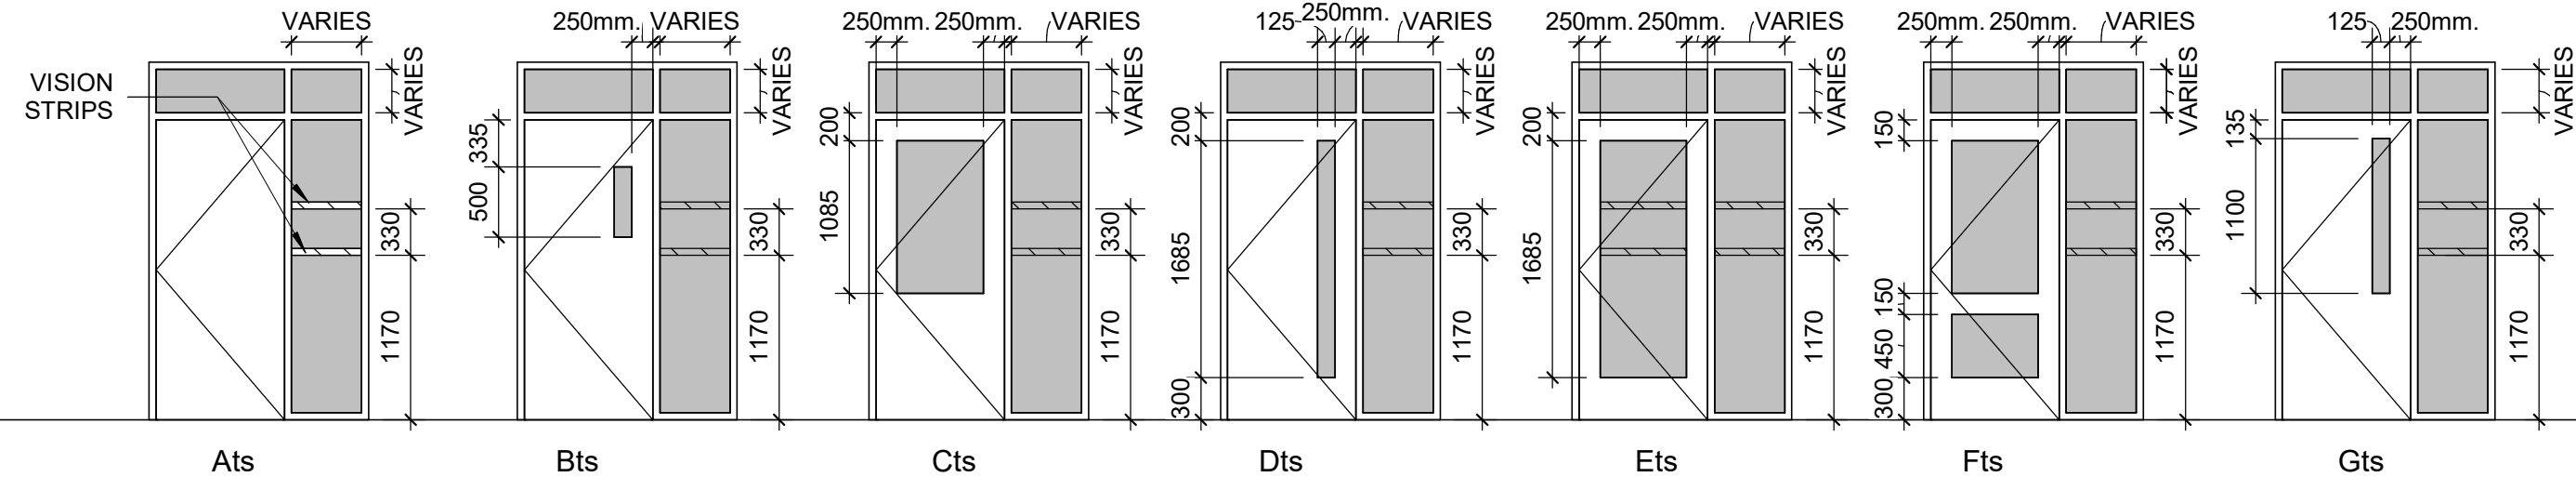


DOUBLE DOOR TYPES

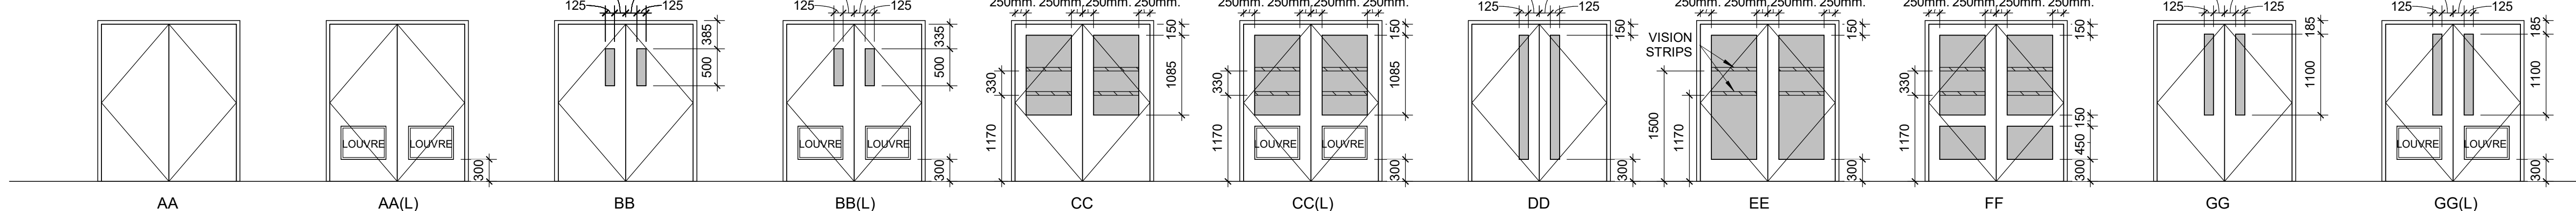


DOUBLE DOOR WITH TRANSOM TYPES

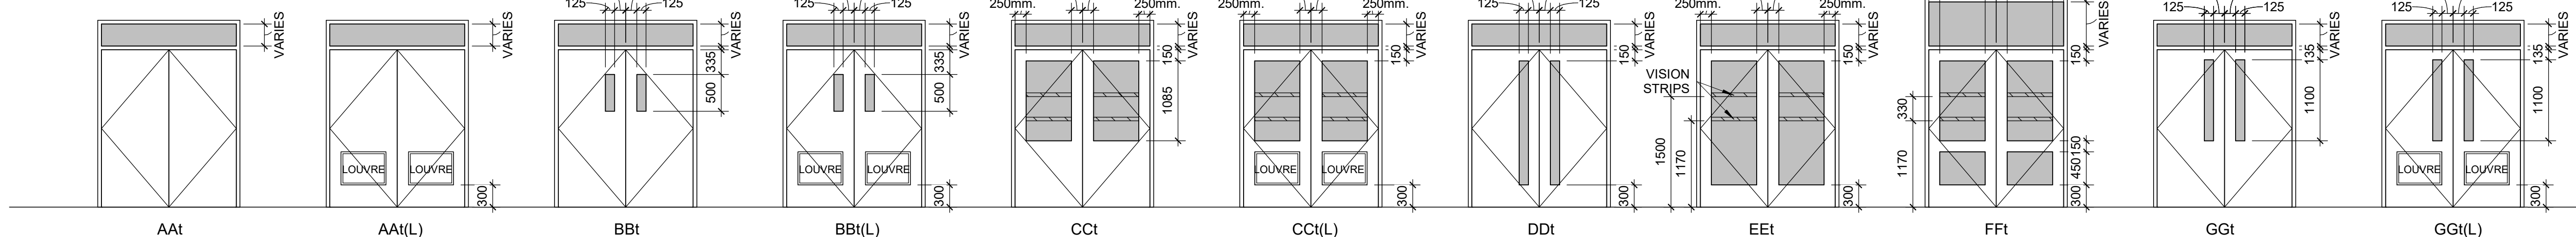

VISION STRIPS

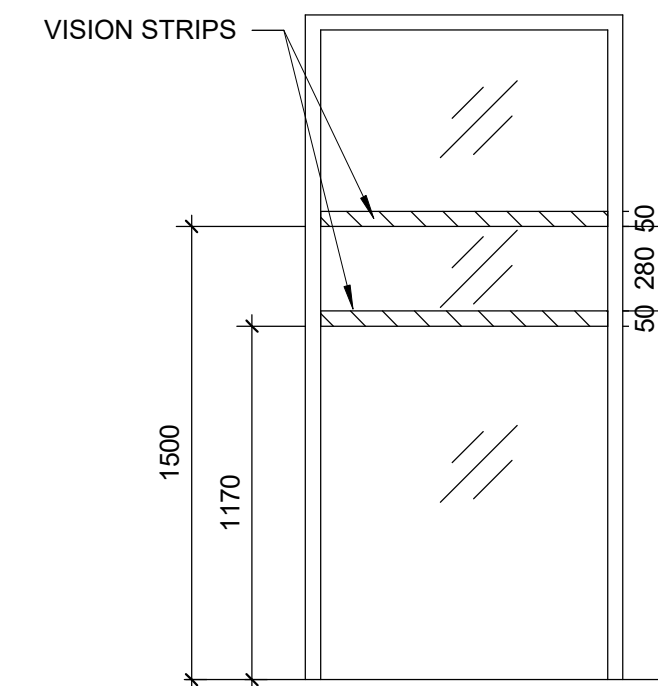

DOOR HANDLE / PANIC BAR HEIGHT

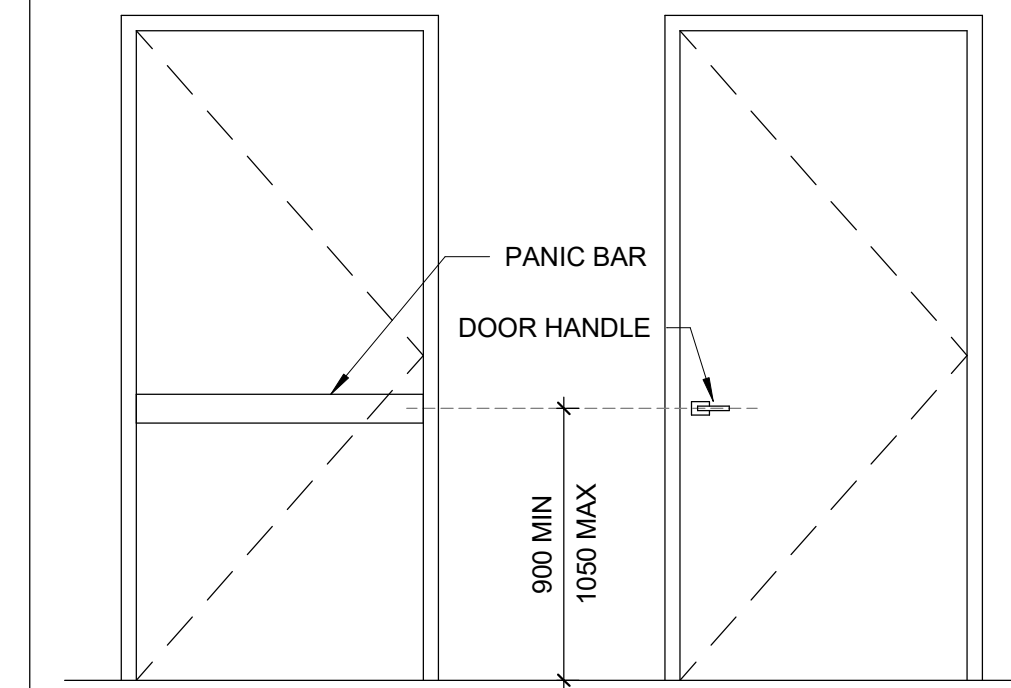

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PROJECT TITLE
CITY OF TORONTO
ACCESSIBILITY UPGRADES

PROJECT ADDRESS

PROJECT NO:
9119- 19- 0162 / Arcadis 30279056

DRAWN BY:

A. BOYNAR

PROJECT M
F. POLICIA

CHECKED BY:	
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L. BANDIERA

SHEET TITLE

DOOR TYPES

SHEET NUMBER

G05-GAL-G0004

ISSUE

D

GENERAL:

1. DO NOT SCALE THE DRAWINGS.
2. THE DRAWINGS ARE TO BE READ IN CONJUNCTION WITH THE SPECIFICATIONS. ALL RELATED ARCHITECTURAL, MECHANICAL, ELECTRICAL, PROCESS & CIVIL DRAWINGS, AND OTHER RELEVANT CONTRACT DOCUMENTS.
3. CONTRACTOR SHALL PROVIDE COMPLETE SET OF ARCHITECTURAL, MECHANICAL, ELECTRICAL, CIVIL & PROCESS DRAWINGS & APPLICABLE SPECIFICATION SECTIONS TO THE STRUCTURAL STEEL, JOIST & METAL FABRICATIONS CONTRACTORS PRIOR TO SUBMISSION OF ANY RELATED SHOP DRAWINGS.
4. THE DESIGN AND CONSTRUCTION OF ALL WORK ON THIS PROJECT IS TO CONFORM TO THE 2012 EDITION OF THE ONTARIO BUILDING CODE (REGULATION 332/12).
5. THE CONTRACTOR SHALL FIELD CHECK AND VERIFY ALL DIMENSIONS, ELEVATIONS AND CONDITIONS AT THE SITE AND REPORT TO THE ENGINEER ANY DISCREPANCIES OR UNSATISFACTORY CONDITIONS WHICH MAY ADVERSELY AFFECT THE PROPER COMPLETION, COST, SCHEDULE OR QUALITY OF WORK. COMMENCEMENT OF WORK BY THE CONTRACTOR IMPLIES ACCEPTANCE OF THE EXISTING CONDITIONS.
6. THE CONTRACTOR SHALL PROTECT ALL EXISTING STRUCTURES, UNDERGROUND UTILITIES AND OTHER EXISTING SERVICES DURING CONSTRUCTION, AND MAKE GOOD ANY DAMAGE RESULTING FROM THE WORK ON THIS PROJECT TO THE SATISFACTION OF THE OWNER AND ENGINEER.
7. THE CONTRACTOR SHALL PROVIDE, MAINTAIN AND TAKE RESPONSIBILITY FOR ALL TEMPORARY BRACING AND SHORING.
8. TYPICAL DETAILS SHOWN ON DRAWINGS SHALL GOVERN THE WORK. IF DETAILS DIFFER ON OTHER DRAWINGS, THE MOST STRINGENT SHALL GOVERN.
9. WORK NOT INDICATED ON A PART OF THE DRAWINGS BUT REASONABLY IMPLIED TO BE SIMILAR TO THAT SHOWN AT CORRESPONDING PLACES SHALL BE REPEATED.
10. UNLESS NOTED OTHERWISE ON THE STRUCTURAL DRAWINGS, THE CORING OR CUTTING OF OPENINGS AND HOLES SHOWN ON THE STRUCTURAL DRAWINGS THROUGH THE EXISTING STRUCTURE SHALL NOT CUT ANY REINFORCING BARS. THE CONTRACTOR SHALL LOCATE THE LOCATION, SIZE, LENGTH, ORIENTATION AND POSITION OF EXISTING REINFORCING AND PROVIDE IBI WITH HARD COPIES OF SUCH FOR OUR REVIEW IN THE VICINITY OF THE HOLES AND SLEEVES TO BE CUT OR CORED, AND THE HOLES AND SLEEVES SHALL BE LOCATED TO AVOID CUTTING OF REINFORCING BARS.
11. NEW OPENINGS OR CORING TO BE CUT THROUGH EXISTING FLOOR SLAB OR WALLS SHALL BE CLEARLY MARKED OUT BY THE CONTRACTOR. THE CONTRACTOR SHALL NOTIFY IBI ONCE THE MARKING OUT HAS BEEN COMPLETED SO THAT IBI CAN REVIEW THE PROPOSED LOCATIONS OF ALL NEW OPENINGS. DO NOT PROCEED WITH CUTTING OF NEW OPENINGS WITHOUT THE APPROVAL OF IBI.
12. UNLESS NOTED OTHERWISE ON THE DRAWINGS NEW STRAIGHT SIDED OPENINGS THROUGH EXISTING SLABS AND WALLS SHALL BE SAWCUT WITH NO OVERCUTS. USE CORED HOLES AT THE CORNERS. JACKHAMMERING SHALL NOT BE PERMITTED REFER TO THE DETAILS AND PROCEDURES INDICATED ON THE STRUCTURAL DRAWINGS FOR THE NEW OPENINGS. ALTERNATES TO THE ABOVE PROCEDURE MUST BE REVIEWED BY IBI PRIOR TO THE START OF DEMOLITION OR CONSTRUCTION.

DESIGN CRITERIA:

1. STRUCTURE HAS BEEN DESIGNED TO RESIST WIND AND SEISMIC LOADS WHICH ARE IN ACCORDANCE WITH THE USER'S GUIDE - NBC 2015 STRUCTURAL COMMENTARIES (PART 4 OF DIVISION B), FOR THE IMPORTANCE CATEGORY STATED IN NOTE #12. THE WIND AND SEISMIC PARAMETERS FOUND IN NOTE #13, AND FOR SITE CLASS D, $F_s = 1.24$, $F_v = 1.55$ I.F.S.(0.2) = 0.271 $R_s = 1.5$, $R_v = 1.3$ (CONVENTIONAL CONSTRUCTION OF MOMENT-RESISTING FRAMES AND BRACED FRAMES), AND NO IRREGULARITIES, USING STATIC ANALYSIS IN BOTH DIRECTIONS.
2. LATERAL LOADS DUE TO WIND AND SEISMIC FORCES ACT THROUGH THE METAL ROOF DECK DIAPHRAGM, AND ARE RESISTED BY MOMENT-RESISTING FRAMES IN THE NORTH-SOUTH DIRECTION AND BY BRACED FRAMES IN THE EAST-WEST DIRECTION.
3. ROOF ELEMENTS SUCH AS JOISTS, JOISTS GIRDERS, METAL DECK, ETC. AND THEIR CONNECTIONS TO THE SUPPORTING STRUCTURE ARE TO BE DESIGNED FOR UPWARD SUCTION DUE TO WIND.
4. ROOF STRUCTURE (INCLUDING JOISTS AND JOIST GIRDERS) IS TO BE DESIGNED FOR PONDING, INCLUDING PONDING INSTABILITY. MAXIMUM DESIGN PONDING DEPTH AT ROOF DRAINS TO BE 150 mm.
5. AS A MINIMUM, WIND LOADS SHALL BE CALCULATED ON THE BASIS OF OPEN TERRAIN AND BUILDING CATEGORY 3 AS DEFINED IN THE USER'S GUIDE - NBC 2015 STRUCTURAL COMMENTARIES (PART 4 OF DIVISION B). IF OTHER PROVISIONS OF SAID COMMENTARIES RESULT IN HIGHER WIND LOADS AND/OR MORE STRINGENT WIND EFFECTS, THESE LOADS AND EFFECTS SHALL BE CONSIDERED IN THE DESIGN.
6. ALL LOADS SHOWN ON DRAWINGS ARE SPECIFIED (NO LOAD FACTOR APPLIED) LOADS UNLESS NOTED OTHERWISE. HOWEVER, (ULS) IMPORTANCE FACTORS ARE APPLIED, UNLESS NOTED OTHERWISE.
7. ALL LOAD EFFECTS (AXIAL FORCES, SHEARS, MOMENTS AND TORSIONS) ARE FACTORED, UNLESS OTHERWISE NOTED.
8. DESIGN SPECIFIED (UNFACTORED) DEAD AND LIVE LOADS ARE SHOWN ON THE DRAWINGS.
9. STRUCTURES ARE NOT STABLE UNTIL ALL COMPONENTS (INCLUDING BUT NOT LIMITED TO MOMENT CONNECTIONS, BRACING, FLOOR & ROOF DECK AND SHEATHING) ARE CONSTRUCTED.
10. MATERIALS:
- | | |
|-----------------------------------|---|
| STRUCTURAL STEEL: | CAN/CSA-G40-20/G40.21, GRADE 350W FOR W-SECTIONS. GRADE 300W FOR OTHERS. YIELD STRENGTH = 350 MPa MIN. |
| COLD-FORMED STEEL: | |
| HOLLOW STRUCTURAL SECTIONS (HSS): | CONFORM TO CAN/CSA G40-20/G40.21-M GRADE 350W, CLASS C. |
| WELDING: | E49XX ELECTRODES. |
| BOLTS, NUTS AND WASHERS: | CONFORM TO ASTM A325. |
| ANCHOR BOLTS: | CONFORM TO ASTM F1554 GRADE 36, UNLESS NOTED OTHERWISE. |
| PRIMER: | SEE SPECIFICATION. |
| REINFORCING STEEL: | DEFORMED CONCRETE REINFORCING BARS CONFORMING TO CAN/CSA-G30.18, GRADE 400R OR 400W, UNLESS NOTED OTHERWISE. WHERE WELDABLE REINFORCING STEEL IS SPECIFIED, IT SHALL BE GRADE 400W, UNLESS NOTED OTHERWISE. |
| WOOD: | LUMBER: GRADED TO NLGA RULES NO.1/NO.2 S-DRY, UNLESS NOTED OTHERWISE. MSR GRADE FOR TRUSSES AS REQUIRED. |
| | GLULAM: CSA 0122 SP GRADE 20F BENDING STRESS, UNLESS NOTED OTHERWISE. 12CE COMPRESSION STRESS, UNLESS NOTED OTHERWISE. |
| | PLYWOOD: CSA 0151 SOFTWOOD EXTERIOR GRADE. |

12. STRUCTURE HAS BEEN ASSIGNED THE 1 IMPORTANCE CATEGORY, AS DEFINED IN THE APPLICABLE EDITION OF THE ONTARIO BUILDING CODE.
13. STRUCTURES HAVE BEEN DESIGNED CONSIDERING THE FOLLOWING CLIMATIC AND SEISMIC DATA:
- | WIND | SEISMIC | SNOW | RAIN |
|---------------|---|----------------------|--------------|
| q 1/50 = 0.47 | Sa(0.2) = 0.190
Sa(0.5) = 0.110
Sa(1.0) = 0.068
Sa(2.0) = 0.022
PGA = 0.076 | Ss = 1.2
Sr = 0.4 | ONE DAY = 92 |
14. THE STRUCTURE HAS BEEN DESIGNED FOR FUTURE EXPANSION AS SHOWN.
15. NO STRUCTURES HAVE BEEN DESIGNED FOR FUTURE EXPANSION.

CONCRETE:

1. THE DESIGN AND CONSTRUCTION OF ALL WORK ON THIS PROJECT SHALL CONFORM TO THE APPLICABLE EDITION OF THE FOLLOWING CSA STANDARDS: CSA-A23.1 "CONCRETE MATERIALS AND METHODS OF CONCRETE CONSTRUCTION"; CSA-A23.2 "TEST METHODS AND STANDARD PRACTICES FOR CONCRETE"; CSA-A23.3 "DESIGN OF CONCRETE STRUCTURES"; CAN/CSA-G30.18 "BILLET-STEEL BARS FOR CONCRETE REINFORCEMENT".
2. UNLESS NOTED OTHERWISE, MINIMUM CONCRETE COMPRESSIVE STRENGTH AT 28 DAYS SHALL BE AS FOLLOWS:
- | | |
|-----------------------------------|------------------------------|
| - LEAN CONCRETE FILL | 15 MPa |
| - MUD SLAB | 15 MPa (EXPOSURE CLASS F-1) |
| - FOOTINGS | 35 MPa (EXPOSURE CLASS C-1) |
| - PIERS, WALLS & CURBS | 35 MPa (EXPOSURE CLASS C-1) |
| - SLABS ON GRADE (INTERIOR) | 32 MPa (EXPOSURE CLASS N-CF) |
| - SLABS ON GRADE (EXTERIOR) | 35 MPa (EXPOSURE CLASS C-1) |
| - EXTERIOR APRONS..... | 35 MPa (EXPOSURE CLASS C-1) |
3. MINIMUM CONCRETE COVER TO REINFORCING BARS:

CONCRETE CLEAR COVER (CSA A23.1			
EXPOSURE CONDITION	EXPOSURE CLASS		
	N	F-1	C-1
CAST AGAINST AND PERMANENTLY EXPOSED TO EARTH, INCLUDING FOOTINGS AND PILES	75 mm	75 mm	75 mm
BEAMS, GIRDERS, COLUMNS AND PILES	30 mm (#1)	40 mm	60 mm
SLABS, WALLS, JOISTS, SHELLS AND FOLDED PLATES	20 mm (#1)	40 mm	60 mm
RATIO OF COVER TO NOMINAL BAR DIAMETER (#2)	1.0 (#1)	1.5	2.0
RATIO OF COVER TO NOMINAL MAXIMUM AGGREGATE SIZE	1.0 (#1 & #3)	1.5	2.0

NOTES:

- #1. THIS REFERS ONLY TO CONCRETE THAT WILL BE CONTINUALLY DRY WITHIN THE CONDITIONED SPACE (i.e., MEMBERS ENTIRELY WITHIN THE VAPOUR BARRIER OF THE BUILDING ENVELOPE).
- #2. THE COVER FOR A BUNDLE OF BARS SHALL BE THE SAME AS THAT FOR A SINGLE BAR WITH AN EQUIVALENT AREA.
- #3. THE SPECIFIED COVER FROM SCREEDED SURFACES SHALL BE AT LEAST 1.5 TIMES THE NOMINAL MAXIMUM AGGREGATE SIZE TO REDUCE INTERFERENCE BETWEEN AGGREGATE AND REINFORCEMENT WHERE VARIATIONS IN BAR PLACEMENT RESULT IN A COVER SMALLER THAN SPECIFIED.
4. DETAIL, BEND, PLACE AND SUPPORT REINFORCING STEEL IN CONFORMANCE WITH THE LATEST RSIC MANUAL OF STANDARD PRACTICE, UNLESS NOTED OTHERWISE.
5. ALTERNATE 90° HOOKS OF CROSSTIES END FOR END OVER HEIGHT OF ALL MEMBERS IN WHICH CROSSTIES ARE SPECIFIED.
6. ALL LAP SPLICES SHALL BE CLASS B TENSION SPLICES. FOR HORIZONTAL REINFORCEMENT THAT WILL BE PLACED IN SUCH A WAY THAT MORE THAN 300 mm OF FRESH CONCRETE IS CAST IN THE MEMBER BELOW THE SPLICE, BAR LOCATION FACTOR (k/1) EQUAL TO 1.3 SHALL BE APPLIED IN DETERMINING CLASS B TENSION SPLICE LENGTH, IN ACCORDANCE WITH APPLICABLE EDITION OF CSA-A23.3.
7. PLAIN (UNREINFORCED) CONCRETE EXPOSED TO DEICING CHEMICALS SHALL MEET EXPOSURE CLASS C-2 IN ACCORDANCE WITH APPLICABLE EDITION OF CSA-A23.1.
8. REINFORCED CONCRETE EXPOSED TO CHLORIDES SHALL MEET EXPOSURE CLASSIFICATION C-1 IN ACCORDANCE WITH APPLICABLE EDITION OF CSA-A23.1.
9. PROVIDE CORROSION INHIBITOR IN ALL CONCRETE OF EXPOSURE CLASS C-1. REFER TO SPECIFICATIONS FOR CORROSION INHIBITOR DOSAGE RATE.
10. USE TYPE GU PORTLAND CEMENT FOR ALL CONCRETE, UNLESS NOTED OTHERWISE.
11. ALL HORIZONTAL WALL AND GRADE BEAM REINFORCING SHALL BE CONTINUOUS THROUGH PIERS. UNLESS NOTED OTHERWISE, SPLICE TOP BARS AT MID-SPAN AND BOTTOM BARS AT SUPPORTS FOR ALL GRADE BEAMS.
12. WHEREVER OPENINGS OCCUR, INTERRUPTING ONE OR MORE REINFORCING BARS, IN SLABS OR WALLS, PROVIDE ADDITIONAL REINFORCING STEEL EQUAL TO THE REINFORCING STEEL DISPLACED BY THE OPENING UNLESS OTHERWISE SHOWN. DISTRIBUTE REINFORCEMENT EQUALLY ON EACH SIDE OF THE OPENING AND EXTENDING THE FULL SPAN LENGTH.
13. NO SLEEVES, PIPES, HOLES OR NOTCHES SHALL BE PLACED IN OR THROUGH WALLS, COLUMNS, PIERS, BEAMS, GRADE BEAMS, SLABS, FOOTINGS, OR ANY OTHER CONCRETE MEMBER, EXCEPT AS SHOWN ON THE STRUCTURAL DRAWINGS OR APPROVED BY THE ENGINEER.
14. DO NOT PLACE CONCRETE FOOTINGS OR ANY OTHER CONCRETE MEMBER UNTIL ALL DESIGNATED REINFORCING STEEL HAS BEEN PLACED AND INSPECTED AND ANY CONDUITS, PIPING OR OTHER EMBEDDED ITEMS ARE INSTALLED AND VERIFIED.
15. MAXIMUM WATER-TO-CEMENTING MATERIALS RATIO (w/cm) SHALL BE 0.55, AND MINIMUM 28-DAY COMPRESSIVE STRENGTH SHALL BE 25 MPa FOR ALL CONCRETE FLOOR SLABS (BOTH SLABS ON GRADE AND SLABS ON DECK).

FOUNDATION:

1. ALL INT. FOOTINGS SHALL BEAR ON NATIVE MATERIAL OR ENGINEERED FILL WITH MINIMUM SLS BEARING RESISTANCE OF 150 kPa AND MINIMUM ULS BEARING RESISTANCE OF 200 kPa, NOTED OTHERWISE.
2. ALL EXT. FOOTINGS SHALL BEAR ON SUITABLE FOUNDING MATERIAL WITH MINIMUM SLS BEARING RESISTANCE OF 150 kPa, MINIMUM ULS BEARING RESISTANCE OF 200 kPa, FRICTION ANGLE OF AT LEAST 35 ° AND MINIMUM FACTORED SLIDING RESISTANCE OF 150. MAX. ALLOWABLE TOTAL SETTLEMENT TO BE 25 mm. MAX. ALLOWABLE DIFFERENTIAL SETTLEMENT TO BE 25 mm.
3. ALL BEARING VALUES AND GEOTECHNICAL INFORMATION ARE BASED ON GEOTECHNICAL REPORT SEE PER BUILDING NOTES IF APPLICABLE
4. THE CONTRACTOR SHALL PROTECT SOIL FROM WATER AND FREEZING ADJACENT TO AND BELOW ALL FOOTINGS, GRADE BEAMS AND OTHER CONCRETE POURS WITH MINIMUM 1200 mm SOIL COVER OR EQUIVALENT.
5. ALL EXCAVATIONS AND FOUNDING MATERIAL SHALL BE INSPECTED AND APPROVED BY A QUALIFIED SOILS ENGINEER PRIOR TO CONCRETE PLACEMENT.
6. THE CONTRACTOR SHALL PROVIDE ALL SHORING WHERE REQUIRED DURING EXCAVATION TO PREVENT CAVE-IN.
7. EXCAVATION SHALL NOT EXTEND BELOW A LINE EXTENDING DOWN AND AWAY FROM ANY FOOTING EDGE OR CORNER AT A RATIO OF 7 VERTICAL TO 10 HORIZONTAL.
8. ANY OVER EXCAVATION NECESSITATED BY LOCAL SOFT AREAS OR OTHER DELETERIOUS CONDITIONS SHALL BE MADE GOOD WITH 15 MPa LEAN CONCRETE FILL.
9. FOUNDATION WALL BACKFILL SHALL BE OPSS TYPE 1 GRANULAR 'B' OR APPROVED FREE-DRAINING, IN-SITU MATERIAL COMPACTED, IN LAYERS NOT TO EXCEED 200 mm, TO 98% STANDARD PROCTOR MAXIMUM DRY DENSITY.
10. BACKFILL TO PROCEED SIMULTANEOUSLY ON BOTH SIDES OF FOUNDATION WALLS UNLESS TEMPORARY SUPPORT IS PROVIDED. DO NOT BACKFILL UNTIL CONCRETE HAS ATTAINED 75% OF ITS SPECIFIED 28-DAY COMPRESSIVE STRENGTH.
11. CONSTRUCTION JOINTS AND CONTROL JOINTS IN REINFORCED FOUNDATION WALLS SHALL BE LOCATED AT THE EDGE OF PIERS (WHERE PIERS ARE PRESENT). MAXIMUM SPACING OF CONSTRUCTION JOINTS SHALL BE AS REQUIRED, BUT NOT GREATER THAN 20 m. UNLESS NOTED OTHERWISE, MAXIMUM SPACING OF CONTROL JOINT'S SHALL BE 6 m, AND 3 m FROM CORNERS.
12. FOUNDATIONS SHALL BE CONSTRUCTED AS SHOWN ON THE DRAWINGS. CONTRACTOR SHALL INCLUDE IN THEIR WORK ALL PROVISIONS, INCLUDING BUT NOT LIMITED TO EXCAVATION AND FORMING, AS REQUIRED TO CONSTRUCT FOUNDATIONS THUS.

SLAB ON GRADE & PAD:

1. SEE PLAN FOR SLAB ON GRADE & PAD THICKNESS.
2. PLACE SLAB ON GRADE ON MIN. 200 mm OPSS GRANULAR 'A' COMPACTED TO 100% STANDARD PROCTOR MAXIMUM DRY DENSITY.
3. PRIOR TO PLACING GRANULAR FILL MATERIALS, PROOF-ROLL EXISTING SUB-GRADE TO IDENTIFY INCONSISTENCIES OR SOFT AREAS. PROCEED WITH GRANULAR PLACEMENT ONLY AFTER THESE AREAS HAVE BEEN REWORKED AND COMPACTED TO THE SATISFACTION OF THE SOILS ENGINEER.
4. DO NOT PLACE CONCRETE UNTIL ALL ELECTRICAL, MECHANICAL AND PROCESS CONDUITS, PIPING OR OTHER EMBEDDED SERVICES ARE INSTALLED AND VERIFIED.
5. AGREE ON LOCATION OF CONSTRUCTION JOINTS WITH ENGINEER PRIOR TO CONSTRUCTION.
6. PROVIDE SAWCUT CONTROL JOINTS AS SHOWN ON PLANS.
7. PROVIDE EXTERIOR COLUMN ISOLATION JOINTS AND SAWCUTTING AS PER DETAILS SHOWN.
8. PERFORM SAWCUTTING FOR CONTROL JOINTS USING DRY METHOD (SOFF-CUT SAW) AS SOON AS POSSIBLE AFTER CONCRETE PLACEMENT WITHOUT LEAVING TREAD MARKS, DISLODGING AGGREGATE AND BEFORE UNCONTROLLED SHRINKAGE OCCURS. FILL CONTROL JOINTS, AS SPECIFIED, NO SOONER THAN 120 DAYS AFTER CONCRETE PLACEMENT.
9. FLOOR FINISH: SEE SPECIFICATIONS.

METAL DECK:

1. ALL METAL DECK SHALL BE NEW AND SHALL BE DESIGNED, FABRICATED AND INSTALLED TO CONFORM TO THE REQUIREMENTS OF THE APPLICABLE EDITION OF CAN/CSA-S136 "NORTH AMERICAN SPECIFICATIONS FOR THE DESIGN OF COLD-FORMED STEEL STRUCTURAL MEMBERS (USING THE APPENDIX B PROVISIONS APPLICABLE TO CANADA)" AND THE REQUIREMENTS OF THE CANADIAN SHEET STEEL BUILDING INSTITUTE.
2. ALL ROOF AND FLOOR DECK SHALL BE DESIGNED AND DETAILED BY A PROFESSIONAL ENGINEER LICENSED TO PRACTICE IN THE PROVINCE OF ONTARIO, AND SHALL BE OF THICKNESS REQUIRED TO SUPPORT ALL LOADS AND EFFECTS SHOWN ON DRAWINGS BUT SHALL NOT BE LESS THAN THAT SHOWN ON DRAWINGS. AFOREMENTIONED DESIGN SHALL INCLUDE APPLICABLE SEISMIC LOADS & EFFECTS. REFER TO SPECIFICATION FOR COATING.
3. SPAN DECK UNITS OVER FOUR OR MORE STRUCTURAL SUPPORTS (MINIMUM 3 CONTINUOUS SPANS) FOR INCREASED RIGIDITY.
4. DESIGN AND CONNECT METAL EDGE AND CLOSURE STRIPS TO SAFELY RESIST CONSTRUCTION LOADS AND PREVENT THE LOSS OF CONCRETE/GROUT WHEN DECK IS CONCRETED.
5. PLACE DECK IN ACCORDANCE WITH MANUFACTURER'S SHOP DRAWINGS. END LAPS SHALL ALWAYS OCCUR OVER SUPPORTS. SIDE LAPS SHALL BE ON HALF CORRUGATION. MINIMUM ROOF DECK END LAP IS 50 mm FOR WELDED ATTACHMENT.
6. ALL CONNECTIONS OF ROOF DECK TO SUPPORTING STRUCTURE SHALL BE DESIGNED BY A PROFESSIONAL ENGINEER LICENSED TO PRACTICE IN THE PROVINCE OF ONTARIO TO RESIST ALL LOADS AND EFFECTS SHOWN ON DRAWINGS, BUT SHALL NOT BE LESS THAN THAT SHOWN ON DRAWINGS.
7. ATTACH DECK UNITS TO TOP OF SUPPORTS BY FUSION WELDS WITH A MINIMUM EFFECTIVE DIAMETER OF 19 mm. MAXIMUM SPACING OF FUSION WELDS AND SIDE LAP BUTTON CLINCH SHALL BE AS FOLLOWS:
- WELDS AT 150 C/C (EACH FLUTE) TRANSVERSE TO SPAN OF DECK AND AROUND PERIMETER
 - LONGITUDINAL WELDS @ 600 C/C
 - SIDE LAP BUTTON CLINCH @ 300 C/C
8. FIELD CUTTING OF DECK UNITS SHALL BE DONE IN WORKMANLIKE MANNER. CUT OPENINGS AND REINFORCE EDGES AS REQUIRED FOR PIPES, DUCTS, ETC. THE MAXIMUM SIZE OF AN UNREINFORCED OPENING IS 150 mm SQUARE OR IN DIAMETER. ROOF OPENINGS LARGER THAN 450 mm WIDE AND FLOOR OPENINGS LARGER THAN 300 mm WIDE SHALL BE SUPPORTED BY STEEL FRAMING.
9. DESIGN METAL ROOF DECK FOR MAXIMUM LIVE, SNOW AND RAIN LOAD DEFLECTIONS OF L/360.

MASONRY:

1. THE DESIGN AND CONSTRUCTION OF ALL WORK ON THIS PROJECT IS TO CONFORM TO APPLICABLE EDITION OF CSA STANDARDS CSA-S304.1, CSA-A370, CSA-A371, CSA-A179 AND CAN/CSA-G30.18. PROVIDE TYPE S MORTAR IN ACCORDANCE WITH APPLICABLE EDITION OF CSA STANDARD CSA-A179.
2. PROVIDE STANDARD, HOLLOW 15 MPa CONCRETE BLOCK UNITS UNLESS NOTED OTHERWISE. AT LOCATIONS WHERE VERTICALLY-REINFORCED MASONRY IS SPECIFIED, PROVIDE ONE ADDITIONAL VERTICAL BAR OF SIZE EQUAL TO DISTRIBUTED VERTICAL REINFORCING, FULL HEIGHT AT EACH SIDE OF CONTROL JOINTS, AND AT CORNERS, INTERSECTIONS, ENDS OF WALLS AND TO EACH SIDE OF ALL OPENINGS, UNLESS NOTED OTHERWISE. PROVIDE 2 ADDITIONAL BARS WHERE OPENING WIDTH IS GREATER THAN 1200 mm. PROVIDE MATCHING DOWELS TO FOOTING, SLAB THICKENING, SLAB ON DECK OR OTHER SUPPORTING STRUCTURE, FOR ALL VERTICAL WALL REINF. (TYP. UN).
3. FOR HIGH-LIFT GROUTING, PROVIDE CLEAN-OUT HOLES IN BOTTOM COURSE AND MINIMUM SLUMP OF 200 mm.
4. MASONRY GROUT SHALL BE FINE GROUT, AND SHALL BE PROPORTIONED ACCORDING TO, AND MEET ALL REQUIREMENTS OF APPLICABLE EDITION OF CSA-A179.
5. PROVIDE CONTINUOUS, HORIZONTAL, STANDARD LADDER-TYPE HORIZONTAL JOINT REINFORCEMENT @ 400 mm C/C, IN BOTTOM TWO BED JOINTS, TOP TWO BED JOINTS AND FIRST BED JOINT. ABOVE AND BELOW ALL WALL OPENINGS. ALL SUCH REINF. SHALL BE SPLICED USING CLASS B TENSION LAP SPLICES (AS DEFINED IN APPLICABLE EDITION OF CSA-S304.1). PREFABRICATED CORNER AND INTERSECTION JOINT REINFORCING PIECES SHALL BE USED. MINIMUM WIRE DIAMETER TO BE 3.65 mm.
6. REFER TO ARCHITECTURAL DRAWINGS FOR LOCATION OF ALL MASONRY WALLS.
7. PROVIDE VERTICAL REINFORCING IN ALL MASONRY WALLS AS PER TABLE ON SPECIFIC BLD. DRAWING ALL REINFORCED CORES SHALL BE GROUTED SOLID FOR FULL HEIGHT OF WALLS. VERTICALLY-CANTILEVERED WALLS SHALL BE CONSTRUCTED OF SOLID-GROUTED MASONRY.
8. PROVIDE VERTICAL REINFORCING AT EACH LATERAL SUPPORT LOCATION (SEE BLD. SPECIFIC DRW.)
9. LAP ALL 15M BARS 675 mm MINIMUM. LAP ALL 20M BARS 850 mm MINIMUM.
10. UNLESS NOTED OTHERWISE, MINIMUM CLEARANCE OF XX mm SHALL BE PROVIDED BETWEEN MASONRY WALLS AND STEEL COLUMNS, BEAMS, GIRDERS, JOIST AND GIRTS. THIS REQUIREMENT DOES NOT APPLY WHERE MASONRY IS INTENDED (BY DESIGN) TO BEAR ON STEEL MEMBER.
11. WHERE POST-INSTALLED ANCHORS ARE INSTALLED IN MASONRY ELEMENTS/MEMBERS, EXISTING REINFORCING STEEL (INCLUDING HORIZONTAL BED JOINT REINFORCING), CAST-INS AND EMBEDDED ITEMS SHALL BE ACCURATELY LOCATED, AND EDGE OF ANCHOR HOLES SHALL BE LOCATED A DISTANCE AWAY FROM EXISTING REINFORCING STEEL (INCLUDING HORIZONTAL BED JOINT REINFORCING), CAST-INS END EMBEDDED ITEM SUCH THAT AT LEAST MINIMUM CONCRETE COVER REQUIREMENTS (SEE MASONRY NOTE #1) ARE MET. EXISTING REINFORCING STEEL (INCLUDING HORIZONTAL BED JOINT REINFORCING), CAST-INS AND EMBEDDED ITEMS SHALL NOT BE DAMAGED ANCHORING ACTIVITIES, INCLUDING DRILLING.
12. MORTAR SHALL BE TYPE :S: PREPARED BY PROPORTION SPECIFICATION IN ACCORDANCE WITH CAN/CSA-A179.
13. HOLLOW CONCRETE BLOCK MASONRY WITH MORTAR TYPE "S" SHALL HAVE A MINIMUM ULTIMATE COMPRESSIVE STRENGTH OF 12.5 MPa - f_m.
14. ALL INTERSECTING MASONRY WALLS TO HAVE MASONRY BOND OR HEAVY DUTY (BLOCK-LOCK) OR EQUIVALENT AT 200mm VERTICALLY MAXIMUM.
15. A MINIMUM 50 mm WIDE ISOLATION JOINT SHALL BE PROVIDED AT ALL LOCATIONS WHERE MASONRY WALLS INTERSECT VERTICAL FACES OF CONCRETE STRUCTURE. NO POSITIVE CONNECTION BETWEEN MASONRY MASONRY WALLS AND VERTICAL FACES OF CONCRETE STRUCTURE SHALL BE MADE.
16. CONCRETE AND STEEL BEAMS BEARING ON MASONRY WALLS SHALL HAVE A MINIMUM BEARING OF 200mm UNLESS OTHERWISE NOTED ON PLAN.
17. PROVIDE 15M DOWELS WITH 150 mm MIN. EMBEDMENT TO THE EXISTING SLAB TO MATCH ALL VERTICAL REINFORCING, UNLESS NOTED OTHERWISE. SCAN EXISTING SLAB PRIOR TO DOWEL INSTALLATION.
18. PROVIDE LINTELS OVER ALL OPENINGS AND RECESSES FOR MECHANICAL AND ELECTRICAL TRADES AS SPECIFIED ON PLANS. SEE ARCHITECTURAL AND MECHANICAL DRAWINGS FOR LOCATIONS AND SIZES OF OPENINGS AND RECESSES.
19. PROVIDE VERTICAL REINFORCEMENT IN ALL NON-LOAD BEARING CMU WALLS AS FOLLOWS IN ADDITION TO THAT NOTED IN (2):
- | WALL THK. | MAX HEIGHT. | REINFORCEMENT. |
|-----------|-------------|----------------|
| 140mm | 4200mm | 15M@600 |
| 190mm | 5500mm | 15M@600 |
| 240mm | 6000mm | 15M@600 |


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PROJECT TITLE		
CITY OF TORONTO ACCESSIBILITY UPGRADES		
PROJECT ADDRESS		
PROJECT NO: 9119- 19- 0162 / Arcadis 30279056		
DRAWN BY: G. POULOU	CHECKED BY: M. FAYAZI	
PROJECT MGR: N. FRISCI	APPROVED BY: K. ANGER	

SHEET TITLE		
STRUCTURAL - GENERAL NOTES		
SHEET NUMBER		
G05-GAL-G2000		

ISSUE		
E		

REINFORCING STEEL


1. ALL REINFORCING STEEL SHALL CONFORM TO CAN/CSA-G30.18-M-2009 (R2014), GRADE 400W.
2. MINIMUM CLEAR SPACING BETWEEN PARALLEL REINFORCING BARS SHALL BE 1.4 TIMES THE BAR DIAMETER, 1.4 TIMES THE MAX. AGGREGATE SIZE OR 30mm WHICHEVER IS GREATER. PROVIDE 75mm MINIMUM LAPPED REBAR CLEARANCE FOR CONCRETE VIBRATOR ACCESS.
3. DEVELOPMENT LENGTHS AND LAP SPLICES SHALL BE IN ACCORDANCE WITH THE REINFORCING STEEL INSTITUTE OF CANADA, MANUAL OF STANDARD PRACTICE UNLESS INDICATED OTHERWISE. ALL LAP SPLICES SHALL BE CLASS 'B' TENSION LAP SPLICES AND CLASS 'B' TENSION LAP SPLICES SHALL BE PROVIDED FOR ALL SHRINKAGE AND TEMPERATURE BARS. WHERE TWO BARS OF DIFFERENT DIAMETERS ARE LAPPED, PROVIDE CLASS 'B' TENSION LAP LENGTH CORRESPONDING TO THE SMALLER BAR BUT NO LESS THAN FULL TENSION DEVELOPMENT LENGTH OF THE LARGER BAR.
4. PROVIDE EMBEDMENT LENGTH FOR FULL TENSION DEVELOPMENT IN ACCORDANCE WITH CSA A23.3
5. DEVELOPMENT LENGTH AND SPLICE LENGTH FOR FY = 400MPa AND F'C=35MPa TO BE AS PER TABLE BELOW, UNLESS OTHERWISE SHOWN ON DRAWINGS.

		fc' = 35MPa		fy = 400MPa			
BAR SIZE	TENSION STEEL				COMPRESSION STEEL		
	HORIZONTAL TOP BARS*		ALL OTHER BARS**				
	DEVELOPMENT	SPLICES	DEVELOPMENT	SPLICES	DEVELOPMENT	LAP SPLICES	
(mm)	(mm)	(mm)	(mm)	(mm)	(mm)	(mm)	
10	360	470	280	370	200	330	
15	510	670	390	510	290	470	
20	620	810	480	630	350	590	
25	1000	1300	770	1010	450	740	
30	1190	1550	910	1190	530	880	
35	1420	1850	1090	1420	630	1050	
45	-	-	-	-	800	-	

REFERENCE: CAN/CSA A23.3-14
db= MAX. OF NORMAL AND ACTUAL BAR DIAMETER
* HORIZONTAL TOP BARS WITH MORE THAN 300mm OF FRESH CONCRETE POURED BELOW THE BARS. AND WALL HORIZONTAL REINFORCEMENT.
** HORIZONTAL BARS WITH NOT MORE THAN 300mm OF FRESH CONCRETE POURED BELOW THE BARS, VERTICAL BARS.

6. STANDARD 90° HOOK TO CONFORM TO A23.3 AND THE FOLLOWING TABLE, WHICHEVER IS MORE STRINGENT, UNLESS OTHERWISE SHOWN ON DRAWINGS.

fc' = 35MPa		fy = 400MPa	
BAR SIZE	D***	A	l _{db} ****
d _b (mm)	(mm)	(mm)	(mm)
10M	70	190	150
15M	100	260	190
20M	120	320	240
25M	150	410	300
30M	250	520	360
35M	300	620	430

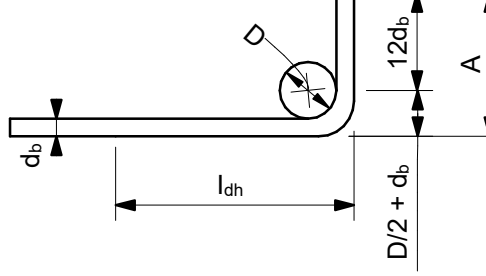

90° HOOK SEE A23.3
*** SEE A23.1, TABLE 16
**** SEE A23.3, §12.5.1, §12.5.3 (b) = 0.7x100d_b / f_c^{0.5} > 150 OR 8 d_b.

STRUCTURAL STEEL:

1. THE DESIGN AND CONSTRUCTION OF ALL WORK IN THIS PROJECT SHALL CONFORM TO THE APPLICABLE EDITION OF CAN/CSA-S16.
2. ALL SHOP CONNECTIONS SHALL BE WELDED. ALL FIELD CONNECTIONS SHALL BE WELDED OR BOLTED USING HIGH TENSILE-STRENGTH BOLTS, BEARING TYPE. WHERE APPLICABLE, AND UNLESS NOTED OTHERWISE, CONNECTIONS SHALL BE CISC DOUBLE ANGLE BEAM CONNECTIONS FOR A325 BOLTS AND E49XX FILLET WELDS. MINIMUM SIZE OF BOLTS - M20 DIAMETER.
3. ALL WELDING SHALL BE CARRIED OUT IN ACCORDANCE WITH APPLICABLE EDITION OF FOLLOWING CSA STANDARDS:
- W47.1 FOR QUALIFICATIONS OF WELDERS
- W48.1 TO W48.7 FOR ELECTRODES
- W59 FOR DESIGN AND WORKMANSHIP
4. ALL COLUMN ENDS SHALL BE SAWCUT AND WELDED TO BASE/CAP PLATES.
5. ALL COLUMNS TO HAVE ANGLES AT TOP TO SUPPORT STEEL DECK WHERE REQUIRED.
6. BRACING MEMBERS SHALL BE CONNECTED FOR THE FOLLOWING (WHICHEVER IS LARGER):
- 50% OF THE NOMINAL TENSION CAPACITY OF THE MEMBER BASED ON GROSS AREA
- FORCES AS SHOWN ON THE DRAWINGS
- A MINIMUM OF TWO BOLTS
7. FOR DOUBLE-ANGLE BRACING (E.G. CROSS-BRACING), ANGLES SHALL HAVE INTERCONNECTING BATTENS AND/OR SPACERS SUCH THAT SLENDERNESS RATIO OF INDIVIDUAL ANGLES (BASED ON LEAST RADIUS OF GYRATION OF INDIVIDUAL ANGLES) DOES NOT EXCEED SLENDERNESS RATIO OF BUILT-UP (DOUBLE-ANGLE) MEMBER.
8. THE CONTRACTOR SHALL SUPPLY, INSTALL, MAINTAIN AND REMOVE ANY TEMPORARY BRACING REQUIRED DURING CONSTRUCTION.
9. FORCES ARE DESIGNATED BY (+) FOR TENSION AND (-) FOR COMPRESSION.
10. CONNECTIONS FOR BEAMS, GIRDERS AND JOISTS SUBJECT TO AXIAL FORCES SHALL BE DESIGNED FOR THE AXIAL FORCES IN ADDITION TO THE SHEAR FORCES, MOMENT FORCES/EFFECTS AND TORSION FORCES/EFFECTS. FORCES INDICATED ARE FACTORED AND IN KN. MOMENTS AND TORSIONS INDICATED ARE FACTORED AND IN KN-m.
11. ALL EXTERIOR STEEL, AND STEEL THAT IS NOT IN A TEMPERATURE AND HUMIDITY CONTROLLED ENVIRONMENT, SHALL BE HOT-DIPPED GALVANIZED (BOTH STRUCTURAL STEEL AND MISCELLANEOUS STEEL). THIS SHALL INCLUDE NUTS, BOLTS, WASHERS, BASE PLATES, LEVELING PLATES, ANCHOR BOLTS AND ANCHORS.
12. FILLER BEAMS AND JOISTS SHALL BE PLACED EQUALLY BETWEEN ESTABLISHED DIMENSIONS, UNLESS NOTED OTHERWISE.
13. PROVIDE WELDED STIFFENER PLATES ON BOTH SIDES OF THE WEB OF BEAMS AND GIRDERS AT POINTS OF CONCENTRATED LOAD, INCLUDING BEAMS AND GIRDERS SUPPORTING COLUMNS OR RUNNING OVER TOPS OF COLUMNS. MINIMUM STIFFENER PLATE THICKNESS SHALL BE 10 mm OR FLANGE THICKNESS OF COLUMNS ABOVE OR BELOW, WHICHEVER IS GREATER. MINIMUM SIZE OF WELD SHALL BE 5 mm DOUBLE FILLET WELD, OR SHALL BE SUFFICIENT TO DEVELOP THE FULL STRENGTH OF THE STIFFENER, WHICHEVER IS GREATER.
14. FOR LOCATIONS OF DOOR FRAMES, WALL OPENINGS, ROOF AND FLOOR OPENINGS, ETC., AND RELATED DETAILS, SEE ARCHITECTURAL, MECHANICAL, ELECTRICAL, PROCESS & CIVIL DRAWINGS.
15. SHOWN ON PLANS DENOTES AXIAL LOADS ALONG BEAMS AND GIRDERS DUE TO WIND OR EARTHQUAKE LOADS. DESIGN BEAM-TO-BEAM, BEAM-TO-GIRDER AND GIRDER-TO-GIRDER CONNECTIONS, AS WELL AS BEAM-TO-COLUMN AND GIRDER-TO-COLUMN CONNECTIONS FOR THESE LOADS IN COMBINATION WITH APPLICABLE GRAVITY LOADS.
16. PERIMETER ROOF ANGLE SHALL BE CONTINUOUS AND BUTT WELDED TOGETHER AT JOINTS. ENSURE CONNECTION OF PERIMETER ANGLE TO SUPPORTING STRUCTURE IS SUFFICIENT TO RESIST MAXIMUM UNIT SHEAR FROM DECK DIAPHRAGM. REFER TO ROOF-DIAPHRAGM SHEAR DIAGRAM ON DRAWINGS
17. ALL WELDABLE REINFORCING STEEL ANCHORS SHALL BE WELDED TO BASE PLATES/BEARING PLATES TO FULLY DEVELOP BARS IN TENSION.
18. REFER TO SPECIFICATIONS FOR BEAM AND GIRDER CAMBER REQUIREMENTS.

ABBREVIATIONS:

2L	two angles	HP	high point
AB	anchor bolt	HS	high strength
ADD	addendum	ID	inside diameter
ADJ	adjacent	IE	invert elevation
AFF	above finished floor	IF	inside face
AHU	air handling unit	IN	inches
ALT	alternate	INCL	include
ANC	anchor	INFO	information
APPROX	approximate	JT	joint
ARCH	architectural	KN	kilnewton
ASTM	American Society for Testing and Materials	kNm	kilnewton meter
B/B	back to back	kPa	kilopascal
BC	bottom chord	L	length
BET	between	LB	pound
BLDG	building	LG	long
BLK	block	LL	live load
BM	beam	LLBB	long legs back-to-back
BOF	bottom of footing	LLH	long leg horizontal
BOS	bottom of steel	LLV	long leg vertical
BOT	bottom	LO	louver opening
BRG	bracing	LP	low point
BRCG	bearing	LS	louver sill
BRK	bracket	m	metre
BSMT	basement	MACH	machine
CA	column above	MAX	maximum
CB	column below	MECH	mechanical
C/C	center to center	MEZZ	mezzanine
CERT	certified	MFR	manufacturer
CHKD PL	checkered plate	MIN	minimum
CIP	cast in place	MISC	miscellaneous
CJ	construction joint	mm	millimetre
CL	centerline	MT	metric ton
CLJ	control joint	NIC	not in contract
CLR	clear	NO	number
COL	column	NTS	not to scale
CONC	concrete	O/O	out to out
CONN	connection	OPNG	opening
CONSTR	construction	OPP	opposite
CONT	continuation (continuous)	PC	piece
CONTR	contractor	PEN	penetration
CSA	Canadian Standards Association	PL	plate
CT	cooling tower	PROJ	projection
CTR	center	PSF	pounds per square foot
CW	complete with	PSI	pounds per square inch
DET	detail	RCB	reinforced concrete beam
DIA	diameter	REF	reference
DIAG	diagonal	REINF	reinforcement
DIM	dimension	REMV	removable
DL	dead load	REQD	required
DO	door opening	RR	railroad
DWG	drawing	R/W	reinforced with
DWL	dowel	SCH	schedule
EA	each	SECT	section
EF	each face	SIM	similar
EL	elevation	SOG	slab on grade
ELEC	electrical	SP	space
EMB	embedment	SPEC	specifications
EQ	equal	SQ	square
EQPT	equipment	SSC	structural steel contract
EW	each way	STAGG	staggered
EXP	expansion	STD	standard
EX	existing	STIFF	stiffener
EXT	exterior	STL	steel
FDN	foundation	STRU	structural
FDNC	foundation contract	SYM	symmetrical
FIN	finish	t	thickness
FL	floor	T	tread
FLG	flange	T&B	top and bottom
FT	feet	TC	top chord
FTG	footing	TEMP	temperature
FUT	future	THK	thick
GA	gauge	TL	total load
GC	general contract	TOF	top of footing
GALV	galvanized	TOS	top of steel
GENL	general	TYP	typical
GOL	gauge outstanding leg	UON	unless otherwise noted
GR	grade	VERT	vertical
GRT	grating	VIF	vertical inside face
H	high	VOF	vertical outside face
HEF	horizontal each face	W	width (wide)
HGR	hanger	W	width
HGT	height	W/O	without
HH	hooked-hooked	WP	working point
HIF	horizontal inside face	WPL	wall plate
HOF	horizontal outside face	WS	water stop
HORIZ	horizontal	WT	weight
		WWF	welded wire fabric

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PROJECT TITLE

CITY OF TORONTO
ACCESSIBILITY UPGRADES

PROJECT ADDRESS

PROJECT NO: 9119- 19- 0162 / Arcadis 30279056	
DRAWN BY: G. POULOU	CHECKED BY: M. FAYAZI
PROJECT MGR: N. FRISCIC	APPROVED BY: K. ANGER

SHEET TITLE

STRUCTURAL - GENERAL
NOTES, SYMBOLS &
ABBREVIATIONS

SHEET NUMBER	ISSUE
G05-GAL-G2002	E

CONTROLS POINT FUNCTION ABBREVIATION						
FIRST LETTER		SECOND LETTER		THIRD LETTER		FOURTH LETTER
A	AIR	A	H-O-A STATUS	H	HIGH	
C	COMPRESSED GAD	C	CLOSE	L	LOW	
D	DAMPER	E	VOLTAGE	X	TRASMITTER	
E	EQUIPMENT	F	FIRE (ALARM) SMOKE	Z	INDICATING TRANSMITTER	
G	NATURAL GAS	FL	FLOW	D	DIFFERENTIAL	
L	LIQUID	H	HUMIDITY			
S	STEAM	I	CURRENT			
V	VALVE	L	LEVEL			
M	MISCELLANEOUS	O	OPEN			
		OL	OVERLOAD			
		OR	OVERRIDE			
		P	PRESSURE			
		SS	START / STOP			
		ST	STATUS			
		T	TEMPERATURE			
		V	VELOCITY / SPEED			
		WT	WINDING TEMPERATURE			
		X	POSITION			
		Y	SERIAL COMM'S			

BMS POINT
NOTE: IF AN INSTRUMENT IS NOT DESIGNATED AS A TRANSMITTER "X" OR AN INDICATING TRANSMITTER "Z", IT IS A SENSOR OR SWITCH, DEPENDING ON POINT TYPE.

XX - YYYY

POINT FUNCTION ABBREVIATION
POINT TYPE

AI: ANALOG INPUT
AO: ANALOG OUTPUT
DI: DIGITAL INPUT
DO: DIGITAL OUTPUT
HW: HARDWIRED
SC: SERIAL COMMUNICATION

e.g. DO - ESS

START / STOP
EQUIPMENT
DIGITAL OUTPUT

GENERAL NOTES

- FOR ROOF OPENING AND ROOF CURB DETAILS SEE ARCHITECTURAL DRAWINGS.
- ALL FRESH AIR OR EXHAUST AIR LOUVRES IN BUILDING WALLS BY GENERAL TRADES UNLESS OTHERWISE NOTED. FOR DETAILS SEE ARCHITECTURAL DRAWINGS.
- ALL STORM COLLAR FLASHINGS BY MECHANICAL FOR DETAILS OF FLASHINGS SEE ARCHITECTURAL DRAWINGS.
- THE CONTRACTOR SHALL VERIFY ALL CONDITIONS AND MEASUREMENTS AT THE SITE AND REPORT TO THE OWNER'S REPRESENTATIVE ANY DISCREPANCIES OR UNSATISFACTORY CONDITIONS WHICH MAY ADVERSELY AFFECT THE PROPER COMPLETION OF THE WORK.
- DIMENSIONS SHOWN ARE FOR PREFERRED LOCATION AND GENERAL ARRANGEMENT OF MECHANICAL SYSTEMS. IT SHALL REMAIN THE CONTRACTORS RESPONSIBILITY TO ENSURE OVERALL COORDINATION OF HIS WORK WITH OTHER TRADES. SHOULD DEVIATION FROM LOCATIONS SHOWN ON DRAWINGS BECOME NECESSARY DUE TO CONFLICTS WITH OTHER TRADES OR LOCAL PROBLEMS THEY MUST BE BROUGHT TO THE ATTENTION OF THE OWNER'S REPRESENTATIVE FOR APPROVAL PRIOR TO PROCEEDING WITH WORK.
- THIS IS THE STANDARD SHEET FORM NOT ALL ITEMS ARE ASSOCIATED WITH THIS PROJECT.
- ALL EXISTING SERVICES TO REMAIN UNLESS NOTED OTHERWISE.
- ALL SYSTEMS TO REMAIN FUNCTIONAL UNLESS PERMISSION FOR SHUTDOWN IS GRANTED BY THE OWNER.

GENERAL NOTES: PLUMBING & DRAINAGE

- ALL SANITARY DRAINS NPS 4 SIZE & LARGER SHALL SLOPE AT 1.0%. ALL SANITARY DRAINS NPS 3 & SMALLER SHALL SLOPE AT 2%.
- ALL PLUMBING, DRAINAGE & VENTING SHALL BE IN CONFORMANCE WITH PART 7 OF THE O.B.C. AND IS THE RESPONSIBILITY OF THE PLUMBING CONTRACTOR.
- ALL VENTING AND TRAP SEAL PRIMER NOT SHOWN BUT REQUIRED, SHALL BE BY PLUMBING CONTRACTOR.
- ALL DOMESTIC COLD AND HOT WATER PIPING SHALL BE THERMALLY INSULATED.
- ALL ABOVE GROUND HORIZONTAL RAIN WATER LEADER AND STORM DRAIN SHALL BE THERMALLY INSULATED.

GENERAL NOTES: FIRE PROTECTION

- ALL MATERIAL SHALL BE UNDERWRITER'S LABORATORIES OF CANADA (ULC) LISTED AND SHALL COMPLY WITH THE OWNER'S INSURER'S STANDARDS AND REQUIREMENTS AND LOCAL AUTHORITIES HAVING JURISDICTION.
- FIRE PROTECTION CONTRACTOR TO COORDINATE ON SITE WITH OTHER TRADES BEFORE ANY WORK IS DONE. ANY SERVICE RELOCATION DUE TO INSUFFICIENT COORDINATION TO BE DONE AT NO EXTRA COST TO THE OWNER. BEFORE PROCEEDING WITH WORK, DUCTWORK, PIPING AND ELECTRICAL DRAWINGS TO BE STUDIED BY FIRE PROTECTION CONTRACTOR. SHOP DRAWINGS TO REFLECT COORDINATED ELEVATIONS.
- REFER TO MECHANICAL AND ELECTRICAL DRAWINGS FOR SIZE AND LOCATION OF DUCTWORK, PIPING, AND LIGHTING FIXTURES, ETC.
- DETAILED FIRE PROTECTION DESIGN SHOP DRAWINGS TO BE STAMPED BY PROFESSIONAL ENGINEER LICENSED IN ONTARIO AND TO BE SUBMITTED TO CONSULTANT AND AUTHORITY HAVING JURISDICTION FOR REVIEW.
- PROVIDE TYPE ABC FIRE EXTINGUISHERS AS PER ONTARIO FIRE CODE. FINAL LOCATION TO BE COORDINATED ON FIELD.
- FIRE PROTECTION CONTRACTOR TO PROVIDE PIPE HANGERS AS PER NFPA 13.
- FIRE PROTECTION SYSTEM SHALL BE SUPPLIED AND INSTALLED IN ACCORDANCE WITH THE LATEST EDITION OF NFPA 13.
- CONTRACTOR TO CONDUCT FLOW TEST AND USE THE RESULTS FOR HYDRAULIC CALCULATIONS.
- HYDRAULIC CALCULATION SHALL START AT FIRE MAIN BUILDING CONNECTION. MAXIMUM SYSTEM PRESSURE TO BE 35KPA (5 PSI) LESS THAN THE PRESSURE TEST RESULT AT REQUIRED FLOW RATE, TO ACCOUNT FOR FUTURE FLUCTUATION IN WATER SUPPLY PRESSURE.
- PIPE DIMENSIONS TO BE DETERMINED BY THE RESULTS OF HYDRAULIC CALCULATION.
- SPRINKLER SYSTEMS TO BE HYDRAULICALLY DESIGNED TO DELIVER THE DENSITIES OVER THE MOST REMOTE AREA AS LISTED IN THE SCHEDULE.
- SPRINKLER COVERAGES INDICATED ARE TO BE CONFIRMED BY FIRE PROTECTION CONTRACTOR.
- PROVIDE SPRINKLER PROTECTION UNDER ALL PLATFORMS INCLUDING BUT NOT LIMITED TO CONVEYORS, STAIRS, CATWALKS, SHELVING PLATFORMS, OVERHEAD DOORS, MEZZANINES, DUCTS OR ANY OBSTRUCTIONS WIDER THAN 1200MM.
- SPRINKLER SHOWN ARE FOR COORDINATION PURPOSE ONLY. FINAL LOCATION OF THE SPRINKLERS TO BE DETERMINED BY FIRE PROTECTION CONTRACTOR BASED ON HYDRAULIC CALCULATIONS.
- USE UPRIGHT SPRINKLER IN SPACE WITHOUT CEILING.
- LOCATE SPRINKLER HEADS IN THE CENTRE OF CEILING TILES.
- SPRINKLER HEAD LOCATION TO BE COORDINATED WITH ARCHITECT PRIOR TO SHOP DRAWING PRODUCTION.
- PIPING AND SPRINKLER HEADS MARKED FOR DEMOLITION TO BE REMOVED AND DISPOSED OF FROM SITE UNLESS OTHERWISE NOTED.
- REFER TO EXISTING SHOP DRAWINGS.
- ALL EXISTING SPRINKLERS TO BE ADJUSTED TO SUIT NEW BUILDING LAYOUT IN ACCORDANCE WITH NFPA 13.
- PROVIDE FIRE WATCH DURING SHUT DOWN.

GENERAL NOTES: HVAC

- ALL DUCTWORK TO BE INSTALLED TO LOW-PRESSURE DUCTWORK TO S.M.A.C.N.A. STANDARDS.
- DUCTWORK: FABRICATED OF PRIME QUALITY GALVANIZED STEEL SHEETS WITH Z275 (G90) DESIGNATION ZINC COATING TO ASTM A653/A653M
- ALL DUCTWORK C/W SEAL CLASS 'A' AS PER S.M.A.C.N.A. STANDARDS.
- ALL EXHAUST DUCTWORK SHALL BE THERMALLY INSULATED FOR 1500mm BEFORE EXITING THE BUILDING ENVELOPE.
- ALL FLEXIBLE DUCT TO BE MAXIMUM 3000MM LONG AND INSULATED.
- ALL SUPPLY AIR DUCTWORK INSIDE CEILING SPACE SHALL BE THERMALLY INSULATED.
- ALL REFRIGERANT LINES SHALL BE THERMALLY INSULATED.
- ALL CONDENSATE DRAIN SHALL BE THERMALLY INSULATED.
- ALL CONTROL WIRING SHALL BE FT-6 RATED.

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
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

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DRAWN BY: K.DURUKAN	CHECKED BY: B.LIAO
PROJECT MGR: N. FRISCIC	APPROVED BY: S. LIU

SHEET TITLE
MECHANICAL LEGEND
SHEET 2 OF 2

SHEET NUMBER G05-GAL-G3002	ISSUE D
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										<table><tr><th>No.</th><th>DESCRIPTION</th><th>DATE</th></tr><tr><td>A</td><td>50% SUBMISSION</td><td>2022-01-20</td></tr><tr><td>B</td><td>90% SUBMISSION</td><td>2022-02-22</td></tr><tr><td>C</td><td>ISSUED FOR PERMIT</td><td>2022-03-18</td></tr><tr><td>D</td><td>ISSUED FOR TENDER</td><td>2025-04-11</td></tr></table>		No.	DESCRIPTION	DATE	A	50% SUBMISSION	2022-01-20	B	90% SUBMISSION	2022-02-22	C	ISSUED FOR PERMIT	2022-03-18	D	ISSUED FOR TENDER	2025-04-11
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DRAWN BY: V. MAC		CHECKED BY: M. BOJIC		
PROJECT MGR: F.BOLOURIAN		APPROVED BY: P. WILLIAMS		
SHEET TITLE				
ELECTRICAL LEGEND 2				
SHEET NUMBER		ISSUE		
G05-G4002		D		

MOUNTING HEIGHTS SCHEDULE		
MOUNTING HEIGHTS TO TOP OF DEVICE.		
ALL DIMENSIONS ARE ABOVE FINISHED FLOOR (AFF) UNLESS NOTED OTHERWISE.		
LIGHT SWITCH	1050mm	
RECEPTACLE - FINISHED AREAS	460mm	
RECEPTACLE - UNFINISHED AREAS	1050mm	
RECEPTACLE - ABOVE COUNTER	300mm	ABOVE COUNTER
DATA OUTLET - FINISHED AREA	460mm	
DATA OUTLET - UNFINISHED AREA	1050mm	
FIRE ALARM MANUAL PULL STATION	1200mm	
FIRE ALARM HORN/STROBE	2460mm	
FIRE ALARM STROBE	2460mm	
FIRE ALARM END OF LINE DEVICE	1500mm	
FIRE ALARM HEAT DETECTOR	CEILING	
FIRE ALARM SMOKE DETECTOR	CEILING	
FIRE ALARM REMOTE ANNUNCIATOR	2000mm	
PANEL	2000mm	
CONTROL PANEL	2000mm	
MOTOR STARTER	1800mm	
DISCONNECT SWITCH	1800mm	
PUSH BUTTON STATION	1050mm	
DOOR ACCESS CONTROL CARD READER	1050mm	
VIDEO INTERCOM		AS PER MANUF. INSTRUCTION
DOOR BY-PASS KEYED SWITCH	1050mm	
BATTERY OPERATED EMERGENCY LIGHT	2700mm	
EMERGENCY LIGHT BATTERY UNIT	2700mm	
THERMOSTAT	1200mm	
MOUNTING HEIGHTS AS APPLICABLE		

1. PROVIDE 1-#6 GND WIRE FOR ALL UNDERGROUND EMPTY CONDUITS AND COMMUNICATIONS CONDUITS WITHOUT METAL WIRING/CABLES TO FACILITATE FUTURE INSTALLATION.
2. NO SPLICES ARE ALLOWED FOR COMMUNICATION CABLES.
3. NO SPLICES ARE ALLOWED BELOW GRADE FOR POWER WIRE AND CABLE.
4. THERE MUST BE A BREAK IN ALL UNDERGROUND CONDUITS OUTSIDE THE BUILDING/TOWERS/ELECTRICAL/COMMUNICATIONS/BOILER ROOM TO ALLOW DRAINAGE OF RACEWAY BEFORE ENTERING THE ROOMS.
5. PROVIDE LAYOUT (WITH DIMENSIONS) OF ALL UNDERGROUND PULL POINTS INCLUDING HAND HOLES, MAN HOLES AND CONCRETE PULL BOXES TO THE CONSULTANT FOR APPROVAL PRIOR TO INSTALLATION.
6. INSTALL HAND HOLES AWAY FROM MAJOR TRAFFIC AREAS (TYPICAL).
7. PROVIDE HEAT TRACING PROTECTION FOR WATER PIPES, STORM PIPES AND SANITARY PIPES AS SHOWN ON ELECTRICAL DRAWINGS. REFER TO MECHANICAL DRAWINGS FOR PIPING LAYOUT. HEAT TRACING SHALL BE RAYCHEM MODEL 48XL-TRACE, 208V, 1PH, SELF REGULATING TRACING CABLE OR APPROVED EQUIVALENT, C/W POWER SUPPLY MODULE, THERMOSTAT AND ALL ACCESSORIES FOR A COMPLETE AND FUNCTIONING SYSTEM. STARTUP TEMPERATURE -29°C (-20°F).
8. WHERE CONDUITS ARE INSTALLED ACROSS EXPANSION JOINTS, PROVIDE CONDUITS WITH EXPANSION/CONTRACTION FITTINGS.
9. ELEVATOR FIRE ALARM AUTOMATIC RECALL:
ELEVATOR LOBBY MOUNTED FIRE DETECTORS AND SECURITY PANEL TO RECALL ELEVATORS TO DESIGNATED LEVEL UPON FIRE ALARM. SHOULD DETECTOR AT DESIGNATED LEVEL, ELEVATOR LOBBY INDICATE FIRE, ELEVATOR TO BE DIRECTED TO ALTERNATE LEVEL. REFER TO ELEVATOR AUTOMATIC FIRE RECALL SCHEDULE. ELEVATOR CONTRACTOR TO COORDINATE WITH TSSA AND CONFIRM DESIGNATED/ALTERNATE LEVELS.
10. SMOKE DETECTOR AT TOP OF ELEVATOR SHAFT TO BE AIR SAMPLING SMOKE DETECTOR TYPE. INSTALL CONTROL UNIT IN A TAMPER PROOF ENCLOSURE (NEMA 4X) OUTSIDE OF ELEVATOR CLOSET. AIR SAMPLING SMOKE DETECTOR TO BE EST READY SET BY EDWARDS OR APPROVED EQUAL.
11. SITE PLAN DRAWINGS INDICATE UNDERGROUND POWER CONDUITS AND CORRESPONDING PULL POINTS FOR CONCRETE PULL BOXES OR HAND HOLES OR MAN HOLES. WHERE OEC REQUIRES ADDITIONAL PULL POINTS FOR WIRING SEPARATION, PROVIDE ADDITIONAL CONCRETE PULL BOX (OR HAND HOLE) AS REQUIRED. IF AN ADDITIONAL MAN HOLE IS REQUIRED, IT IS PREFERRED TO PROVIDE AN ADDITIONAL HAND HOLE OR CONCRETE PULL BOX IF POSSIBLE.

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PROJECT ADDRESS

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DRAWN BY: V. MAC	CHECKED M. BOJIC
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PROJECT MGR: F.BOLOURIAN	APPROVED BY P. WILLIAMS
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SHEET TITLE
ELECTRICAL GENERAL
NOTES

SHEET NUMBER
G05-G4002

ISSUE
D

CITY OF TORONTO

ACCESSIBILITY UPGRADES

TYPICAL DETAILS BOOKLET

9119- 19- 0162 / Arcadis 30279056

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D1002	DOOR ENLARGEMENT
D1201	ACCESSIBLE WASHROOM, SHOWER & ACCESSORIES DETAILS
D1202	UNIVERSAL WASHROOM & SHOWER PLANS
D1203	UNIVERSAL WASHROOM ELEVATIONS
D1204	MULTI-STALL WASHROOM PLANS
D1205	UW - EMERGENCY CALL SYSTEM
D1301	KITCHEN MILLWORK PLANS & ELEVATIONS
D1302	KITCHEN MILLWORK DETAIL SECTIONS
D1303	KITCHEN HOOD VENT DETAIL
D1305	RECEPTION DESK MILLWORK PLANS & ELEVATIONS
D1306	RECEPTION DESK WITH TEMPERED GLASS DETAIL SECTIONS
D1401	STAIR DETAILS - 01
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D1501	MISCELLANEOUS DETAILS - 01
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D1601	ELEVATOR DETAILS
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D1701	ACCESSIBLE PARKING AND SITE MARKING DETAILS
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D2201	STRUCTURAL STEEL DETAILS - 2
D2300	MASONRY DETAILS

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D3301	DRAINAGE DETAILS
D3401	FIRE PROTECTION DETAILS
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D3601	PIPING DETAILS SHEET 1 OF 2
D3602	PIPING DETAILS SHEET 2 OF 2

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SHEET #	SHEET TITLE
D4001	ELECTRICAL DETAILS 1

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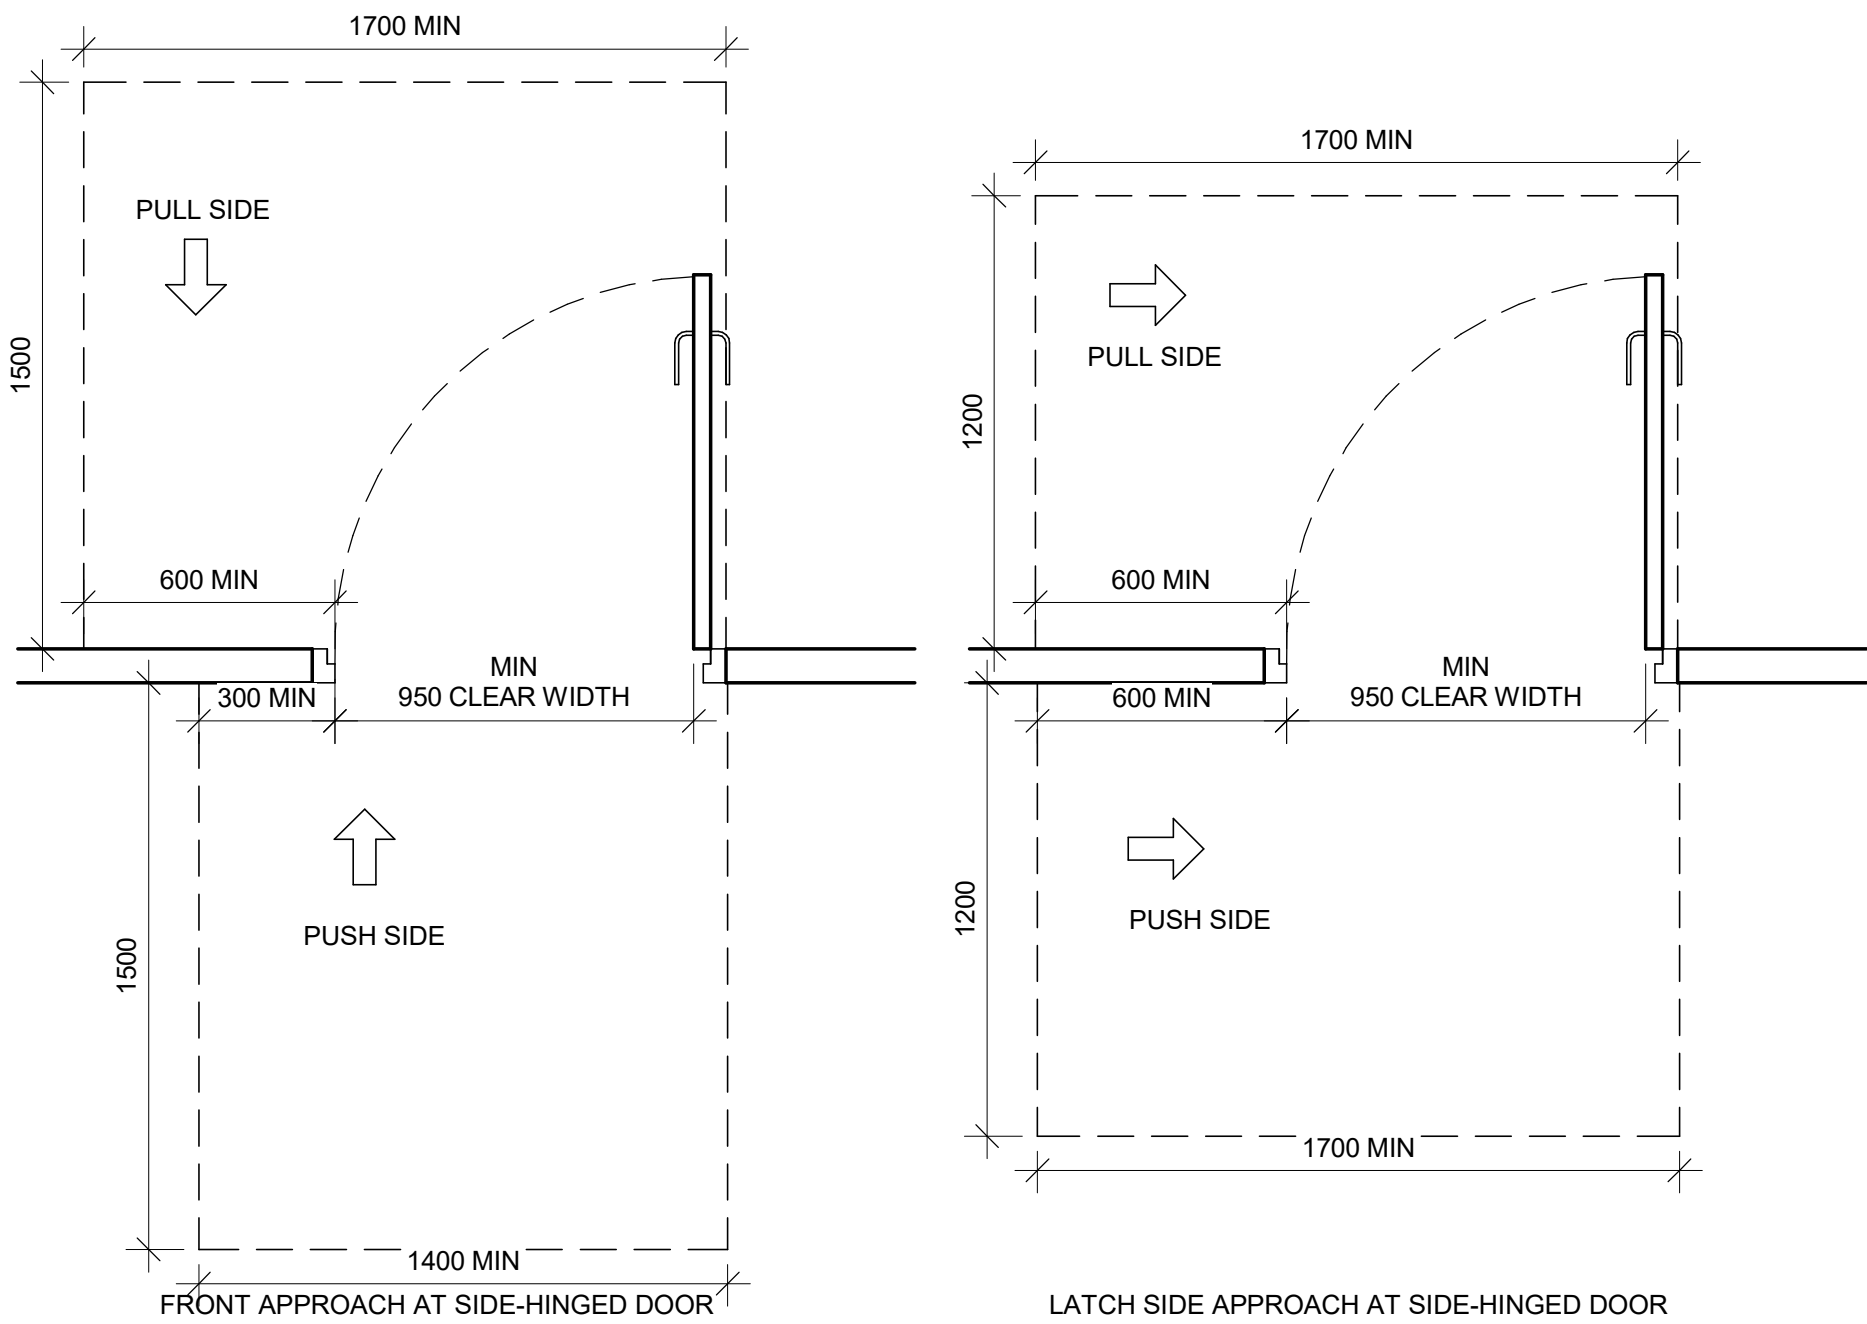
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SHEET NUMBER D1000	ISSUE A
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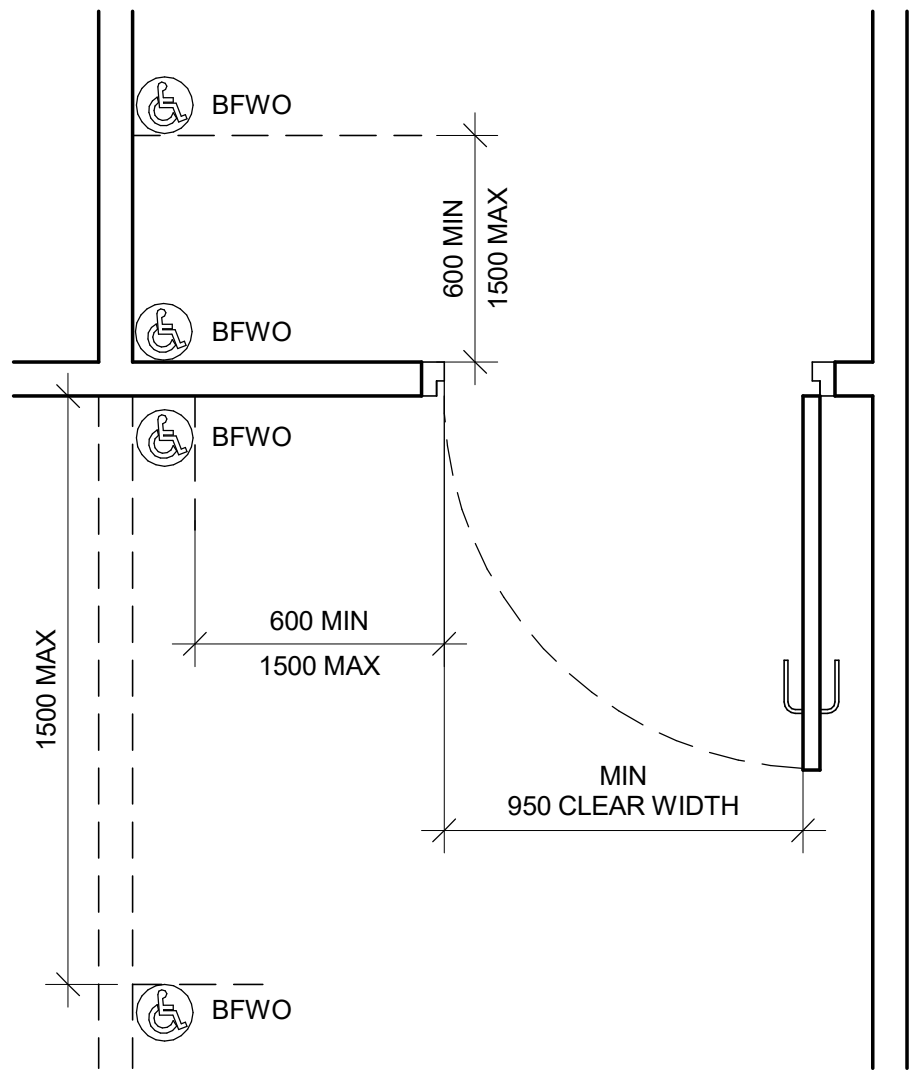
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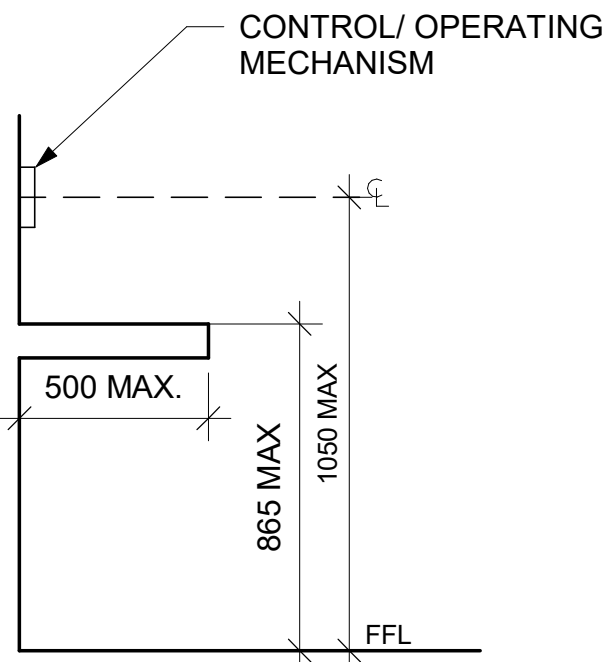
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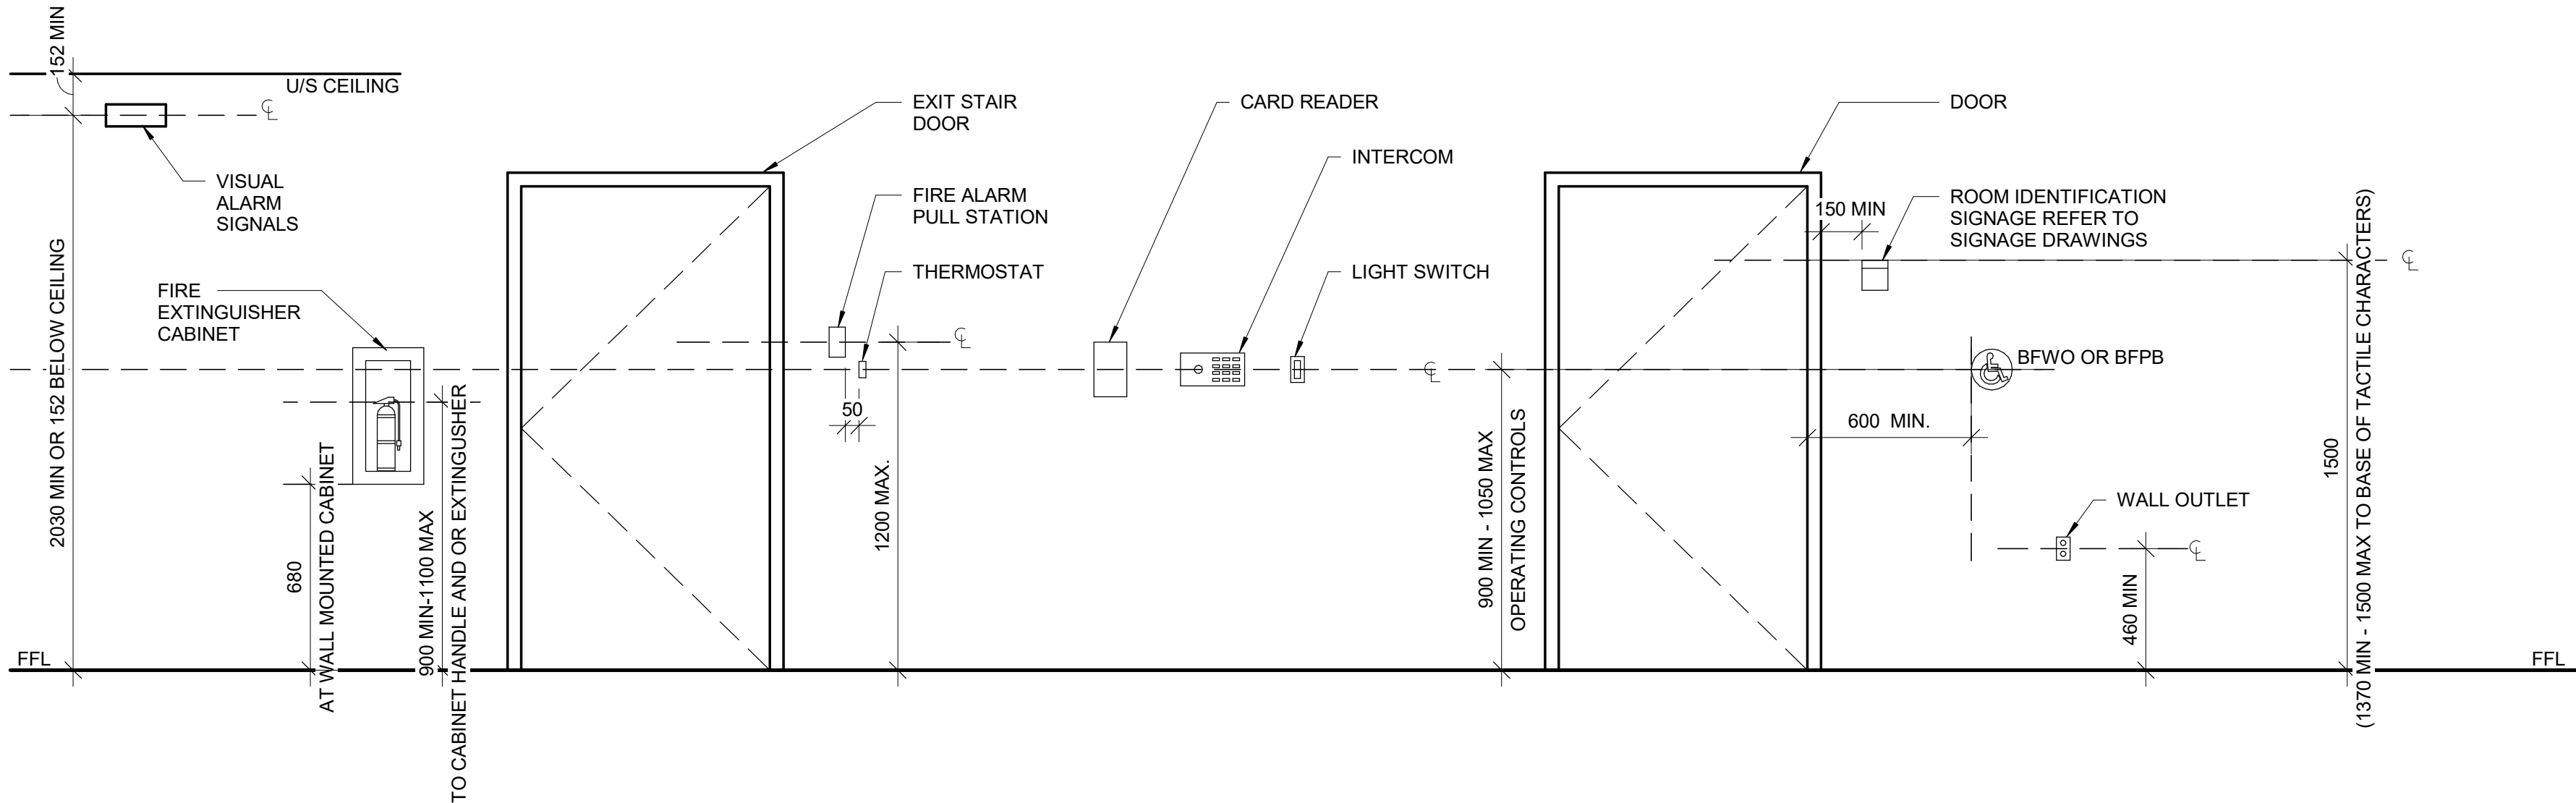
2 DOOR APPROACH CLEARANCES
D1001 Scale: 1 : 20



3 BARRIER-FREE WAVE TO OPEN LOCATION
D1001 Scale: 1 : 20



4 CONTROL HEIGHTS AT OBSTRUCTIONS
D1001 Scale: 1 : 20






5 MOUNTING HEIGHTS
D1001 Scale: 1 : 20

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WIDENING AN EXISTING OPENING IN EXISTING MASONRY WALL TYP.

NEW DOOR/WINDOW OPENING INTO EXISTING MASONRY WALL TYP.

PROPOSED SEQUENCE OF WORK


1	CREATE NEW 150x150mm HOLES @ 400mm INTO EXISTING MASONRY WALL AND SHORE THE WALL ABOVE, SEE DETAIL 1. OR SHORE THE WALL ABOVE BY USING 2 CHANNELS BACK TO BACK AND THROUGH BOLTS @350mm, SEE DETAIL 2
2	DEMOLISH THE EXISTING LINTEL, THE VOID FOR NEW BEAM AND THE WALL FROM EACH SIDE OF THE NEW OPENING
3	FILL TWO CORES MIN. OF EXISTING MASONRY WALL WITH GROUT EACH SIDE OF THE NEW OPENING, (DRILL HOLES TOP AND BOTTOM OF EACH CORE, INJECT GROUT, CLOSE HOLES WITH MORTAR AND MAKE GOOD SURFACE)
4	INSTALL NEW LINTEL. SEE LINTEL SCHEDULE FOR LINTEL SIZE
5	ADD MASONRY FACES AT LINTEL AND REPAIR MASONRY COURSE

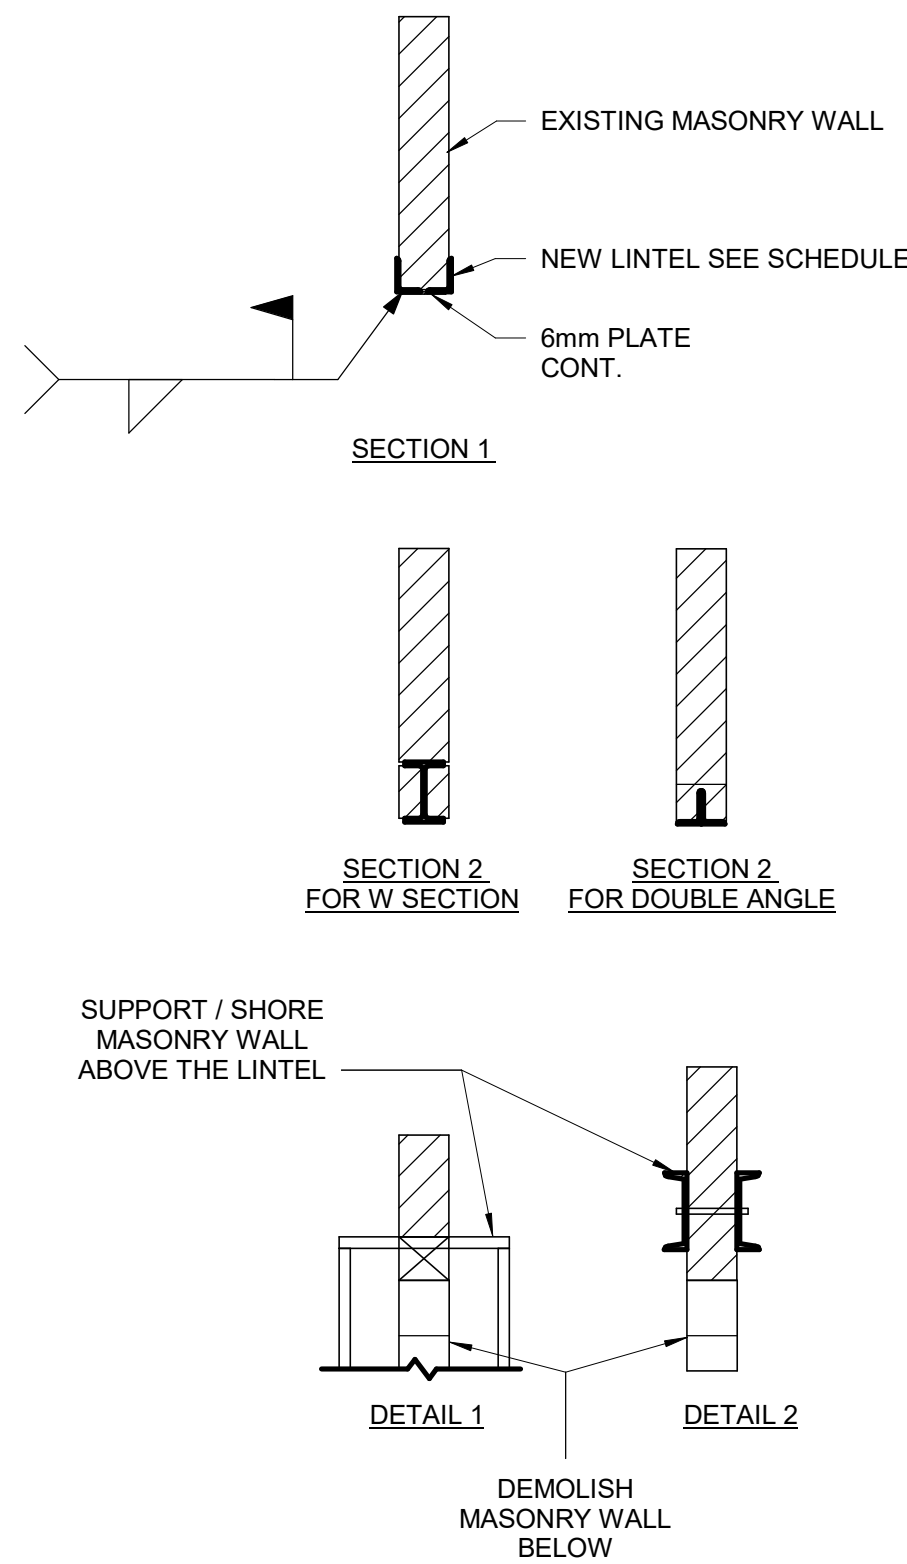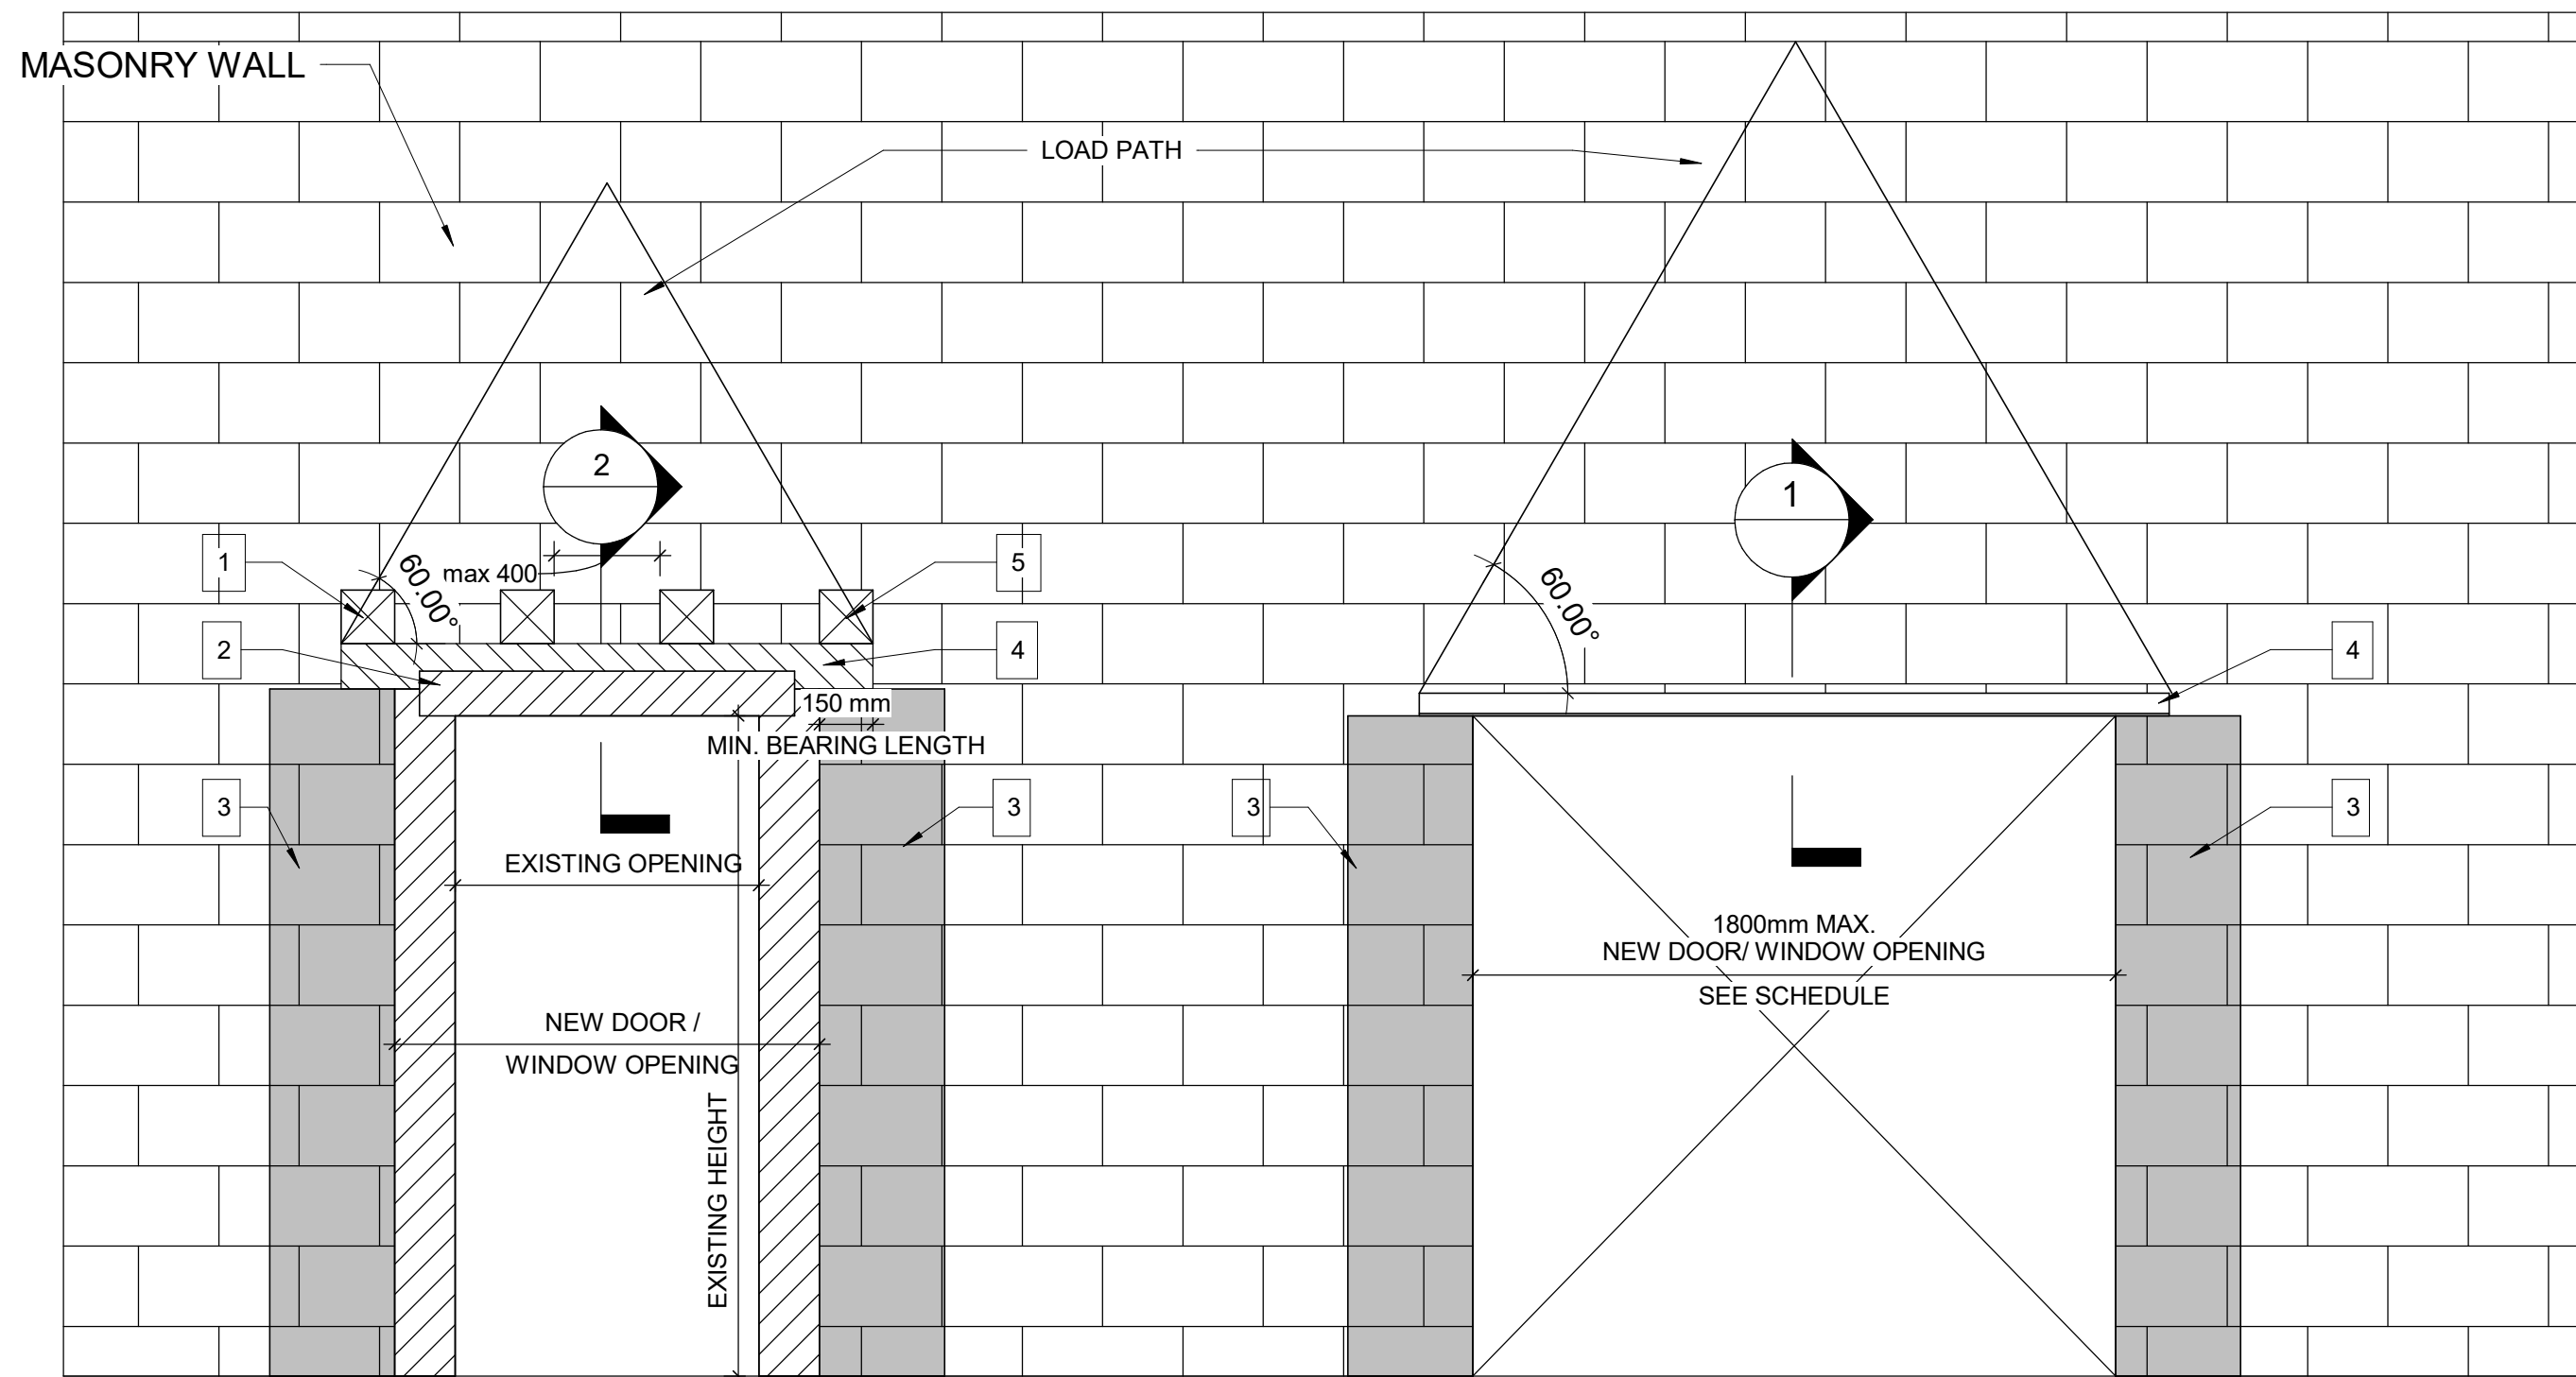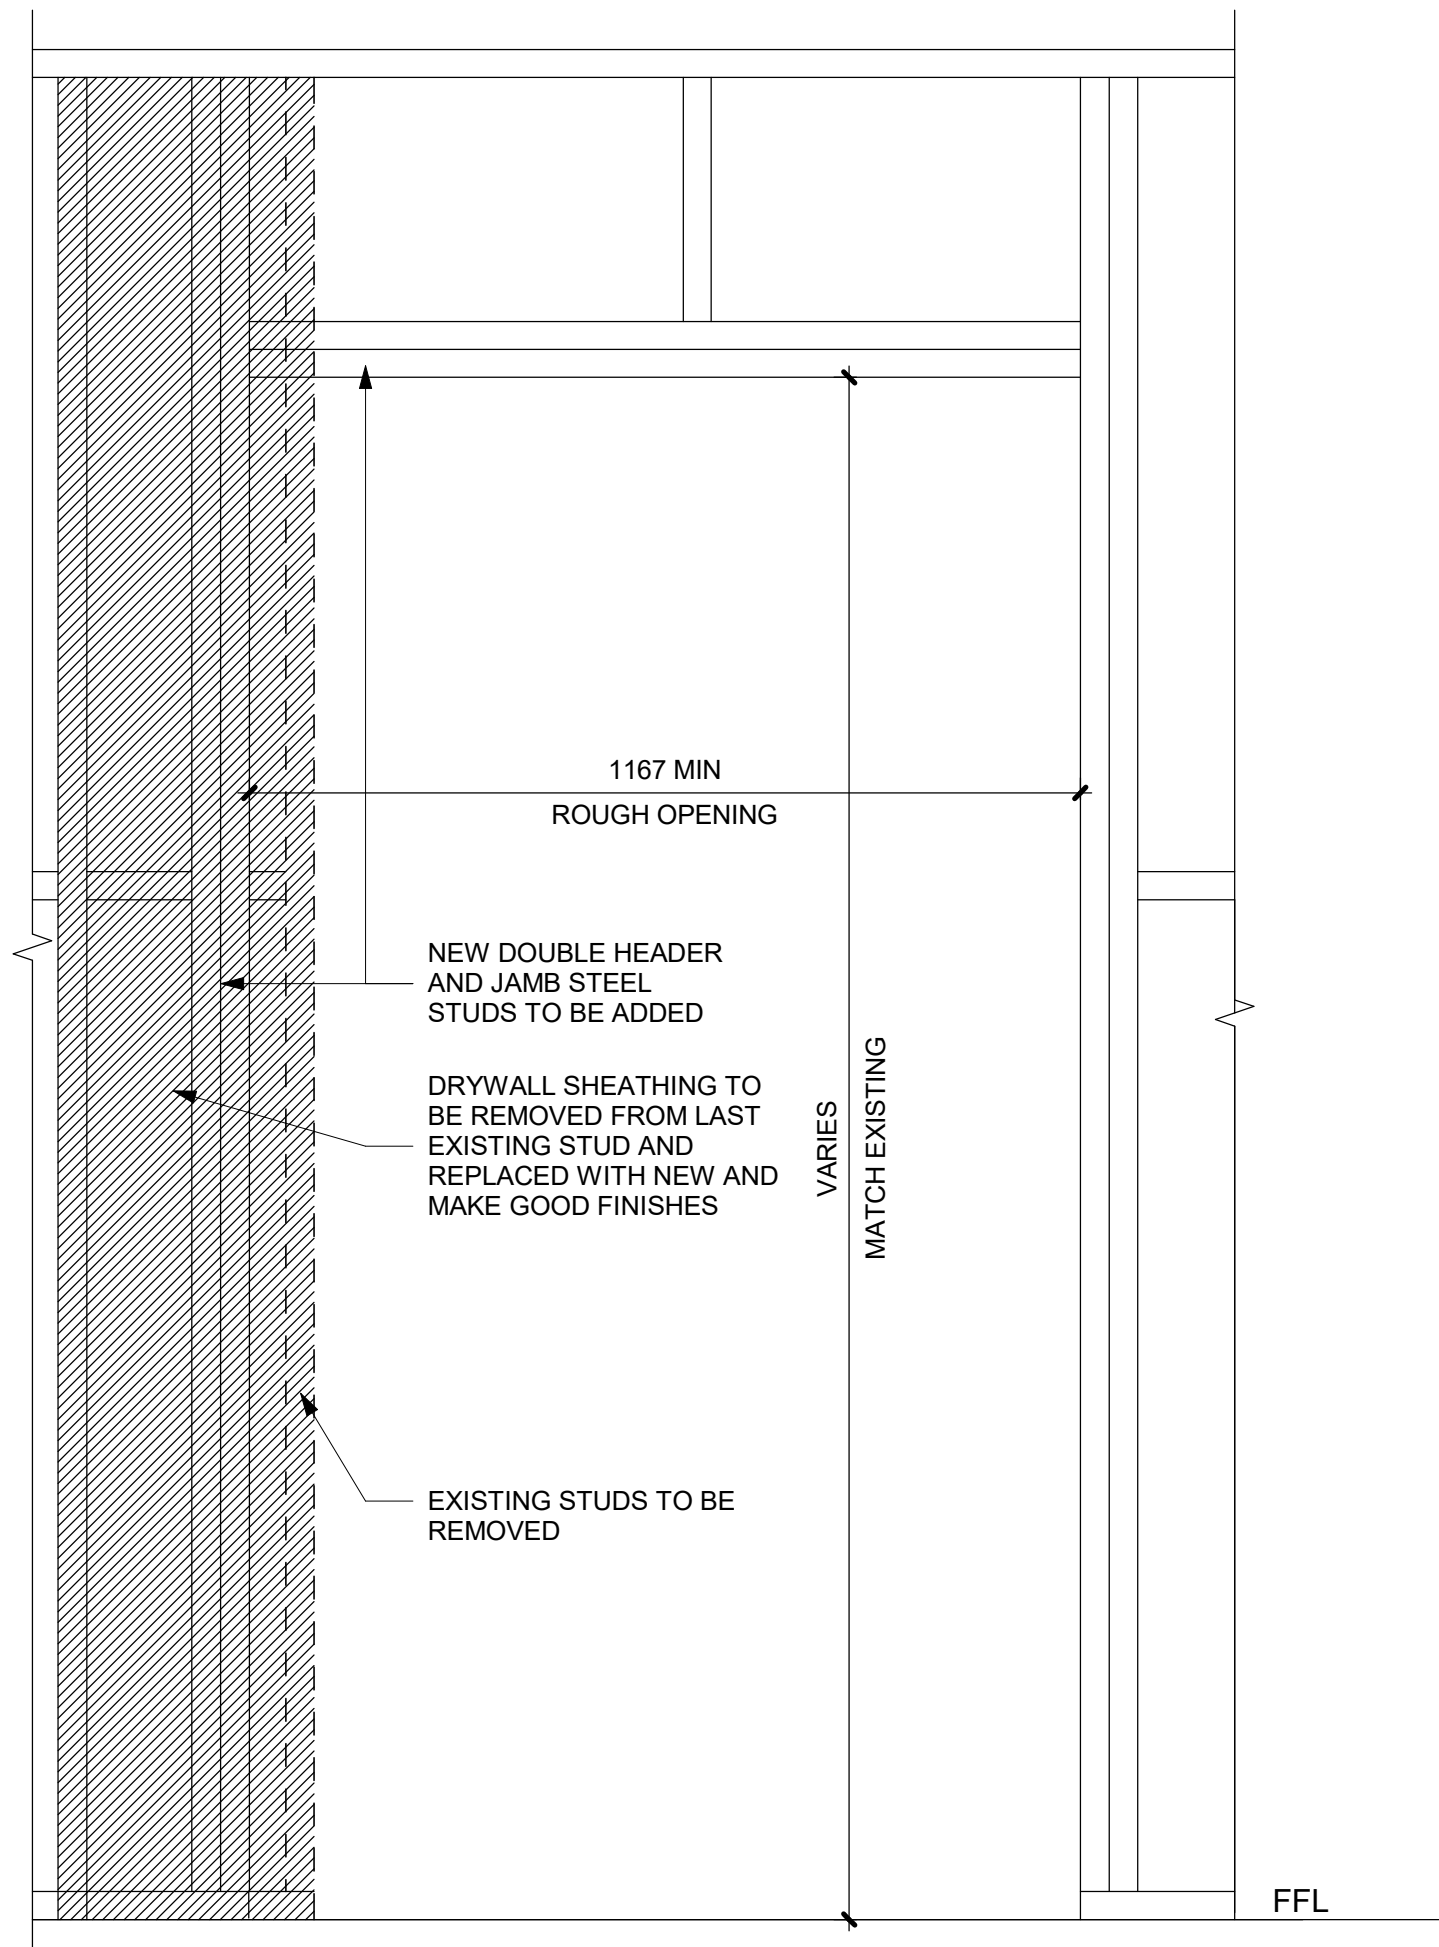LINTEL:

OVER ALL OPENINGS IN MASONRY WALLS PROVIDE THE FOLLOWING LINTELS.
UNLESS OTHERWISE SHOWN.

STEEL LINTELS

CLEAR SPAN mm (ft-in)	140 (6") WALL	190 (8") WALL	240 (10") WALL	290 (12") WALL	350 WALL	430 WALL
UP TO 1200 (4'-0")	L127x127x7.9	2-L89x89x7.9 +170x6mm PL	L89x89x7.9 +L127x89x7.9 LLV +220x6mm PL	3-L89x89x7.9 +270x6mm PL	3-L127x89x7.9 (LLV)	3-L127x127x7.9 +410x6mm PL
1201 TO 1800 (4'-0" - 6'-)	2-L89x64x6.4LLV	2-L127x89x7.9LLV	L127x89x7.9LLV +L127x127x7.9	3-L127x89x7.9LLV		
1801 TO 3100 (6'- 10")	2-L89x64x9.5LLV	2-L152x89x9.5LLV	2-L152x89x9.5LLV	3-L152x89x9.5LLV		

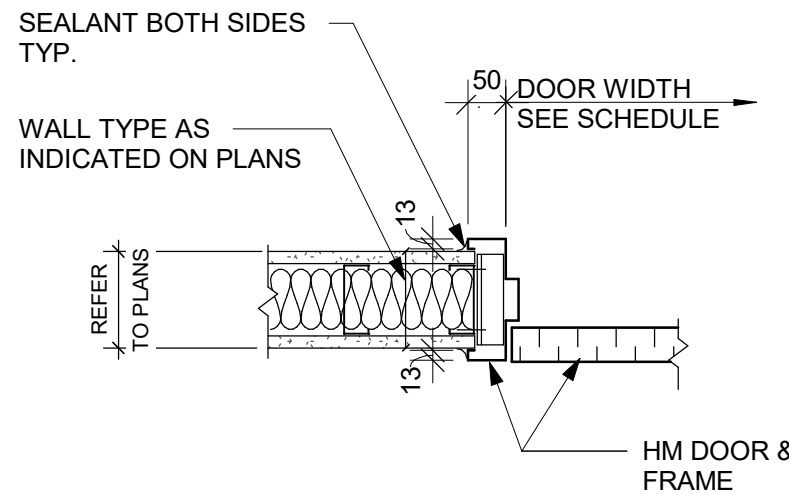

NOTE: FOR MASONRY WALL CUT OUT,
REFER TO STRUCTURAL DETAIL

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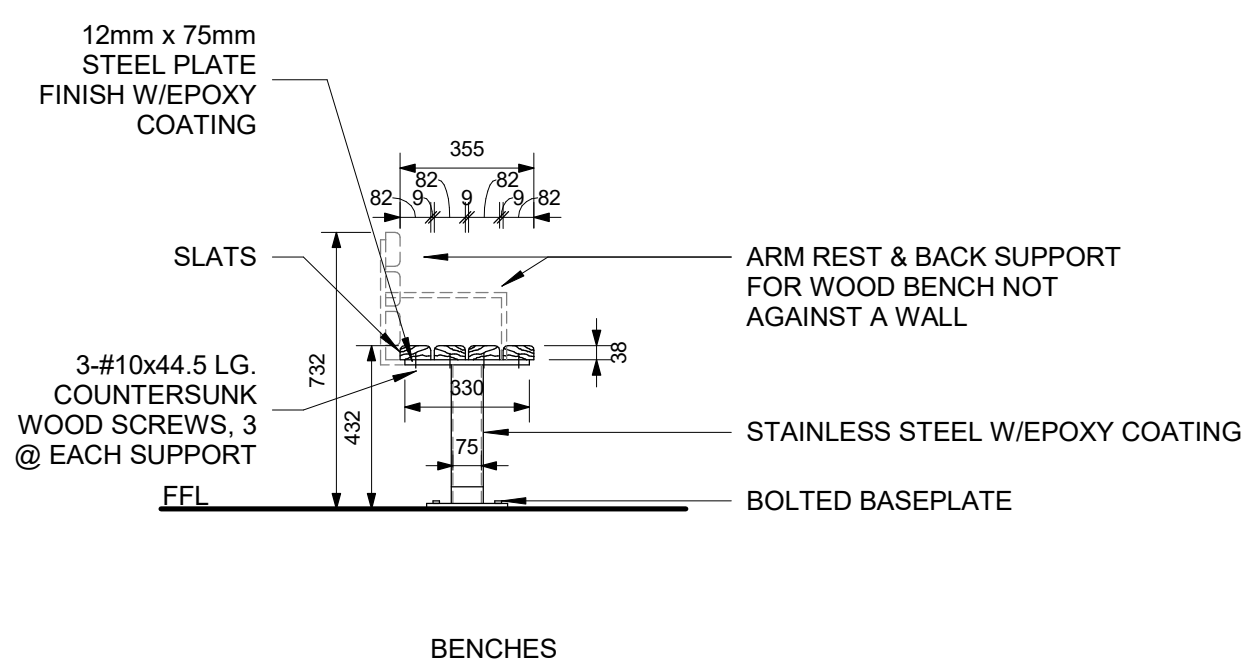
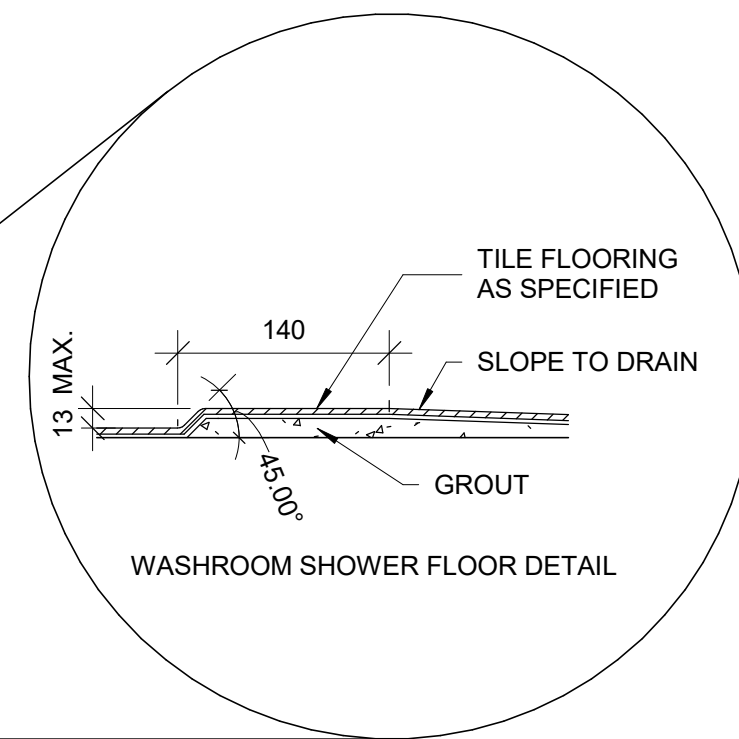
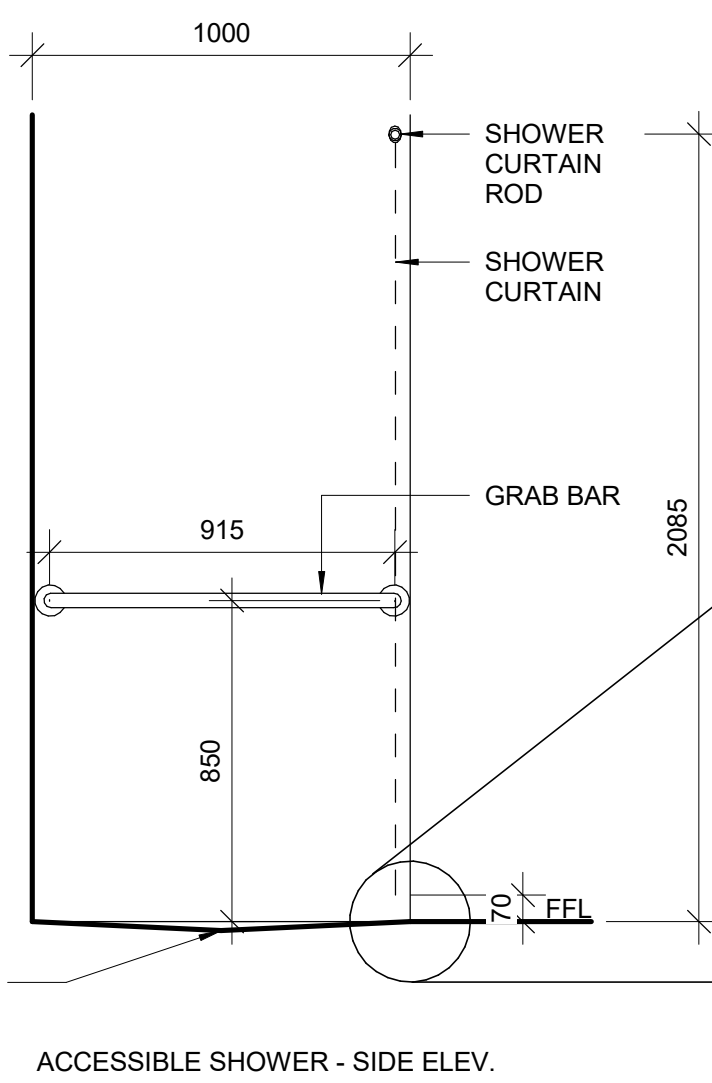
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DRAWN BY: A. BOYNARIAN	CHECKED BY: K. TILAHUN
PROJECT MGR: F. BOLOURIAN	APPROVED BY: E. FENUTA

SHEET TITLE
DRYWALL CUT OUT

SHEET NUMBER D1002	ISSUE A
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6 WASHROOM/CHANGEROOM BENCH
D1201 Scale: 1 : 20



-
- Technical drawing of a wall-mounted accessible urinal. The drawing shows a side view of the urinal unit mounted on a wall. Key dimensions and components are labeled:
- Dimensions:**
 - Top mounting bracket width: 480 MIN.
 - Distance from wall to urinal body: 50 MIN.
 - Distance from wall to grab bar: 380 MIN.
 - Distance from grab bar to urinal body: 380 MIN.
 - Maximum distance from wall to urinal body: 450 MAX.
 - Maximum distance from grab bar to urinal body: 450 MAX.
 - Height from floor to top of urinal body: 300 MIN.
 - Height from floor to bottom of urinal body: 430 MAX.
 - Height from floor to top of privacy screen: 275.
 - Height from floor to bottom of privacy screen: 1000.
 - Components:**
 - GRAB BAR:** A horizontal bar mounted on the wall, used for support.
 - CONTROL:** A lever or button used to operate the urinal.
 - PRIVACY SCREEN WHEN REQUIRED:** A vertical screen that can be added to the urinal for privacy.
 - Labels:**
 - WALL MOUNTED ACCESSIBLE URINAL:** The main title of the drawing.
 - FFL:** Finished Floor Level, indicated by a horizontal line at the bottom.

5 ACCESSIBLE WASHROOM - URINAL
D1201 Scale: 1 : 20

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
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
ISSUES

No.	DESCRIPTION	DATE
A	ISSUED FOR TENDER	2025-04-11

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PROJECT TITLE

CITY OF TORONTO
ACCESSIBILITY UPGRADES

PROJECT ADDRESS

PROJECT NO:

9119- 19- 0162 / Arcadis 30279056

DRAWN BY:

A. BOYNARIAN

CHECKED BY:

K. TILAHUN

PROJECT MGR:

F. BOLOURIAN

APPROVED BY:

E. FENUTA

SHEET TITLE

UNIVERSAL WASHROOM
ELEVATIONS

SHEET NUMBER

D1203

ISSUE

A

2025-04-11 10:39:53 AM

SCALE CHECK


1 in

10mm

RESERVED

RESERVED

RESERVED

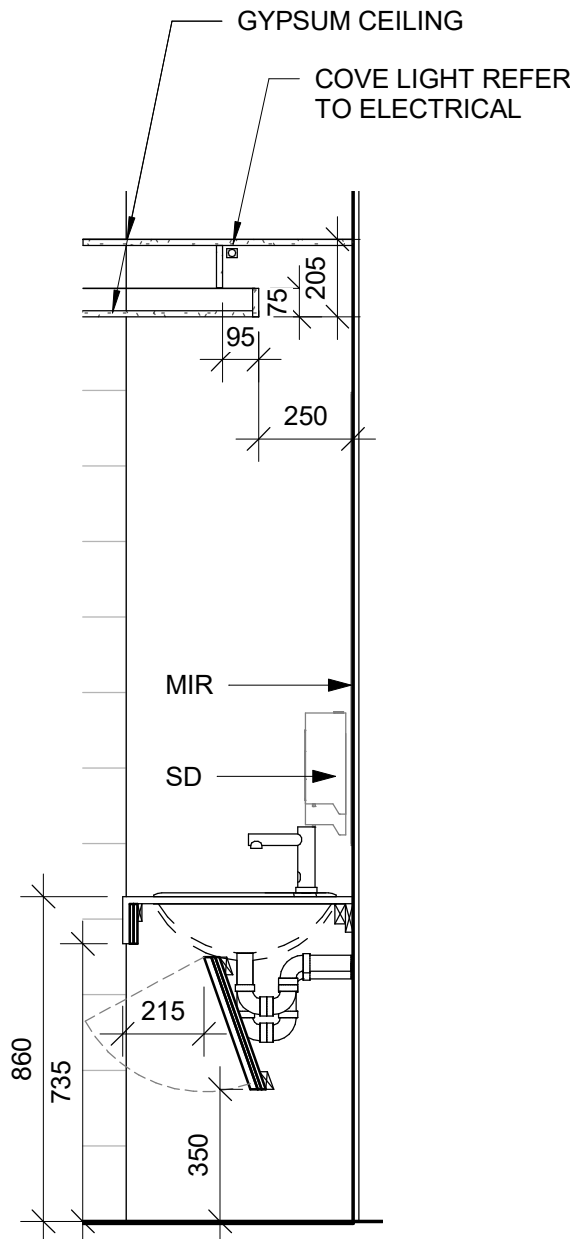

- UNIVERSAL WASHROOM GENERAL NOTES:**
1. ALL DIMENSIONS ARE TAKEN FROM FINISH FLOOR SURFACE.
 2. MOISTURE RESISTANT GYPSUM BOARD TO BE PROVIDED IN ALL WASHROOMS AND LOCKER ROOMS.
 3. SEE STANDARD MOUNTING HEIGHT DETAILS 2/D1201, 3/D1201, 4/D1201 & 5/D1202
 4. WASHROOM ARRANGMENTS FOR ILLUSTRATION PURPOSES - REFER TO EACH BUILDING ENLARGED PLAN WASHROOM FOR EXACT ARRANGEMENT

3 SECTION THROUGH VANITY
D1204 Scale: 1 : 20

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PROJECT ADDRESS

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DRAWN BY: A. BOYNARIAN	CHECKED BY: K. TILAHUN
PROJECT MGR: F. BOLOURIAN	APPROVED BY: E. FENUTA

SHEET TITLE
**WASHROOM VANITY
SECTION**


SHEET NUMBER
D1204

ISSUE
A


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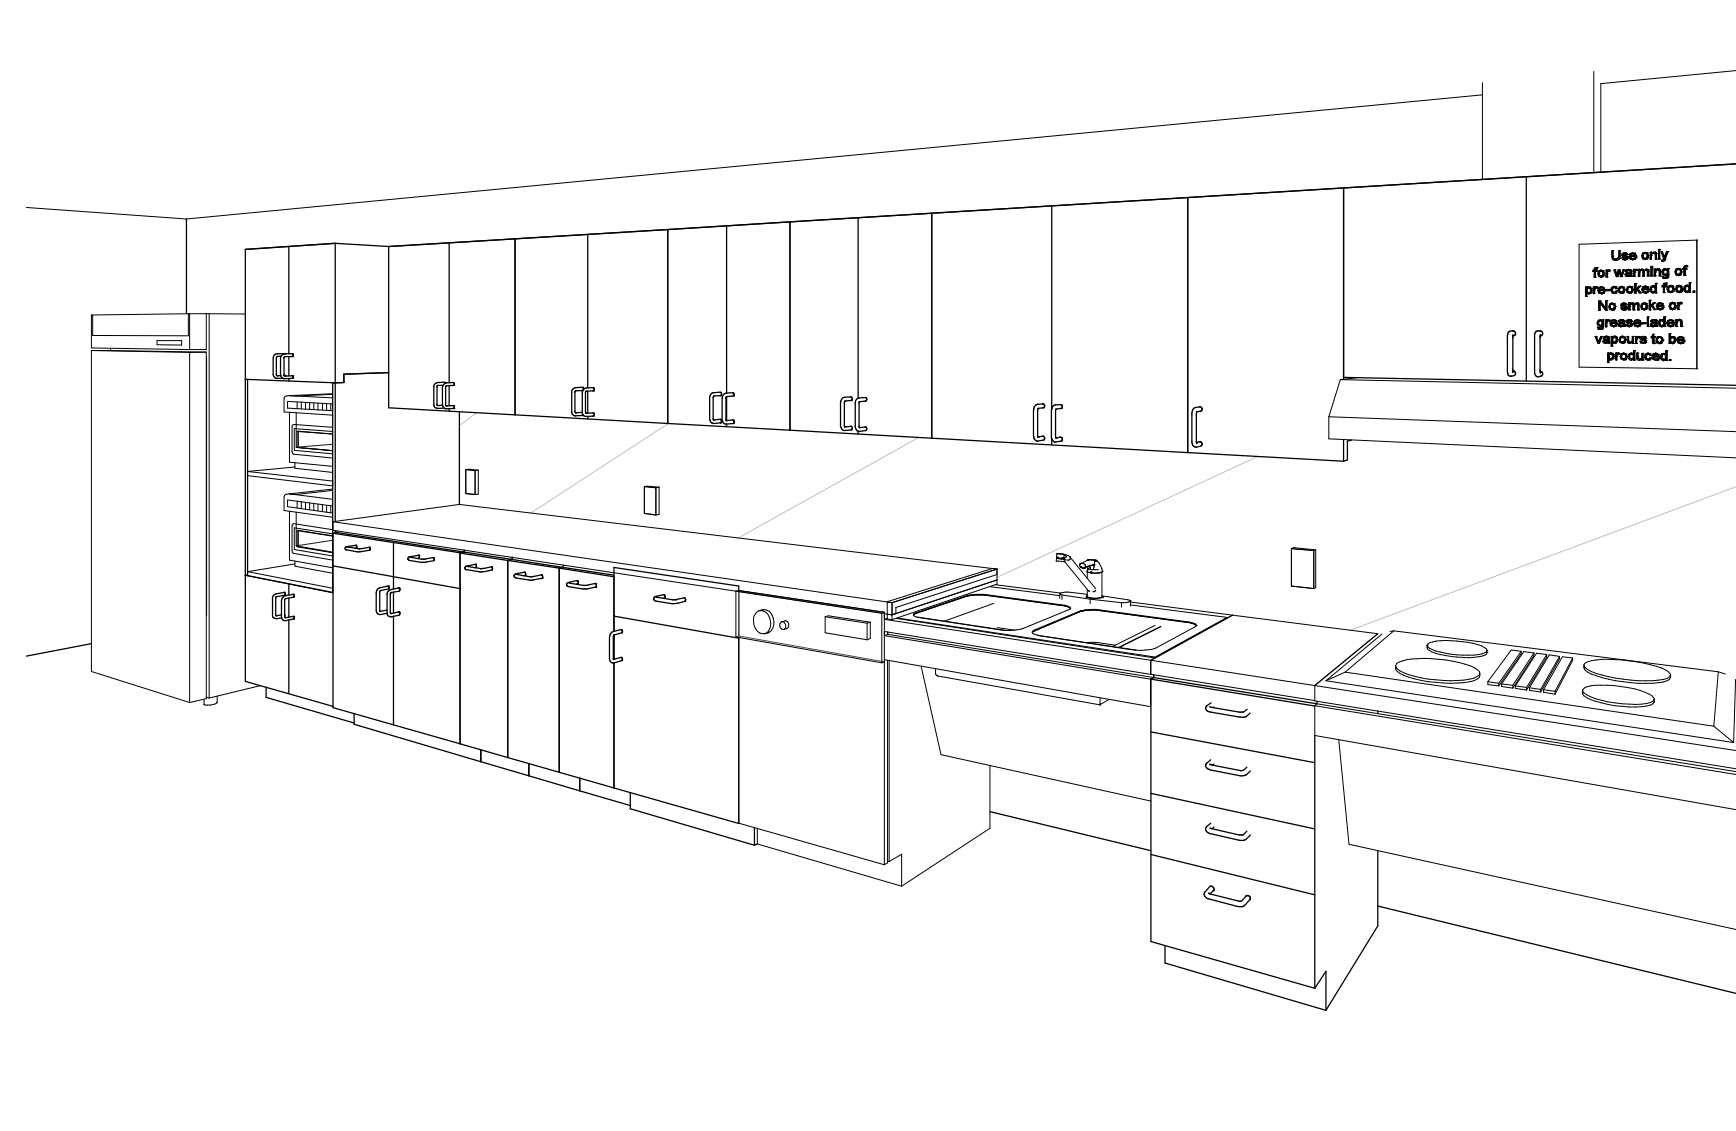
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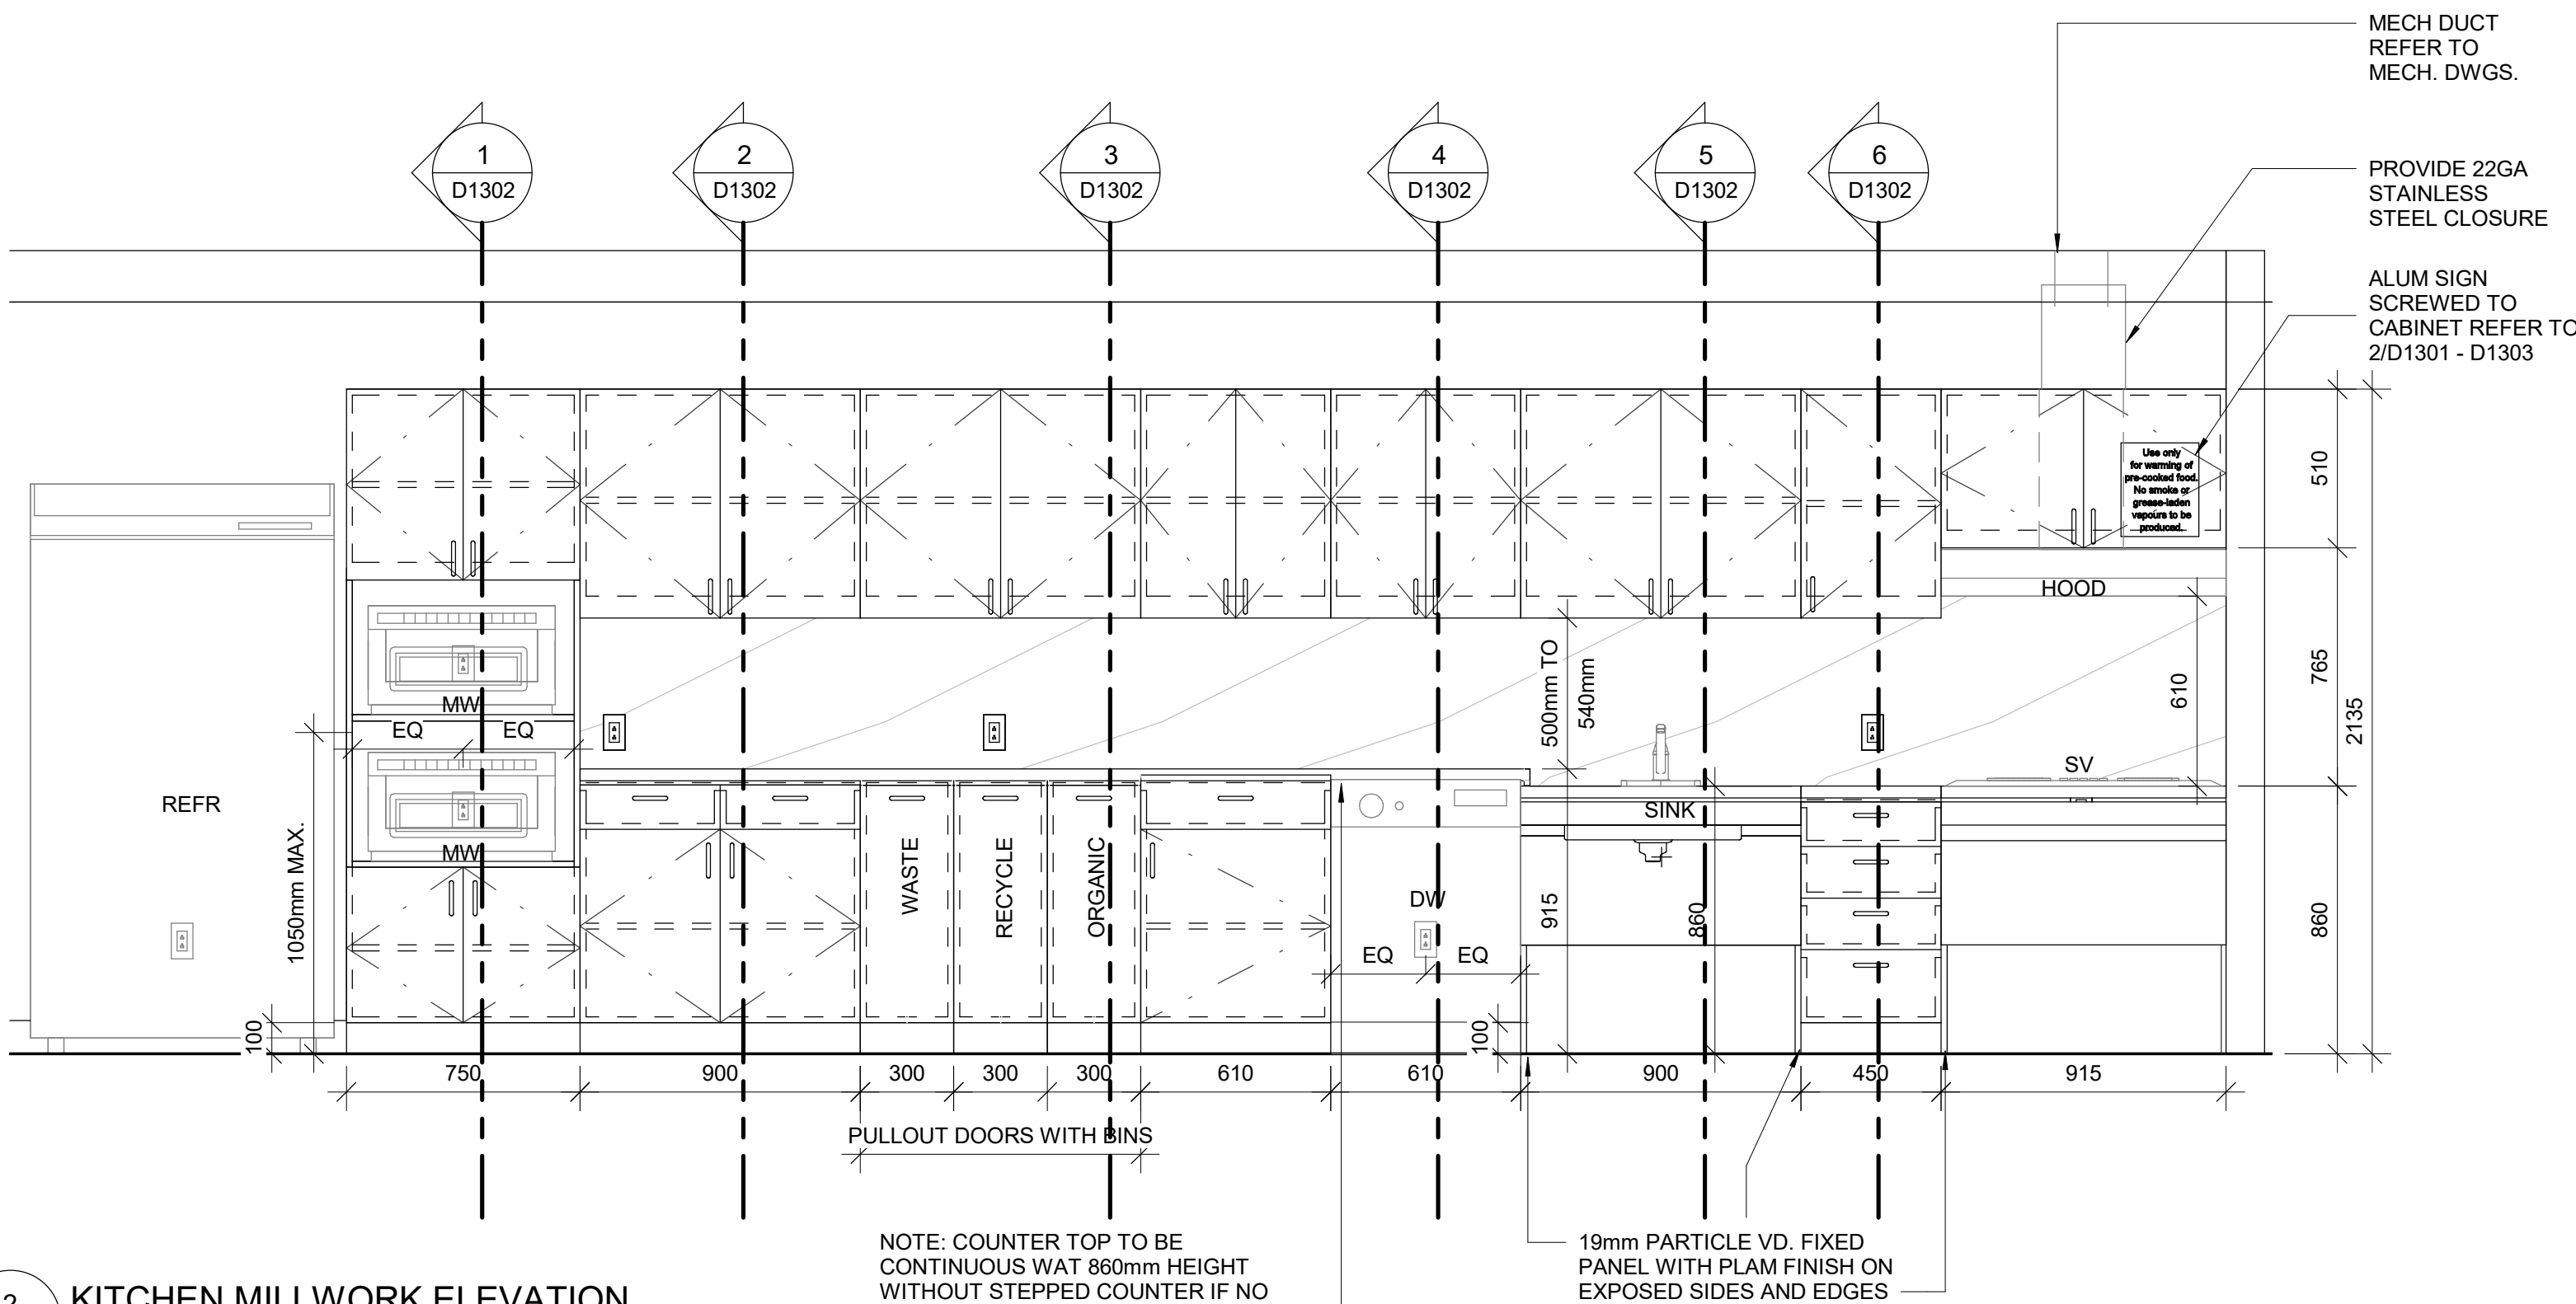
1 KITCHEN PLAN
D1301 Scale: 1 : 20




3 KITCHEN PERSPECTIVE 01
D1301 Scale:

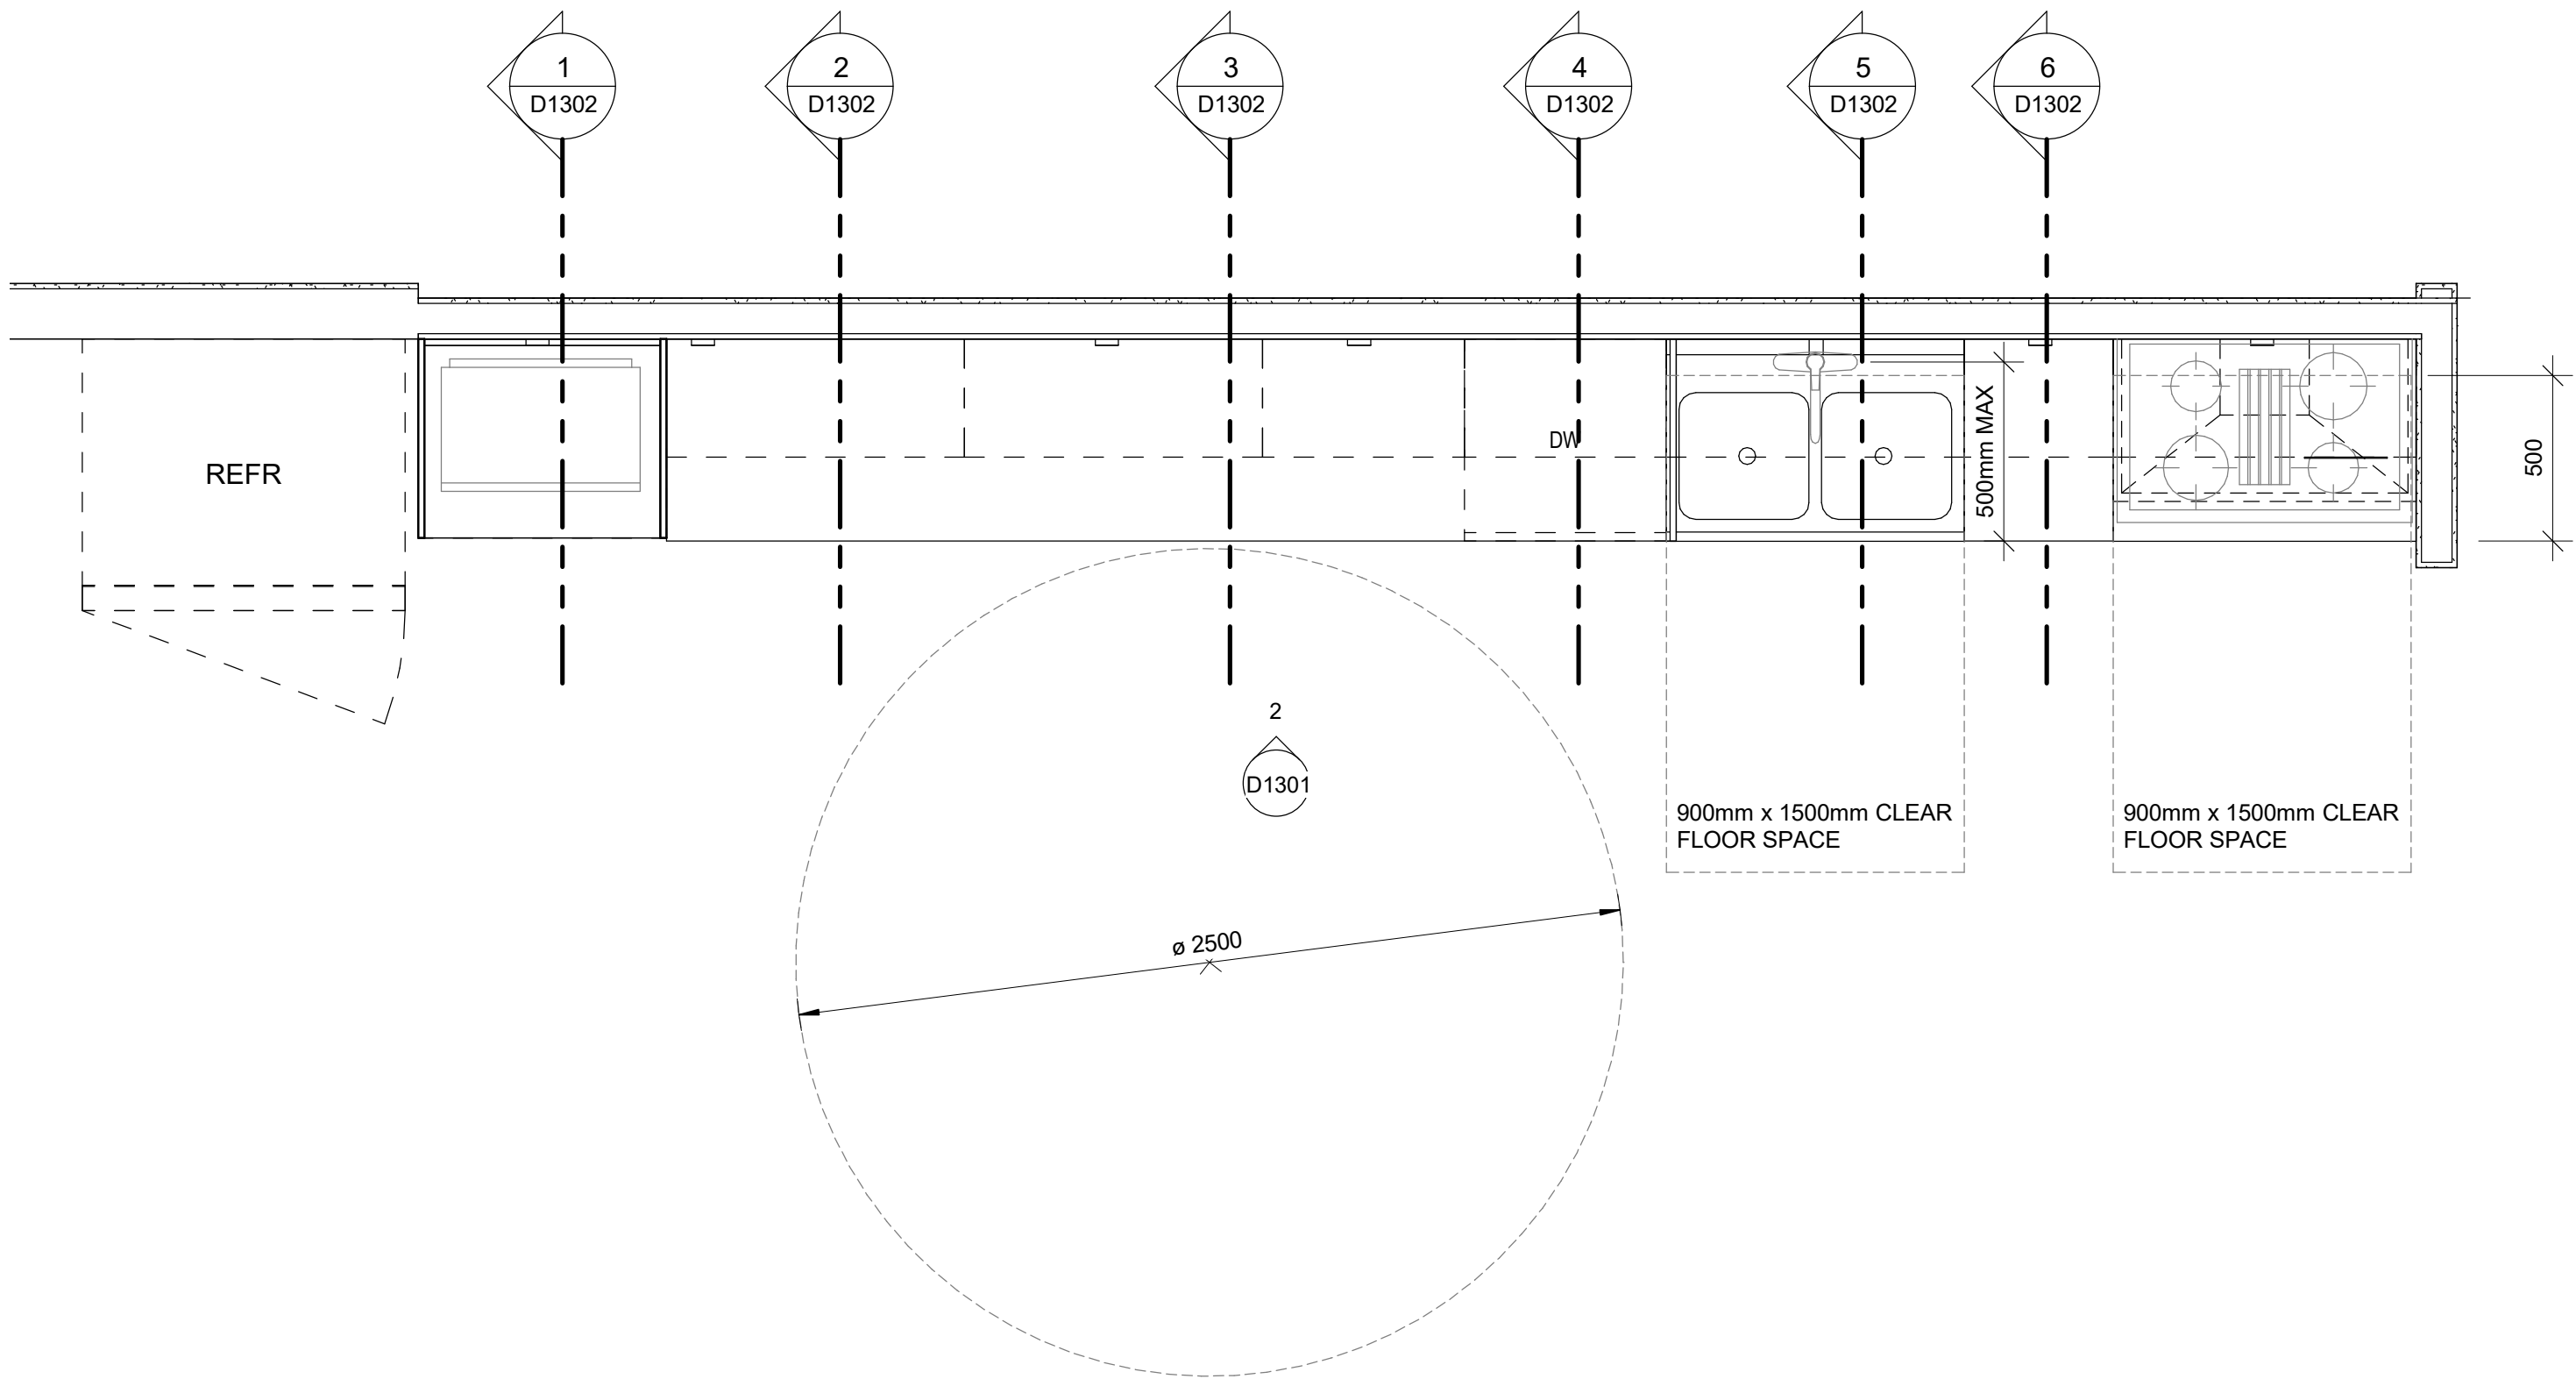


4 KITCHEN PERSPECTIVE 02
D1301 Scale:

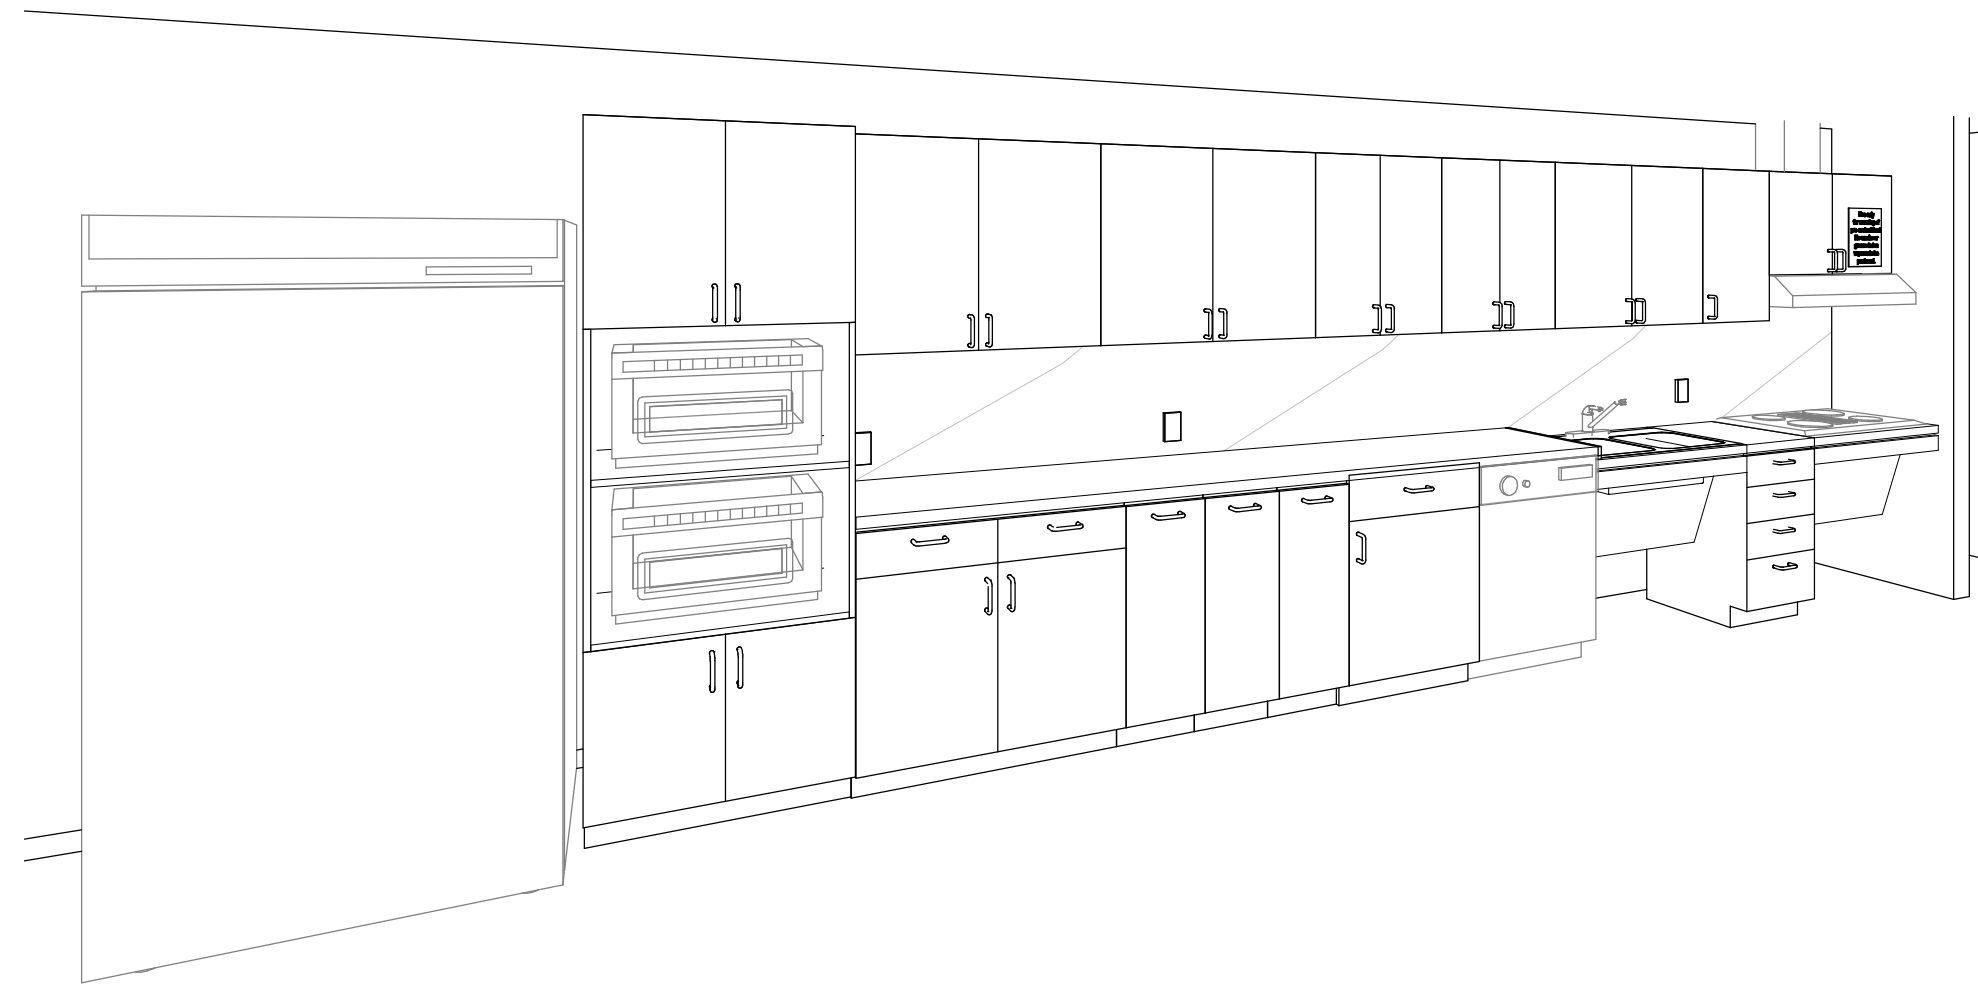

2 KITCHEN MILLWORK ELEVATION
D1301 Scale: 1 : 20

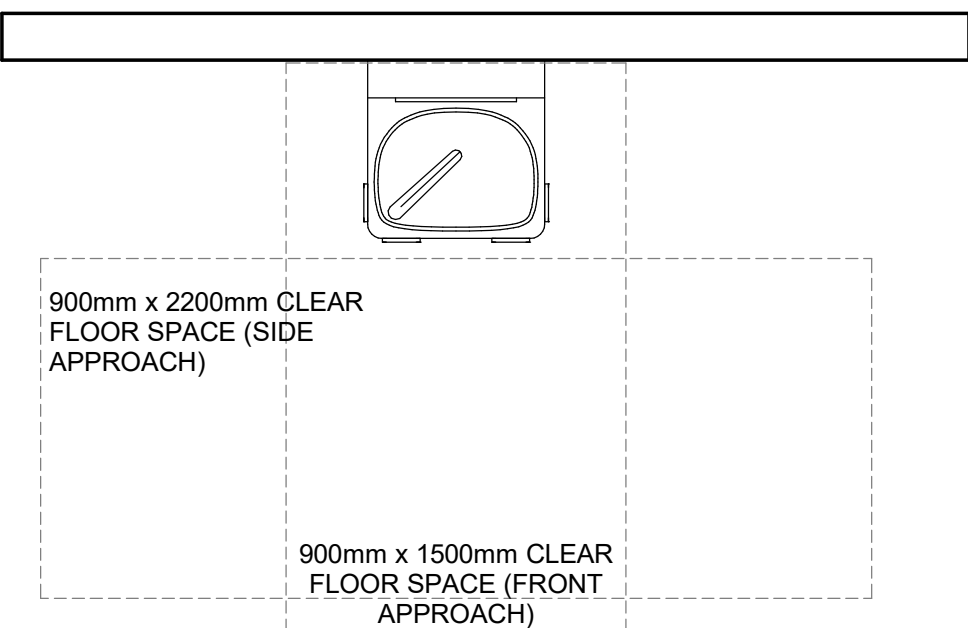

5 DRINKING FOUNTAIN PLAN
D1301 Scale: 1 : 20

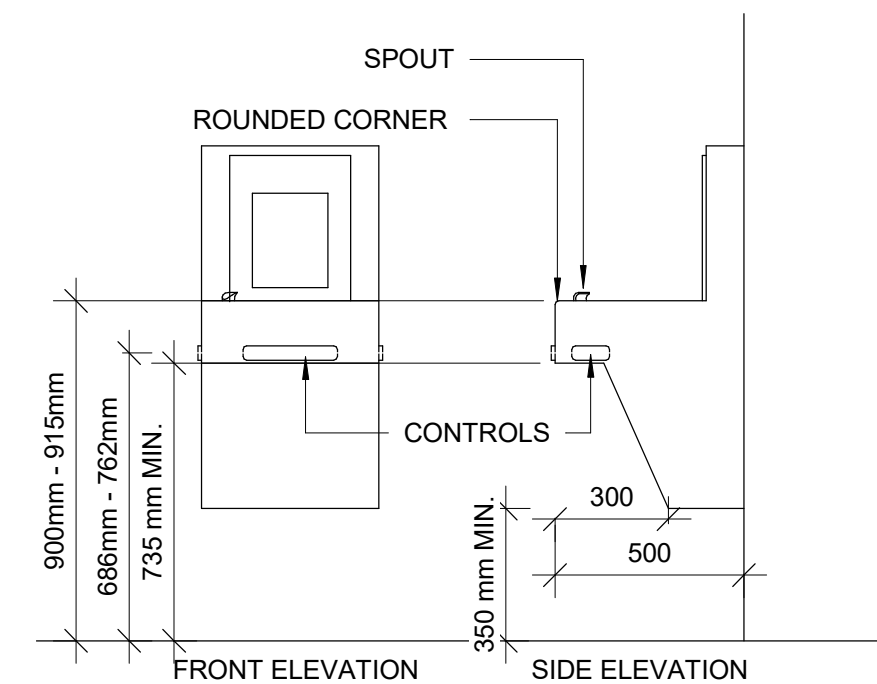

6 DRINKING FOUNTAIN ELEVATION
D1301 Scale: 1 : 20

- NOTE:**
- ALL APPLIANCES ARE OUT OF SCOPE AND ARE FOR INFORMATION PURPOSES ONLY
 - CONTRACTOR TO CONFIRM APPLIANCES SIZES PRIOR TO FABRICATION OF MILLWORK

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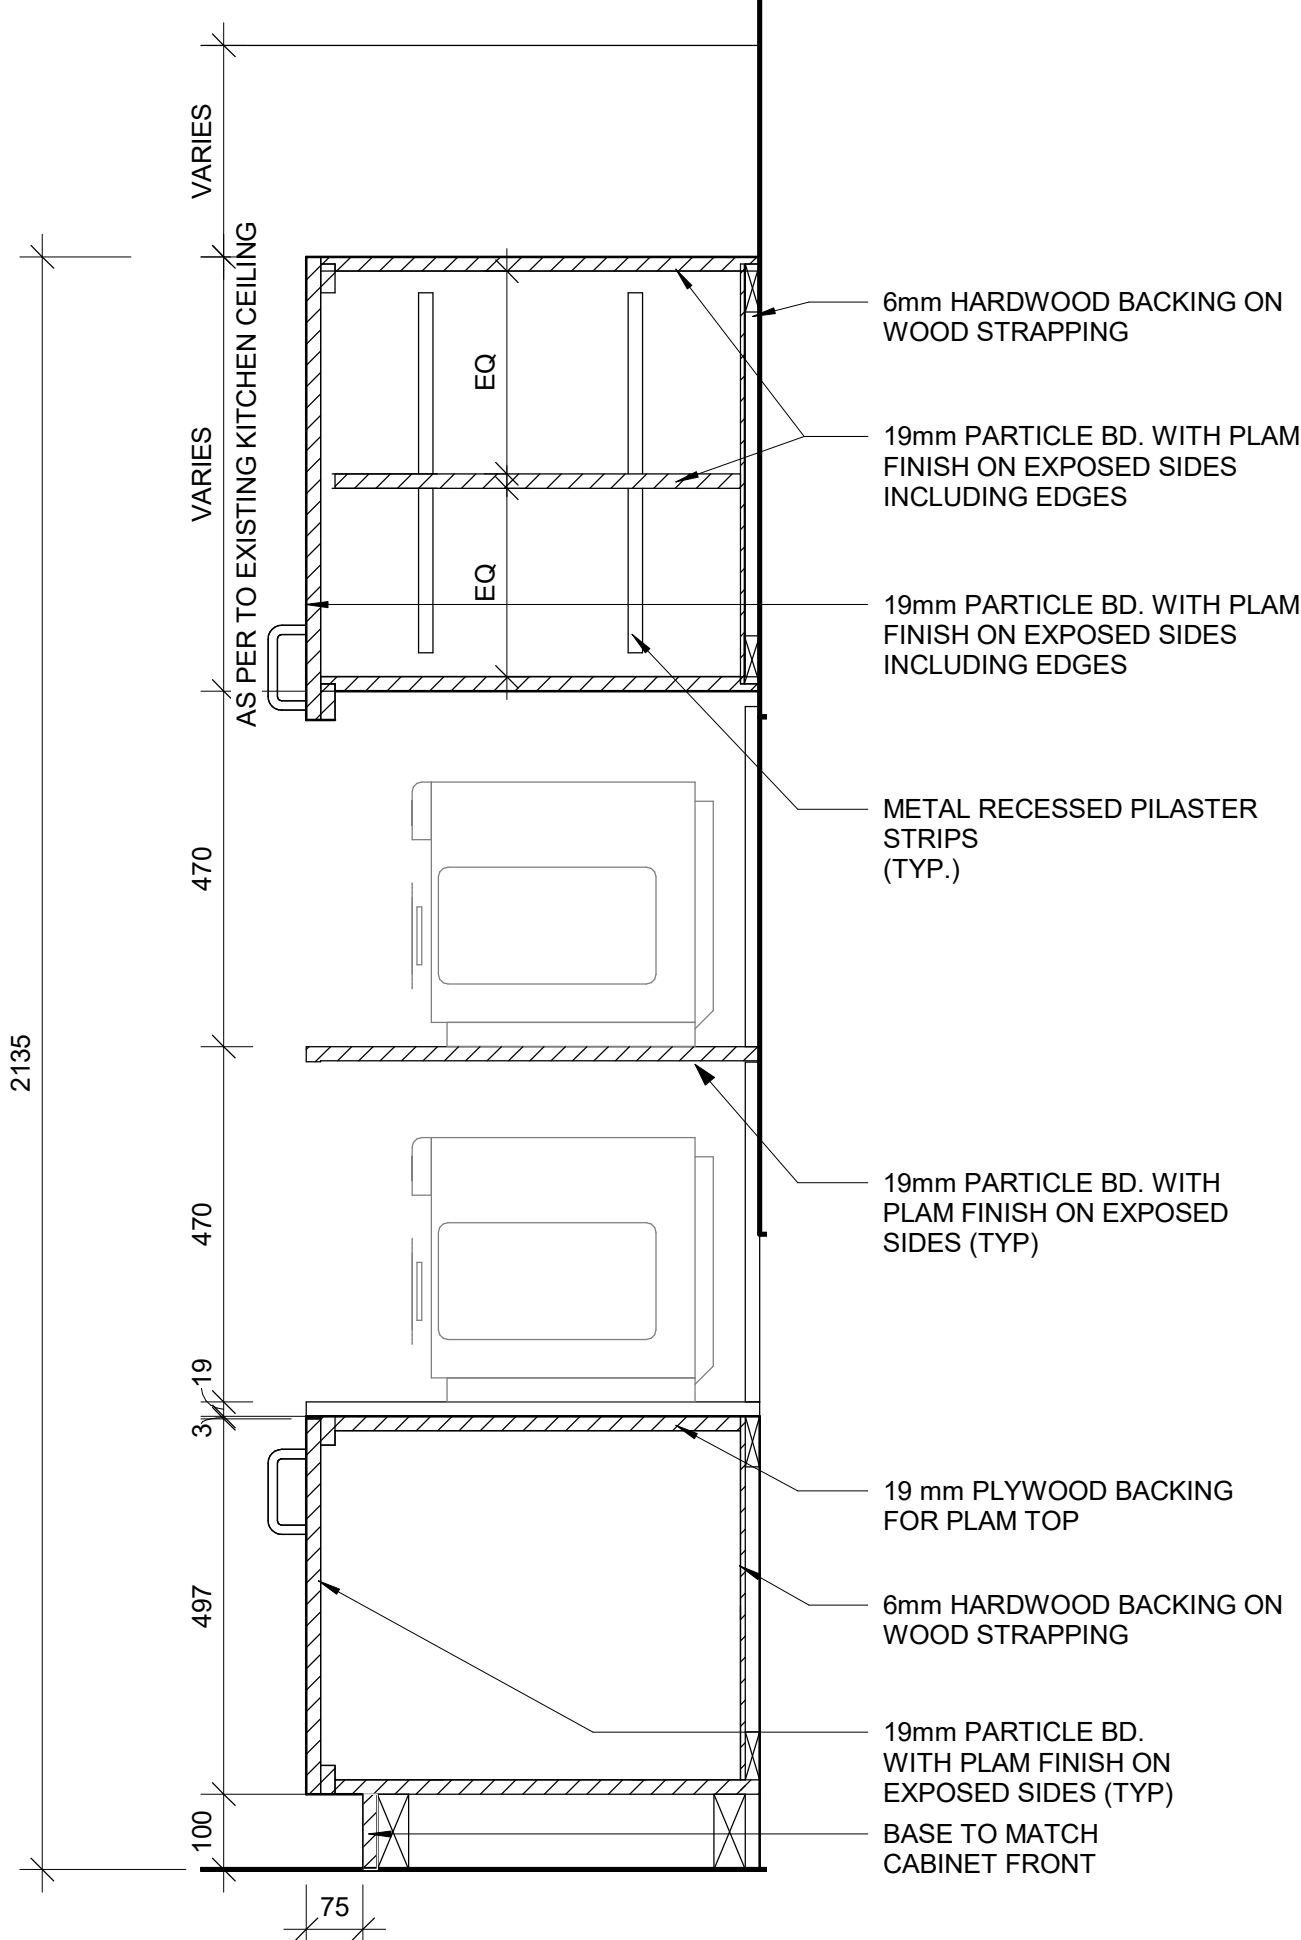
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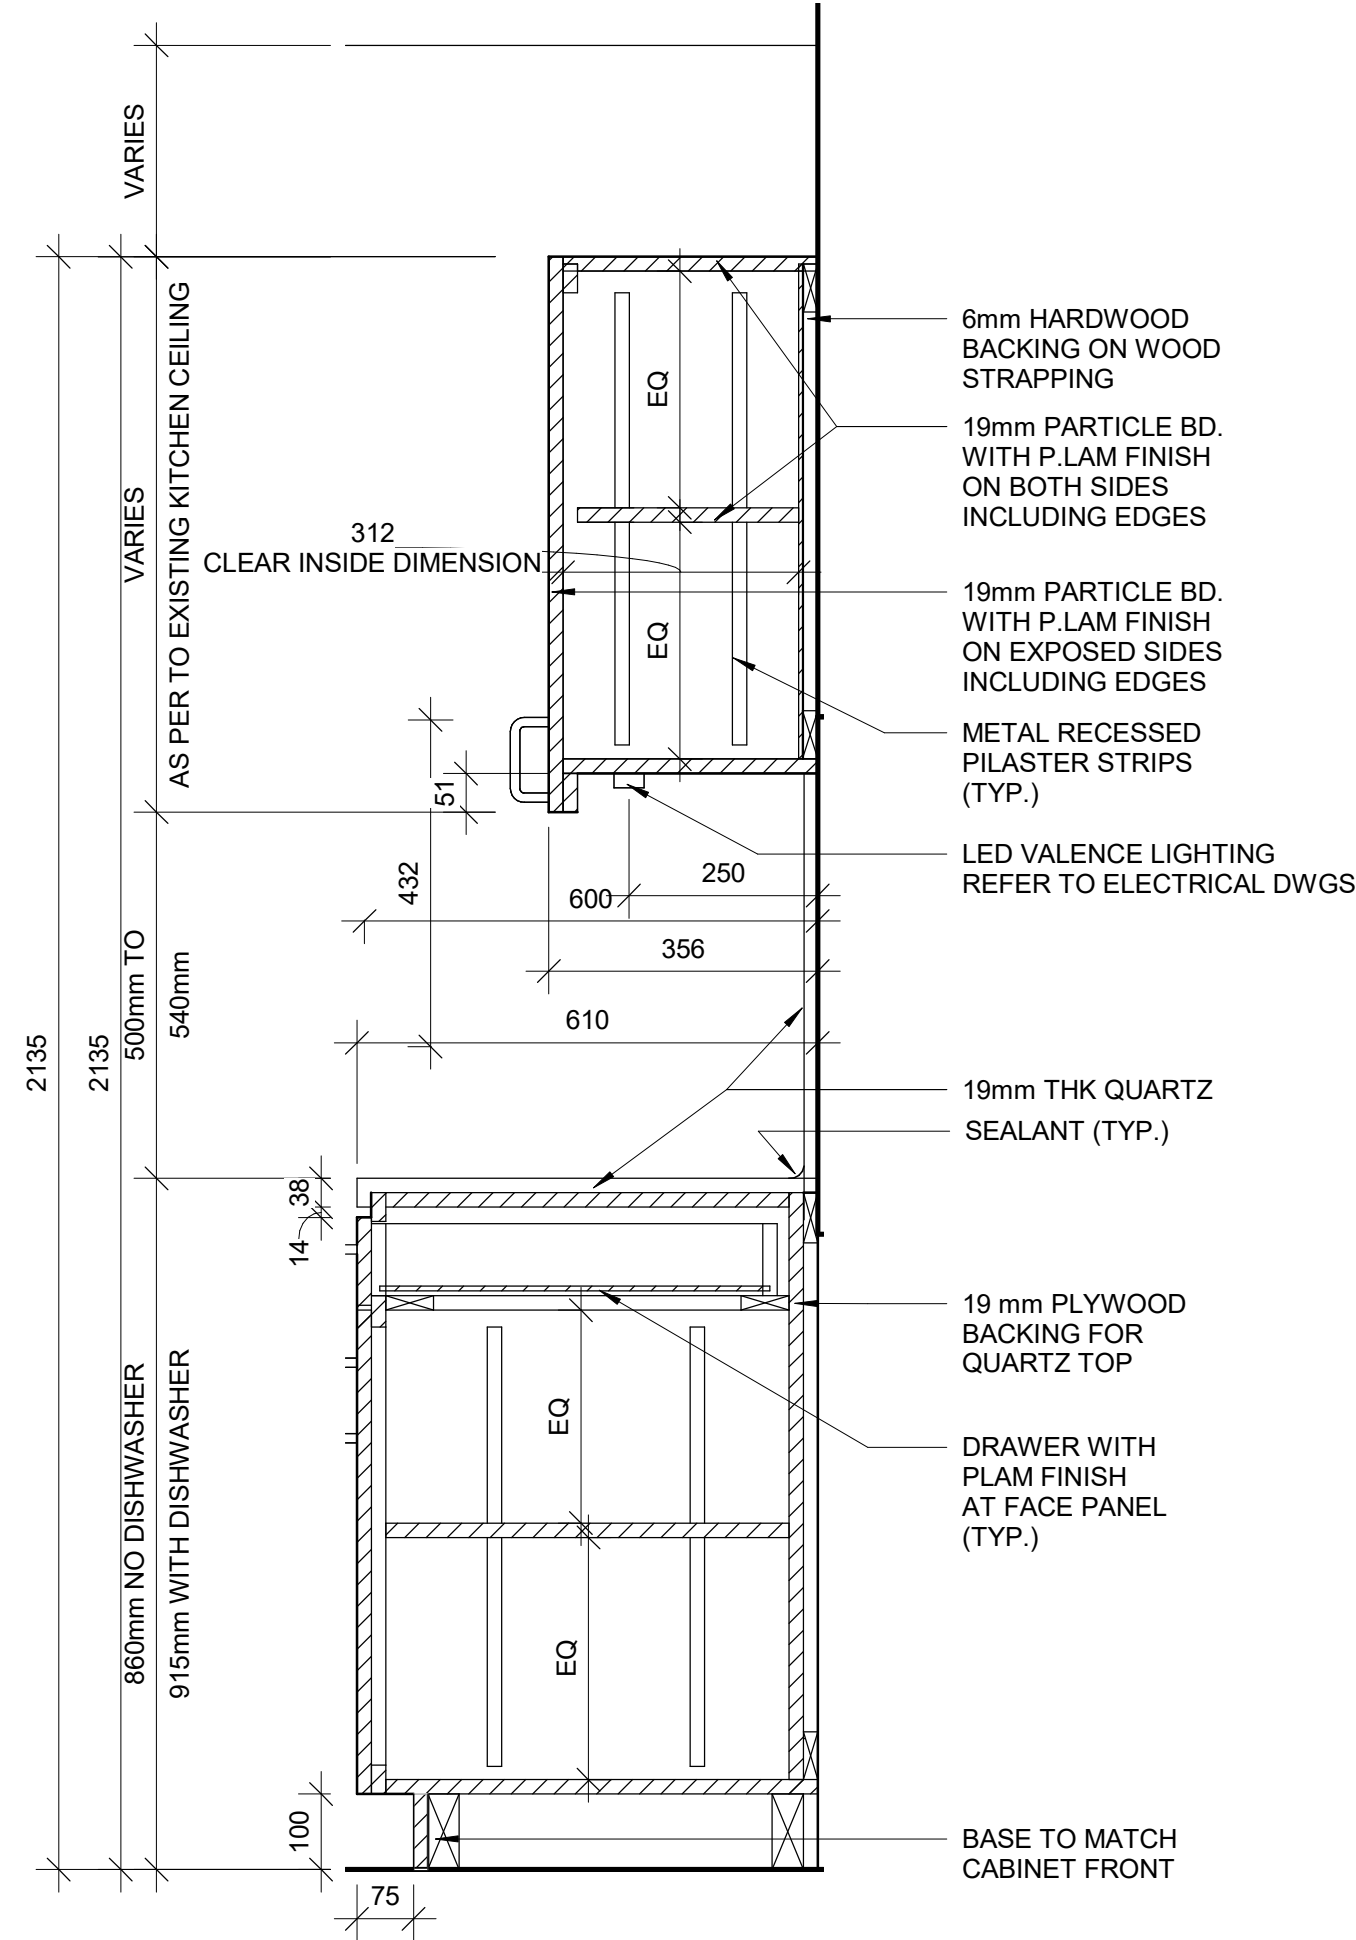
SHEET TITLE
**KITCHEN MILLWORK
PLANS & ELEVATIONS**

SHEET NUMBER D1301	ISSUE A
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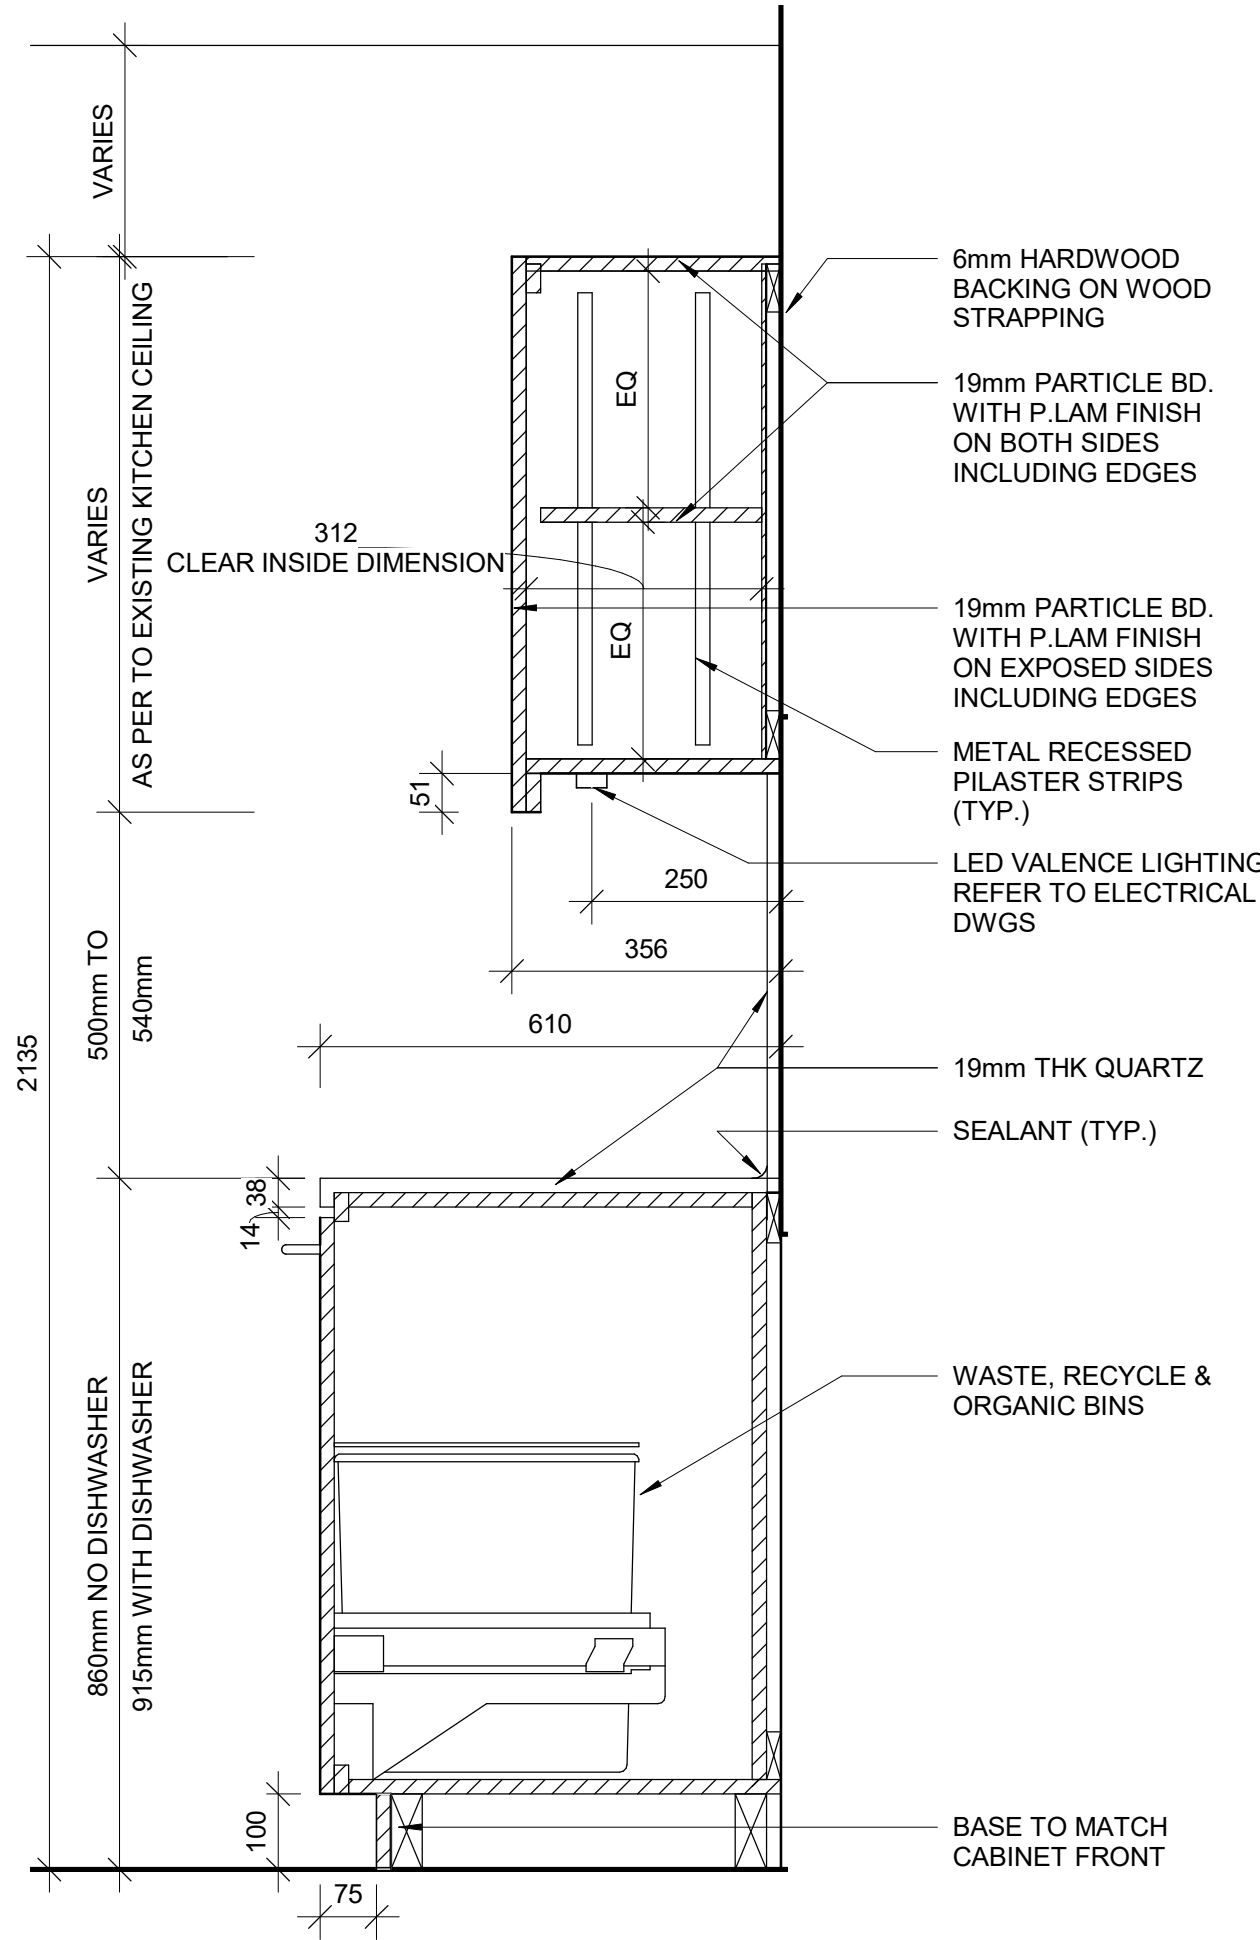
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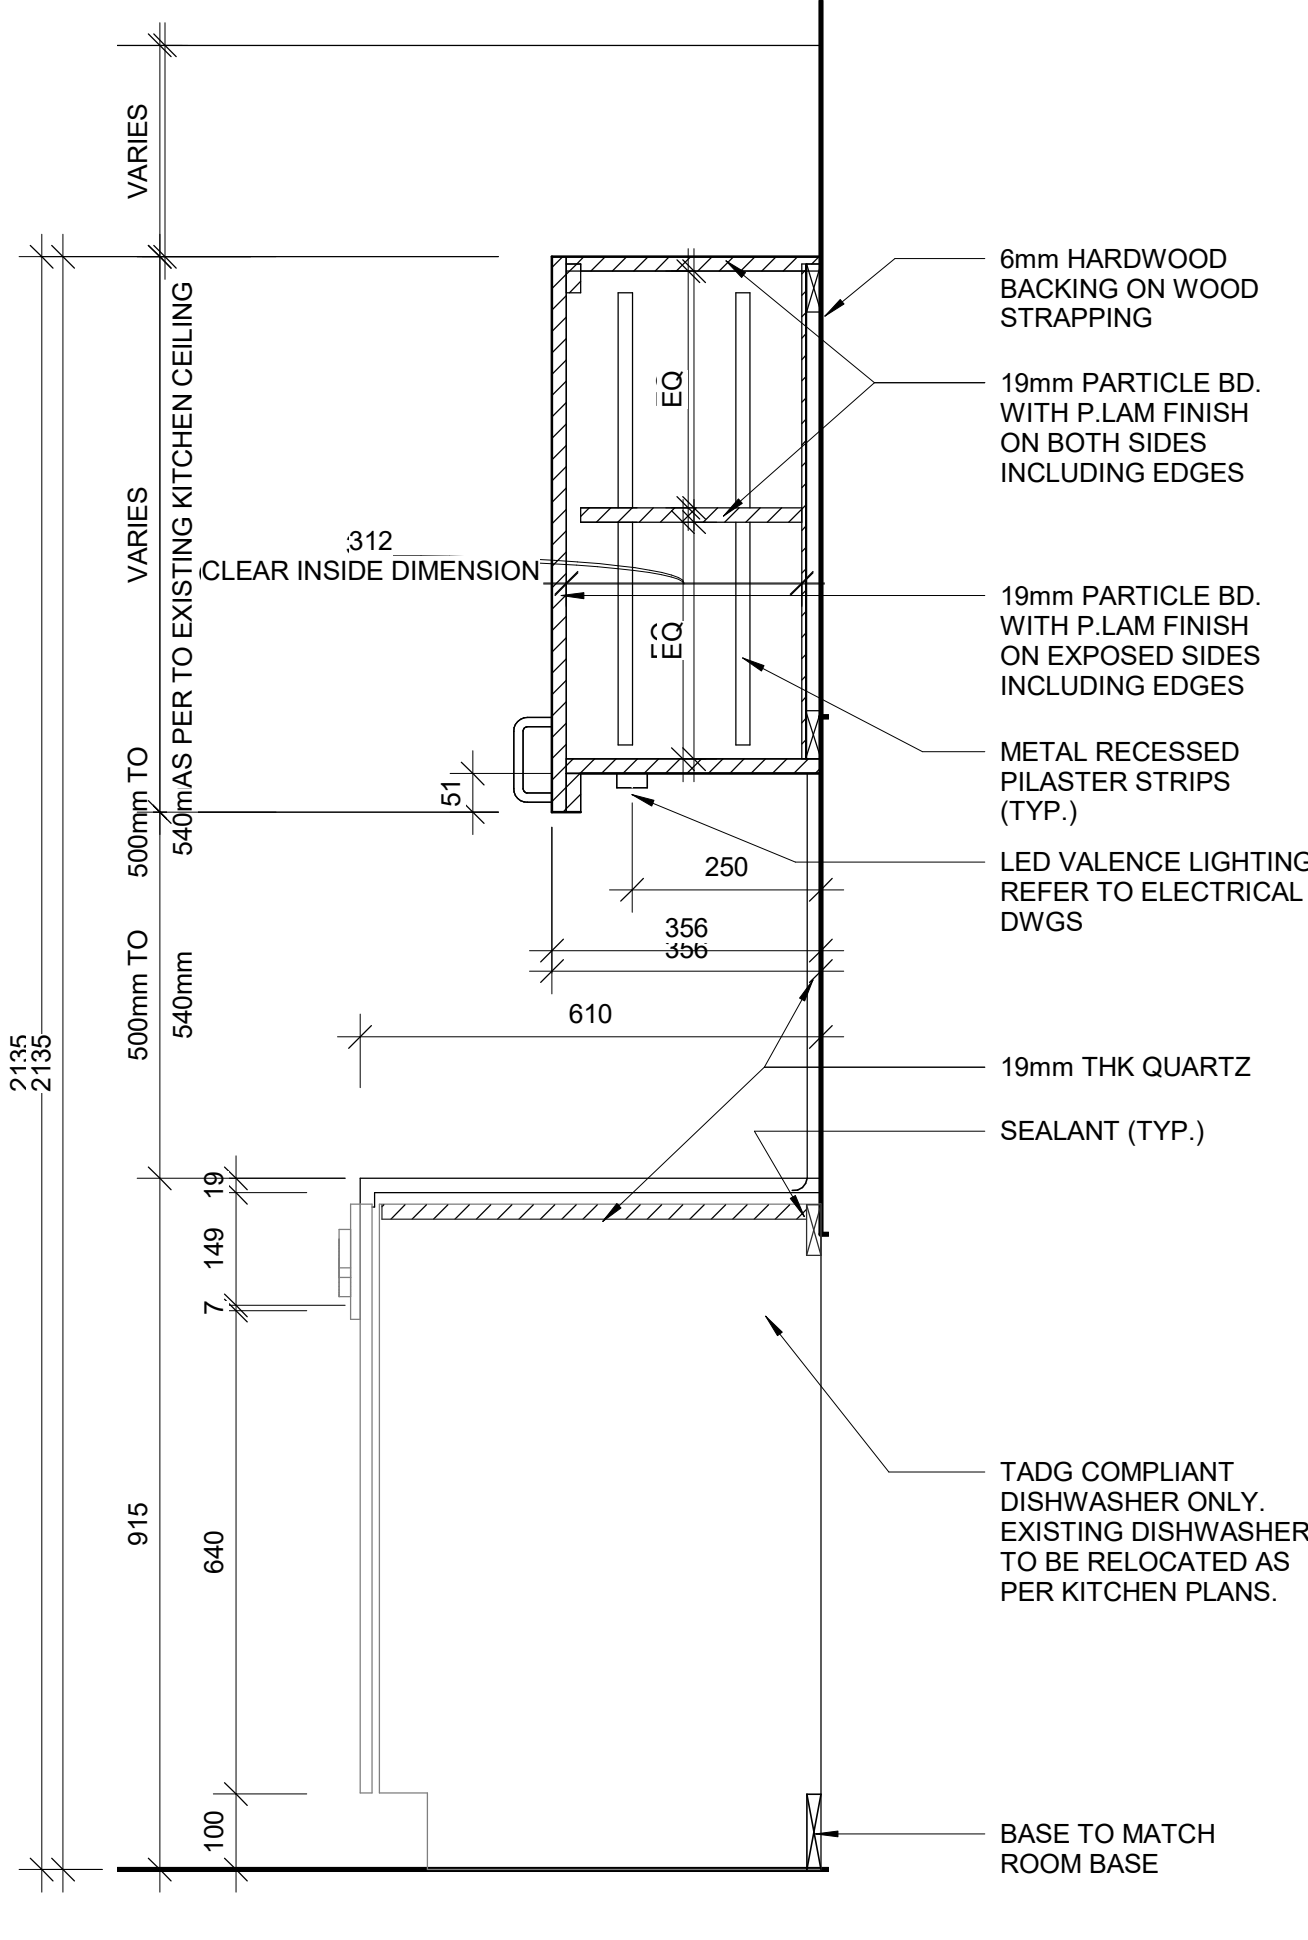
1 BASE CABINETRY- MICROWAVE STORAGE
D1302 Scale: 1 : 10




2 BASE CABINETRY WITH DRAWER
D1302 Scale: 1 : 10




3 BASE CABINETRY WITH GARBAGE BIN
D1302 Scale: 1 : 10



4 BASE CABINETRY WITH DISHWASHER
D1302 Scale: 1 : 10

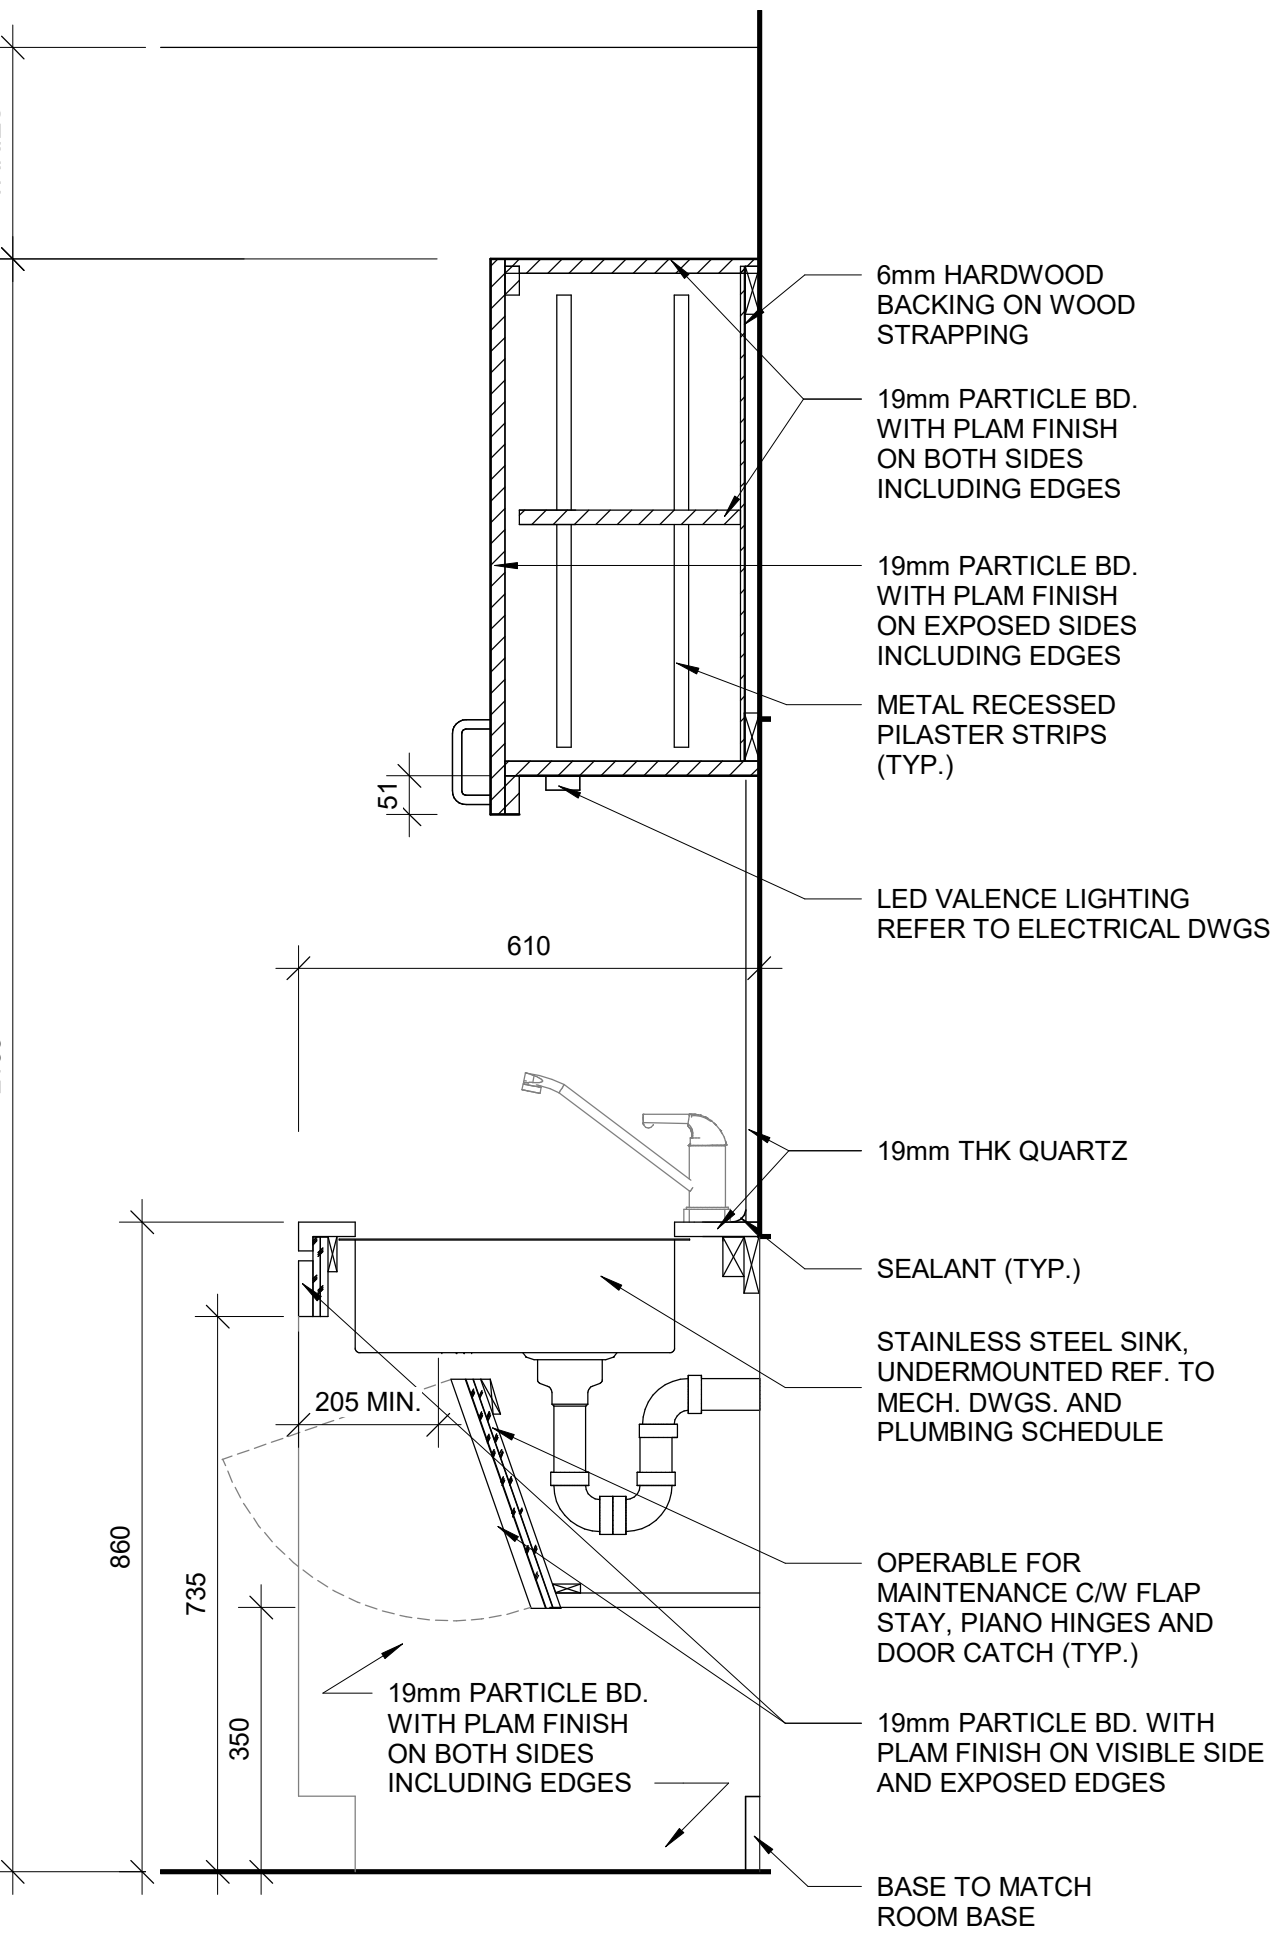


5 BASE CABINETRY WITH SINK
D1302 Scale: 1 : 10

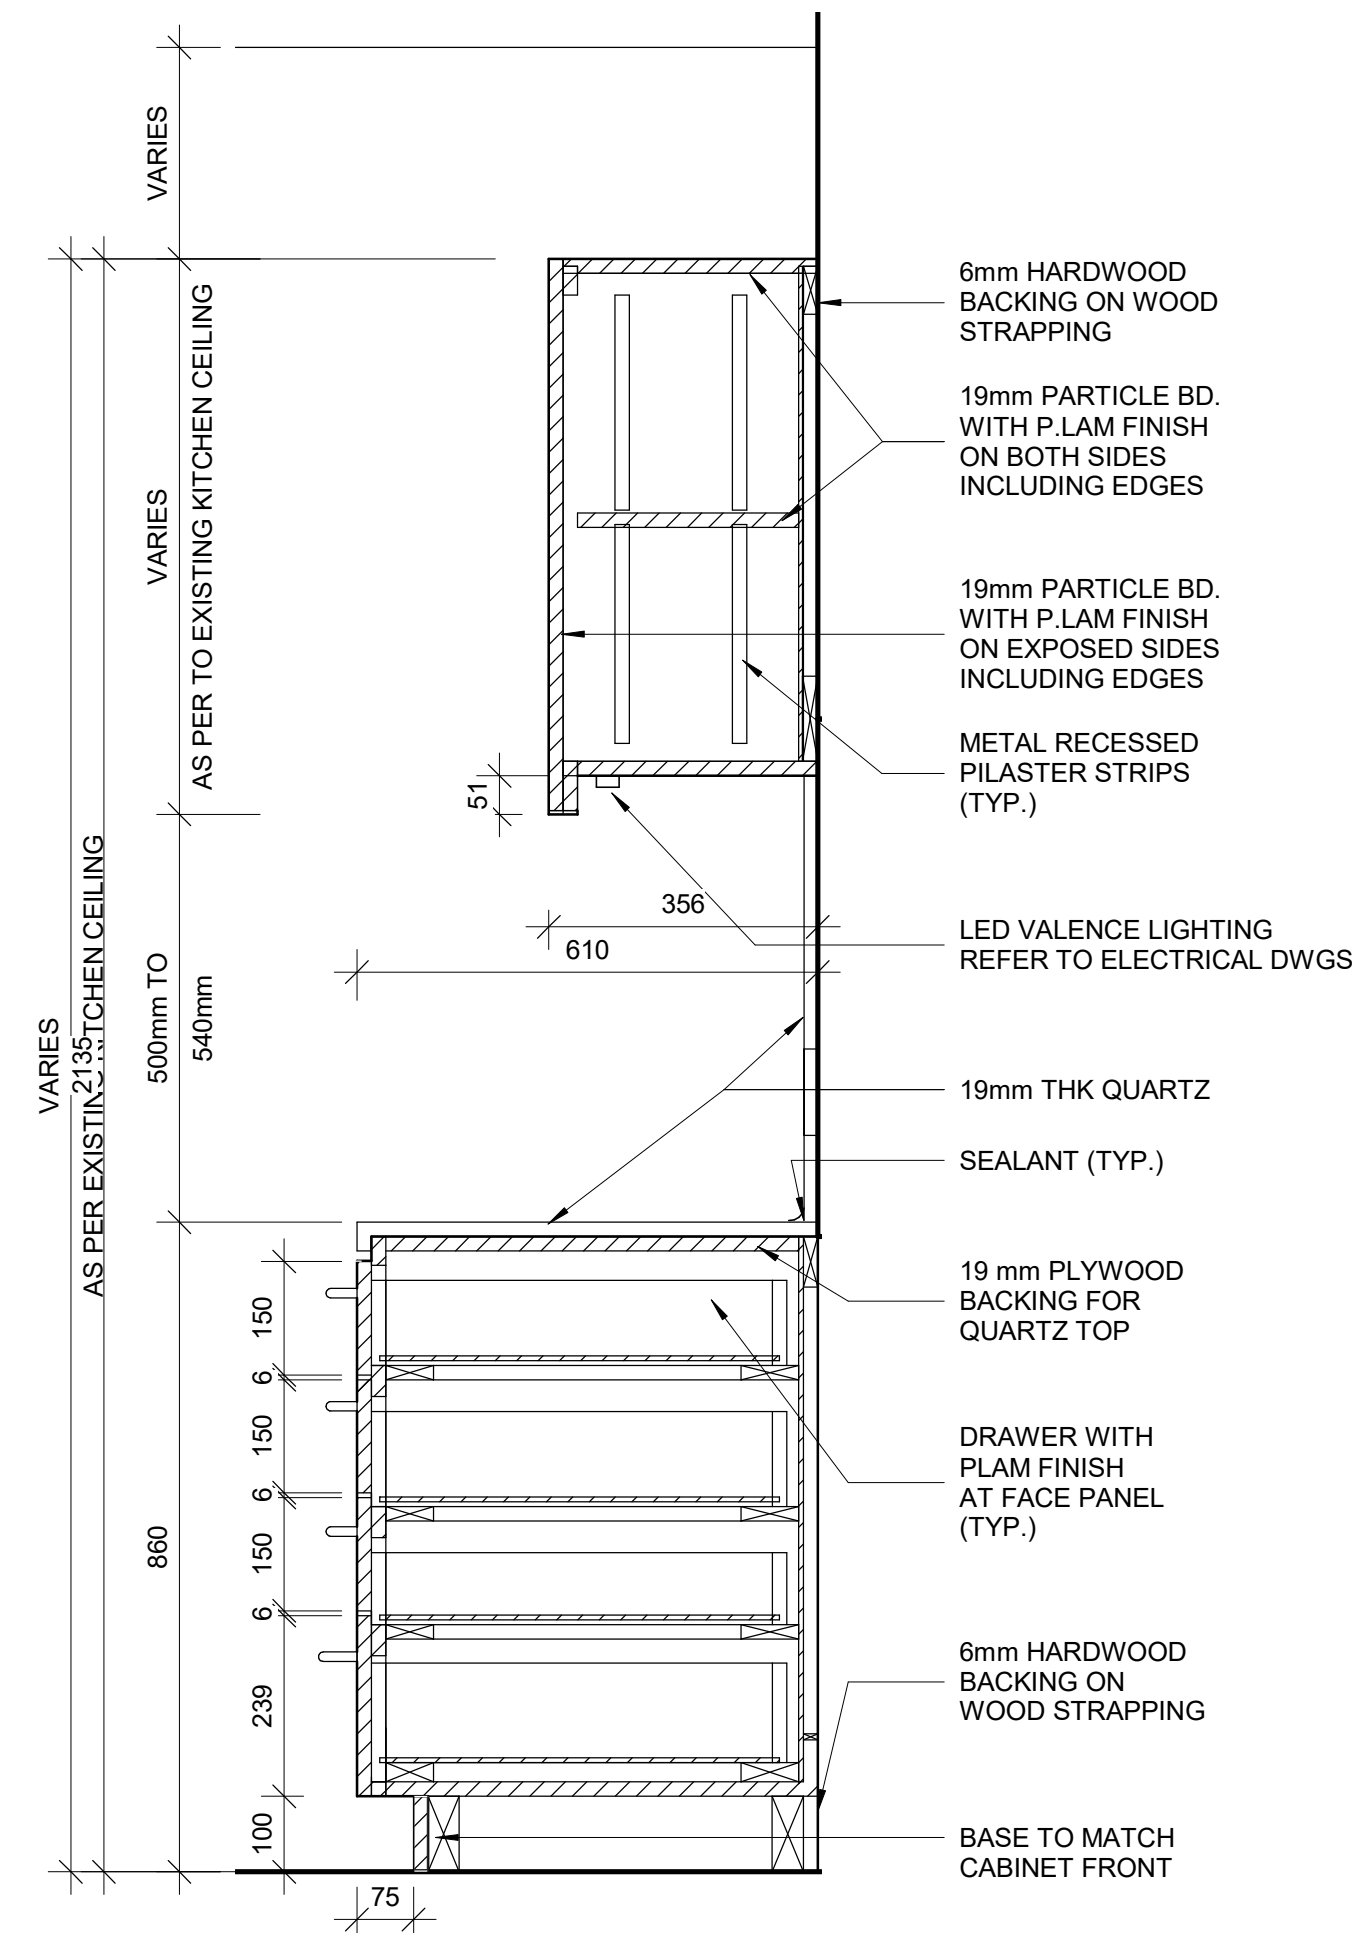

6 BASE CABINETRY WITH FOUR DRAWERS
D1302 Scale: 1 : 10

RESERVED

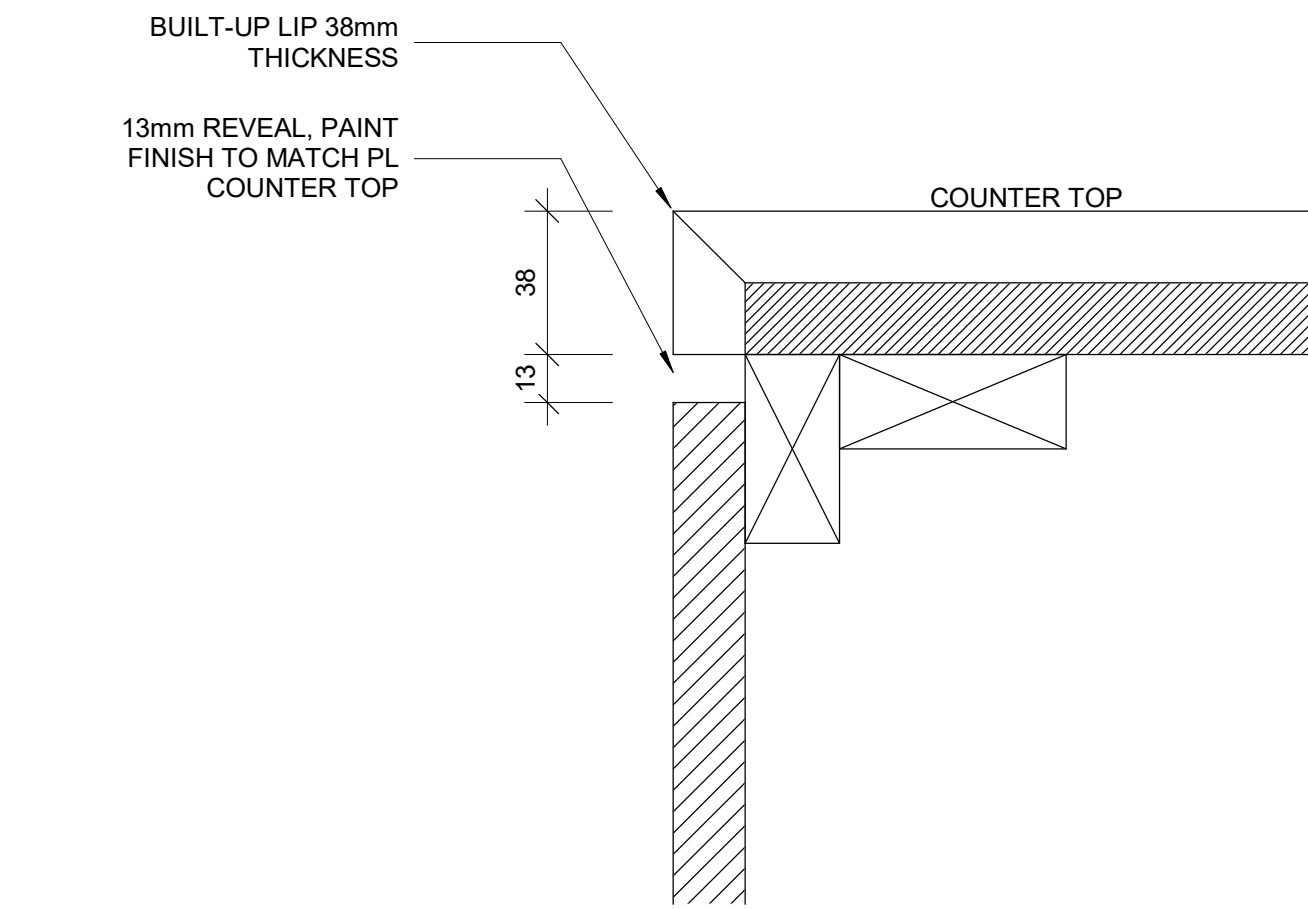

8 TYPICAL BUILT-UP NOSING DOOR COUNTER TOP
D1302 Scale: 1 : 2

NOTE:

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PROJECT TITLE

CITY OF TORONTO
ACCESSIBILITY UPGRADES

PROJECT ADDRESS

PROJECT NO:
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DRAWN BY: A. BOYNARIAN	CHECKED BY: K. TILAHUN
PROJECT MGR: F. BOLOURIAN	APPROVED BY: E. FENUITA



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

KITCHEN MILLWORK
DETAIL SECTIONS



SHEET NUMBER	ISSUE
D1302	A

A large rectangular area divided into two horizontal sections by a thin line. The top section is white and contains the word "RESERVED" in black, uppercase letters, rotated 45 degrees counter-clockwise. The bottom section is light gray and also contains the word "RESERVED" in black, uppercase letters, rotated 45 degrees counter-clockwise.

A large rectangular area divided into two horizontal sections by a thin line. The top section contains the word "RESERVED" written diagonally. The bottom section also contains the word "RESERVED" written diagonally.

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<div>CONSULTANTS</div>								
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<div><div>PRIME CONSULTANT</div><div>ARCADIS</div><div>100 - 175 Galaxy Blvd, Toronto, ON M9W 0C9, Canada tel 416 679 1930 www.arcadis.com</div></div>								
<div><div>PROJECT TITLE</div><div>CITY OF TORONTO ACCESSIBILITY UPGRADES</div></div>								
<div>PROJECT ADDRESS</div>								
<div>PROJECT NO: 9119- 19- 0162 / Arcadis 30279056</div> <table><tr><td>DRAWN BY: A. BOYNARIAN</td><td>CHECKED BY: K. TILAHUN</td></tr><tr><td>PROJECT MGR: F. BOLOURIAN</td><td>APPROVED BY: E. FENUTA</td></tr></table>			DRAWN BY: A. BOYNARIAN	CHECKED BY: K. TILAHUN	PROJECT MGR: F. BOLOURIAN	APPROVED BY: E. FENUTA		
DRAWN BY: A. BOYNARIAN	CHECKED BY: K. TILAHUN							
PROJECT MGR: F. BOLOURIAN	APPROVED BY: E. FENUTA							
<div><div>SHEET TITLE</div><div>KITCHEN HOOD VENT DETAIL</div></div>								
<div>SHEET NUMBER D1303</div>		<div>ISSUE A</div>						

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<div>CONSULTANTS</div>								
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<div>PROJECT TITLE</div> <div>CITY OF TORONTO ACCESSIBILITY UPGRADES</div>								
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DRAWN BY: A. BOYNARIAN	CHECKED BY: K. TILAHUN							
PROJECT MGR: F. BOLOURIAN	APPROVED BY: E. FENUTA							
<div>SHEET TITLE</div> <div>KITCHEN HOOD VENT DETAIL</div>								
<div>SHEET NUMBER</div> <div>D1303</div>		<div>ISSUE</div> <div>A</div>						

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PROJECT MGR: F. BOLOURIAN	APPROVED BY: E. FENUTA							
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<div>SHEET NUMBER</div> <div>D1303</div>		<div>ISSUE</div> <div>A</div>						

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PROJECT TITLE

CITY OF TORONTO
ACCESSIBILITY UPGRADES

PROJECT ADDRESS

PROJECT NO:
9119- 19- 0162 / Arcadis 30279056

DRAWN BY: A. BOYNARIAN	CHECKED BY: K. TILAHUN
PROJECT MGR: F. BOLOURIAN	APPROVED BY: E. FENUTA

SHEET TITLE

RECEPTION DESK WITH
TEMPERED GLASS
MILLWORK

SHEET NUMBER	ISSUE
D1305	A

2025-04-11 10:39:53 AM

SCALE CHECK

1 in

10mm

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PROJECT TITLE
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ACCESSIBILITY UPGRADES

PROJECT ADDRESS


PROJECT NO:
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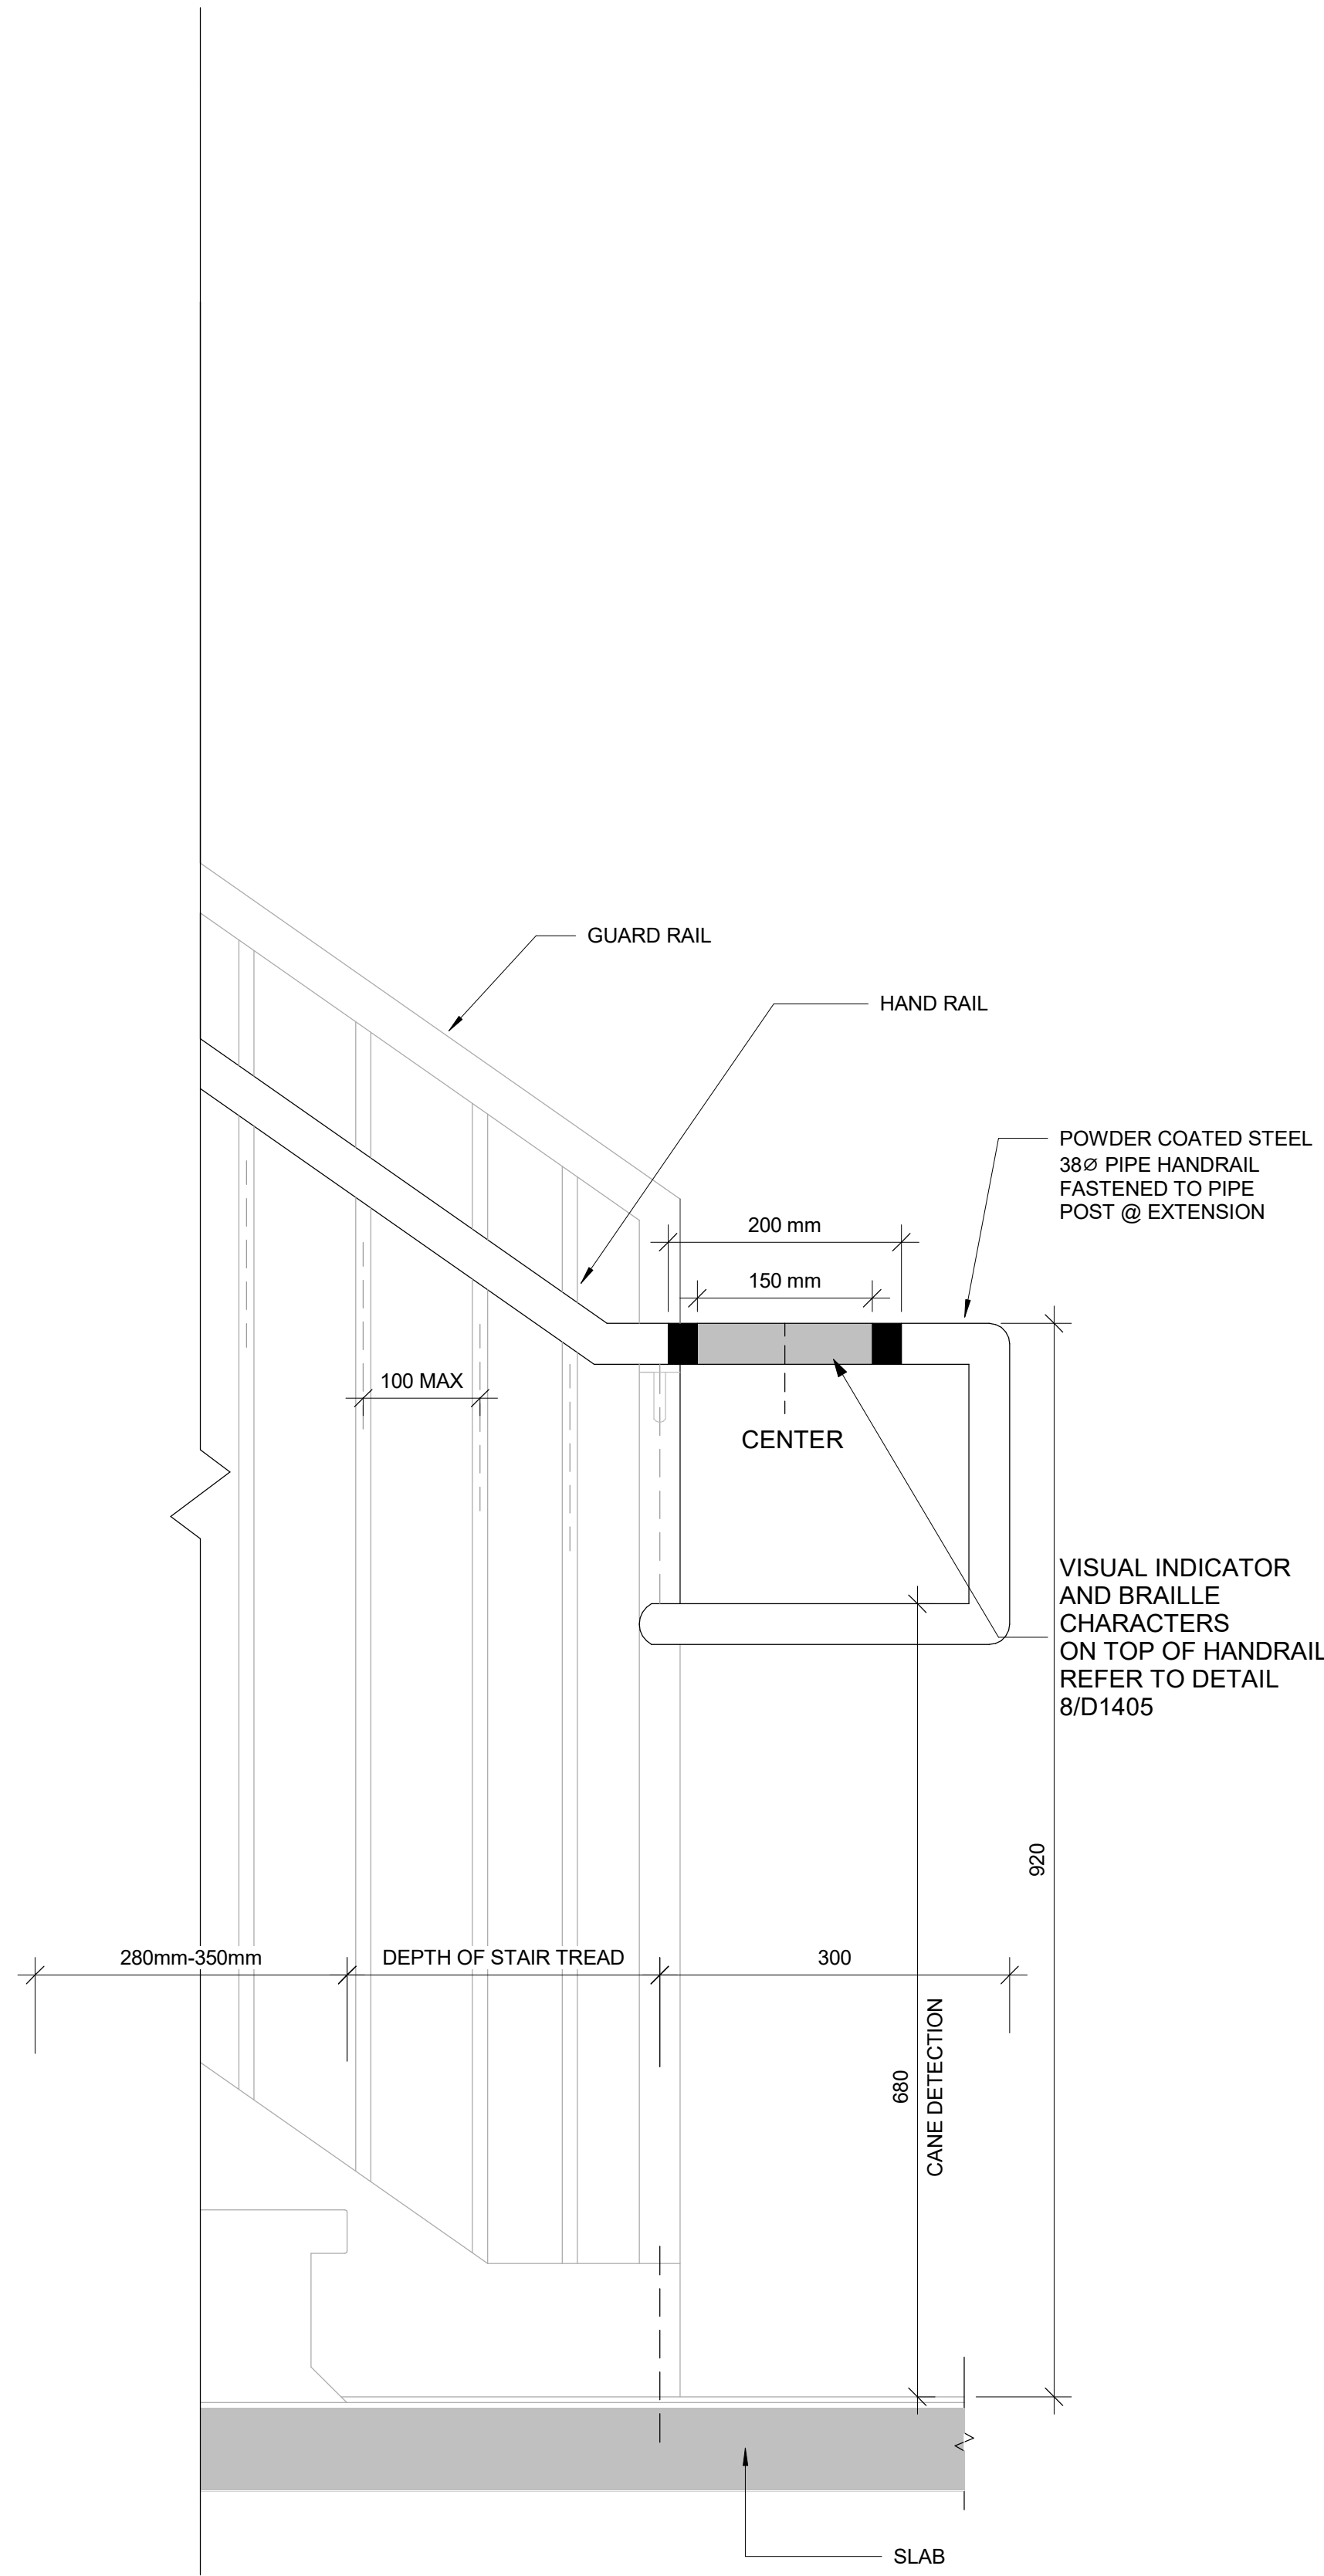
PROJECT MGR: F. BOLOURIAN	APPROVED BY: E. FENUTA
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SHEET TITLE
RECEPTION DESK WITH
TEMPERED GLASS
DETAIL SECTIONS


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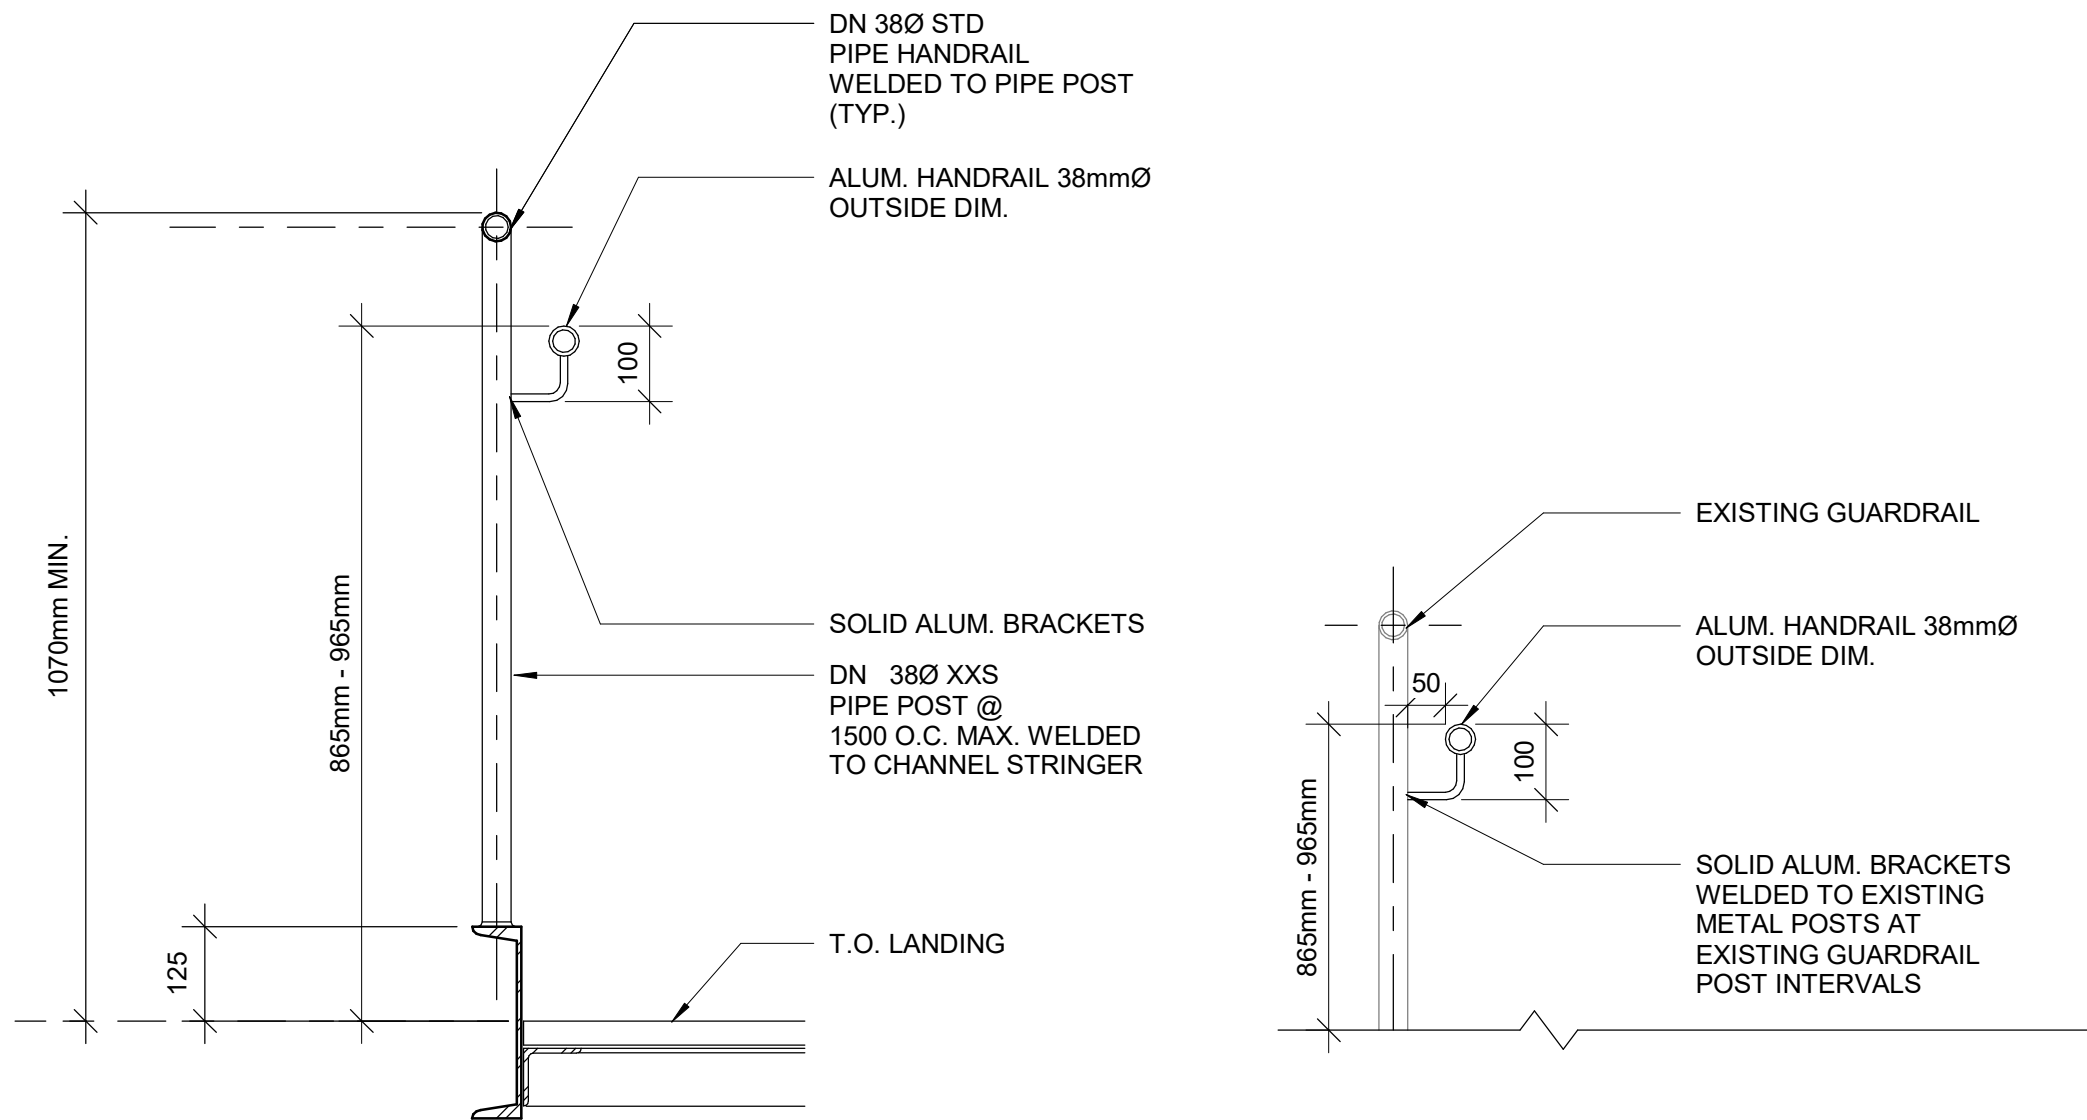
3 HANDRAIL & ADDITION TO EXISTING GUARD
D1401 Scale: 1 : 5



- NOTES:
- INTERIOR GUARDS AND HANDRAILS TO BE STEEL WITH POWDER COATED FINISH UNLESS NOTED OTHERWISE
 - EXTERIOR GUARDS AND HANDRAILS TO BE GALVANIZED STEEL WITH POWDER COATED FINISH UNLESS NOTED OTHERWISE
 - FOR ALL TACTILE INDICATOR, USE TA-1A - YELLOW COLOUR UNLESS OTHERWISE NOTED
 - FOR ALL TEXTURE AND CONTRAST WARNING STRIP INTERIOR APPLICATION, USE TA-10 - YELLOW COLOUR UNLESS OTHERWISE NOTED
 - FOR ALL TEXTURE AND CONTRAST WARNING STRIP EXTERIOR APPLICATION, USE TA-11, EXCEPT CAST IN PLACE EXTERIOR CONCRETE APPLICATION USE TA-12

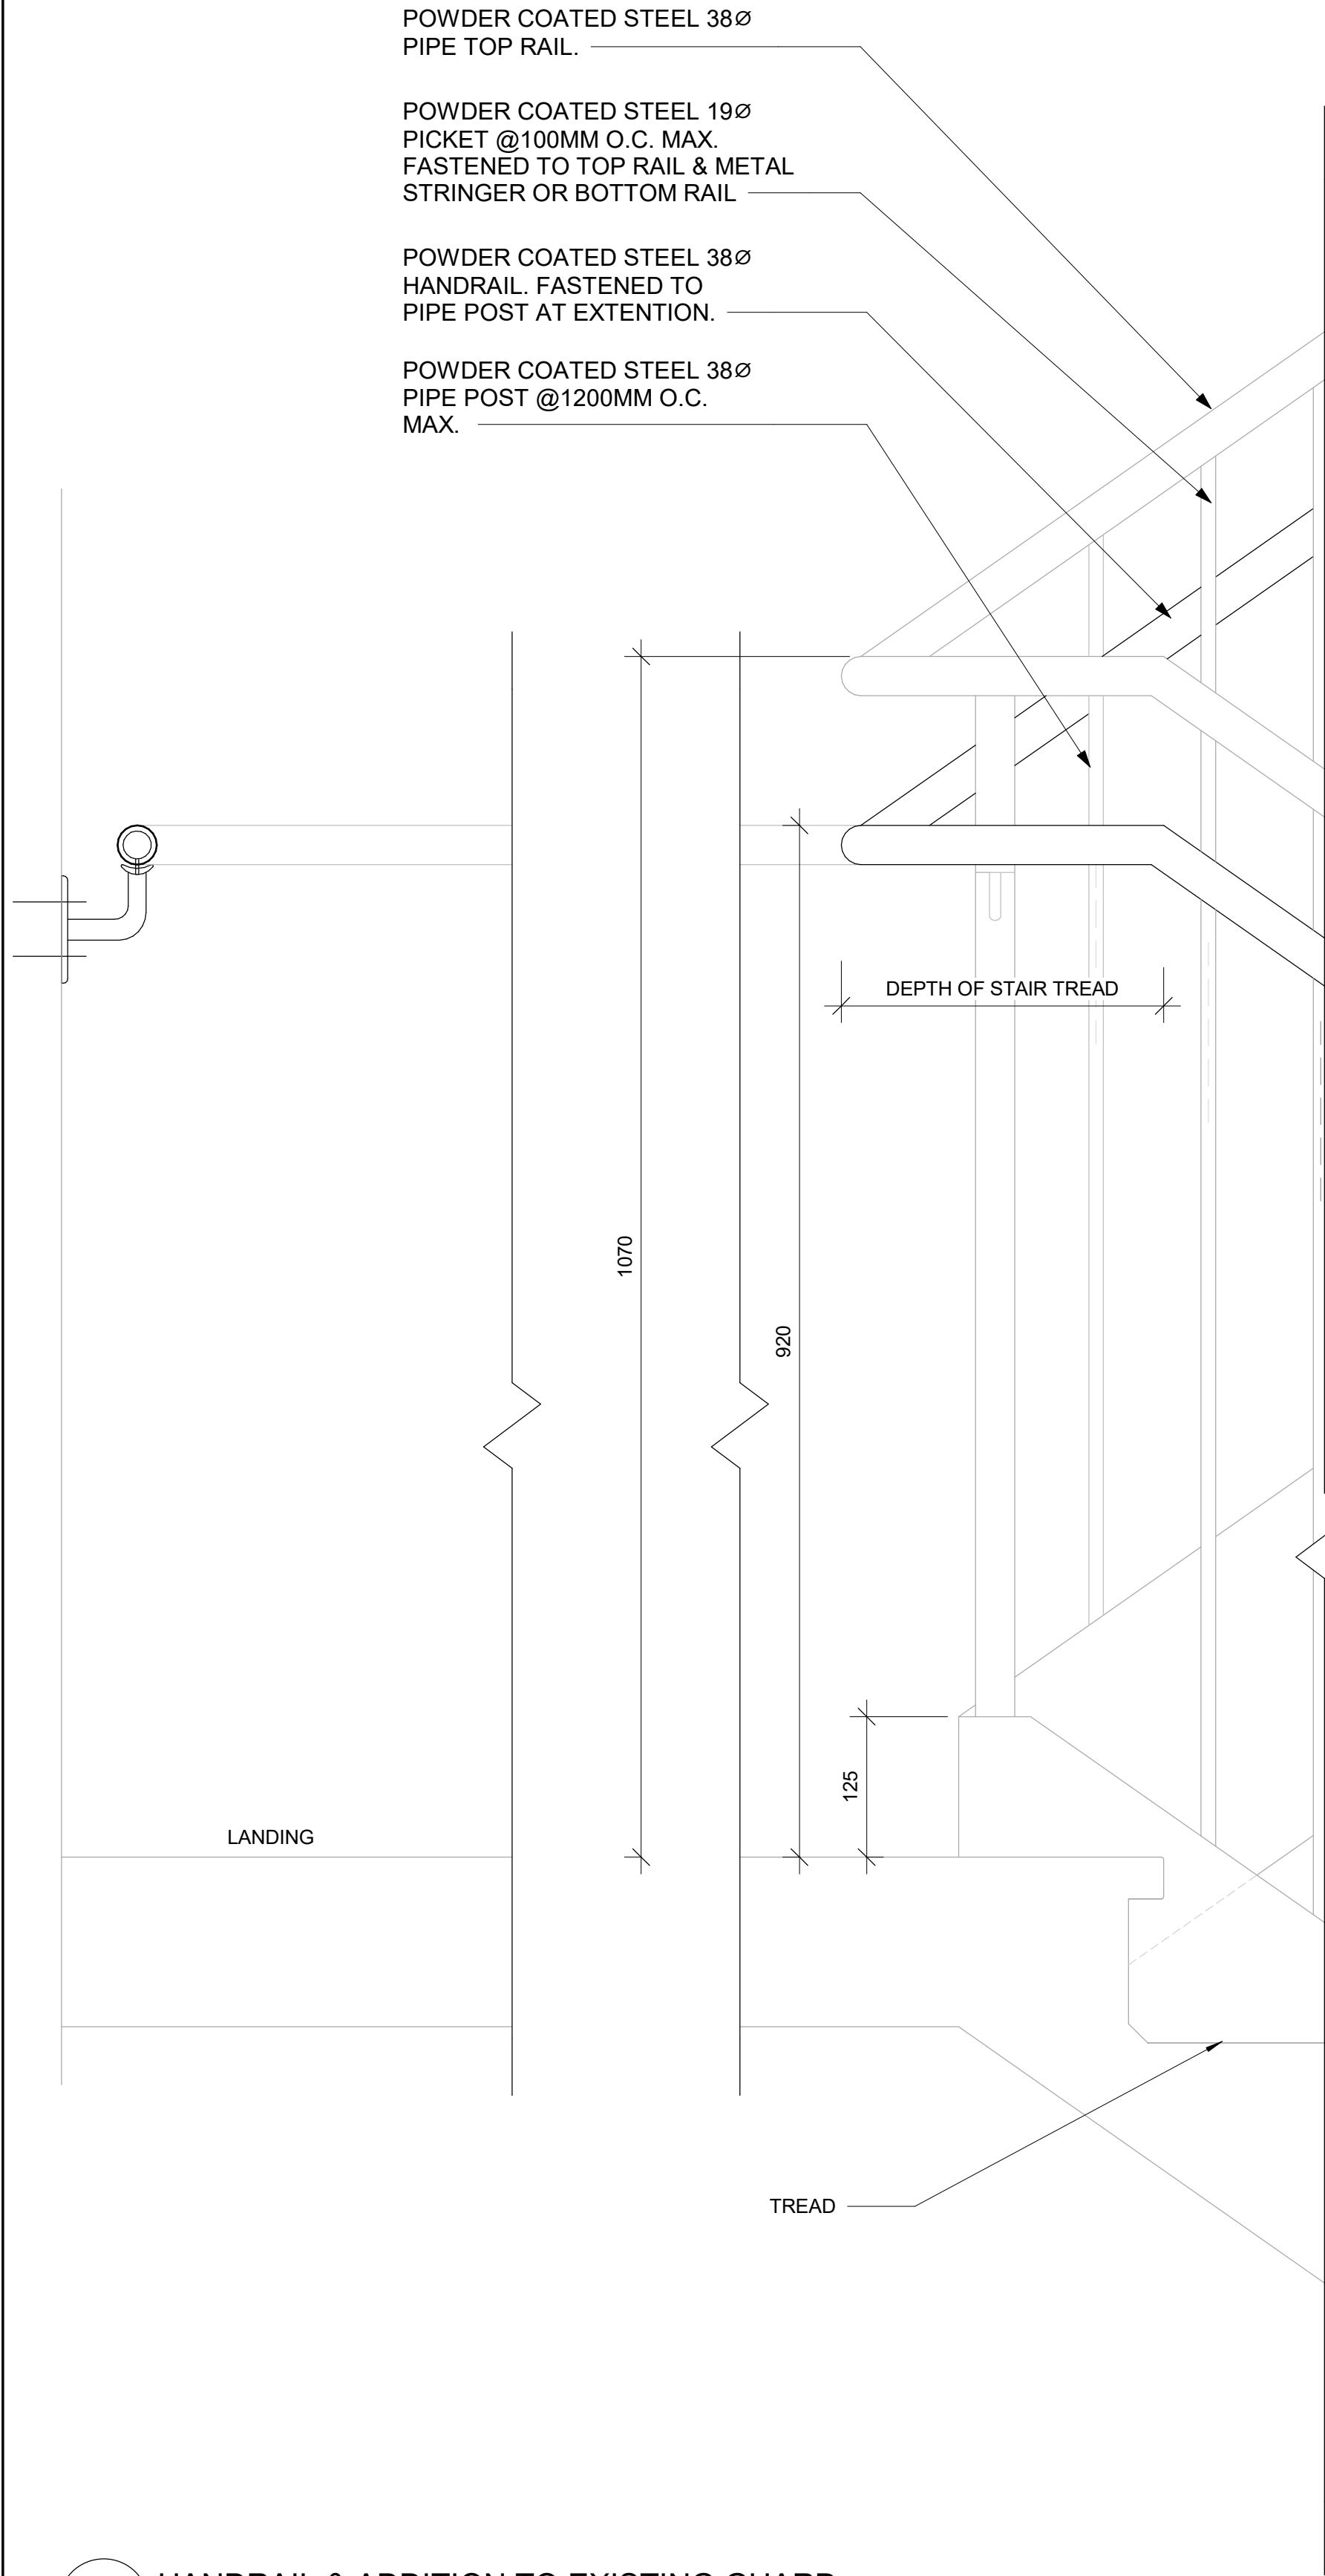


1 STAIR HANDRAIL DETAIL WITH WALL REINFORCEMENT
D1401 Scale: 1 : 5

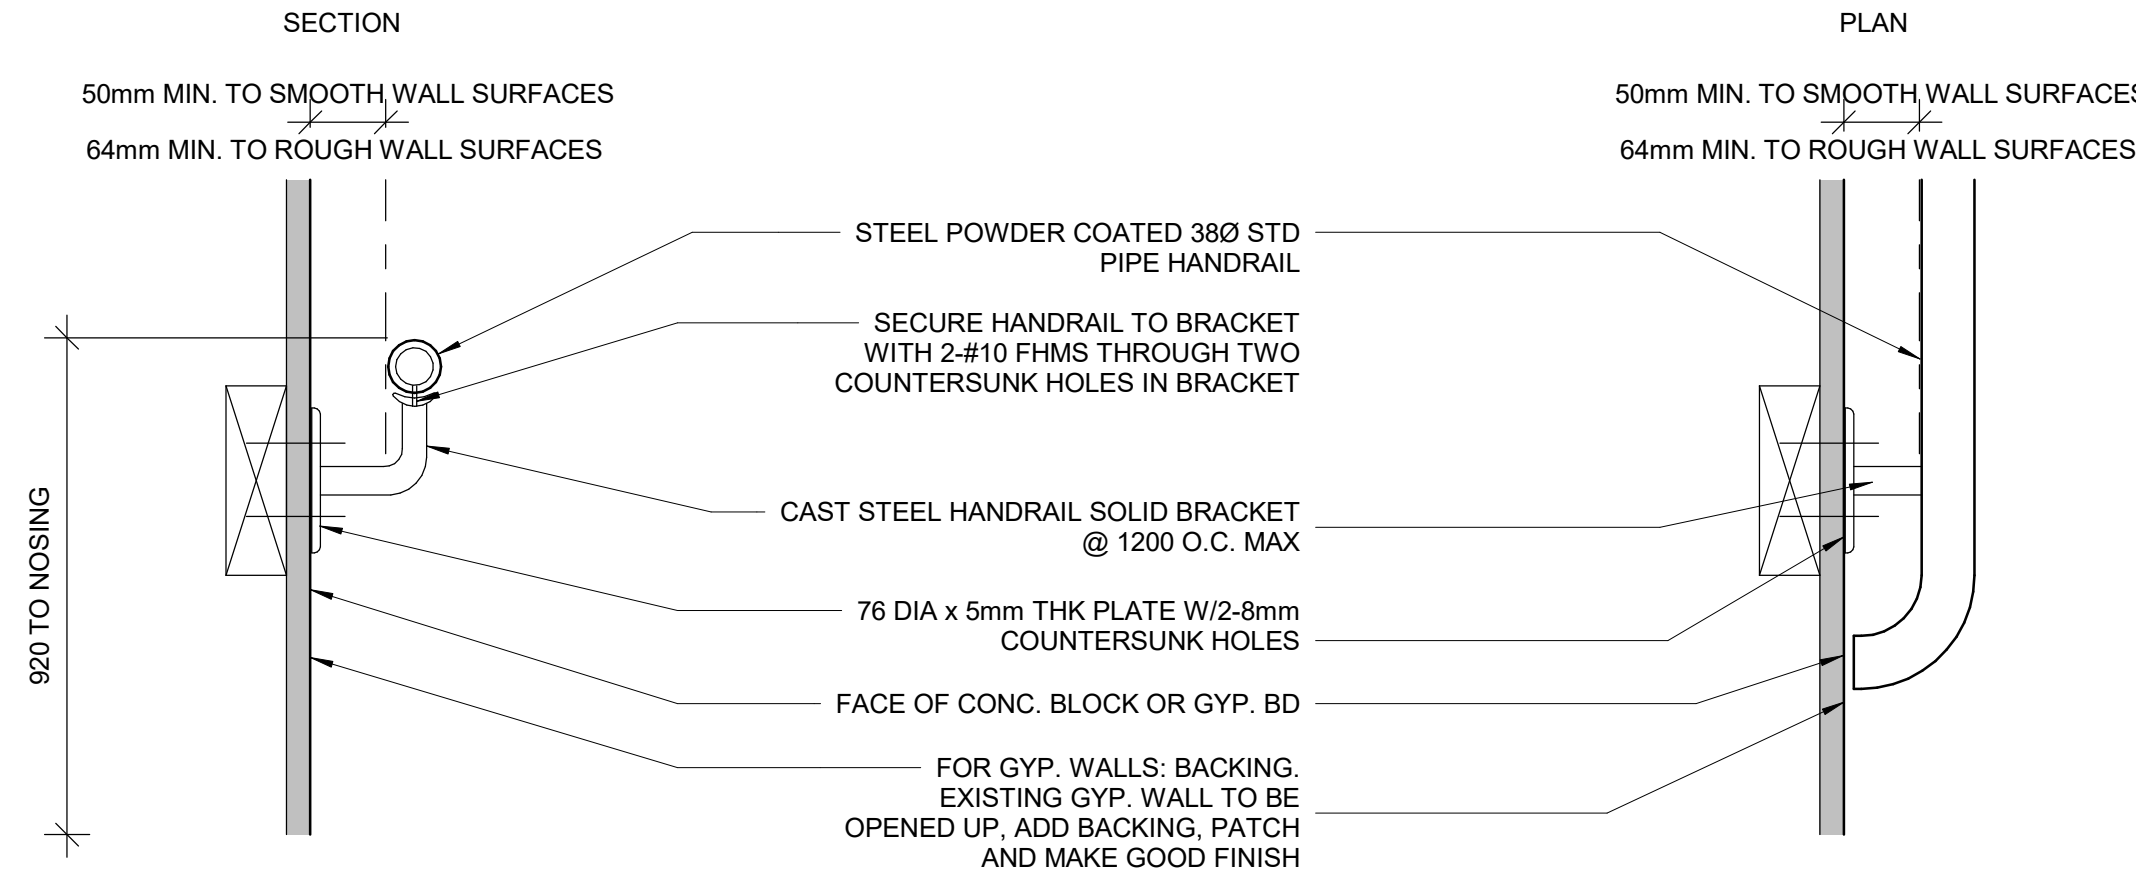

2 TYPICAL GUARDRAIL DETAIL AT LANDING
D1401 Scale: 1 : 10

5 EXISTING GUARDRAIL RETROFIT DETAIL
D1401 Scale: 1 : 10

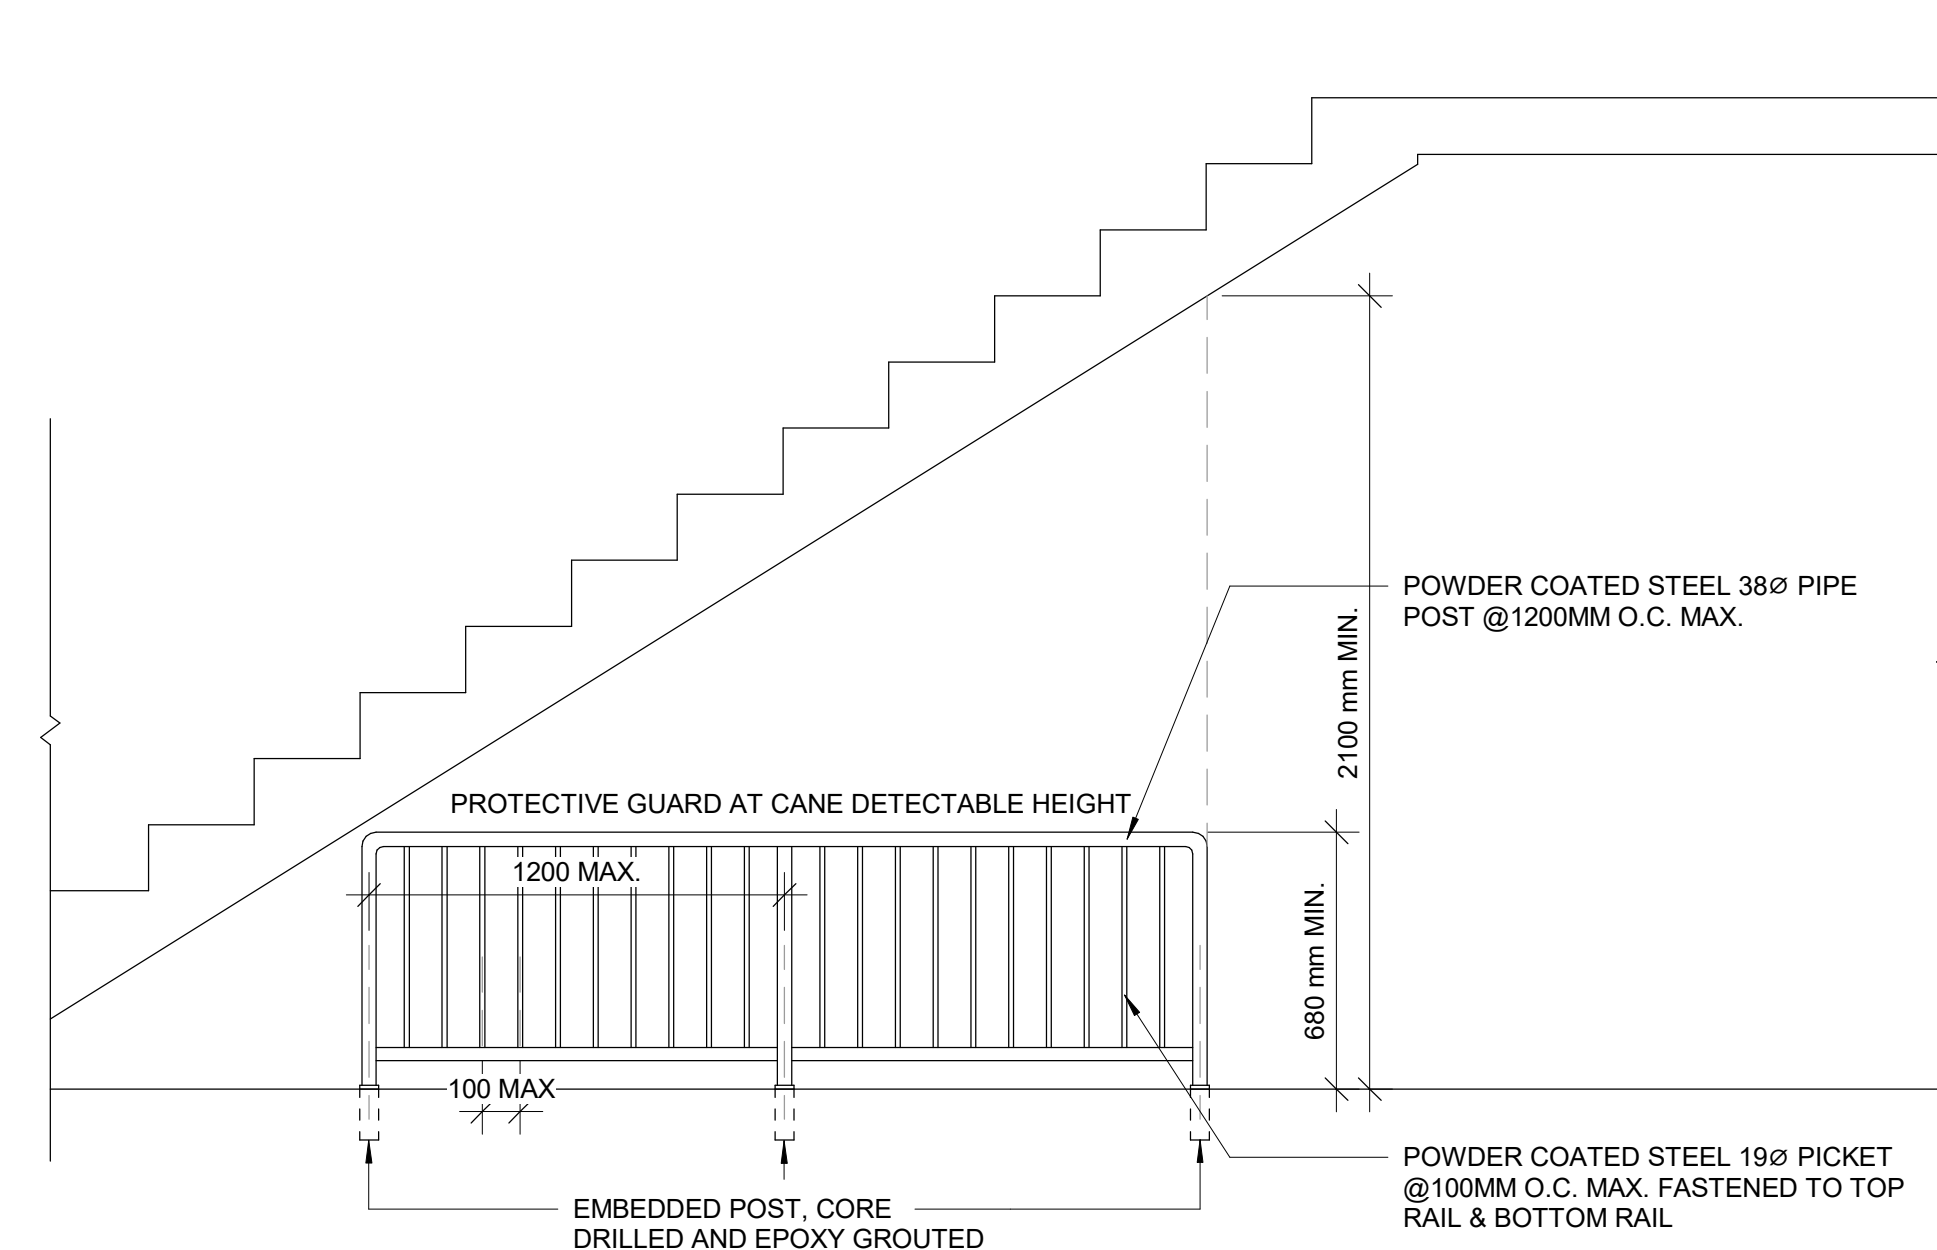

4 PROTECTION GUARD UNDER STAIRS
D1401 Scale: 1 : 20

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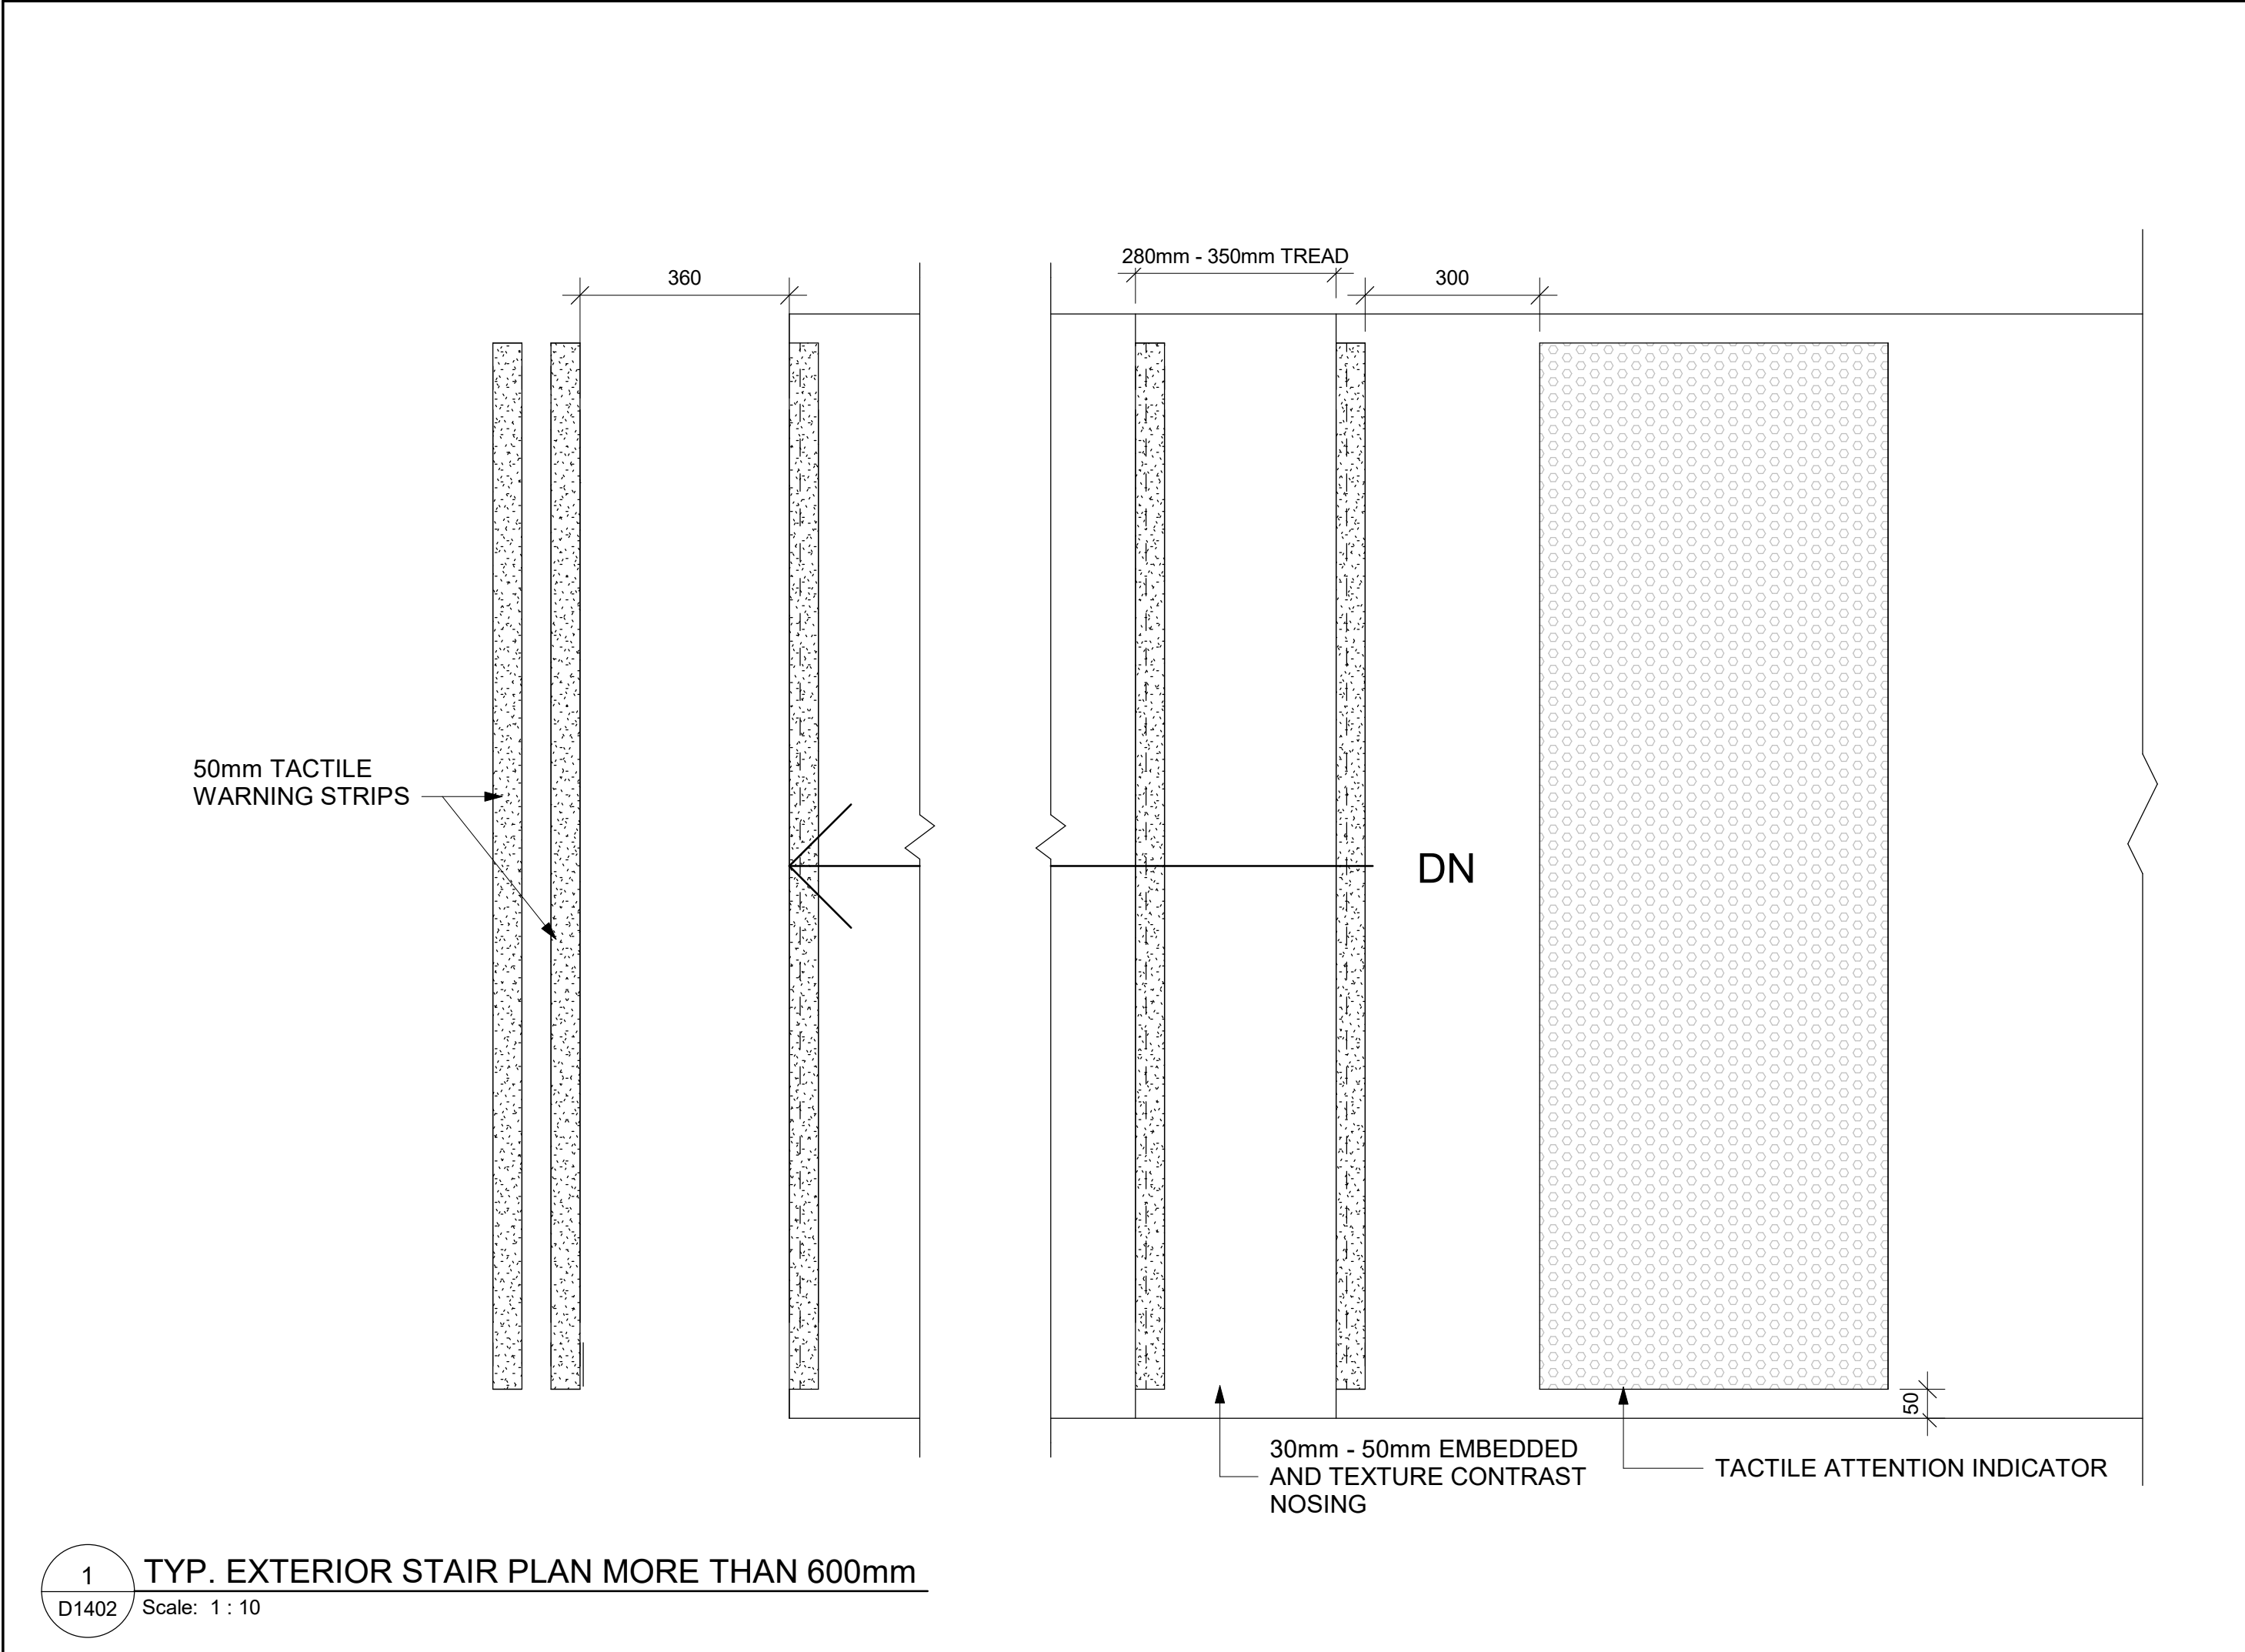
PROJECT TITLE
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APPROVED BY:
E. FENUITA


SHEET TITLE
STAIR DETAILS - 01

SHEET NUMBER D1401	ISSUE A
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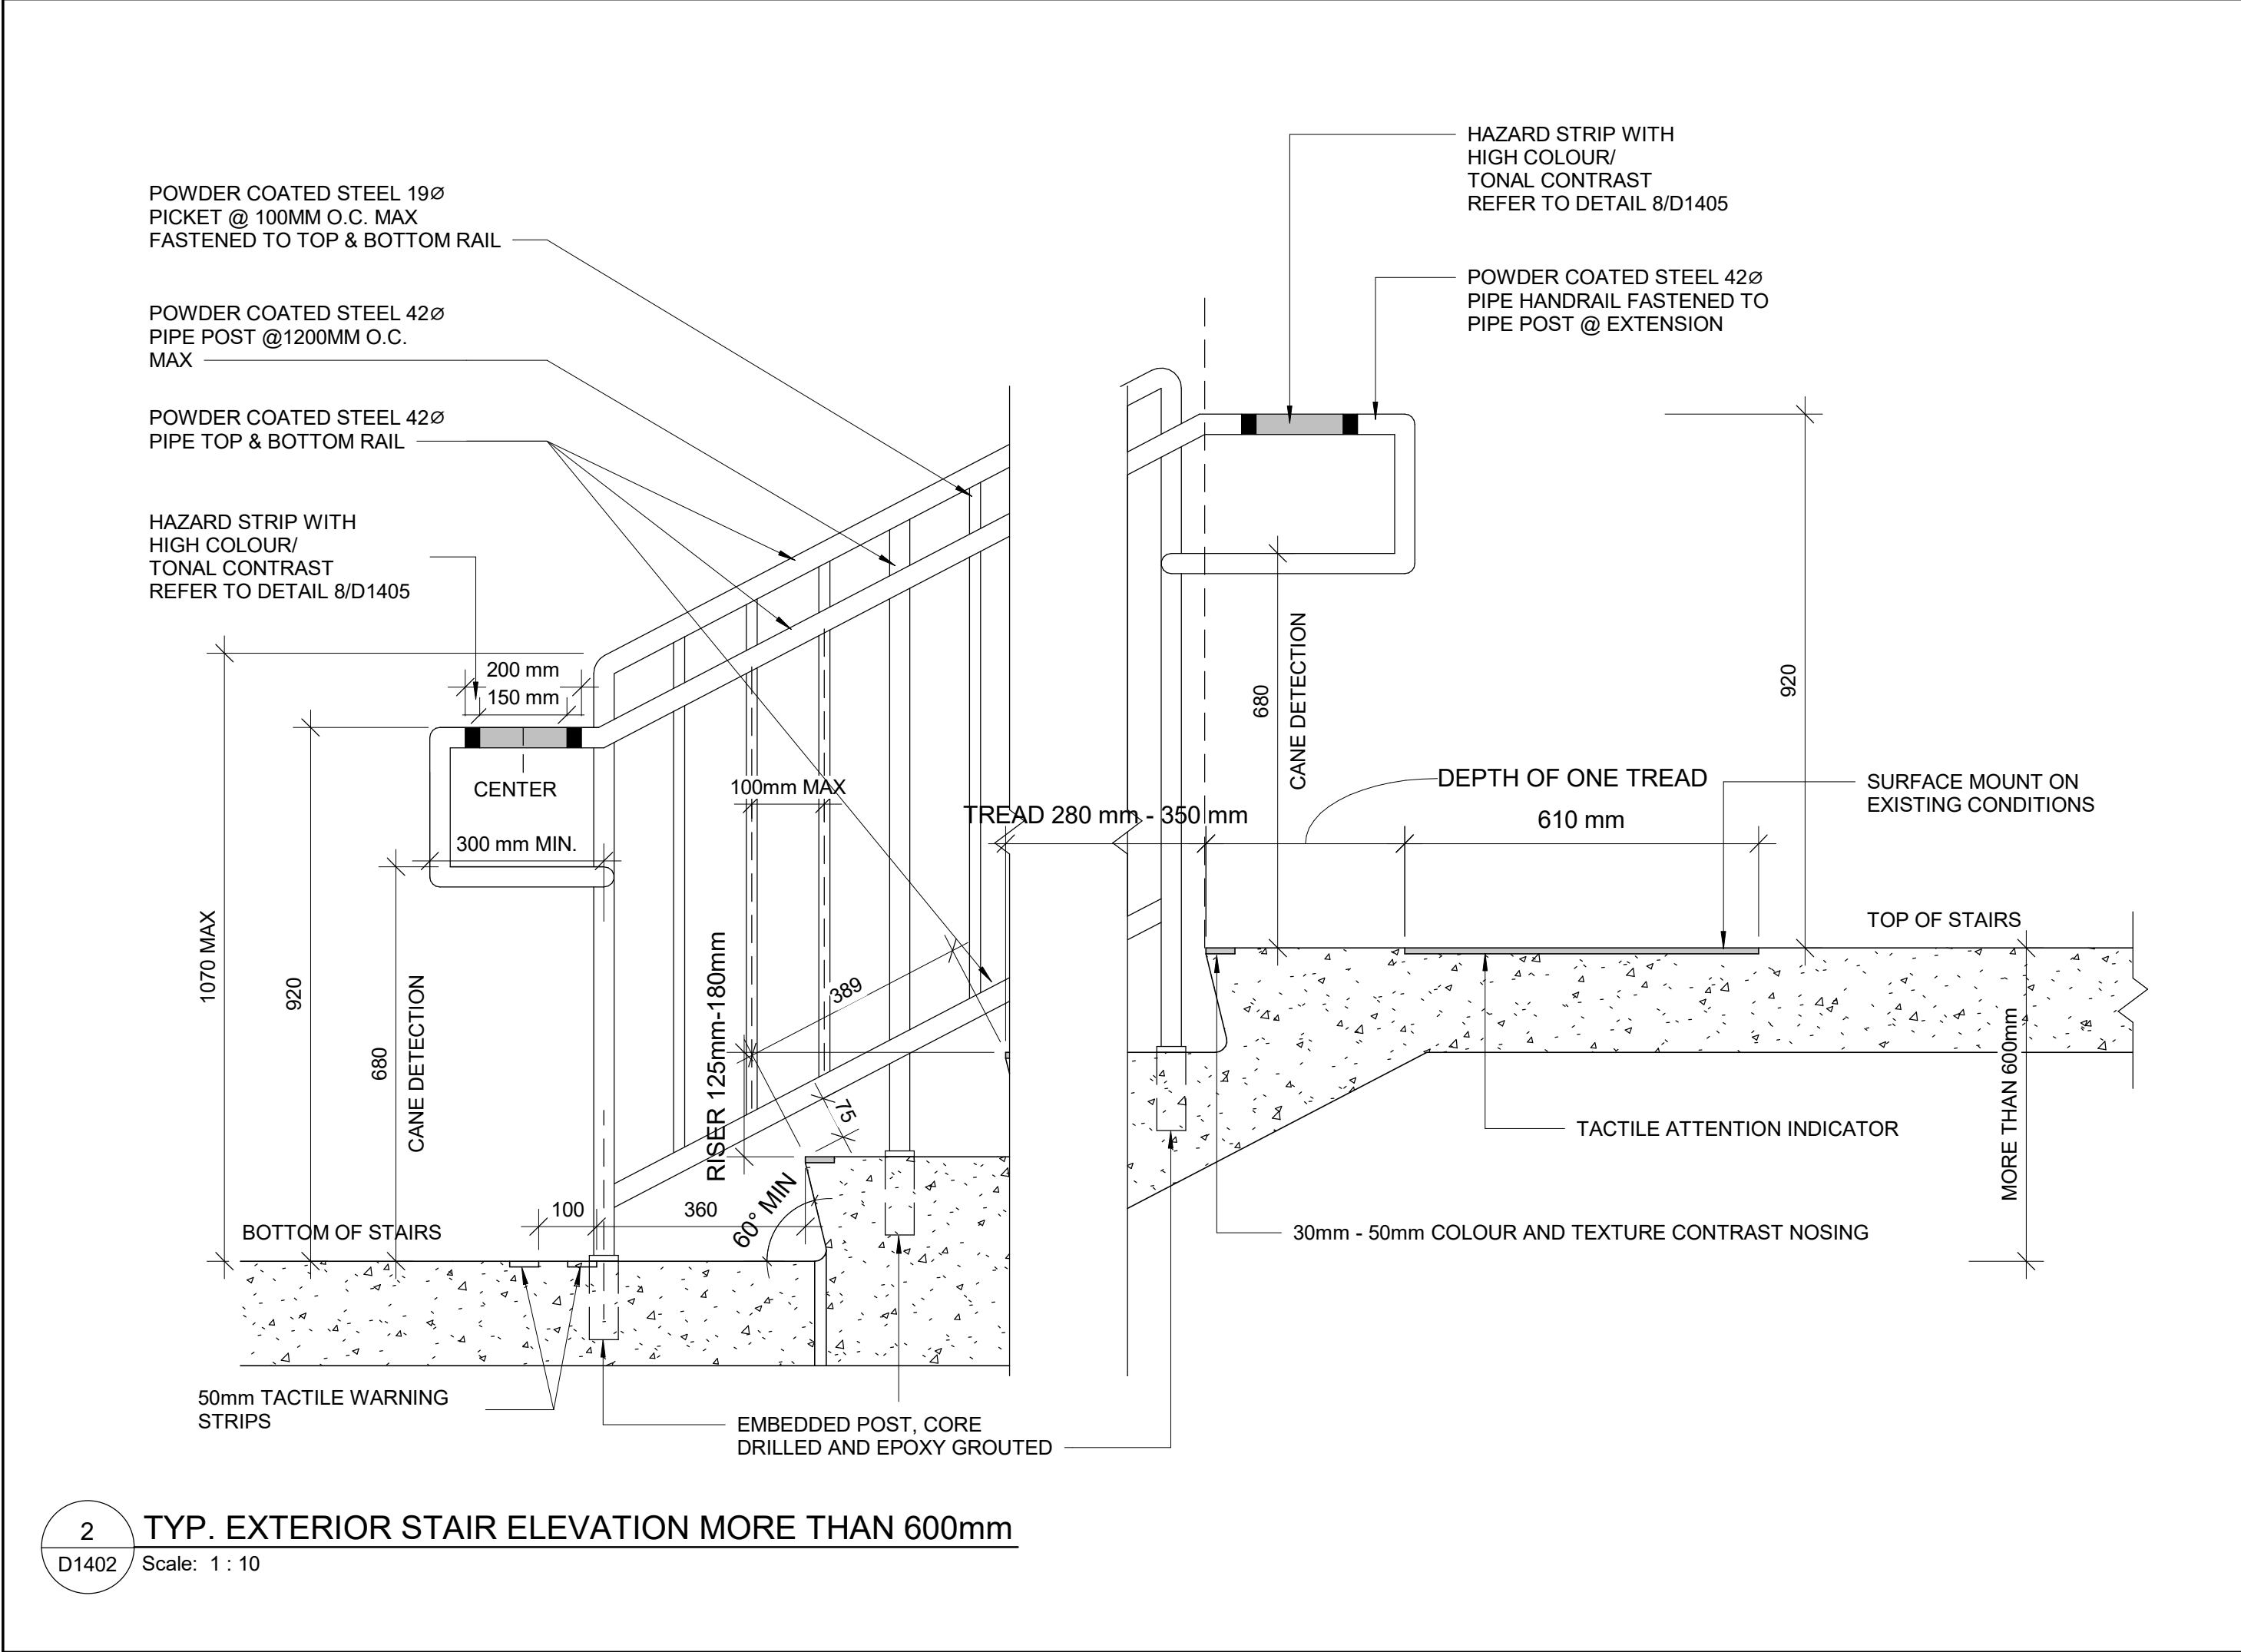
1 TYP. EXTERIOR STAIR PLAN MORE THAN 600mm

D1402 Scale: 1 : 10




3 RAILING ELBOW CONNECTION DETAIL TYP.

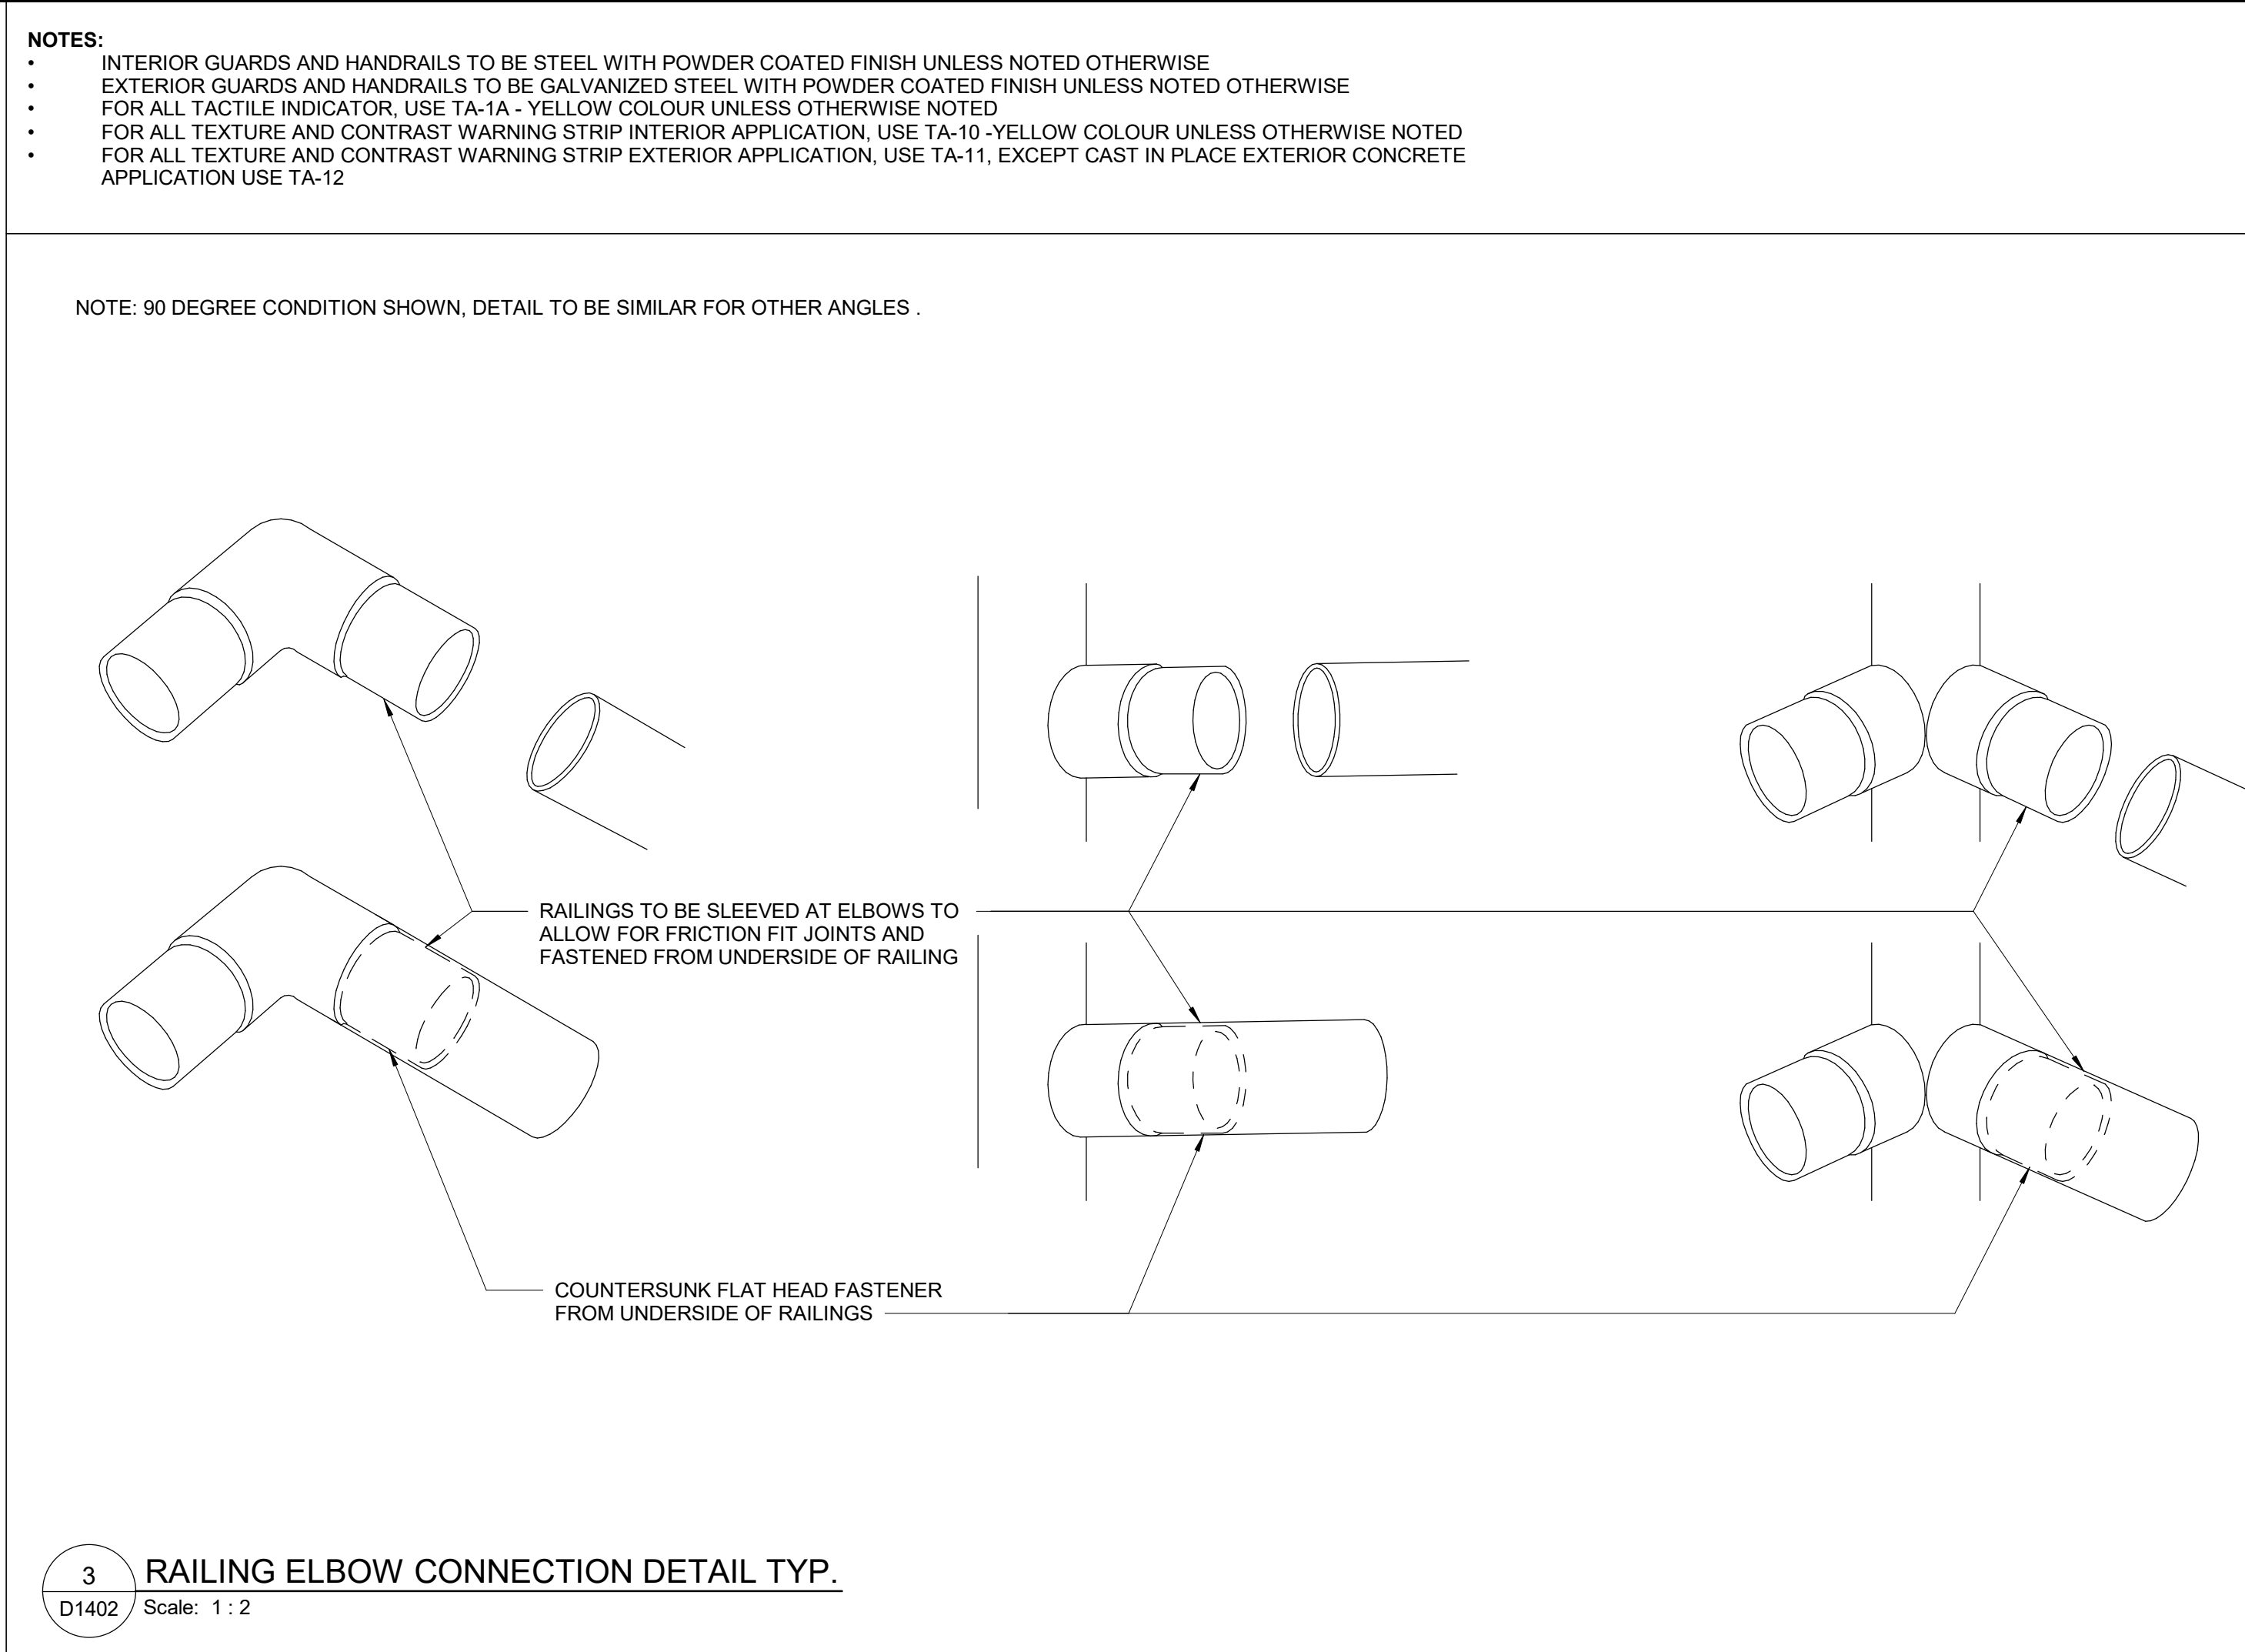D1402 Scale: 1 : 2



2 TYP. EXTERIOR STAIR ELEVATION MORE THAN 600mm

D1402 Scale: 1 : 10

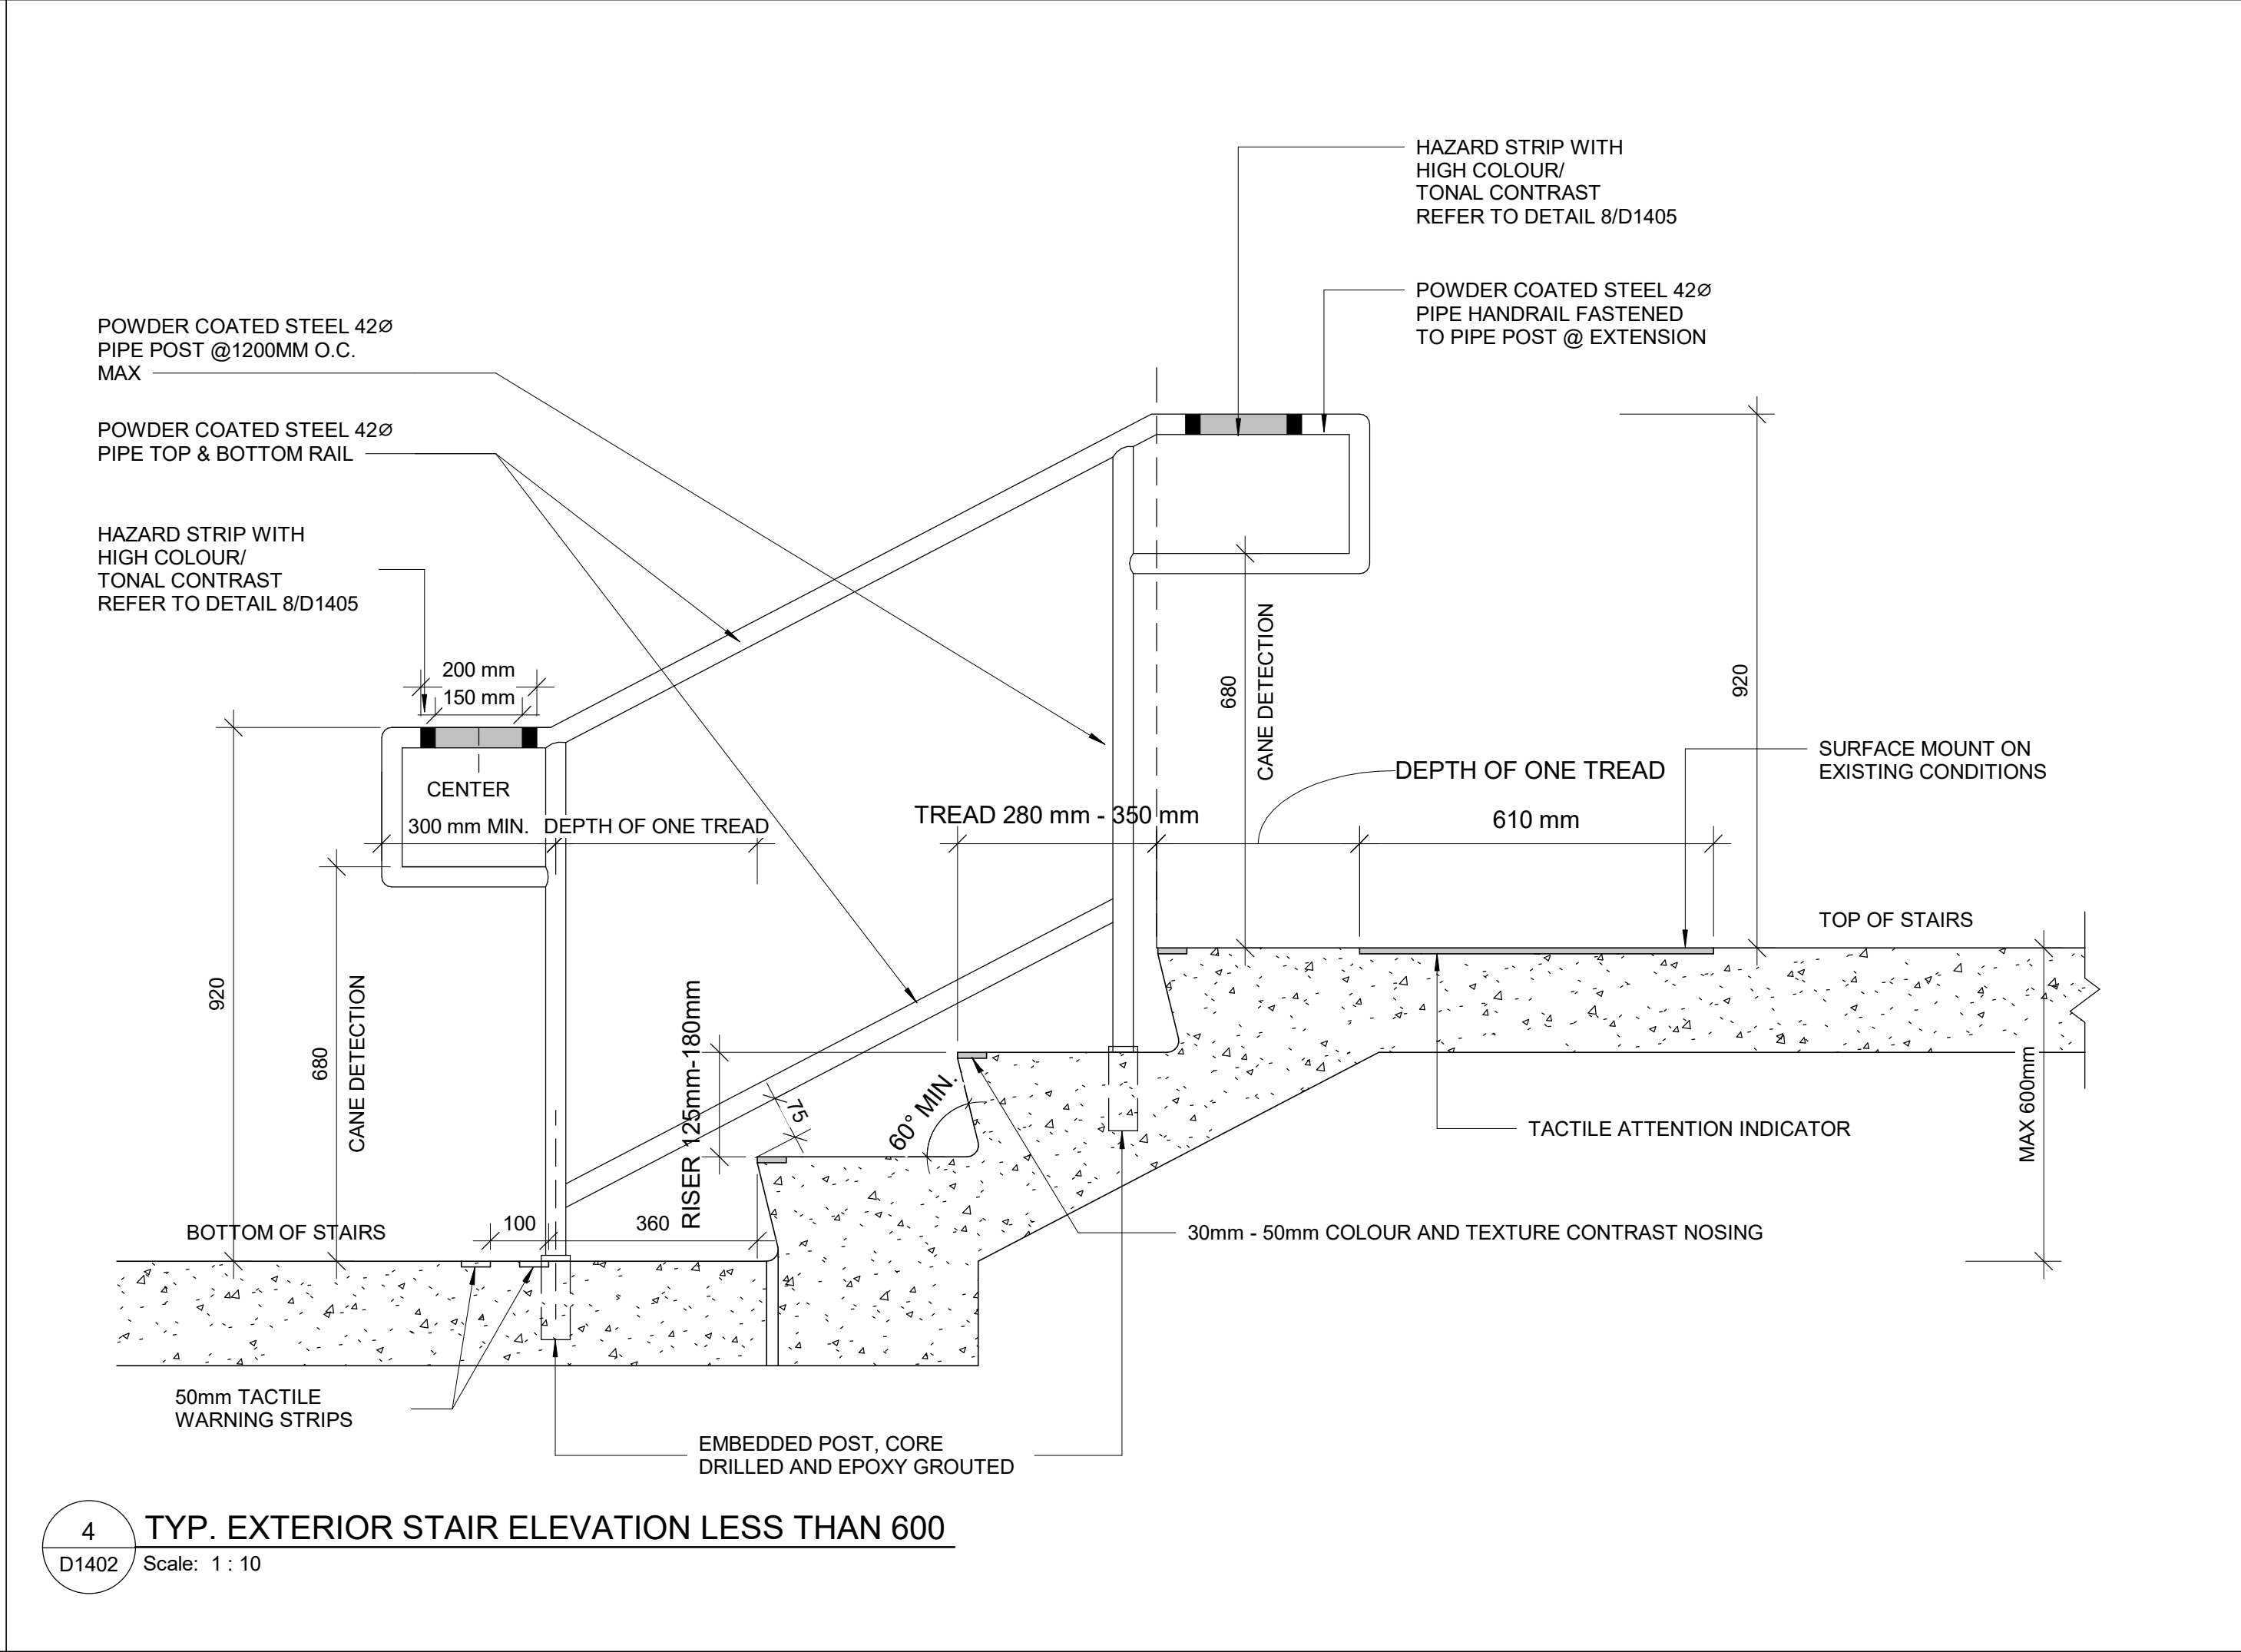

4 TYP. EXTERIOR STAIR ELEVATION LESS THAN 600

D1402 Scale: 1 : 10

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PROJECT TITLE
**CITY OF TORONTO
ACCESSIBILITY UPGRADES**

PROJECT ADDRESS

PROJECT NO:
9119- 19- 0162 / Arcadis 30279056

DRAWN BY: A. BOYNARIAN	CHECKED BY: K. TILAHUN
PROJECT MGR: F. BOLOURIAN	APPROVED BY: E. FENUTA

SHEET TITLE
STAIR DETAILS - 02

SHEET NUMBER D1402	ISSUE A
------------------------------	-------------------

- NOTES:
- INTERIOR GUARDS AND HANDRAILS TO BE STEEL WITH POWDER COATED FINISH UNLESS NOTED OTHERWISE
 - EXTERIOR GUARDS AND HANDRAILS TO BE GALVANIZED STEEL WITH POWDER COATED FINISH UNLESS NOTED OTHERWISE
 - FOR ALL TACTILE INDICATOR, USE TA-1A - YELLOW COLOUR UNLESS OTHERWISE NOTED
 - FOR ALL TEXTURE AND CONTRAST WARNING STRIP INTERIOR APPLICATION, USE TA-10 -YELLOW COLOUR UNLESS OTHERWISE NOTED
 - FOR ALL TEXTURE AND CONTRAST WARNING STRIP EXTERIOR APPLICATION, USE TA-11, EXCEPT CAST IN PLACE EXTERIOR CONCRETE APPLICATION USE TA-12

CLIENT


CITY OF TORONTO


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Project Management Office
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MSV 3C6


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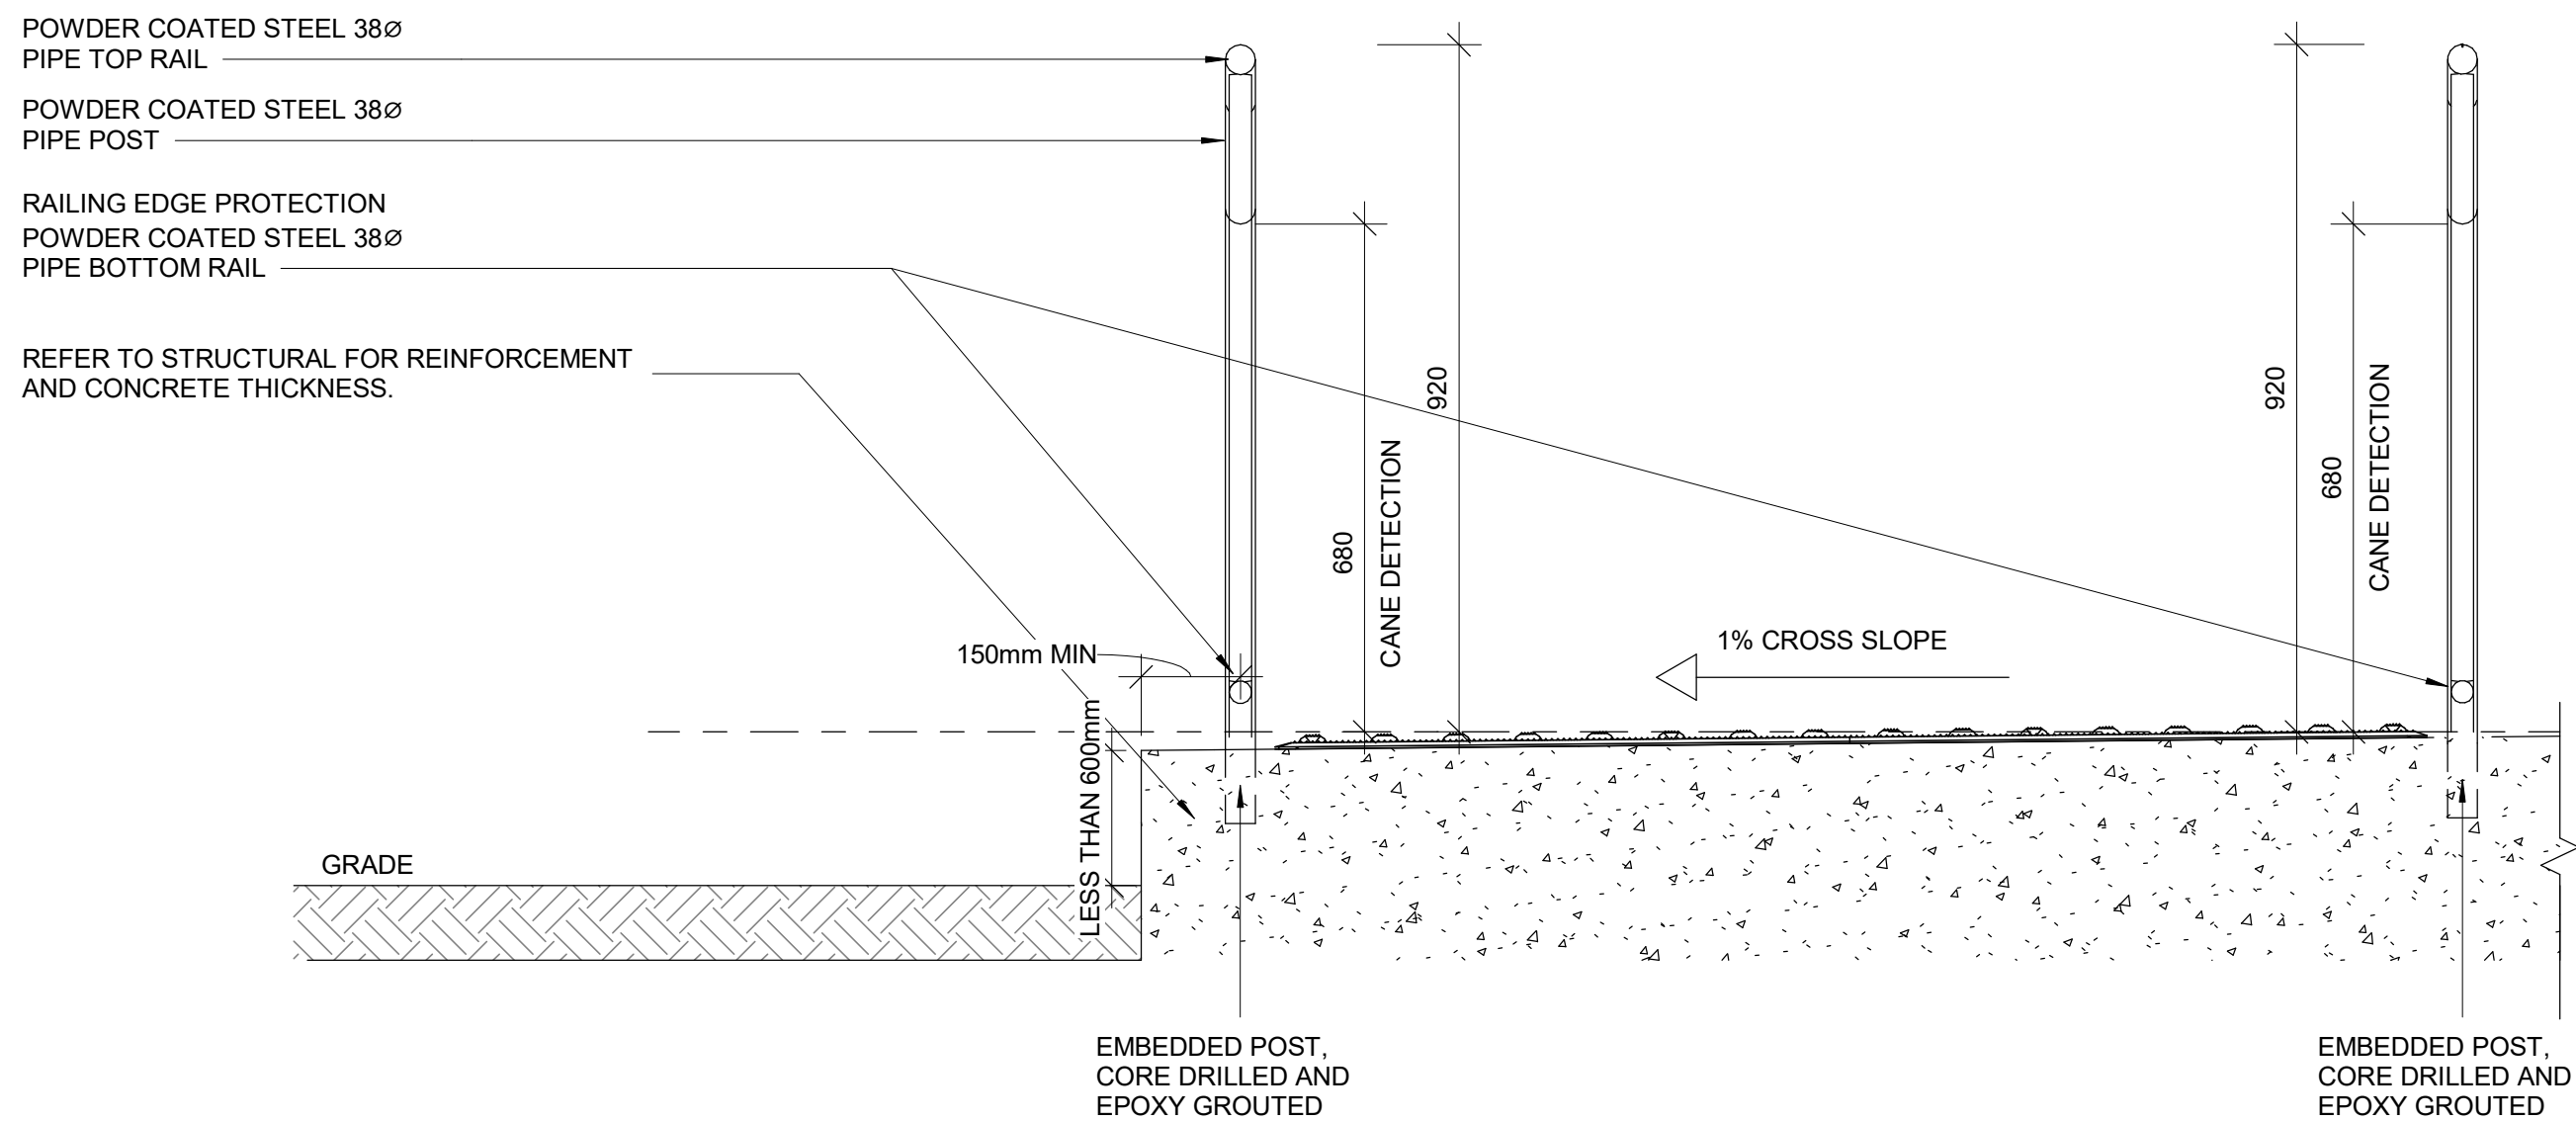
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No.	DESCRIPTION	DATE
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1 TYP. GUARDRAIL CONNECTION DETAIL AT STEEL STRINGER
D1403 Scale: 1 : 10



2 ELEVATION OF GUARDRAIL FOR RAMP AT GRADE DIFFERENCE LESS THAN 600 MM
D1403 Scale: 1 : 10

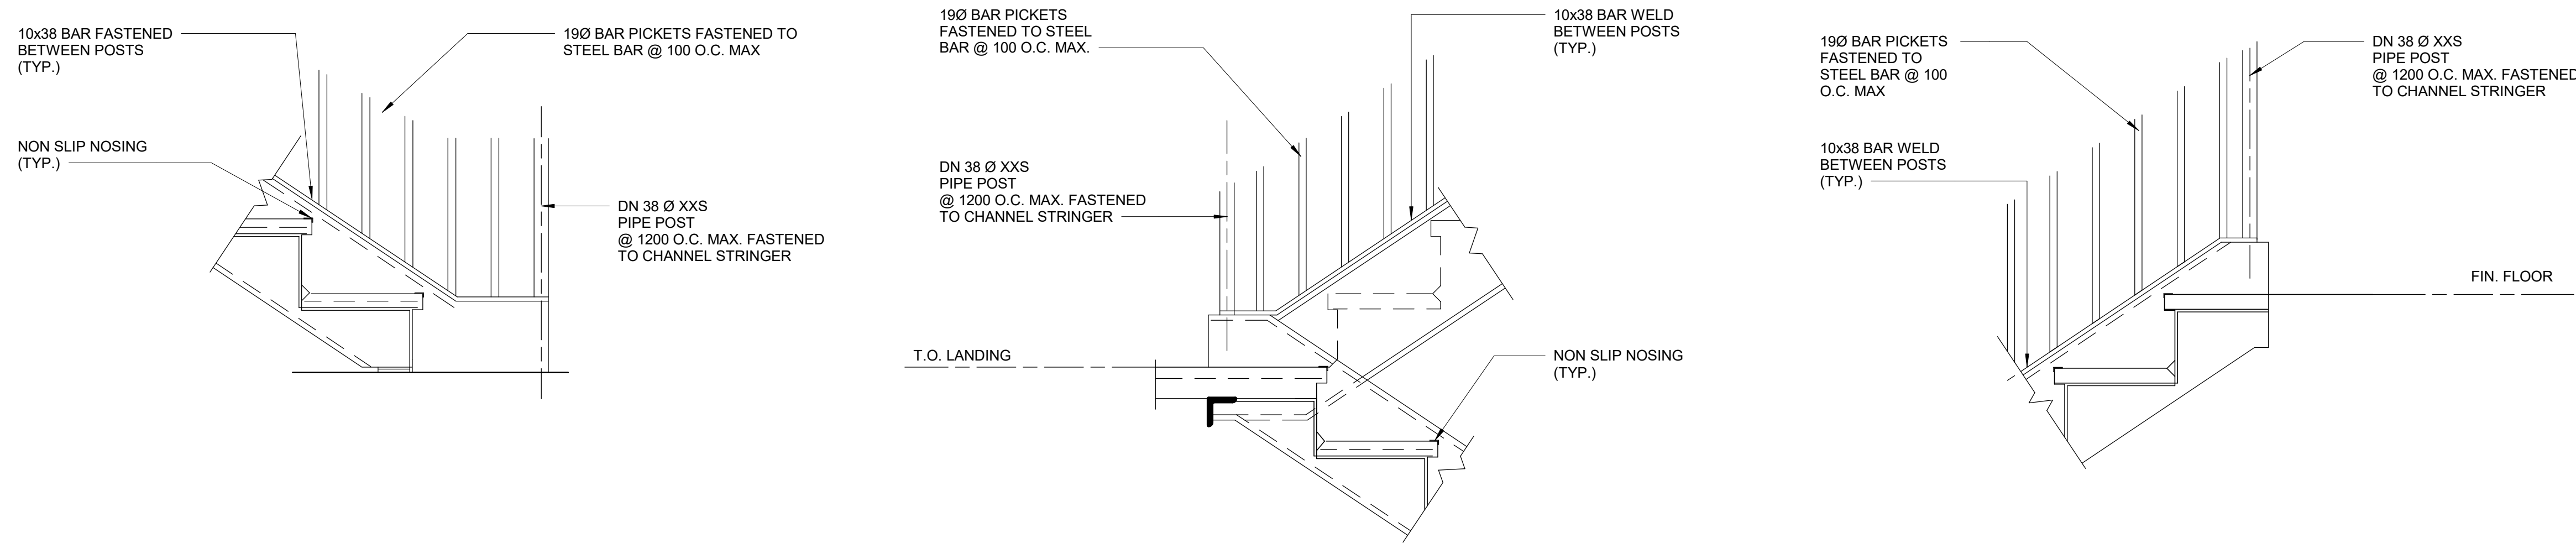

3 SECTION OF GUARDRAIL FOR RAMP AT GRADE DIFFERENCE LESS THAN 600 MM
D1403 Scale: 1 : 10
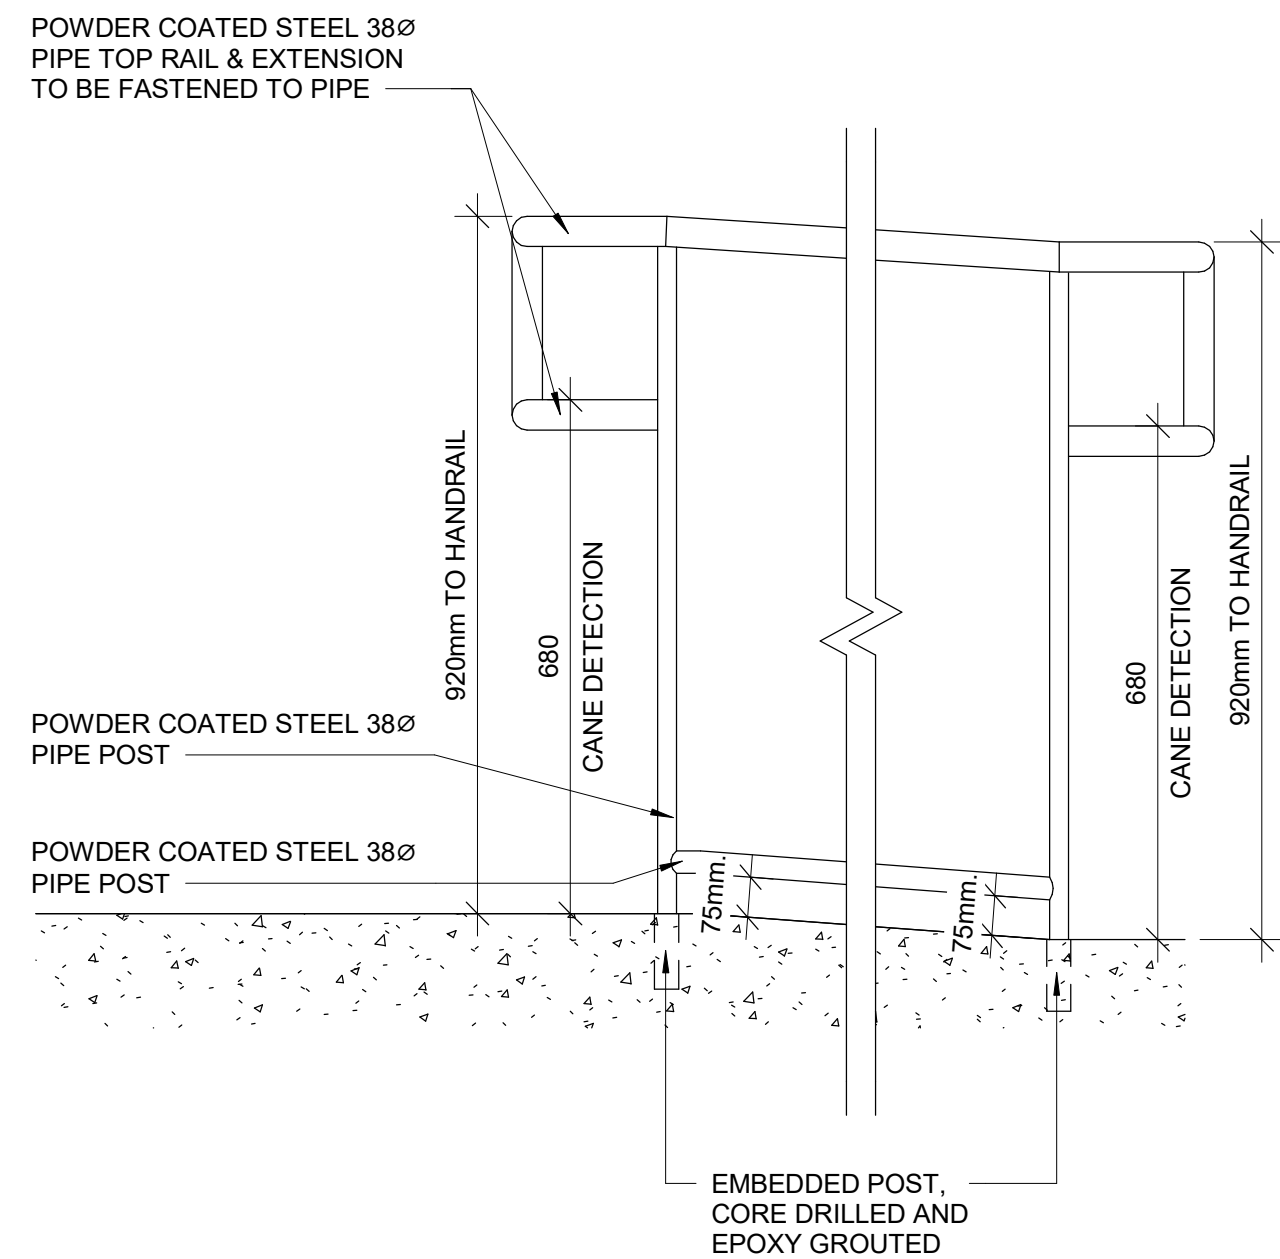
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PROJECT TITLE
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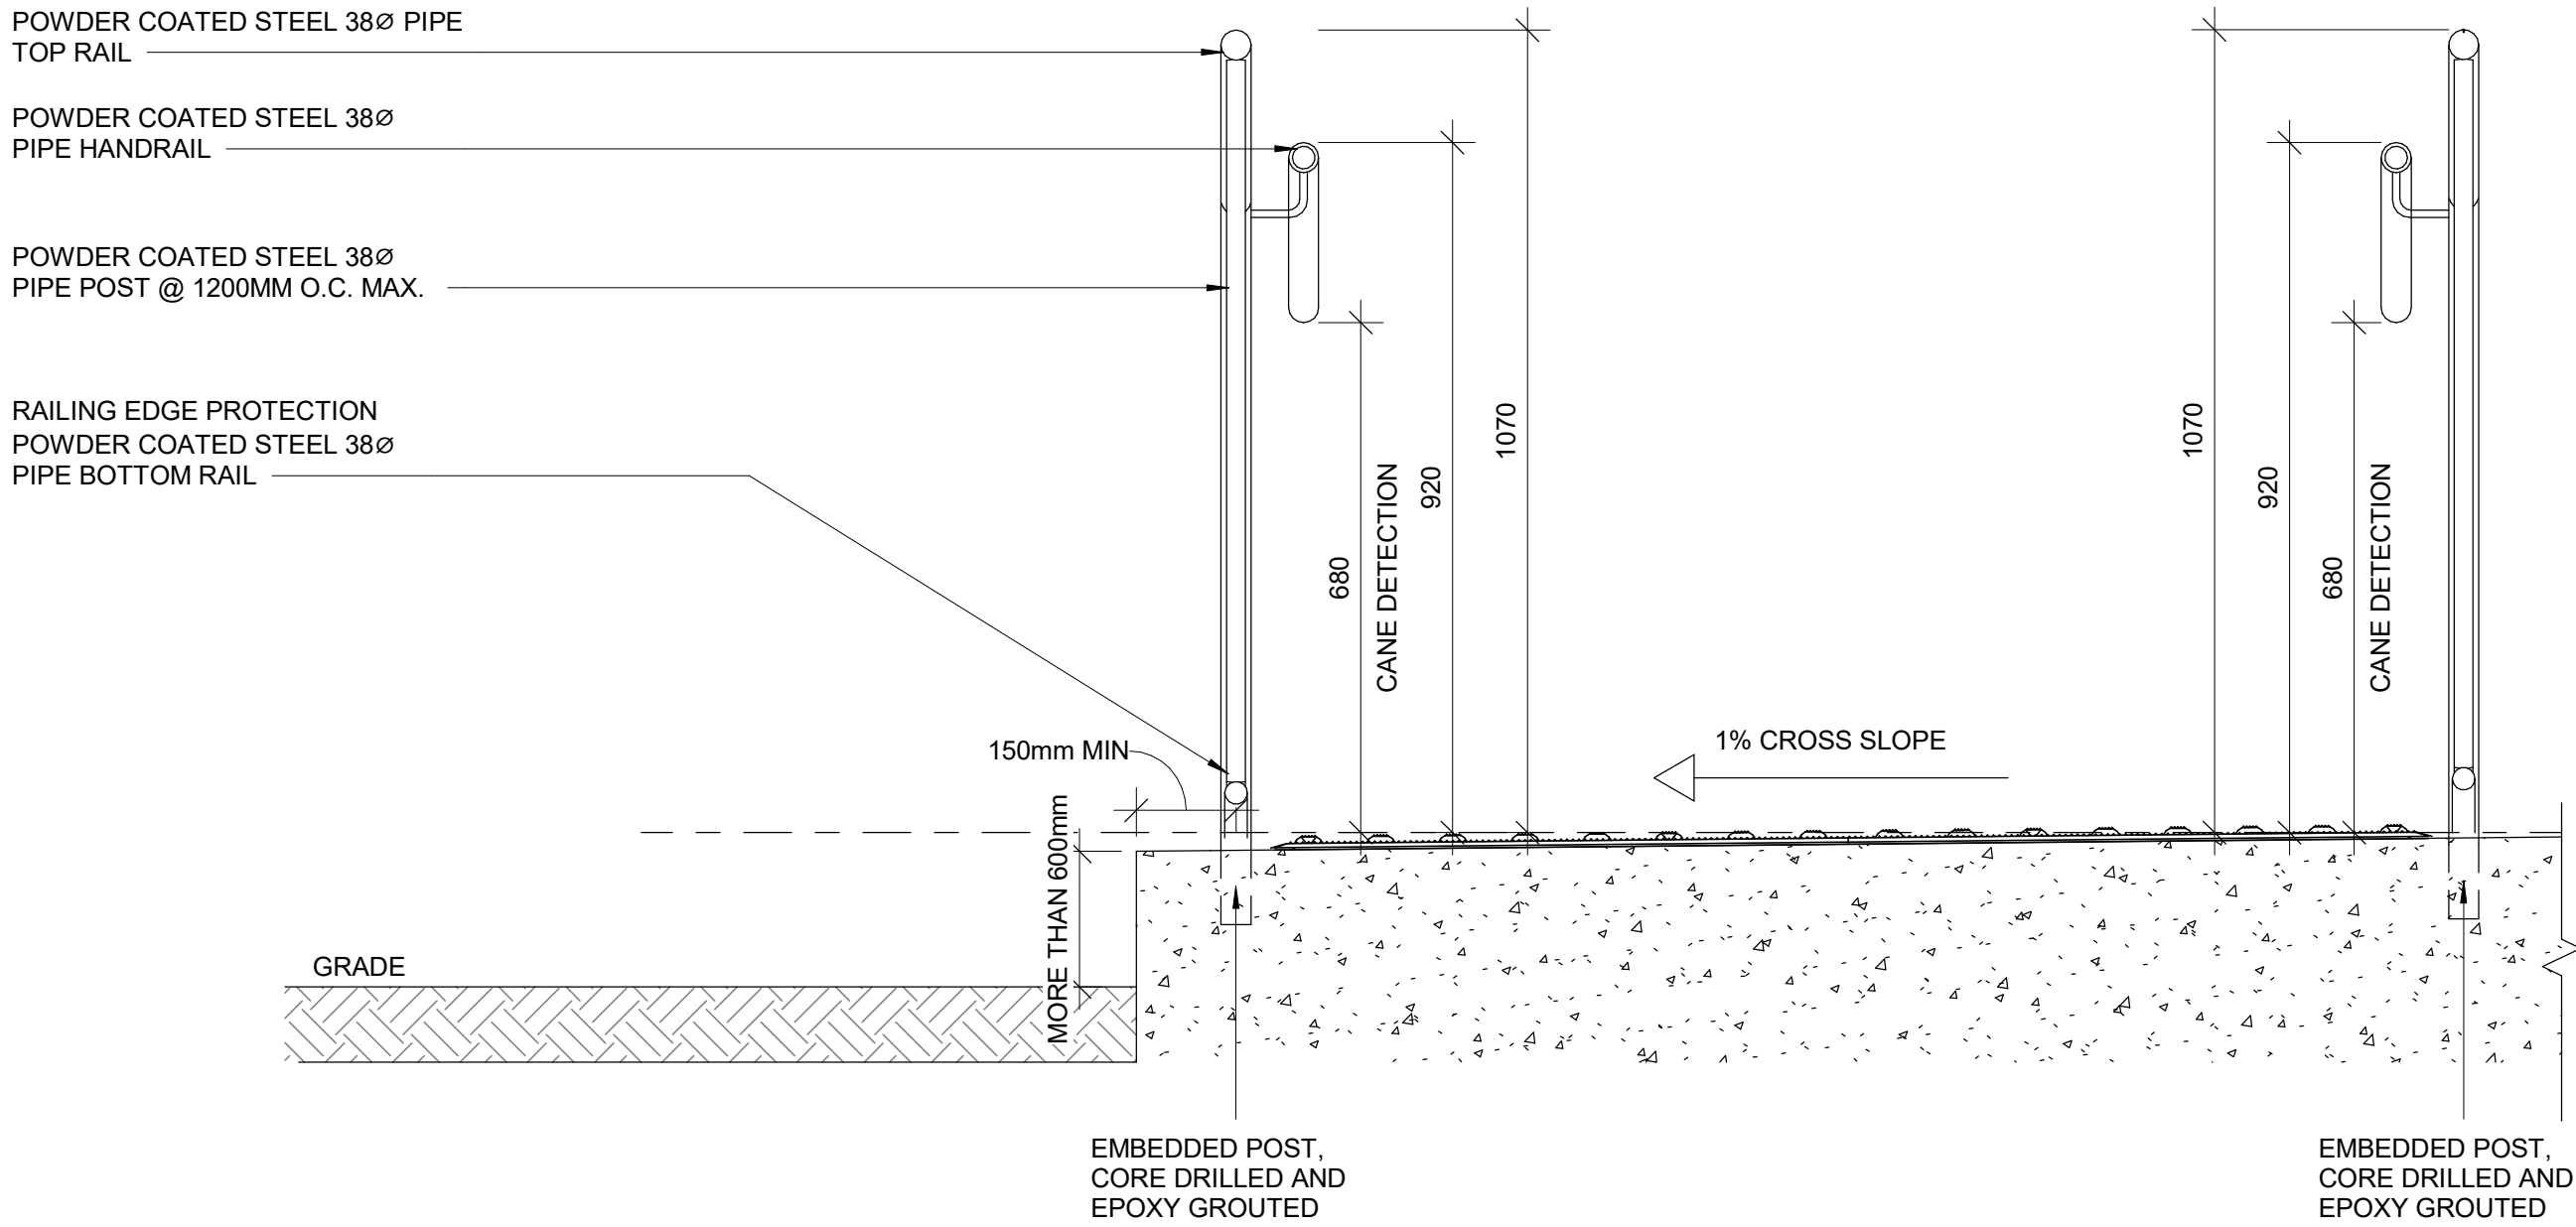
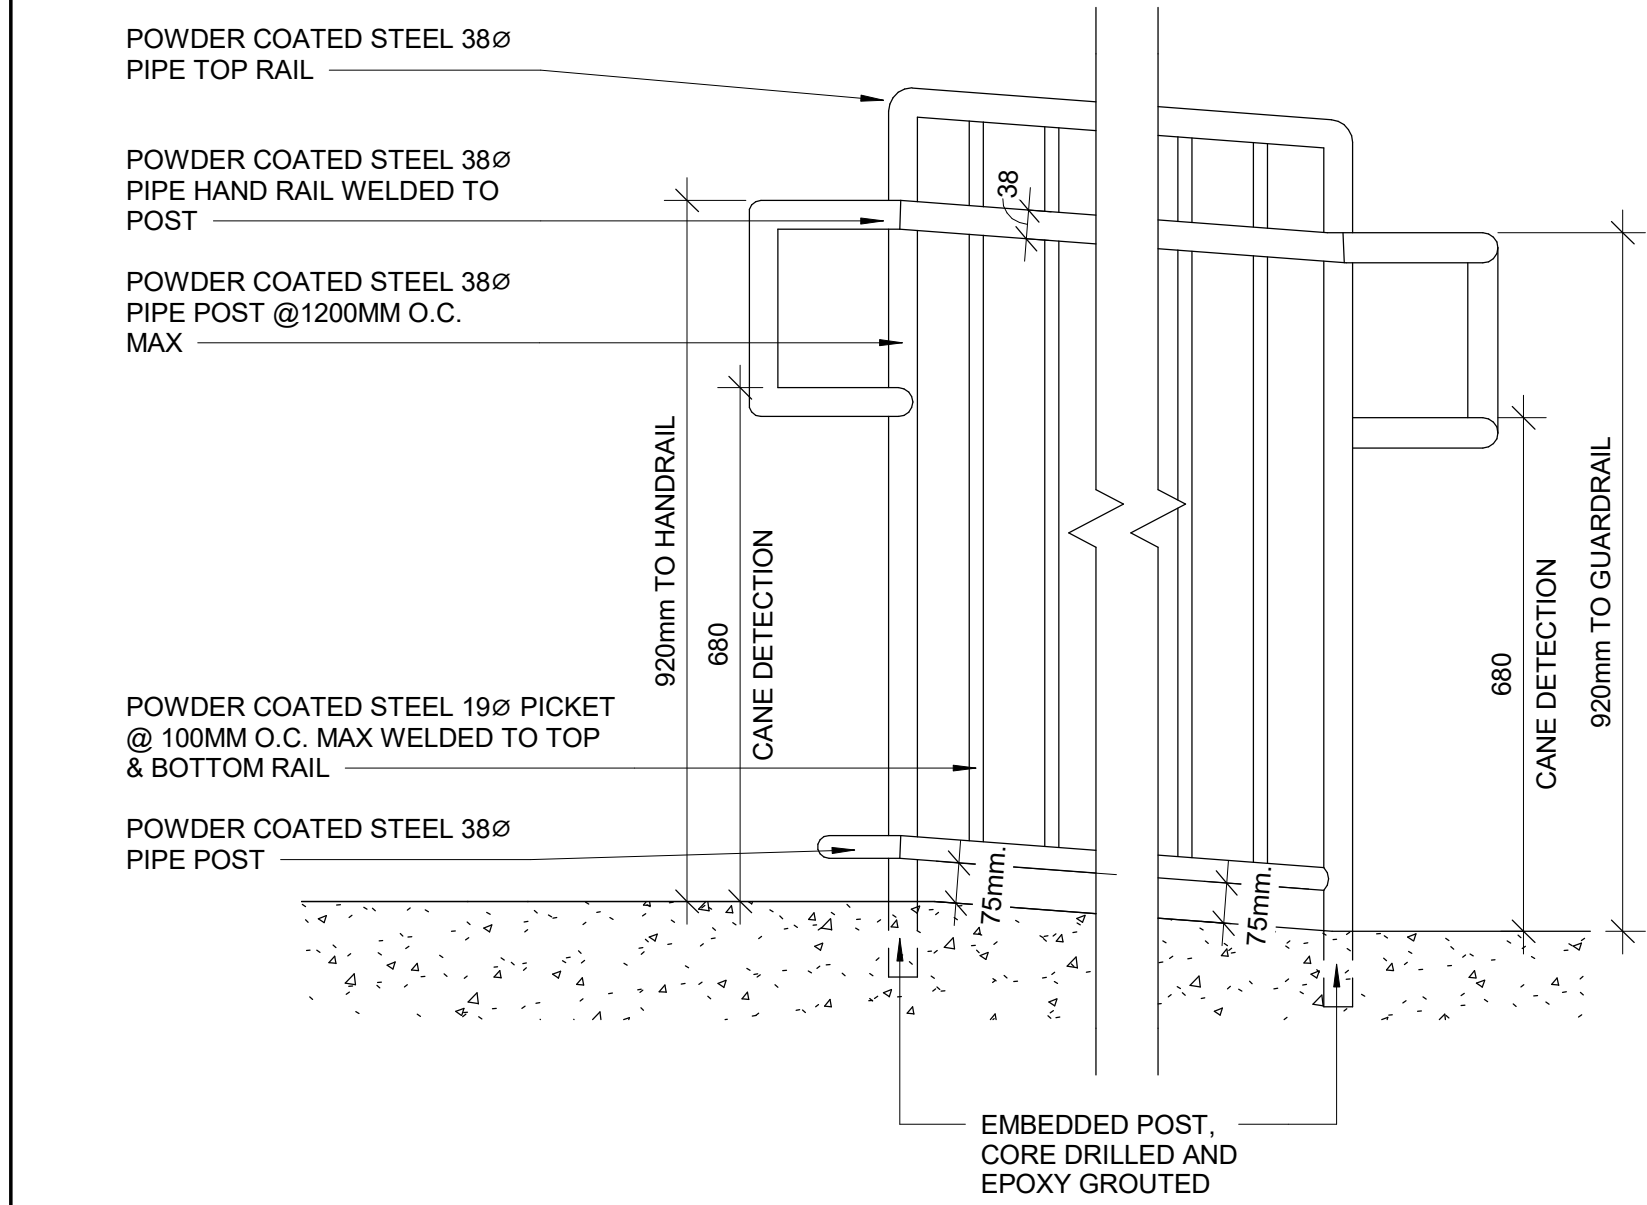
PROJECT NO:
9119- 19- 0162 / Arcadis 30279056

DRAWN BY: A. BOYNARIAN	CHECKED BY: K. TILAHUN
PROJECT MGR: F. BOLOURIAN	APPROVED BY: E. FENUTA

SHEET TITLE
RAMP DETAILS - 01

SHEET NUMBER D1403	ISSUE A
------------------------------	-------------------

- NOTES:
- INTERIOR GUARDS AND HANDRAILS TO BE STEEL WITH POWDER COATED FINISH UNLESS NOTED OTHERWISE
 - EXTERIOR GUARDS AND HANDRAILS TO BE GALVANIZED STEEL WITH POWDER COATED FINISH UNLESS NOTED OTHERWISE
 - FOR ALL TACTILE INDICATOR, USE TA-1A - YELLOW COLOUR UNLESS OTHERWISE NOTED
 - FOR ALL TEXTURE AND CONTRAST WARNING STRIP INTERIOR APPLICATION, USE TA-10 -YELLOW COLOUR UNLESS OTHERWISE NOTED
 - FOR ALL TEXTURE AND CONTRAST WARNING STRIP EXTERIOR APPLICATION, USE TA-11, EXCEPT CAST IN PLACE EXTERIOR CONCRETE APPLICATION USE TA-12



1 ELEVATION OF GUARDRAIL FOR RAMP AT GRADE DIFFERENCE MORE THAN 600 MM
D1404 Scale: 1 : 10

2 SECTION OF GUARDRAIL FOR RAMP AT GRADE DIFFERENCE MORE THAN 600 MM
D1404 Scale: 1 : 10

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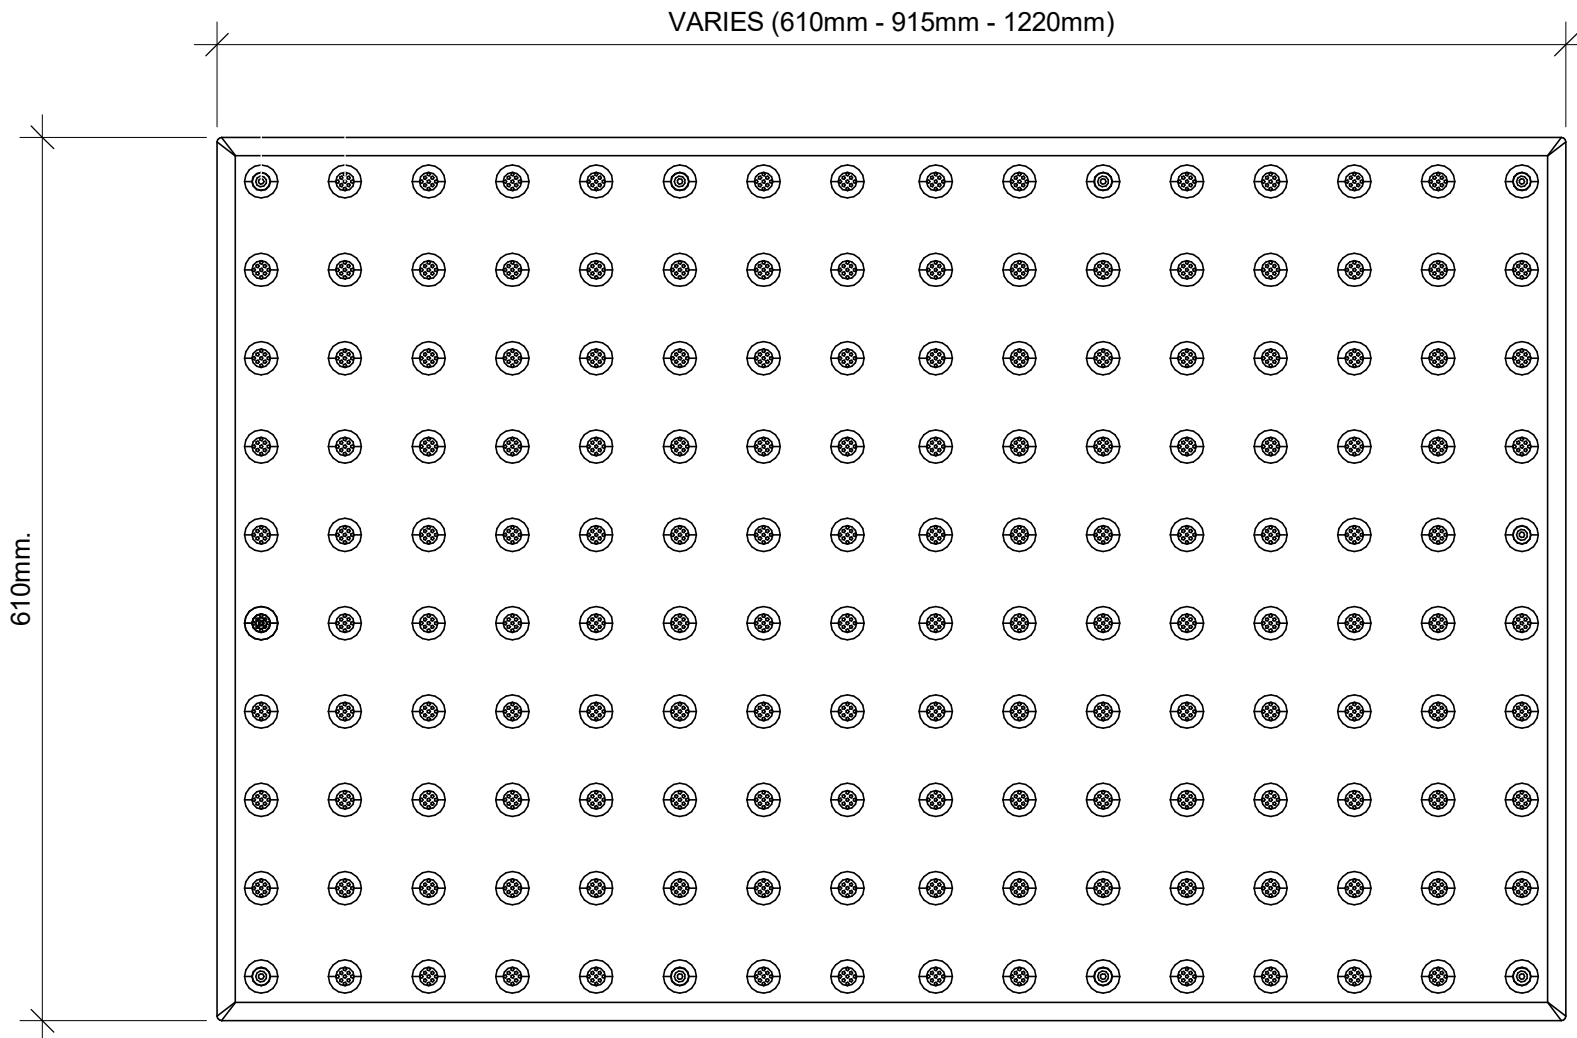
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SHEET TITLE
RAMP DETAILS - 02


SHEET NUMBER D1404	ISSUE A
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TA - 1a
EXTERIOR AND INTERIOR APPLICATION



1 TACTILE ATTENTION INDICATOR
D1405 / Scale: 1 : 5

TA-8
INTERIOR APPLICATION

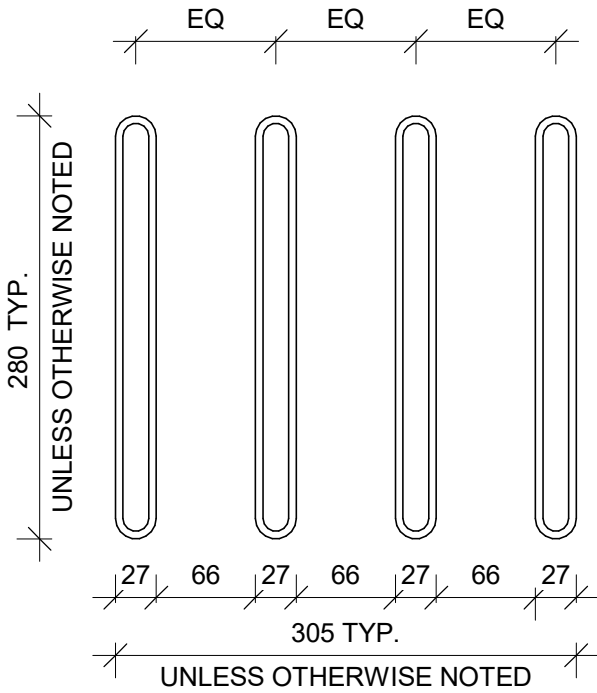


2 GUIDANCE BARS PLAN
D1405 / Scale: 1 : 5

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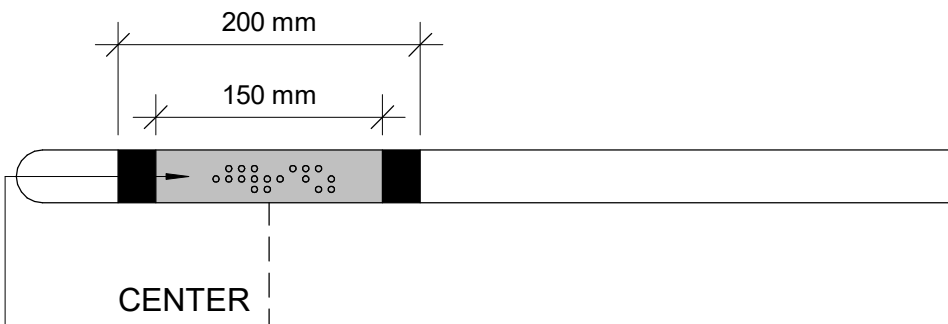
150mm LONG YELLOW COLOUR
WAYFINDING SIGN WITH BRAILLE AND
25mm WIDE RED COLOUR ON EITHER
SIDE OF THE SIGN

BRAILLE INDICATES FLOOR
LEVEL AND NUMBER ON TOP
OF RAILING. SEE 10/D1405

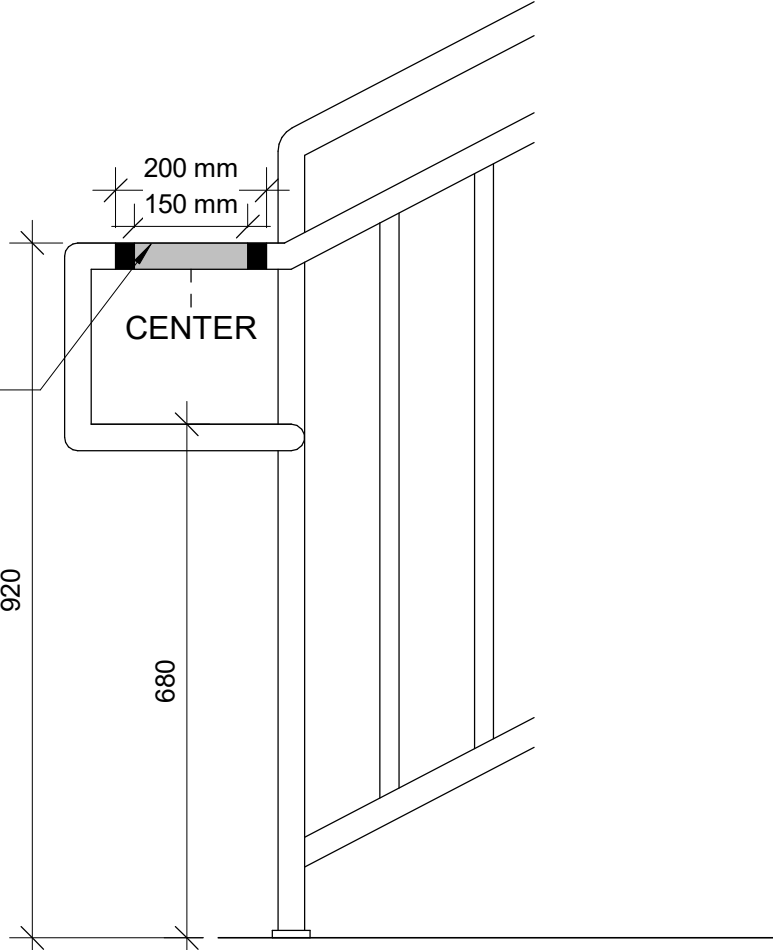

8 HANDRAIL WARNING STRIP
D1405 / Scale: 1 : 10

150mm LONG YELLOW COLOUR
WAYFINDING SIGN WITH BRAILLE AND
25mm WIDE RED COLOUR ON EITHER
SIDE OF THE SIGN



BRAILLE INDICATES FLOOR
LEVEL AND NUMBER ON TOP
OF RAILING.

10 HANDRAIL HAZARD STRIP PLAN
D1405 / Scale: 1 : 5

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PROJECT NO:
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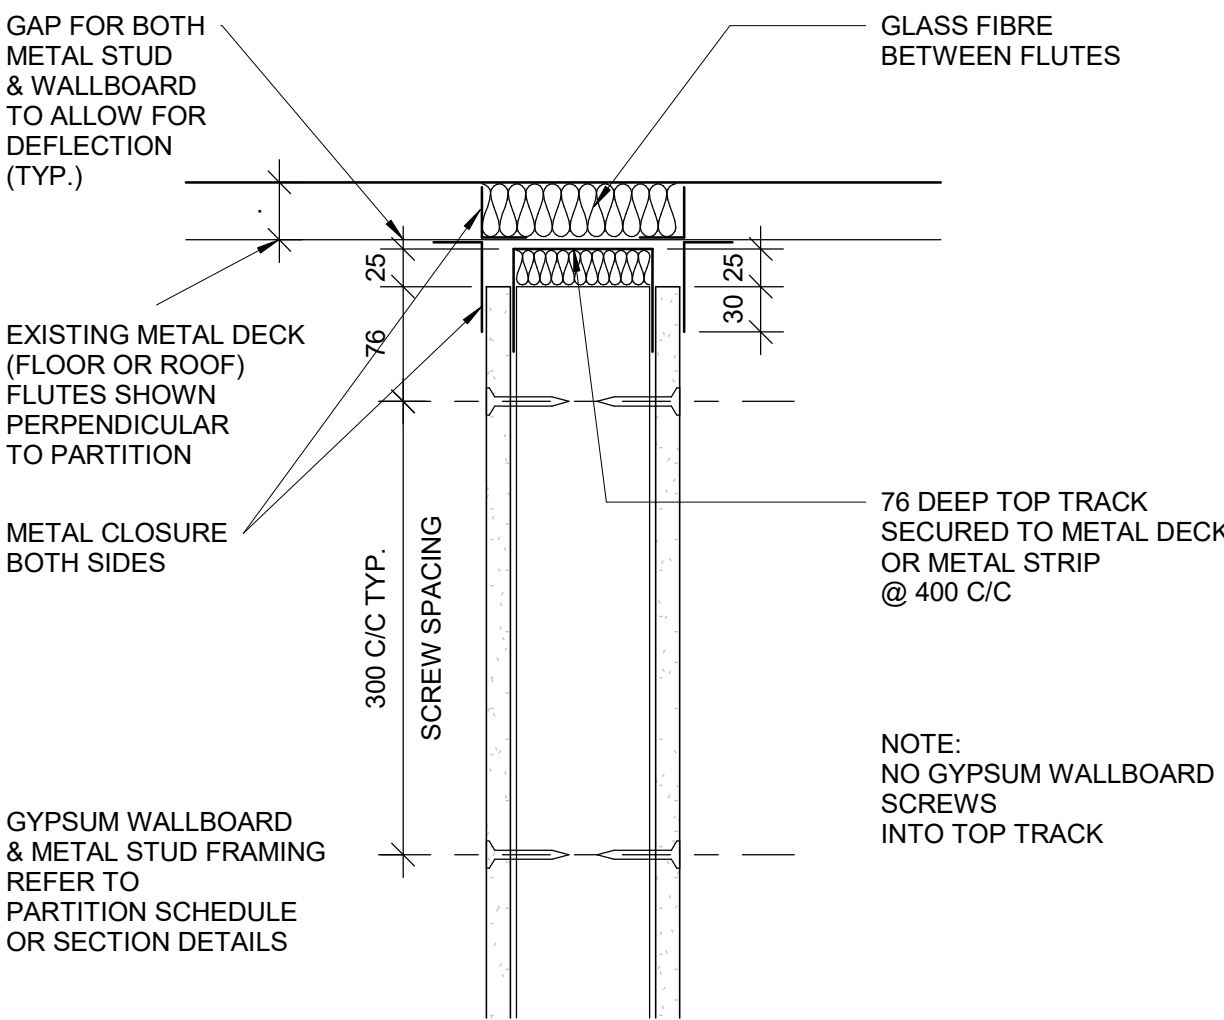
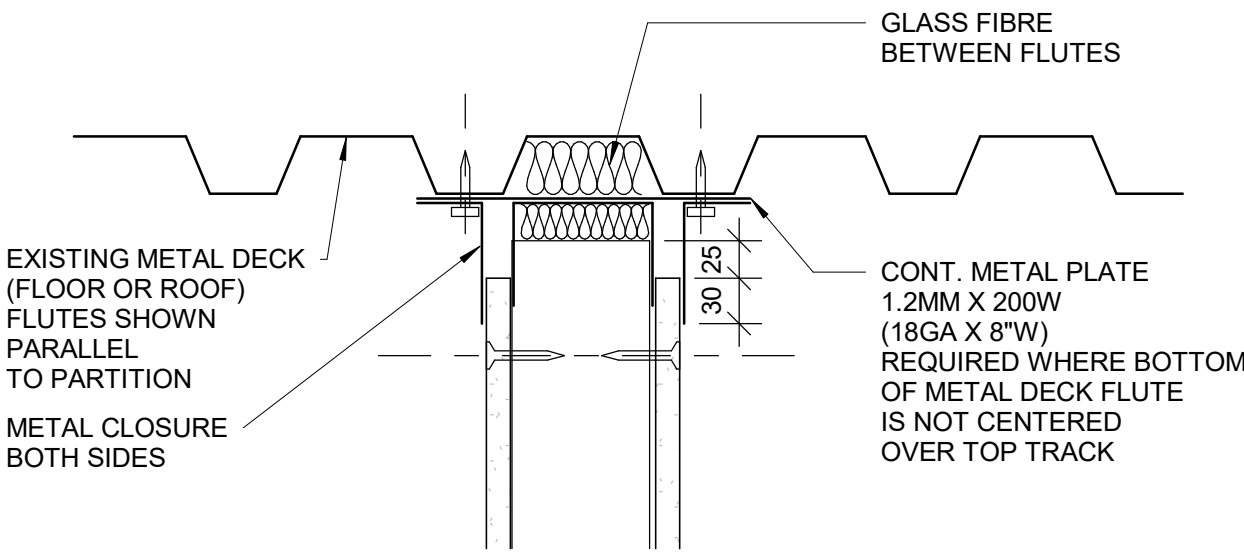
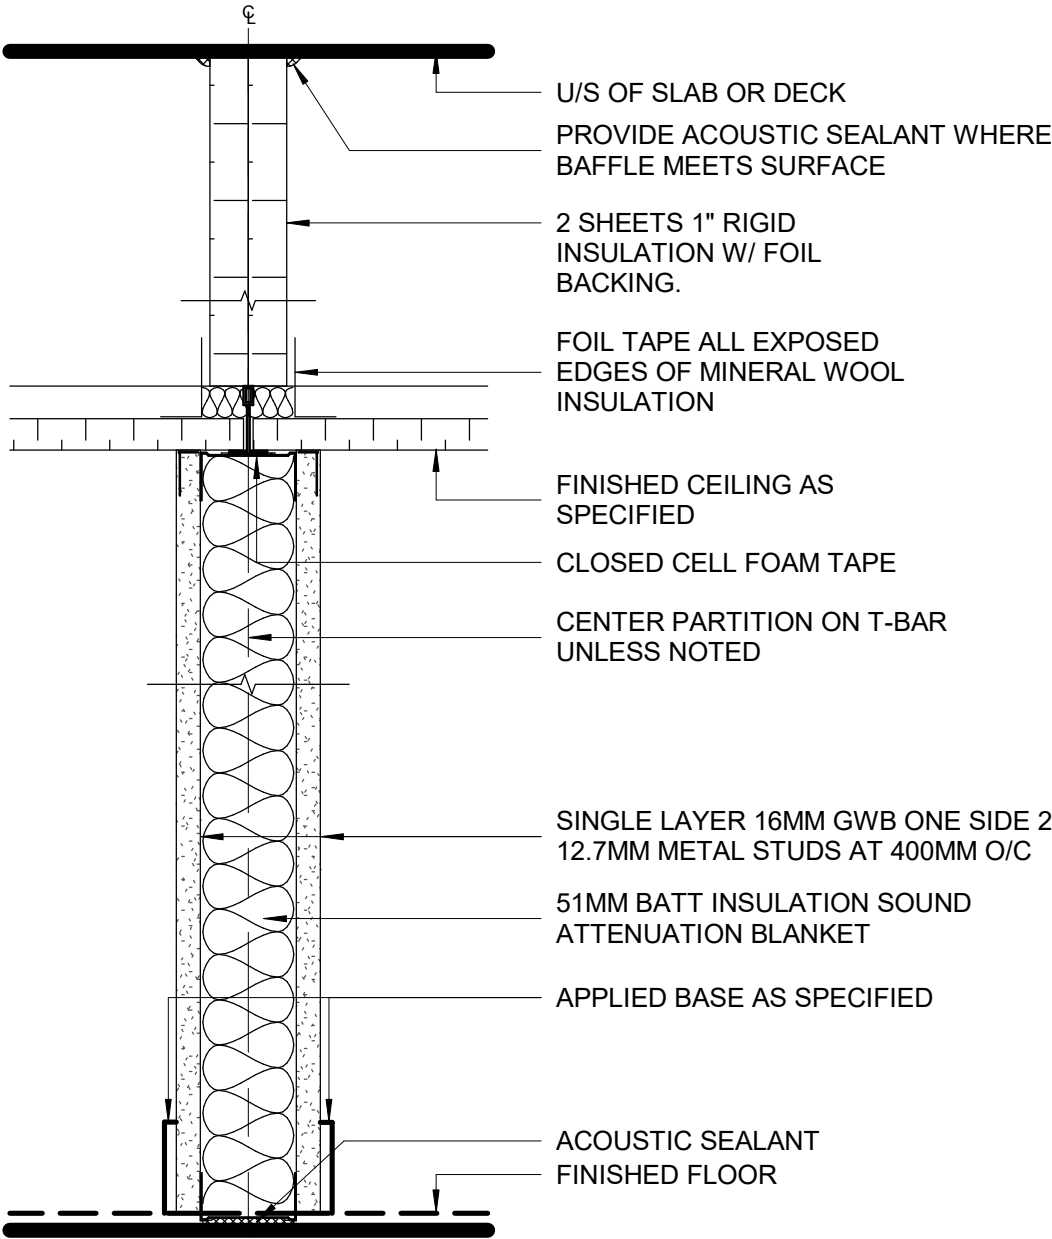
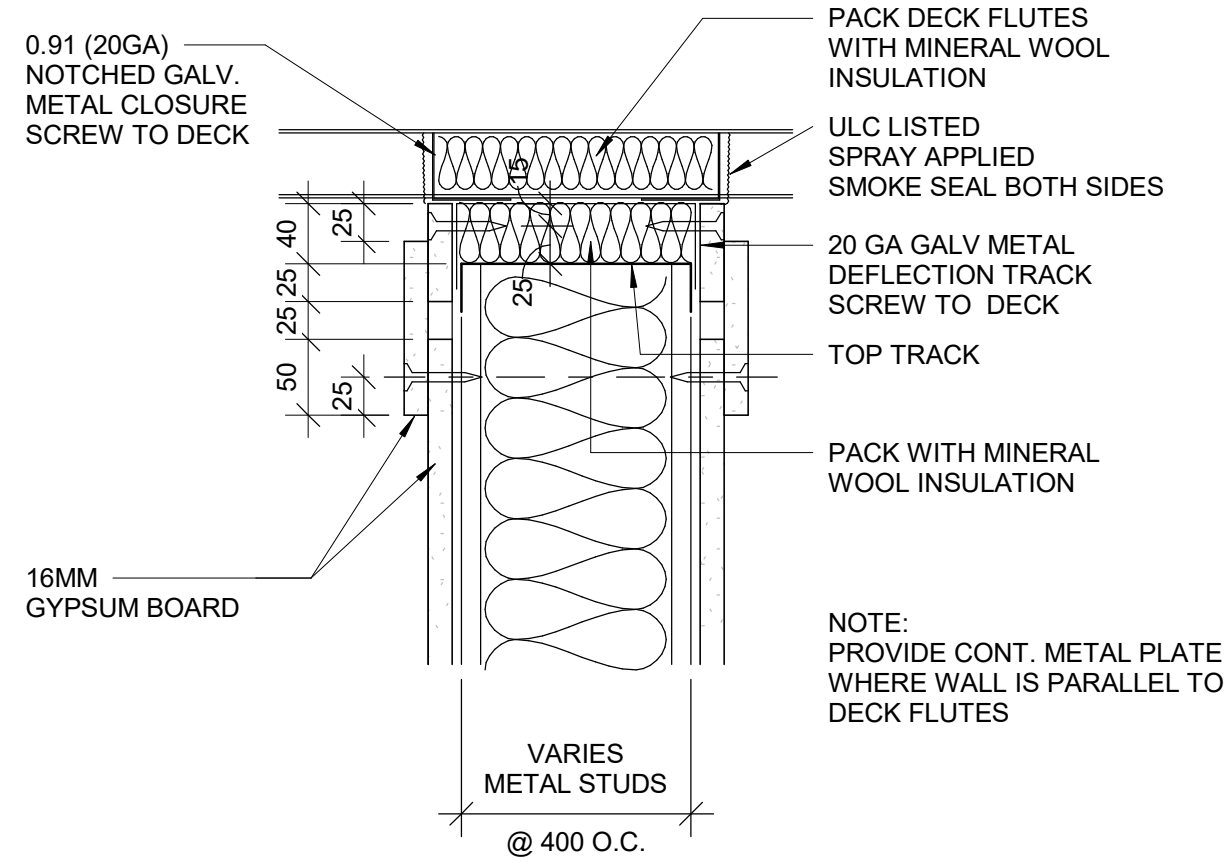
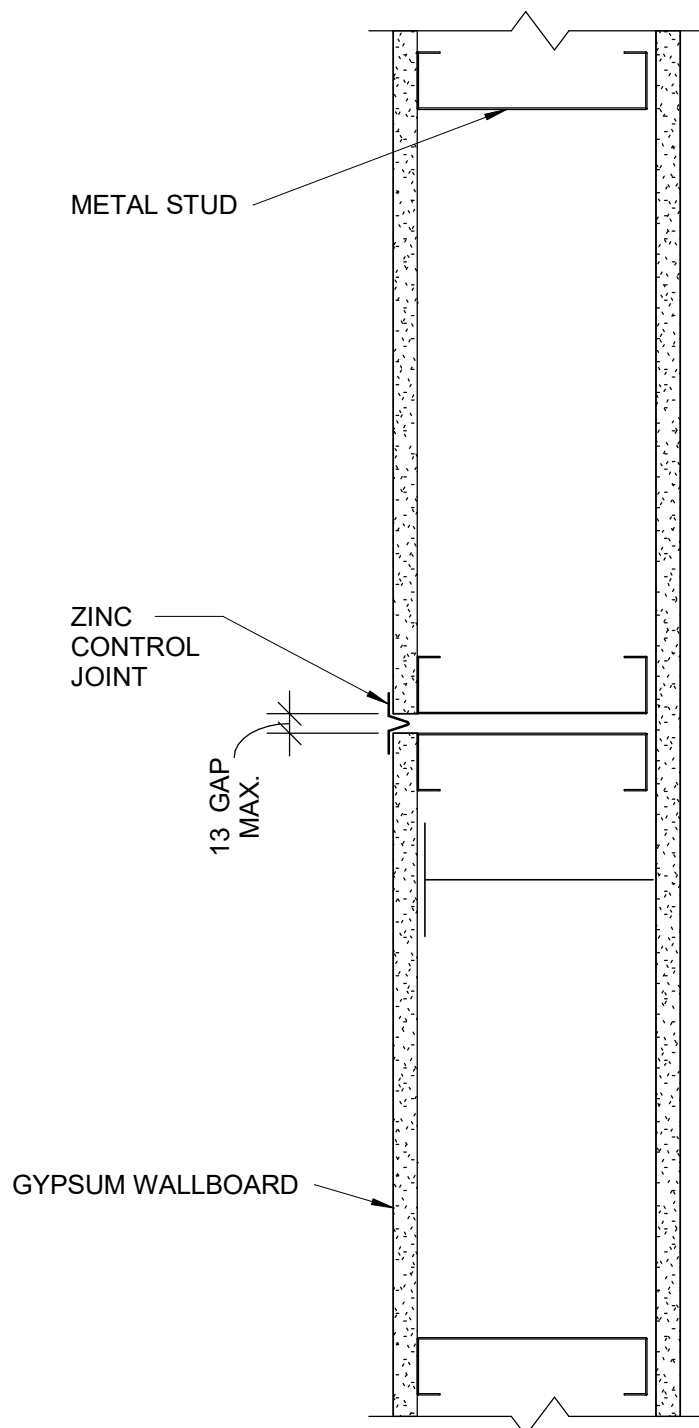
PROJECT MGR:
F. BOLOURIAN

APPROVED BY:
E. FENUTA

SHEET TITLE
TACTILE DETAILS

SHEET NUMBER
D1405

ISSUE
A



1 CONTROL JOINT PLAN DETAIL - DRYWALL

D1501 Scale: 1 : 5

3 HEAD DRYWALL FIRE RATED PARTITION

D1501 Scale: 1 : 5

5 DRYWALL - ACOUSTICAL TREATMENT ABOVE CEILING

D1501 Scale: 1 : 5

4 HEAD FULL HEIGHT DRYWALL PARTITION - NON RATED

D1501 Scale: 1 : 5

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PROJECT MGR: F. BOLOURIAN	APPROVED BY: E. FENUTA


SHEET TITLE

MISCELLANEOUS
DETAILS - 01


SHEET NUMBER	ISSUE
D1501	A

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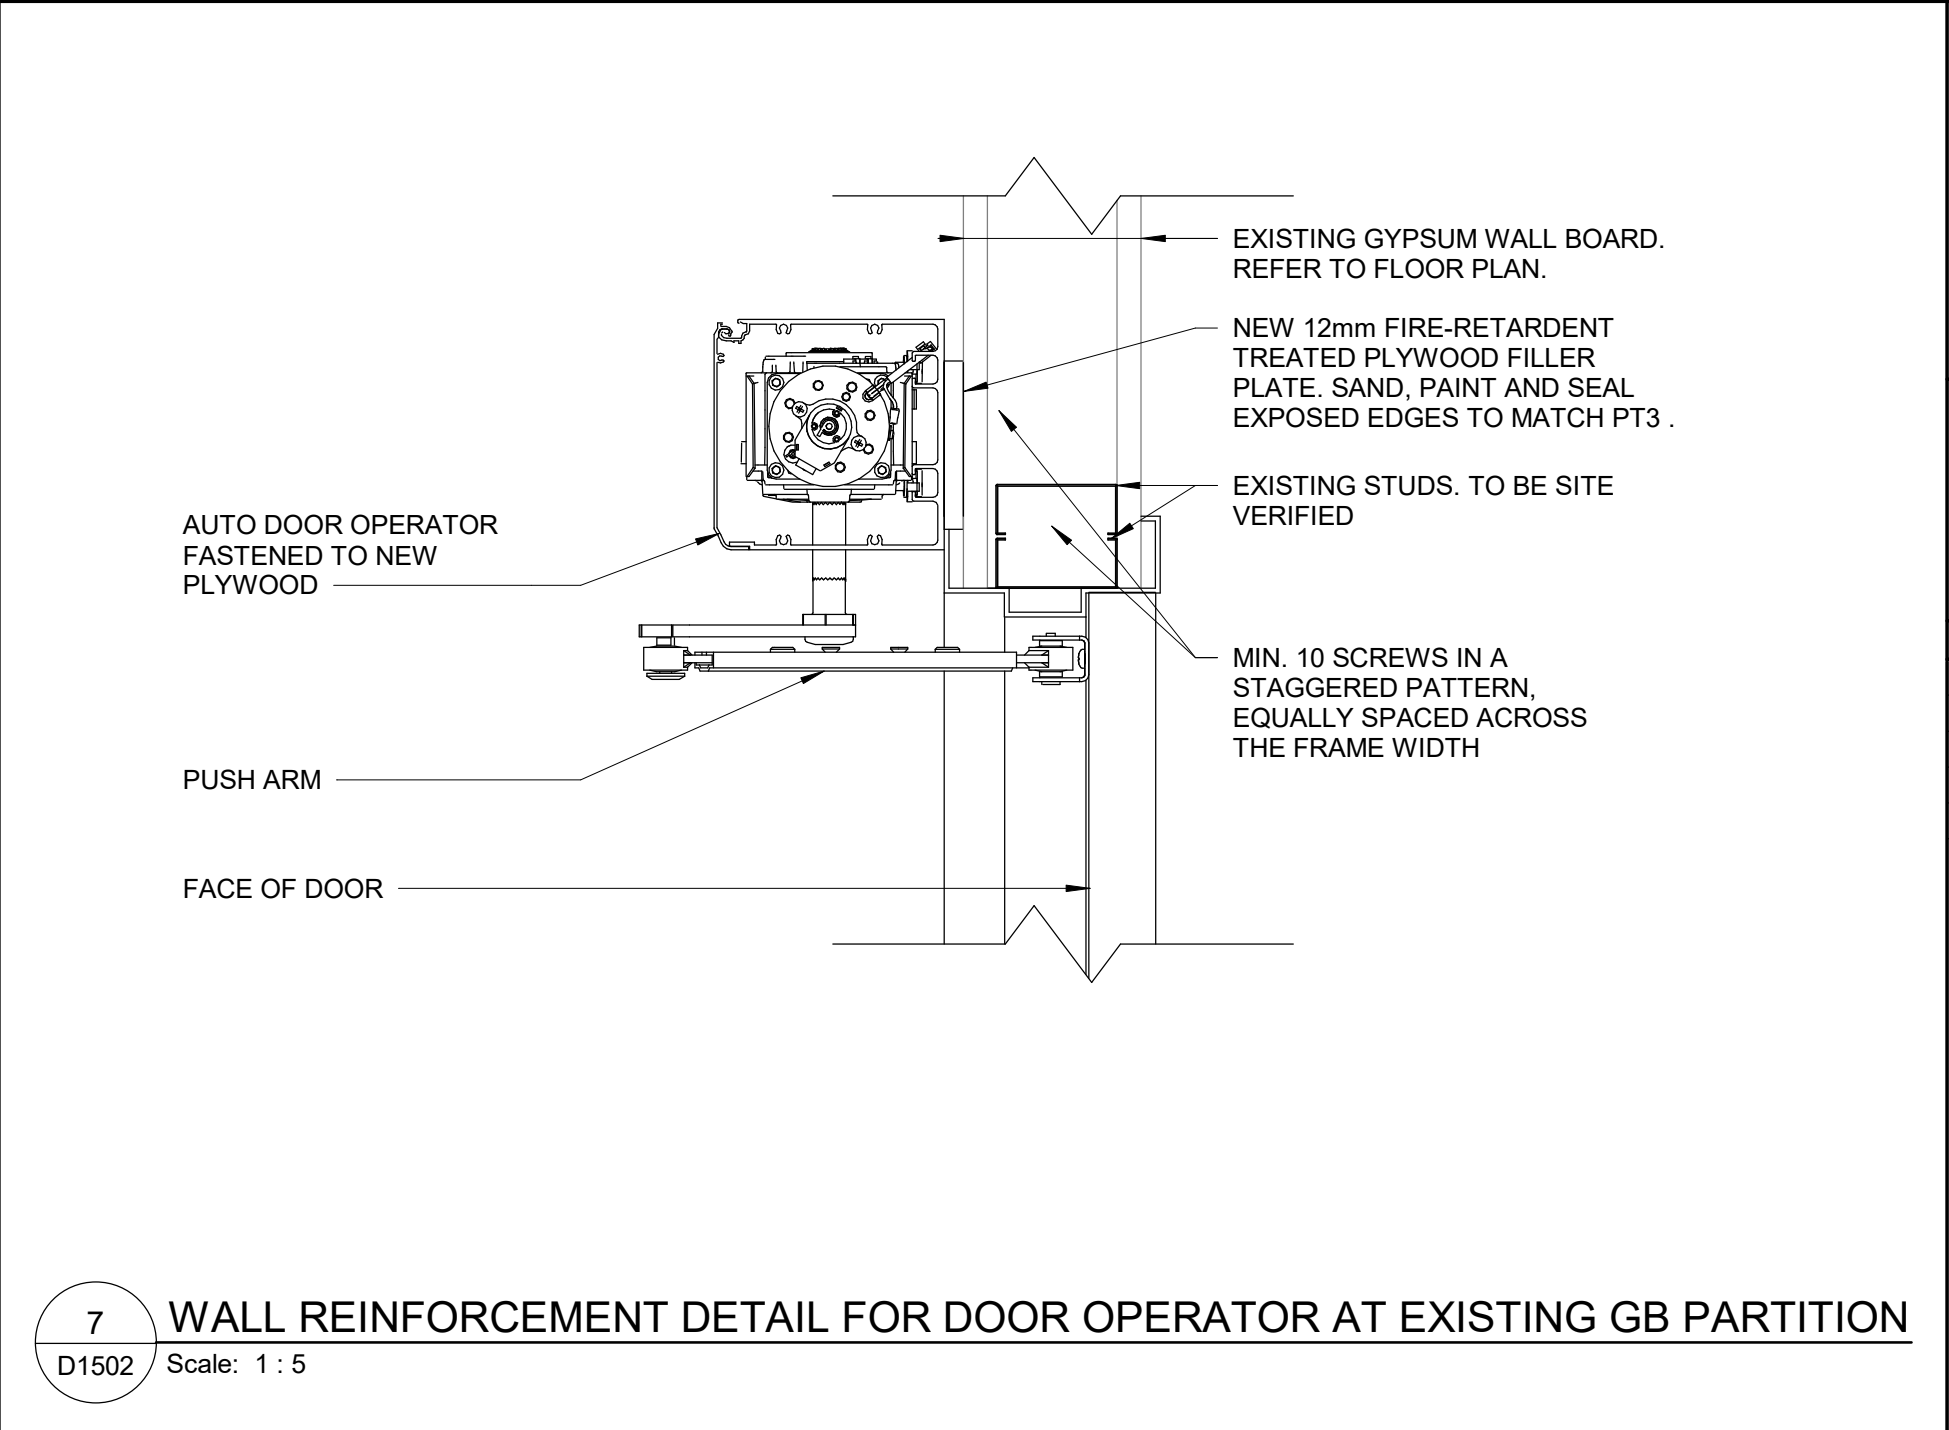
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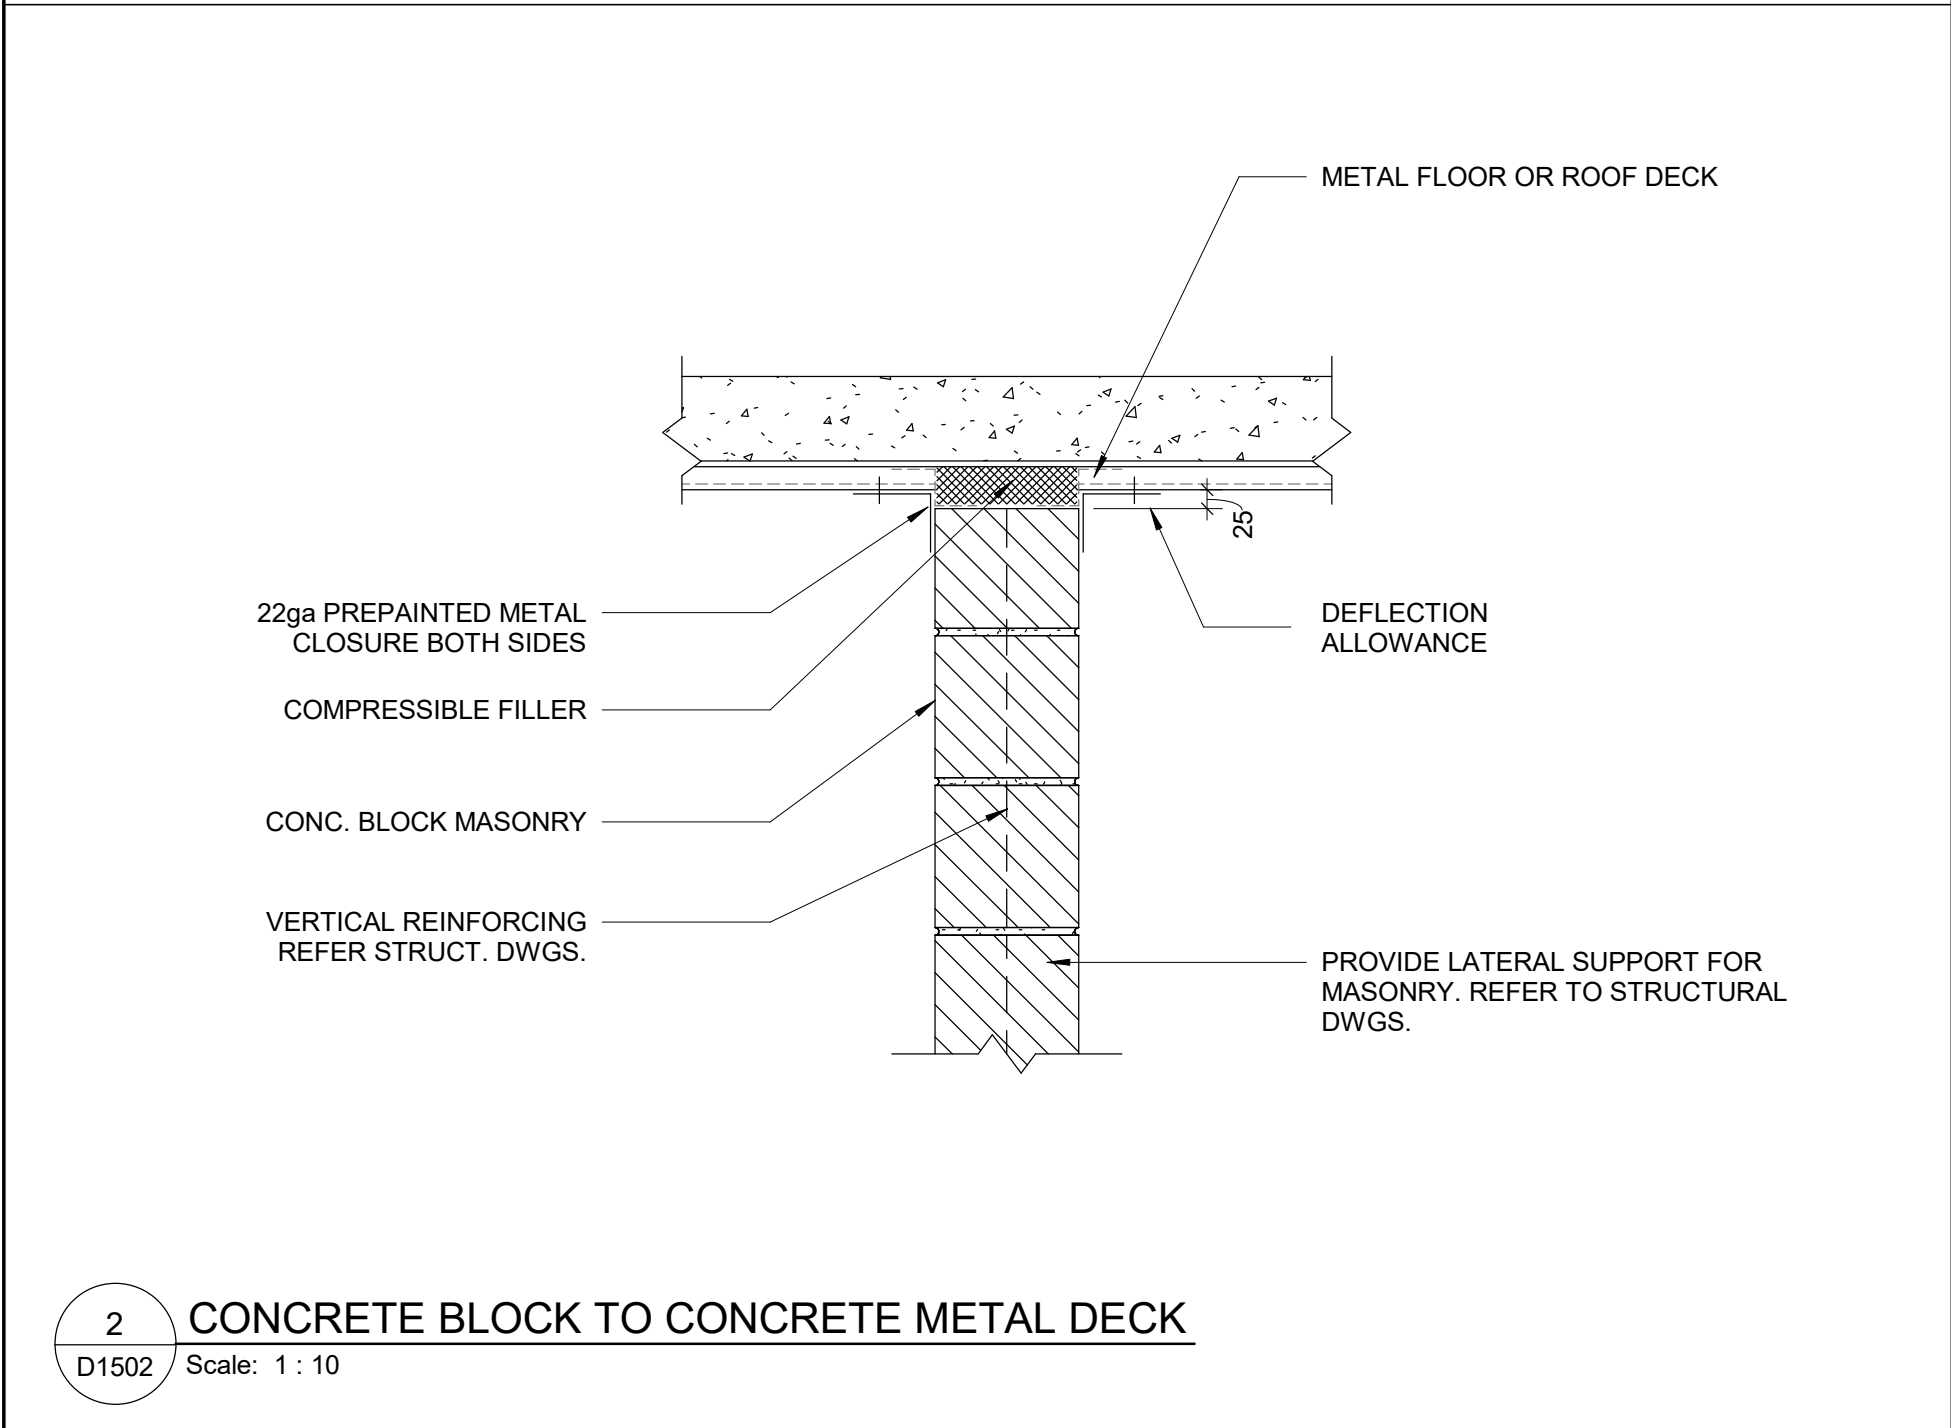
1 CONC BLOCK CONTROL JOINT DETAIL
D1502 Scale: 1 : 5

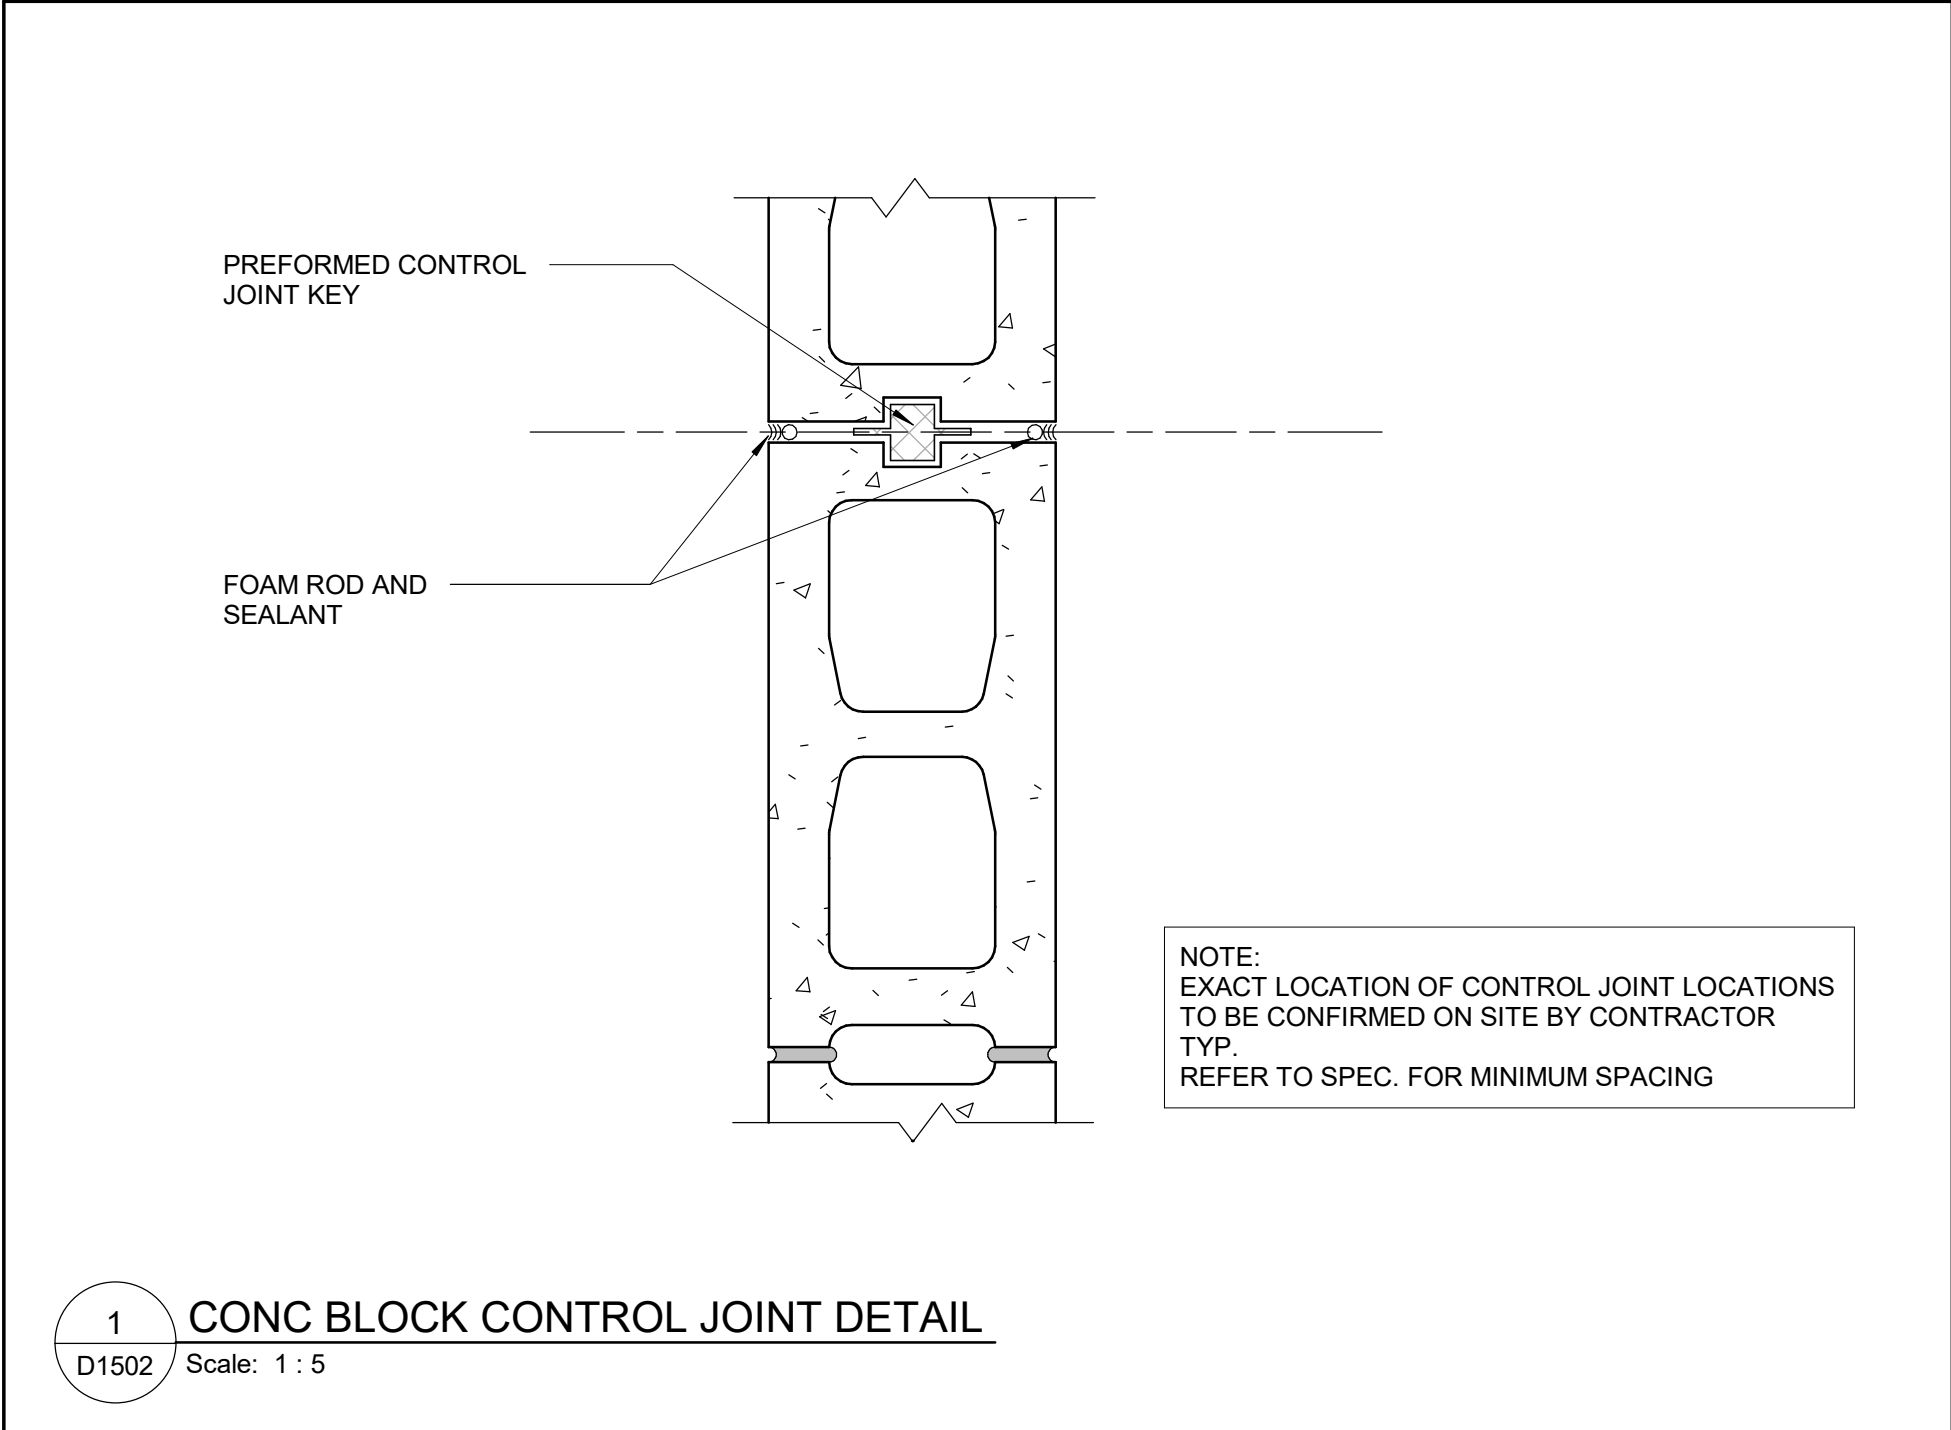


4 MASONRY ANCHOR DETAIL
D1502 Scale: 1 : 10

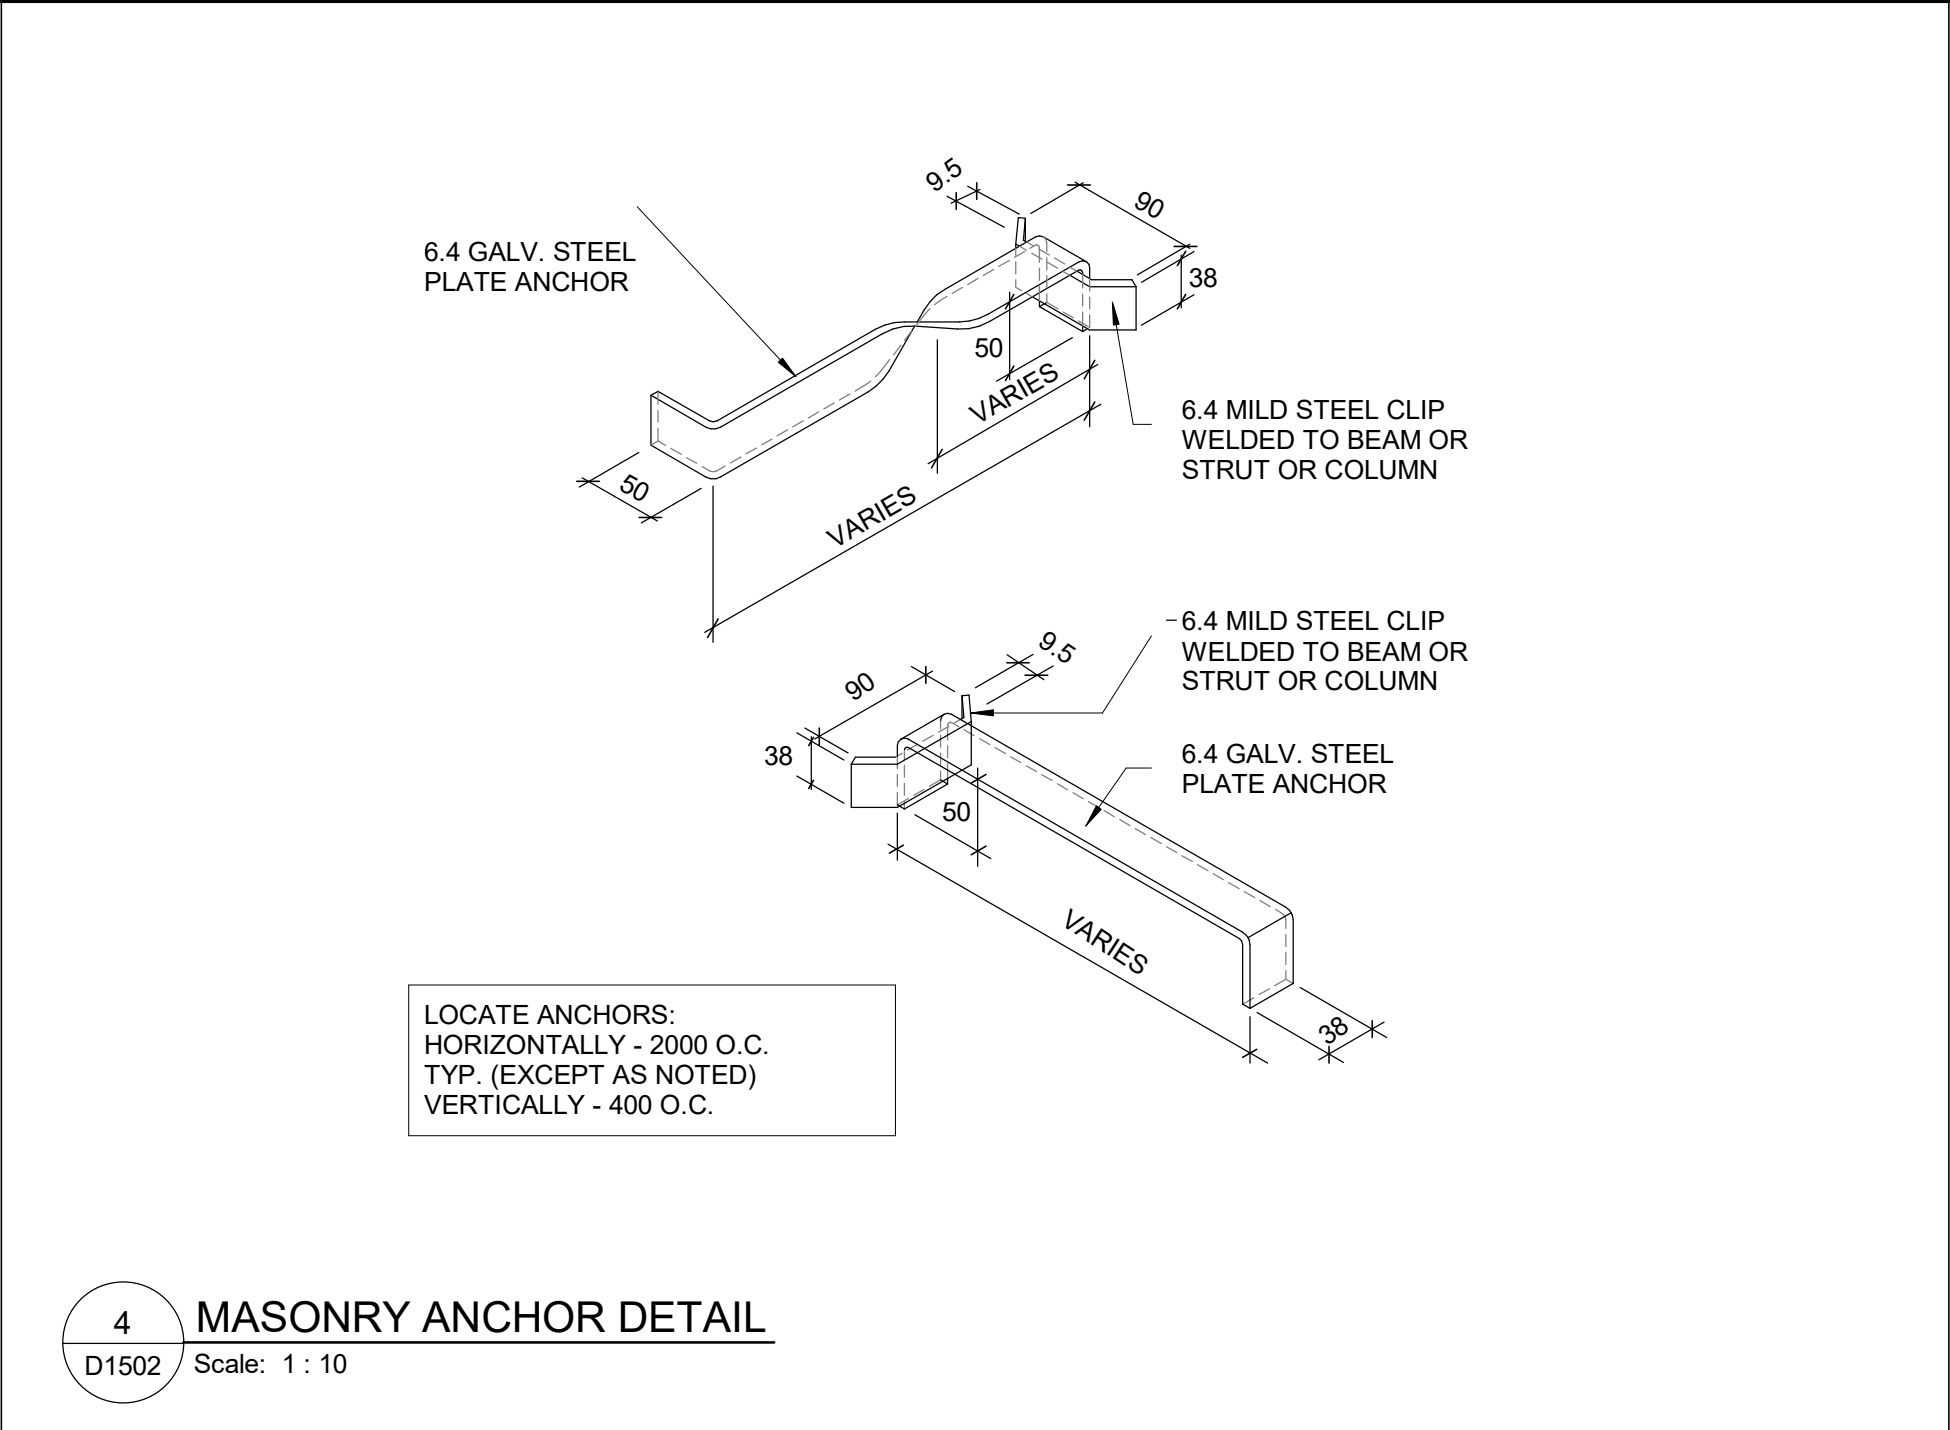


7 WALL REINFORCEMENT DETAIL FOR DOOR OPERATOR AT EXISTING GB PARTITION
D1502 Scale: 1 : 5





2 CONCRETE BLOCK TO CONCRETE METAL DECK
D1502 Scale: 1 : 10

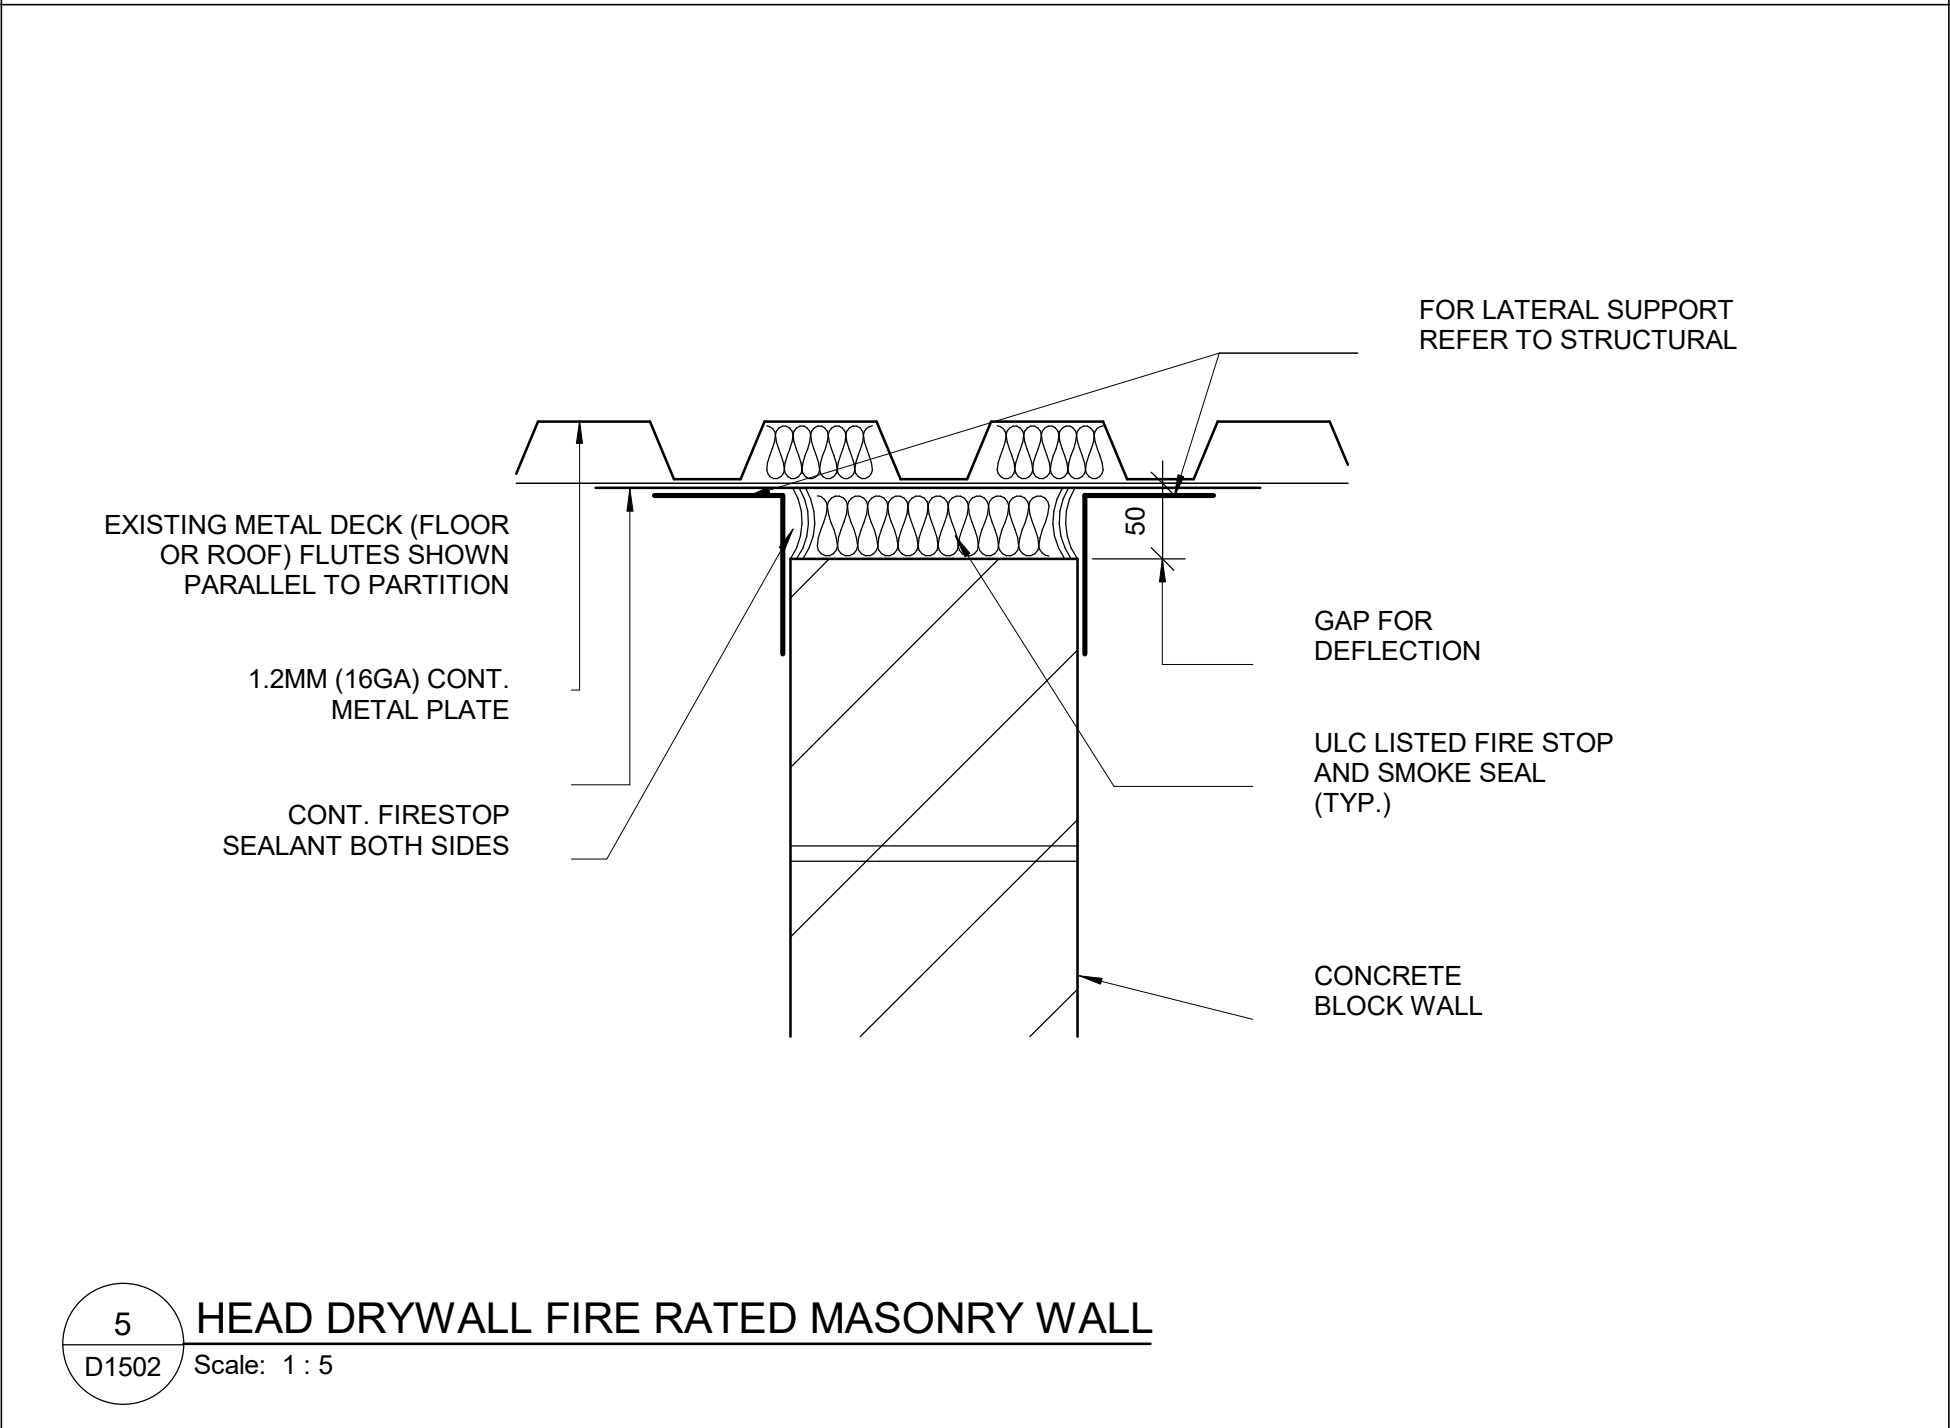

5 HEAD DRYWALL FIRE RATED MASONRY WALL
D1502 Scale: 1 : 5

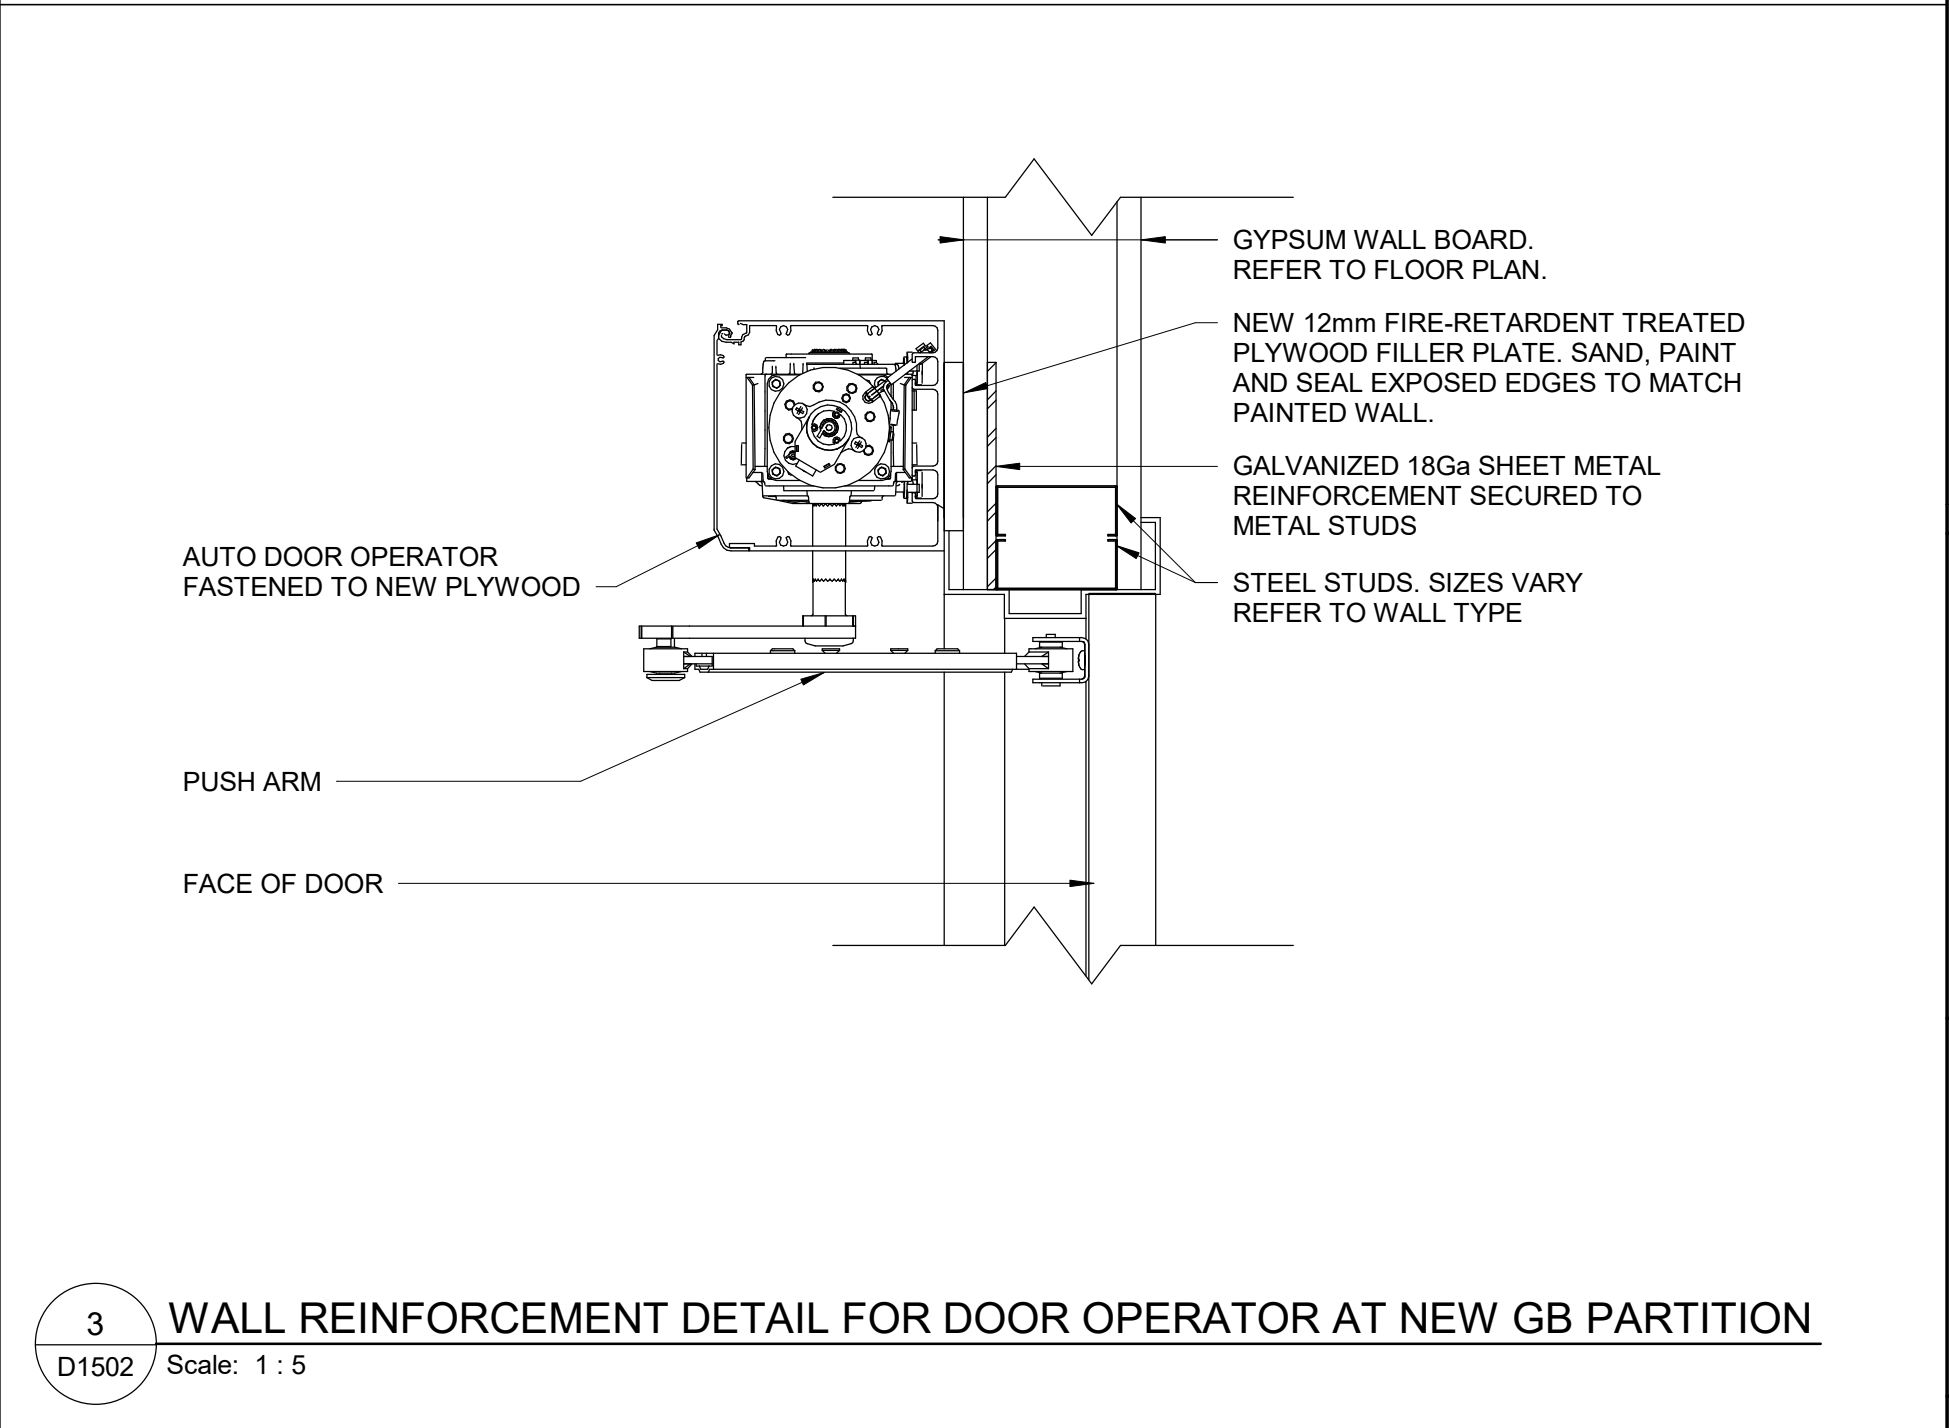

3 WALL REINFORCEMENT DETAIL FOR DOOR OPERATOR AT NEW GB PARTITION
D1502 Scale: 1 : 5

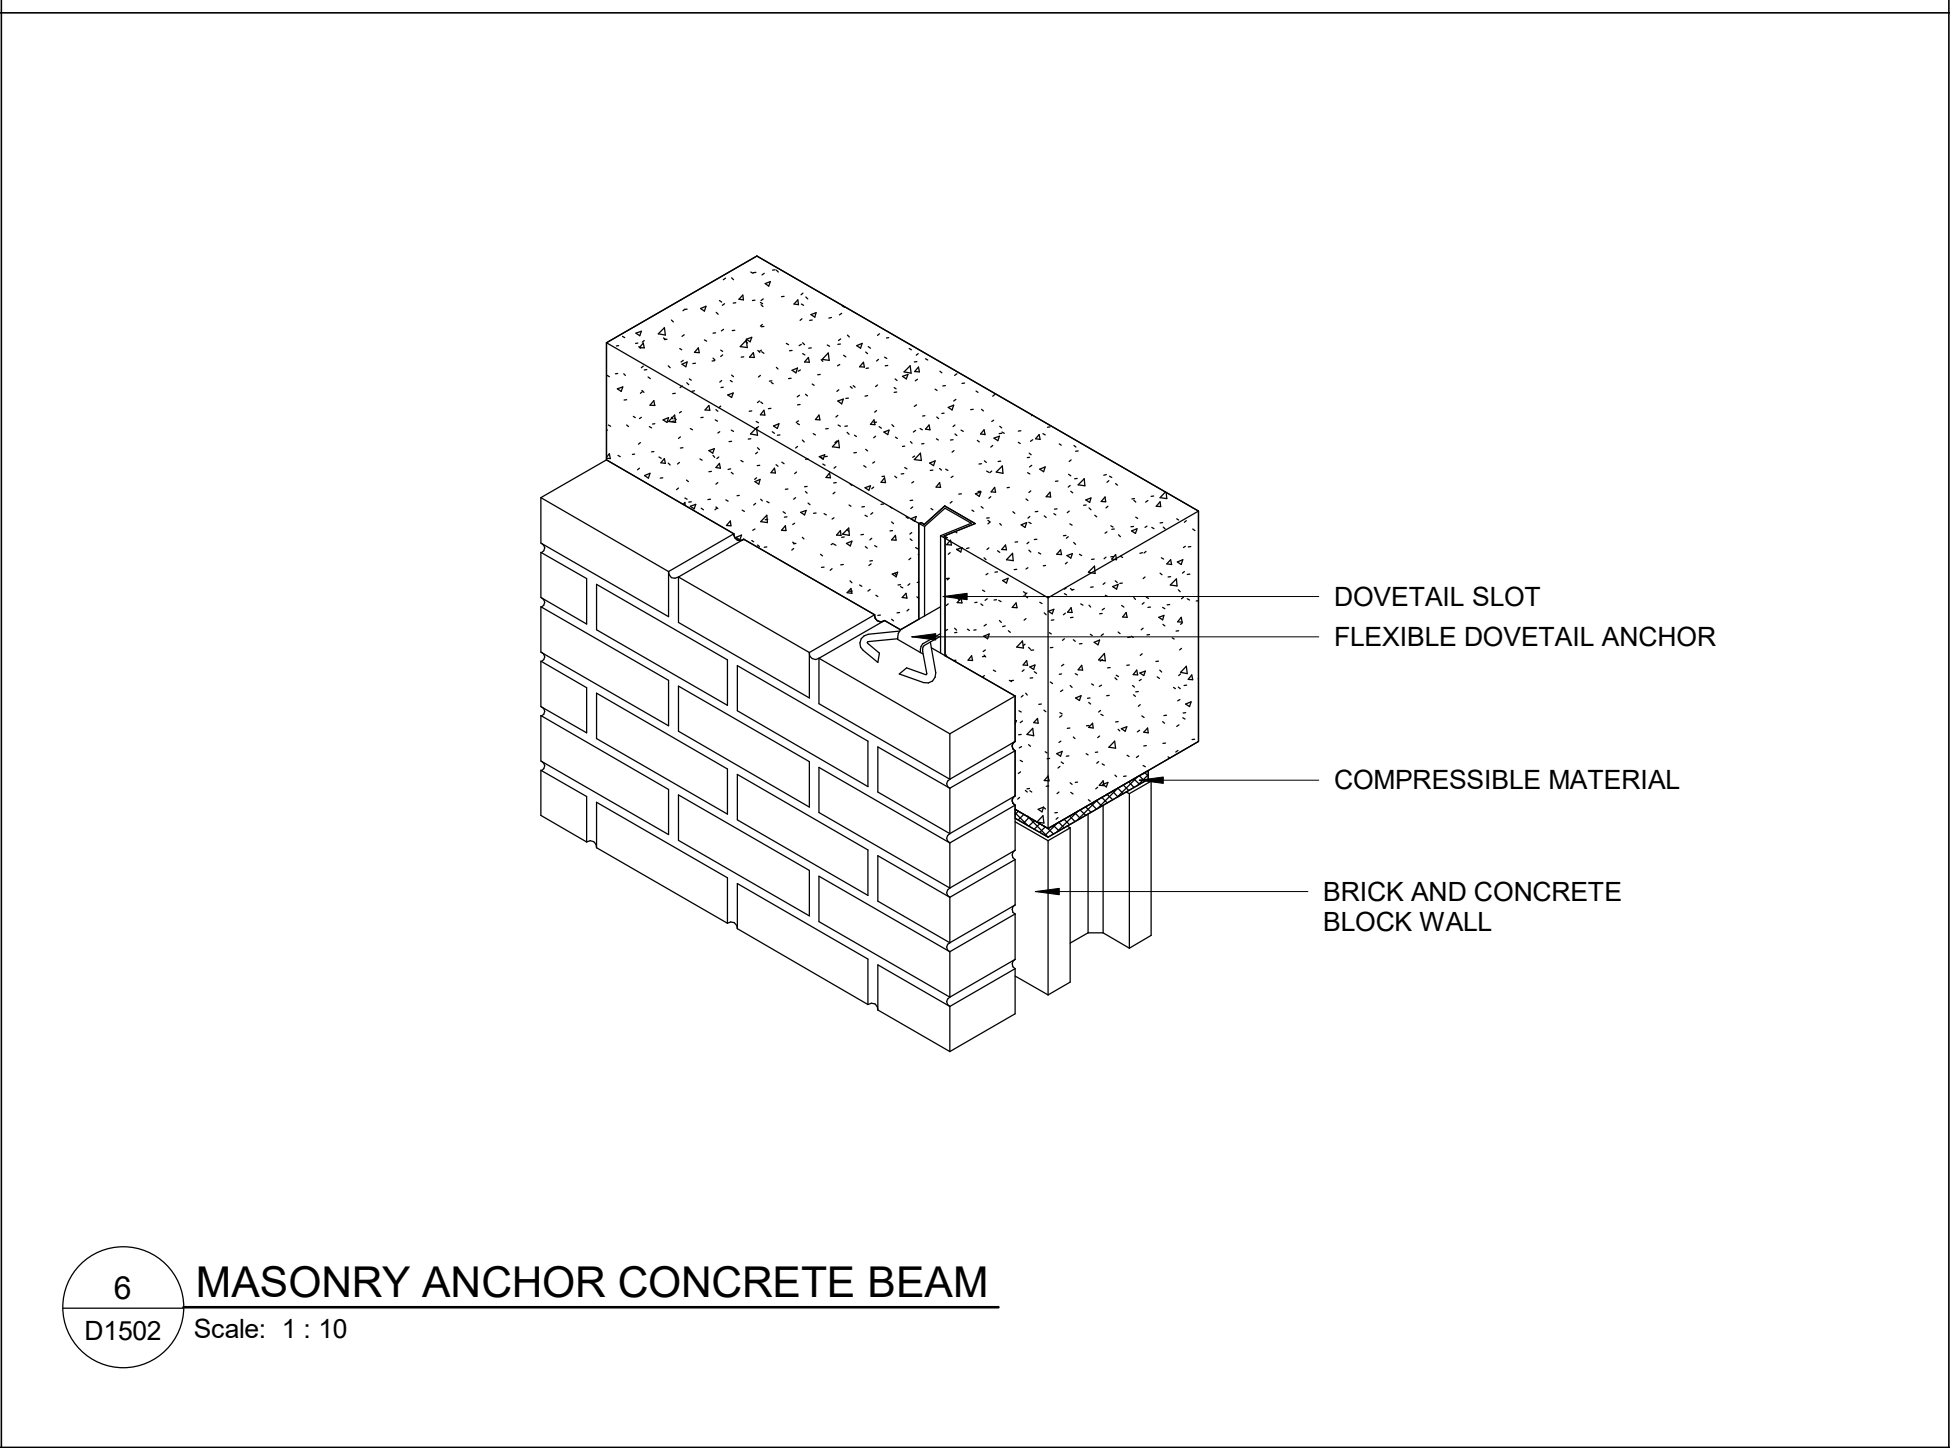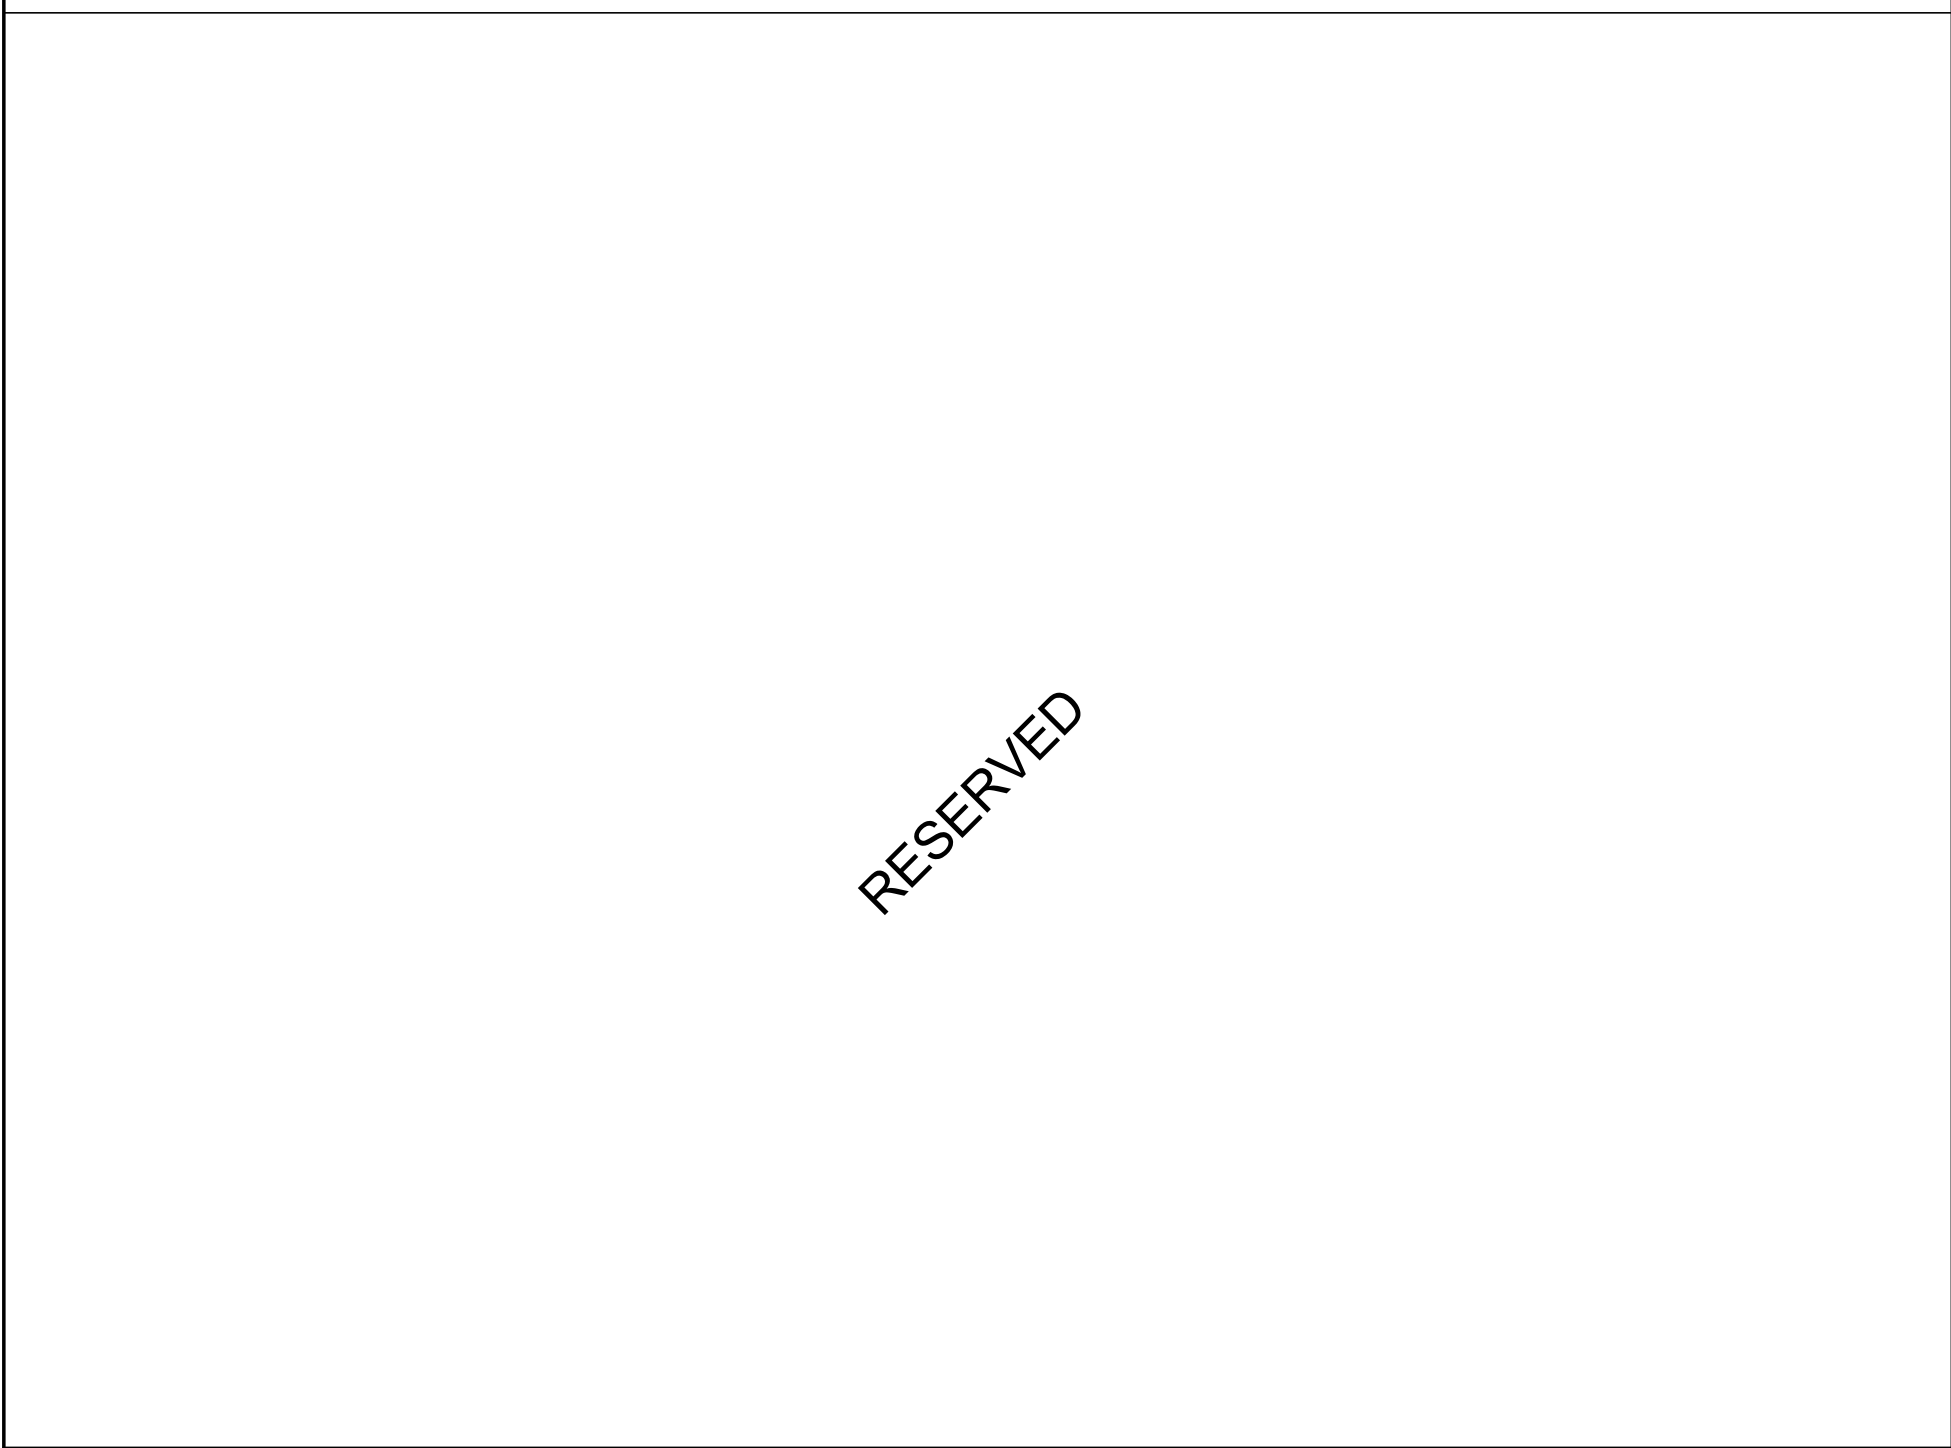

6 MASONRY ANCHOR CONCRETE BEAM
D1502 Scale: 1 : 10

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PROJECT ADDRESS

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DRAWN BY:
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CHECKED BY:
K. TILAHUN

PROJECT MGR:
F. BOLOURIAN

APPROVED BY:
E. FENUITA

SHEET TITLE

MISCELLANEOUS
DETAILS -02

SHEET NUMBER

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SCALE CHECK
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10mm

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
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
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PROJECT MGR: F. BOLOURIAN	APPROVED BY: E. FENUTA

SHEET TITLE
ELEVAOTOR DETAILS

SHEET NUMBER D1601	ISSUE A
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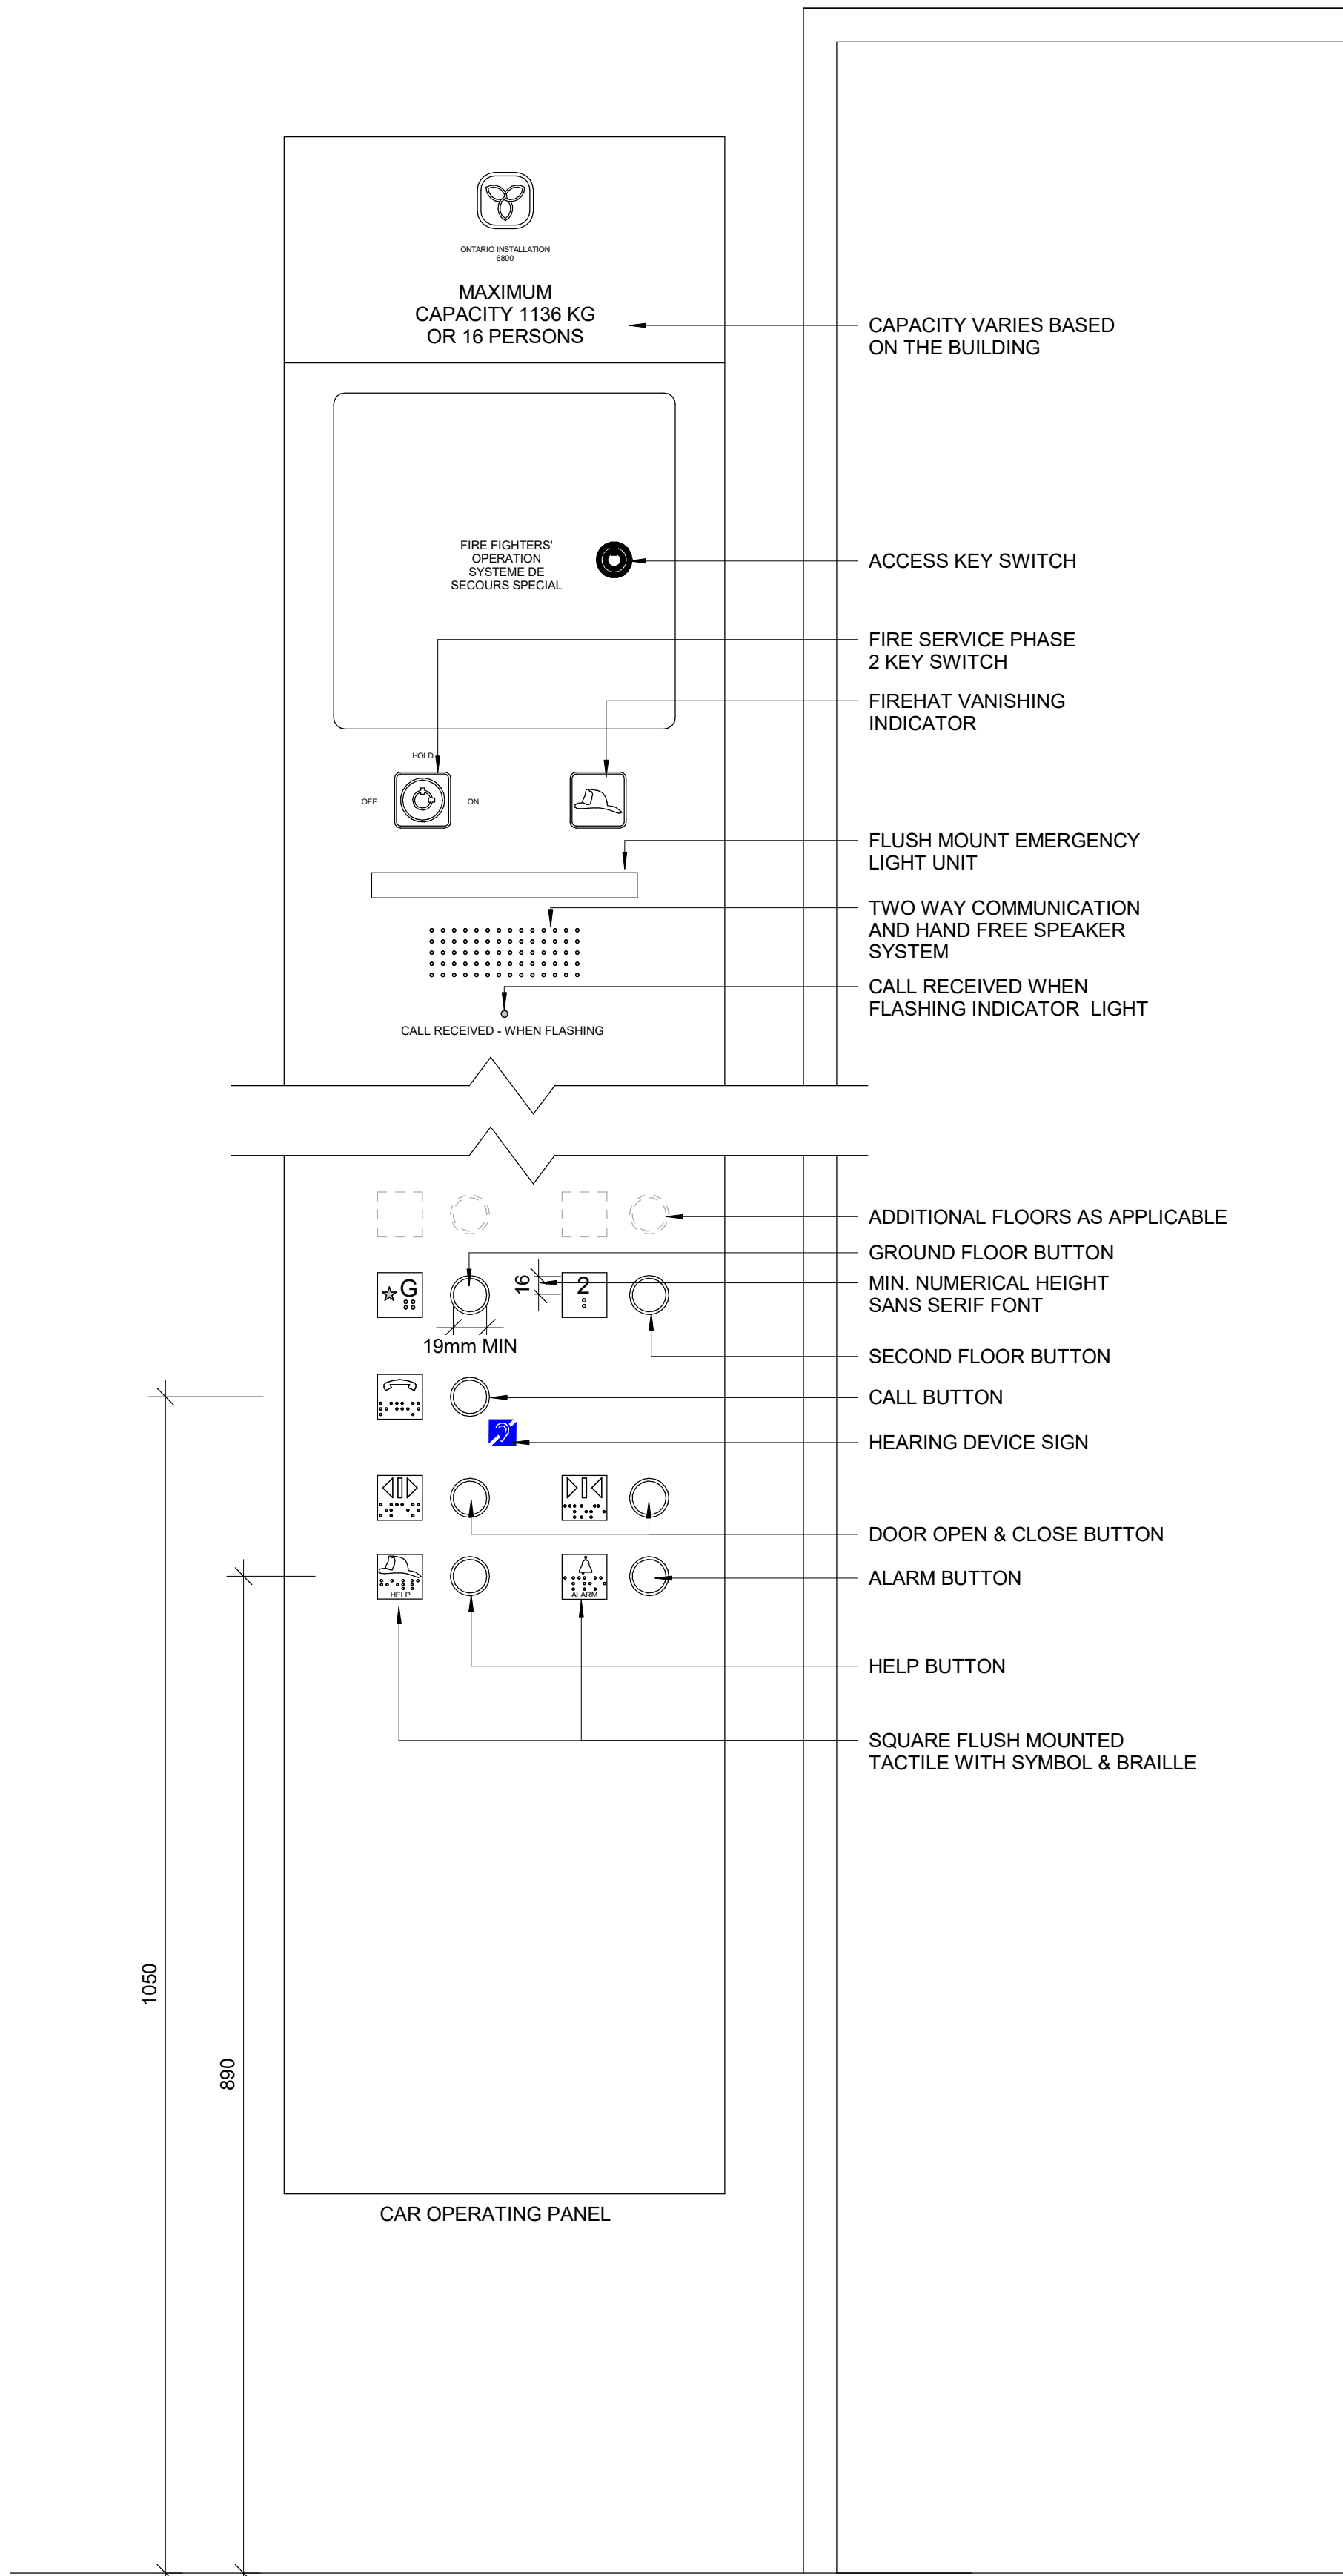
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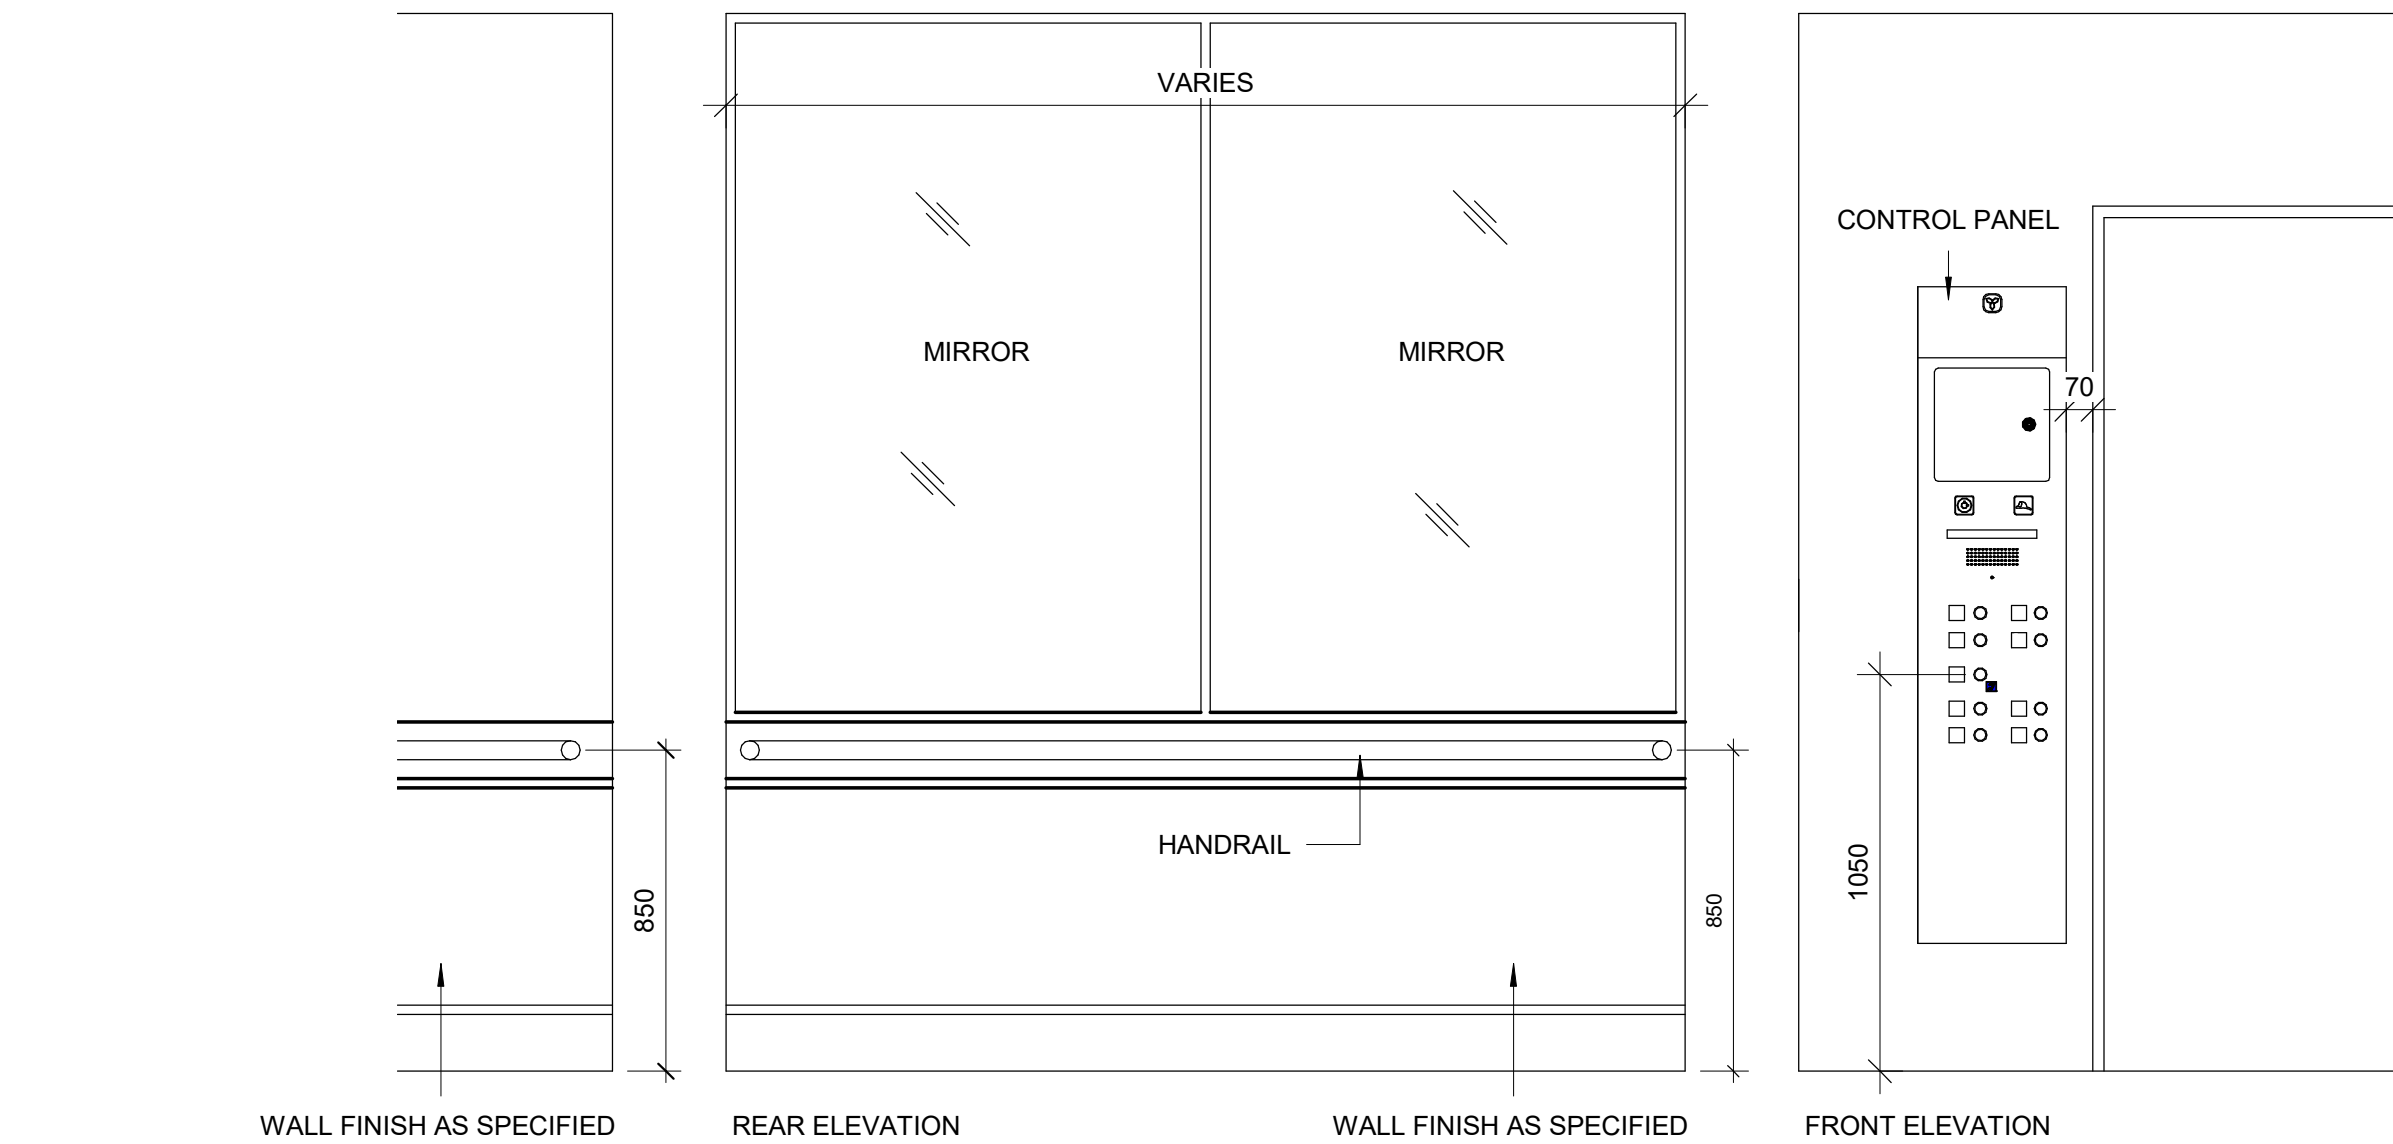
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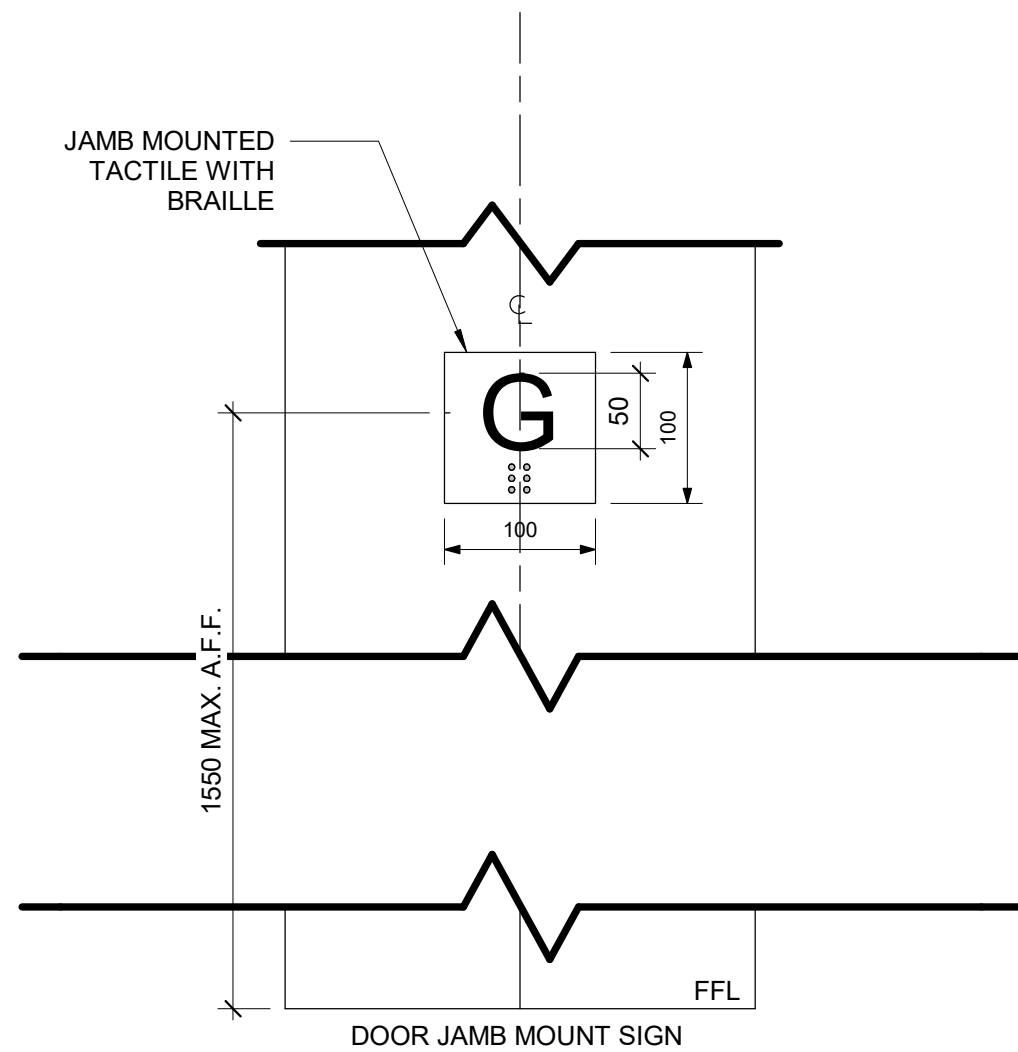
1 INTERIOR ELEVATOR CONTROLS
D1602 Scale: 1 : 5




2 ELEVATOR INTERIOR ELEVATIONS
D1602 Scale: 1 : 20



3 TACTILE FLOOR MARKER
D1602 Scale: 1 : 5



4 ELEVATOR EXTERIOR PANEL ELEVATION
D1602 Scale: 1 : 5

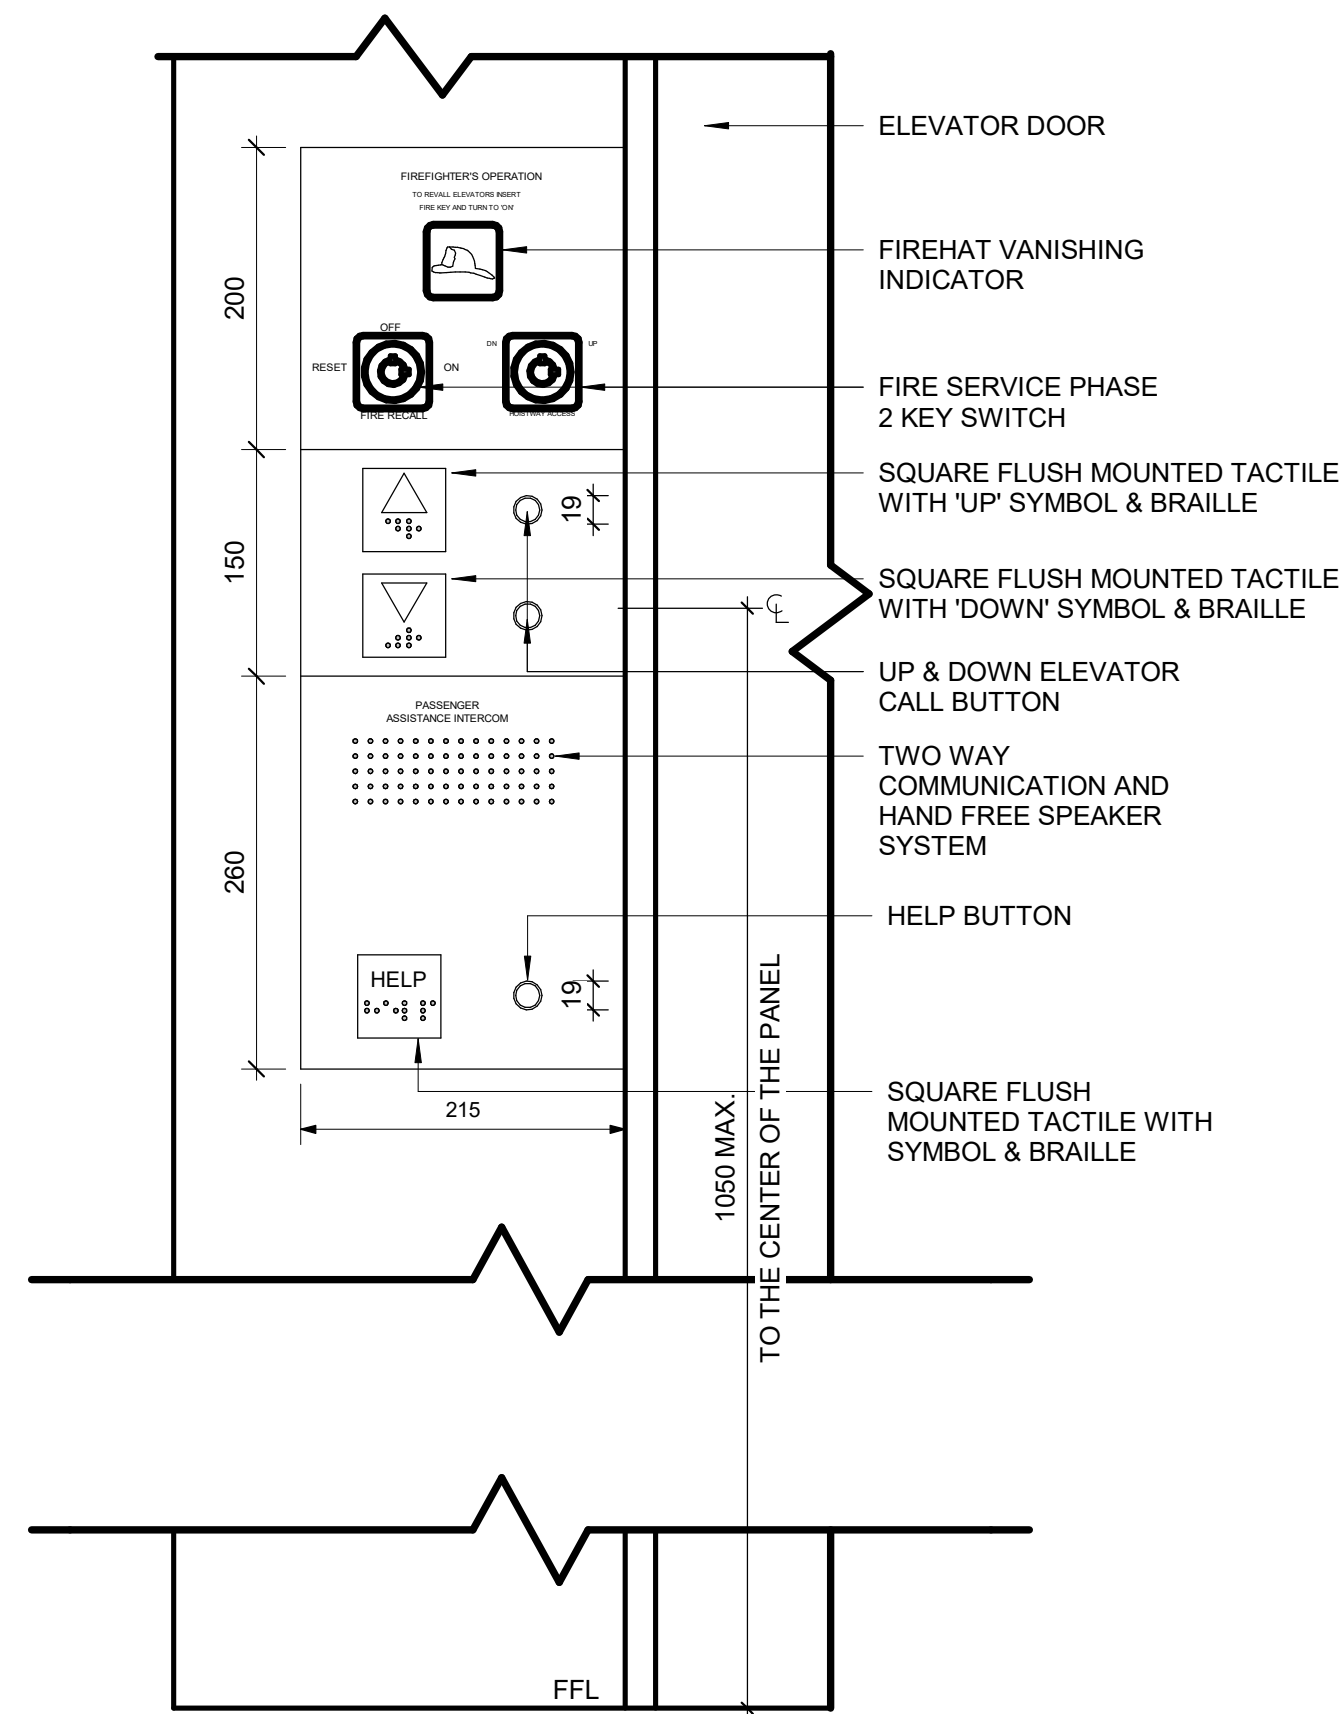

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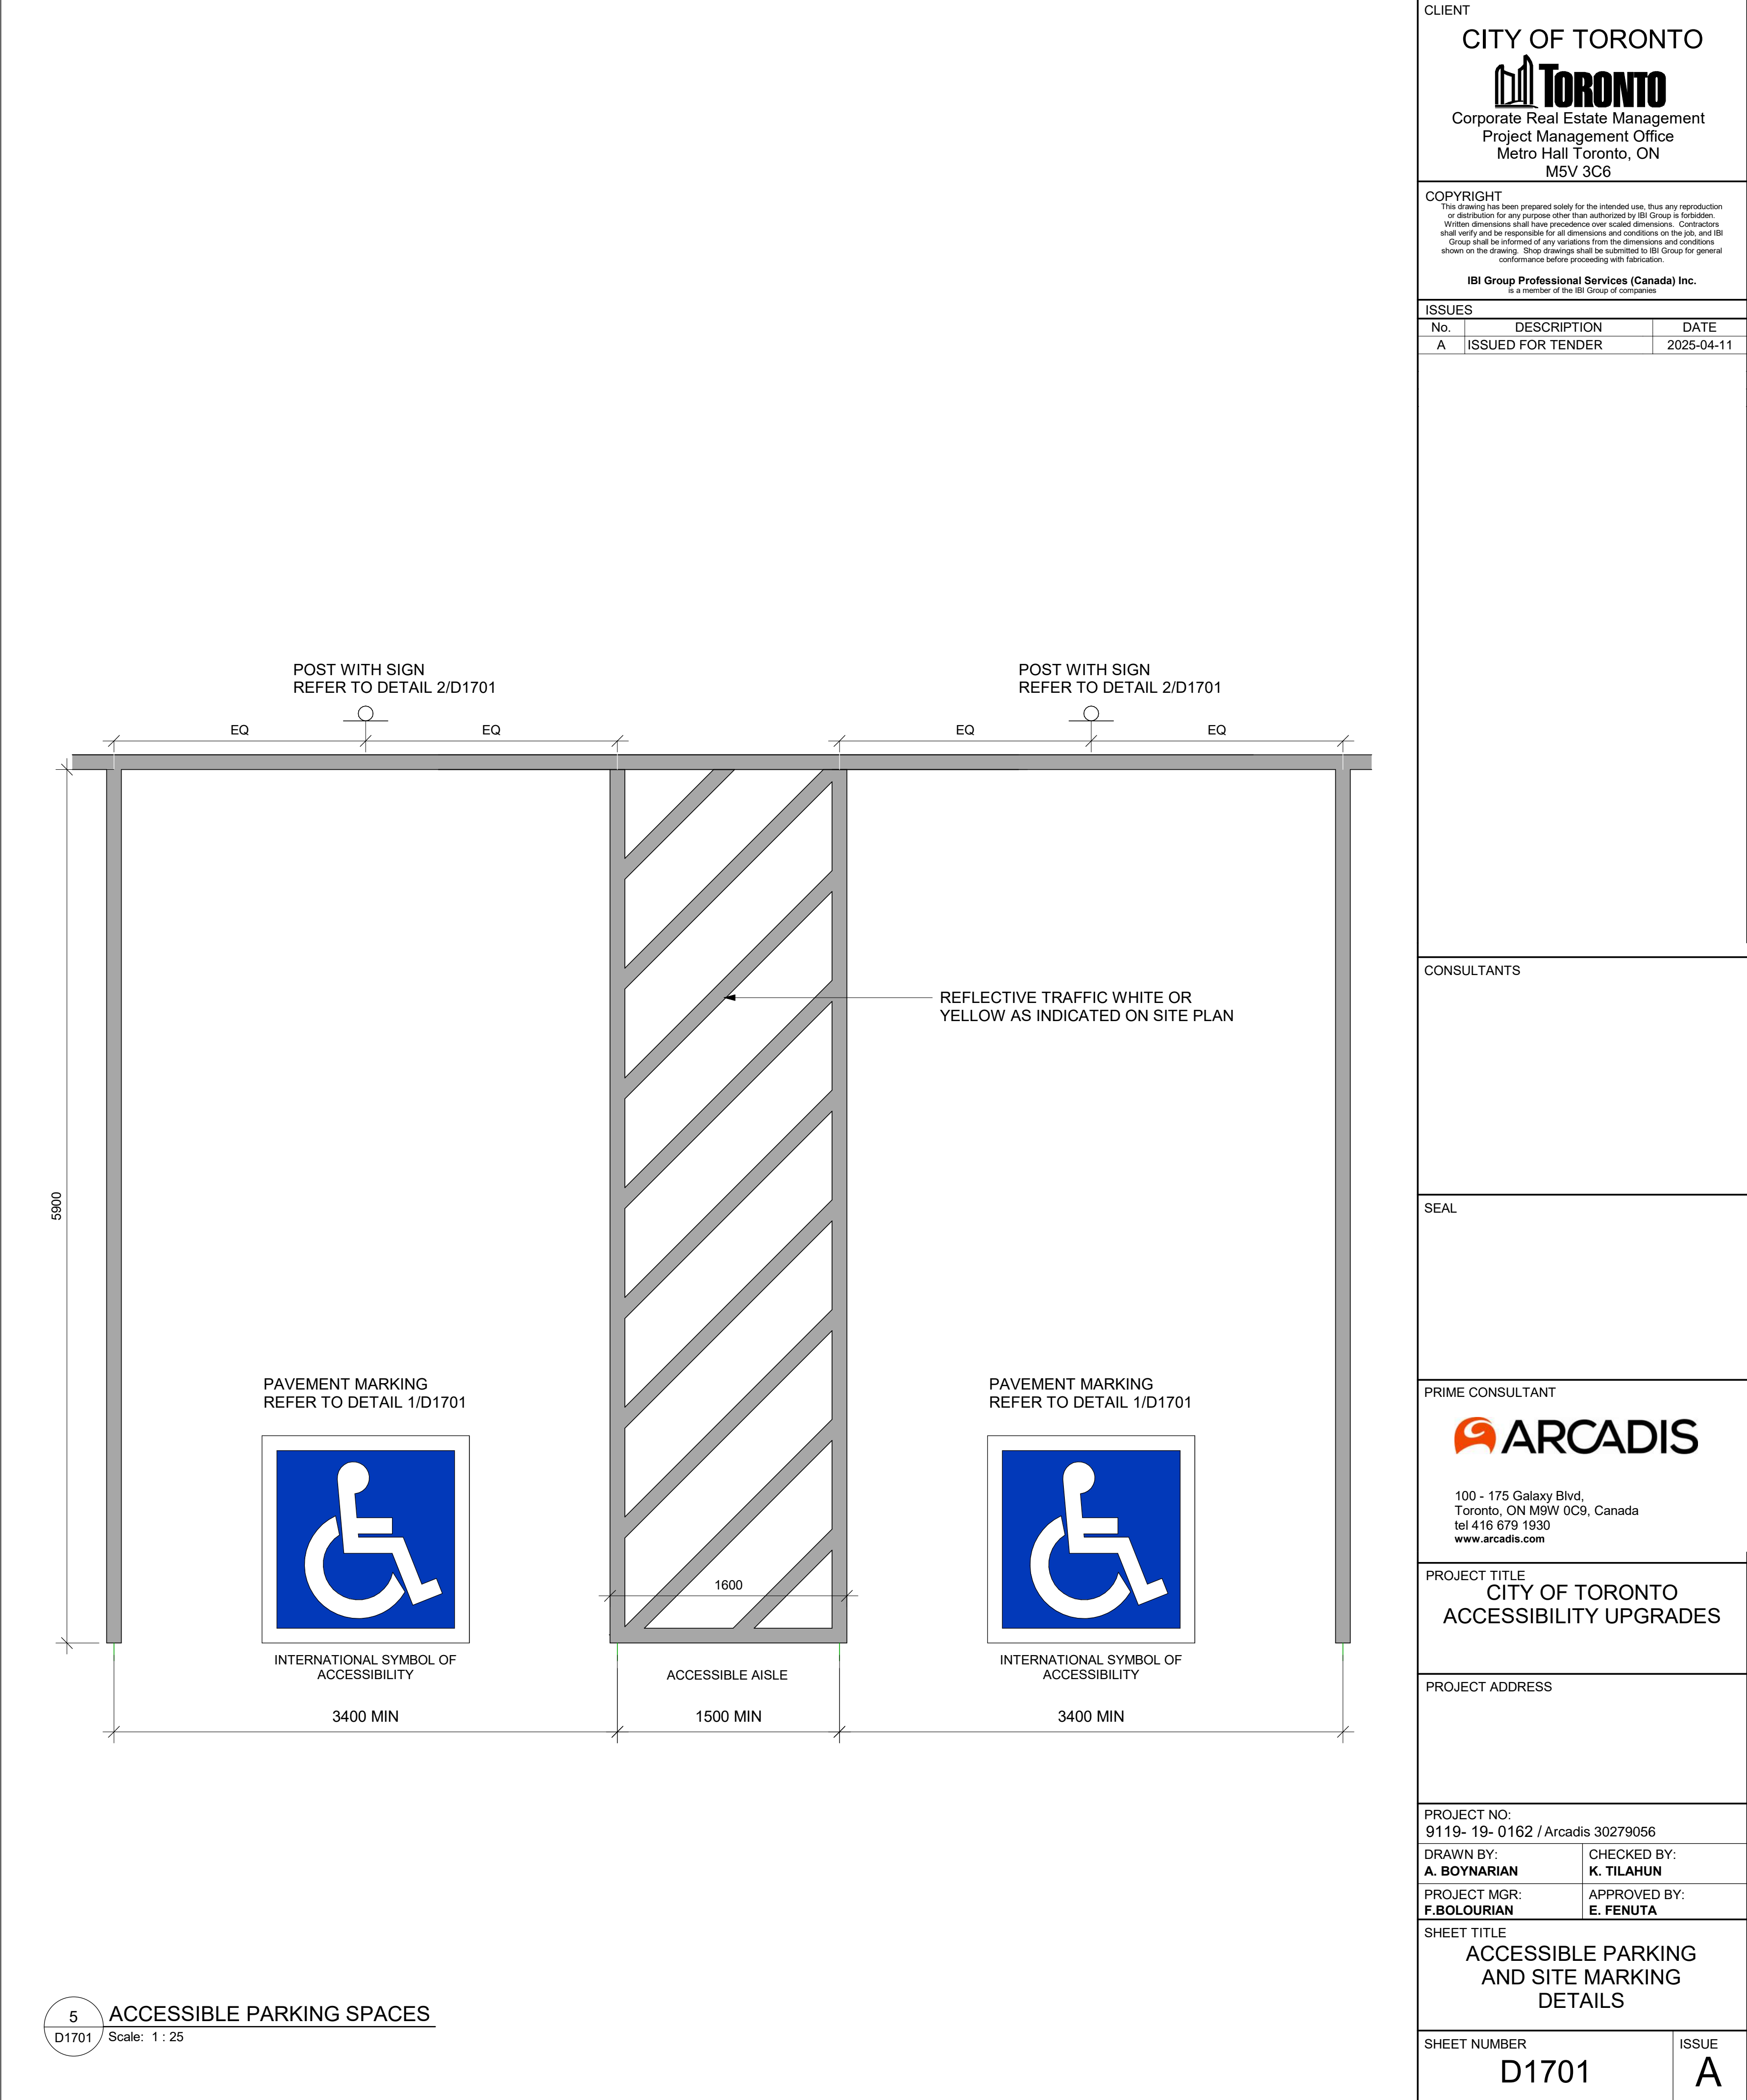
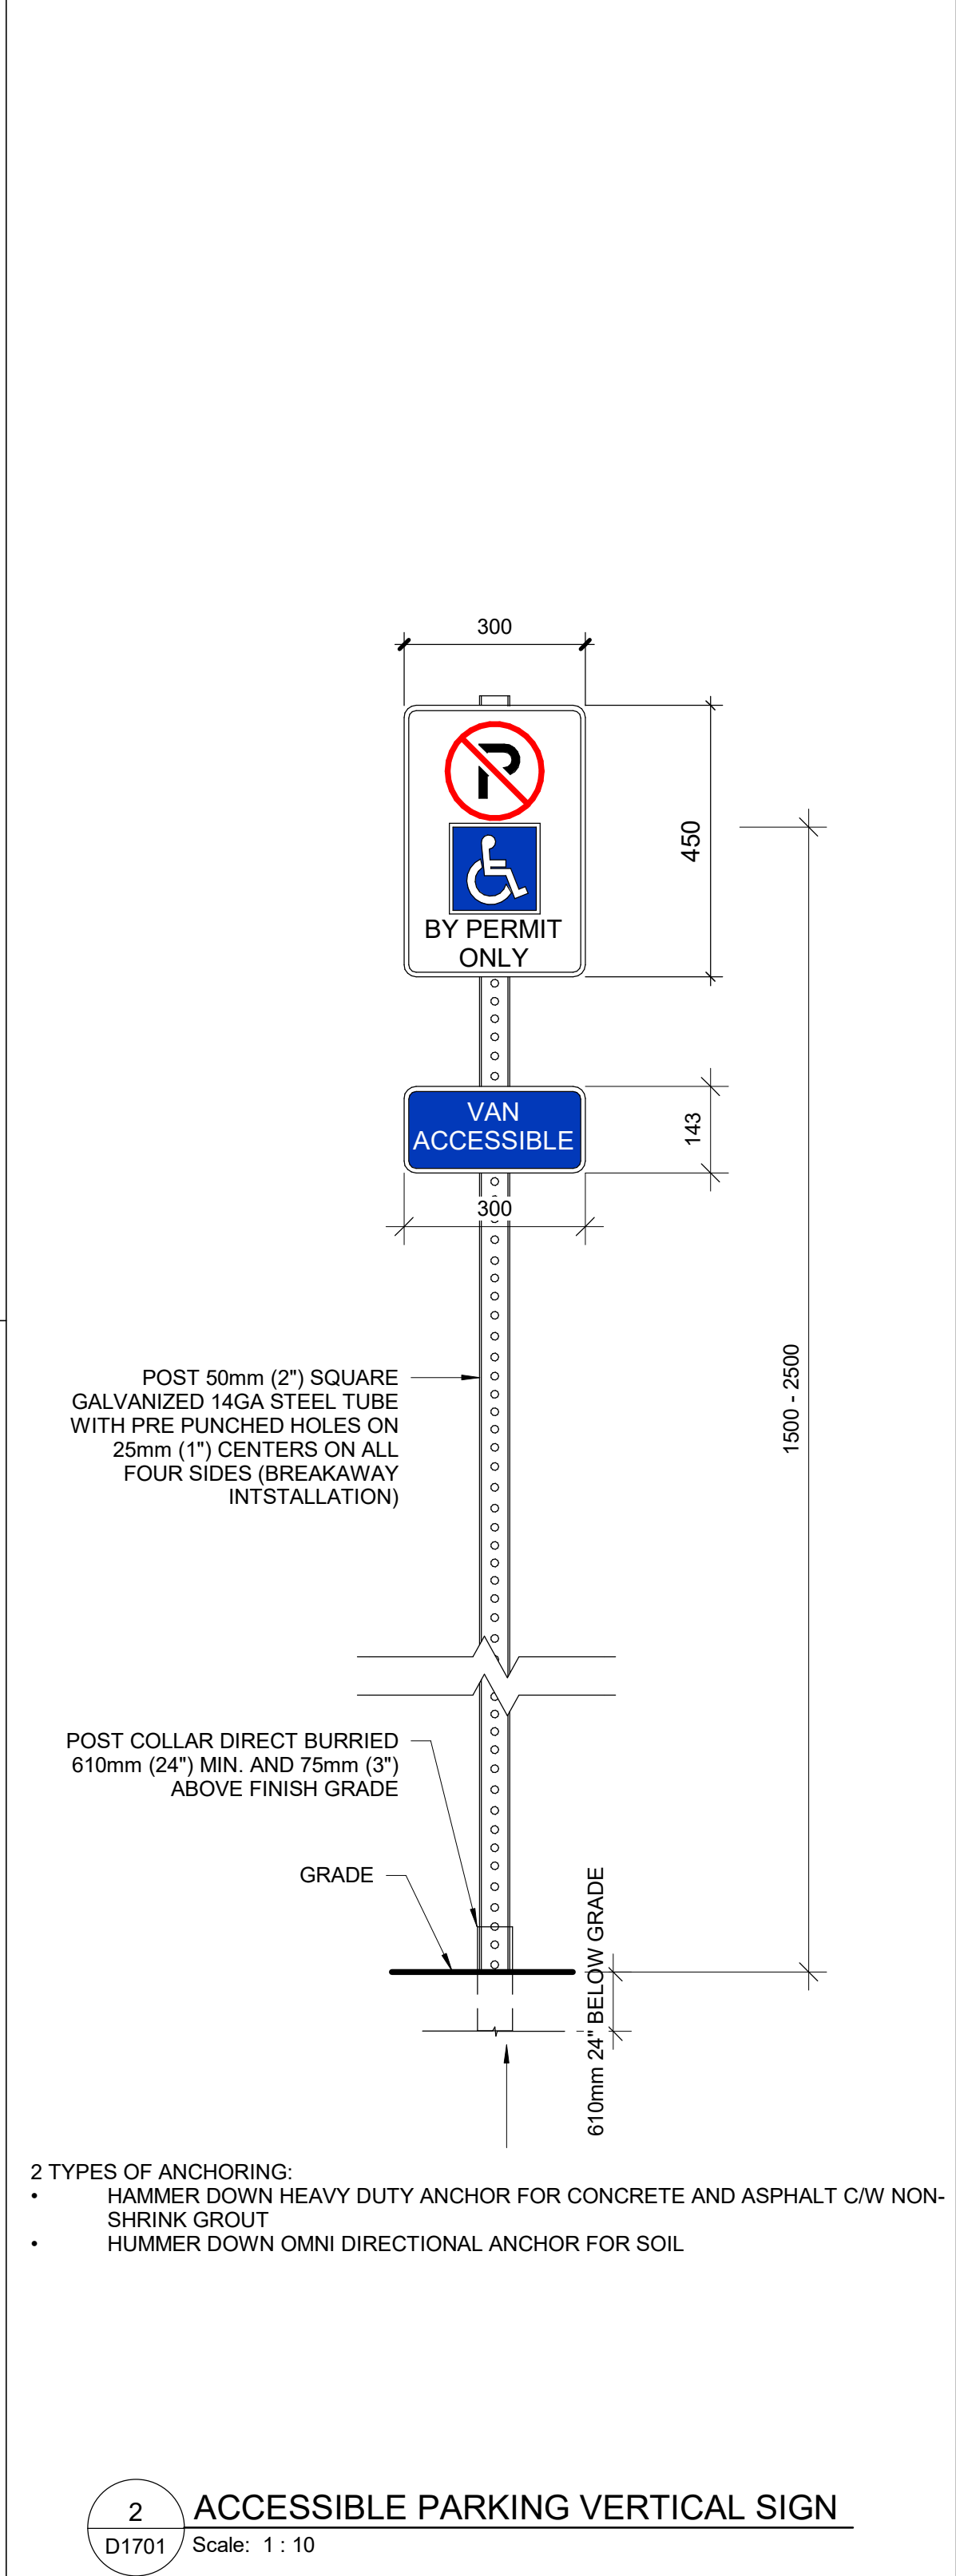
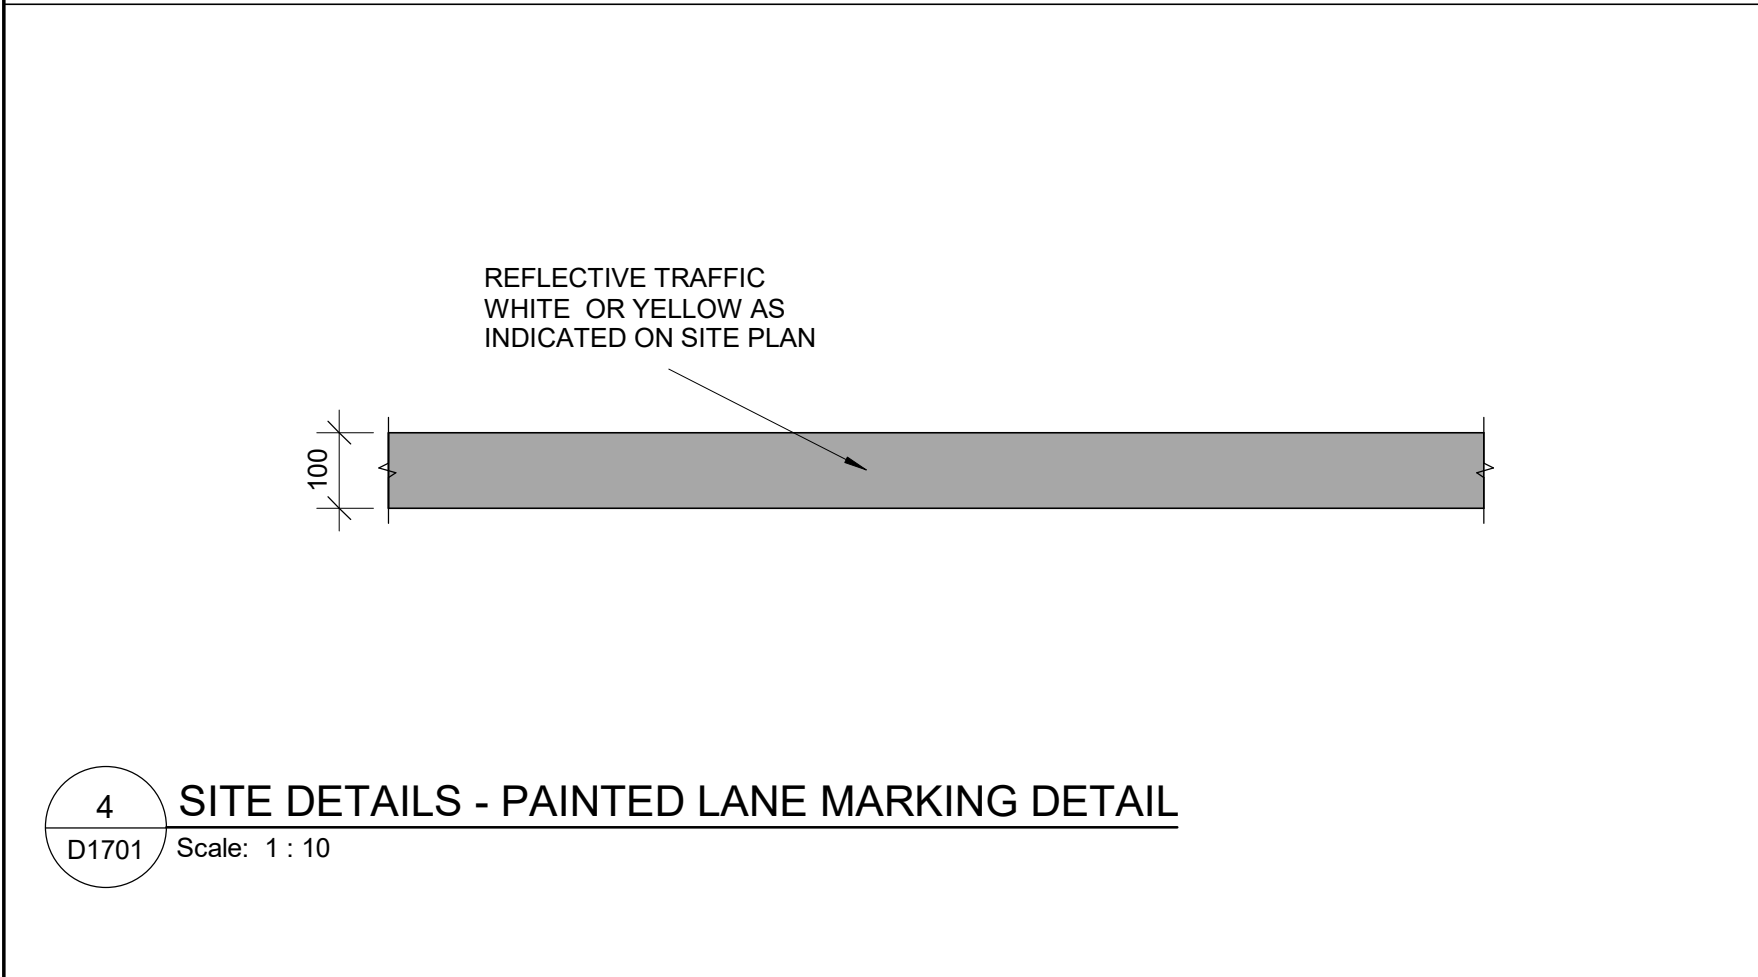
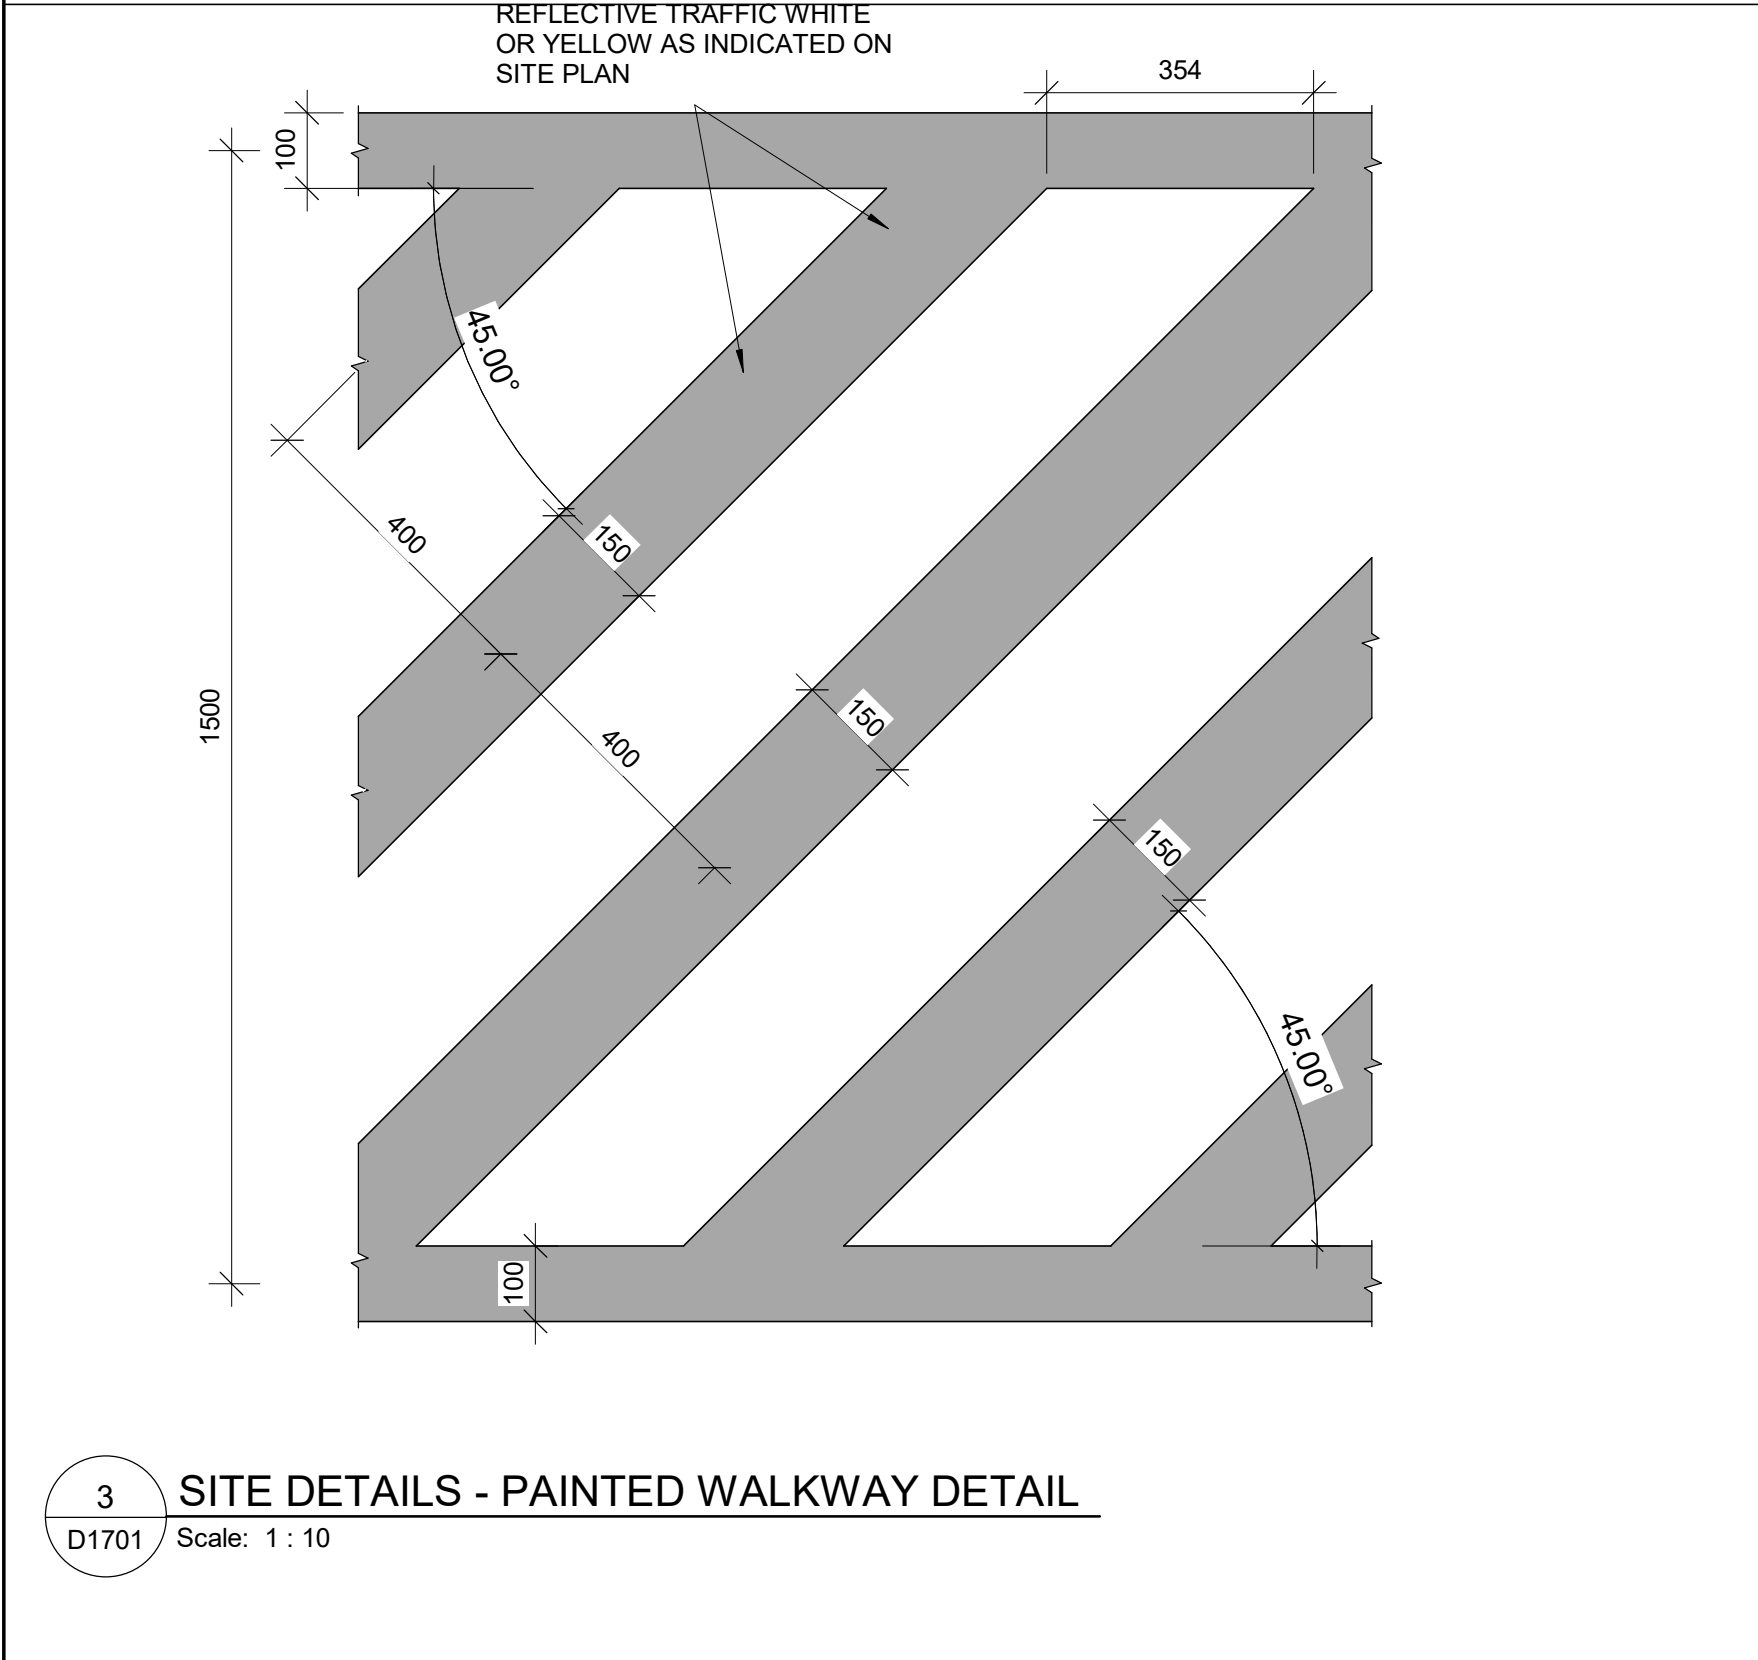
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

PROJECT NO:
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DRAWN BY:
A. BOYNARIAN
CHECKED BY:
K. TILAHUN
PROJECT MGR:
F. BOLOURIAN
APPROVED BY:
E. FENUITA


SHEET TITLE
**ELEVATOR CONTROL &
INTERIOR CABIN
DETAILS**

SHEET NUMBER D1602	ISSUE A
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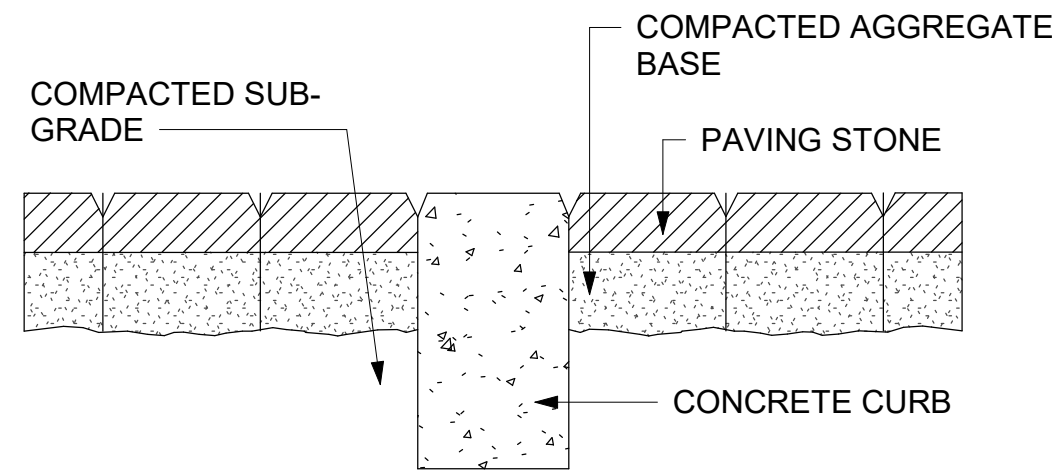
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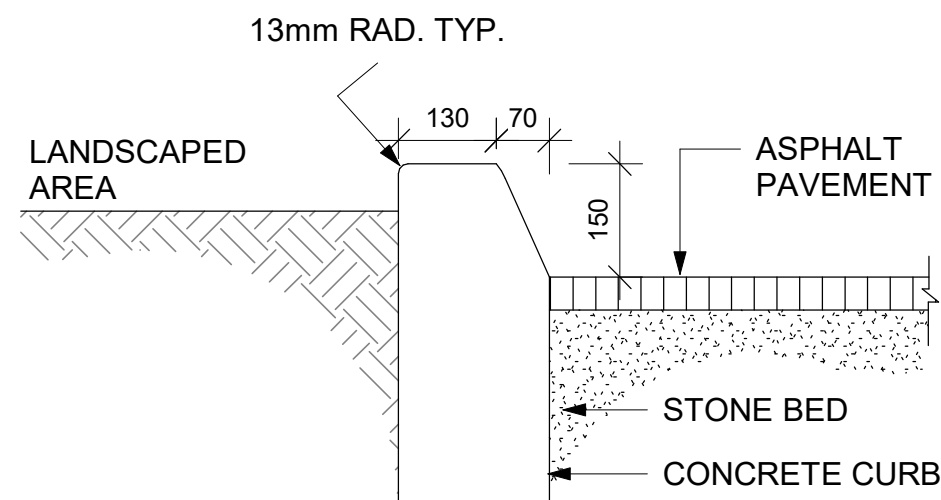
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No.	DESCRIPTION	DATE
A	ISSUED FOR TENDER	2025-04-11
CONSULTANTS		
SEAL		
PRIME CONSULTANT		
<div> ARCADIS</div> 100 - 175 Galaxy Blvd, Toronto, ON M9W 0C9, Canada tel 416 679 1930 www.arcadis.com		
PROJECT TITLE CITY OF TORONTO ACCESSIBILITY UPGRADES		
PROJECT ADDRESS		
PROJECT NO: 9119- 19- 0162 / Arcadis 30279056		
DRAWN BY: A. BOYNARIAN		CHECKED BY: K. TILAHUN
PROJECT MGR: F. BOLOURIAN		APPROVED BY: E. FENUTA
SHEET TITLE ACCESSIBLE PARKING AND SITE MARKING DETAILS		
SHEET NUMBER D1701		ISSUE A




1 PAVER
D1702 Scale: 1 : 10

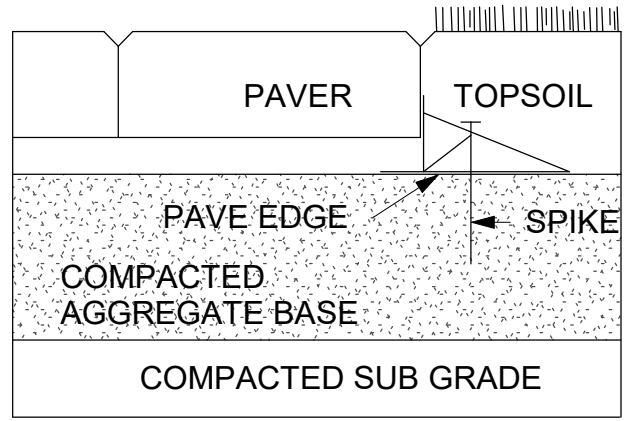


2 DEPRESSION CURB
D1702 Scale: 1 : 10




3 CURB DETAIL AT LANDSCAPED AREA
D1702 Scale: 1 : 10

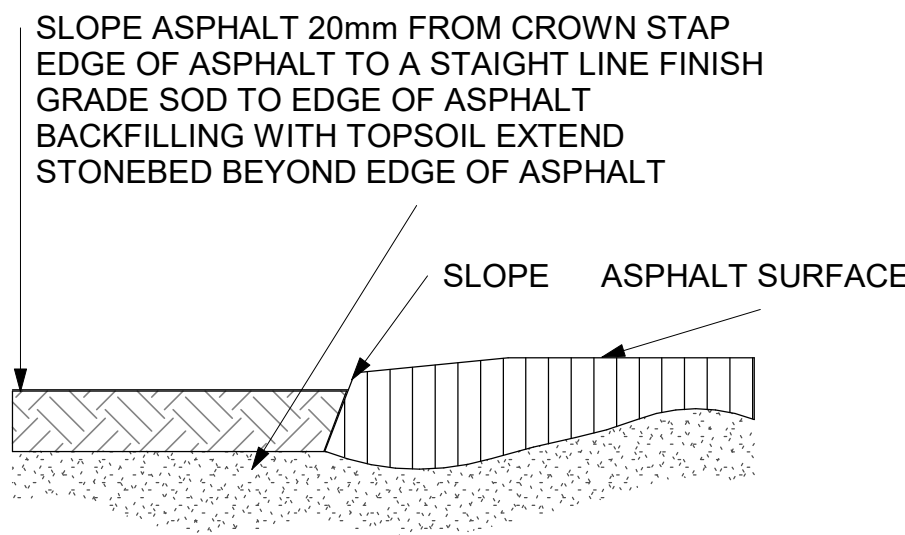


4 ASPHALT EDGE
D1702 Scale: 1 : 10

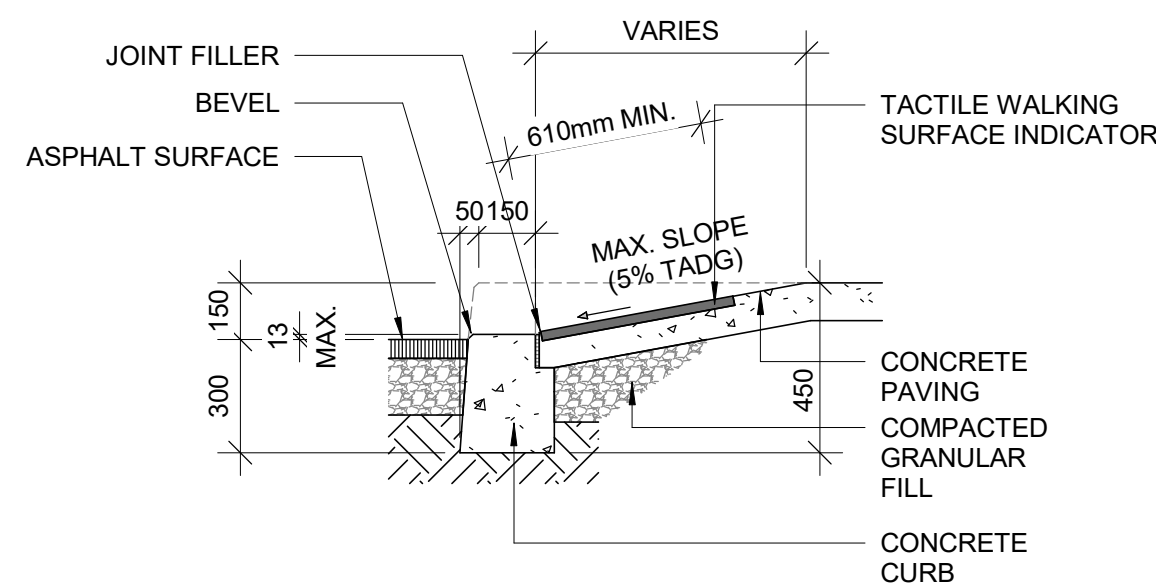

6 CURB RAMP SECTION
D1702 Scale: 1 : 20

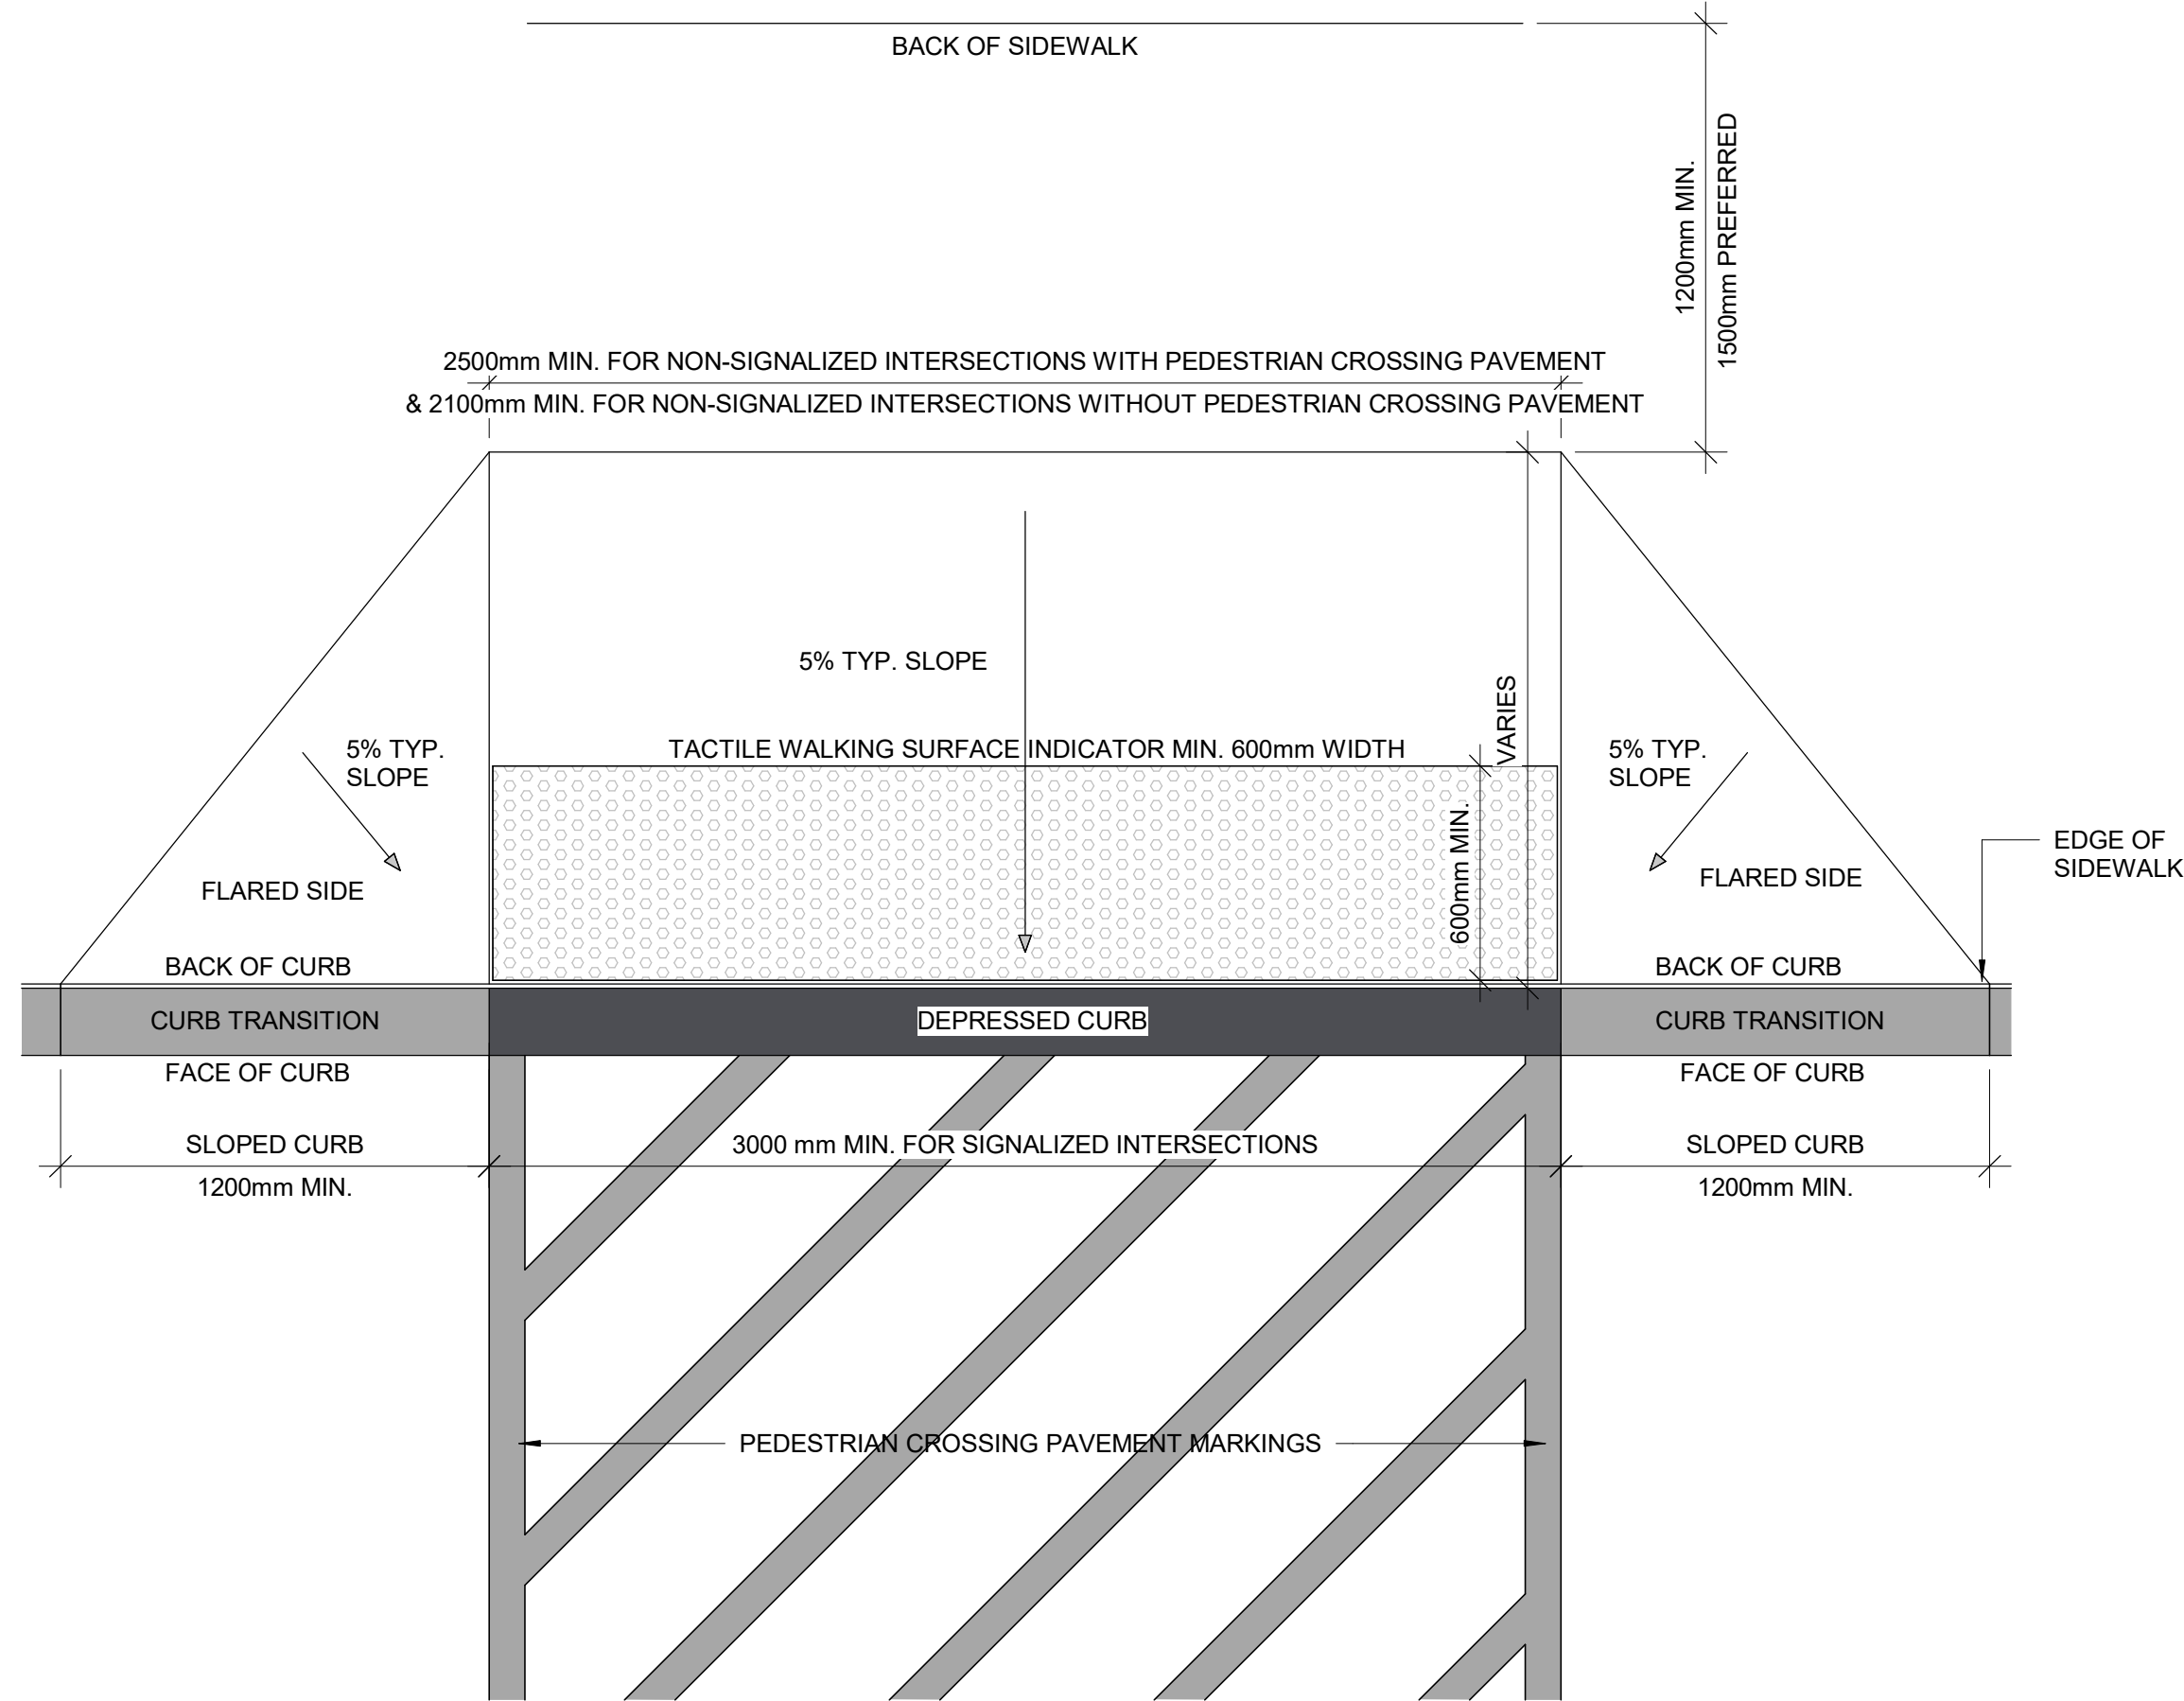

5 LARGE CURB RAMP PLAN
D1702 Scale: 1 : 20

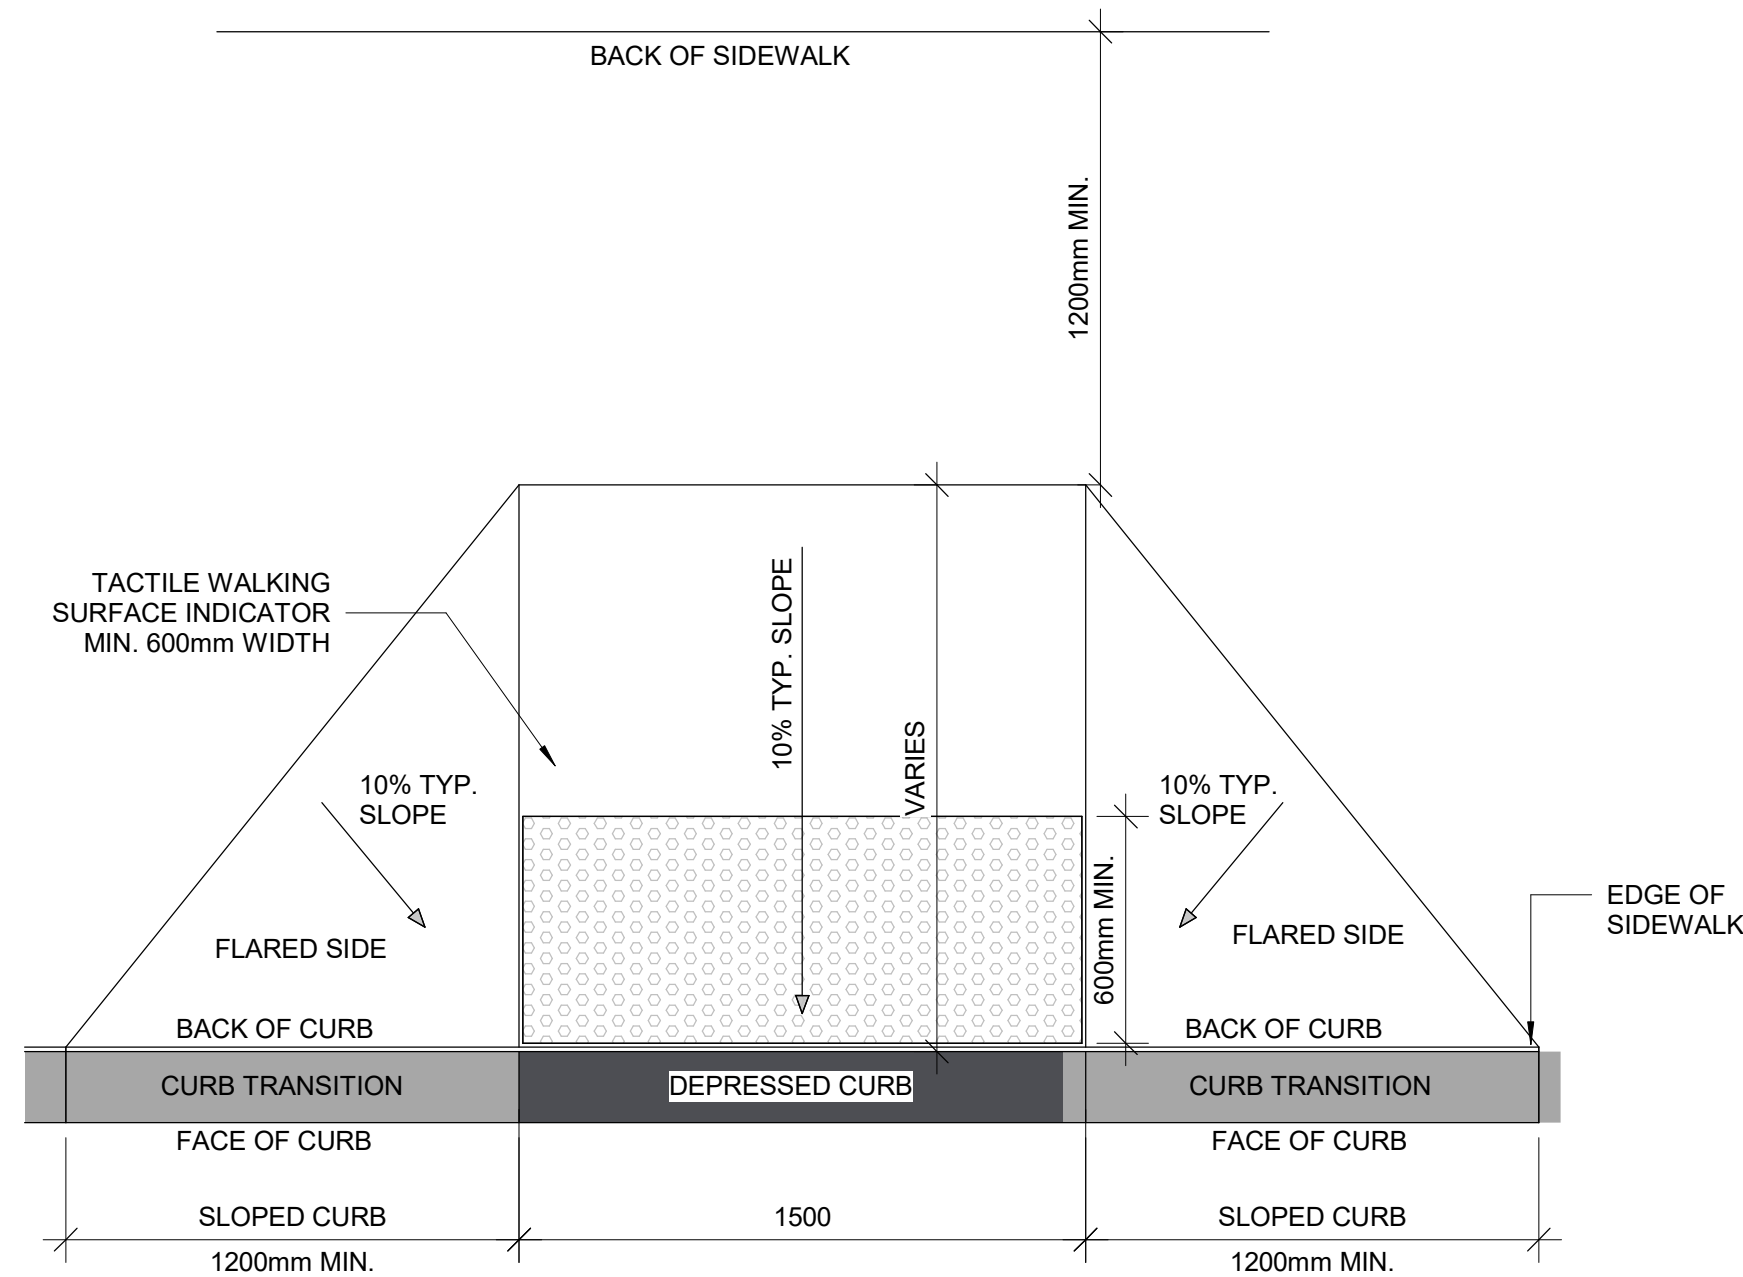


7 CURB RAMP PLAN
D1702 Scale: 1 : 20

ISSUES		
No.	DESCRIPTION	DATE
A	ISSUED FOR TENDER	2025-04-11


CONSULTANTS

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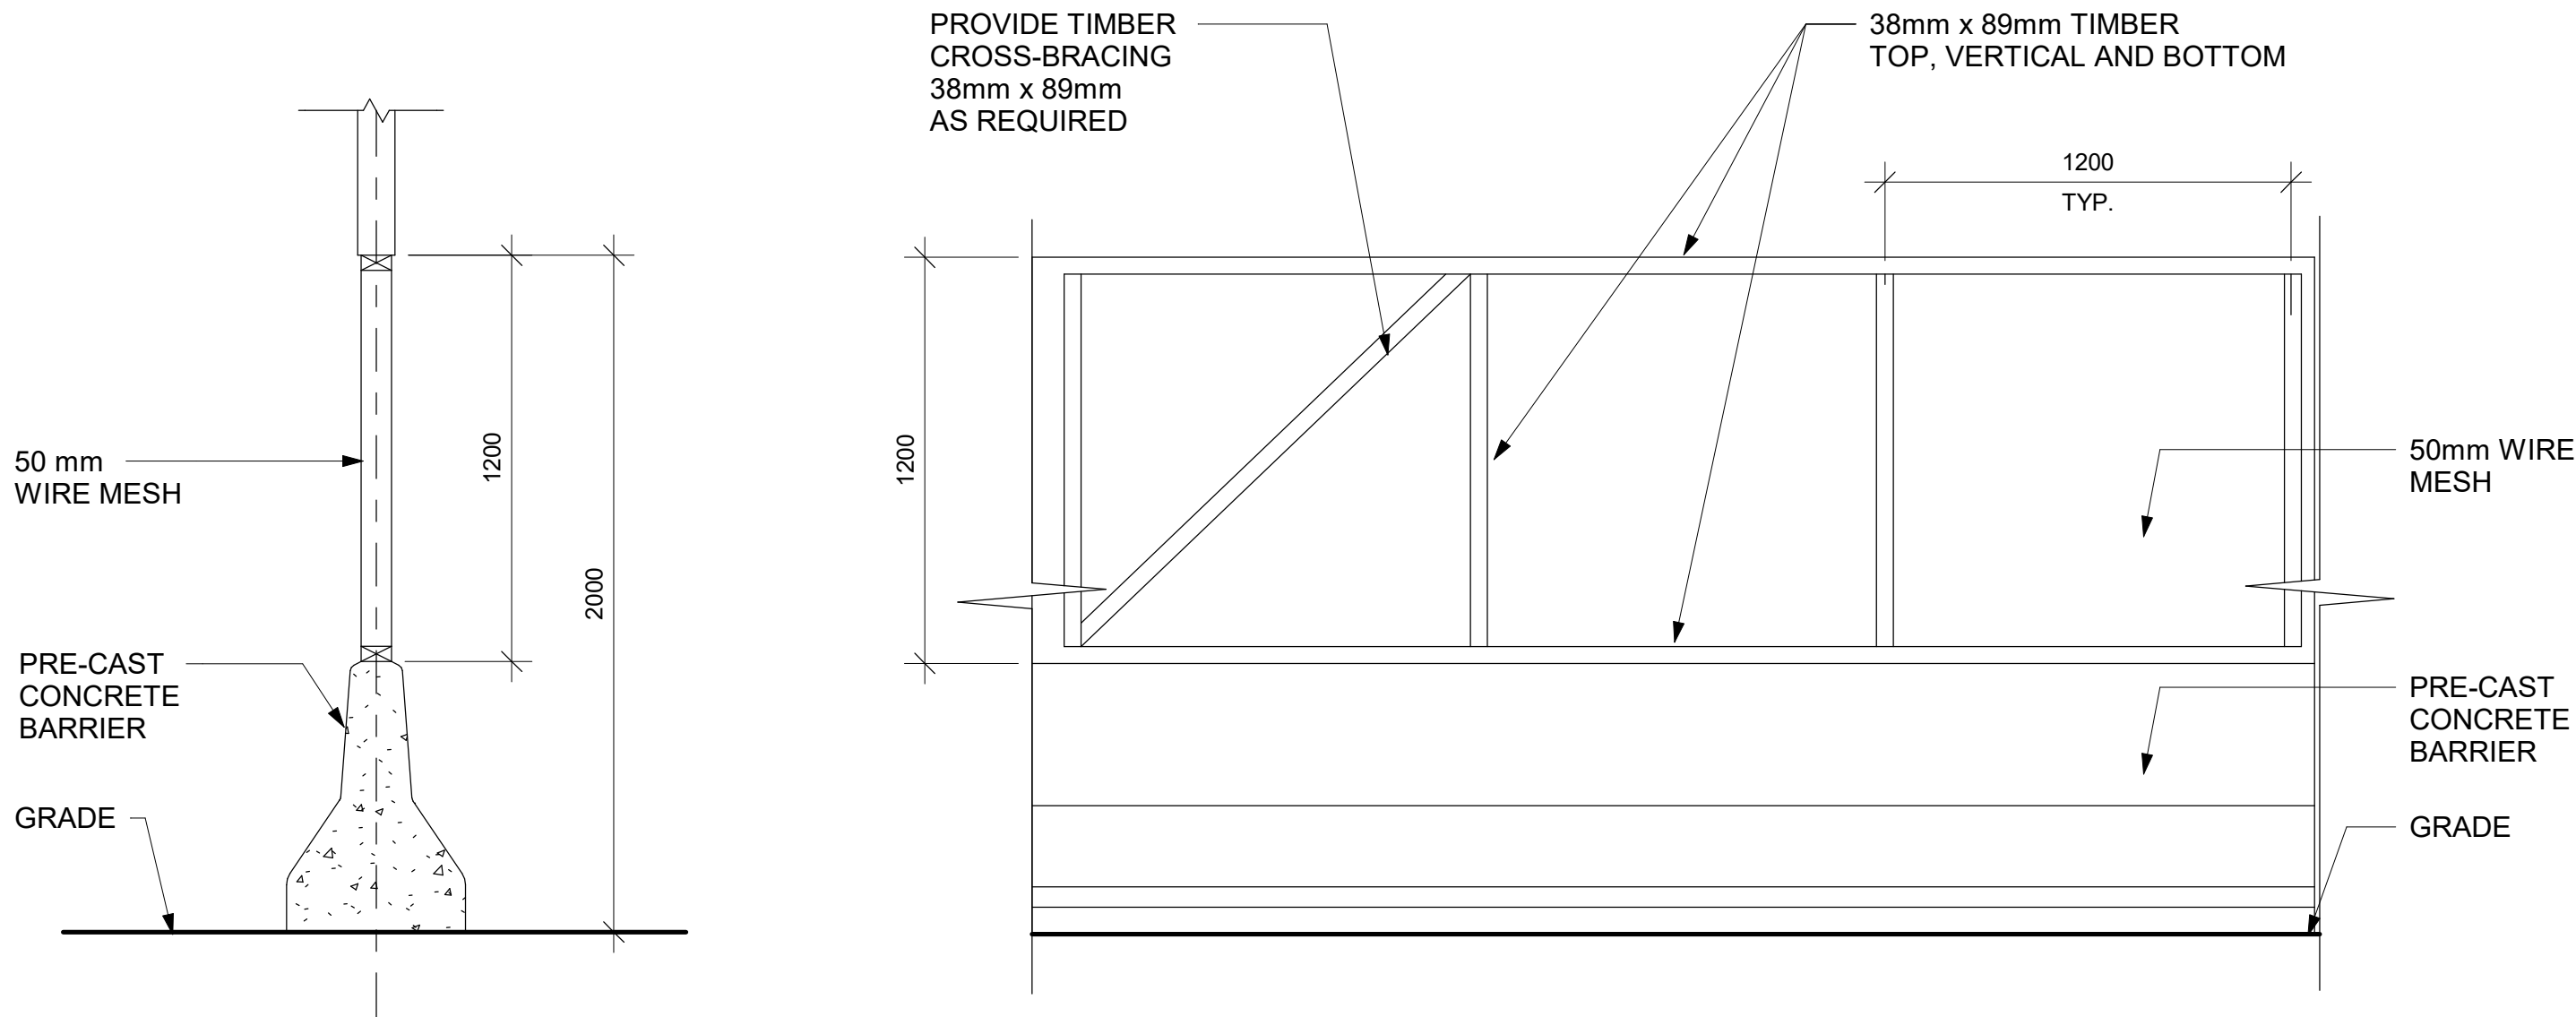
PROJECT ADDRESS

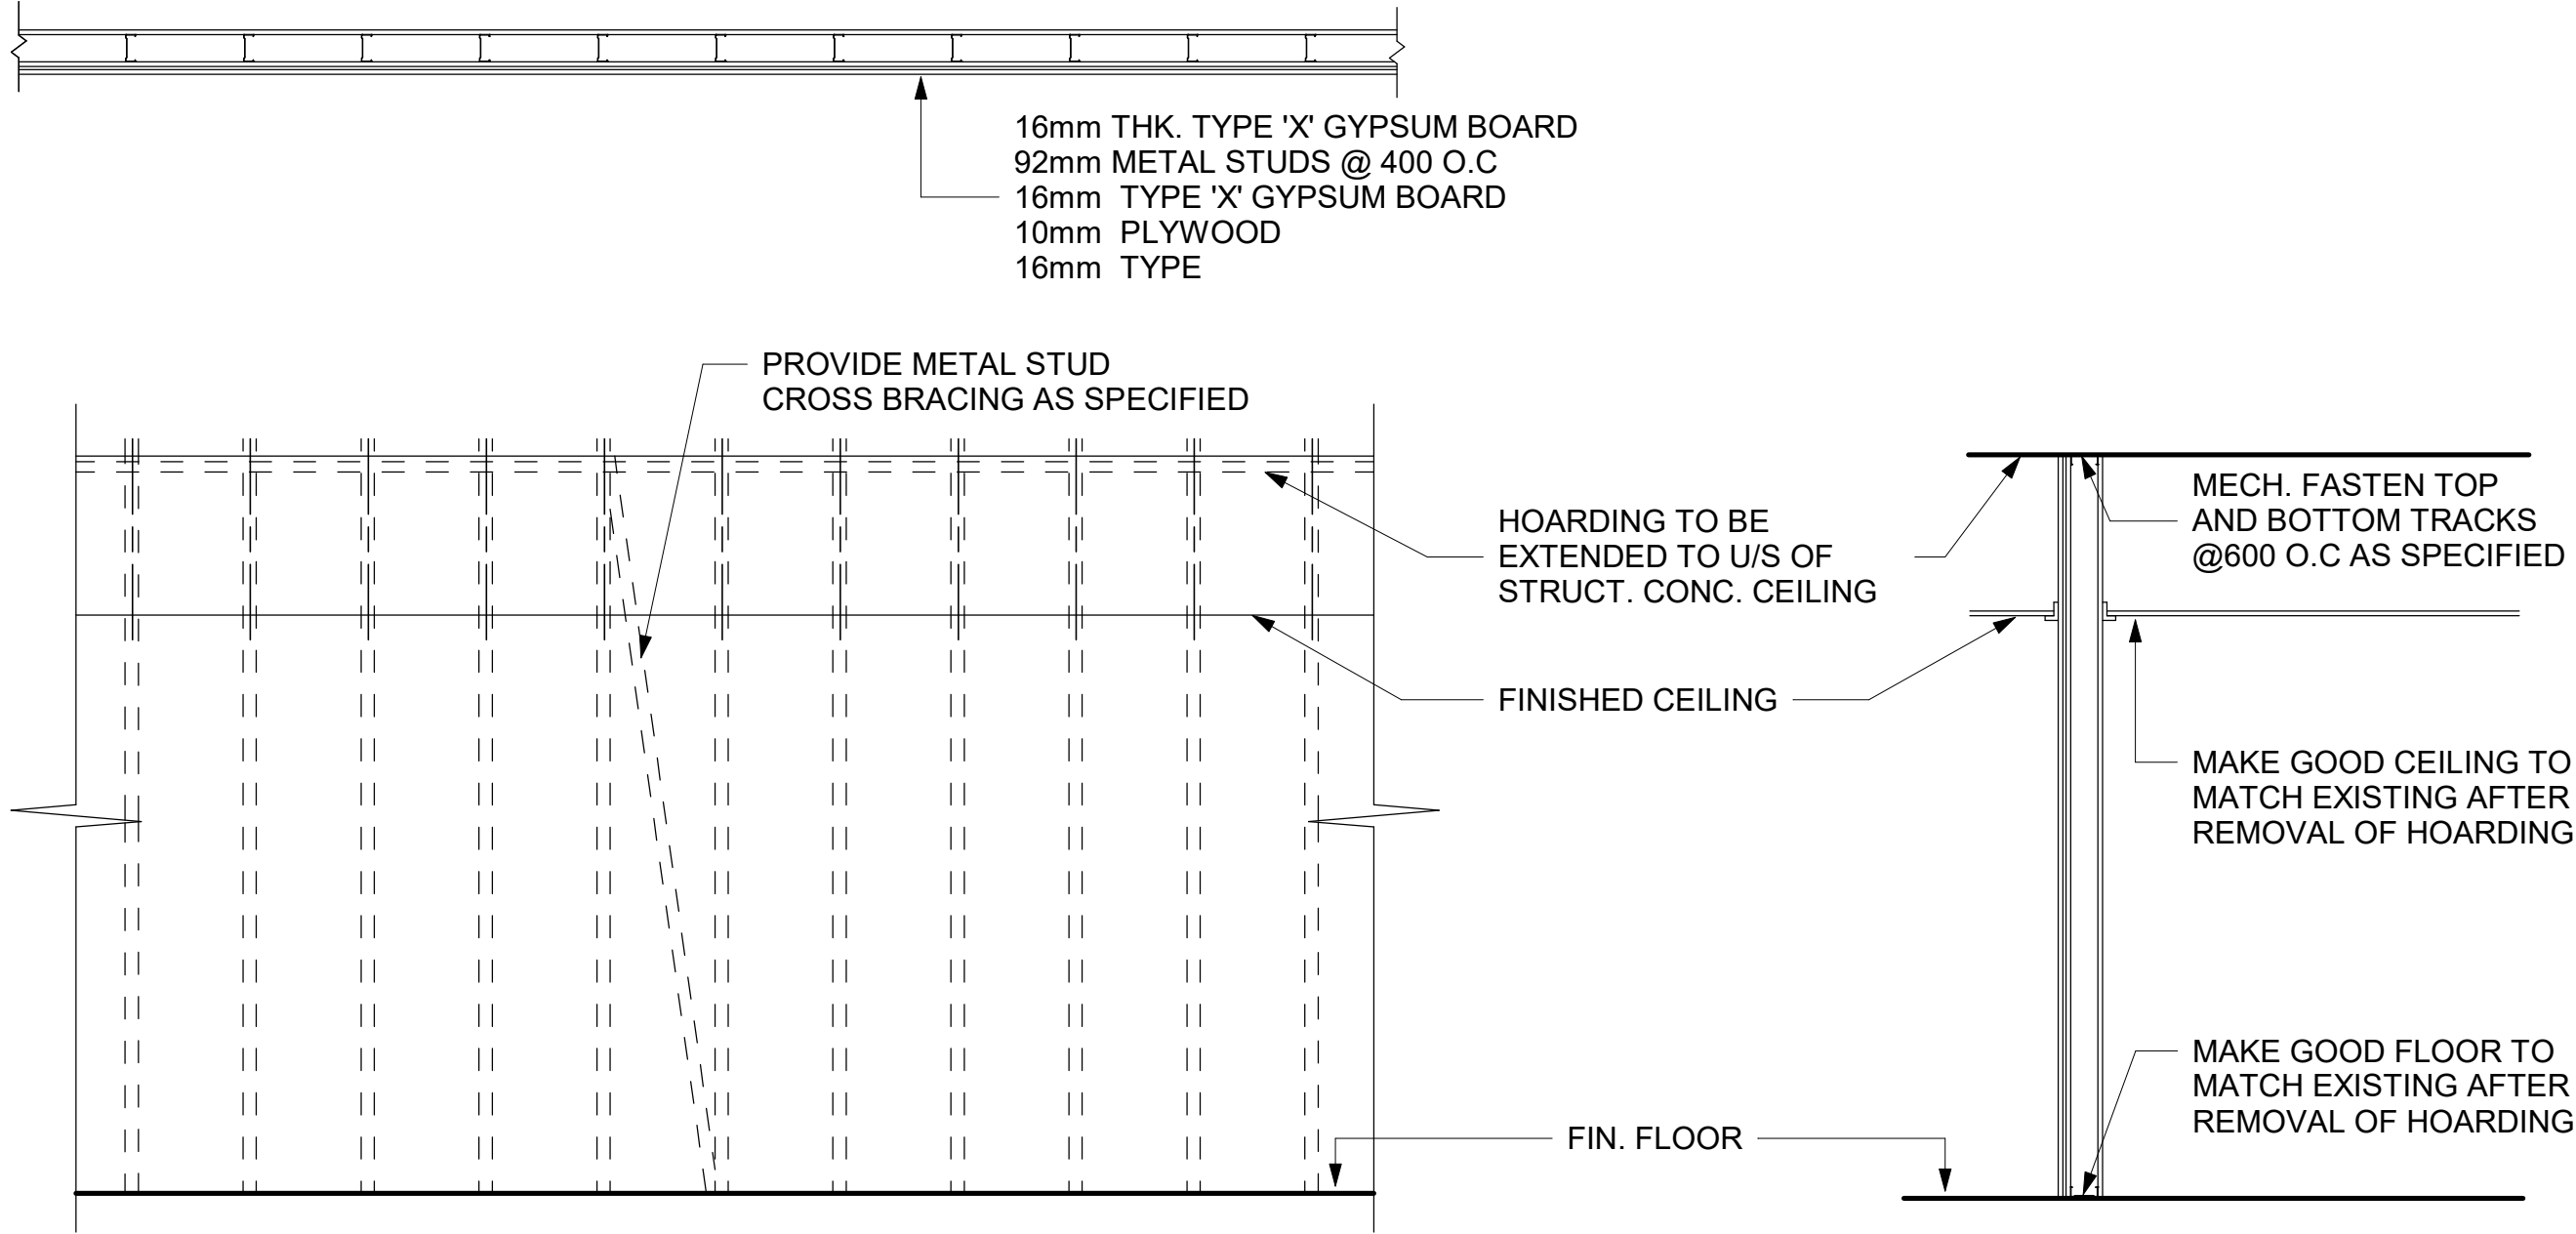

1 PHASING / HOARDING DETAILS 1
D1801 Scale: 1 : 25

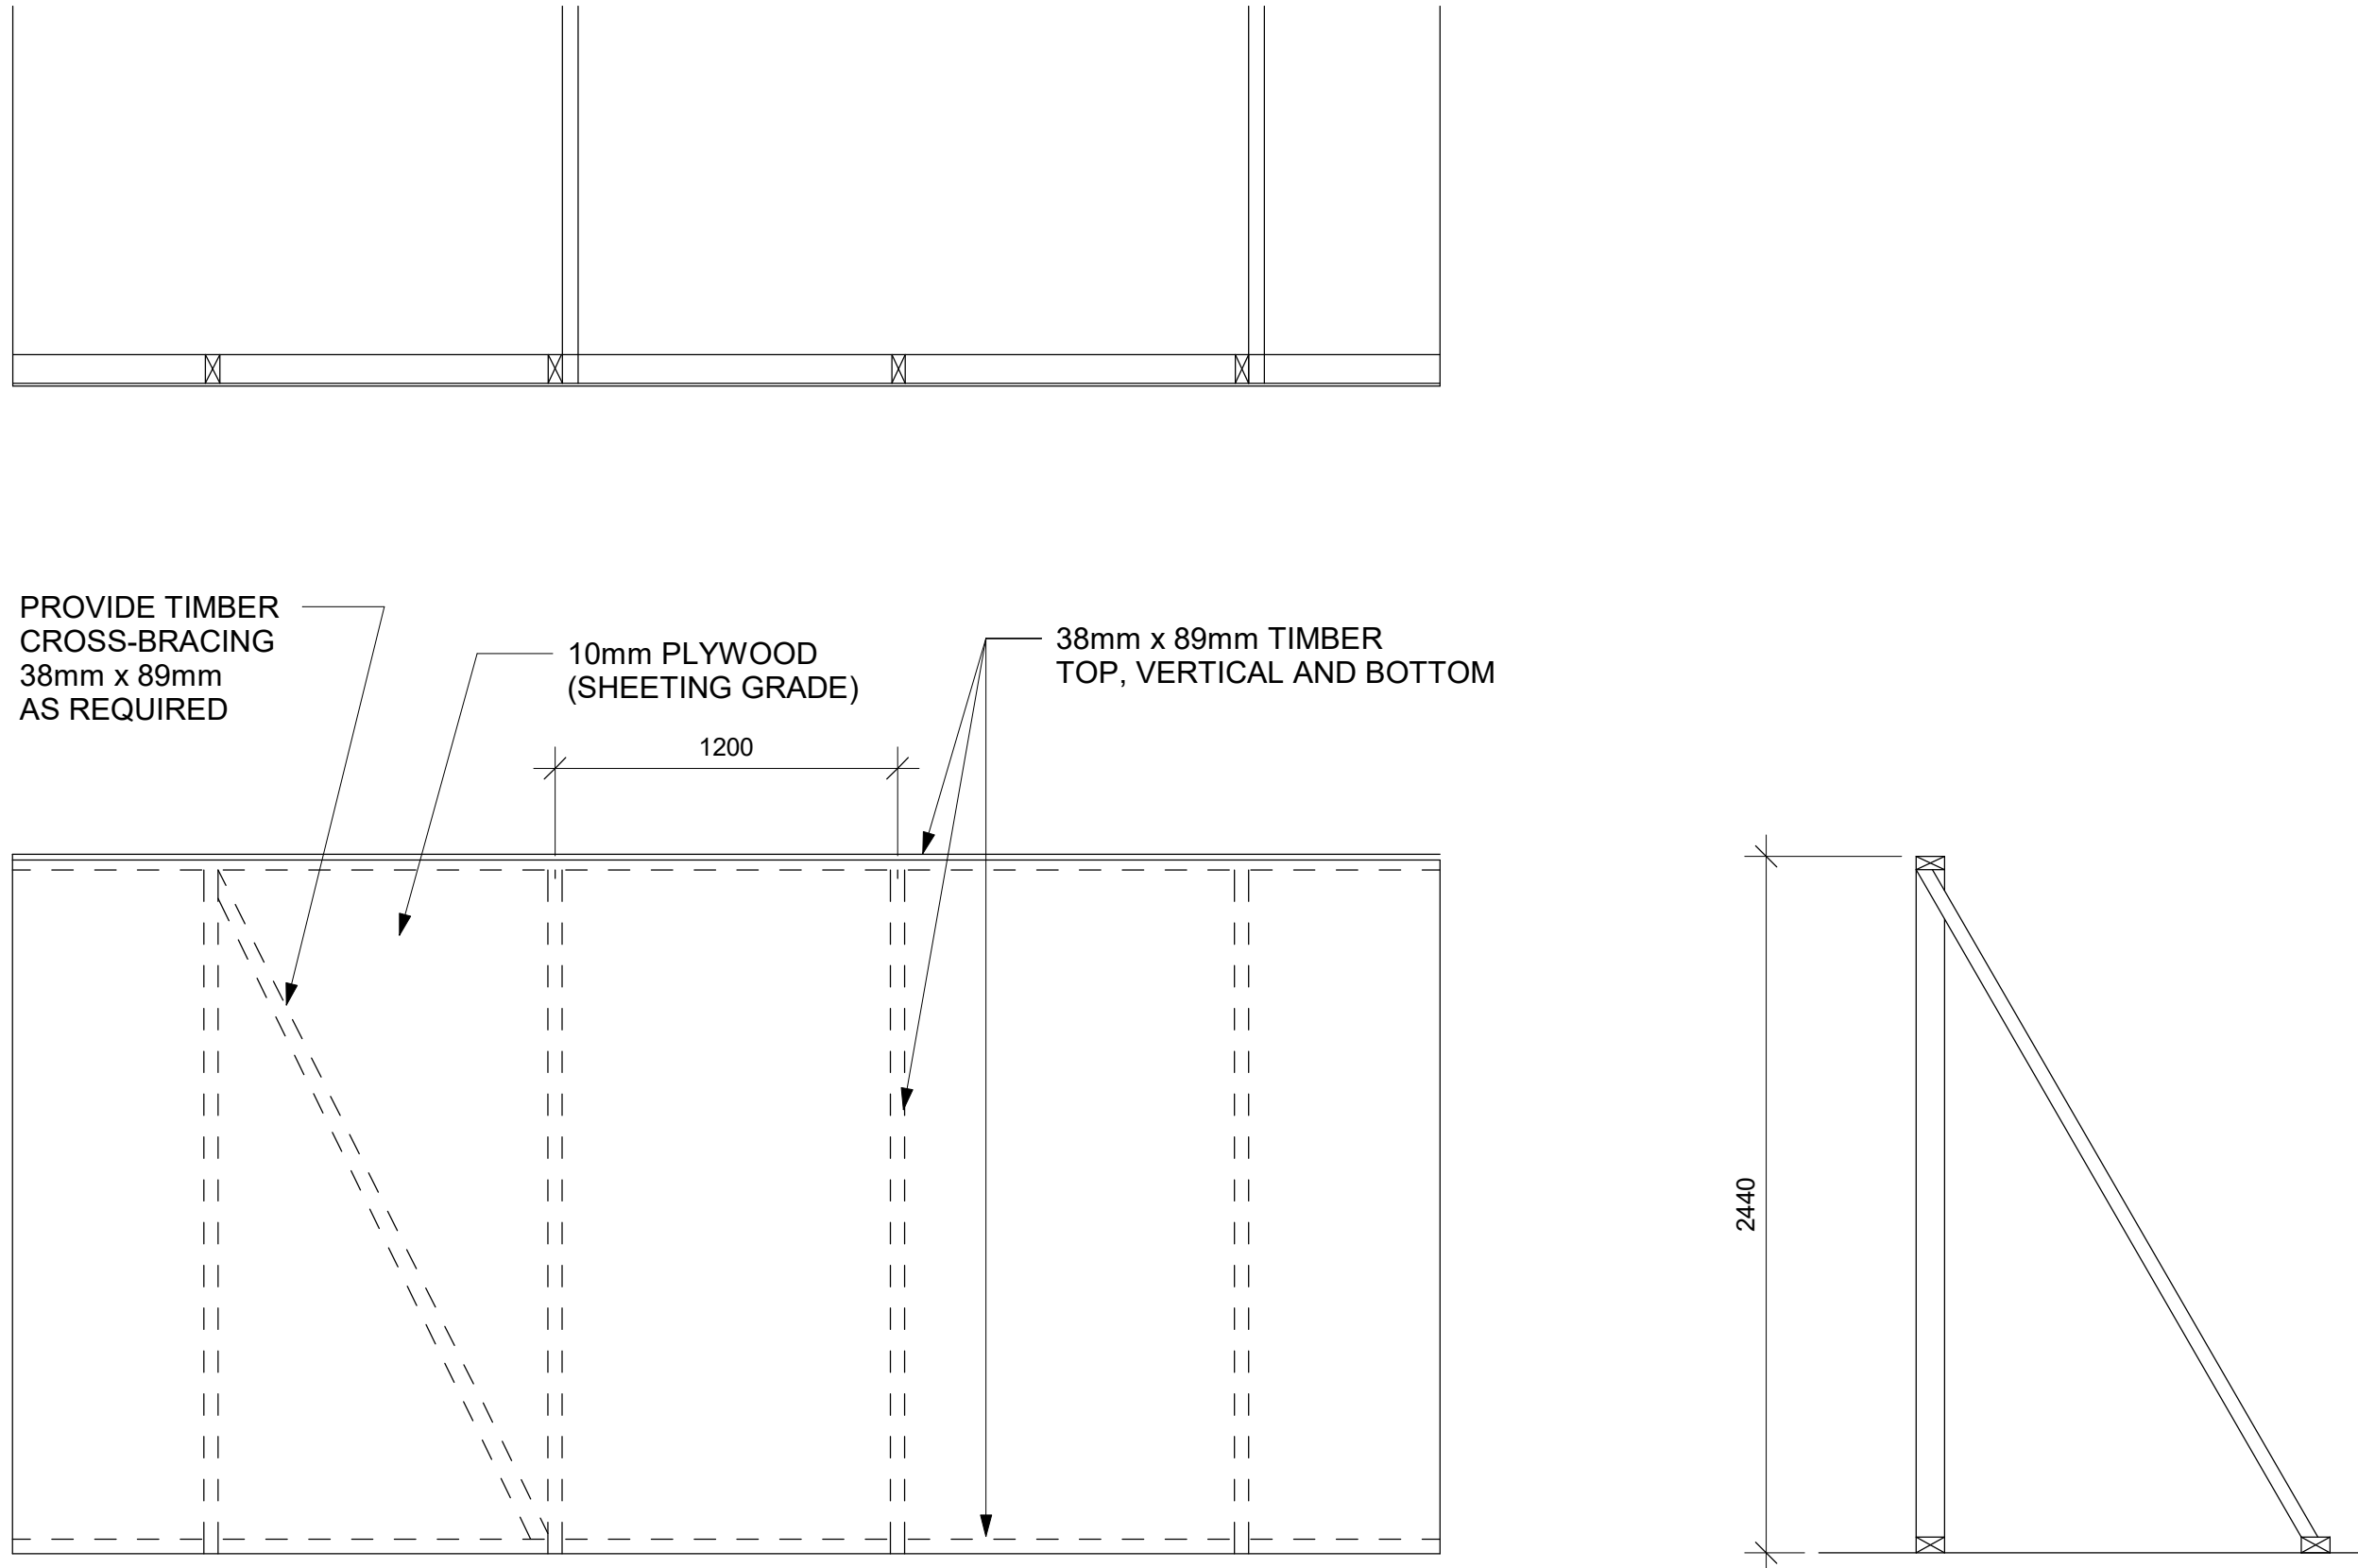

3 PHASING / HOARDING DETAILS 3
D1801 Scale: 1 : 25



2 PHASING / HOARDING DETAILS 2
D1801 Scale: 1 : 20

ISSUES		
No.	DESCRIPTION	DATE
A	ISSUED FOR TENDER	2025-04-11

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www.arcadis.com

PROJECT TITLE
**CITY OF TORONTO
ACCESSIBILITY UPGRADES**

PROJECT ADDRESS


PROJECT NO:
9119- 19- 0162 /Arcadis 30279056
DRAWN BY:
A. BOYNARIAN
PROJECT MGR:
F. BOLOURIAN
CHECKED BY:
K. TILAHUN
APPROVED BY:
E. FENUTA

SHEET TITLE
HOARDING DETAILS

SHEET NUMBER D1801	ISSUE A
------------------------------	-------------------

ABCDEFGHIJKLMNOPQRSTUVWXYZ
abcdefghijklmnopqrstuvwxyz
1234567890

ABCDEFGHIJKLMNOPQRSTUVWXYZ
abcdefghijklmnopqrstuvwxyz
1234567890





FRONT VIEW



- Overall width: 680 mm
- Overall height: 970 mm
- Top section height: 150 mm
- Text "South Entrance" height: 150 mm
- Wheelchair symbol diameter: 450 mm
- Callout 1: Zero-thick **clear panel** (PFI-236 AGC) with tactile pins, message & logo. Surface and letters painted in MattBlack Paint WP1-11521. Frontal Blue-Semi-gloss Finish. Spots mounted on convex clear surface with 3M VHS Clearing Tape and Edgelo.
- Callout 2: Tactile graphics, message and line painted in WP1-22111 White-Roller Semi-gloss Finish on the flat surface.
- Callout 3: Do not use **STAMP PAINT** for Exterior signs, have to be painted.
- Callout 4: Grade 1 Braille, colour to match background.
- Bottom section height: 150 mm
- Text "H&J ACCESSIBLE ENTRANCE © - EXTERIOR SCALE 1:1" at bottom.

TOP VIEW

- Width: 195 mm
- Height: 2 mm



SIDE VIEW

- Thickness: 2 mm

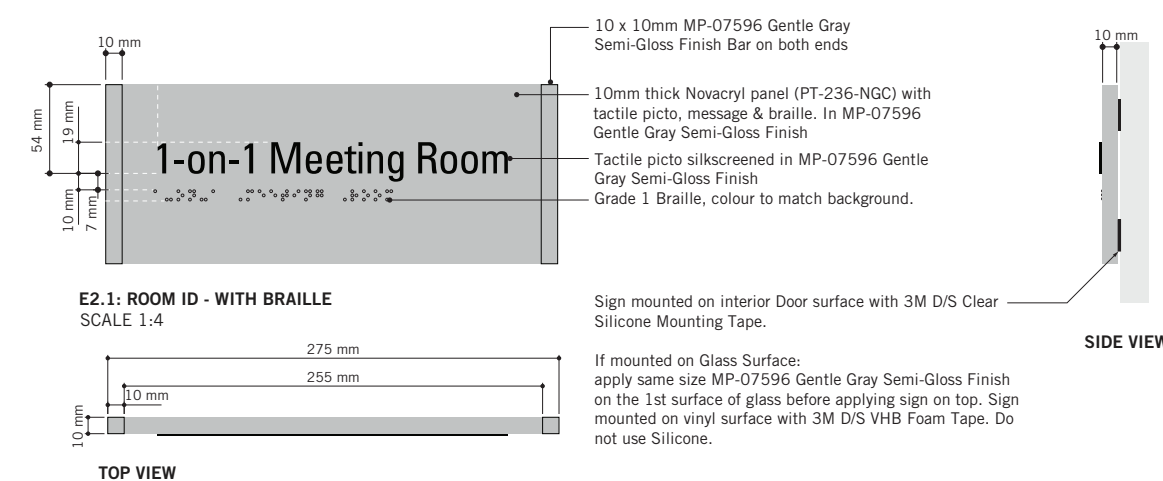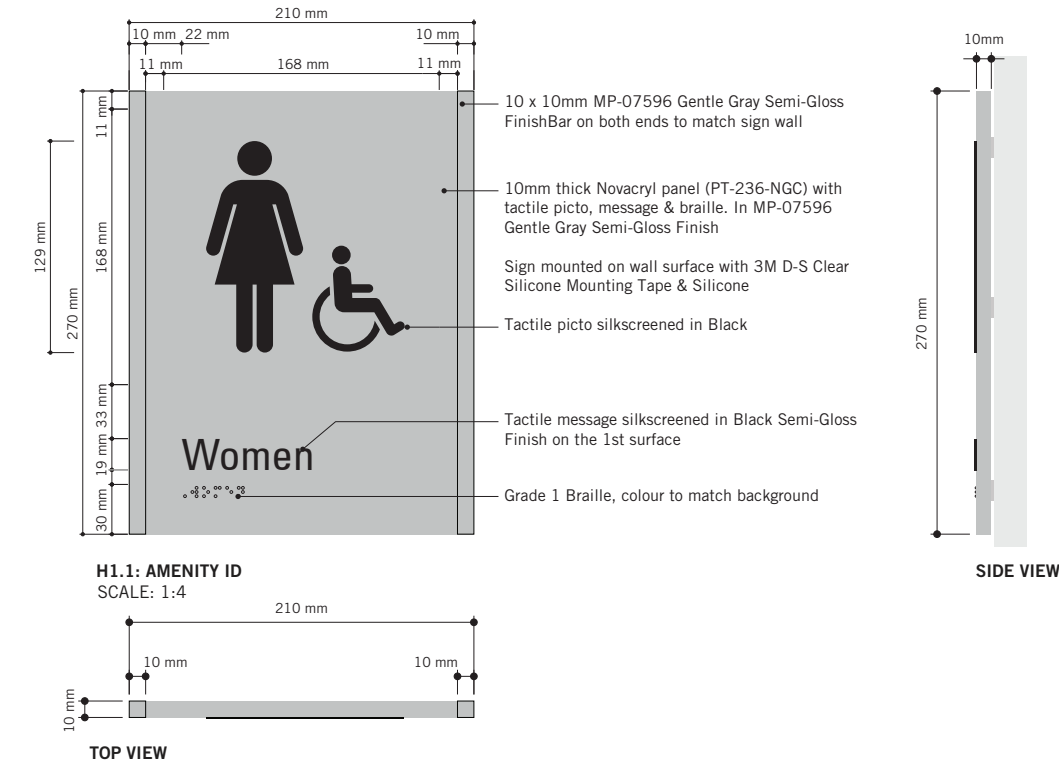


Note:
Typical colours for all Toronto Police
Service Standards building upgrades.

ISSUES		
No.	DESCRIPTION	DATE
A	ISSUED FOR TENDER	2025-04-11

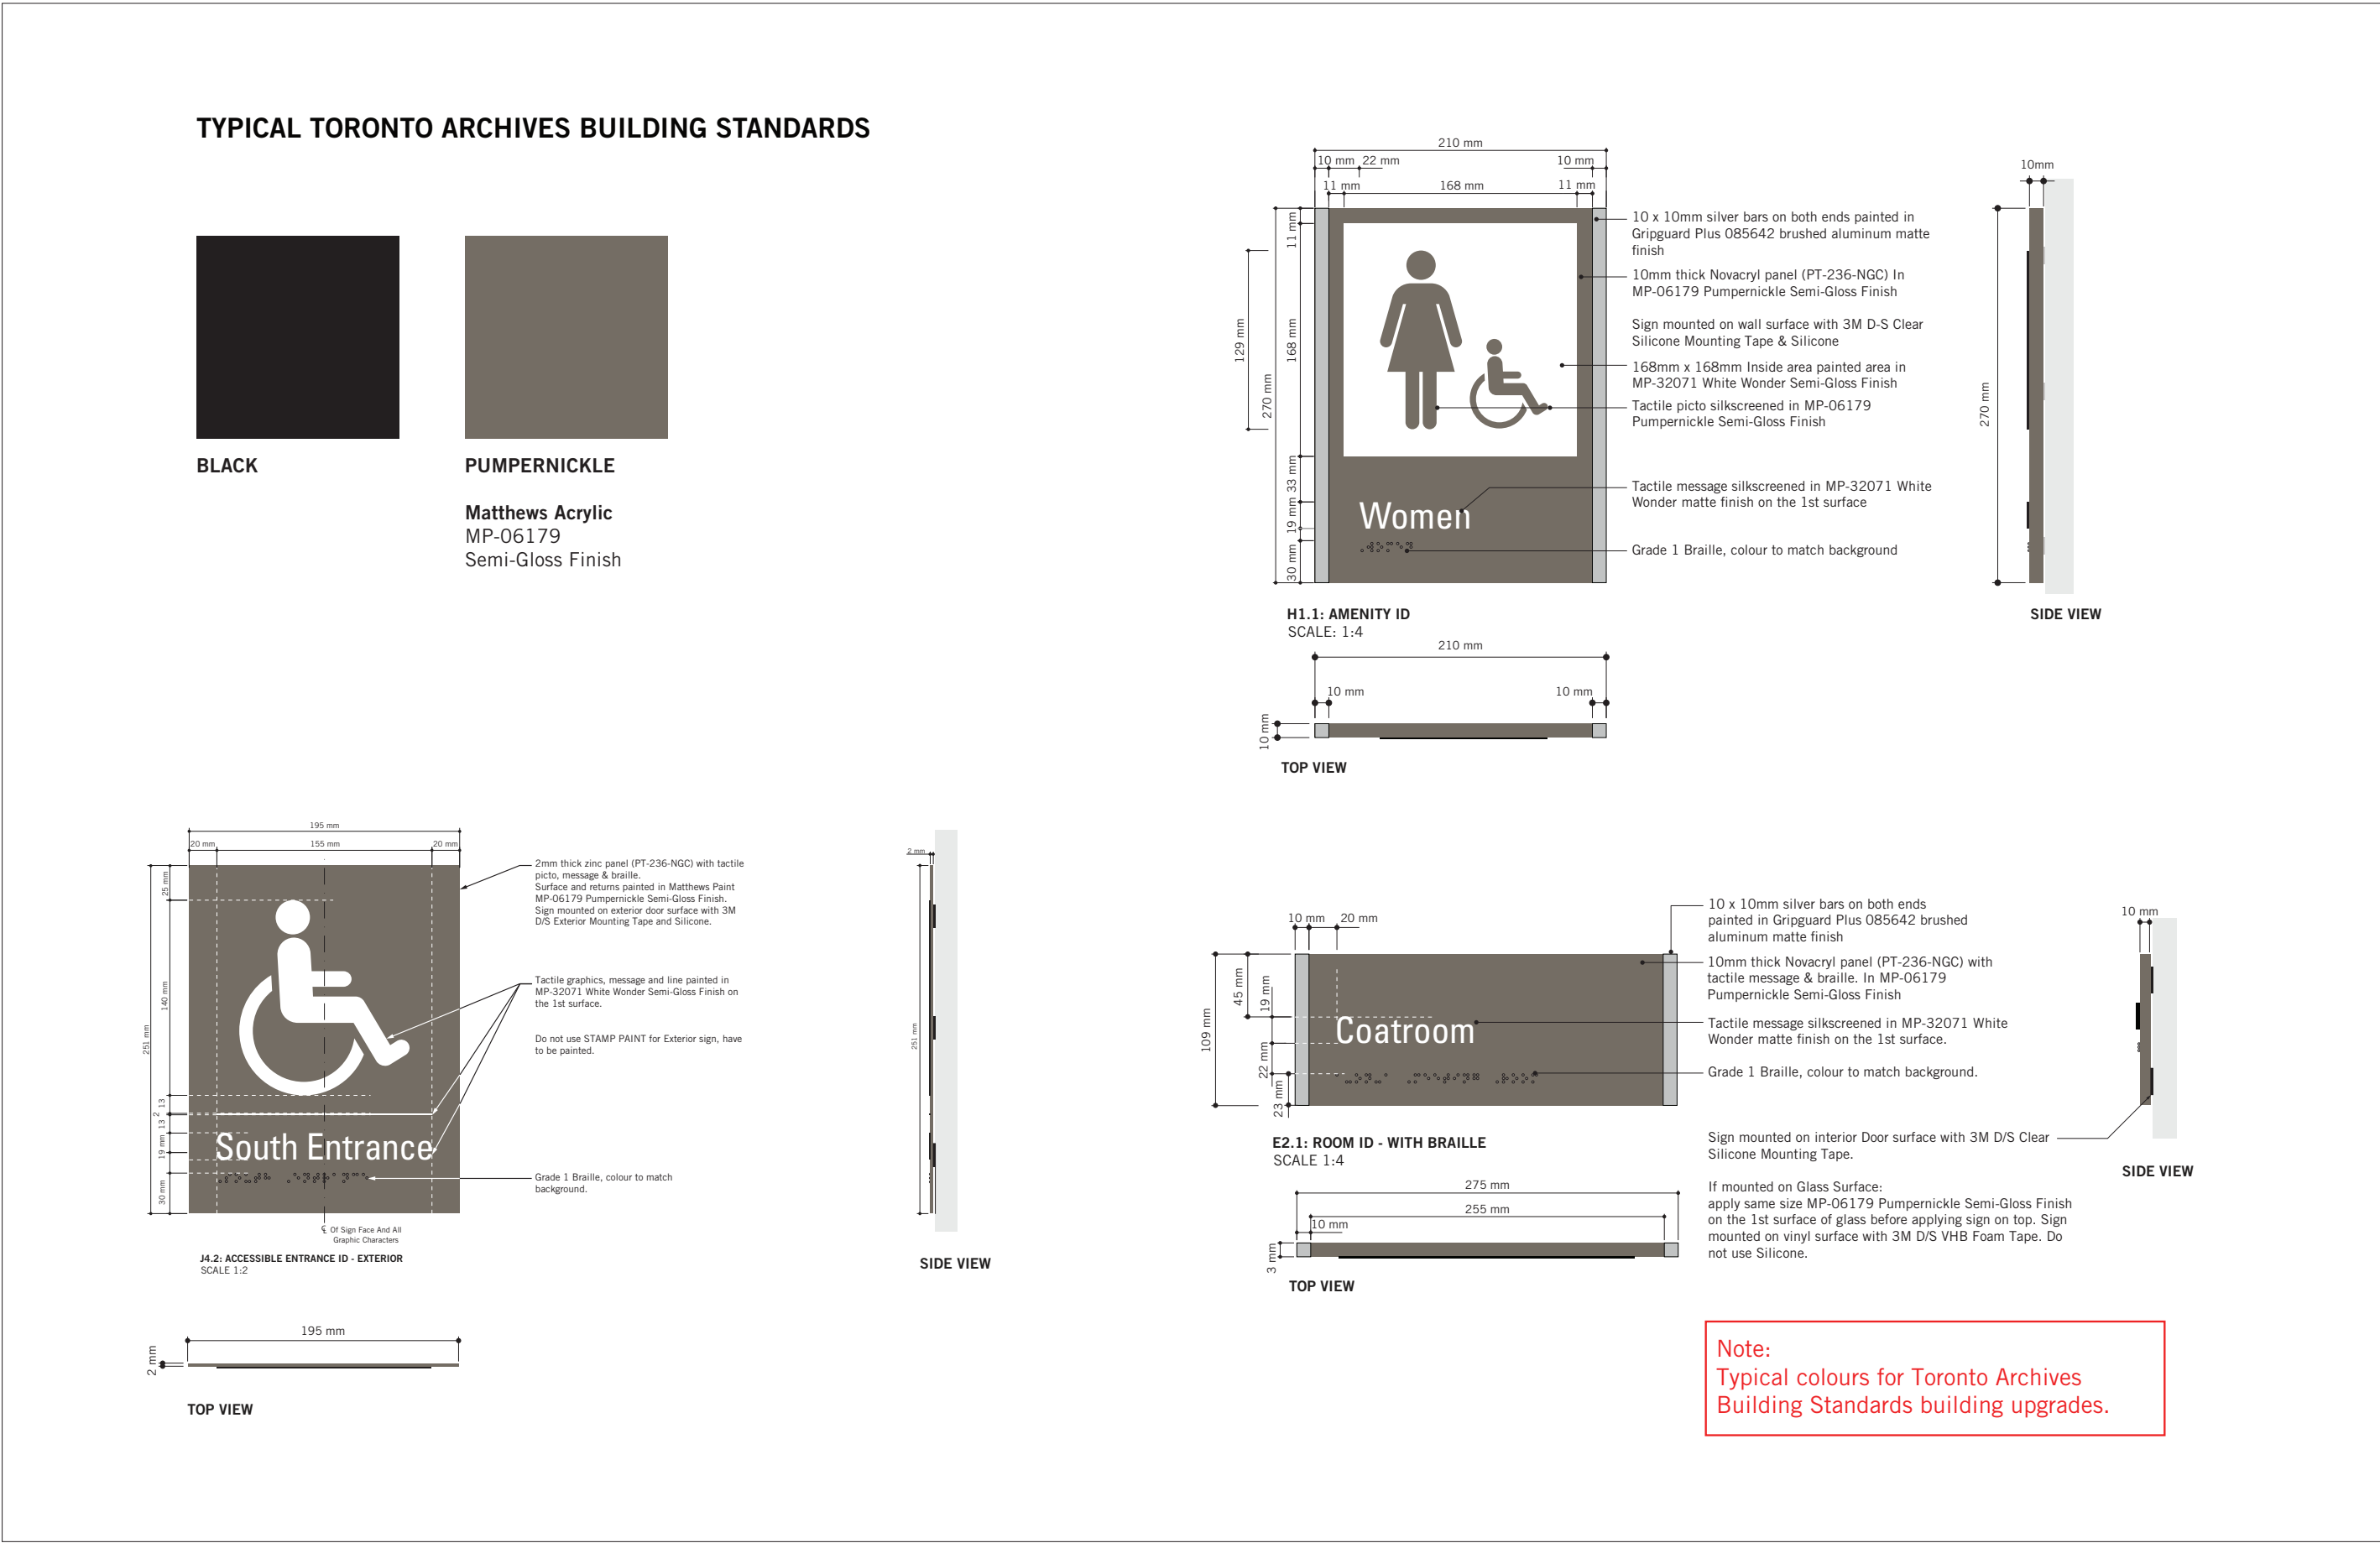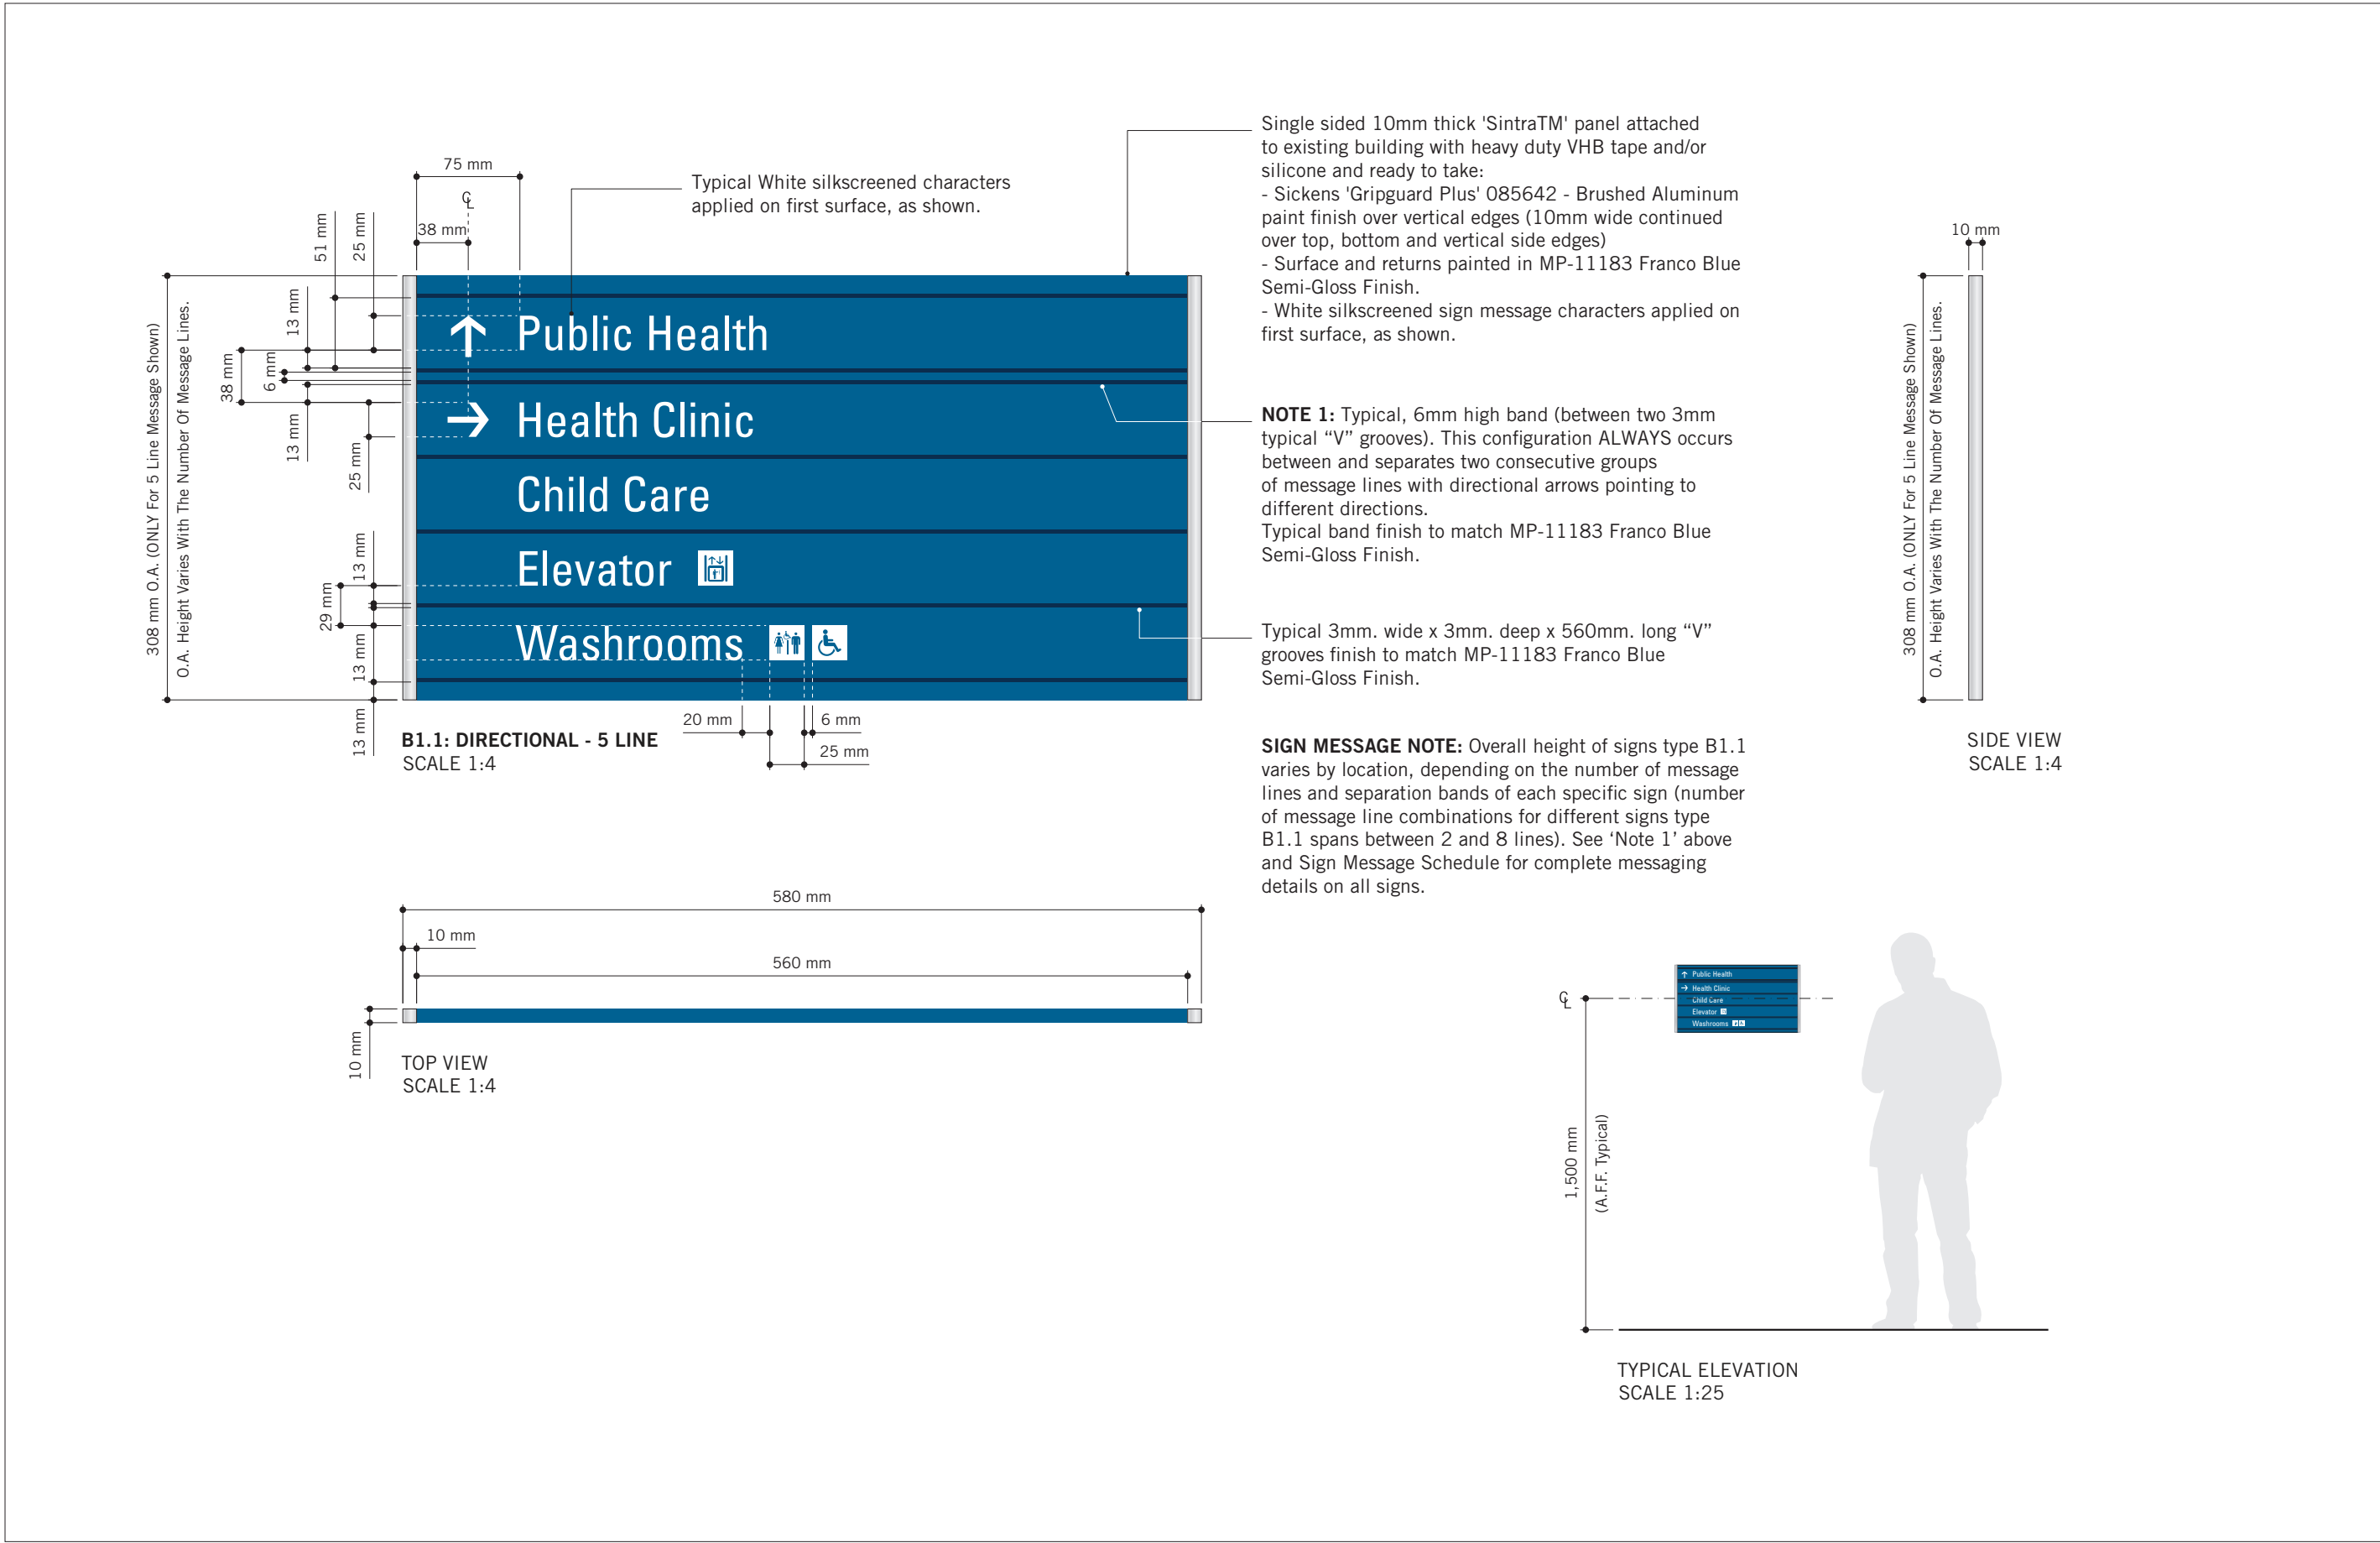

CLIENT

CITY OF TORONTO



55 John ST.
TORONTO, ON
M5V 3C6

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
ISSUES

No.	DESCRIPTION	DATE
A	ISSUED FOR TENDER	2025-04-11

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www.arcadis.com

PROJECT TITLE

CITY OF TORONTO
ACCESSIBILITY UPGRADES

PROJECT ADDRESS

GROUP 05 BUILDINGS

PROJECT NO:
9119 – 19 – 0162 / Arcadis 30279056




DRAWN BY: M. LOW	CHECKED BY: C.D. SCHNOBB
PROJECT MGR: R. DALY	APPROVED BY:

SHEET TITLE

SIGNAGE & WAYFINDING
DETAILS

B1.1: DIRECTIONAL SIGNAGE

SHEET NUMBER	ISSUE
D1902	A

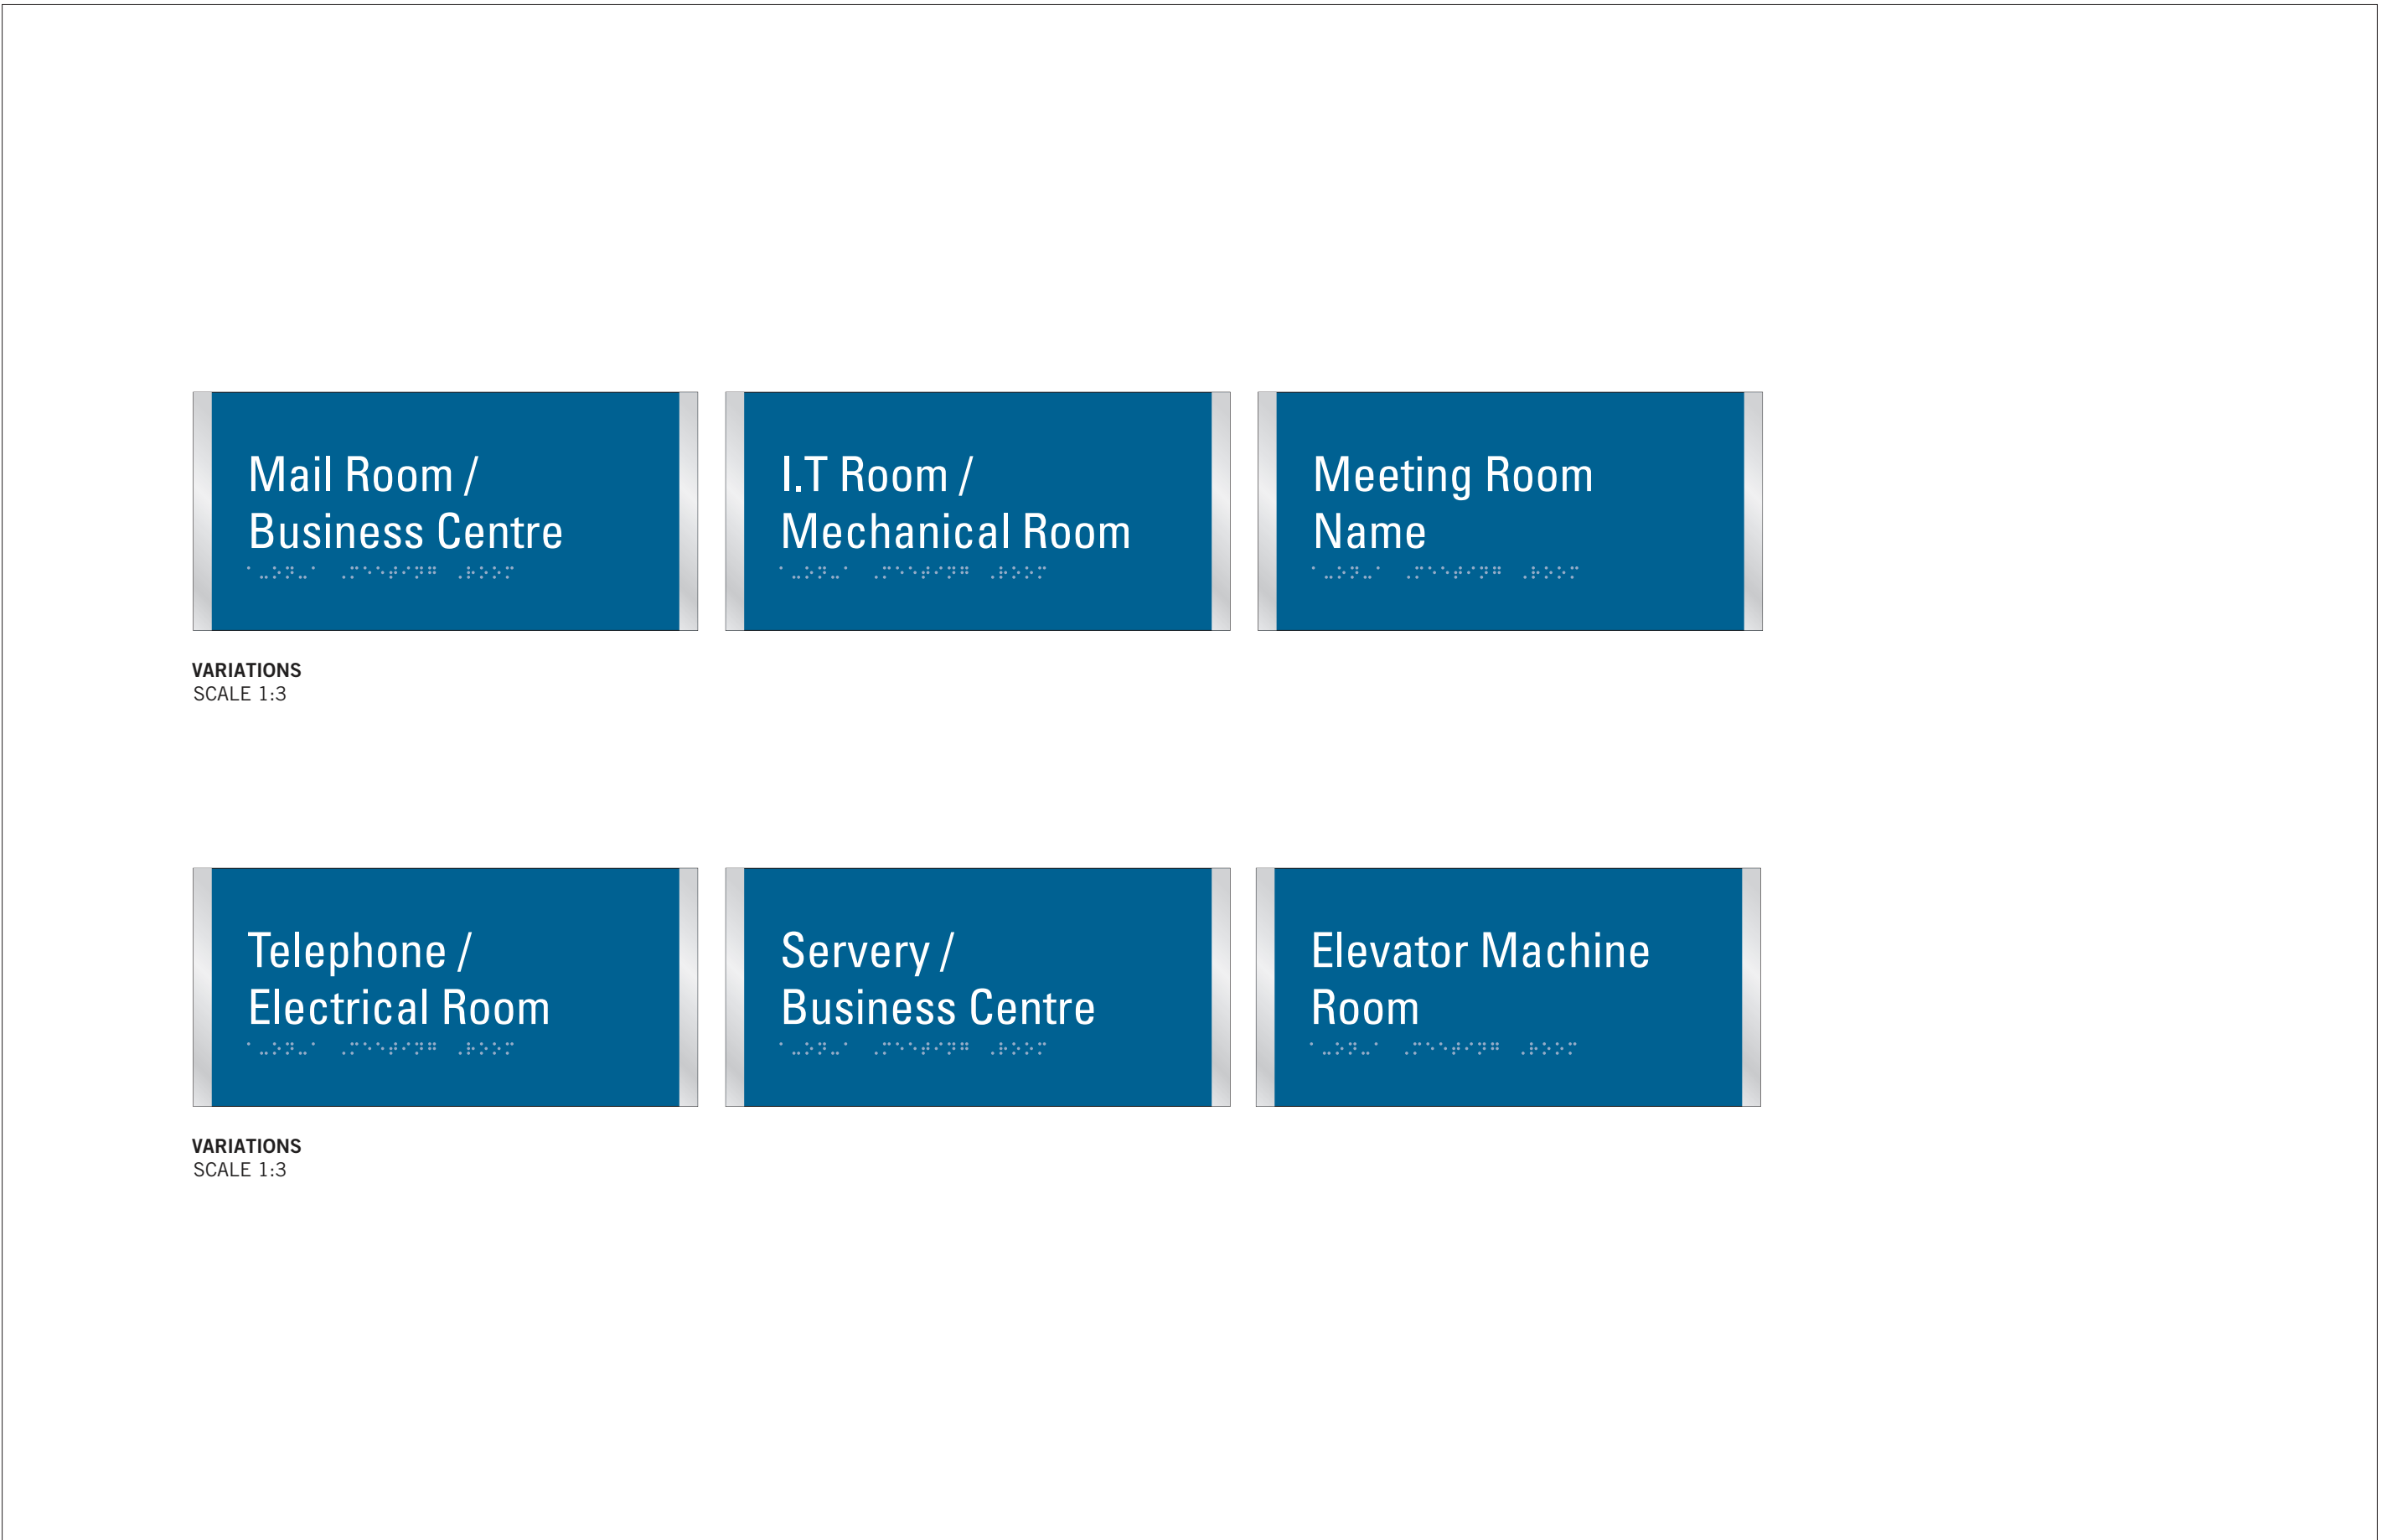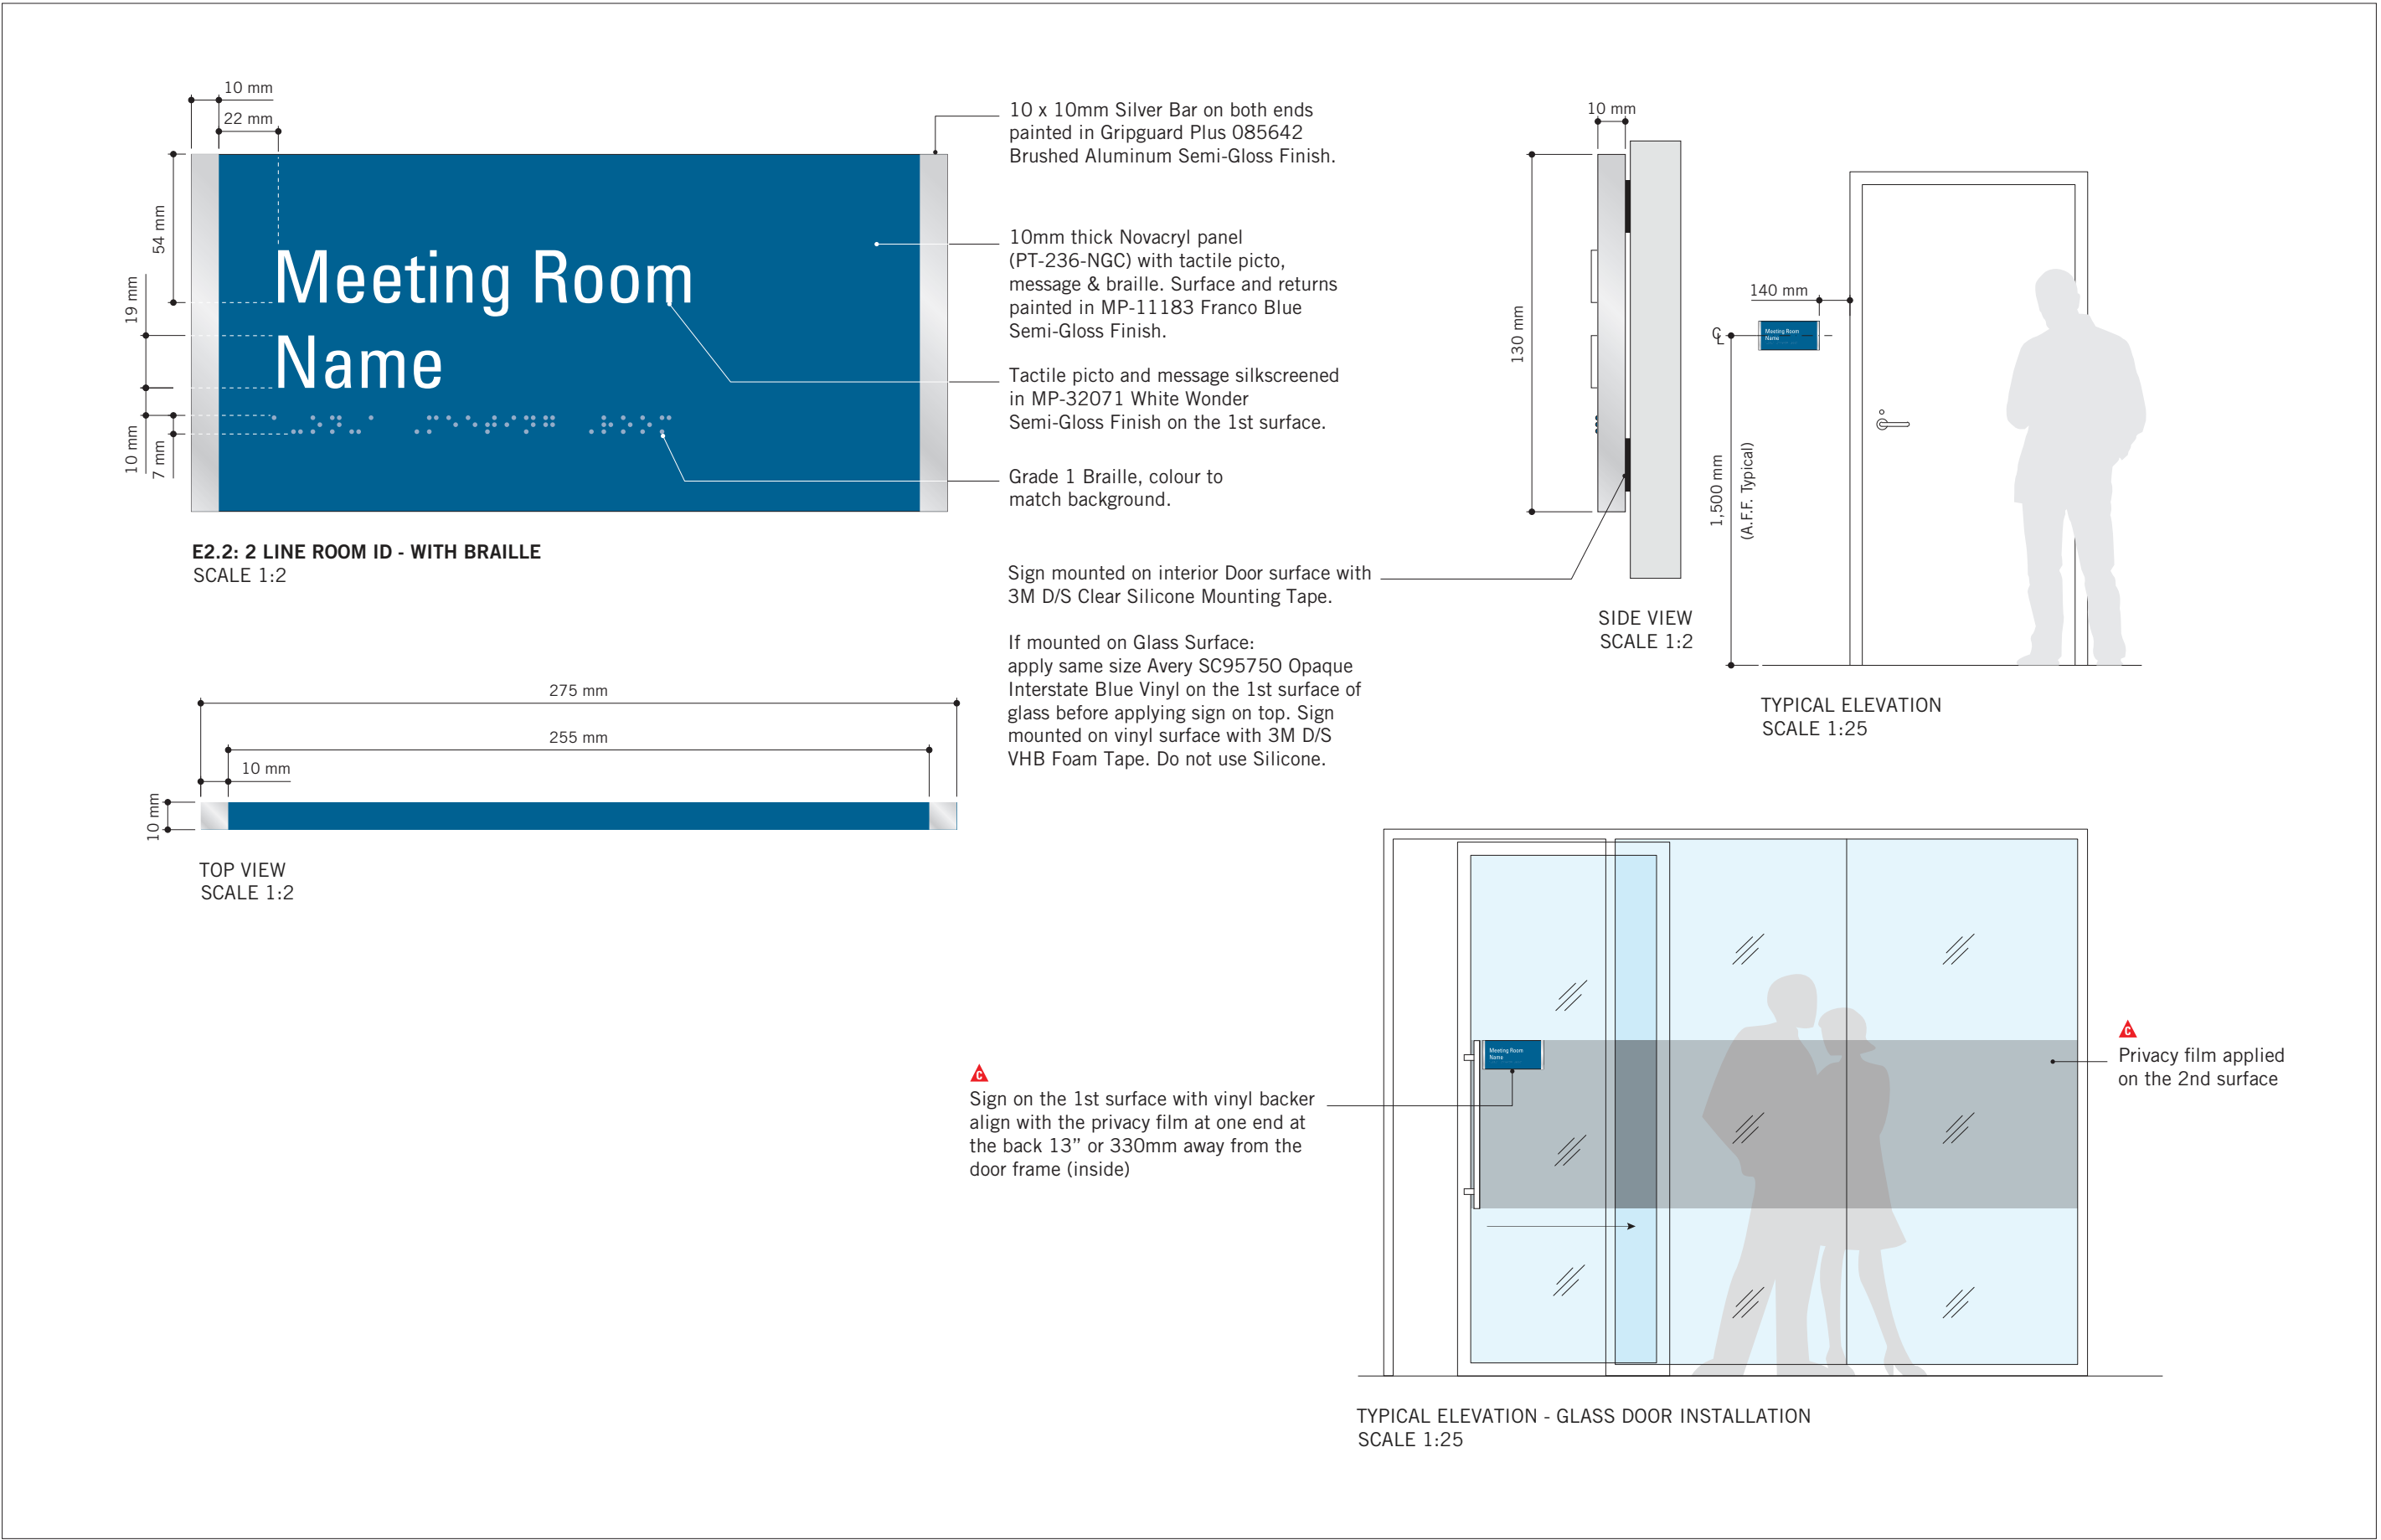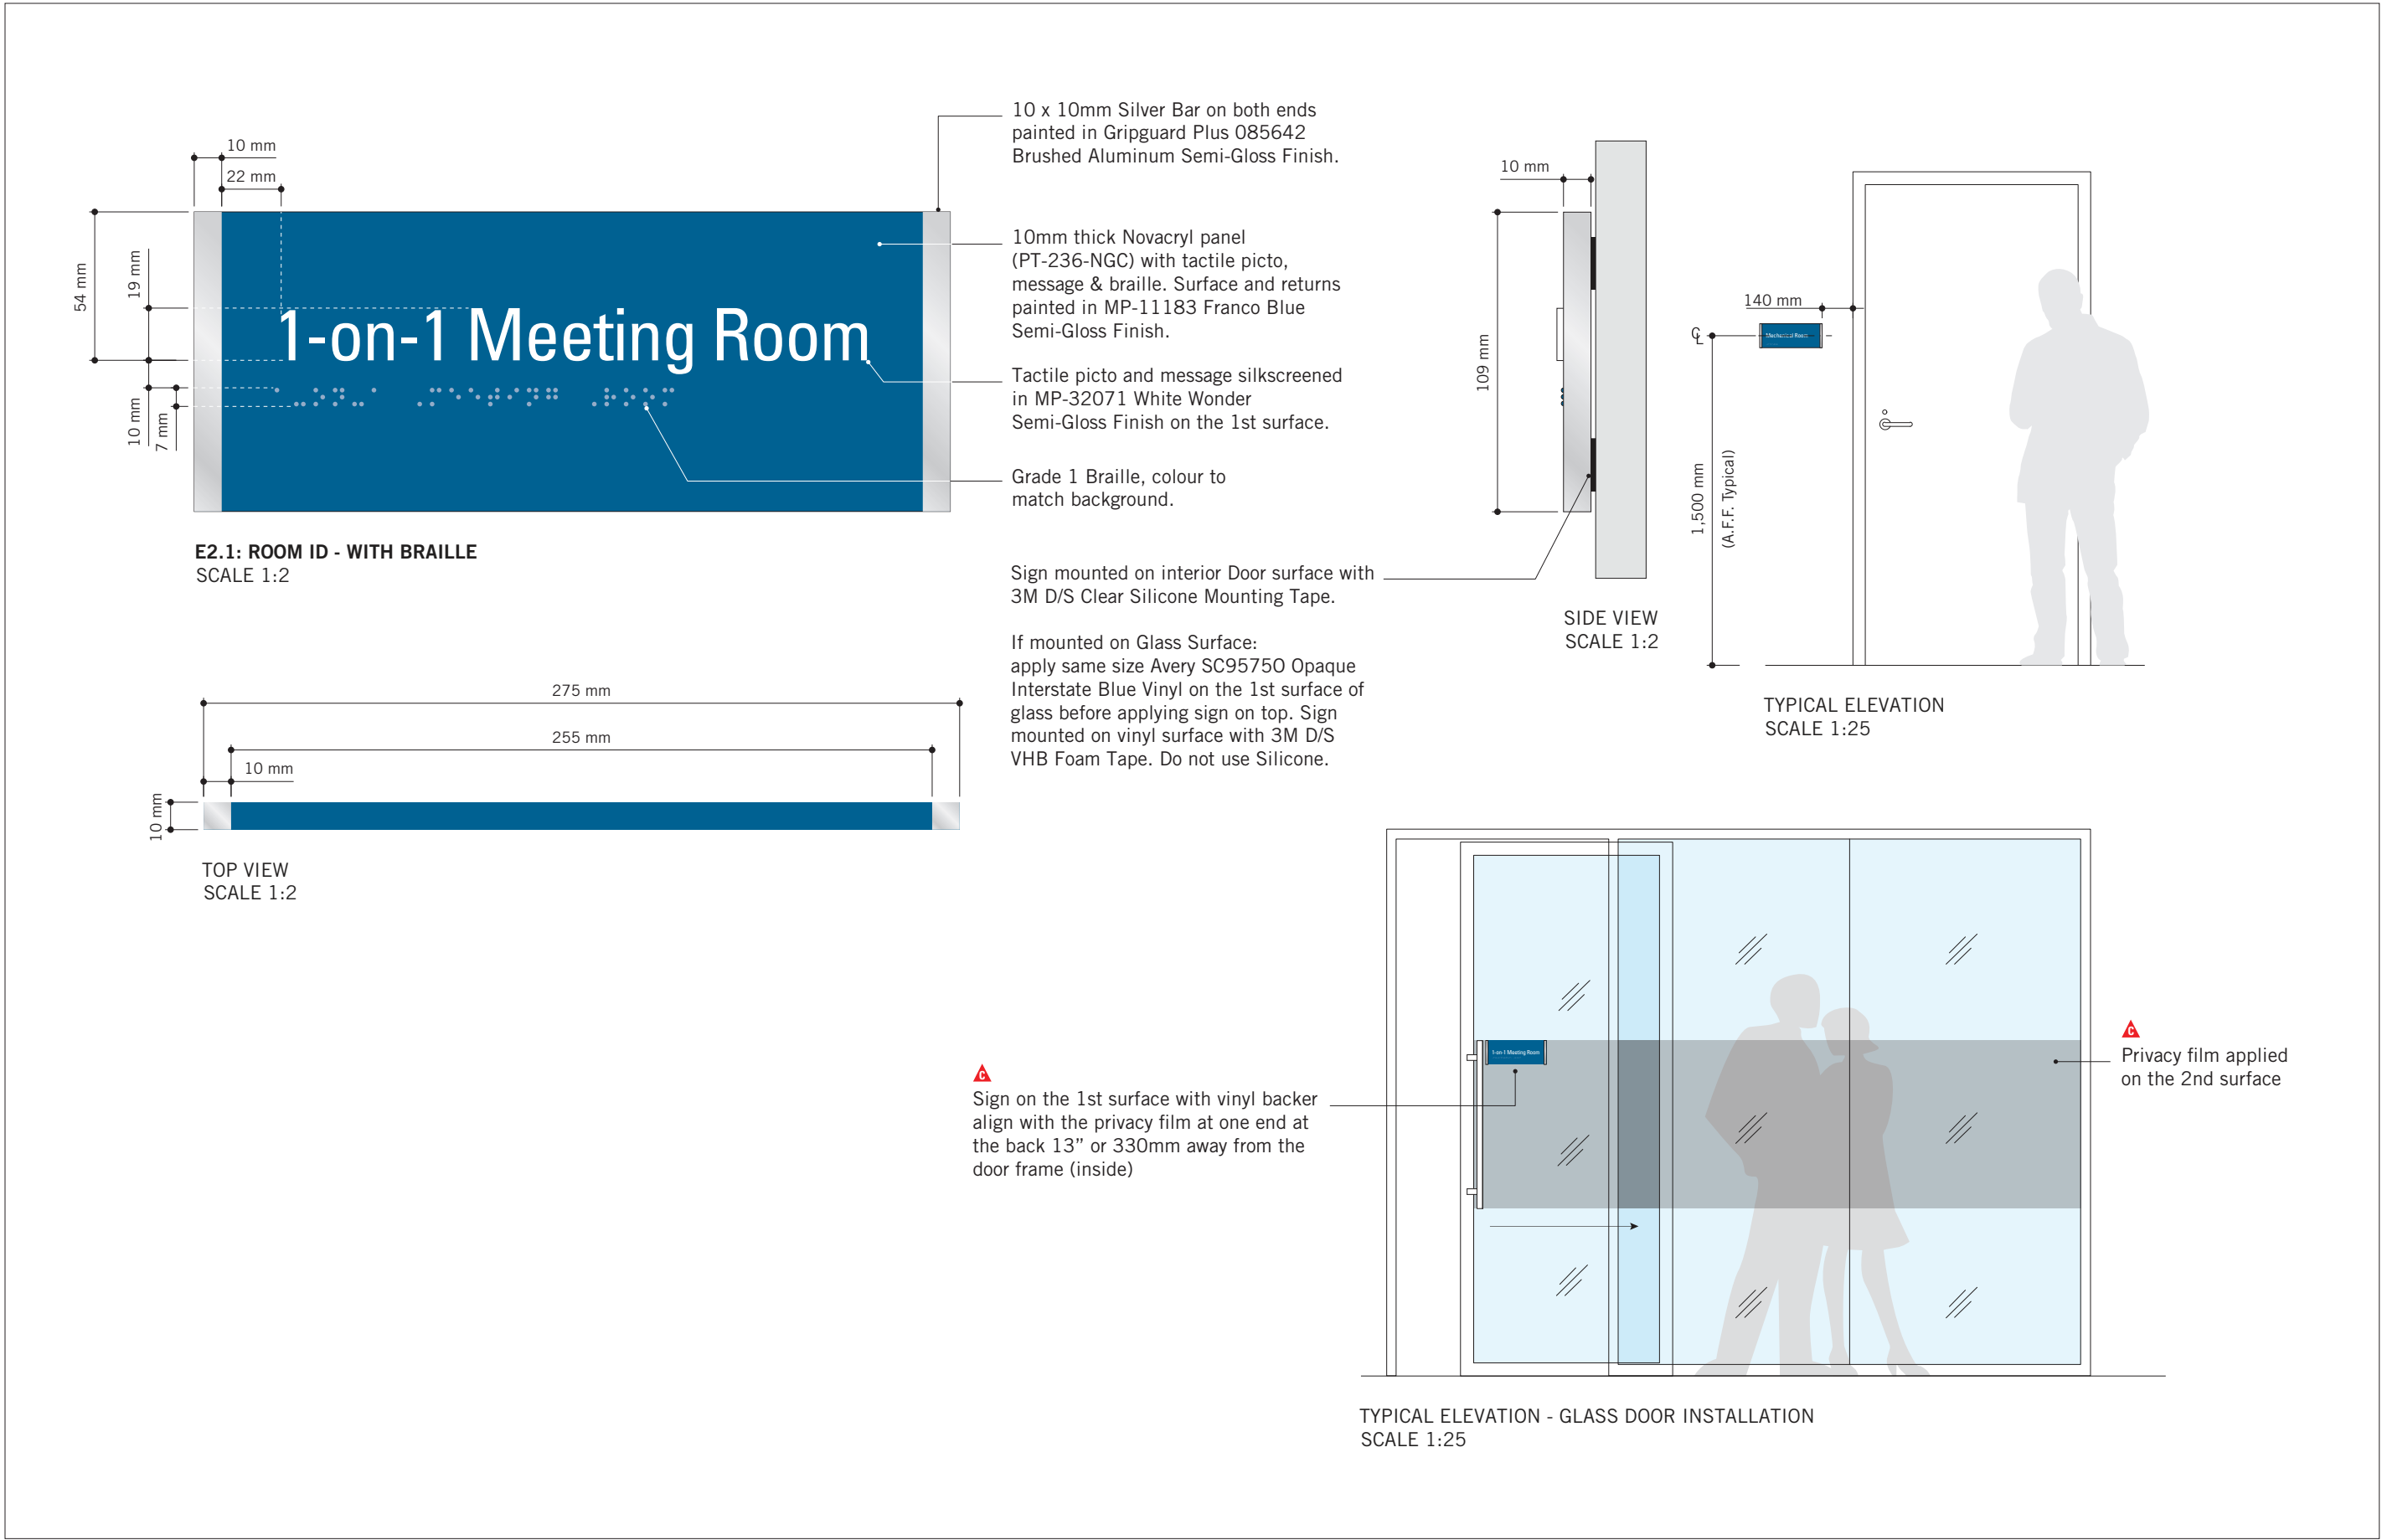

ISSUES		
No.	DESCRIPTION	DATE
A	ISSUED FOR TENDER	2025-04-11

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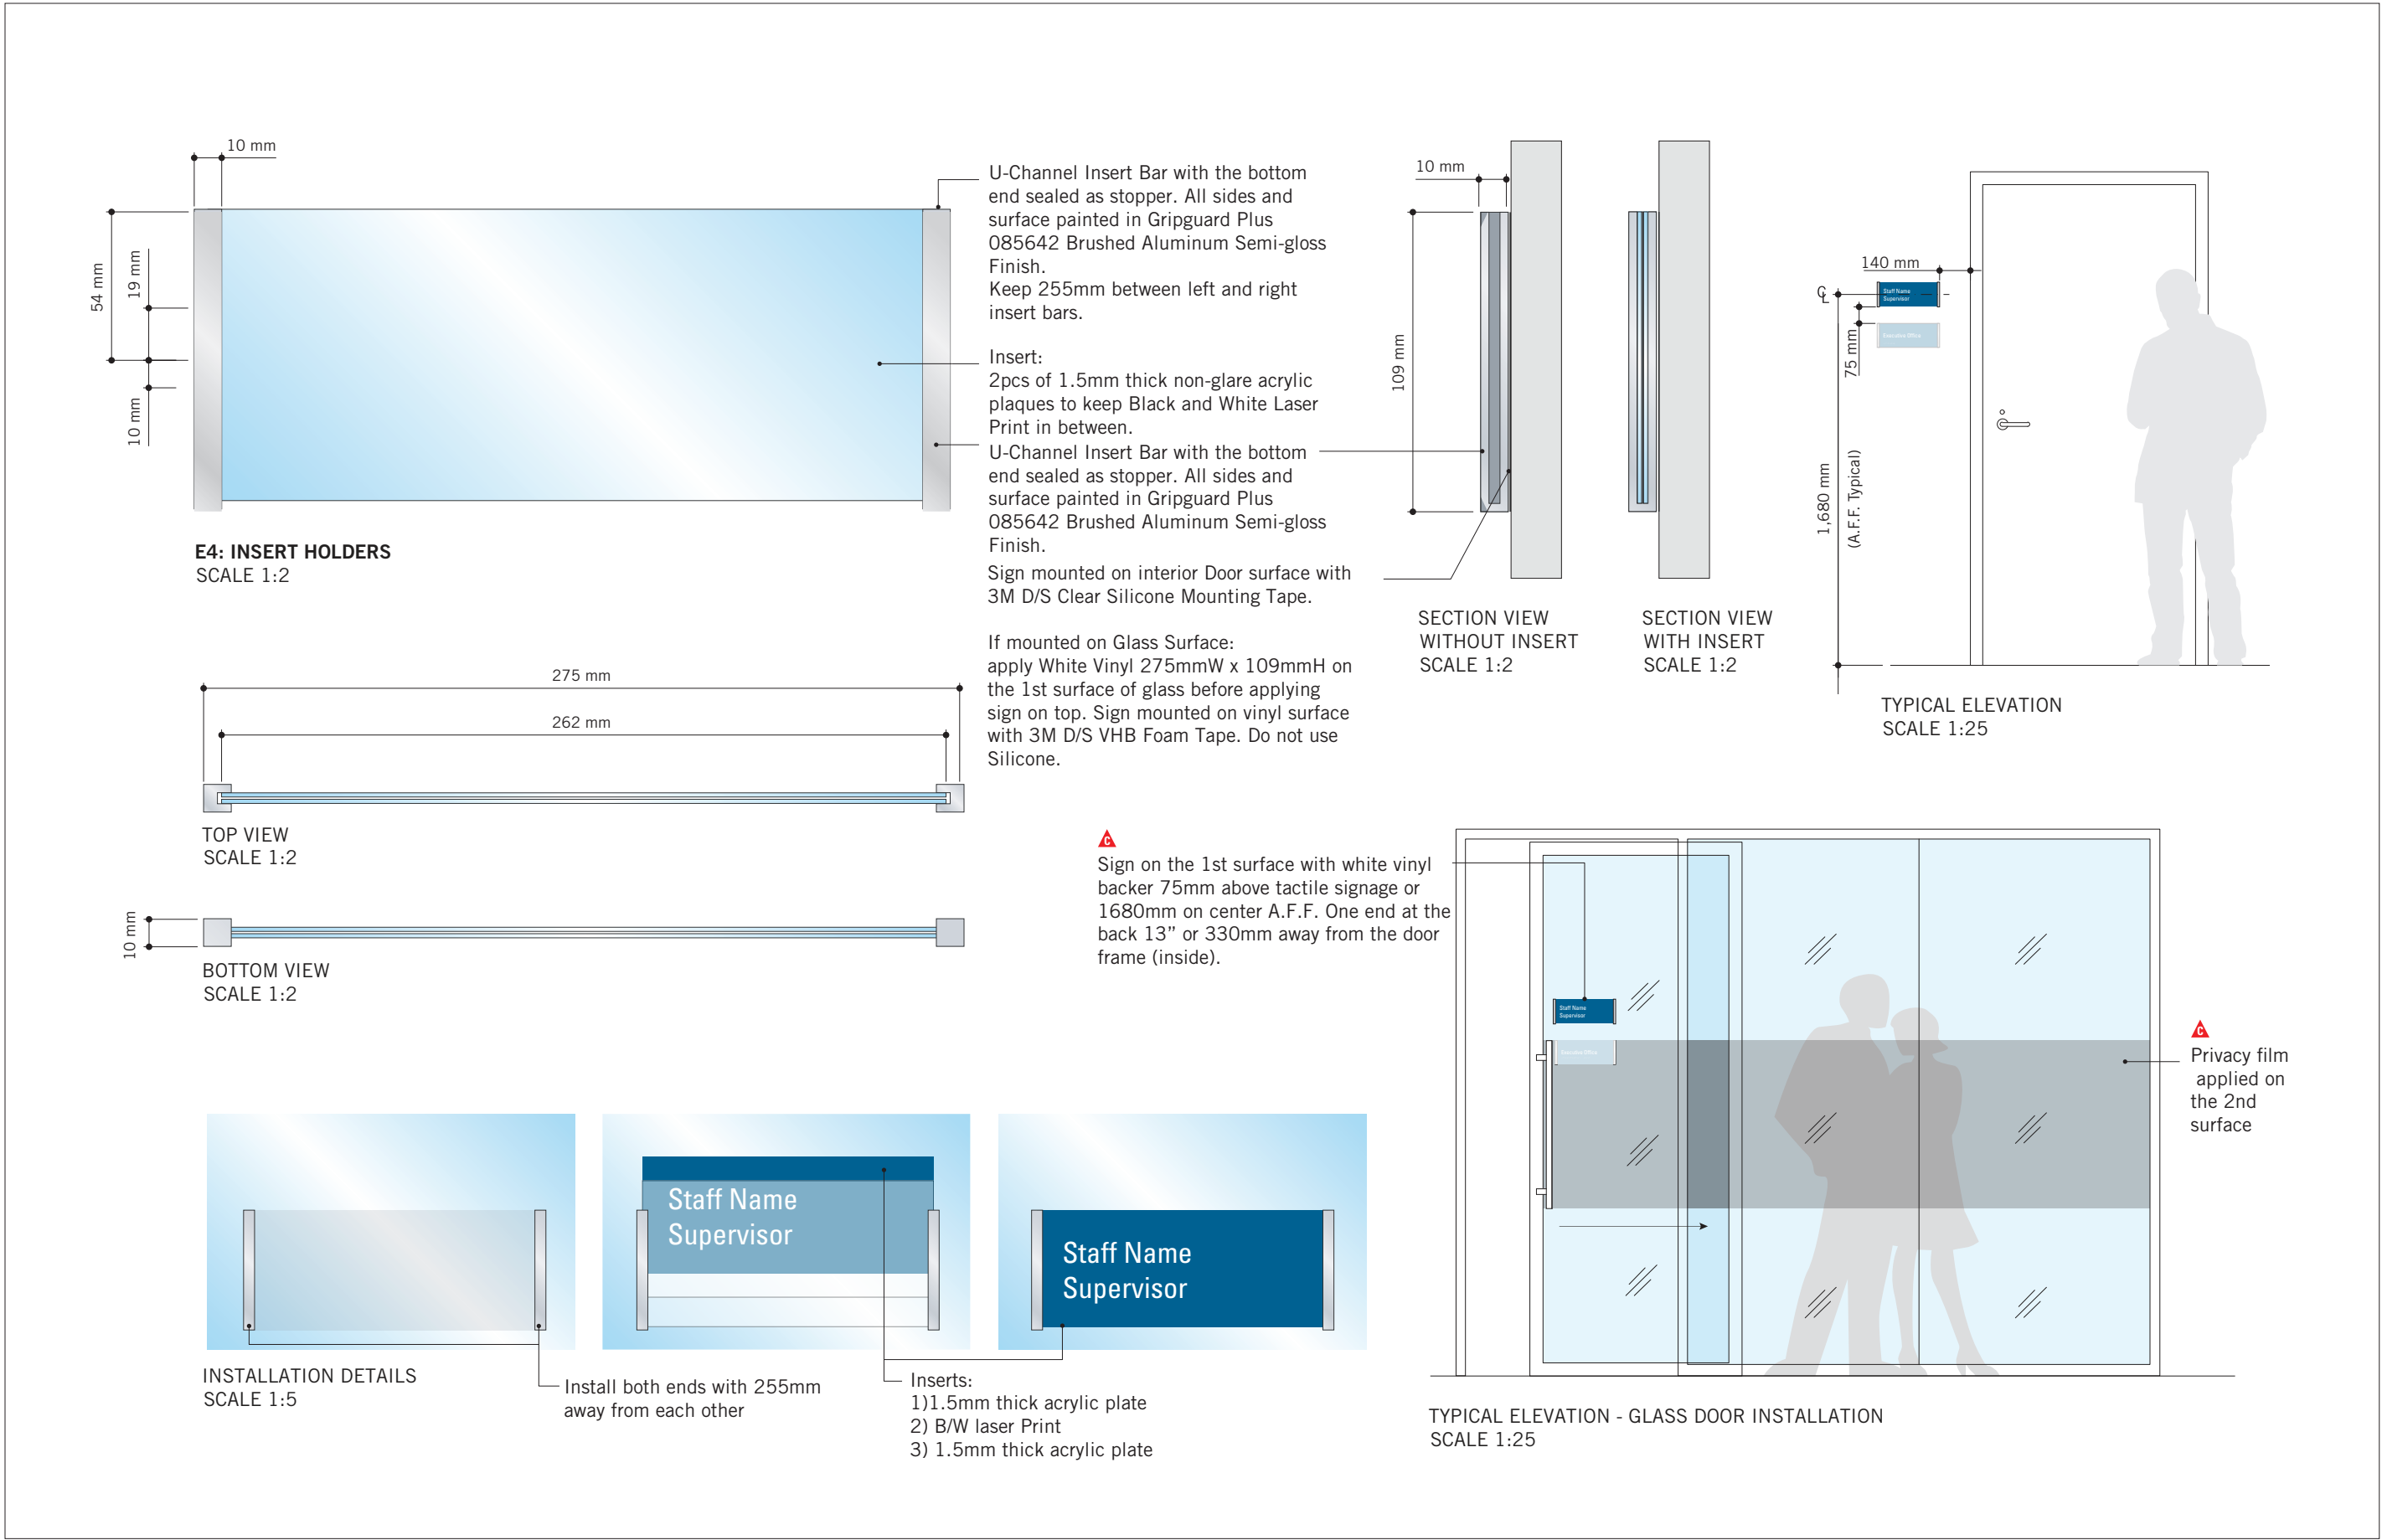
PROJECT TITLE
**CITY OF TORONTO
ACCESSIBILITY UPGRADES**

PROJECT ADDRESS
GROUP 05 BUILDINGS

PROJECT NO: 9119 - 19 - 0162 / Arcadis 30279056	
DRAWN BY: M.LOW	CHECKED BY: C.D. SCHNOBB
PROJECT MGR: R. DALY	APPROVED BY:

SHEET TITLE
**SIGNAGE & WAYFINDING
DETAILS
E2: ROOM ID**

SHEET NUMBER D1903	ISSUE A
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ISSUES

No.	DESCRIPTION	DATE
A	ISSUED FOR TENDER	2025-04-11

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PROJECT TITLE

CITY OF TORONTO
ACCESSIBILITY UPGRADES

PROJECT ADDRESS

GROUP 05 BUILDINGS

PROJECT NO:

9119 – 19 – 0162 / Arcadis 30279056

DRAWN BY:
M.LOW

CHECKED BY:
C.D. SCHNOBB

PROJECT MGR:
R. DALY

APPROVED BY:

SHEET TITLE





SIGNAGE & WAYFINDING
DETAILS
E4: INSERT HOLDER

SHEET NUMBER

D1904

ISSUE

A

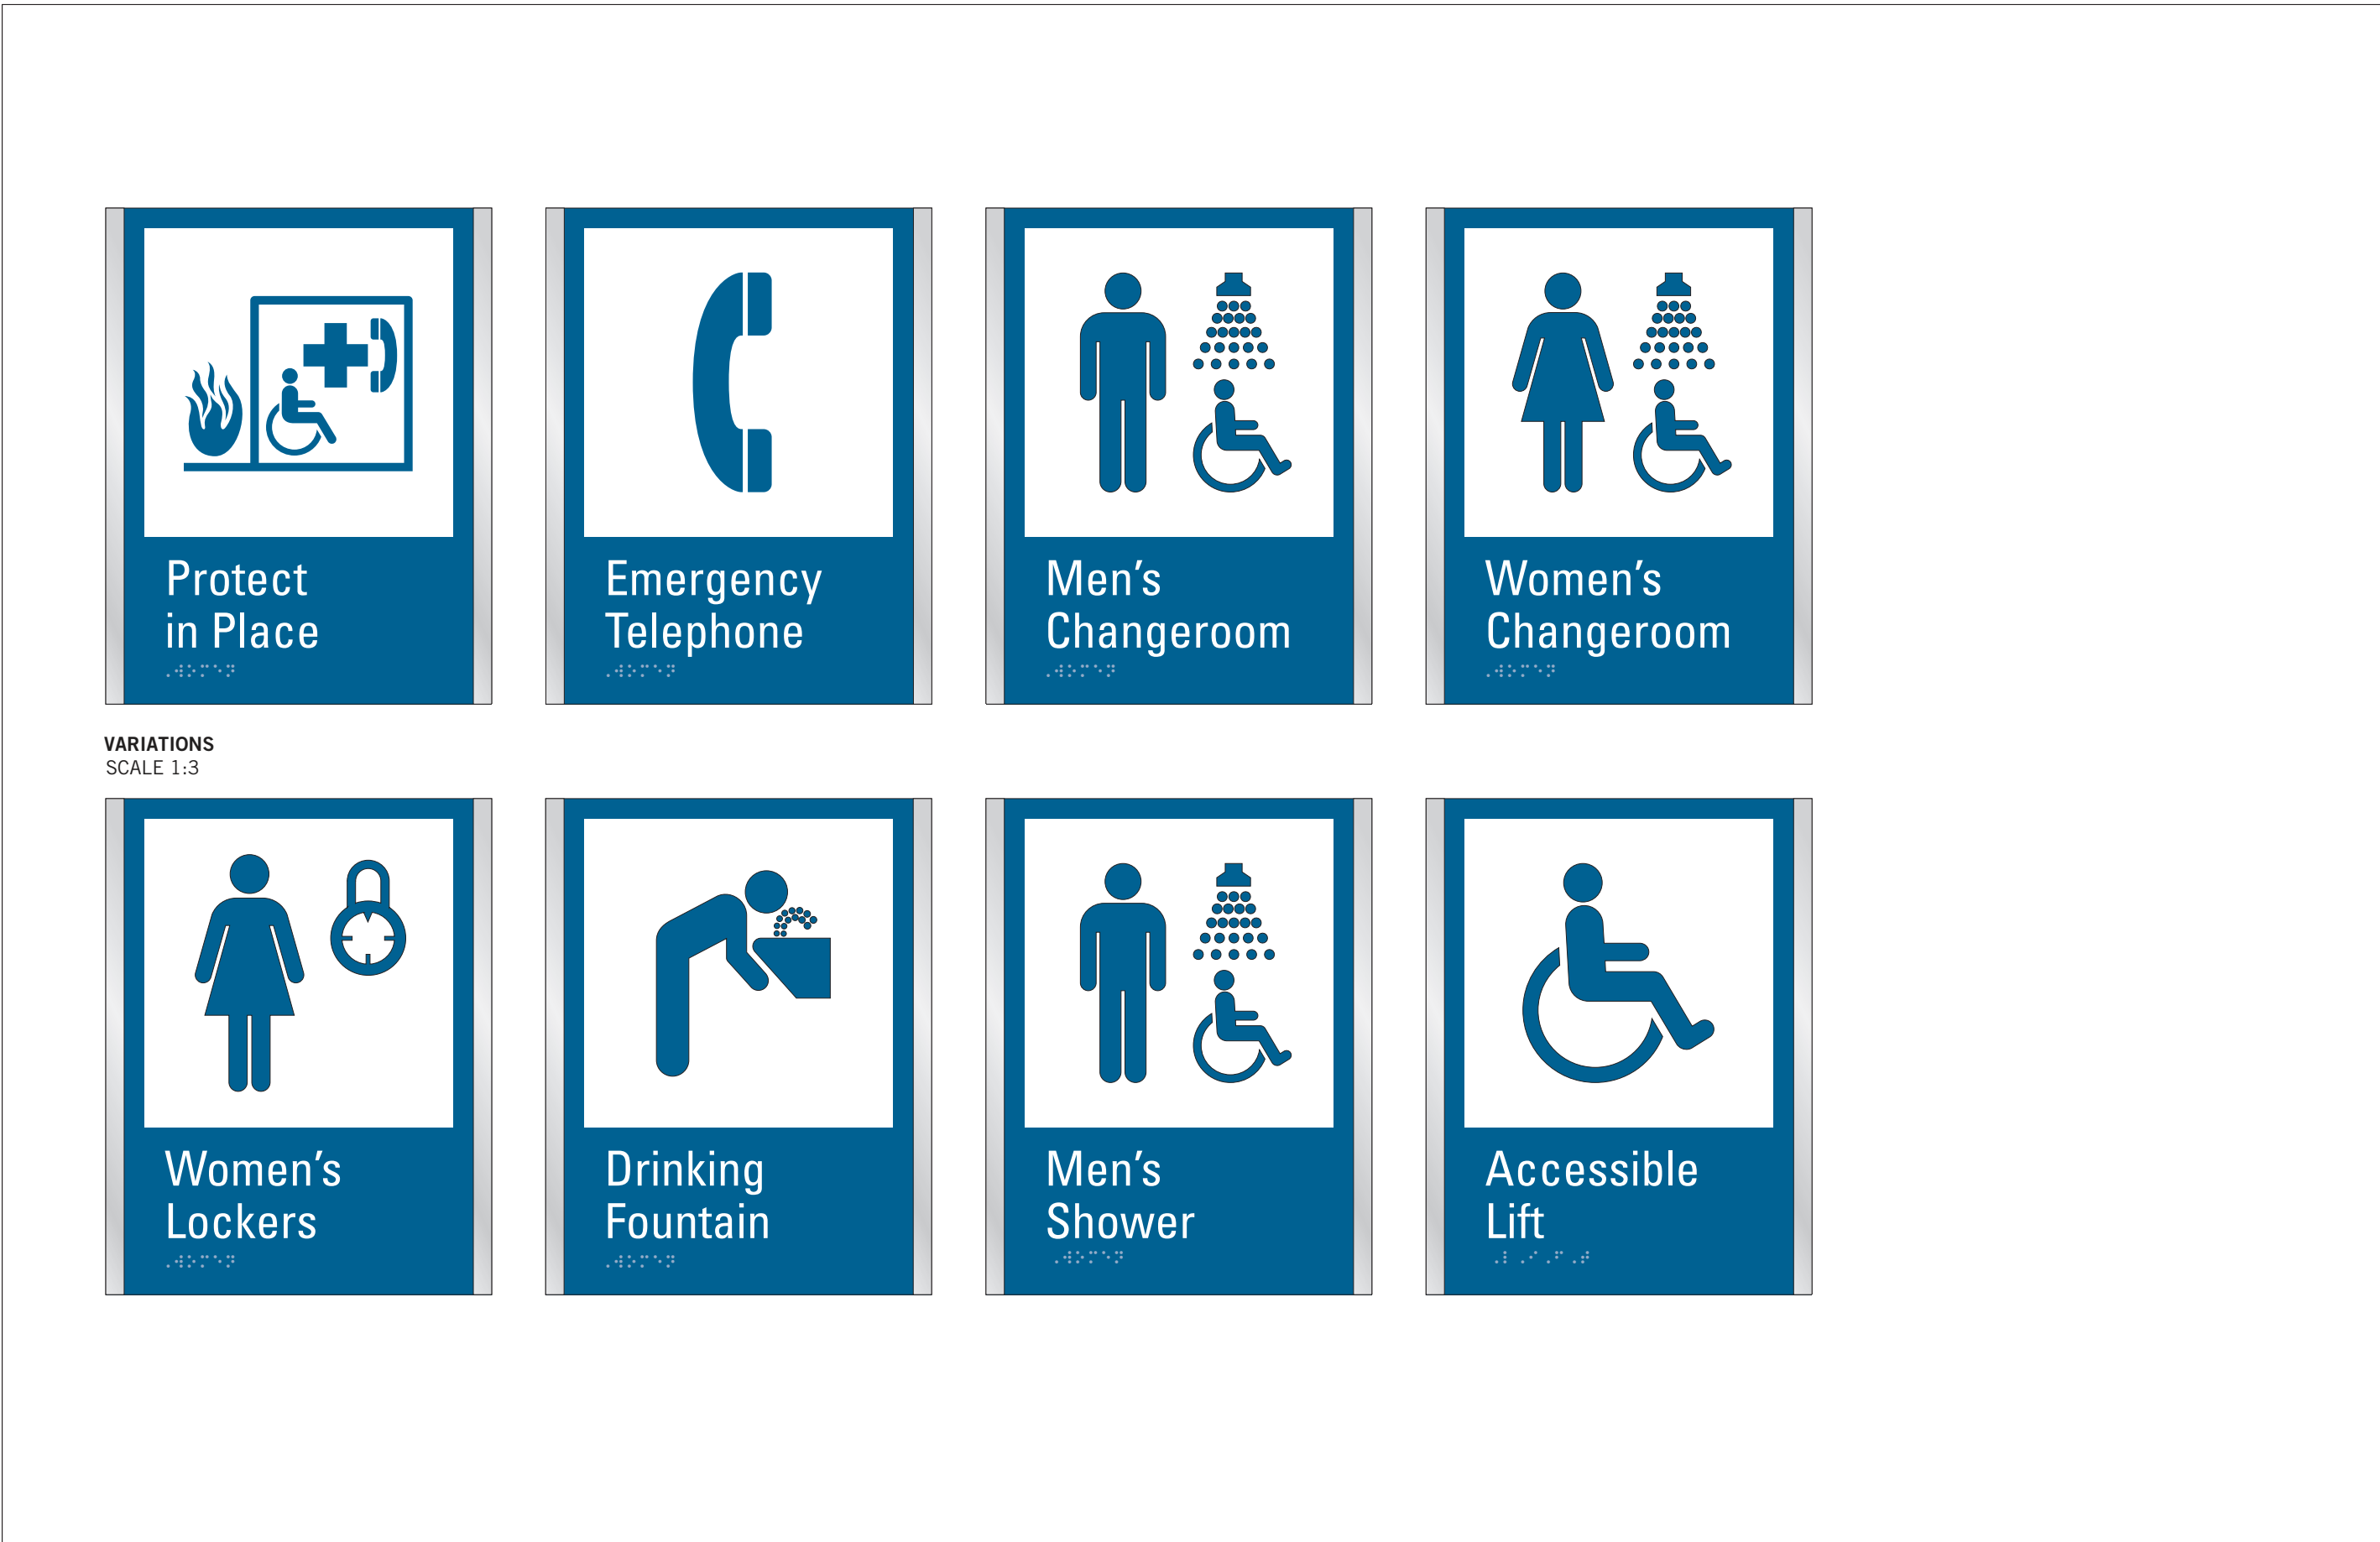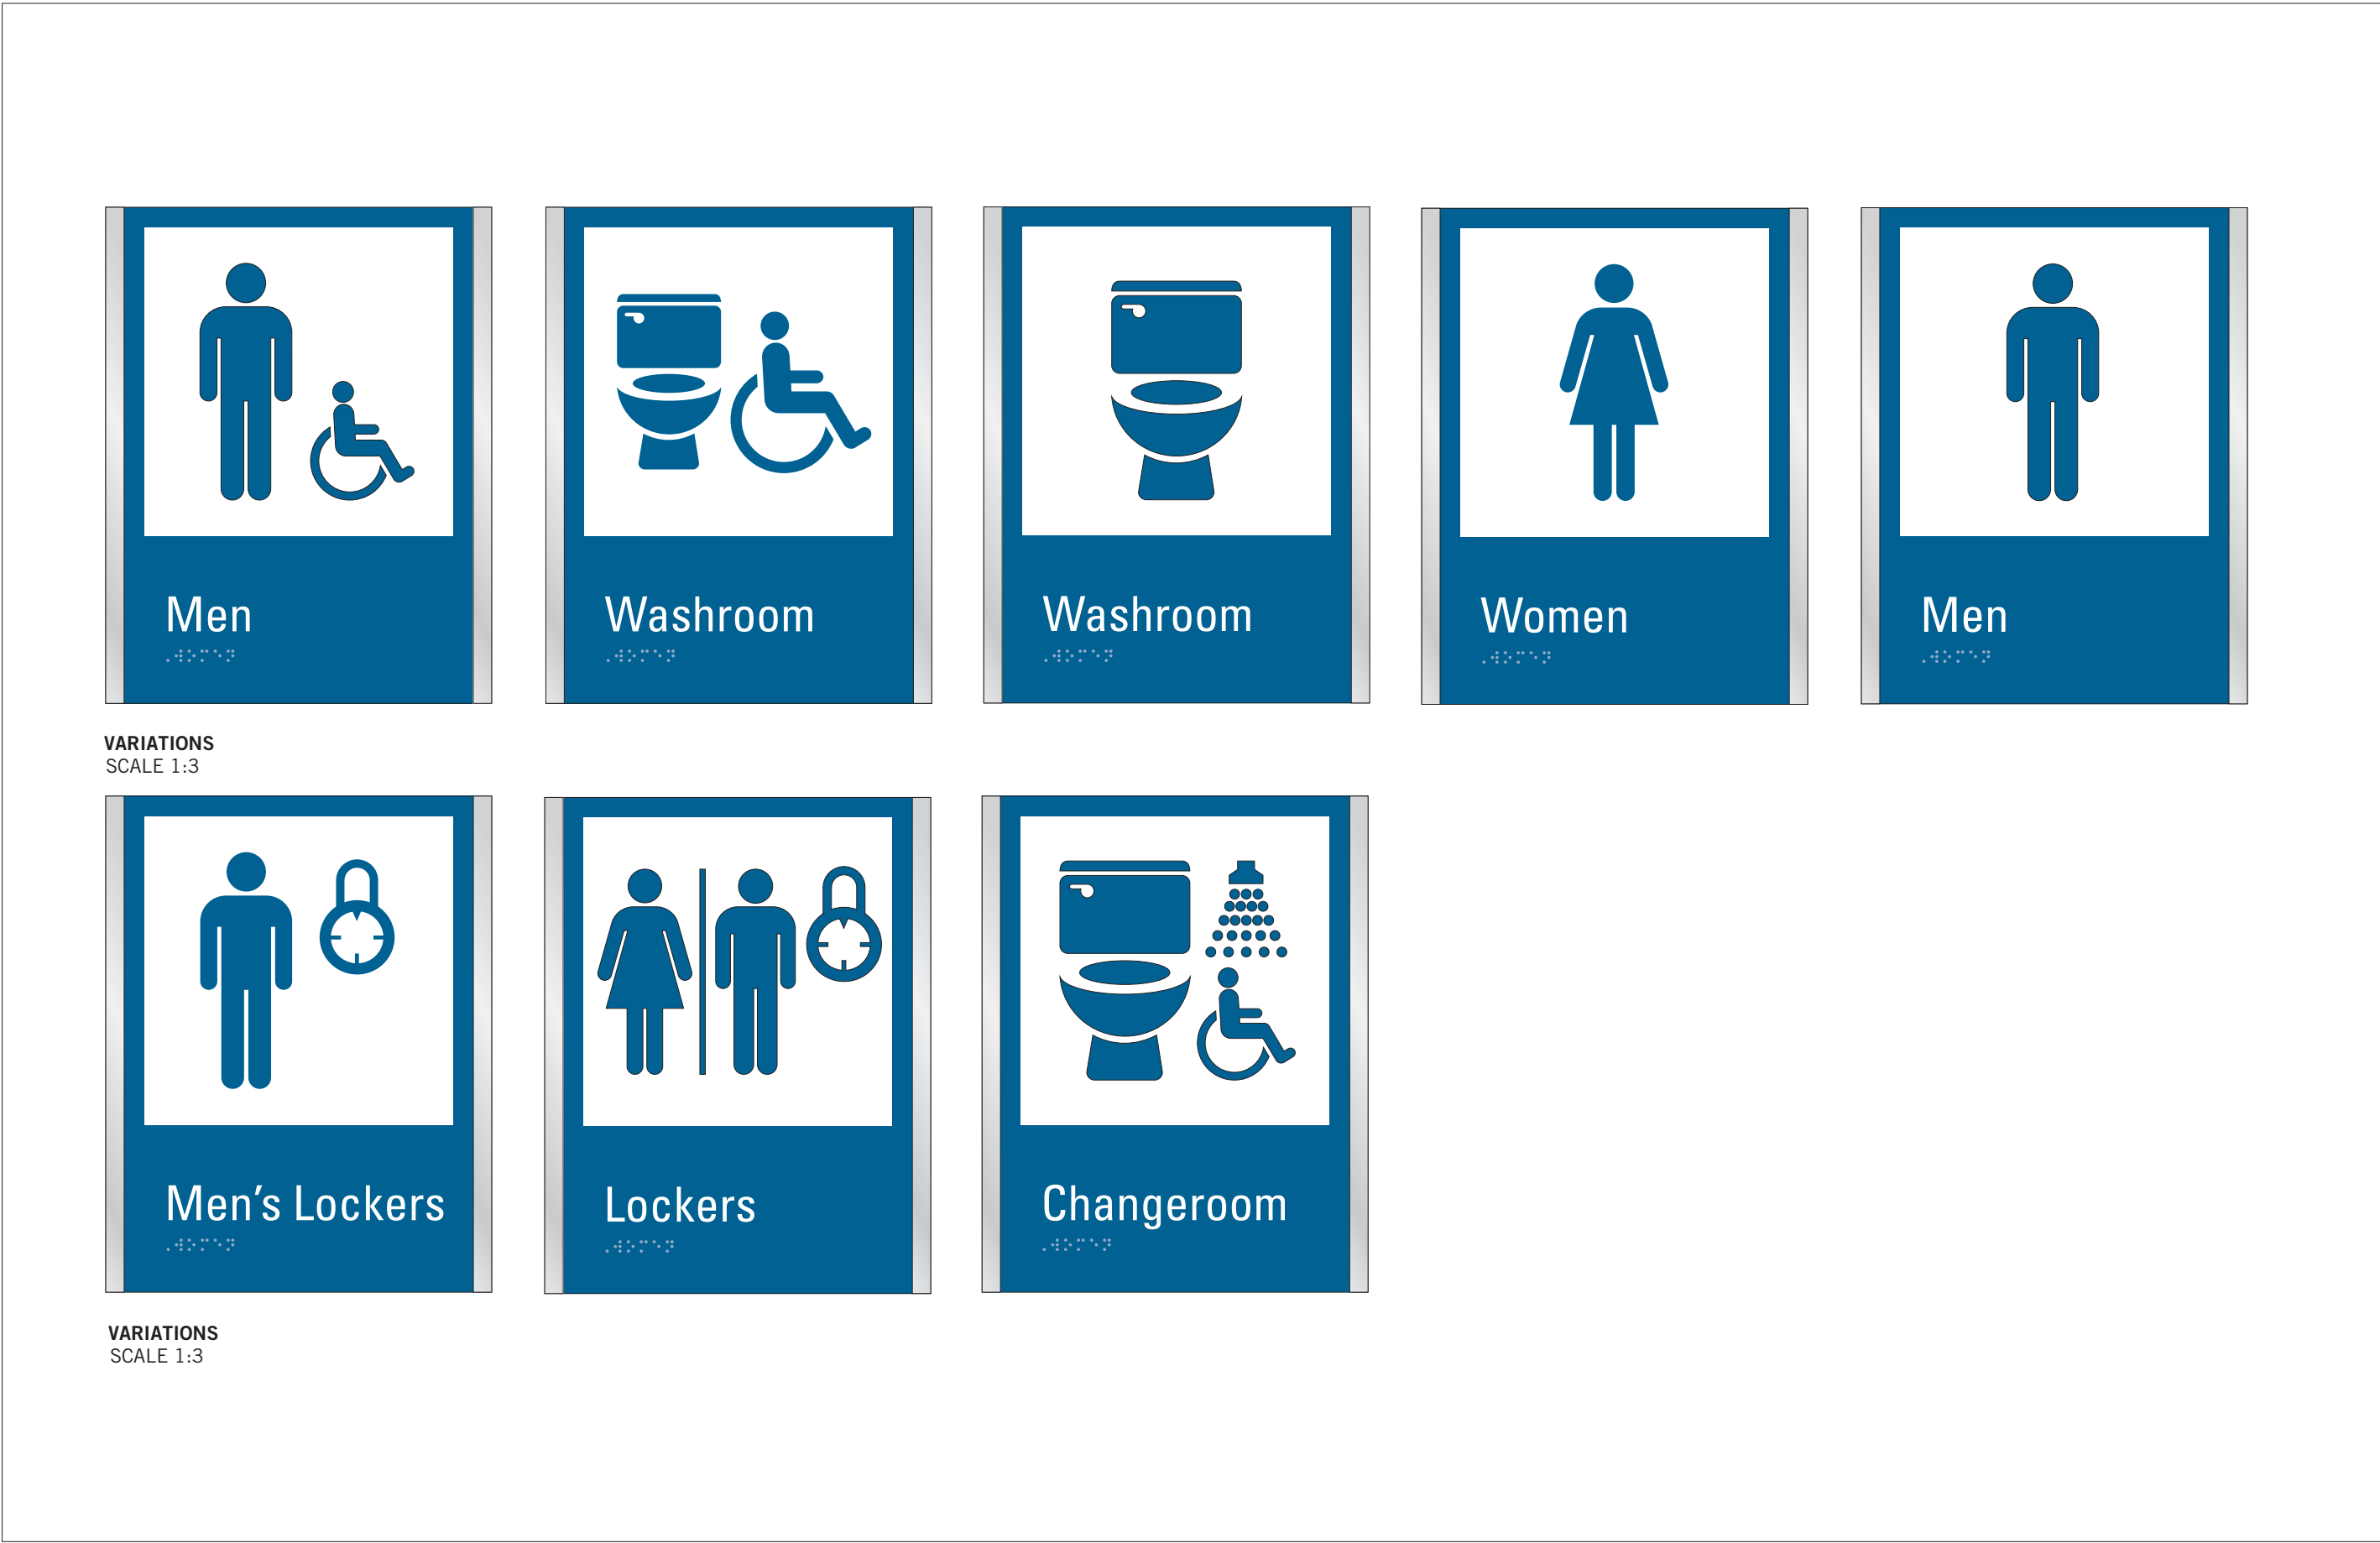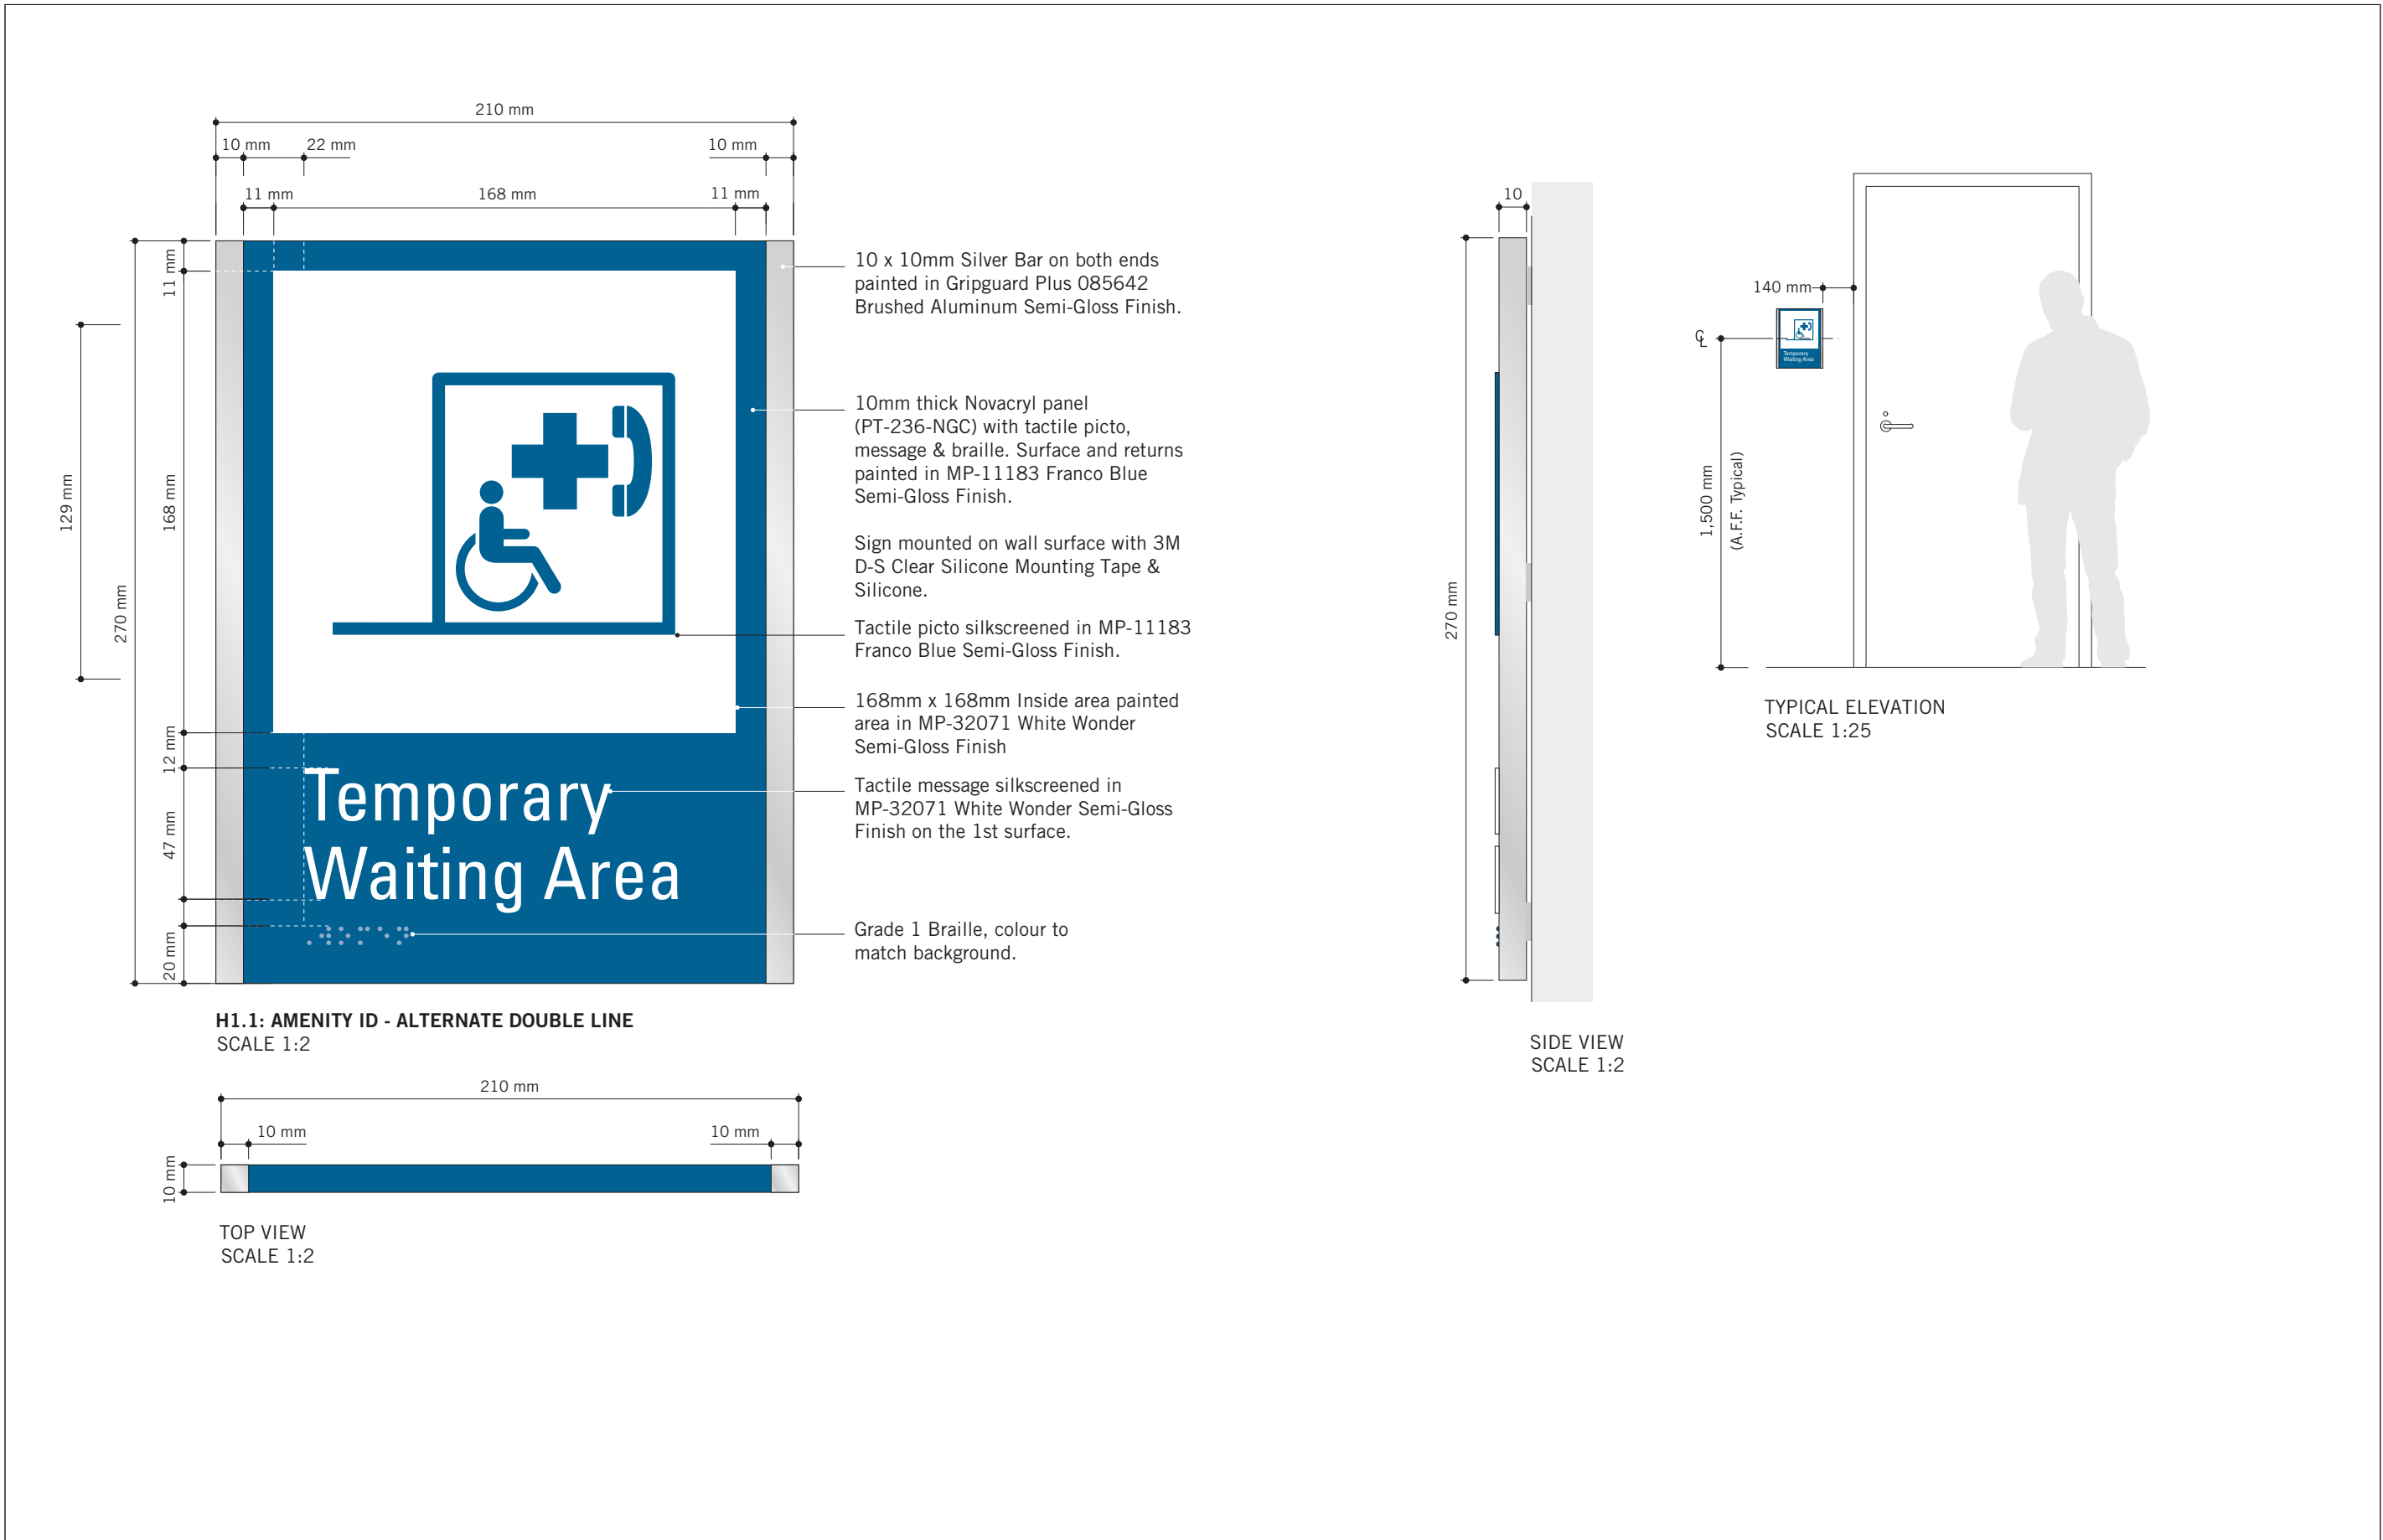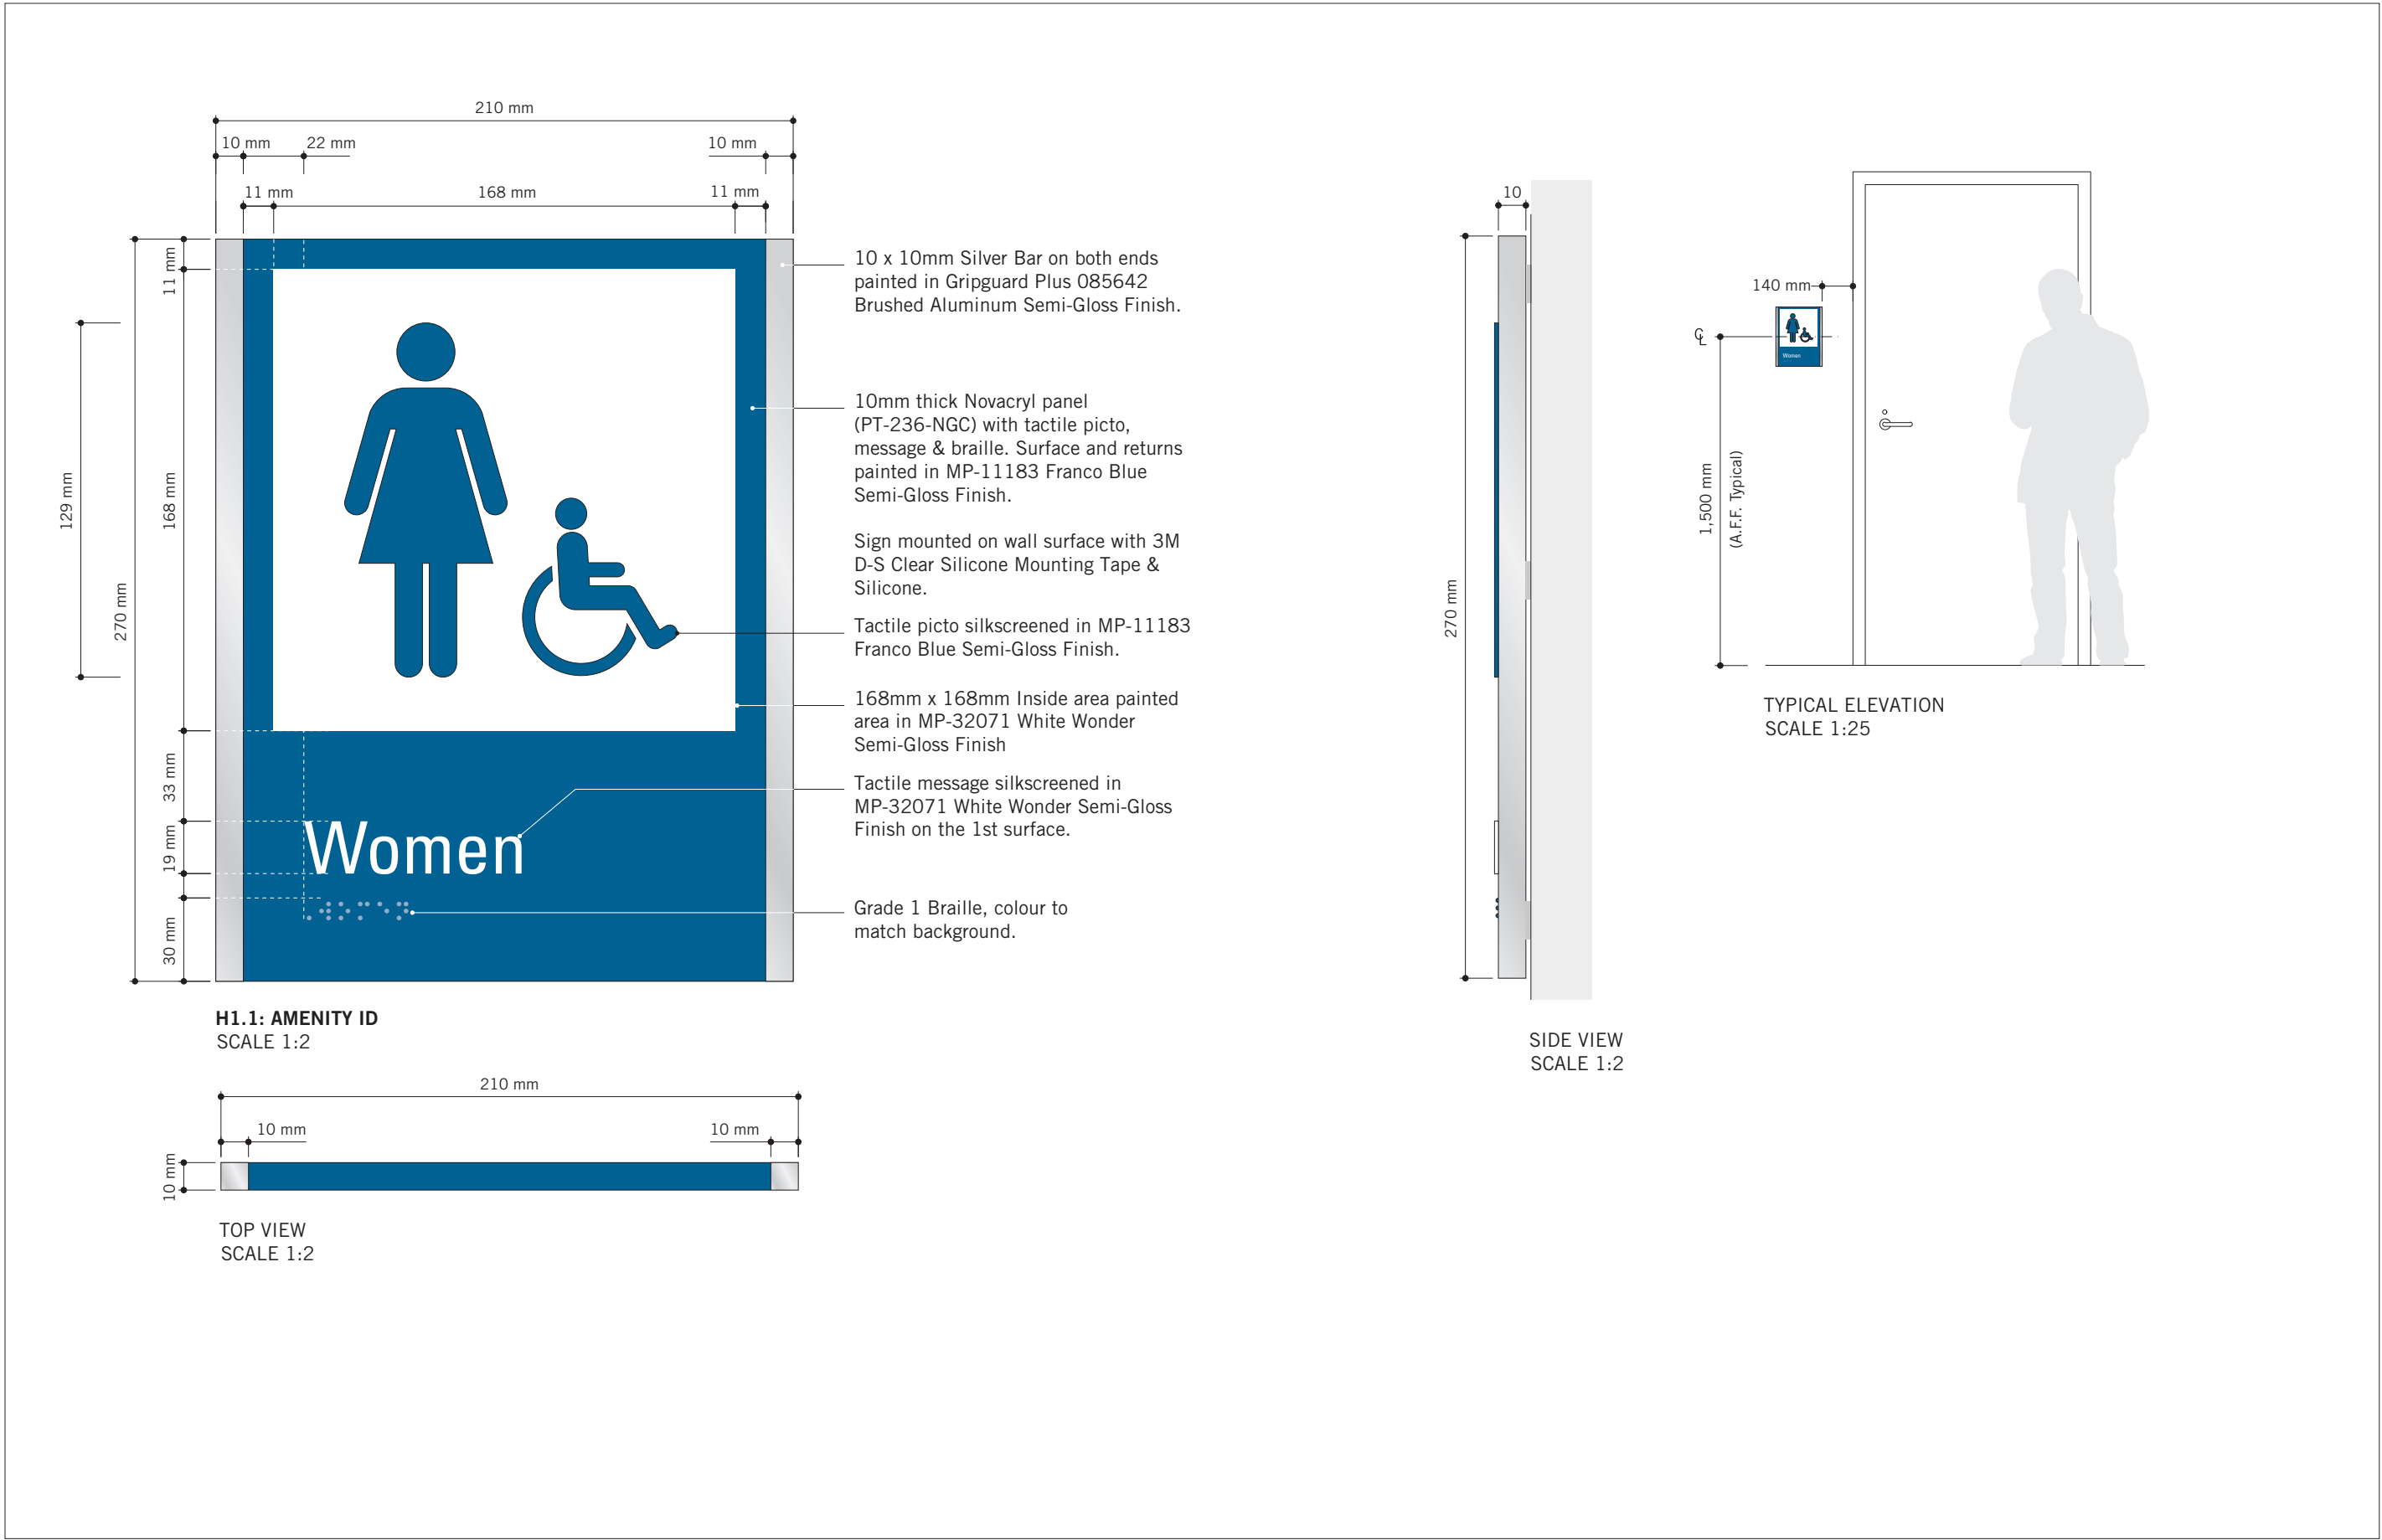

ISSUES		
No.	DESCRIPTION	DATE
A	ISSUED FOR TENDER	2025-04-11

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PROJECT TITLE
CITY OF TORONTO
ACCESSIBILITY UPGRADES

PROJECT ADDRESS
GROUP 05 BUILDINGS

PROJECT NO:
9119 - 19 - 0162 / Arcadis 30279056

DRAWN BY:
M.LOW

CHECKED BY:
C.D. SCHNOBB

PROJECT MGR:
R. DALY


APPROVED BY:

SHEET TITLE
SIGNAGE & WAYFINDING
DETAILS


H1.1: AMENITY ID

SHEET NUMBER
D1905


ISSUE
A

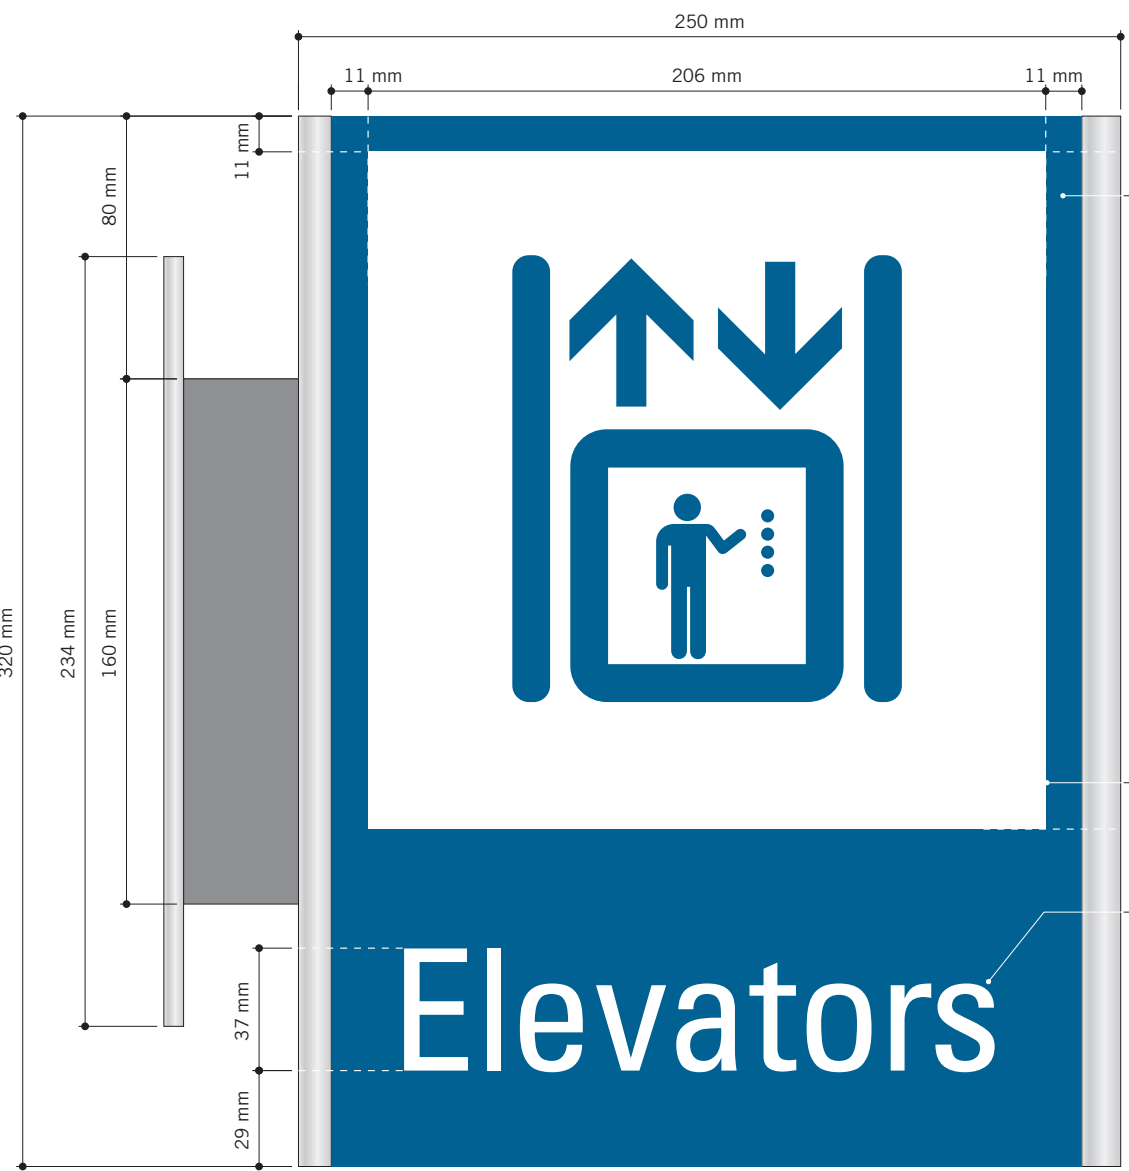


H2.1: PROJECTING AMENITY ID
SCALE 1:2

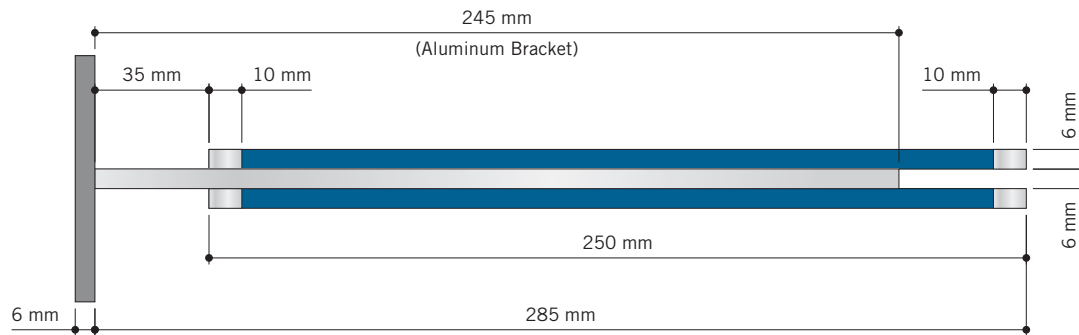

TOP VIEW
SCALE 1:2

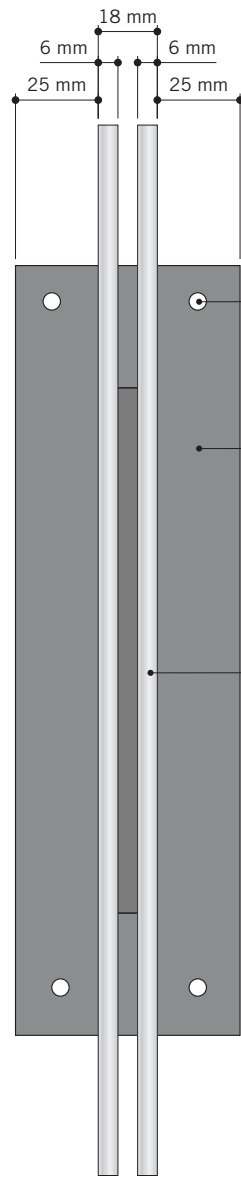

SIDE VIEW
SCALE 1:2

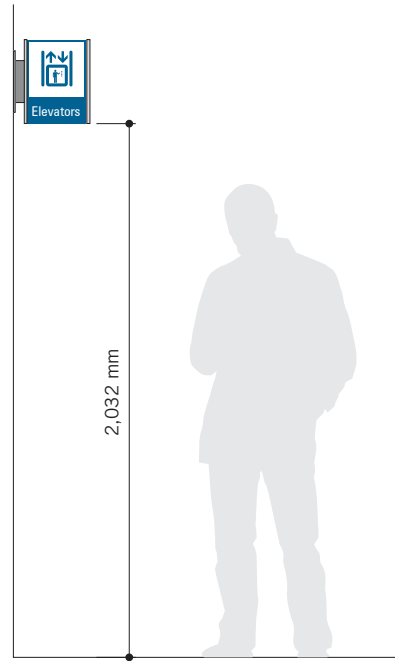

TYPICAL ELEVATION
SCALE 1:25

(2) 6mm thick 'Sintra' panels, attached back to back to the 6mm thick Aluminum wall bracket, as shown.

Paint sign face (230mm wide continued over top & bottom) in Matthews Paint Semi-Gloss Finish MP-11183 Franco Blue.

Vertical edges (10mm wide continued over top, bottom and vertical edges) painted in GripGuard Plus 085642 Brushed Aluminum Semi-Gloss Finish.

3M 7725-20 Opaque Matte White Vinyl with knocked-out graphics applied to both sign faces.

3M 7725-20 Opaque Matte White Vinyl Letters applied to both sign faces.

(4) 1/4" C/S Toggle bolts into existing drywall (TBC). Heads painted to match.

6mm (1/4") thick Aluminum Wall Plate Painted in GripGuard Plus 085642 Brushed Aluminum.

(2) 6mm thick Sintra panels, attached back to back to 6mm thick Aluminum bracket.



VARIATIONS
SCALE 1:4



ISSUES		
No.	DESCRIPTION	DATE
A	ISSUED FOR TENDER	2025-04-11

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PROJECT TITLE
CITY OF TORONTO
ACCESSIBILITY UPGRADES

PROJECT ADDRESS
GROUP 05 BUILDINGS

PROJECT NO:
9119 - 19 - 0162 / Arcadis 30279056

DRAWN BY:
M.LOW

CHECKED BY:
C.D. SCHNOBB



PROJECT MGR:
R. DALY

APPROVED BY:

SHEET TITLE
SIGNAGE & WAYFINDING
DETAILS
H2.1:PROJECTING AMENITY
ID

SHEET NUMBER
D1906

ISSUE
A

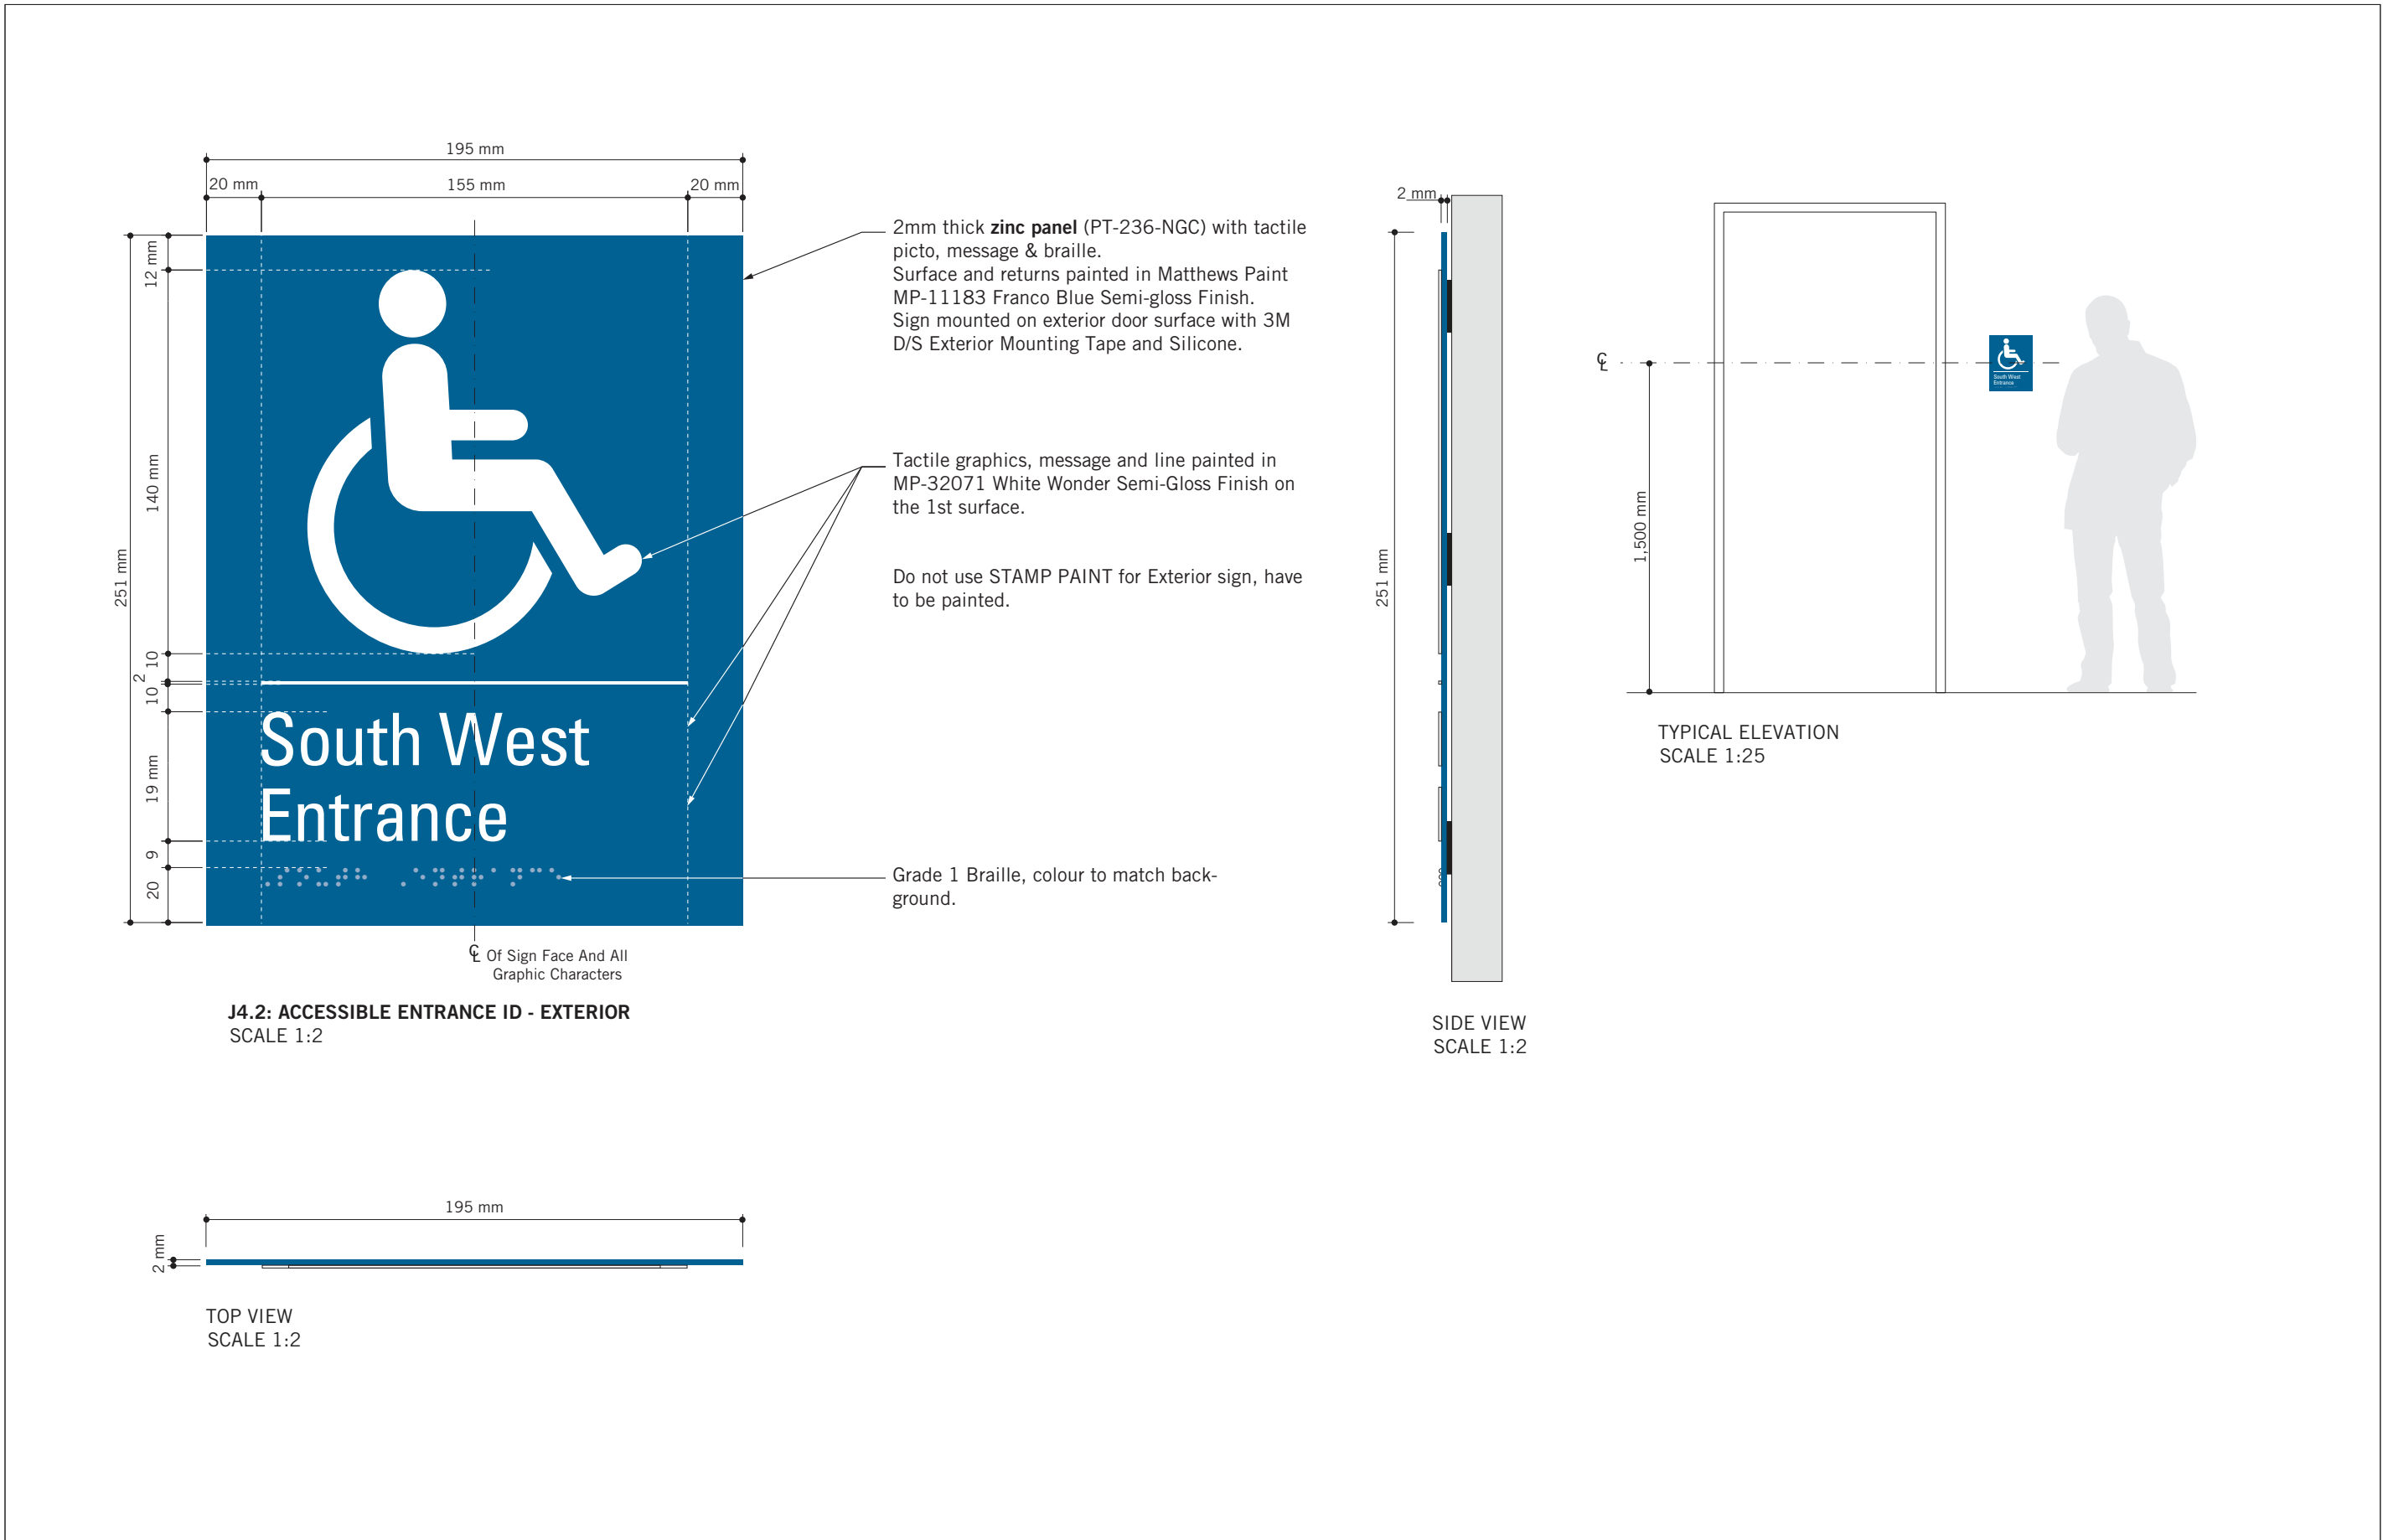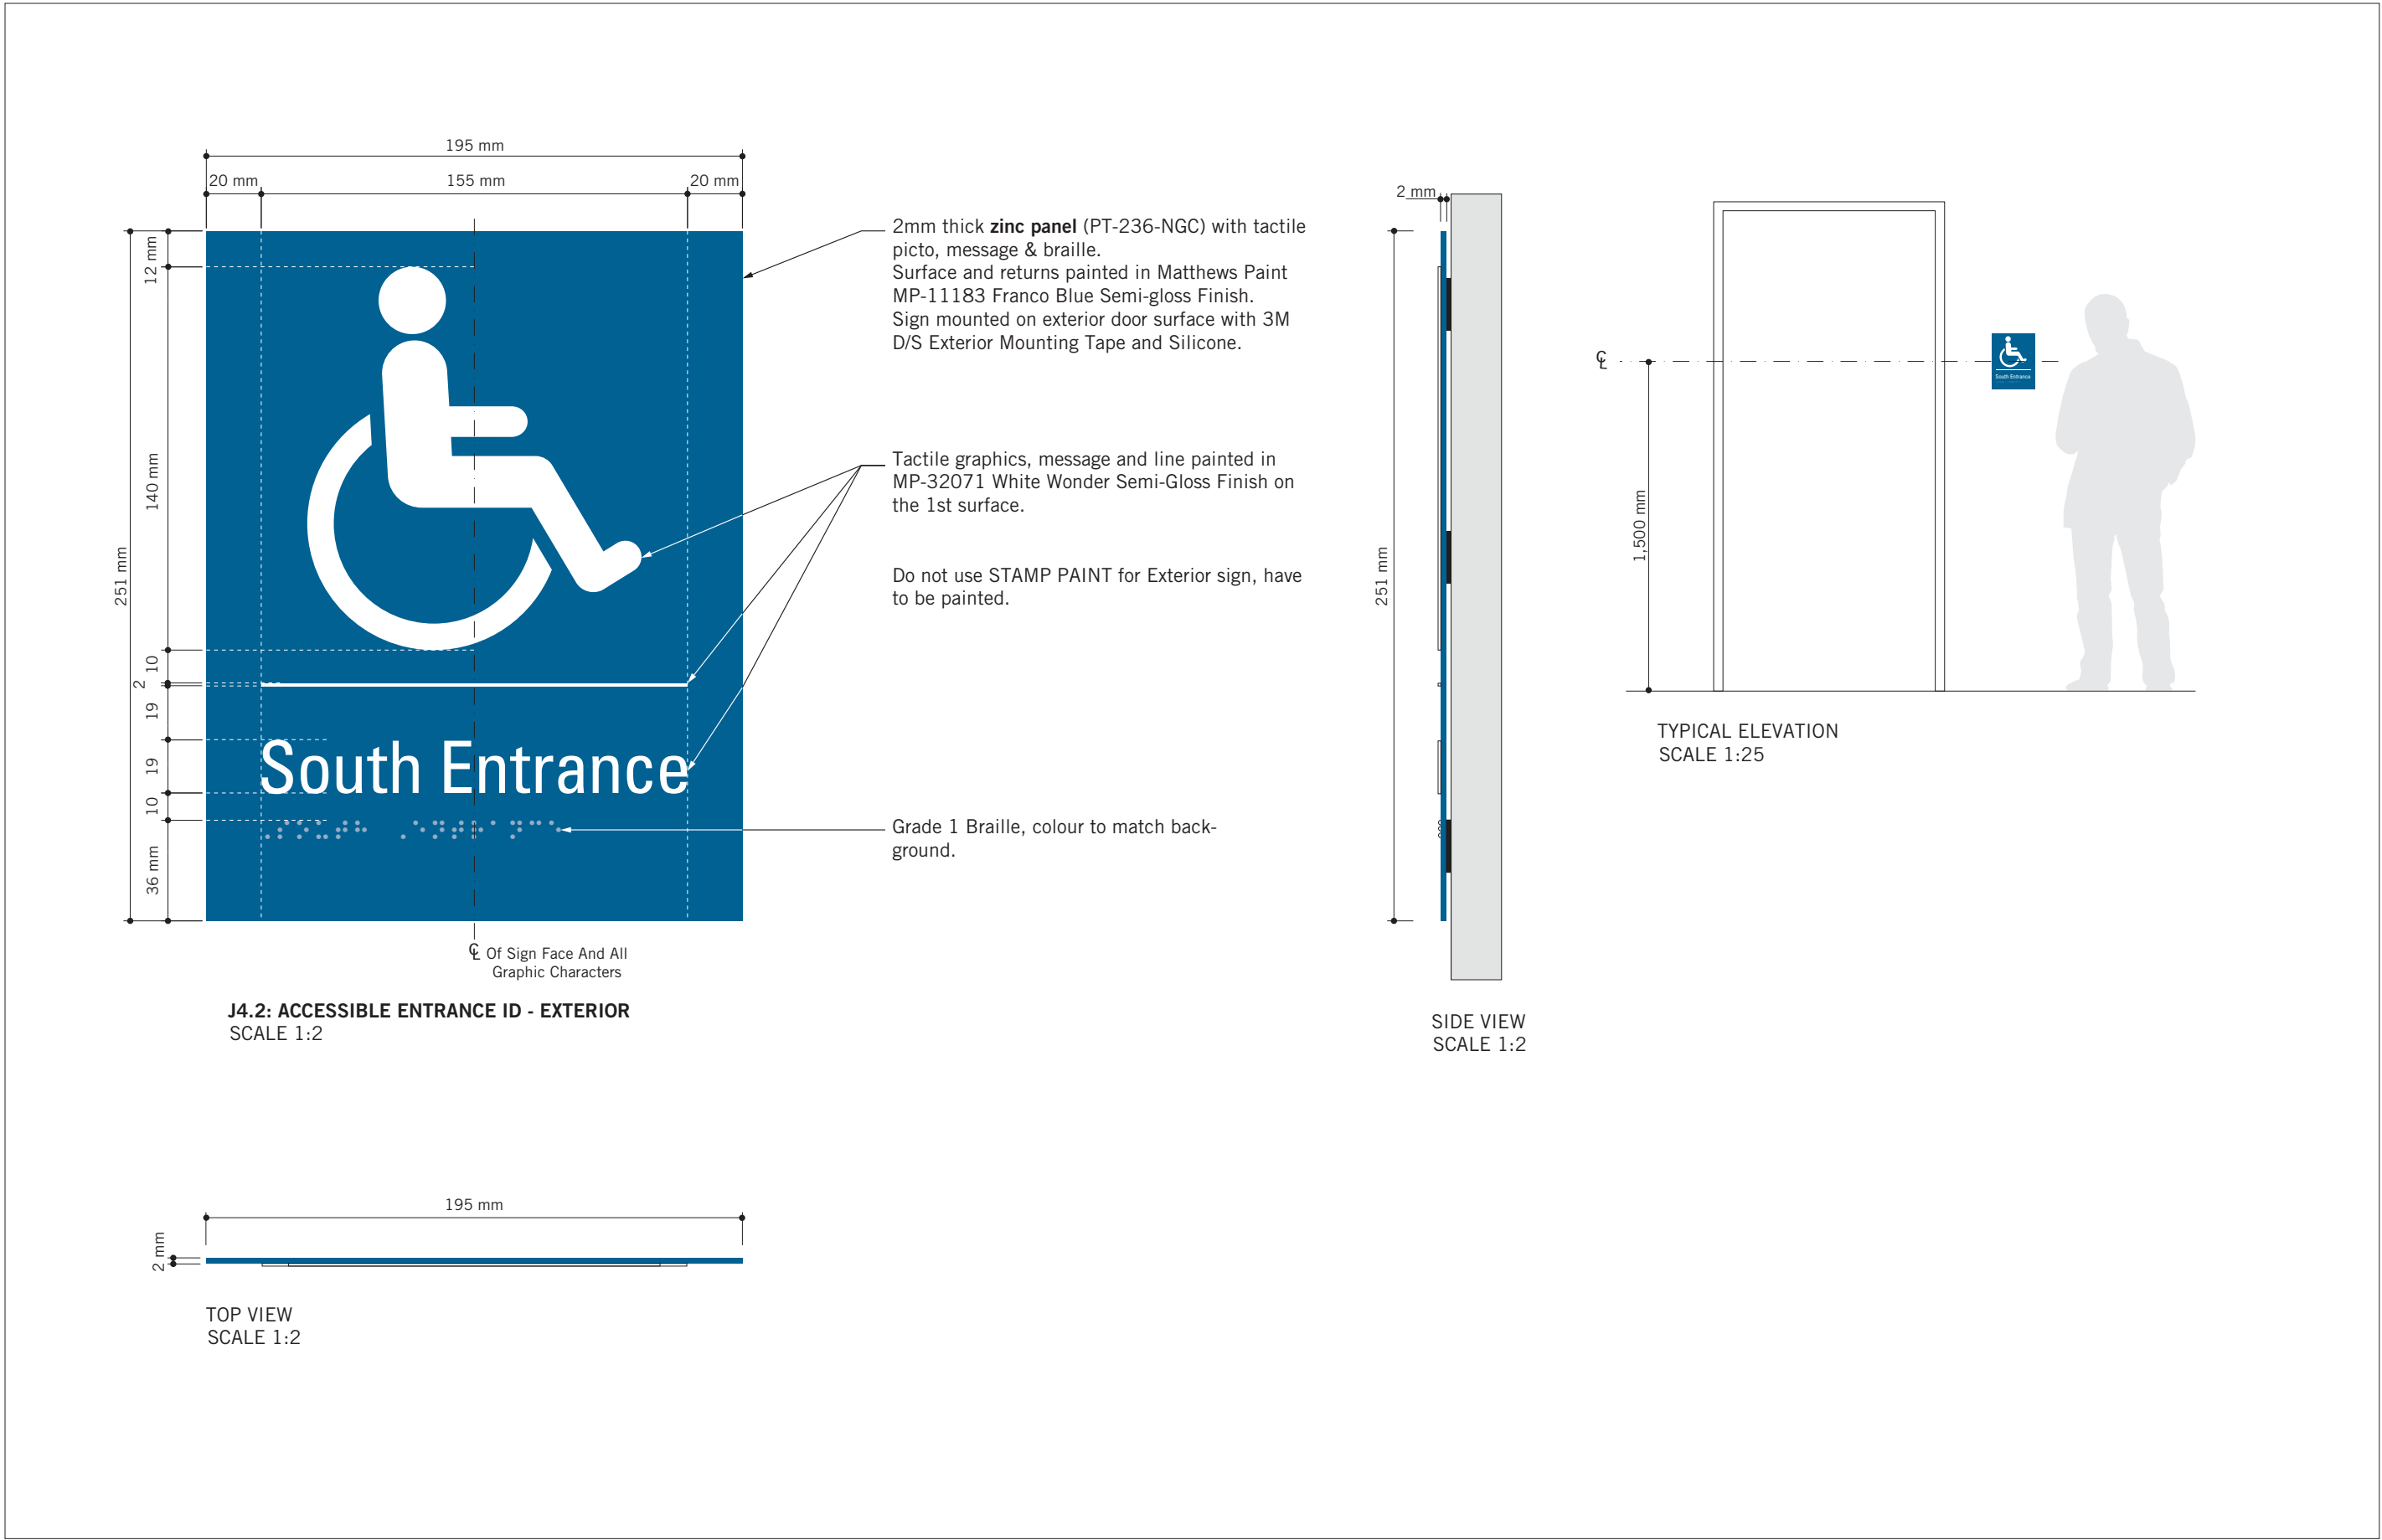

VARIATIONS
SCALE 1:3



VARIATIONS
SCALE 1:3

ISSUES		
No.	DESCRIPTION	DATE
A	ISSUED FOR TENDER	2025-04-11

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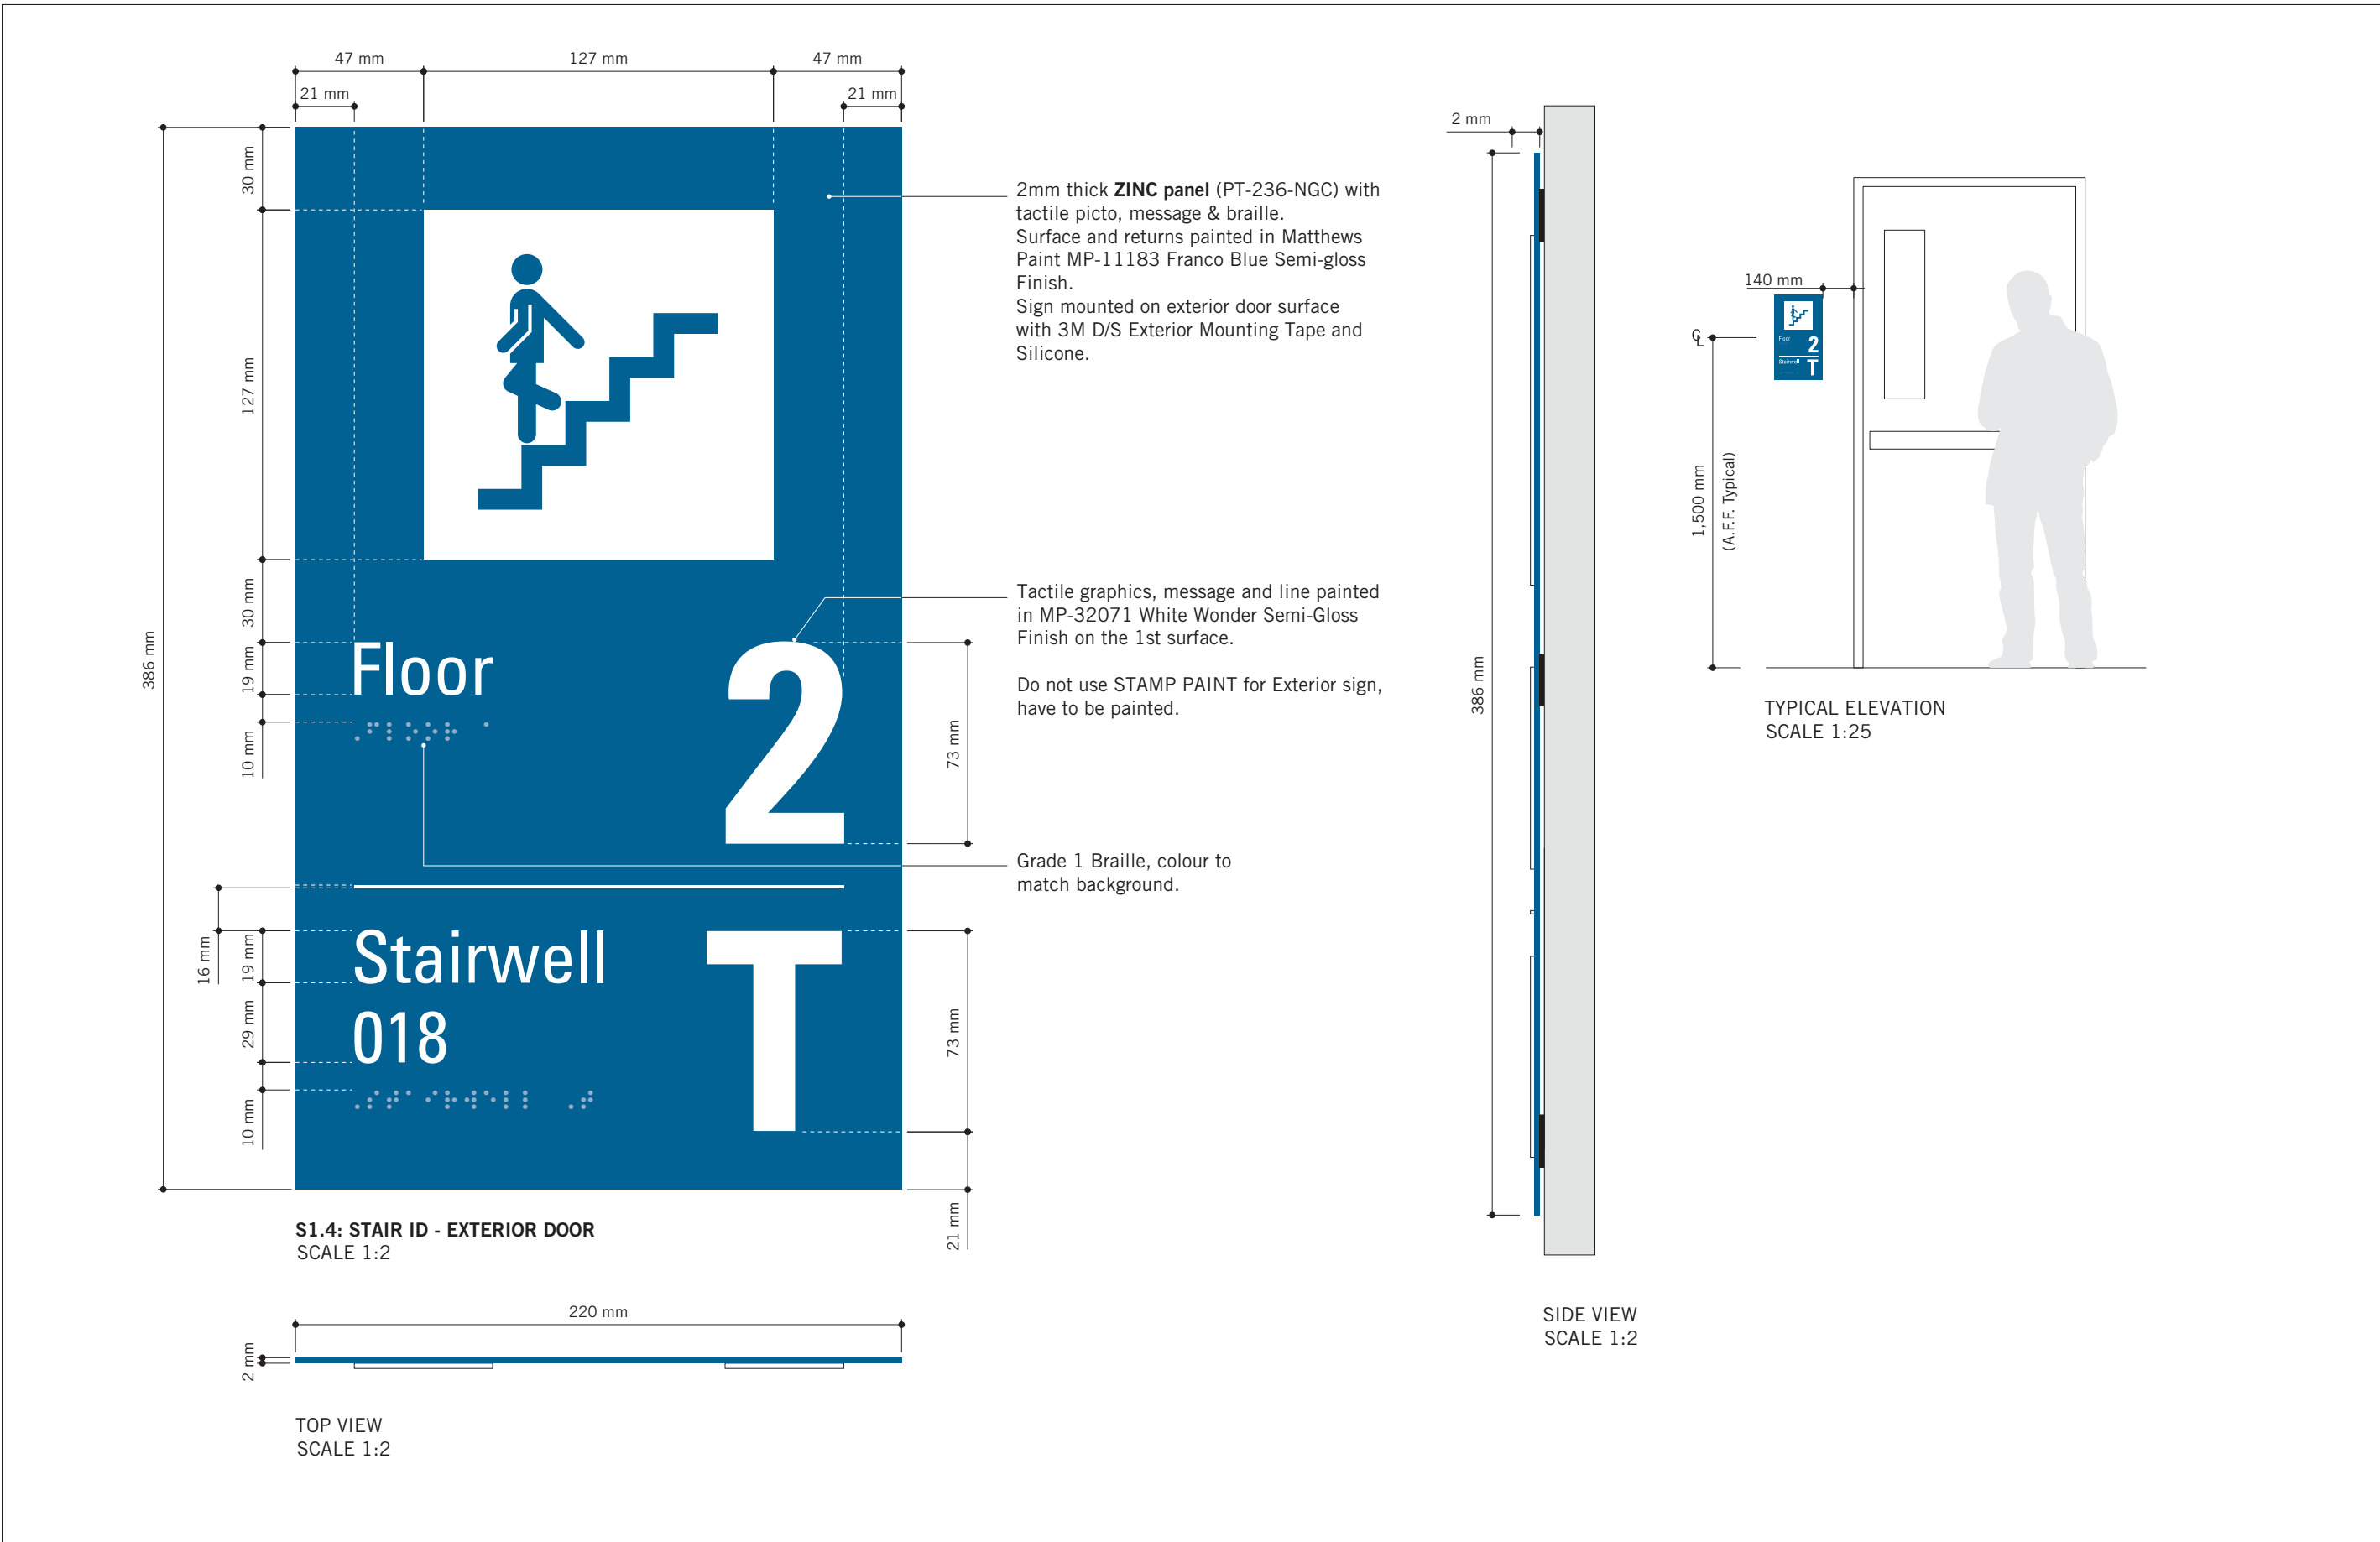
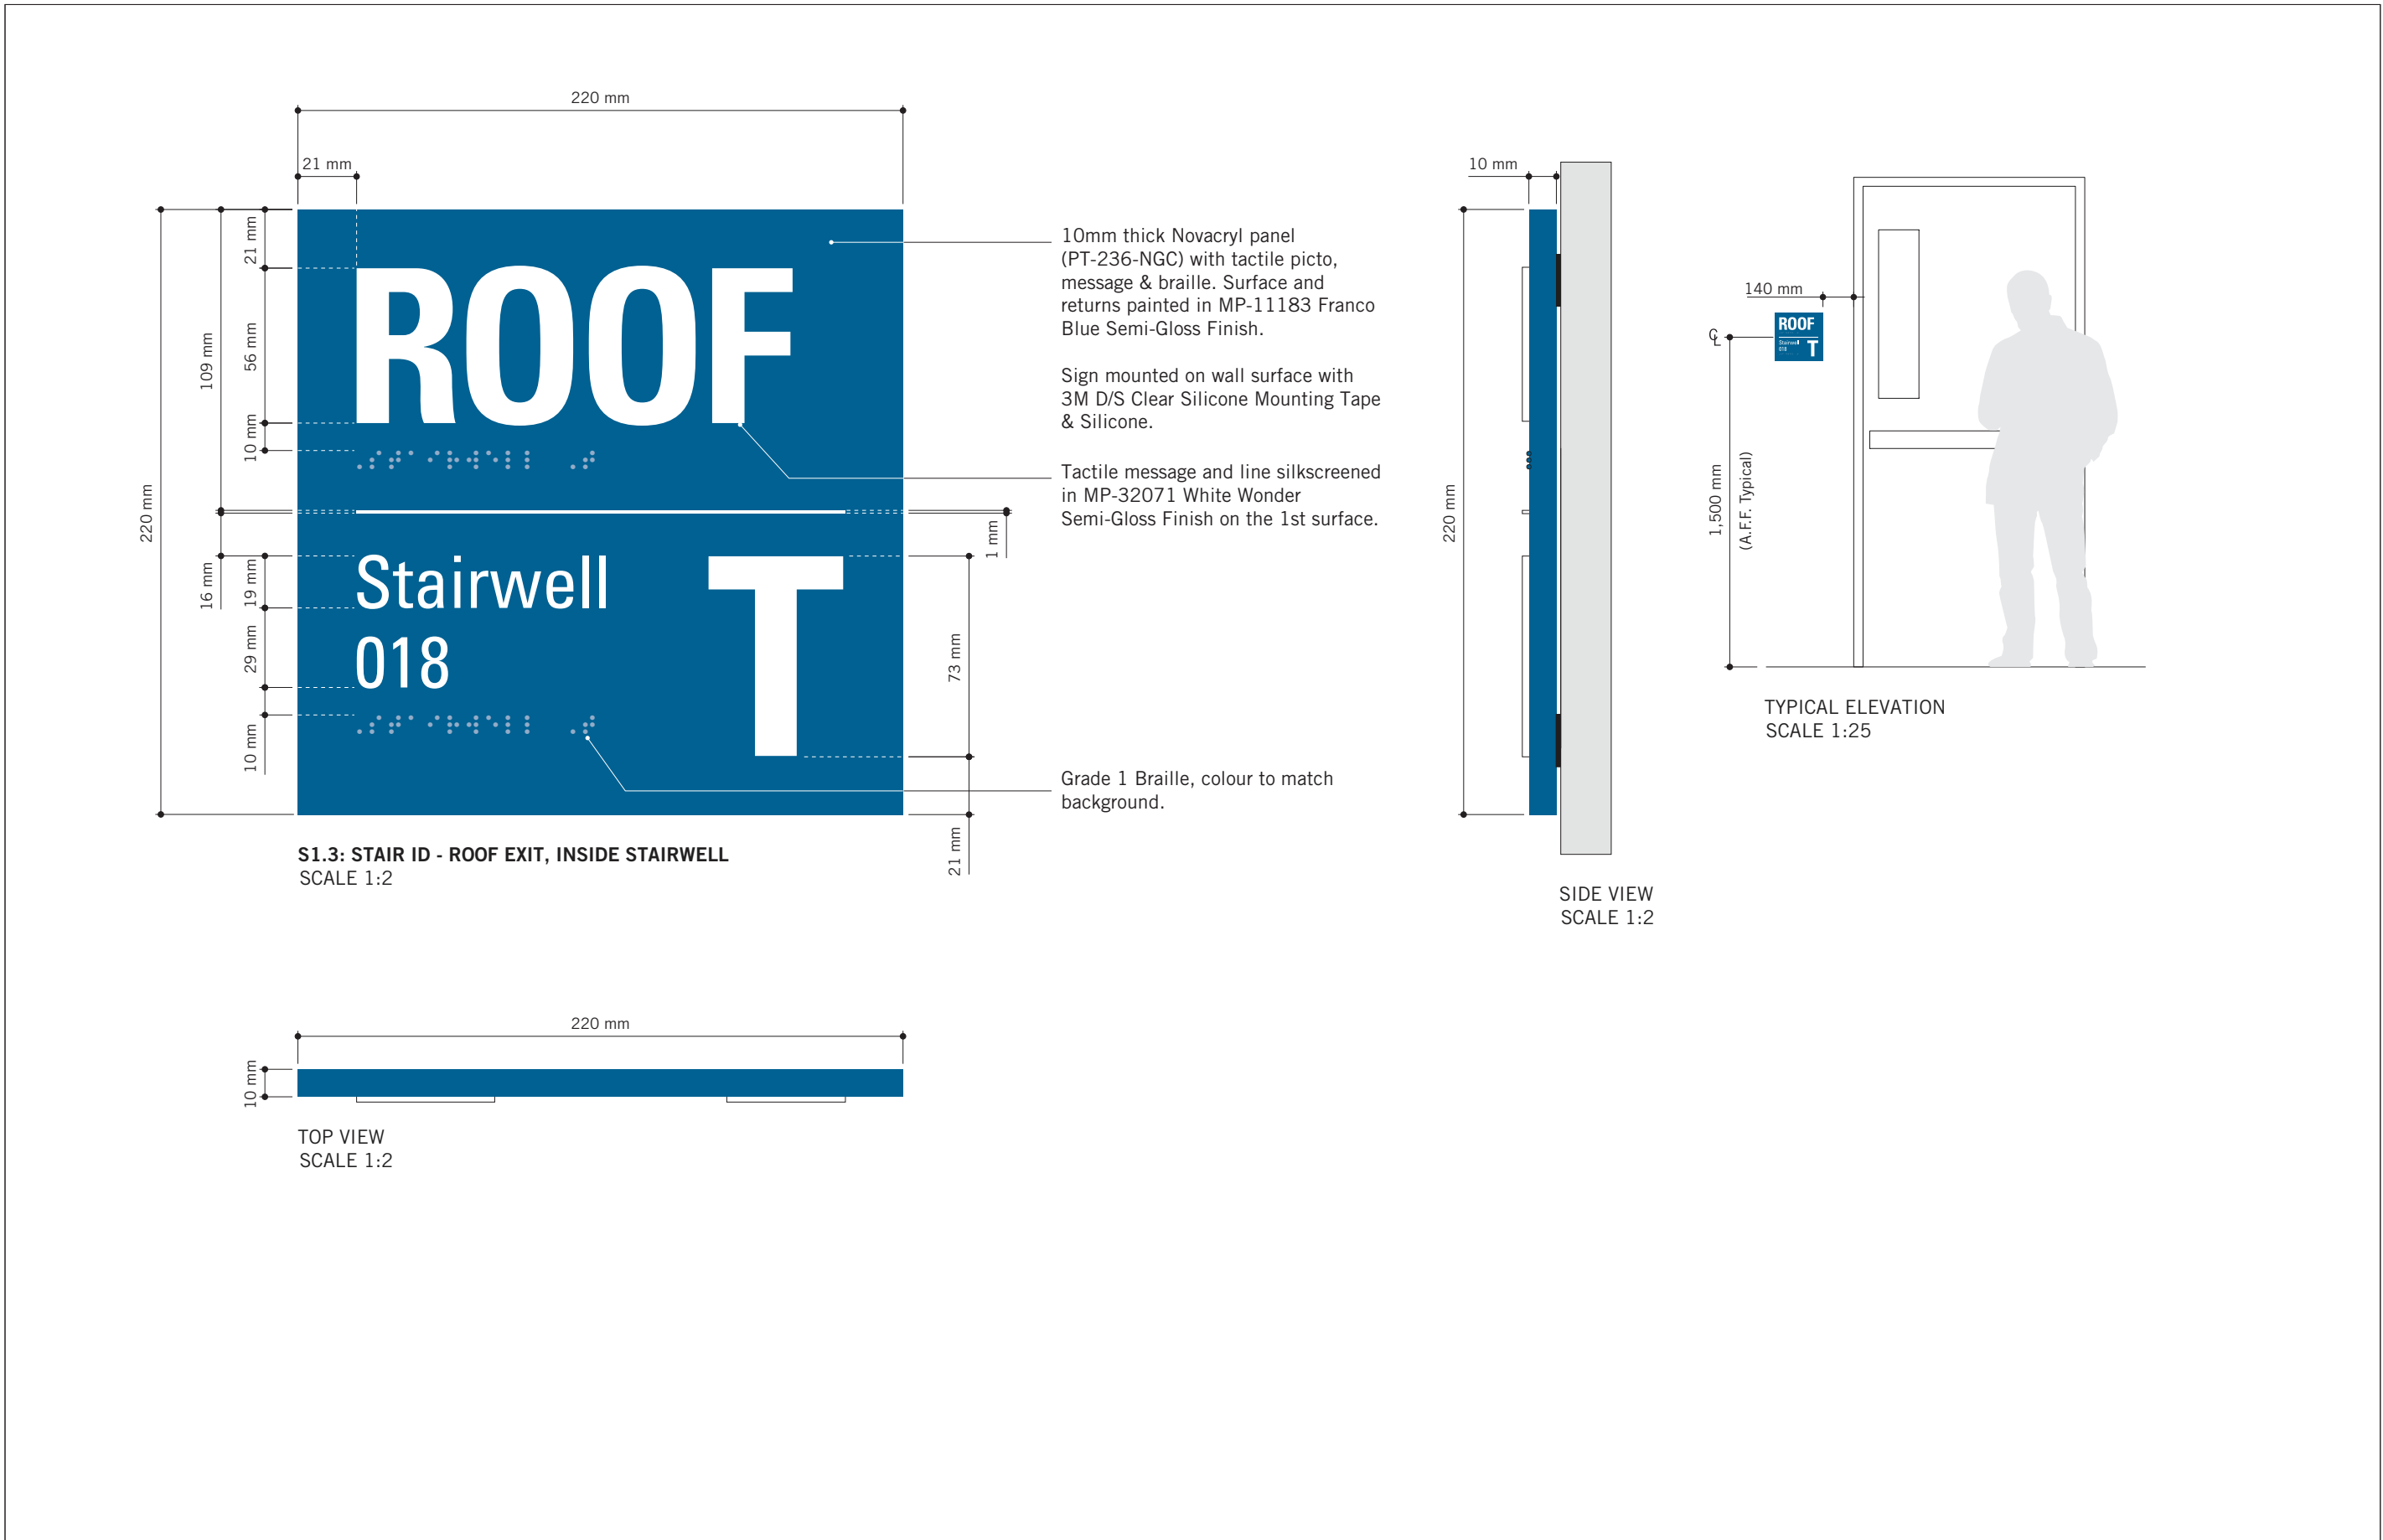
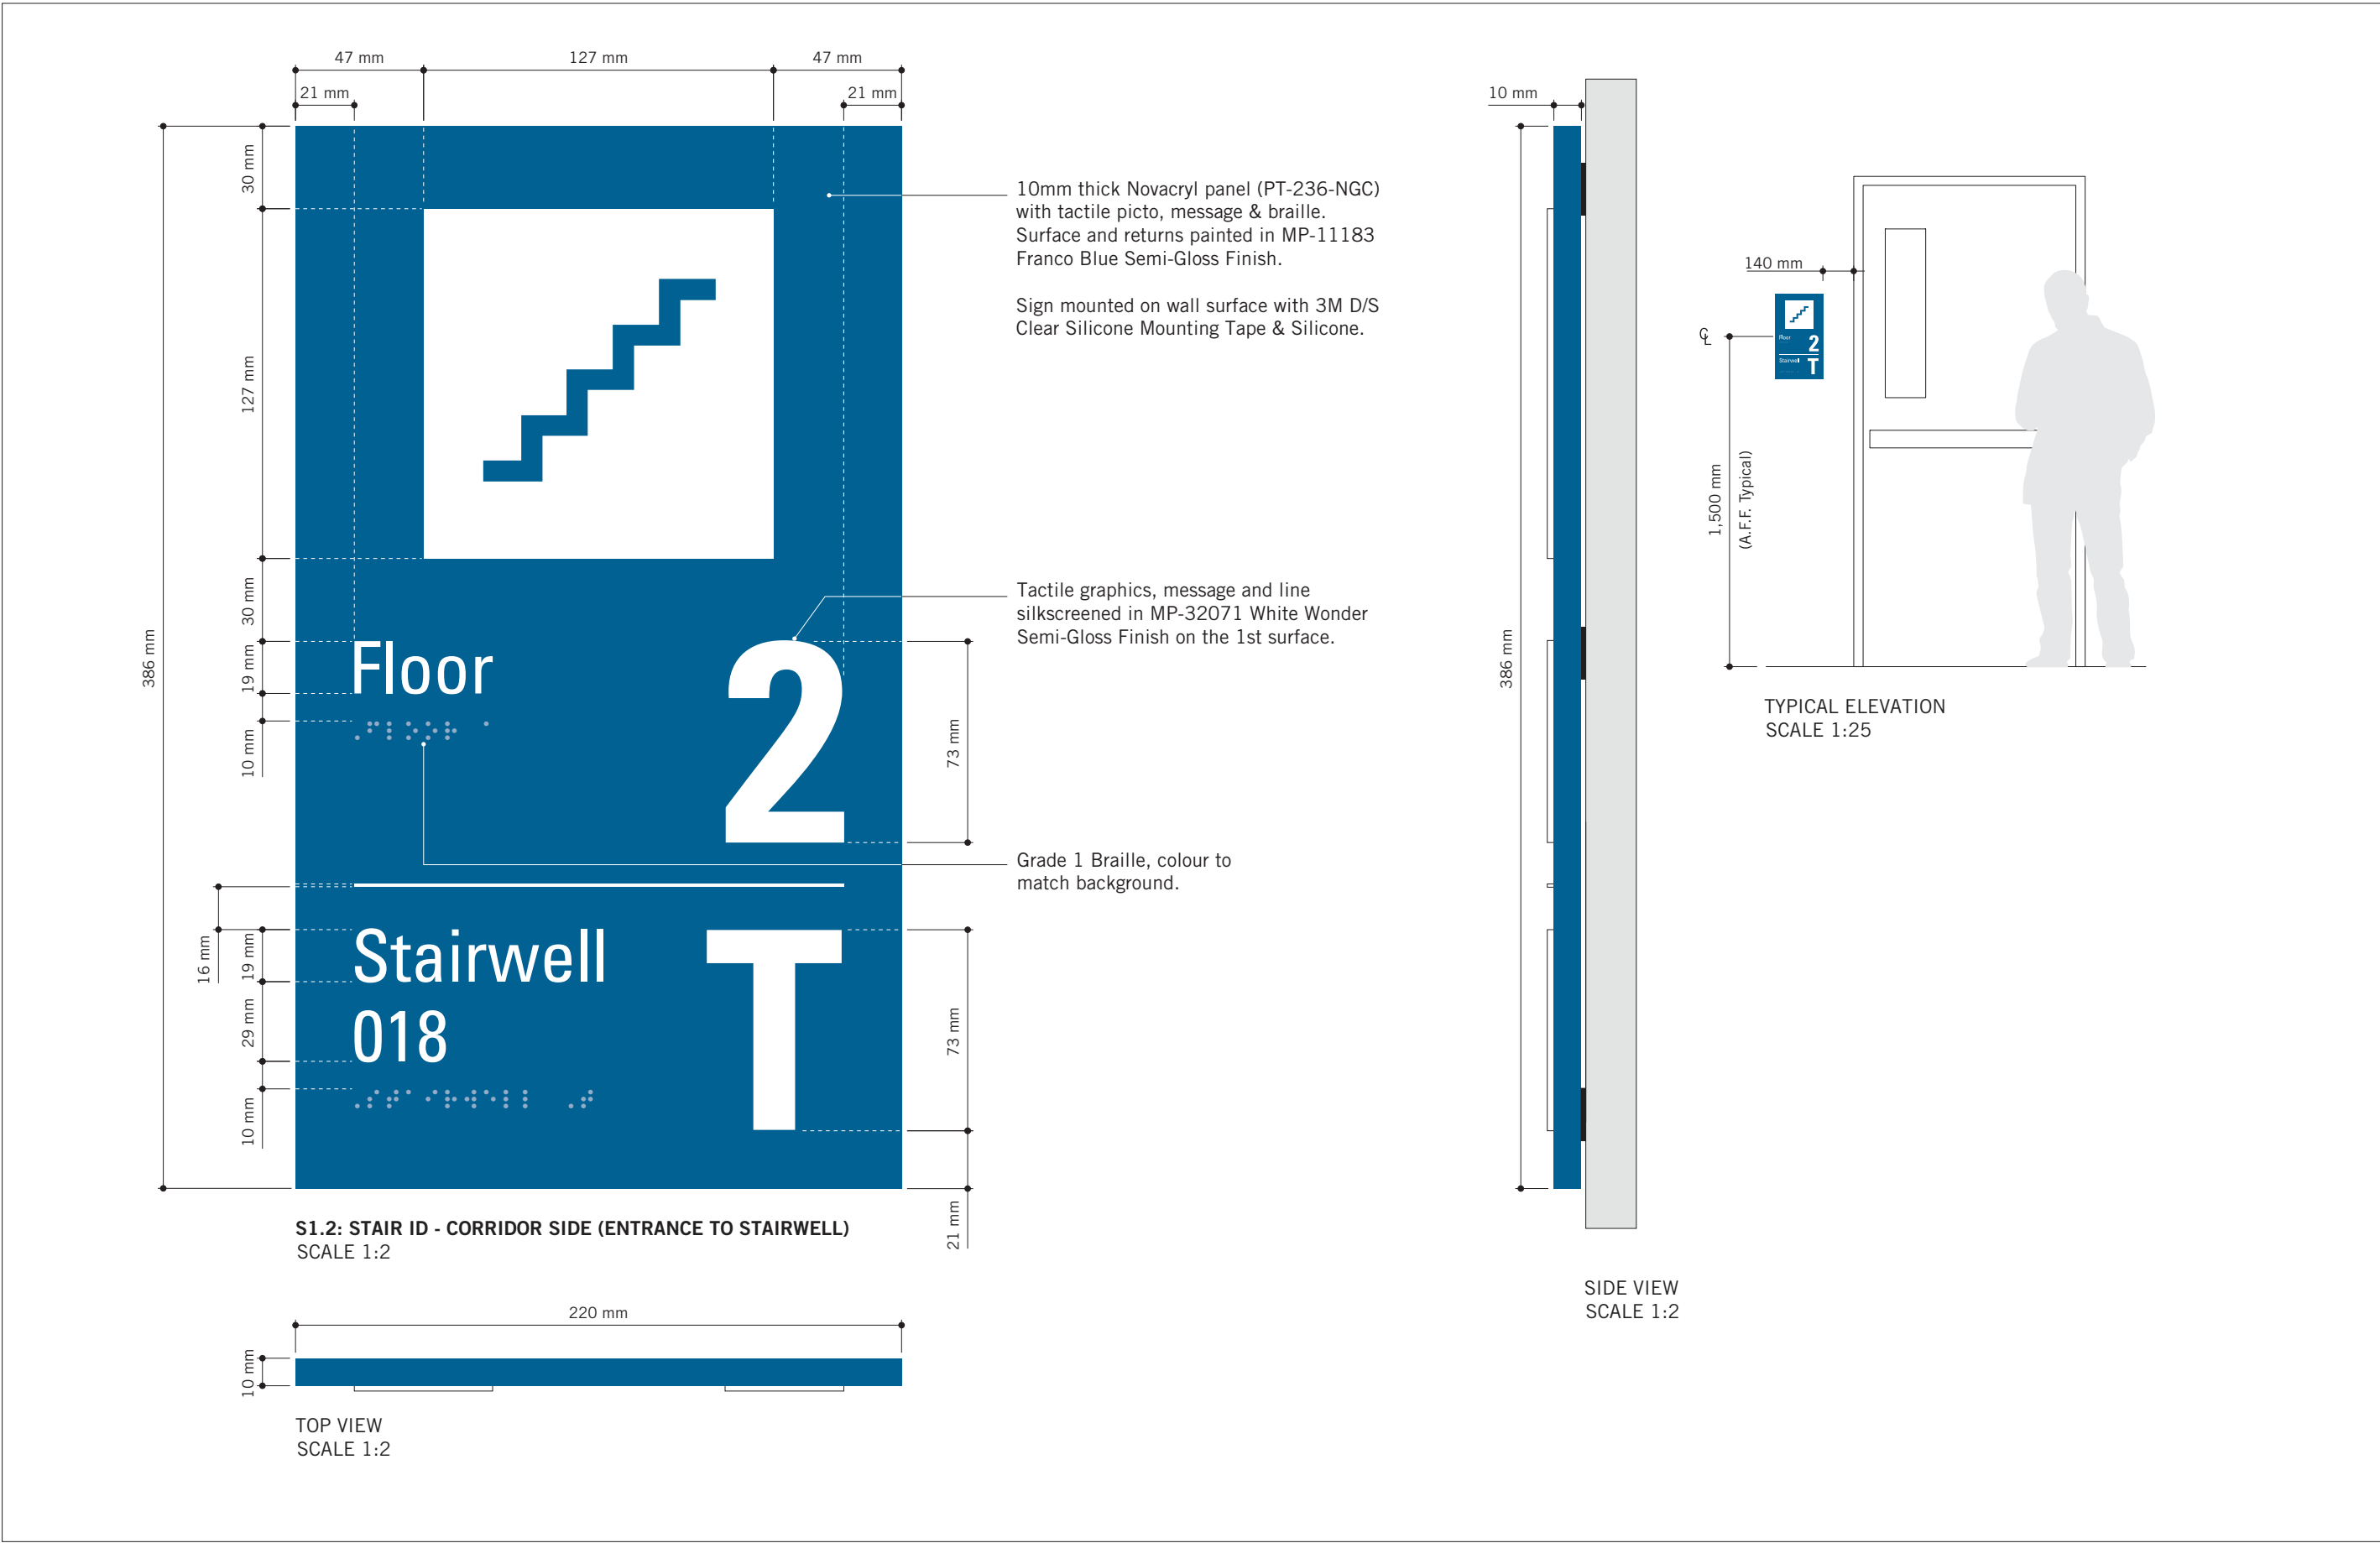
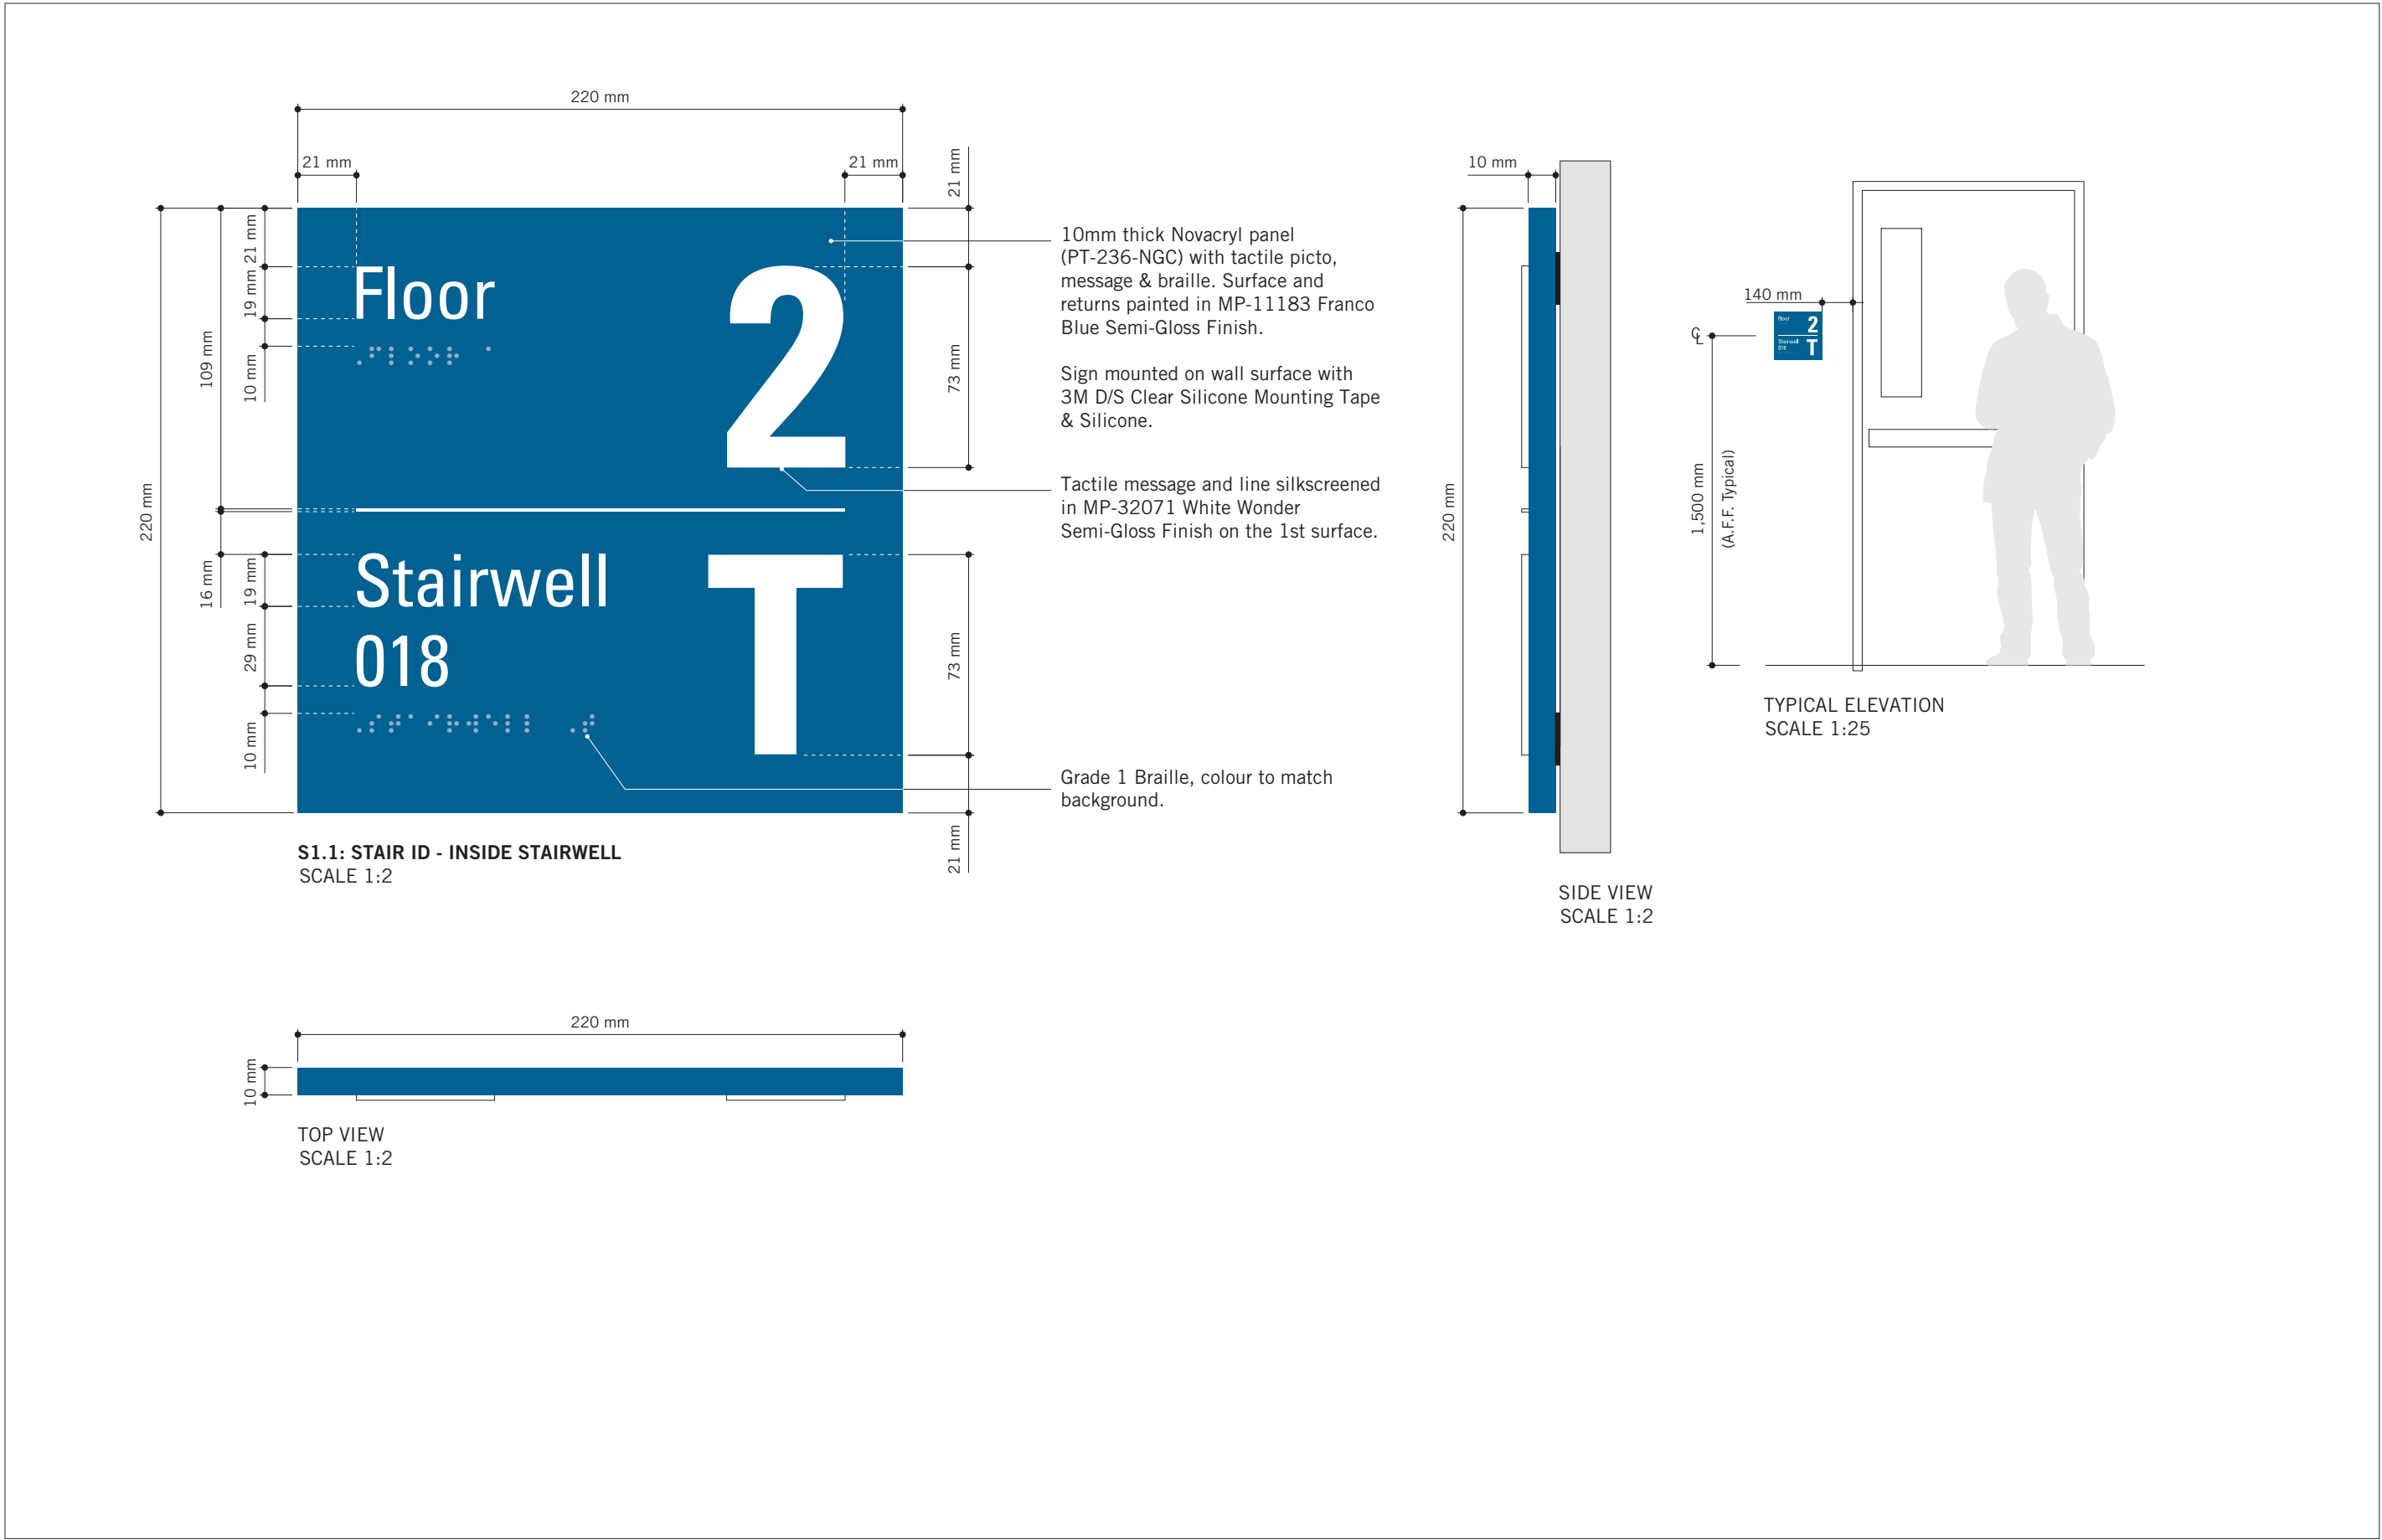
PROJECT TITLE
**CITY OF TORONTO
ACCESSIBILITY UPGRADES**

PROJECT ADDRESS
GROUP 05 BUILDINGS

PROJECT NO: 9119 – 19 – 0162 / Arcadis 30279056	
DRAWN BY: M.LOW	CHECKED BY: C.D. SCHNOBB
PROJECT MGR: R. DALY	APPROVED BY:

SHEET TITLE
**SIGNAGE & WAYFINDING
DETAILS
J4: ACCESSIBLE ENTRANCE**

SHEET NUMBER D1907	ISSUE A
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ISSUES		
No.	DESCRIPTION	DATE
A	ISSUED FOR TENDER	2025-04-11

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PROJECT TITLE
**CITY OF TORONTO
ACCESSIBILITY UPGRADES**


PROJECT ADDRESS
GROUP 05 BUILDINGS

PROJECT NO:
9119 – 19 – 0162 / Arcadis 30279056


DRAWN BY: M.LOW	CHECKED BY: C.D. SCHNOBB
PROJECT MGR: R. DALY	APPROVED BY:

SHEET TITLE
**SIGNAGE & WAYFINDING
DETAILS
S1: STAIR ID**


SHEET NUMBER D1908	ISSUE A
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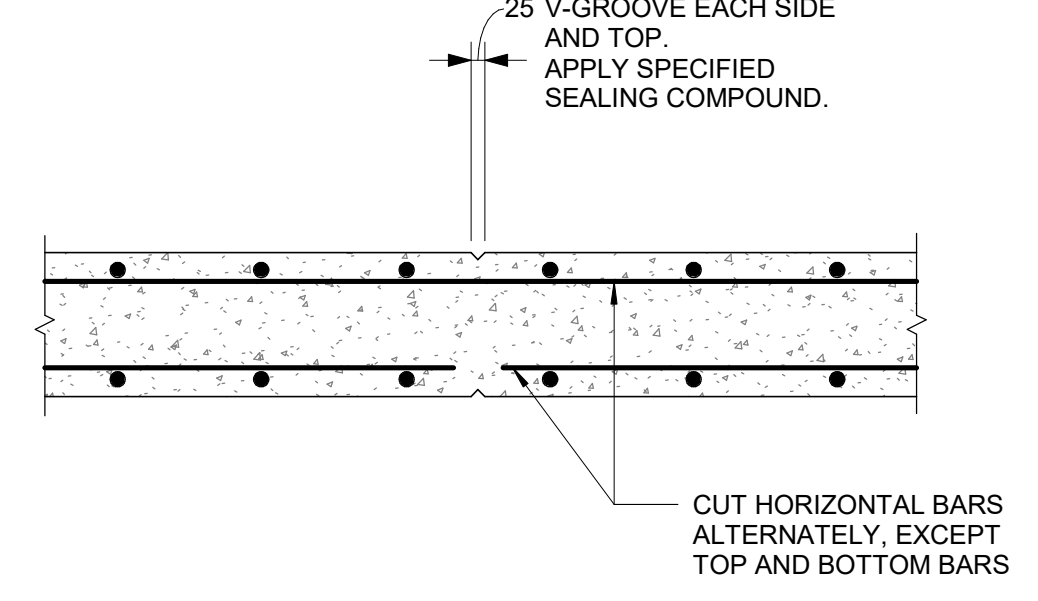
1 INTERIOR FOUNDATION WALL
D2100 Scale: NTS

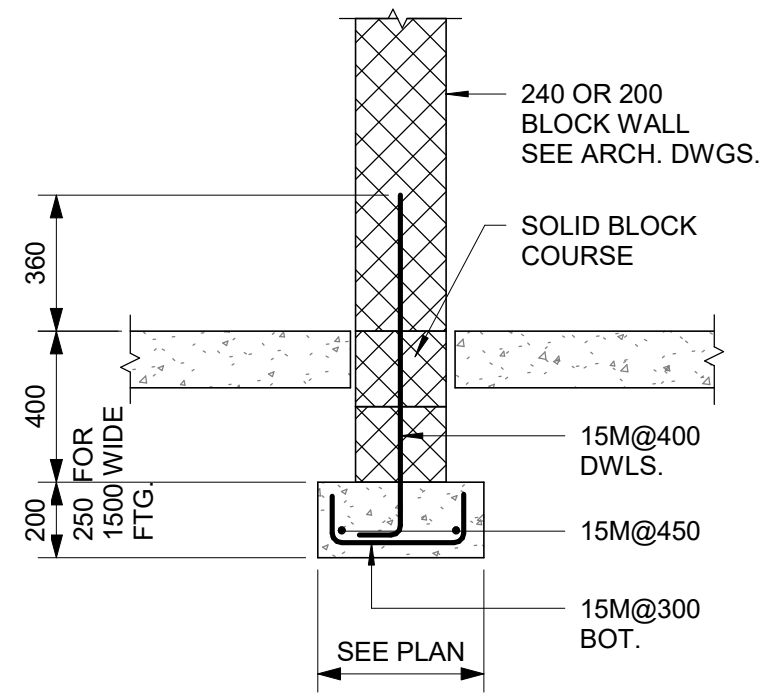


2 NEW SLAB CONNECTION TO EXISTING SLAB
D2100 Scale: NTS

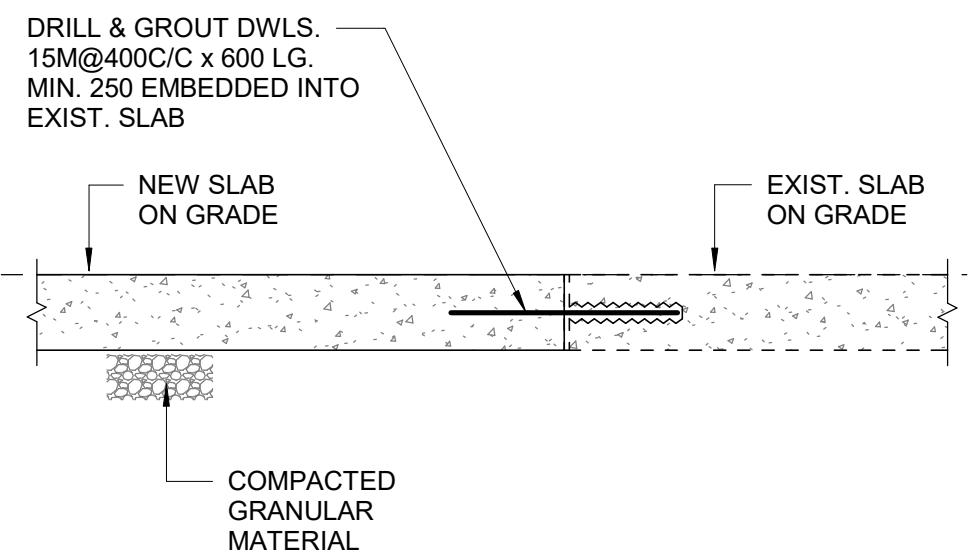


3 SLAB ON GRADE
D2100 Scale: NTS

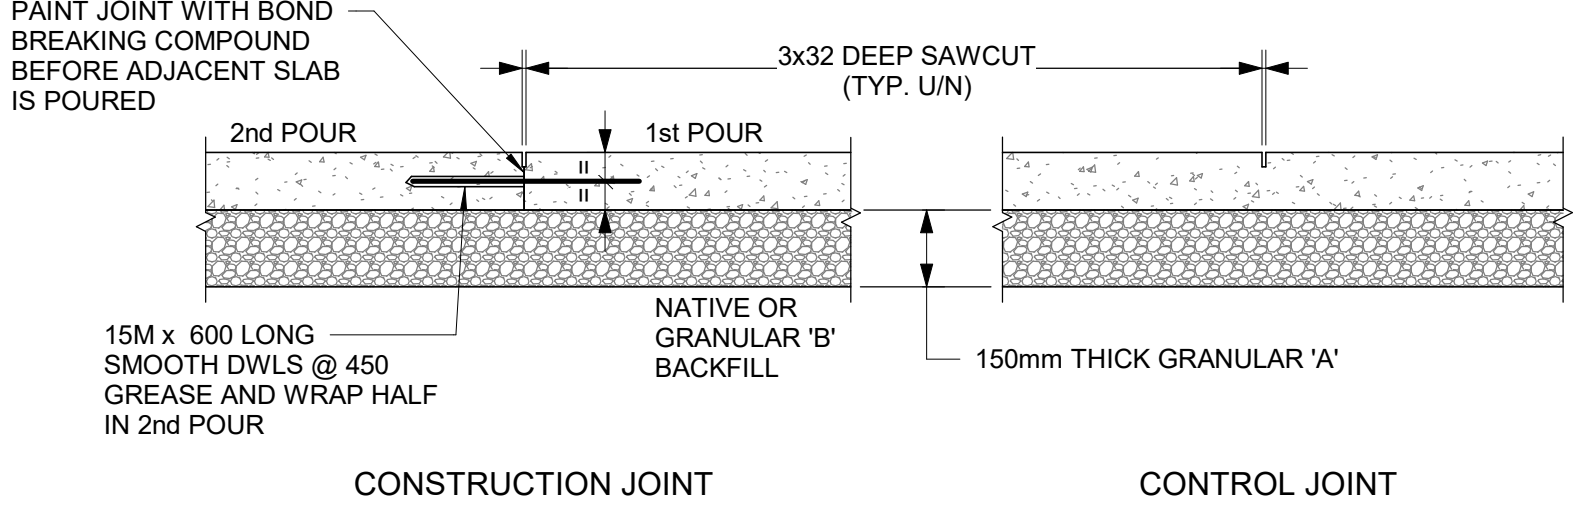

4 RETAINING WALL CONTROL JOINT
D2100 Scale: 1 : 20

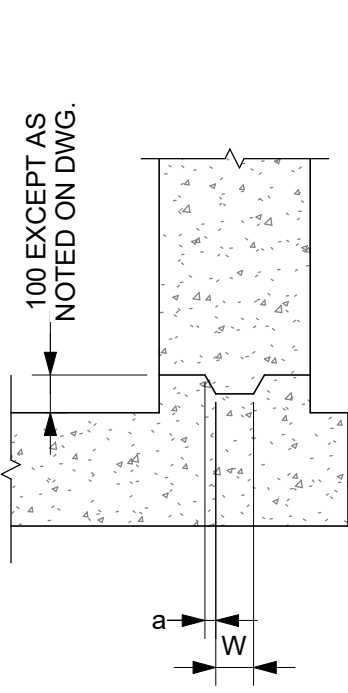


TYPE 1

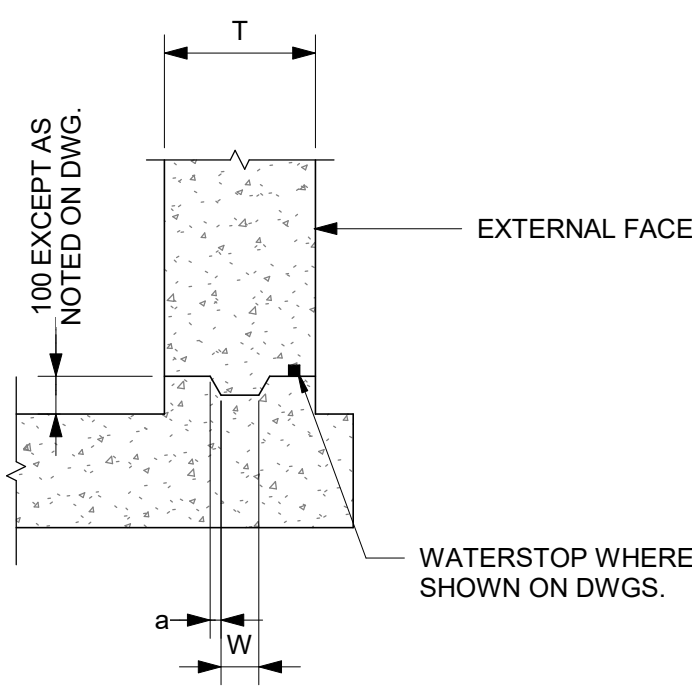


TYPE 1WS

WALL THICKNESS "T"	KEY SIZE		"a"
	"D"	"W"	
200 TO 300	50	100	5
310 TO 440	50	150	10
450 TO 590	75	200	20
600 TO 890	75	250	20


5 TYPICAL CONSTRUCTION JOINT AT EXTERIOR WALL
D2100 Scale: 1 : 20

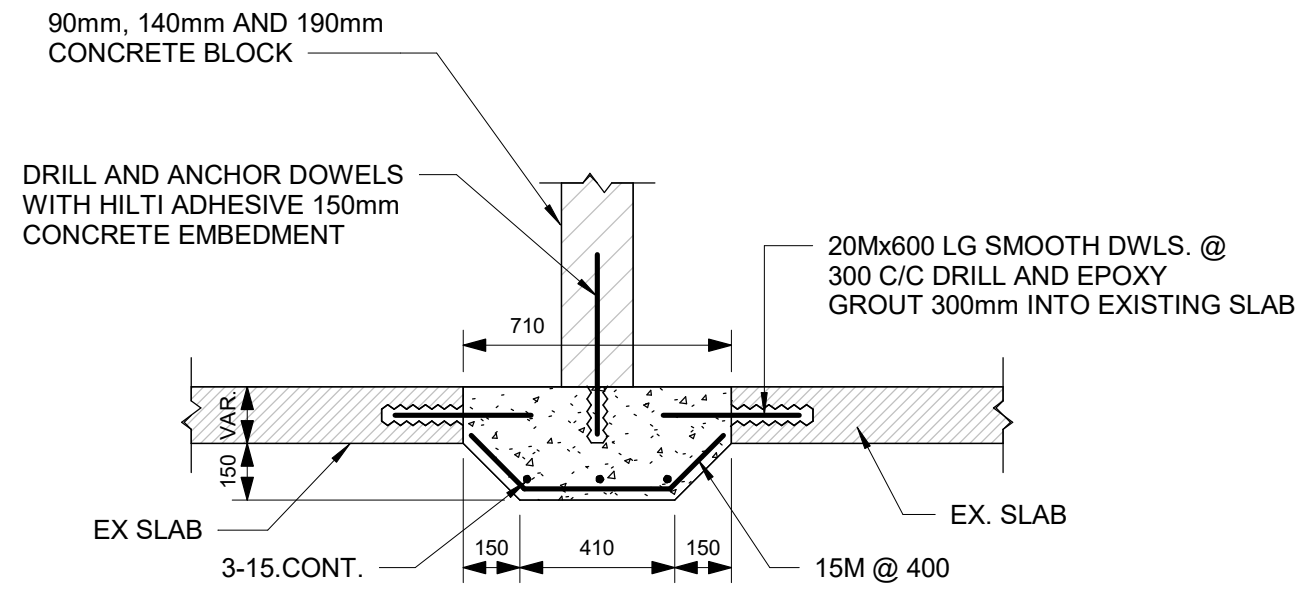

6 BLOCK WALL SLAB - THICKENING AT EXISTING SLAB
D2100 Scale: 1 : 20

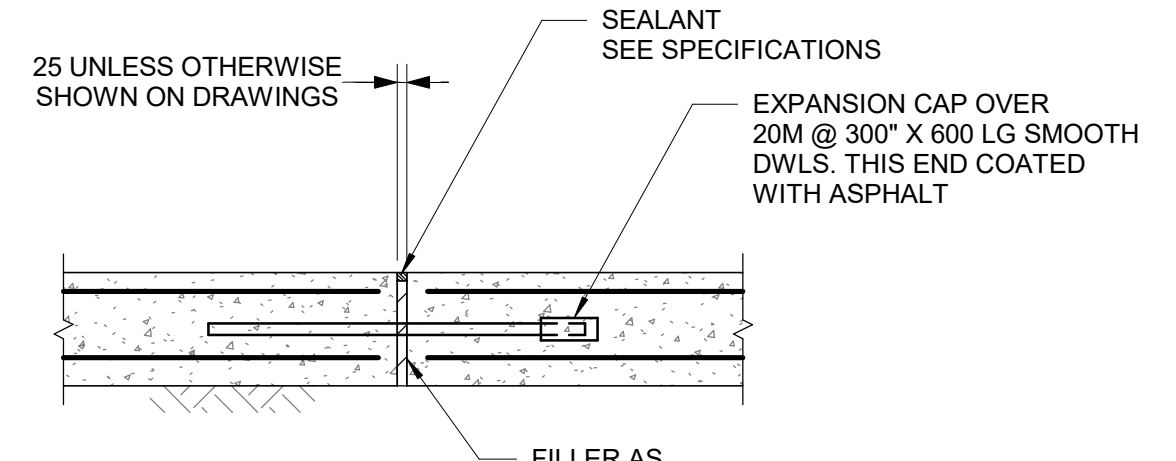


EXPANSION JOINTS

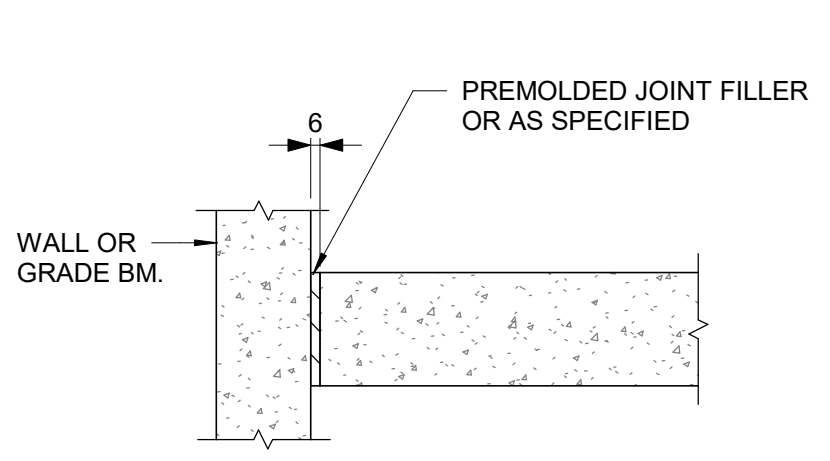

ISOLATION JOINT

7 FLOOR JOINTS
D2100 Scale: 1 : 20

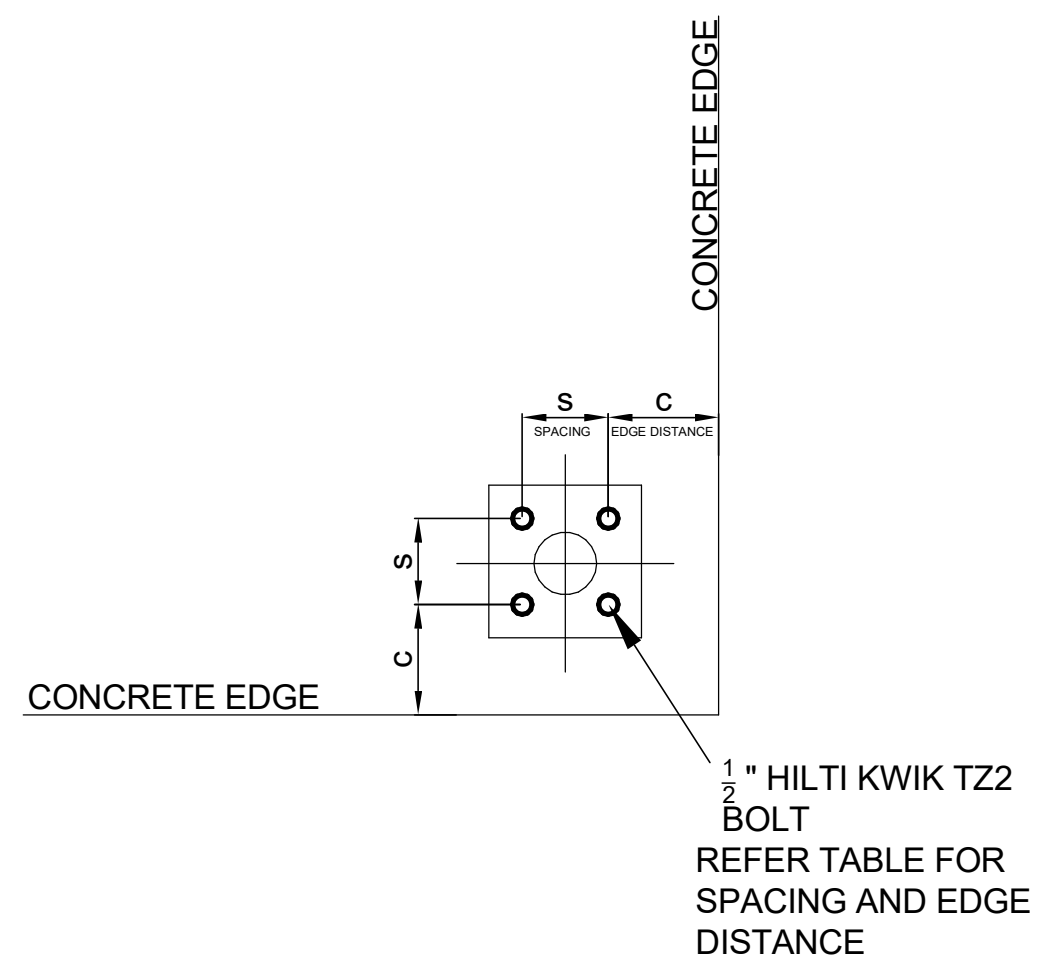

8 SPACING AND EDGE REQUIREMENTS FOR WEDGE ANCHORS (TYPICALLY USED FOR HANDRAILS)
D2100 Scale: 1 : 5

HILTI KWIKBOLT TZ2 CARBON STEEL, DIA 1/2"					
CONCRETE THICKNESS	EFFECTIVE EMBEDMENT	Case 1		Case 2	
		MIN EDGE DIST. C _{MIN1}	FOR SPACING S _{MIN1}	MIN EDGE DIST. C _{MIN2}	FOR SPACING S _{MIN2}
200	83	57	133	121	51
150	64	70	248	203	76
125	51	70	140	254	89
100	38	203	305	203	305


ISSUES		
No.	DESCRIPTION	DATE
A	50% SUBMISSION	2022-04-27
B	90% SUBMISSION	2022-07-29
C	ISSUED FOR PERMIT	2022-07-29
D	ISSUED FOR TENDER	2022-12-09
E	ISSUED FOR TENDER	2025-04-11

CONSULTANTS


SEAL

PROJECT ADDRESS


4/29/2025 11:45:10 AM

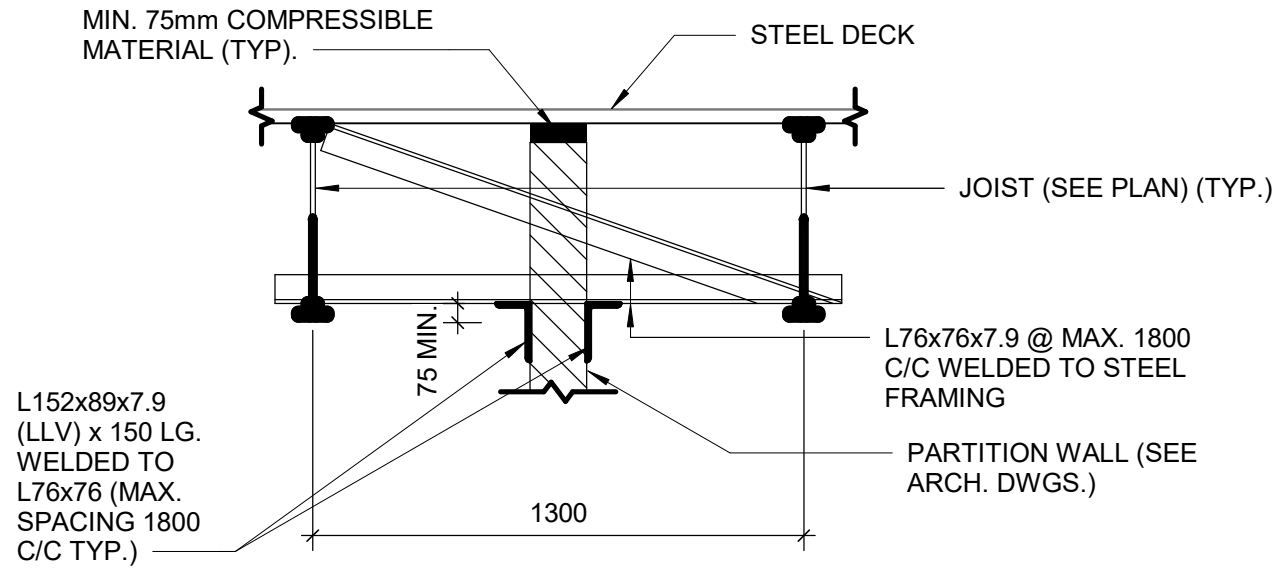


1 PARTITION WALL BETWEEN JOIST
D2200 Scale: 1 : 20

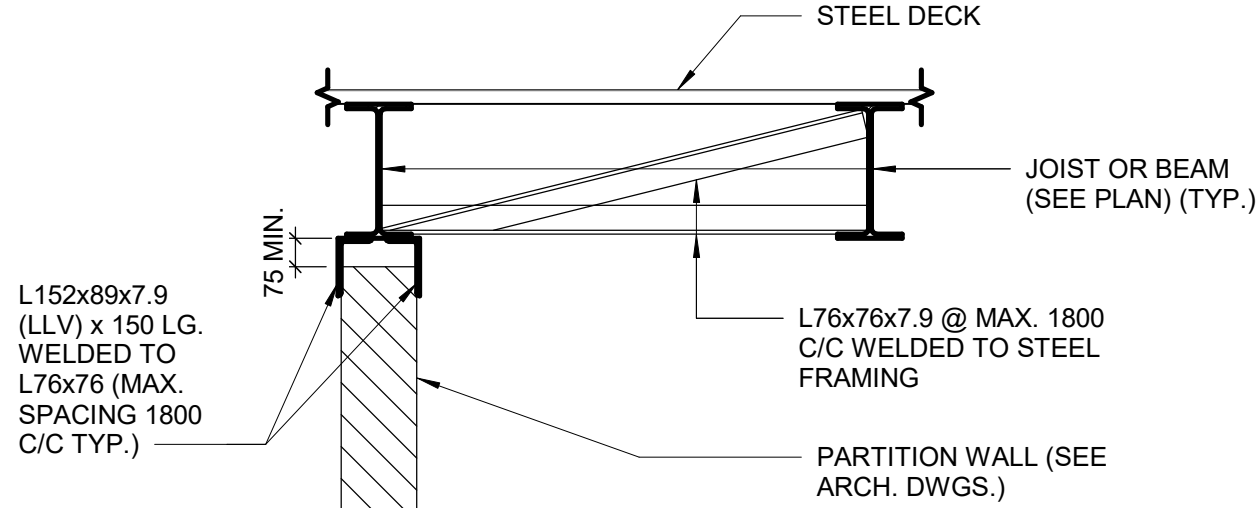


2 PARTITION WALL PARALLEL TO AND CENTERED ON JOIST OR BEAM
D2200 Scale: 1 : 20

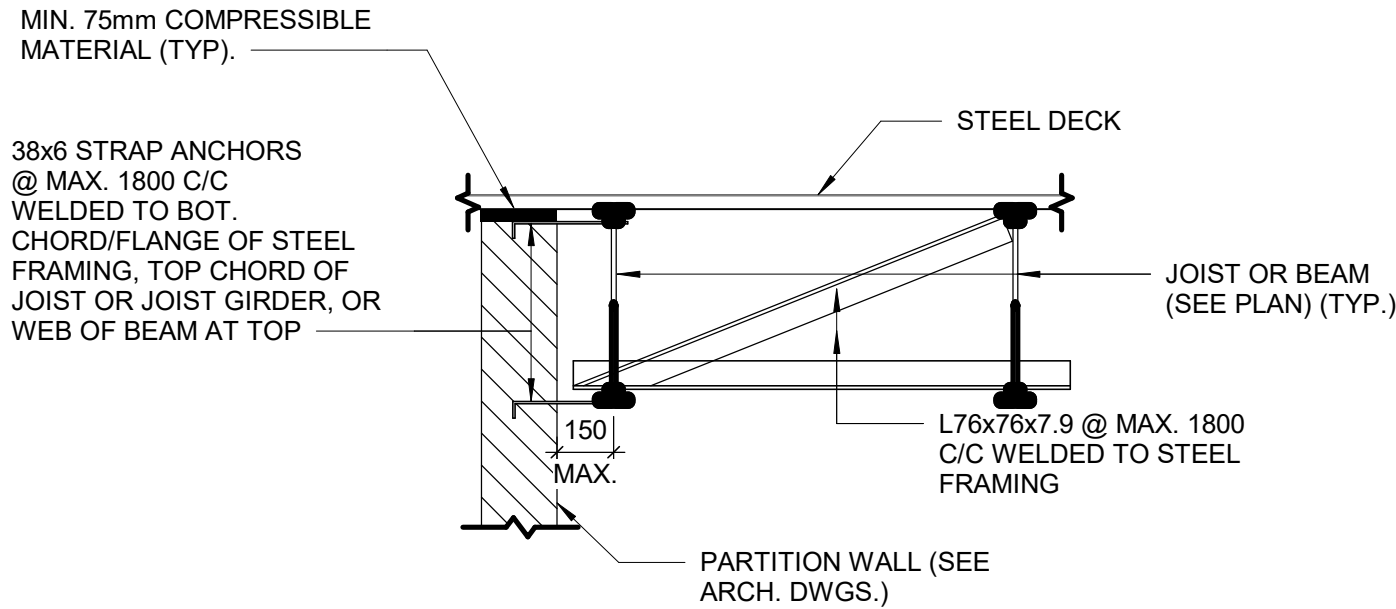


3 PARTITION WALL PARALLEL TO JOISTS OR BEAM
D2200 Scale: 1 : 20

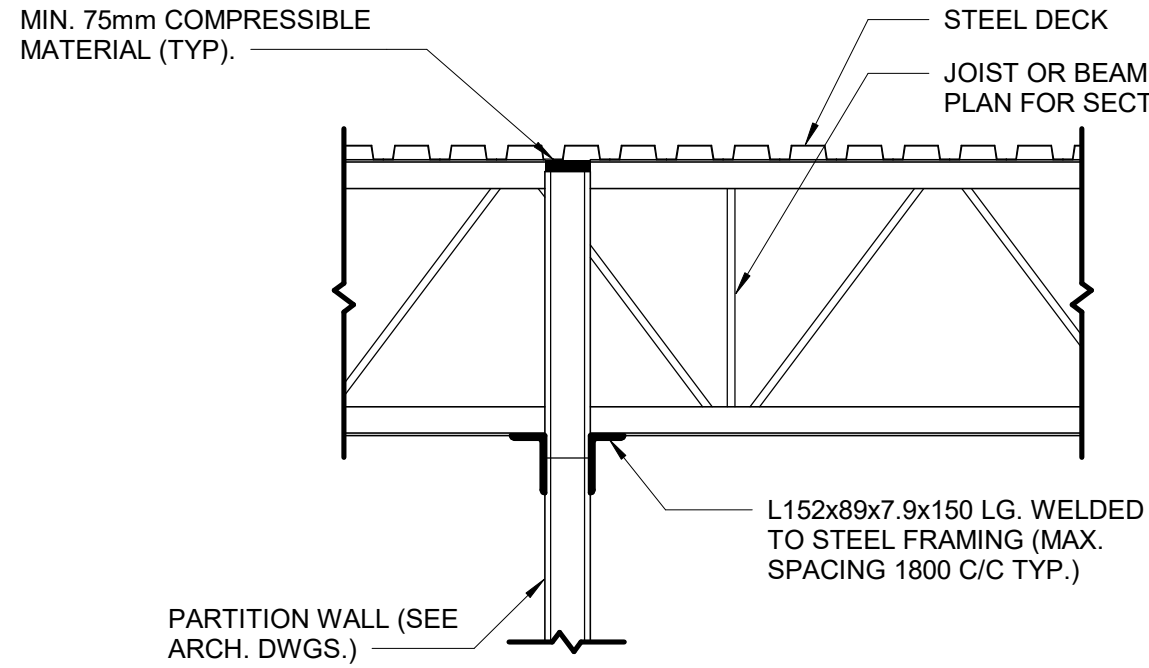


4 PARTITION WALL PERPENDICULAR TO JOIST OR BEAM
D2200 Scale: 1 : 20

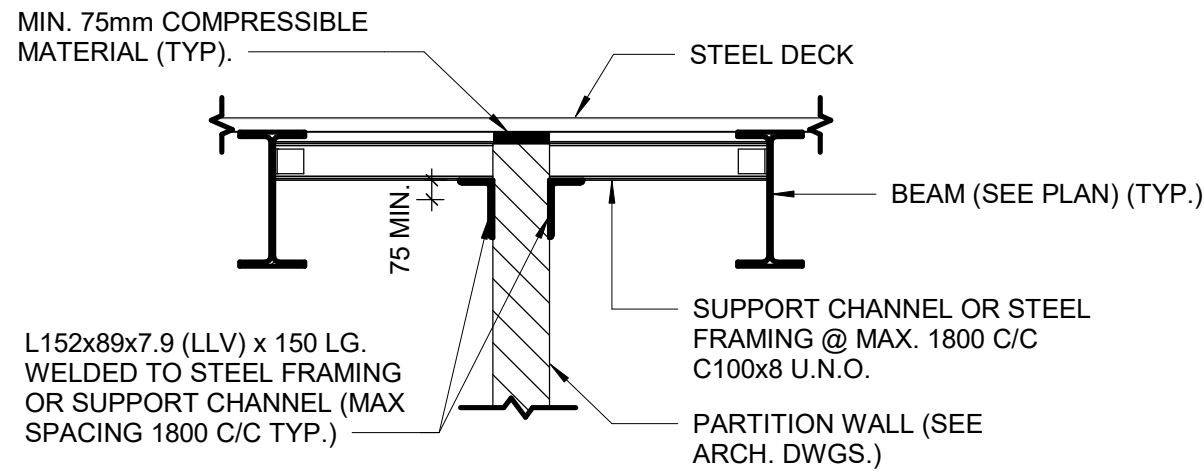

5 PARTITION WALL BETWEEN BEAMS
D2200 Scale: 1 : 20

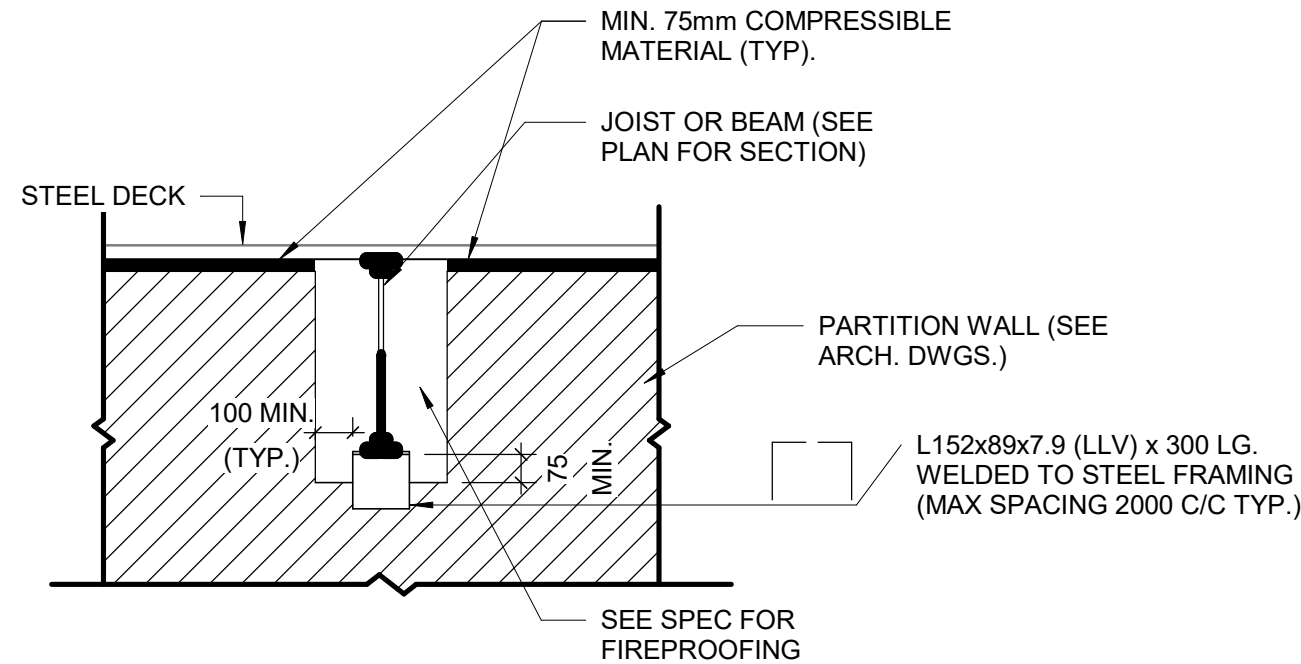


6 PARTITION PERPENDICULAR TO JOIST OR BEAMS
D2200 Scale: 1 : 20

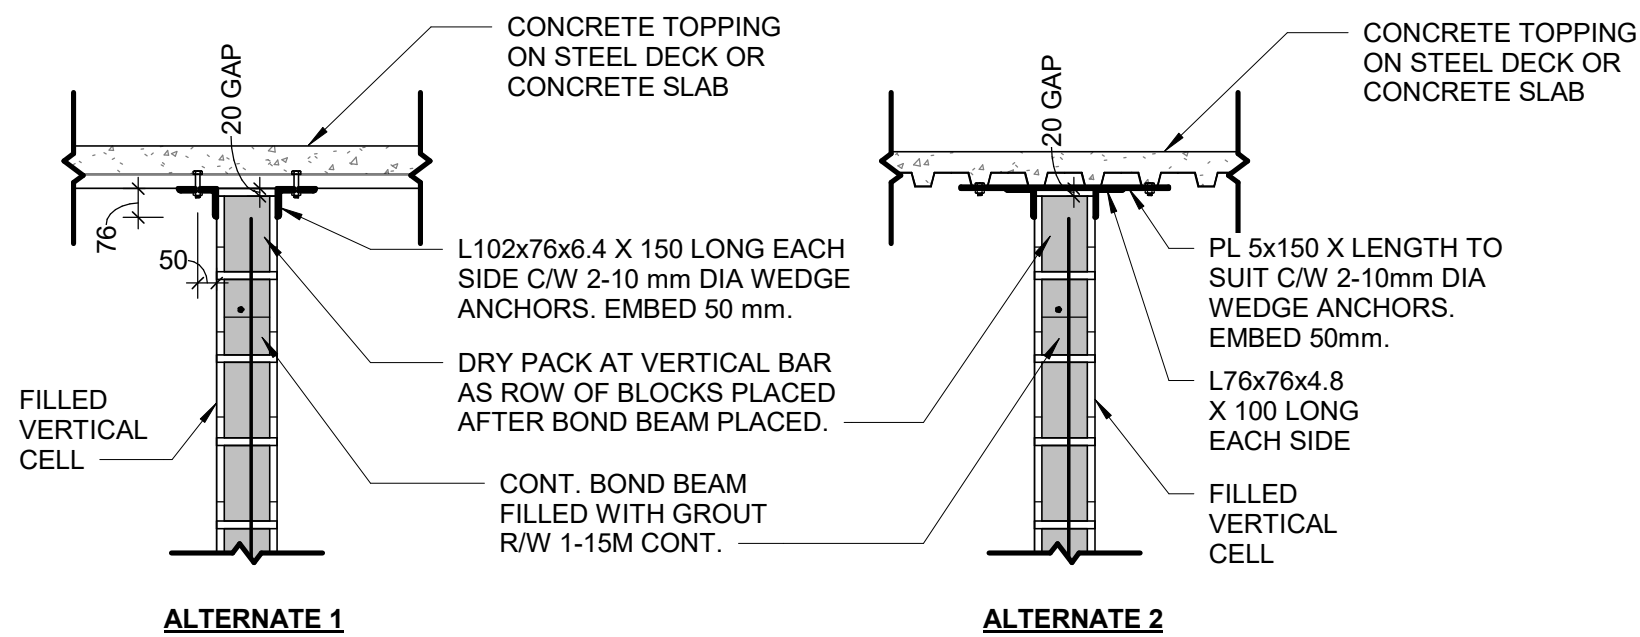


NOTES:
1. ALL CONNECTIONS TO BE AT FILLED VERTICAL CELLS AT 1200 mm O/C MAXIMUM UNLESS NOTED OTHERWISE.
2. FIELD WELD ANGLES TO EMBEDDED PLATE.


7 SUPPORT DETAIL AT TOP OF BLOCK WALL
D2200 Scale: 1 : 20

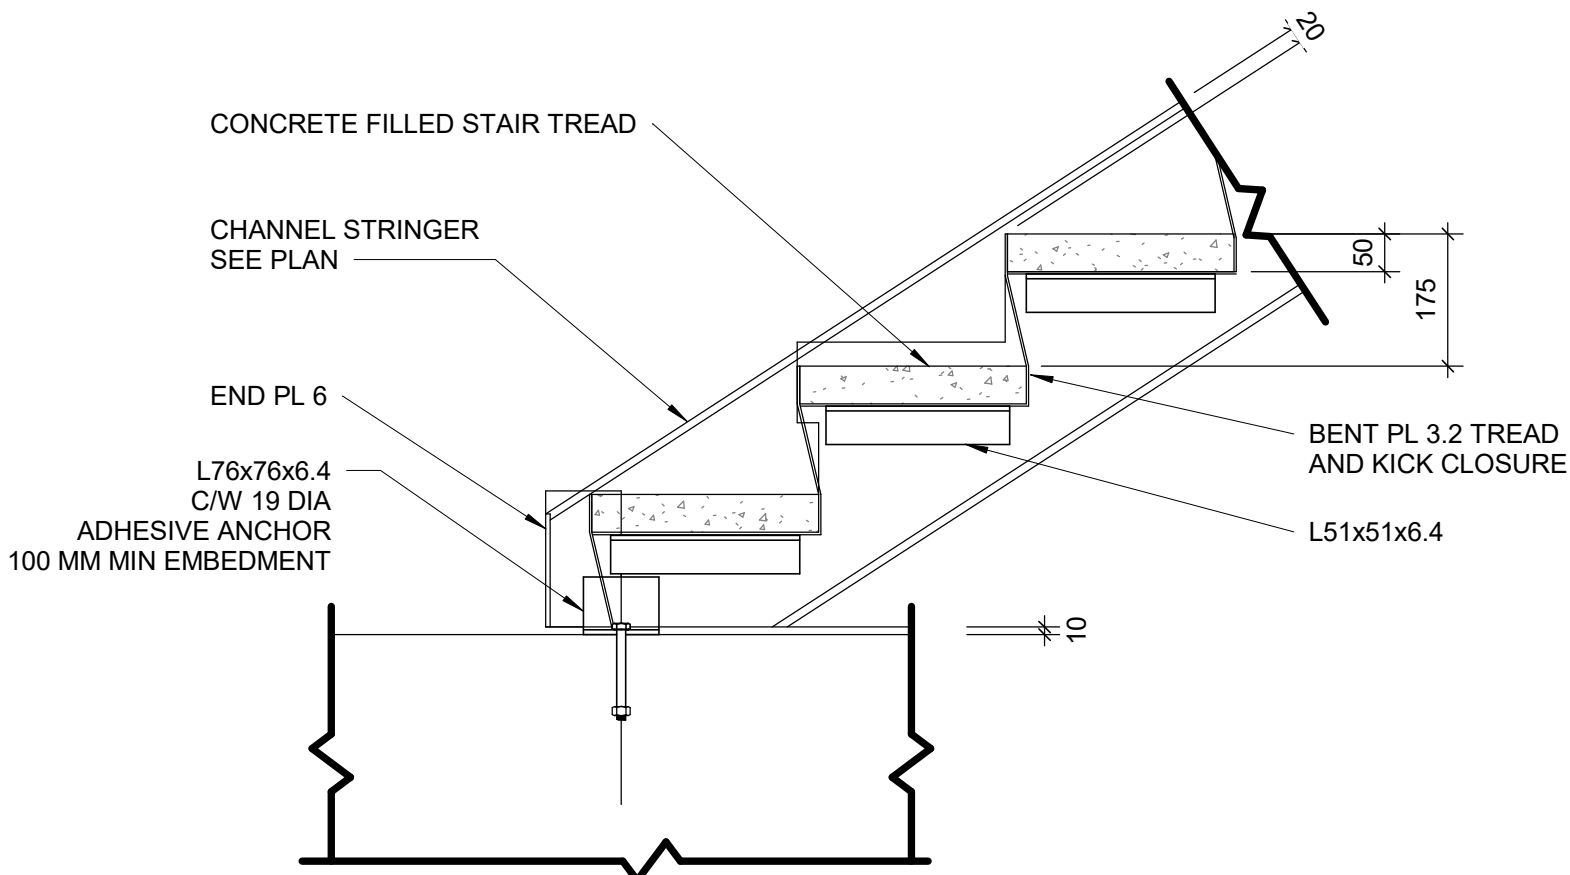


8 TYPICAL SLAB UNDER STRINGER
D2200 Scale: 1 : 10

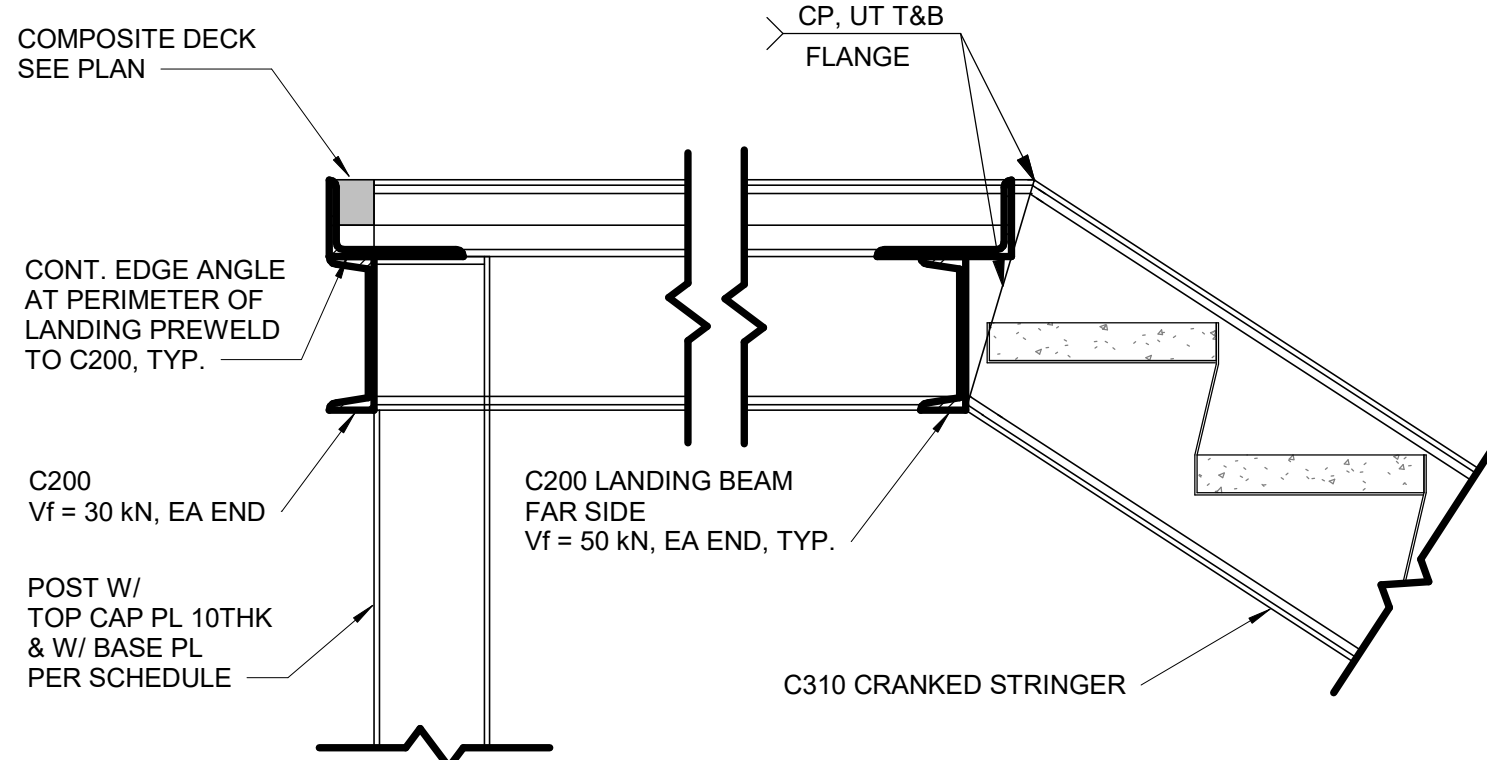


9 TYPICAL SECTION AT UPPER LANDING STRINGER
D2200 Scale: 1 : 10

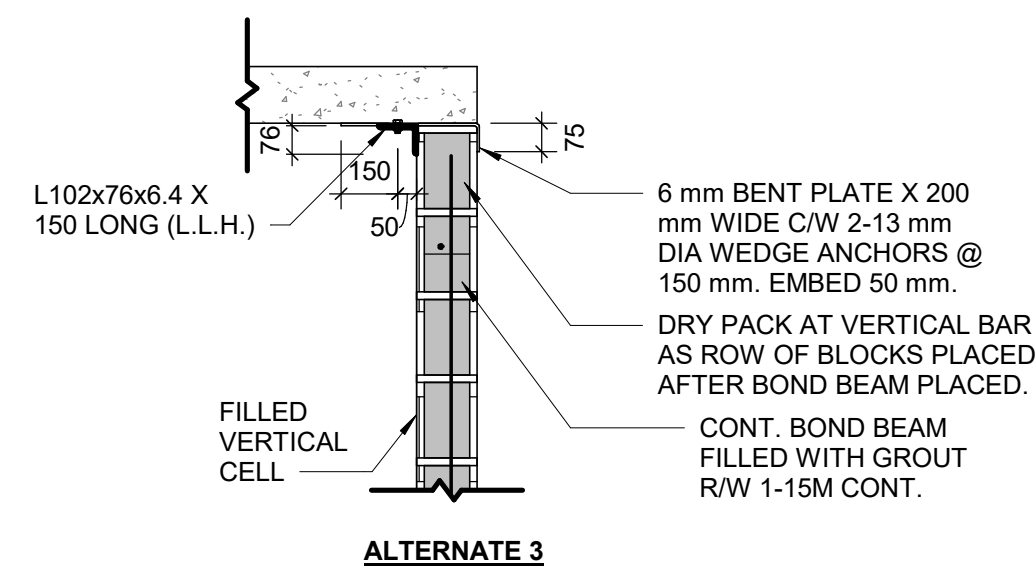

10 TYPICAL SECTION AT UPPER LANDING
D2200 Scale: 1 : 10

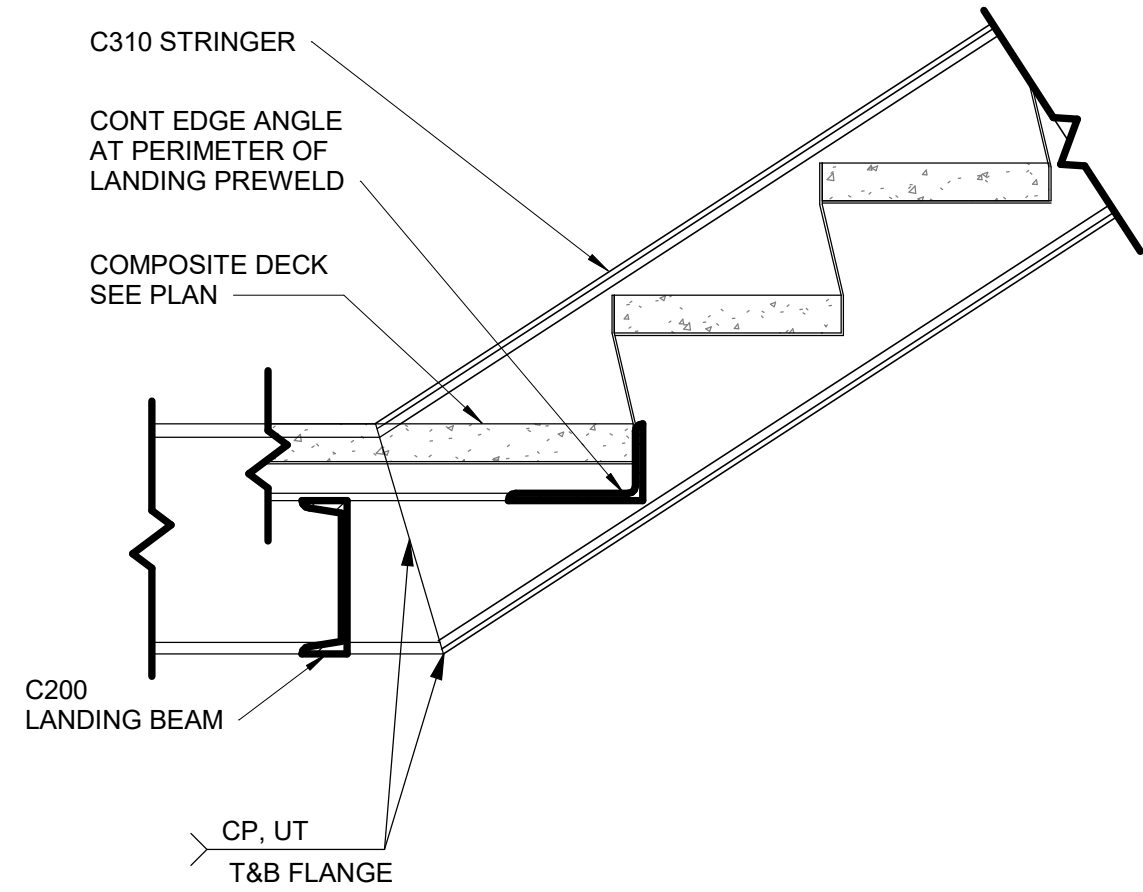

12 TYPICAL SECTION AT LOWER LANDING STRINGER
D2200 Scale: 1 : 10

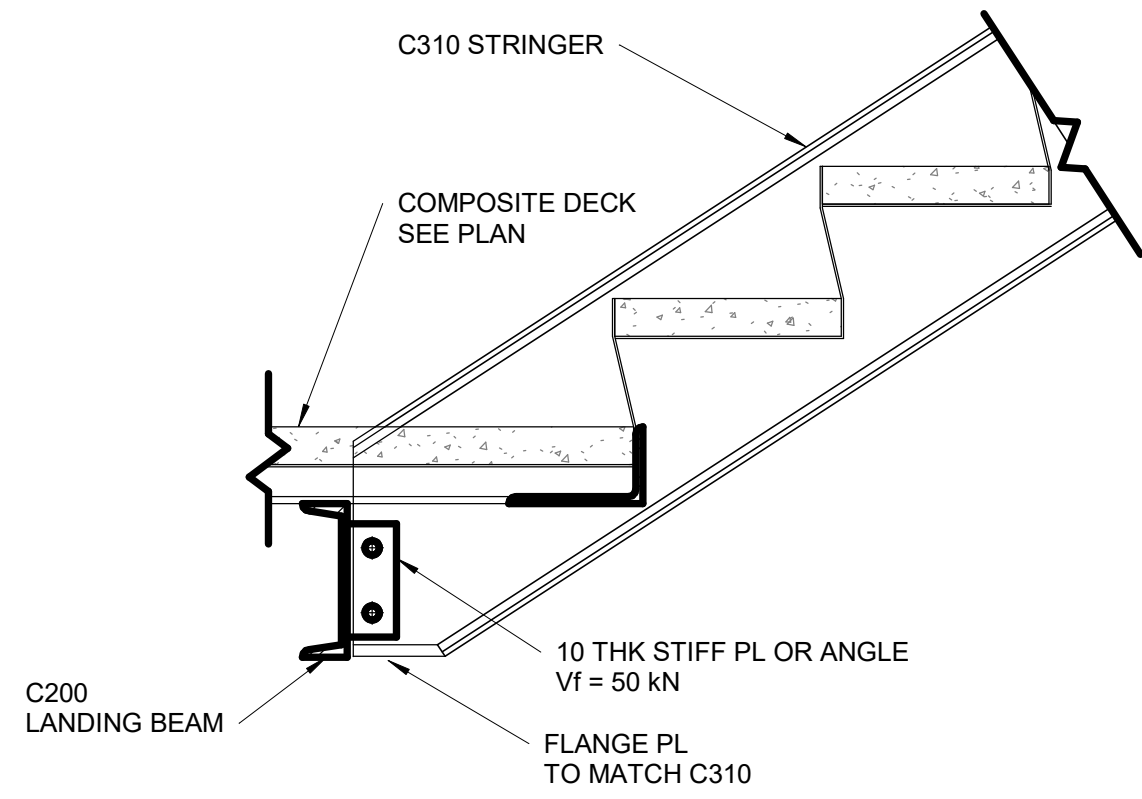

11 TYPICAL SECTION AT LOWER LANDING
D2200 Scale: 1 : 10

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B	90% SUBMISSION	2022-07-29
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D	ISSUED FOR TENDER	2022-12-09
E	ISSUED FOR TENDER	2025-04-11

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tel 416 679 1930
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PROJECT TITLE
**CITY OF TORONTO
ACCESSIBILITY UPGRADES**

PROJECT ADDRESS

PROJECT NO:
9119- 19- 0162 / Arcadis 30279056

DRAWN BY:

G. POULOU

CHECKED BY:

M. FAYAZI

PROJECT MGR:

N. FRISIC

APPROVED BY:

K. ANGER

SHEET TITLE
**STRUCTURAL STEEL
DETAILS - 1**

SHEET NUMBER

G05-D2200


ISSUE

E


Autodesk Docs // 122260 - Cot TAU Upgrades R2024122260-TAU-G05-Details-R20.rvt

10mm


SCALE CHECK
1 in

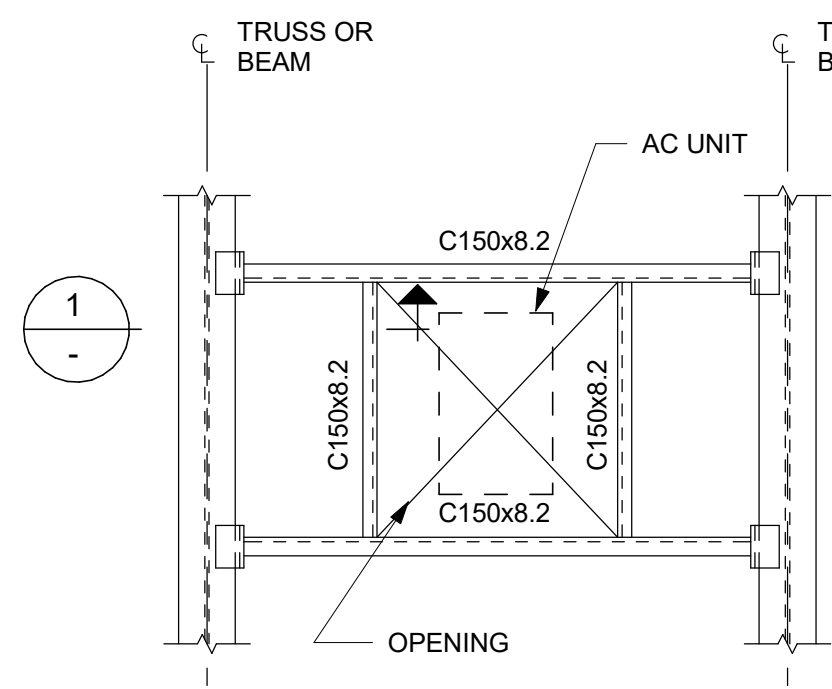


FRAME TYPE "A"

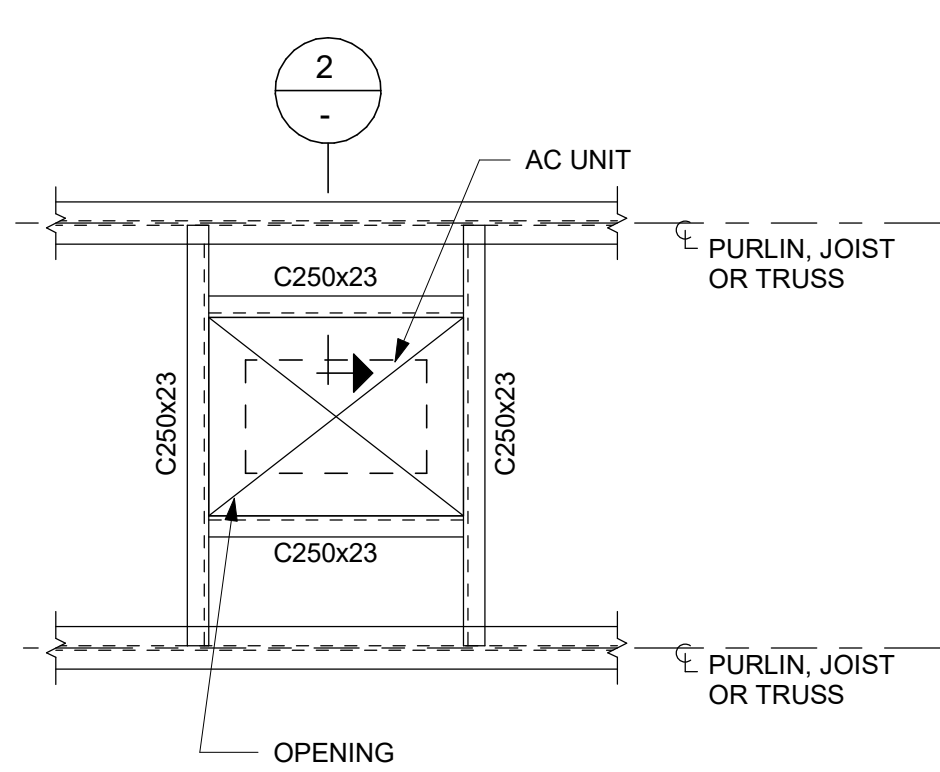

FRAME TYPE "B"

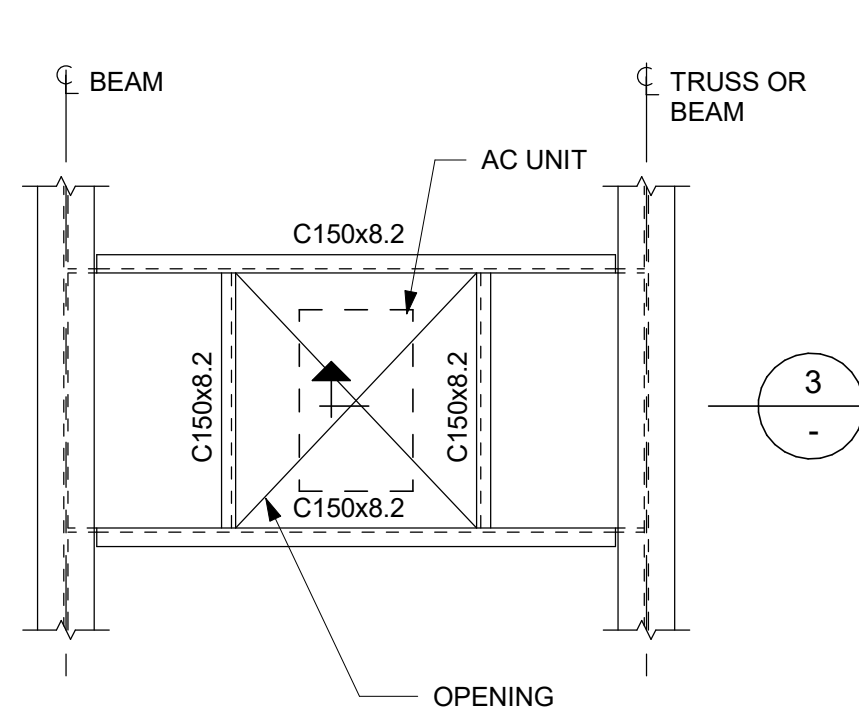


FRAME TYPE "C"

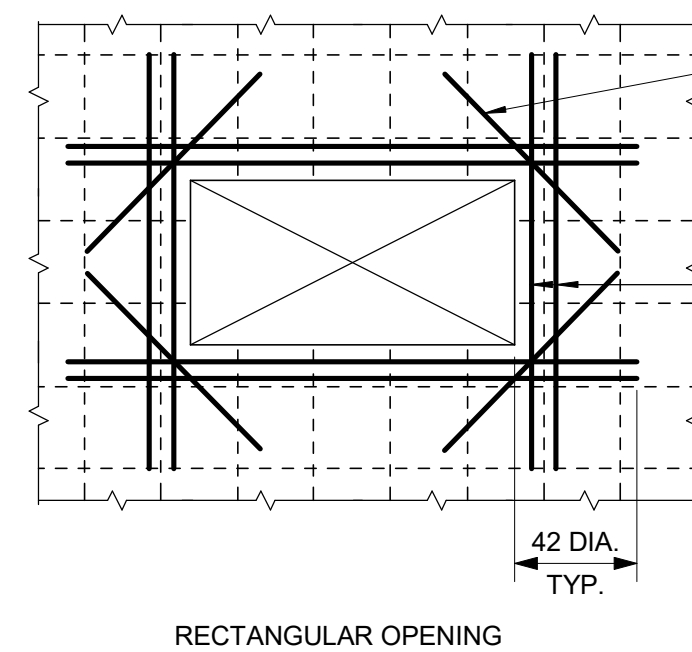



RECTANGULAR OPENING

NOTES:



1. UNLESS NOTED OTHERWISE ON PLANS AND SECTION, REINFORCE AROUND OPENINGS AS SHOWN. DO NOT MAKE OPENINGS LARGER THAN THE MAXIMUM DIMENSIONS NOTED BELOW WITHOUT PRIOR REVIEW FROM THE ENGINEER OF RECORD, UNLESS NOTED ON STRUCTURAL DRAWINGS.
2. MAXIMUM SLAB OPENING SIZE IS 2500mm SQUARE OR ROUND U/N ON DRAWINGS. THIS DETAIL APPLIES FOR OPENINGS WITH A DIMENSION GREATER THAN 150mm. THIS DETAIL ALSO APPLIES AT PIPE OPENINGS.

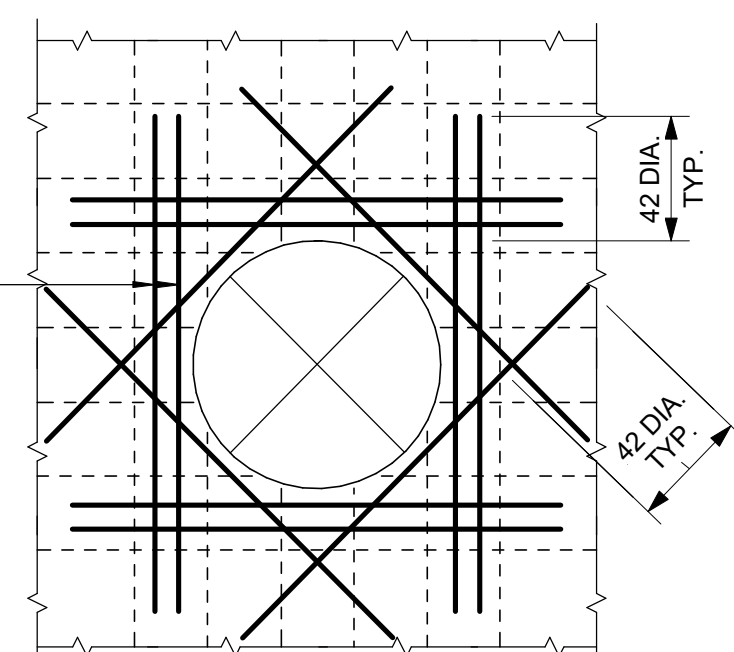

CIRCULAR OPENING

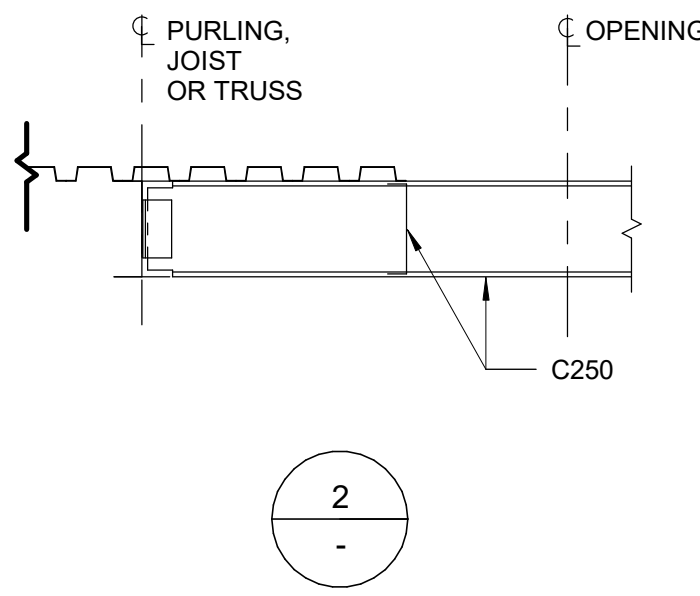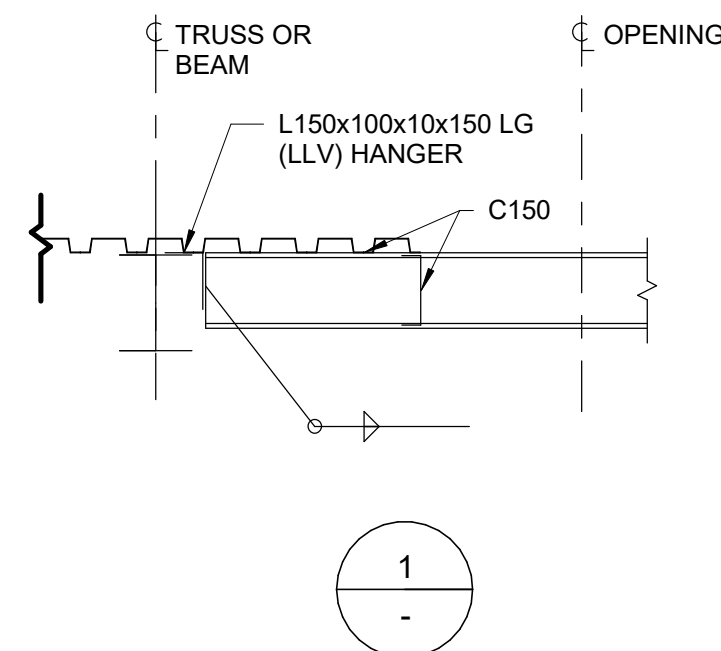


1 TYPICAL ROOF OPENING
D2201 Scale: 1 : 20

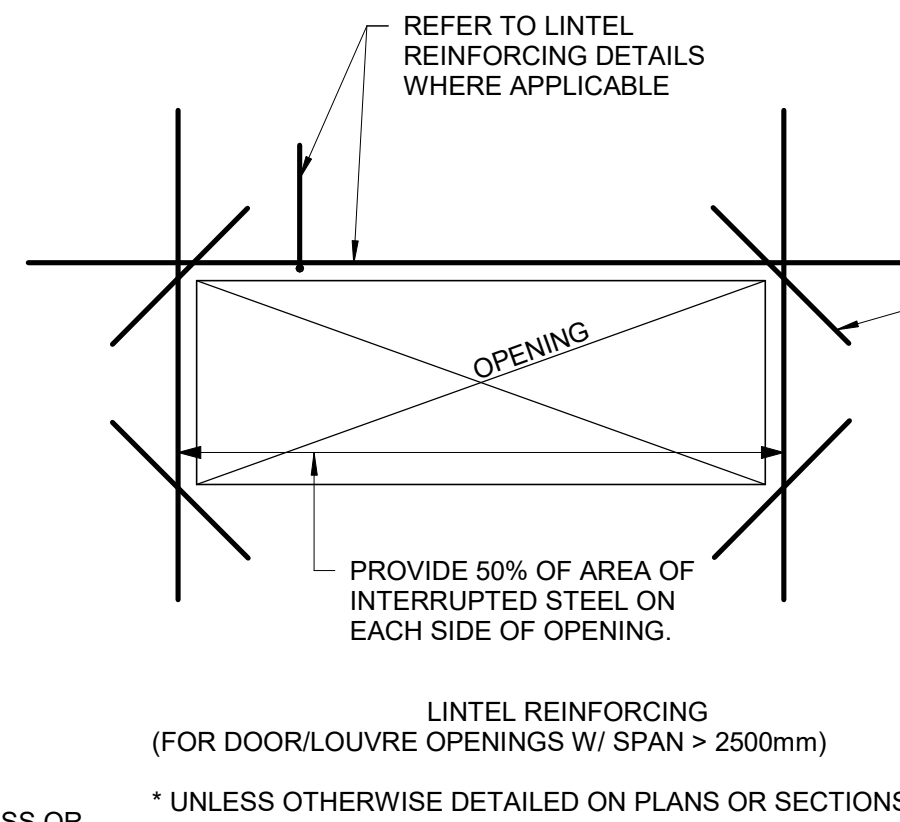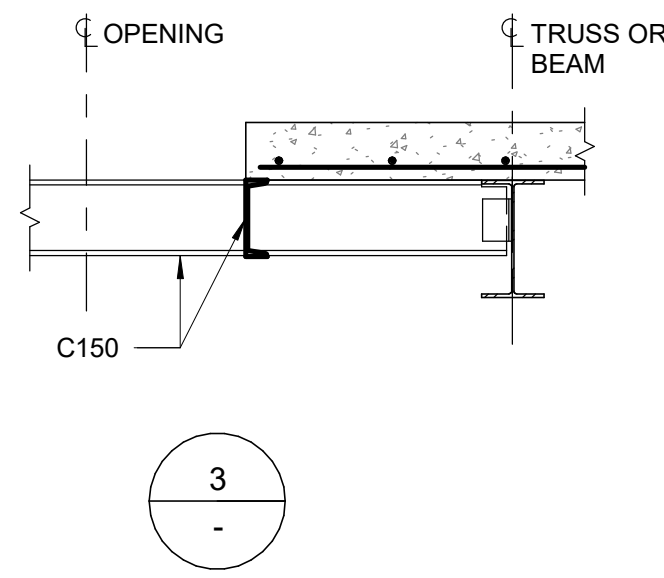


LINTEL REINFORCING
(FOR DOOR/LOUVRE OPENINGS W/ SPAN > 2500mm)

* UNLESS OTHERWISE DETAILED ON PLANS OR SECTIONS

2 ADD'L REINF. TO OPENINGS IN CONC. WALLS AND SLABS
D2201 Scale: 1 : 20


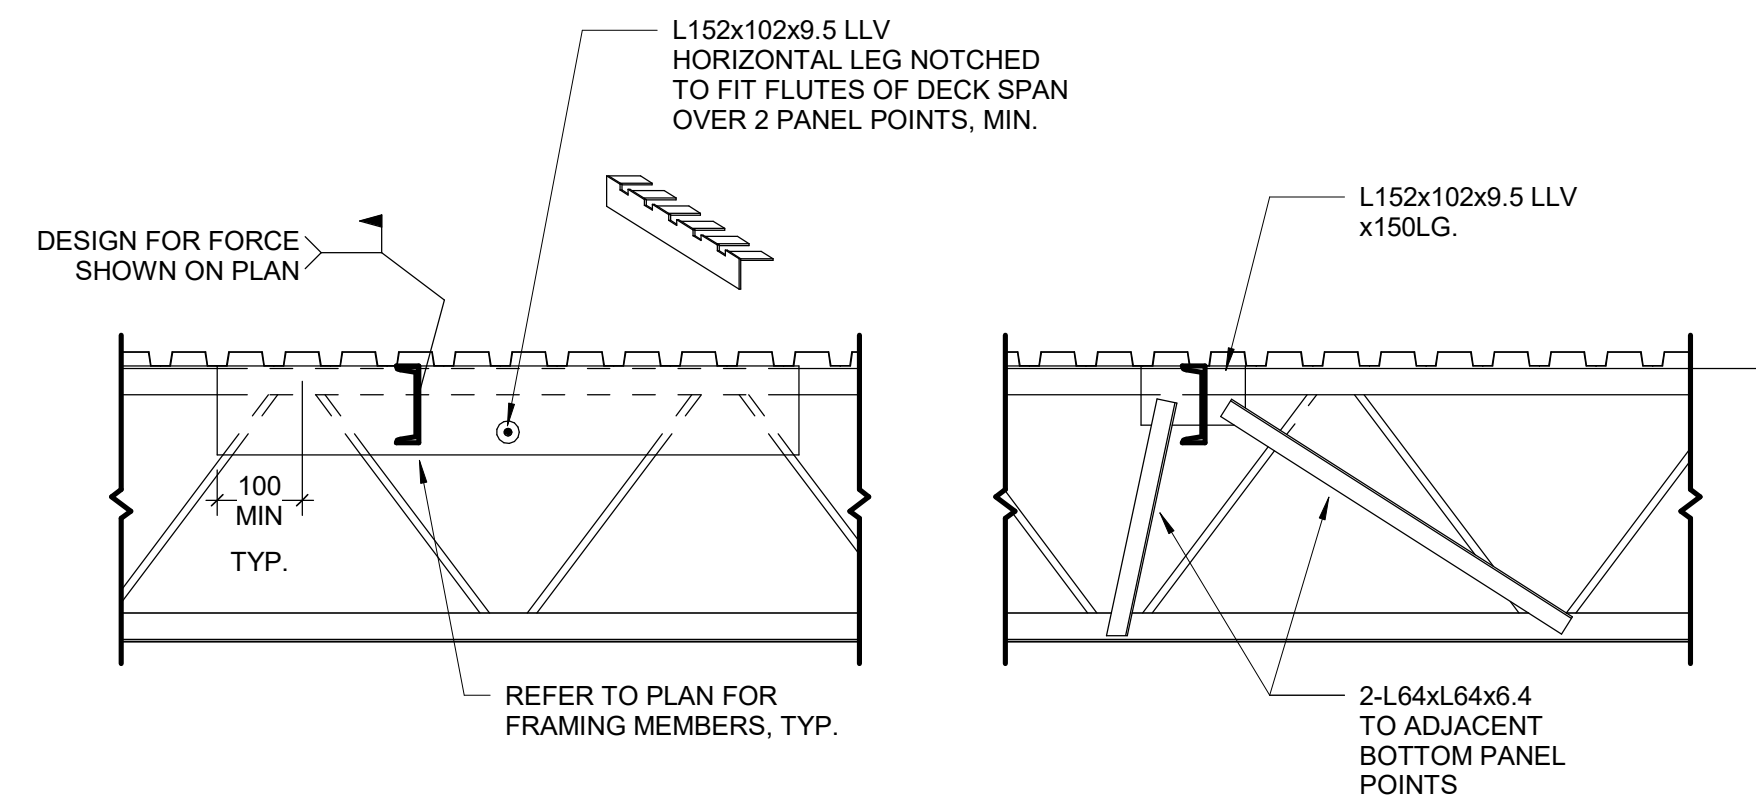


DETAIL AT EXISTING JOIST
(TWO OPTIONS SHOWN)

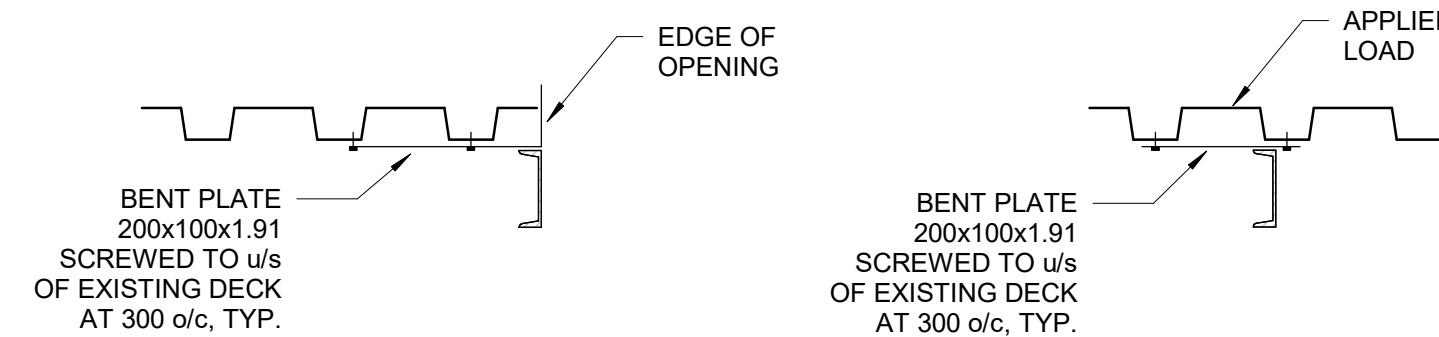


DETAIL AT EXISTING DECK

3 FRAMING INTO EXISTING STEEL JOISTS AND DECK
D2201 Scale: 1 : 20

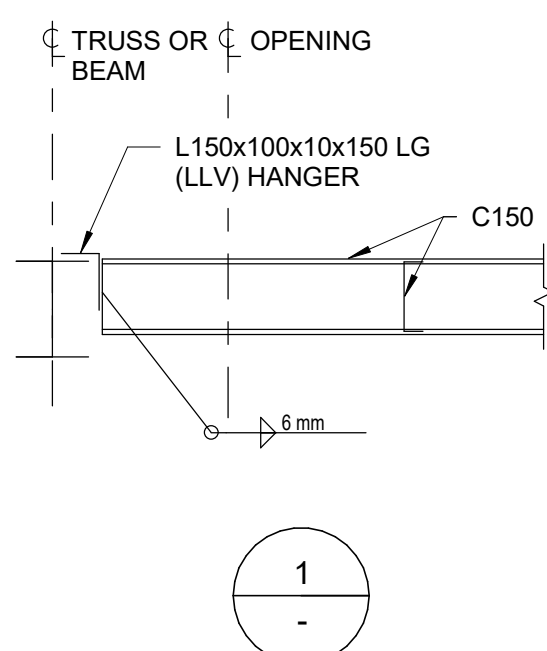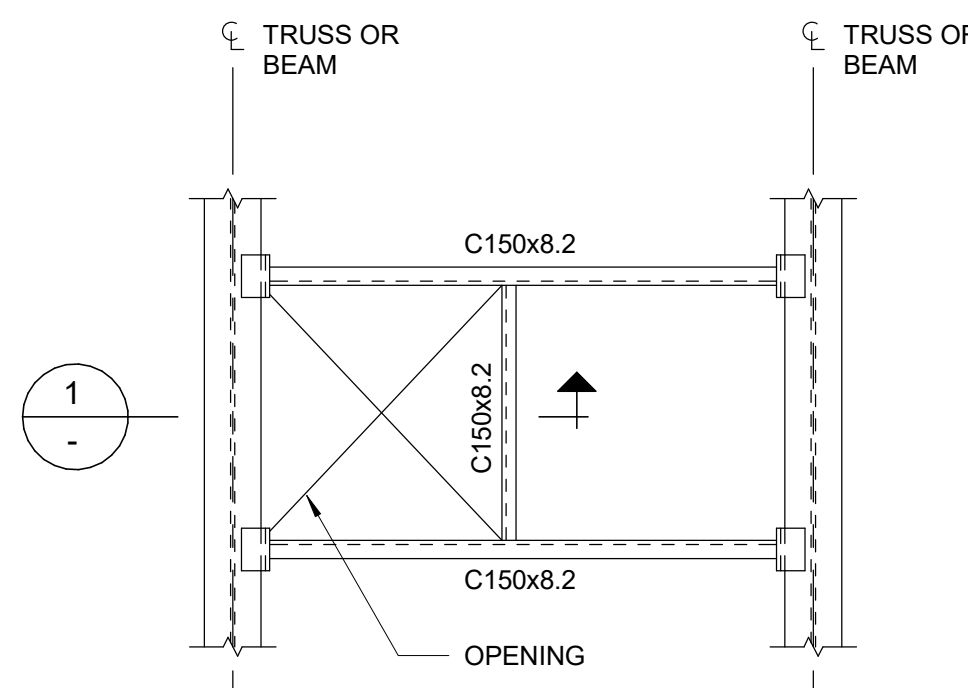


4 TAU-S-014-00 TYPICAL ROOF OPENING ADJACENT TO BEAM
D2201 Scale: 1 : 20

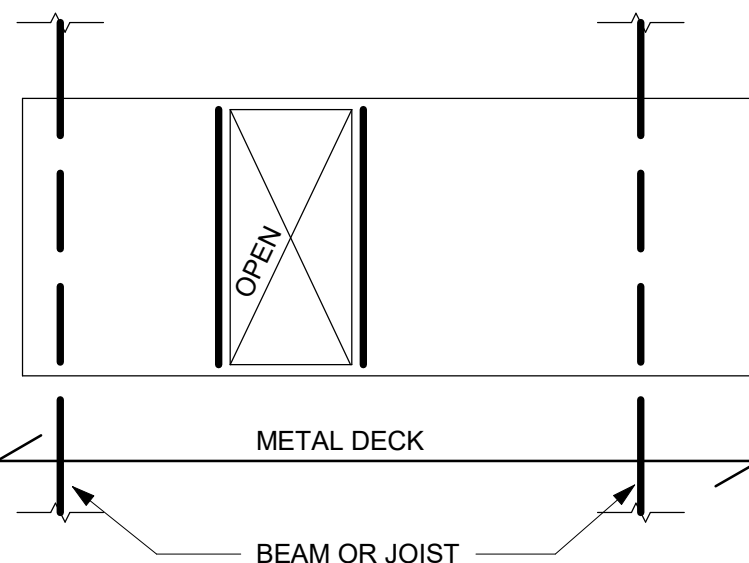

6 OPENINGS IN METAL ROOF DECK
D2201 Scale: 1 : 20


NOTES:

1. OPENINGS UP TO 150mm SQUARE OR IN DIAMETER AND SPACED A MINIMUM 300mm CLEAR FROM ADJACENT OPENINGS DO NOT REQUIRE REINFORCING.
2. OPENINGS LARGER THEN 150mm, BUT NOT EXCEEDING 450mm, ARE TO BE REINFORCED. SEE DETAIL 7/D2201.
3. OPENINGS LARGER THAN 450mm UP TO MAXIMUM ON DETAIL 1/D2201 1200mm SQUARE ARE TO BE REINFORCED AS SHOWN ABOVE, UNLESS INDICATED OTHERWISE ON PLAN.
4. CONNECT FRAMING FOR A MINIMUM END REACTION OF 10kN.

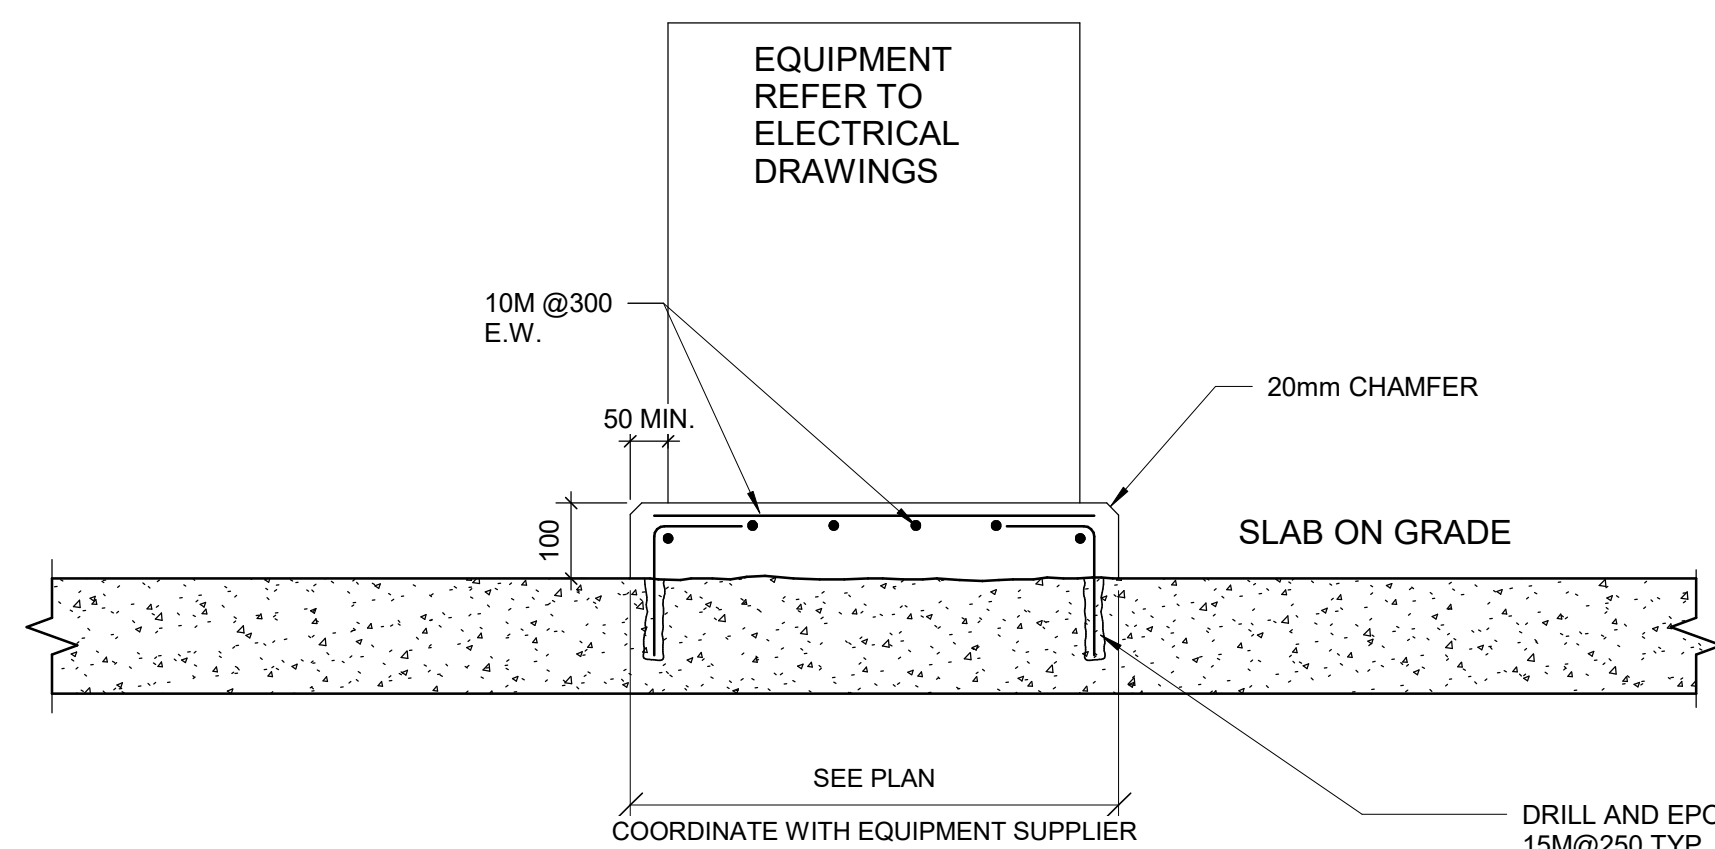

MIN EMBEDMENT	S.O.G. THICKNESS
MIN 3"	125mm
MIN 4"	150mm
MIN 6"	200mm

5 TYPICAL HOUSEKEEPING PAD
D2201 Scale: 1 : 10

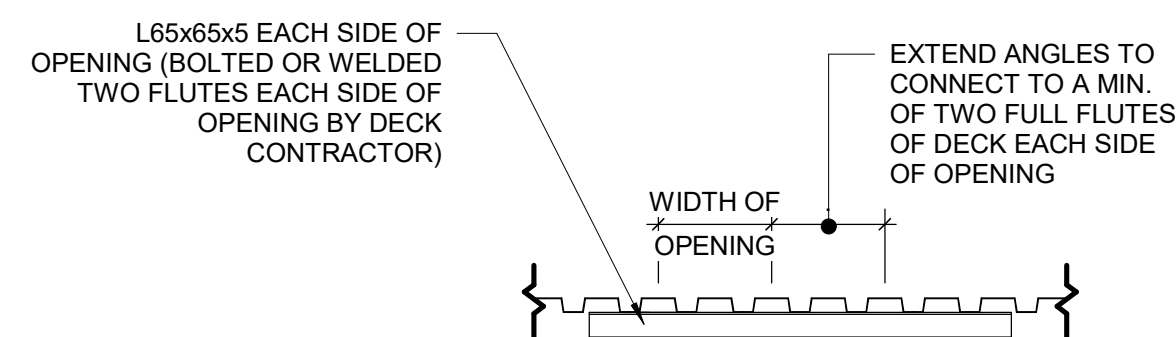

7 METAL DECK OPENINGS 200 TO 360 WIDE
D2201 Scale: 1 : 20

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PROJECT TITLE
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ACCESSIBILITY UPGRADES**



PROJECT ADDRESS

PROJECT NO:
9119- 19- 0162 / Arcadis 30279056


DRAWN BY: G. POULOU	CHECKED BY: M. FAYAZI
PROJECT MGR: N. FRISIC	APPROVED BY: K. ANGER

SHEET TITLE
**STRUCTURAL STEEL
DETAILS - 2**


SHEET NUMBER G05-D2201	ISSUE E
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2 TYPICAL CMU WALL CONNECTION TO EXISTING WALL
D2300 Scale: 1 : 10

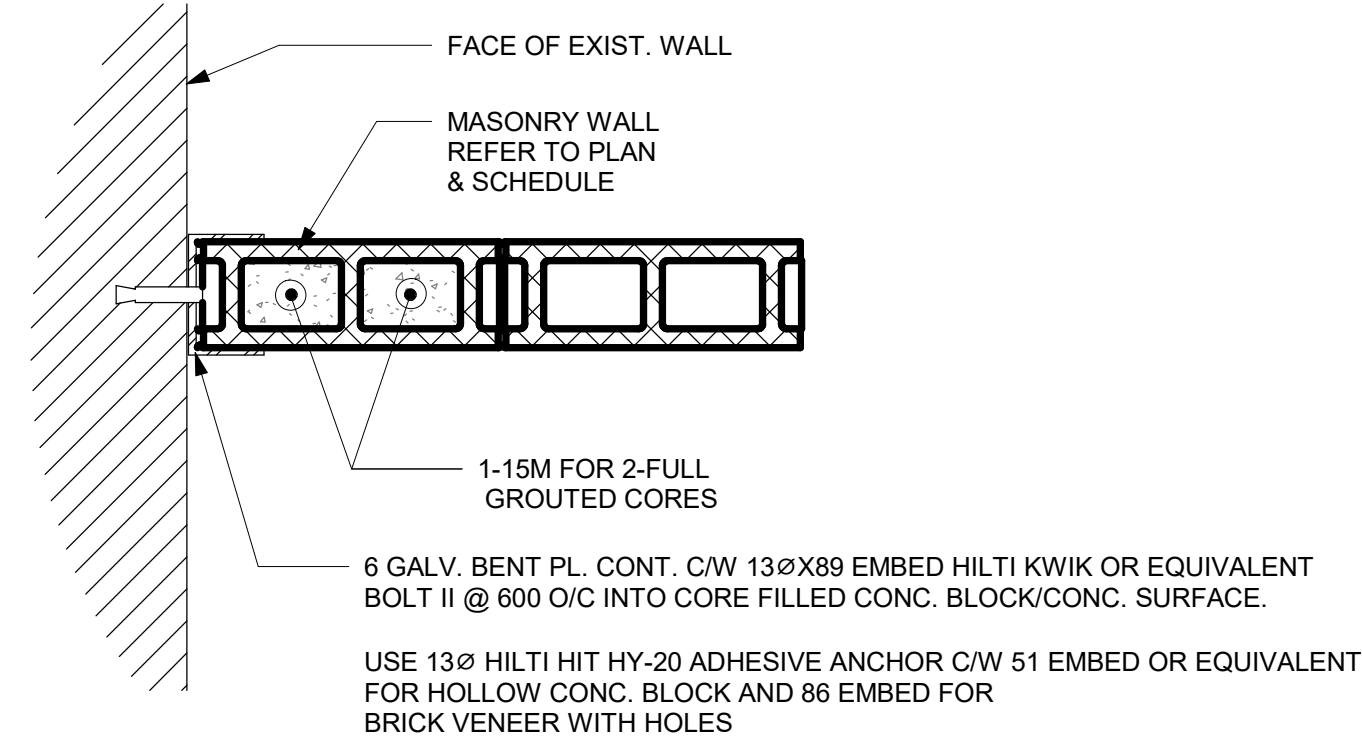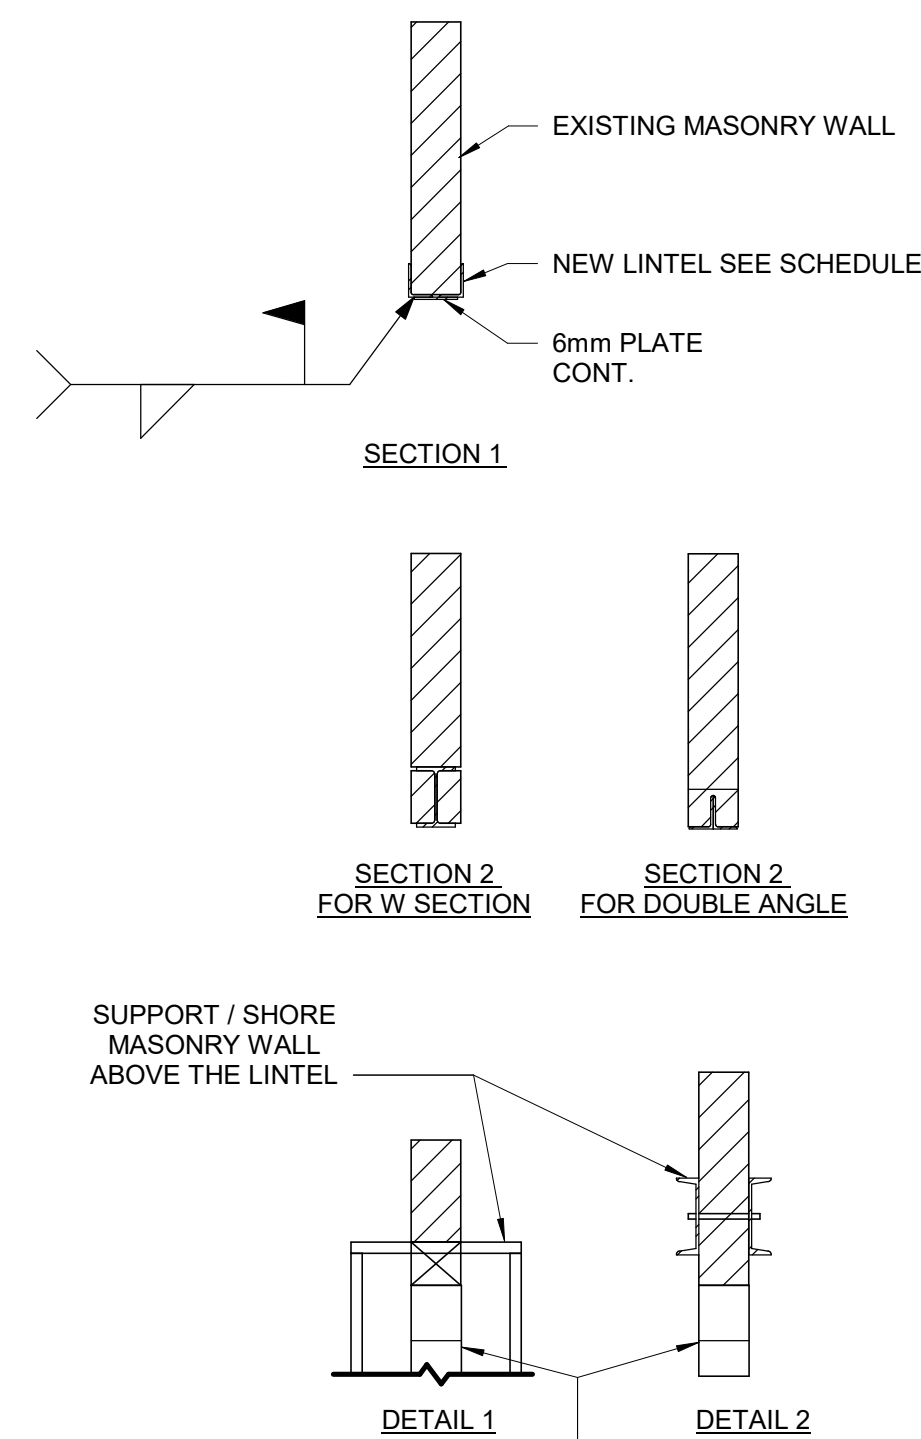

3 TYPICAL NEW MASONRY WALL DETAILS
D2300 Scale: 1 : 20

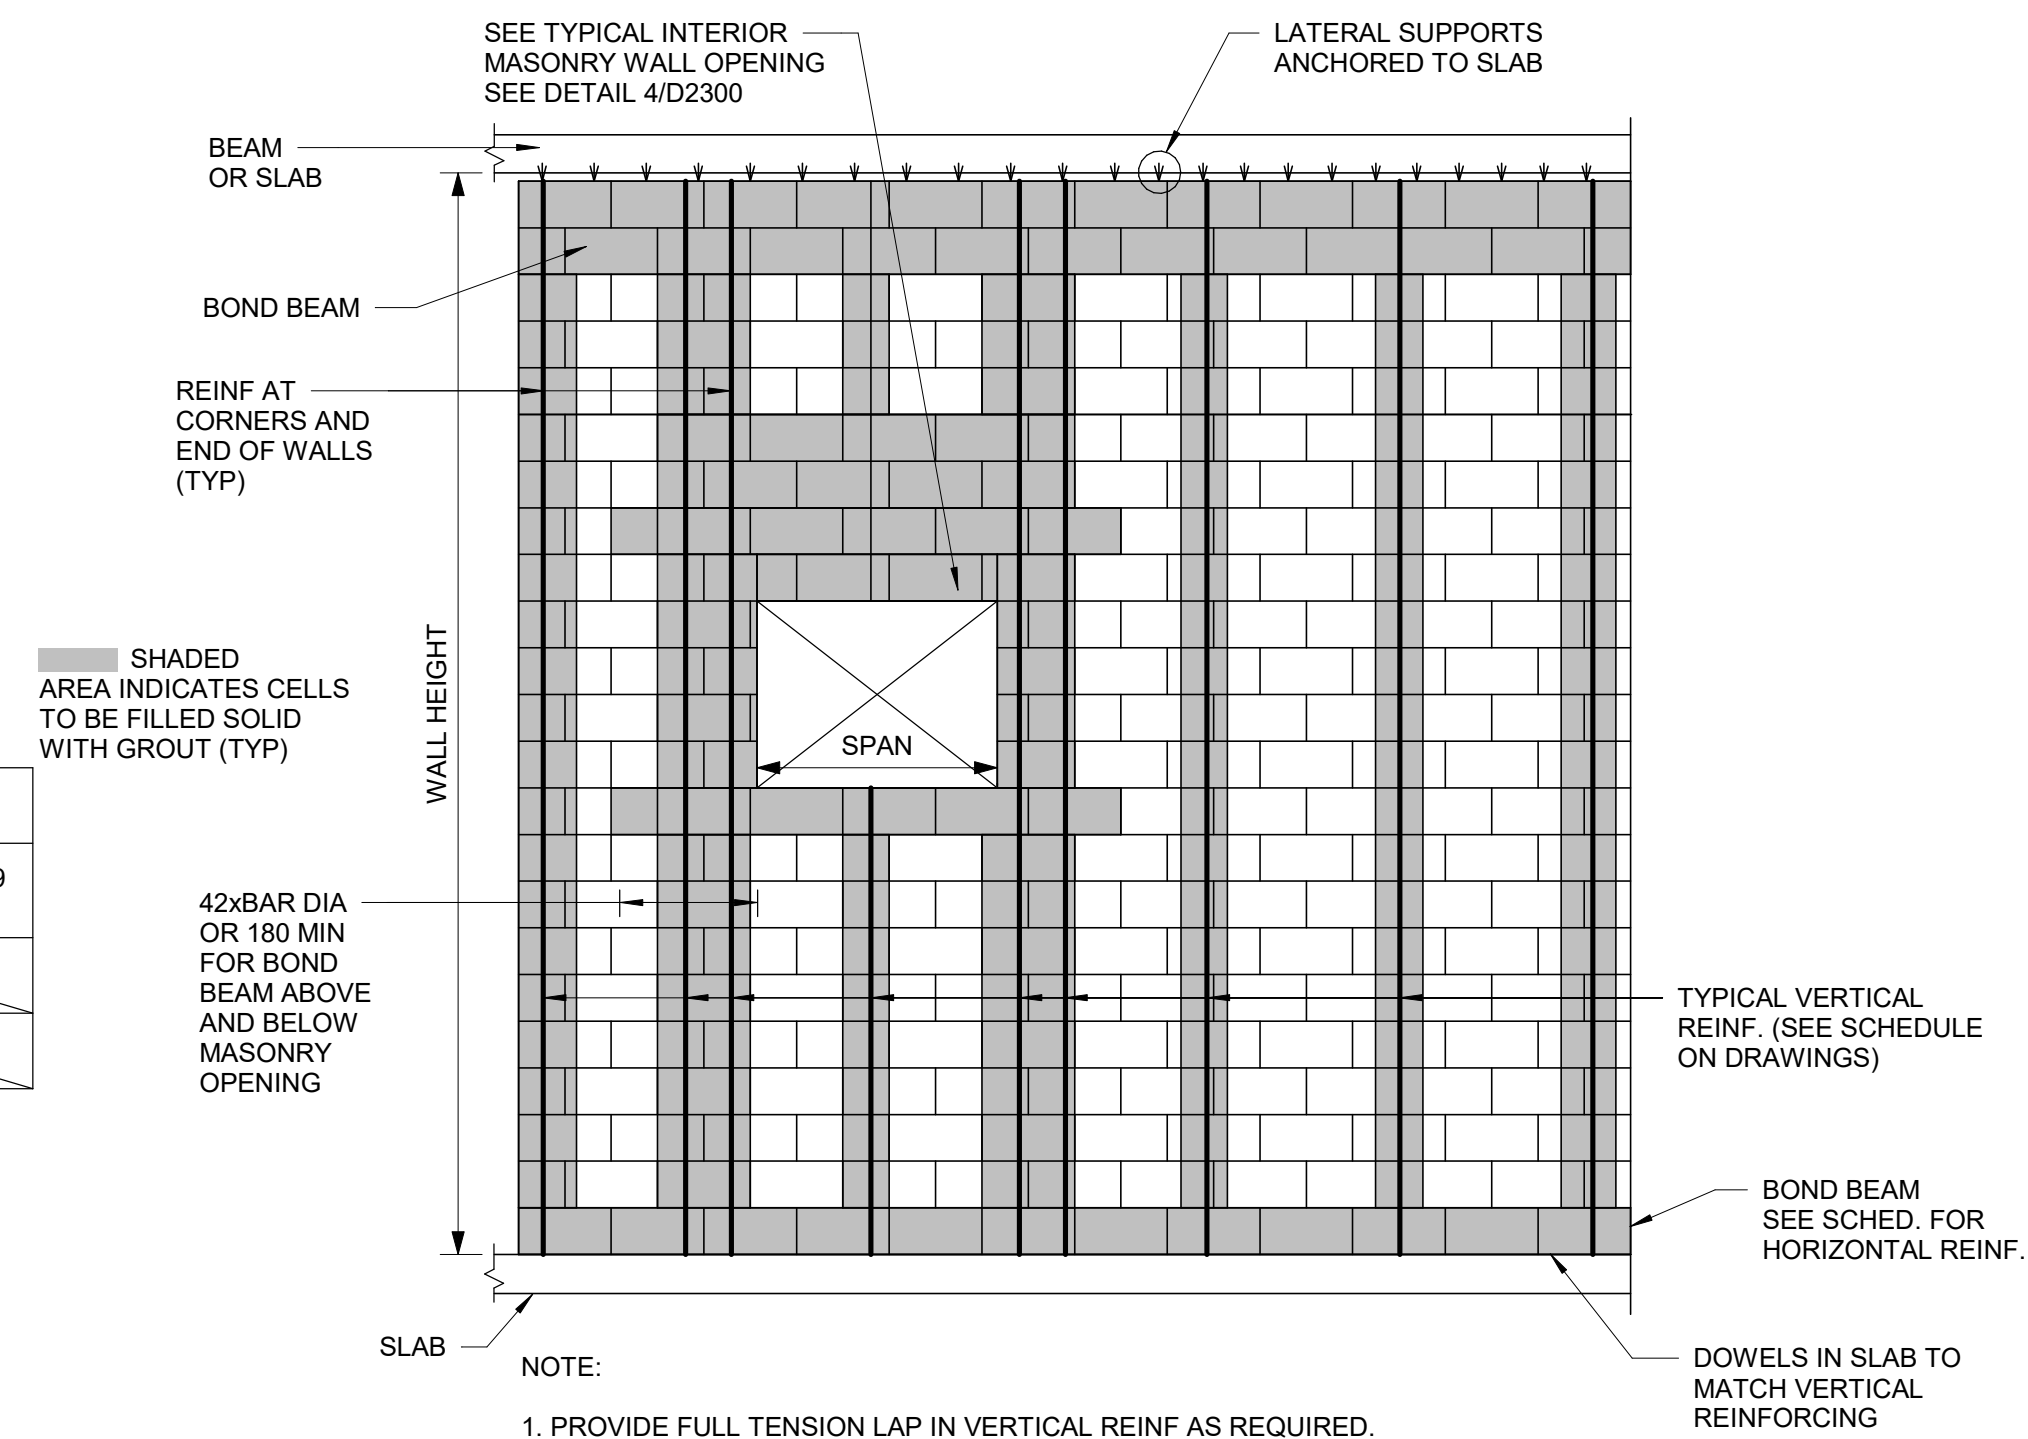


4 OPENING IN NEW MASONRY WALL
D2300 Scale: 1 : 20

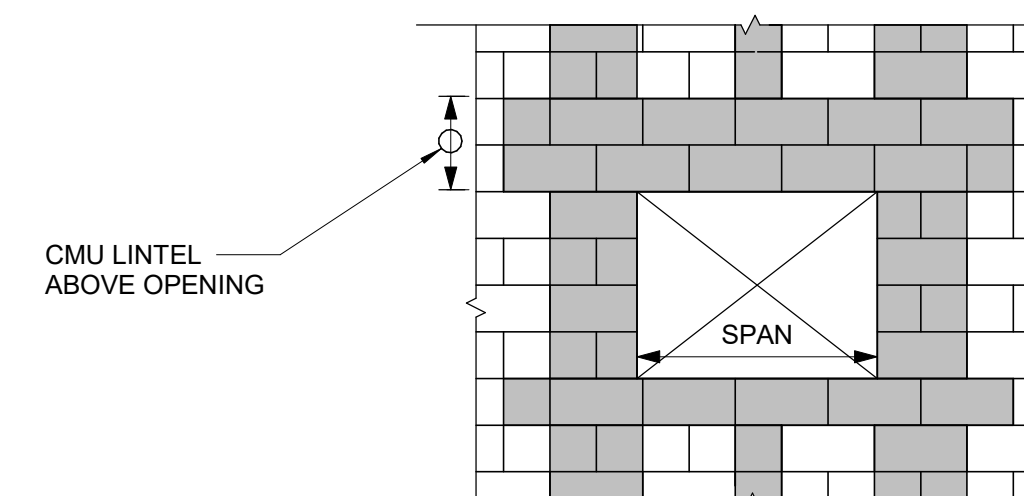1	WIDENING MASONRY WALL OPENING OR NEW OPENING IN EXISTING MASONRY WALL
D2300	Scale: 1 : 20

PLUMBING FIXTURE SCHEDULE					
DESCRIPTION	SERVICES				REMARKS
	CW	HW	WASTE	VENT	
WATER CLOSET (FLUSH VALVE)	25	-	75	40	
WATER CLOSET (FLUSH TANK)	12	-	75	40	
URINAL (FLUSH VALVE)	20	-	50	40	
URINAL (FLUSH TANK)	12	-	40	32	
LAVATORY	12	12	32	32	
SHOWER	12	12	75	32	
SERVICE SINK	12	12	75	40	
DRINKING FOUNTAIN	12	-	32	32	
SINKS	12	12	40	32	
GROUP WASH FOUNTAIN	25	25	40	40	

NOTES:

- SIZING OF SUPPLIES INSIDE WASHROOM TO BE BASED ON 35 KPa PRESSURE DROP PER 30m OF PIPE OR MAXIMUM VELOCITY OF 1.2 mps.
- CONTRACTOR SHALL PROVIDE SHOP DRAWING OF PLUMBING AND DRAINAGE INSIDE WASHROOM AREA FOR ALL WASHROOMS.

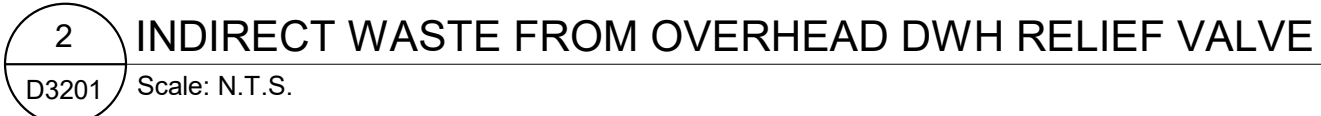

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tel 416 679 1930
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PROJECT TITLE
CITY OF TORONTO
ACCESSIBILITY UPGRADES

PROJECT ADDRESS

PROJECT NO:
9119- 19- 0162 / Arcadis 30279056

DRAWN BY:
K. DURUKA

CHECKED BY:
B. LIAO

PROJECT MGR
F. BOLOURIAN

APPROVED BY
S. LIU

SHEET TITLE






PLUMBING DETAILS


SHEET NUMBER

G05-GAL-D3201

ISSU

F

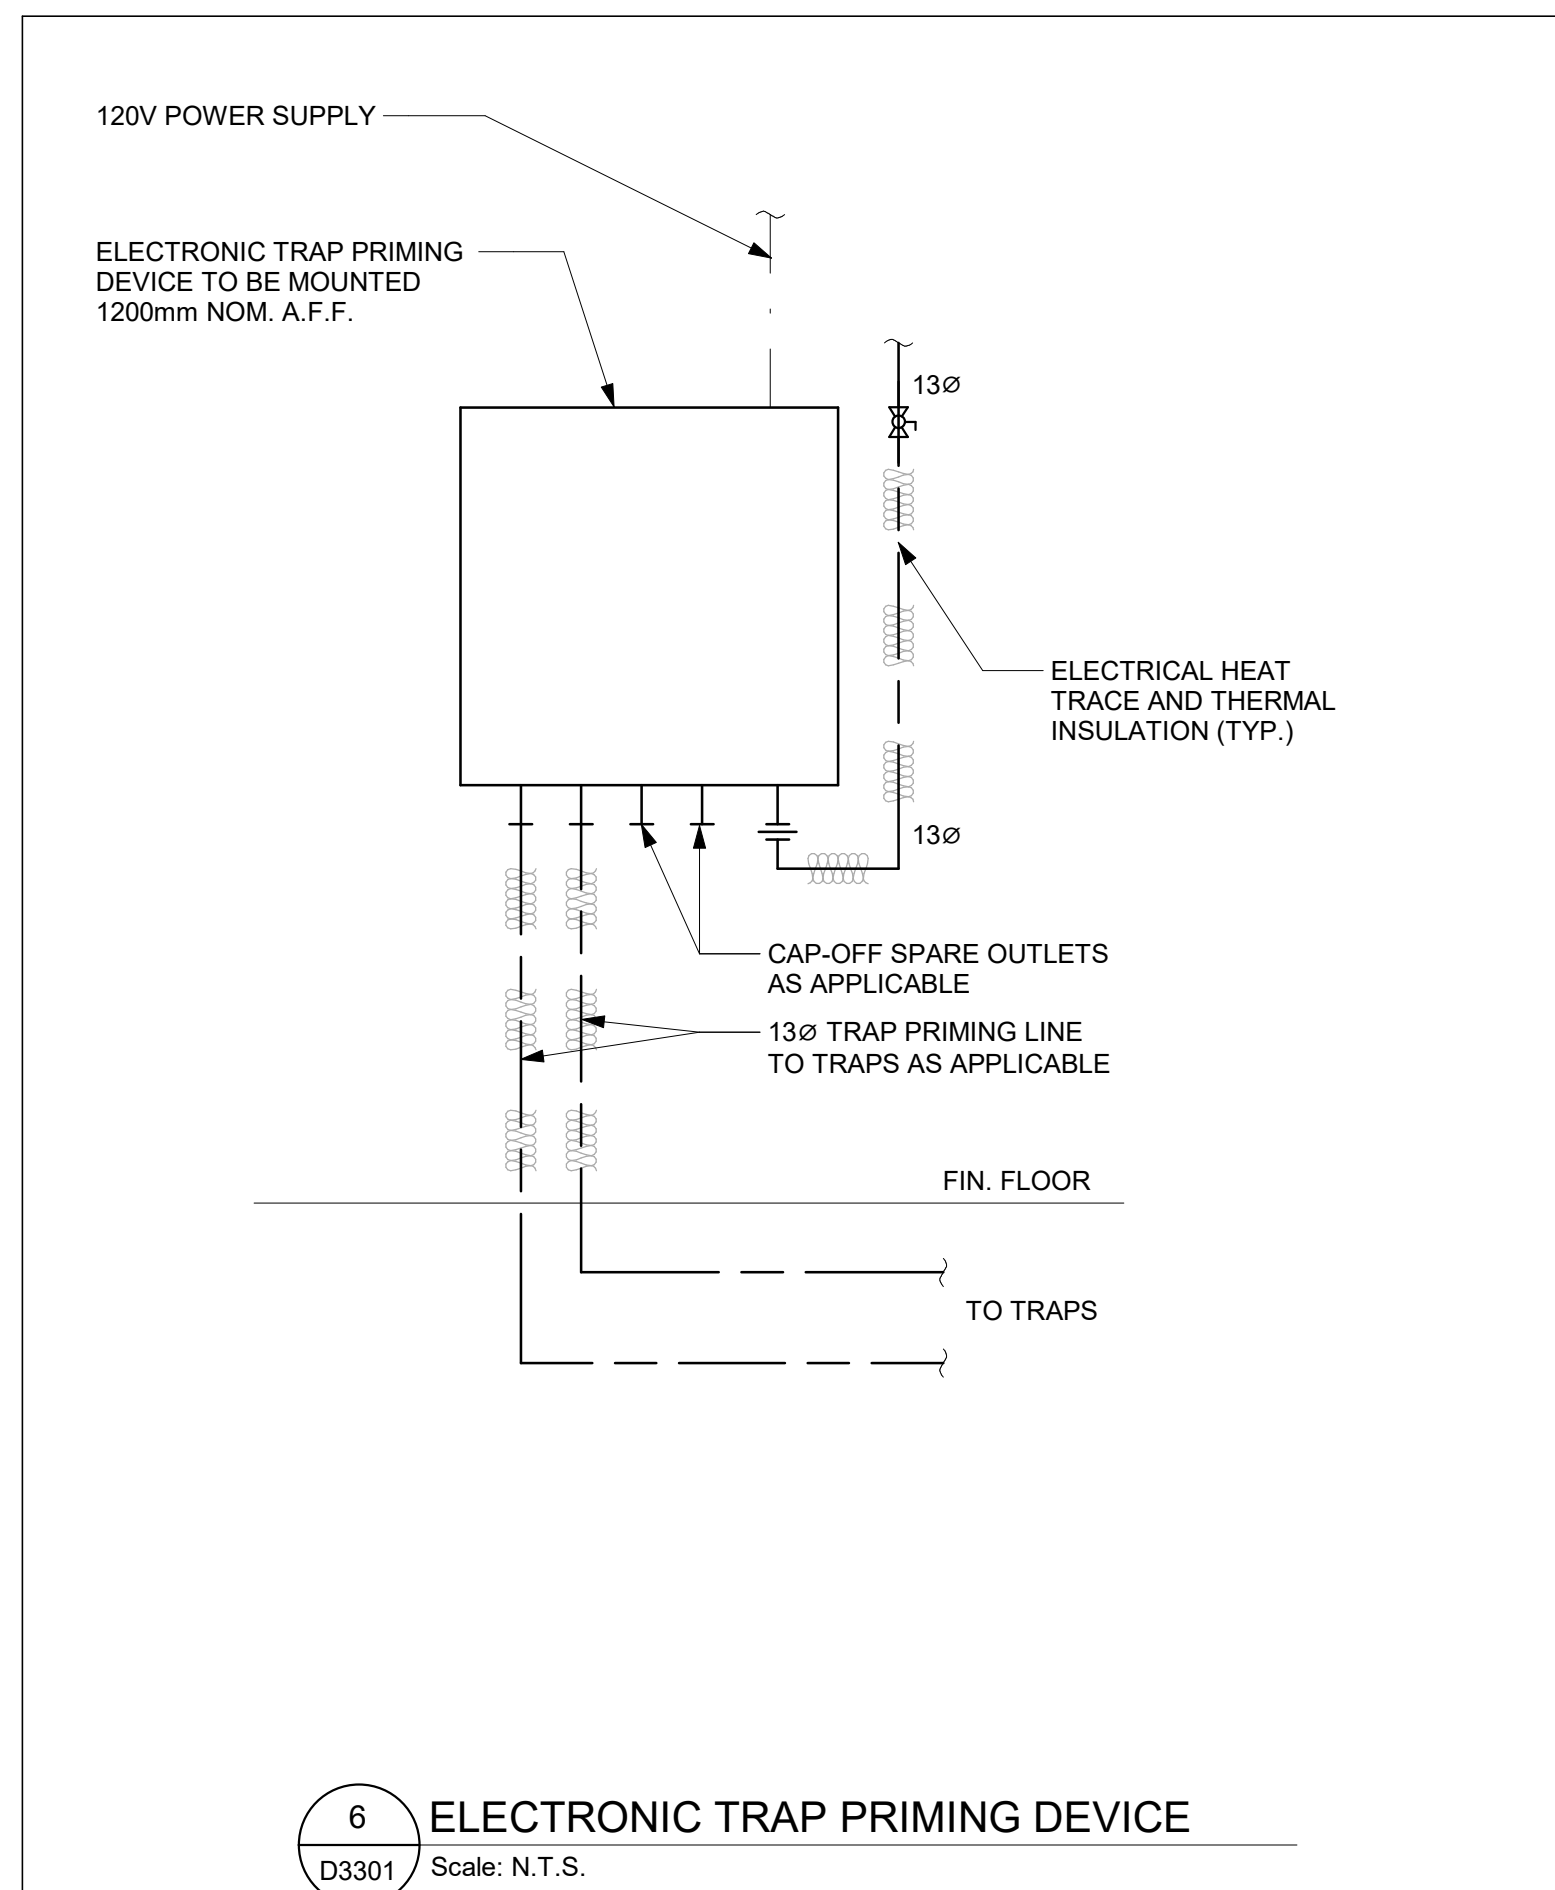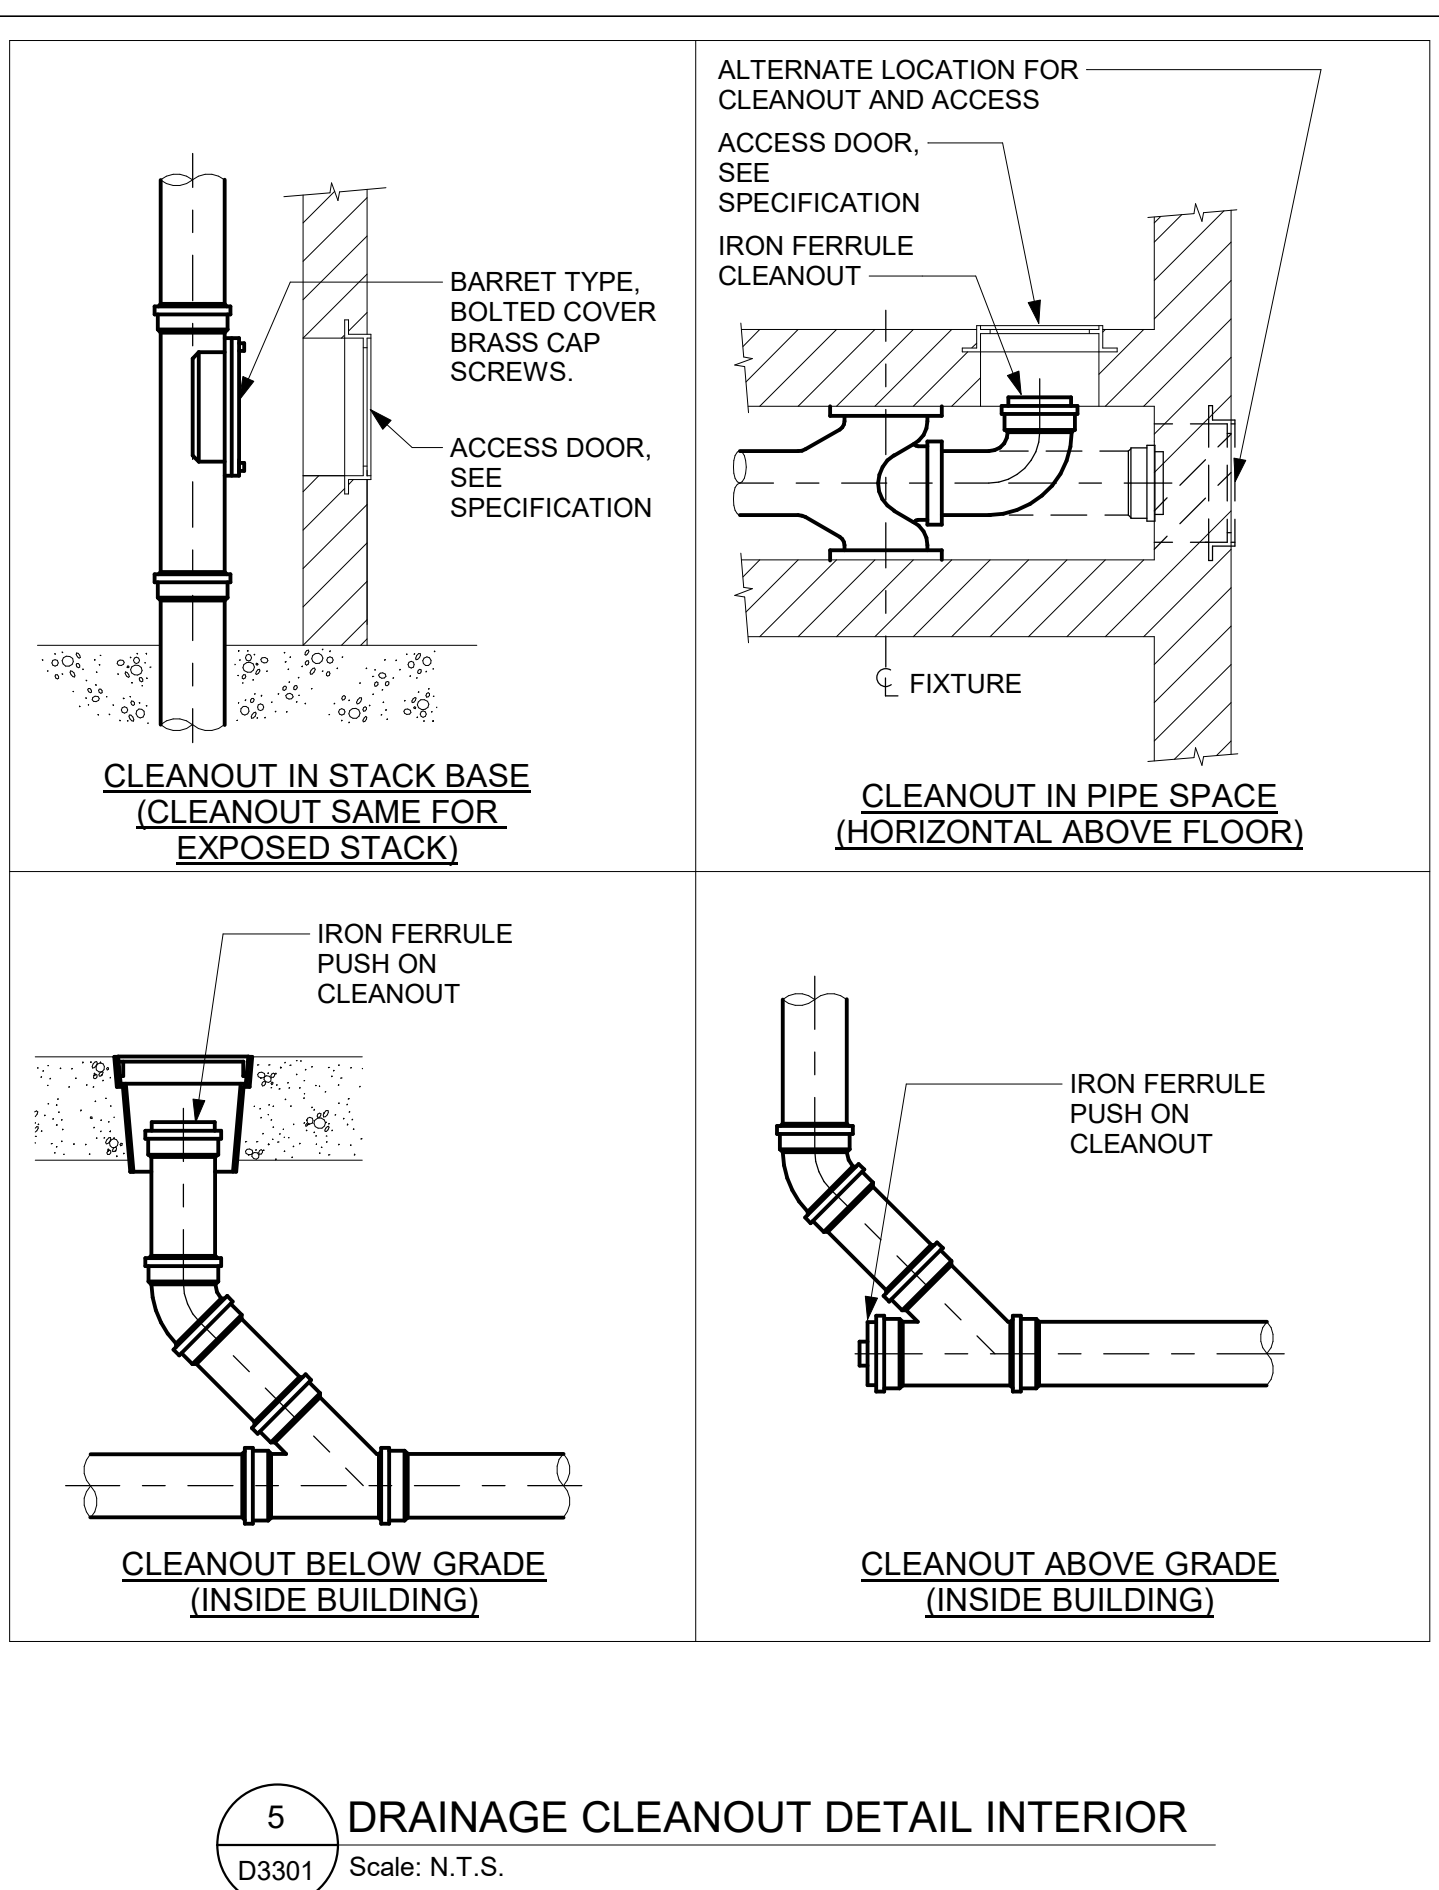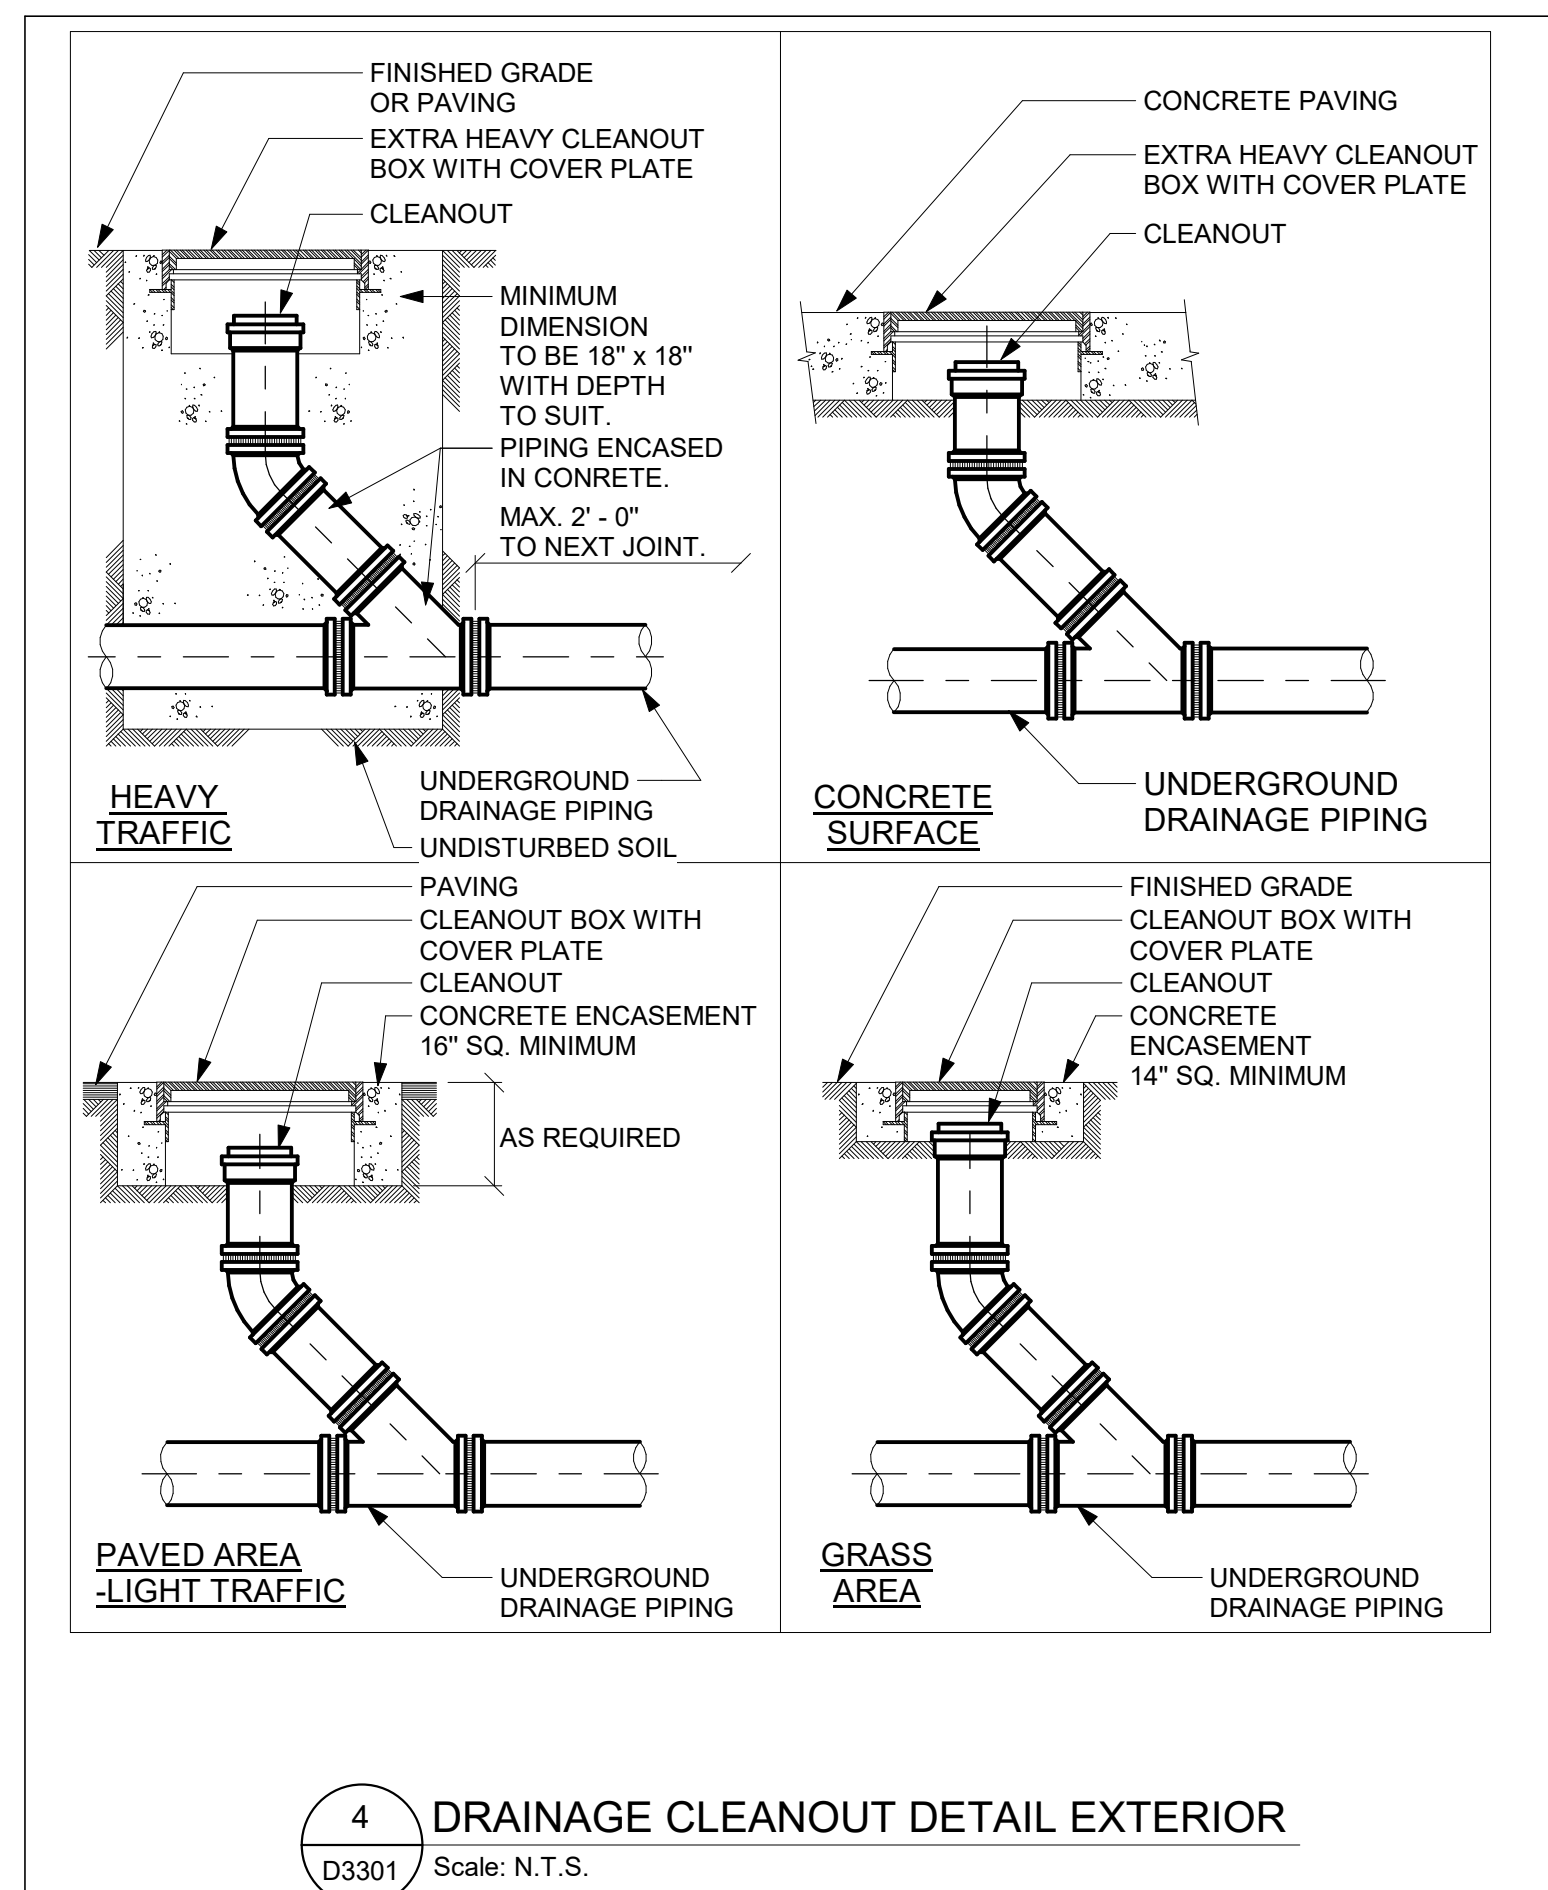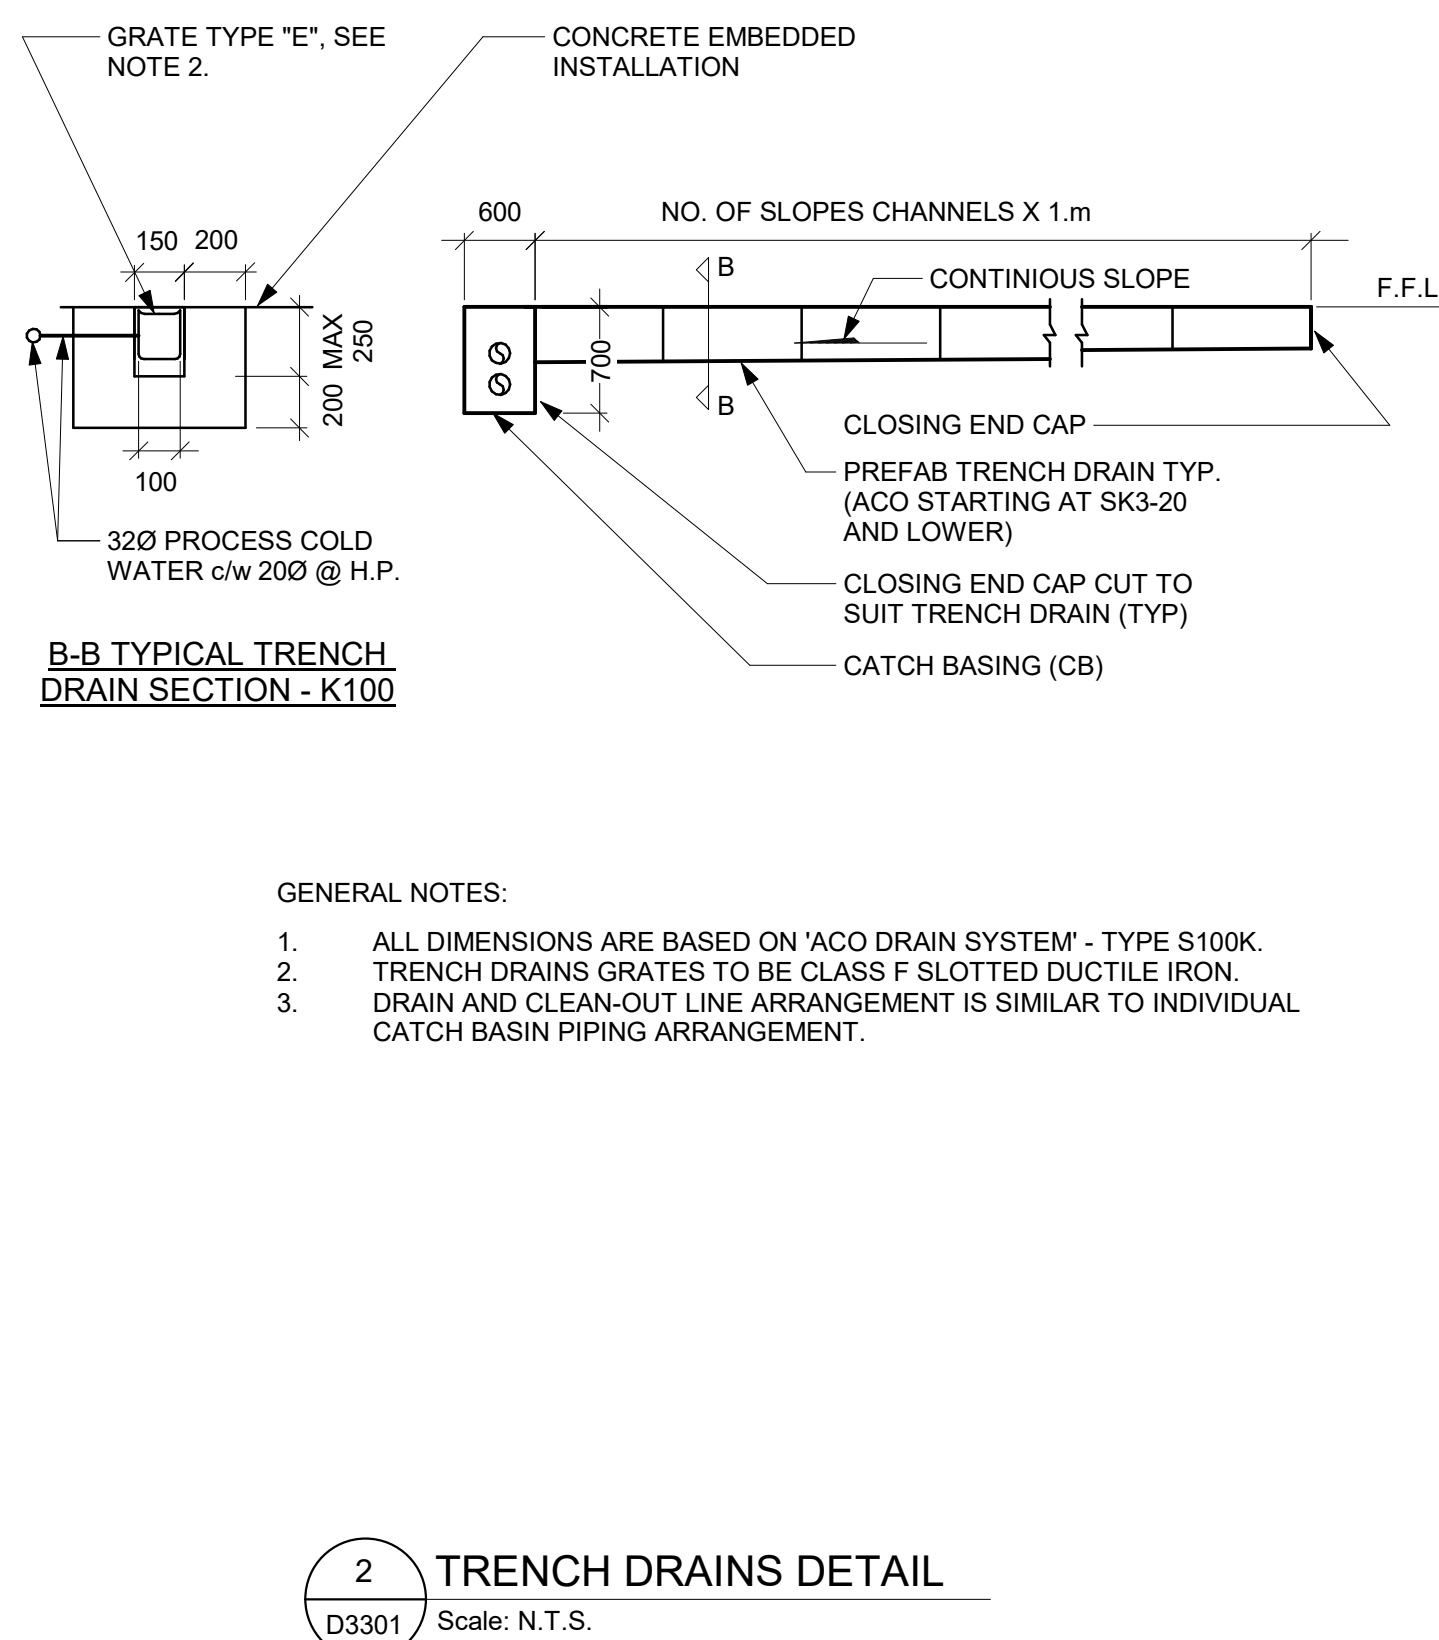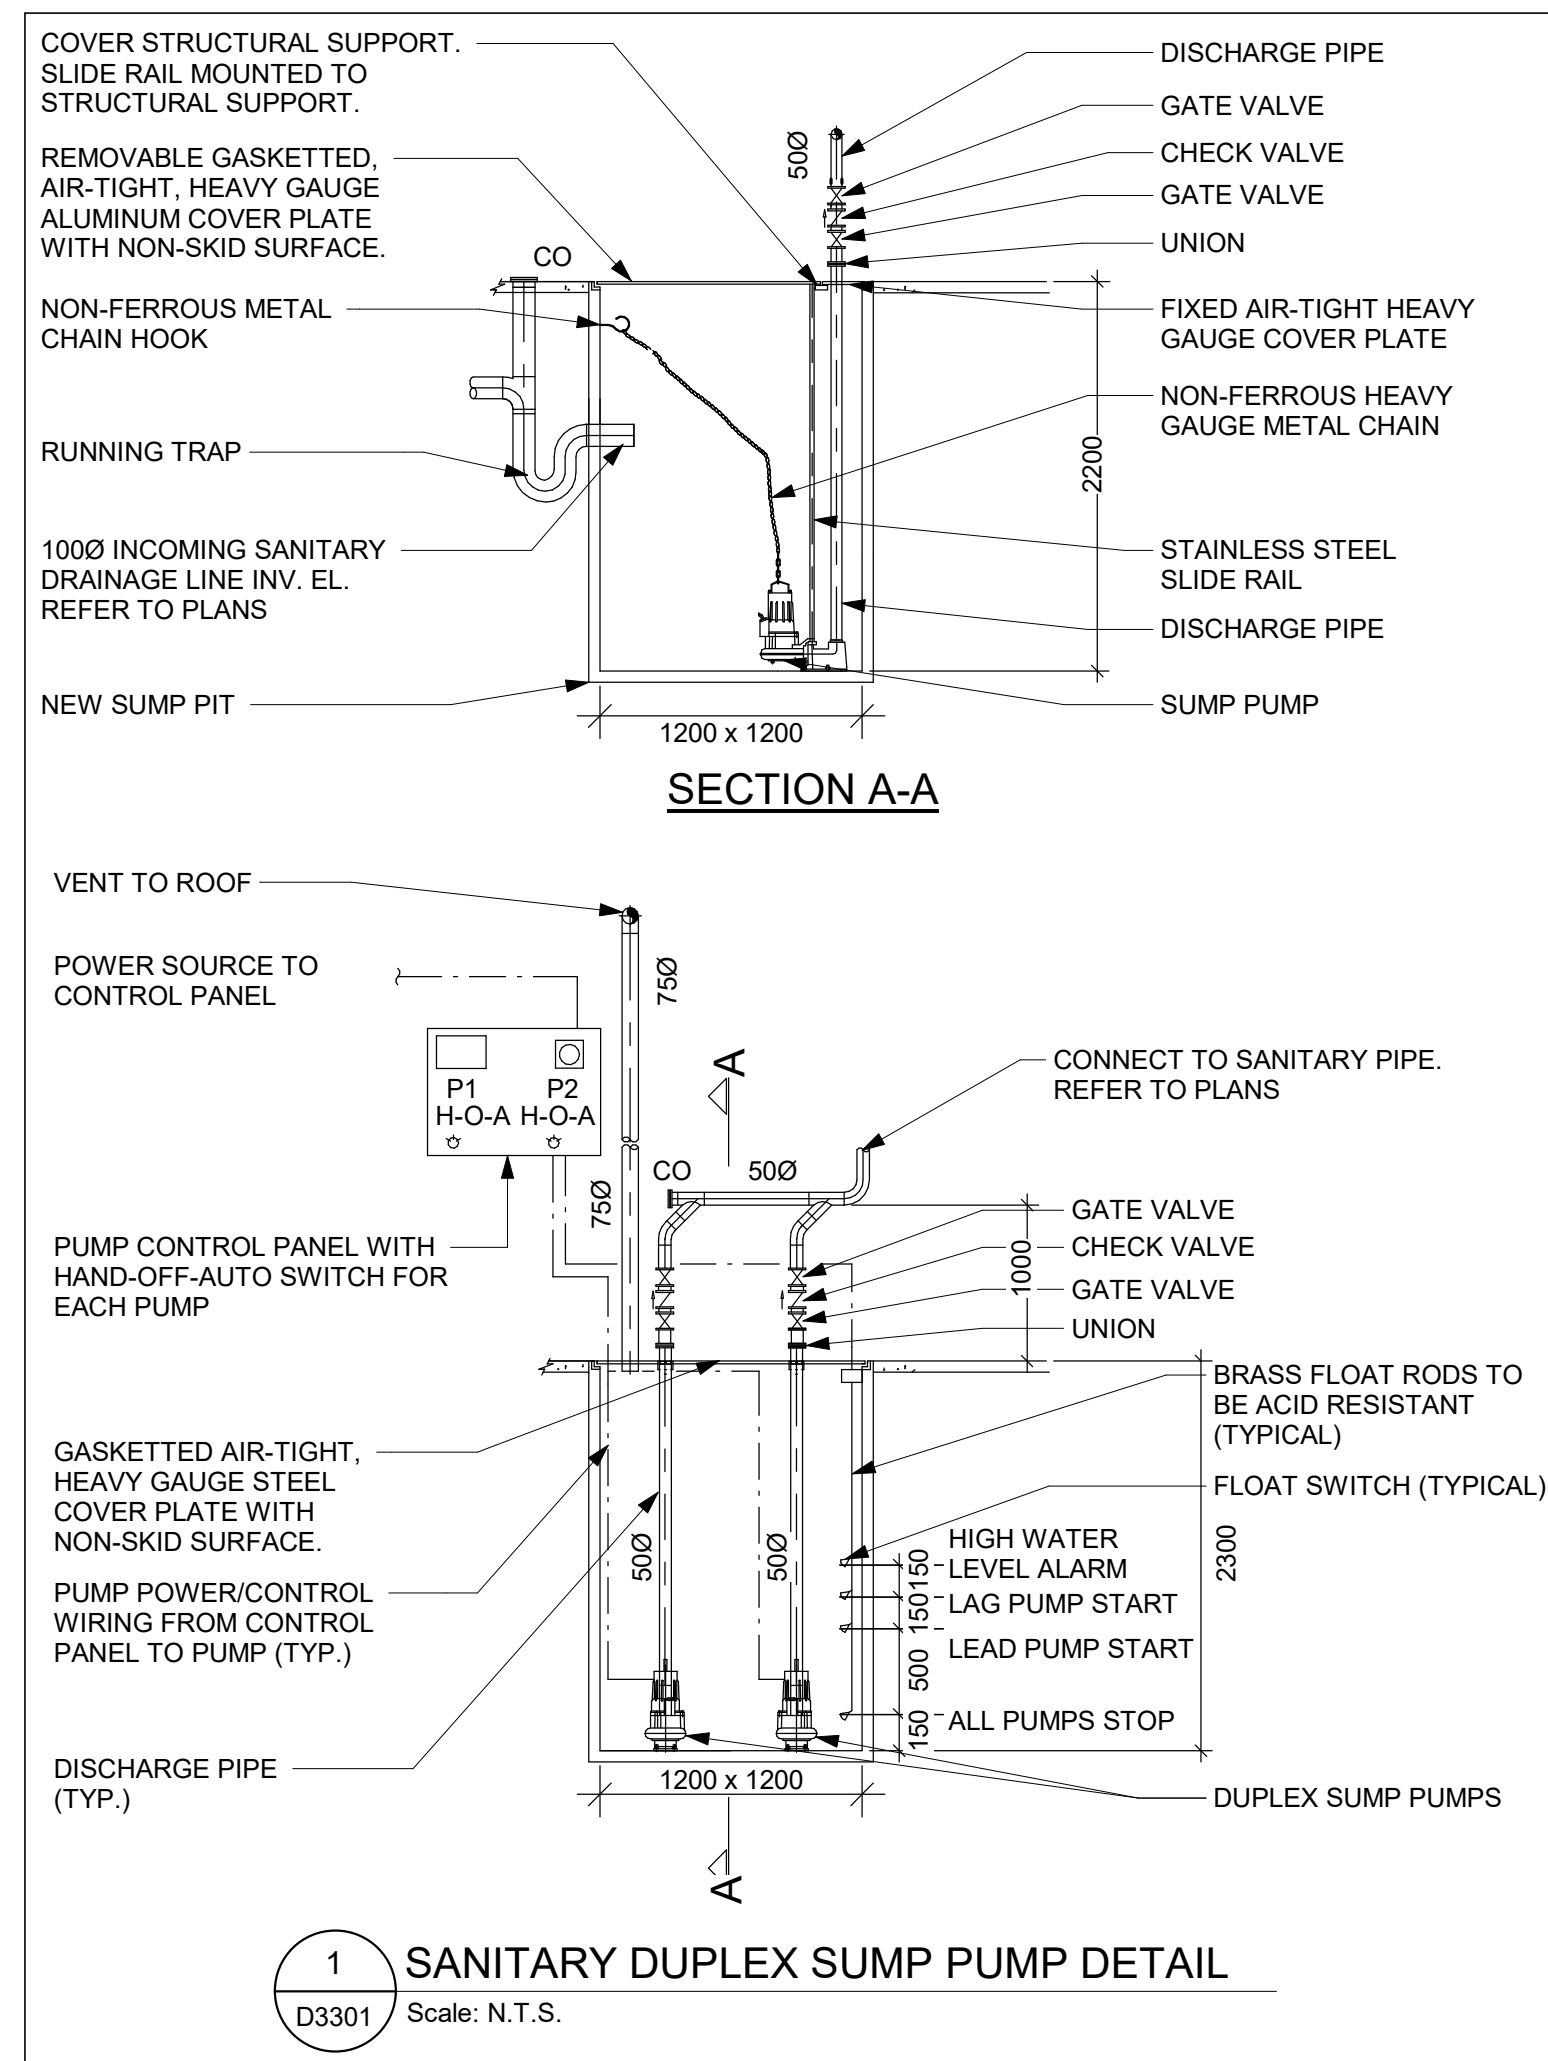

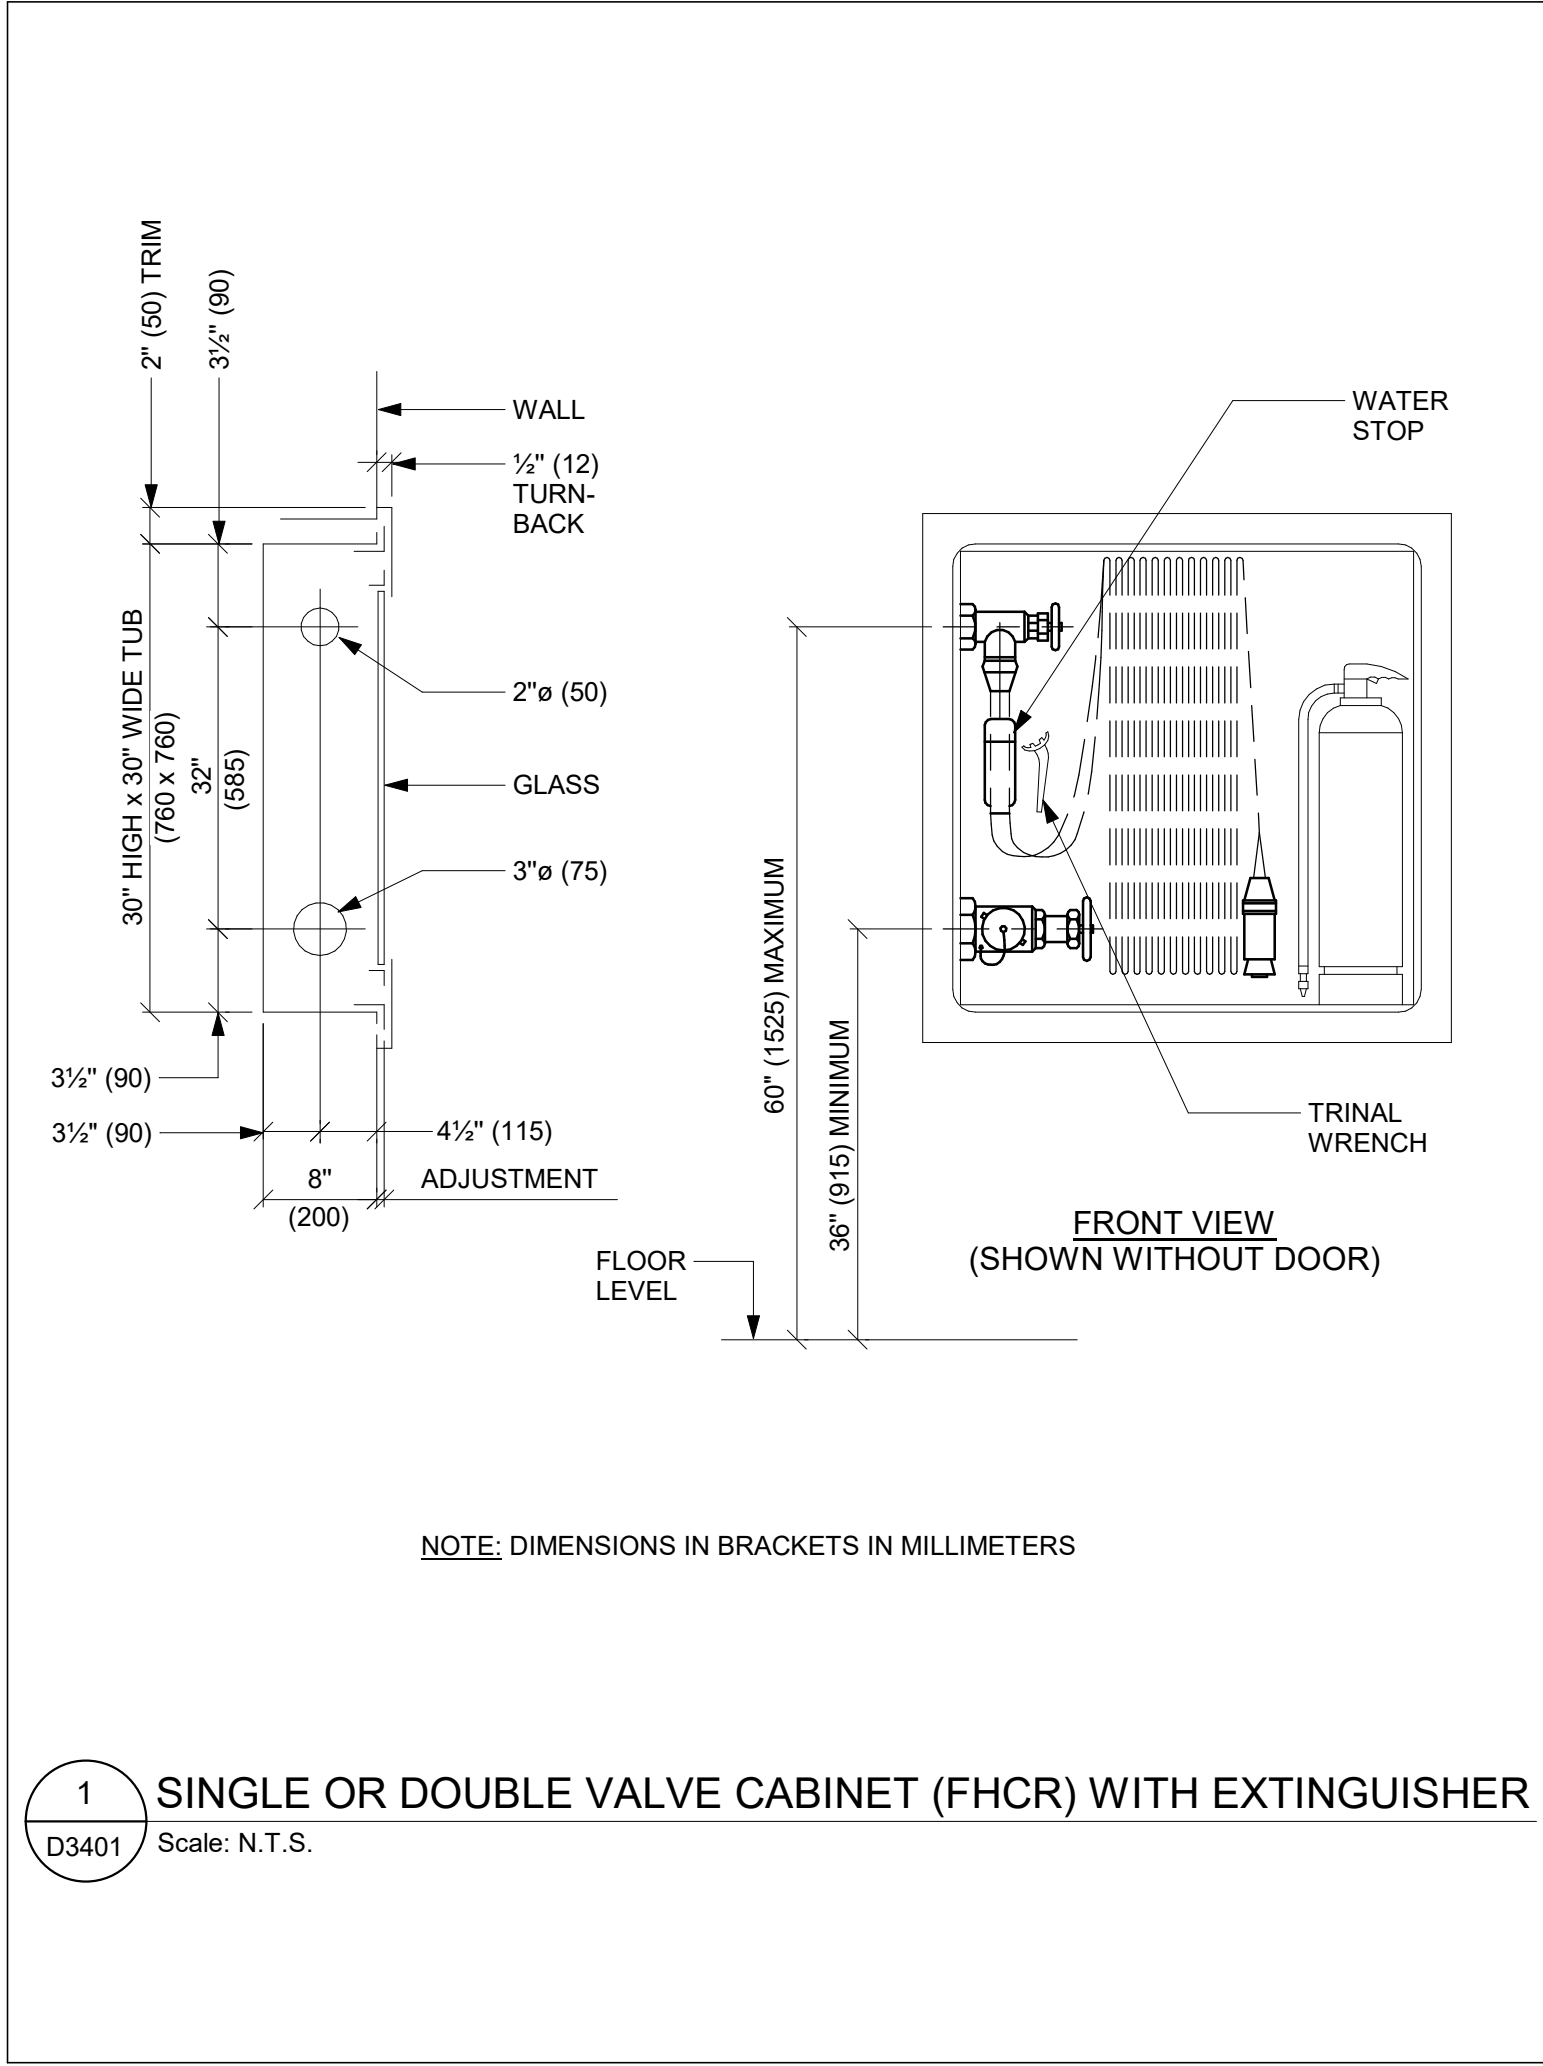

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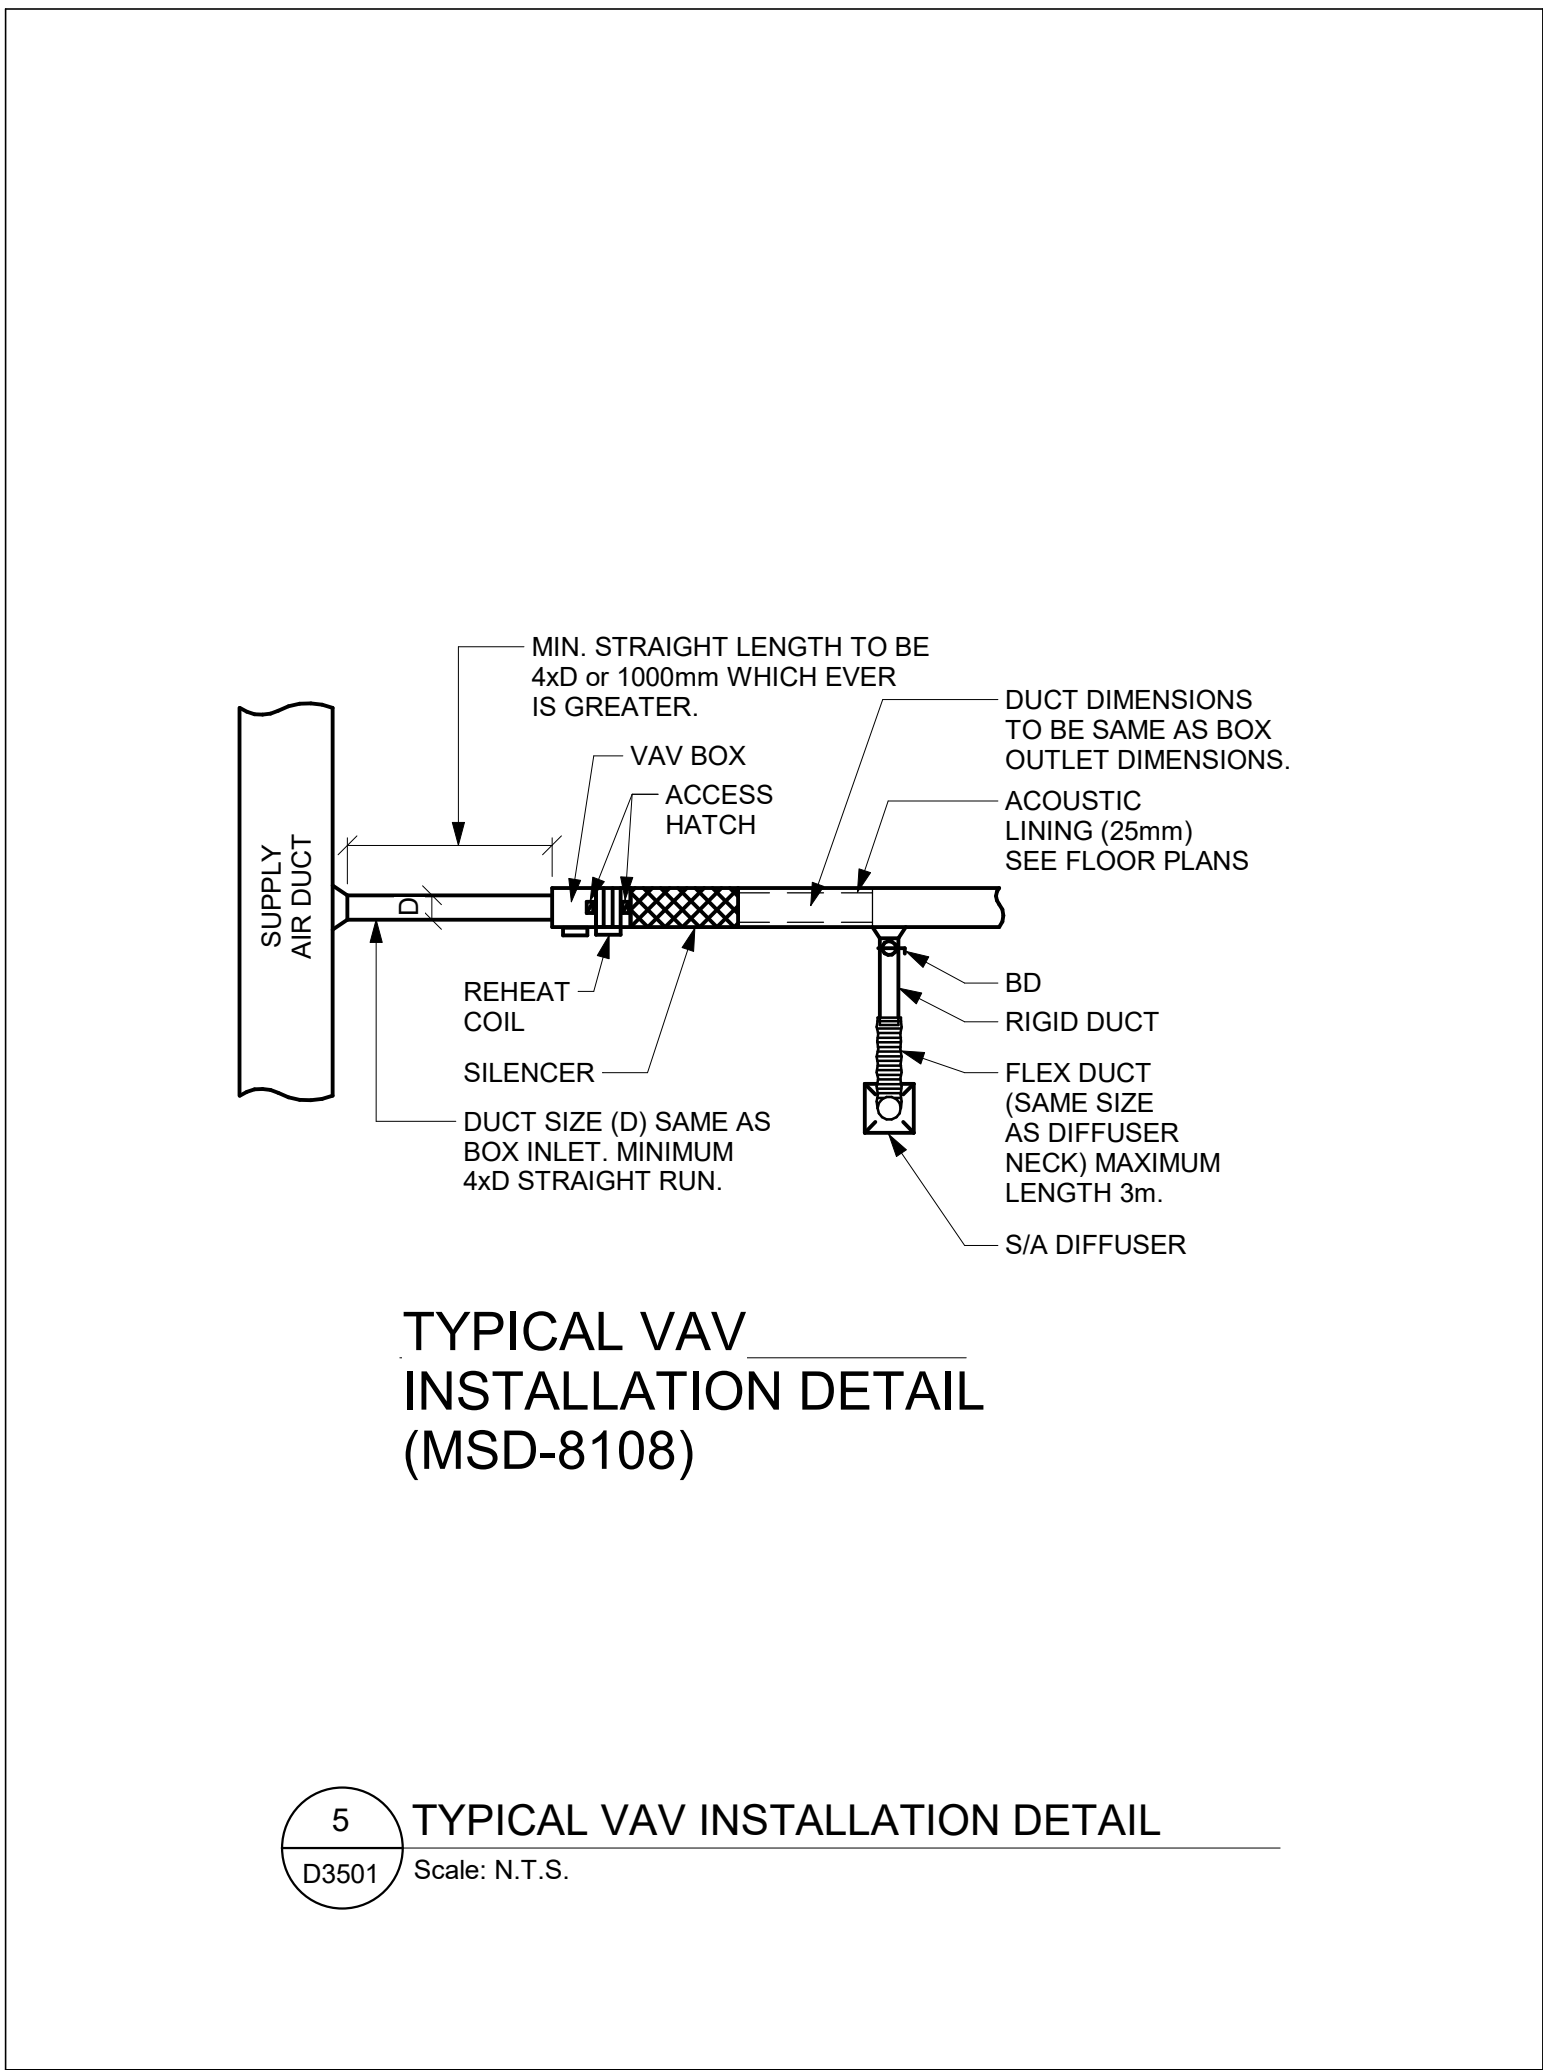
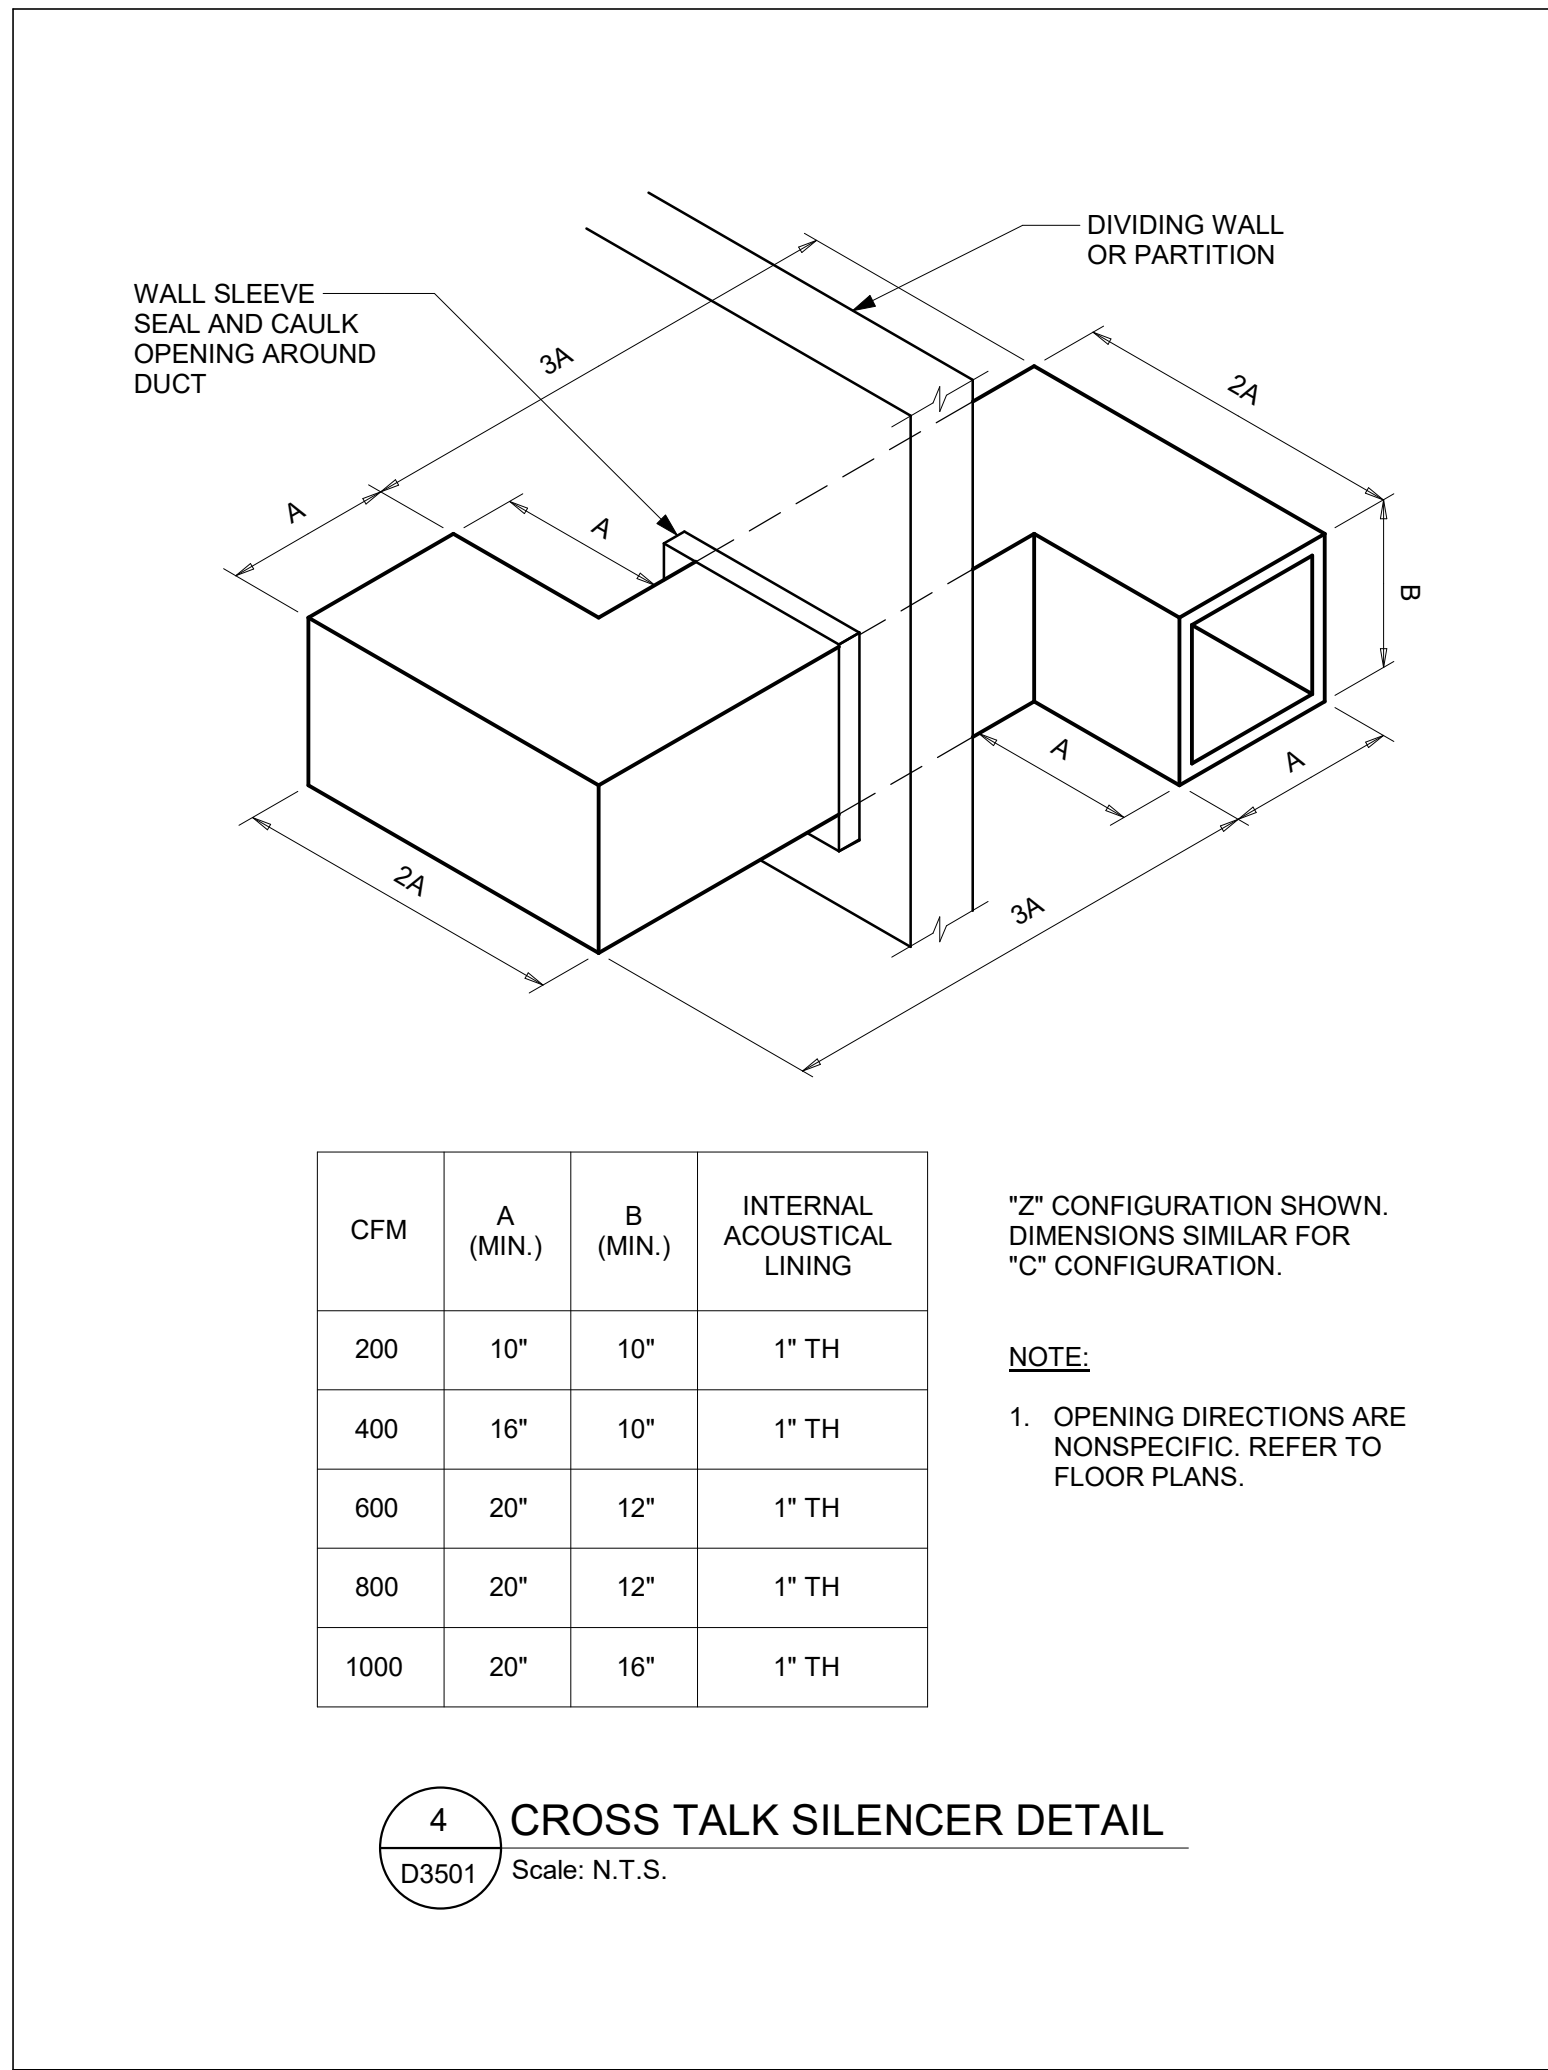
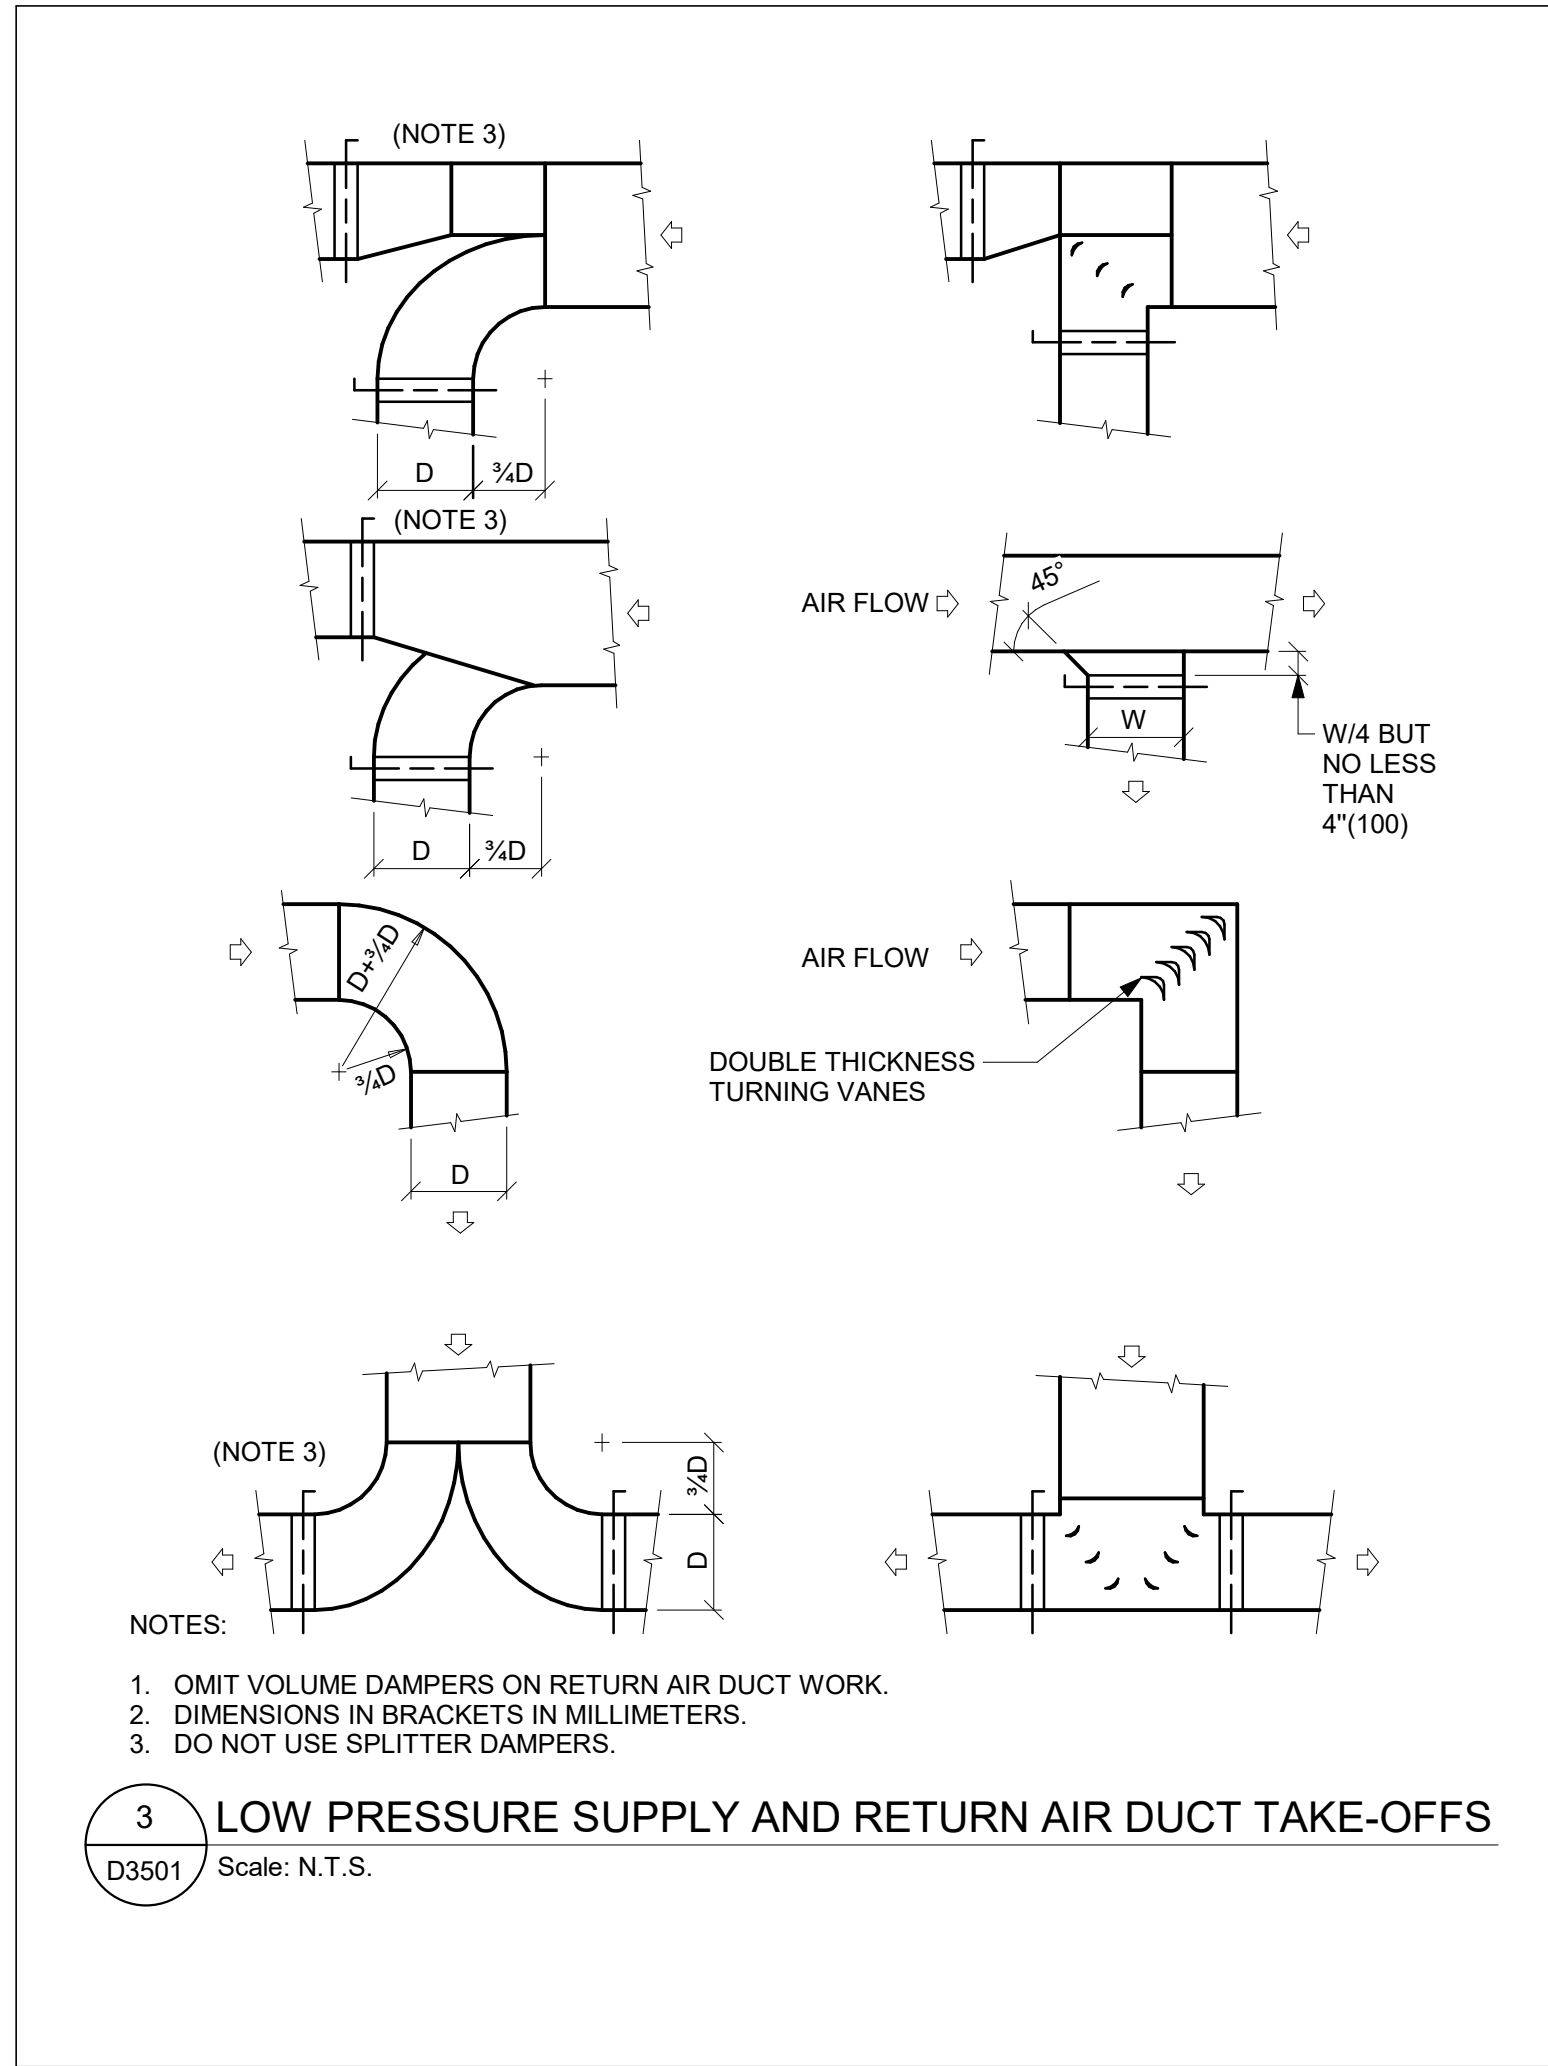
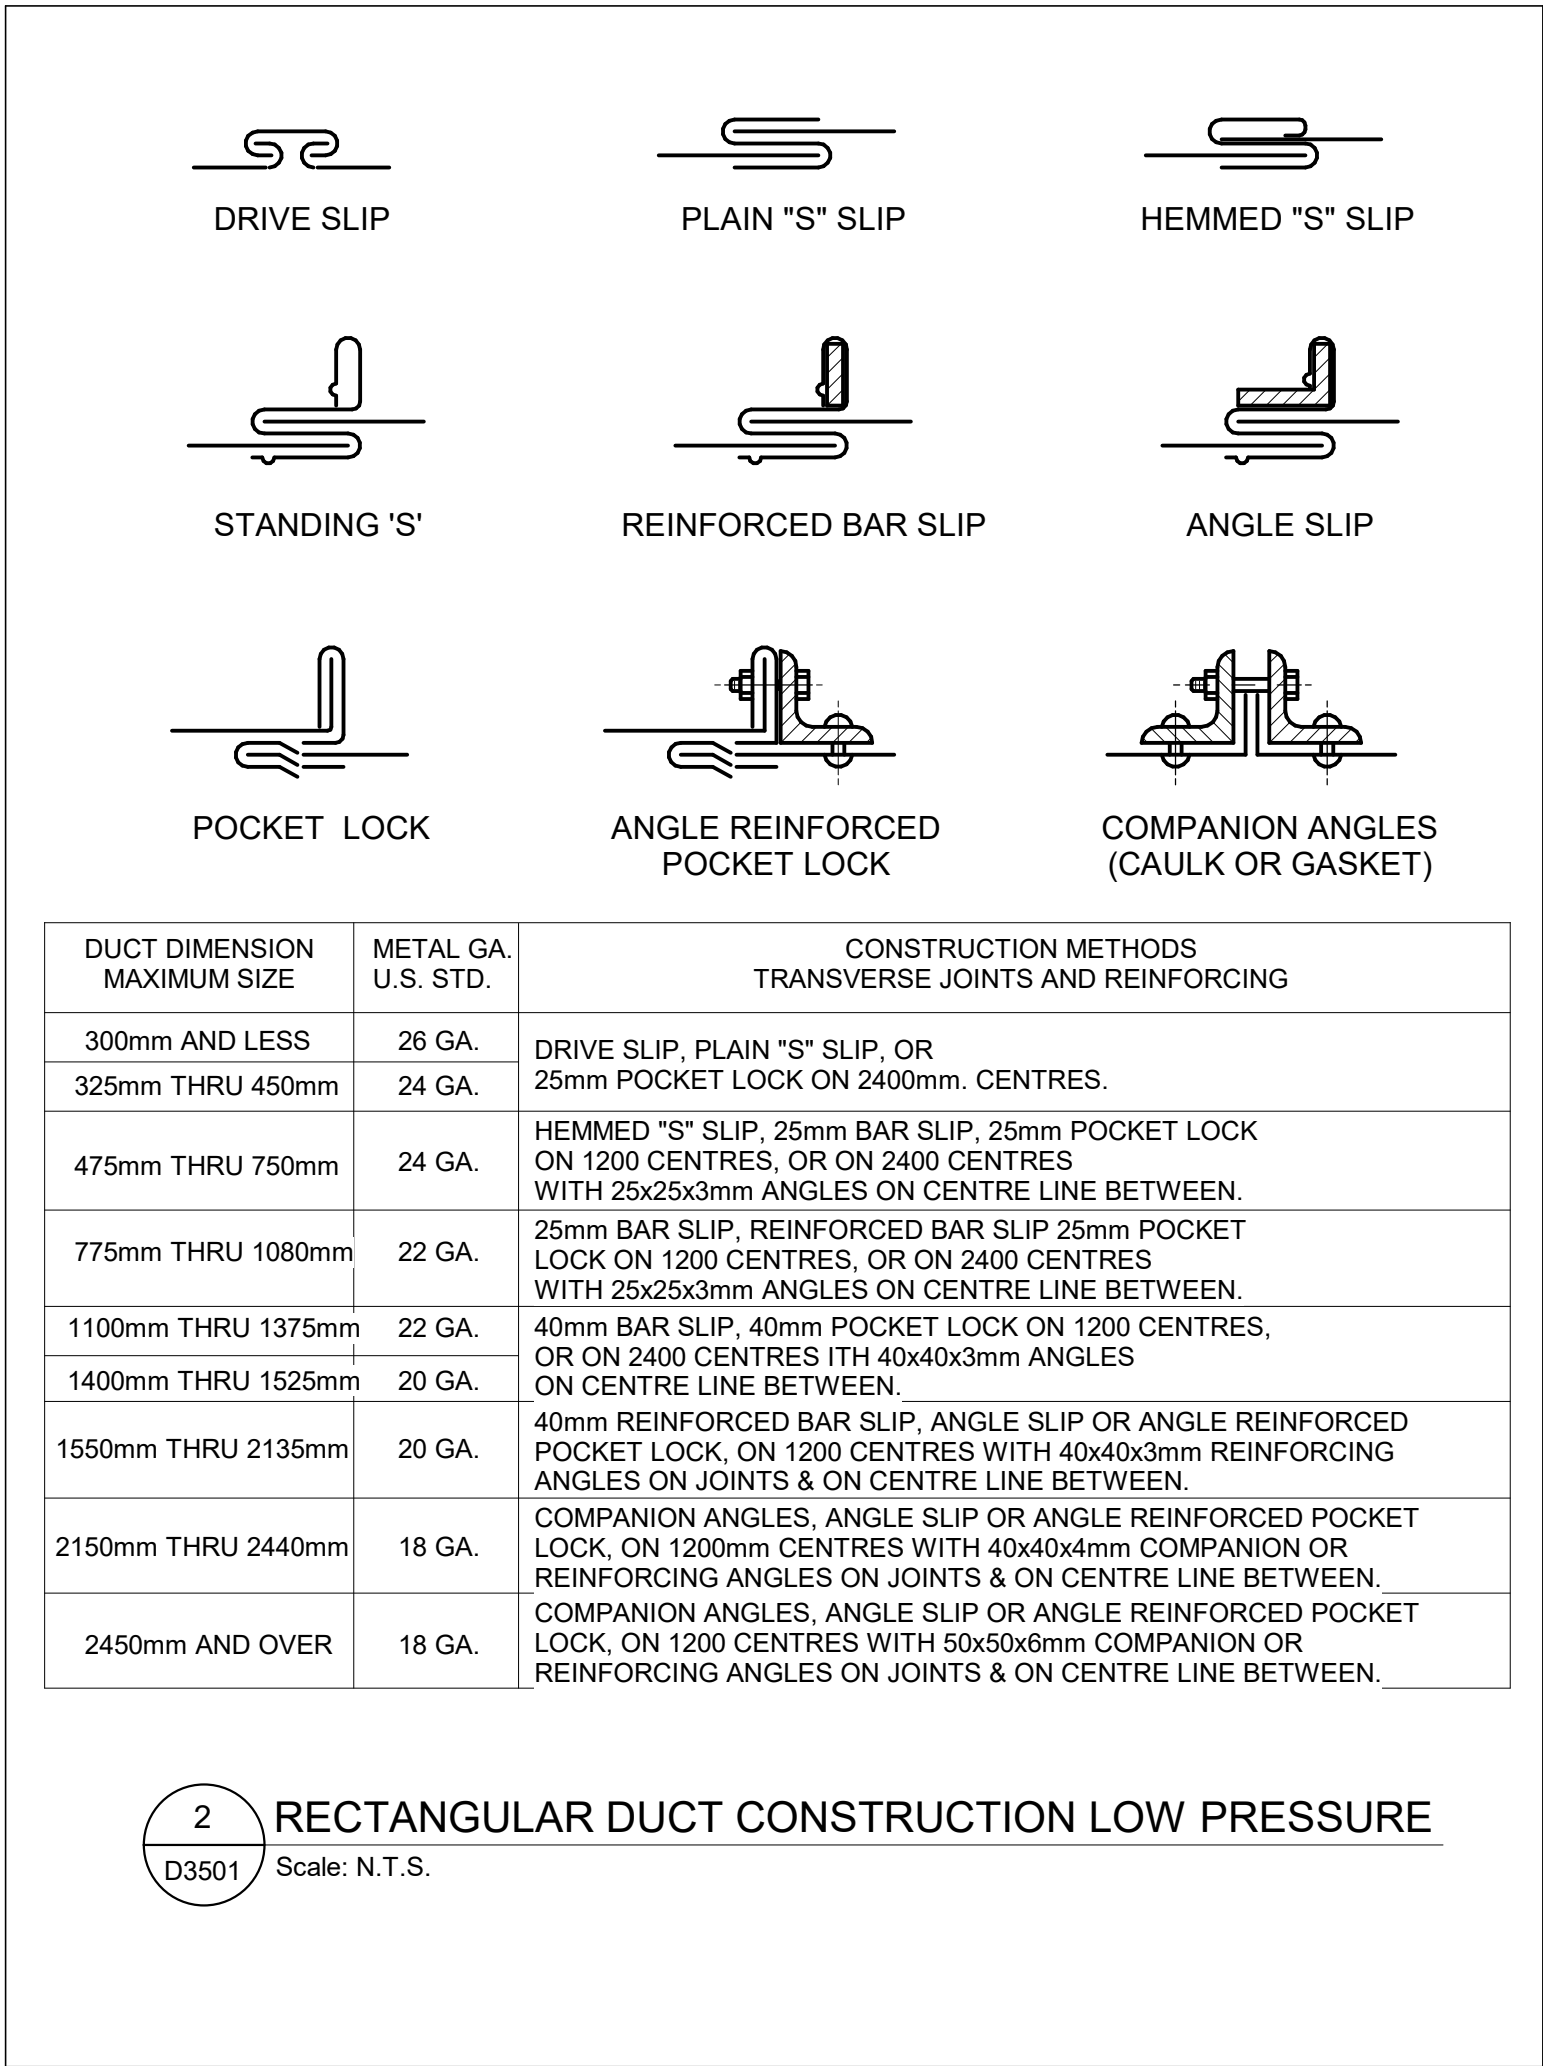
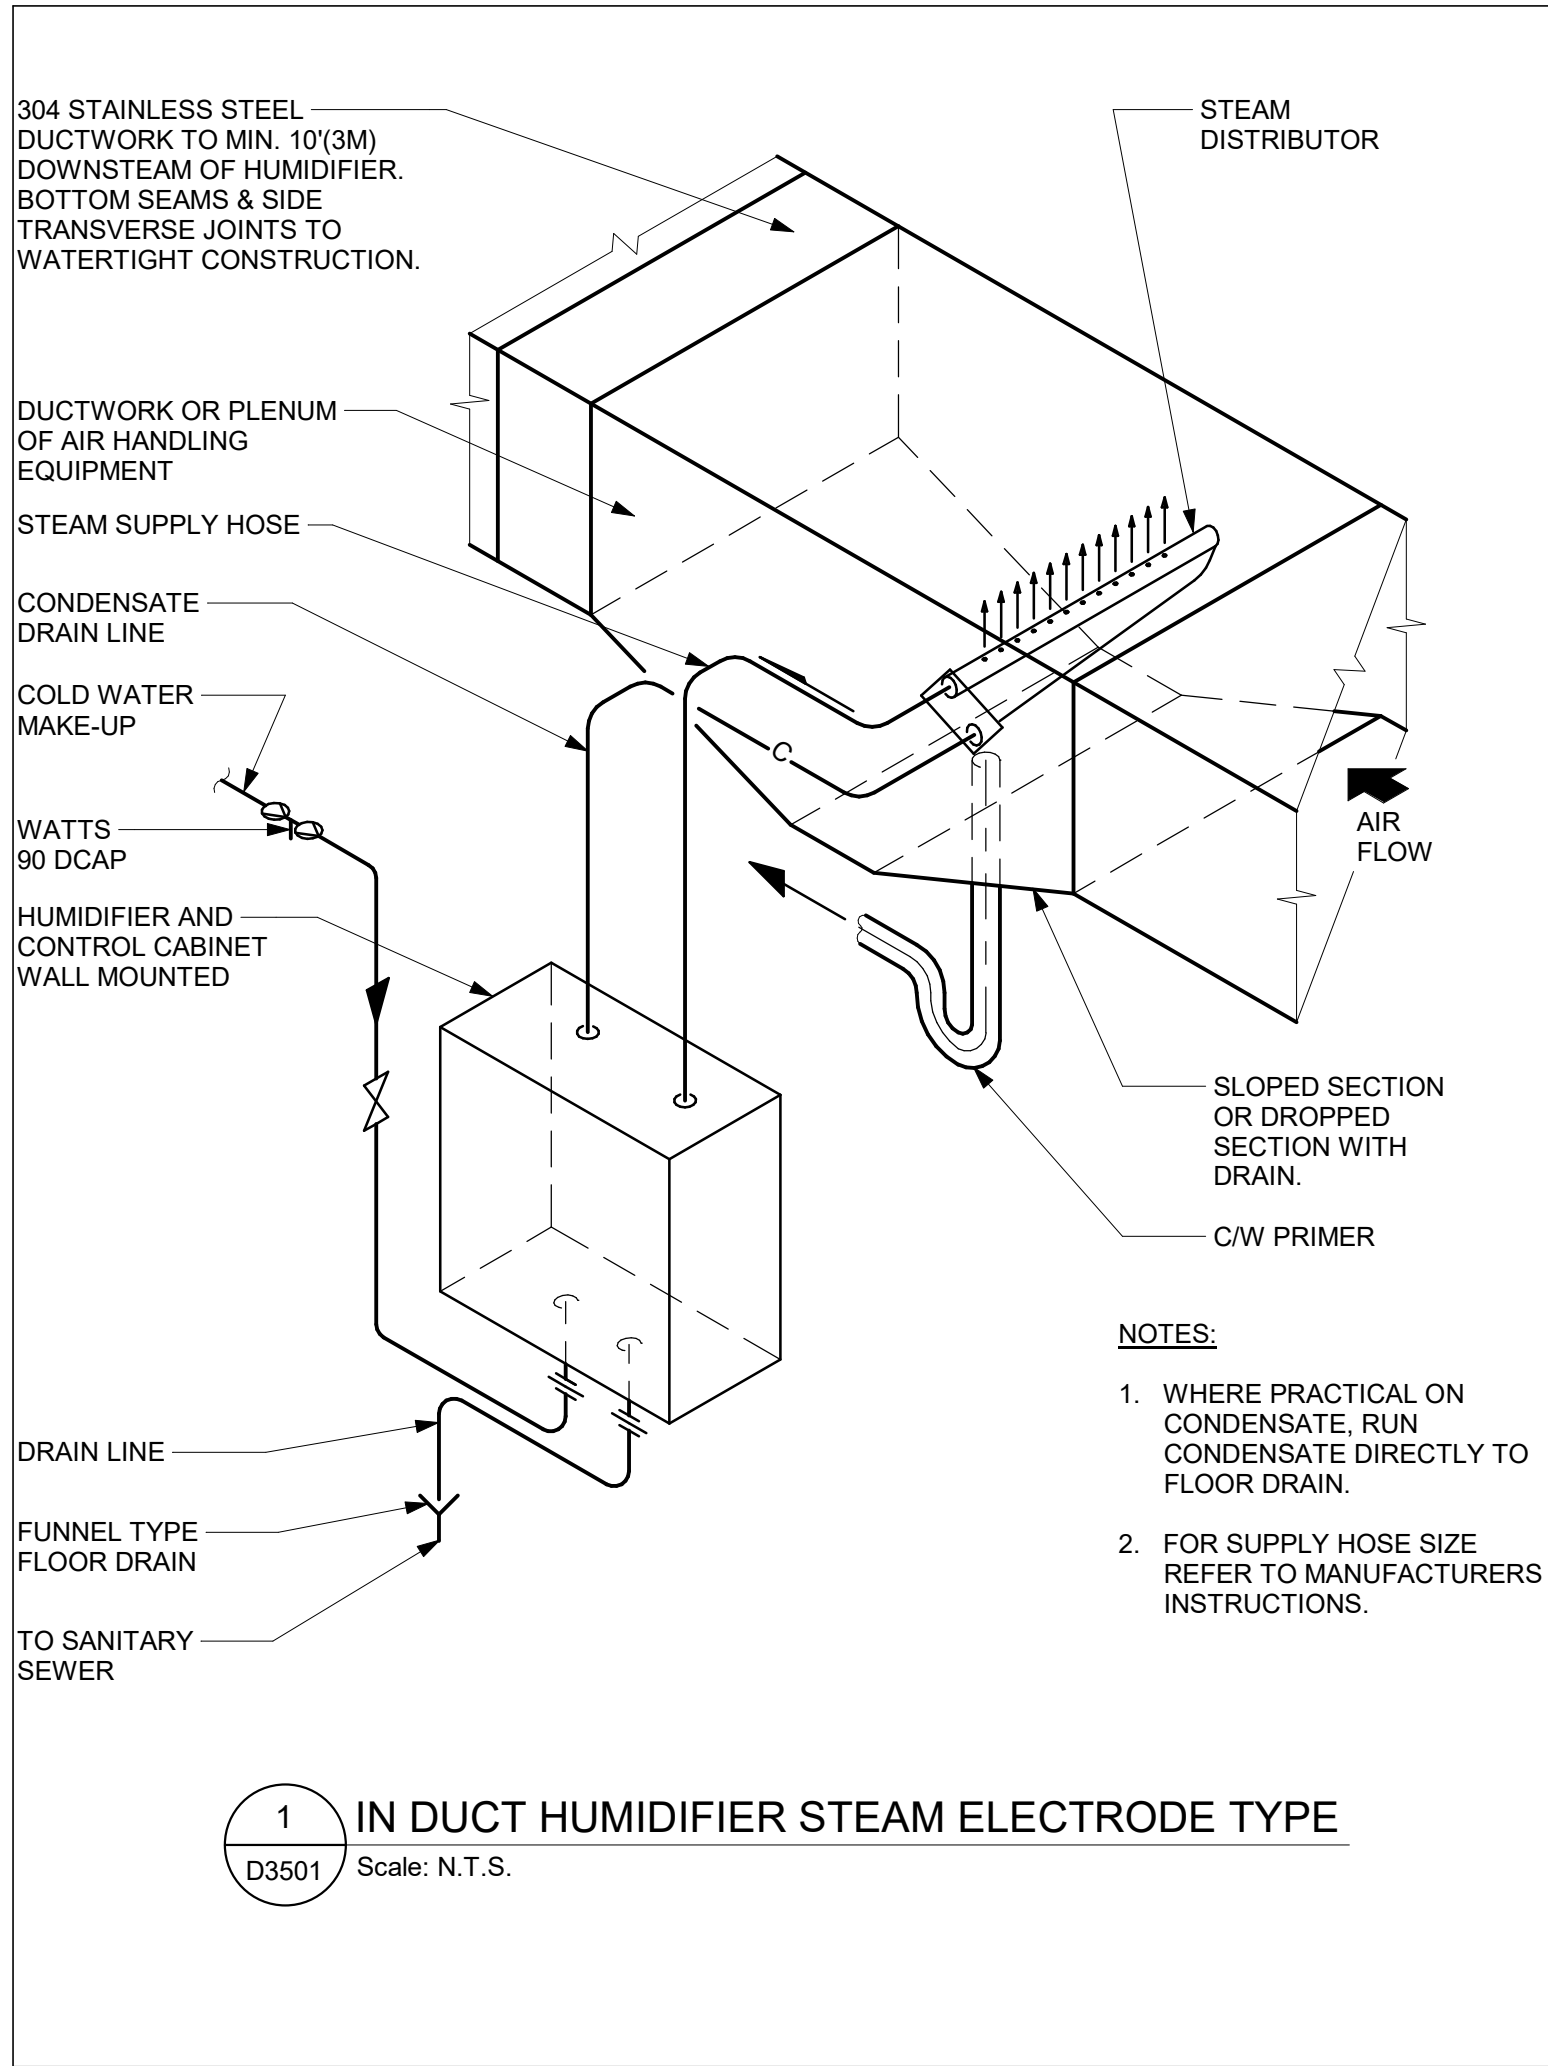
PROJECT TITLE
**CITY OF TORONTO
ACCESSIBILITY UPGRADES**

PROJECT ADDRESS

PROJECT NO: 9119- 19- 0162 / Arcadis 30279056	
DRAWN BY: K. DURUKAN	CHECKED BY: B. LIAO
PROJECT MGR: F. BOLOURIAN	APPROVED BY: S. LIU

SHEET TITLE
**FIRE PROTECTION
DETAILS**

SHEET NUMBER G05-GAL-D3401	ISSUE F
--------------------------------------	-------------------



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CITY OF TORONTO

Corporate Real Estate Management
Project Management Office
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PROJECT ADDRESS

PROJECT NO:
9119- 19- 0162 / Arcadis 30279056

DRAWN BY:
K. DURUKAN

CHECKED BY:
B. LIAO


PROJECT MGR:
F. BOLOURIAN

APPROVED BY:
S. LIU


SHEET TITLE
HVAC DETAILS

SHEET NUMBER
G05-GAL-D3501


ISSUE
F

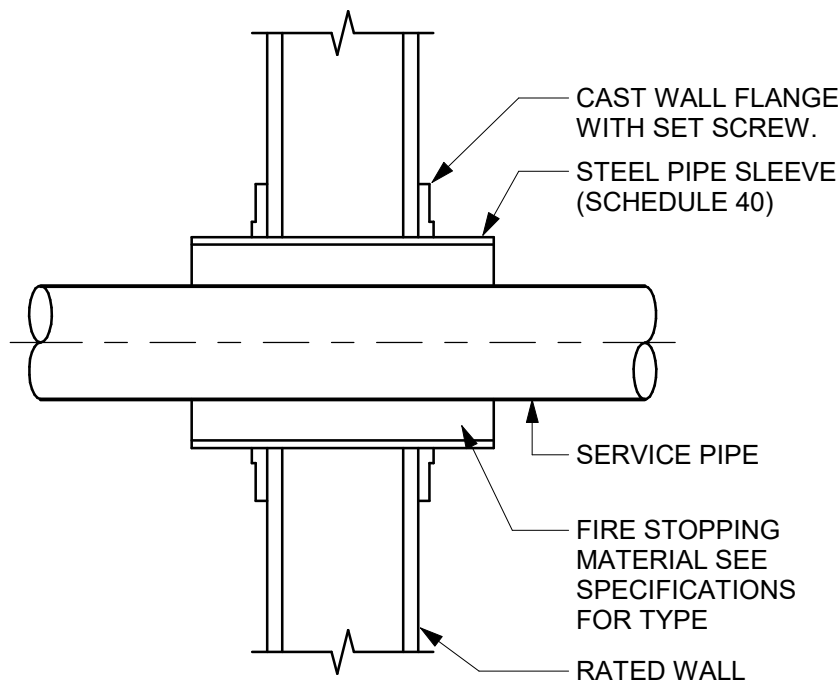



1 SLEEVE THROUGH RATED WALL
D3601 Scale: N.T.S.

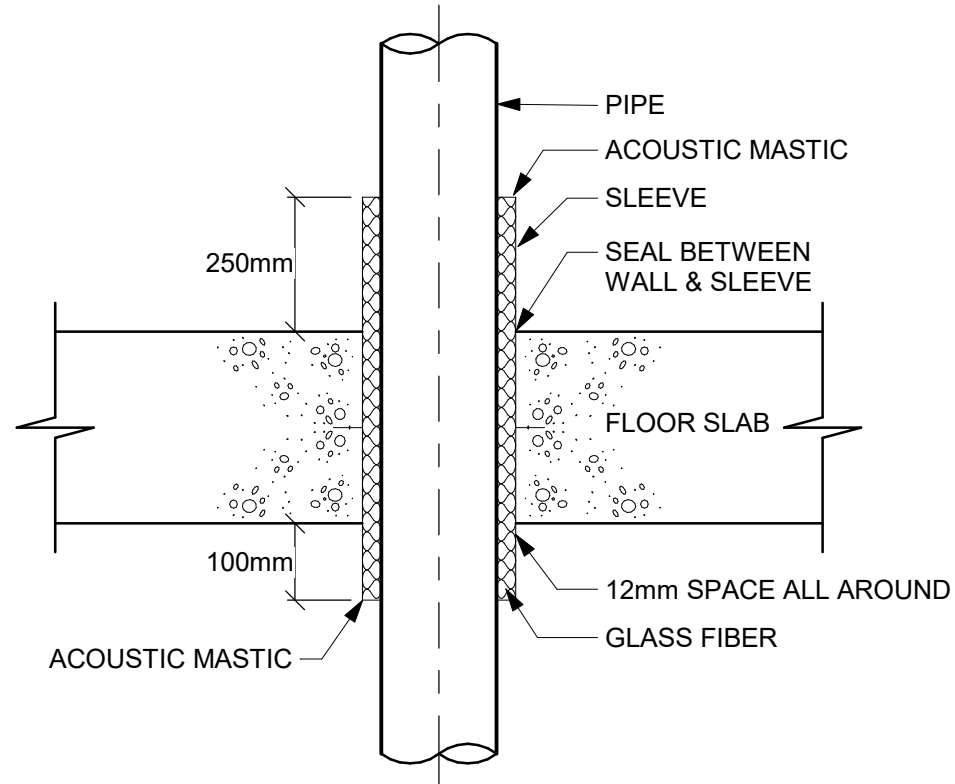


2 ACOUSTIC TREATMENT OF PIPE PENETRATION
OF MECHANICAL ROOM FLOOR SLAB
D3601 Scale: N.T.S.

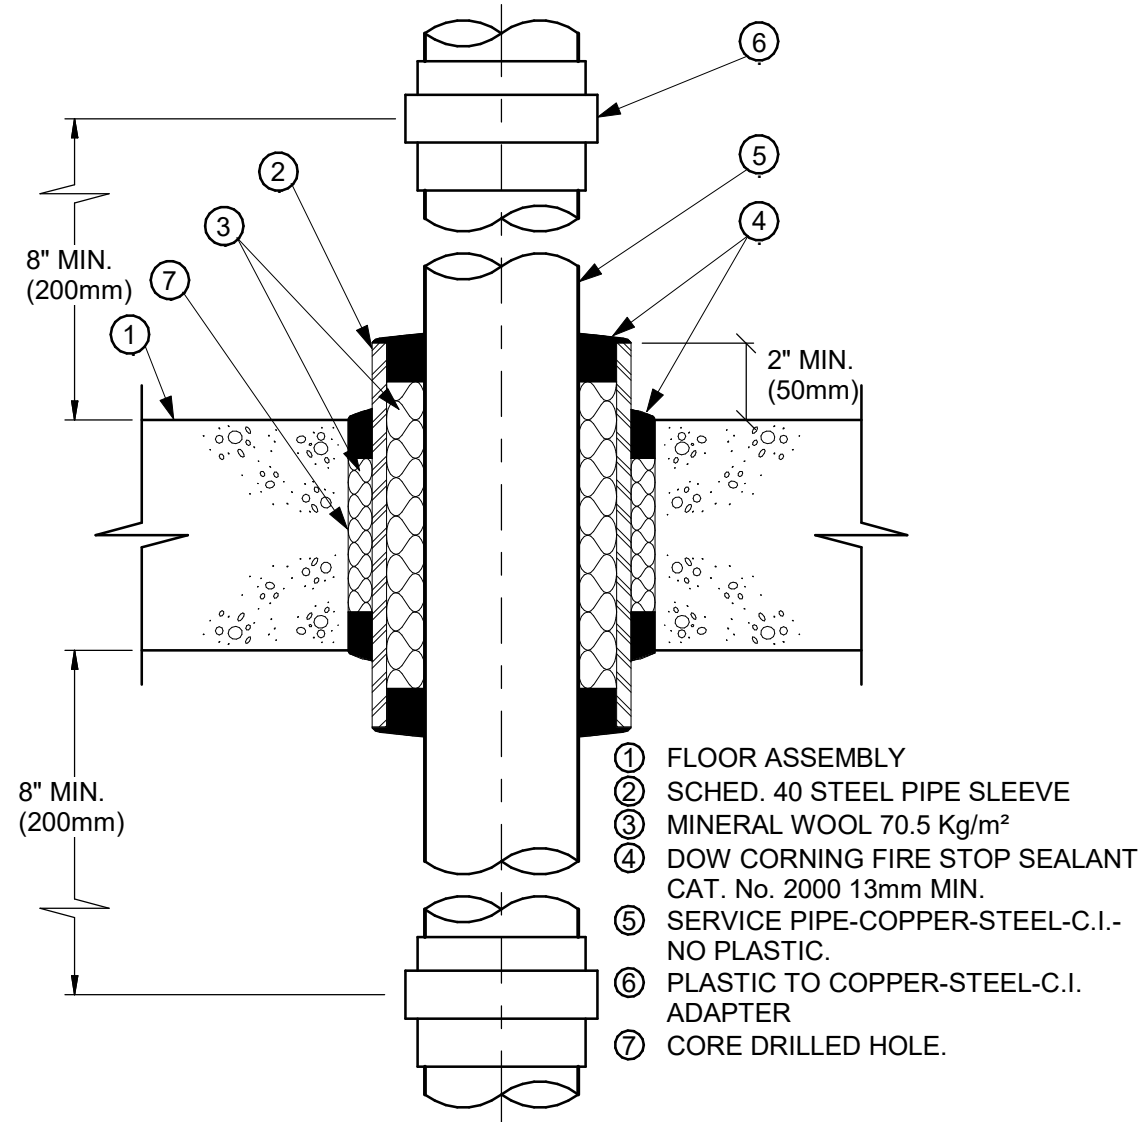


3 PIPE SLEEVE THROUGH FIRE RATED FLOOR SLAB
D3601 Scale: N.T.S.

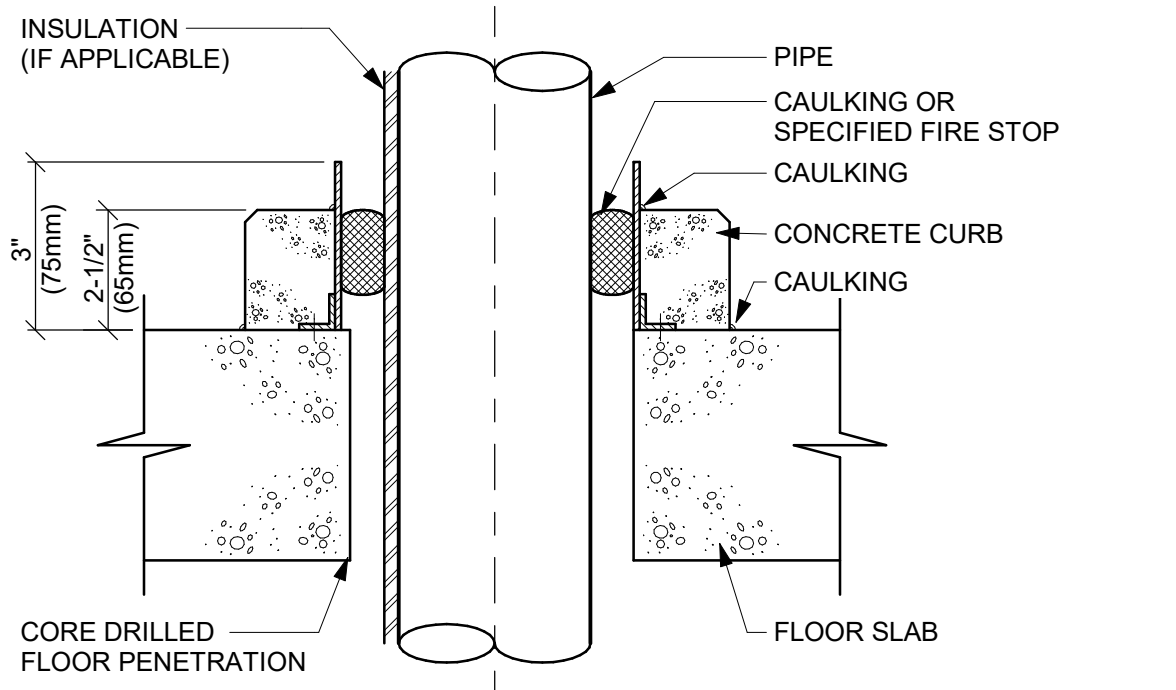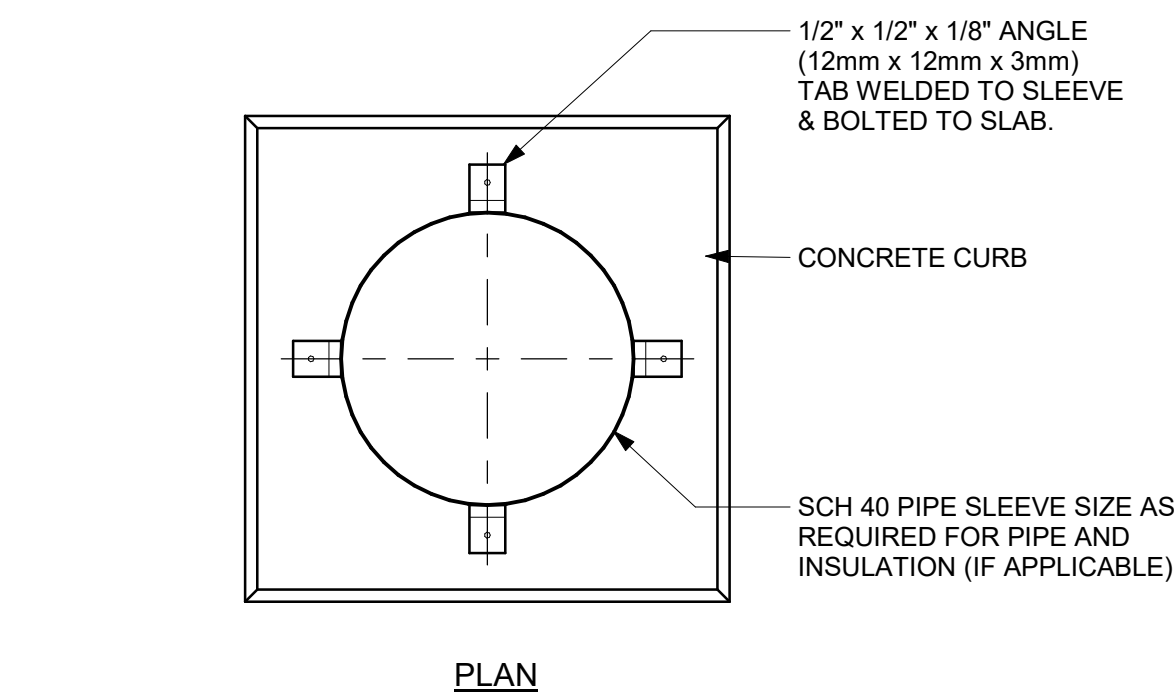

4 PIPE SLEEVE THROUGH EXISTING FLOOR SLAB
D3601 Scale: N.T.S.

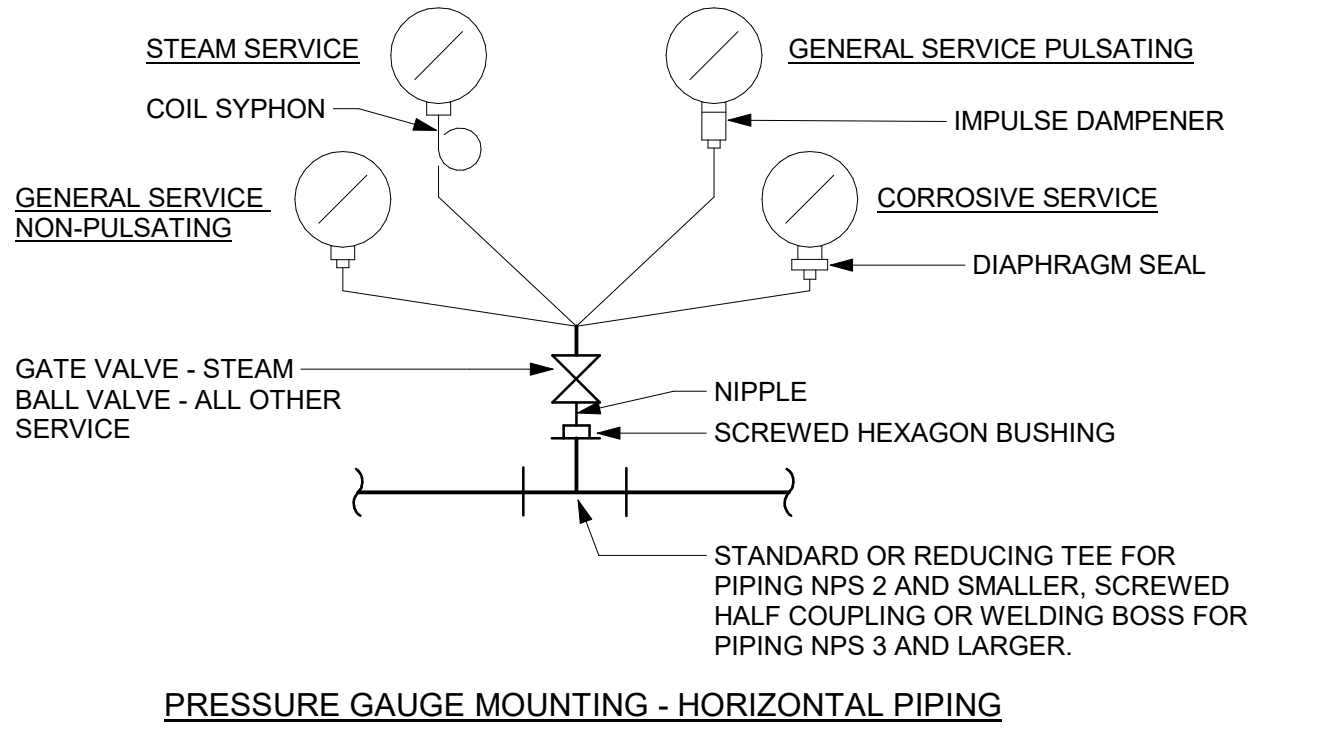

5 PRESSURE GAUGES
D3601 Scale: N.T.S.

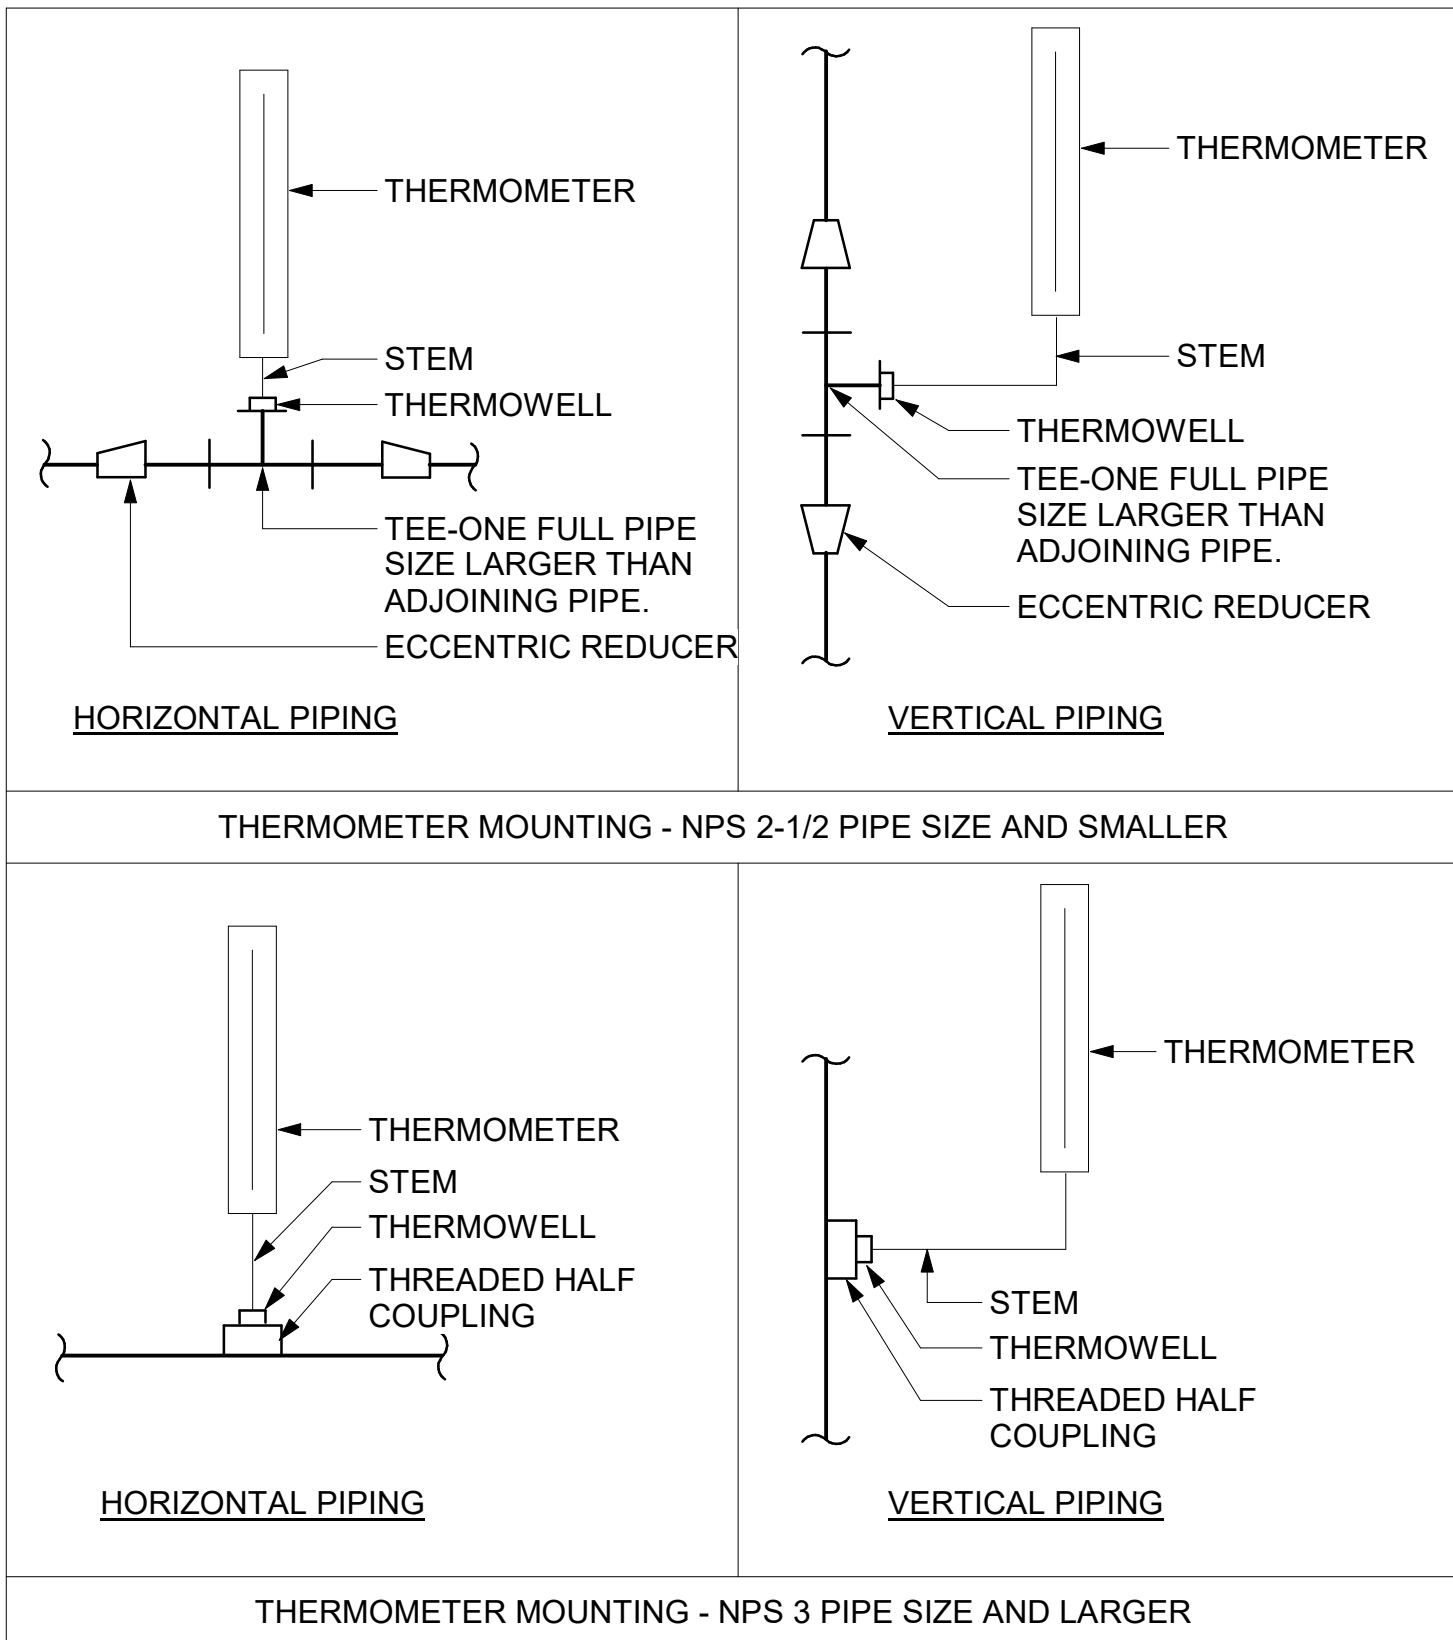

6 TEMPERATURE GAUGES
D3601 Scale: N.T.S.

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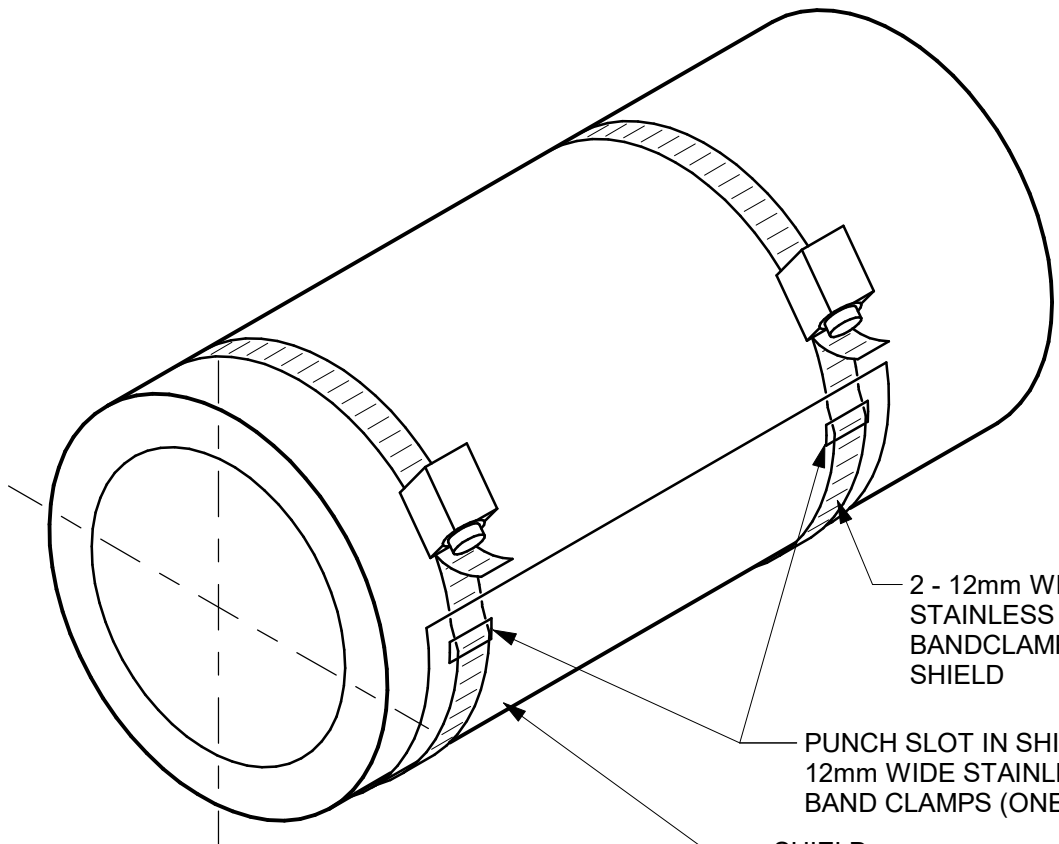
PROJECT TITLE
**CITY OF TORONTO
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PROJECT ADDRESS


PROJECT NO:
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DRAWN BY:
K. DURUKAN
CHECKED BY:
B. LIAO
PROJECT MGR:
F. BOLOURIAN
APPROVED BY:
S. LIU

SHEET TITLE
**PIPING DETAILS
SHEET 1 OF 2**

SHEET NUMBER
G05-GAL-D3601
ISSUE
F



1 INSULATION SHIELD INSTALLATION
D3602 Scale: N.T.S.

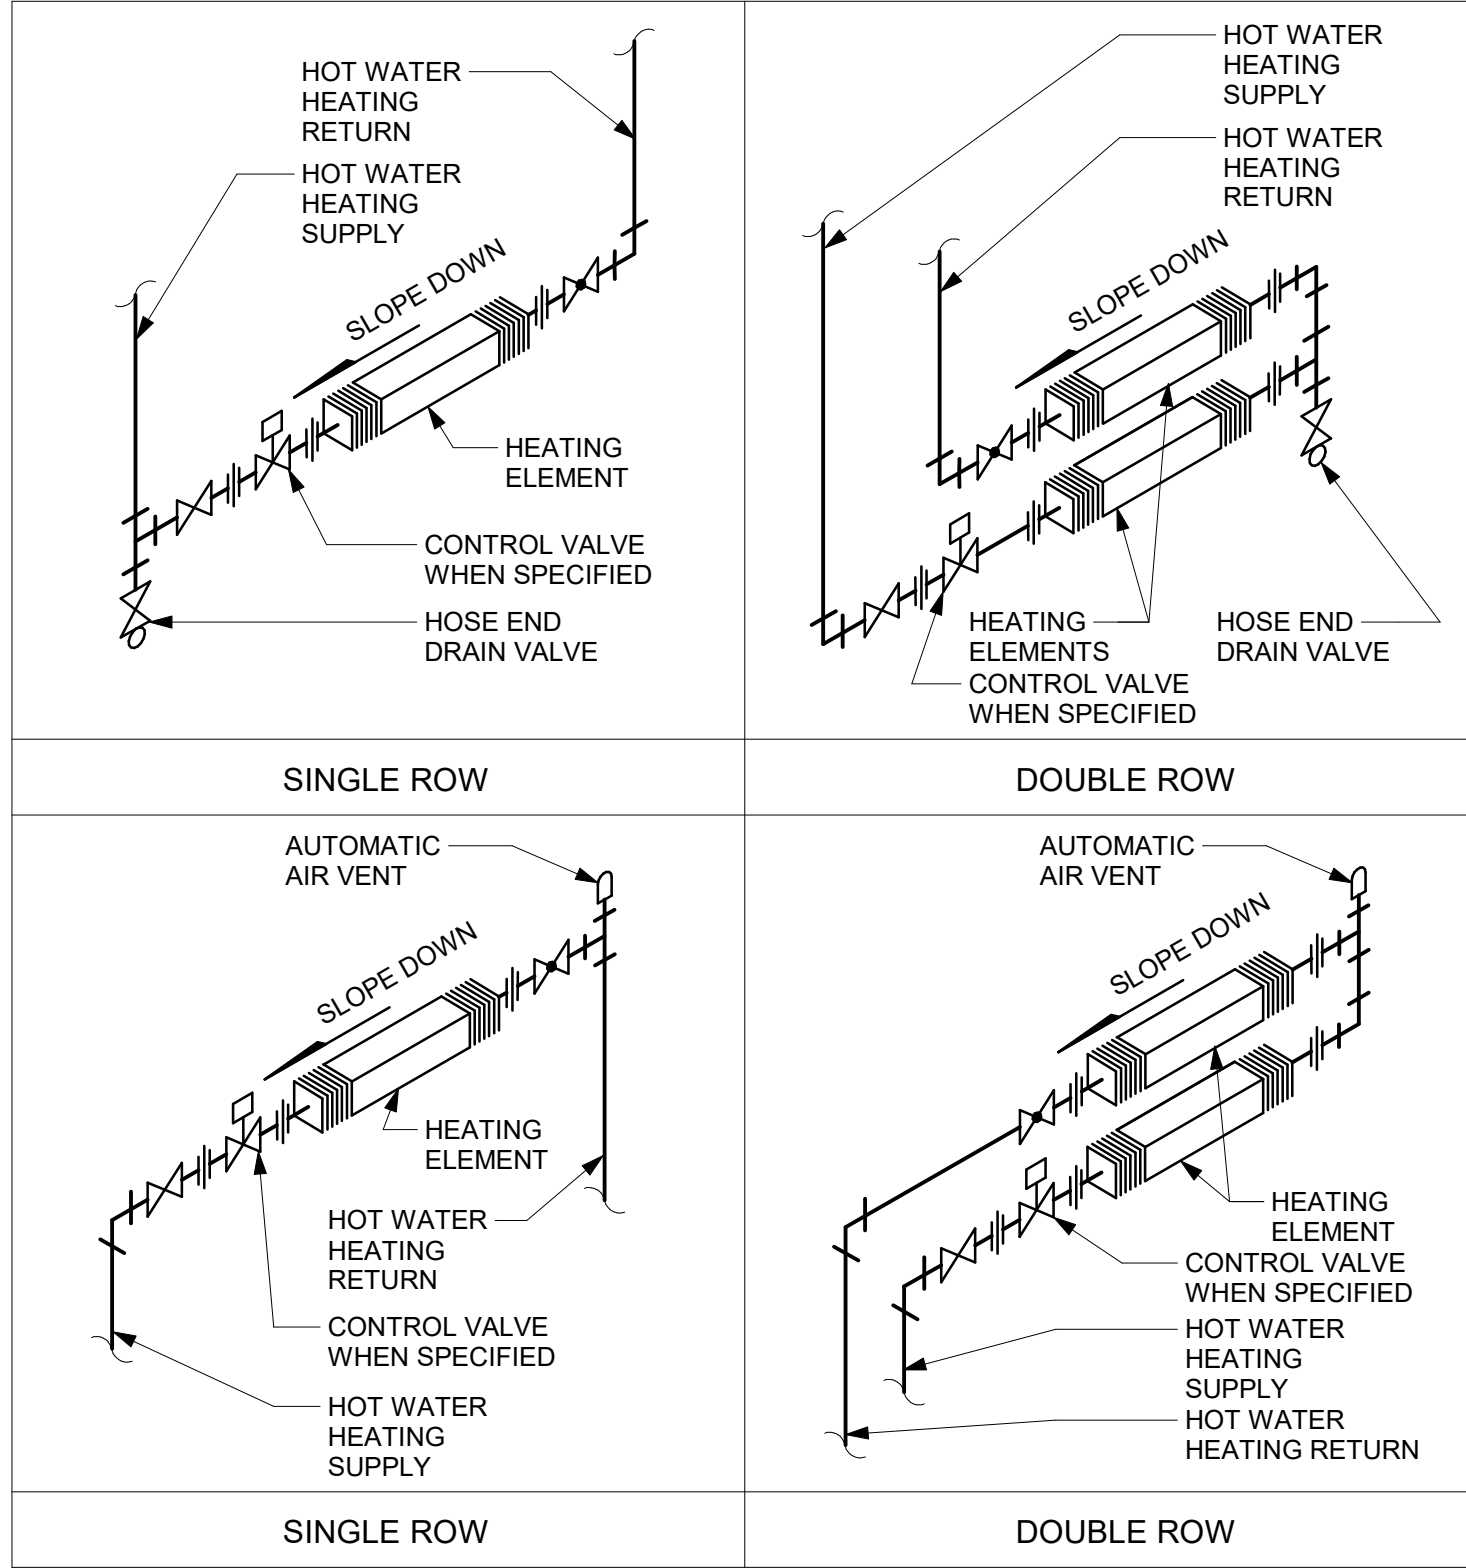

2 WALL FINNED CONVECTORS: HOT WATER
D3602 Scale: N.T.S.

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**CITY OF TORONTO
ACCESSIBILITY UPGRADES**

PROJECT ADDRESS

PROJECT NO:
9119- 19- 0162 / Arcadis 30279056

DRAWN BY: N. KHOURY	CHECKED BY: G. VERNESCU
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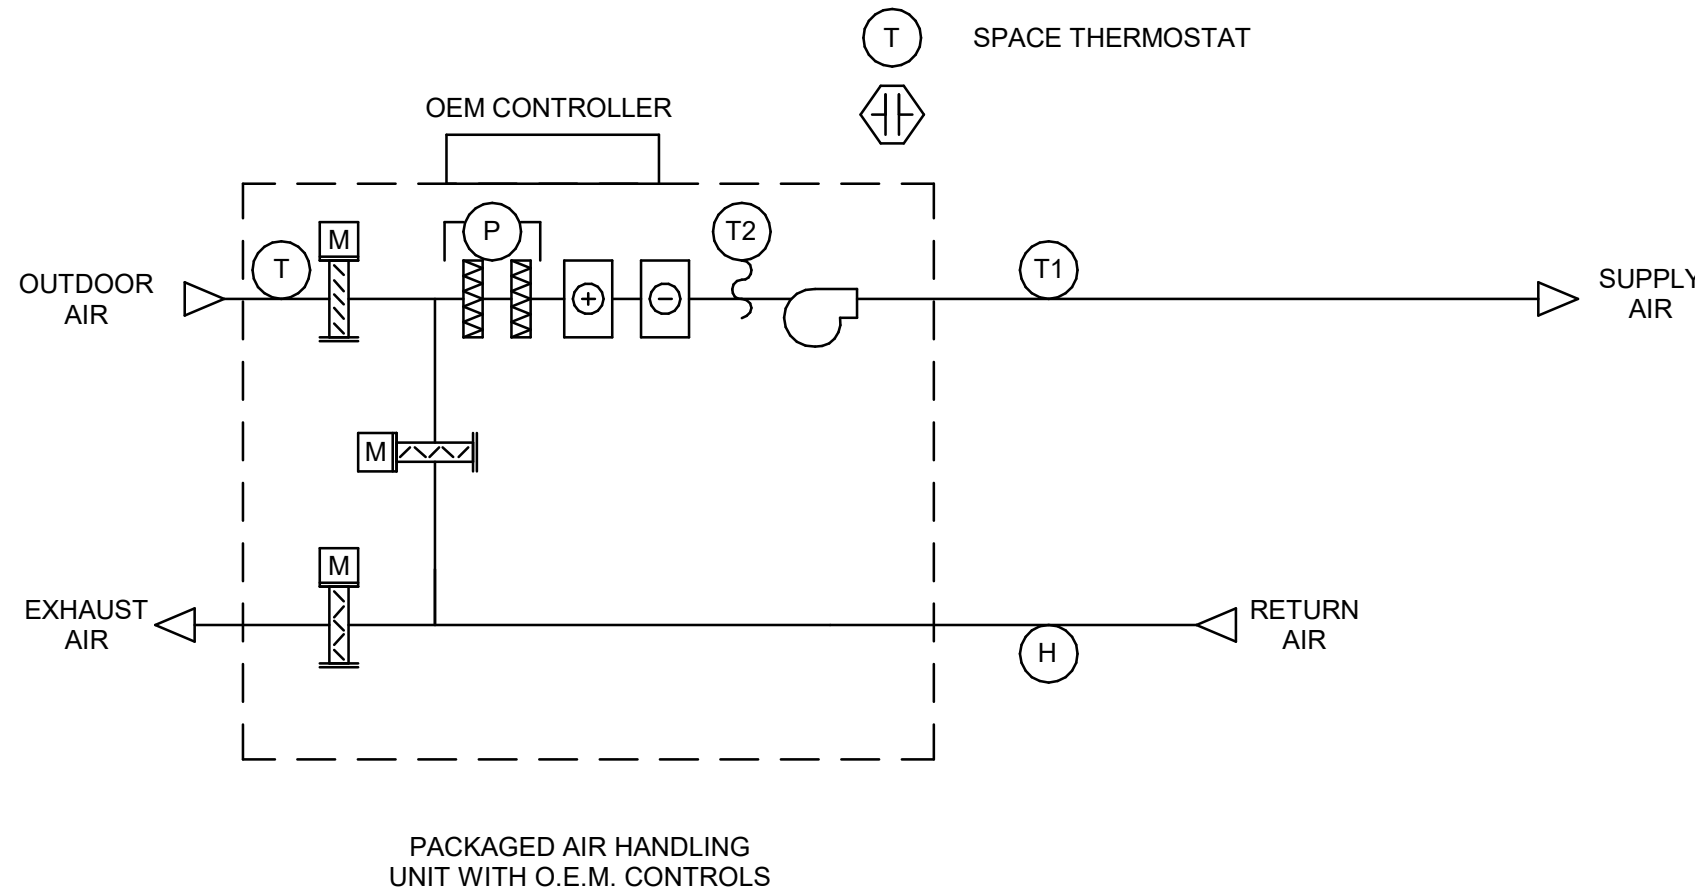
PROJECT MGR: F. BOLOURIAN	APPROVED BY: S. LIU
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SHEET TITLE
**PIPING DETAILS
SHEET 2 OF 2**

SHEET NUMBER G05-GAL-D3602	ISSUE F
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5 PACKAGED ROOFTOP HVAC SYSTEM CONTROL SEQUENCE - NO BAS CONTROL
D3701 Scale: N.T.S



SYSTEM START
AIR HANDLING UNIT START-UP ON TIME SCHEDULE

NORMAL OPERATION OEM CONTROL
AIR HANDLING UNIT OPERATES UNDER O.E.M. CONTROL.

TEMPERATURE CONTROL
OEM CONTROL MODULATES OUTDOOR AIR, RETURN AIR AND EXHAUST AIR DAMPERS IN AN AIR-ECONOMIZER CYCLE TO MAINTAIN SPACE AIR TEMPERATURE SETPOINT. MECHANICAL COOLING SUPPLEMENTS THE ECONOMIZER COOLING AS REQUIRED

- SPACE AIR TEMPERATURE SETPOINT: 25°C
- ECONOMIZER CUTOFF TEMPERATURE SETPOINT > 18°C

WHEN RETURN AIR RELATIVE HUMIDITY LEVEL > 55%, STOP AIR-ECONOMIZER CYCLE; START MECHANICAL COOLING.

SYSTEM STOP
OPERATOR INITIATED OR BY OPERATING SCHEDULE.

ON COMMAND OR SCHEDULE STOP ESS, SUPPLY AND RETURN FANS STOP, OUTDOOR AIR AND EXHAUST DAMPERS CLOSE, AND RECIRCULATION DAMPER OPENS.

SCHEDULE
TO BE DETERMINED DURING SYSTEM COMMISSIONING

FIRE ALARM
N/A


ALARMS
ALARM ON OEM CONTROLLER:

- HIGH FILTER PRESSURE DROP > 2 IN. W.C.
- AIR HANDLING UNIT GENERAL FAULT
- HIGH BUILDING RELATIVE HUMIDITY > 60% RH
- HIGH SPACE AIR TEMPERATURE > 25C
- LOW SPACE AIR TEMPERATURE < 10C

MONITOR
N/A

TREND LOGS
N/A

EMERGENCY POWER
NO

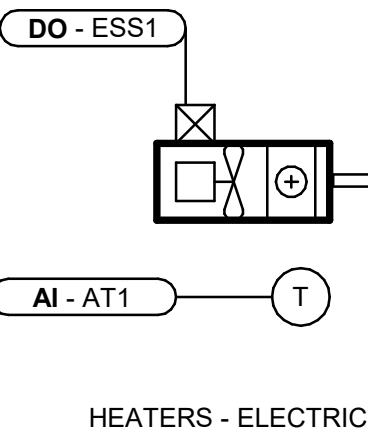

SYSTEM START
B.M.S. ENABLES UNIT HEATER WHEN OUTDOOR AIR TEMPERATURE IS < 10°C

NORMAL OPERATION
SPACE TEMPERATURE SENSOR CYCLES UNIT HEATER ON/OFF TO MAINTAIN SPACE TEMPERATURE SETPOINT [20°C]

SYSTEM STOP
CONTINUOUS OPERATION

SCHEDULE
CONTINUOUS OPERATION

FIRE ALARM
N/A


ALARMS
LOW SPACE TEMPERATURE (<10C)

MONITOR
SPACE TEMPERATURE

TREND LOGS
N/A

EMERGENCY POWER
NO

3 ELECTRIC HEATER CONTROL SEQUENCE - WITH BMS
D3701 Scale: N.T.S

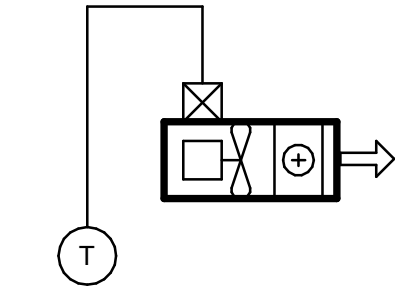

SYSTEM START
OPERATOR MANUALLY ENERGIZES THE UNIT HEATER LOCALLY. NO B.M.S. CONTROL

NORMAL OPERATION
HARD-WIRED SPACE TEMPERATURE SWITCH CYCLES UNIT HEATER ON/OFF TO MAINTAIN SPACE TEMPERATURE SETPOINT [20°C]

SYSTEM STOP
CONTINUOUS OPERATION

SCHEDULE
CONTINUOUS OPERATION

FIRE ALARM
N/A


ALARMS
N/A

MONITOR
N/A

TREND LOGS
N/A

EMERGENCY POWER
NO

4 ELECTRIC HEATER CONTROL SEQUENCE - NO BMS
D3701 Scale: N.T.S

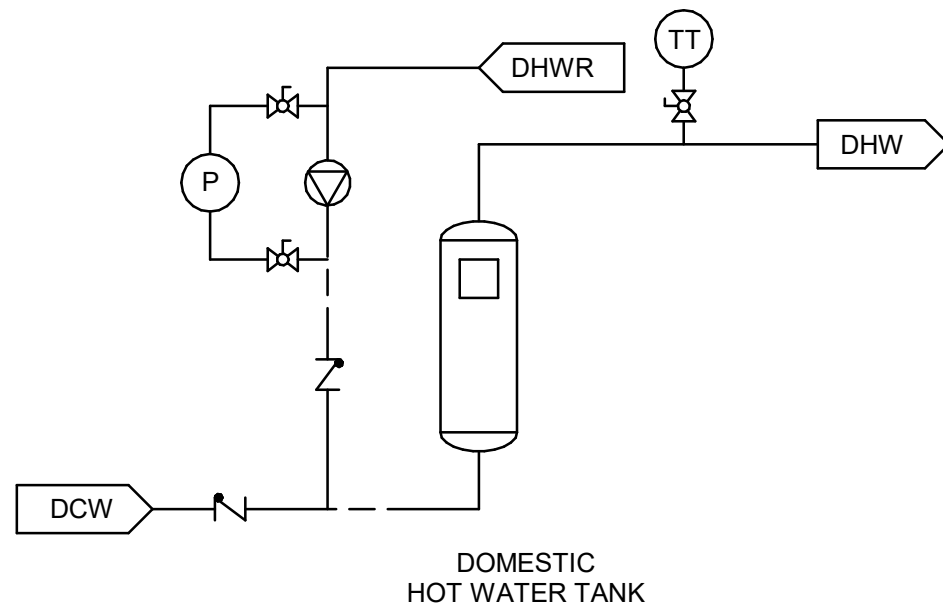

SYSTEM START
RECIRCULATION PUMP STARTS. ENABLE HOT WATER TANK

NORMAL OPERATION
WATER HEATER OPERATE UNDER OEM CONTROL TO MAINTAIN WATER LEAVING TEMPERATURE AT 60°C

RECIRCULATION PUMP OPERATES WHEN REMOTE RECIRCULATION WATER TEMPERATURE IS 50°C (ADJUSTABLE) BELOW HOT WATER SUPPLY SET POINT

SYSTEM STOP
RECIRCULATION PUMP STOPS ONLY ON OPERATOR COMMAND

SCHEDULE
OPERATOR DEFINED

DEFAULT = CONTINUOUS OPERATION

FIRE ALARM
N/A


ALARMS
N/A

MONITOR
N/A

TREND LOGS
N/A

EMERGENCY POWER
NO

2 HOT WATER TANK (WITH RECIRCULATION PUMP) CONTROL SEQUENCE - NO BMS CONTROL
D3701 Scale: N.T.S

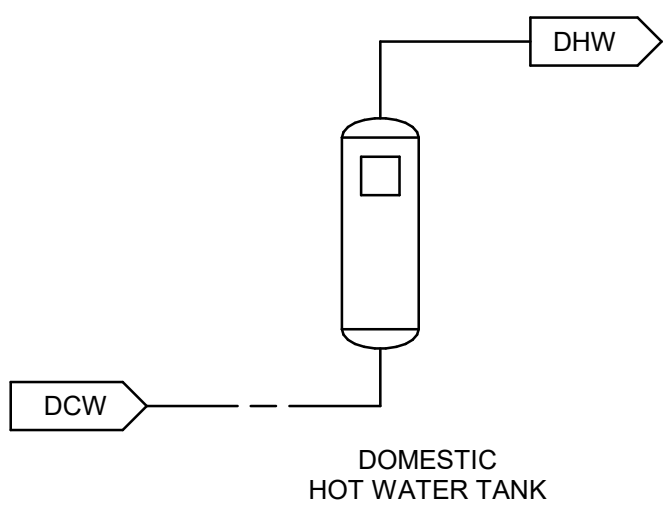

SYSTEM START
SYSTEM ENABLED ON OPERATOR COMMAND

NORMAL OPERATION
WATER HEATER OPERATE UNDER OEM CONTROL TO MAINTAIN WATER LEAVING TEMPERATURE AT 60°C

SYSTEM STOP
SYSTEM DISABLED ON OPERATOR COMMAND

SCHEDULE
OPERATOR DEFINED

DEFAULT = CONTINUOUS OPERATION

FIRE ALARM
N/A

ALARMS
N/A

MONITOR
N/A

TREND LOGS
N/A

EMERGENCY POWER
NO

1 HOT WATER TANK CONTROL SEQUENCE - NO BMS CONTROL
D3701 Scale: N.T.S

ISSUES		
No.	DESCRIPTION	DATE
A	50% SUBMISSION	2021-11-19
B	90% SUBMISSION	2022-02-22
C	ISSUED FOR PERMIT	2022-03-18
D	ISSUED FOR TENDER	2022-12-07
E	ISSUED FOR TENDER	2025-04-11

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100 - 175 Galaxy Blvd,
Toronto, ON M9W 0C9, Canada
tel 416 679 1930
www.arcadis.com

PROJECT TITLE
**CITY OF TORONTO
ACCESSIBILITY UPGRADES**

PROJECT ADDRESS

PROJECT NO:
9119- 19- 0162 / Arcadis 30279056

DRAWN BY:
N. KHOURY

CHECKED BY:
G. VERNESCU


PROJECT MGR:
F. BOLOURIAN

APPROVED BY:
S. LIU

SHEET TITLE
CONTROL DETAILS


SHEET NUMBER
G05-GAL-D3701

ISSUE
E

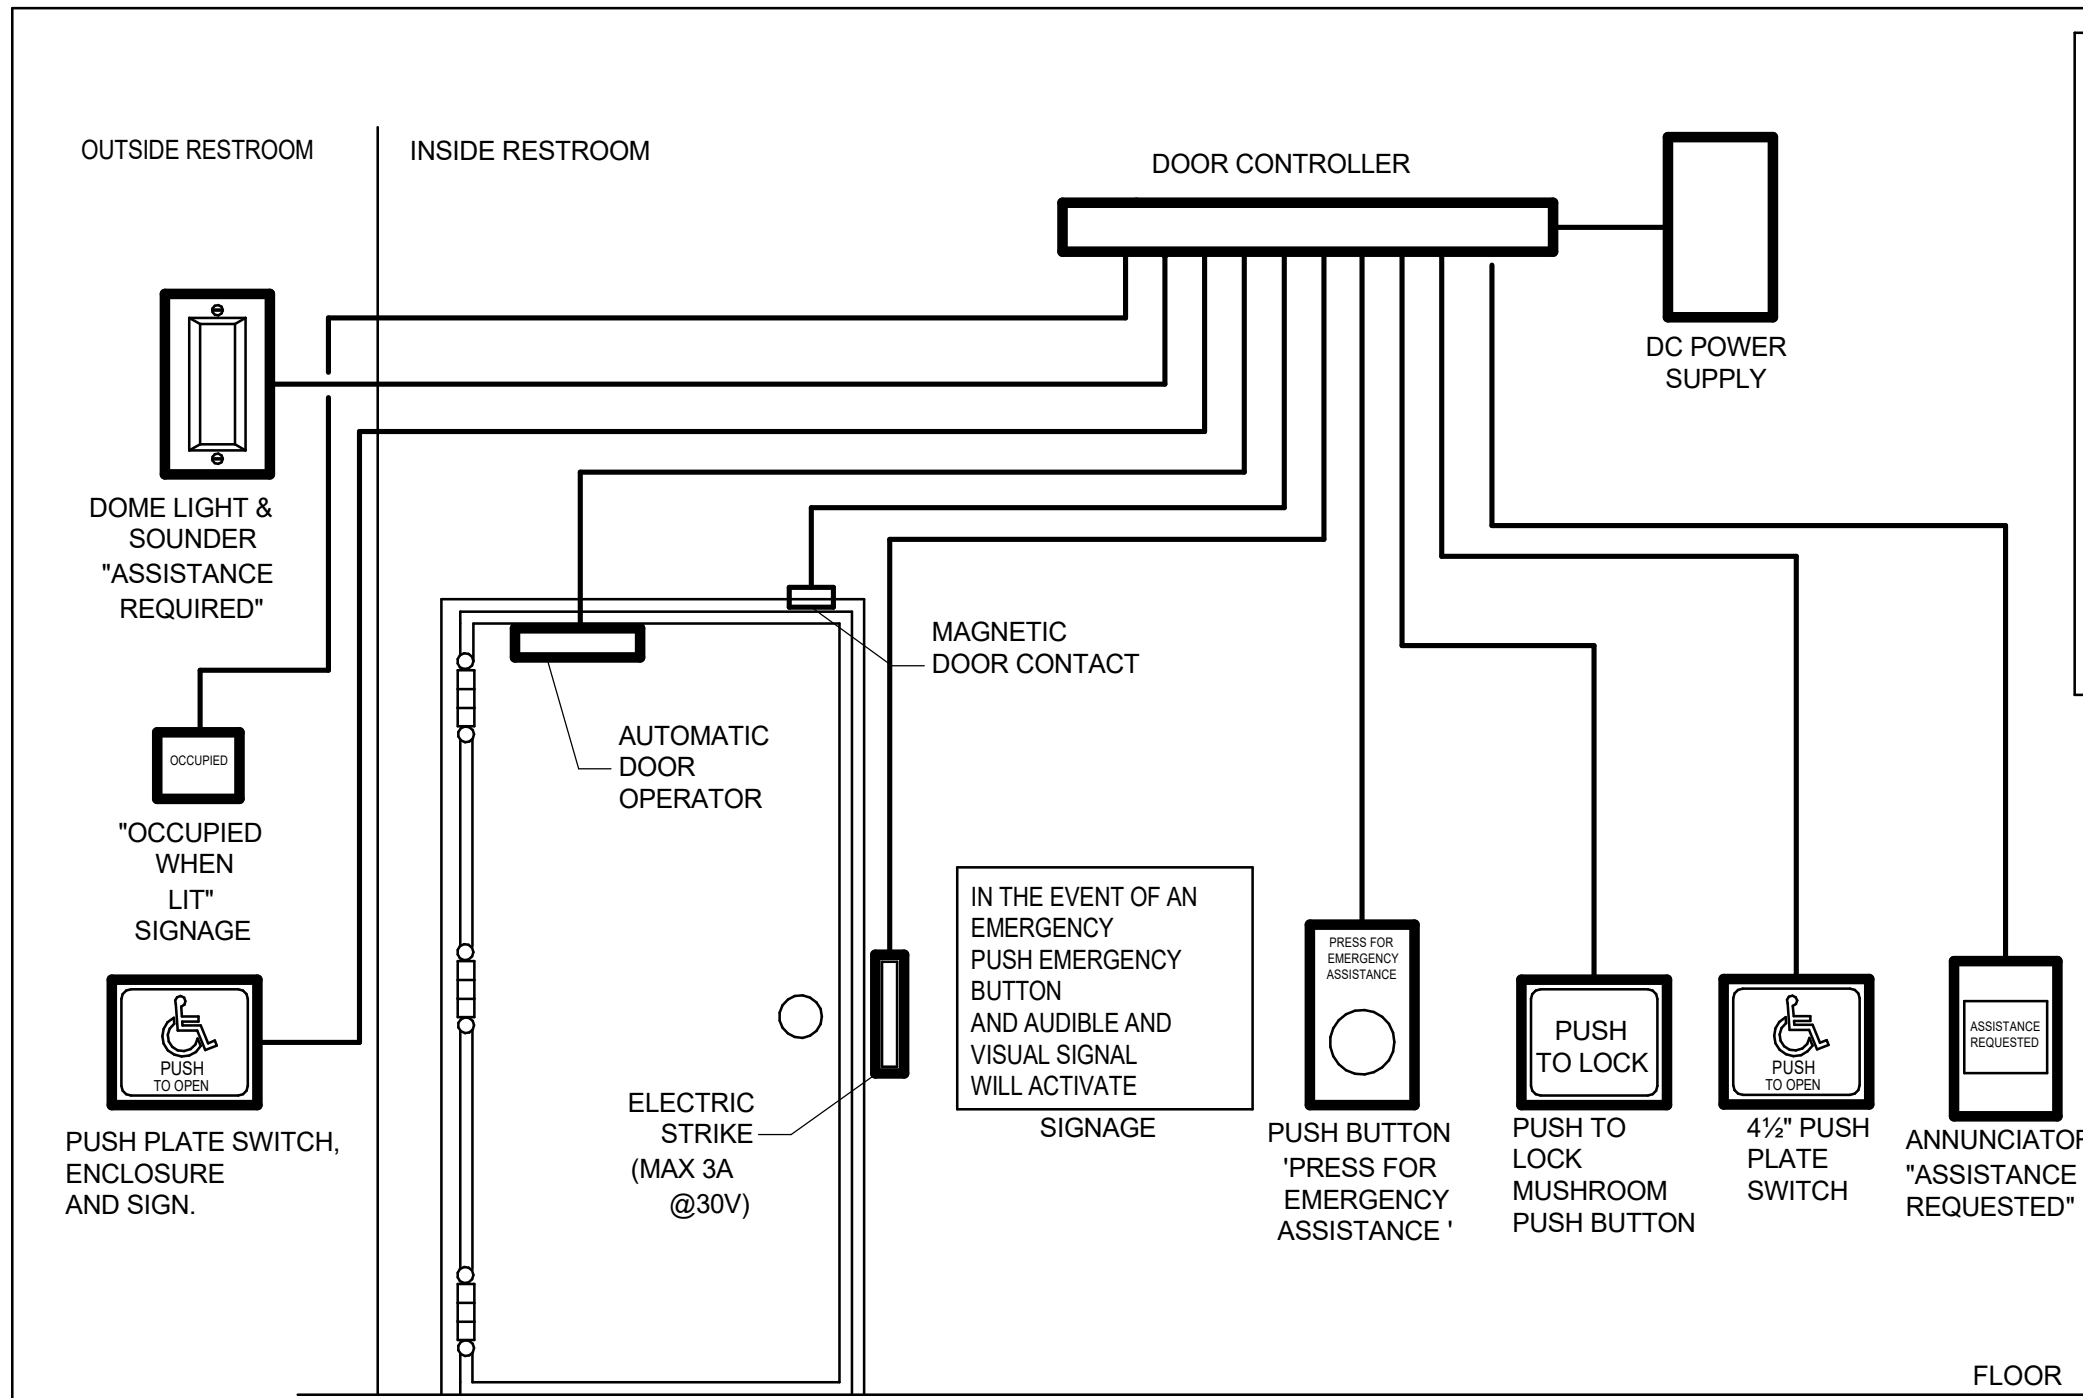

- NOTES**
1. PROVIDE EMERGENCY CALL SYSTEM EQUIPMENT. PROVIDE EMPTY CONDUITS ONLY. COMPLETE WITH PULL STRINGS.
 2. BACK BOXES AND CONDUITS SHALL BE ACCORDING TO APPROVED SHOP DRAWINGS. CONDUITS SHALL BE EMT, MINIMUM SIZE 21mm DIA. CONTRACTOR TO COORDINATE.
 3. LOCATIONS OF DEVICES SHALL BE ACCORDING TO ARCHITECTURAL DRAWINGS. VERIFY EXACT LOCATION WITH THE ARCHITECT PRIOR TO ROUGHING-IN.
 4. PROVIDE DOOR OPERATOR. PROVIDE 120V CIRCUIT FOR POWER AND CONDUIT FOR CONTROL CONNECTIONS TO DOOR CONTROLLER AS REQUIRED.
 5. PROVIDE ELECTRIC STRIKE AND CONDUIT FOR CONNECTION TO DOOR CONTROLLER AS REQUIRED.

- SEQUENCE OF OPERATION:**
1. UPON PRESSING THE EXTERIOR PUSH PLATE, THE DOOR SHALL OPEN.
 2. AFTER ENTRY, THE OCCUPANT SHALL PRESS THE "PUSH TO LOCK" PUSH PLATE, AND LOCK THE DOOR VIA ELECTRIC STRIKE. THE EXTERNAL SIGNAGE WILL BE IN THE "OCCUPIED" STATE. PRESSING THE EXTERIOR PUSH PLATE WILL NOT HAVE ANY EFFECT.
 3. THE OCCUPANT WILL EXIT BY PRESSING THE INTERIOR UNIVERSAL SYMBOL FOR ACCESSIBILITY, WHICH WILL UNLOCK THE STRIKE, ACTIVATE THE DOOR OPERATOR AND AND RESET THE EXTERIOR SIGNAGE TO ITS "UNOCCUPIED" STATE. SIMILARLY, THE OCCUPANT MIGHT TURN THE DOOR HANDLE, AND OPEN THE DOOR. THE MAGNETIC DOOR CONTACT WILL REGISTER THIS AS A DOOR OPEN STATUS, AND RESET THE EXTERIOR SIGNAGE TO ITS "UNOCCUPIED" STATE AND RELEASE THE ELECTRIC STRIKE.
- IF THE EMERGENCY 'PUSH/PULL' MUSHROOM IS DEPRESSED, THE EXTERIOR DOME LIGHT AND SOUNDER WILL ACTIVATE IN CONJUNCTION WITH THE INTERIOR ANNUNCIATOR AND SOUNDER. AT THE SAME TIME, THE DOOR STRIKE WILL RELEASE AND RESET THE EXTERIOR SIGNAGE TO ITS "UNOCCUPIED" STATE
4. THE INTERIOR AND EXTERIOR REQUEST FOR EMERGENCY ASSISTANCE AUDIBLE AND VISUAL SIGNAL DEVICES WILL DEACTIVATE UPON RELEASE (PULL) OF THE MUSHROOM PUSHBUTTON. THE DOOR STRIKE WILL REMAIN UNLOCKED AND THE EXTERIOR SIGNAGE WILL BE IN ITS "UNOCCUPIED" STATE.

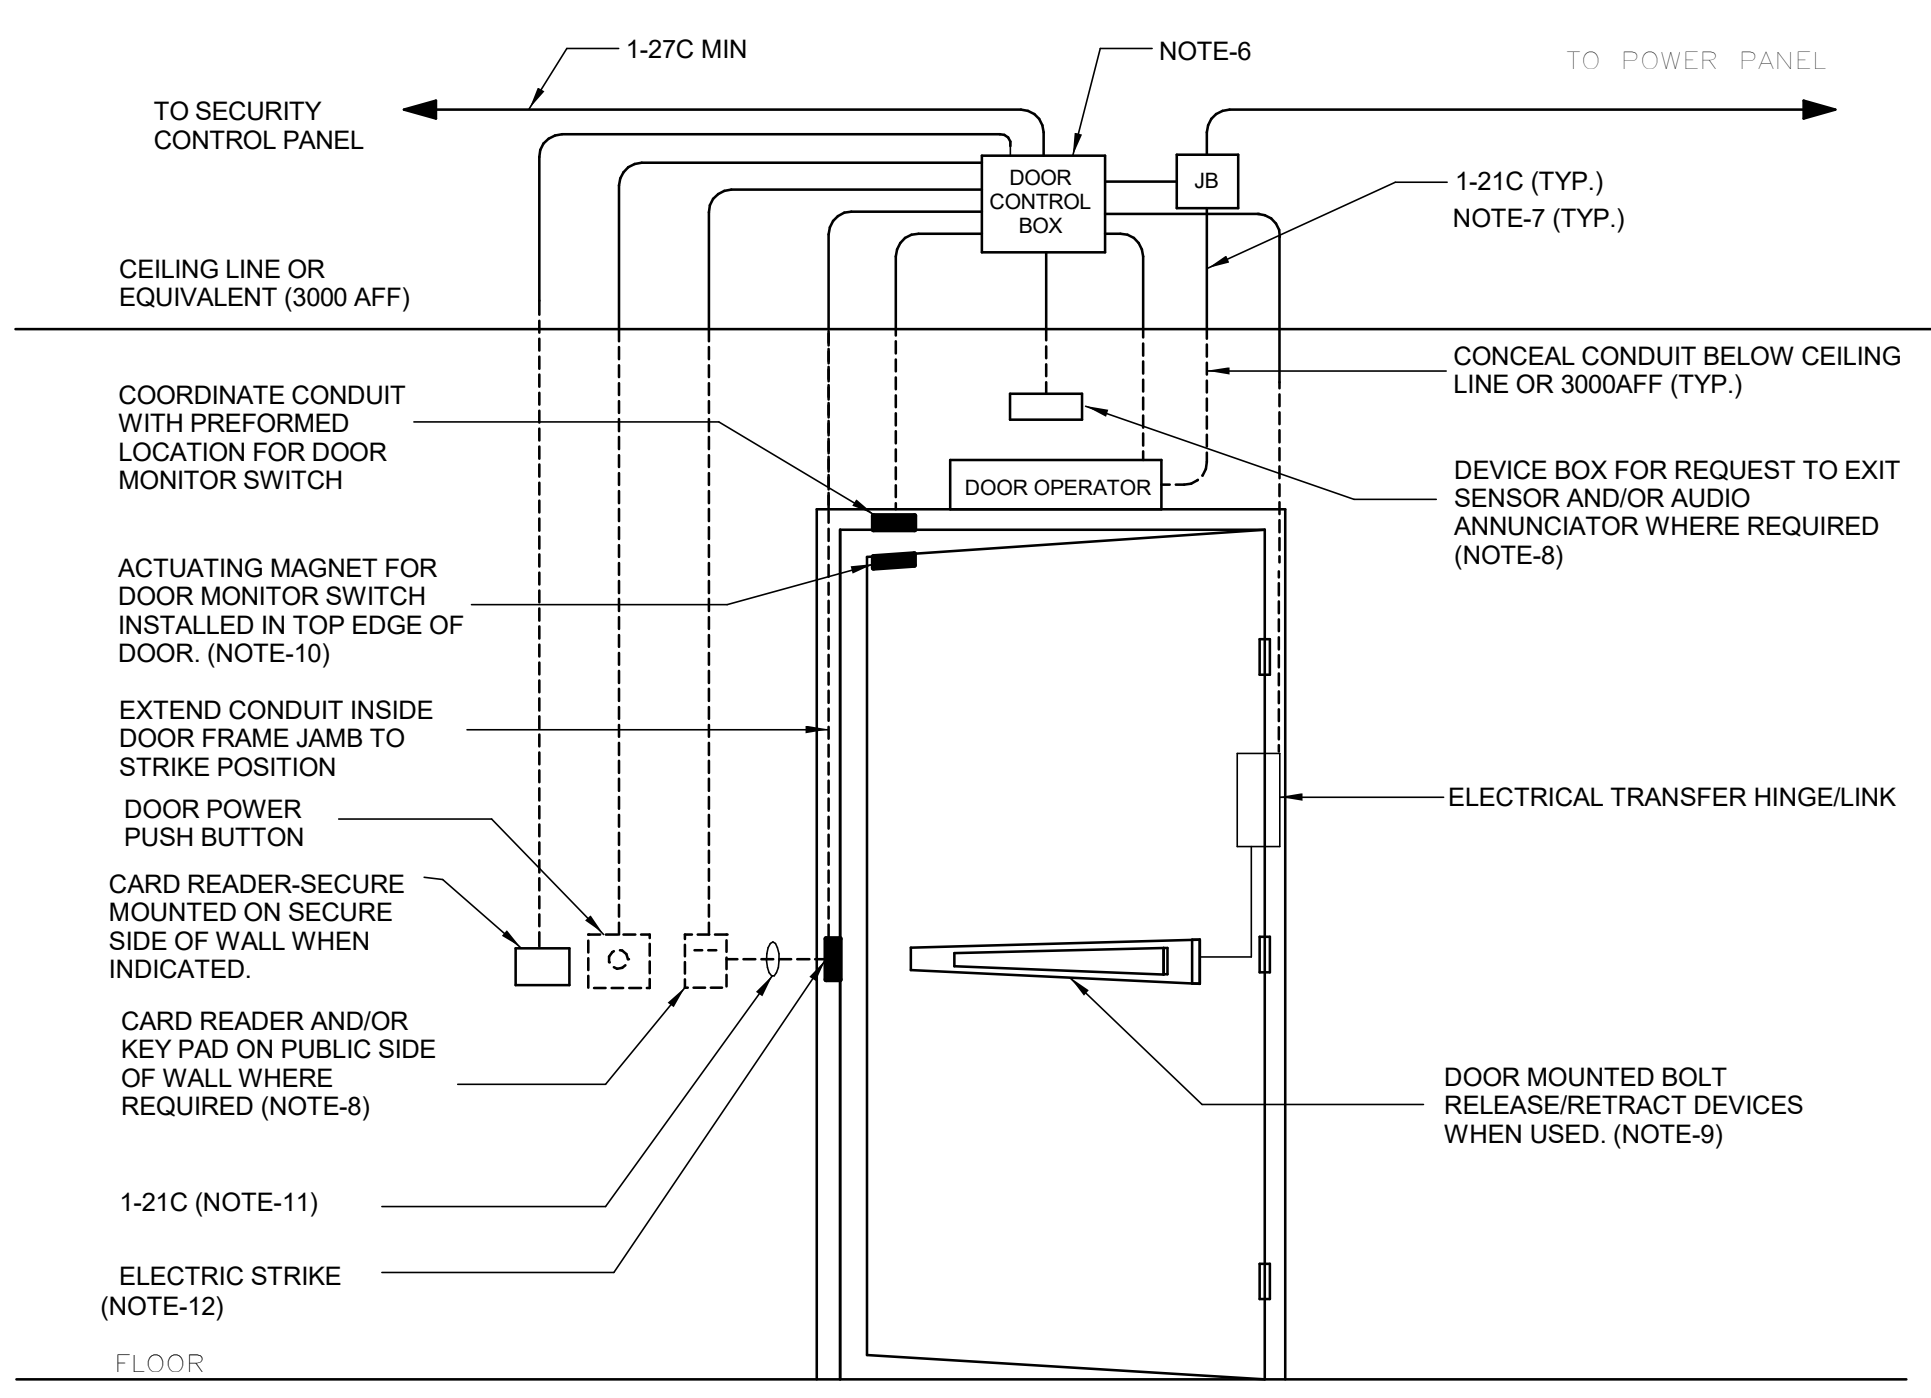

- NOTES:**
1. THIS CONSTRUCTION DETAIL IS FOR SCHEMATIC PURPOSE ONLY, REFER TO POWER AND SECURITY LAYOUT DRAWINGS AND DOOR HARDWARE SCHEDULE FOR EXACT COMPONENTS REQUIRED AND CONDUIT ROUTING.
 2. ALL CONDUITS WITH PULL STRING, JUNCTION BOXES, PULL BOXES, DEVICE BOXES AND POWER WIRES BY DIV.26.
 3. SECURITY DOOR CONTROLLER, CARD READER, ALARM BUZZER, KEYPAD, REQUEST TO EXIT SENSOR AND SECURITY WIRES BY SECURITY VENDER WHERE REQUIRED.
 4. POWER SUPPLY, DOOR OPERATOR/CONTROLLER, DOOR POWER PUSH BUTTON, ELECTRIC STRIKE/BOLT/LATCH, DOOR CONTACT (MONITOR SWITCH), BY DOOR HARDWARE CONTRACTOR WHERE REQUIRED.
 5. PROVIDE CONTINUOUS ELECTRICAL RACEWAY CONSISTING OF CONDUIT AND/OR CABLE TRAY. NO FREE AIR RUNNING SECURITY CABLE.
 6. JUNCTION BOX SIZED TO ACCOMMODATE LOCAL DOOR CONTROL SYSTEM; MIN. 300x300x150 WITH REMOVABLE AND TAMPER RESISTANT COVER; SURFACE MOUNTED FOR SOLID WALL CONSTRUCTION. SAME WITH 100x100x54 DEVICE BOX WITH 38MM EXTENSION RING TO DEPTH OF 92MM. FLUSH MOUNT FOR CAVITY OR BLOCK WALL CONSTRUCTION. USE COMMON CONDUIT, PULL BOXES AND JUNCTION BOXES FOR INTRUSION DETECTION AND ACCESS CONTROL WIRING.
 7. USE JUNCTION BOX AT CORNER FOR BLOCK WALL CONSTRUCTION. CONCEAL VERTICAL CONDUIT. SURFACE MOUNT HORIZONTAL CONDUIT ON SOLID WALL ONLY
 8. DEVICE BOX. MOUNTED FLUSH WITH SURFACE. PROVIDE SINGLE DEVICE COVER PLASTER RING FOR CAVITY OR BLOCK WALL CONSTRUCTION. REFER TO LAYOUT DRAWING FOR LOCATION. COORDINATE WITH DOOR HARDWARE SCHEDULE FOR EXACT SIZE. DISPENSE WITH WALL BOX WHEN MULLION MOUNT IS INDICATED IN THE DOOR HARDWARE SCHEDULE.
 9. BOLT RELEASE/RETRACT DEVICE MAY BE PUSH-BAR OR LEVER TYPE. USE TYPE INDICATED IN DOOR HARDWARE SCHEDULE.
 10. WHERE DOOR PERFORMANCE REQUIREMENTS CALL FOR INTRUSION DETECTION AND ACCESS CONTROL, USE MAY BE MADE OF 2 SEPARATE SINGLE POLE SWITCHES OR ONE COMMON 2 POLE SWITCH. MAINTAIN SEPARATION BETWEEN WIRING OF TWO SYSTEMS.
 11. USE OF BRIDGING CONDUIT ACCEPTABLE FOR CAVITY OR BLOCK WALL CONSTRUCTION WHERE SITE CONDITIONS PERMIT.
 12. OMIT WHEN ELECTRIC LATCH IS USED.
 13. ENSURE THAT WHEN CREDENTIAL IS NOT PRESENTED AND DOOR PUSH BUTTON IS TRIGGERED THAT MOTOR DOES NOT ENGAGE. SEQUENCE OF OPERATION IS TO PRESENT CREDENTIAL -> ACTIVATE DOOR OPERATOR PUSH BUTTON

2 SECURITY SINGLE DOOR DETAIL - POWER OPERATED

1 UNIVERSAL WASHROOM DETAIL

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ISSUES

No.	DESCRIPTION	DATE
A	50% SUBMISSION	2022-04-27
B	90% SUBMISSION	2022-07-29
C	ISSUED FOR PERMIT	2022-07-29
D	ISSUED FOR TENDER	2025-04-11

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PRIME CONSULTANT
ARCADIS
100 - 175 Galaxy Blvd,
Toronto, ON M9W 0C9, Canada
tel 416 679 1930
www.arcadis.com

PROJECT TITLE
**CITY OF TORONTO
ACCESSIBILITY UPGRADES**

PROJECT ADDRESS

PROJECT NO:
9119- 19- 0162 / Arcadis 30279056
DRAWN BY:
V. MAC
PROJECT MGR:
N. FRISCH
CHECKED BY:
M. BOJIC
APPROVED BY:
P. WILLIAMS

SHEET TITLE
ELECTRICAL DETAILS 1

SHEET NUMBER
D4001
ISSUE
D

MOUNTING HEIGHTS SCHEDULE		
MOUNTING HEIGHTS TO TOP OF DEVICE.		
ALL DIMENSIONS ARE ABOVE FINISHED FLOOR (AFF) UNLESS NOTED OTHERWISE.		
LIGHT SWITCH	1050mm	
RECEPTACLE - FINISHED AREAS	460mm	
RECEPTACLE - UNFINISHED AREAS	1050mm	
RECEPTACLE - ABOVE COUNTER	300mm	ABOVE COUNTER
DATA OUTLET - FINISHED AREA	460mm	
DATA OUTLET - UNFINISHED AREA	1050mm	
FIRE ALARM MANUAL PULL STATION	1200mm	
FIRE ALARM HORN/STROBE	2460mm	
FIRE ALARM STROBE	2460mm	
FIRE ALARM END OF LINE DEVICE	1500mm	
FIRE ALARM HEAT DETECTOR	CEILING	
FIRE ALARM SMOKE DETECTOR	CEILING	
FIRE ALARM REMOTE ANNUNCIATOR	2000mm	
PANEL	2000mm	
CONTROL PANEL	2000mm	
MOTOR STARTER	1800mm	
DISCONNECT SWITCH	1800mm	
PUSH BUTTON STATION	1050mm	
DOOR ACCESS CONTROL CARD READER	1050mm	
VIDEO INTERCOM		AS PER MANUF. INSTRUCTION
DOOR BY-PASS KEYED SWITCH	1050mm	
BATTERY OPERATED EMERGENCY LIGHT	2700mm	
EMERGENCY LIGHT BATTERY UNIT	2700mm	
THERMOSTAT	1200mm	
MOUNTING HEIGHTS AS APPLICABLE		

1. PROVIDE 1-#6 GND WIRE FOR ALL UNDERGROUND EMPTCY CONDUITS AND COMMUNICATIONS CONDUITS WITHOUT METAL WIRING/CABLES TO FACILITATE FUTURE DEDICATION.
2. NO SPLICES ARE ALLOWED FOR COMMUNICATION CABLES.
3. NO SPLICES ARE ALLOWED BELOW GRADE FOR POWER WIRE AND CABLE.
4. THERE MUST BE A BREAK IN ALL UNDERGROUND CONDUITS OUTSIDE THE BUILDING/TOWERS/ELECTRICAL/COMMUNICATIONS/BOILER ROOM TO ALLOW DRAINAGE OF RACEWAY BEFORE ENTERING THE ROOMS.
5. PROVIDE LAYOUT (WITH DIMENSIONS) OF ALL UNDERGROUND PULL POINTS INCLUDING HAND HOLES, MAN HOLES AND CONCRETE PULL BOXES TO THE CONSULTANT FOR APPROVAL PRIOR TO INSTALLATION.
6. INSTALL HAND HOLES AWAY FROM MAJOR TRAFFIC AREAS (TYPICAL).
7. PROVIDE HEAT TRACING PROTECTION FOR WATER PIPES, STORM PIPES AND SANITARY PIPES AS SHOWN ON ELECTRICAL DRAWINGS. REFER TO MECHANICAL DRAWINGS FOR PIPING LAYOUT. HEAT TRACING SHALL BE RAYCHEM MODEL 48XL-TRACE, 208V, 1PH, SELF REGULATING TRACING CABLE OR APPROVED EQUIVALENT, C/W POWER SUPPLY MODULE, THERMOSTAT AND ALL ACCESSORIES FOR A COMPLETE AND FUNCTIONING SYSTEM. STARTUP TEMPERATURE -29°C (-20°F).
8. WHERE CONDUITS ARE INSTALLED ACROSS EXPANSION JOINTS, PROVIDE CONDUITS WITH EXPANSION/CONTRACTION FITTINGS.
9. ELEVATOR FIRE ALARM AUTOMATIC RECALL:
ELEVATOR LOBBY MOUNTED FIRE DETECTORS AND SECURITY PANEL TO RECALL ELEVATORS TO DESIGNATED LEVEL UPON FIRE ALARM. SHOULD DETECTOR AT DESIGNATED LEVEL, ELEVATOR LOBBY INDICATE FIRE, ELEVATOR TO BE DIRECTED TO ALTERNATE LEVEL. REFER TO ELEVATOR AUTOMATIC FIRE RECALL SCHEDULE. ELEVATOR CONTRACTOR TO COORDINATE WITH TSSA AND CONFIRM DESIGNATED/ALTERNATE LEVELS.
10. SMOKE DETECTOR AT TOP OF ELEVATOR SHAFT TO BE AIR SAMPLING SMOKE DETECTOR TYPE. INSTALL CONTROL UNIT IN A TAMPER PROOF ENCLOSURE (NEMA 4X) OUTSIDE OF ELEVATOR CLOSET. AIR SAMPLING SMOKE DETECTOR TO BE EST READY SET BY EDWARDS OR APPROVED EQUAL.
11. SITE PLAN DRAWINGS INCLUDING UNDERGROUND POWER CONDUITS AND CORRESPONDING PULL POINTS FOR CONCRETE PULL BOXES OR HAND HOLES (WHERE OEC REQUIRES ADDITIONAL PULL POINTS FOR WIRING SEPARATION, PROVIDE ADDITIONAL CONCRETE PULL BOX (OR HAND HOLE) AS REQUIRED. IF AN ADDITIONAL MAN HOLE IS REQUIRED, IT IS PREFERRED TO PROVIDE AN ADDITIONAL HAND HOLE OR CONCRETE PULL BOX IF POSSIBLE.

CITY OF TORONTO
 **Toronto**
Corporate Real Estate Management
Project Management Office
Metro Hall Toronto, ON
M5V 3C6

Arcadis Professional Services (Canada) Inc

No.	DESCRIPTION	DATE
A	50% SUBMISSION	2022-01-20
B	90% SUBMISSION	2022-02-22
C	ISSUED FOR PERMIT	2022-03-18
D	ISSUED FOR TENDER	2025-04-11

SEAL



PROJECT TITLE
CITY OF TORONTO
ACCESSIBILITY UPGRADES

PROJECT NO:
9119- 19- 0162 / Arcadis 30279056

DRAWN BY: V. MAC	CHECKED BY: M. BOJIC
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PROJECT MGR: F. BOLOURIAN	APPROVED BY: P. WILLIAMS
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SHEET TITLE
ELECTRICAL GENERAL
NOTES

SHEET NUMBER
G05-G4003

ISSUE

CITY OF TORONTO

ACCESSIBILITY UPGRADES

TOUCH AND FEEL INDEX	
SHEET #	SHEET TITLE
T00	COVER PAGE
T01	WASHROOM
T02	WASHROOM ACCESSORIES
T02.1	WASHROOM ACCESSORIES
T03	WASHROOM FIXTURES & DRINKING FOUNTAIN
T04	KITCHEN MATERIALS AND FIXTURES
T05	RESERVED
T06	TACTILE ATTENTION INDICATORS
T07	TEXTURAL & COLOUR CONTRAST WARNING STRIP AND NOSING
T08	DOOR THRESHOLDS



CITY OF
TORONTO
ACCESSIBILITY
UPGRADES



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tel 416 679 1930
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TOUCH AND FEEL

INTERIOR FIXTURES AND MATERIALS

TOUCH-AND-FEEL DOCUMENT SHOULD BE READ IN CONJUNCTION WITH
DRAWINGS AND SPECIFICATIONS


Project Number: 9119- 19- 0162 / Arcadis 30279056

Date: 2025-04-11

WASHROOM FINISHES	
WASHROOM / SHOWER WALLS	COLLECTION: COLOUR & DIMENSION
CWT-1	COLOUR: ARCTIC WHITE MATTE
	SIZE: 100mm X 400mm (4"X16")
	SUPPLIER: OLYMPIA
WASHROOM / SHOWER WALL ACCENT	MATCH EXISTING
CWT-2	TILE SIZE IS INDICATED ON ROOM FINISH SCHEDULE
WASHROOM / SHOWER WALL ACCENT	COLLECTION: COLOUR & DIMENSION
CWT-3	COLOUR: TAUPE, MATTE
	SIZE: 100mm X 400mm (4"X16")
	SUPPLIER: OLYMPIA
WASHROOM / SHOWER WALL ACCENT	COLLECTION: COLOUR & DIMENSION
CWT-4	COLOUR: DARK GREY MATTE
	SIZE: 100mm X 400mm (4"X16")
	SUPPLIER: OLYMPIA
FLOORS	COLLECTION: MICA, MATTE FINISH
PFT-1	SIZE: 300mm X 600mm (12"X24")
	MEETS DYNAMIC COEFFICIENT OF FRICTION
	PREFERRED SUPPLIER: D9 / EMOTION
SHOWER FLOORS	COLLECTION: STI MOSAICO
PFT-2	COLOUR: MID GREY UNGLAZ
	SIZE: 50mm X 50mm (2"X2")
	MEETS DYNAMIC COEFFICIENT OF FRICTION
	SUPPLIER: STONE TILE
FLOORS	MATCH EXISTING
PFT-3	TILE SIZE IS INDICATED ON ROOM FINISH SCHEDULE
FLOORS	COLLECTION: CORE COLLECTION TERRA
PFT-4	COLOUR: 200 SMOOTH (V)
	SIZE: 304.8mm X 609.6mm (12"X24")
	MEETS DYNAMIC COEFFICIENT OF FRICTION
	SUPPLIER: MOSA TILE

NOTE: THE FINISHES PRESENTED ON THIS PAGE ARE THE BASIS OF DESIGN - ANY ALTERNATES ARE SUBJECT TO APPROVAL BY CITY OF TORONTO, PROJECT MANAGER, FACILITY MANAGER AND STAKEHOLDERS

FOR WASHROOMS WHERE ALL FIXTURES AND WALLS ARE BEING REMOVED ONLY

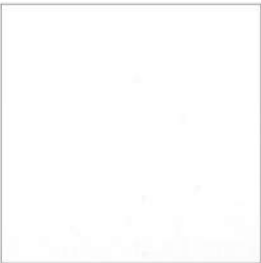

CWT-1



CWT-3



CWT-4




PFT-1



PFT-2



PFT-4

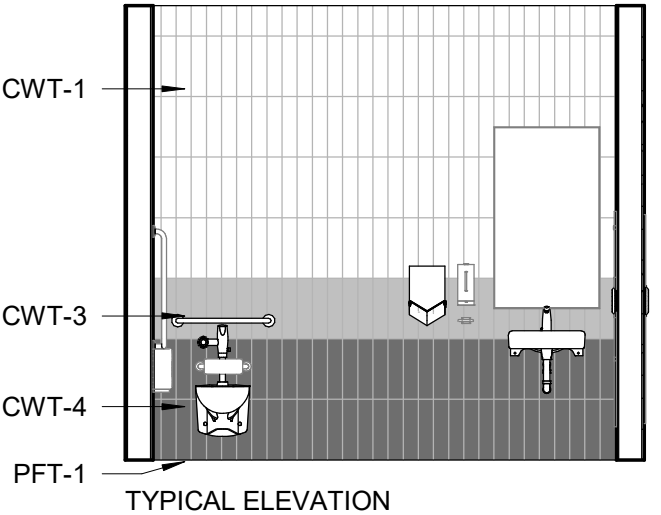

PICTURE 1



PICTURE 2

NOTE: PICTURES ARE ONLY FOR ILLUSTRATION PURPOSES



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tel 416 679 1930
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CITY OF TORONTO
ACCESSIBILITY UPGRADES
CITY OF TORONTO
ACCESSIBILITY UPGRADES

DRAWING TITLE:

WASHROOM

Project No: 9119- 19- 0162 / Arcadis 30279056

Date: 2025-04-11

Issue: ISSUED FOR TENDER

NO.


T01

 SHELF: SHLF GAMCO MS-18 STAINLESS STEEL MIRROR SHELF – 18"	 SOAP DISH: SDI-1 RECESSED MOUNTED SOAP DISH, HEAVY DUTY STAIN FINISH STAINLESS STEEL. BRADLEY MODEL NO. SA16	 SOAP DISPENSER: SD-1 WALL MOUNTED, AUTOMATIC STAINLESS STEEL WITH STAIN FINISH, CLEAR ACRYLIC REFILL INDICATOR WINDOW AND KEY LOCK. BRADLEY 6A00-11.	 L-SHAPED GRAB: GRB-1 SATIN FINISH WITH PEENED GRIPPING SURFACE; 18-GAUGE (1.2MM) STAINLESS STEEL TUBING WITH SATIN-FINISH. 38MM OUTSIDE DIAMETER. ENDS ARE HELIARC WELDED TO FLANGES. CLEARANCE BETWEEN THE GRAB BAR AND WALL IS 38MM. 30" X 30" 762MM X 762MM)	 L-SHAPED GRAB: GRB-2 SATIN FINISH WITH PEENED GRIPPING SURFACE; 18-GAUGE (1.2MM) STAINLESS STEEL TUBING WITH SATIN-FINISH. 38MM OUTSIDE DIAMETER. ENDS ARE HELIARC WELDED TO FLANGES. CLEARANCE BETWEEN THE GRAB BAR AND WALL IS 38MM. 40" X 30" (1016MM X 762MM)
	 SOAP DISH: SDI-2 SURFACE MOUNTED, STAINLESS STEEL, TYPE 304 FLANGE. BRADLEY MODEL NO. 901	 SOAP DISPENSER: SD-2 COUNTER MOUNTED, TOUCH FREE, ONE PIECE, CAST BRASS CONSTRUCTION ABOVE DECK, SINGLE MOUNT FOAM SOAP DISPENSER WITH ADJUSTABLE SENSOR. MOEN, MODEL NO. 8560		
COAT HOOK: CTH-1 B-983 STAINLESS STEEL, 14- GAUGE AUTO-RELEASE CLOTHES HOOK WITH EXPOSED STAIN FINISH, FACEPLATE WITH SLOPED EDGES. 	 HAND DRYER: HNDR DYSON SPRAYED NICKEL 307174-01, NET WEIGHT: 2.9 KG / 6.17 LBS. H:39.3CM X W:19CM X D:10CM			
COAT HOOK: CTH-2 B-2116 12-GAUGE (2.7mm) CASE HARDENED STEEL. ONE PIECE BRASS CASTING WITH SATIN NICKEL-PLATED FINISH 				
 TOILET TISSUE DISPENSER: TPD SURFACE-MOUNTED TWIN JUMBO-ROLL B-2892: 18-8, TYPE-304, 20-GAUGE (1.0MM) STAINLESS STEEL WITH SATIN- FINISH. EQUIPPED WITH A TUMBLER LOCK KEYED LIKE OTHER BOBRICK WASHROOM ACCESSORIES.	 MIRROR: MIR 6 MM" FLOAT GLASS, SELECTED FOR SILVERING, ELECTROLYTICALLY COPPER-PLATED BY GALVANIC PROCESS FURNISH UNITS IN TYPE 430 STAINLESS STEEL FRAMING	GRAB BAR: GRB-3 SATIN FINISH WITH PEENED GRIPPING SURFACE; 18-GAUGE (1.2MM) STAINLESS STEEL TUBING WITH SATIN-FINISH. 38MM OUTSIDE DIAMETER. ENDS ARE HELIARC WELDED TO FLANGES. CLEARANCE BETWEEN THE GRAB BAR AND WALL IS 38MM. 30" (762MM)	GRAB BAR: GRB-4 SATIN FINISH WITH PEENED GRIPPING SURFACE; 18-GAUGE (1.2MM) STAINLESS STEEL TUBING WITH SATIN-FINISH. 38MM OUTSIDE DIAMETER. ENDS ARE HELIARC WELDED TO FLANGES. CLEARANCE BETWEEN THE GRAB BAR AND WALL IS 38MM. 36" (914MM)	GRAB BAR: GRB-5 SATIN FINISH WITH PEENED GRIPPING SURFACE; 18-GAUGE (1.2MM) STAINLESS STEEL TUBING WITH SATIN-FINISH. 38MM OUTSIDE DIAMETER. ENDS ARE HELIARC WELDED TO FLANGES. CLEARANCE BETWEEN THE GRAB BAR AND WALL IS 38MM. 40" (1016MM)


			
<p>PAPER TOWEL DISPENSER & WASTE RECEPTACLE: PTD/WR (SR) <u>SEMI-RECESSED</u> B-38032: 18-8, TYPE 304, HEAVY-GAUGE STAINLESS STEEL. ALL-WELDED CONSTRUCTION.</p>	<p>PAPER TOWEL DISPENSER AND WASTE RECEPTACLE: PTD/WR (R) <u>RECESSED CONVERTIBLE</u> B-3940: 18-8, TYPE 304, HEAVY-GAUGE STAINLESS STEEL. EXPOSED SURFACES HAVE STAIN-FINISH.</p>	<p>PAPER TOWEL DISPENSER AND WASTE RECEPTACLE: PTD/WR (S) <u>SURFACE-MOUNTED</u> B-3699: 18-8, TYPE 304, 22-GAUGE (0.8mm) STAINLESS STEEL. ALL-WELDED CONSTRUCTION. EXPOSED SURFACES HAVE STAIN-FINISH.</p>	
			
<p>PAPER TOWEL DISPENSER: PTD (S) <u>SURFACE MOUNTED</u> B-2974: TYPE 304, 18 GUAGE STAINLESS STEEL. ALL-WELDED CONSTRUCTION.</p>	<p>PAPER TOWEL DISPENSER: PTD (R) <u>RECESSED</u> B-35903: TYPE 304, HEAVY-GAUGE STAINLESS STEEL. ALL-WELDED CONSTRUCTION. EXPOSED SURFACES HAVE STAIN-FINISH.</p>		

					<div>DRINKING FOUNTAIN</div> 	
<p>WALL MOUNTED SINK: (BARRIER FREE USE) L1H DECORUM WALL HUNG LAVATORY WITH EVERCLEAN 9024.001EC.020 - VITREOUS CHINA, WHITE FINISH, WITH SINGLE FAUCET HOLE AND OVERFLOW</p>	<p>COUNTER-MOUNTED SINK: L1 WHITE, SELF-RIMMING, REAR/FRONT OVERFLOW, DRILLED FOR 100 MM SUPPLY FITTING. AMERICAN STANDARD "AQUALYN" #0475.047.020 518 X 441 MM</p>	<p>COUNTER-MOUNTED SINK: (BARRIER FREE USE) L2H WHITE, FOR BARRIER FREE USE, SELF-RIMMING WITH SEALANT, OVERFLOW, DRILLED FOR 100 MM SUPPLY FITTING. AMERICAN STANDARD "AQUALYN" #0475.047.020 518 X 441 MM</p>	<p>WALL MOUNTED SINK C/O WITH SHROUD: (BARRIER FREE USE) L3H DECORUM WALL HUNG LAVATORY WITH EVERCLEAN NO. 9134.001EC/0059.020EC SHROUD - VITREOUS CHINA, WHITE FINISH, WITH SINGLE FAUCET HOLE AND OVERFLOW</p>	<p>UNDER-MOUNTED SINK: (BARRIER FREE USE) L4H WHITE, FOR BARRIER FREE USE WITH REAR OVERFLOW AND UNDERMOUNT CLIPS AMERICAN STANDARD OVALYN UNICERSAL ACCESS 9482.000 489 X 400MM</p>	<p>DRINKING FOUNTAIN: DF EZSDWSLK GALVANIZED STEEL WALL MOUNTED, WHEELCHAIR TYPE WATER COOLER WITH STAINLESS STEEL TOP, FRONT AND SIDE MOUNTED PUSH TO OPERATE LEVER(S), SENSOR, TOUCHLESS ACTIVATION WITH AUTO SHUT OFF BOTTLE FILLER, FLEXI-GUARD SAFETY BUBBLER, AND TRAP PACKAGE.</p>	
<p>FAUCET: TO BE USED WITH ALL LAVATORY TYPES MOEN ALIGN SENSOR FAUCET - 8559 ELECTRONIC 'NO-TOUCH' HARDWIRED POWERED FAUCET</p>						
						
<p>TOILET: W1H <u>WALL HUNG</u> - WHITE FINISH - VITREOUS CHINA WITH EVERCLEAN ANTIMICROBIAL SURFACE. NO. 3351.101.002</p>	<p>TOILET: W2H <u>FLOOR MOUNTED</u> WHITE FINISH - VITREOUS CHINA WITH EVERCLEAN ANTIMICROBIAL SURFACE. NO. 3461.001.020</p>	<p>TOILET WITH TANK: W3H <u>FLOOR MOUNTED</u> WHITE FINISH - VITREOUS CHINA WITH EVERCLEAN ANTIMICROBIAL SURFACE. PA TANK, 1.1 GPF WHITE</p>		<p>URINAL: U1H WALL HUNG 6590.001.020 - WASHBROOK FLOWISE - EXTENDED SIDES FOR PRIVACY - WASHDOWN ACTION - FLUSHING RIM - 19 MM DIA.</p>		
<div><div>100 - 175 Galaxy Blvd, Toronto, ON M9W 0C9, Canada tel 416 679 1930 www.arcadis.com</div></div>		<div><div>CITY OF TORONTO ACCESSIBILITY UPGRADES CITY OF TORONTO ACCESSIBILITY UPGRADES</div></div>		<div>DRAWING TITLE: WASHROOM FIXTURES & DRINKING FOUNTAIN</div> <div>Project No: 9119- 19- 0162 / Arcadis 30279056</div> <div>Date: 2025-04-11</div> <div>Issue: ISSUED FOR TENDER</div>		<div>NO.</div> <div>T03</div>

ONLY WHEN ENTIRE KITCHEN MILLWORK IS TO BE REMOVED (UPPER AND LOWERS) ALL OTHER SCENARIOS, KITCHEN MILLWORK WILL MATCH EXISTING AESTHETIC

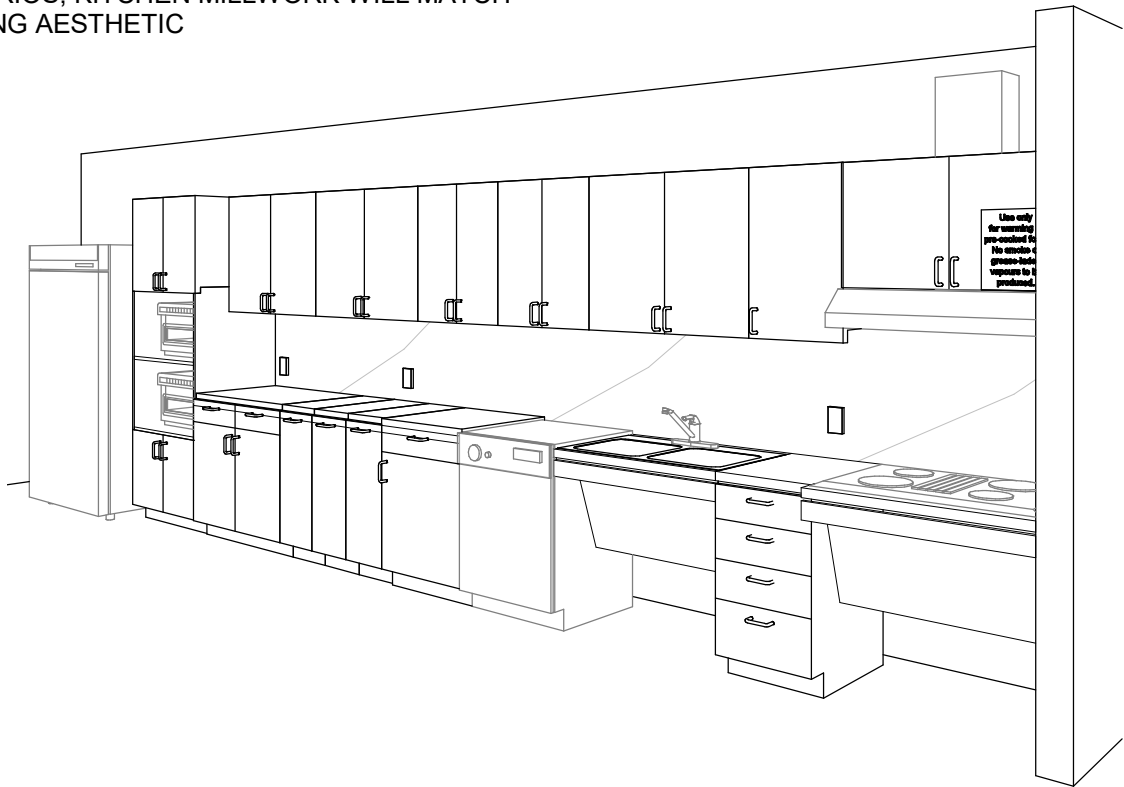

PERSPECTIVE: N.T.S

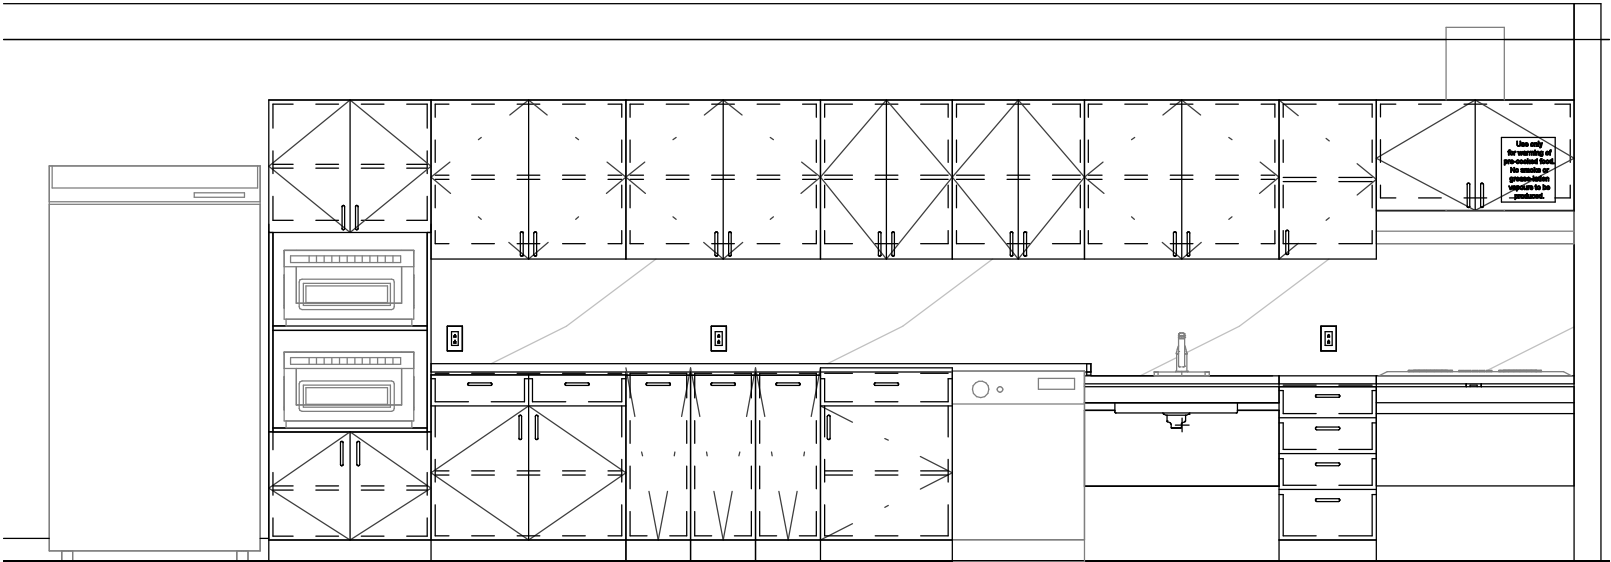

ELEVATION: N.T.S


PERSPECTIVE & ELEVATION VIEWS ARE REPRESENTATIVE ONLY - REFER TO BUILDING-SPECIFIC DRAWINGS



COUNTERTOP AND BACKSPLASH: Q-1
CAESARSTONE - QUARTZ
SUPERNATURAL COLLECTION
1111 VIVID WHITE



CABINETS: PLAM-1
PLASTIC LAMINATE
WILSONART NORTH
SEA D90

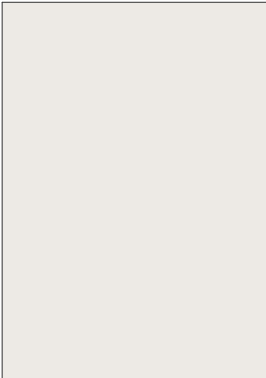

PAINT: PT-1
SHERWIN WILLIAMS SW
7004 SNOWBOUND
PAINT SHIELD EGGSHEL
SHEEN



UPPER CABINETS: PLAM-2
PLASTIC LAMINATE
WILSONART
ALABASTER D431



S1
FAUCET:
AMERICAN STANDARD NO.
7074100.00
SINK:
UCS6105P-1 SINGLE BOWL



S2
FAUCET:
AMERICAN STANDARD NO.
7074100.00
SINK:
FRANKE COMMERCIAL
UCD6405P



S3
FAUCET:
MOEN ALIGN WITH
MOTIONSENSE NO. 7565EC
SINK:
UCS6105P-1 SINGLE BOWL



S4
FAUCET:
MOEN ALIGN WITH
MOTIONSENSE NO. 7565EC
SINK:
FRANKE COMMERCIAL
UCD6405P



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DRAWING TITLE:

KITCHEN MATERIALS AND FIXTURES

Project No: 9119- 19- 0162 / Arcadis 30279056

Date: 2025-04-11

Issue: ISSUED FOR TENDER

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T04

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DRAWING TITLE:

RESERVED


Project No: 9119- 19- 0162 / Arcadis 30279056

Date: 2025-04-11

Issue: ISSUED FOR TENDER


NO.

T05

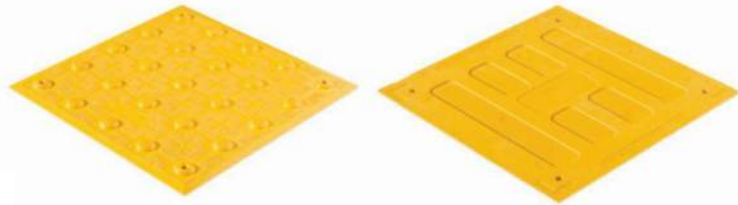


TA - 1a (SURFACE MOUNTED) INTERIOR AND EXTERIOR
TA - 1b (CAST IN PLACE) EXTERIOR
TA - 1c (SURFACE MOUNTED FIRE RATED) INTERIOR

- POLYMER, COMPOSITE TACTILE INDICATORS
- SURFACE APPLIED SUITABLE FOR INTERIOR APPLICATIONS
 - FIRE RATED TILES FOR INTERIOR APPLICATIONS HIGHER THAN 6 FLOORS
 - CAST IN PLACE SUITABLE FOR EXISTING

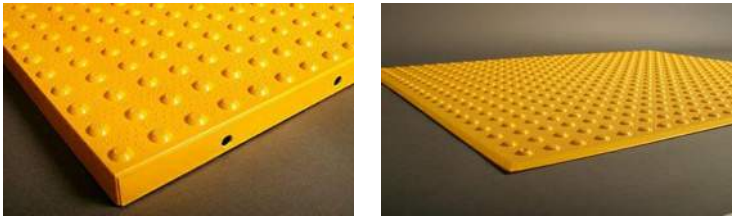

TA - 2a (SURFACE MOUNTED) INTERIOR AND EXTERIOR
TA - 2b (CAST IN PLACE) EXTERIOR


- ENGINEERED POLYMER COMPOSITE TACTILE INDICATORS
- EXTERIOR APPLICATIONS
 - FOR NEWLY CONSTRUCTED CURBS RAMPS, STAIRS, RAMPS, OR PLATFORM EDGES

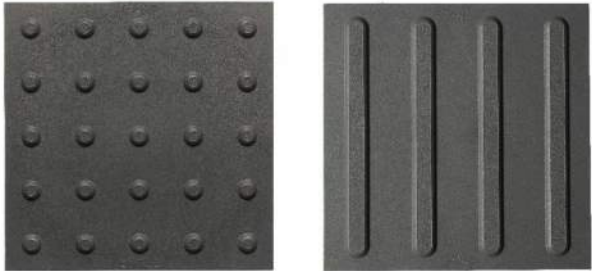

TRUNCATED DOMES WAYFINDING BARS

TA - 3


- RESILIENT POLYMER TACTILE INDICATORS
- INTERIOR OR EXTERIOR APPLICATIONS
 - TRUNCATED DOME OR WAYFINDING BAR VARIANTS.
 - FOR SKATE RINK EDGES OR USE WITH VCT FLOORING

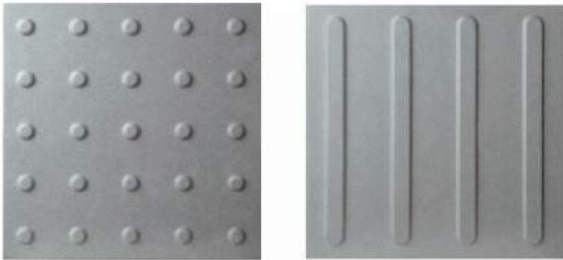

TRUNCATED DOMES WAYFINDING BARS

TA - 4

- PORCELAIN TACTILE INDICATORS
- INTERIOR OR EXTERIOR APPLICATIONS
 - TRUNCATED DOME OR WAYFINDING BAR VARIANTS.
 - FOR USE WITH PORCELAIN TILE FLOORING

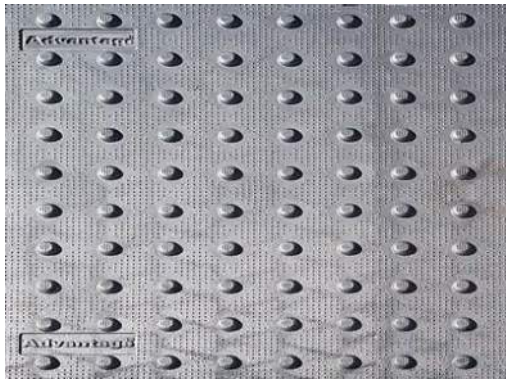

TA - 5

- CAST IRON CAST IN PLACE TACTILE INDICATORS
- EXTERIOR APPLICATION
 - HIGHLY DURABLE
 - FOR NEW CONSTRUCTION HIGH TRAFFIC AREAS



TA - 6

- INDIVIDUAL STAINLESS STEEL PLATE TACTILE INDICATORS
- INTERIOR OR EXTERIOR APPLICATIONS
 - FOR HIGH PROFILE ARCHITECTURAL SPACES WHERE AESTHETICS ARE IMPORTANT



TA - 7

- TRUNCATED DOMES:
- INDIVIDUAL STAINLESS STEEL TACTILE INDICATORS
 - INTERIOR OR EXTERIOR APPLICATIONS
 - CAN BE INSTALLED ON ALL SURFACES
 - FOR HIGH PROFILE ARCHITECTURAL SPACES WHERE AESTHETICS ARE IMPORTANT
 - TO BE USED ON NON-HERITAGE DESIGNATED STAIRS



TA - 8

- GUIDANCE BARS:
- INDIVIDUAL STAINLESS STEEL, BRASS, BRONZE OR ALUMINUM CARBORUNDUM NON-SLIP OR LINEAR GROOVE PATTERN.
 - INTERIOR APPLICATIONS
 - CAN BE INSTALLED ON ALL SURFACES
 - FOR HIGH PROFILE ARCHITECTURAL SPACES WHERE AESTHETICS ARE IMPORTANT
 - TO BE USED ON NON-HERITAGE DESIGNATED STAIRS



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DRAWING TITLE:

TACTILE ATTENTION INDICATORS

Project No: 9119- 19- 0162 / Arcadis 30279056

Date: 2025-04-11

Issue: ISSUED FOR TENDER

NO.

T06



TA - 11 INTERIOR AND EXTERIOR TEXTURAL WARNING STRIP

- AFFIXED WITH ADHESIVE AND SCREWS
- SIZES: 50.8MM X 203MM
- REFER TO DRAWINGS FOR REQUIRED LENGTH AND WIDTH




TA - 12 EXTERIOR CAST IN PLACE CONTRAST AND TEXTURAL WARNING STRIP

- DESIGNED FOR INSTALLATION ON STEP EDGES WHEN CONCRETE IS POURED.
- INSTALLED IN WET-SET CONCRETE.
- SIZES: 50.8MM X 76.2MM WIDE
- REFER TO DRAWINGS FOR REQUIRED LENGTH AND WIDTH




TA - 16 INTERIOR AND EXTERIOR USE (ON EXISTING) ON SMOOTH SURFACES STAIR NOSING FOR: TILE, CONC, WOOD, CARPET, VINYL.

- ANODIZED ALUMINUM NOSE, INSTALLED WITH EITHER NON-SLIP STRIP OR WITH PHOTOLUMINESCENT CONTRAST STRIP.
- AVAILABLE IN 5 DIFFERENT PROFILES TO MATCH THE DESIGN OF THE STEP EDGE
- AFFLICTED WITH ADHESIVE OR ADHESIVE AND SCREWS
- SIZES: 70.1MM - 78.7MM WIDE
- REFER TO DRAWINGS FOR REQUIRED LENGTH AND WIDTH

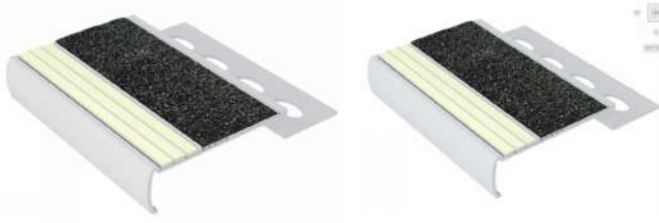

TA - 17 INTERIOR USE ON NEW TILED SURFACES. STAIR NOSING.

- ALUMINUM NOSE SPECIFICALLY DESIGNED FOR INSTALLATION ON TILED STAIRS.
- 3.2MM TILED STAIRS OR 2.54MM TILED STAIRS.
- REFER TO DRAWINGS FOR REQUIRED LENGTH AND WIDTH

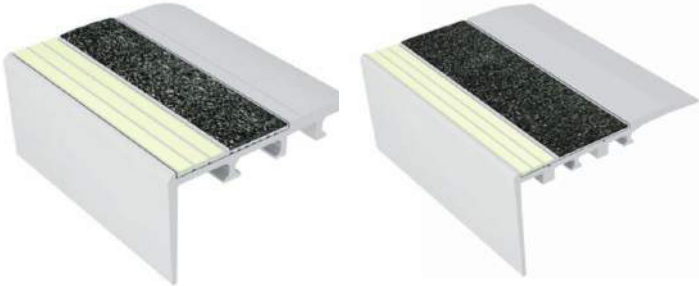

TA - 18 INTERIOR USE ON NEW CARPETED FLOORING. STAIR NOSING.

- ANODIZED ALUMINUM NOSE, SPECIFICALLY DESIGNED FOR CARPETED STAIRS, INSTALLED WITH EITHER NON-SLIP STRIP OR WITH PHOTOLUMINESCENCE CONTRAST STRIP
- INSTALLED WITH SCREWS
- SIZES: 66MM - 89MM
- REFER TO DRAWINGS FOR REQUIRED LENGTH AND WIDTH



TA - 19 EXTERIOR USE ON POURED CONCRETE. STAIR NOSING.

- HEAT TREATED EXTRUDED ALUMINUM ALLOY 6063-T-6, FILLED WITH A MIXTURE OF VIRGIN ALUMINUM OXIDE AND SILICON CARBIDE ABRASIVE GRANULES IN AN EPOXY BINDER.
- FULL LENGTH, INTEGRALLY EXTRUDED 5/8" ANCHOR.
- SIZES: 79.4MM X 25.4MM
- REFER TO DRAWINGS FOR REQUIRED LENGTH AND WIDTH
- TO BE USED ON NON-HERITAGE DESIGNATED STAIRS



TA - 20 INDOOR AND OUTDOOR USE ON NEW POURED CONCRETE STAIR NOSING.

- INSTALL INTO WET CONCRETE. USED ON CONCRETE STAIRS, CONCRETE-FILLED STEEL PAN STAIRS, AND PRE-CAST CONCRETE STAIRS.
- AVAILABLE IN CUT TO LENGTH SIZES. (TOLERANCE +OR- 1/8")
- STANDARD LENGTHS ARE 8FT AND 10FT.
- INSERTS ATTACHED OR UNATTACHED – INSERTS UNATTACHED CAN BE INSTALLED LATER TO ENSURE THE PRODUCT IS CLEAN AND HAS NOT BEEN DAMAGED DURING CONSTRUCTION. INSERTS ARE INSTALLED WITH A PREMIUM POLYURETHANE ADHESIVE.
- A CLEAR PROTECTIVE TAPE WRAPS AROUND THE PRODUCT TO KEEP THE PRODUCT CLEAN DURING INSTALLATION. TO REMOVE, CUT THE TAPE ALONG THE EDGES AND PEEL AWAY.



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DRAWING TITLE:
TEXTURAL & COLOUR CONTRAST
WARNING STRIP AND NOSING

Project No: 9119- 19- 0162 / Arcadis 30279056

Date: 2025-04-11

Issue: ISSUED FOR TENDER

NO.

T07


TH-1a

SMOOTH 6" WIDE THRESHOLD WITH ANTI-SLIP COATING




TH-2a

EXTERIOR APPLICATIONS - THERMALLY BROKEN METAL THRESHOLD
ANY EXISTING FLOORING MATERIAL TO ANY EXISTING FLOORING MATERIAL

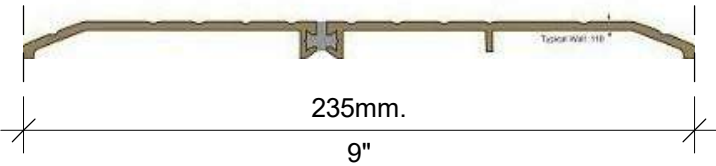

TH-3a

METAL THRESHOLD
ANY EXISTING FLOORING MATERIAL TO ANY EXISTING FLOORING MATERIAL

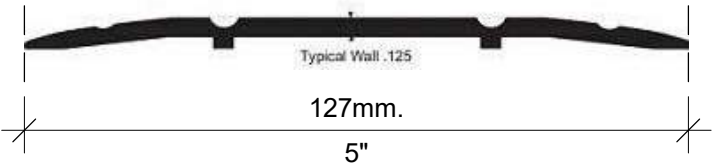

TH-4a

ANODIZED ALUMINUM TRANSITION STRIP
BETWEEN NEW AND EXISTING FLOOR



TH-5a

SATIN ANODIZED ALUMINUM TRANSITION STRIP
FOR NEW FLOORING ON BOTH SIDE VARIES HEIGHTS (TILE TO ANY FLOOR SURFACE)



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DRAWING TITLE:
DOOR THRESHOLDS & TRANSITIONS

Project No: 9119- 19- 0162 / Arcadis 30279056

Date: 2025-04-11

Issue: ISSUED FOR TENDER

NO.

T08

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9119-19-0162 / Arcadis 30279056

POLICE NO. 33 DIVISION
50 UPJOHN RD



CITY OF TORONTO



55 John ST.
TORONTO, ON
M5V 3C6

ISSUES		
No.	DESCRIPTION	DATE
A	50% SUBMISSION	2021-11-19
B	90% SUBMISSION	2022-02-22
C	ISSUED FOR PERMIT	2022-03-18
D	ISSUED FOR TENDER	2023-04-11

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PROGRAM GROUP 5

NOT FOR CONSTRUCTION

ISSUED FOR TENDER



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PROJECT NO: 9119-19-0162 / Arcadis 30279056	
DATE: 2023-04-11	
SHEET NUMBER G05-249-G0001	ISSUE D

4/9/2025 4:04:42 PM

GENERAL DRAWING INDEX	
SHEET NUMBER	SHEET NAME
G0001	COVER SHEET
G0002	DRAWING LIST

ARCHITECTURAL DRAWING INDEX PART 1	
SHEET NUMBER	SHEET NAME
A1001	DEMOLITION PLAN SITE PLAN
A1201	SITE PLAN
A1202	ENLARGED SITE PLAN PROPOSED
A2001	BASEMENT STAGING PLAN
A2011	FIRST FLOOR STAGING PLAN
A2021	SECOND FLOOR STAGING PLAN
A2031	THIRD FLOOR STAGING PLAN
A2101	BASEMENT DEMOLITION PLAN
A2111	FIRST FLOOR DEMOLITION PLAN
A2112	FIRST FLOOR DEMOLITION PLAN - PHOTOGRAPHS
A2121	SECOND FLOOR DEMOLITION PLAN
A2131	THIRD FLOOR DEMOLITION PLAN
A2132	THIRD FLOOR DEMOLITION PLAN - PHOTOGRAPHS
A2401	BASEMENT PROPOSED PLAN
A2411	FIRST FLOOR PROPOSED PLAN
A2421	SECOND FLOOR PROPOSED PLAN
A2431	THIRD FLOOR PROPOSED PLAN
A2611	FIRST FLOOR FLOOR FINISH PLAN
A2631	THIRD FLOOR FLOOR FINISH PLAN
A2831	THIRD FLOOR REFLECTED CEILING PLAN - ROOM
A2911	ROOF PLAN - DEMOLITION PLAN
A2912	ROOF PLAN - PROPOSED PLAN

ARCHITECTURAL DRAWING INDEX PART 2	
SHEET NUMBER	SHEET NAME
A5011	BARRIER FREE WASHROOM 1 - FIRST FLOOR
A5111	BARRIER FREE WASHROOM 2- FIRST FLOOR
A5211	BARRIER FREE WASHROOM 3- FIRST FLOOR
A5311	BARRIER FREE WASHROOM 4 - THIRD FLOOR
A5411	UNIVERSAL WASHROOM - THIRD FLOOR
A5611	STAIR PLANS AND SECTION
A5612	STAIR PLANS AND SECTION
A5711	NEW KITCHEN PLANS & ELEVATIONS
A5811	ELEVATOR PLANS
A5812	ELEVATOR SECTIONS
A5813	ELEVATOR DETAILS
A5815	ELEVATOR DETAILS
A5912	RECEPTION AREA - PLANS/ ELEVATIONS
A5913	RECEPTION AREA - DETAILS
A6011	MAIN ENTRANCE - PLAN/ ELEVATIONS
A8000	SIGNAGE & WAYFINDING DETAILS LEVEL B LOCATION PLAN
A8010	SIGNAGE & WAYFINDING DETAILS LEVEL 1 LOCATION PLAN
A8020	SIGNAGE & WAYFINDING DETAILS LEVEL 2 LOCATION PLAN
A8030	SIGNAGE & WAYFINDING DETAILS LEVEL 3 LOCATION PLAN
A8100	SIGNAGE & WAYFINDING DETAILS MESSAGE SCHEDULE
A8101	SIGNAGE & WAYFINDING DETAILS MESSAGE SCHEDULE
A8102	SIGNAGE & WAYFINDING DETAILS MESSAGE SCHEDULE
A9001	ROOM FINISH SCHEDULE
A9111	DOOR SCHEDULE

STRUCTURAL DRAWING INDEX	
SHEET NUMBER	SHEET NAME
S0001	DRAWING LIST
S1201	SITE PLAN
S2001	DEMOLITION PLAN - BASEMENT
S2002	DEMOLITION PLAN - GROUND FLOOR
S2003	DEMOLITION PLAN - SECOND FLOOR
S2004	DEMOLITION PLAN - THIRD FLOOR
S2005	DEMOLITION PLAN - MECHANICAL FLOOR
S2501	PROPOSED PLAN - BASEMENT
S2502	PROPOSED PLAN - GROUND FLOOR
S2503	PROPOSED PLAN - SECOND FLOOR
S2504	PROPOSED PLAN - THIRD FLOOR
S2505	PROPOSED PLAN - MECHANICAL FLOOR
S5200	PLANS, SECTION - STAIRS
S5301	ELEVATOR - FOUNDATION
S5302	ELEVATOR - PLANS
S5303	ELEVATOR - PLANS
S5304	ELEVATOR - ROOF
S5305	ELEVATOR - SECTIONS
S5306	Unnamed
S5400	PLANS, SECTION - ESCALATORS
S5700	PLANS, SECTION - SOG
S6000	PLANS, SECTION - DEMOLUTIONS
S6200	PLANS, SECTION - STAIRS
S6300	PLANS, SECTION - ELEVATORS
S6400	PLANS, SECTION - ESCALATORS
S6801	WALL OPENINGS
S6900	PLANS, SECTION - MISC

MECHANICAL DRAWING INDEX	
SHEET NUMBER	SHEET NAME
M0001	MECHANICAL DRAWING LIST
M0201	EQUIPMENT SCHEDULE
M1101	DEMOLITION PLAN - GROUND FLOOR
M1102	DEMOLITION PLAN - THIRD FLOOR
M2101	PLUMBING - GROUND FLOOR
M2102	PLUMBING - THIRD FLOOR
M3101	DRAINAGE - BASEMENT
M3102	DRAINAGE - GROUND FLOOR
M3103	DRAINAGE - THIRD FLOOR
M5101	HVAC - BASEMENT
M5102	HVAC - GROUND FLOOR
M5103	HVAC - THIRD FLOOR
M5104	HVAC - ROOF PLAN
M6101	FIRE PROTECTION PLAN

ELECTRICAL DRAWING INDEX	
SHEET NUMBER	SHEET NAME
E0000	DRAWING LIST
E1101	ELECTRICAL DEMOLITION 1ST FLOOR
E1103	ELECTRICAL DEMOLITION 3RD FLOOR
E2101	POWER & SYSTEMS PLAN 1ST FLOOR
E2103	POWER & SYSTEMS PLAN 3RD FLOOR
E2104	POWER & SYSTEMS PLAN ROOF

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ISSUES		
No.	DESCRIPTION	DATE
A	50% SUBMISSION	2021-11-19
B	90% SUBMISSION	2022-02-22
C	ISSUED FOR PERMIT	2022-03-18
D	ISSUED FOR TENDER	2025-04-11

CONSULTANTS

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PRIME CONSULTANT



100 - 175 Galaxy Blvd,
Toronto, ON M9W 0C9, Canada
tel 416 679 1930
www.arcadis.com

PROJECT TITLE
CITY OF TORONTO
ACCESSIBILITY UPGRADES

PROJECT ADDRESS

POLICE NO. 33 DIVISION
50 UPJOHN RD

PROJECT NO:
9119-19-0162 / Arcadis 30279056
DRAWN BY:
A.Sunil
PROJECT MGR:
F. BOLOURIAN
CHECKED BY:
K.Tilahun
APPROVED BY:
E.Fenuta

SHEET TITLE
DRAWING LIST

SHEET NUMBER	ISSUE
G05-249-G0002	D

Firm Name: IBI GROUP ARCHITECTS (CANADA) INC. CERTIFICATE OF PRACTICE NUMBER 5605 100-175 Galaxy Boulevard Toronto, ON M9W 0C9 T 416 679 1930 F 416 675 4620				Name of Project DISCO YARD-OFFICE BUILDING NO.100 ACCESSIBILITY UPGRADES Location 150 DISCO RD. ETOBICOKE, TORONTO ON M9W 1M4			
ITEM	Ontario's 2012 Building Code Data Matrix Part 3 or 9			OBC REFERENCE References are to Division B unless noted (A) for Division A or (C) for Division C		REMARKS	
1.	PROJECT DESCRIPTION	<input type="checkbox"/> New <input type="checkbox"/> Addition <input type="checkbox"/> CHANGE OF USE <input checked="" type="checkbox"/> Alteration	<input checked="" type="checkbox"/> PART 11 11.1 to 11.4	<input checked="" type="checkbox"/> PART 3	<input type="checkbox"/> PART 9		
2.	MAJOR OCCUPANCY(S) SUBSIDIARY OCCUPANCY(S)	GROUP B 1 POLICE STATIONS WITH DETENTION QUARTERS		3.1.2.1. (1)	9.10.2.	EXISTING NO CHANGE	
3.	BUILDING AREA (m²)	EXISTING - 1080.4 NEW -- TOTAL - 1080.4		1.4.1.2. [A]	1.4.1.2. [A]		
4.	GROSS AREA (m²)	EXISTING - 4233.2 NEW -- TOTAL - 4233.2		1.4.1.2. [A]	1.4.1.2. [A]	EXISTING NO CHANGE	
5.	NUMBER OF STOREYS	ABOVE GRADE - 3 BELOW GRADE - 1 PARTIAL		1.4.1.2. [A] & 3.2.1.1.	1.4.1.2. [A] & 9.10.4.		
6.	NUMBER OF STREETS/FIRE FIGHTER ACCESS - 2	EXISTING NO CHANGE		3.2.2.10. & 3.2.5.	9.10.20.		
7.	BUILDING CLASSIFICATION -	EXISTING NO CHANGE		3.2.2.67.	9.10.2.		
8.	SPRINKLER SYSTEM PROPOSED	<input type="checkbox"/> ENTIRE BUILDING <input type="checkbox"/> SELECTED COMPARTMENTS <input type="checkbox"/> SELECTED FLOOR AREAS <input type="checkbox"/> BASEMENT <input type="checkbox"/> IN LIEU OF ROOF RATING <input checked="" type="checkbox"/> NOT REQUIRED		3.2.2.67 3.2.1.5 3.2.2.17 INDEX	9.10.8.2 INDEX	EXISTING NO CHANGE	
9.	STANDPIPE REQUIRED STANDPIPE PROVIDED	<input type="checkbox"/> YES <input checked="" type="checkbox"/> NO <input type="checkbox"/> YES <input checked="" type="checkbox"/> NO		3.2.9.	N/A	EXISTING NO CHANGE	
10.	FIRE ALARM REQUIRED FIRE ALARM PROVIDED	<input checked="" type="checkbox"/> YES <input type="checkbox"/> NO <input checked="" type="checkbox"/> YES <input type="checkbox"/> NO		3.2.4.	9.10.18.	EXISTING NO CHANGE	
11.	WATER SERVICE/SUPPLY IS ADEQUATE	<input checked="" type="checkbox"/> YES <input type="checkbox"/> NO		3.2.5.7.	N/A	EXISTING NO CHANGE	
12.	HIGH BUILDING	<input type="checkbox"/> YES <input checked="" type="checkbox"/> NO		3.2.6.	N/A		
13.	CONSTRUCTION RESTRICTIONS ACTUAL CONSTRUCTION	<input type="checkbox"/> COMBUSTIBLE PERMITTED <input type="checkbox"/> COMBUSTIBLE <input checked="" type="checkbox"/> NON-COMBUSTIBLE <input type="checkbox"/> BOTH <input type="checkbox"/> COMBUSTIBLE <input checked="" type="checkbox"/> NON-COMBUSTIBLE <input type="checkbox"/> BOTH		3.2.2.67.	9.10.6.	EXISTING NO CHANGE	
14.	MEZZANINE (S) AREA m²	N/A		3.2.1.1. (3) - (8)	9.10.4.1.		
15.	OCCUPANT LOAD BASED ON	<input type="checkbox"/> m²/PERSON 1ST FLOOR: OCCUPANCY _____ LOAD ____ PERSONS 2ND FLOOR: OCCUPANCY _____ LOAD ____ PERSONS MEZZANINE FLOOR: OCCUPANCY _____ LOAD ____ PERSONS	<input checked="" type="checkbox"/> DESIGN OF BUILDING	3.1.17.	4.9.13.	EXISTING NO CHANGE	
16.	BARRIER FREE DESIGN	<input checked="" type="checkbox"/> YES <input type="checkbox"/> NO (EXPLAIN)		3.8.	9.5.2.	ONLY PROPOSED AREA OF WORK - COMPLIANT WITH CITY OF TORONTO ACCESSIBILITY DESIGN GUIDELINE DRAFT 2016 WHEN POSSIBLE	
17.	HAZARDOUS SUBSTANCES	<input type="checkbox"/> YES <input checked="" type="checkbox"/> NO		3.3.1.2 & 3.3.1.19	9.10.1.3.(4)		
18a.	REQUIRED FIRE RESISTANCE RATING (FRR)	HORIZONTAL ASSEMBLIES FRR (HOURS) FLOORS NO CHANGE ROOF NO CHANGE MEZZANINE N/A	LISTED DESIGN NO. OR DESCRIPTION (SB-2)	3.2.2.67. & 3.2.1.4.	9.10.8. 9.10.9.		

ITEM	Ontario's 2012 Building Code Data Matrix Part 3 or 9										OBC REFERENCE References are to Division B unless noted (A) for Division A or (C) for Division C		REMARKS		
18b.	REQUIRED FIRE RESISTANCE RATING (FRR)	FRR OF SUPPORTING MEMBERS FLOORS NO CHANGE ROOF NO CHANGE MEZZANINE		LISTED DESIGN NO. OR DESCRIPTION (SB-2)				SB-2 TABLE 2.1.1. SB-2 TABLE 2.1.1.							
19.	SPATIAL SEPARATION - CONSTRUCTION OF EXTERIOR WALLS										3.2.3.	9.10.14.			
	WALL	AREA OF EBF (m²)	LD (M)	L/H OR H/L	PERMITTED MAX. % OF OPENINGS	PROPOSED % OF OPENINGS	FRR (HOURS)	LISTED DESIGN OR DESCRIPTION	COMB. CONST.	COMB. CONST. NONC. CLADDING	NON-COMB. CONST.	EXISTING NO CHANGE			
	NORTH					-	0	-	-	-	-				
	SOUTH					-	0	-	-	-	-				
	EAST					-	0	-	-	-	-				
	WEST					-	0	-	-	-	-				
20.	PLUMBING FIXTURE REQUIREMENTS										-				
	MALE / FEMALE COUNT @ EXCEPT AS NOTED OTHERWISE										EXISTING NO CHANGE		<input checked="" type="checkbox"/> PART 3	<input type="checkbox"/> PART 9	
	MAJOR OCCUPANCY										OCCUPANT LOAD	OBC TABLE NUMBER	FIXTURES REQUIRED	FIXTURES PROVIDED	
											X MALE	3.7.4.9.	X	X	3.7.4.9.
											X FEMALE	3.7.4.9.	X	X	3.7.4.9.
21.	EXITS/ ACCESS TO EXIT-												EXISTING NO CHANGE		
22.	OTHER (DESCRIBE) -														
ITEM	Ontario Building Code Data Matrix - Part 11 - Renovation of Existing Building										OBC REREFENCE		REMARKS		
11.1	EXISTING BUILDING CLASSIFICATION:	DESCRIBE EXISTING USE: CONSTRUCTION INDEX: HAZARD INDEX: <input checked="" type="checkbox"/> NOT APPLICABLE (NO CHANGE OF MAJOR OCCUPANCY)								11.2.1. TABLE 11.2.1.1.A. TABLE 11.2.1.1.B. TO N					
11.2	ALTERATION TO EXISTING BUILDING IS:	BASIC RENOVATION <input checked="" type="checkbox"/> EXTENSIVE RENOVATION <input type="checkbox"/>								11.3.3.1. 11.3.3.2.					
11.3	REDUCTION IN PERFORMANCE LEVEL:	STRUCTURAL: BY INCREASE IN OCCUPANT LOAD: BY CHANGE OF MAJOR OCCUPANCY: PLUMBING: SEWAGE SYSTEM:								<input checked="" type="checkbox"/> NO <input type="checkbox"/> YES <input checked="" type="checkbox"/> NO <input type="checkbox"/> YES <input checked="" type="checkbox"/> NO <input type="checkbox"/> YES <input checked="" type="checkbox"/> NO <input type="checkbox"/> YES	11.4.2. 11.4.2.1. 11.4.2.2. 11.4.2.3.				
11.4	COMPENSATING CONSTRUCTION:	STRUCTURAL: BY INCREASE IN OCCUPANT LOAD: BY CHANGE OF MAJOR OCCUPANCY: PLUMBING: SEWAGE SYSTEM:								<input checked="" type="checkbox"/> NO <input type="checkbox"/> YES (EXPLAIN) <input checked="" type="checkbox"/> NO <input type="checkbox"/> YES (EXPLAIN) <input checked="" type="checkbox"/> NO <input type="checkbox"/> YES (EXPLAIN) <input checked="" type="checkbox"/> NO <input type="checkbox"/> YES (EXPLAIN)	11.4.3 11.4.3.2 11.4.3.3 11.4.3.4 11.4.3.5				
11.5	COMPLIANCE ALTERNATIVES PROPOSED:	<input checked="" type="checkbox"/> NO <input type="checkbox"/> YES (GIVE NUMBERS)								11.5.1					



2 KEY PLAN
A1001 Scale: 1 : 1000

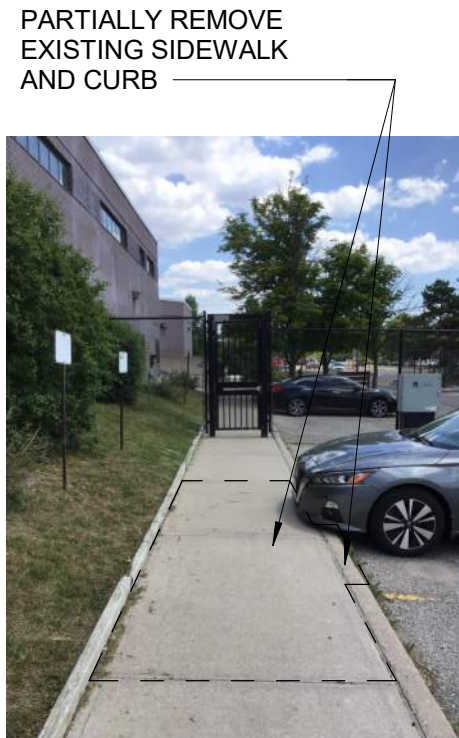


PHOTO 01: EXISTING SIDEWALK

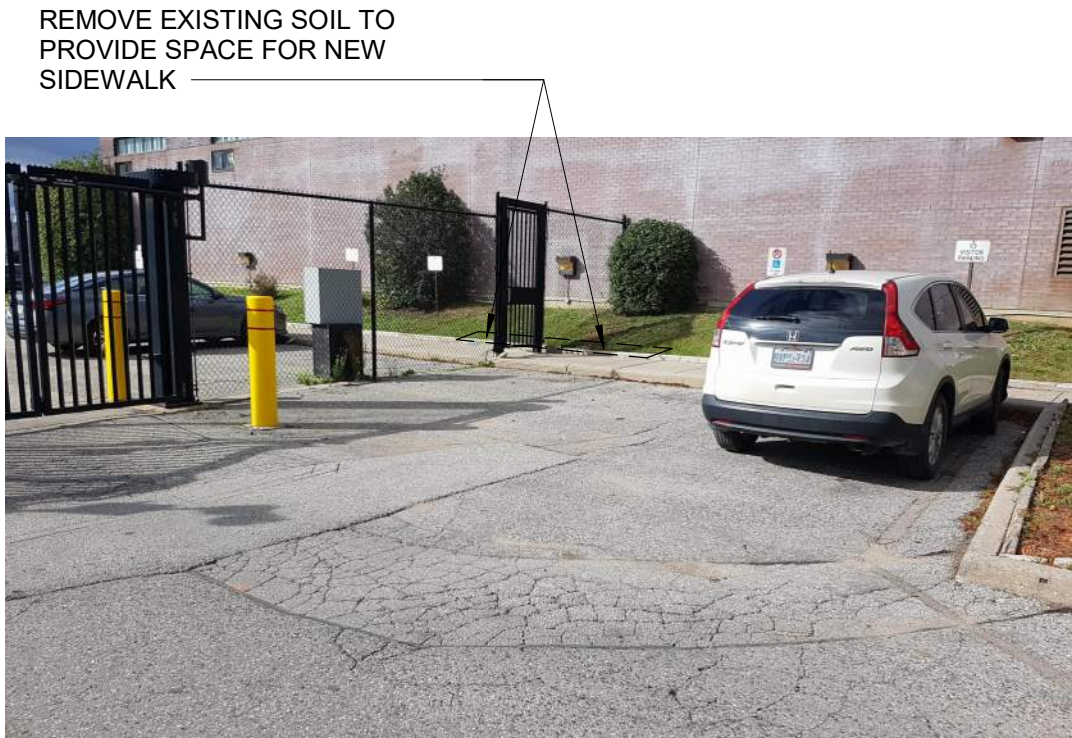



PHOTO 02: EXISTING SIDEWALK AND FENCE



PHOTO 03: EXISTING EXTERIOR STAIR



PHOTO 04: EXISTING EXTERIOR RAMP

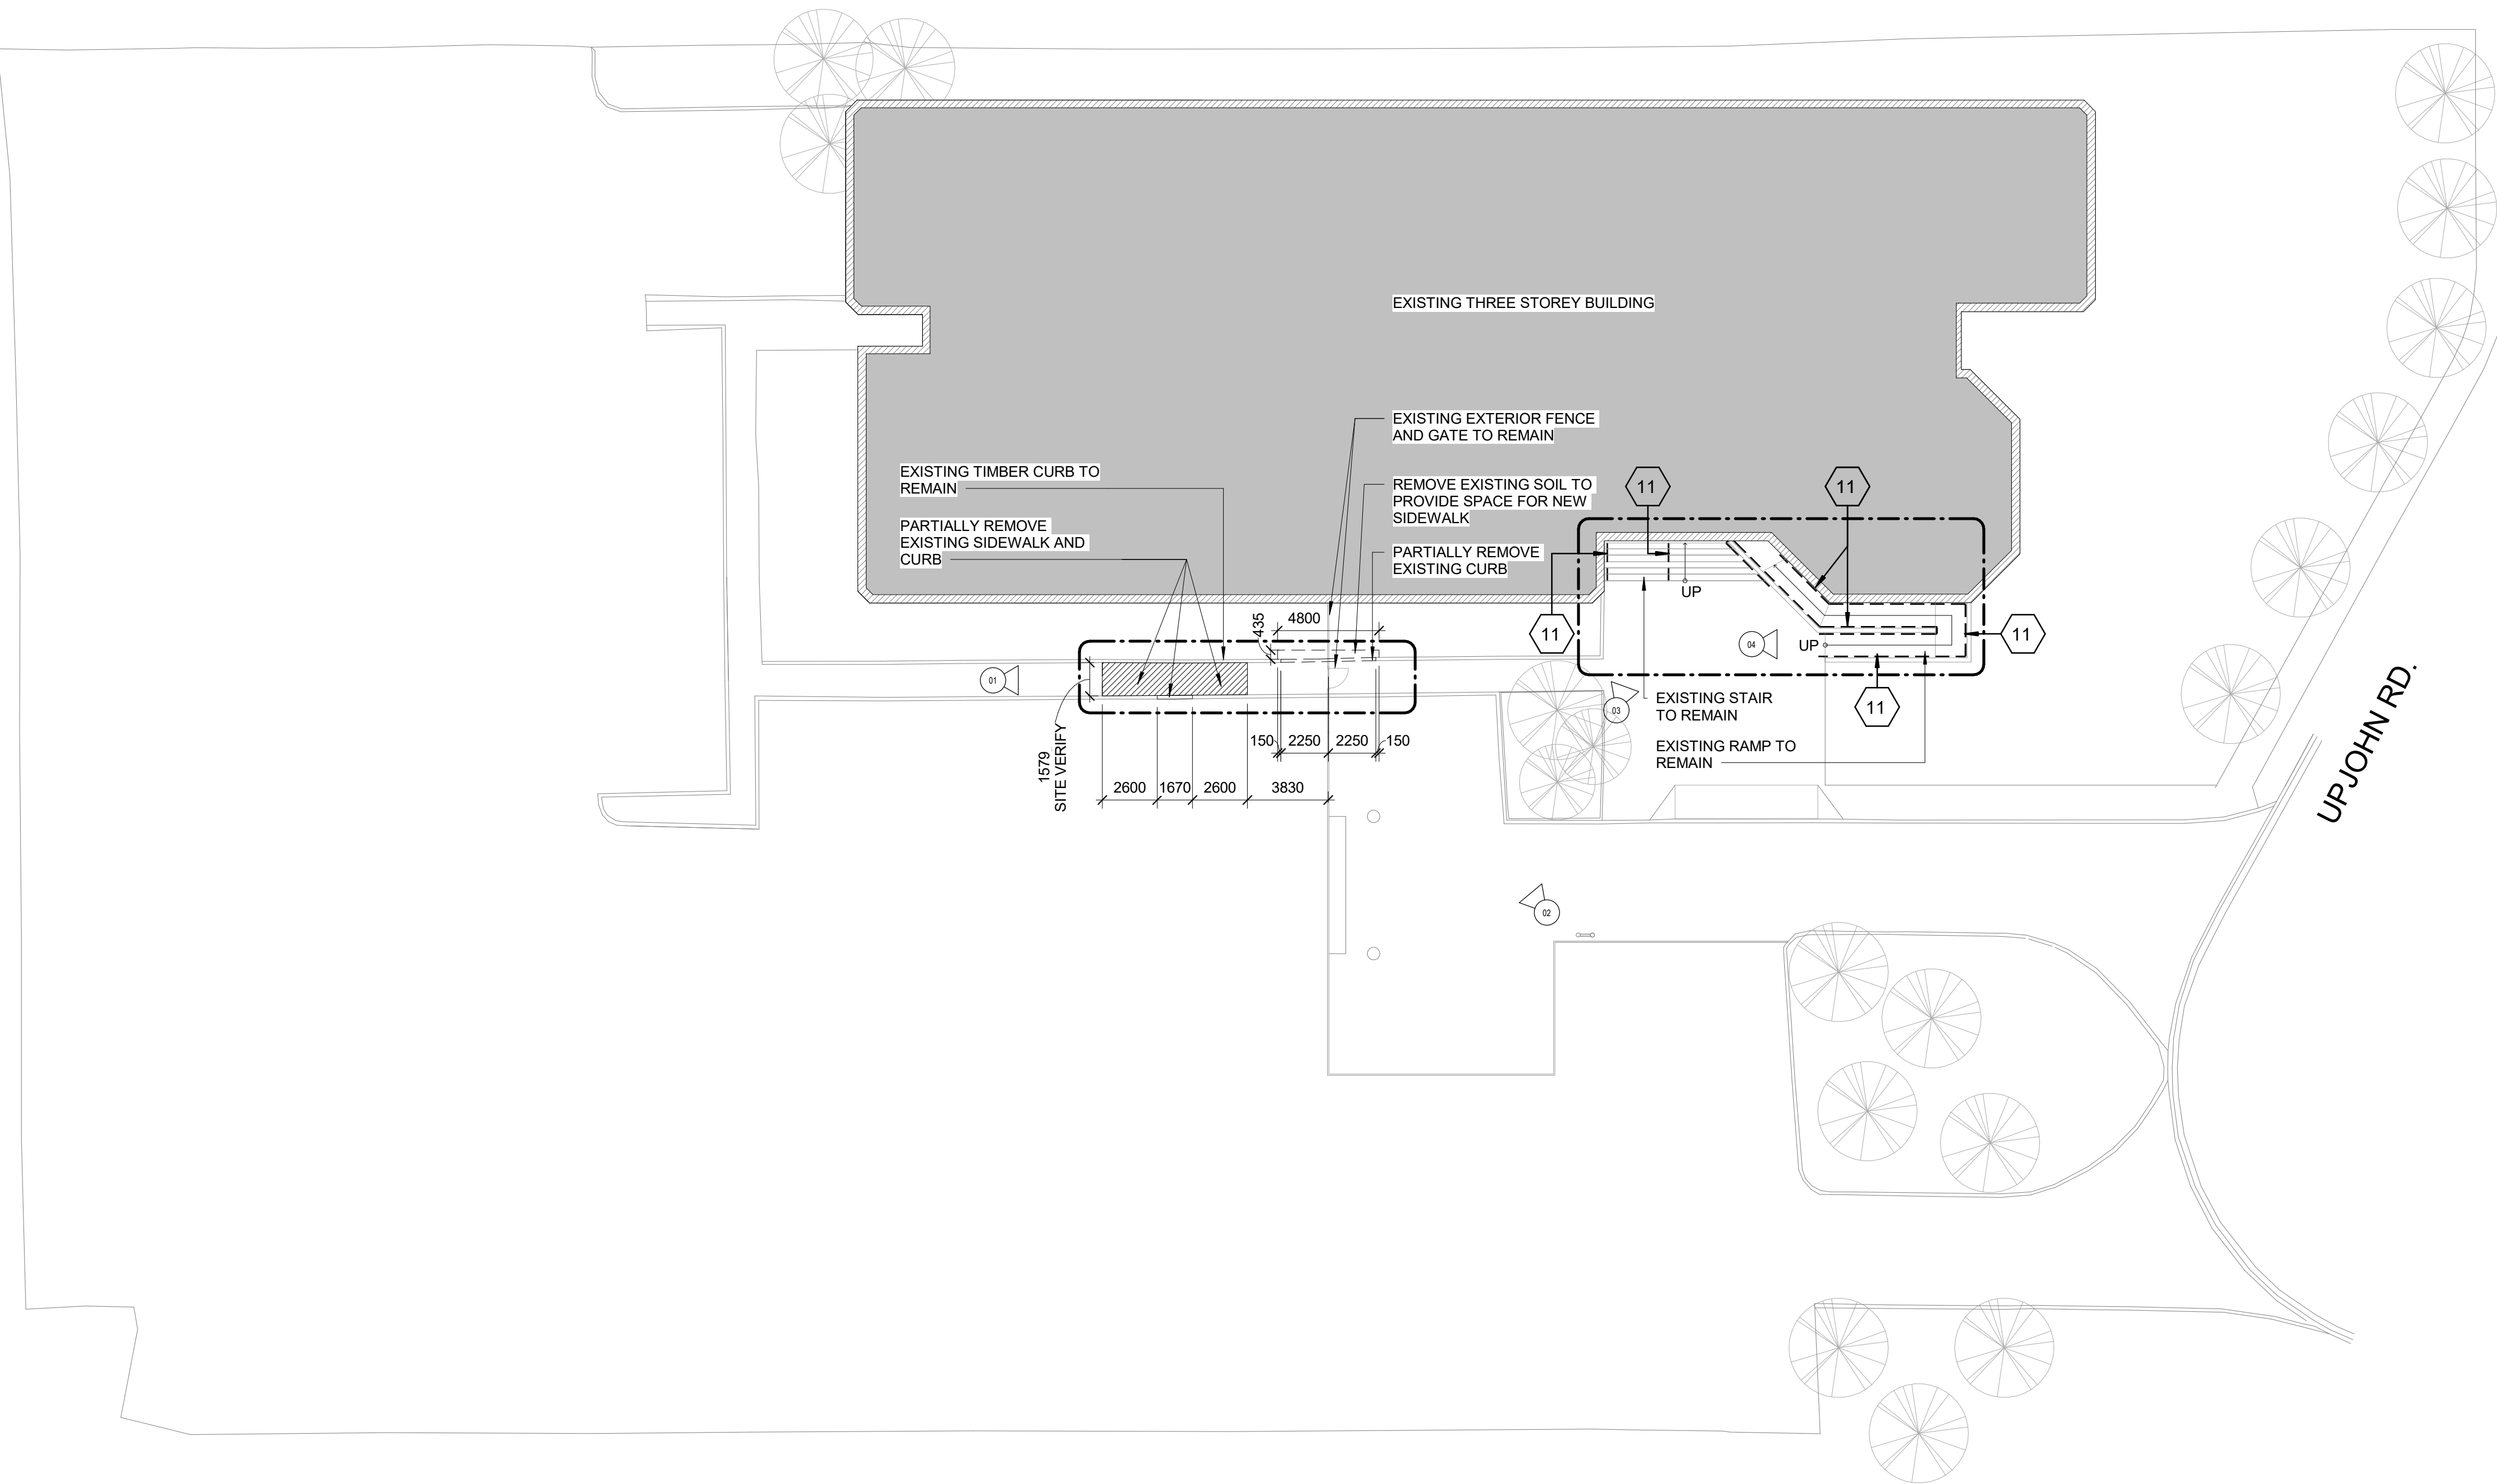

1 SITE PLAN - DEMOLITION PLAN
A1001 Scale: 1 : 200

SITE LEGEND




NEW BARRIER FREE PARKING SPACE - REFER TO DETAIL 1/D1701 & 5/D1701




ACCESSIBLE PARKING SIGN ON POST - REFER TO DETAIL 2/D1702




EXISTING MAIN ENTRANCE

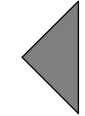

EXISTING EXIT TO REMAIN

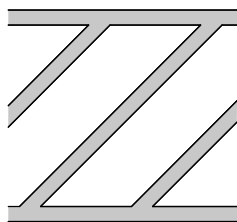

NEW PAINTED LINE MARKING DETAIL - REFER TO DETAIL 3/D1701

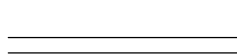

NEW PAINTED LINE MARKING DETAIL - REFER TO DETAIL 4/D1701



DASHED AREA INDICATES AREA OF WORK

SITE PLAN GENERAL NOTES

- 1 SITE PLAN DIMENSIONS ARE APPROXIMATE BASED ON GOOGLE MAPS. CONTRACTOR TO VERIFY ALL DIMENSIONS AND EXISTING SITE SERVICES AND TO REPORT ANY DISCREPANCY TO THE CONSULTANT AND THE OWNER BEFORE COMMENCEMENT OF THE WORK.
- 2 DURING CONSTRUCTION, CONTRACTOR TO COORDINATE ENTRANCES WITH OWNER FOR HOARDING AND EXTERIOR FENCING. RESTORE EXTERIOR WALKWAY, DRIVEWAY, PAVING AND ALL SOFT LANDSCAPING MATERIAL AROUND ALL EXTERIOR EXCAVATED AREAS AFTER CONSTRUCTION AS NEEDED WITH THE SAME MATERIAL AND FINISH.
- 3 VERIFY ALL UNDERGROUND BURIED UTILITIES PRIOR TO DIGGING AND REPORT ANY CONFLICTS TO THE CONSULTANT.

CONSTRUCTION KEY NOTES

NO	DESCRIPTION
11	REMOVE EXISTING GUARDRAIL, HANDRAIL AND/OR HANDRAIL POST BASE. REPAIR AND MAKE GOOD ALL SURFACES.

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Corporate Real Estate Management
Project Management Office
Metro Hall Toronto, ON
M5V 3C6

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Arcadis Professional Services (Canada) Inc.

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POLICE NO. 33 DIVISION
50 UPJOHN RD

PROJECT NO:
9119-19-0162 / Arcadis 30279056

DRAWN BY:
A.Sunil

CHECKED BY:
K.Tilahun

PROJECT MGR:
F. BOLOURIAN

APPROVED BY:
E.Fenuta

SHEET TITLE
DEMOLITION PLAN SITE
PLAN


SHEET NUMBER

G05-249-A1001

ISSUE

D

4/9/2025 4:04:48 PM

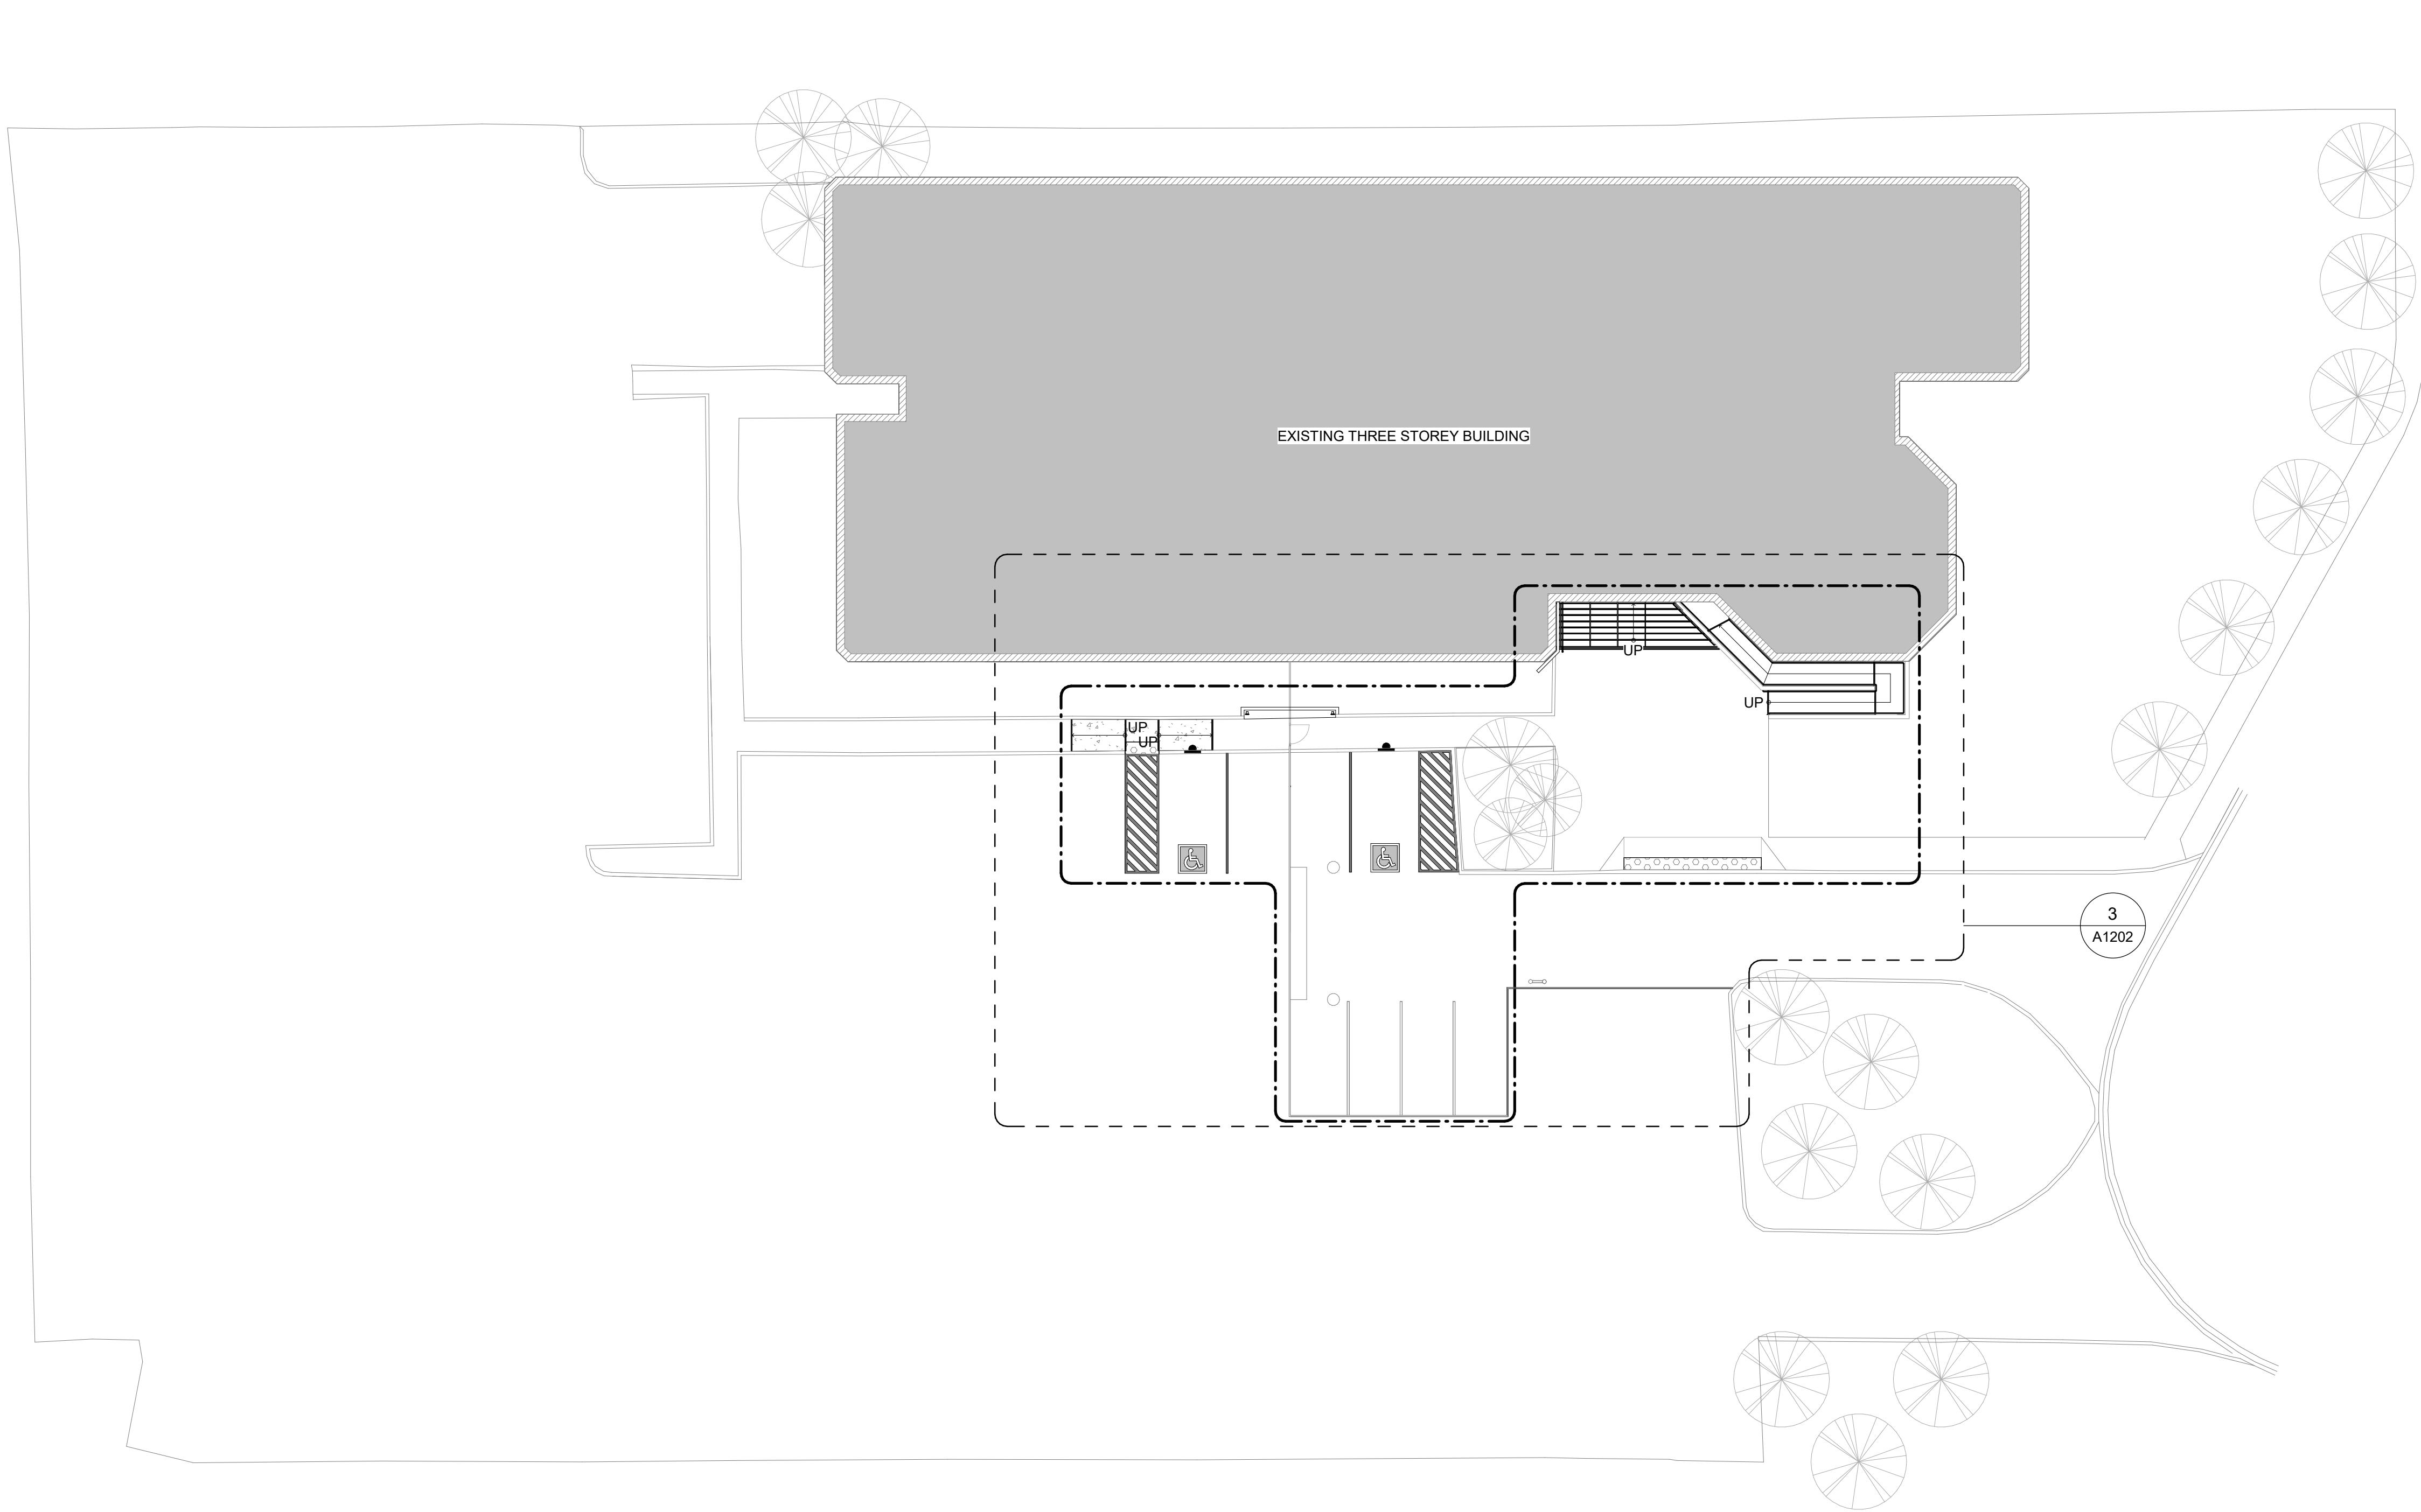

SITE LEGEND



NEW BARRIER FREE PARKING
SPACE - REFER TO DETAIL
1/D1701 & 5/D1701




ACCESSIBLE PARKING SIGN ON
POST - REFER TO DETAIL 2/D1702




EXISTING MAIN ENTRANCE



EXISTING EXIT TO REMAIN

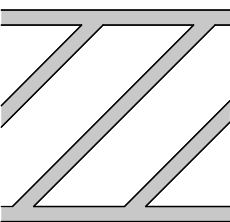

NEW PAINTED LINE MARKING
DETAIL - REFER TO DETAIL 3/D1701

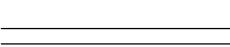

NEW PAINTED LINE MARKING
DETAIL - REFER TO DETAIL 4/D1701



DASHED AREA INDICATES
AREA OF WORK

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KEYPLAN

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PROJECT TITLE

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PROJECT ADDRESS

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PROJECT NO:

9119-19-0162 / Arcadis 30279056

DRAWN BY:

A.Sunil

CHECKED BY:

K.Tilahun

PROJECT MGR:

F. BOLOURIAN

APPROVED BY:

E.Fenuta

SHEET TITLE



SITE PLAN

SHEET NUMBER

G05-249-A1201

ISSUE



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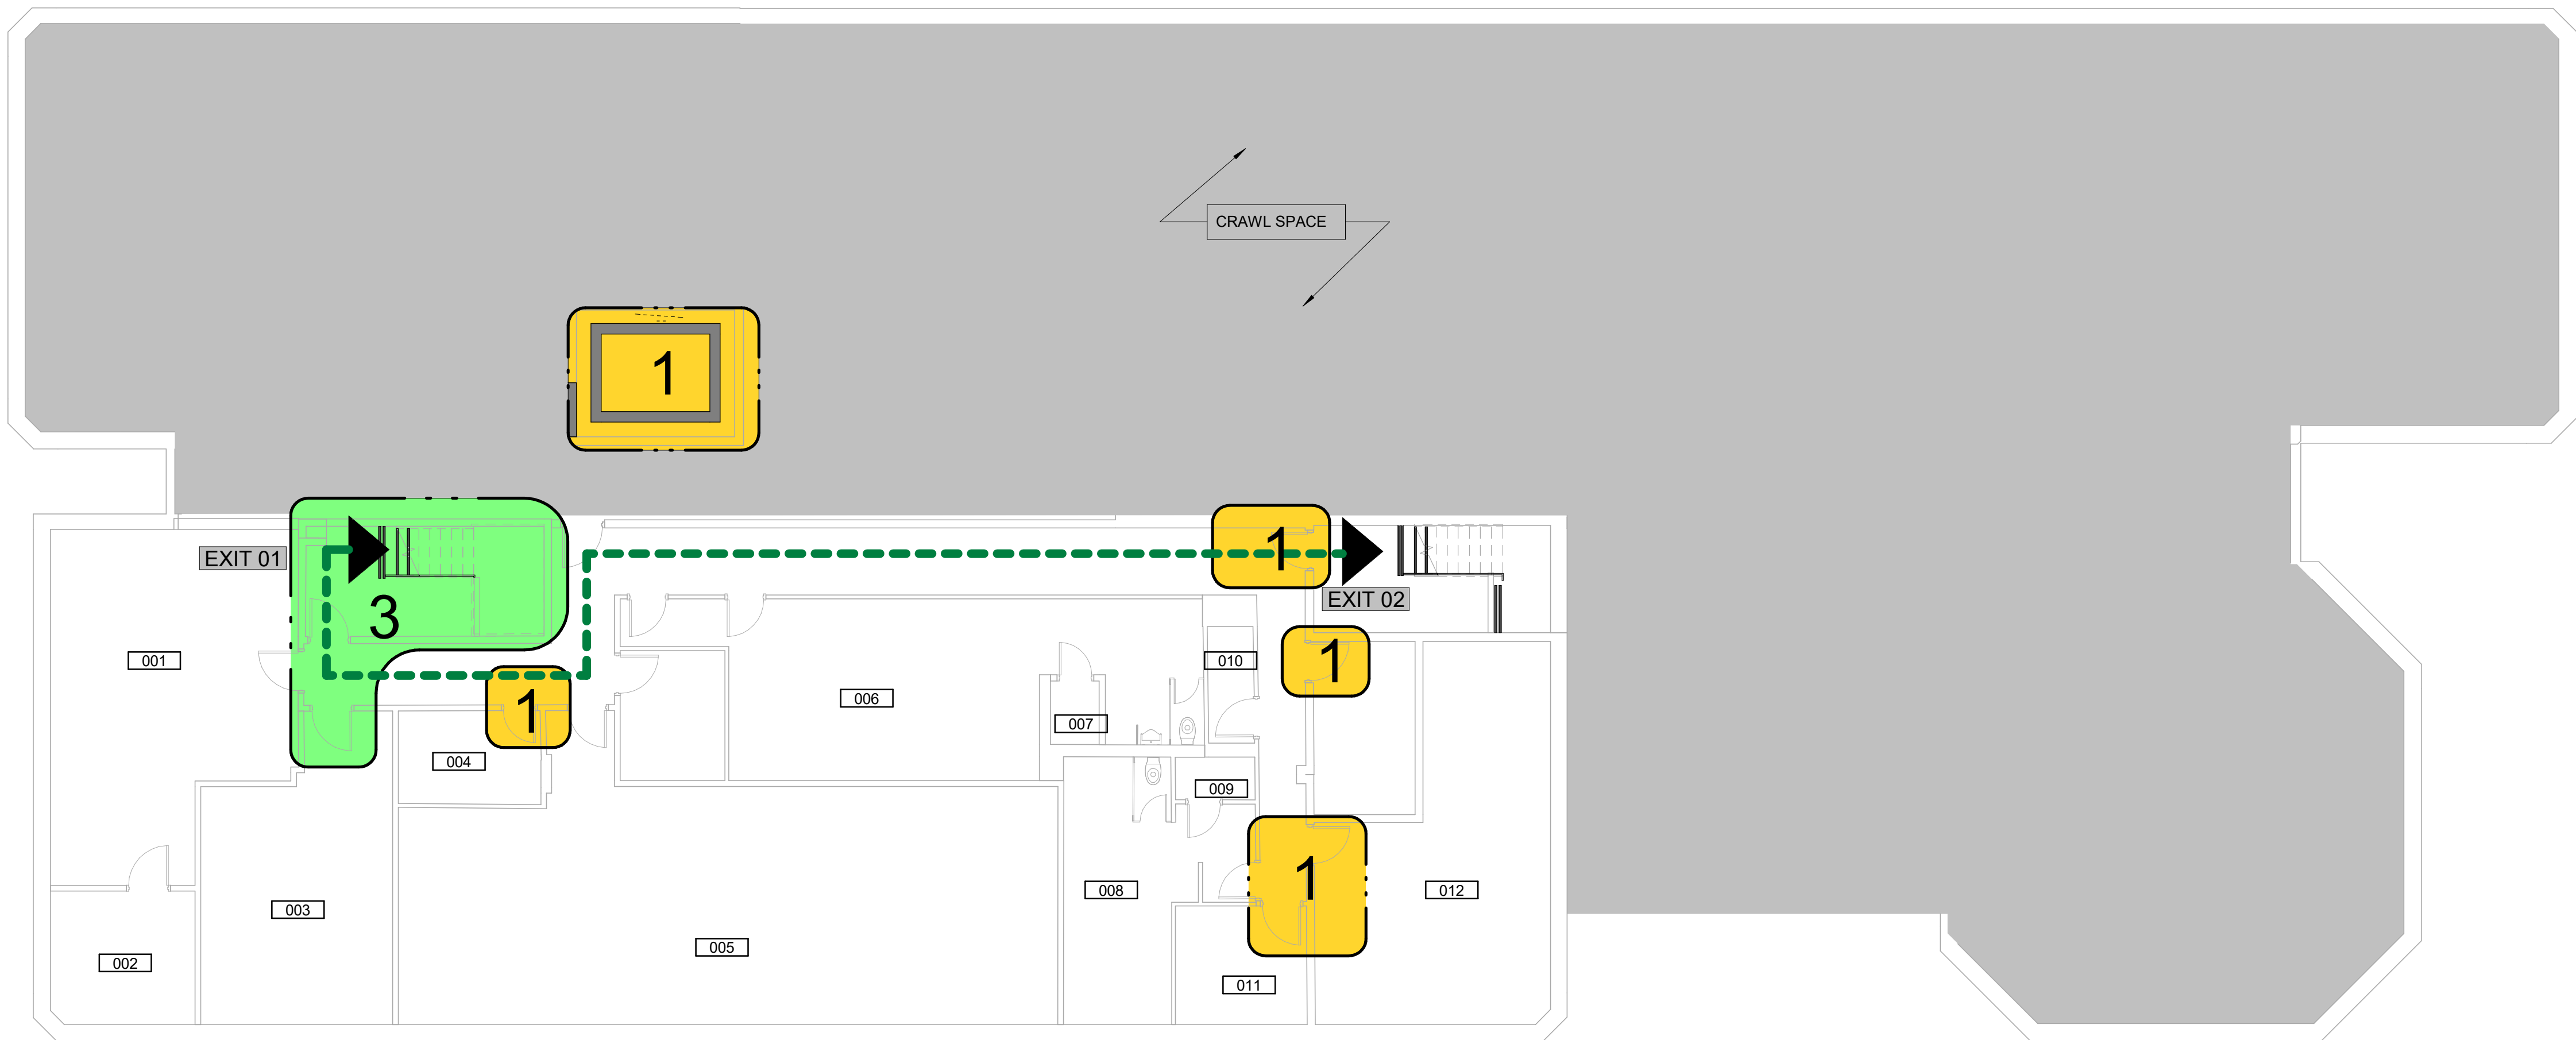

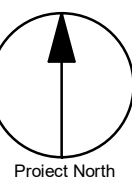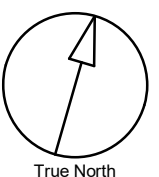
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10mm

SCALE CHECK
1 m



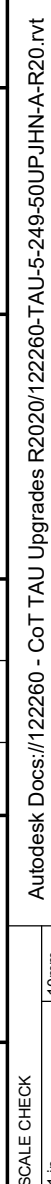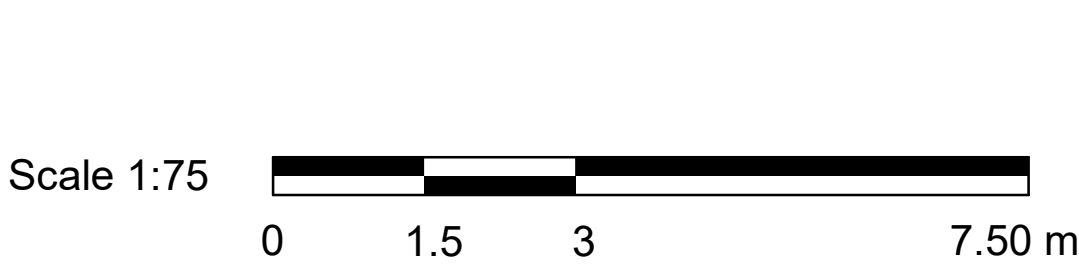

CONSTRUCTION STAGING LEGEND

- STAGE 1
- STAGE 2
- STAGE 3
- STAGE 4
- EMERGENCY EXIT
- TRAVEL PATH

STAGING GENERAL NOTES

- EXISTING FACILITY WILL REMAIN OPERATIONAL DURING CONSTRUCTION. CONSTRUCTION WORKS CANNOT IMPACT FACILITY OPERATION WITHOUT FIRST NOTIFYING AND CONSULTING WITH THE OWNER.
- ALL STAGES ARE TO BE COMPLETED IN SEQUENTIAL ORDER.
- IF AN EXIT WILL BE BLOCKED DUE TO CONSTRUCTION, THE GC IS TO PROVIDE A TEMPORARY EXIT LOCATION THAT IS APPROVED BY THE ARCHITECT AND THE FIRE DEPARTMENT. SHOULD THE WORK BE ABLE TO BE COMPLETED OVER THE COURSE OF A WEEKEND OR AFTER HOURS, THE GC IS TO OBTAIN APPROVAL FROM THE ARCHITECT PRIOR TO PROCEEDING WITH THE WORK.
- IF EXISTING FIRE ALARM SYSTEM NEEDS TO BE TEMPORARILY INTERRUPTED TO COMPLETE THE WORK, A FULL TIME FIRE WATCH SHALL BE PROVIDED.
5. CONTRACTOR SHALL ALLOW FOR THE FOLLOWING:
A) TEMPORARY SIGNAGE
B) TEMPORARY ACCESS WITH ACCESSIBLE RAMPS AS REQUIRED BY ONTARIO REGULATION 191/11 80.13
- ALL STAGING INCLUDES BOTH DEMOLITION AND NEW SCOPE OF WORKS.
- PROVIDE AND MODIFY CONSTRUCTION BARRIER/SIGNAGE ETC. TO SUIT SITE CONDITION AND CONSTRUCTION SEQUENCE.
- WORK LISTED IN STAGES IS FOR REFERENCE ONLY. EACH STAGE MUST BE COMPLETED AS PER CONTRACT DOCUMENTS BEFORE STARTING THE NEXT STAGE AND SHALL NOT AFFECT NORMAL OPERATION OR EXITING OF THE FACILITY.
- FOR ALL OTHER REQUIREMENTS - REFER TO SPECIFICATIONS.
- KEEP EXITS CLEAR FROM OBSTRUCTIONS DURING CONSTRUCTION.

CLIENT

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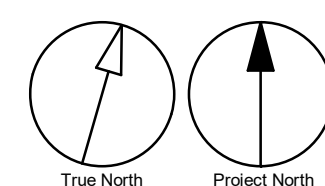
SHEET TITLE
**BASEMENT STAGING
PLAN**


SHEET NUMBER

G05-249-A2001

ISSUE

D



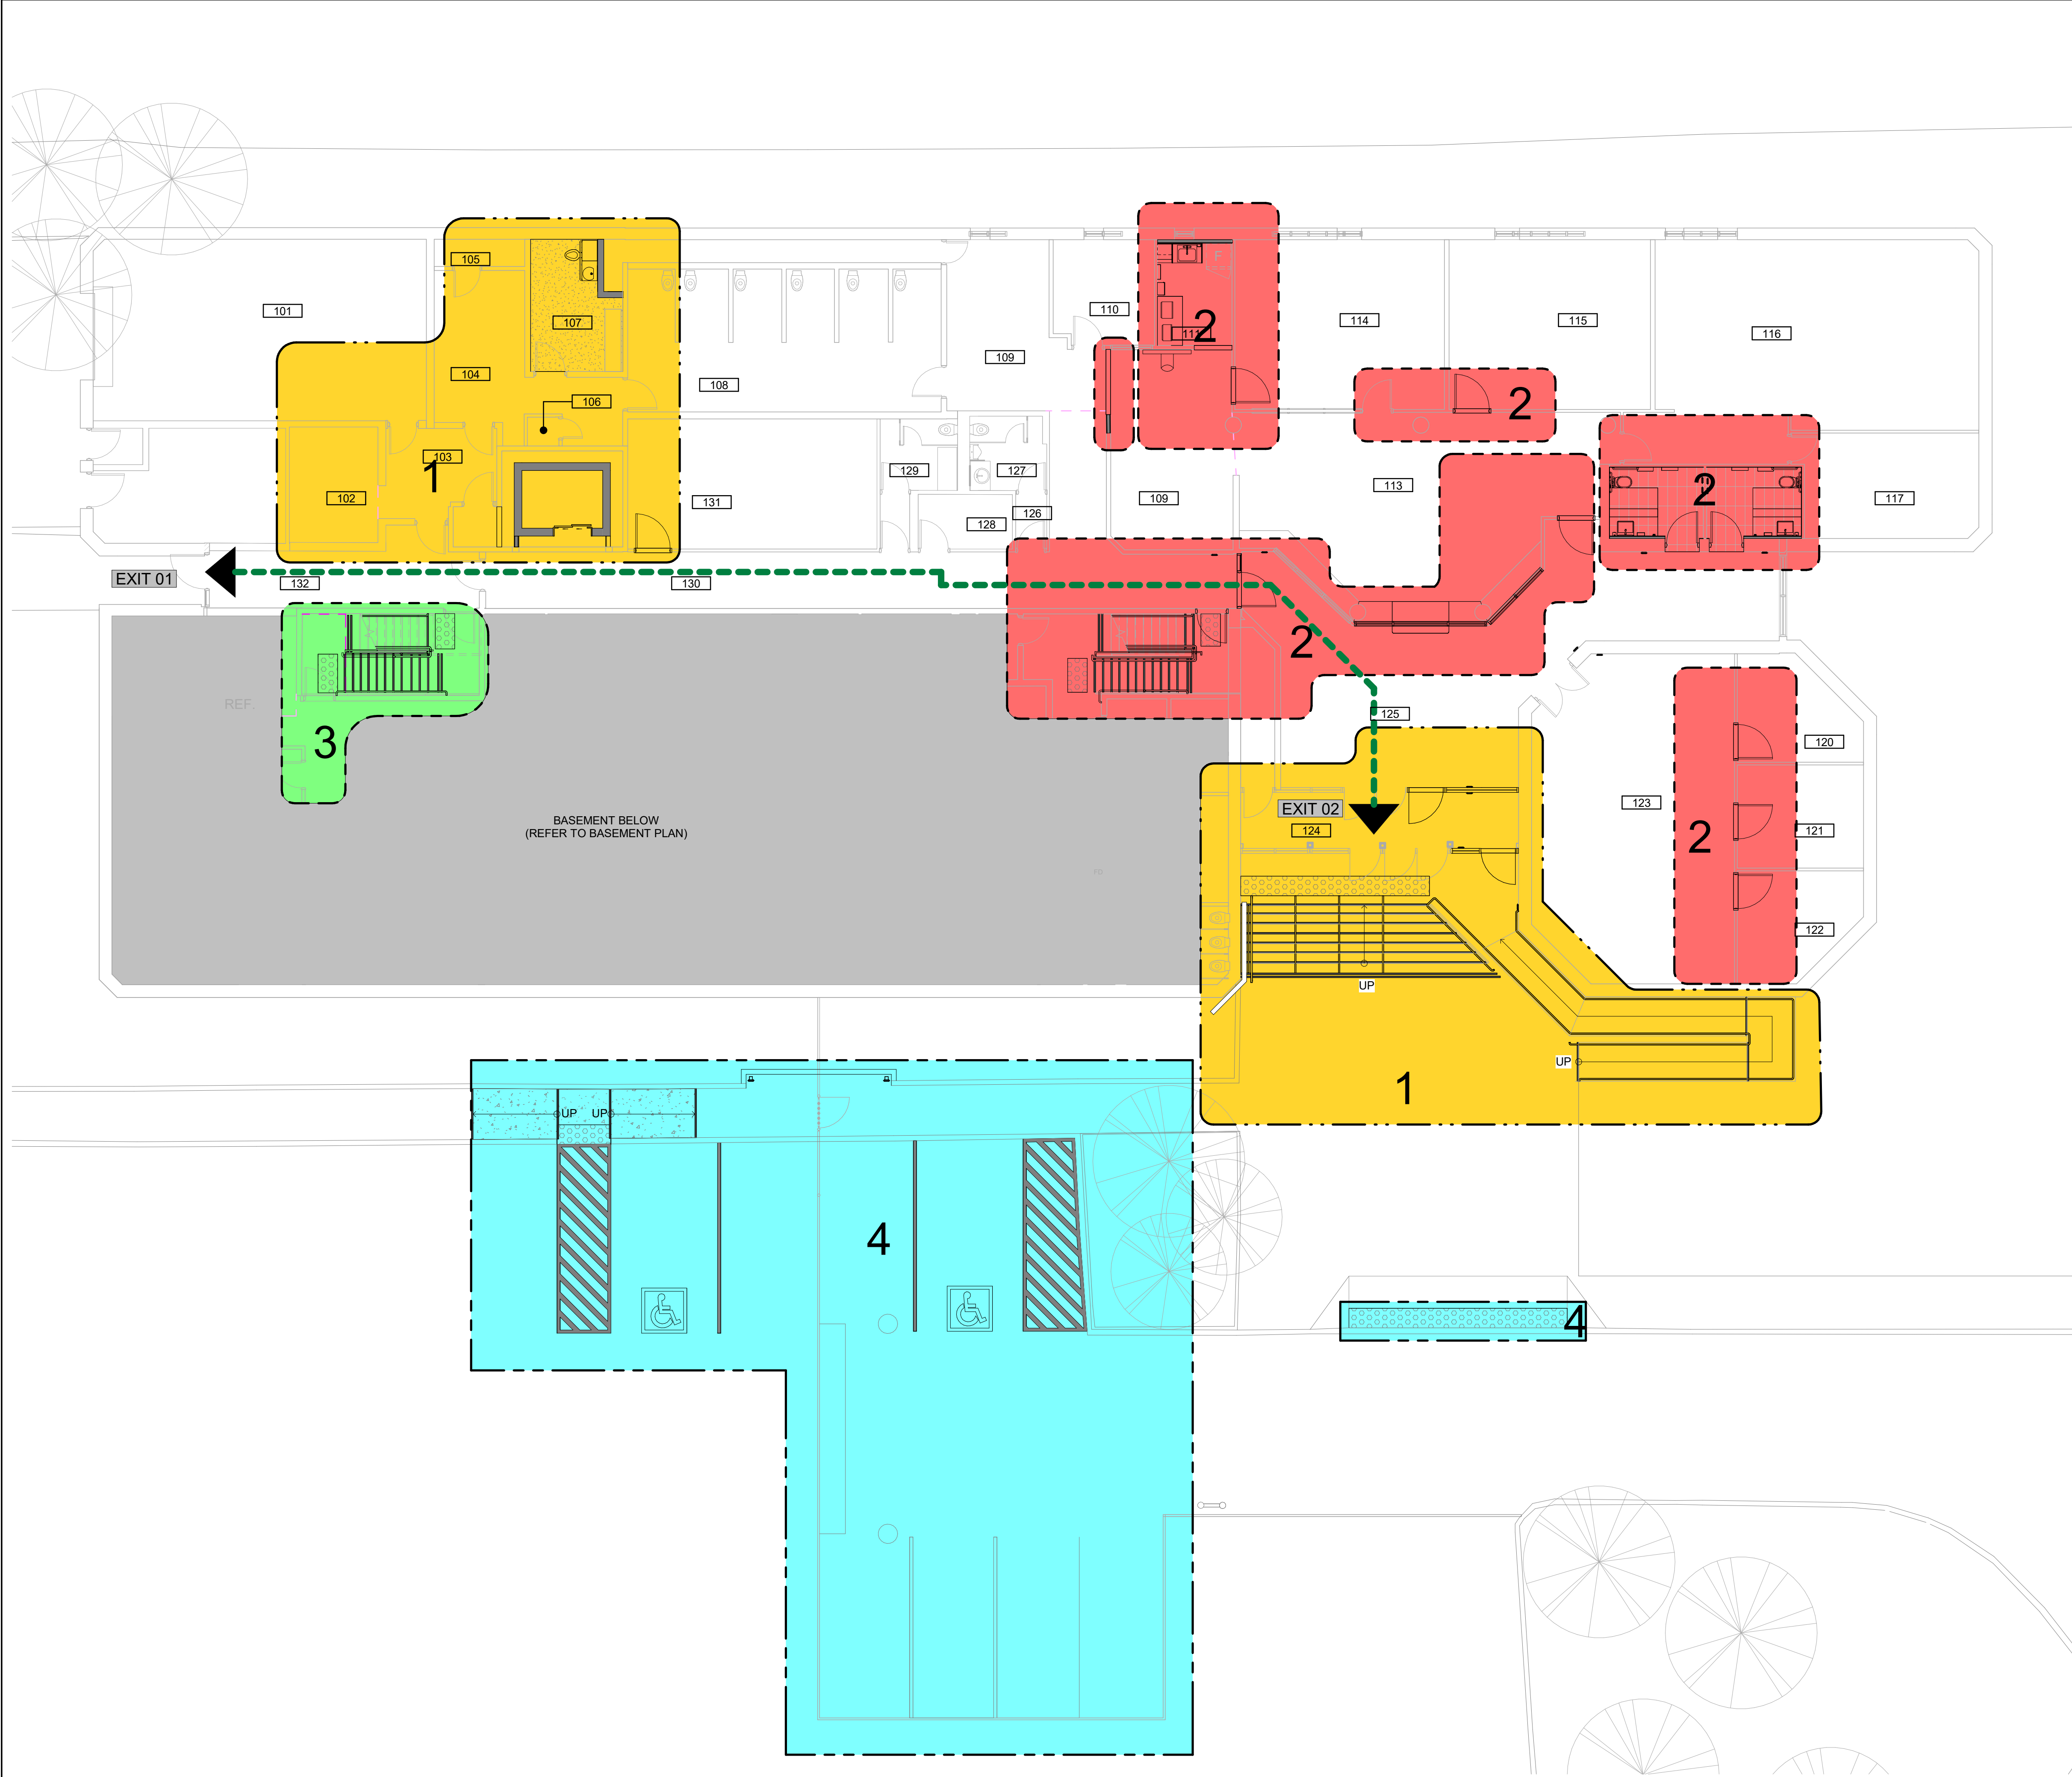

CONSTRUCTION STAGING LEGEND

- STAGE 1
- STAGE 2
- STAGE 3
- STAGE 4
- EMERGENCY EXIT
- TRAVEL PATH

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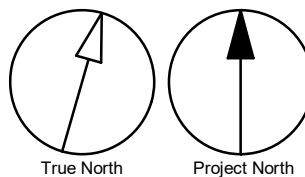
FIRST FLOOR STAGING
PLAN



SHEET NUMBER

G05-249-A2011

ISSUE

D



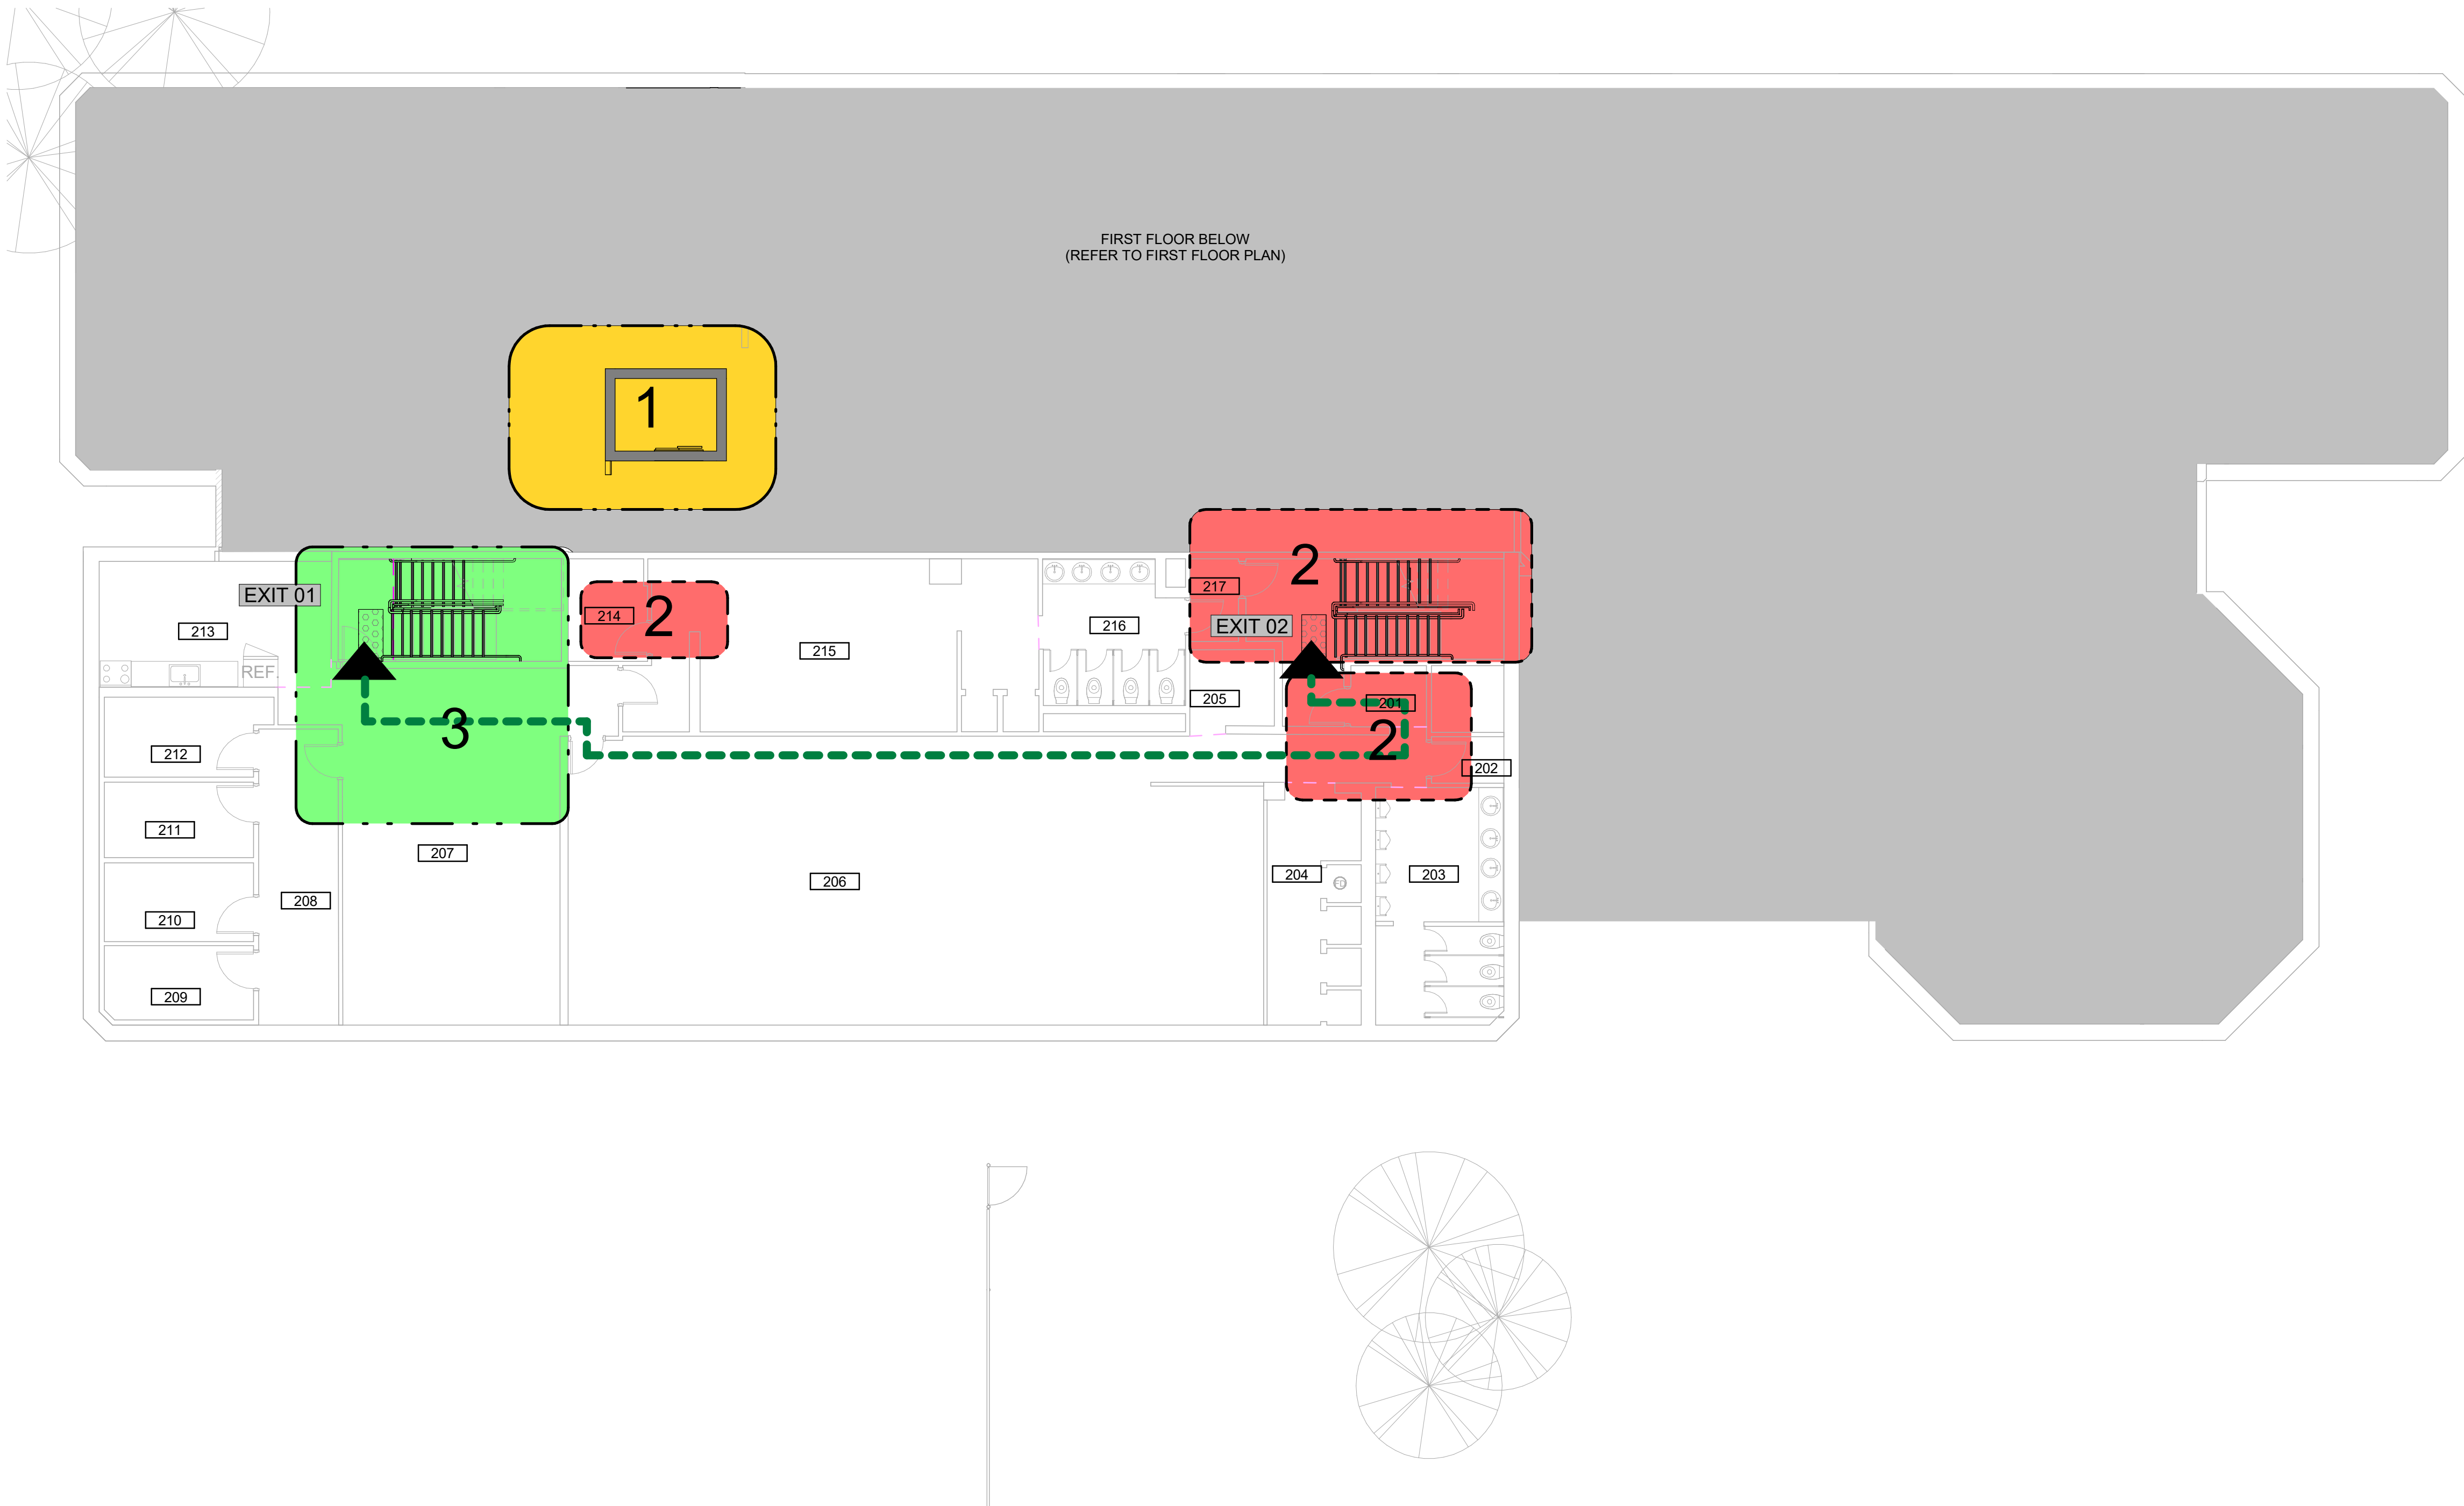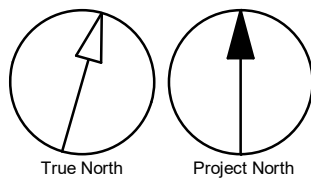

CONSTRUCTION STAGING LEGEND

- STAGE 1
- STAGE 2
- STAGE 3
- STAGE 4
- EMERGENCY EXIT
- TRAVEL PATH

STAGING GENERAL NOTES

- EXISTING FACILITY WILL REMAIN OPERATIONAL DURING CONSTRUCTION. CONSTRUCTION WORKS CANNOT IMPACT FACILITY OPERATION WITHOUT FIRST NOTIFYING AND CONSULTING WITH THE OWNER.
- ALL STAGES ARE TO BE COMPLETED IN SEQUENTIAL ORDER.
- IF AN EXIT WILL BE BLOCKED DUE TO CONSTRUCTION, THE GC IS TO PROVIDE A TEMPORARY EXIT LOCATION THAT IS APPROVED BY THE ARCHITECT AND THE FIRE DEPARTMENT. SHOULD THE WORK BE ABLE TO BE COMPLETED OVER THE COURSE OF A WEEKEND OR AFTER HOURS, THE GC IS TO OBTAIN APPROVAL FROM THE ARCHITECT PRIOR TO PROCEEDING WITH THE WORK.
- IF EXISTING FIRE ALARM SYSTEM NEEDS TO BE TEMPORARILY INTERRUPTED TO COMPLETE THE WORK, A FULL TIME FIRE WATCH SHALL BE PROVIDED.
5. CONTRACTOR SHALL ALLOW FOR THE FOLLOWING:
A) TEMPORARY SIGNAGE
B) TEMPORARY ACCESS WITH ACCESSIBLE RAMPS AS REQUIRED BY ONTARIO REGULATION 191/11 80.13
- ALL STAGING INCLUDES BOTH DEMOLITION AND NEW SCOPE OF WORKS.
- PROVIDE AND MODIFY CONSTRUCTION BARRIER/SIGNAGE ETC. TO SUIT SITE CONDITION AND CONSTRUCTION SEQUENCE.
- WORK LISTED IN STAGES IS FOR REFERENCE ONLY. EACH STAGE MUST BE COMPLETED AS PER CONTRACT DOCUMENTS BEFORE STARTING THE NEXT STAGE AND SHALL NOT AFFECT NORMAL OPERATION OR EXITING OF THE FACILITY.
- FOR ALL OTHER REQUIREMENTS - REFER TO SPECIFICATIONS.
- KEEP EXITS CLEAR FROM OBSTRUCTIONS DURING CONSTRUCTION.

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www.arcadis.com

PROJECT TITLE
CITY OF TORONTO
ACCESSIBILITY UPGRADES

PROJECT ADDRESS

POLICE NO. 33 DIVISION
50 UPJOHN RD

PROJECT NO:
9119-19-0162 / Arcadis 30279056

DRAWN BY: A.Sunil	CHECKED BY: K.Tilahun
PROJECT MGR: F. BOLOURIAN	APPROVED BY: E.Fenuta

SHEET TITLE


SECOND FLOOR
STAGING PLAN

SHEET NUMBER

G05-249-A2021

ISSUE

D

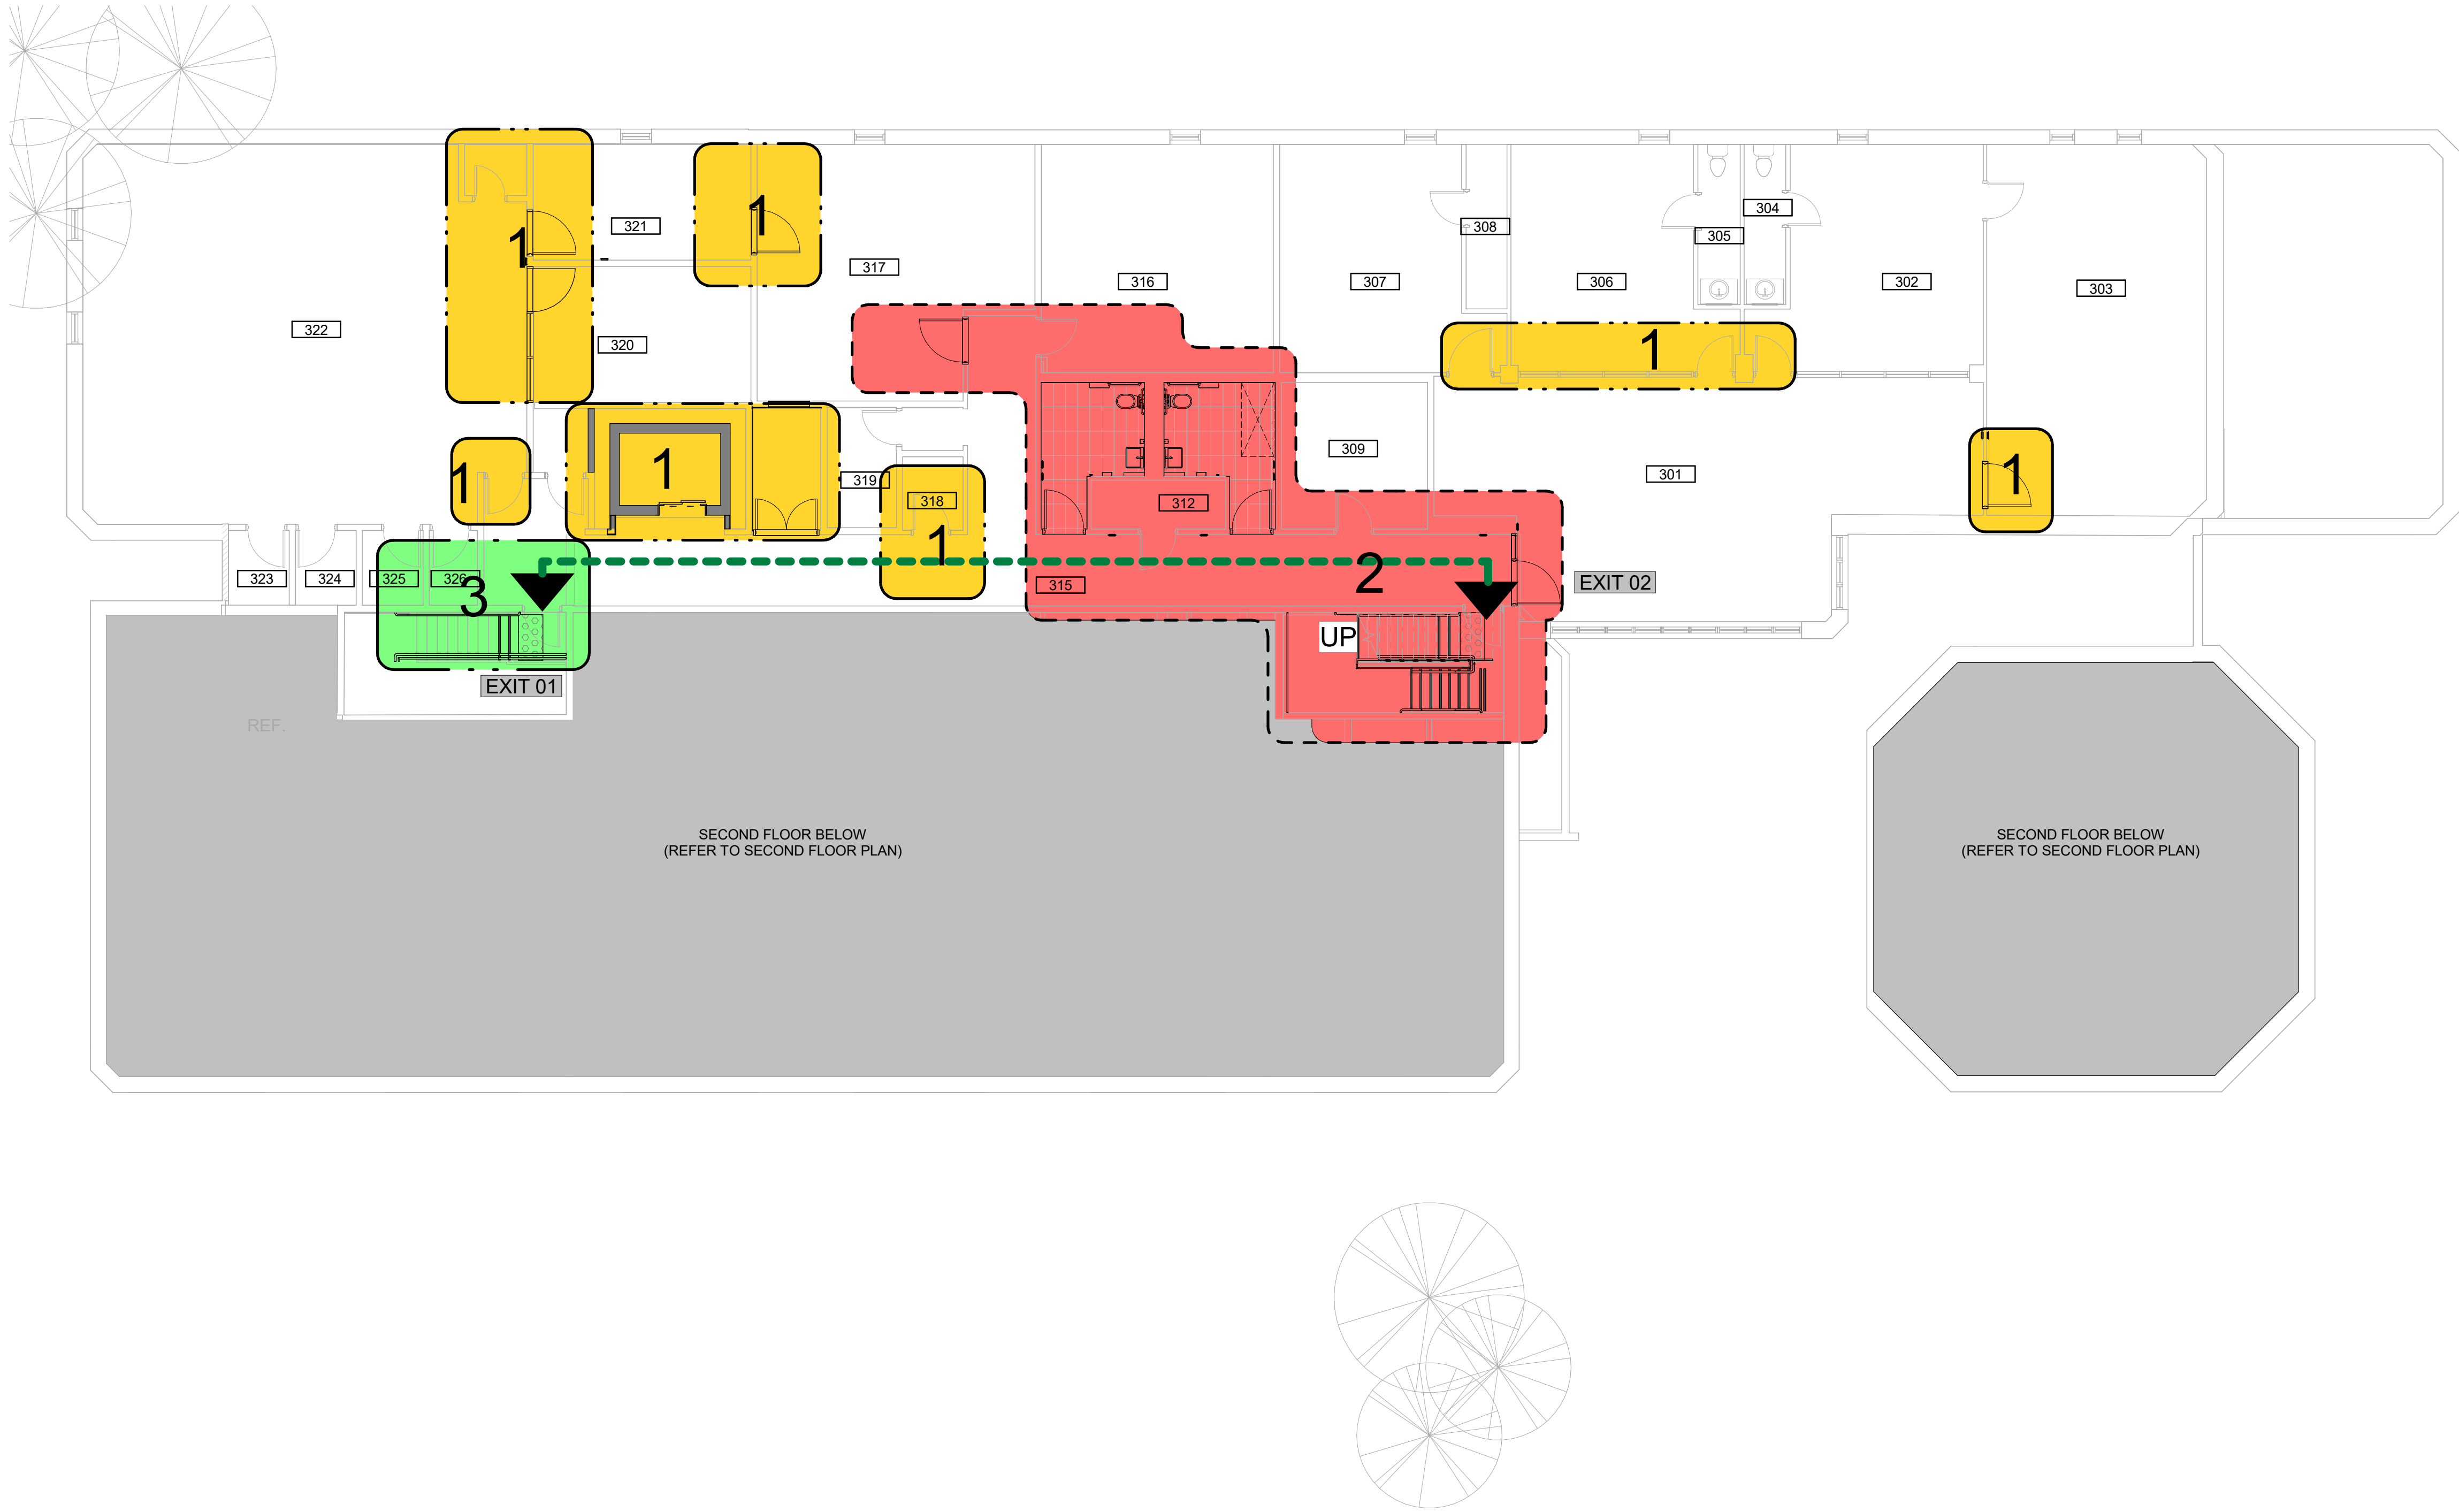

CONSTRUCTION STAGING LEGEND

- STAGE 1
- STAGE 2
- STAGE 3
- STAGE 4
- EMERGENCY EXIT
- TRAVEL PATH

STAGING GENERAL NOTES

- EXISTING FACILITY WILL REMAIN OPERATIONAL DURING CONSTRUCTION. CONSTRUCTION WORKS CANNOT IMPACT FACILITY OPERATION WITHOUT FIRST NOTIFYING AND CONSULTING WITH THE OWNER.
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PROJECT TITLE
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ACCESSIBILITY UPGRADES

PROJECT ADDRESS

POLICE NO. 33 DIVISION
50 UPJOHN RD

PROJECT NO:
9119-19-0162 / Arcadis 30279056

DRAWN BY: A.Sunil	CHECKED BY: K.Tilahun
PROJECT MGR: F. BOLOURIAN	APPROVED BY: E.Fenuta


SHEET TITLE
THIRD FLOOR STAGING
PLAN

SHEET NUMBER

G05-249-A2031

ISSUE

D

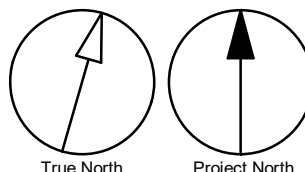



DEMOLITION KEY LEGEND


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- - - - EXISTING INTERIOR PARTITION TO BE DEMOLISHED
- ===== EXISTING EXTERIOR WALL TO REMAIN
- ===== EXISTING PARTITION TO REMAIN
- - - - EXISTING DOOR, FRAME, AND ASSOCIATED HARDWARE TO BE REMOVED
- - - - EXISTING DOOR TO REMAIN
- [Dashed Box] DASHED AREA INDICATES AREA OF WORK

DEMOLITION GENERAL NOTES


No.	Comments
1	REMOVE ALL EXISTING TACTILE SURFACE INDICATORS (WALKING ATTENTION INDICATOR, TEXTURAL WARNING STRIP, NOSING STRIP AND HAZARD STRIP ON HANDRAIL) INCLUDING ADHESIVE MATERIAL AND FASTENING SYSTEM. MAKE GOOD SURFACE TO RECEIVE NEW TACTILE SURFACE INDICATORS IN LOCATIONS SHOWN. INCREASE DEPTH AND EXTENT OF EXISTING FLOOR DEPRESSIONS AND/OR CUT BACK EXISTING FLOOR FINISH AS APPLICABLE TO SUIT THE NEW INSTALLATION.

DEMOLITION KEY NOTES

NO	DESCRIPTION
1	REMOVE EXISTING WALL AND/OR COLUMN ENCLOSURE INCLUDING BUT NOT LIMITED TO TILE, CORNER GUARDS, METAL PANELS, WALL MOUNTED FIXTURES AND FINISHES AS INDICATED. PROVIDE SMOOTH TRANSITION BETWEEN SURFACES AT LOCATION OF DEMOLISHED AREA.
3	REMOVE EXISTING FLOORING AND BASE. REMOVE EXISTING TILE FLOORING TO CLOSEST FULL TILE OR TO EXTENT SHOWN. REPAIR, LEVEL AND CLEAN SURFACE READY TO RECEIVE NEW FLOOR FINISHES. REFER TO FINISH SCHEDULE.
4	REMOVE EXISTING CEILING TO THE EXTENT OF THE PROPOSED ROOM SIZE.
5	REMOVE EXISTING DOOR AND FRAME. CUT PARTITION TO ACCOMMODATE NEW DOOR AND FRAME. REPAIR ADJACENT AFFECTED WALL SURFACES. REFER TO DETAIL D1002 AND D102300.
6	REMOVE EXISTING PLUMBING FIXTURES AND WASHROOM ACCESSORIES, CAP PLUMBING PIPES.
9	REPAIR EXISTING WALL. PATCH AND MAKE GOOD ALL ADJACENT SURFACES DAMAGED DURING CONSTRUCTION.
10	REMOVE EXISTING DOOR HARDWARE AS INDICATED IN DOOR SCHEDULE A9001 AND HARDWARE SCHEDULE WITHIN SPECIFICATIONS.
11	REMOVE EXISTING GUARDRAIL, HANDRAIL AND/OR HANDRAIL POST BASE. REPAIR AND MAKE GOOD ALL SURFACES.
25	DEMOLISH EXISTING CONCRETE STAIR OR RAMP. REMOVE DEBRIS AND PREPARE FOR NEW STAIR OR RAMP. PROVIDE SMOOTH TRANSITION BETWEEN SURFACES AND PROTECT SURROUNDING AREAS DURING THE WORK.
27	REMOVE EXISTING WALL TILE. REPAIR, LEVEL AND CLEAN SURFACE READY TO RECEIVE NEW WALL TILE. REFER TO FINISH SCHEDULE.
30	REMOVE CURTAIN WALL, GLAZING, EXTERIOR DOOR AND HARDWARE.
31	REMOVE EXISTING DOOR, WINDOW AND FRAME TO ACCOMMODATE NEW.

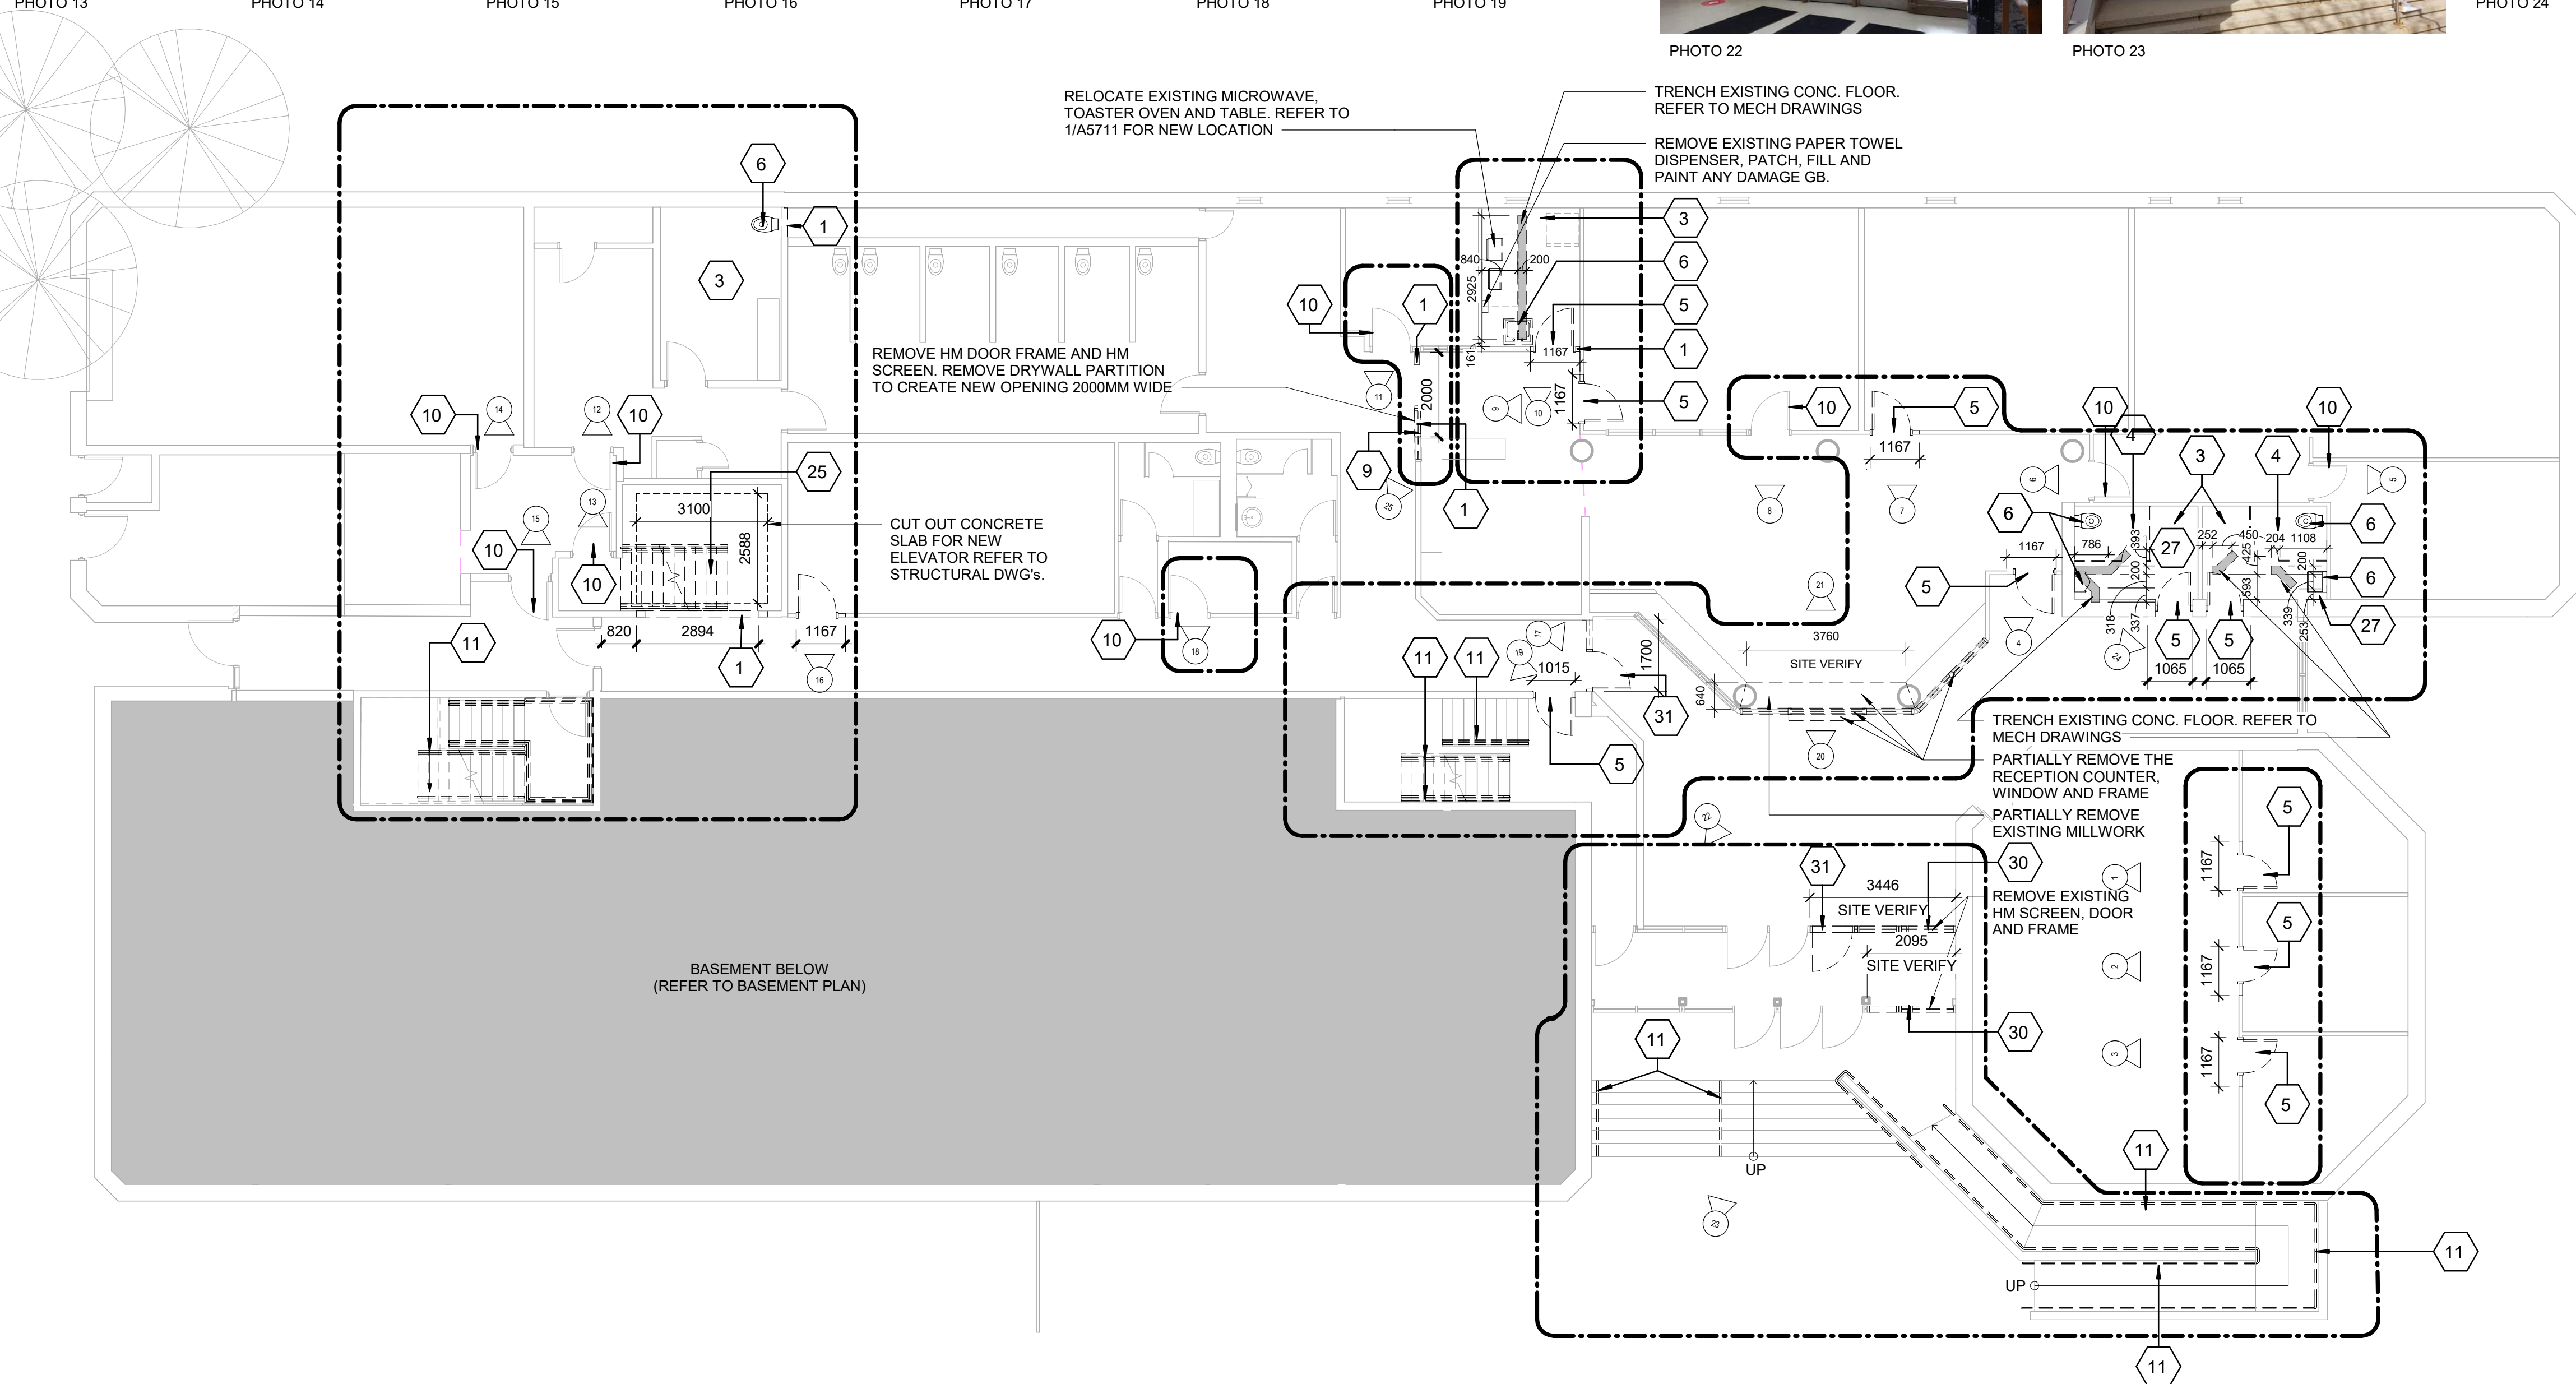

Scale 1:100

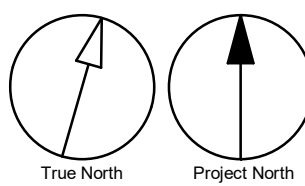

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tel 416 679 1930
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PROJECT TITLE

**CITY OF TORONTO
ACCESSIBILITY UPGRADES**

PROJECT ADDRESS

**POLICE NO. 33 DIVISION
50 UPJOHN RD**

PROJECT NO:
9119-19-0162 / Arcadis 30279056

DRAWN BY: A.Sunil	CHECKED BY: K.Tilahun
PROJECT MGR: F. BOLOURIAN	APPROVED BY: E.Fenuta

SHEET TITLE

**FIRST FLOOR
DEMOLITION PLAN**

SHEET NUMBER G05-249-A2111	ISSUE D
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PHOTO 12

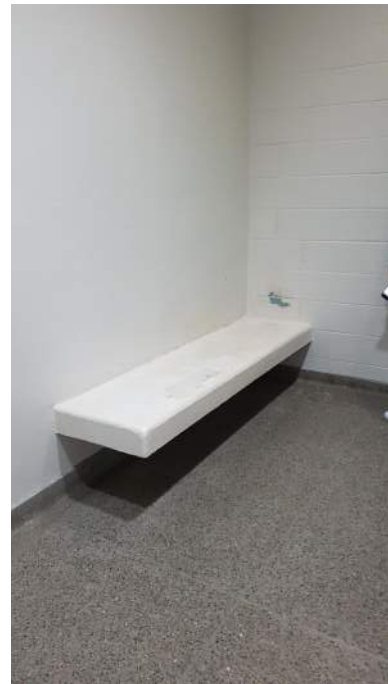


PHOTO 13



PHOTO 14



PHOTO 15



PHOTO 16



PHOTO 17



PHOTO 18



PHOTO 20



PHOTO 22



PHOTO 19



PHOTO 21




PHOTO 23



PHOTO 24



PHOTO 25

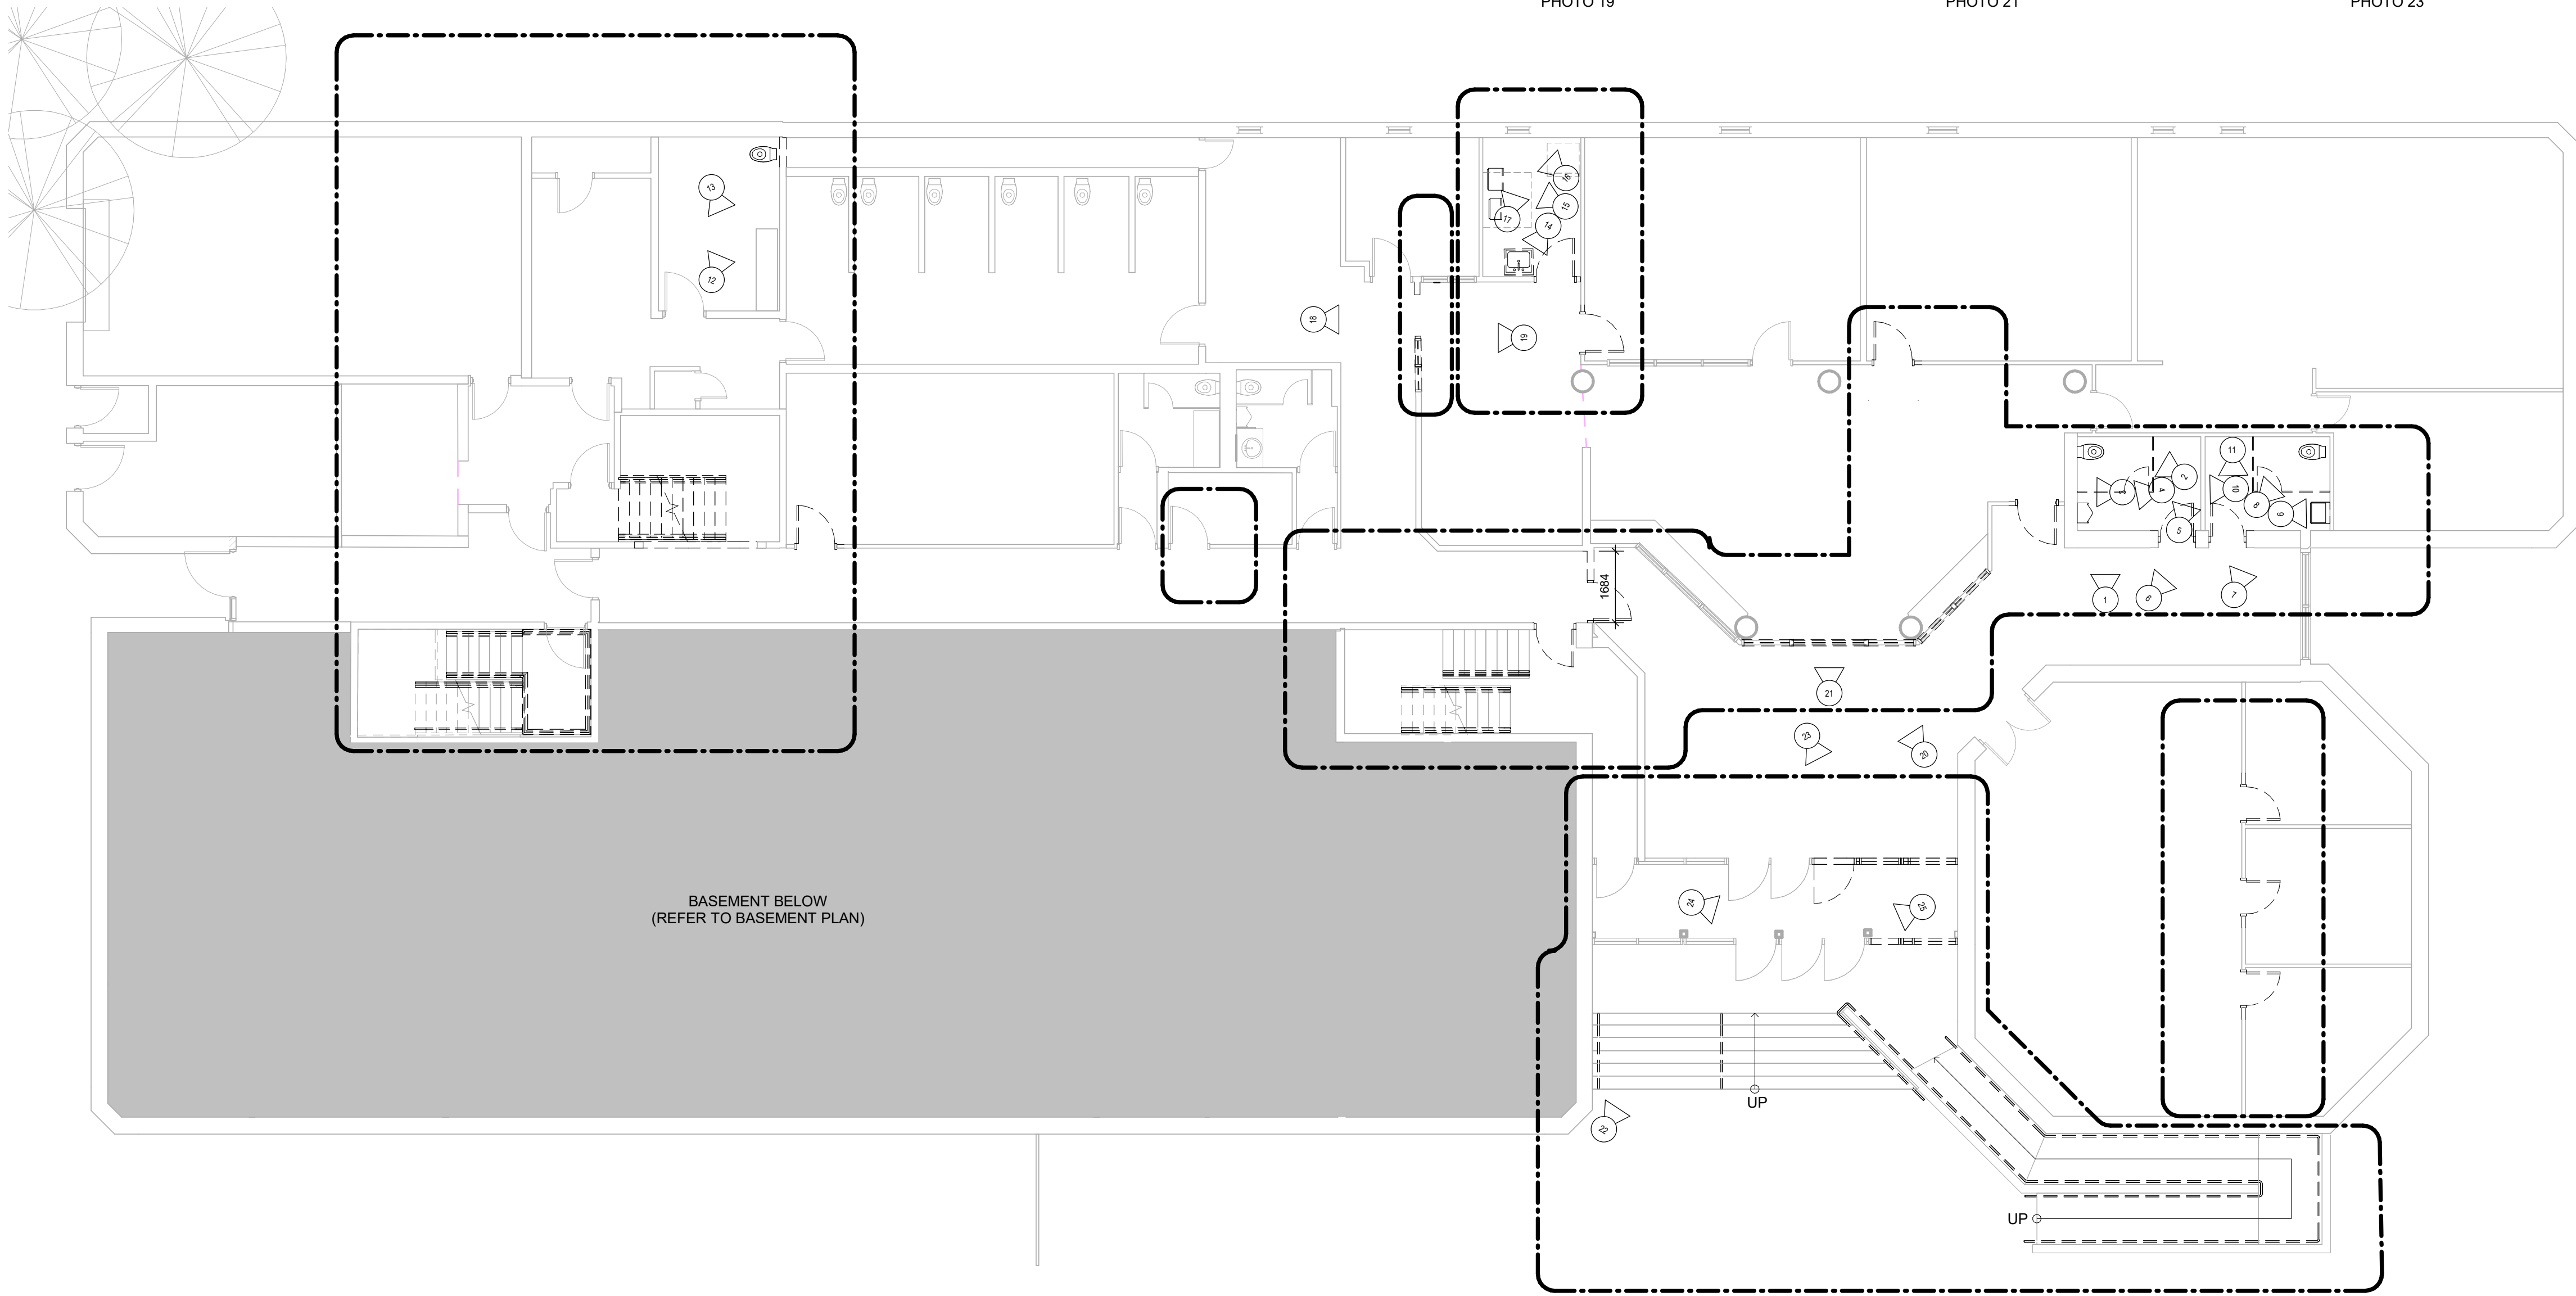

DEMOLITION KEY LEGEND

- EXISTING TO BE DEMOLISHED
- - - - - EXISTING INTERIOR PARTITION TO BE DEMOLISHED
- ===== EXISTING EXTERIOR WALL TO REMAIN
- ===== EXISTING PARTITION TO REMAIN
- - - - - EXISTING DOOR, FRAME, AND ASSOCIATED HARDWARE TO BE REMOVED
- - - - - EXISTING DOOR TO REMAIN
- [Dashed Area] DASHED AREA INDICATES AREA OF WORK

DEMOLITION GENERAL NOTES

1	Comments
1	REMOVE ALL EXISTING TACTILE SURFACE INDICATORS (WALKING ATTENTION INDICATOR, TEXTURAL WARNING STRIP, NOSING STRIP AND HAZARD STRIP ON HANDRAIL) INCLUDING ADHESIVE MATERIAL AND FASTENING SYSTEM. MAKE GOOD SURFACE TO RECEIVE NEW TACTILE SURFACE INDICATORS IN LOCATIONS SHOWN. INCREASE DEPTH AND EXTENT OF EXISTING FLOOR DEPRESSIONS AND/OR CUT BACK EXISTING FLOOR FINISH AS APPLICABLE TO SUIT THE NEW INSTALLATION.



PHOTO 1



PHOTO 2



PHOTO 3



PHOTO 4



PHOTO 5



PHOTO 6



PHOTO 7



PHOTO 8



PHOTO 9




PHOTO 10



PHOTO 11

Scale 1:100

0 2.5 5 10 m

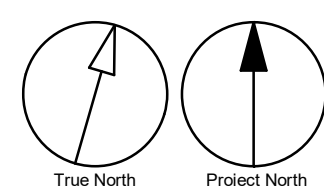

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PROJECT TITLE
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ACCESSIBILITY UPGRADES**

PROJECT ADDRESS

**POLICE NO. 33 DIVISION
50 UPJOHN RD**

PROJECT NO:
9119-19-0162 / Arcadis 30279056

DRAWN BY:
Author

CHECKED BY:
Checker

PROJECT MGR:
F. BOLOURIAN

APPROVED BY:
Approver

SHEET TITLE

**FIRST FLOOR
DEMOLITION PLAN -
PHOTOGRAPHS**

SHEET NUMBER

G05-249-A2112

ISSUE

D

4/9/2025 4:05:07 PM



PHOTO 1


PHOTO 2

PHOTO 3

PHOTO 4

PHOTO 5

PHOTO 6

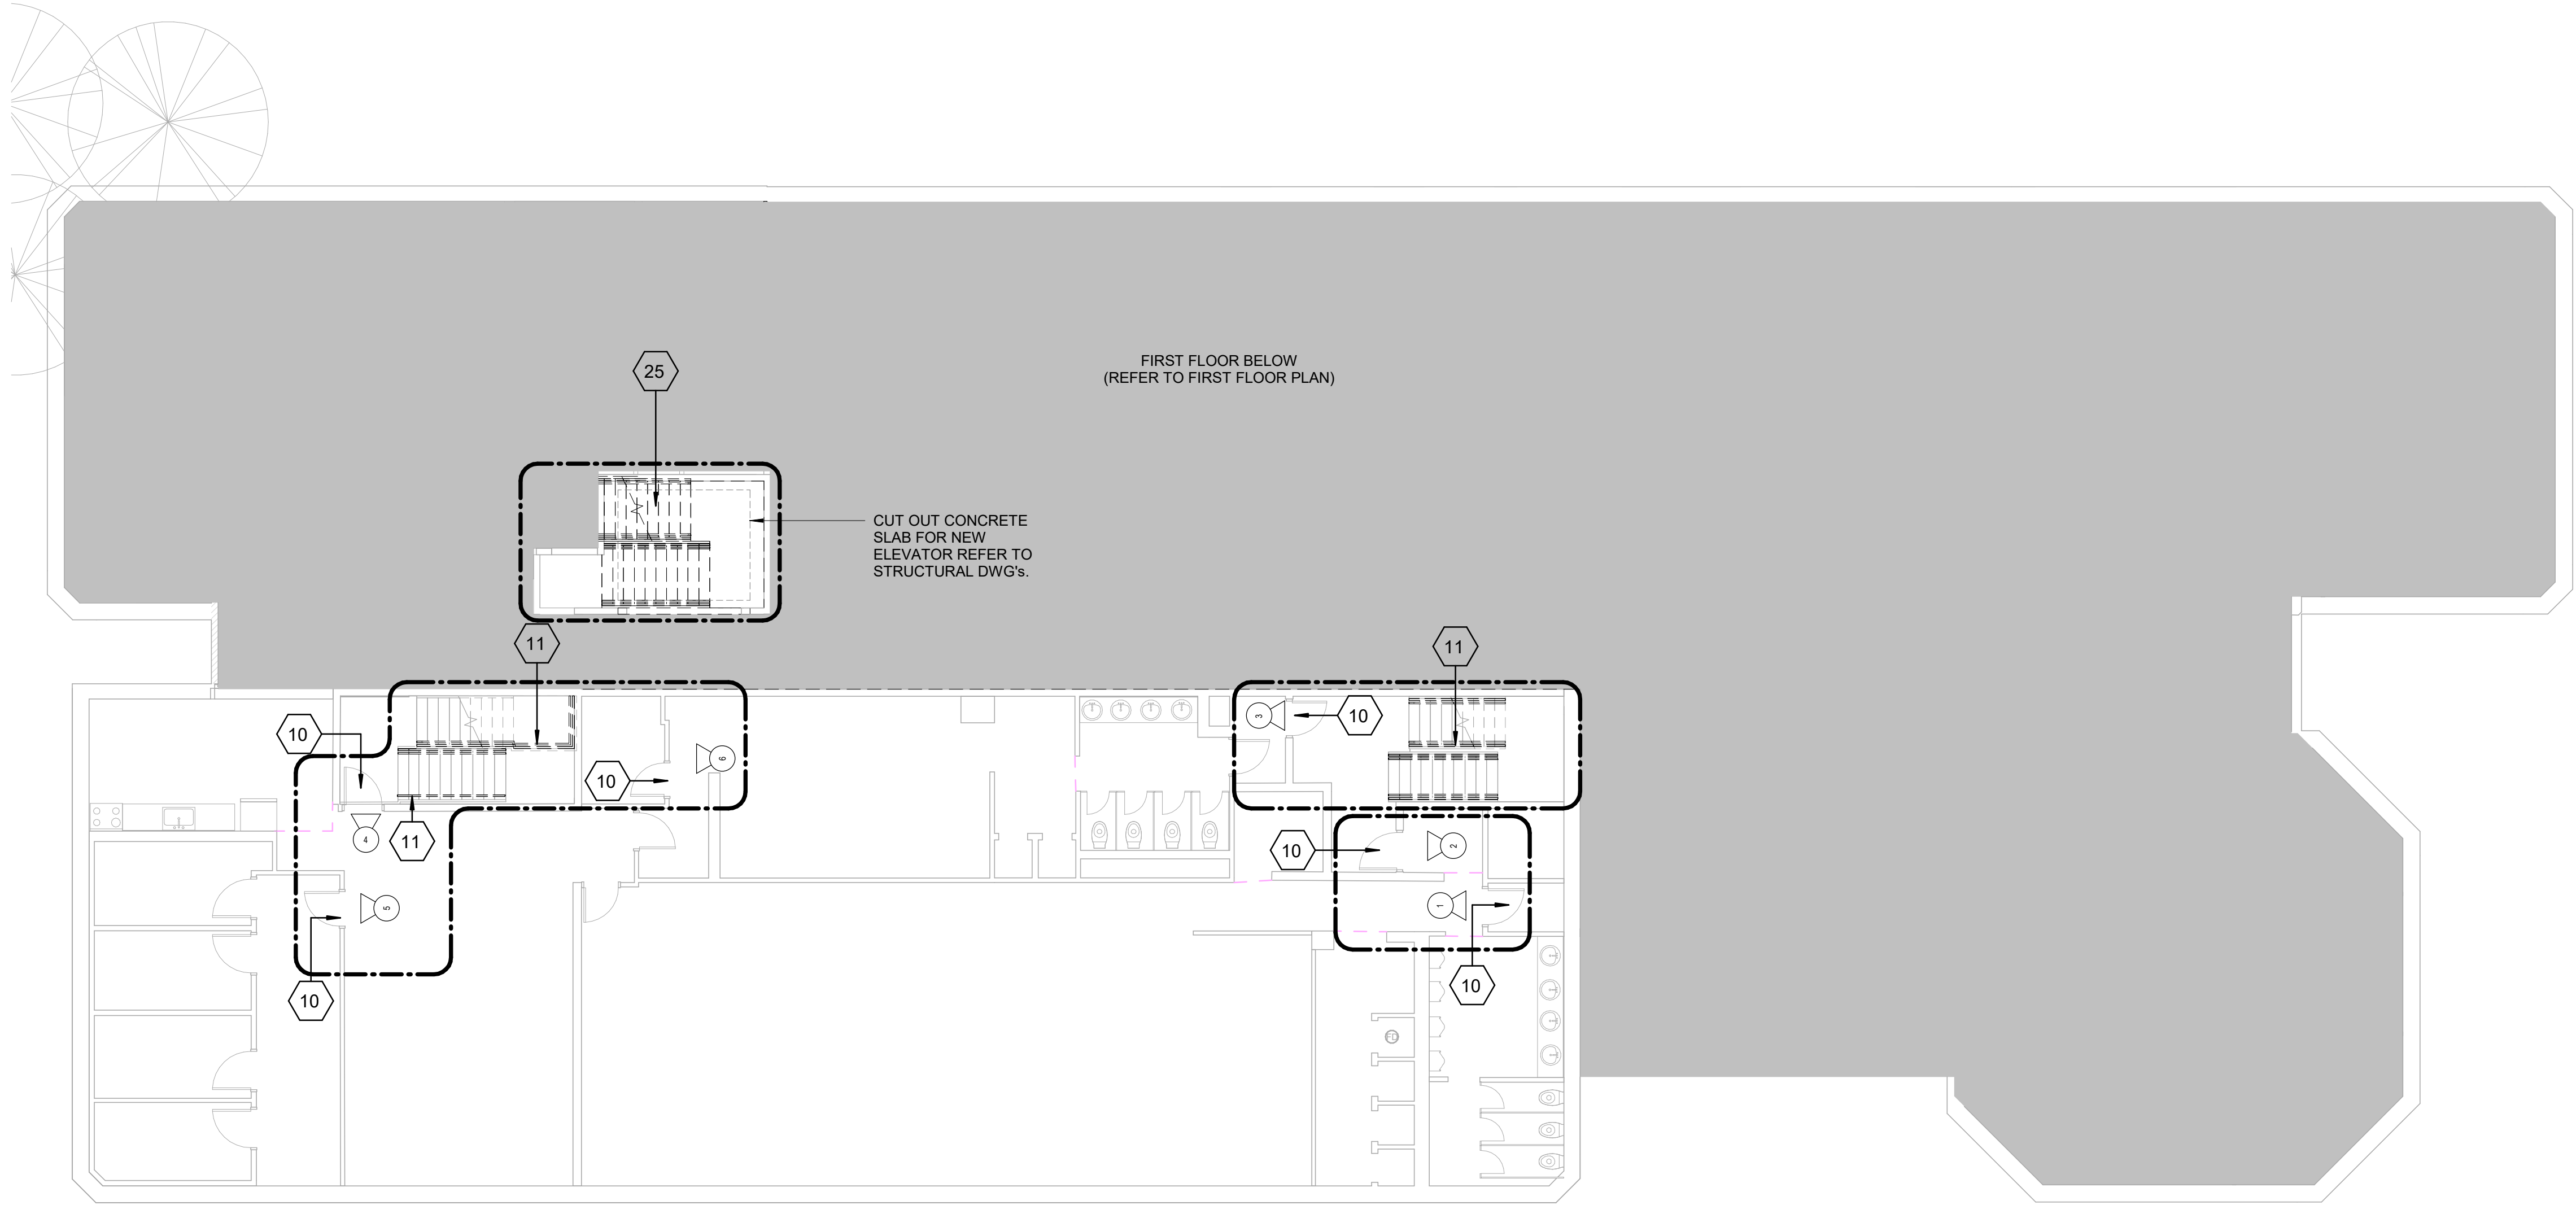

DEMOLITION KEY LEGEND

- EXISTING TO BE DEMOLISHED
- - - - - EXISTING INTERIOR PARTITION TO BE DEMOLISHED
- ===== EXISTING EXTERIOR WALL TO REMAIN
- ===== EXISTING PARTITION TO REMAIN
- [Dashed Arc] EXISTING DOOR, FRAME, AND ASSOCIATED HARDWARE TO BE REMOVED
- [Solid Arc] EXISTING DOOR TO REMAIN
- [Dashed Box] DASHED AREA INDICATES AREA OF WORK

DEMOLITION GENERAL NOTES


No.	Comments
1	REMOVE ALL EXISTING TACTILE SURFACE INDICATORS (WALKING ATTENTION INDICATOR, TEXTURAL WARNING STRIP, NOSING STRIP AND HAZARD STRIP ON HANDRAIL) INCLUDING ADHESIVE MATERIAL AND FASTENING SYSTEM. MAKE GOOD SURFACE TO RECEIVE NEW TACTILE SURFACE INDICATORS IN LOCATIONS SHOWN. INCREASE DEPTH AND EXTENT OF EXISTING FLOOR DEPRESSIONS AND/OR CUT BACK EXISTING FLOOR FINISH AS APPLICABLE TO SUIT THE NEW INSTALLATION.

DEMOLITION KEY NOTES

NO	DESCRIPTION
10	REMOVE EXISTING DOOR HARDWARE AS INDICATED IN DOOR SCHEDULE A9001 AND HARDWARE SCHEDULE WITHIN SPECIFICATIONS.
11	REMOVE EXISTING GUARDRAIL, HANDRAIL AND/OR HANDRAIL POST BASE. REPAIR AND MAKE GOOD ALL SURFACES.
25	DEMOLISH EXISTING CONCRETE STAIR OR RAMP. REMOVE DEBRIS AND PREPARE FOR NEW STAIR OR RAMP. PROVIDE SMOOTH TRANSITION BETWEEN SURFACES AND PROTECT SURROUNDING AREAS DURING THE WORK.

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
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PROJECT ADDRESS

POLICE NO. 33 DIVISION
50 UPJOHN RD

PROJECT NO:

9119-19-0162 / Arcadis 30279056

DRAWN BY:

A.Sunil

CHECKED BY:

K.Tilahun

PROJECT MGR:

F. BOLOURIAN

APPROVED BY:

E.Fenuta

SHEET TITLE


SECOND FLOOR
DEMOLITION PLAN

SHEET NUMBER

G05-249-A2121

ISSUE

D

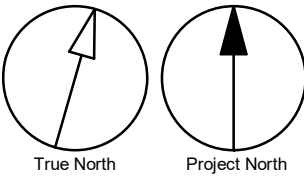

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PHOTO 8

PHOTO 9

PHOTO 10

PHOTO 11

PHOTO 12

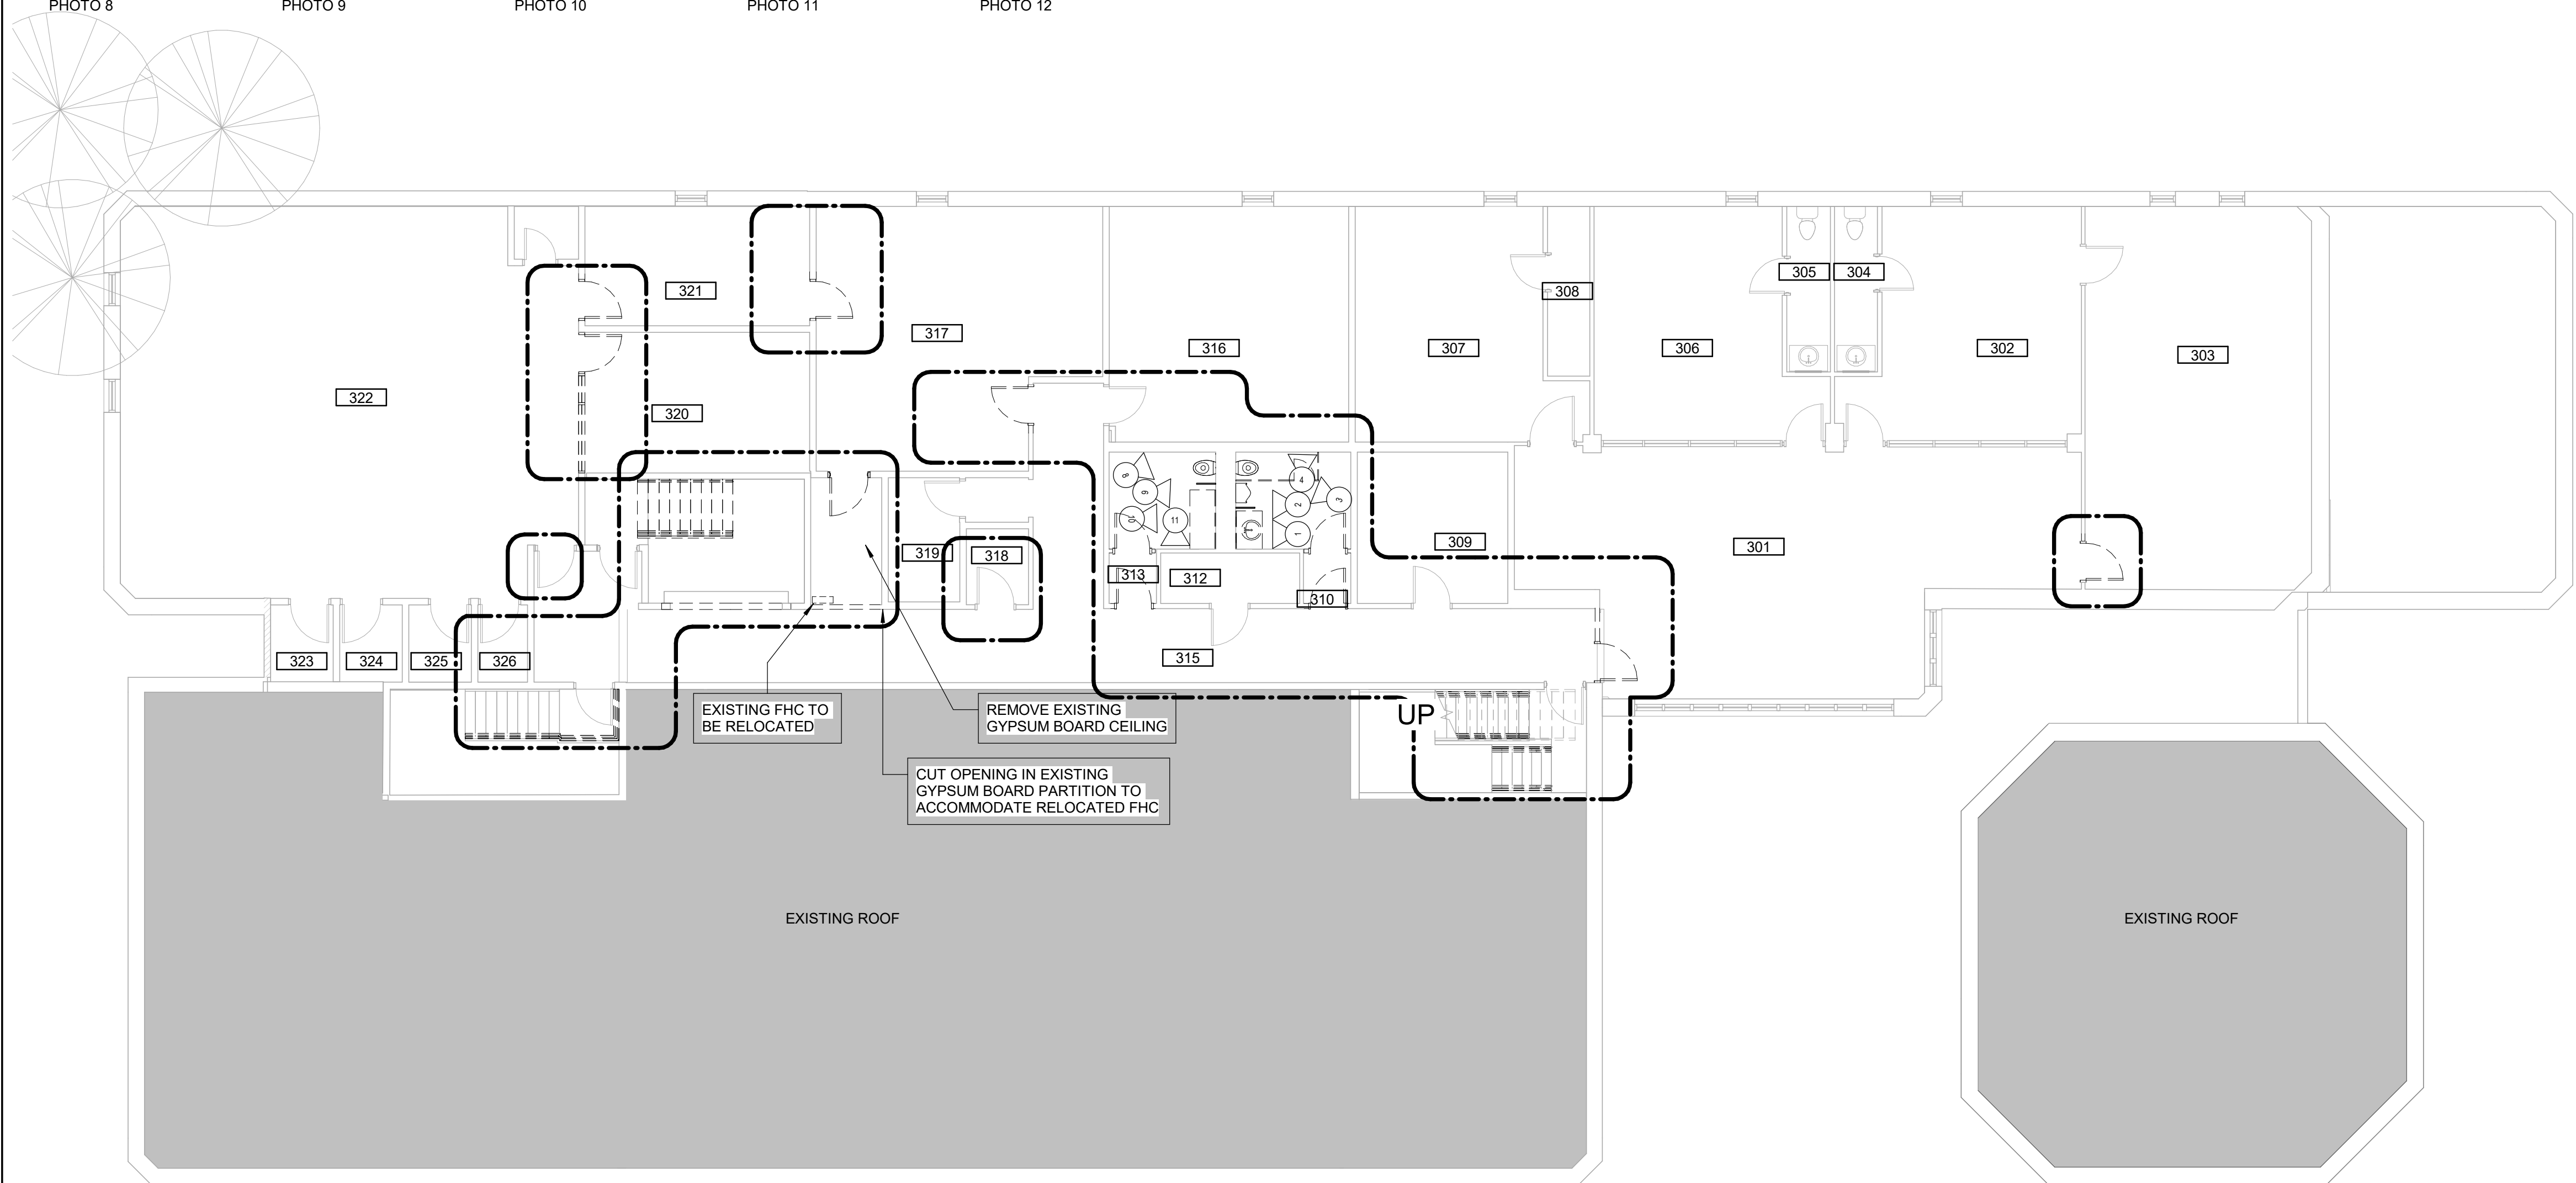


PHOTO 1

PHOTO 2

PHOTO 3


PHOTO 4

PHOTO 5

PHOTO 6



PHOTO 7

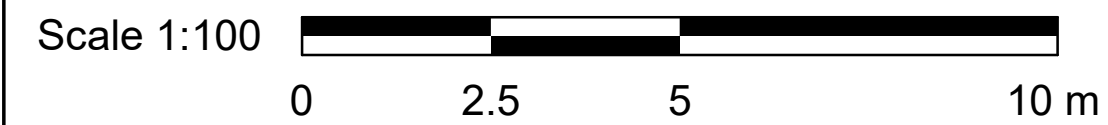

DEMOLITION KEY LEGEND

- EXISTING TO BE DEMOLISHED
- - - - - EXISTING INTERIOR PARTITION TO BE DEMOLISHED
- ===== EXISTING EXTERIOR WALL TO REMAIN
- ===== EXISTING PARTITION TO REMAIN
- - - - - EXISTING DOOR, FRAME, AND ASSOCIATED HARDWARE TO BE REMOVED
- - - - - EXISTING DOOR TO REMAIN
- [Dashed Area] DASHED AREA INDICATES AREA OF WORK

DEMOLITION GENERAL NOTES

- | No. | Comments |
|-----|---|
| 1 | REMOVE ALL EXISTING TACTILE SURFACE INDICATORS (WALKING ATTENTION INDICATOR, TEXTURAL WARNING STRIP, NOSING STRIP AND HAZARD STRIP ON HANDRAIL) INCLUDING ADHESIVE MATERIAL AND FASTENING SYSTEM. MAKE GOOD SURFACE TO RECEIVE NEW TACTILE SURFACE INDICATORS IN LOCATIONS SHOWN. INCREASE DEPTH AND EXTENT OF EXISTING FLOOR DEPRESSIONS AND/OR CUT BACK EXISTING FLOOR FINISH AS APPLICABLE TO SUIT THE NEW INSTALLATION. |

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ACCESSIBILITY UPGRADES**

PROJECT ADDRESS

**POLICE NO. 33 DIVISION
50 UPJOHN RD**

PROJECT NO:
9119-19-0162 / Arcadis 30279056

DRAWN BY:
Author

CHECKED BY:
Checker

PROJECT MGR:
F. BOLOURIAN

APPROVED BY:
Approver

SHEET TITLE


**THIRD FLOOR
DEMOLITION PLAN -
PHOTOGRAPHS**


SHEET NUMBER

G05-249-A2132

ISSUE

D

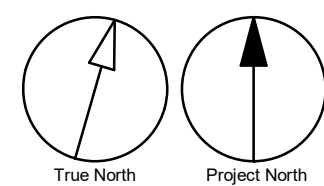

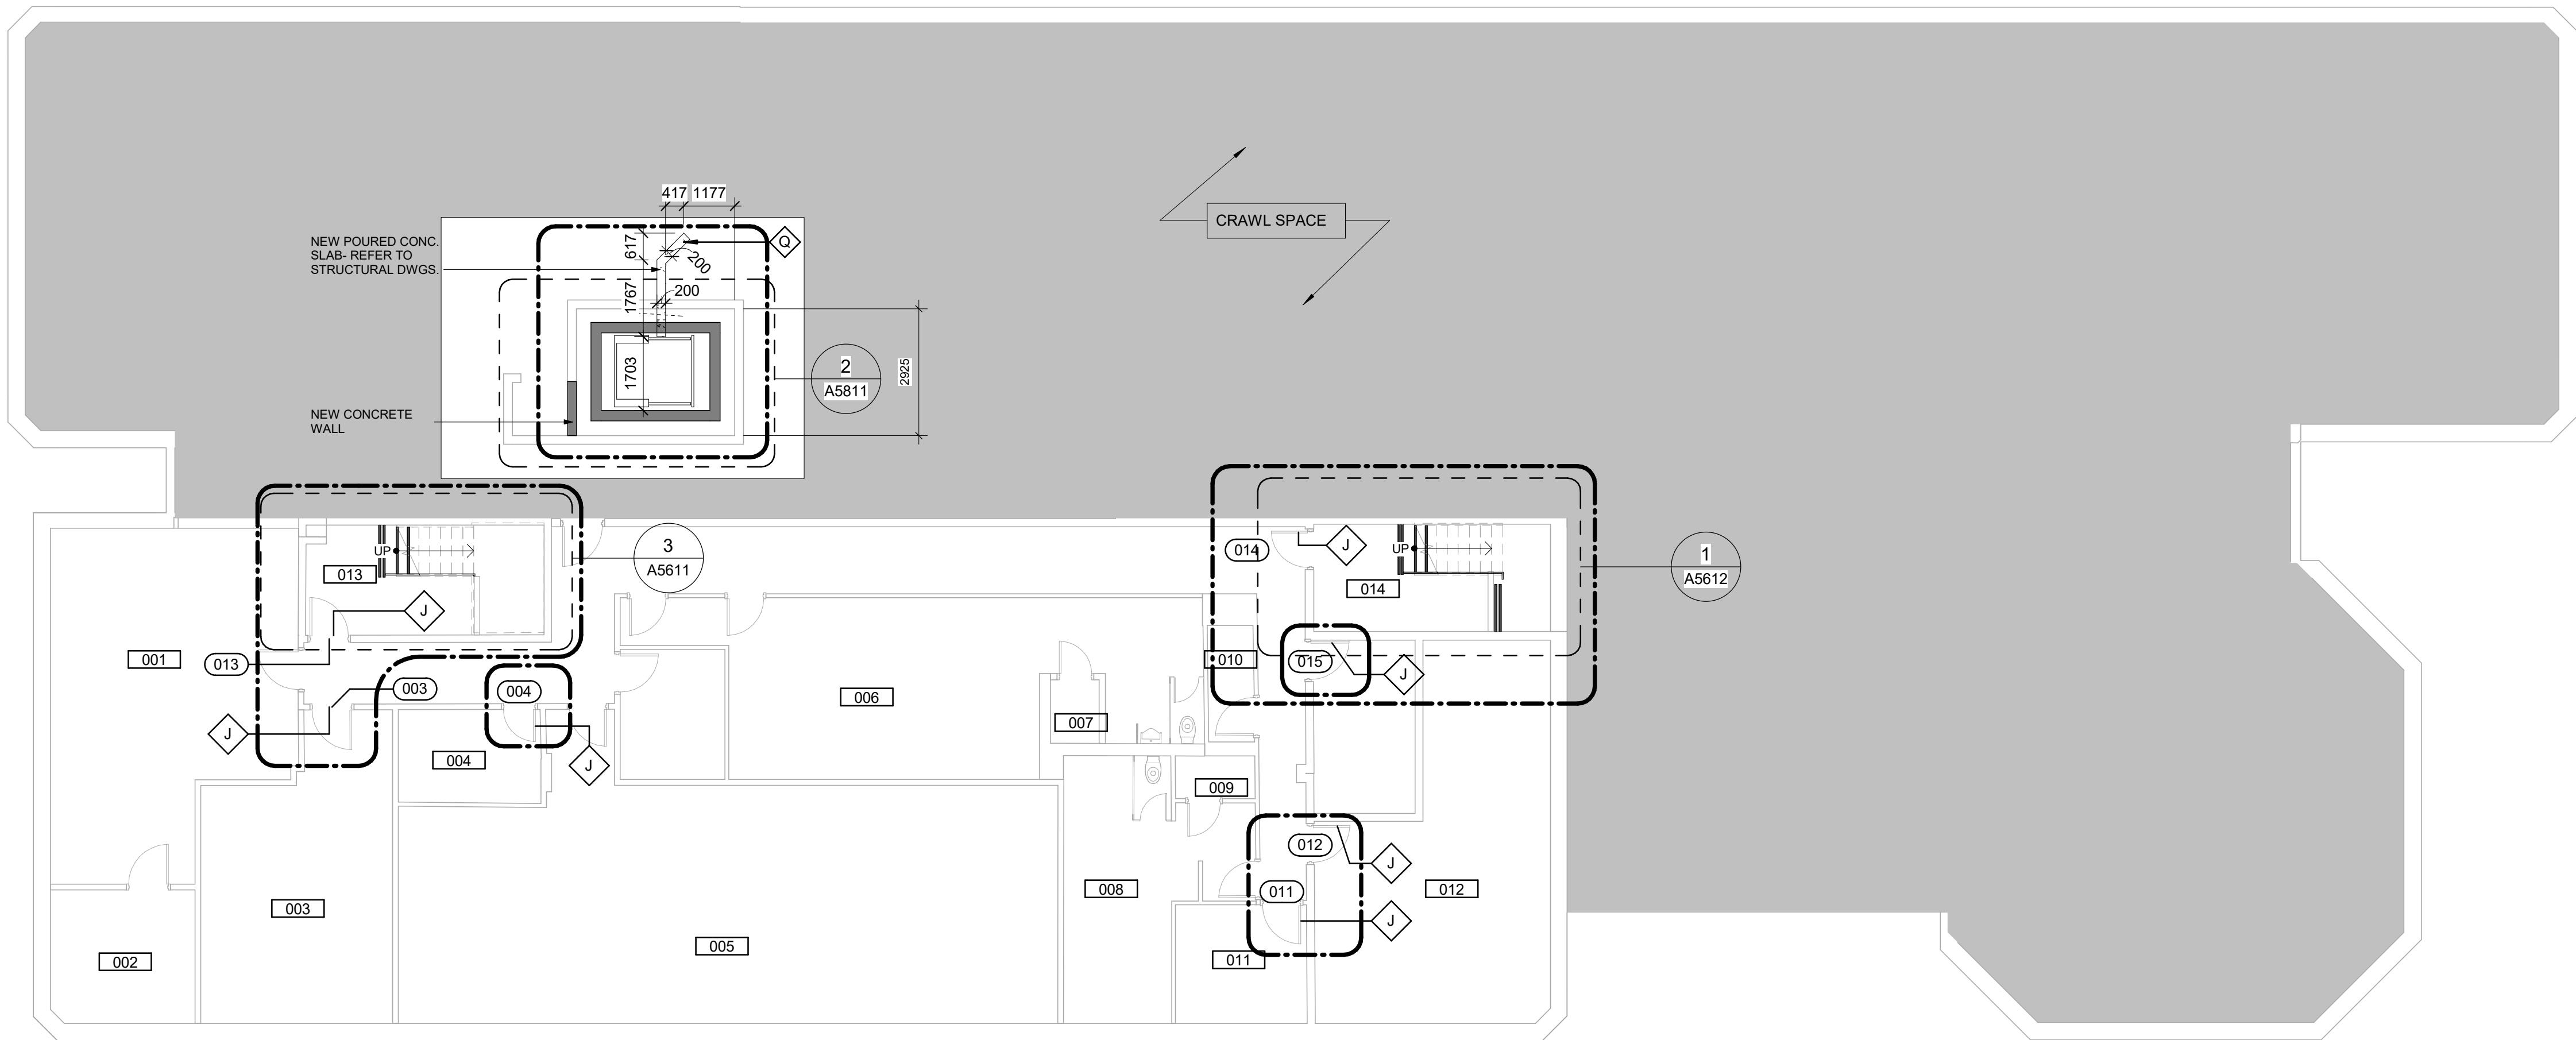

CONSTRUCTION KEY LEGEND

- EXISTING EXTERIOR WALL TO REMAIN
- EXISTING PARTITION TO REMAIN
- NEW EXTERIOR WALL REFER TO WALL SCHEDULE
- NEW PARTITION REFER TO PARTITION SCHEDULE
- EXISTING DOOR TO REMAIN
- NEW DOOR AND/ OR NEW HARDWARE
- DASHED AREA INDICATES AREA OF WORK

CONSTRUCTION GENERAL NOTES

- NEW DOOR CARD READER AND BARRIER FREE PUSH BUTTON - REFER TO ELECTRICAL DRAWINGS. FOR LOCATION AND HEIGHT INSTALLATION REFER TO ARCHITECTURAL DETAIL BOOKLET.
- REPAINT ENTIRE WALL AFTER WALL-MOUNTED HANDRAIL REPLACEMENT - UNLESS OTHERWISE NOTED. COLOUR AND FINISH TO MATCH EXISTING

CONSTRUCTION KEY NOTES

- | NO | DESCRIPTION |
|----|--|
| J | EXISTING DOOR TO REMAIN. DOOR HARDWARE TO BE CHANGED AS PER DOOR SCHEDULE ON A5001 AND DOOR HARDWARE SCHEDULE IN THE SPECIFICATIONS. |
| Q | PATCH, REPAIR AND MAKE GOOD EXISTING FLOOR SLAB. |

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Toronto, ON M9W 0C9, Canada
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www.arcadis.com

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A.Sunil

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K.Tilahun

PROJECT MGR:
F. BOLOURIAN

APPROVED BY:
E.Fenuta

SHEET TITLE


BASEMENT PROPOSED
PLAN

SHEET NUMBER


G05-249-A2401

ISSUE

D

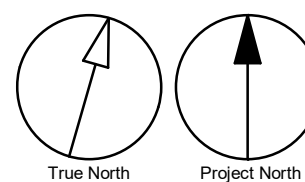

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CONSTRUCTION KEY LEGEND

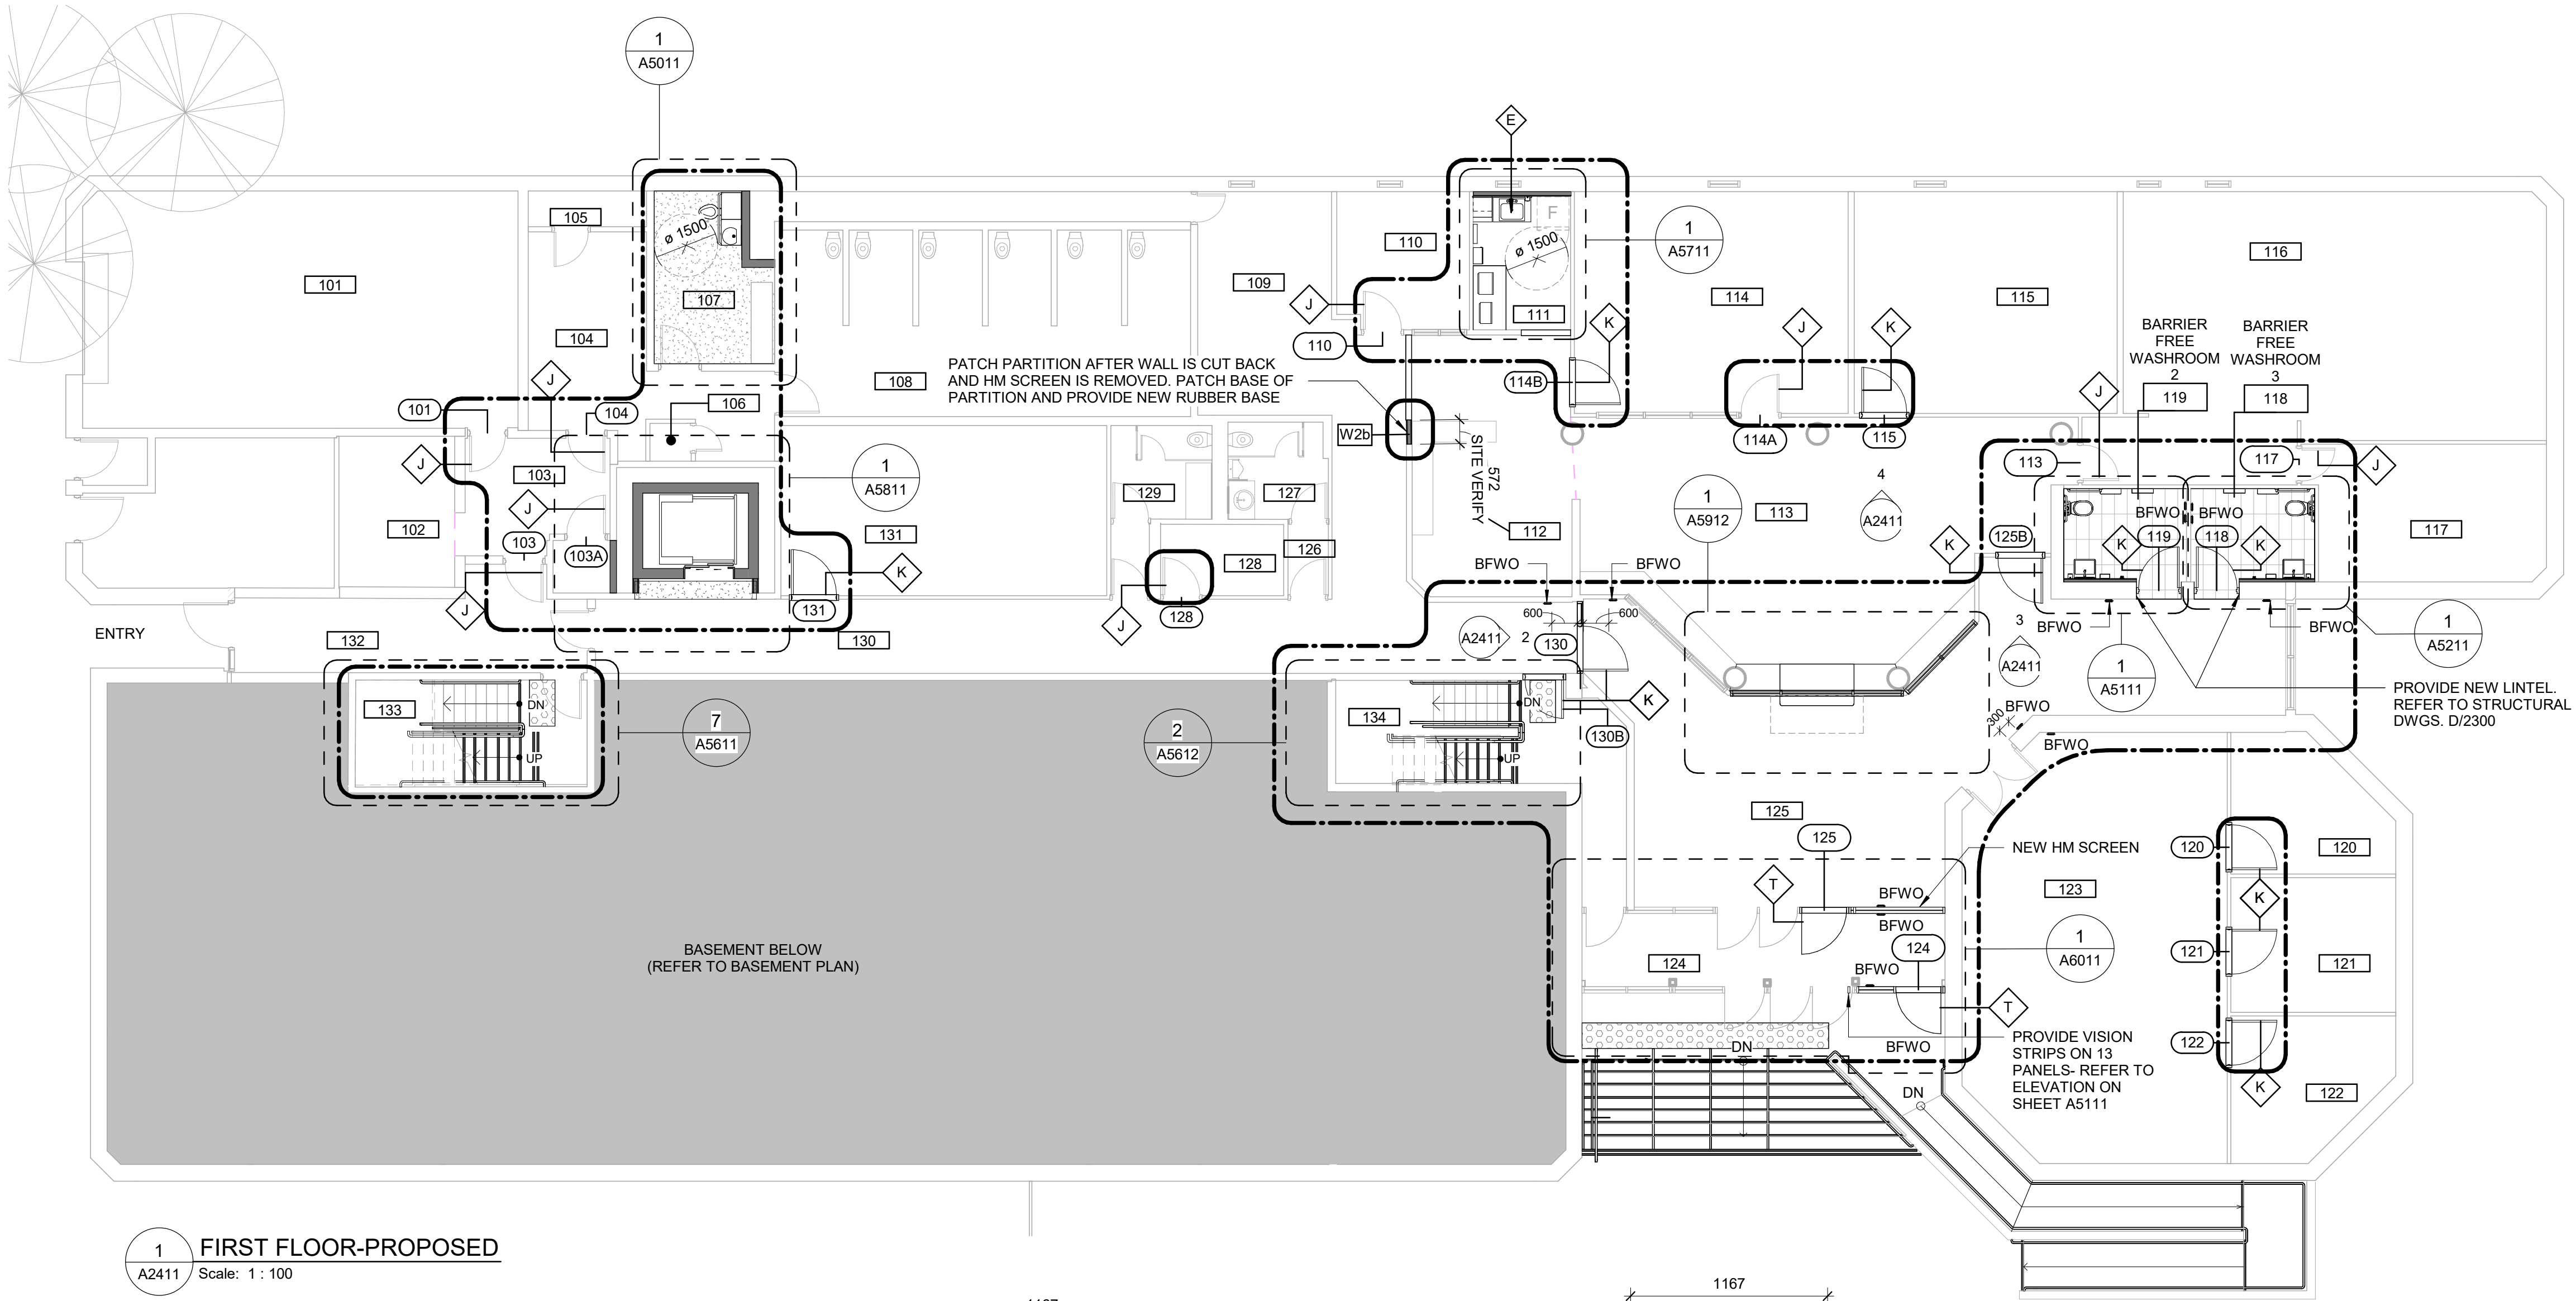- EXISTING EXTERIOR WALL TO REMAIN
- EXISTING PARTITION TO REMAIN
- NEW EXTERIOR WALL REFER TO WALL SCHEDULE
- NEW PARTITION REFER TO PARTITION SCHEDULE
- EXISTING DOOR TO REMAIN
- NEW DOOR AND/ OR NEW HARDWARE
- DASHED AREA INDICATES AREA OF WORK

CONSTRUCTION GENERAL NOTES

- NEW DOOR CARD READER AND BARRIER FREE PUSH BUTTON - REFER TO ELECTRICAL DRAWINGS. FOR LOCATION AND HEIGHT INSTALLATION REFER TO ARCHITECTURAL DETAIL BOOKLET.
- REPAINT ENTIRE WALL AFTER WALL-MOUNTED HANDRAIL REPLACEMENT - UNLESS OTHERWISE NOTED. COLOUR AND FINISH TO MATCH EXISTING

CONSTRUCTION KEY NOTES

NO	DESCRIPTION
E	CONSTRUCT NEW KITCHEN MILLWORK. REFER TO MILLWORK DETAILS 1/D1301, 2/D1301, 3/D1301, 4/D1301, 1/D1302, 2/D1302, 3/D1302, 4/1302, 5/D1302, 6/D1302, 8/D1302.
J	EXISTING DOOR TO REMAIN. DOOR HARDWARE TO BE CHANGED AS PER DOOR SCHEDULE ON A9001 AND DOOR HARDWARE SCHEDULE IN THE SPECIFICATIONS.
K	INSTALL NEW DOOR AND FRAME. REFER TO DOOR SCHEDULE A9001, G0004 AND DOOR HARDWARE SCHEDULE IN THE SPECIFICATIONS.
T	INSTALL NEW STOREFRONT FRAMING TO MATCH EXISTING WITH NEW DOOR PER SPECIFIED WIDTH AND HEIGHT. REFER TO DOOR SCHEDULE A9001 AND DOOR HARDWARE SCHEDULE IN THE SPECIFICATIONS.

CLIENT

CITY OF TORONTO



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Project Management Office
Metro Hall Toronto, ON
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B	90% SUBMISSION	2022-02-22
C	ISSUED FOR PERMIT	2022-03-18
D	ISSUED FOR TENDER	2025-04-11

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Toronto, ON M9W 0C9, Canada
tel 416 679 1930
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PROJECT TITLE
CITY OF TORONTO
ACCESSIBILITY UPGRADES

PROJECT ADDRESS

POLICE NO. 33 DIVISION
50 UPJOHN RD

PROJECT NO:
9119-19-0162 / Arcadis 30279056

DRAWN BY:

A.Sunil

CHECKED BY:

K.Tilahun

PROJECT MGR:

F. BOLOURIAN

APPROVED BY:

E.Fenuta

SHEET TITLE


FIRST FLOOR
PROPOSED PLAN

SHEET NUMBER

G05-249-A2411



ISSUE

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1 x 1

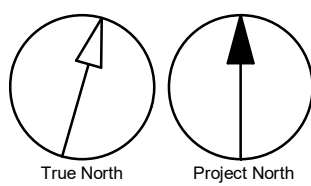Autodesk Docs/1122280 - Cot TAU Upgrades R2020/122260 TAU-5-249-50UP-PHNA-A020.rvt 1/11



CONSTRUCTION KEY LEGEND

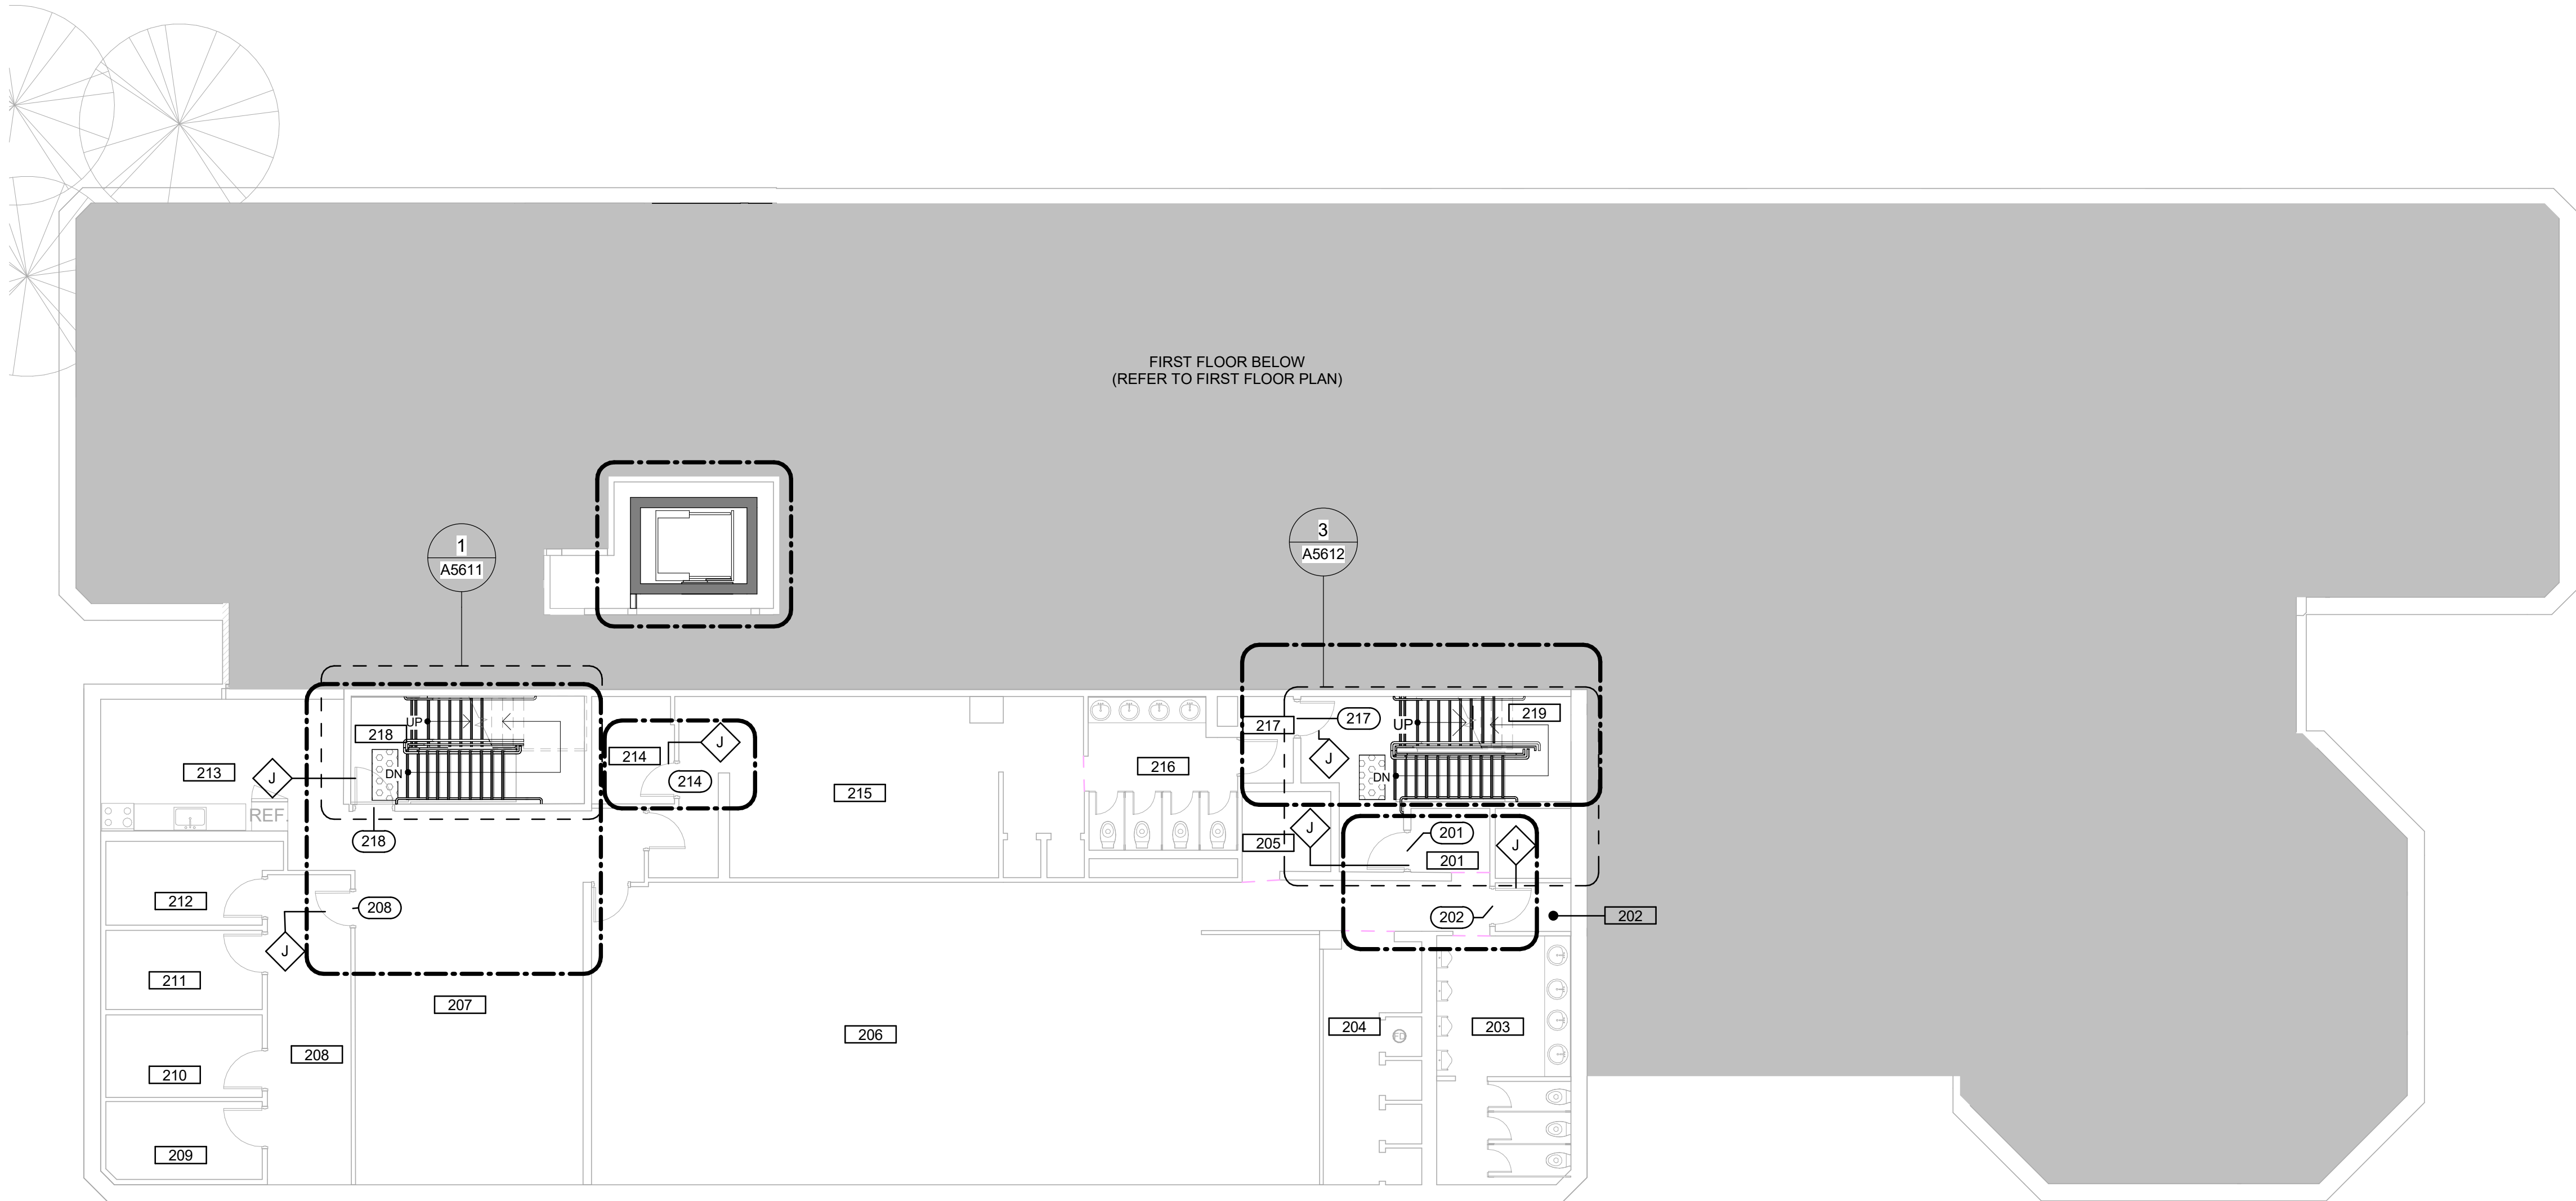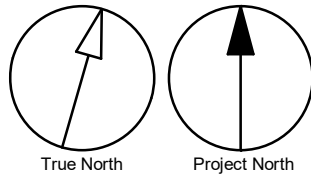- EXISTING EXTERIOR WALL TO REMAIN
- EXISTING PARTITION TO REMAIN
- NEW EXTERIOR WALL REFER TO WALL SCHEDULE
- NEW PARTITION REFER TO PARTITION SCHEDULE
- EXISTING DOOR TO REMAIN
- NEW DOOR AND/ OR NEW HARDWARE
- DASHED AREA INDICATES AREA OF WORK

CONSTRUCTION GENERAL NOTES

- NEW DOOR CARD READER AND BARRIER FREE PUSH BUTTON - REFER TO ELECTRICAL DRAWINGS. FOR LOCATION AND HEIGHT INSTALLATION REFER TO ARCHITECTURAL DETAIL BOOKLET.
- REPAINT ENTIRE WALL AFTER WALL-MOUNTED HANDRAIL REPLACEMENT - UNLESS OTHERWISE NOTED. COLOUR AND FINISH TO MATCH EXISTING

CONSTRUCTION KEY NOTES

NO	DESCRIPTION
J	EXISTING DOOR TO REMAIN. DOOR HARDWARE TO BE CHANGED AS PER DOOR SCHEDULE ON A5001 AND DOOR HARDWARE SCHEDULE IN THE SPECIFICATIONS.

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PROJECT TITLE
CITY OF TORONTO
ACCESSIBILITY UPGRADES

PROJECT ADDRESS

POLICE NO. 33 DIVISION
50 UPJOHN RD

PROJECT NO:
9119-19-0162 / Arcadis 30279056

DRAWN BY: A.Sunil	CHECKED BY: K.Tilahun
PROJECT MGR: F. BOLOURIAN	APPROVED BY: E.Fenuta

SHEET TITLE


SECOND FLOOR
PROPOSED PLAN

SHEET NUMBER

G05-249-A2421

ISSUE

D

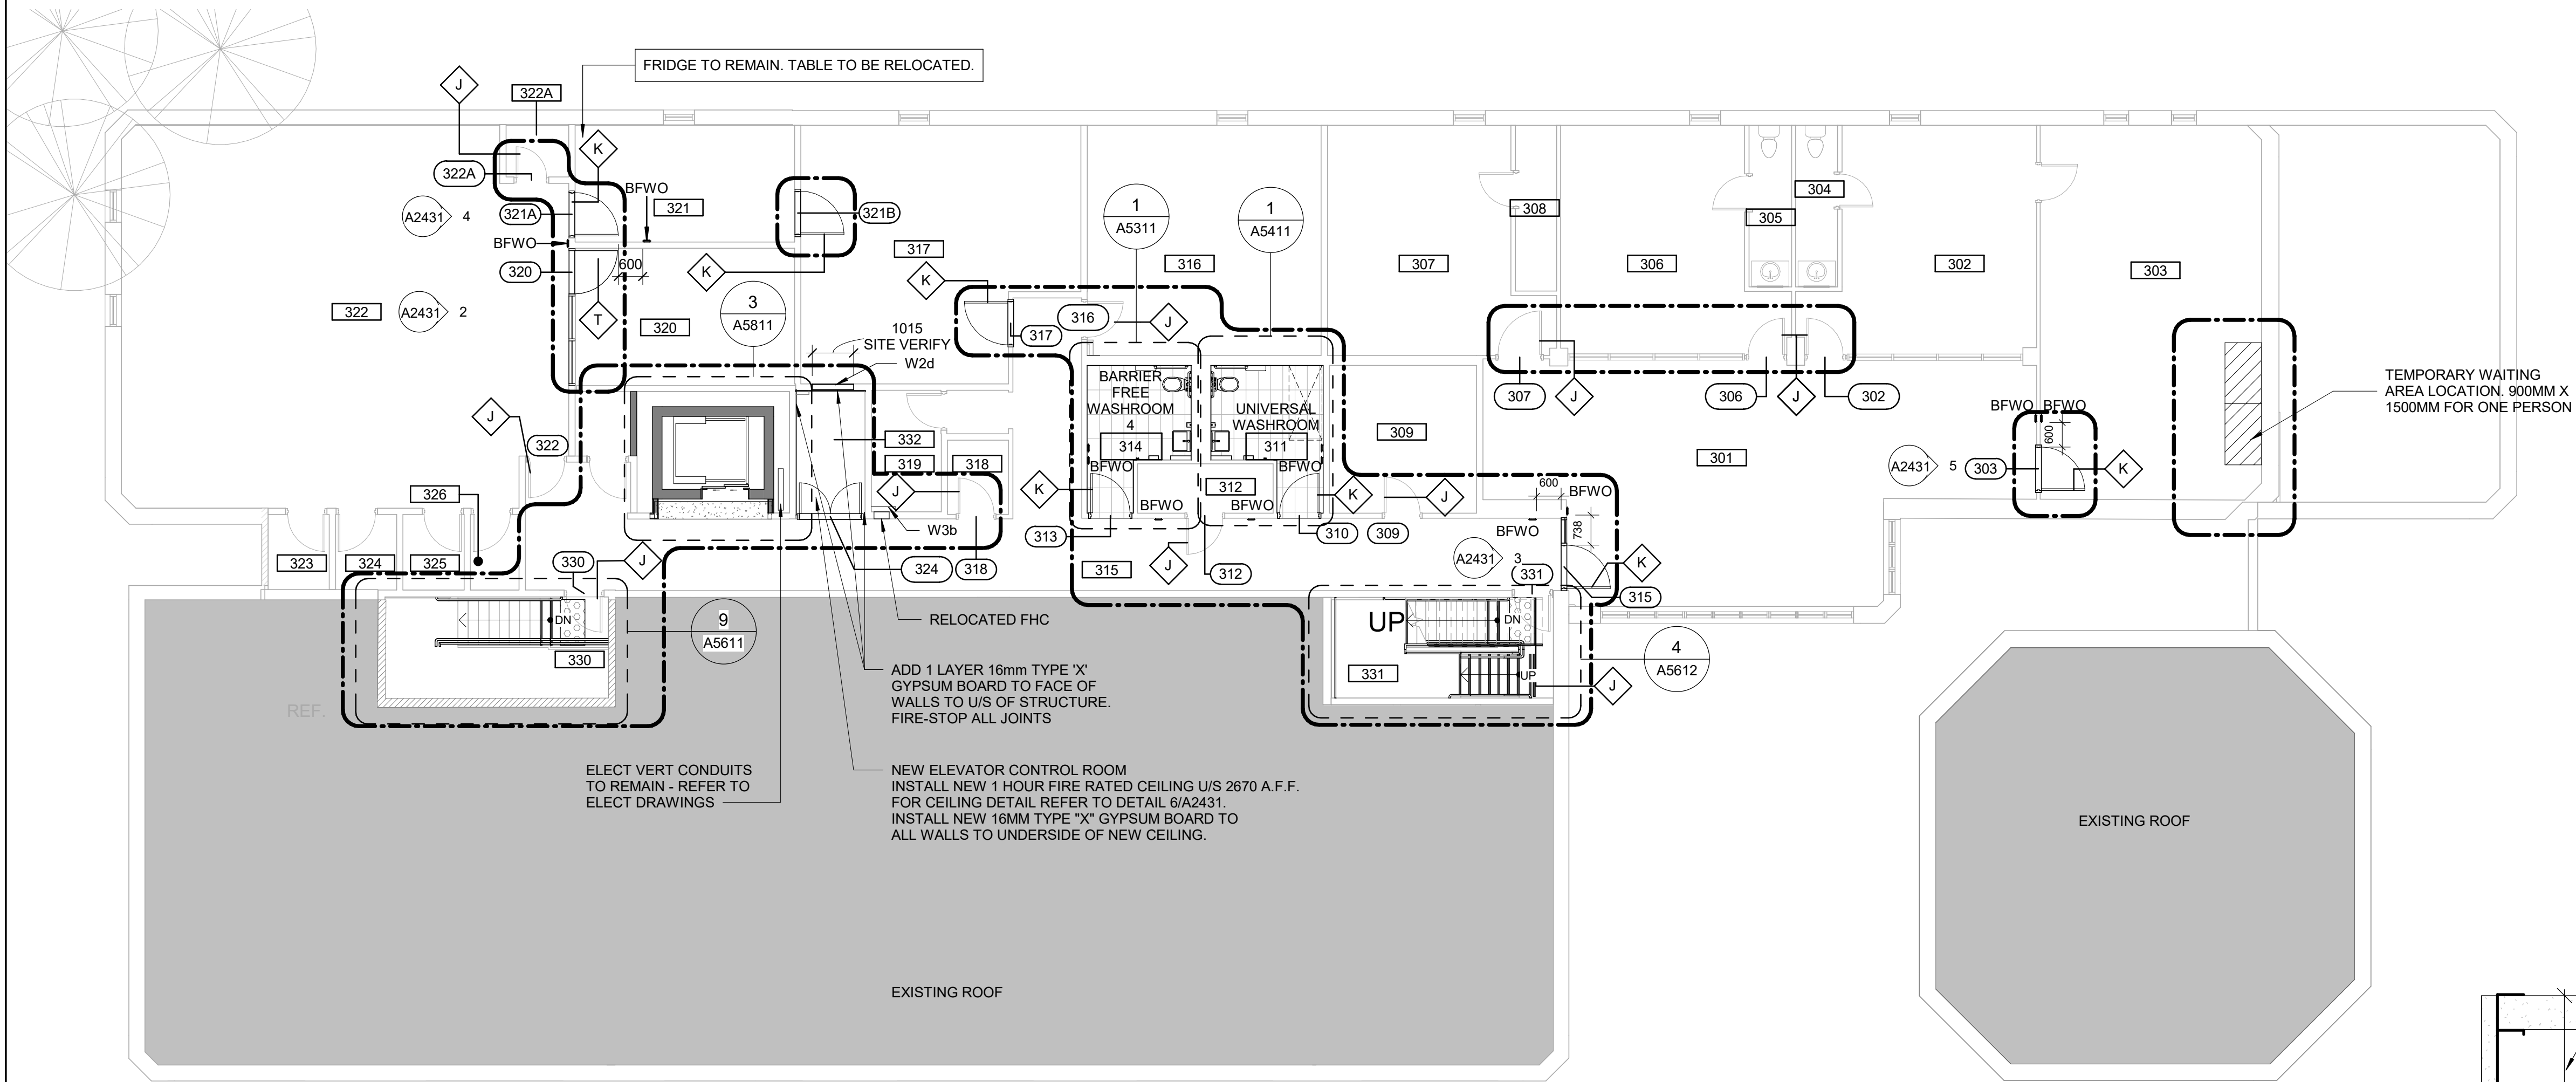

CONSTRUCTION KEY LEGEND

EXISTING EXTERIOR WALL TO REMAIN

EXISTING PARTITION TO REMAIN

###

CONSTRUCTION GENERAL NOTES

1

NEW DOOR CARD READER AND BARRIER FREE PUSH BUTTON - REFER TO ELECTRICAL DRAWINGS. FOR LOCATION AND HEIGHT INSTALLATION REFER TO ARCHITECTURAL DETAIL BOOKLET.

2

REPAINT ENTIRE WALL AFTER WALL-MOUNTED HANDRAIL REPLACEMENT - UNLESS OTHERWISE NOTED. COLOUR AND FINISH TO MATCH EXISTING

CONSTRUCTION KEY NOTES

NO

DESCRIPTION

J


EXISTING DOOR TO REMAIN. DOOR HARDWARE TO BE CHANGED AS PER DOOR SCHEDULE ON A9001 AND DOOR HARDWARE SCHEDULE IN THE SPECIFICATIONS.

K

INSTALL NEW DOOR AND FRAME. REFER TO DOOR SCHEDULE A9001, G0004 AND DOOR HARDWARE SCHEDULE IN THE SPECIFICATIONS.


T

INSTALL NEW STOREFRONT FRAMING TO MATCH EXISTING WITH NEW DOOR PER SPECIFIED WIDTH AND HEIGHT. REFER TO DOOR SCHEDULE A9001 AND DOOR HARDWARE SCHEDULE IN THE SPECIFICATIONS.

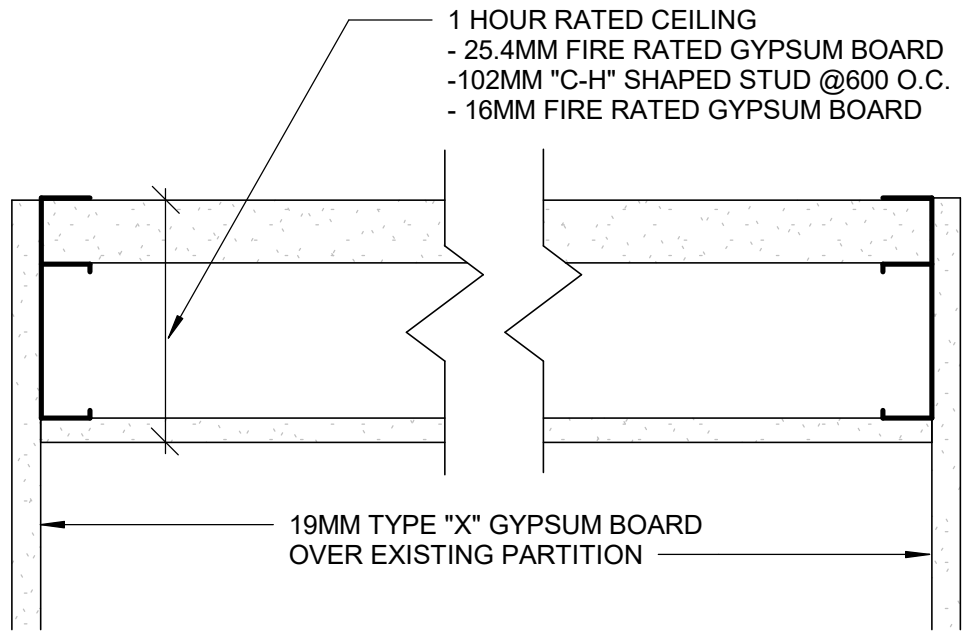


1 THIRD FLOOR-PROPOSED PLAN
A2431 Scale: 1 : 100


6 CEILING DETAIL
A2431 Scale: 1 : 5

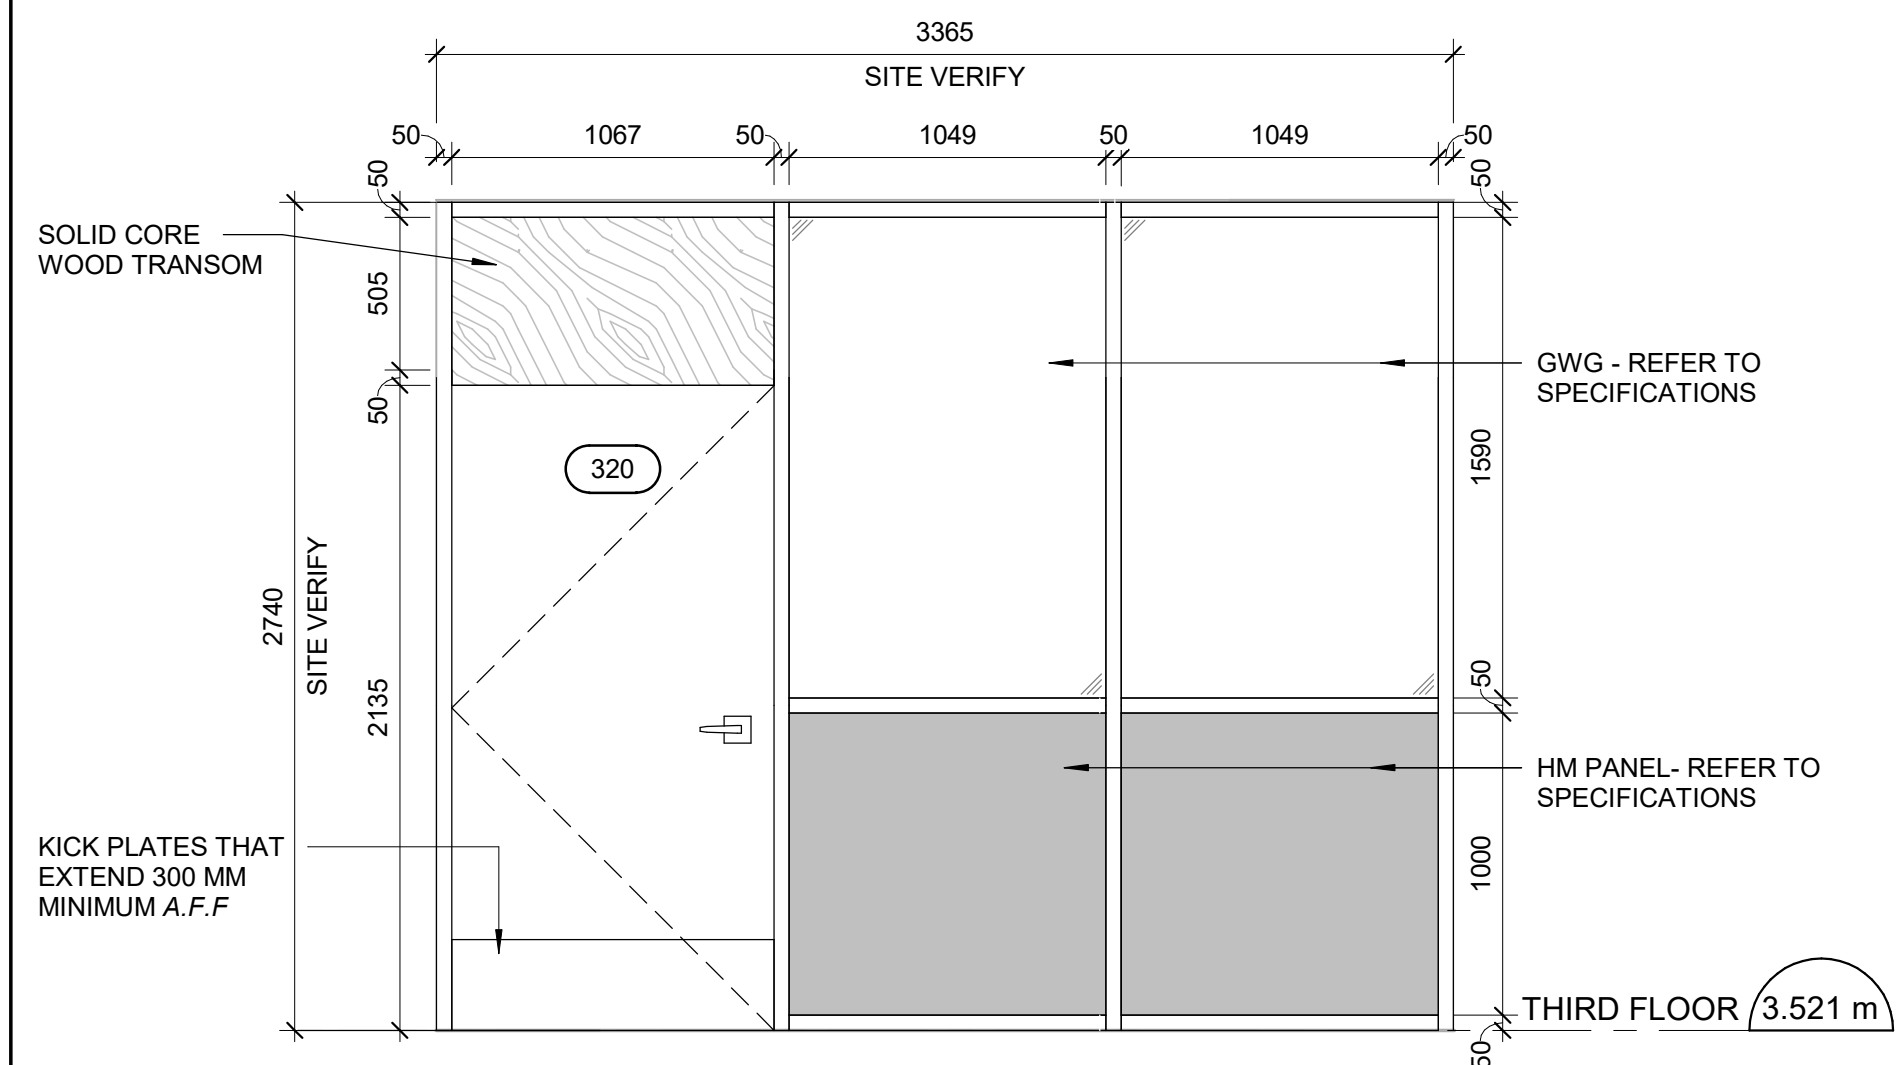


2 DOOR 320 - ELEVATION
A2431 Scale: 1 : 25

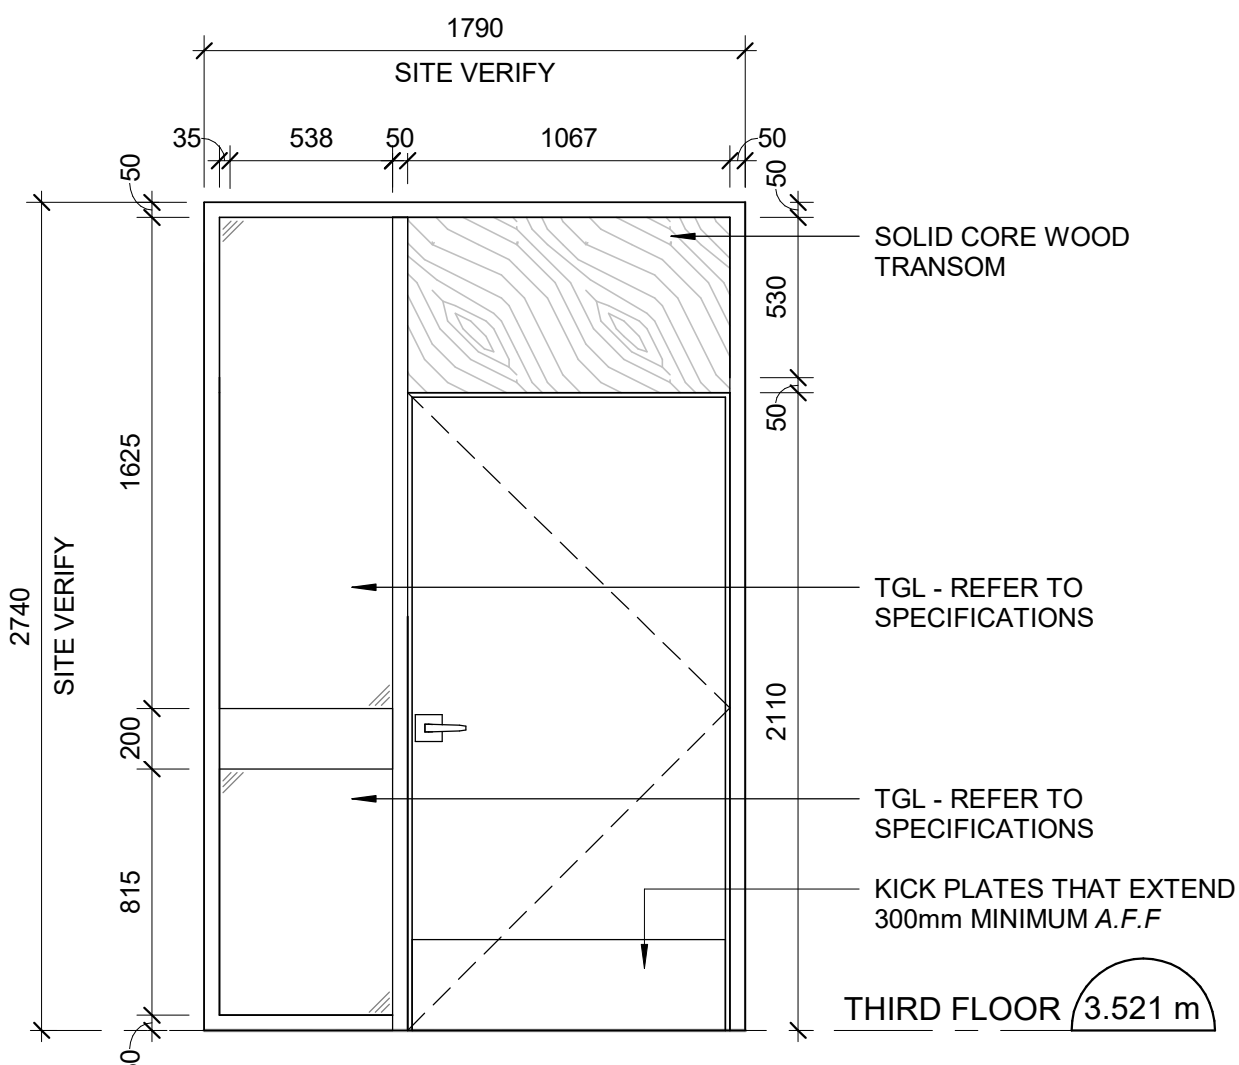

3 DOOR 315 - ELEVATION
A2431 Scale: 1 : 25

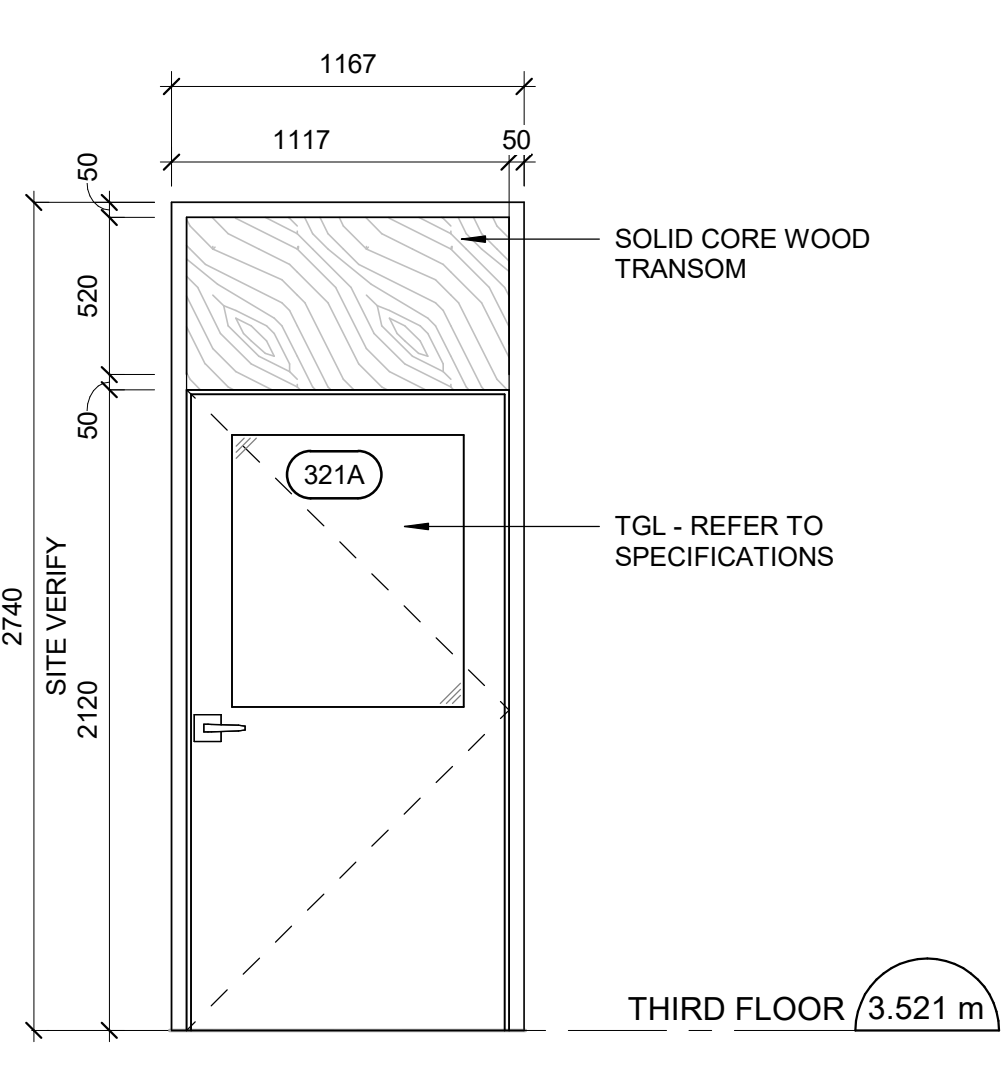

4 DOOR 321A - ELEVATION
A2431 Scale: 1 : 25

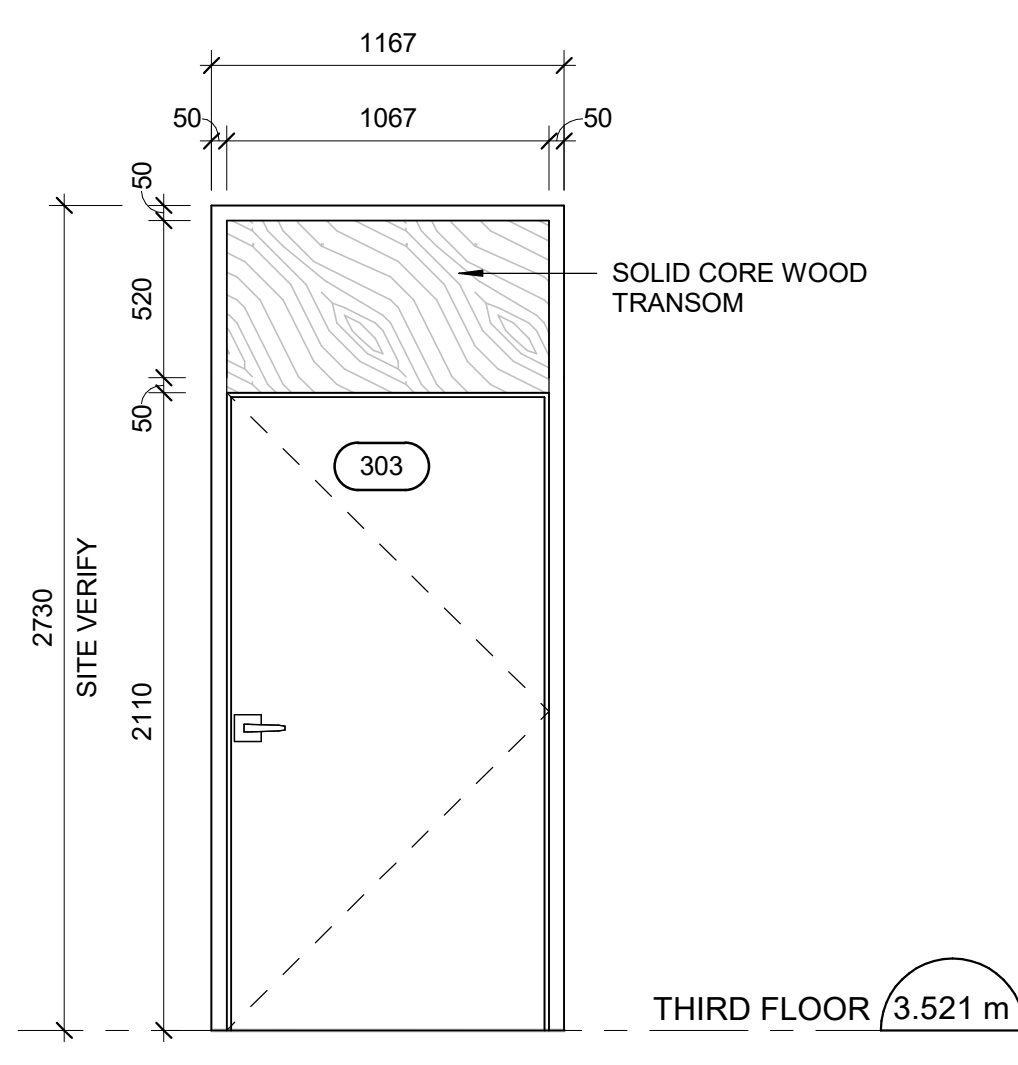

5 DOOR 303 - ELEVATION
A2431 Scale: 1 : 25

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D	ISSUED FOR TENDER	2025-04-11

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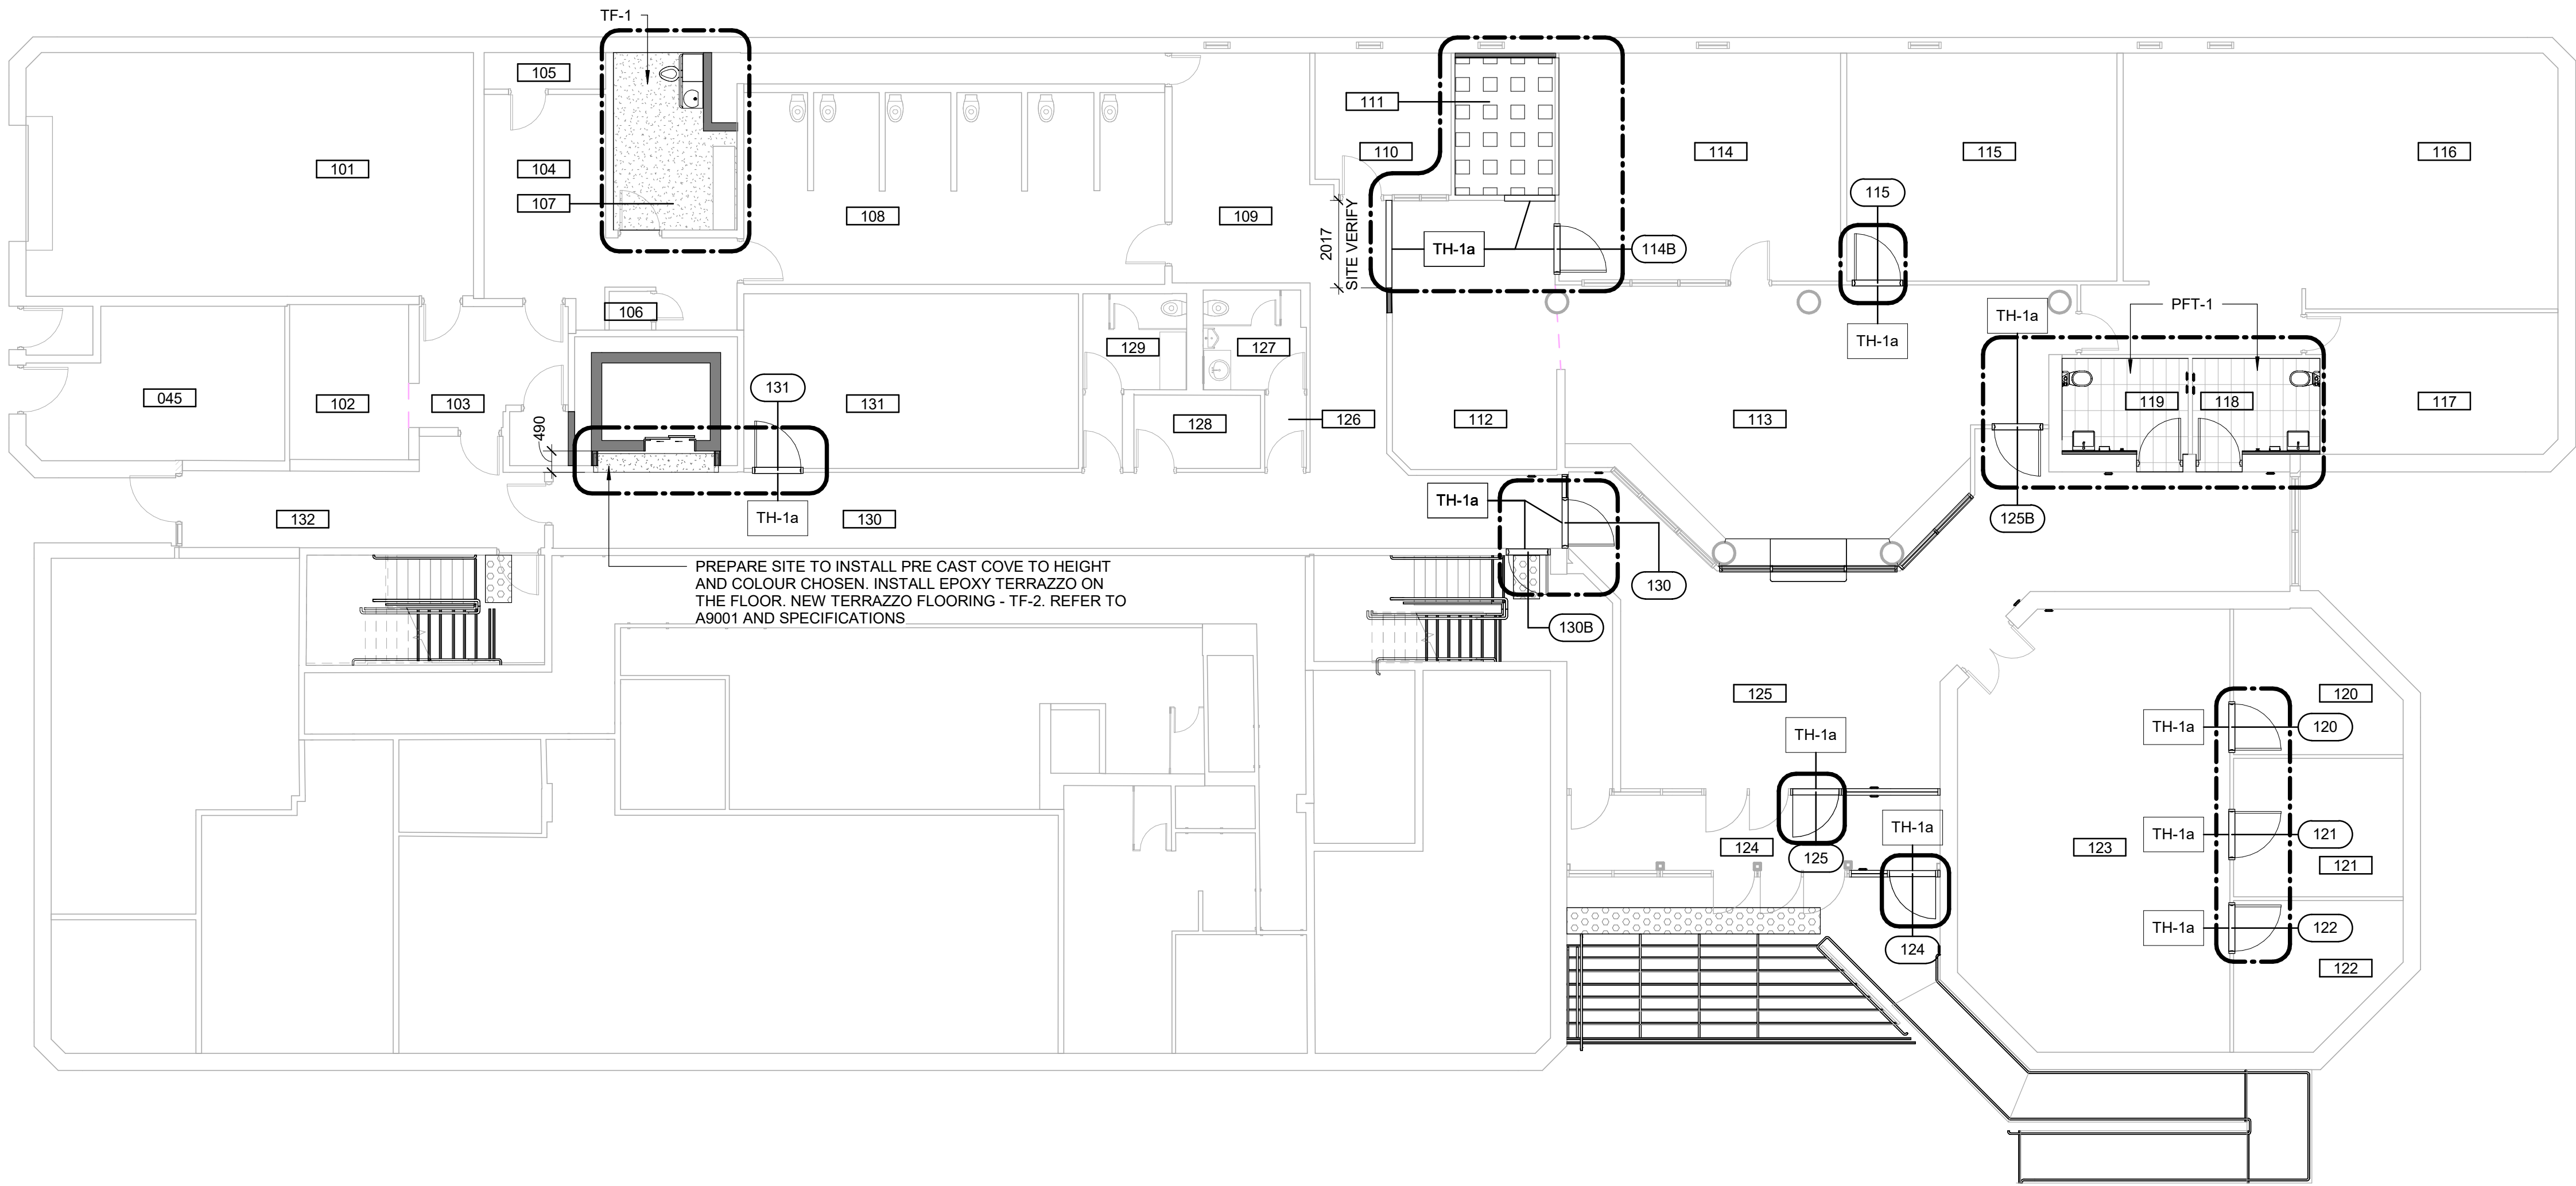
PROJECT TITLE
**CITY OF TORONTO
ACCESSIBILITY UPGRADES**

PROJECT ADDRESS
**POLICE NO. 33 DIVISION
50 UPJOHN RD**

PROJECT NO:
9119-19-0162 / Arcadis 30279056
DRAWN BY:
A.Sunil
PROJECT MGR:
F. BOLOURIAN
CHECKED BY:
K.Tilahun
APPROVED BY:
E.Fenuta

SHEET TITLE
**THIRD FLOOR
PROPOSED PLAN**

SHEET NUMBER
G05-249-A2431
ISSUE
D



FLOOR FINISHES LEGEND

- VINYL COMPOSITE TILE
- CARPET TILE
- PORCELAIN SHOWER TILE
- PORCELAIN TILE
- CONCRETE SEALER
- FLOOR FINISH TO MATCH EXISTING
REFER TO ROOM FINISH SCHEDULE
- DASHED AREA INDICATES
AREA OF WORK

FLOOR FINISH GENERAL NOTES

- FLOOR FINISH PLANS TO BE READ IN CONJUNCTION WITH ROOM FINISH SCHEDULE AND SPECIFICATIONS.
- PROTECT ALL NEW AND EXISTING FLOOR FINISHES WITH PLYWOOD SHEETS ANYWHERE OTHER CONSTRUCTION WORK IS STILL ONGOING.
- CHANGE OF FLOORING MATERIAL TO OCCUR BELOW THE DOOR LEAF UNLESS OTHERWISE INDICATED.
- WHERE A CHANGE OF MATERIAL THICKNESS OCCURS, PROVIDE THRESHOLD AS PER DETAILS AND SPECIFICATIONS.
- PROVIDE REPLACEMENT FLOOR FINISH TO MATCH EXISTING FOR ANY FLOORING DAMAGED DUE TO WORK OF THIS PROJECT.

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**CITY OF TORONTO
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PROJECT ADDRESS

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50 UPJOHN RD**

PROJECT NO:
9119-19-0162 / Arcadis 30279056

DRAWN BY:
A.Sunil

CHECKED BY:
K.Tilahun

PROJECT MGR:
F. BOLOURIAN

APPROVED BY:
E.Fenuta


SHEET TITLE
**FIRST FLOOR FLOOR
FINISH PLAN**

SHEET NUMBER

G05-249-A2611

ISSUE



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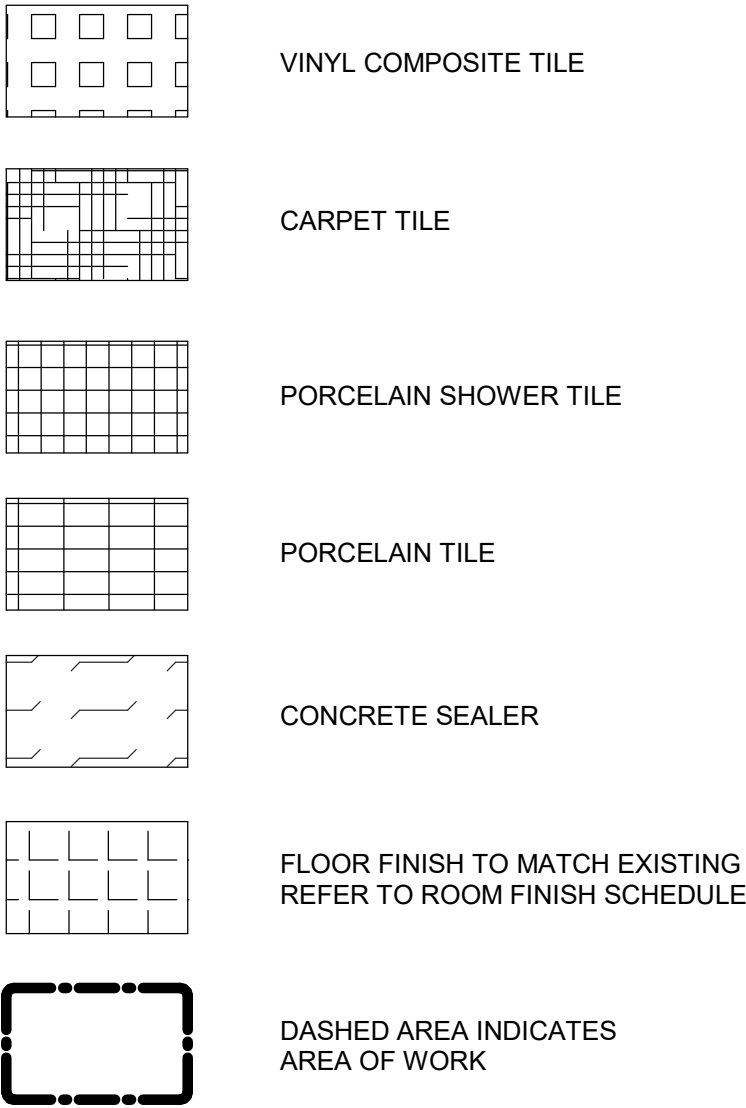
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FLOOR FINISHES LEGEND

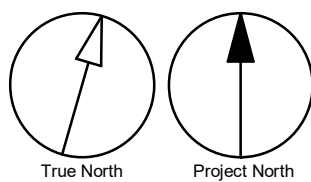


FLOOR FINISH GENERAL NOTES

- 1 FLOOR FINISH PLANS TO BE READ IN CONJUNCTION WITH ROOM FINISH SCHEDULE AND SPECIFICATIONS.
- 2 PROTECT ALL NEW AND EXISTING FLOOR FINISHES WITH PLYWOOD SHEETS ANYWHERE OTHER CONSTRUCTION WORK IS STILL ONGOING.
- 3 CHANGE OF FLOORING MATERIAL TO OCCUR BELOW THE DOOR LEAF UNLESS OTHERWISE INDICATED.
- 4 WHERE A CHANGE OF MATERIAL THICKNESS OCCURS, PROVIDE THRESHOLD AS PER DETAILS AND SPECIFICATIONS.
- 5 PROVIDE REPLACEMENT FLOOR FINISH TO MATCH EXISTING FOR ANY FLOORING DAMAGED DUE TO WORK OF THIS PROJECT.

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
ISSUES
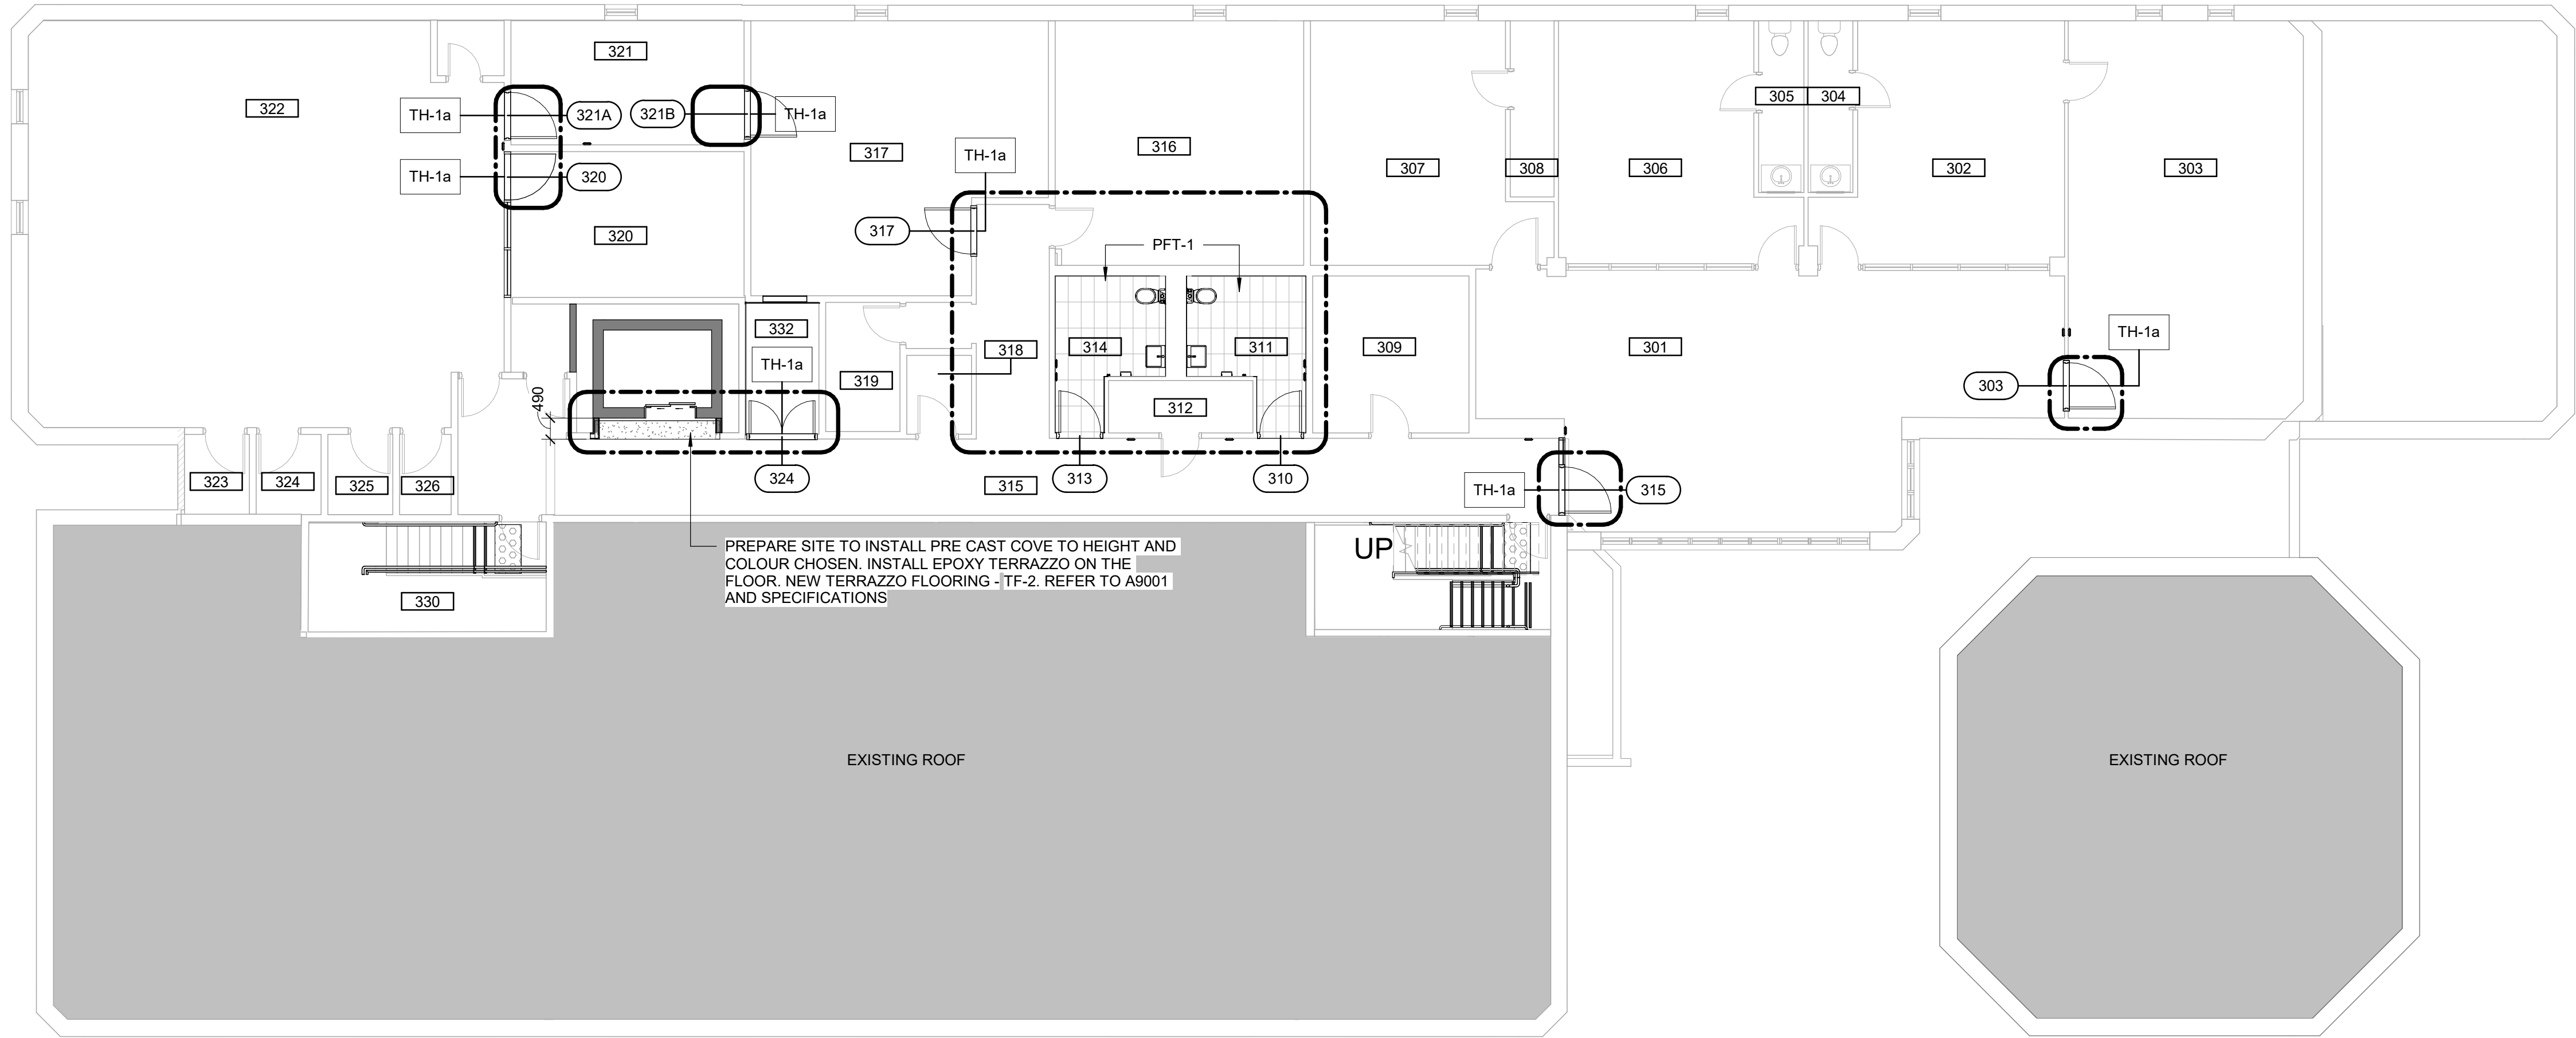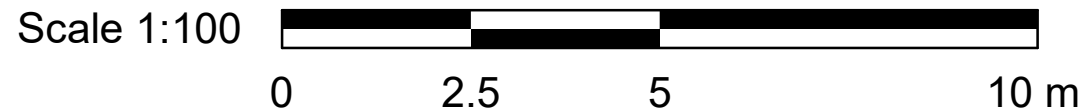
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PROJECT TITLE

CITY OF TORONTO
ACCESSIBILITY UPGRADES

PROJECT ADDRESS

POLICE NO. 33 DIVISION
50 UPJOHN RD

PROJECT NO:

9119-19-0162 / Arcadis 30279056

DRAWN BY:

A.Sunil

CHECKED BY:

K.Tilahun

PROJECT MGR:

F. BOLOURIAN

APPROVED BY:

E.Fenuta

SHEET TITLE


THIRD FLOOR FLOOR
FINISH PLAN


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G05-249-A2631

ISSUE





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1 THIRD FLOOR-PROPOSED RCP
A2831 Scale: 1 : 20

CEILING LEGEND

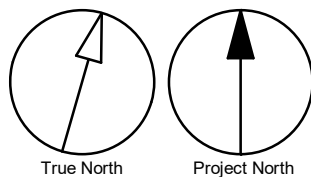- SUSPENDED METAL GRID
AND LAY-IN ACOUSTIC TILE
SIZE TO MATCH EXISTING
- SUPPLY / RETURN DUCT
- CEILING, PENDANT OR
WALL MOUNTED LUMINAIRE
- CEILING OR PENDANT
MOUNTED LUMINAIRE

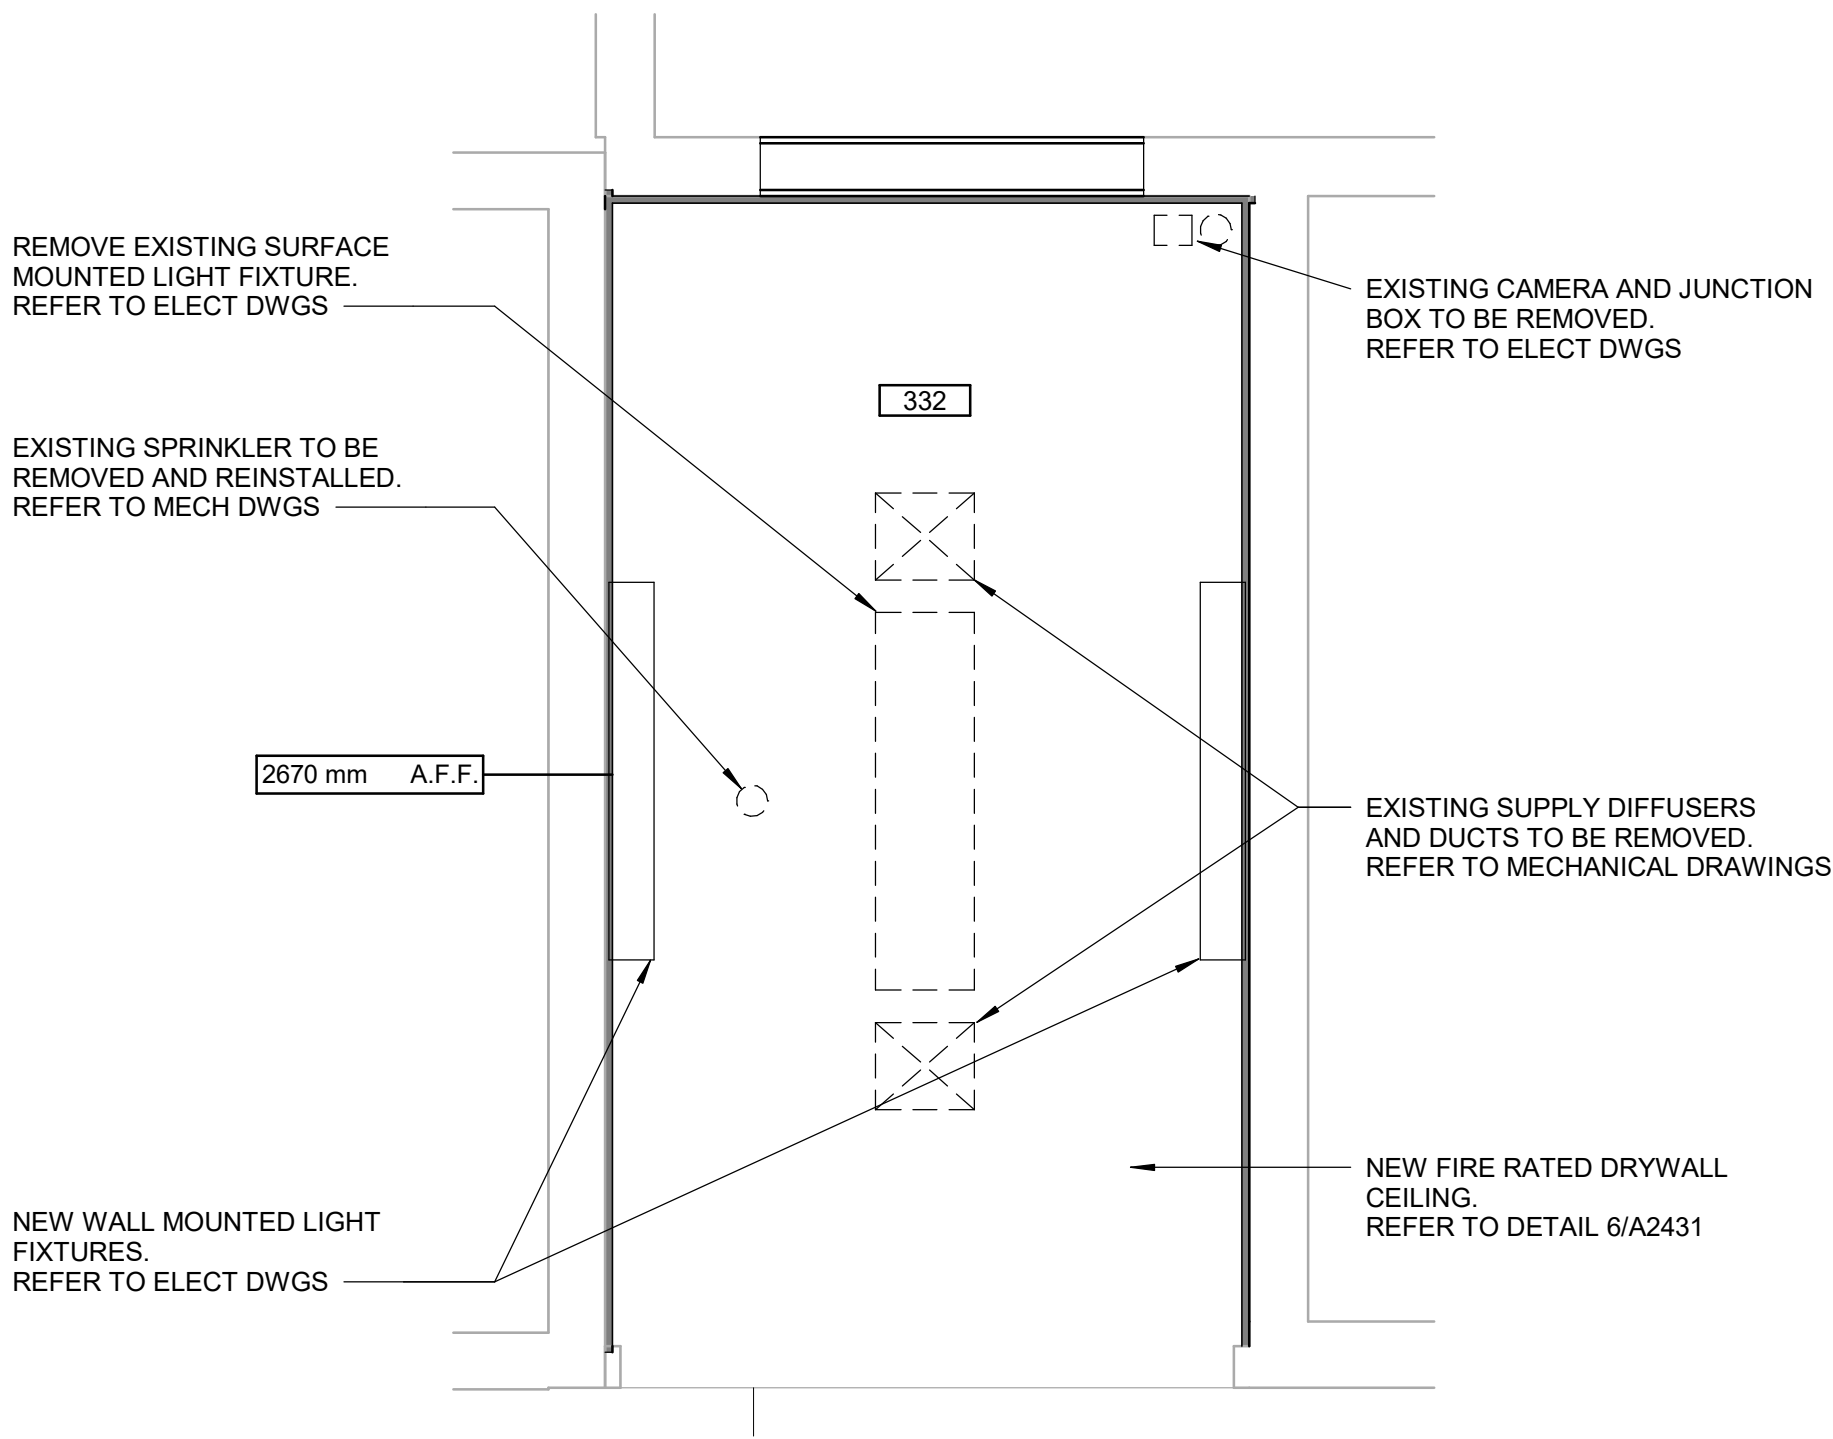CEILING GENERAL NOTES

- 1 PROPOSED CEILING HEIGHT TO MATCH EXISTING, UNLESS OTHERWISE NOTED.
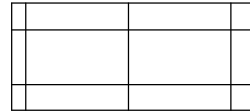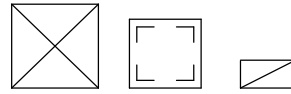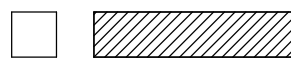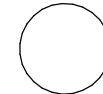
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PROJECT TITLE
CITY OF TORONTO
ACCESSIBILITY UPGRADES

PROJECT ADDRESS

POLICE NO. 33 DIVISION
50 UPJOHN RD

PROJECT NO:
9119-19-0162 / Arcadis 30279056

DRAWN BY: A.Sunil	CHECKED BY: K.Tilahun
PROJECT MGR: F. BOLOURIAN	APPROVED BY: E.Fenuta

SHEET TITLE


THIRD FLOOR
REFLECTED CEILING
PLAN - ROOM

SHEET NUMBER

G05-249-A2831


ISSUE

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4/9/2025 4:05:22 PM

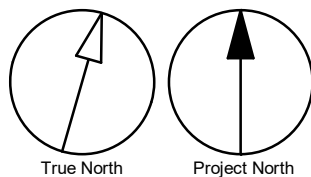Scale 1:100



DEMOLITION KEY LEGEND

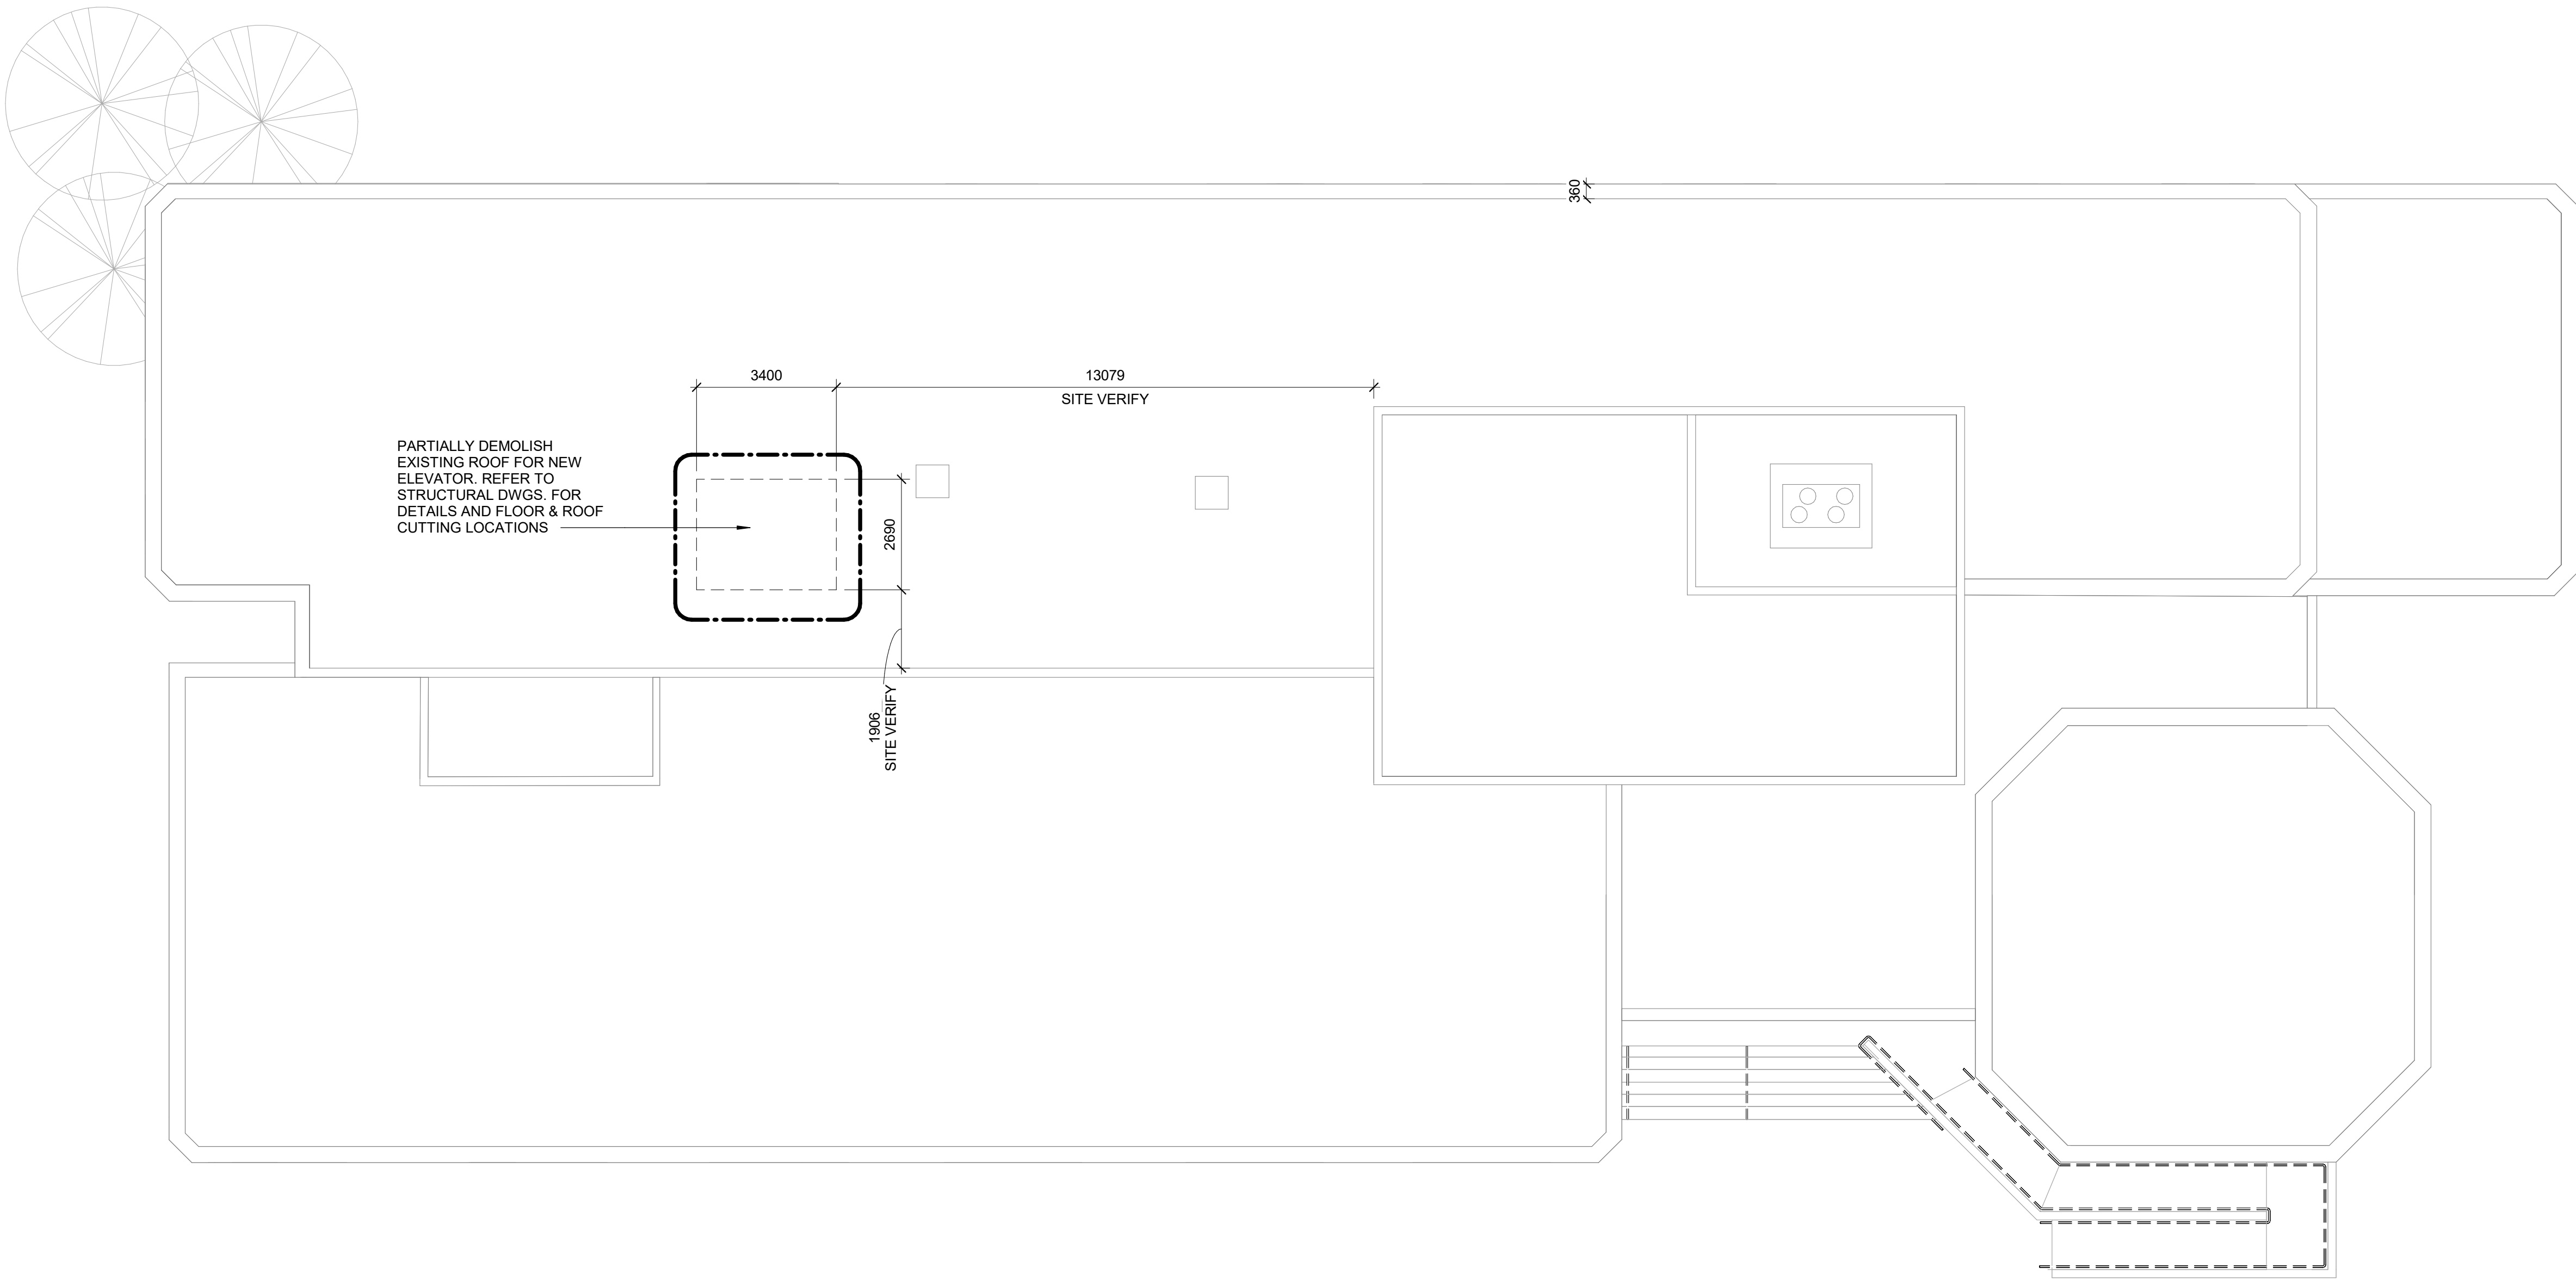- EXISTING TO BE DEMOLISHED
- - - - - EXISTING PARTITION TO BE DEMOLISHED
- ////// EXISTING EXTERIOR WALL TO REMAIN
- [Dashed Box] DASHED AREA INDICATES AREA OF WORK

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PROJECT TITLE

CITY OF TORONTO
ACCESSIBILITY UPGRADES

PROJECT ADDRESS

POLICE NO. 33 DIVISION
50 UPJOHN RD

PROJECT NO:

9119-19-0162 / Arcadis 30279056

DRAWN BY:

A.Sunil

CHECKED BY:

K.Tilahun

PROJECT MGR:

F. BOLOURIAN

APPROVED BY:

E.Fenuta

SHEET TITLE


ROOF PLAN -
DEMOLITION PLAN

SHEET NUMBER

G05-249-A2911




ISSUE

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4
A5811

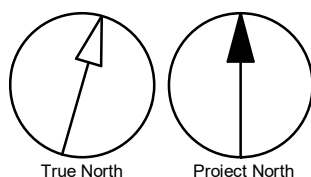CONSTRUCTION KEY LEGEND

- EXISTING PARTITION TO REMAIN
- NEW PARTITION
REFER TO PARTITION SCHEDULE
- NEW DOOR AND/ OR
NEW HARDWARE

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A	90% SUBMISSION	2022-02-22
B	ISSUED FOR PERMIT	2022-03-18
C	ISSUED FOR TENDER	2025-04-11
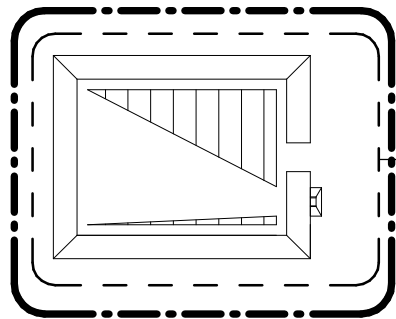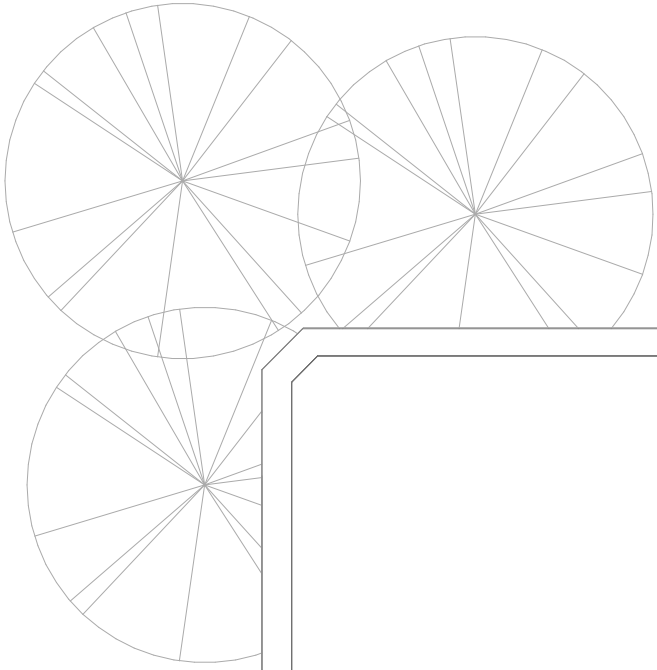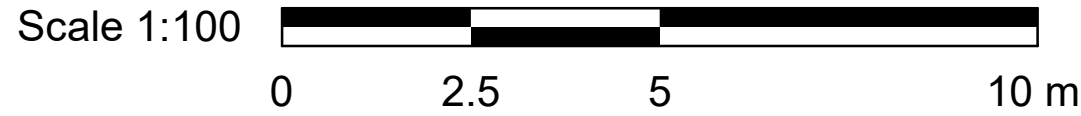
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tel 416 679 1930
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PROJECT TITLE
CITY OF TORONTO
ACCESSIBILITY UPGRADES

PROJECT ADDRESS


POLICE NO. 33 DIVISION
50 UPJOHN RD

PROJECT NO:
9119-19-0162 / Arcadis 30279056

DRAWN BY: A. Kvasniuk	CHECKED BY: K.Tilahun
PROJECT MGR: F. BOLOURIAN	APPROVED BY: E.Fenuta

SHEET TITLE
ROOF PLAN - PROPOSED
PLAN


SHEET NUMBER G05-249-A2912	ISSUE C
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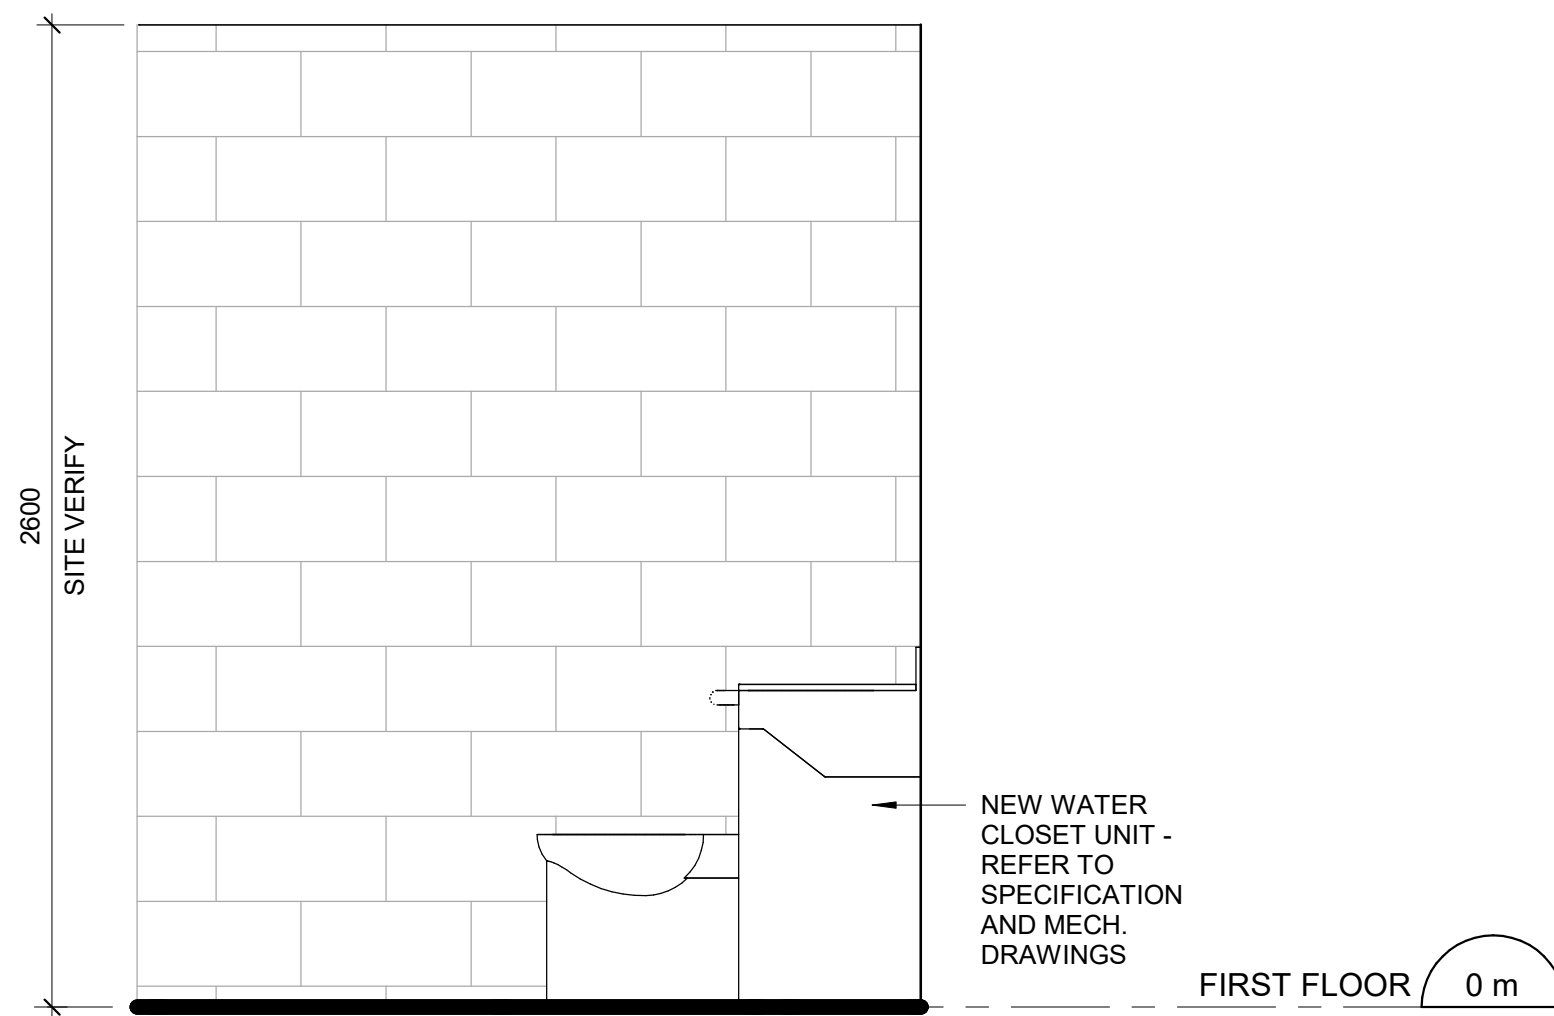
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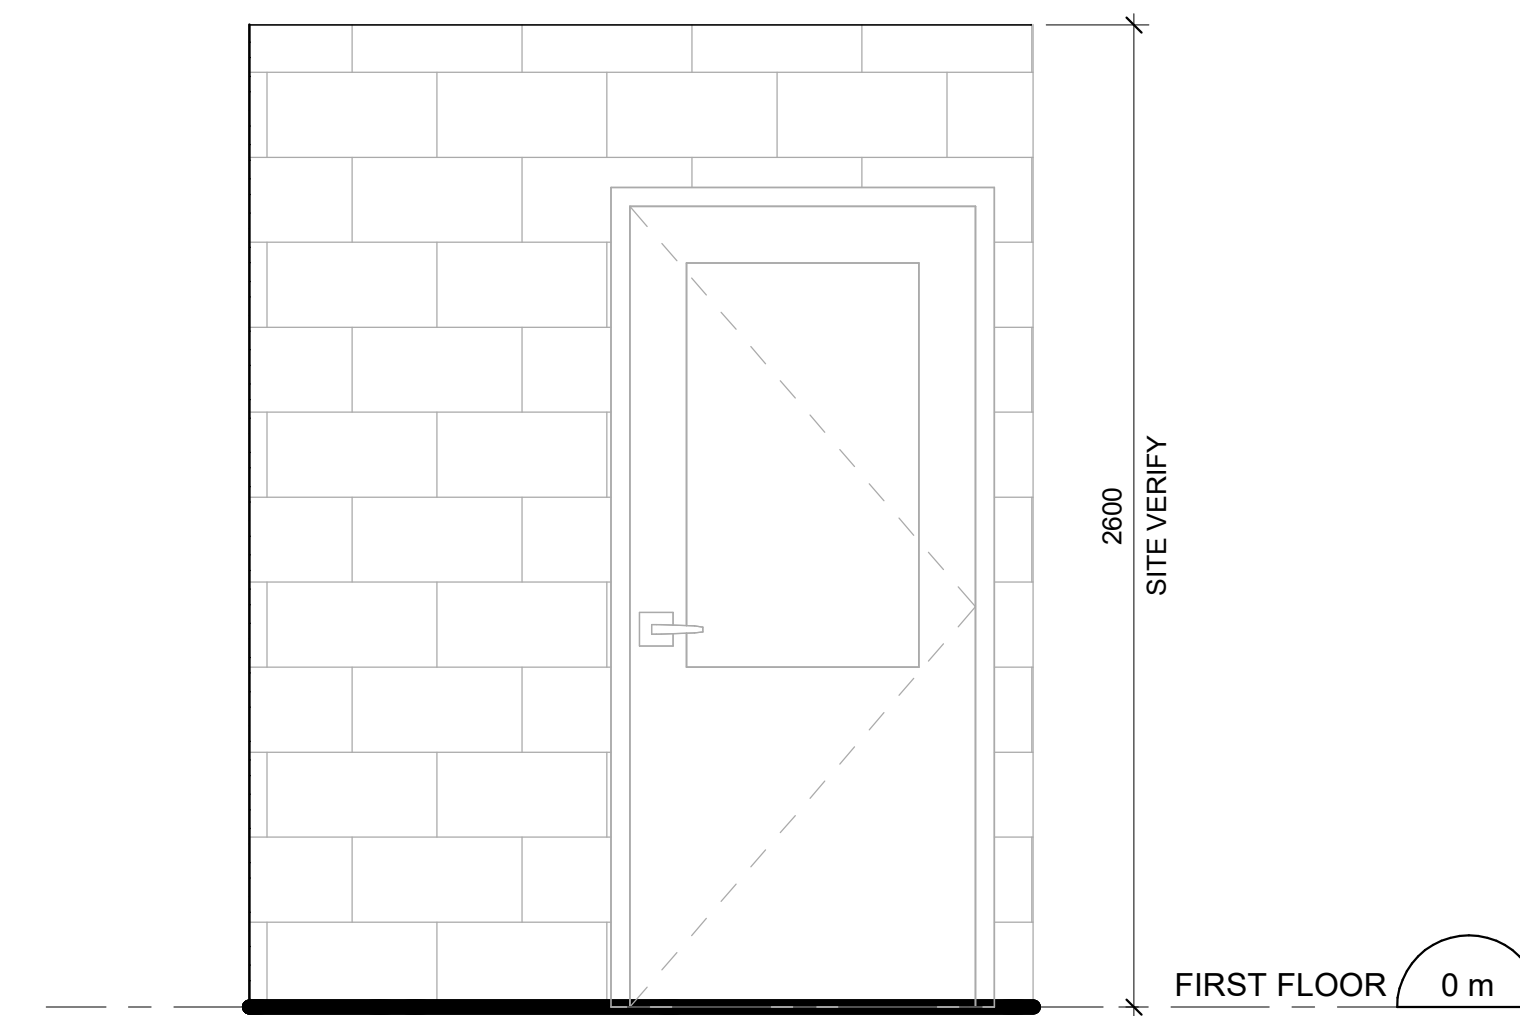
1 FIRST FLOOR PLAN - BARRIER-FREE WSHROOM/ HOLDING UNIT
A5011 Scale: 1 : 20

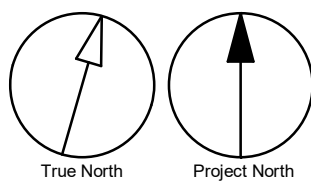


3 BARRIER-FREE WSHROOM/ HOLDING UNIT - EAST ELEVATION
A5011 Scale: 1 : 20



4 BARRIER-FREE WSHROOM/ HOLDING UNIT - NORTH ELEVATION
A5011 Scale: 1 : 20

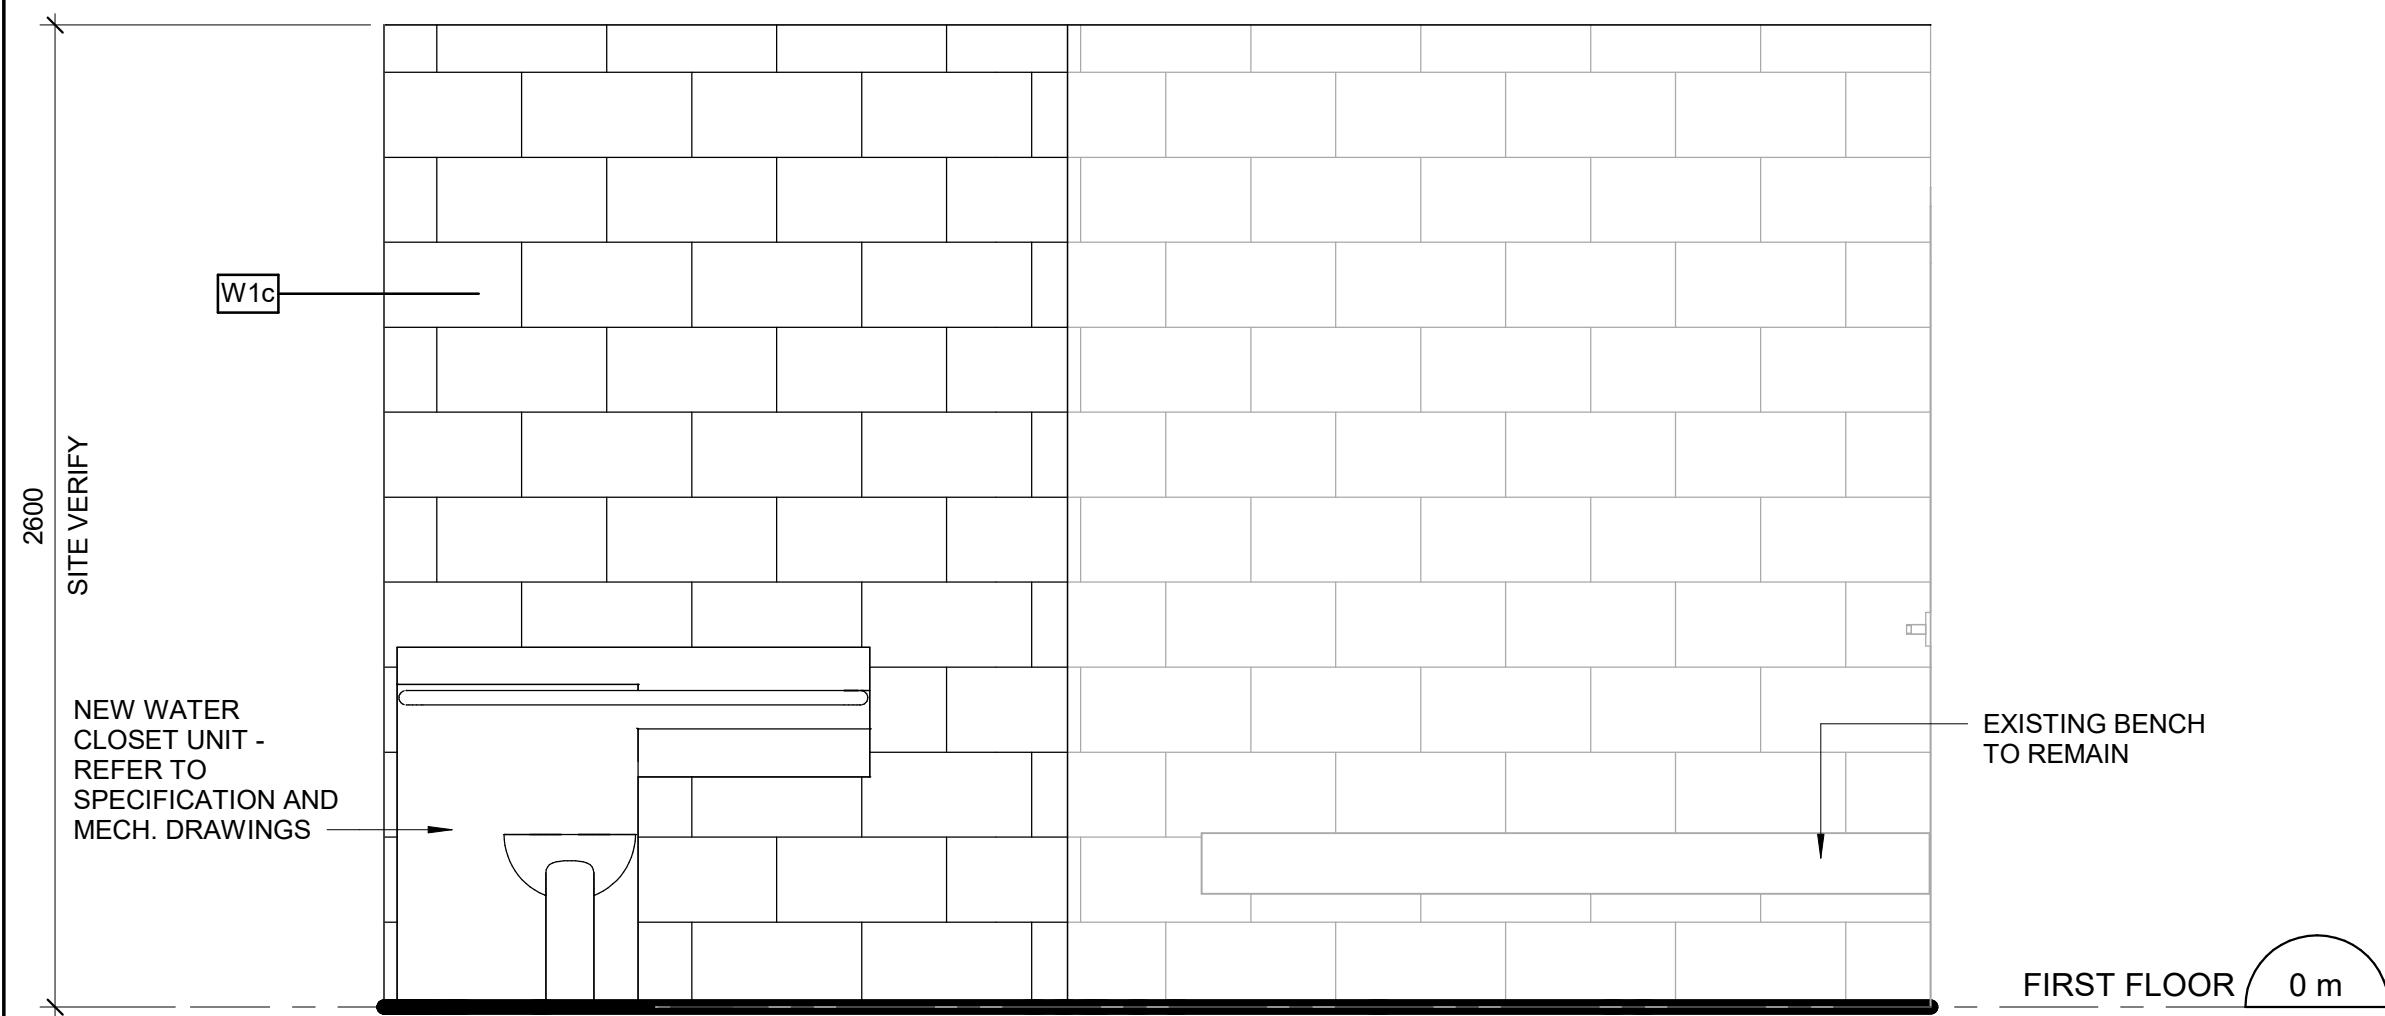

2 BARRIER-FREE WSHROOM/ HOLDING UNIT - SOUTH ELEVATION
A5011 Scale: 1 : 20

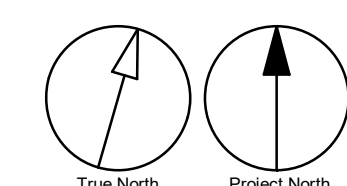

ISSUES		
No.	DESCRIPTION	DATE
A	50% SUBMISSION	2021-11-19
B	90% SUBMISSION	2022-02-22
C	ISSUED FOR PERMIT	2022-03-18
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Toronto, ON M9W 0C9, Canada
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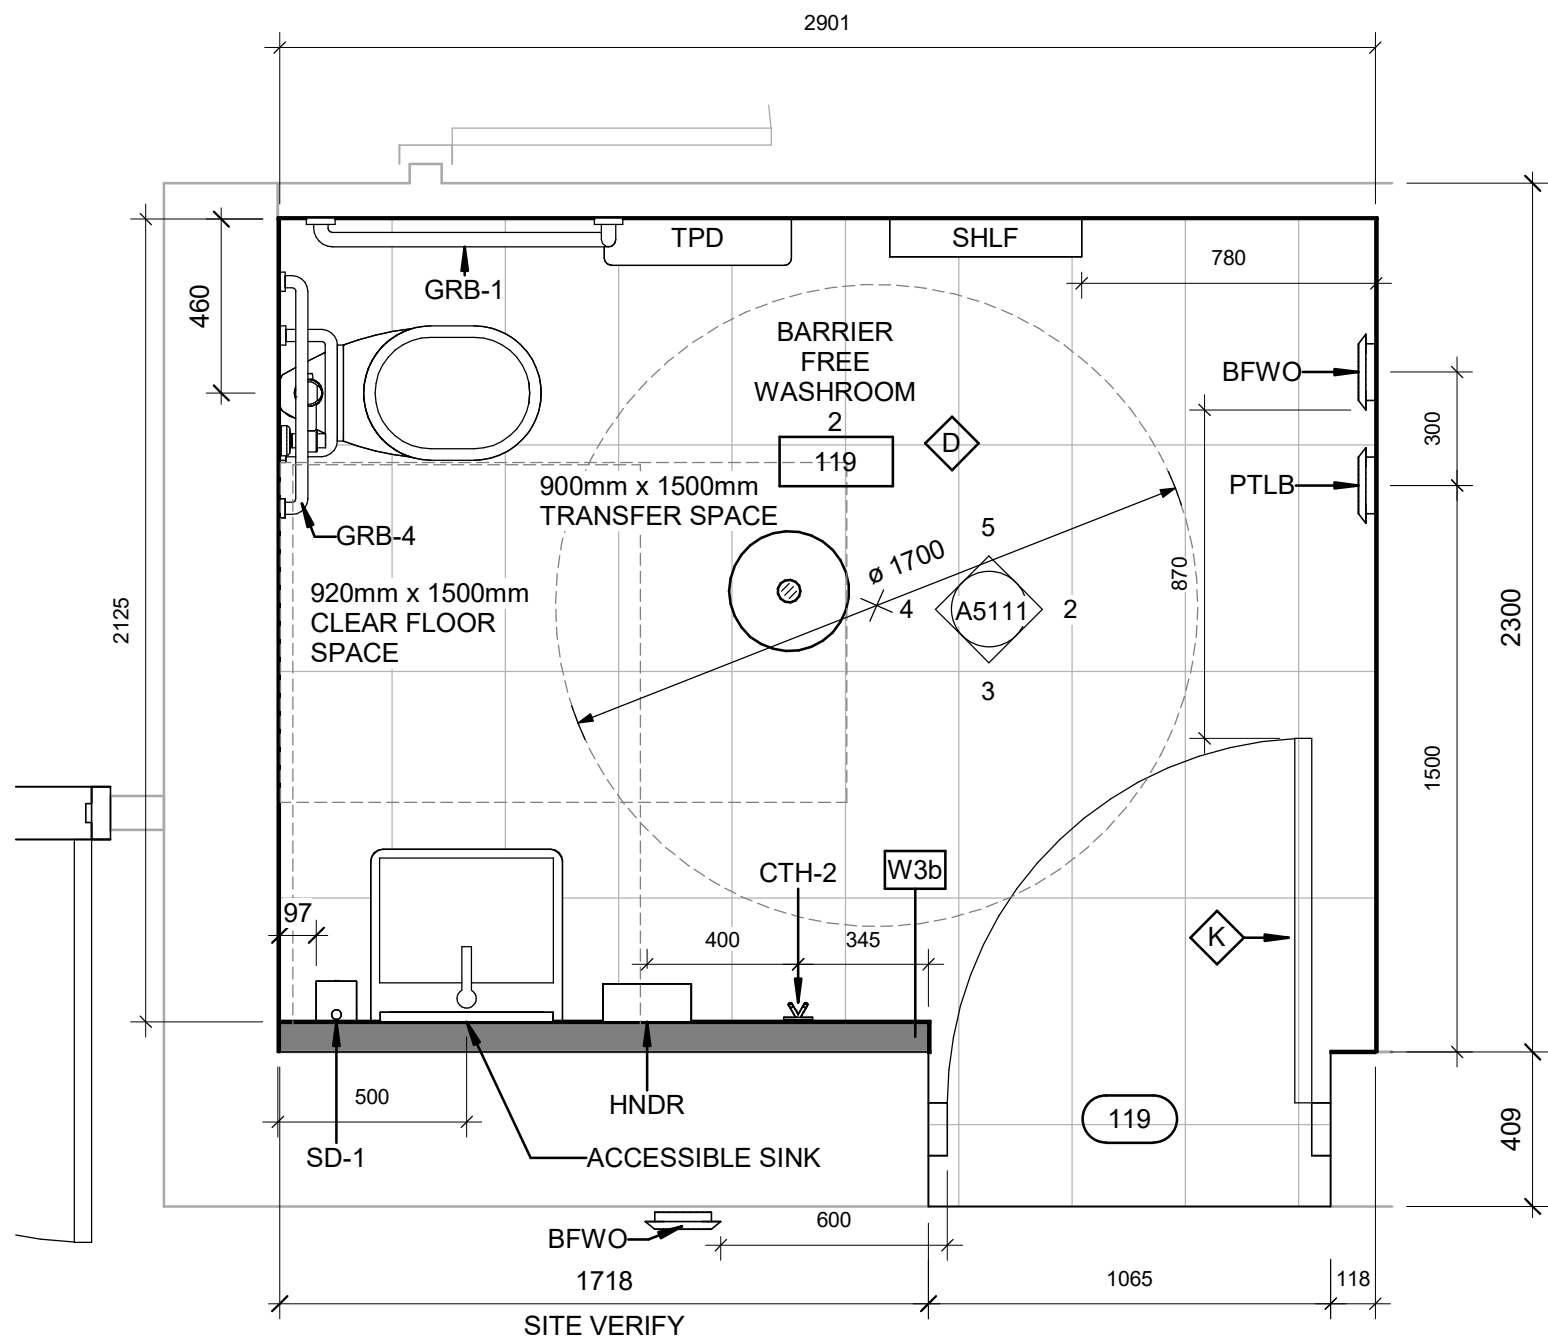
PROJECT TITLE
**CITY OF TORONTO
ACCESSIBILITY UPGRADES**

PROJECT ADDRESS
**POLICE NO. 33 DIVISION
50 UPJOHN RD**


PROJECT NO:
9119-19-0162 / Arcadis 30279056
DRAWN BY:
A.Sunil
PROJECT MGR:
F. BOLOURIAN
CHECKED BY:
K.Tilahun
APPROVED BY:
E.Fenuta

SHEET TITLE
**BARRIER FREE
WASHROOM 1 - FIRST
FLOOR**


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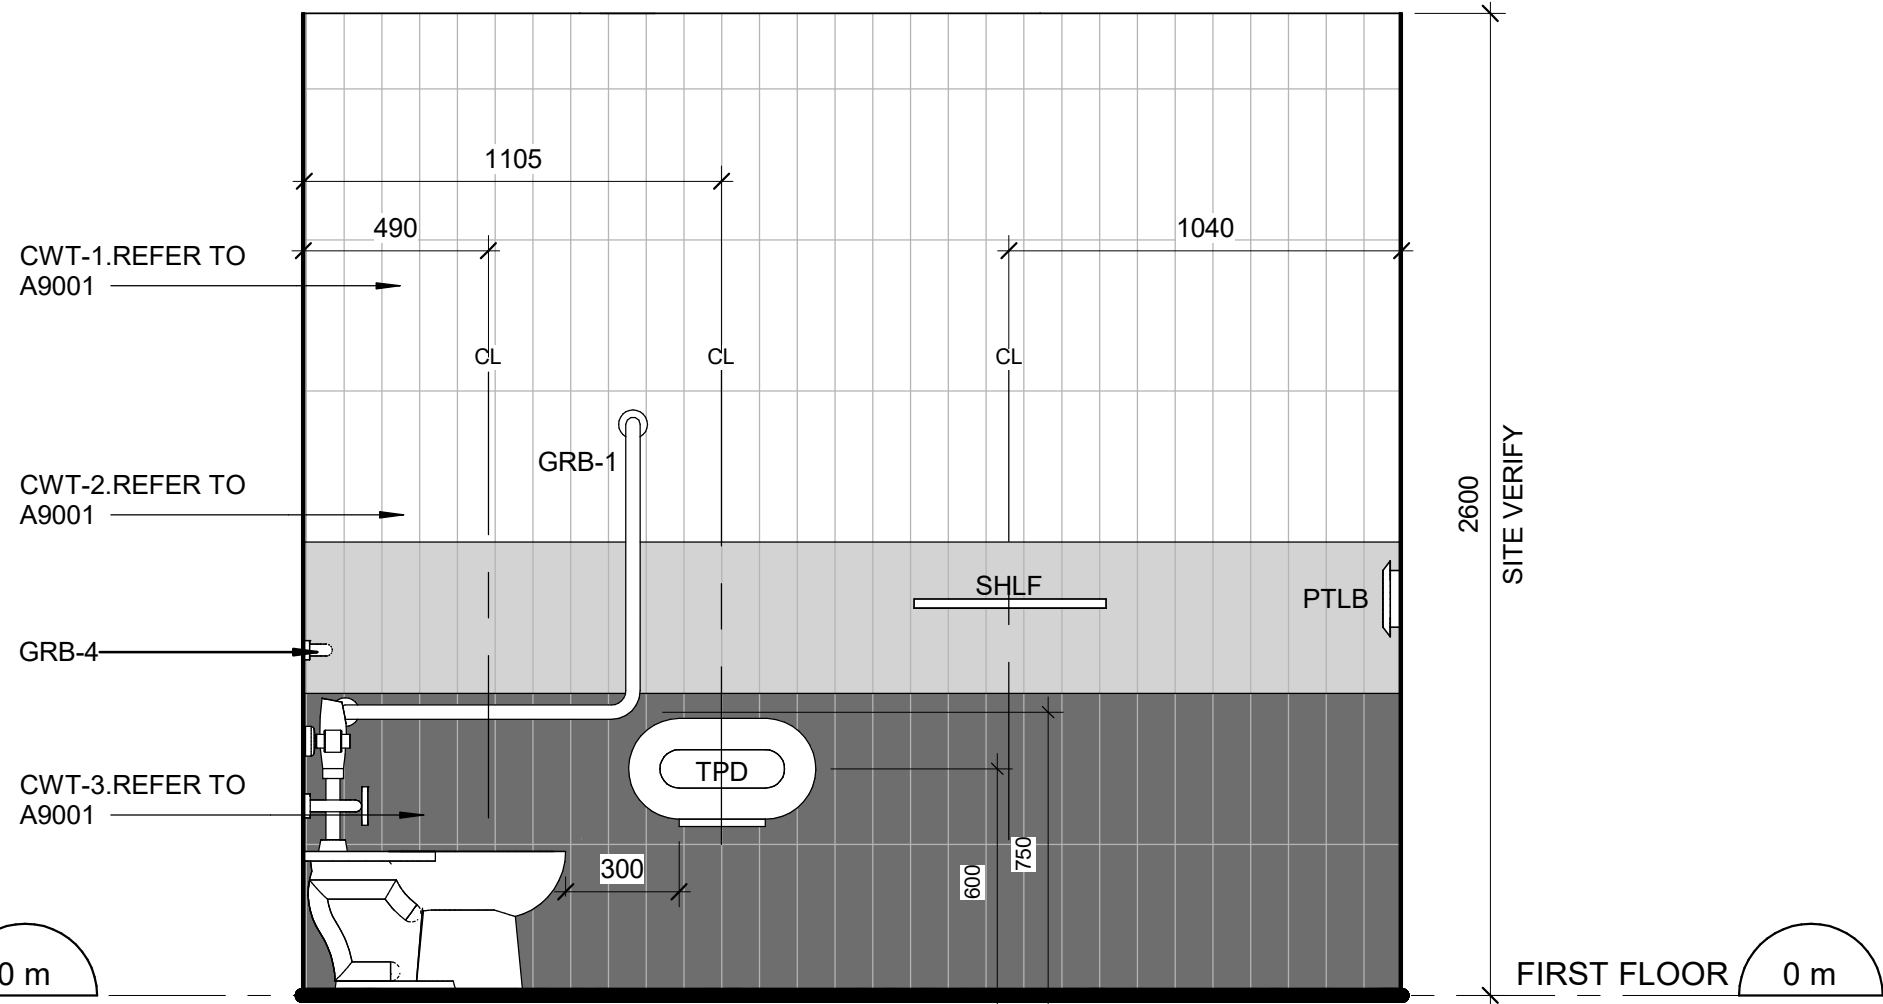
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A5111 Scale: 1 : 20




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A5111 Scale: 1 : 20

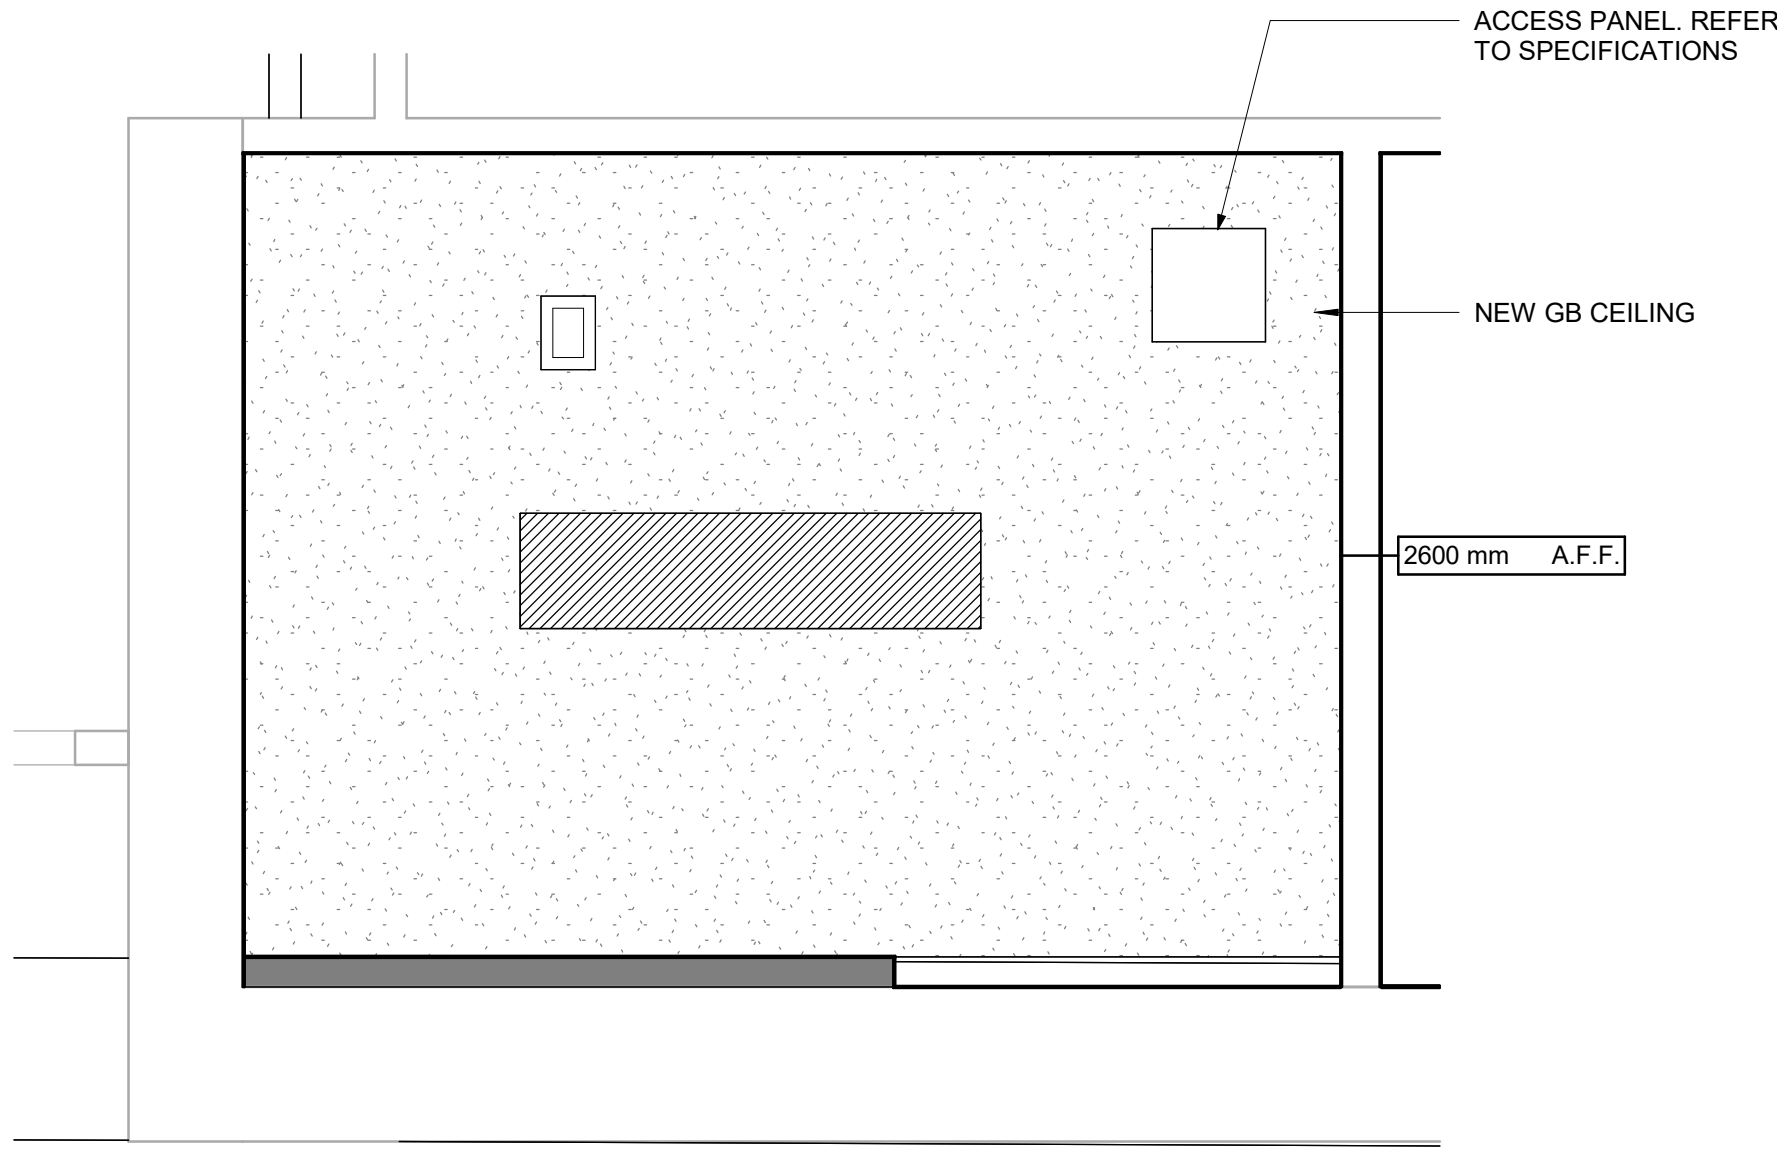


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A5111 Scale: 1 : 20

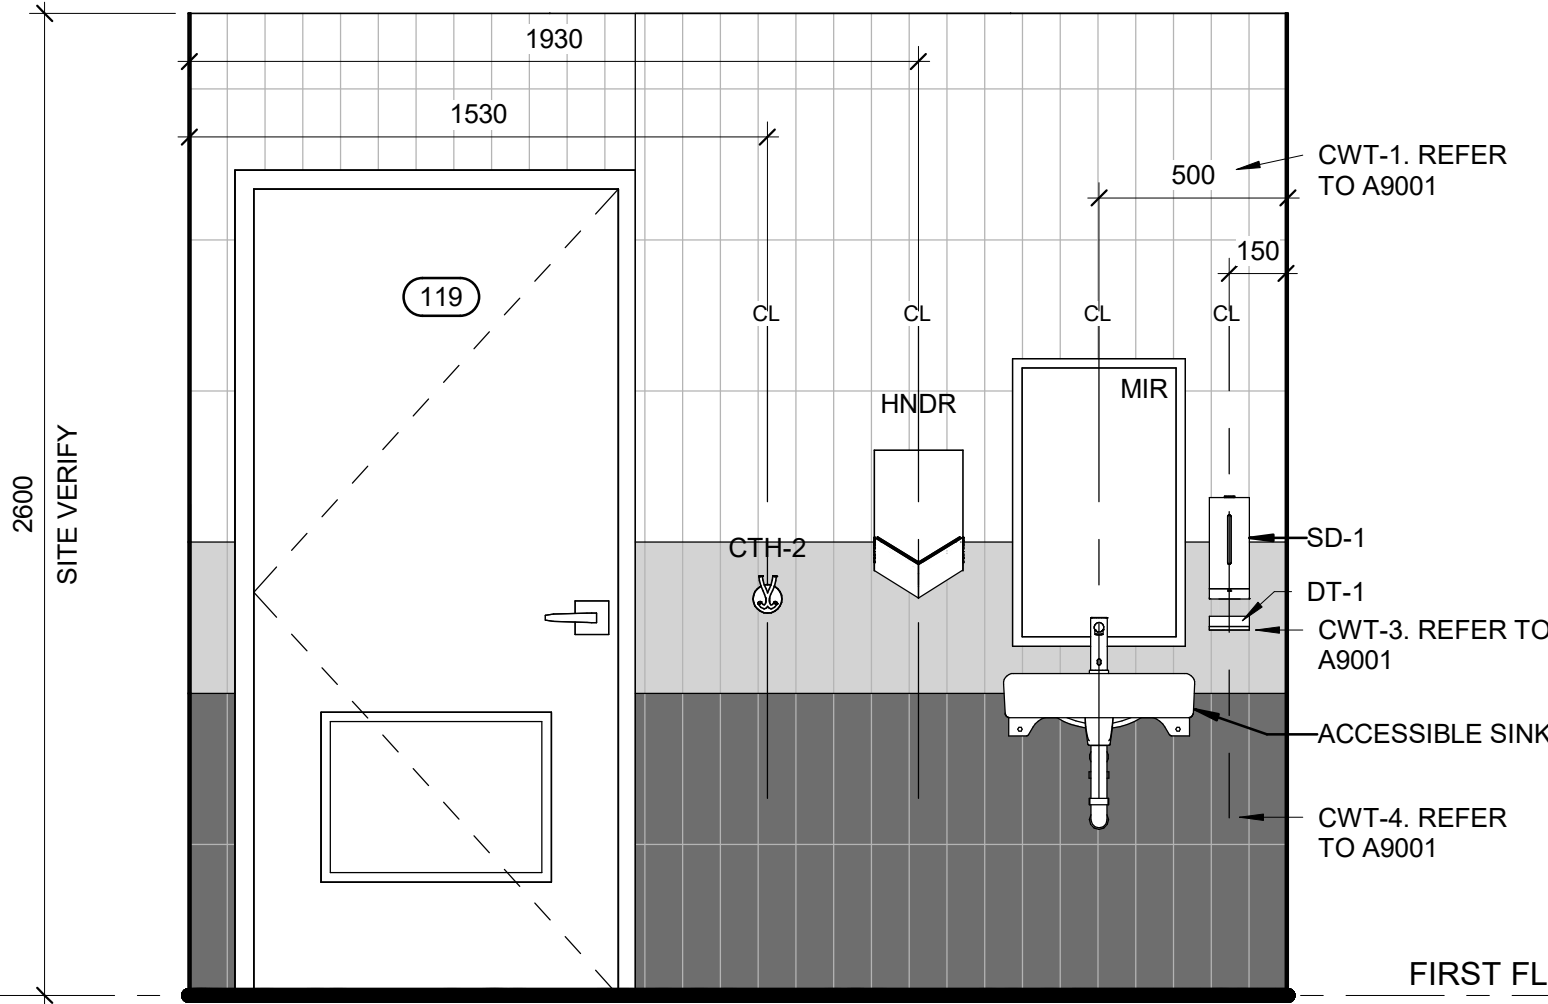

5 BARRIER FREE WASHROOM 2 - NORTH ELEVATION
A5111 Scale: 1 : 20

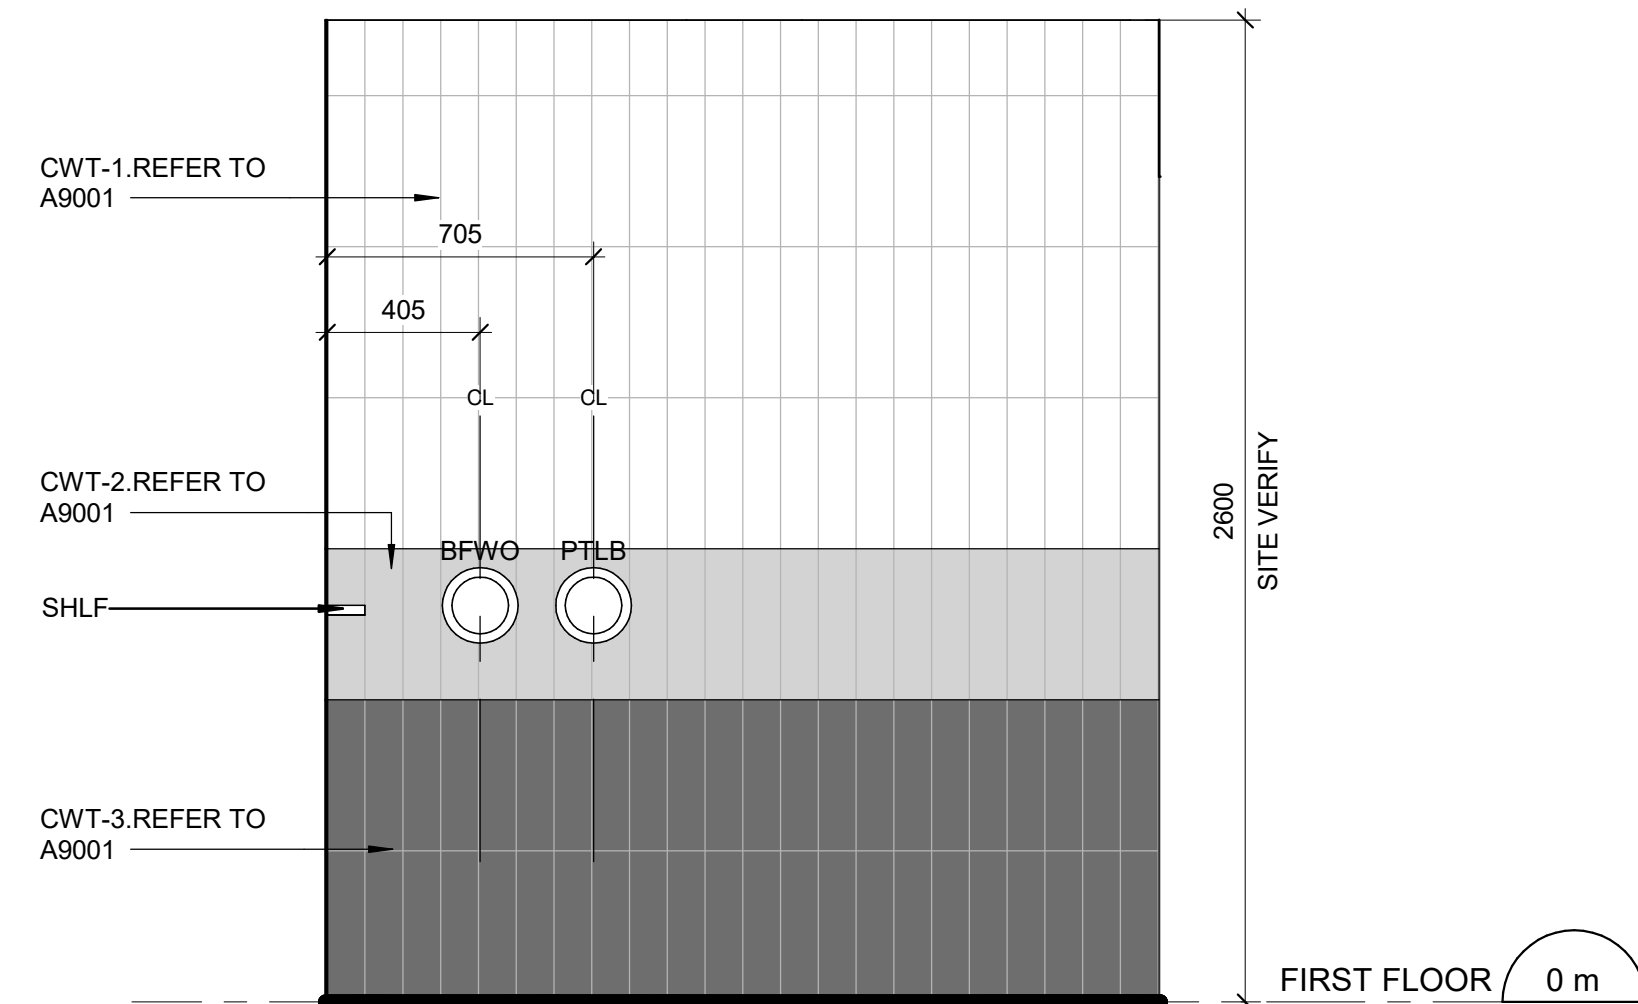

2 BARRIER FREE WASHROOM 2 - EAST ELEVATION
A5111 Scale: 1 : 20

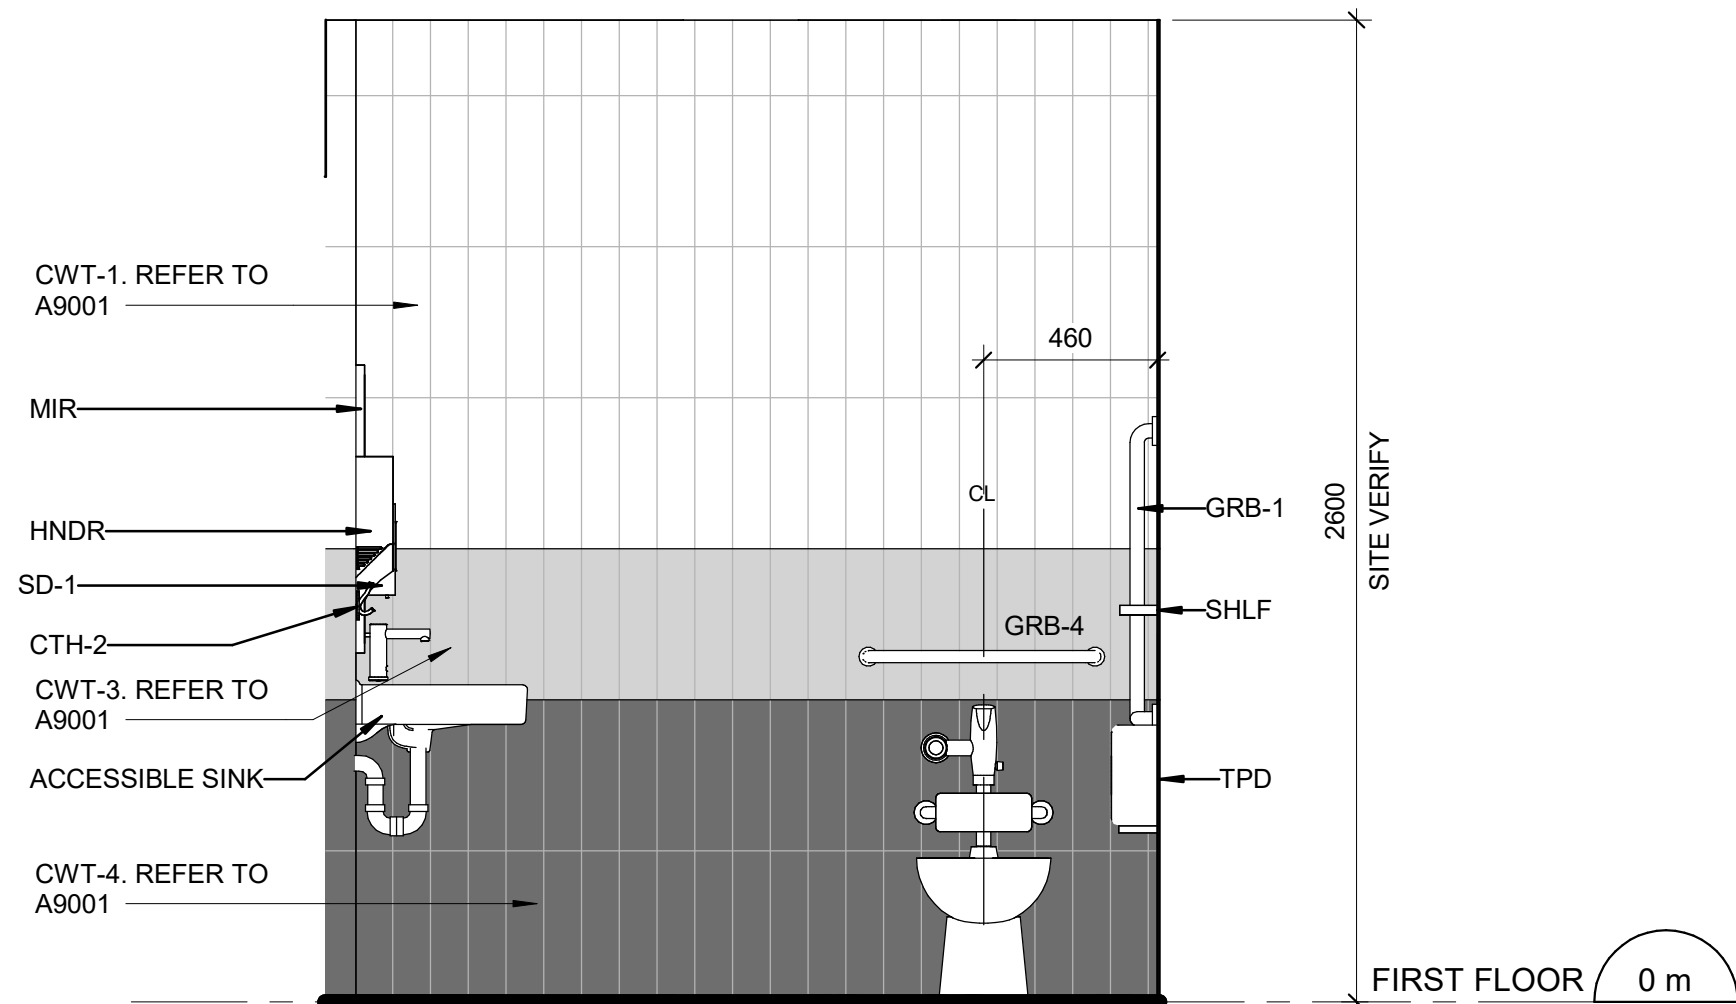

4 BARRIER FREE WASHROOM 2 - WEST ELEVATION
A5111 Scale: 1 : 20

CONSTRUCTION KEY LEGEND

- EXISTING PARTITION TO REMAIN
- NEW PARTITION
REFER TO PARTITION SCHEDULE
- NEW DOOR AND/ OR
NEW HARDWARE

CONSTRUCTION GENERAL NOTES

- NEW DOOR CARD READER AND BARRIER FREE PUSH BUTTON - REFER TO ELECTRICAL DRAWINGS. FOR LOCATION AND HEIGHT INSTALLATION REFER TO ARCHITECTURAL DETAIL BOOKLET.
- REPAINT ENTIRE WALL AFTER WALL-MOUNTED HANDRAIL REPLACEMENT - UNLESS OTHERWISE NOTED. COLOUR AND FINISH TO MATCH EXISTING

CONSTRUCTION KEY NOTES

- | NO | DESCRIPTION |
|----|---|
| D | INSTALL NEW WASHROOM ACCESSORIES - REFER TO DETAILS 1/D1201, 2/D1201, 3/D1201, 4/D1201, 5/D1201. |
| K | INSTALL NEW DOOR AND FRAME. REFER TO DOOR SCHEDULE A9001, G0004 AND DOOR HARDWARE SCHEDULE IN THE SPECIFICATIONS. |

CEILING LEGEND

- GYPSUM BOARD CEILING
AND BULKHEAD
- SUPPLY / RETURN DUCT
- CEILING, PENDANT OR
WALL MOUNTED LUMINAIRE

WASHROOM GENERAL NOTES

- ALL EXISTING SOAP DISPENSERS AND MIRRORS TO BE LOWERED. REFER TO 2/D1201, 4/D1201.
- ALL WASHROOM ACCESSORIES TO BE INSTALLED AFTER SPECIFIED WALL FINISH HAS BEEN APPLIED. NEW SOAP COLLECTORS TO BE ADDED TO ALL SOAP DISPENSERS. REFER TO 2/D1201.
- MOISTURE RESISTANT GYPSUM BOARD TO BE PROVIDED IN ALL WASHROOMS AND LOCKER ROOMS

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Project Management Office
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B	90% SUBMISSION	2022-02-22
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D	ISSUED FOR TENDER	2025-04-11

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PROJECT TITLE
**CITY OF TORONTO
ACCESSIBILITY UPGRADES**

PROJECT ADDRESS

**POLICE NO. 33 DIVISION
50 UPJOHN RD**

PROJECT NO:
9119-19-0162 / Arcadis 30279056

DRAWN BY:
A.Sunil

CHECKED BY:
K.Tilahun

PROJECT MGR:
F. BOLOURIAN

APPROVED BY:
E.Fenuta

SHEET TITLE


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WASHROOM 2- FIRST
FLOOR**


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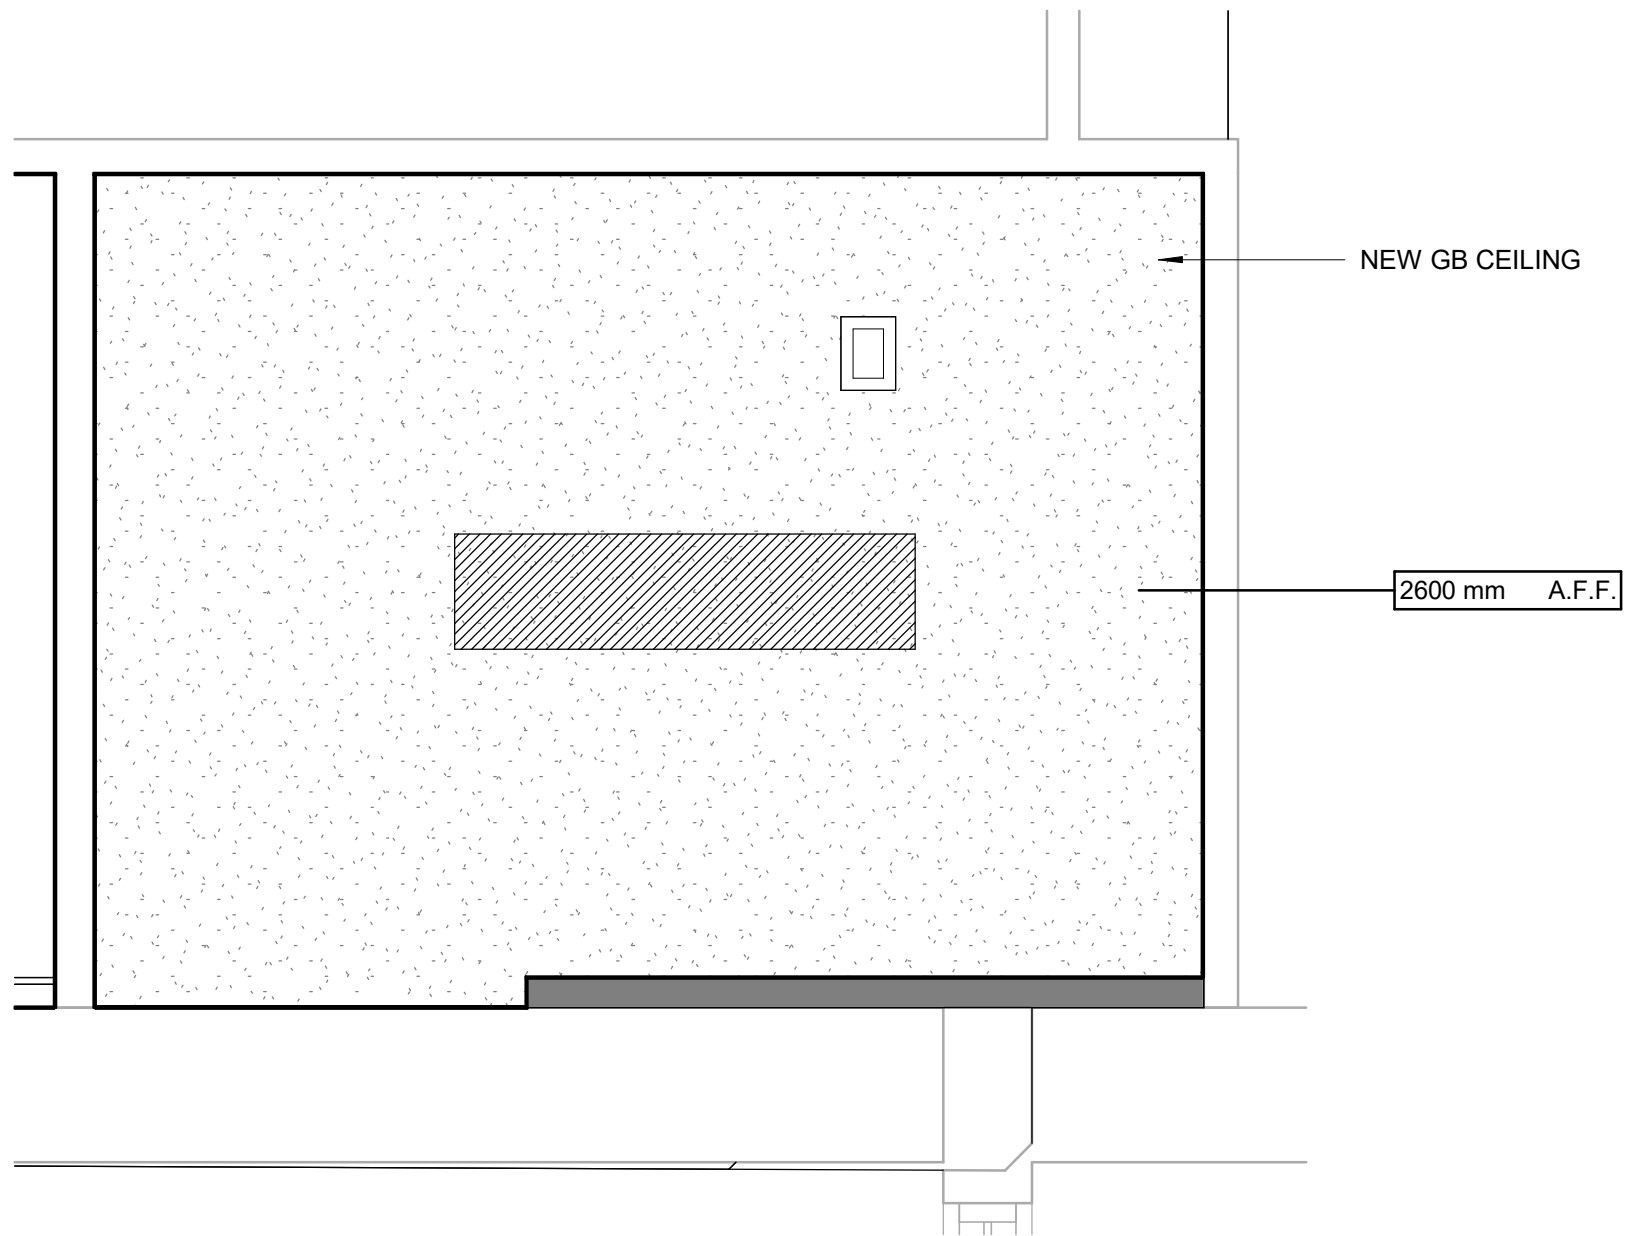
ISSUE

D




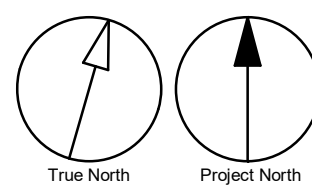


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A5211 / Scale: 1 : 20

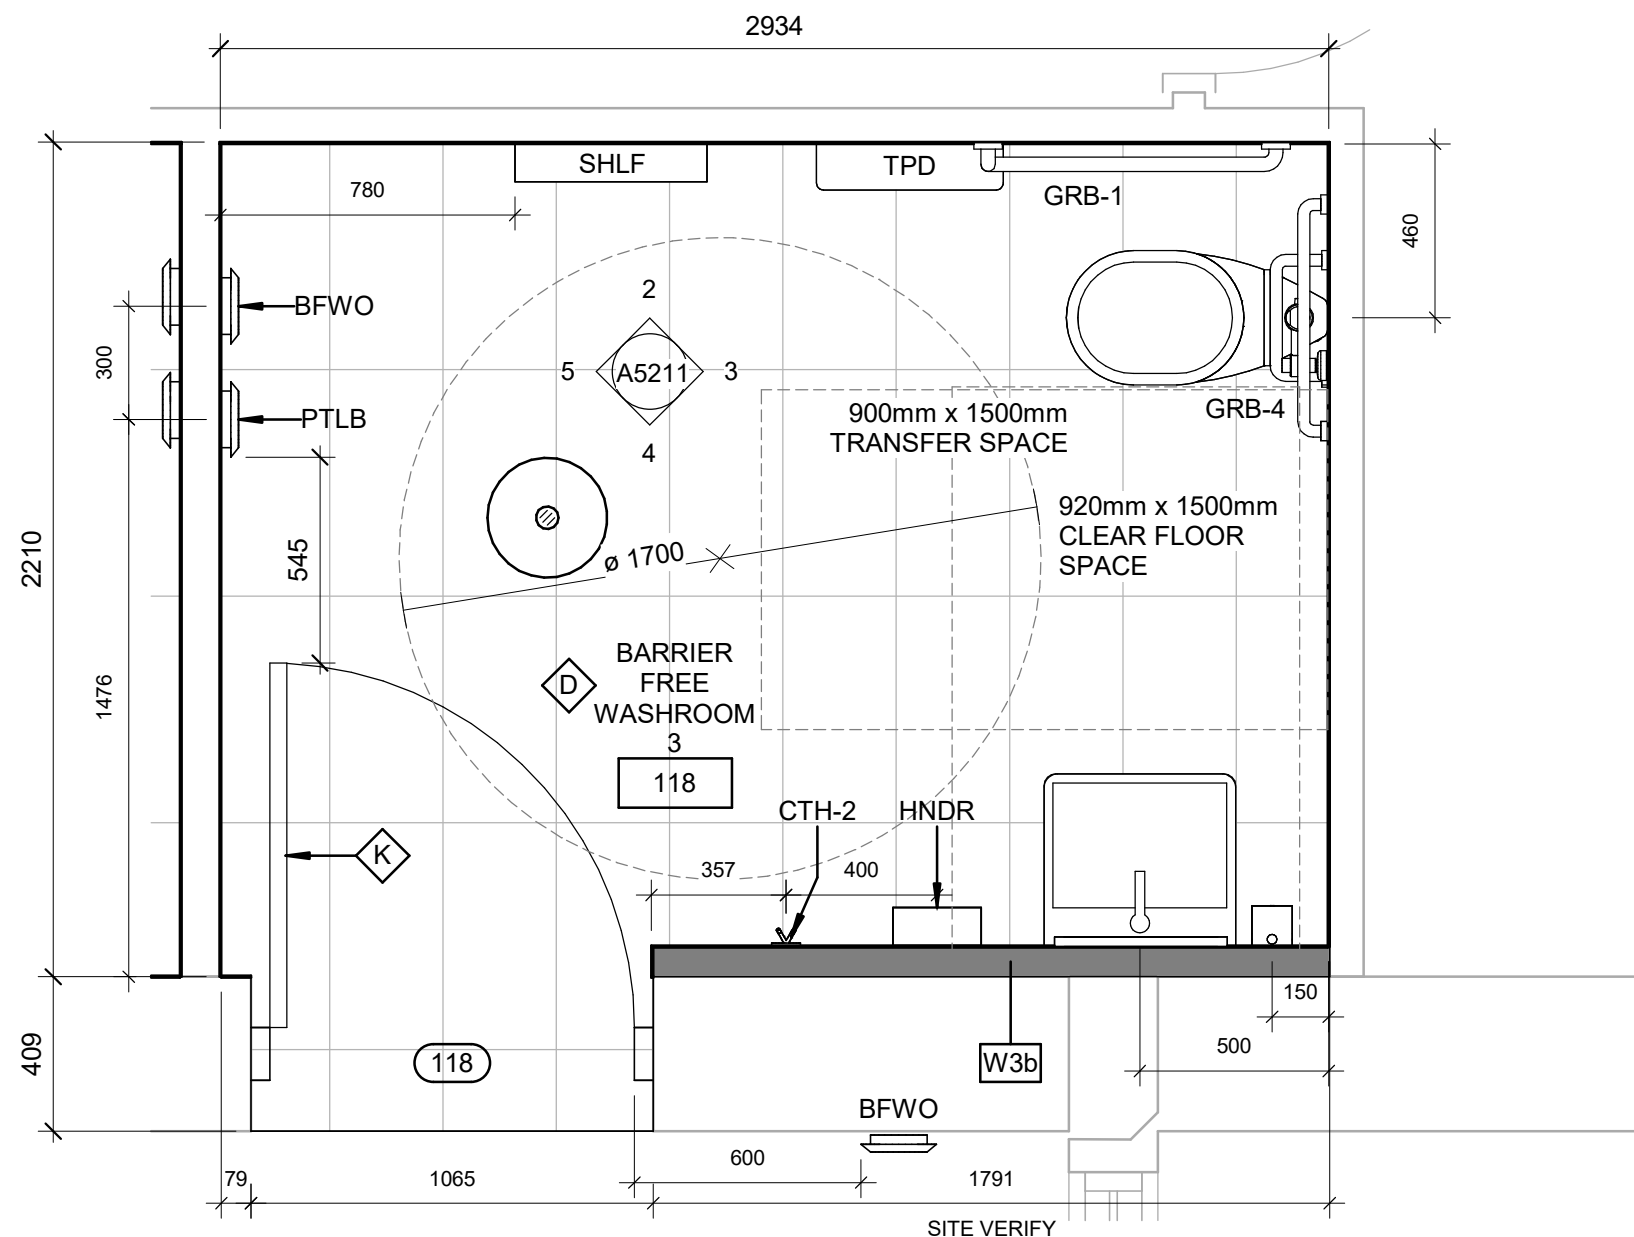


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A5211 / Scale: 1 : 20

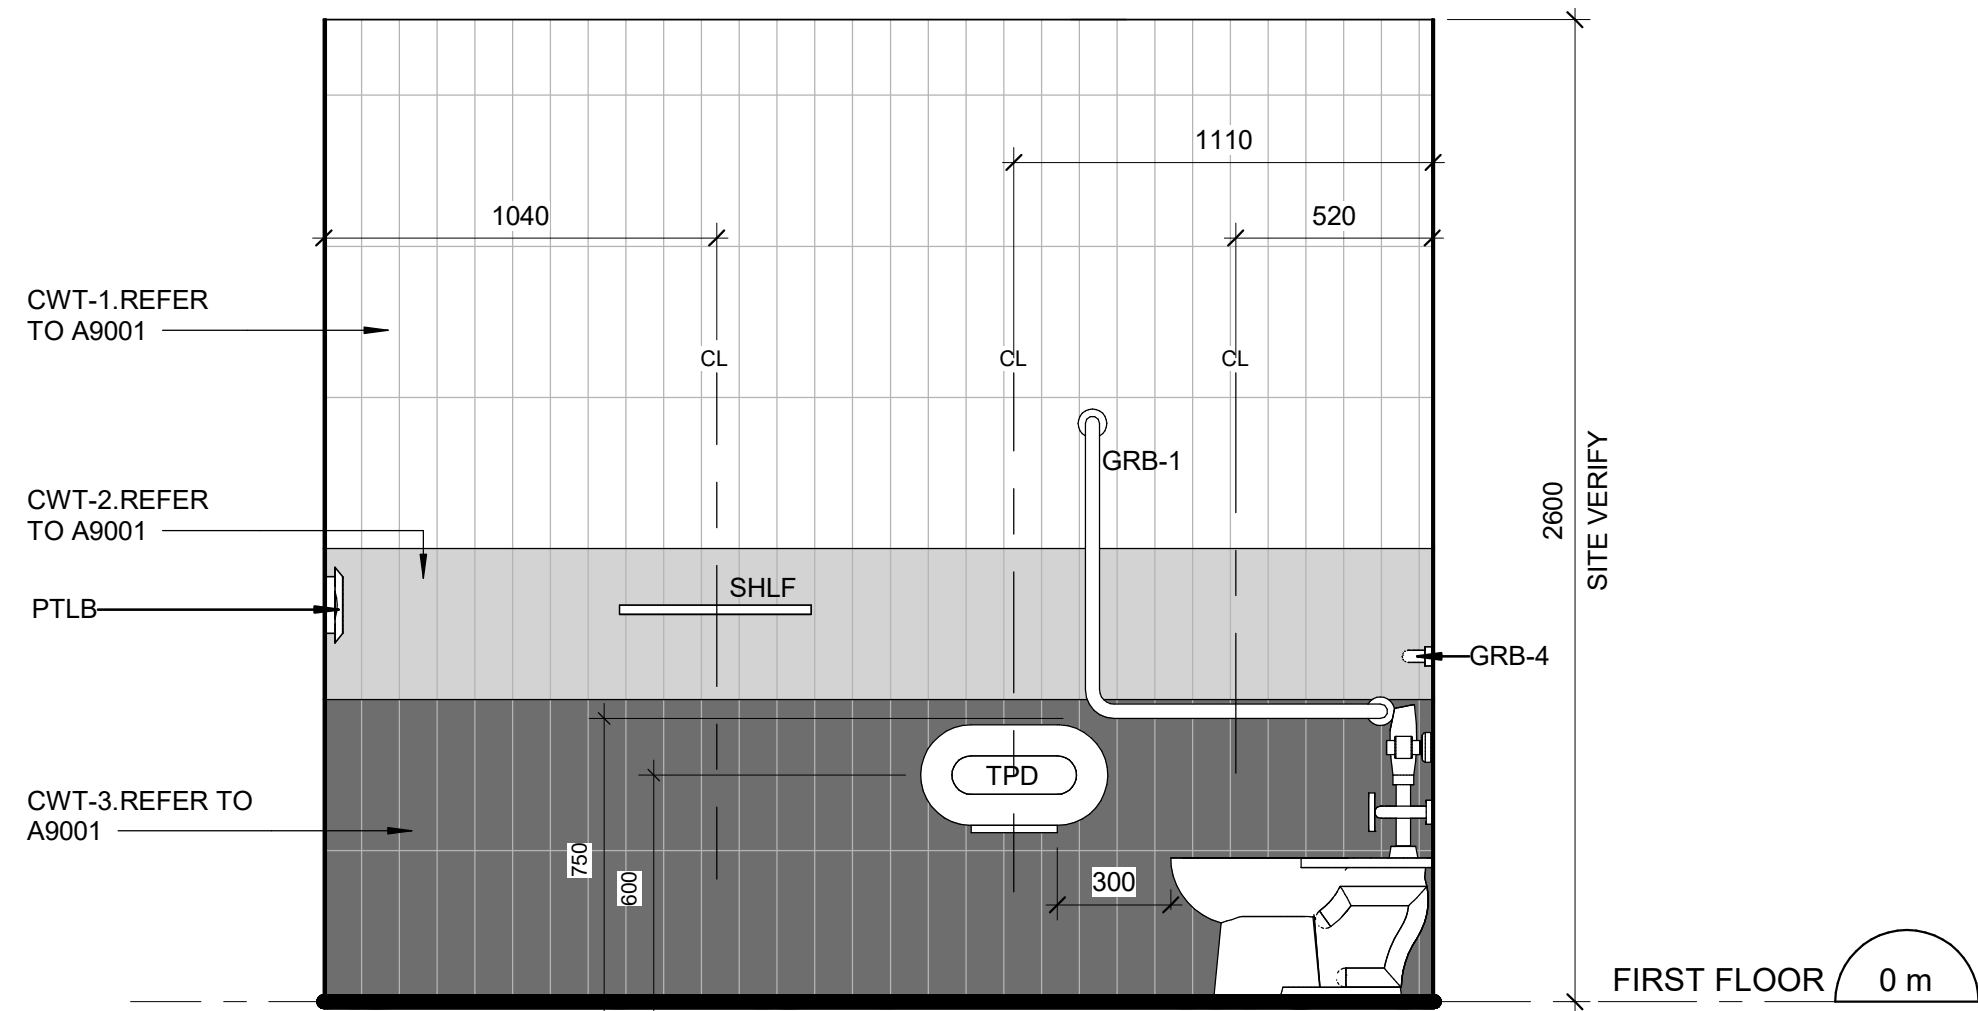


2 BARRIER FREE WASHROOM 3 - NORTH ELEVATION
A5211 / Scale: 1 : 20

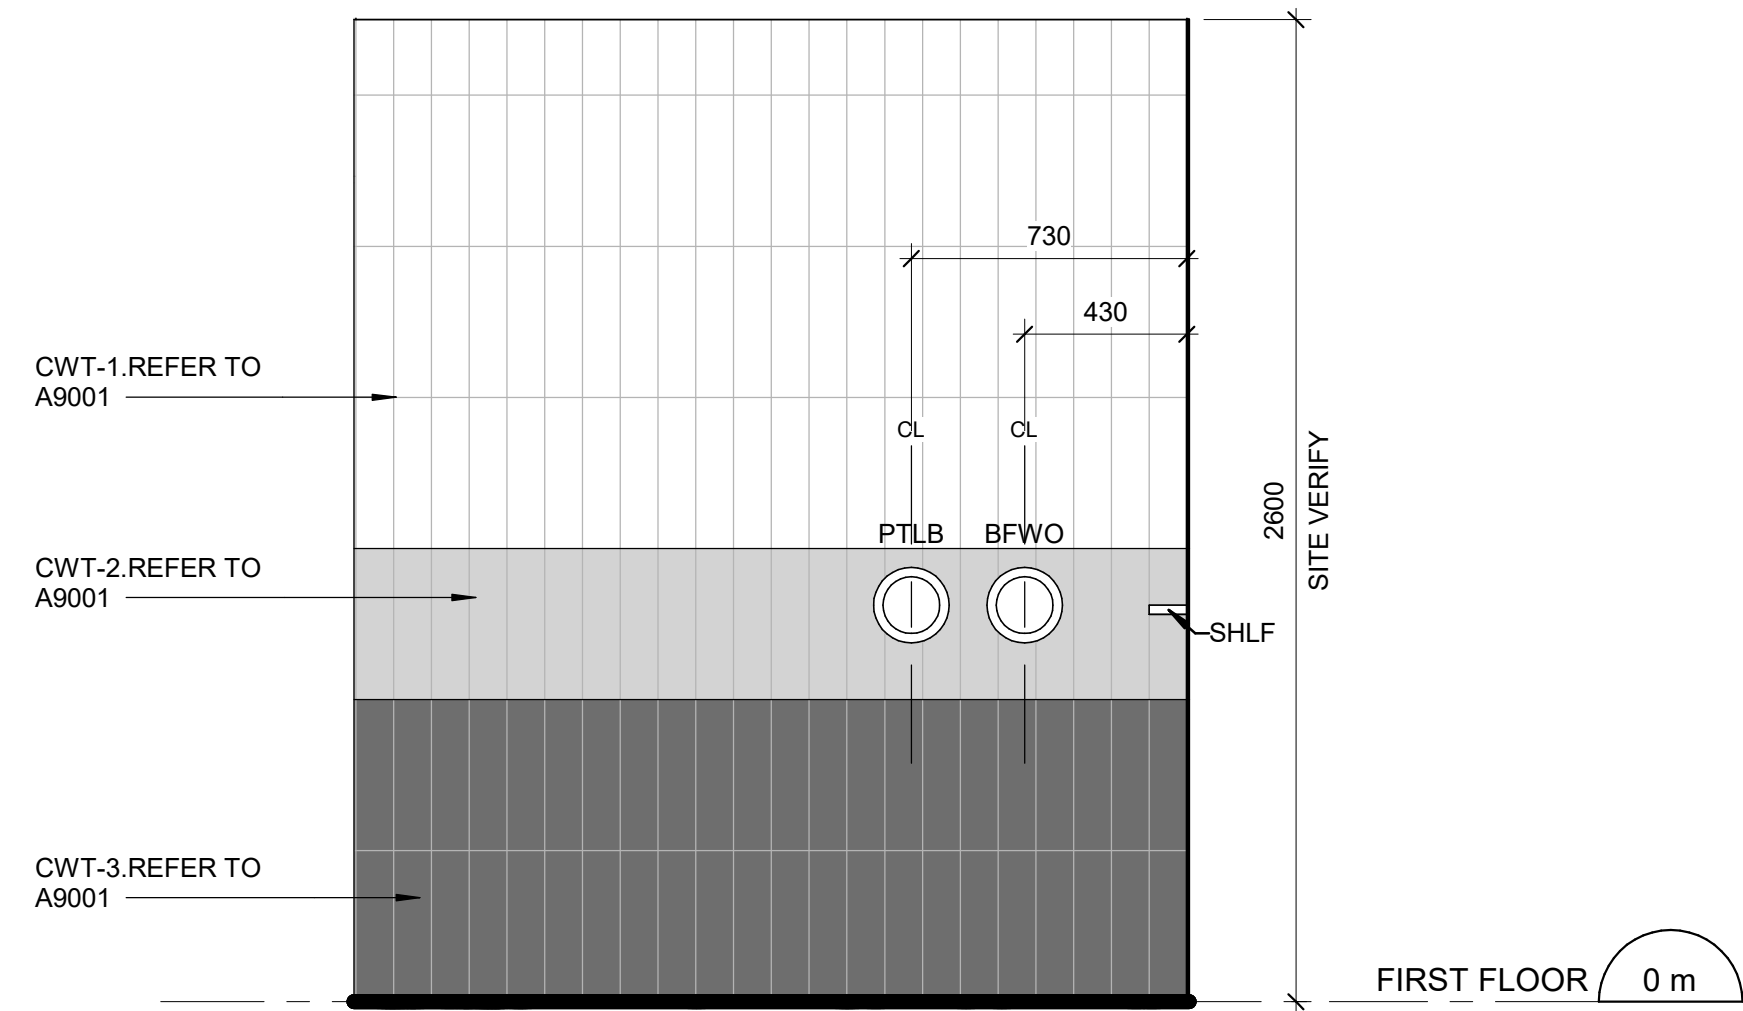

5 BARRIER FREE WASHROOM 3 - WEST ELEVATION
A5211 / Scale: 1 : 20

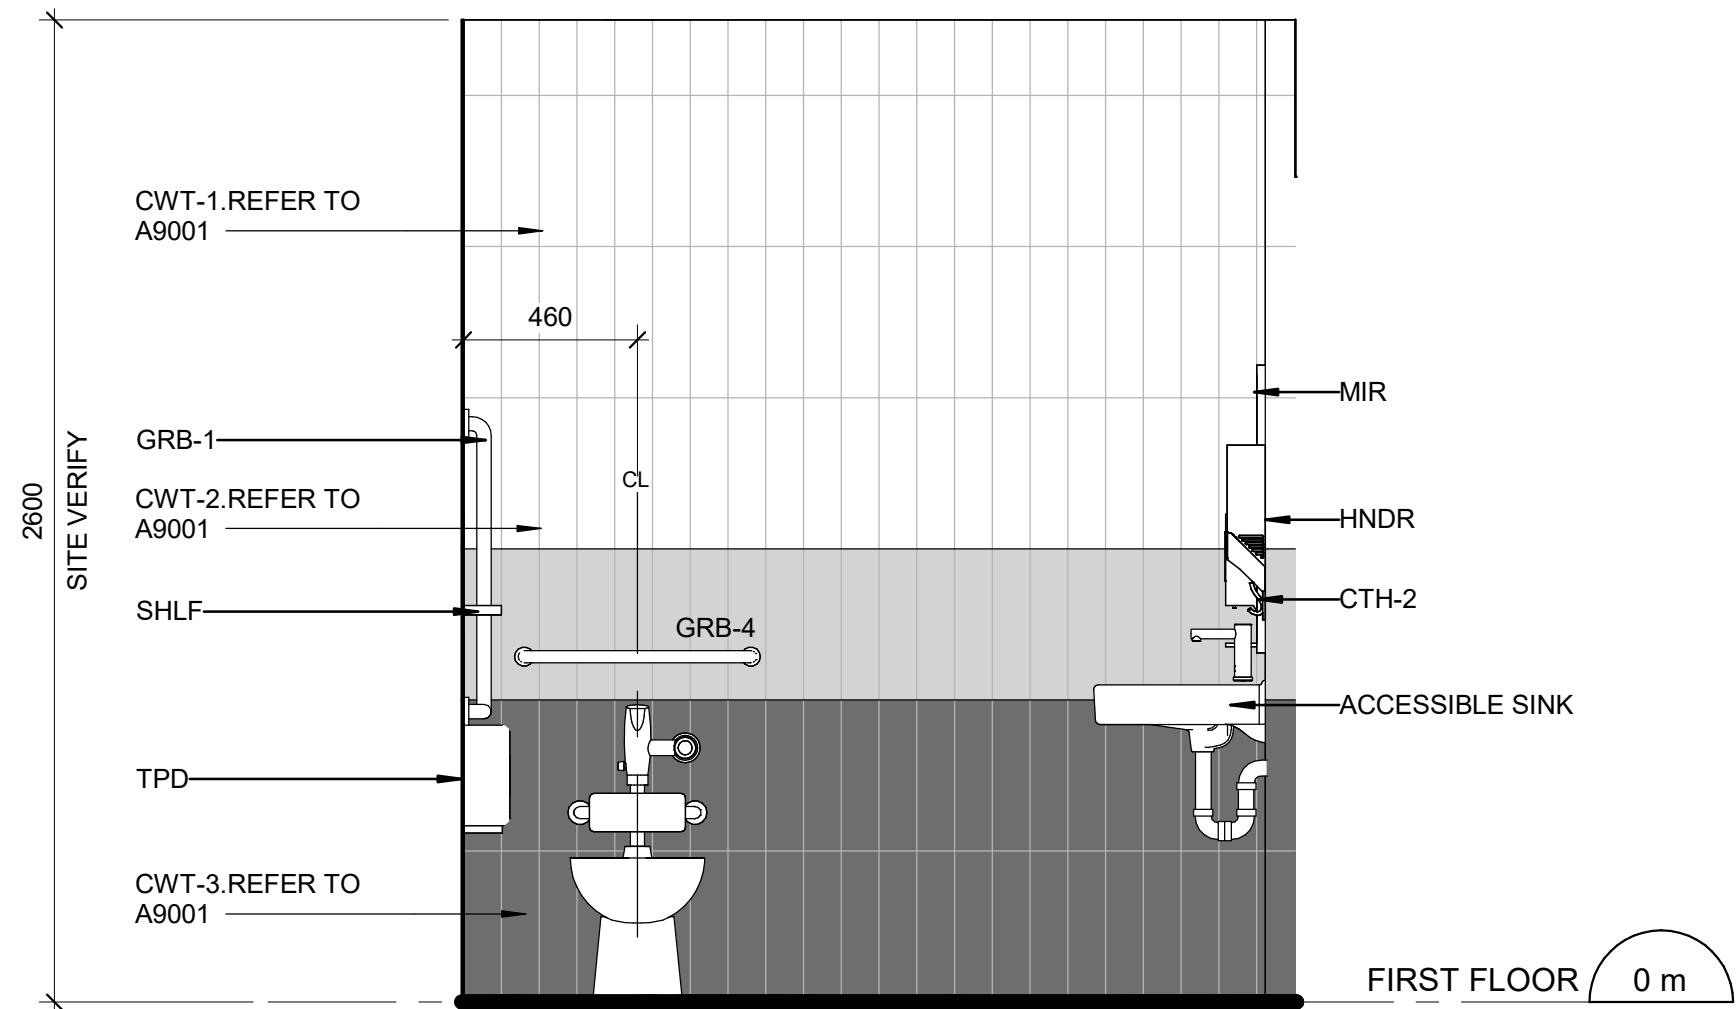

3 BARRIER FREE WASHROOM 3 - EAST ELEVATION
A5211 / Scale: 1 : 20

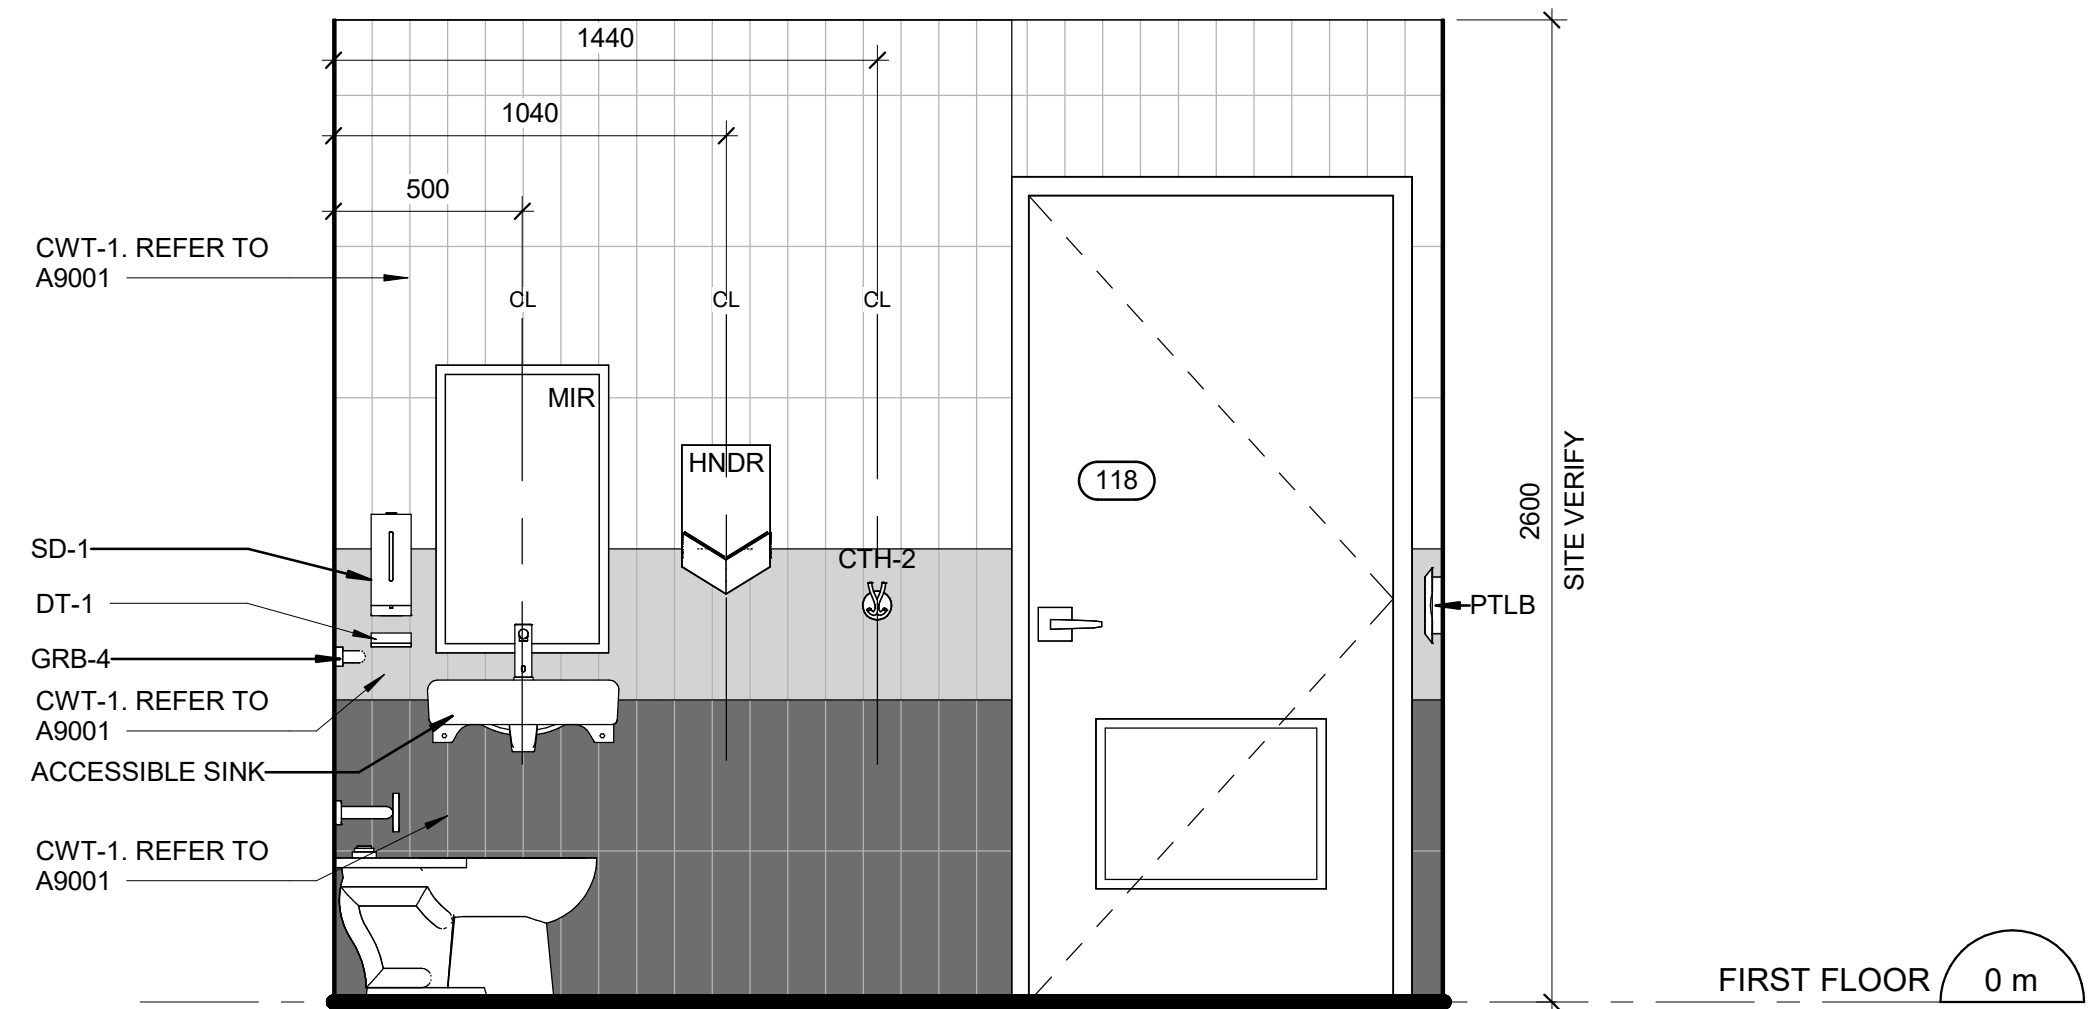

4 BARRIER FREE WASHROOM 3 - SOUTH ELEVATION
A5211 / Scale: 1 : 20

CONSTRUCTION KEY LEGEND

	EXISTING PARTITION TO REMAIN
	NEW PARTITION REFER TO PARTITION SCHEDULE
	NEW DOOR AND/ OR NEW HARDWARE

CONSTRUCTION GENERAL NOTES

- NEW DOOR CARD READER AND BARRIER FREE PUSH BUTTON - REFER TO ELECTRICAL DRAWINGS. FOR LOCATION AND HEIGHT INSTALLATION REFER TO ARCHITECTURAL DETAIL BOOKLET.
- REPAINT ENTIRE WALL AFTER WALL-MOUNTED HANDRAIL REPLACEMENT - UNLESS OTHERWISE NOTED. COLOUR AND FINISH TO MATCH EXISTING

CONSTRUCTION KEY NOTES

NO	DESCRIPTION
D	INSTALL NEW WASHROOM ACCESSORIES - REFER TO DETAILS 1/D1201, 2/D1201, 3/D1201, 4/D1201, 5/D1201.
K	INSTALL NEW DOOR AND FRAME. REFER TO DOOR SCHEDULE A9001, G0004 AND DOOR HARDWARE SCHEDULE IN THE SPECIFICATIONS.

CEILING LEGEND

	GYPSUM BOARD CEILING AND BULKHEAD
	SUPPLY / RETURN DUCT
	CEILING, PENDANT OR WALL MOUNTED LUMINAIRE

WASHROOM GENERAL NOTES

- ALL EXISTING SOAP DISPENSERS AND MIRRORS TO BE LOWERED. REFER TO 2/D1201, 4/D1201.
- ALL WASHROOM ACCESSORIES TO BE INSTALLED AFTER SPECIFIED WALL FINISH HAS BEEN APPLIED. NEW SOAP COLLECTORS TO BE ADDED TO ALL SOAP DISPENSERS. REFER TO 2/D1201.
- MOISTURE RESISTANT GYPSUM BOARD TO BE PROVIDED IN ALL WASHROOMS AND LOCKER ROOMS

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B	90% SUBMISSION	2022-02-22
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PROJECT TITLE
**CITY OF TORONTO
ACCESSIBILITY UPGRADES**

PROJECT ADDRESS

**POLICE NO. 33 DIVISION
50 UPJOHN RD**

PROJECT NO:
9119-19-0162 / Arcadis 30279056

DRAWN BY:
A.Sunil

CHECKED BY:
K.Tilahun

PROJECT MGR:
F. BOLOURIAN

APPROVED BY:
E.Fenuta

SHEET TITLE


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WASHROOM 3- FIRST
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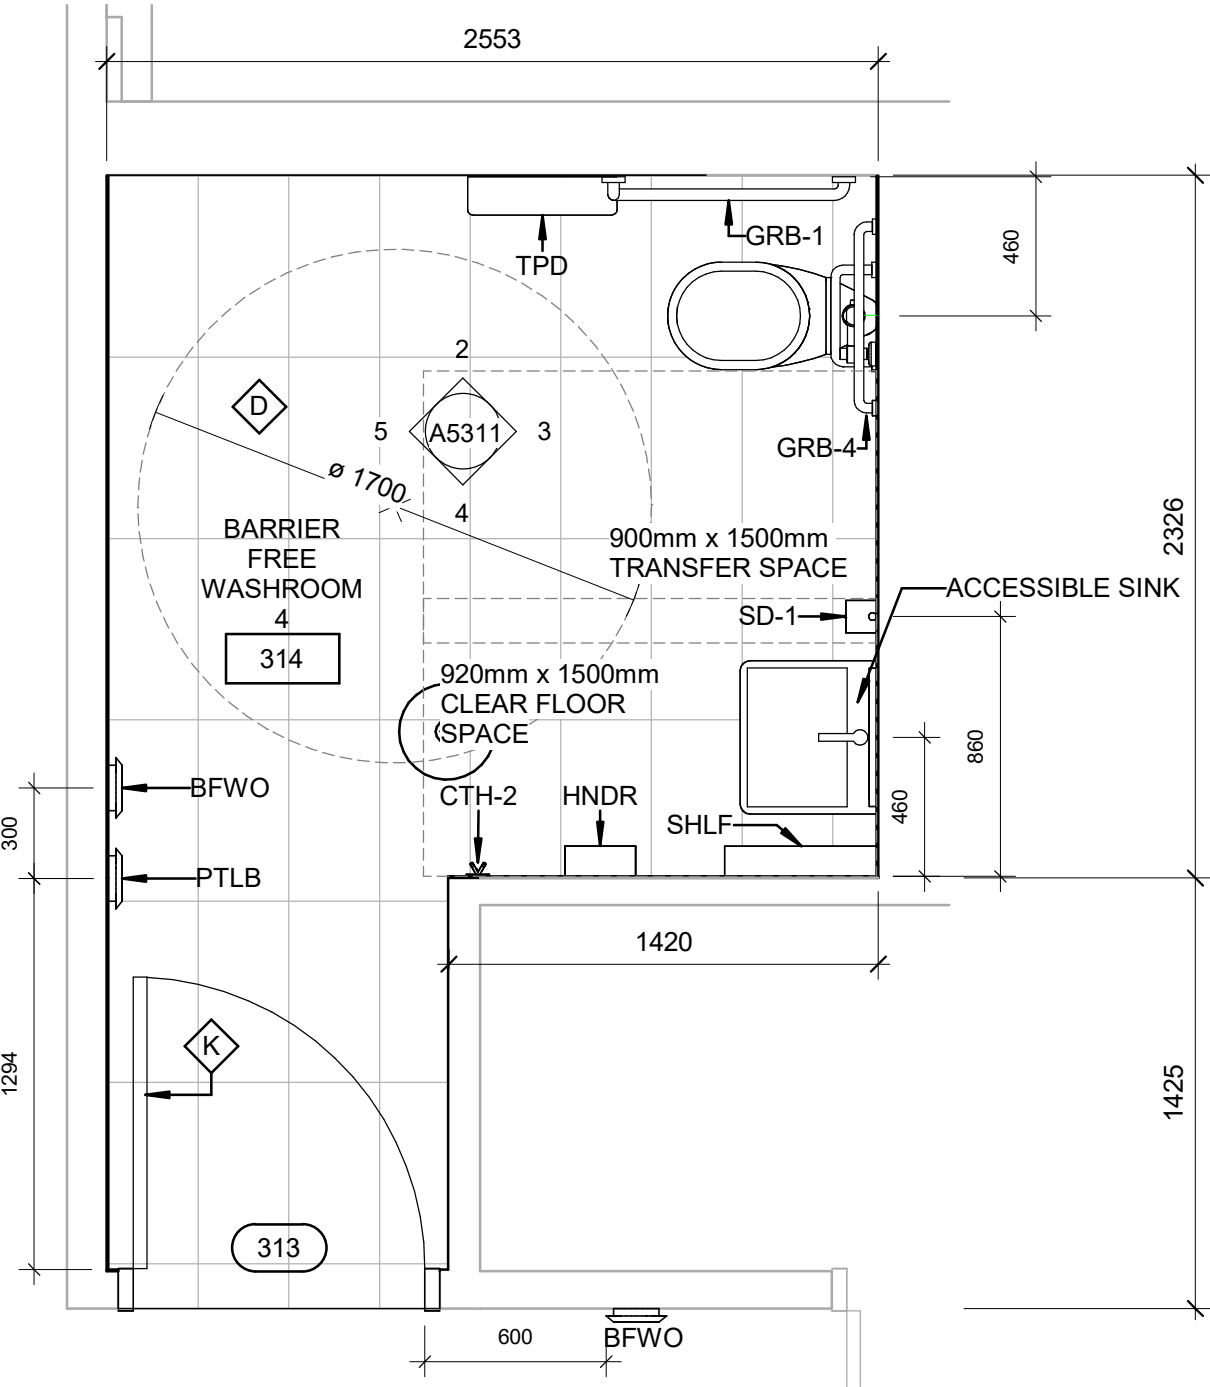
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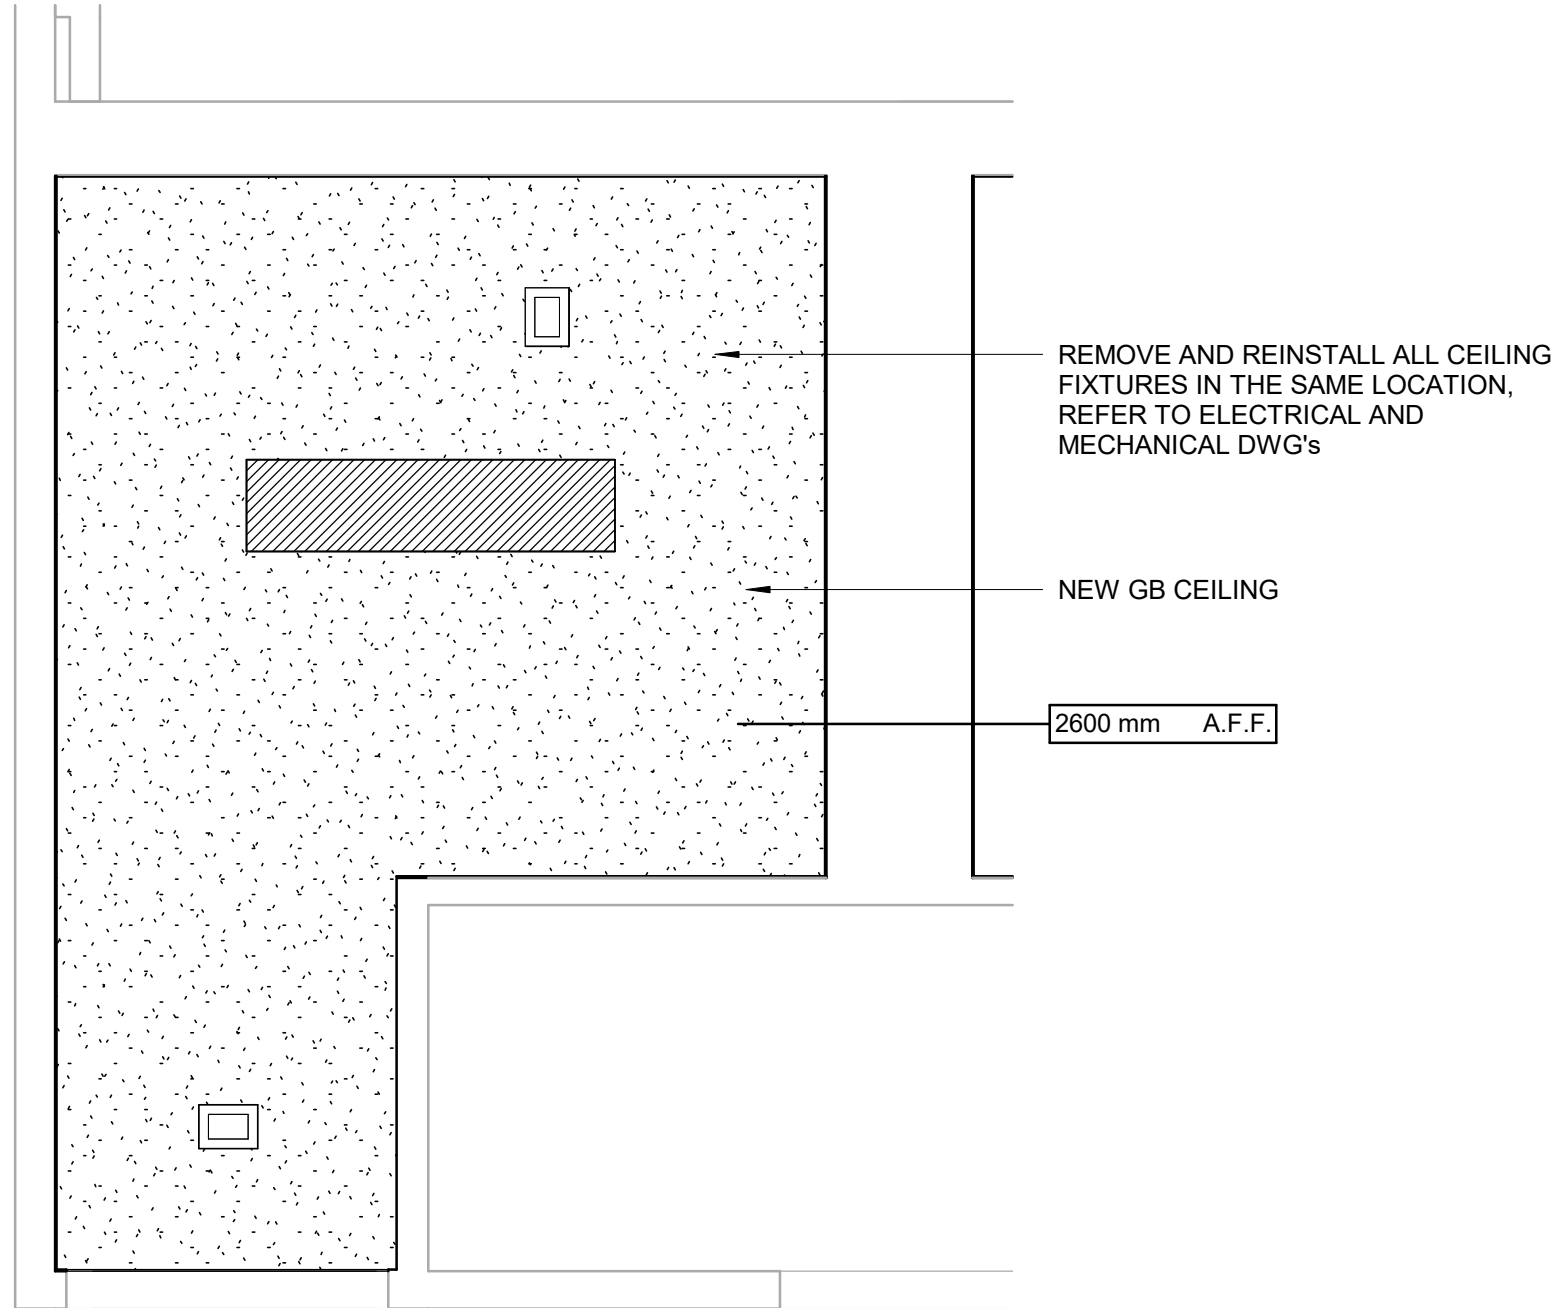
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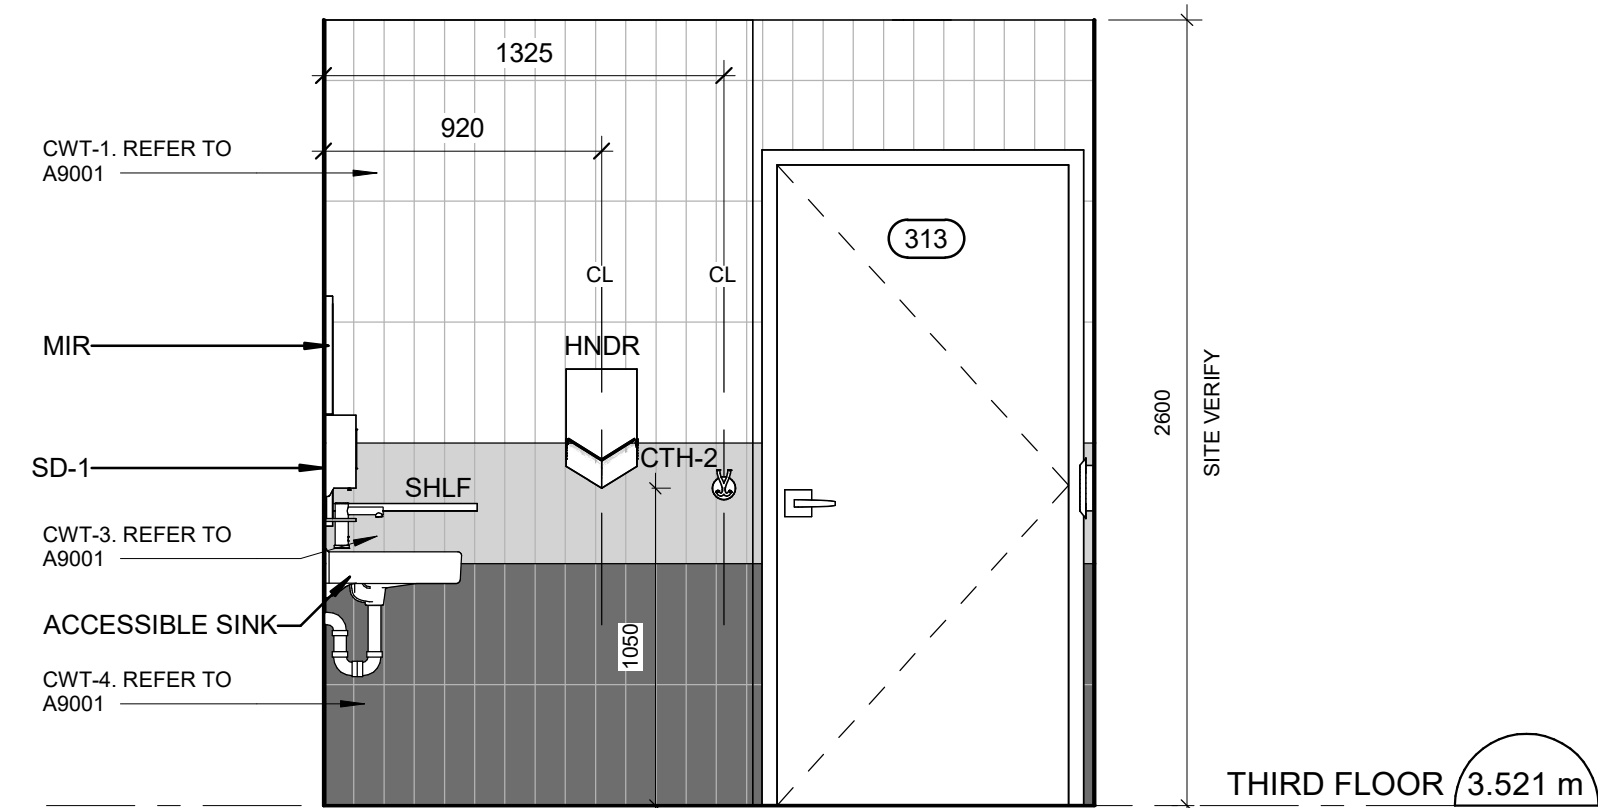





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A5311 Scale: 1 : 25




8 BARRIER FREE WASHROOM 4 - THIRD FLOOR RCP.
A5311 Scale: 1 : 25

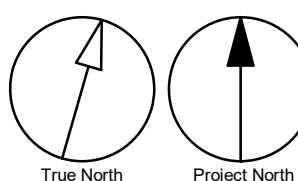


4 BARRIER FREE WASHROOM 4 - SOUTH ELEVATION
A5311 Scale: 1 : 25

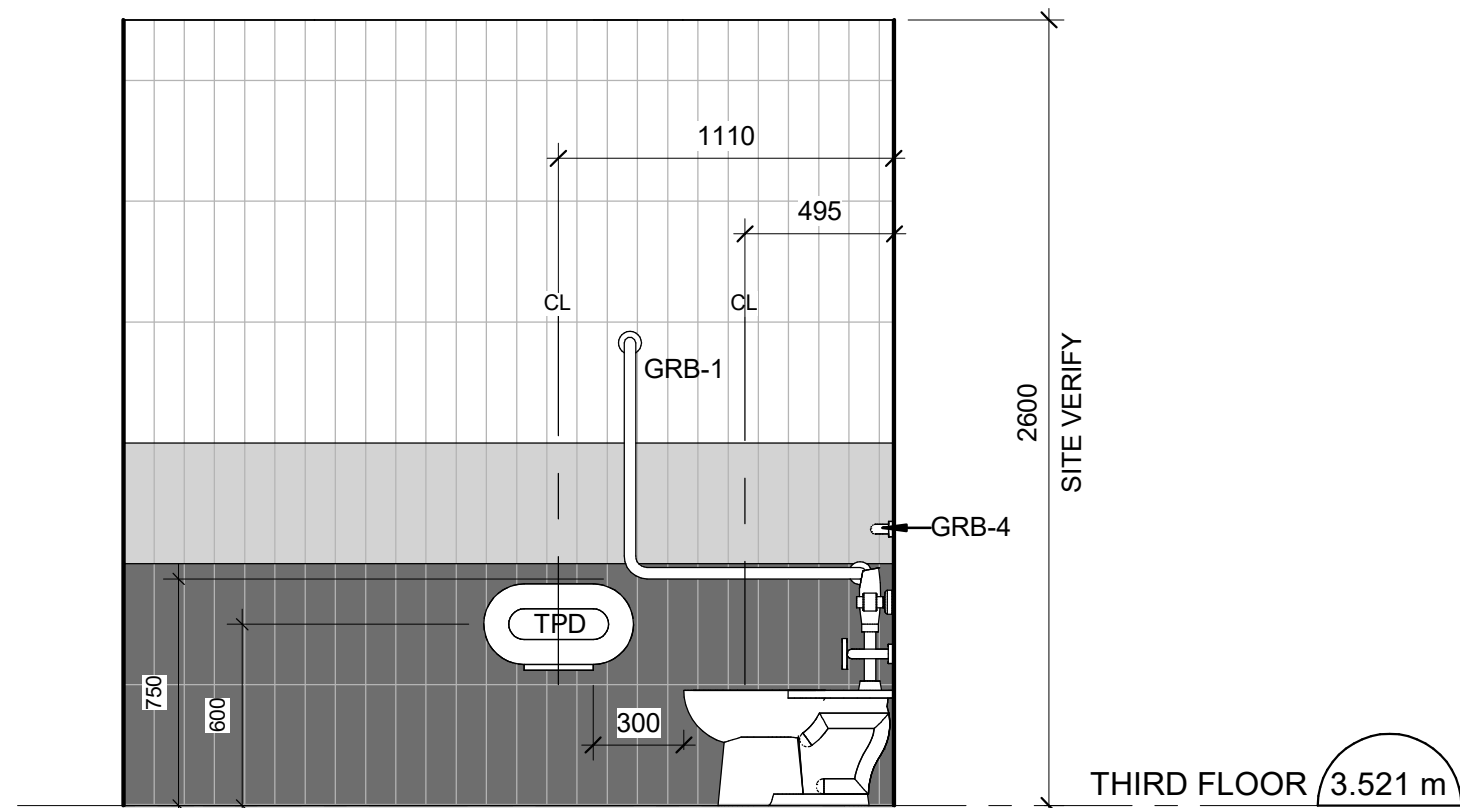

2 BARRIER FREE WASHROOM 4 - NORTH ELEVATION
A5311 Scale: 1 : 25

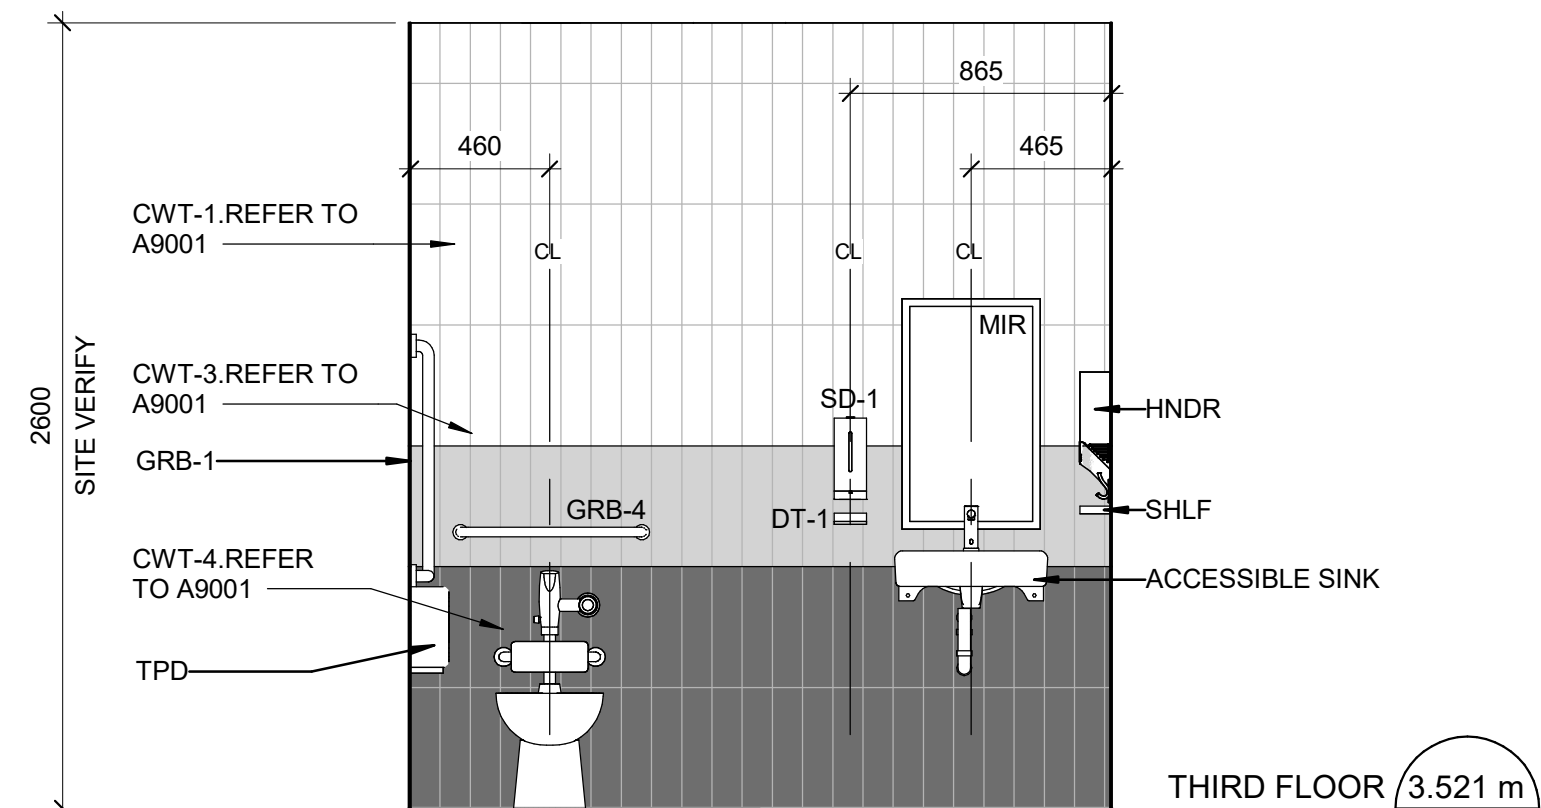

3 BARRIER FREE WASHROOM 4 - EAST ELEVATION
A5311 Scale: 1 : 25

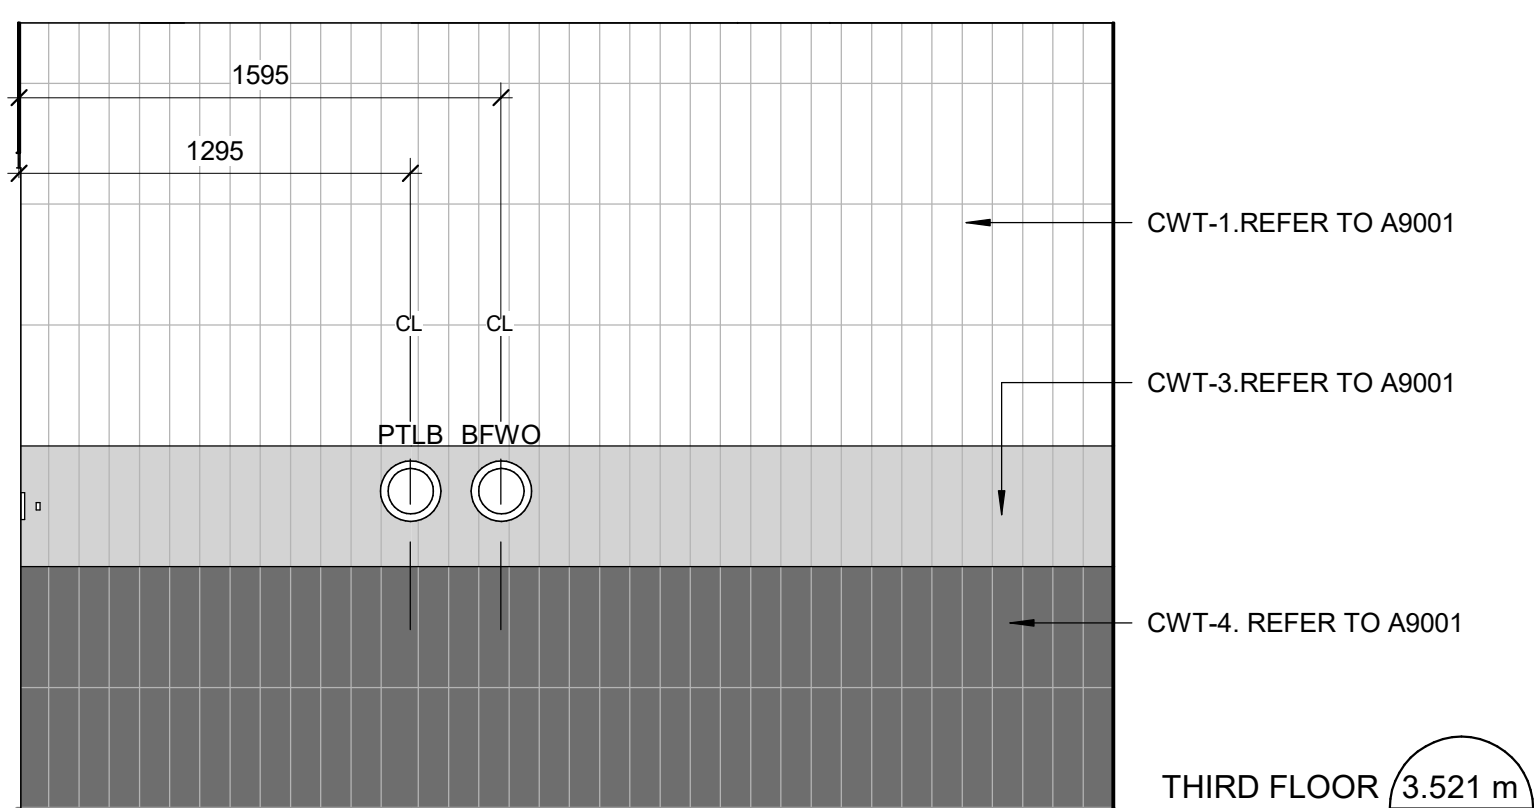

5 BARRIER FREE WASHROOM 4 - WEST ELEVATION
A5311 Scale: 1 : 25

CONSTRUCTION KEY LEGEND

- EXISTING PARTITION TO REMAIN
- NEW PARTITION
REFER TO PARTITION SCHEDULE
- NEW DOOR AND/ OR
NEW HARDWARE

CONSTRUCTION GENERAL NOTES

- NEW DOOR CARD READER AND BARRIER FREE PUSH BUTTON - REFER TO ELECTRICAL DRAWINGS FOR LOCATION AND HEIGHT INSTALLATION REFER TO ARCHITECTURAL DETAIL BOOKLET.
- REPAINT ENTIRE WALL AFTER WALL-MOUNTED HANDRAIL REPLACEMENT - UNLESS OTHERWISE NOTED, COLOUR AND FINISH TO MATCH EXISTING

CONSTRUCTION KEY NOTES

- | NO | DESCRIPTION |
|----|---|
| D | INSTALL NEW WASHROOM ACCESSORIES - REFER TO DETAILS 1/D1201, 2/D1201, 3/D1201, 4/D1201, 5/D1201. |
| K | INSTALL NEW DOOR AND FRAME. REFER TO DOOR SCHEDULE A9001, G0004 AND DOOR HARDWARE SCHEDULE IN THE SPECIFICATIONS. |

CEILING LEGEND

- GYPSUM BOARD CEILING AND BULKHEAD
- SUPPLY / RETURN DUCT
- CEILING, PENDANT OR
WALL MOUNTED LUMINAIRE

WASHROOM GENERAL NOTES

- ALL EXISTING SOAP DISPENSERS AND MIRRORS TO BE LOWERED. REFER TO 2/D1201, 4/D1201
- ALL WASHROOM ACCESSORIES TO BE INSTALLED AFTER SPECIFIED WALL FINISH HAS BEEN APPLIED. NEW SOAP COLLECTORS TO BE ADDED TO ALL SOAP DISPENSERS. REFER TO 2/D1201.
- MOISTURE RESISTANT GYPSUM BOARD TO BE PROVIDED IN ALL WASHROOMS AND LOCKER ROOMS

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Project Management Office
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PROJECT TITLE
**CITY OF TORONTO
ACCESSIBILITY UPGRADES**

PROJECT ADDRESS

**POLICE NO. 33 DIVISION
50 UPJOHN RD**

PROJECT NO:
9119-19-0162 / Arcadis 30279056

DRAWN BY:
A.Sunil

CHECKED BY:
K.Tilahun

PROJECT MGR:
F. BOLOURIAN

APPROVED BY:
E.Fenuta

SHEET TITLE


**BARRIER FREE
WASHROOM 4 - THIRD
FLOOR**


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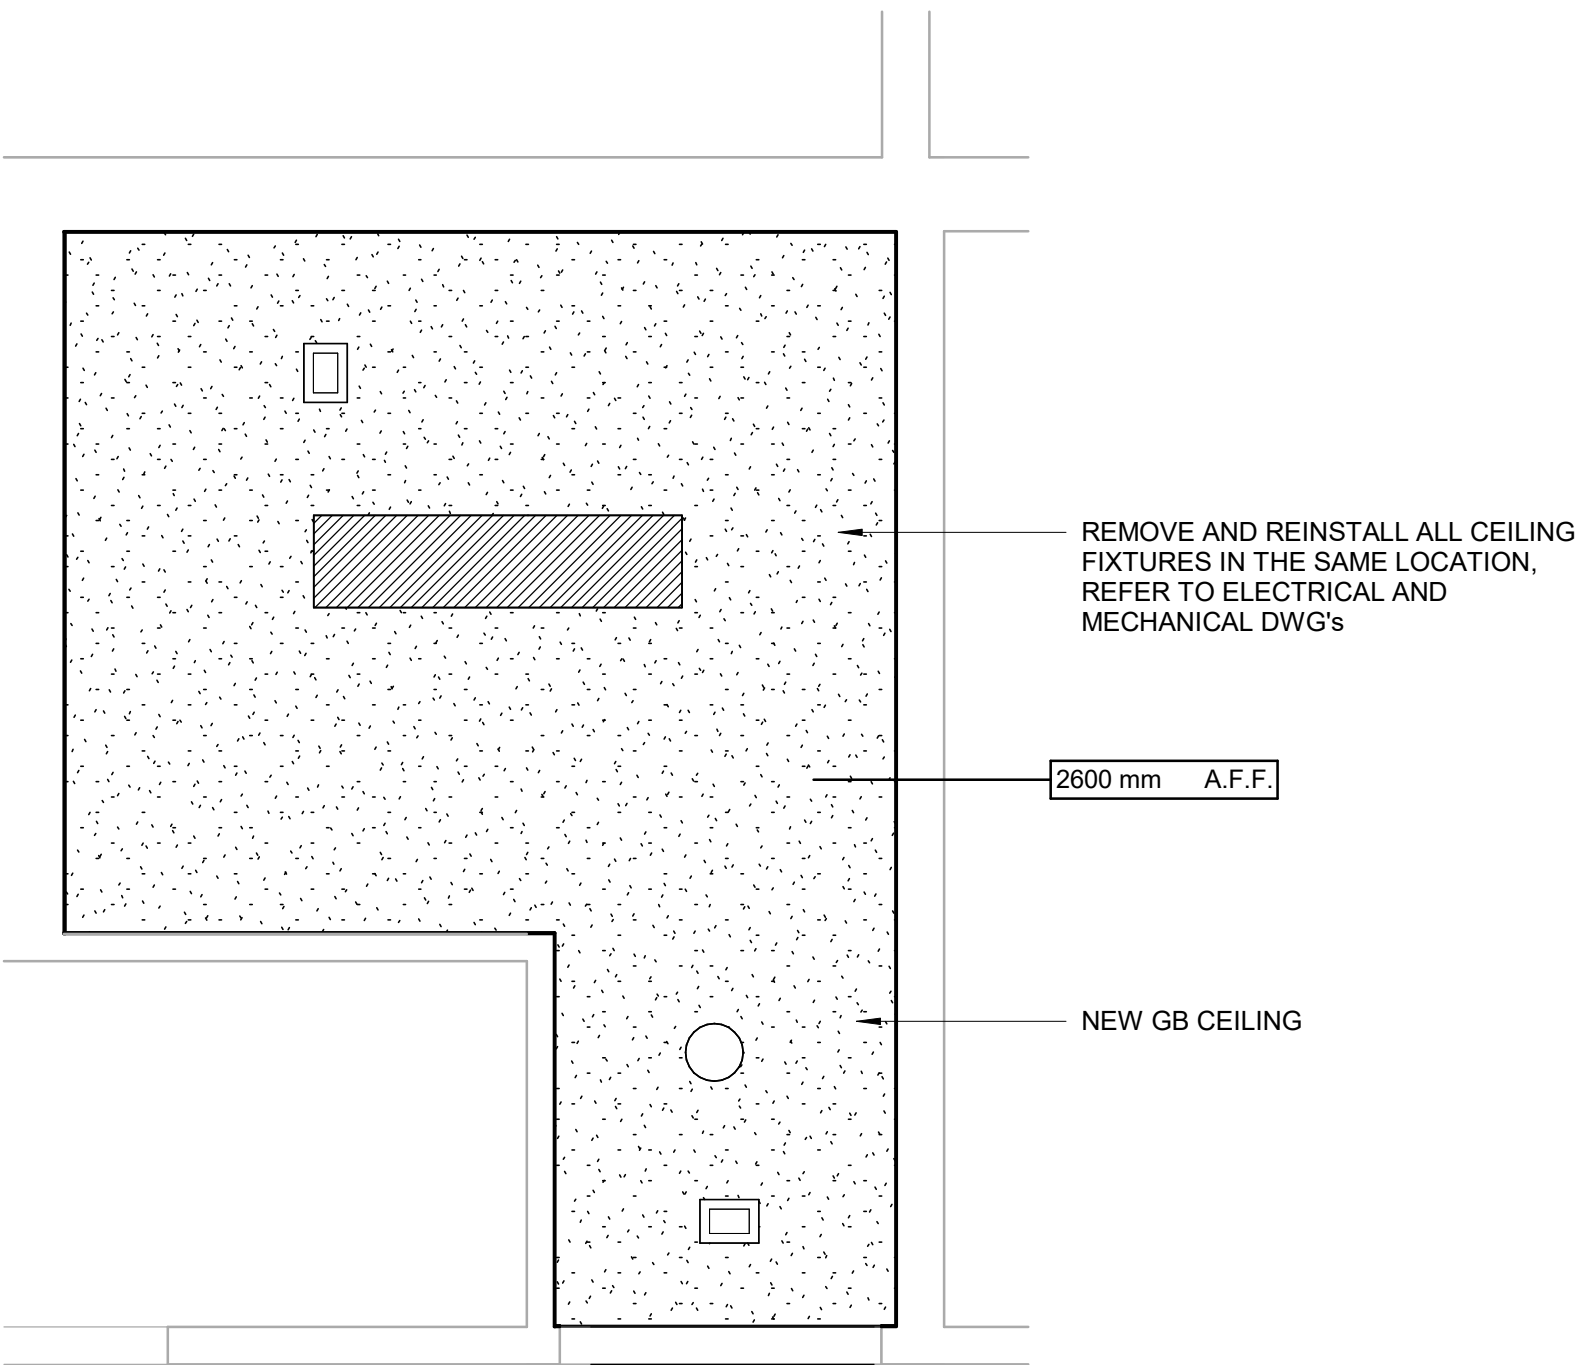
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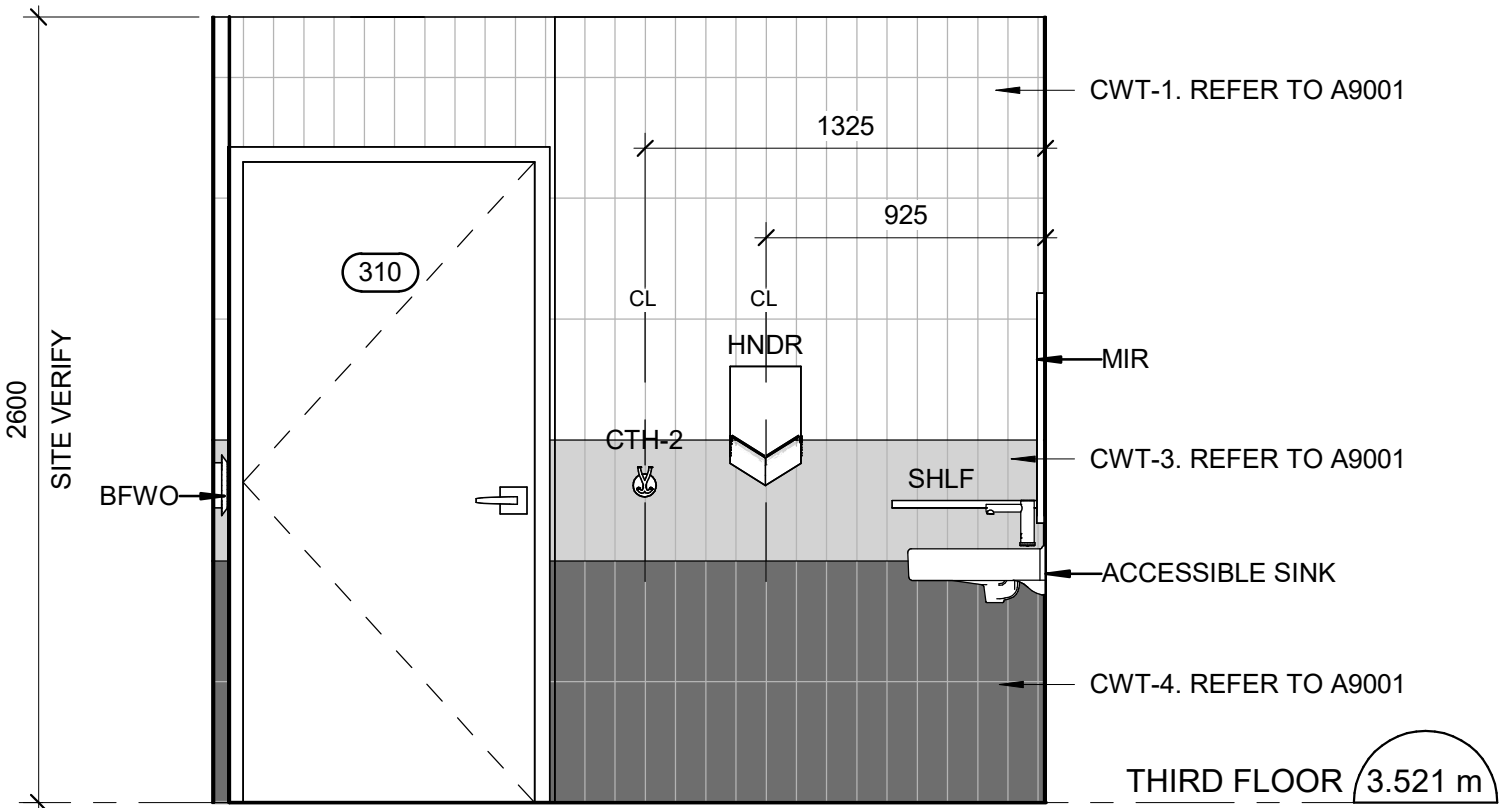





1 THIRD FLOOR PLAN - UNIVERSAL WASHROOM
A5411 Scale: 1 : 25

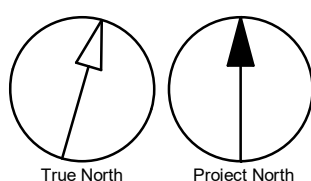


8 UNIVERSAL WASHROOM - THIRD FLOOR RCP
A5411 Scale: 1 : 25

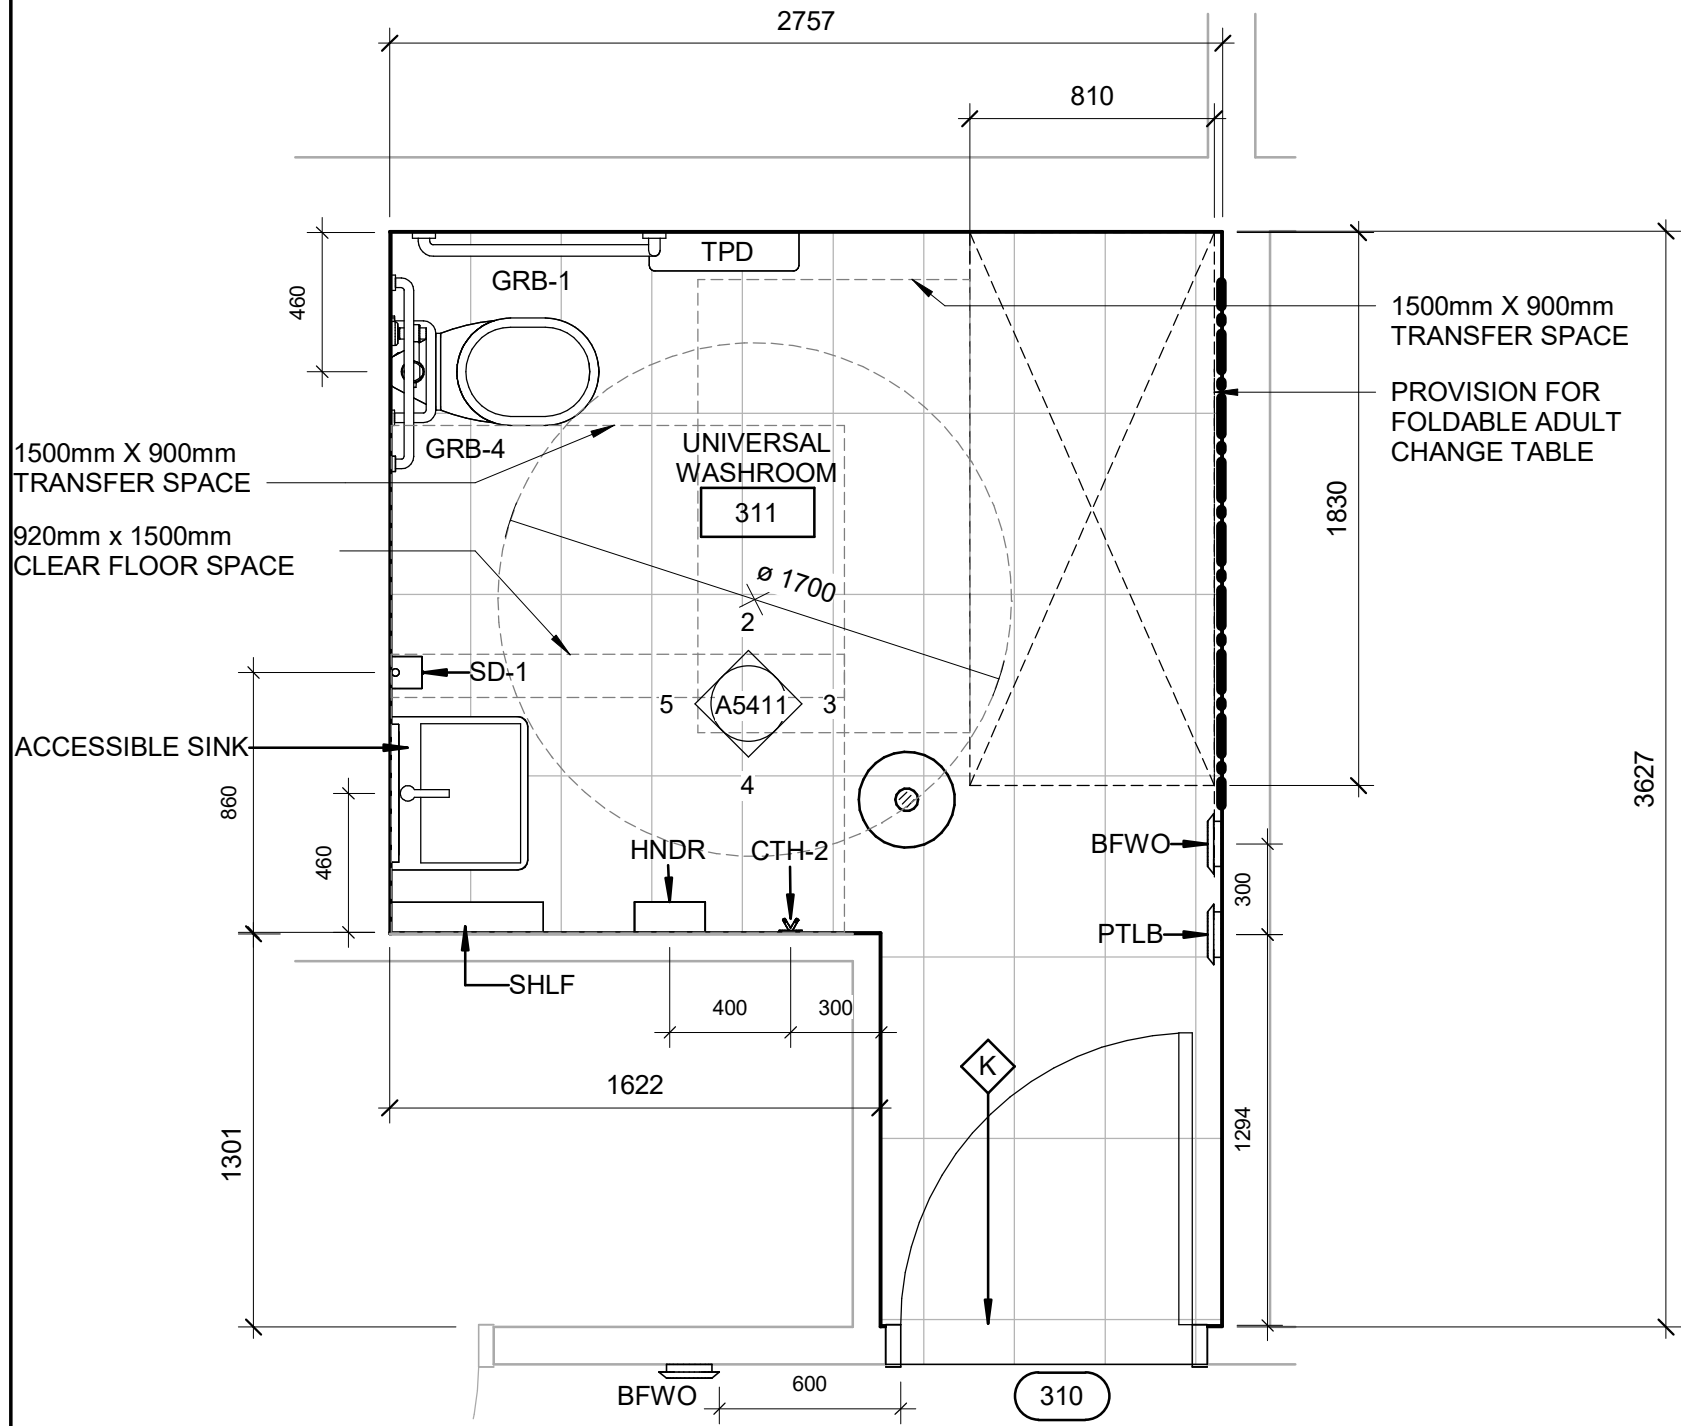


4 UNIVERSAL WASHROOM - SOUTH ELEVATION
A5411 Scale: 1 : 25

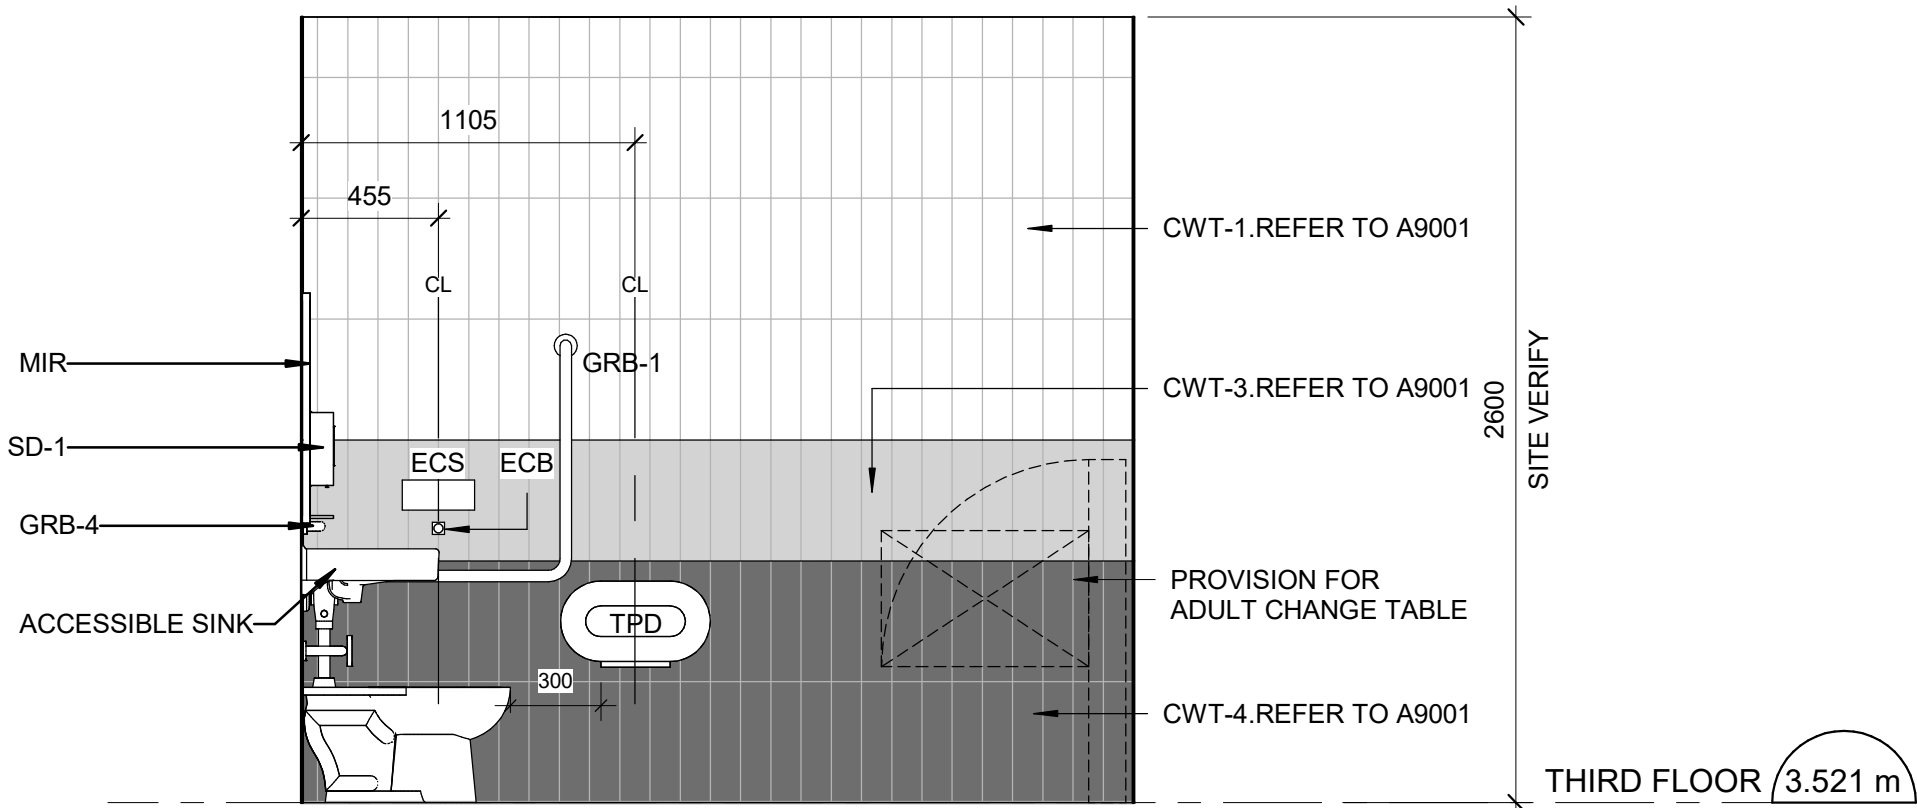

2 UNIVERSAL WASHROOM - NORTH ELEVATION
A5411 Scale: 1 : 25

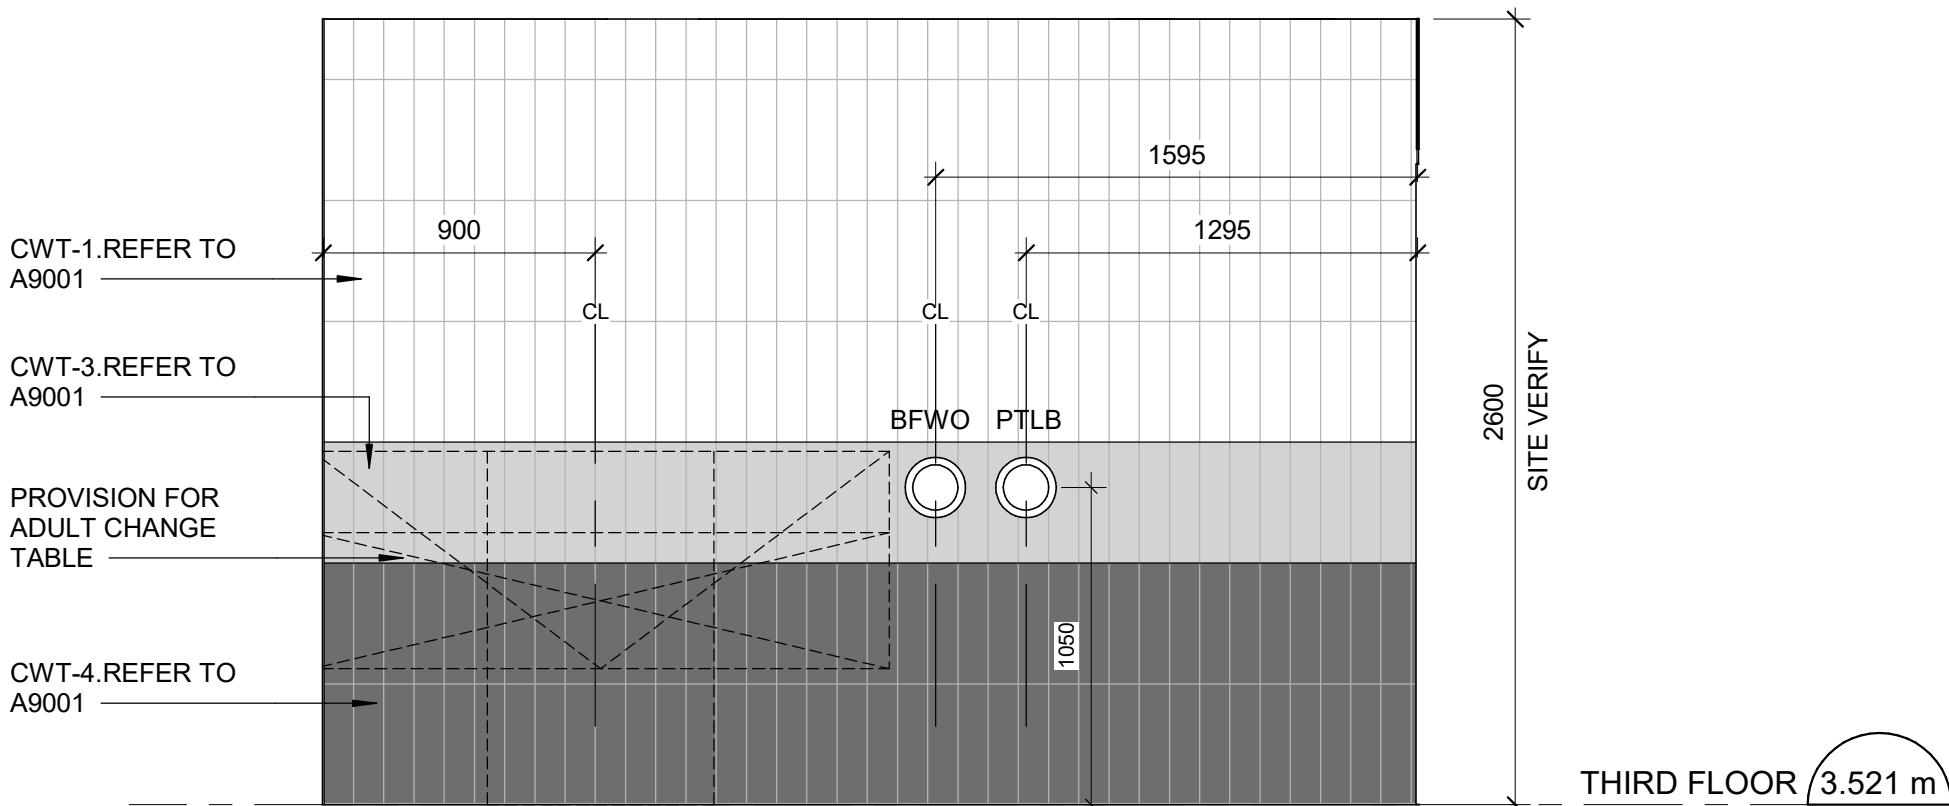

3 UNIVERSAL WASHROOM - EAST ELEVATION
A5411 Scale: 1 : 25

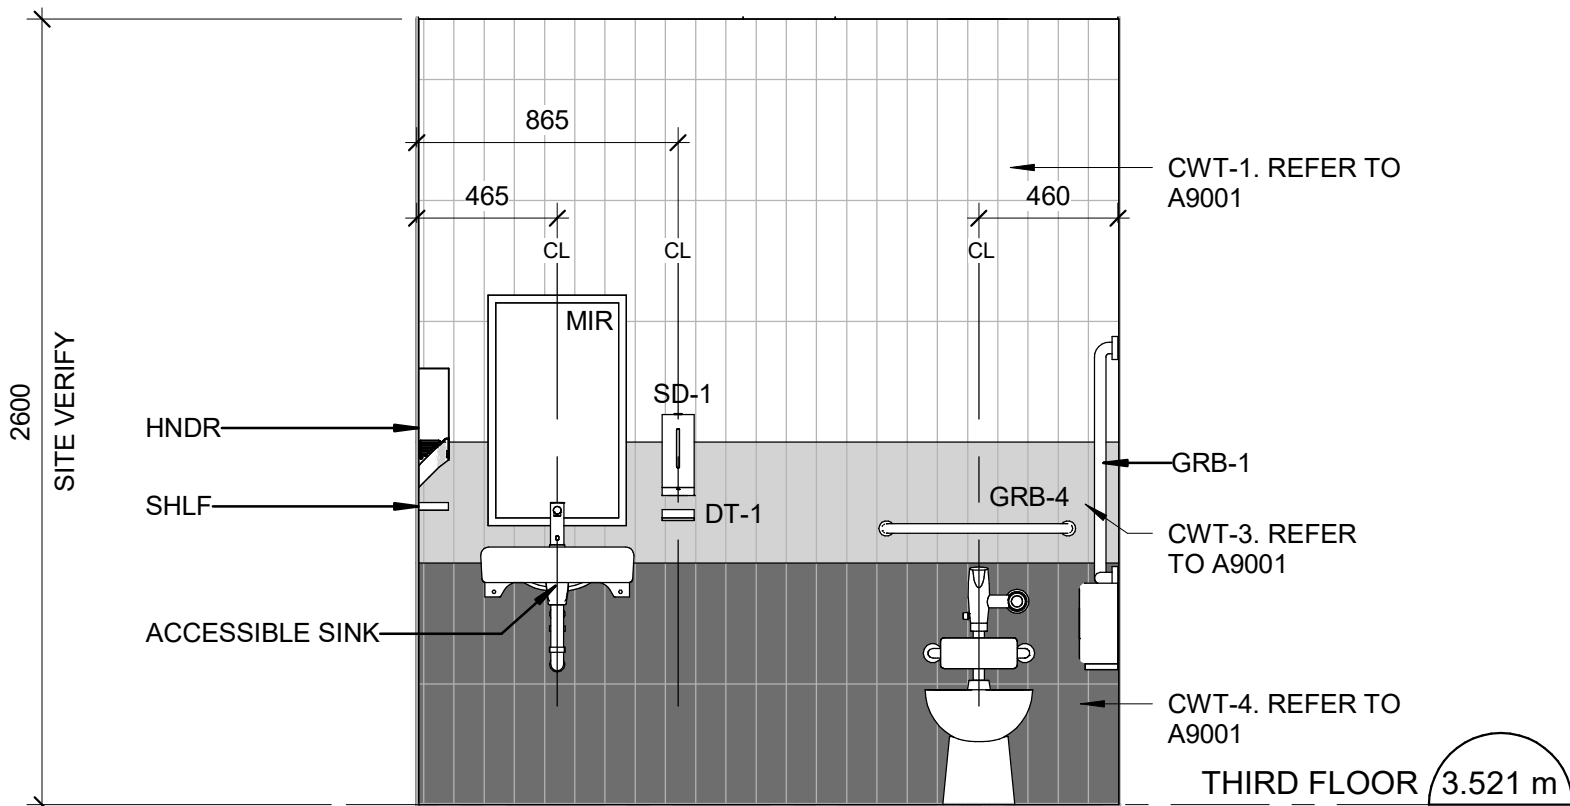

5 UNIVERSAL WASHROOM - WEST ELEVATION
A5411 Scale: 1 : 25

CONSTRUCTION KEY LEGEND

- EXISTING PARTITION TO REMAIN
- NEW PARTITION
REFER TO PARTITION SCHEDULE
- NEW DOOR AND/ OR
NEW HARDWARE

CONSTRUCTION GENERAL NOTES

- NEW DOOR CARD READER AND BARRIER FREE PUSH BUTTON - REFER TO ELECTRICAL DRAWINGS. FOR LOCATION AND HEIGHT INSTALLATION REFER TO ARCHITECTURAL DETAIL BOOKLET.
- REPAINT ENTIRE WALL AFTER WALL-MOUNTED HANDRAIL REPLACEMENT - UNLESS OTHERWISE NOTED. COLOUR AND FINISH TO MATCH EXISTING

CONSTRUCTION KEY NOTES

- | NO | DESCRIPTION |
|----|---|
| K | INSTALL NEW DOOR AND FRAME. REFER TO DOOR SCHEDULE A9001, G0004 AND DOOR HARDWARE SCHEDULE IN THE SPECIFICATIONS. |

CEILING LEGEND

- GYPSUM BOARD CEILING
AND BULKHEAD
- SUPPLY / RETURN DUCT
- CEILING, PENDANT OR
WALL MOUNTED LUMINAIRE

WASHROOM GENERAL NOTES

- ALL EXISTING SOAP DISPENSERS AND MIRRORS TO BE LOWERED. REFER TO 2/D1201, 4/D1201.
- ALL WASHROOM ACCESSORIES TO BE INSTALLED AFTER SPECIFIED WALL FINISH HAS BEEN APPLIED. NEW SOAP COLLECTORS TO BE ADDED TO ALL SOAP DISPENSERS. REFER TO 2/D1201.
- MOISTURE RESISTANT GYPSUM BOARD TO BE PROVIDED IN ALL WASHROOMS AND LOCKER ROOMS

UNIVERSAL WASHROOM GENERAL NOTES

- PROVIDE WALL REINFORCEMENT TO SUPPORT FUTURE ADULT CHANGE TABLE MINIMUM LOAD OF 1.33 KN AND POWER OUTLET

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ACCESSIBILITY UPGRADES

PROJECT ADDRESS

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50 UPJOHN RD

PROJECT NO:
9119-19-0162 / Arcadis 30279056

DRAWN BY:
A.Sunil

CHECKED BY:
K.Tilahun

PROJECT MGR:
F. BOLOURIAN

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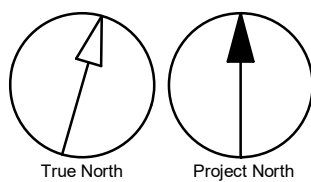
SHEET TITLE
UNIVERSAL WASHROOM
- THIRD FLOOR






SHEET NUMBER

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ISSUE

D



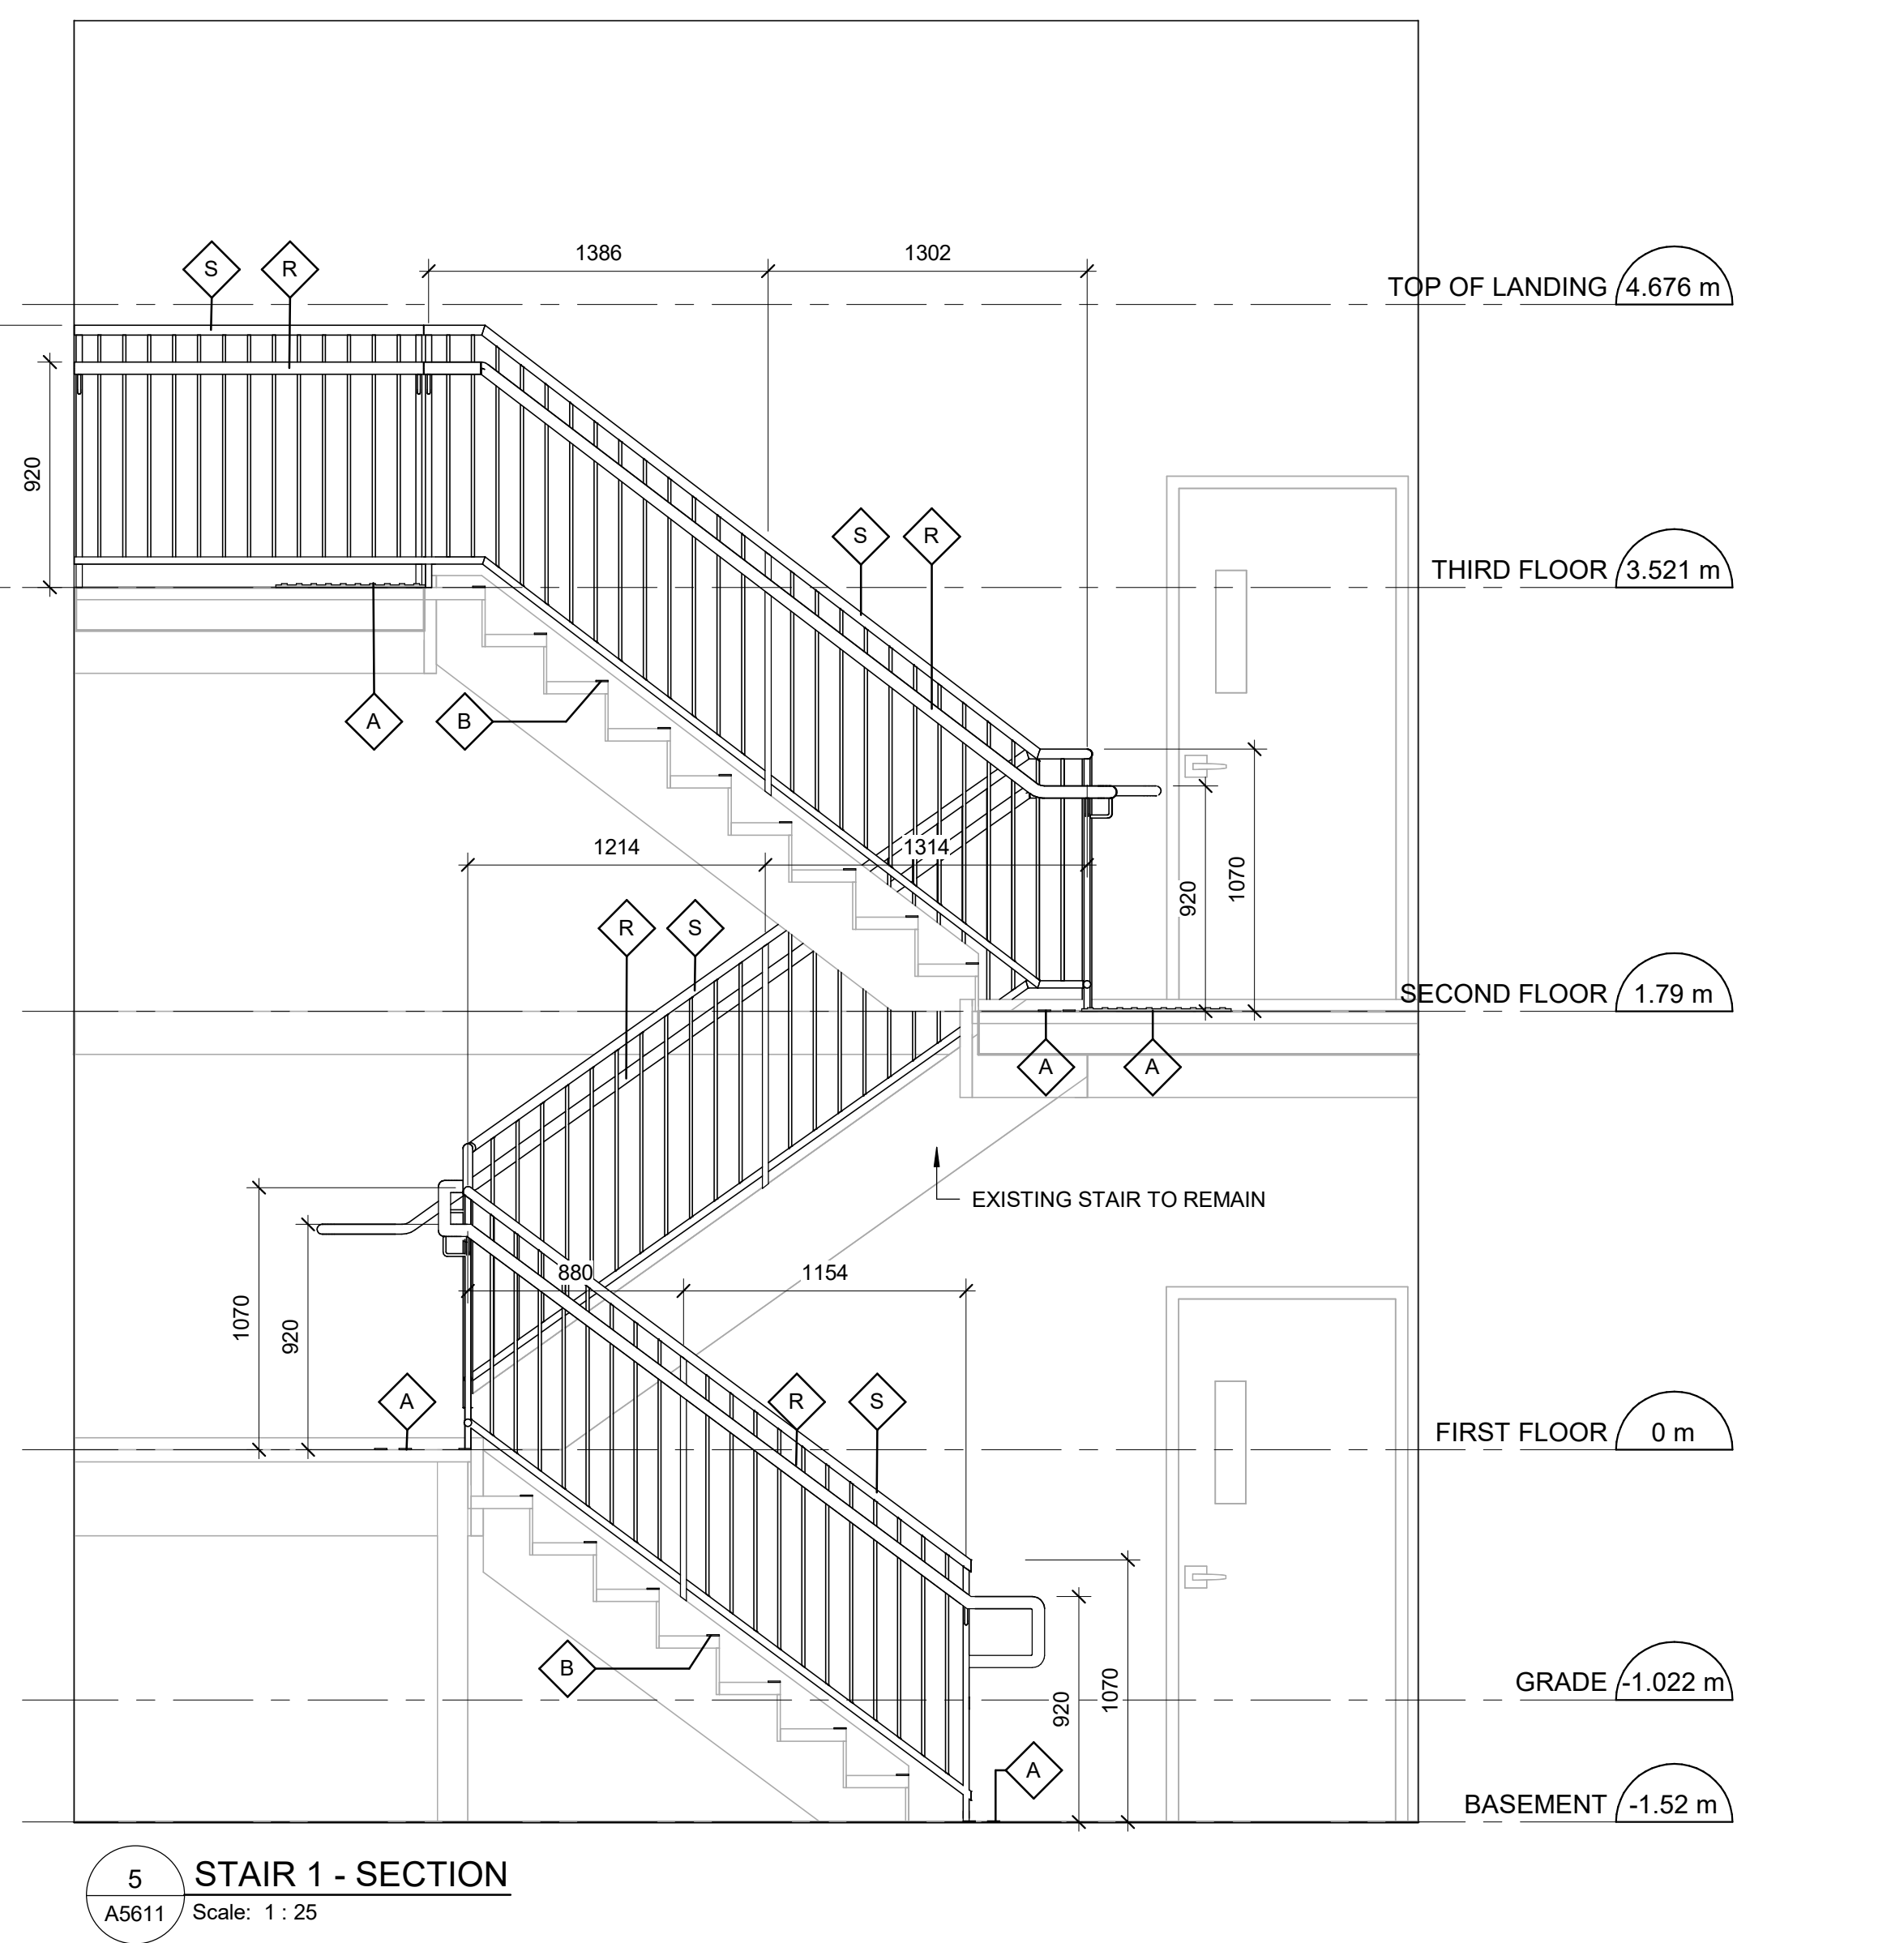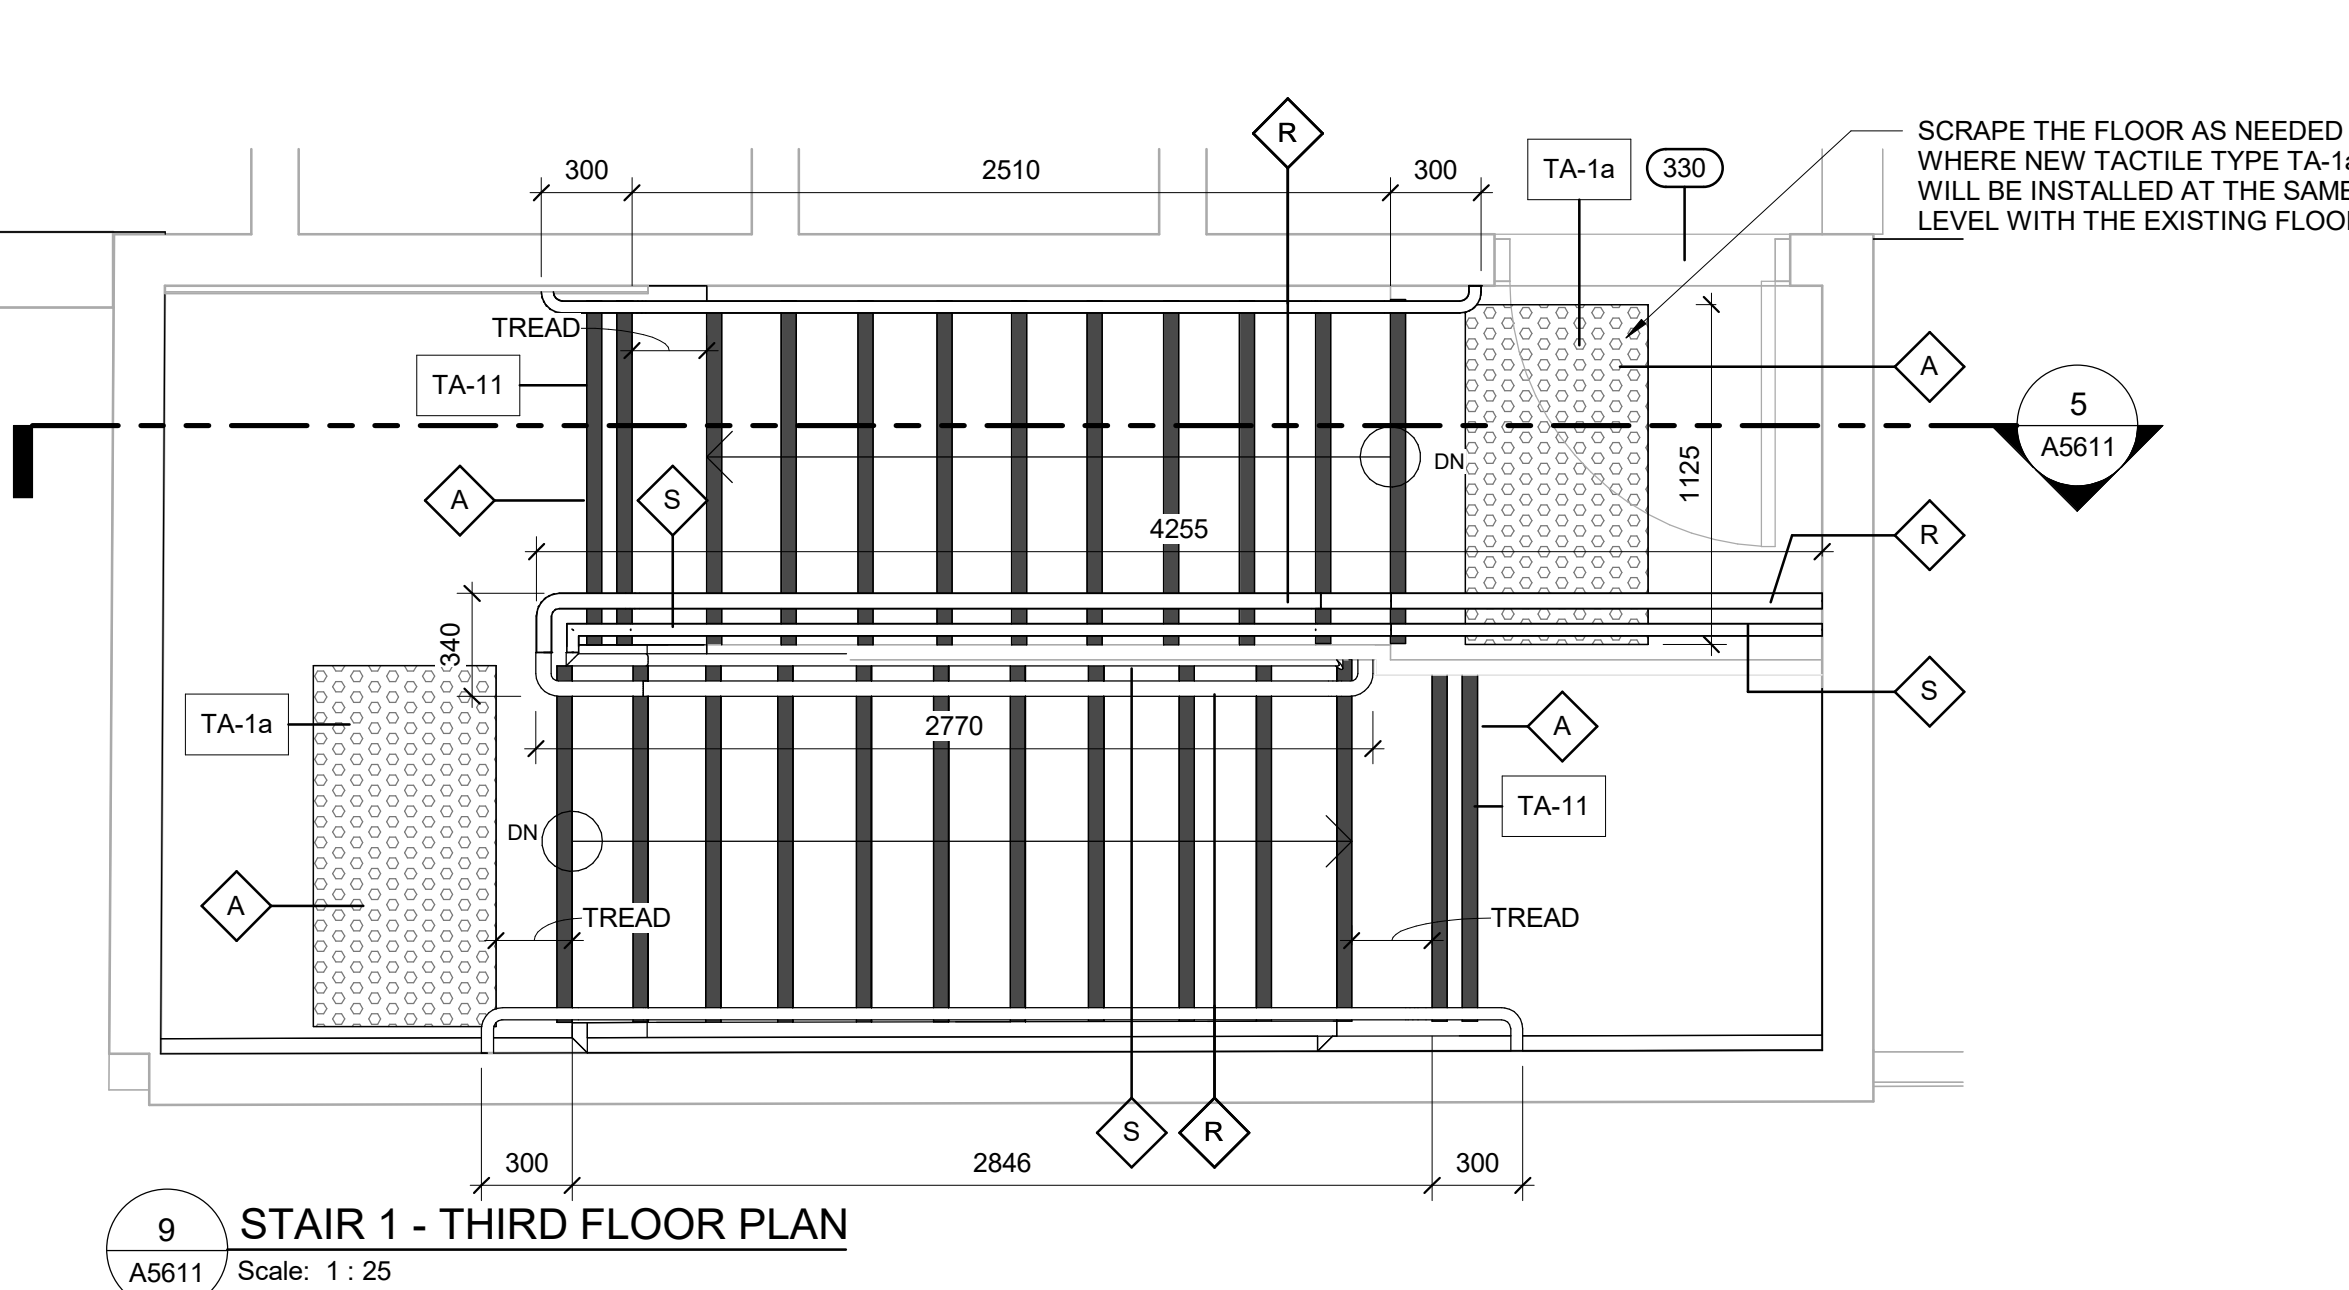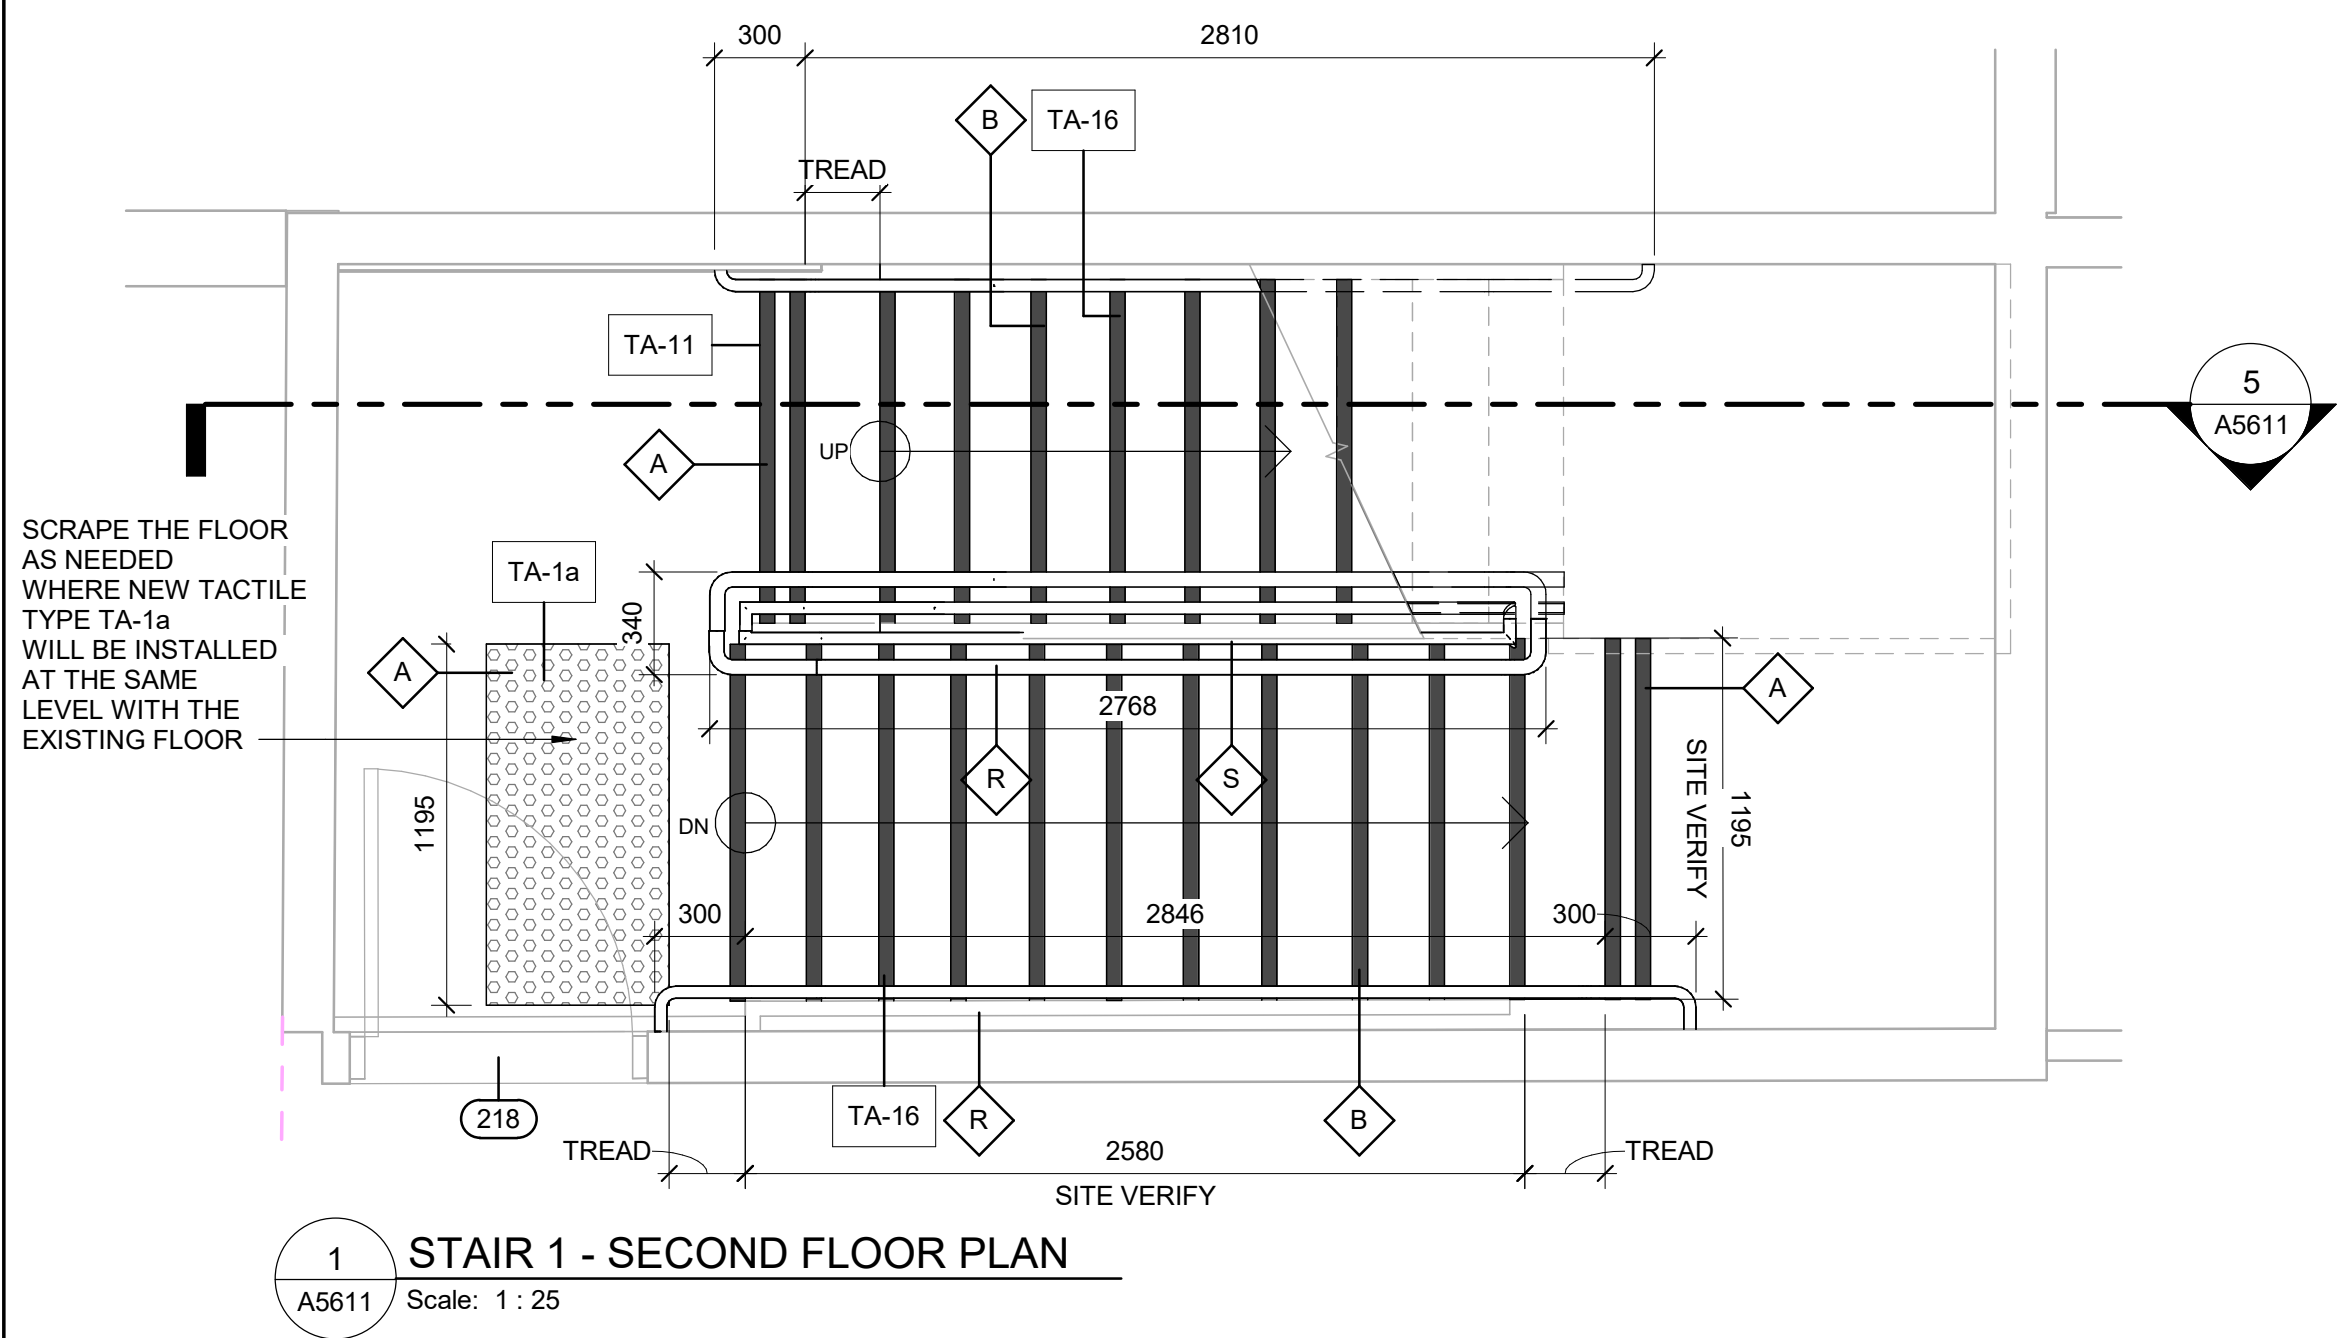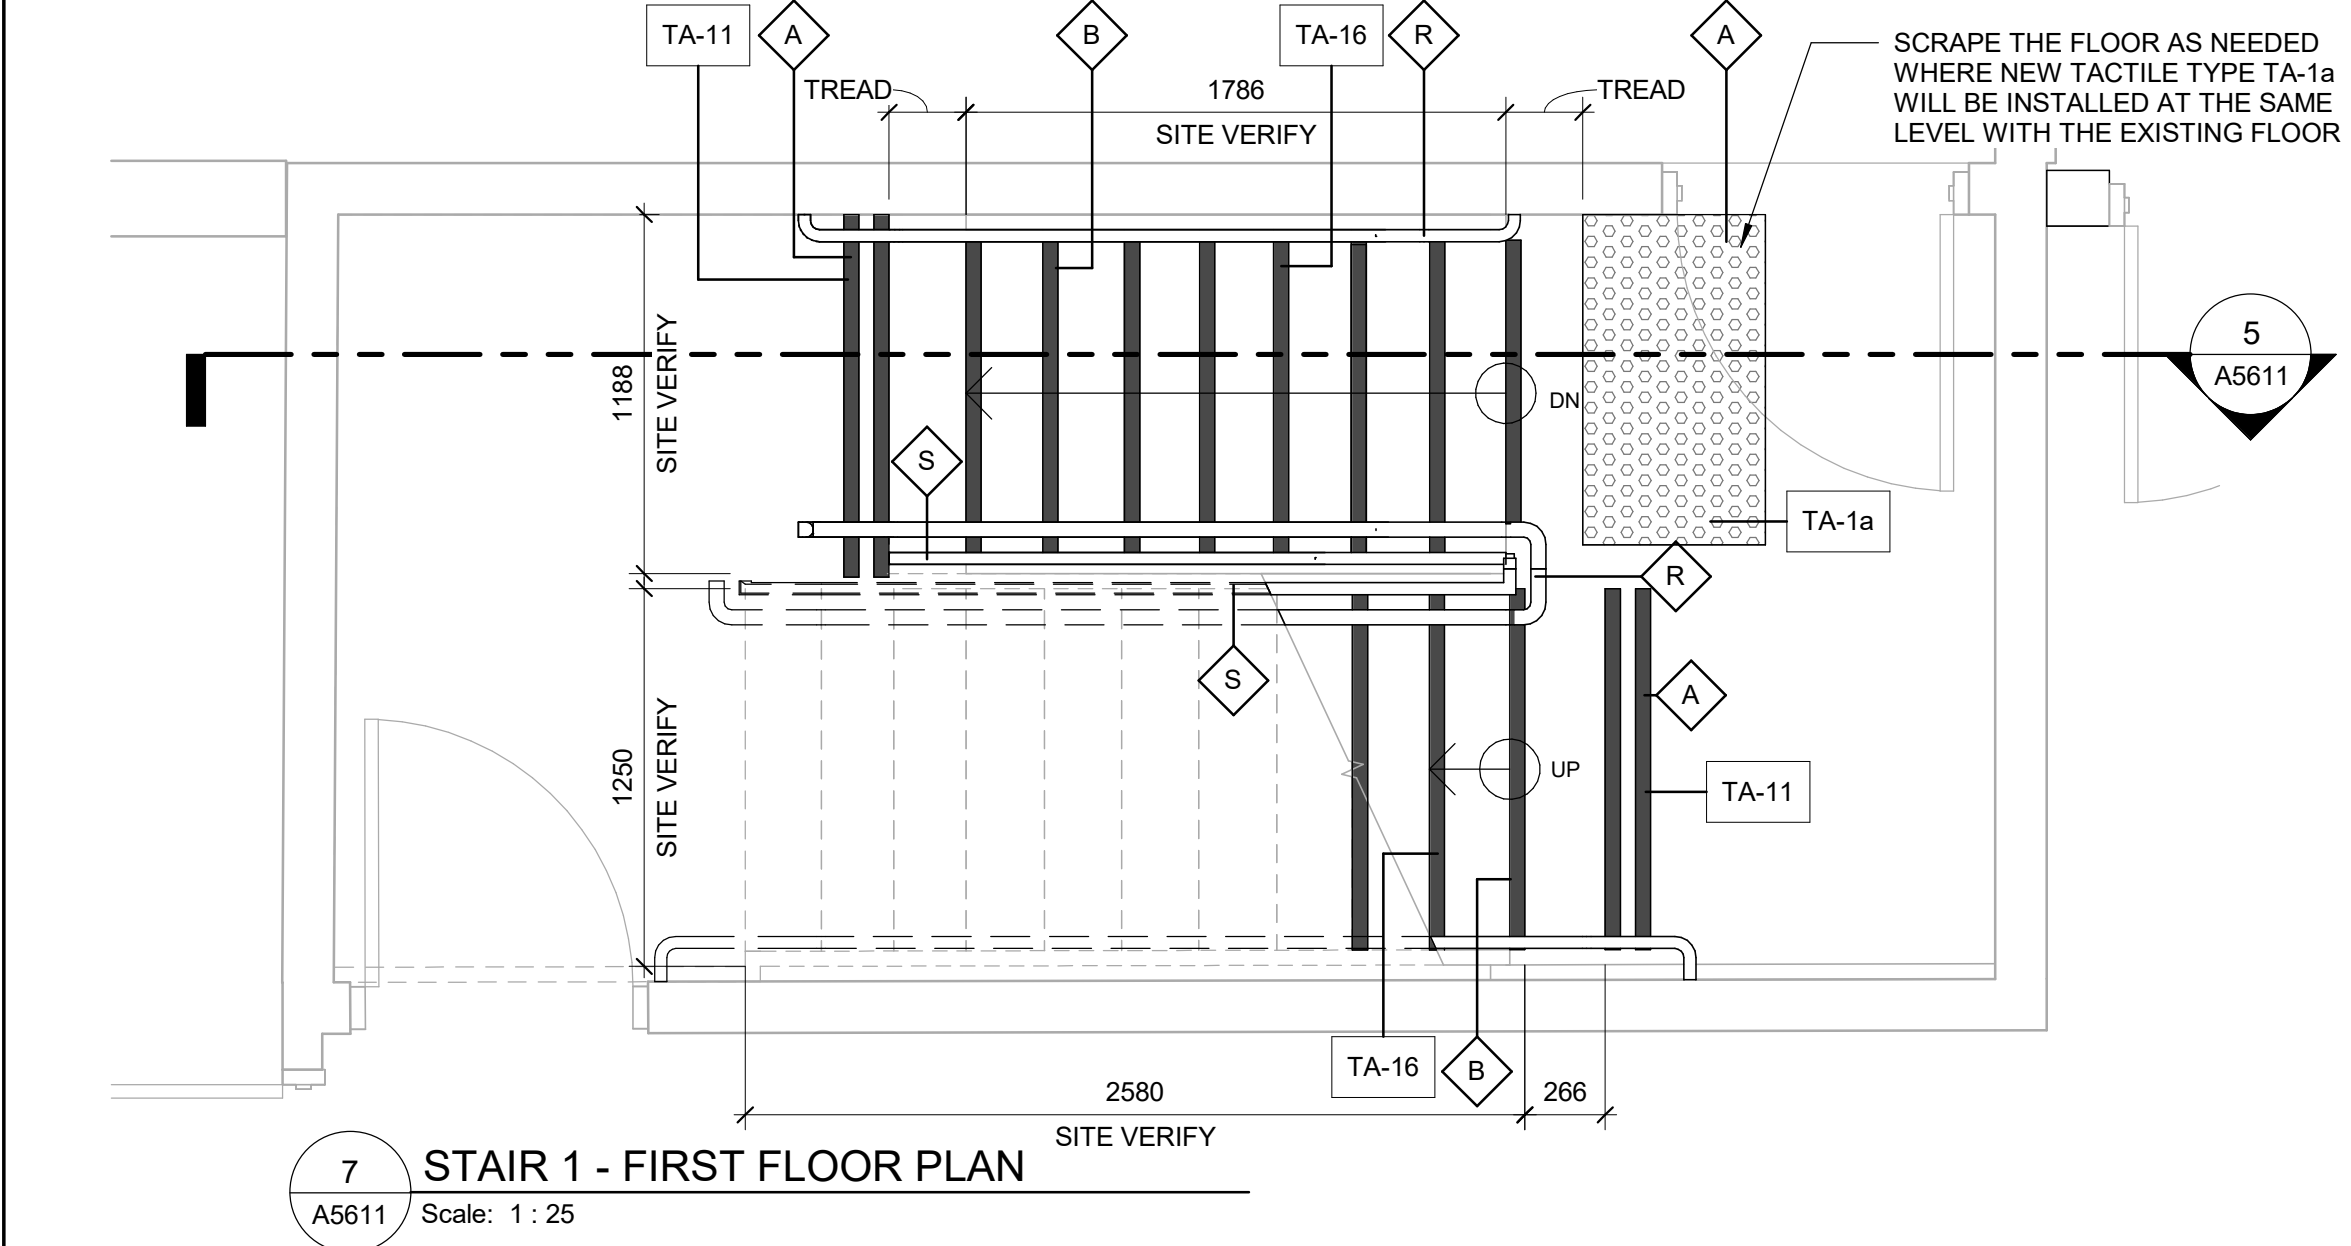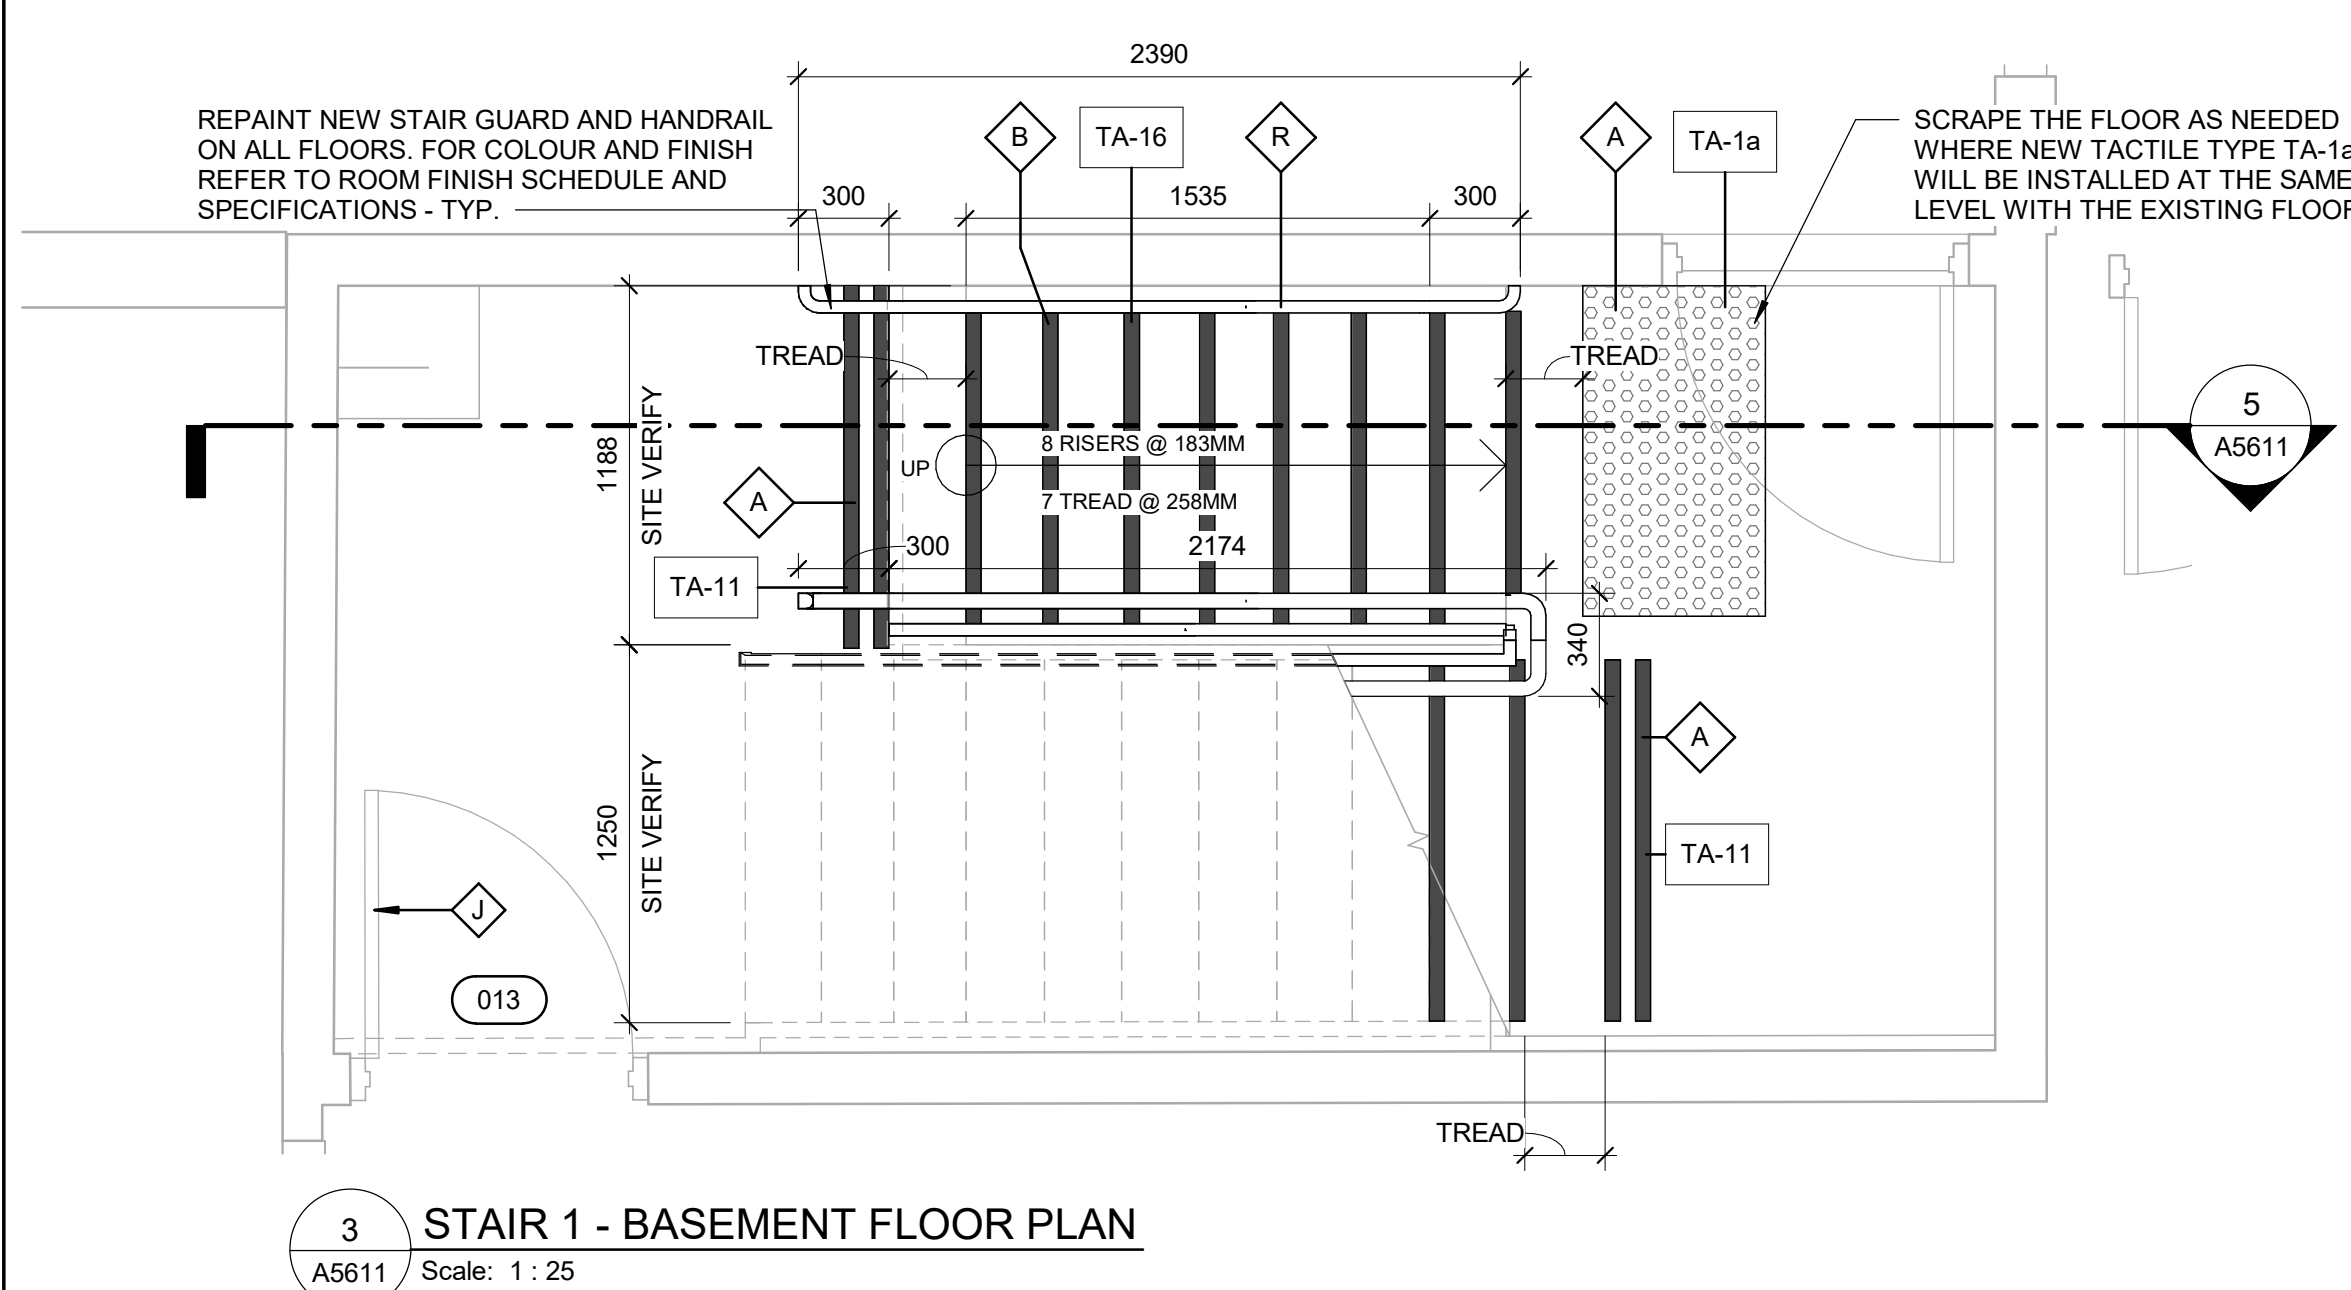

CONSTRUCTION KEY LEGEND

- EXISTING EXTERIOR WALL TO REMAIN
- EXISTING PARTITION TO REMAIN
- NEW EXTERIOR WALL REFER TO WALL SCHEDULE
- NEW PARTITION REFER TO PARTITION SCHEDULE
- EXISTING DOOR TO REMAIN
- NEW DOOR AND/ OR NEW HARDWARE
- DASHED AREA INDICATES AREA OF WORK

CONSTRUCTION KEY NOTES

NO	DESCRIPTION
A	INSTALL TACTILE ATTENTION INDICATOR AND TACTILE WARNING STRIP - REFER TO TYPICAL DETAILS 1/D1402 AND 1/D1405.
B	INSTALL COLOUR AND TEXTURE NOSING STRIP - REFER TO TYPICAL DETAIL 1/D1402.
J	EXISTING DOOR TO REMAIN. DOOR HARDWARE TO BE CHANGED AS PER DOOR SCHEDULE ON A9001 AND DOOR HARDWARE SCHEDULE IN THE SPECIFICATIONS.
R	INSTALL NEW HANDRAIL - REFER TO DETAILS 1/D1401, 3/D1401, 2/1403, 3/1403, 4/D1402.
S	INSTALL NEW GUARDRAIL - REFER TO DETAILS 5/D1401, 6/D1401, 1/D1403.

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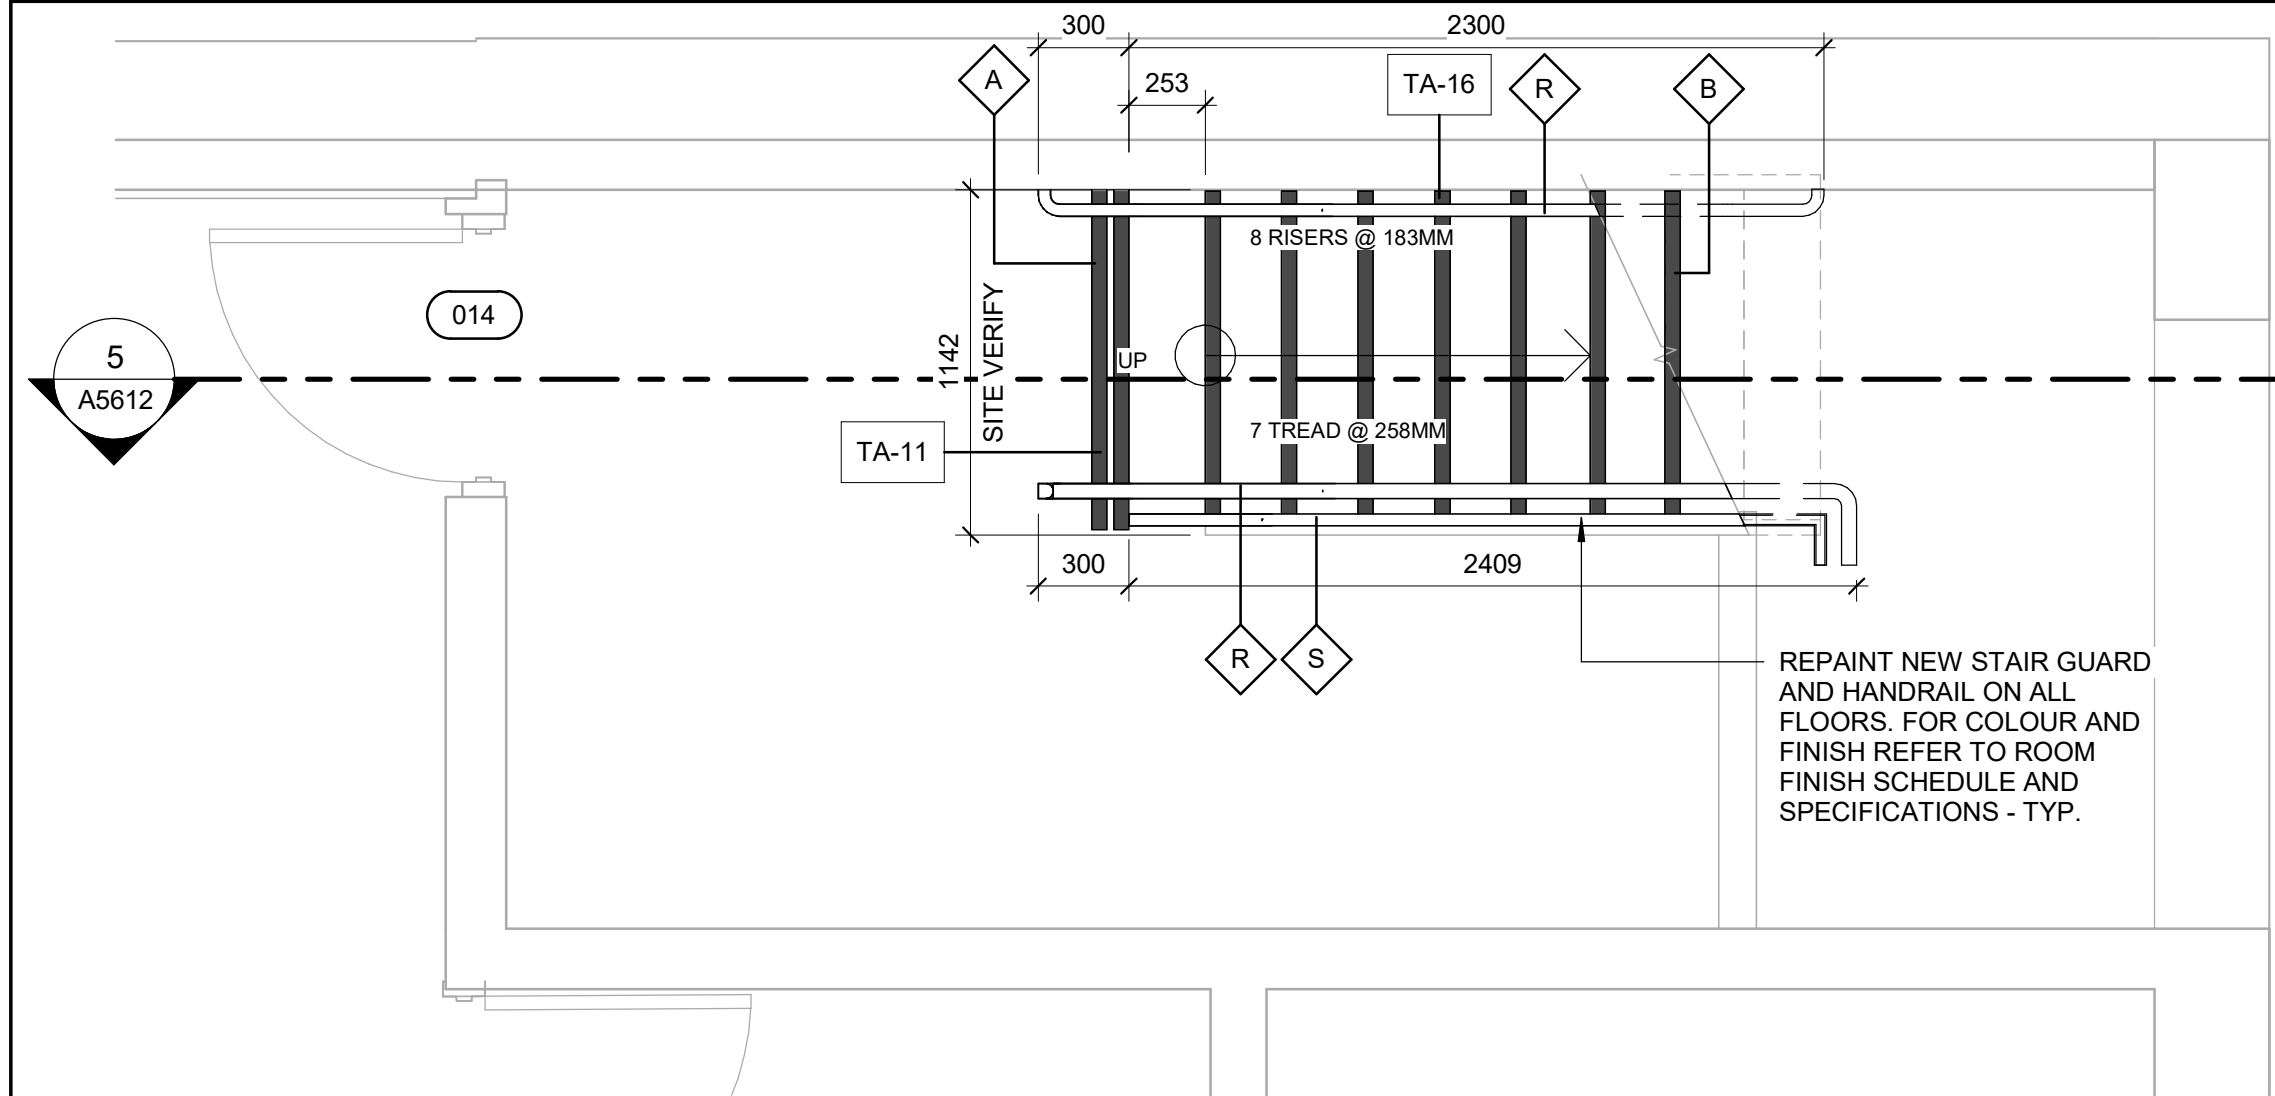
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**CITY OF TORONTO
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PROJECT ADDRESS
**POLICE NO. 33 DIVISION
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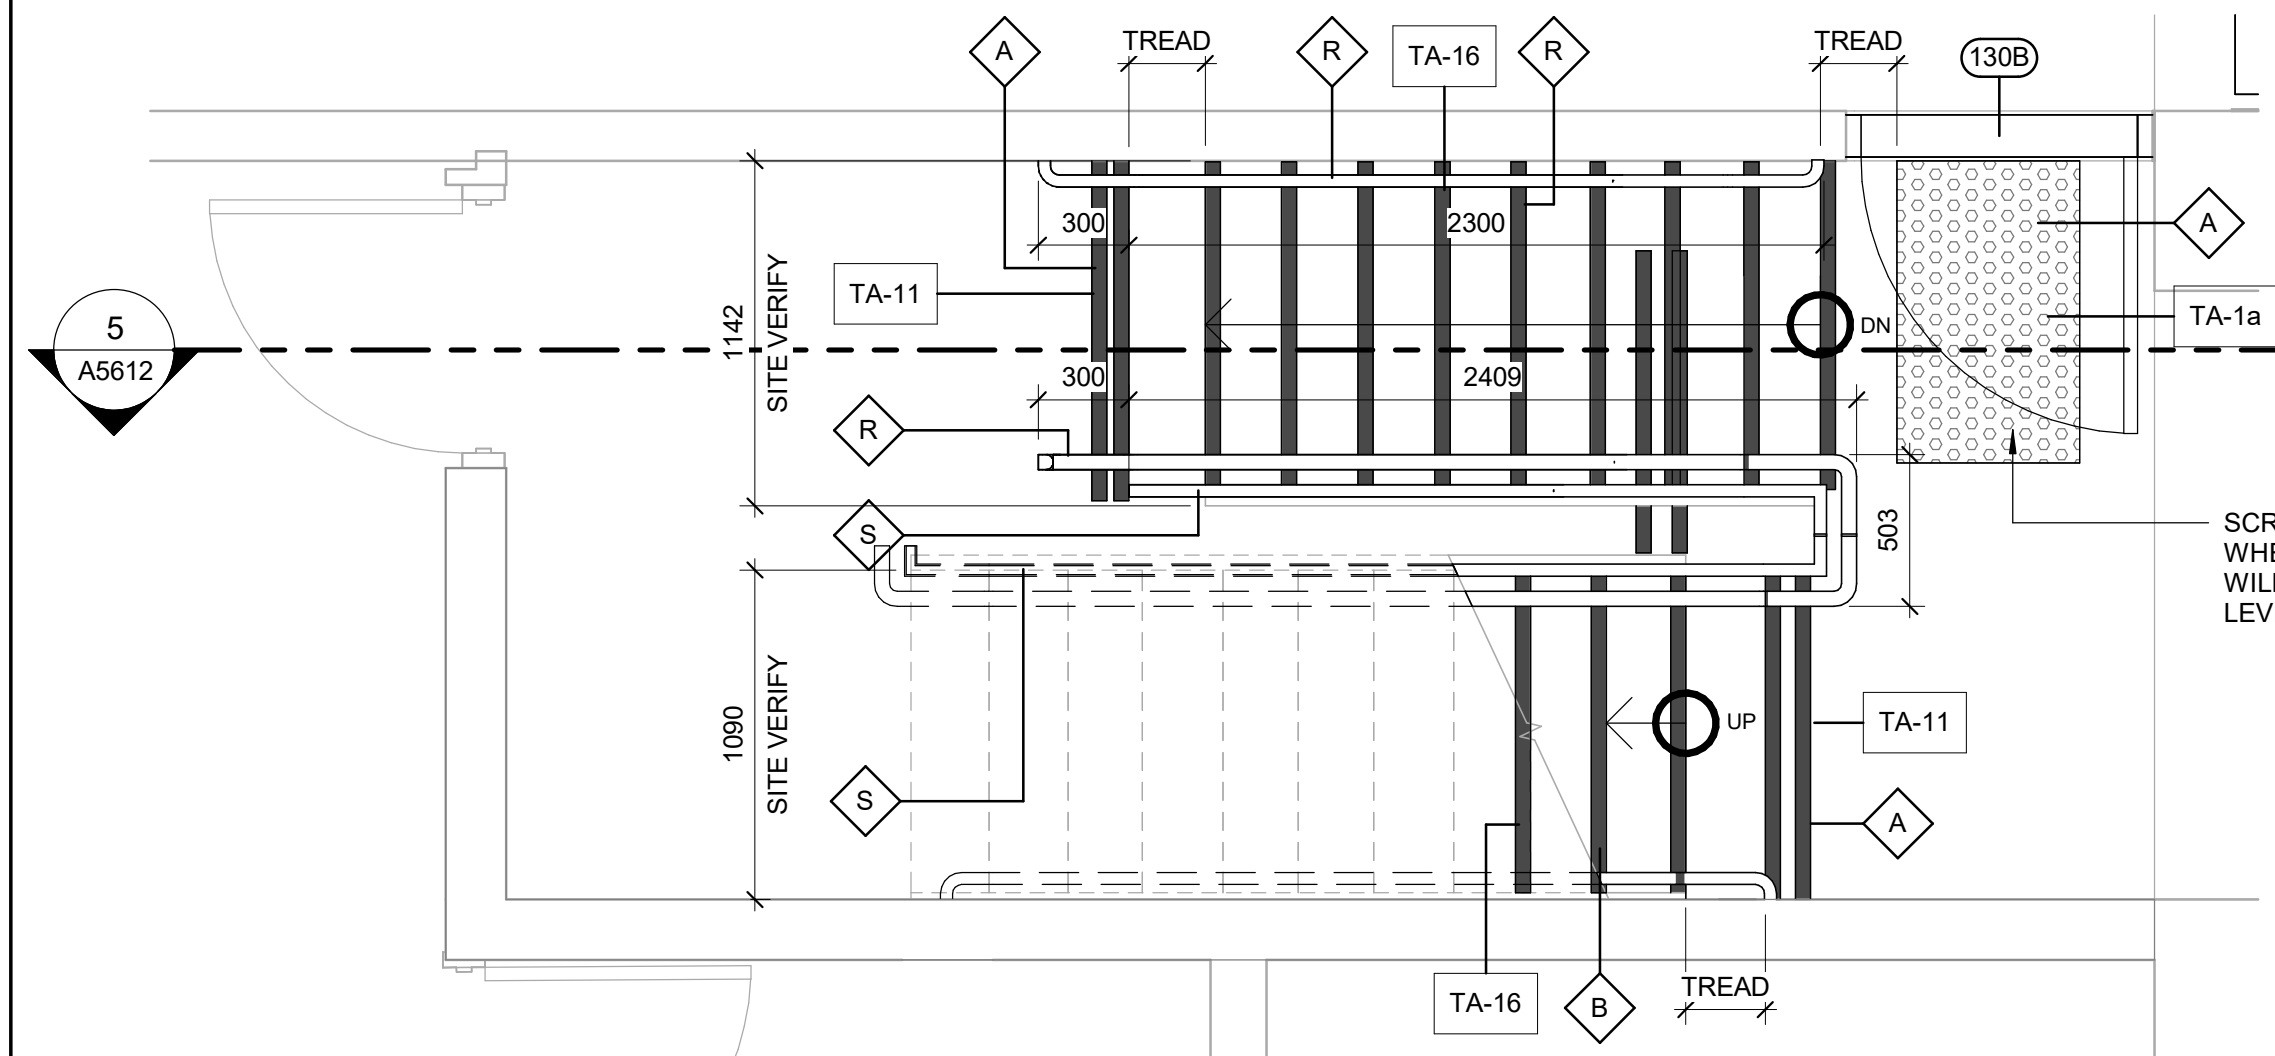
PROJECT NO:
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DRAWN BY:
A.Sunil
PROJECT MGR:
F. BOLOURIAN
CHECKED BY:
K.Tilahun
APPROVED BY:
E.Fenuta

SHEET TITLE
**STAIR PLANS AND
SECTION**


SHEET NUMBER
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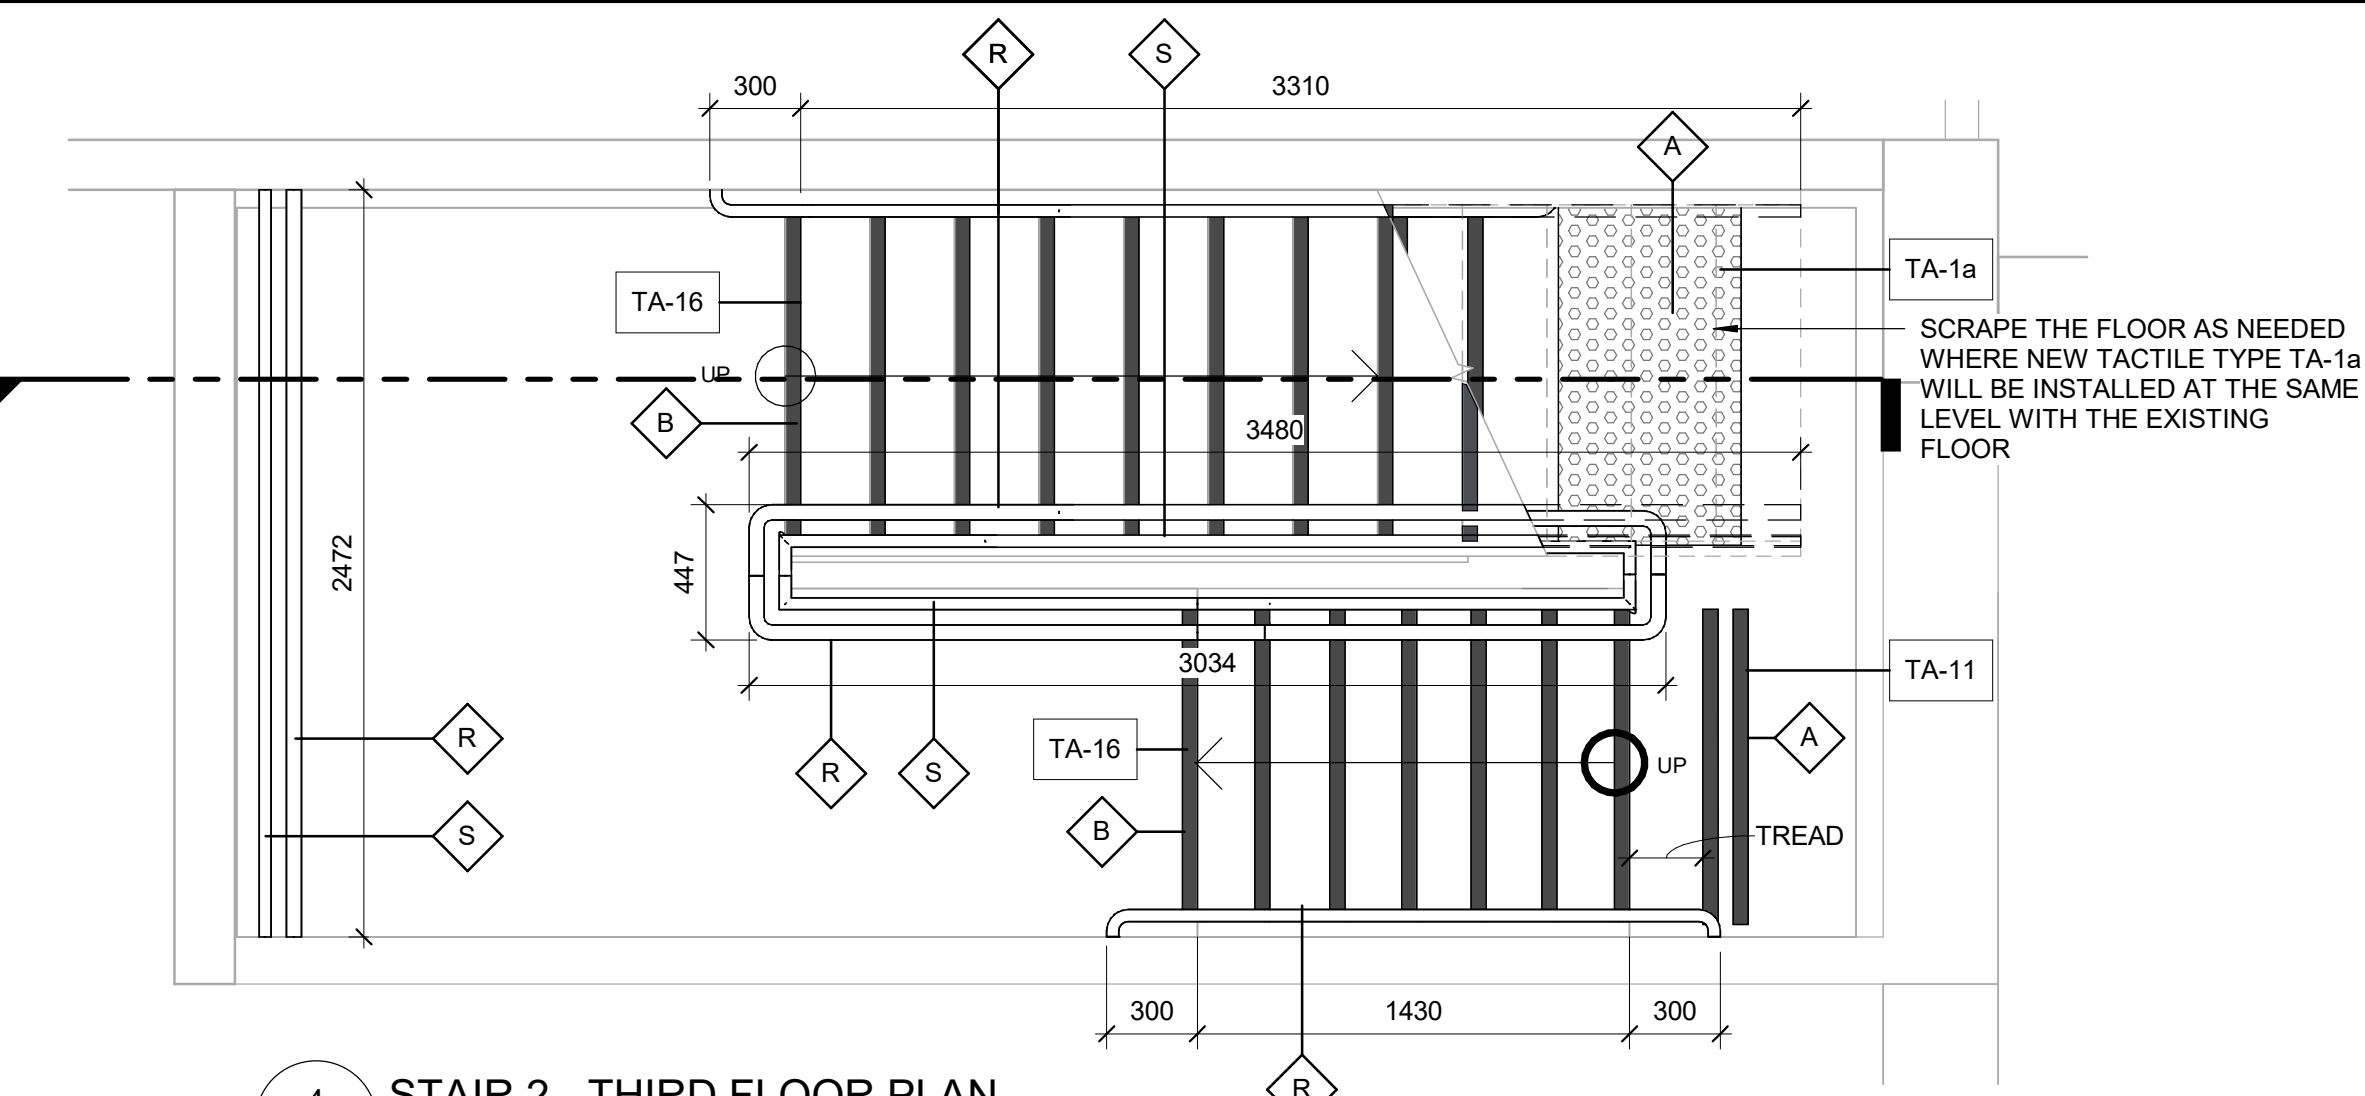
1 STAIR 2 - BASEMENT FLOOR PLAN
A5612 Scale: 1 : 25




2 STAIR 2 - FIRST FLOOR PLAN
A5612 Scale: 1 : 25



3 STAIR 2 - SECOND FLOOR PLAN
A5612 Scale: 1 : 25

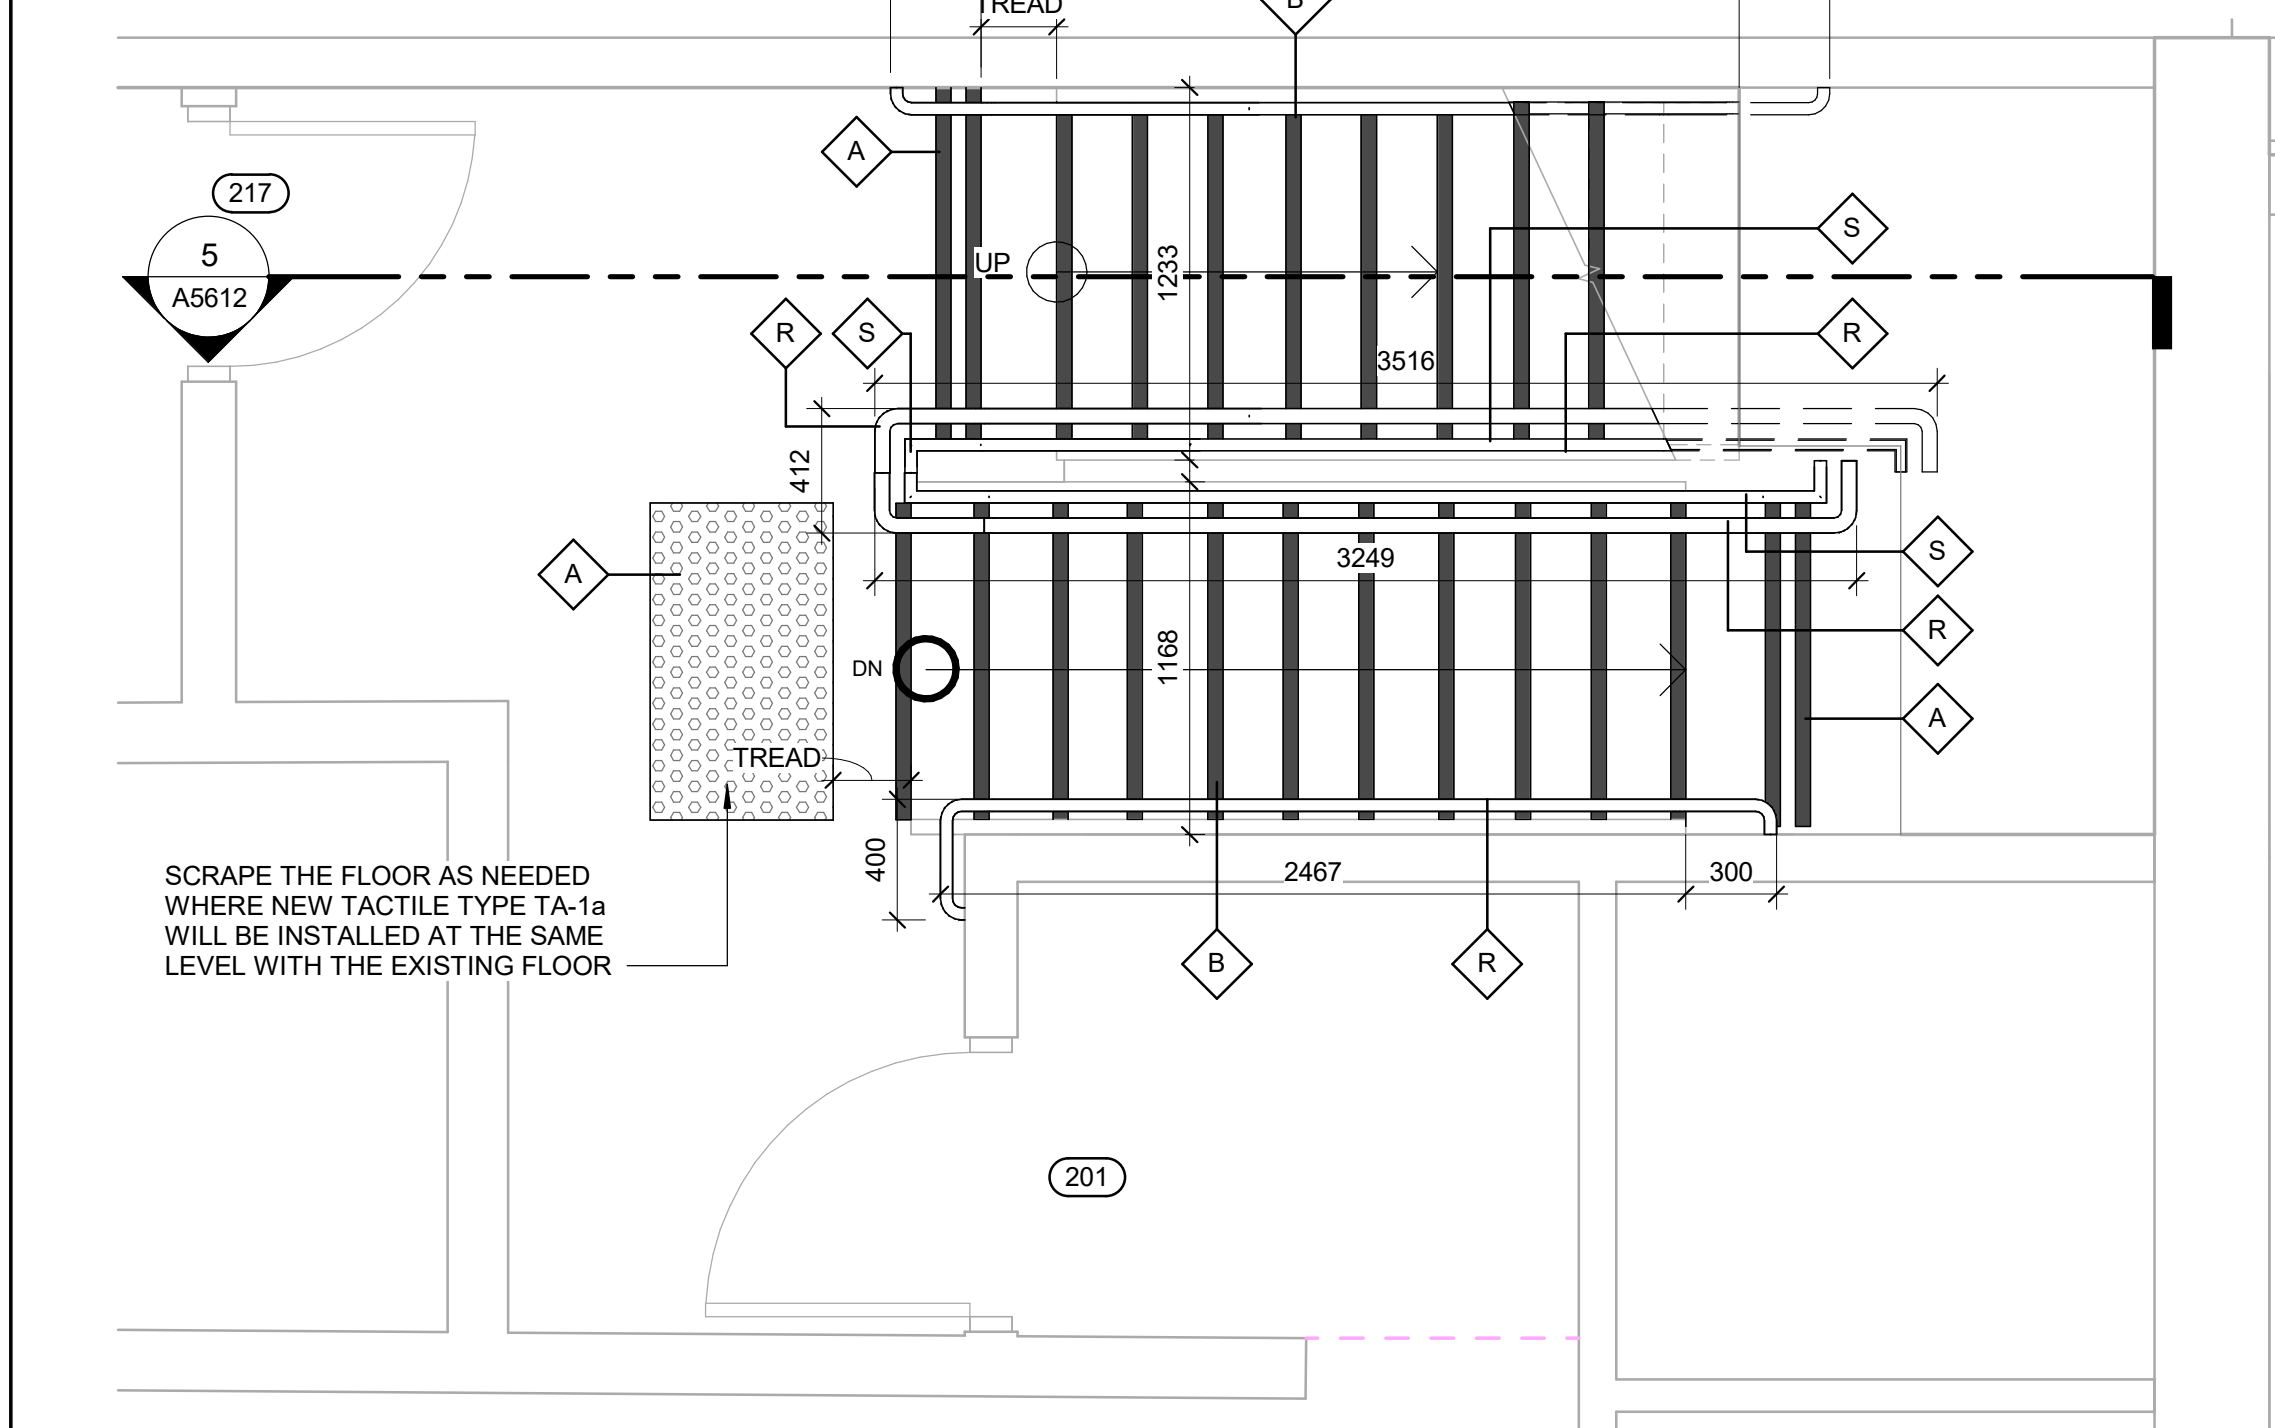

4 STAIR 2 - THIRD FLOOR PLAN
A5612 Scale: 1 : 25

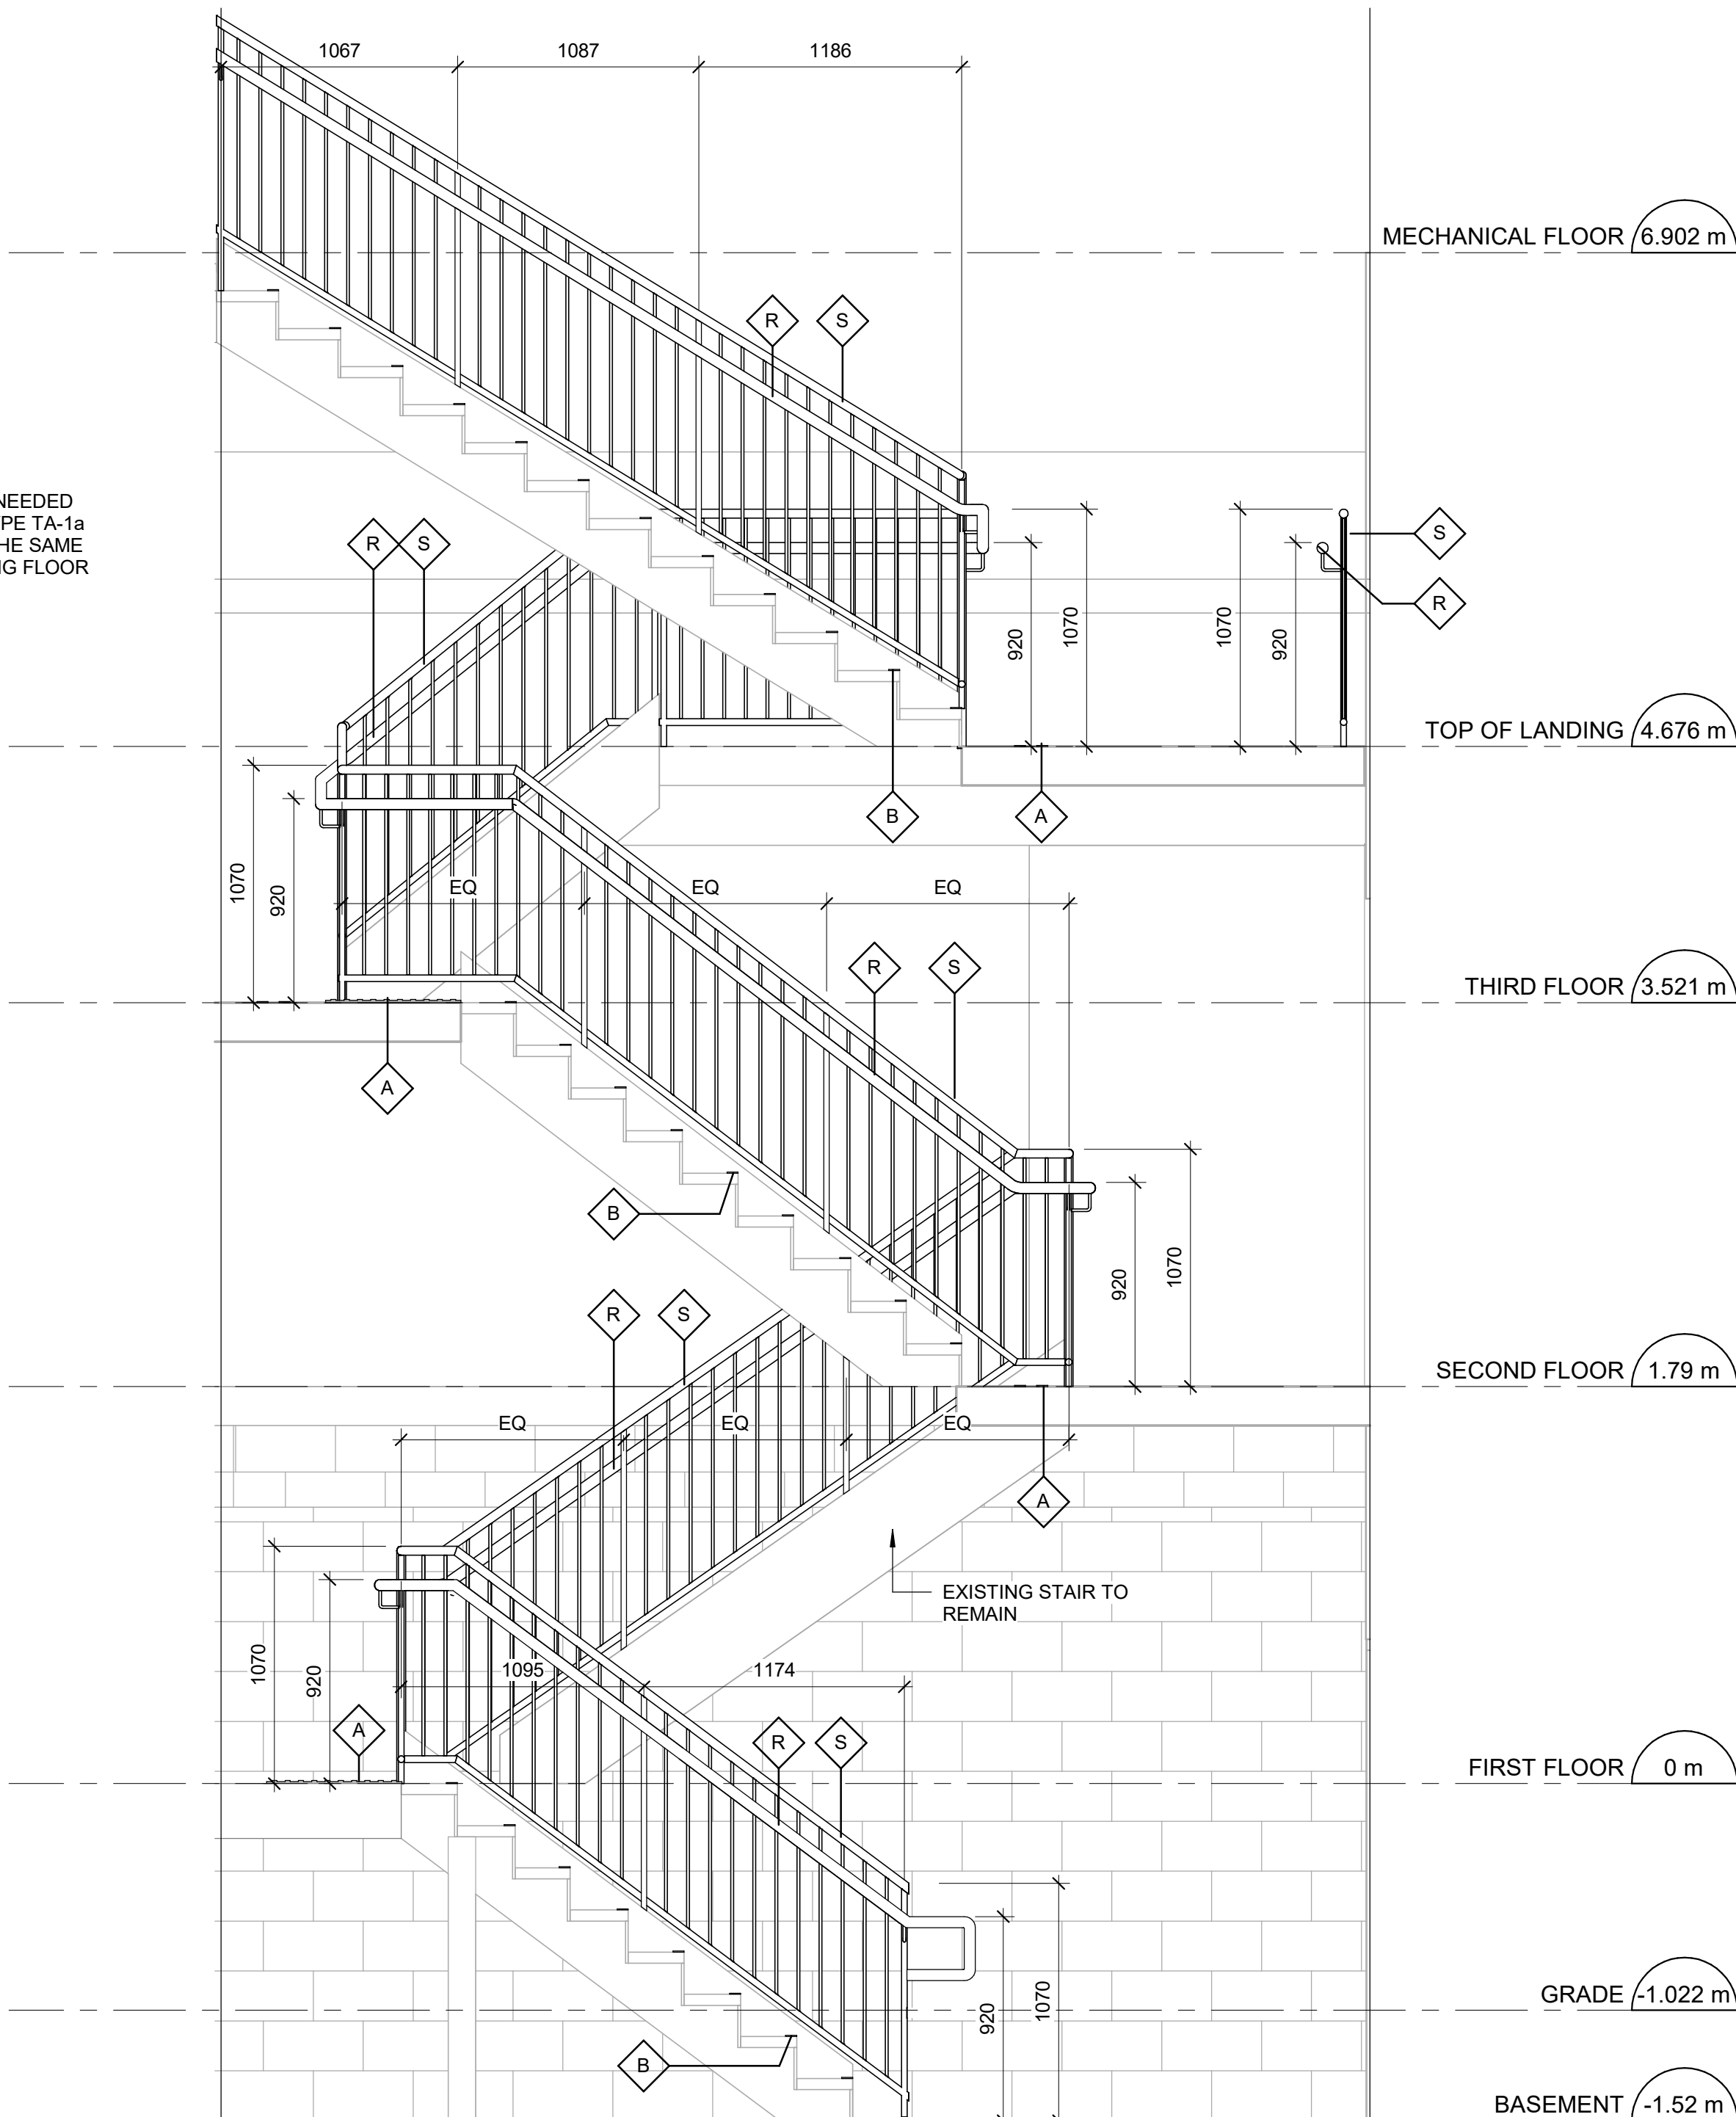

5 STAIR 2 - SECTION
A5612 Scale: 1 : 25

CONSTRUCTION KEY LEGEND

- EXISTING EXTERIOR WALL TO REMAIN
- EXISTING PARTITION TO REMAIN
- NEW EXTERIOR WALL REFER TO WALL SCHEDULE
- NEW PARTITION REFER TO PARTITION SCHEDULE
- EXISTING DOOR TO REMAIN
- NEW DOOR AND/ OR NEW HARDWARE
- DASHED AREA INDICATES AREA OF WORK

CONSTRUCTION KEY NOTES

NO	DESCRIPTION
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B	INSTALL COLOUR AND TEXTURE NOSING STRIP - REFER TO TYPICAL DETAIL 1/D1402.
R	INSTALL NEW HANDRAIL - REFER TO DETAILS 1/D1401, 3/D1401, 2/1403, 3/1403, 4/D1402.
S	INSTALL NEW GUARDRAIL - REFER TO DETAILS 5/D1401, 6/D1401, 1/D1403.

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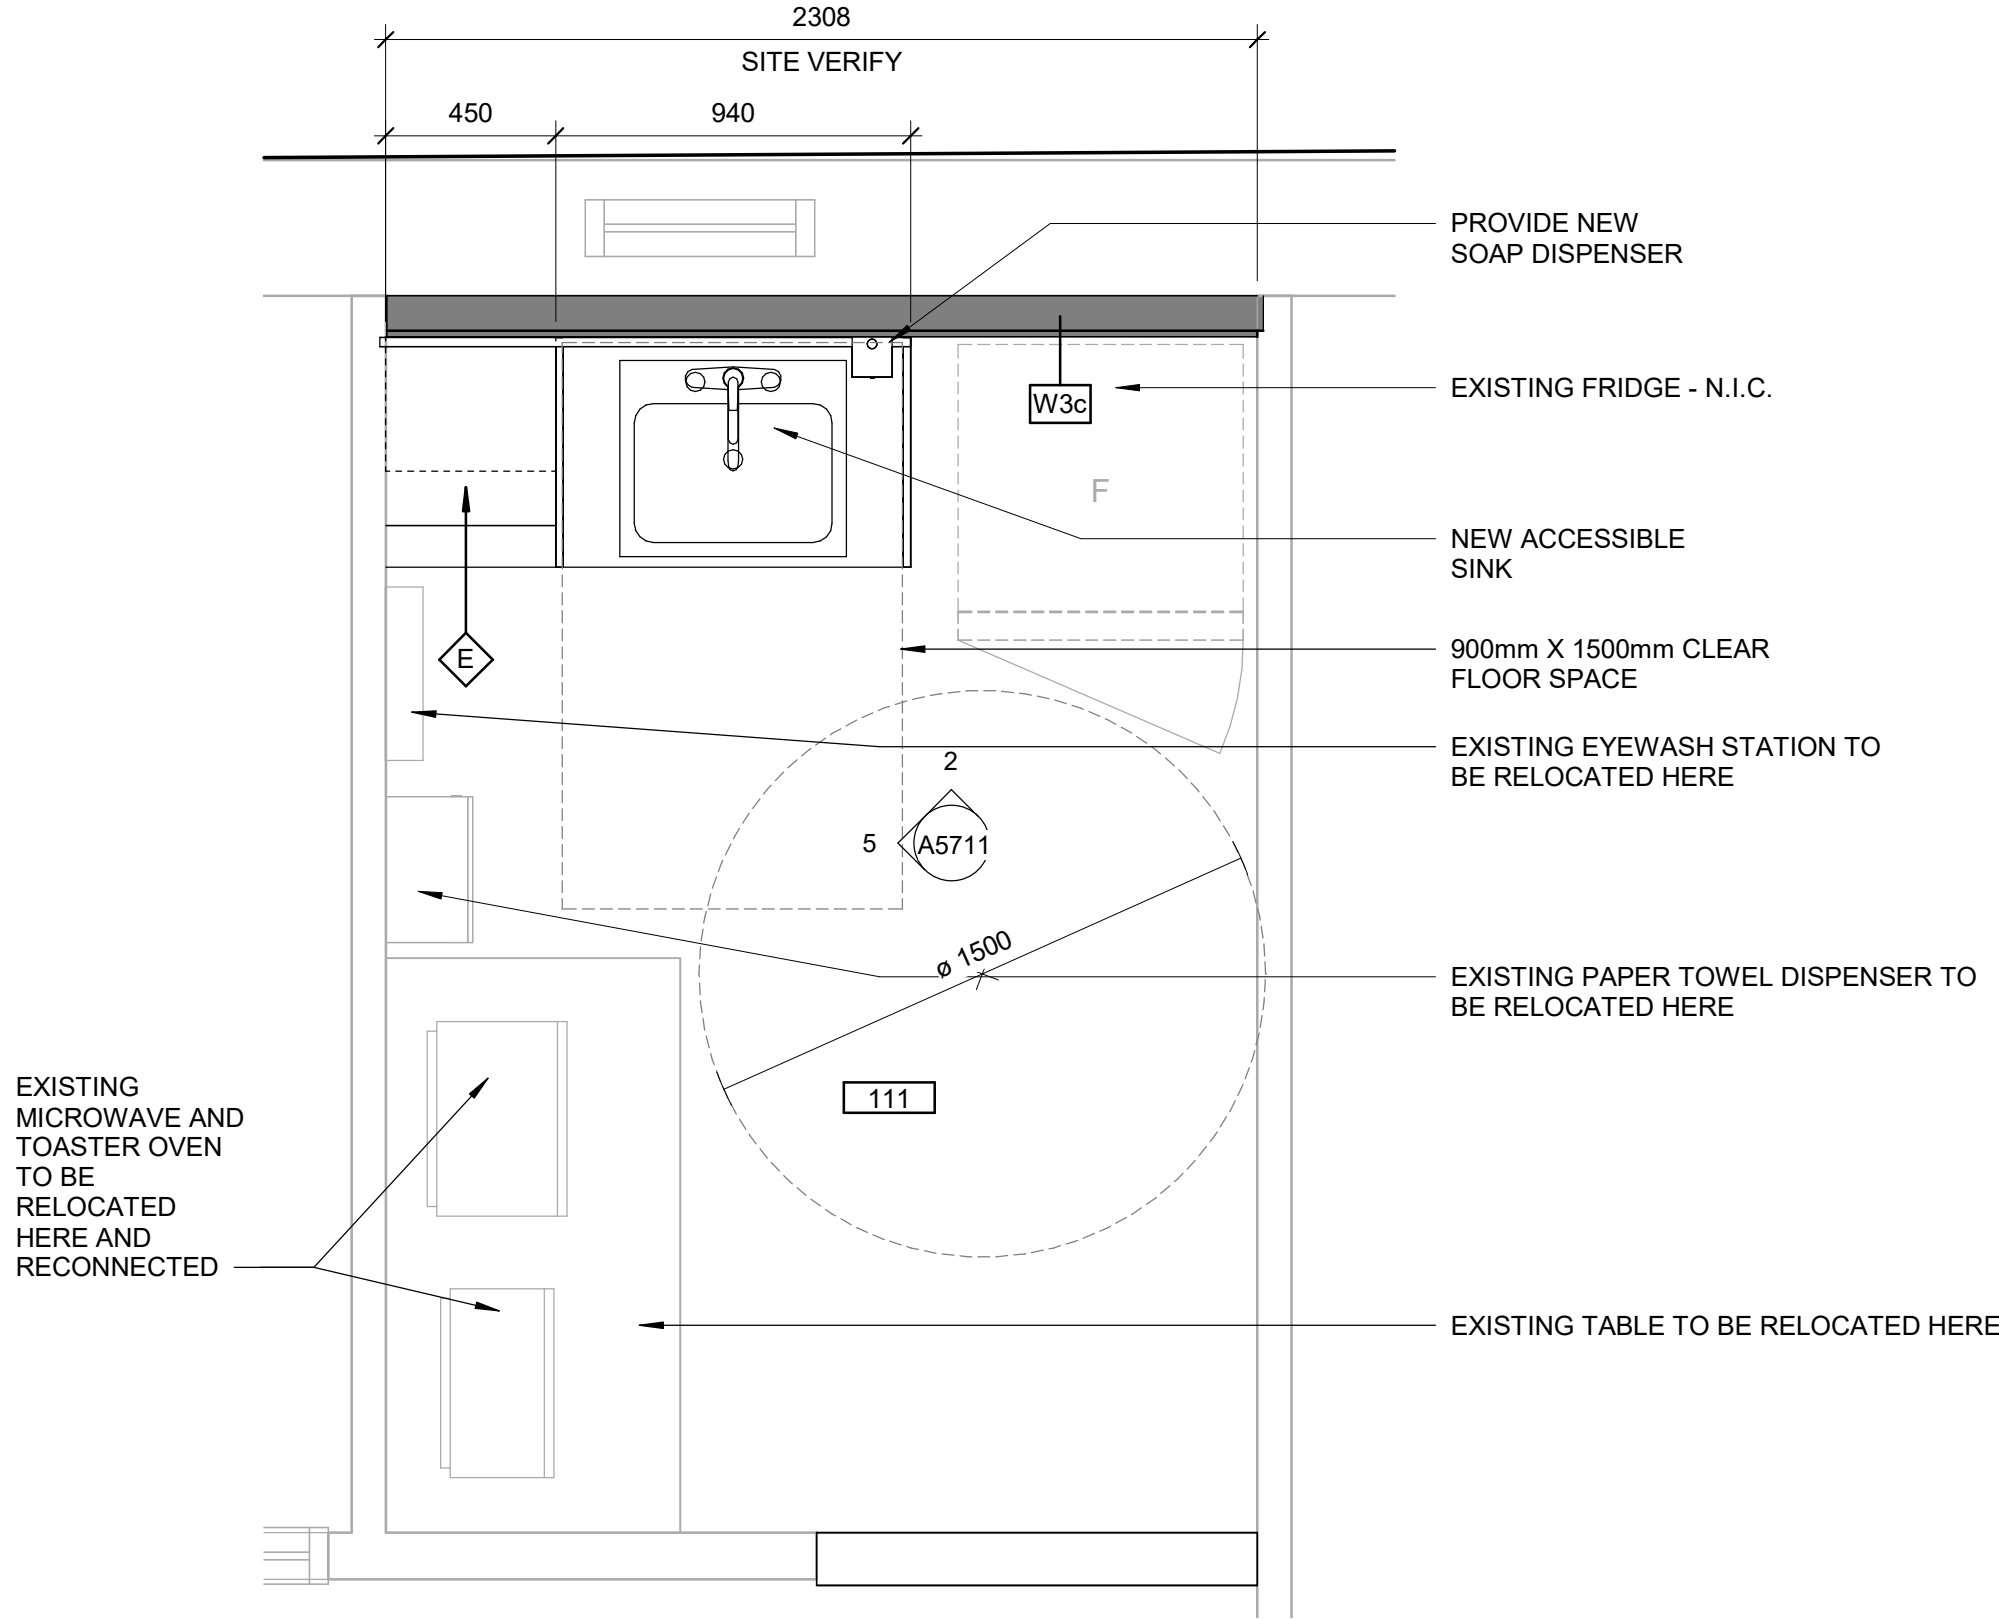
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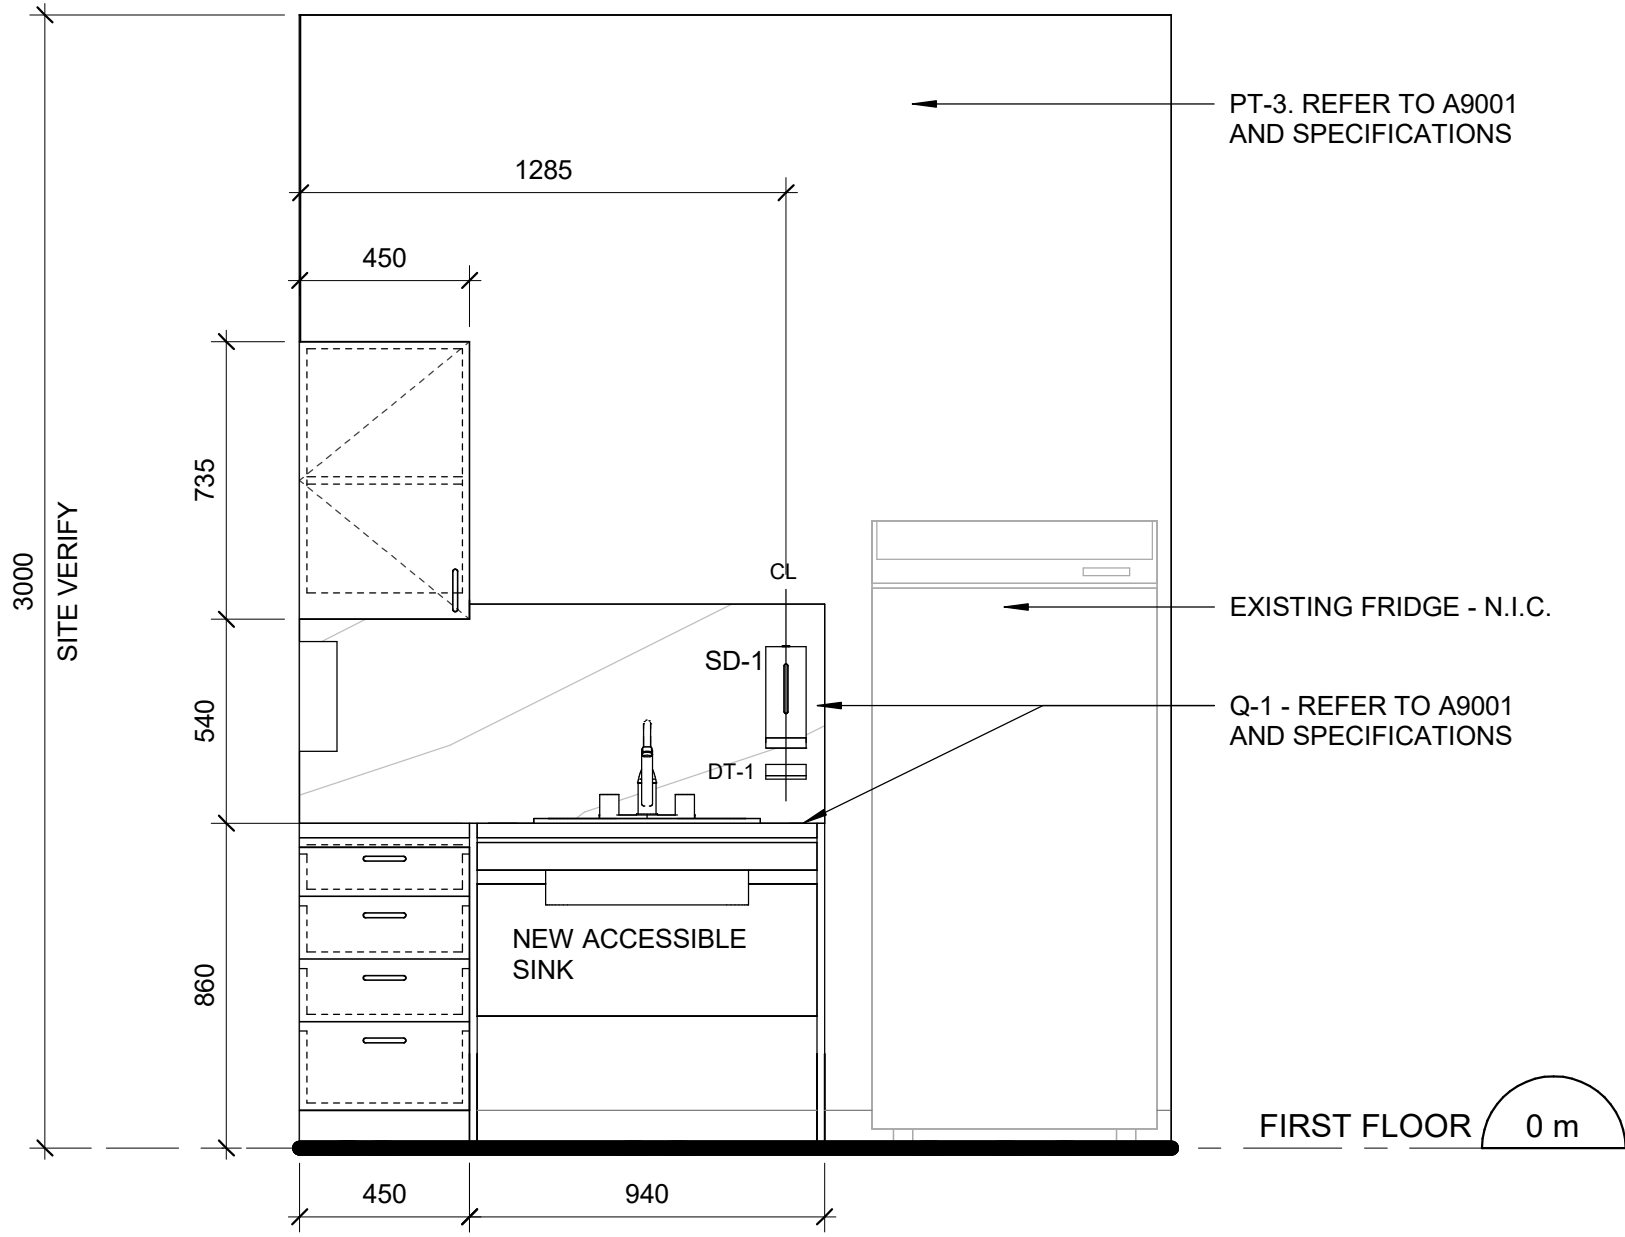
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K.Tilahun
APPROVED BY:
E.Fenuta

SHEET TITLE
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SECTION**


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G05-249-A5612
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D



1 FIRST FLOOR PLAN - NEW ACCESSIBLE KITCHEN
A5711 Scale: 1 : 20




2 NORTH ELEVATION - NEW KITCHEN
A5711 Scale: 1 : 20

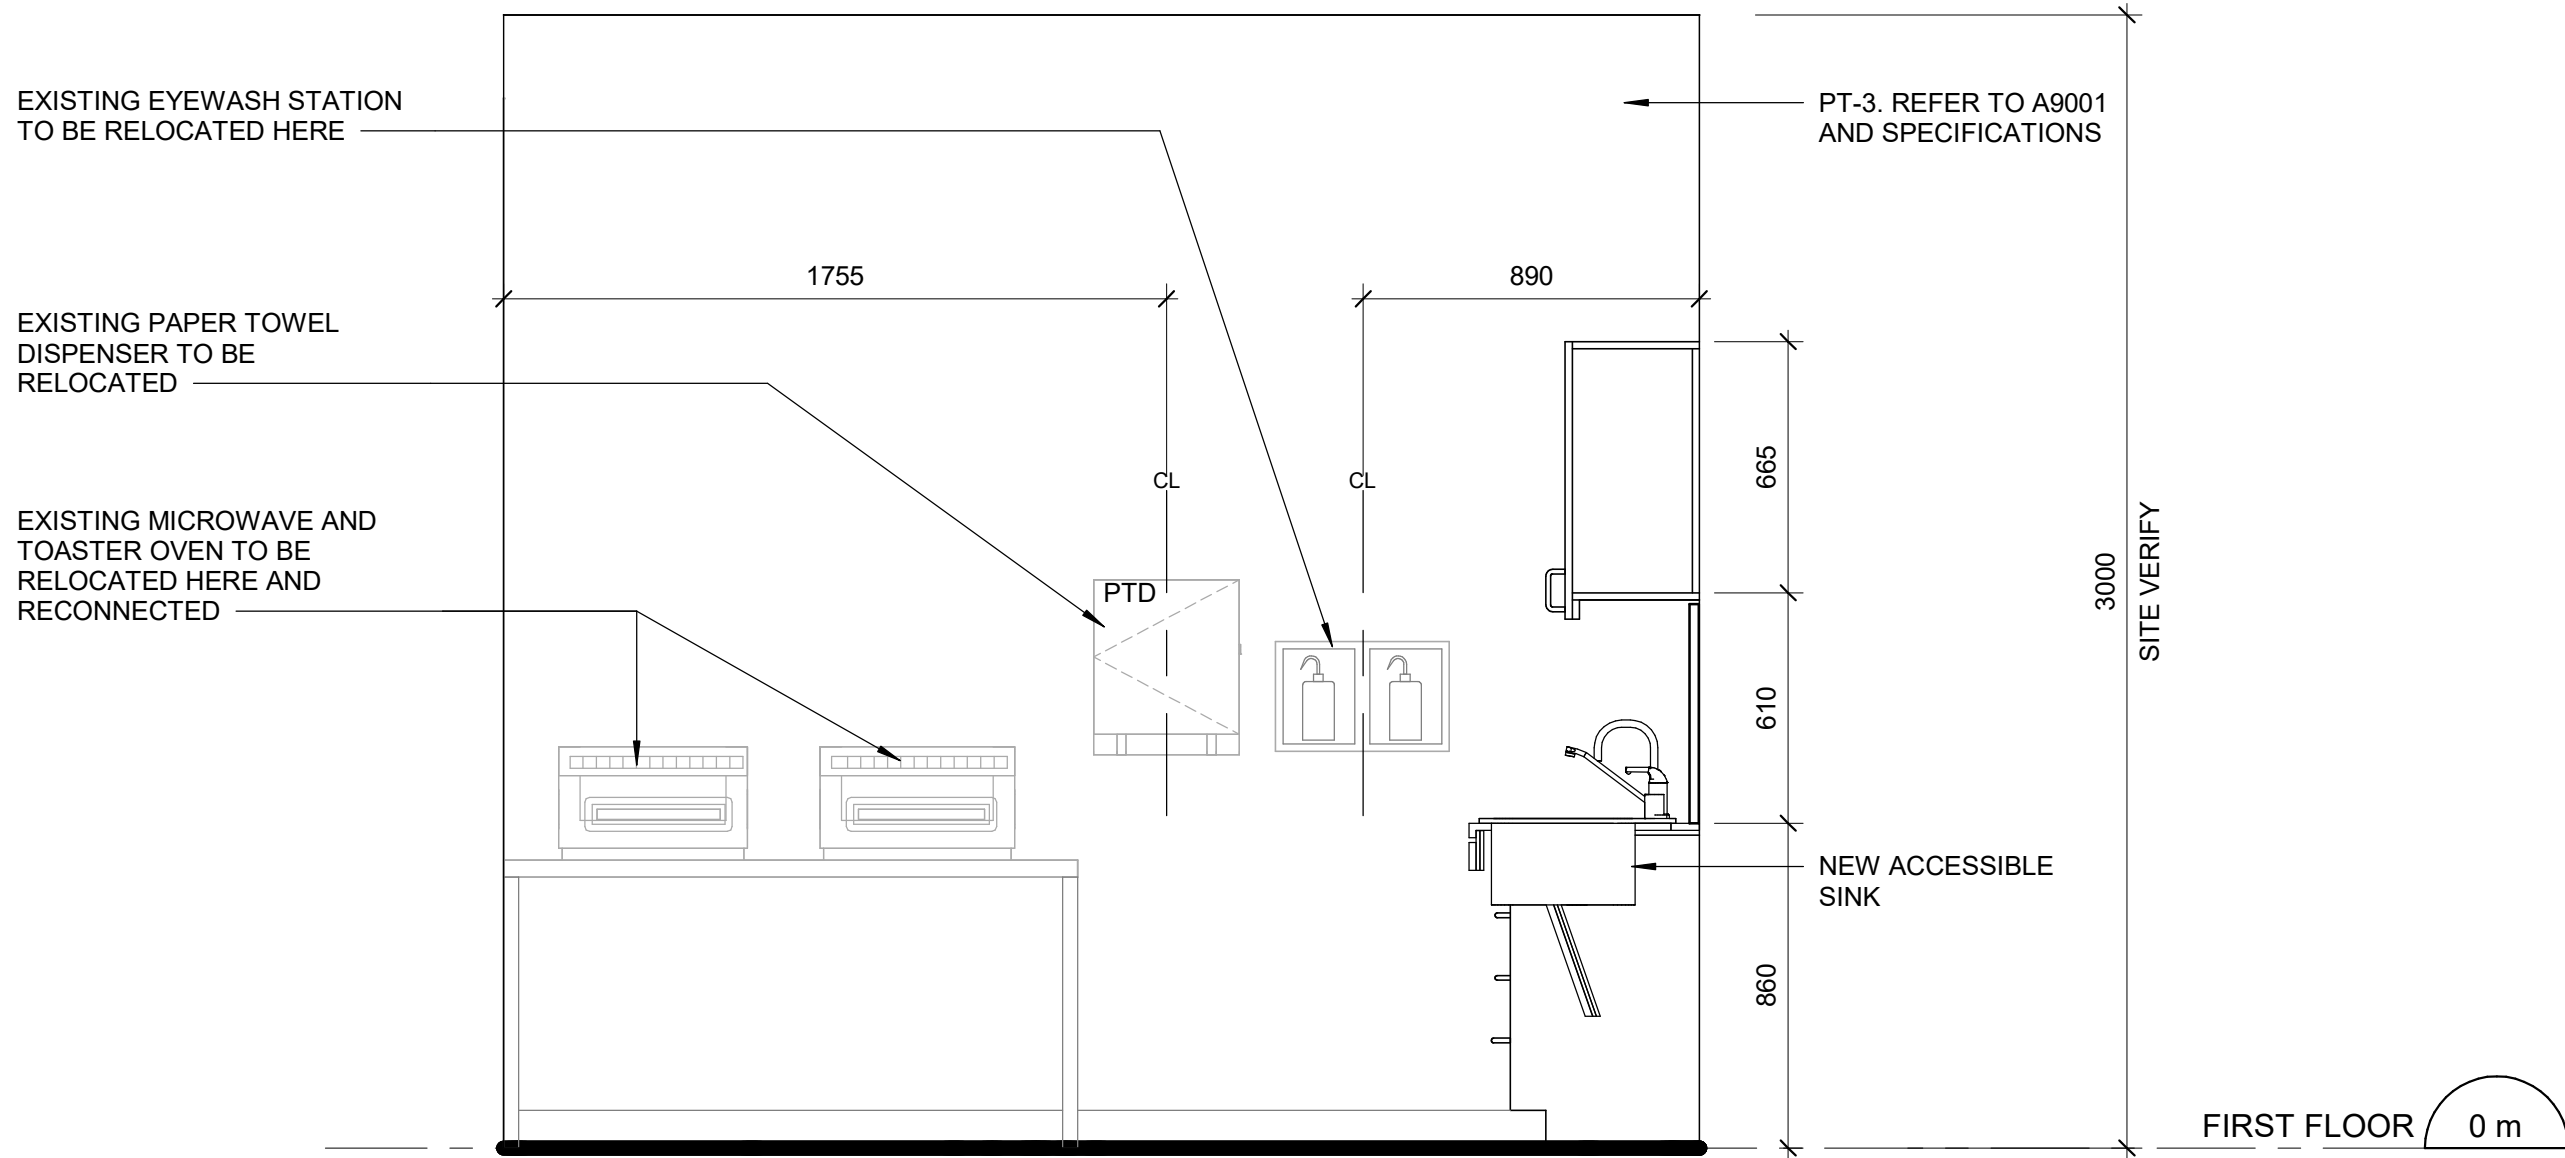

5 WEST ELEVATION - NEW KITCHEN
A5711 Scale: 1 : 20

CONSTRUCTION KEY LEGEND

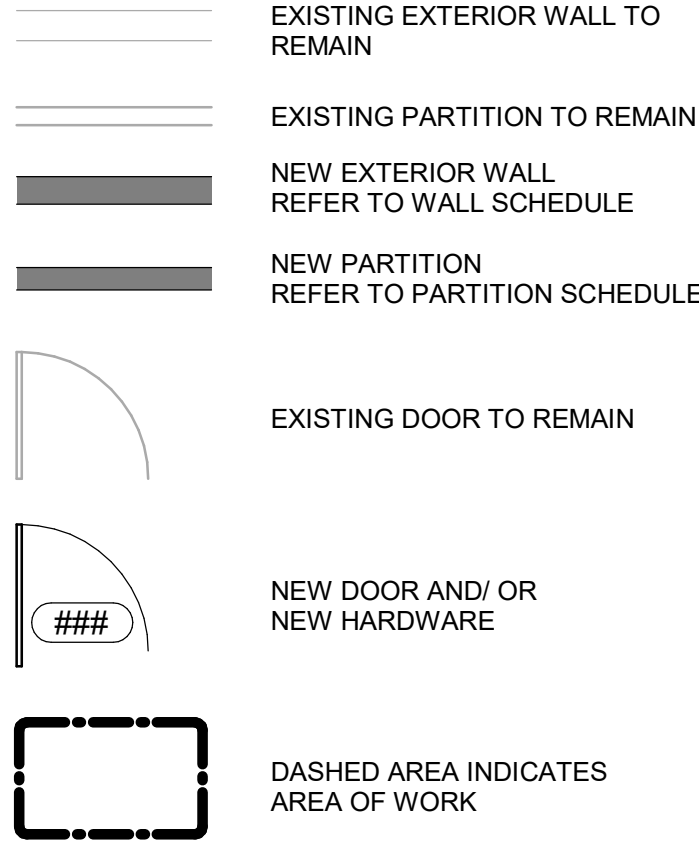

CONSTRUCTION KEY NOTES

NO	DESCRIPTION
E	CONSTRUCT NEW KITCHEN MILLWORK. REFER TO MILLWORK DETAILS 1/D1301, 2/D1301, 3/D1301, 4/D1301, 1/D1302, 2/D1302, 3/D1302, 4/1302, 5/D1302, 6/D1302, 8/D1302.



PHOTO 1



PHOTO 2



PHOTO 3

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APPROVED BY:
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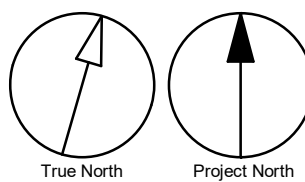
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**NEW KITCHEN PLANS &
ELEVATIONS**


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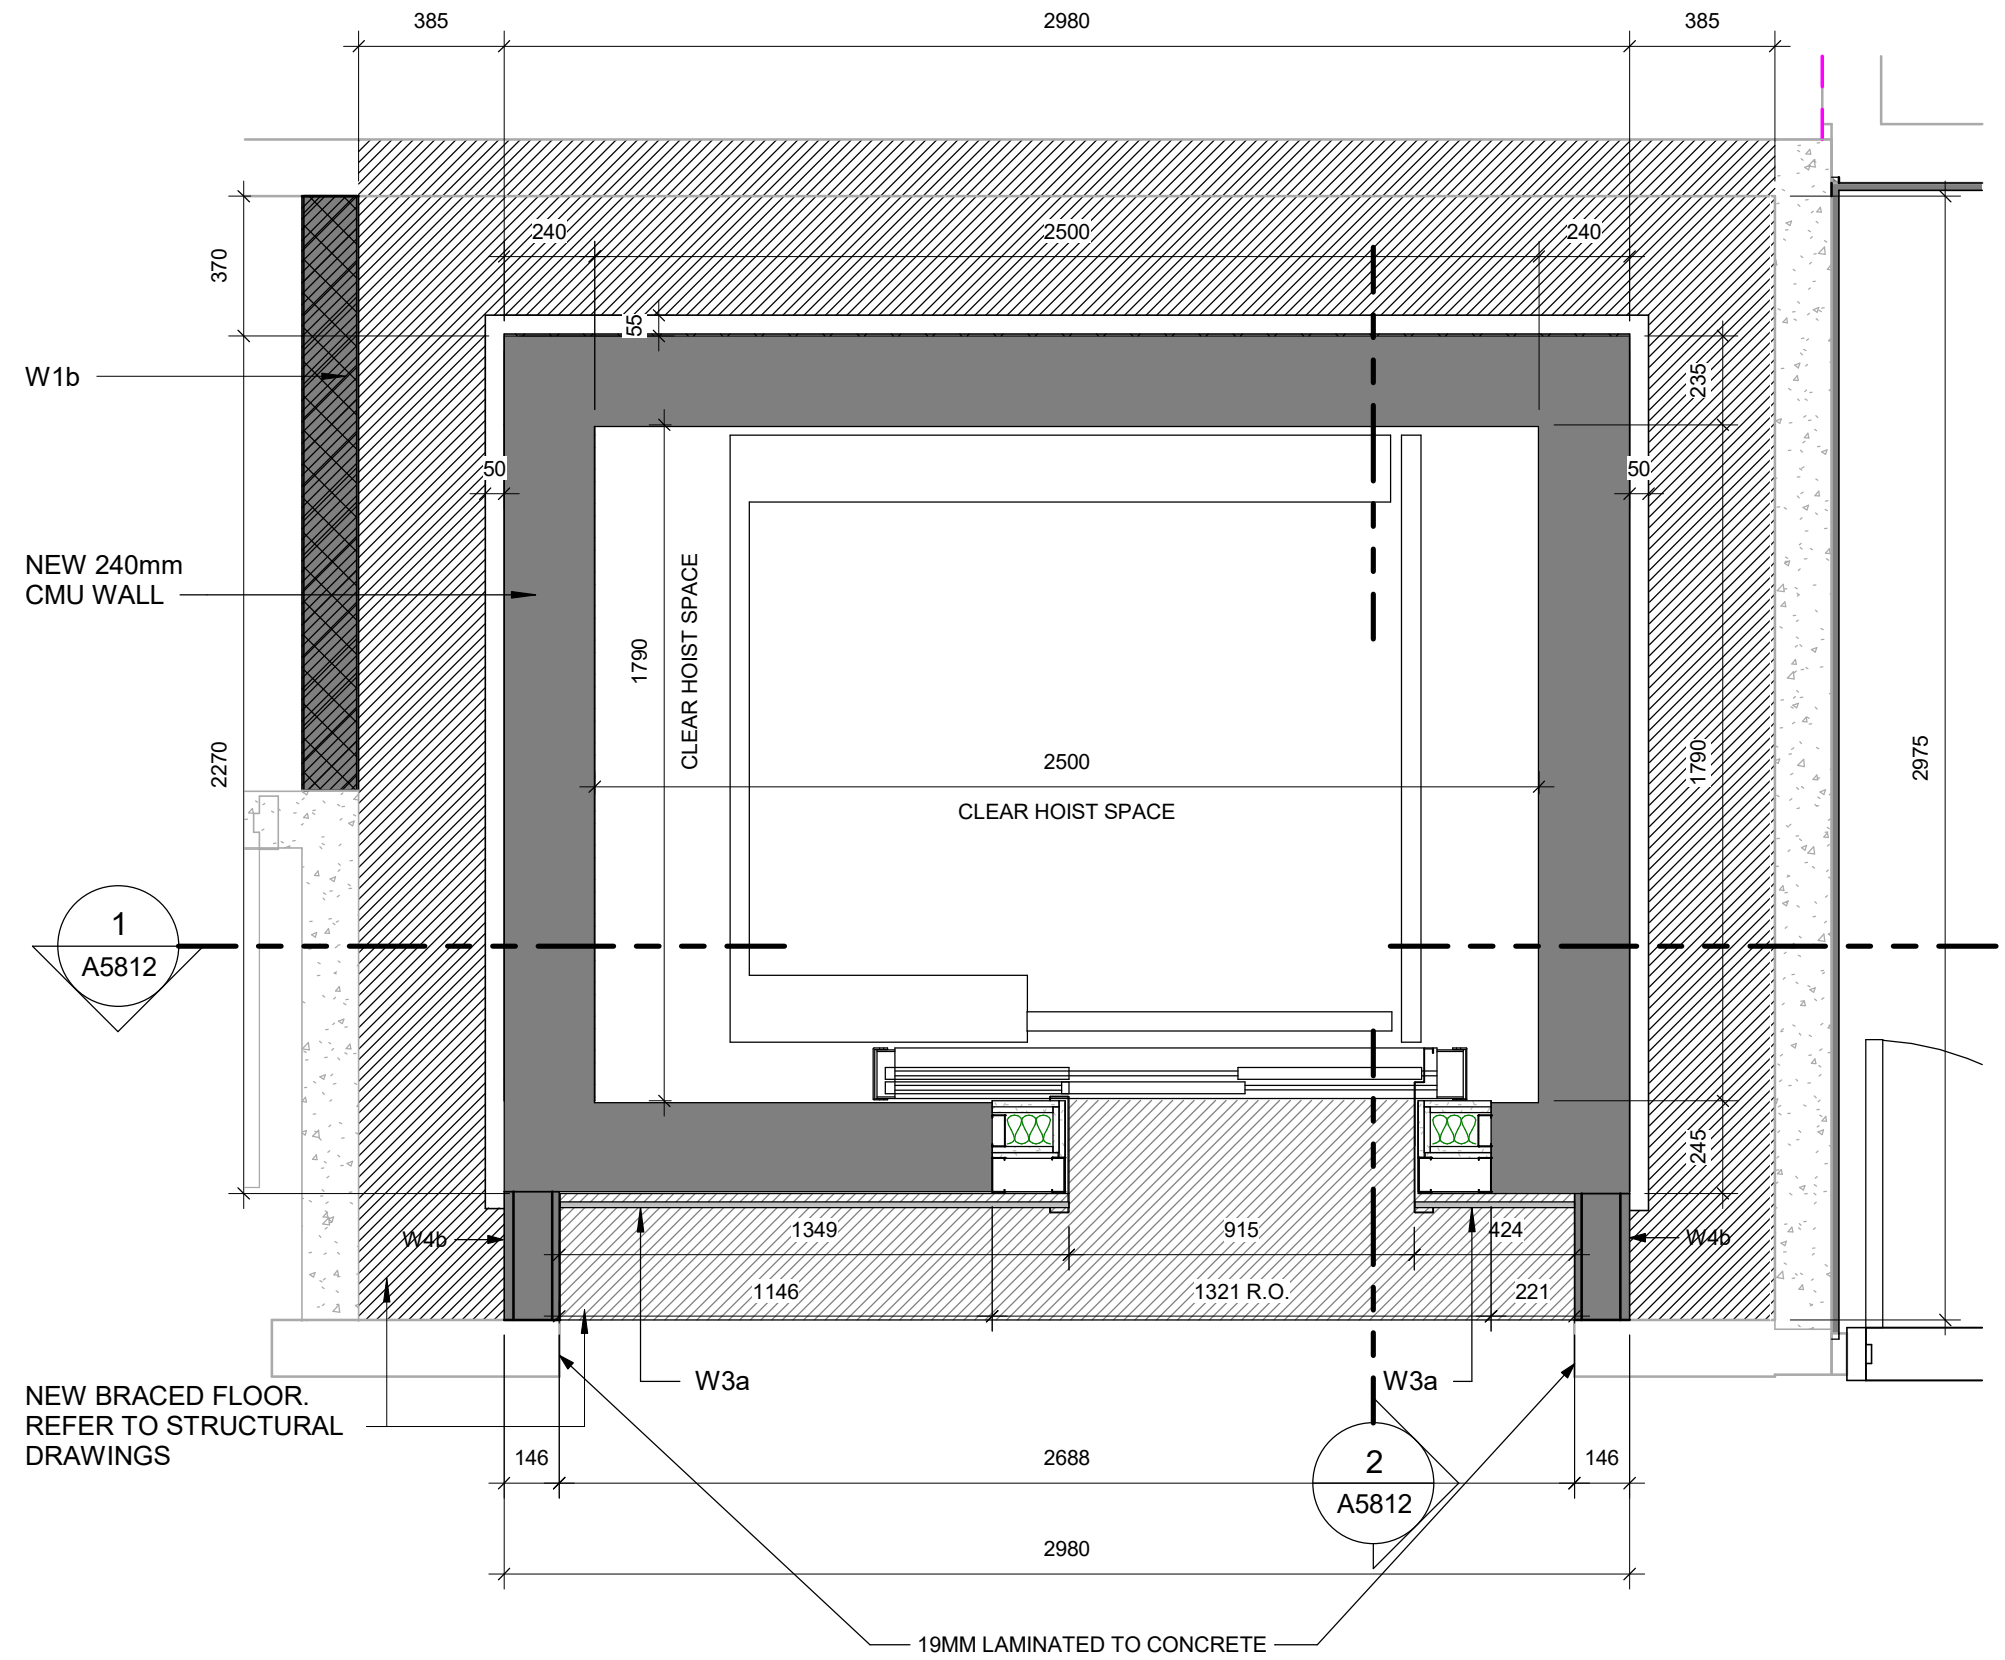
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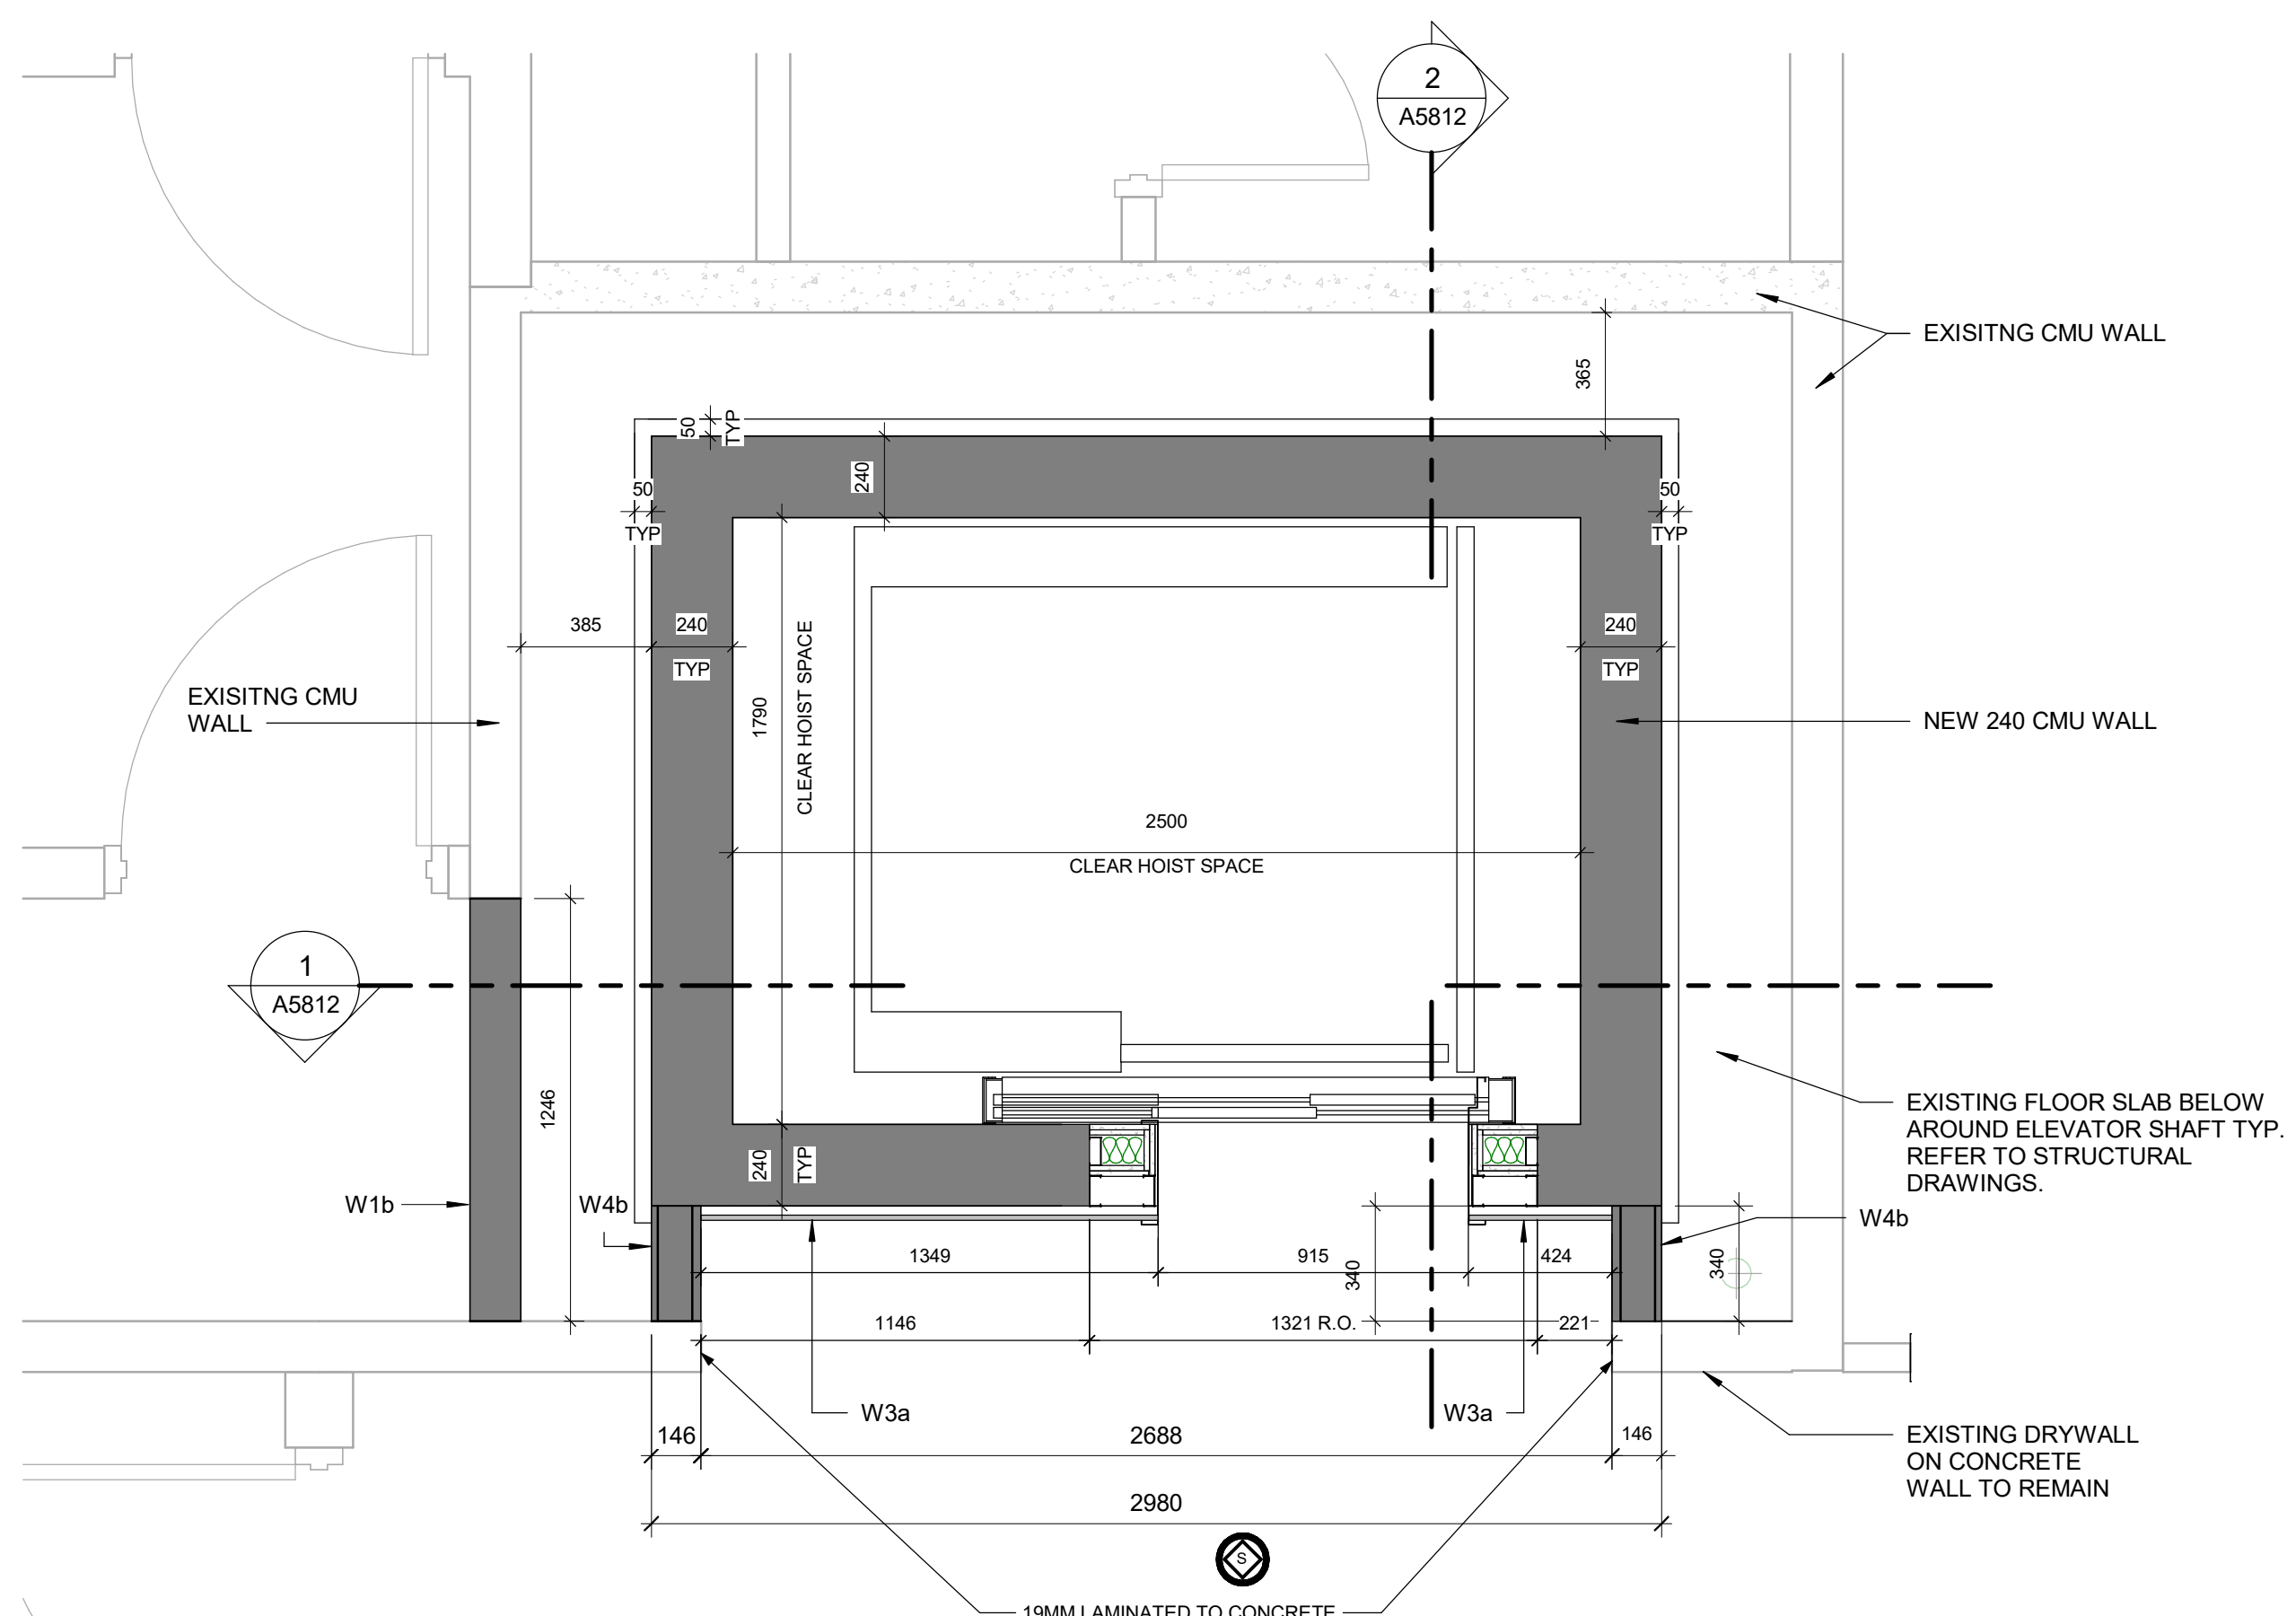





2 ELEVATOR - ENLARGED BASEMENT PLAN
A5811 Scale: 1 : 20



3 ELEVATOR - ENLARGED THIRD FLOOR PLAN
A5811 Scale: 1 : 20

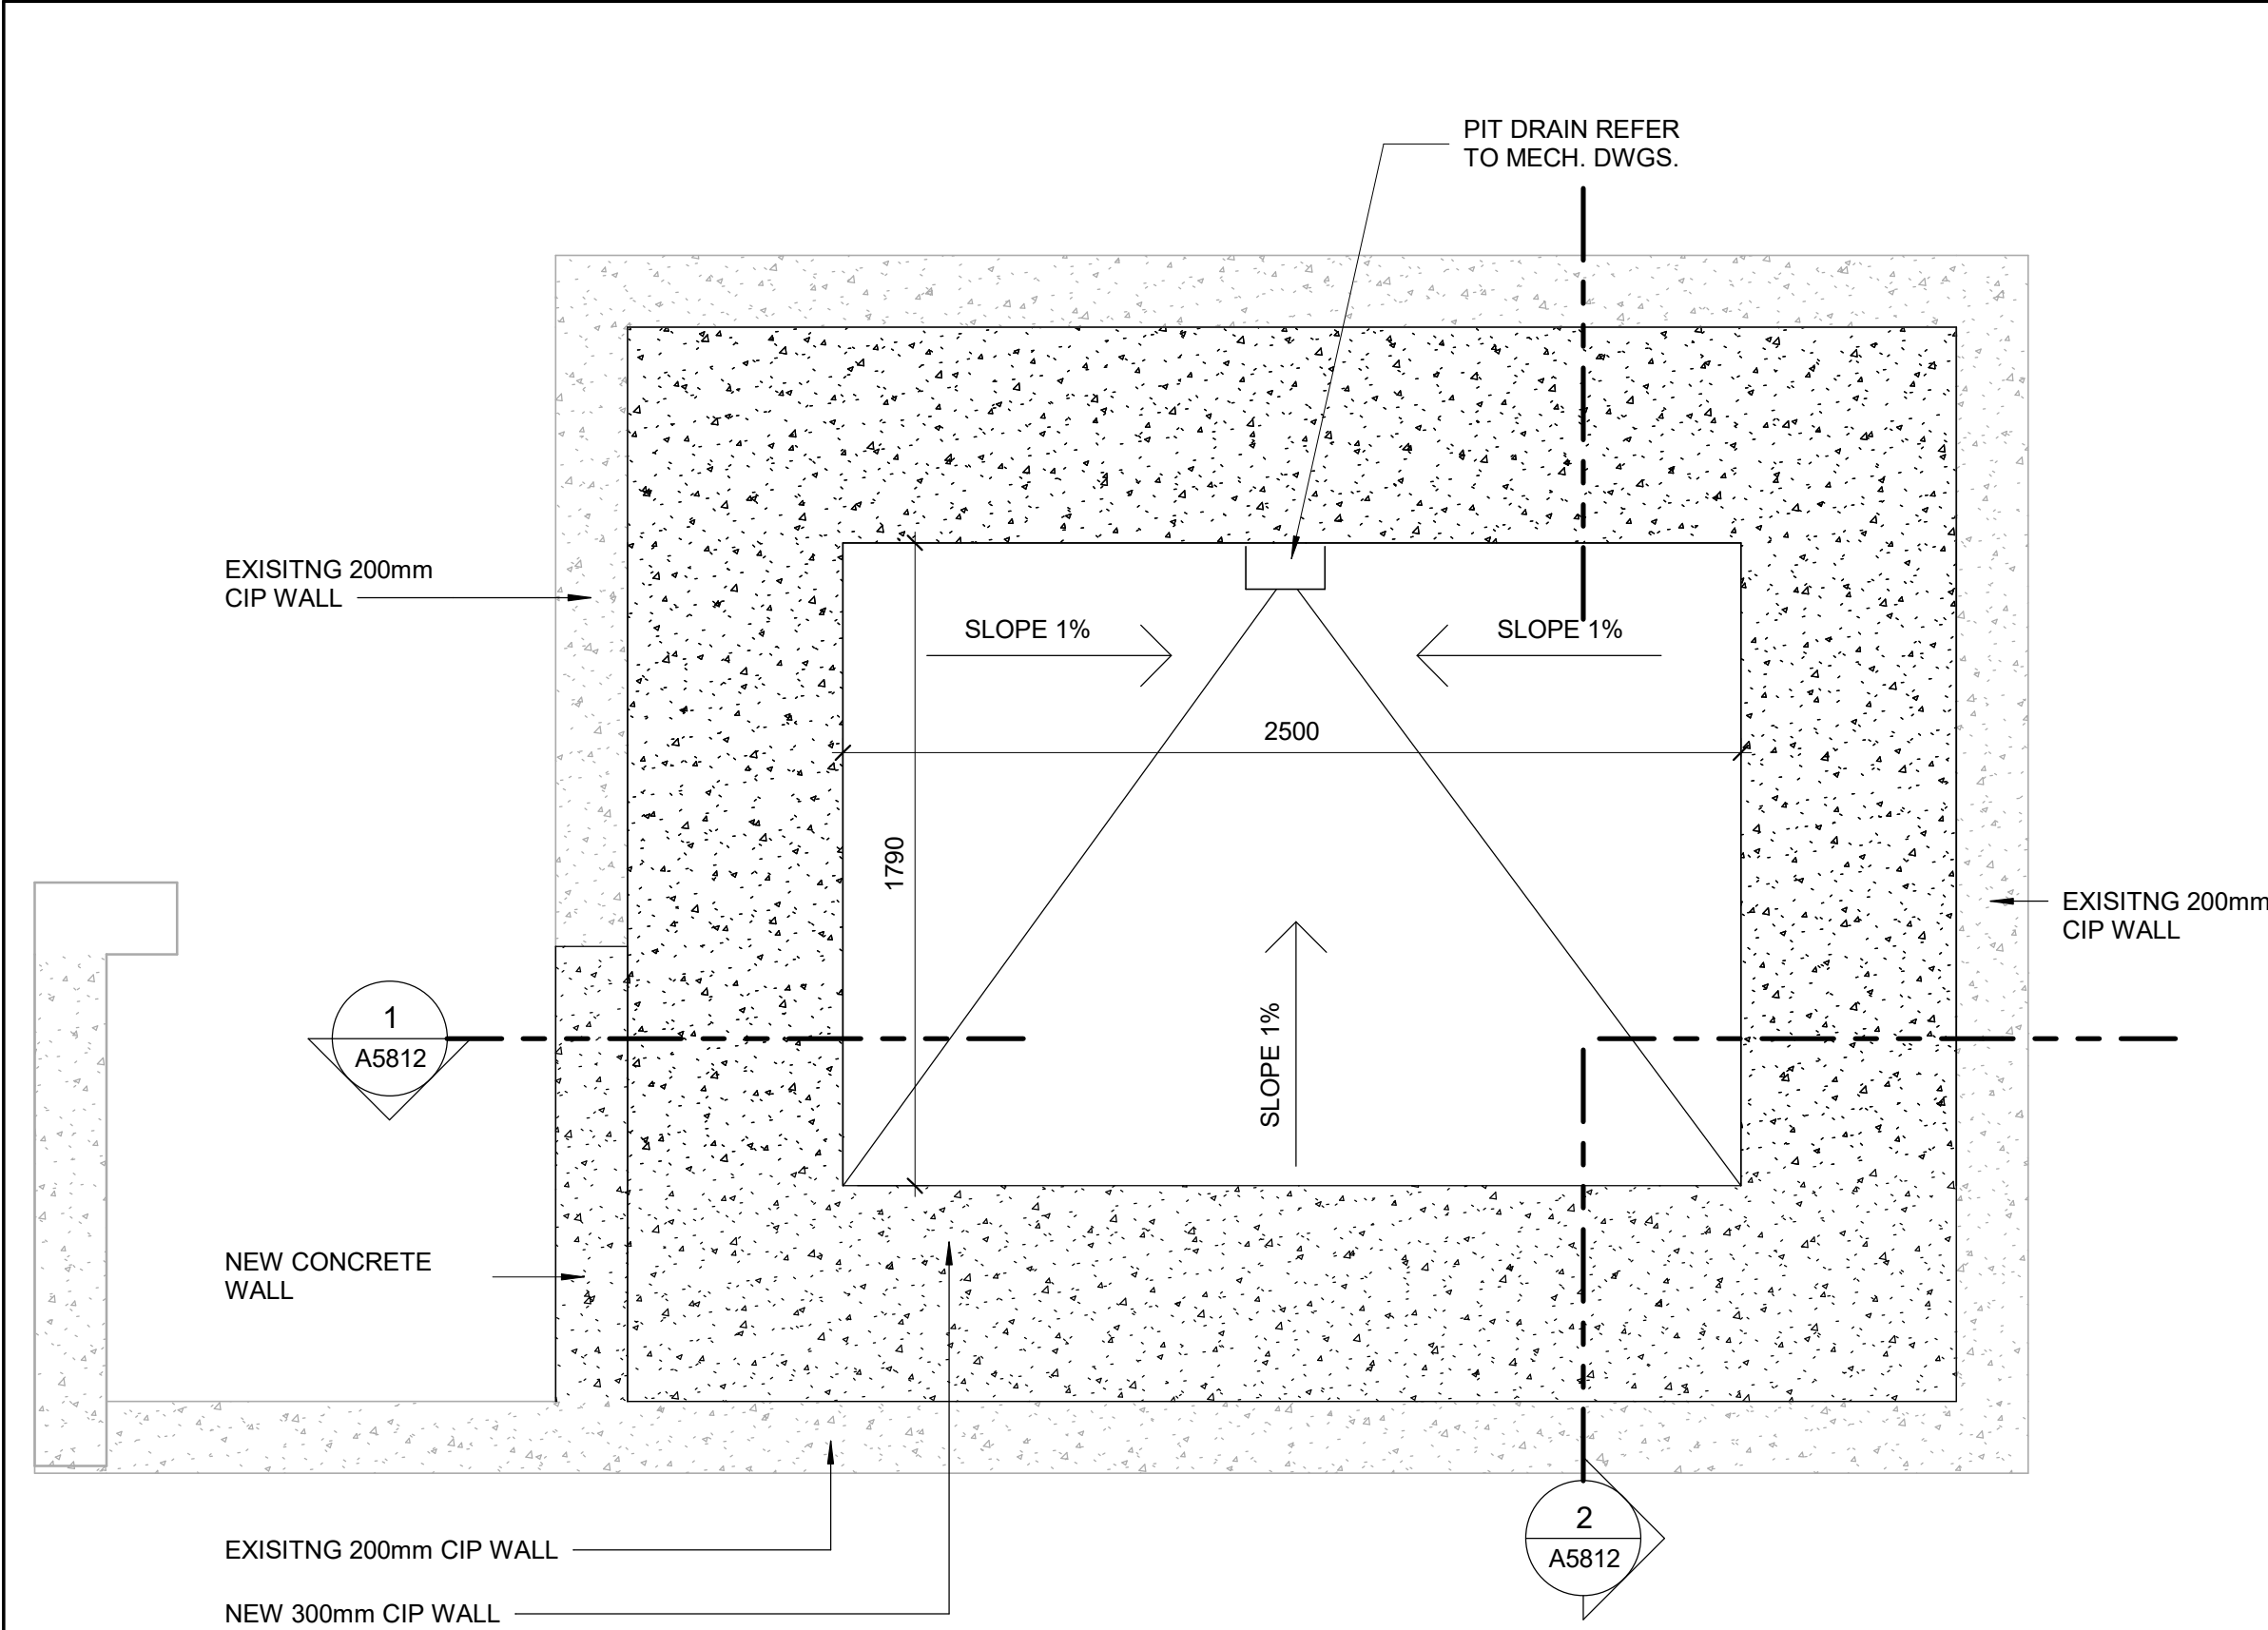

1 ELEVATOR - ENLARGED FIRST FLOOR PLAN
A5811 Scale: 1 : 20

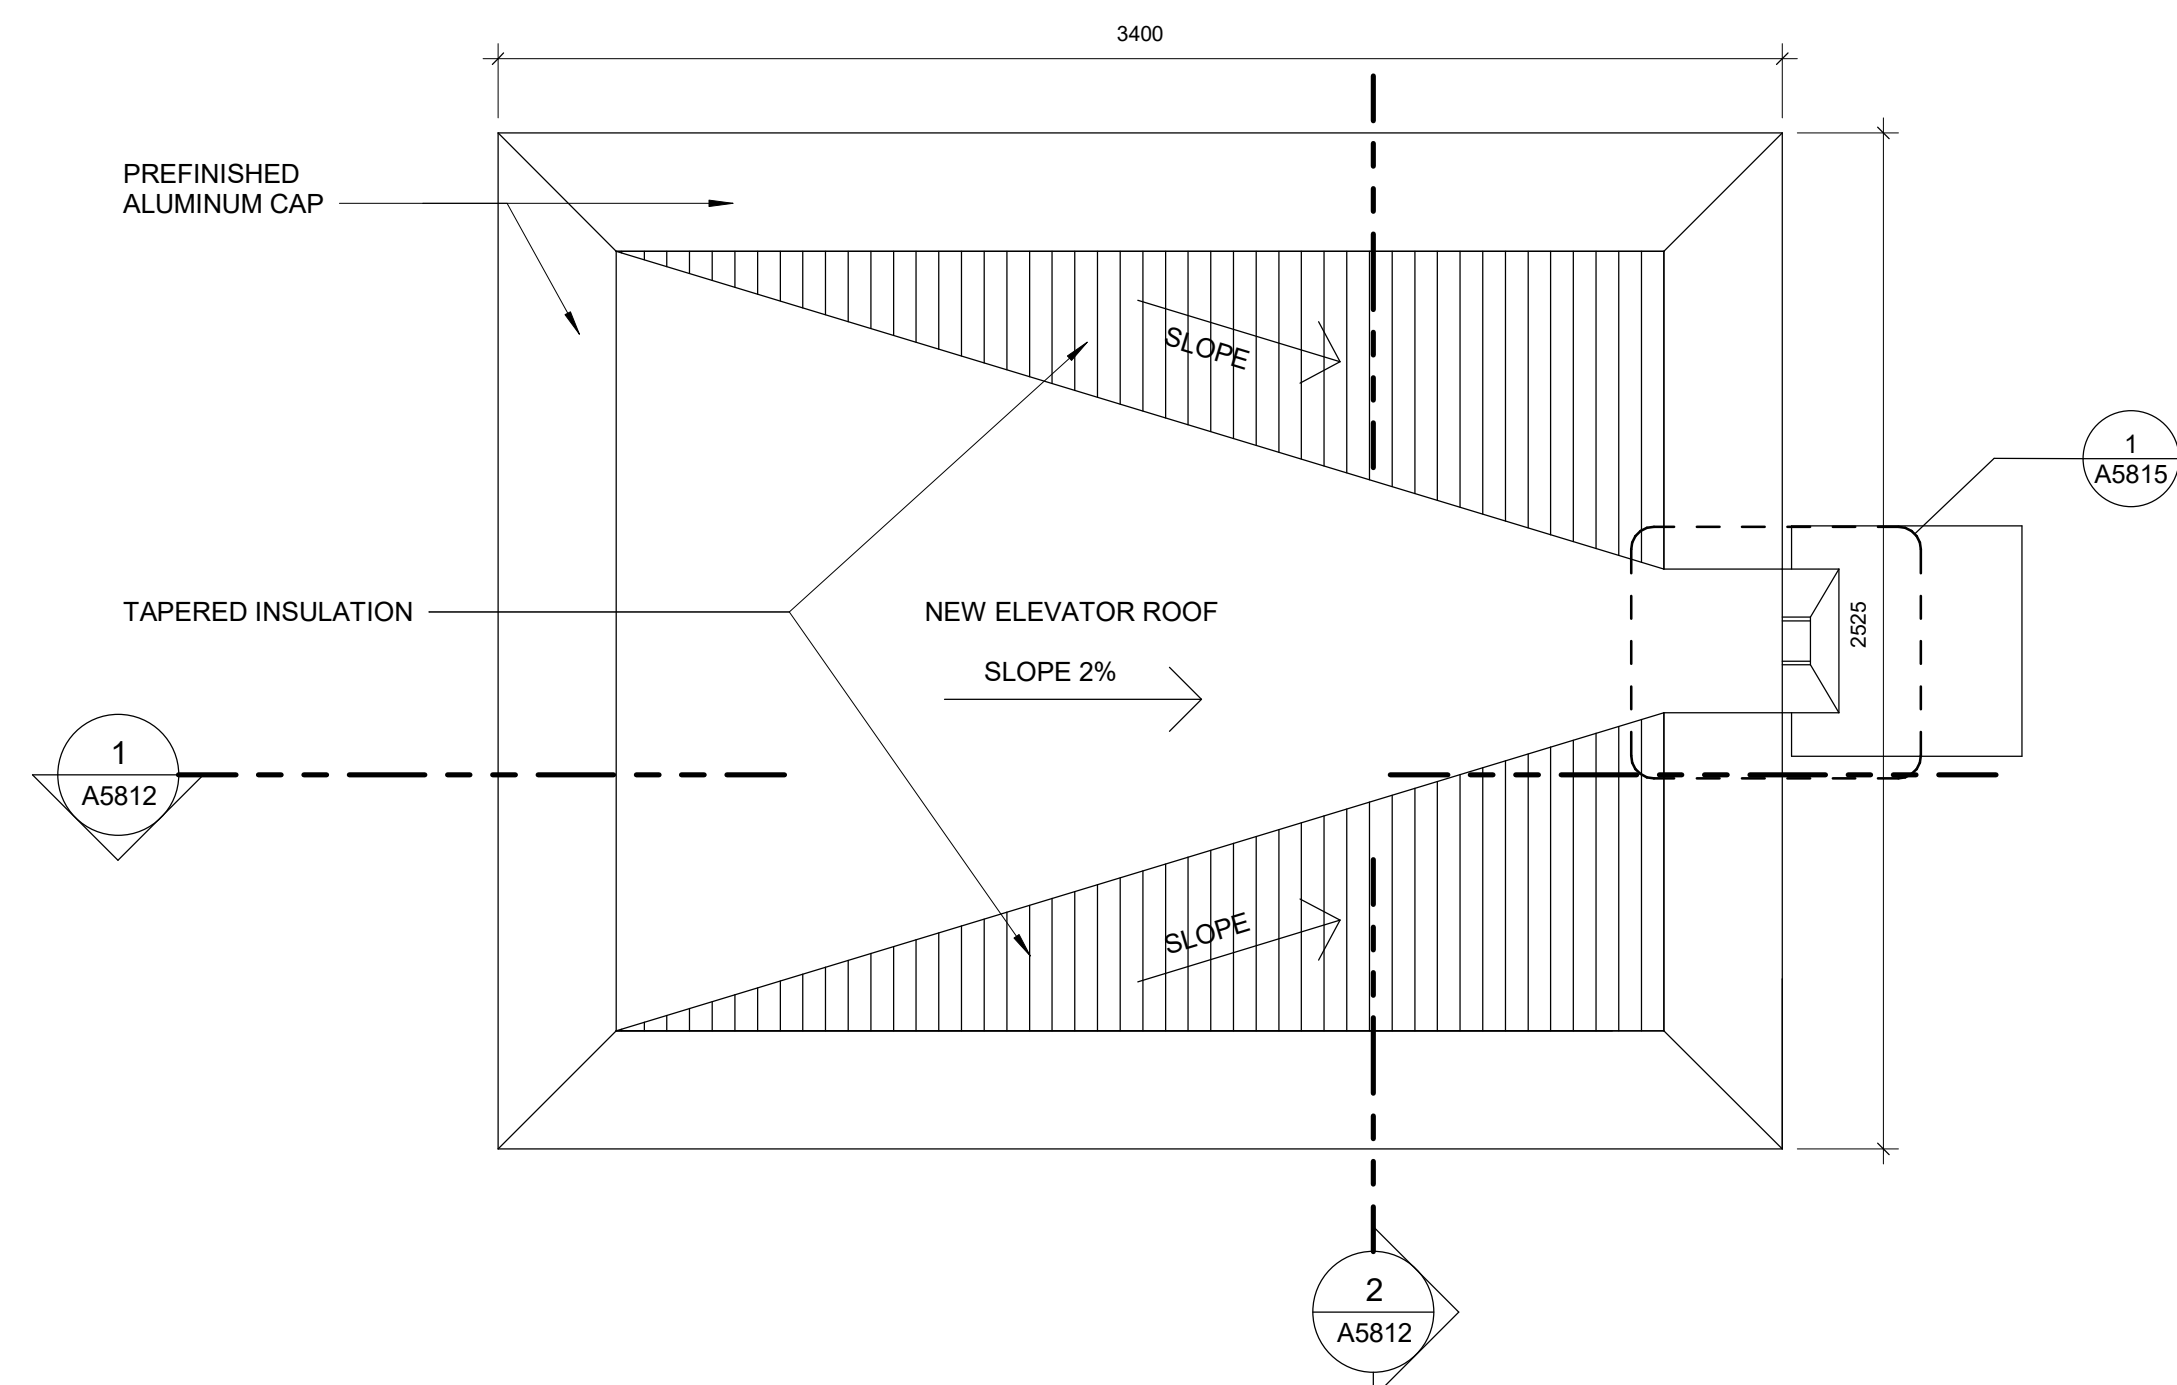

4 ELEVATOR - ENLARGED MECHANICAL FLOOR PLAN
A5811 Scale: 1 : 20

CONSTRUCTION KEY LEGEND

- EXISTING EXTERIOR WALL TO REMAIN
- EXISTING PARTITION TO REMAIN
- NEW EXTERIOR WALL REFER TO WALL SCHEDULE
- NEW PARTITION REFER TO PARTITION SCHEDULE
- EXISTING DOOR TO REMAIN
- NEW DOOR AND/ OR NEW HARDWARE
- DASHED AREA INDICATES AREA OF WORK

NOTE:
FOR DETAILS REFER TO STRUCTURAL DWGS.

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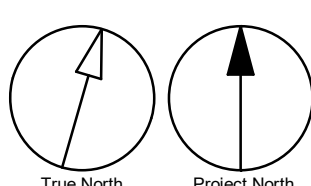
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PROJECT ADDRESS
**POLICE NO. 33 DIVISION
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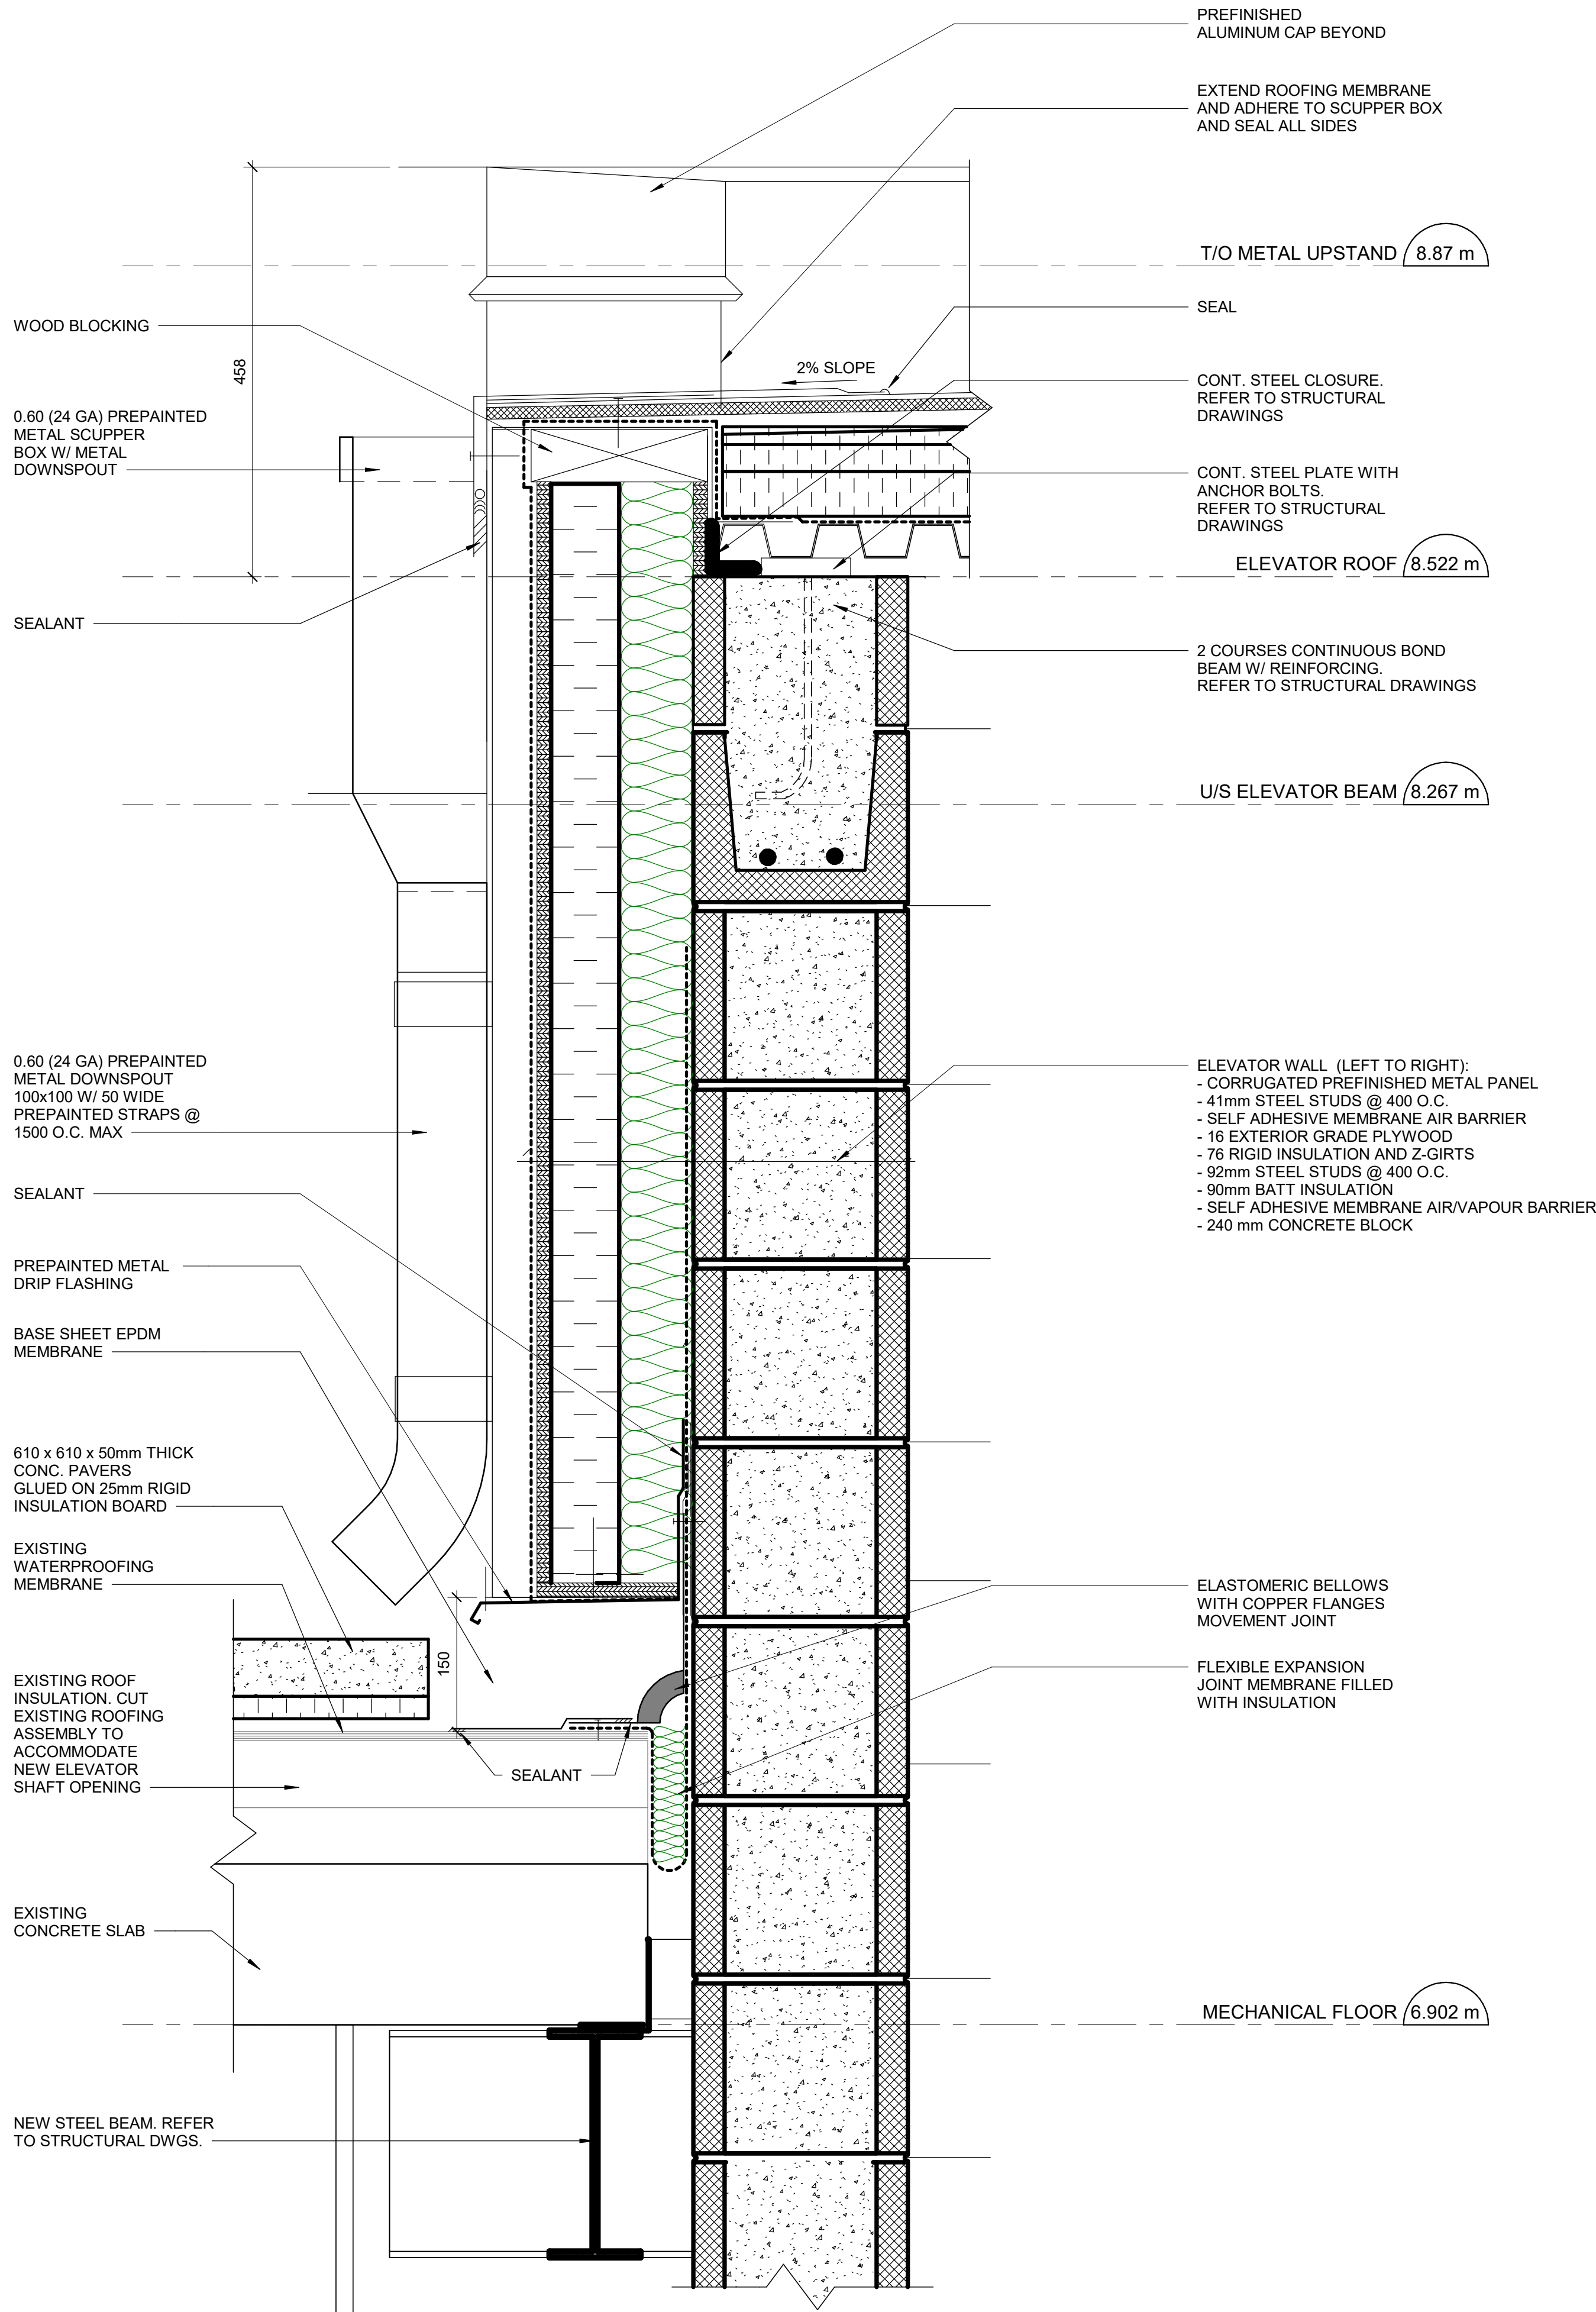
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DRAWN BY:
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PROJECT MGR:
F. BOLOURIAN
CHECKED BY:
K.Tilahun
APPROVED BY:
E.Fenuta

SHEET TITLE
ELEVATOR PLANS


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G05-249-A5811
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4/9/2025 4:05:40 PM



3 ROOF SCUPPER - OPTION 1
A5813 Scale: 1 : 5



4 ROOF PARAPET - OPTION 1
A5813 Scale: 1 : 5
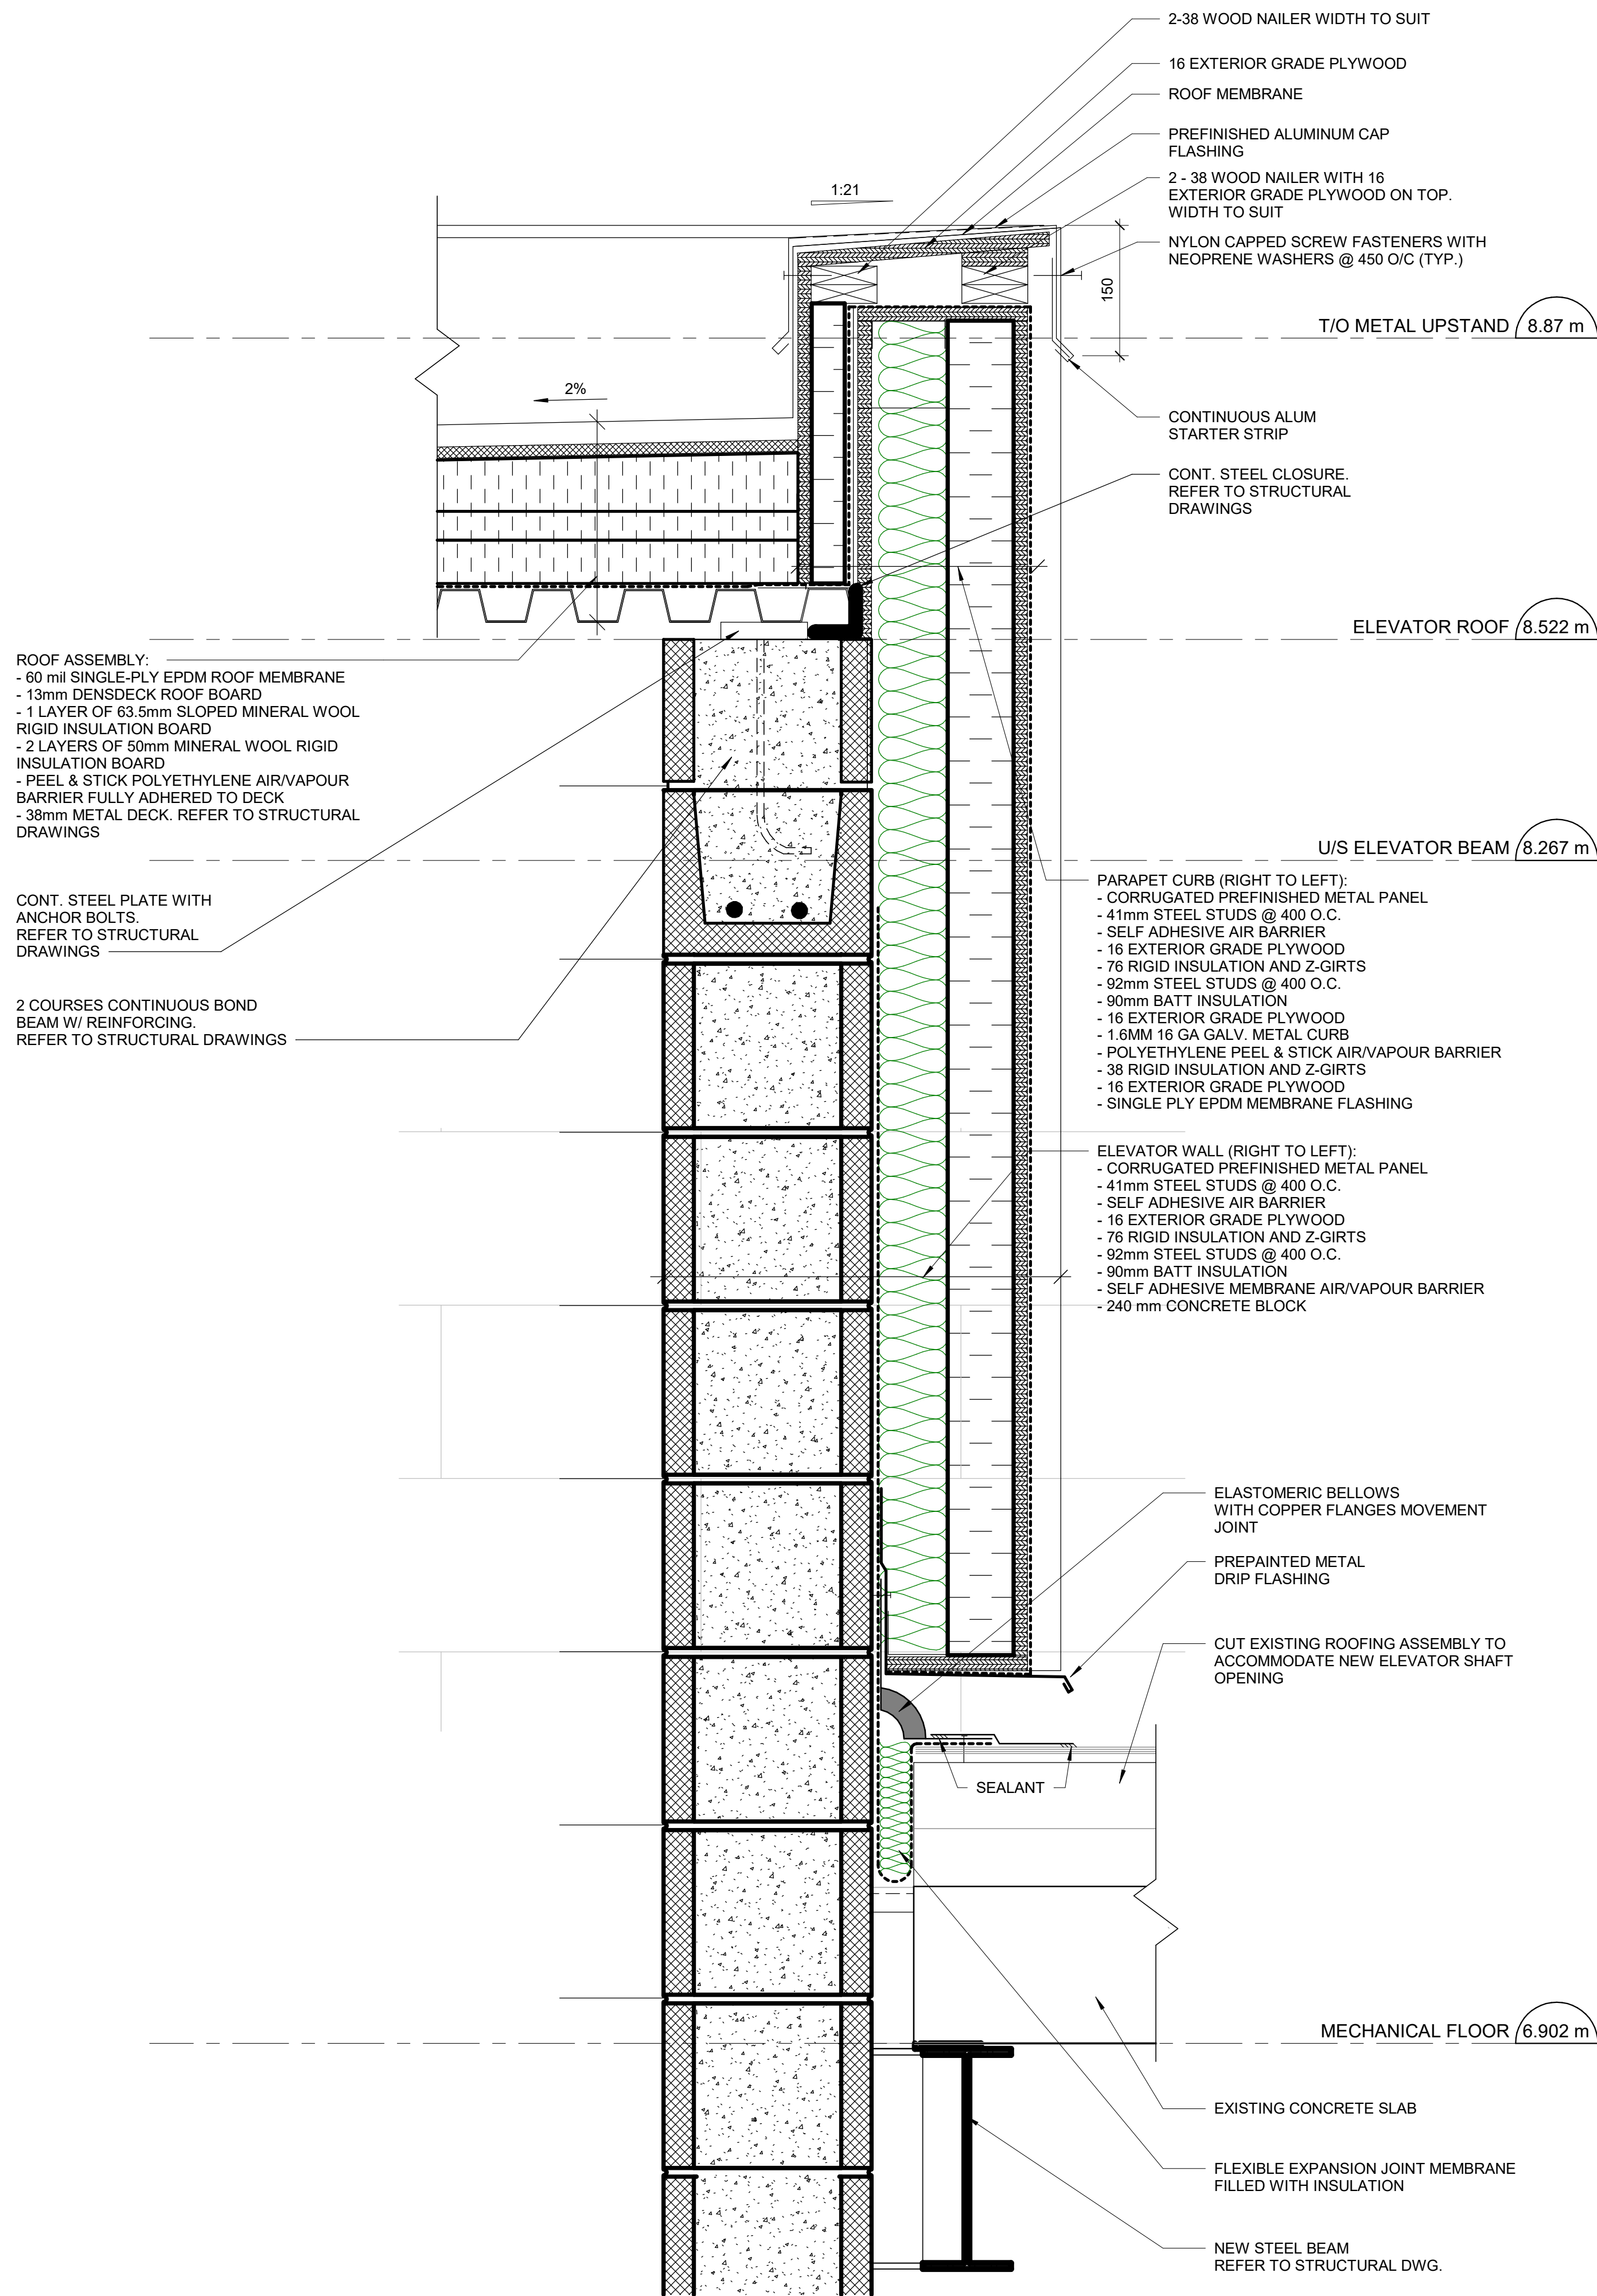
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DRAWN BY:
Author

CHECKED BY:
Checker

PROJECT MGR:
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APPROVED BY:
Approver

SHEET TITLE
ELEVATOR DETAILS

SHEET NUMBER

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4 JAMB DETAIL
A5815 Scale: 1 : 10



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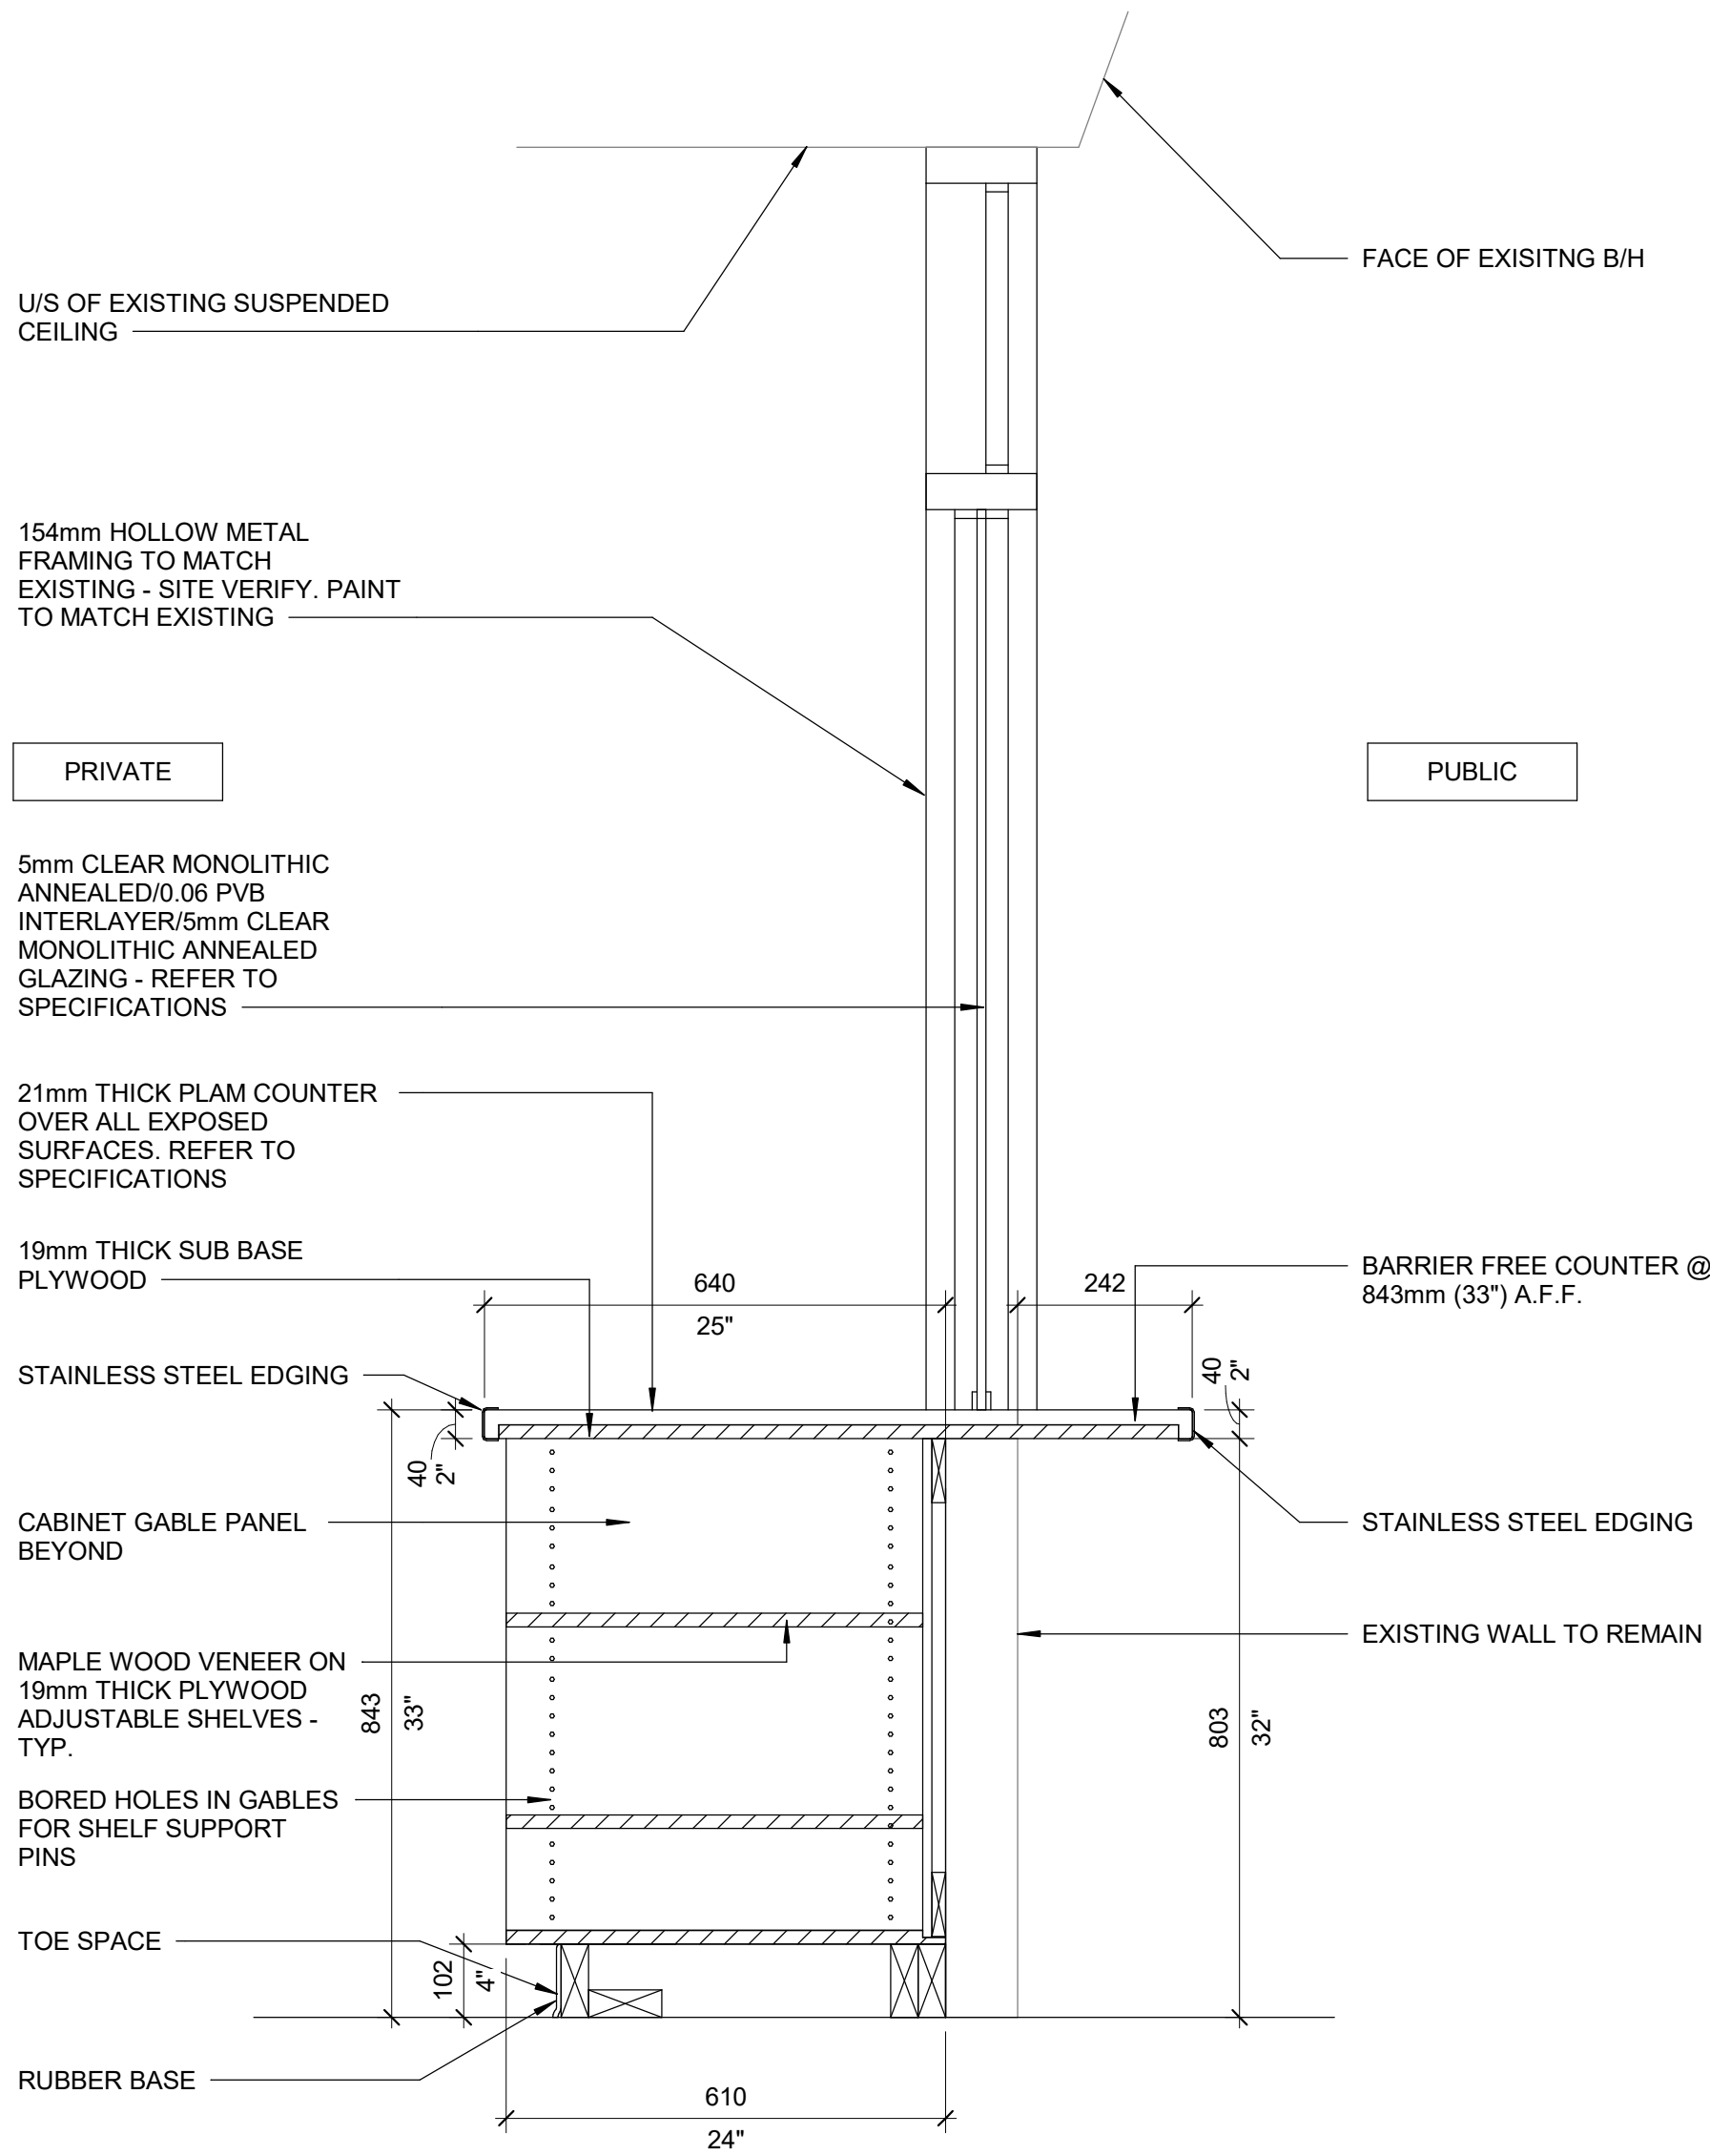
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DRAWN BY: A. Kvasniuk	CHECKED BY: K.Tilahun
PROJECT MGR: F. BOLOURIAN	APPROVED BY: E.Fenuta

SHEET TITLE
ELEVATOR DETAILS

SHEET NUMBER	ISSUE
G05-249-A5815	B





1 REREPTION AREA MILLWORK - SECTION
A5913 Scale: 1 : 10

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PROJECT NO:
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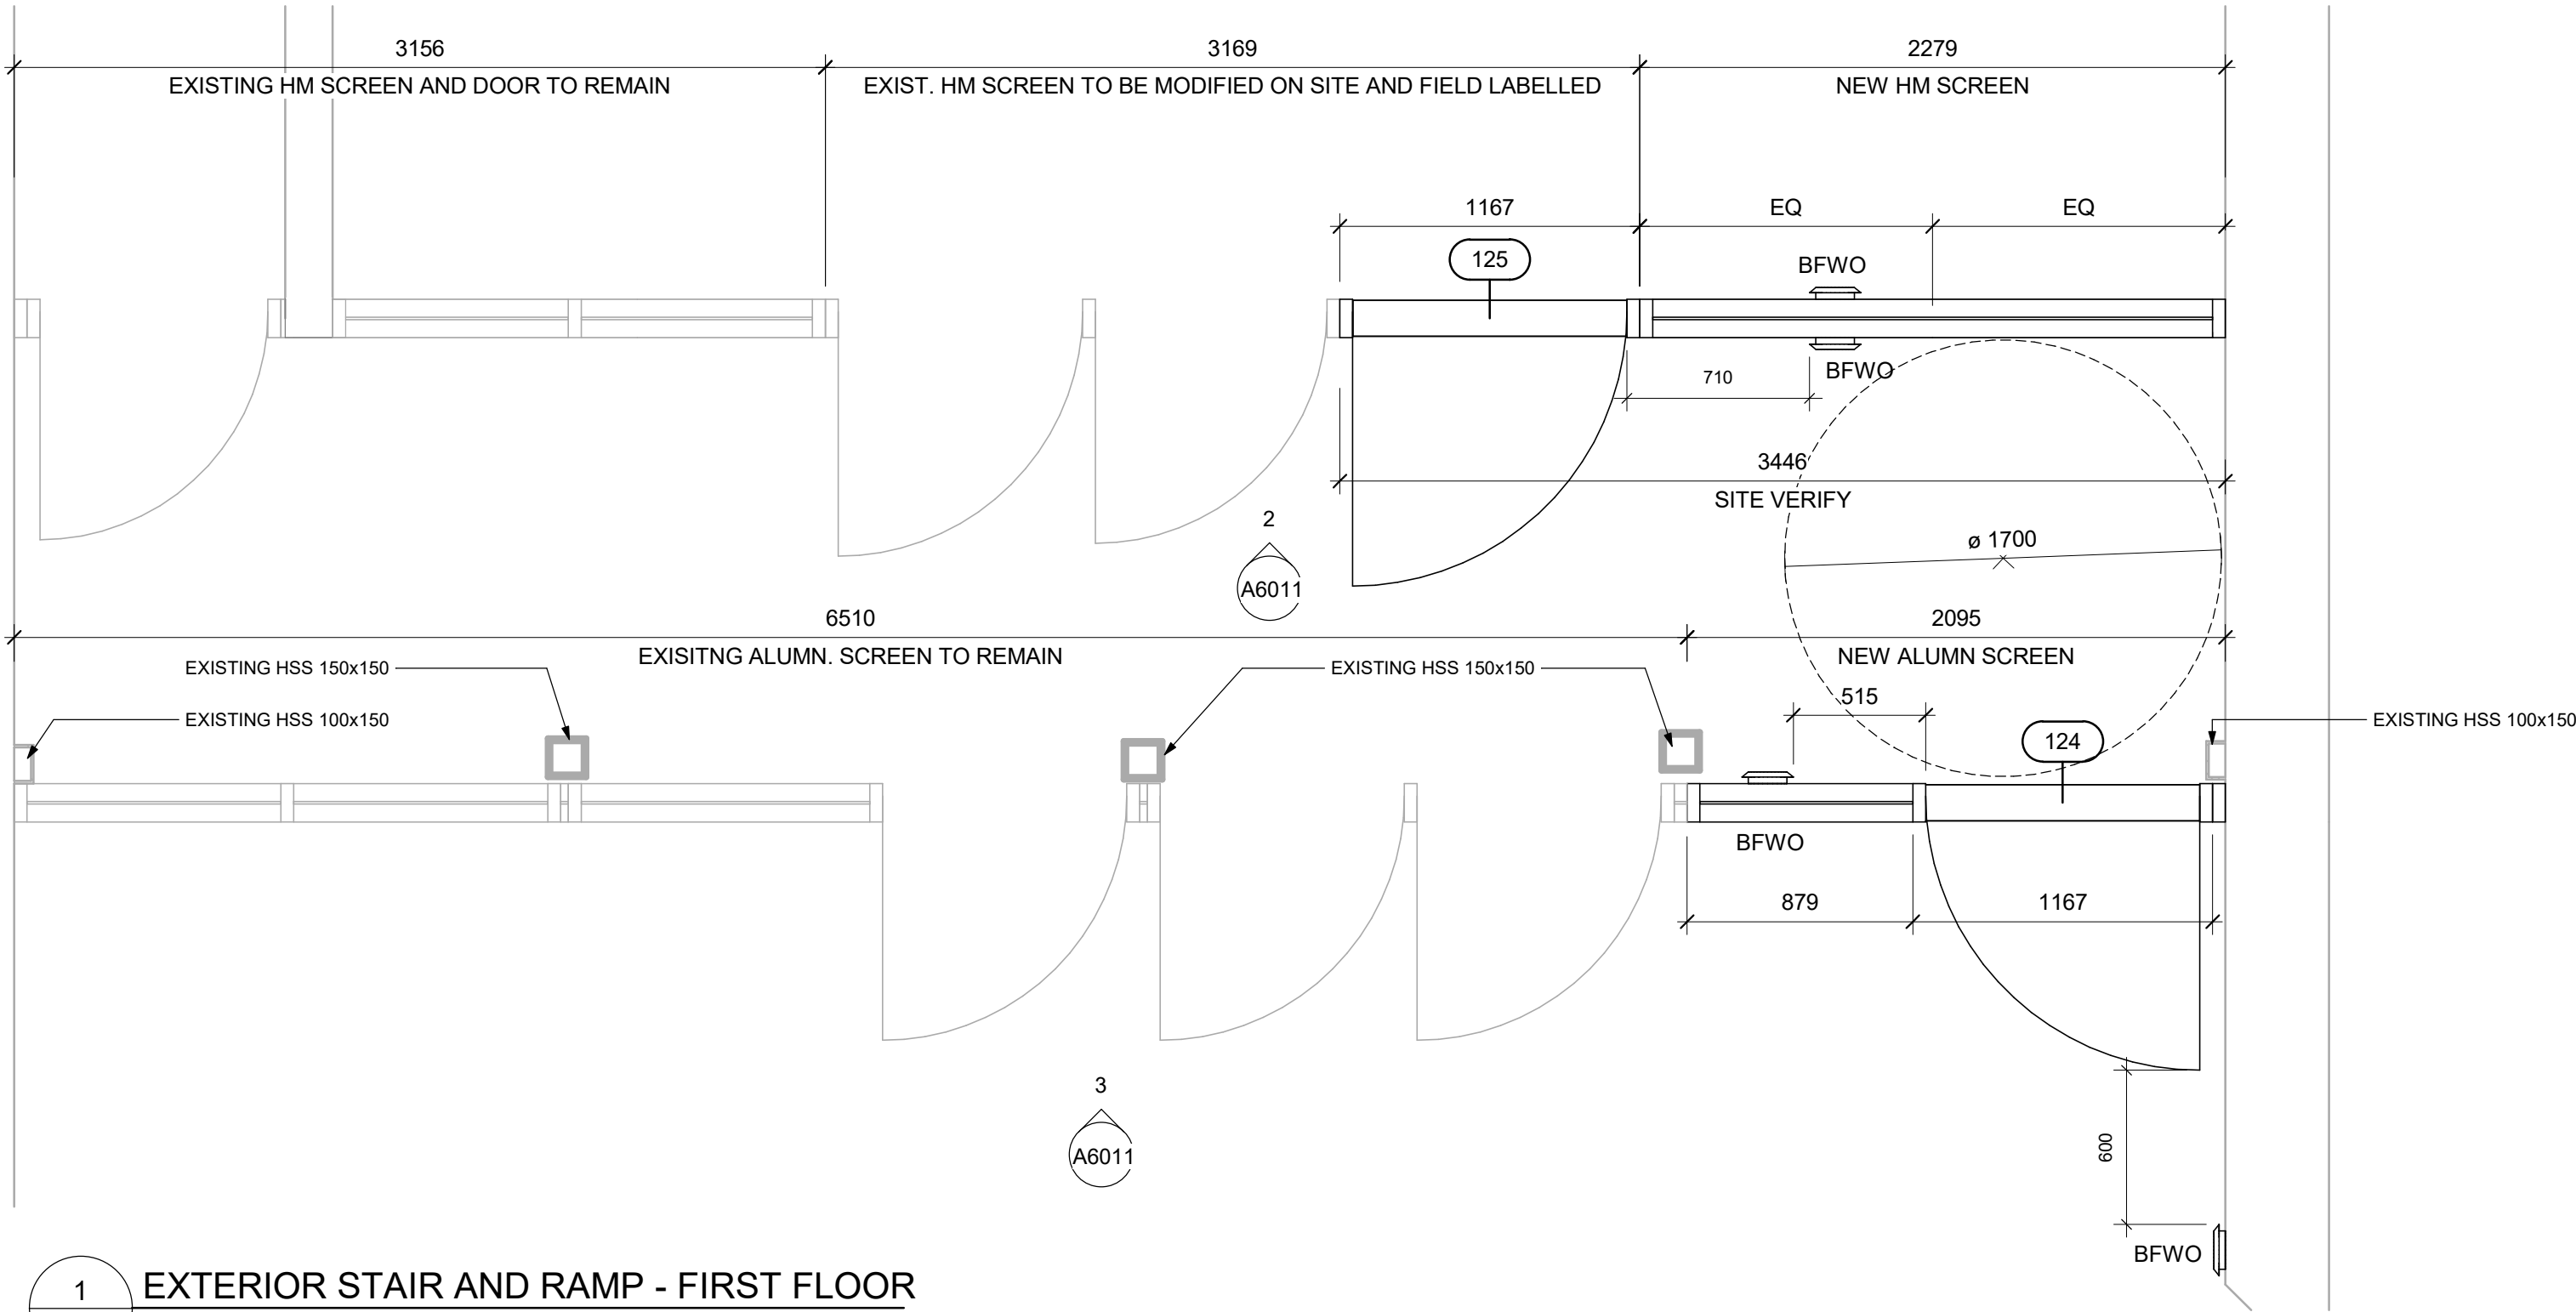
PROJECT MGR:
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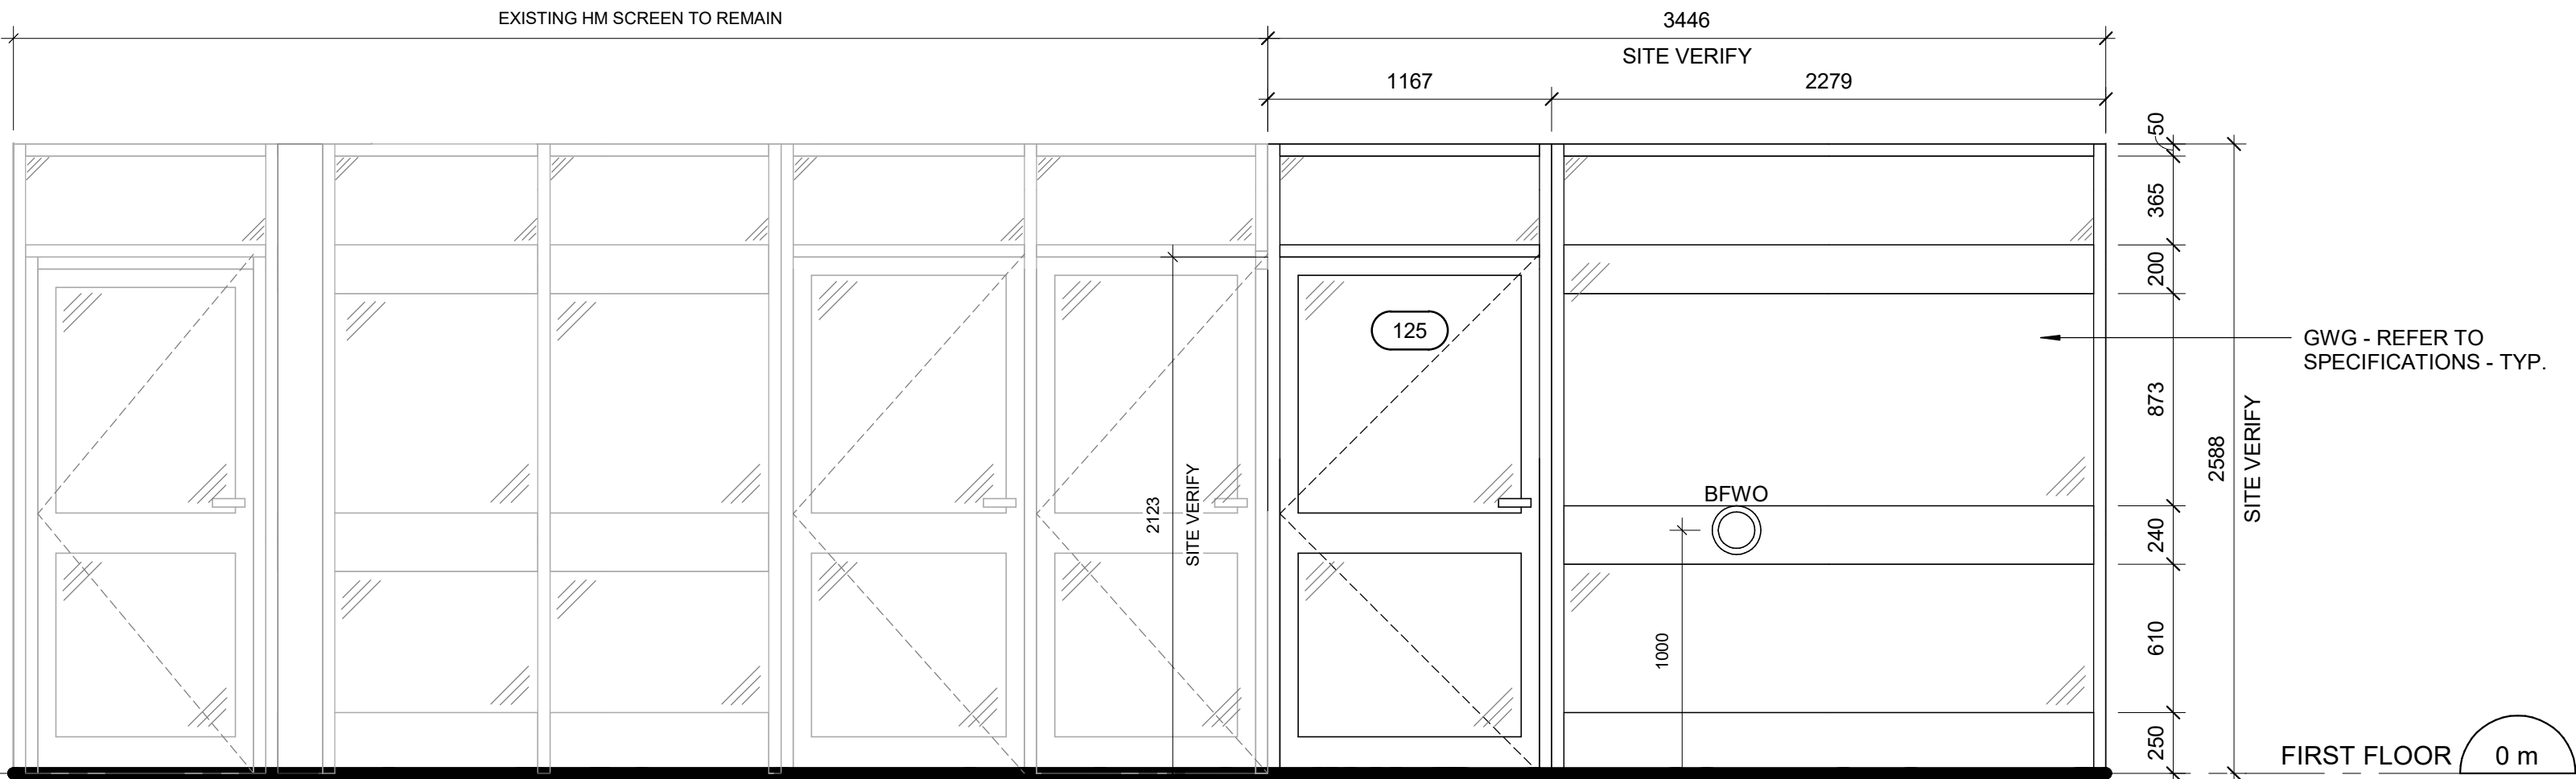
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DETAILS

SHEET NUMBER
G05-249-A5913


ISSUE
C



1 EXTERIOR STAIR AND RAMP - FIRST FLOOR
A6011 Scale: 1 : 25



2 ENTRANCE ELEVATION INTERIOR
A6011 Scale: 1 : 25

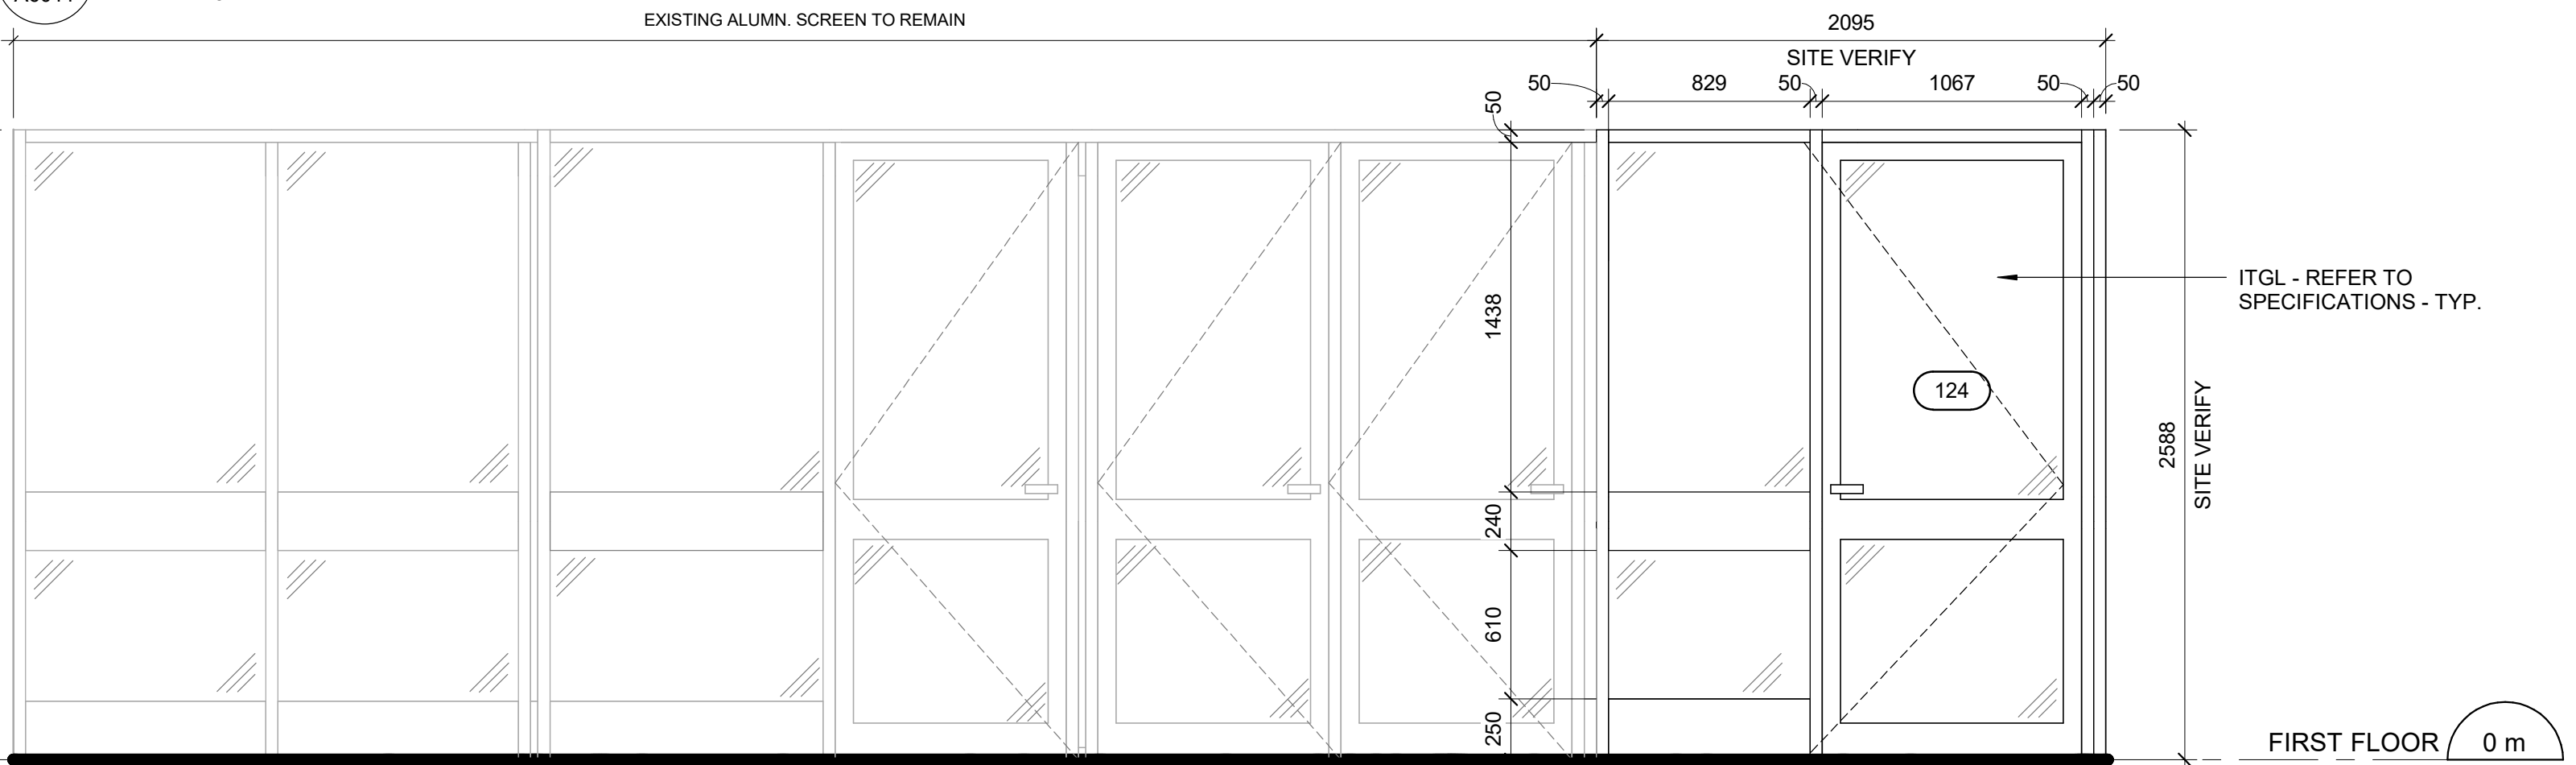

3 ENTRANCE ELEVATION EXTERIOR
A6011 Scale: 1 : 25

CONSTRUCTION KEY LEGEND

- EXISTING EXTERIOR WALL TO REMAIN
- EXISTING PARTITION TO REMAIN
- NEW EXTERIOR WALL
REFER TO WALL SCHEDULE
- NEW PARTITION
REFER TO PARTITION SCHEDULE
- EXISTING DOOR TO REMAIN
- NEW DOOR AND/ OR
NEW HARDWARE
- DASHED AREA INDICATES
AREA OF WORK

CONSTRUCTION GENERAL NOTES

- NEW DOOR CARD READER AND BARRIER FREE PUSH BUTTON TO BE COORDINATED WITH ELECTRICAL DRAWINGS FOR LOCATION AND HEIGHT INSTALLATION REFER TO ARCHITECTURAL DETAIL BOOKLET.
- REINSTALL ALL ELECTRICAL SWITCHES, RECEPTACLES, CARD READERS AND PULL STATIONS AT ACCESSIBLE HEIGHT AS IDENTIFIED IN THE ELECTRICAL DRAWINGS

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CHECKED BY:
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PROJECT MGR:
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APPROVED BY:
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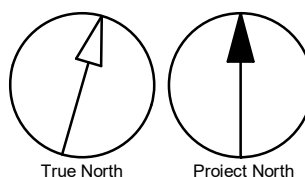
SHEET TITLE
**MAIN ENTRANCE - PLAN/
ELEVATIONS**

SHEET NUMBER

G05-249-A6011

ISSUE

D



ROOM FINISH SCHEDULE																			
ROOM NUMBER	ROOM NAME	FLOOR		BASE		NORTH				EAST		SOUTH		WEST		CEILING			NOTES
		MAT.	FIN.	MAT.	FIN.	MAT.	FIN.	MAT.	FIN.	MAT.	FIN.	MAT.	FIN.	MAT.	FIN.	HEIGHT			
BASEMENT																			
013	013	EXIST	EXIST	EXIST	EXIST	EXIST	PT-3	EXIST	PT-3	EXIST	PT-3	EXIST	PT-3	EXIST	PT-3	EXIST	EXIST	EXIST	REPAINT NEW STAIR GUARD AND HANDRAIL - PT-7
014	014	EXIST	EXIST	EXIST	EXIST	EXIST	PT-3	EXIST	PT-3	EXIST	PT-3	EXIST	PT-3	EXIST	PT-3	EXIST	EXIST	EXIST	
FIRST FLOOR																			
107	BARRIER FREE WASHROOM 1	EXIST	TF-1	EXIST	TF-1	EXIST, CMU	PT-3	EXIST, CMU	PT-3	EXIST	PT-3	EXIST	PT-3	EXIST	PT-3	EXIST	EXIST	EXIST	
109	109	EXIST	EXIST	EXIST, RB-1	PT-3	EXIST	EXIST	EXIST, GB	PT-3	EXIST	EXIST	EXIST	EXIST	EXIST	EXIST	EXIST	EXIST	EXIST	
111	111	EXIST	EXIST	EXIST, RB-1	PT-3	GB	PT-3, Q-1	EXIST	PT-3	EXIST	PT-3	EXIST	PT-3	EXIST	PT-3	EXIST	EXIST	EXIST	
112	112	EXIST	EXIST	EXIST, RB-1	PT-3	EXIST	PT-3	EXIST	PT-3	EXIST	EXIST	EXIST	EXIST	EXIST, GB	PT-3	EXIST	EXIST	EXIST	
113	113	EXIST	EXIST	EXIST	EXIST	EXIST	PT-3	EXIST	EXIST	EXIST	PT-3	EXIST	EXIST	EXIST	EXIST	EXIST	EXIST	EXIST	
114	114	EXIST	EXIST	EXIST	EXIST	EXIST	EXIST	EXIST	EXIST	EXIST	EXIST	EXIST	EXIST	EXIST	PT-3	EXIST	EXIST	EXIST	
115	115	EXIST	EXIST	EXIST	EXIST	EXIST	EXIST	EXIST	EXIST	EXIST	PT-3	EXIST	EXIST	EXIST	EXIST	EXIST	EXIST	EXIST	
118	BARRIER FREE WASHROOM 3	EXIST	PFT-1	CWT-4	CWT-4	EXIST	CWT-1, CWT-3, CWT-4	EXIST	CWT-1, CWT-3, CWT-4	EXIST, GB	CWT-1, CWT-3, CWT-4	EXIST	CWT-1, CWT-3, CWT-4	EXIST	CWT-1, CWT-3, CWT-4	GB	PT-2	2600	
119	BARRIER FREE WASHROOM 2	EXIST	PFT-1	CWT-4	CWT-4	EXIST	CWT-1, CWT-3, CWT-4	EXIST	CWT-1, CWT-3, CWT-4	EXIST, GB	CWT-1, CWT-3, CWT-4	EXIST	CWT-1, CWT-3, CWT-4	EXIST	CWT-1, CWT-3, CWT-4	GB	PT-2	2600	
120	120	EXIST	EXIST	EXIST	EXIST	EXIST	EXIST	EXIST	EXIST	EXIST	EXIST	EXIST	EXIST	EXIST	PT-3	EXIST	EXIST	EXIST	
121	121	EXIST	EXIST	EXIST	EXIST	EXIST	EXIST	EXIST	EXIST	EXIST	EXIST	EXIST	EXIST	EXIST	PT-3	EXIST	EXIST	EXIST	
122	122	EXIST	EXIST	EXIST	EXIST	EXIST	EXIST	EXIST	EXIST	EXIST	EXIST	EXIST	EXIST	EXIST	PT-3	EXIST	EXIST	EXIST	
123	123	EXIST	EXIST	EXIST	EXIST	EXIST	EXIST	EXIST	PT-3	EXIST	EXIST	EXIST	EXIST	EXIST	EXIST	EXIST	EXIST	EXIST	
130	130	EXIST	EXIST, TF-2	EXIST, TF-2	EXIST, TF-2	EXIST	PT-3	EXIST	PT-3	EXIST	PT-3	EXIST	PT-3	EXIST	EXIST	EXIST	EXIST	EXIST	
131	131	EXIST	EXIST	EXIST	EXIST	EXIST	EXIST	EXIST	EXIST	EXIST	PT-3	EXIST	PT-3	EXIST	EXIST	EXIST	EXIST	EXIST	
133	133	EXIST	EXIST	EXIST	EXIST	EXIST	PT-3	EXIST	PT-3	EXIST	PT-3	EXIST	PT-3	EXIST	PT-3	EXIST	EXIST	EXIST	REPAINT NEW STAIR GUARD AND HANDRAIL - PT-7
134	134	EXIST	EXIST	EXIST	EXIST	EXIST	PT-3	EXIST	PT-3	EXIST	PT-3	EXIST	PT-3	EXIST	PT-3	EXIST	EXIST	EXIST	REPAINT NEW STAIR GUARD AND HANDRAIL - PT-7
SECOND FLOOR																			
218	218	EXIST	EXIST	EXIST	EXIST	EXIST	PT-3	EXIST	PT-3	EXST	PT-3	EXIST	PT-3	EXIST	PT-3	EXIST	EXIST	EXIST	REPAINT NEW STAIR GUARD AND HANDRAIL - PT-7
219	219	EXIST	EXIST	EXIST	EXIST	EXIST	PT-3	EXIST	PT-3	EXIST	PT-3	EXIST	PT-3	EXIST	PT-3	EXIST	EXIST	EXIST	REPAINT NEW STAIR GUARD AND HANDRAIL - PT-7
THIRD FLOOR																			
301	301	EXIST	EXIST	EXIST	EXIST	EXIST	EXIST	EXIST	PT-3	EXIST	PT-3	EXIST	EXIST	EXIST	PT-3	EXIST	EXIST	EXIST	
303	303	EXIST	EXIST	EXIST	EXIST	EXIST	EXIST	EXIST	EXIST	EXIST	EXIST	EXIST	EXIST	EXIST	PT-3	EXIST	EXIST	EXIST	
311	UNIVERSAL WASHROOM	EXIST	PFT-1	CWT-4	CWT-4	EXIST	CWT-1, CWT-3, CWT-4	EXIST	CWT-1, CWT-3, CWT-4	EXIST	CWT-1, CWT-3, CWT-4	EXIST	CWT-1, CWT-3, CWT-4	EXIST	CWT-1, CWT-3, CWT-4	GB	PT-2	2600	
314	BARRIER FREE WASHROOM 4	EXIST	PFT-1	CWT-4	CWT-4	EXIST	CWT-1, CWT-3, CWT-4	EXIST	CWT-1, CWT-3, CWT-4	EXIST	CWT-1, CWT-3, CWT-4	EXIST	CWT-1, CWT-3, CWT-4	EXIST	CWT-1, CWT-3, CWT-4	GB	PT-2	2600	
315	315	EXIST	EXIST, TF-2	EXIST, TF-2	EXIST, TF-2	EXIST	PT-3	EXIST	PT-3	EXIST	EXIST	EXIST	EXIST	EXIST	PT-3	EXIST	EXIST	EXIST	
316	316	EXIST	EXIST	EXIST	EXIST	EXIST	EXIST	EXIST	EXIST	EXIST	EXIST	EXIST	EXIST	EXIST	PT-3	EXIST	EXIST	EXIST	
317	317	EXIST	EXIST	EXIST	EXIST	EXIST	EXIST	EXIST	PT-3	EXIST	EXIST	EXIST	EXIST	EXIST	PT-3	EXIST	EXIST	EXIST	
319	319	EXIST	EXIST	EXIST	EXIST	EXIST	EXIST	EXIST	EXIST	EXIST	EXIST	EXIST	EXIST	EXIST, GB	PT-3	EXIST	EXIST	EXIST	
320	320	EXIST	EXIST	EXIST	EXIST	EXIST	EXIST	EXIST	EXIST	EXIST	EXIST	EXIST	EXIST	EXIST	PT-3	EXIST	EXIST	EXIST	
321	321	EXIST	EXIST	EXIST	EXIST	EXIST	EXIST	EXIST	PT-3	EXIST	EXIST	EXIST	EXIST	EXIST	PT-3	EXIST	EXIST	EXIST	
322	322	EXIST	EXIST	EXIST	EXIST	EXIST	EXIST	EXIST	PT-3	EXIST	EXIST	EXIST	EXIST	EXIST	EXIST	EXIST	EXIST	EXIST	
330	330	EXIST	EXIST	EXIST	EXIST	EXIST	PT-3	EXIST	PT-3	EXIST	PT-3	EXIST	PT-3	EXIST	PT-3	EXIST	EXIST	EXIST	
331	331	EXIST	EXIST	EXIST	EXIST	EXIST	PT-3	EXIST	PT-3	EXIST	PT-3	EXIST	PT-3	EXIST	PT-3	EXIST	EXIST	EXIST	REPAINT NEW STAIR GUARD AND HANDRAIL - PT-7
332	332	EXIST	EXIST	EXIST	EXIST	EXIST, GB	PT-3	EXIST	EXIST	EXIST	EXIST	EXIST	PT-3	EXIST	EXIST	ACT	PREF	2660	REPAINT NEW STAIR GUARD AND HANDRAIL - PT-7

ROOM FINISH KEY SCHEDULE							
ABBRV	MATERIAL	COLOUR	FINISH	SIZE	REF	SUPPLIER	NOTES
CWT-1	CERAMIC WALL TILE	ARCTIC WHITE	MATTE	100mm X 400mm (4"X16")	COLOUR AND DIMENSIONS SERIES	OLYMPIA TILE	
CWT-3	CERAMIC WALL TILE	TAUPE	MATTE	100mm X 400mm (4"X16")	COLOUR AND DIMENSIONS SERIES	OLYMPIA TILE	ACCENT SHOWER TILE
CWT-4	CERAMIC WALL TILE	DARK GREY	MATTE	100mm X 400mm (4"X16")	COLOUR AND DIMENSIONS SERIES	OLYMPIA TILE	ACCENT SHOWER TILE
MAT-1	ANTI FATIGUE MATTING	EC20	SILVER	1000mm X 1800mm (40"X72")		FORBO	REQUEST NON-BEVELED EDGES
PFT-1	PORCELAIN FLOOR TILE	MICA	MATTE	300mm X 600 mm(12"X24")		D9/EMOTION	
PLAM-1	PLASTIC LAMINATE	ALABASTER D431	N/A	AS SPECIFIED IN DRAWINGS		WILSONART	CABINET MILWORKS UPPERS
PLAM-2	PLASTIC LAMINATE	SEA D90	N/A	AS SPECIFIED IN DRAWINGS		WILSONART NORTH	CABINET MILWORKS LOWERS
PT-2	PAINT	OC-64 PURE WHITE	FLAT	N/A		BENJAMIN MOORE	CEILINGS
PT-3	PAINT	MATCH EXISTING PAINT	TBD	N/A		BENJAMIN MOORE	GC TO PROVIDE SAMPLE ON 12"X12" CARD FOR APPROVAL. PAINT ENTIRE WALL OR CEILING AS SPECIFIED IN ROOM FINISH SCHEDULE.
PT-7	PAINT	HC-116 KENDALL CHARCOAL		N/A	N/AHISTORICAL COLOURS	BENJAMIN MOORE	
Q-1	QUARTZ	5151 EMPIRE WHITE	N/A	AS SPECIFIED IN DRAWINGS	SUPERNATURAL COLLECTION	CAESARSTONE	FOR BACKSPLASH AND COUNTERTOPS
RB-1	RUBBER WALL BASE	MATCH EXISTING	MATCH EXISTING	4" HIGH		JOHNSONITE	
TF-1	TERRAZZO FLOORING	SW10-1057TZ		AS SPECIFIED IN DRAWINGS	RESUFLOL TERRAZZO TG SYSTEM	SHERWIN-WILLIAMS	GC TO PROVIDE THREE SAMPLES TO BE APPROVED BY ARCHITECT PRIOR TO CONSTRUCTION
TF-2	TERRAZZO FLOORING	MATCH EXISTING	MATCH EXISTING	AS SPECIFIED IN DRAWINGS	RESUFLOL TERRAZZO TG SYSTEM	SHERWIN-WILLIAMS	GC TO PROVIDE THREE SAMPLES TO BE APPROVED BY ARCHITECT PRIOR TO CONSTRUCTION

CLIENT

CITY OF TORONTO



Corporate Real Estate Management
Project Management Office
Metro Hall Toronto, ON
M5V 3C6

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Arcadis Professional Services (Canada) Inc.

ISSUES

No.	DESCRIPTION	DATE
A	50% SUBMISSION	2021-11-19
B	90% SUBMISSION	2022-02-22
C	ISSUED FOR PERMIT	2022-03-18
D	ISSUED FOR TENDER	2025-04-11

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PRIME CONSULTANT



100 - 175 Galaxy Blvd,
Toronto, ON M9W 0C9, Canada
tel 416 679 1930
www.arcadis.com

PROJECT TITLE

CITY OF TORONTO
ACCESSIBILITY UPGRADES

PROJECT ADDRESS

POLICE NO. 33 DIVISION
50 UPJOHN RD

PROJECT NO:
9119-19-0162 / Arcadis 30279056

DRAWN BY:
A.Sunil

CHECKED BY:
K.Tilahun

PROJECT MGR:
F. BOLOURIAN

APPROVED BY:
E.Fenuta

SHEET TITLE

ROOM FINISH SCHEDULE

SHEET NUMBER

G05-249-A9001

ISSUE

D

DOOR SCHEDULE																	
DOOR NO.	LOCATION	DOOR	WIDTH	HEIGHT	THICKNESS	PANEL			FRAME		DOOR HARDWARE			FIRE RATING (MINUTES)	SIGN	REMARKS	
		TYPE				MAT.	FIN.	GLASS	MAT.	FIN.	SECURITY ACCESS CONTROL DEVICE	BFPB/BFWO/ BFAO	PANIC DEVICE				
BASEMENT																	
003	003	EXIST	EXIST	EXIST	EXIST	EXIST	PT-3	<-->	EXIST	PT-3				NA		EXIST. DOOR - REPLACE DOOR LATCHSET (REFER TO HARDWARE SCHEDULE)	
004	004	EXIST	EXIST	EXIST	EXIST	EXIST	PT-3	<-->	EXIST	PT-3				NA		EXIST. DOOR - REPLACE DOOR LATCHSET (REFER TO HARDWARE SCHEDULE)	
011	011	EXIST	EXIST	EXIST	EXIST	EXIST	PT-3	<-->	EXIST	PT-3				NA		EXIST. DOOR - REPLACE DOOR LATCHSET (REFER TO HARDWARE SCHEDULE)	
012	012	EXIST	EXIST	EXIST	EXIST	EXIST	PT-3	<-->	EXIST	PT-3				NA		EXIST. DOOR - REPLACE DOOR LATCHSET (REFER TO HARDWARE SCHEDULE)	
013	013	EXIST	EXIST	EXIST	EXIST	EXIST	PT-3	<-->	EXIST	PT-3				NA		EXIST. DOOR - REPLACE DOOR LATCHSET (REFER TO HARDWARE SCHEDULE)	
014	014	EXIST	EXIST	EXIST	EXIST	EXIST	PT-3	<-->	EXIST	PT-3				NA		EXIST. DOOR - REPLACE DOOR LATCHSET (REFER TO HARDWARE SCHEDULE)	
015	015	EXIST	EXIST	EXIST	EXIST	EXIST	PT-3	<-->	EXIST	PT-3				NA		EXIST. DOOR - REPLACE DOOR LATCHSET (REFER TO HARDWARE SCHEDULE)	
FIRST FLOOR																	
120	120	A	1067	2020	45	SCWD	PT-3	<-->	HM	PT-3				NA			
121	121	A	1067	2020	45	SCWD	PT-3	<-->	HM	PT-3				NA			
122	122	A	1067	2020	45	SCWD	PT-3	<-->	HM	PT-3				NA			
118	BARRIER FREE WASHROOM 3	A(L)	965	2135	45	HM	PT-3	<-->	HM	PT-3		*		NA			
119	BARRIER FREE WASHROOM 2	A(L)	965	2135	45	HM	PT-3	<-->	HM	PT-3		*		NA			
115	115	At	1067	2110	45	HM	PT-3	<-->	HM	PT-3				NA			
124	124	Ats	1067	2538	45	HM	PT-3	GWG	HM	PT-3			45			FIRE RATING OF MODIFIED HM MODIFIED SCREEN AND DOOR TO RECEIVE SITE FIRE LABEL	
125	125	Ats	1067	2073	45	IALUM	ANOD	ITGL	IALUM	ANOD		*		NA		ANODIZE FIN TO MATCH EXIST	
130B	130	B	965	2130	45	HM	PT-3	GWG	HM	PT-3				90			
131	131	B	1067	2120	45	HM	PT-3	TGL	HM	PT-3				90			
130	130	Bts	1067	2130	45	HM	PT-3	GWG	HM	PT-3	*	*		NA			
114B	114	C	1067	2120	45	HM	PT-3	TGL	HM	PT-3				NA			
125B	125	Ct	1067	2110	45	HM	PT-3	TGL	HM	PT-3	*			NA			
101	101	EXIST	EXIST	EXIST	EXIST	EXIST	PT-3	<-->	EXIST	PT-3				NA		EXIST. DOOR - REPLACE DOOR LATCHSET (REFER TO HARDWARE SCHEDULE)	
103	103	EXIST	EXIST	EXIST	EXIST	EXIST	PT-3	<-->	EXIST	PT-3				NA		EXIST. DOOR - REPLACE DOOR LATCHSET (REFER TO HARDWARE SCHEDULE)	
103A	103	EXIST	EXIST	EXIST	EXIST	EXIST	PT-3	<-->	EXIST	PT-3				NA		EXIST. DOOR - REPLACE DOOR LATCHSET (REFER TO HARDWARE SCHEDULE)	
104	104	EXIST	EXIST	EXIST	EXIST	EXIST	PT-3	<-->	EXIST	PT-3				NA		EXIST. DOOR - REPLACE DOOR LATCHSET (REFER TO HARDWARE SCHEDULE)	
110	110	EXIST	EXIST	EXIST	EXIST	EXIST	PT-3	<-->	EXIST	PT-3				NA		EXIST. DOOR - REPLACE DOOR LATCHSET (REFER TO HARDWARE SCHEDULE)	
113	113	EXIST	EXIST	EXIST	EXIST	EXIST	PT-3	<-->	EXIST	PT-3				NA		EXIST. DOOR - REPLACE DOOR LATCHSET (REFER TO HARDWARE SCHEDULE)	
114A	114	EXIST	EXIST	EXIST	EXIST	EXIST	PT-3	<-->	EXIST	PT-3				NA		EXIST. DOOR - REPLACE DOOR LATCHSET (REFER TO HARDWARE SCHEDULE)	
117	117	EXIST	EXIST	EXIST	EXIST	EXIST	PT-3	<-->	EXIST	PT-3				NA		EXIST. DOOR - REPLACE DOOR LATCHSET (REFER TO HARDWARE SCHEDULE)	
128	128	EXIST	EXIST	EXIST	EXIST	EXIST	PT-3	<-->	EXIST	PT-3				NA		EXIST. DOOR - REPLACE DOOR LATCHSET (REFER TO HARDWARE SCHEDULE)	
SECOND FLOOR																	
201	201	EXIST	EXIST	EXIST	EXIST	EXIST	PT-3	<-->	EXIST	PT-3				NA		EXIST. DOOR - REPLACE DOOR LATCHSET (REFER TO HARDWARE SCHEDULE)	
202	202	EXIST	EXIST	EXIST	EXIST	EXIST	PT-3	<-->	EXIST	PT-3				NA		EXIST. DOOR - REPLACE DOOR LATCHSET (REFER TO HARDWARE SCHEDULE)	
208	208	EXIST	EXIST	EXIST	EXIST	EXIST	PT-3	<-->	EXIST	PT-3				NA		EXIST. DOOR - REPLACE DOOR LATCHSET (REFER TO HARDWARE SCHEDULE)	
214	214	EXIST	EXIST	EXIST	EXIST	EXIST	PT-3	<-->	EXIST	PT-3				NA		EXIST. DOOR - REPLACE DOOR LATCHSET (REFER TO HARDWARE SCHEDULE)	
217	217	EXIST	EXIST	EXIST	EXIST	EXIST	PT-3	<-->	EXIST	PT-3				NA		EXIST. DOOR - REPLACE DOOR LATCHSET (REFER TO HARDWARE SCHEDULE)	
218	218	EXIST	EXIST	EXIST	EXIST	EXIST	PT-3	GWG	EXIST	PT-3				90		EXIST. DOOR - REPLACE DOOR LATCHSET (REFER TO HARDWARE SCHEDULE)	
THIRD FLOOR																	
310	UNIVERSAL WASHROOM	A	965	2120	45	SCWD	PT-3	<-->	HM	PT-3		*		NA			
313	BARRIER FREE WASHROOM 4	A	965	2120	45	SCWD	PT-3	<-->	HM	PT-3		*		NA			
317	317	A	1067	2110	45	HM	PT-3	<-->	HM	PT-3				NA			
321B	321	A	1067	2130	45	SCWD	PT-3	<-->	HM	PT-3				NA			
324	315	AA(L)	762	2135	45	HM	PT-3	<-->	HM	PT-3				NA			
303	303	At	1067	2110	45	SCWD	VNR-1	TGL	HM	PT-3		*		NA		SHOULD NOT BE LOCKABLE	
321A	321	At	1067	2120	45	SCWD	PT-3	TGL	HM	PT-3		*		NA			
315	315	Ats	1067	2110	45	SCWD	PT-3	GWG	HM	PT-3				NA			
320	320	Ats	1067	2135	45	SCWD	PT-3	GWG	HM	PT-3				NA			
302	302	EXIST	EXIST	EXIST	EXIST	EXIST	PT-3	<-->	EXIST	PT-3				NA		EXIST. DOOR - REPLACE DOOR LATCHSET (REFER TO HARDWARE SCHEDULE)	
306	306	EXIST	EXIST	EXIST	EXIST	EXIST	PT-3	<-->	EXIST	PT-3				NA		EXIST. DOOR - REPLACE DOOR LATCHSET (REFER TO HARDWARE SCHEDULE)	
307	307	EXIST	EXIST	EXIST	EXIST	EXIST	PT-3	<-->	EXIST	PT-3				NA		EXIST. DOOR - REPLACE DOOR LATCHSET (REFER TO HARDWARE SCHEDULE)	
309	309	EXIST	EXIST	EXIST	EXIST	EXIST	PT-3	<-->	HM	PT-3				NA		EXIST. DOOR - REPLACE DOOR LATCHSET (REFER TO HARDWARE SCHEDULE)	
312	315	EXIST	EXIST	EXIST	EXIST	EXIST	PT-3	<-->	EXIST	PT-3				NA		EXIST. DOOR - REPLACE DOOR LATCHSET (REFER TO HARDWARE SCHEDULE)	
316	316	EXIST	EXIST	EXIST	EXIST	EXIST	PT-3	<-->	EXIST	PT-3				NA		EXIST. DOOR - REPLACE DOOR LATCHSET (REFER TO HARDWARE SCHEDULE)	
318	318	EXIST	EXIST	EXIST	EXIST	EXIST	PT-3	<-->	EXIST	PT-3				NA		EXIST. DOOR - REPLACE DOOR LATCHSET (REFER TO HARDWARE SCHEDULE)	
322	322	EXIST	EXIST	EXIST	EXIST	EXIST	PT-3	<-->	EXIST	PT-3				NA		EXIST. DOOR - REPLACE DOOR LATCHSET (REFER TO HARDWARE SCHEDULE)	
322A	322	EXIST	EXIST	EXIST	EXIST	EXIST	PT-3	<-->	EXIST	PT-3				NA		EXIST. DOOR - REPLACE DOOR LATCHSET (REFER TO HARDWARE SCHEDULE)	
330	330	EXIST	EXIST	EXIST	EXIST	EXIST	PT-3	<-->	EXIST	PT-3				NA		EXIST. DOOR - REPLACE DOOR LATCHSET (REFER TO HARDWARE SCHEDULE)	
331	331	EXIST	EXIST	EXIST	EXIST	EXIST	PT-3	<-->	EXIST	PT-3				NA		EXIST. DOOR - REPLACE DOOR LATCHSET (REFER TO HARDWARE SCHEDULE)	

DOOR SCHEDULE GENERAL NOTES	
1	DOOR HEIGHT IS FOR INFO ONLY DOOR HEIGHT TO MATCH EXISTING DOOR HEIGHT AND IS TO BE SITE MEASURED.
2	REFER TO ELECTRICAL DRAWINGS FOR DOOR CARD READER LOCATION ON EXISTING DOORS.
3	REFER TO DOOR HARDWARE SCHEDULE AND TO THE SPECIFICATIONS FOR A COMPLETE SET OF DOOR HARDWARE.

DOOR ABBREVIATIONS	
*	DENOTES YES
ALUM	ALUMINUM
ANOD	ANODIZED
BFAO	BARRIER-FREE AUTOMATIC OPENER
BFPB	BARRIER-FREE PUSH BUTTON
BFWO	BARRIER-FREE WAVE TO OPEN
CR	CARD READER
EXIST	EXISTING
FBM	FINGER BIOMETRIC
GWG	GEORGIAN WIRE GLASS
HM	HOLLOW METAL
IALUM	INSULATED ALUMINUM
IHM	INSULATED HOLLOW METAL
ITGL	INSULATED TEMPERED (SAFETY) GLASS
KP	KEY PAD
OEM	OCULAR BIOMETRIC
PF	PRE FINISHED
PLAM	PLASTIC LAMINATE
PT	PAINT
SIM	SIMILAR
SS	STAINLESS STEEL
TGL	TEMPERED GLASS
WD	WOOD

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
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Arcadis Professional Services (Canada) Inc.		
ISSUES		
No.	DESCRIPTION	DATE
A	90% SUBMISSION	2022-02-22
B	ISSUED FOR PERMIT	2022-03-18
C	ISSUED FOR TENDER	2025-04-11

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PRIME CONSULTANT



100 - 175 Galaxy Blvd,
Toronto, ON M9W 0C9, Canada
tel 416 679 1930
www.arcadis.com

PROJECT TITLE

CITY OF TORONTO
ACCESSIBILITY UPGRADES

PROJECT ADDRESS

POLICE NO. 33 DIVISION
50 UPJOHN RD

PROJECT NO:
9119-19-0162 / Arcadis 30279056

DRAWN BY:
A. Kvasniuk

CHECKED BY:
K.Tilahun

PROJECT MGR:
F. BOLOURIAN

APPROVED BY:
E.Fenuta

SHEET TITLE

DOOR SCHEDULE

SHEET NUMBER

G05-249-A9111

ISSUE

C

Note:
Refer to technical drawing D1901 - Typical Toronto Police Service Standards, for signage requirements

CONSTRUCTION KEY LEGEND

EXISTING EXTERIOR WALL TO REMAIN

EXISTING PARTITION TO REMAIN

NEW EXTERIOR WALL
REFER TO WALL SCHEDULE

NEW PARTITION
REFER TO PARTITION SCHEDULE

EXISTING DOOR TO REMAIN

NEW DOOR AND/ OR
NEW HARDWARE

DASHED AREA INDICATES
AREA OF WORK

CONSTRUCTION GENERAL NOTES

1

NEW DOOR CARD READER AND BARRIER FREE PUSH BUTTON - REFER TO ELECTRICAL DRAWINGS. FOR LOCATION AND HEIGHT INSTALLATION REFER TO ARCHITECTURAL DETAIL BOOKLET.

2

REPAINT ENTIRE WALL AFTER WALL-MOUNTED HANDRAIL REPLACEMENT - UNLESS OTHERWISE NOTED. COLOUR AND FINISH TO MATCH EXISTING

CONSTRUCTION KEY NOTES

NO


DESCRIPTION

I

INSTALL HANDRAIL WARNING STRIP - REFER TO DETAIL 8/D1405 AND 10/D1405.

J

EXISTING DOOR TO REMAIN. DOOR HARDWARE TO BE CHANGED AS PER DOOR SCHEDULE ON A9001 AND DOOR HARDWARE SCHEDULE IN THE SPECIFICATIONS.

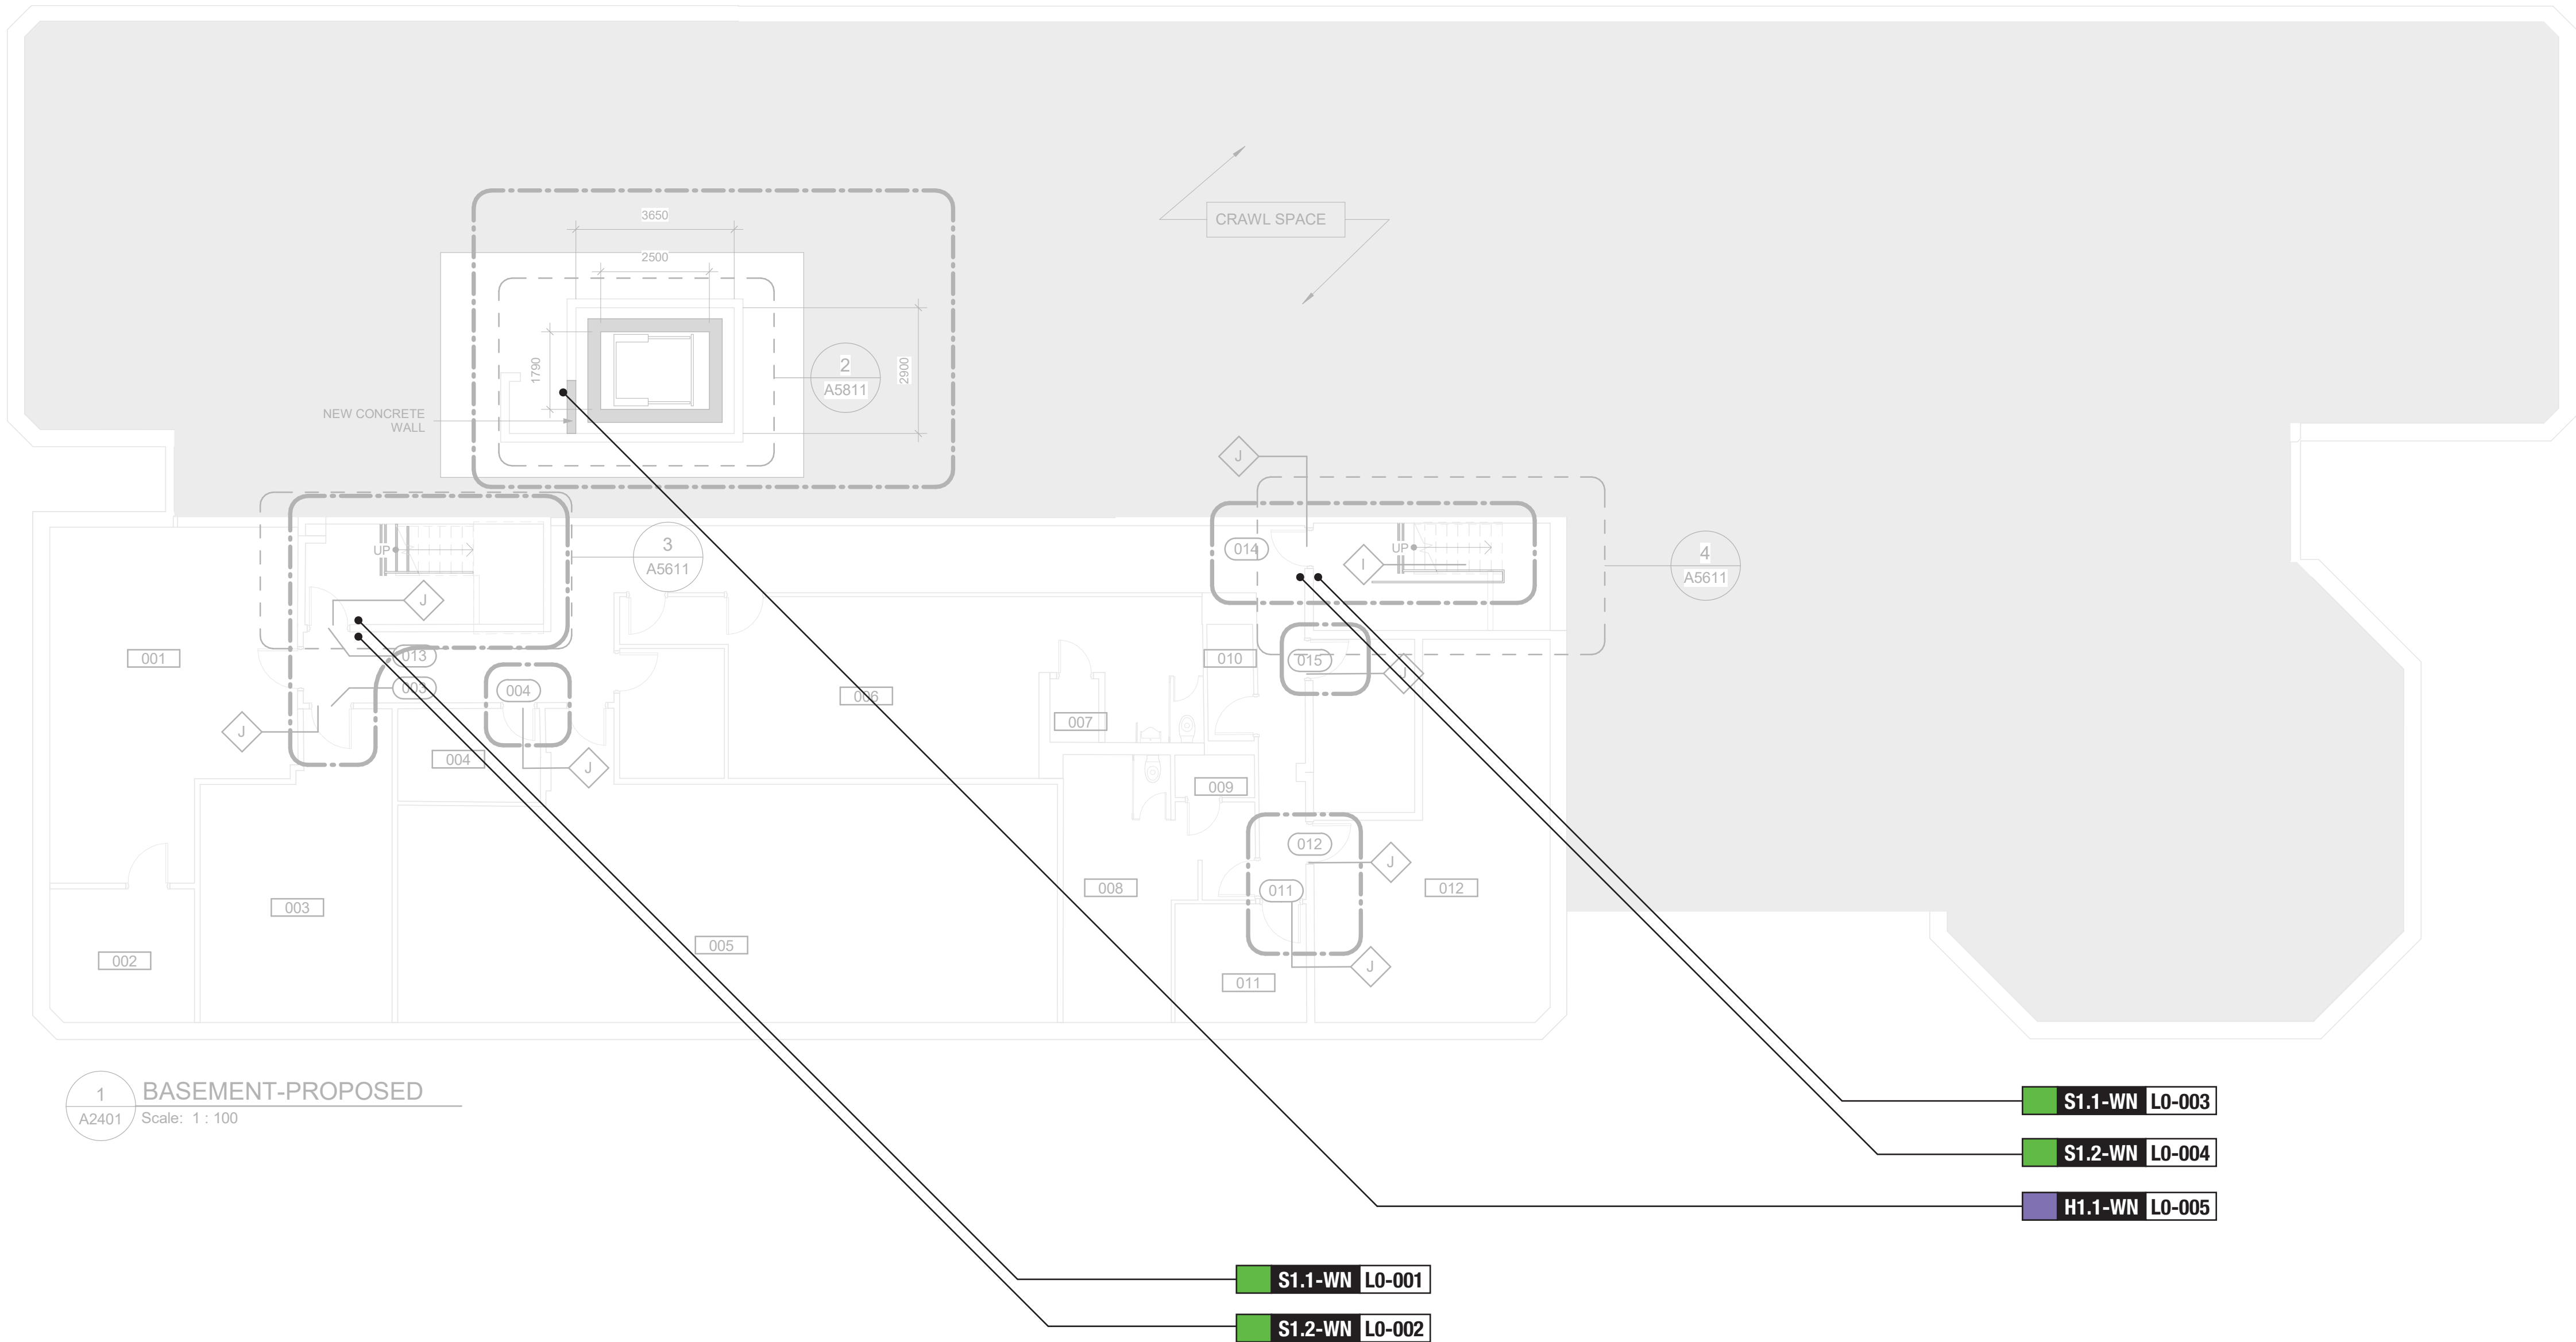

1 BASEMENT-PROPOSED
A2401 Scale: 1 : 100

SIGN TAG LEGEND

Signtype Colour

Signtype

EX
LO
L1
L2
L3

Exterior
Basement
Level 1
Level 2
Level 3

Specific Sign Location

A1.1-WN

L1-000

Powered:
Y Yes
N No
D Data

Mounting Style:
P Projecting
S Suspended
F Freestanding
W Wall-mounted

G Glass
C Column
D Door
T Transom

SIGN TAG LEGEND

B

LX-000

Directional

H

LX-000

Amenity

G

LX-000

Inside Stair ID

E

LX-000

Room ID

J


LX-000

Entrance

S

LX-000

Stair ID

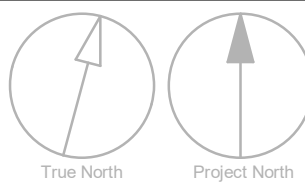

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TORONTO, ON
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ISSUES

No.	DESCRIPTION	DATE
A	ISSUED FOR TENDER	2022-04-08

CONSULTANTS

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33 Harbour Square, Suite 202
Toronto, Canada M5J 2G2

SEAL

PRIME CONSULTANT

100 - 175 Galaxy Blvd.
Toronto, ON M6H 0C3, Canada
tel 416 679 1930
www.arcadis.com

PROJECT TITLE

CITY OF TORONTO
ACCESSIBILITY UPGRADES

PROJECT ADDRESS

POLICE STATION NO. 33
50 UPJOHN ROAD

PROJECT NO:
9119 - 19 - 0162 / IBI 122260

DRAWN BY:
M.LOW

CHECKED BY:
C.D. SCHNOBB

PROJECT MGR:
R. DALY

APPROVED BY:

SHEET TITLE

SIGNAGE & WAYFINDING
DETAILS
LEVEL B LOCATION PLAN

SHEET NUMBER

G05-999-A8000

ISSUE

A

Note:
Refer to technical drawing D1901 - Typical Toronto Police Service Standards, for signage requirements

CONSTRUCTION KEY LEGEND

- EXISTING EXTERIOR WALL TO REMAIN
- EXISTING PARTITION TO REMAIN
- NEW EXTERIOR WALL
REFER TO WALL SCHEDULE
- NEW PARTITION
REFER TO PARTITION SCHEDULE
- EXISTING DOOR TO REMAIN
- NEW DOOR AND/ OR
NEW HARDWARE
- DASHED AREA INDICATES
AREA OF WORK


CONSTRUCTION GENERAL NOTES

- 1 NEW DOOR CARD READER AND BARRIER FREE PUSH BUTTON - REFER TO ELECTRICAL DRAWINGS. FOR LOCATION AND HEIGHT INSTALLATION REFER TO ARCHITECTURAL DETAIL BOOKLET.
- 2 REPAINT ENTIRE WALL AFTER WALL-MOUNTED HANDRAIL REPLACEMENT - UNLESS OTHERWISE NOTED. COLOUR AND FINISH TO MATCH EXISTING

CONSTRUCTION KEY NOTES

- | NO | DESCRIPTION |
|----|---|
| A | INSTALL TACTILE ATTENTION INDICATOR AND TACTILE WARNING STRIP - REFER TO TYPICAL DETAILS 1/D1402 AND 1/D1405. |
| B | INSTALL COLOUR AND TEXTURE NOSING STRIP - REFER TO TYPICAL DETAIL 1/D1402. |
| C | INSTALL NEW GUARDRAIL AND HANDRAIL - REFER TO TYPICAL DETAILS 1/D1401, 2/D1401, 3/D1401, 1/D1403, 5/D1401 AND 6/D1404. |
| D | INSTALL NEW WASHROOM ACCESSORIES - REFER TO DETAILS 1/D1201, 2/D1201, 3/D1201, 4/D1201, 5/D1201. |
| E | CONSTRUCT NEW KITCHEN MILLWORK. REFER TO MILLWORK DETAILS 1/D1301, 2/D1301, 3/D1301, 4/D1301, 1/D1302, 2/D1302, 3/D1302, 4/1302, 5/D1302, 6/D1302, 7/D1302, 8/D1302 AND 3/D1303. |
| J | EXISTING DOOR TO REMAIN. DOOR HARDWARE TO BE CHANGED AS PER DOOR SCHEDULE ON A9001 AND DOOR HARDWARE SCHEDULE IN THE SPECIFICATIONS. |
| K | INSTALL NEW DOOR AND FRAME. REFER TO DOOR SCHEDULE A9001, G1004 AND DOOR HARDWARE SCHEDULE IN THE SPECIFICATIONS. |
| O | INSTALL NEW CURTAIN WALL OR STORE FRONT FRAMING TO MATCH EXISTING, WITH NEW DOOR PER SPECIFIED WIDTH AND HEIGHT. REFER TO DOOR SCHEDULE A9001 AND DOOR HARDWARE SCHEDULE IN THE SPECIFICATIONS. |

SIGN TAG LEGEND

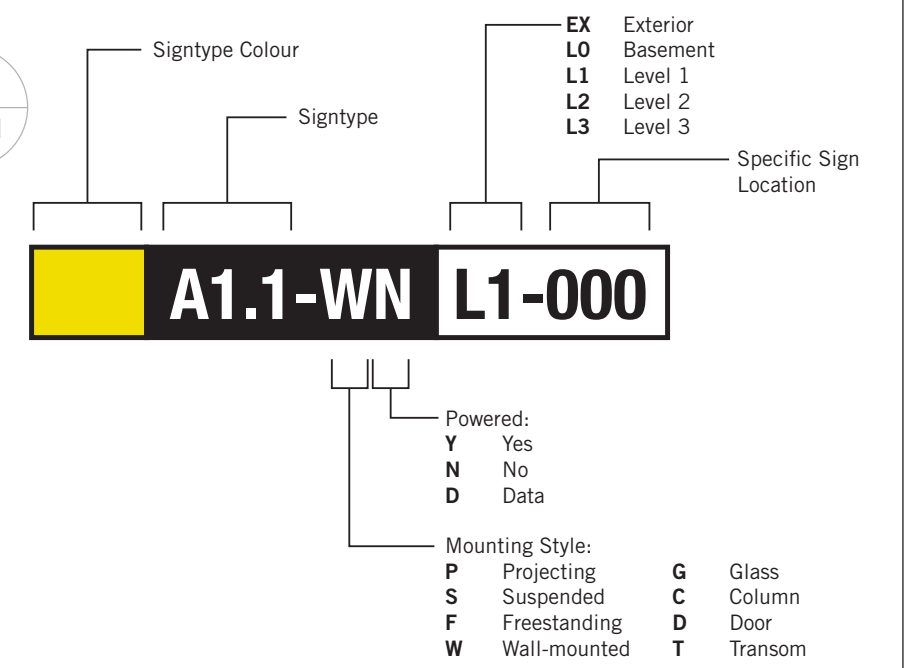

SIGN TAG LEGEND

- | | | |
|-----------------------------|--------------------------|---------------------------------|
| B LX-000 Directional | H LX-000 Amenity | G LX-000 Inside Stair ID |
| E LX-000 Room ID | J LX-000 Entrance | S LX-000 Stair ID |

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CITY OF TORONTO



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No.	DESCRIPTION	DATE
A	ISSUED FOR TENDER	2022-04-08

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ENTRO
33 Harbour Square, Suite 202
Toronto, Canada M5J 2G2

SEAL

PRIME CONSULTANT

ARCADIS

100 - 175 Galaxy Blvd.
Toronto, ON M6H 0C3, Canada
tel 416 679 1930
www.arcadis.com

PROJECT TITLE

CITY OF TORONTO
ACCESSIBILITY UPGRADES

PROJECT ADDRESS

POLICE STATION NO. 33
50 UPJOHN ROAD

PROJECT NO:
9119 - 19 - 0162 / IBI 122260

DRAWN BY:

M. LOW

CHECKED BY:

C.D. SCHNOBB

PROJECT MGR:

R. DALY

APPROVED BY:

SHEET TITLE

SIGNAGE & WAYFINDING
DETAILS
LEVEL 1 LOCATION PLAN

SHEET NUMBER

G05-999-A8010

ISSUE

A

Note:
Refer to technical drawing D1901 - Typical Toronto Police Service Standards, for signage requirements

CONSTRUCTION KEY LEGEND

EXISTING EXTERIOR WALL TO REMAIN

EXISTING PARTITION TO REMAIN

NEW EXTERIOR WALL
REFER TO WALL SCHEDULE

NEW PARTITION
REFER TO PARTITION SCHEDULE

EXISTING DOOR TO REMAIN

NEW DOOR AND/ OR
NEW HARDWARE

DASHED AREA INDICATES
AREA OF WORK

CONSTRUCTION GENERAL NOTES

1

NEW DOOR CARD READER AND BARRIER FREE PUSH BUTTON - REFER TO ELECTRICAL DRAWINGS. FOR LOCATION AND HEIGHT INSTALLATION REFER TO ARCHITECTURAL DETAIL BOOKLET.

2

REPAINT ENTIRE WALL AFTER WALL-MOUNTED HANDRAIL REPLACEMENT - UNLESS OTHERWISE NOTED. COLOUR AND FINISH TO MATCH EXISTING

CONSTRUCTION KEY NOTES

NO


DESCRIPTION

I


INSTALL HANDRAIL WARNING STRIP - REFER TO DETAIL 8/D1405 AND 10/D1405.

J

EXISTING DOOR TO REMAIN. DOOR HARDWARE TO BE CHANGED AS PER DOOR SCHEDULE ON A9001 AND DOOR HARDWARE SCHEDULE IN THE SPECIFICATIONS.

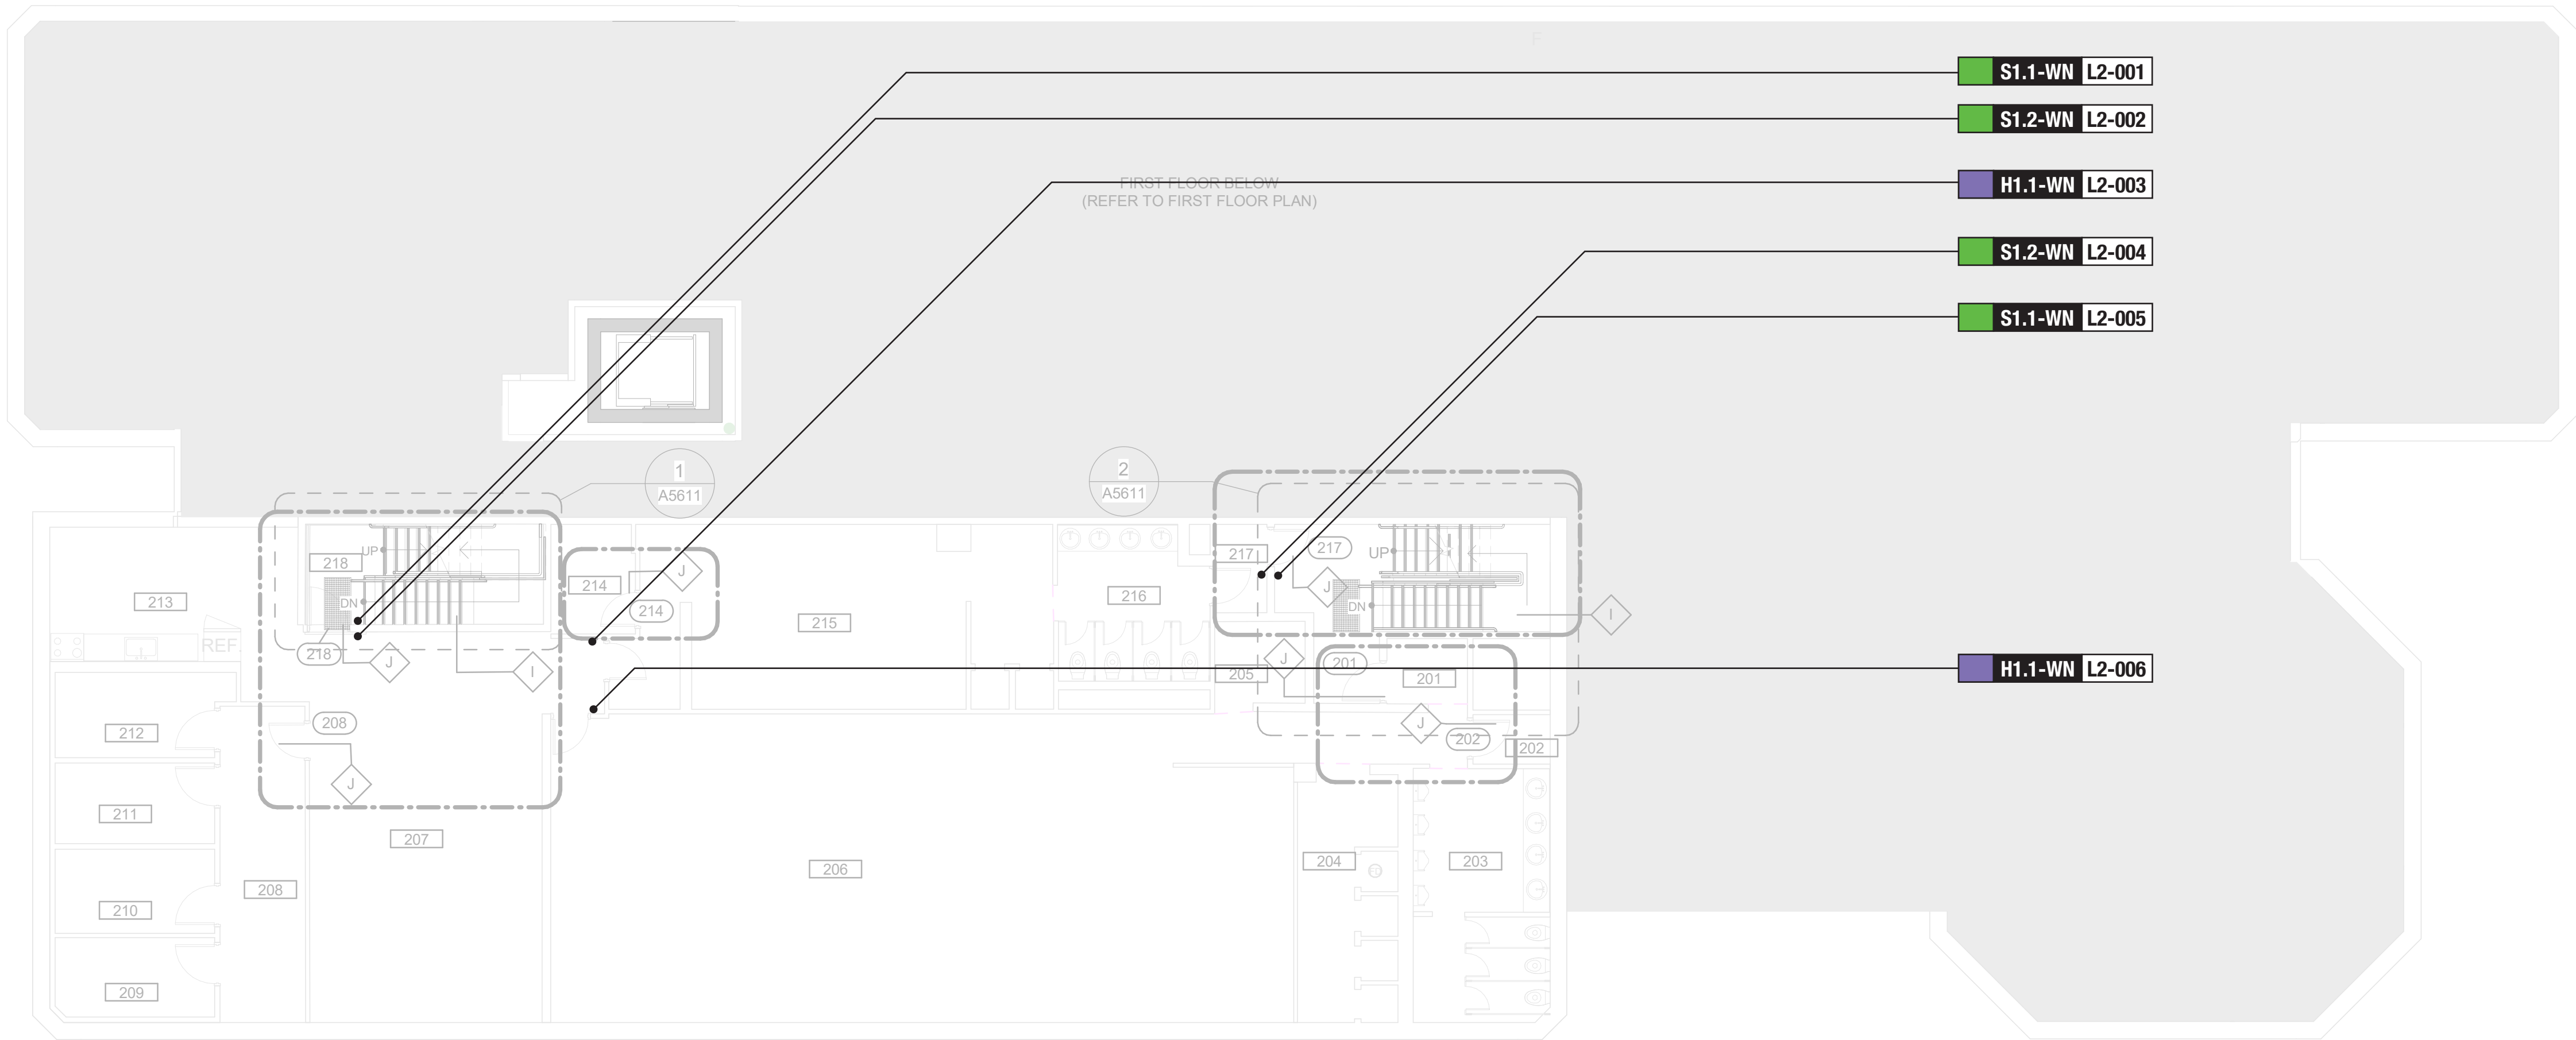

1 SECOND FLOOR-PROPOSED
A2421 Scale: 1 : 100

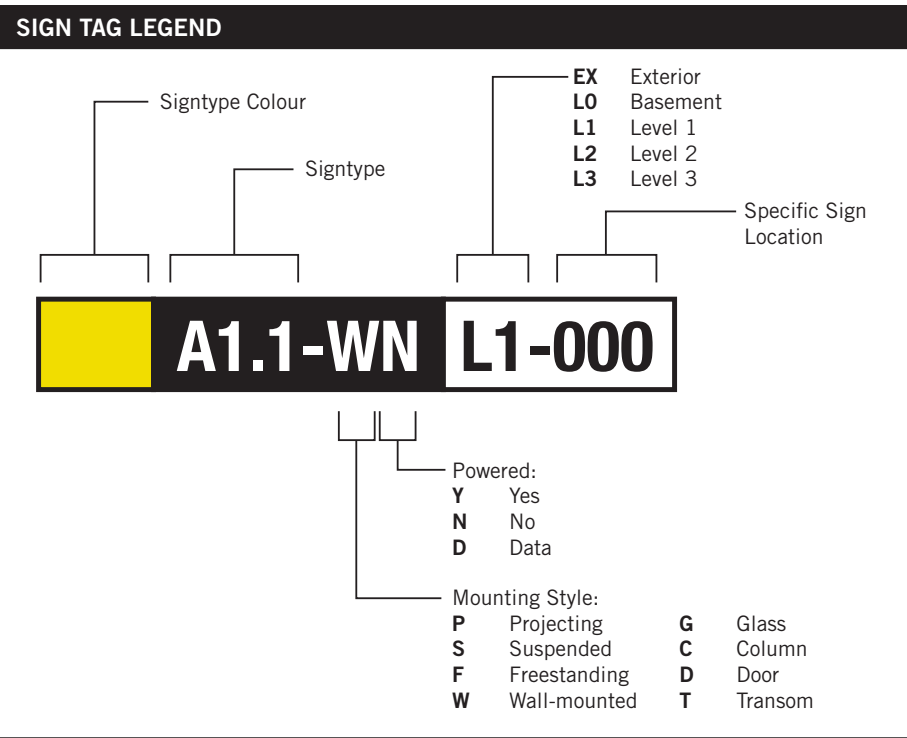

SIGN TAG LEGEND			
<div><div>B</div><div>LX-000</div></div>	Directional	<div><div>H</div><div>LX-000</div></div>	Amenity
<div><div>E</div><div>LX-000</div></div>	Room ID	<div><div>J</div><div>LX-000</div></div>	Entrance
<div><div>G</div><div>LX-000</div></div>	Inside Stair ID	<div><div>S</div><div>LX-000</div></div>	Stair ID

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No.	DESCRIPTION	DATE
A	ISSUED FOR TENDER	2022-04-08

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tel 416 679 1930
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PROJECT TITLE

CITY OF TORONTO
ACCESSIBILITY UPGRADES

PROJECT ADDRESS

POLICE STATION NO. 33
50 UPJOHN ROAD

PROJECT NO:
9119 - 19 - 0162 / IBI 122260

DRAWN BY:
M.LOW

CHECKED BY:
C.D. SCHNOBB

PROJECT MGR:
R. DALY

APPROVED BY:

SHEET TITLE

SIGNAGE & WAYFINDING
DETAILS
LEVEL 2 LOCATION PLAN


SHEET NUMBER

G05-999-A8020

ISSUE

A

Note:
Refer to technical drawing D1901 - Typical Toronto Police Service Standards, for signage requirements

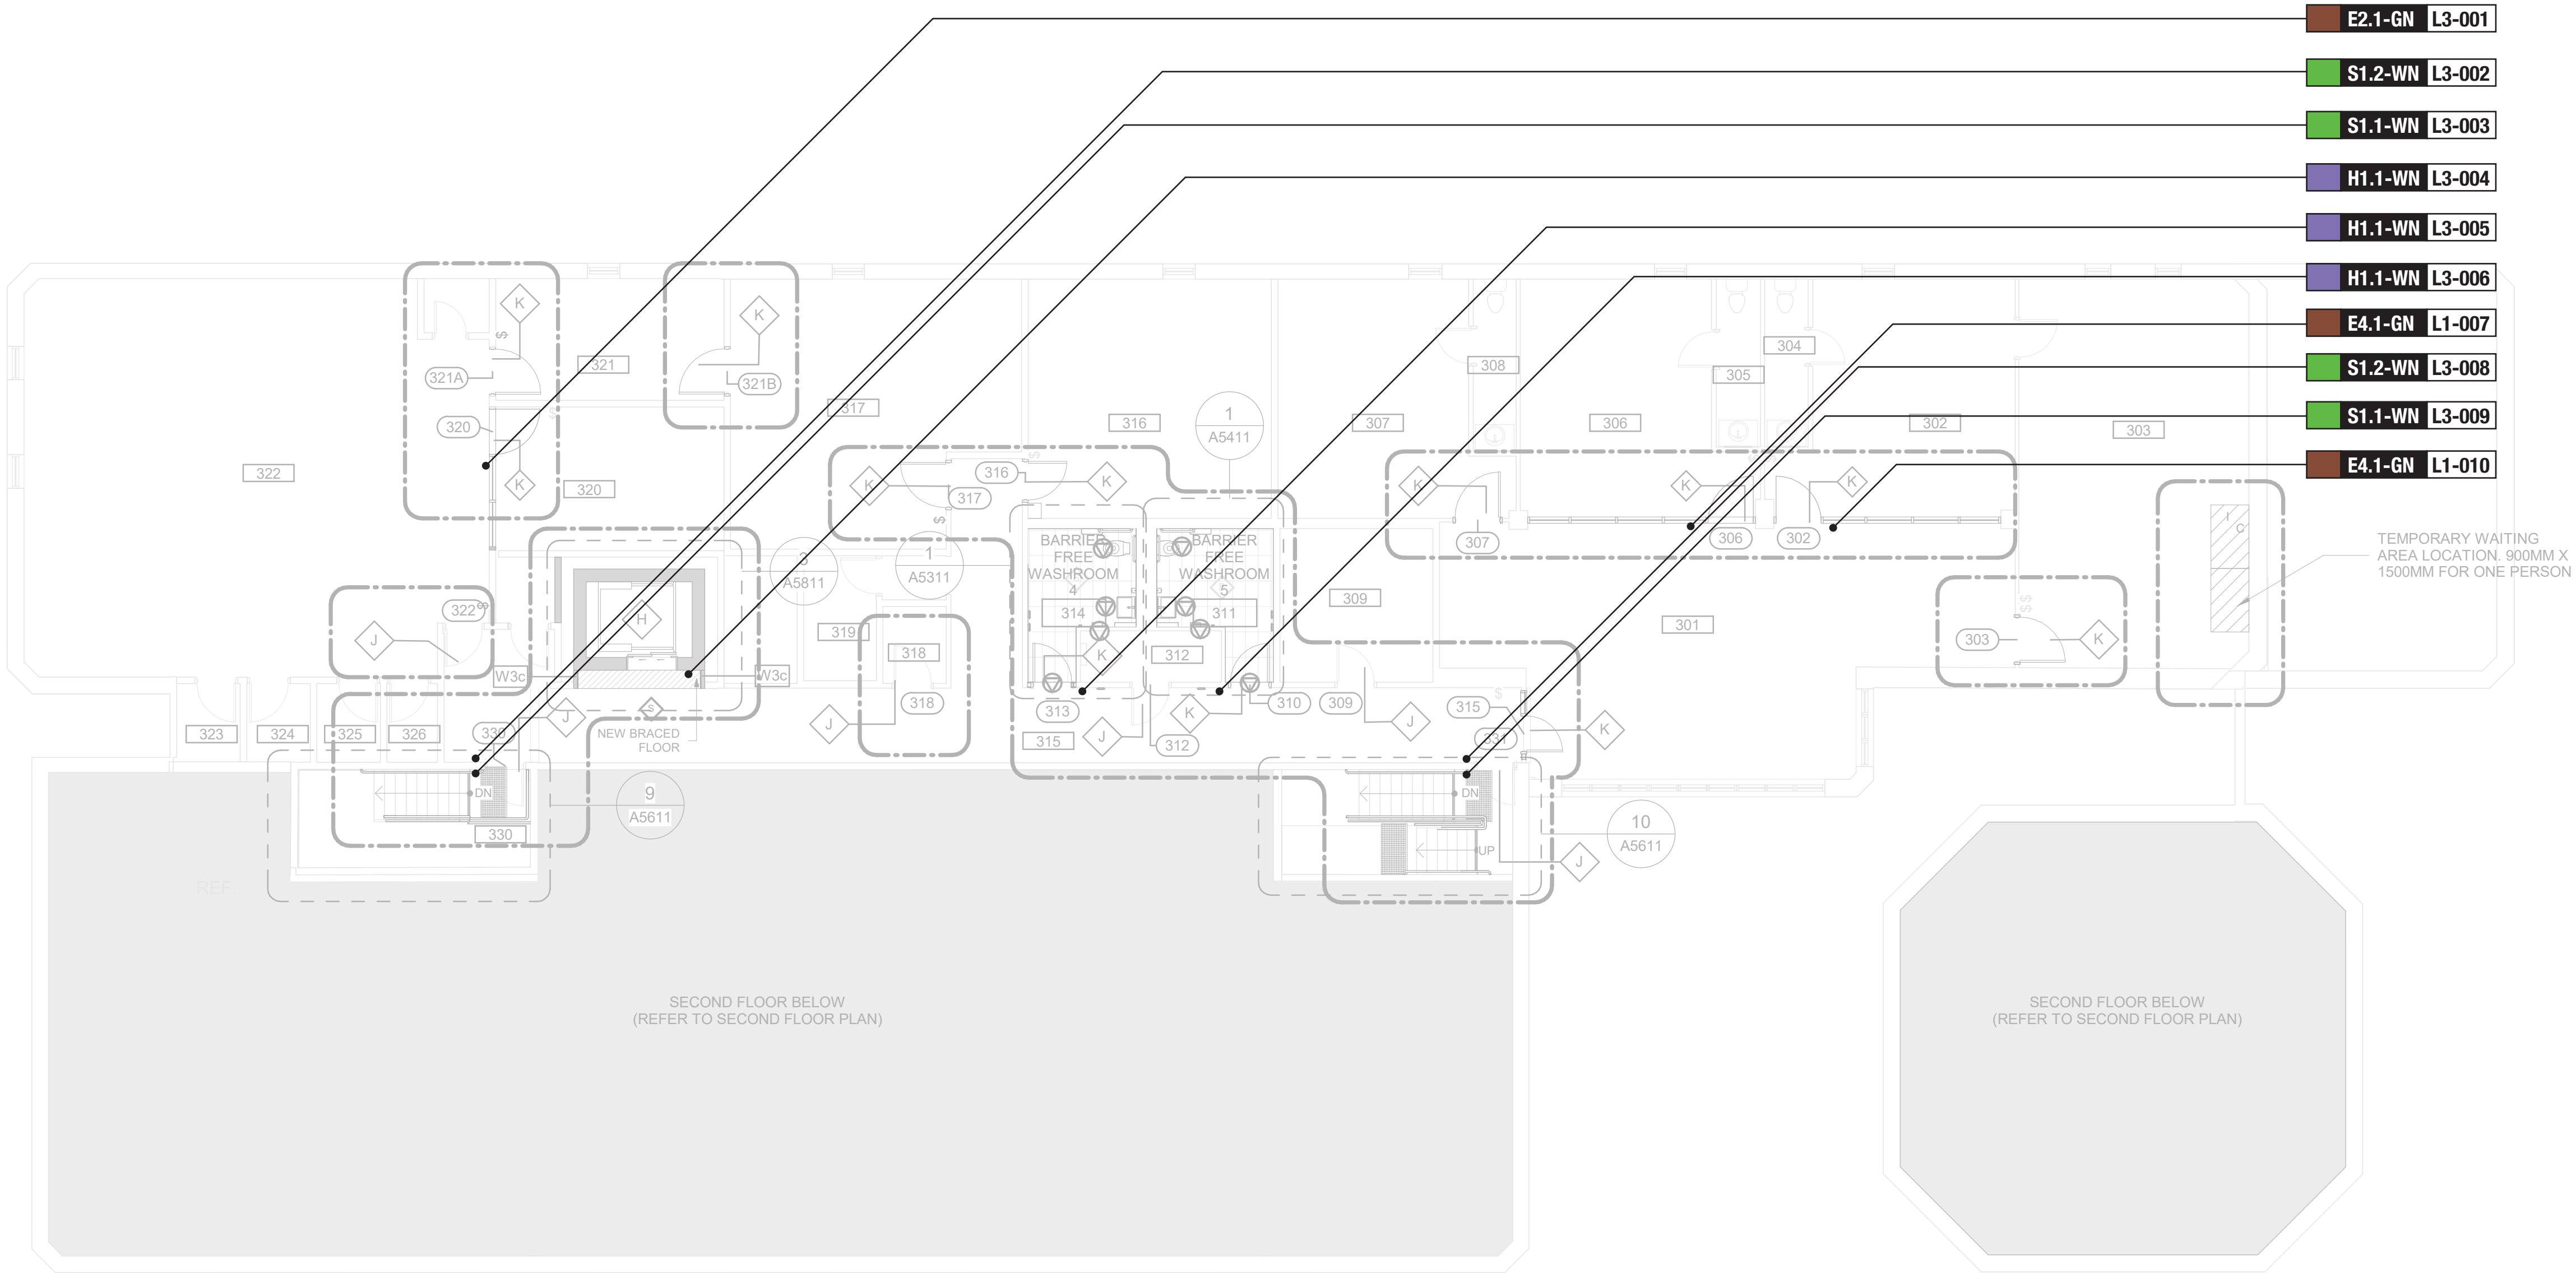

1 THIRD FLOOR-PROPOSED
A2431 Scale: 1 : 100

CONSTRUCTION KEY LEGEND

EXISTING EXTERIOR WALL TO REMAIN

EXISTING PARTITION TO REMAIN

###

CONSTRUCTION GENERAL NOTES

1

NEW DOOR CARD READER AND BARRIER FREE PUSH BUTTON - REFER TO ELECTRICAL DRAWINGS. FOR LOCATION AND HEIGHT INSTALLATION REFER TO ARCHITECTURAL DETAIL BOOKLET.

2

REPAINT ENTIRE WALL AFTER WALL-MOUNTED HANDRAIL REPLACEMENT - UNLESS OTHERWISE NOTED. COLOUR AND FINISH TO MATCH EXISTING

CONSTRUCTION KEY NOTES

NO	DESCRIPTION
H	INSTALL NEW ELEVATOR CONTROLS AND INTERIOR CABIN - REFER TO TYPICAL DETAIL 1/D1602, 2/D1602, 3/D1603 AND 4/D1604.
J	EXISTING DOOR TO REMAIN. DOOR HARDWARE TO BE CHANGED AS PER DOOR SCHEDULE ON A9001 AND DOOR HARDWARE SCHEDULE IN THE SPECIFICATIONS.
K	INSTALL NEW DOOR AND FRAME. REFER TO DOOR SCHEDULE A9001, G1004 AND DOOR HARDWARE SCHEDULE IN THE SPECIFICATIONS.

SIGN TAG LEGEND

B

LX-000

Directional

E

LX-000

Room ID

H

LX-000

Amenity

J

LX-000

Entrance

G

LX-000

Inside Stair ID

S

LX-000

Stair ID

SIGN TAG LEGEND

Signtype Colour

Signtype

Signtype Location

Specific Sign Location

Powered:
Y Yes
N No
D Data

Mounting Style:
P Projecting
S Suspended
F Freestanding
W Wall-mounted

EX Exterior
LO Basement
L1 Level 1
L2 Level 2
L3 Level 3

G Glass
C Column
D Door
T Transom

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No.	DESCRIPTION	DATE
A	ISSUED FOR TENDER	2022-04-08

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Toronto, ON M5H 0C3, Canada
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PROJECT TITLE

CITY OF TORONTO
ACCESSIBILITY UPGRADES

PROJECT ADDRESS

POLICE STATION NO. 33
50 UPJOHN ROAD

PROJECT NO:
9119 - 19 - 0162 / IBI 122260

DRAWN BY:
M.LOW

CHECKED BY:
C.D. SCHNOBB

PROJECT MGR:
R. DALY

APPROVED BY:

SHEET TITLE

SIGNAGE & WAYFINDING
DETAILS
LEVEL 3 LOCATION PLAN

SHEET NUMBER

G05-999-A8030

ISSUE

A

KEYPLAN

B


L1

SIGN CODE	LEVEL	LOC #	SIGN TYPE DESCRIPTION	SIDE A		SIDE B
				MESSAGE (English)		MESSAGE (English)
S1.1	B	001	Stair ID - Inside Stairwell	Floor	B	
				Braille		
				Stairwell	TBD	
				TBD		
				Braille		
S1.2	B	002	Stair ID - Corridor Side	[stairs picto]		
				Floor	B	
				Braille		
				Stairwell	TBD	
				TBD		
				Braille		
S1.1	B	003	Stair ID - Inside Stairwell	Floor	B	
				Braille		
				Stairwell	TBD	
				TBD		
				Braille		
S1.2	B	004	Stair ID - Corridor Side	[stairs picto]		
				Floor	B	
				Braille		
				Stairwell	TBD	
				TBD		
				Braille		
H1.1	B	005	Amenity ID	[elevator picto]		
				Elevator		
				Braille		
S1.2	L1	001	Stair ID - Corridor Side	[universal lockers picto]		
				Lockers		
				Braille		
S1.1	L1	002	Stair ID - Inside Stairwell			
H1.1	L1	003	Amenity ID			
E2.1	L1	004	Room ID	[accessible universal washroom picto]		
				Washroom		
				Braille		
S1.2	L1	005	Stair ID - Corridor Side	[stairs picto]		
				Floor	1	
				Braille		
				Stairwell	TBD	
				TBD		
				Braille		
S1.1	L1	006	Stair ID - Inside Stairwell	Floor	1	
				Braille		
				Stairwell	TBD	
				TBD		
				Braille		
H1.1	L1	007	Amenity ID	[accessible universal washroom picto]		
				Washroom		
				Braille		
H1.1	L1	008	Amenity ID	[accessible universal washroom picto]		
				Washroom		
				Braille		

SIGN TYPE	SIGN TYPE DESCRIPTION	COUNT
B1.1	Directional	0
E2.1	Room ID	1
E2.2	Line Room ID	0
E4	Insert Holder	3
H1.1	Amenity ID	9
H2.1	Projecting Amenity ID	0
J4.2	Accessible Entrance ID - Exterior	1
S1.1	Stair ID - Inside Stairwell	8
S1.2	Stair ID - Corridor Side	8
S1.3	Stair ID - Roof Exit, Inside Stairwell	0
S1.4	Stair ID - Exterior Door	0
Total		30

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CITY OF TORONTO



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M5V 3C6

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ISSUES

No.	DESCRIPTION	DATE
A	ISSUED FOR TENDER	2022-04-08


CONSULTANTS

ENTRO

33 Harbour Square, Suite 202
Toronto, Canada M5J 2G2

SEAL

PRIME CONSULTANT



100 - 175 Galaxy Blvd.
Toronto, ON M6H 0C3, Canada
tel 416 679 1930
www.arcadis.com

PROJECT TITLE

CITY OF TORONTO
ACCESSIBILITY UPGRADES

PROJECT ADDRESS

POLICE STATION NO. 33
50 UPJOHN ROAD

PROJECT NO:

9119 - 19 - 0162 / IBI 122260

DRAWN BY:

M.LOW

CHECKED BY:

C.D. SCHNOBB

PROJECT MGR:

R. DALY

APPROVED BY:

SHEET TITLE

SIGNAGE & WAYFINDING
DETAILS
MESSAGE SCHEDULE

SHEET NUMBER

G05-999-A8100

ISSUE

A

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Scale Check

1 of 1

KEYPLAN


L2

L3

SIGN CODE	LEVEL	LOC #	SIGN TYPE DESCRIPTION	SIDE A		SIDE B	
				MESSAGE (English)		MESSAGE (English)	
J4.2	L1	009	Accessible Entrance ID - Exterior	[accessible picto] Entrance Braille			
S1.1	L2	001	Stair ID - Inside Stairwell	Floor 2 Braille Stairwell TBD Braille			
S1.2	L2	002	Stair ID - Corridor Side	[stairs picto] Floor 2 Braille Stairwell TBD TBD Braille			
H1.1	L2	003	Amenity ID	[female changerom picto] Women's Changeroom Braille			
S1.2	L2	004		[stairs picto] Floor 2 Braille Stairwell TBD TBD Braille			
S1.1	L2	005	Stair ID - Inside Stairwell	Floor 2 Braille Stairwell TBD TBD Braille			
H1.1	L2	006	Amenity ID	[male changerom picto] Men's Changeroom Braille			
E4	L3	001	Insert Holder				
S1.2	L3	002	Stair ID - Corridor Side	[stairs picto] Floor 3 Braille Stairwell TBD TBD Braille			
S1.1	L3	003	Stair ID - Inside Stairwell	Floor 3 Braille Stairwell TBD TBD Braille			
H1.1	L3	004	Amenity ID	[elevator picto] Elevator Braille			
H1.1	L3	005	Amenity ID	[accessible universal washroom picto] Washroom Braille			

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CITY OF TORONTO



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ISSUES


No.	DESCRIPTION	DATE
A	ISSUED FOR TENDER	2022-04-08

CONSULTANTS

ENTRO
33 Harbour Square, Suite 202
Toronto, Canada M5J 2G2

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PRIME CONSULTANT



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Toronto, ON M6H 0C3, Canada
tel 416 679 1930
www.arcadis.com

PROJECT TITLE

CITY OF TORONTO
ACCESSIBILITY UPGRADES

PROJECT ADDRESS

POLICE STATION NO. 33
50 UPJOHN ROAD

PROJECT NO:

9119 – 19 – 0162 / IBI 122260

DRAWN BY:

M.LOW

CHECKED BY:

C.D. SCHNOBB

PROJECT MGR:

R. DALY

APPROVED BY:

SHEET TITLE

SIGNAGE & WAYFINDING
DETAILS
MESSAGE SCHEDULE

SHEET NUMBER

G05-999-A8101

ISSUE

A

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1 of 1

SCALE CHECK

KEYPLAN

SIGN CODE	LEVEL	LOC #	SIGN TYPE DESCRIPTION	SIDE A	SIDE B
				MESSAGE (English)	MESSAGE (English)
H1.1	L3	006	Amenity ID	[accessible universal washroom picto] Washroom Braille	
E4	L3	007	Insert Holder		
S1.2	L3	008	Stair ID - Corridor Side	[stairs picto] Floor 3 Braille Stairwell TBD TBD Braille	
S1.1	L3	009	Stair ID - Inside Stairwell	Floor 3 Braille Stairwell TBD TBD Braille	
E4	L3	010	Insert Holder		

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ISSUES		
No.	DESCRIPTION	DATE
A	ISSUED FOR TENDER	2022-04-08

CONSULTANTS
ENTRO
33 Harbour Square, Suite 202
Toronto, Canada M5J 2G2

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PRIME CONSULTANT
ARCADIS
100 - 175 Galaxy Blvd.
Toronto, ON M5H 0C3, Canada
tel 416 679 1930
www.arcadis.com

PROJECT TITLE
CITY OF TORONTO
ACCESSIBILITY UPGRADES

PROJECT ADDRESS
POLICE STATION NO. 33
50 UPJOHN ROAD

PROJECT NO:
9119 - 19 - 0162 / IBI 122260

DRAWN BY: M.LOW	CHECKED BY: C.D. SCHNOBB
---------------------------	------------------------------------

PROJECT MGR: R. DALY	APPROVED BY:
--------------------------------	--------------

SHEET TITLE
SIGNAGE & WAYFINDING
DETAILS
MESSAGE SCHEDULE


SHEET NUMBER
G05-999-A8102

ISSUE
A

Sheet List	
Sheet Number	Sheet Name
06 - Structural	
S0001	DRAWING LIST
S1201	SITE PLAN
S2001	DEMOLITION PLAN - BASEMENT
S2002	DEMOLITION PLAN - GROUND FLOOR
S2003	DEMOLITION PLAN - SECOND FLOOR
S2004	DEMOLITION PLAN - THIRD FLOOR
S2005	DEMOLITION PLAN - MECHANICAL FLOOR
S2501	PROPOSED PLAN - BASEMENT
S2502	PROPOSED PLAN - GROUND FLOOR
S2503	PROPOSED PLAN - SECOND FLOOR
S2504	PROPOSED PLAN - THIRD FLOOR
S2505	PROPOSED PLAN - MECHANICAL FLOOR
S5301	ELEVATOR - FOUNDATION
S5302	ELEVATOR - PLANS
S5303	ELEVATOR - PLANS
S5304	ELEVATOR - ROOF
S5305	ELEVATOR - SECTIONS
S6801	WALL OPENINGS

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CITY OF TORONTO



Corporate Real Estate Management
Project Management Office
Metro Hall Toronto, ON
M5V 3C6

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Arcadis Professional Services (Canada) Inc.


ISSUES

No.	DESCRIPTION	DATE
A	50% SUBMISSION	2021-11-19
B	90% SUBMISSION	2022-03-04
C	ISSUED FOR PERMIT	2022-03-18
D	ISSUED FOR TENDER	2022-12-07
E	ISSUED FOR TENDER	2025-04-11

CONSULTANTS

SEAL

PRIME CONSULTANT



100 - 175 Galaxy Blvd,
Toronto, ON M9W 0C9, Canada
tel 416 679 1930
www.arcadis.com

PROJECT TITLE

CITY OF TORONTO
ACCESSIBILITY UPGRADES

PROJECT ADDRESS

POLICE NO. 33 DIVISION
50 UPJOHN RD

PROJECT NO:


Arcadis 30279056

DRAWN BY: L. CHATZIGIANNAKOS	CHECKED BY: M. FAYAZI
PROJECT MGR: F. BOLOURIAN	APPROVED BY: K. ANGER


SHEET TITLE

DRAWING LIST

SHEET NUMBER	ISSUE
S0001	E

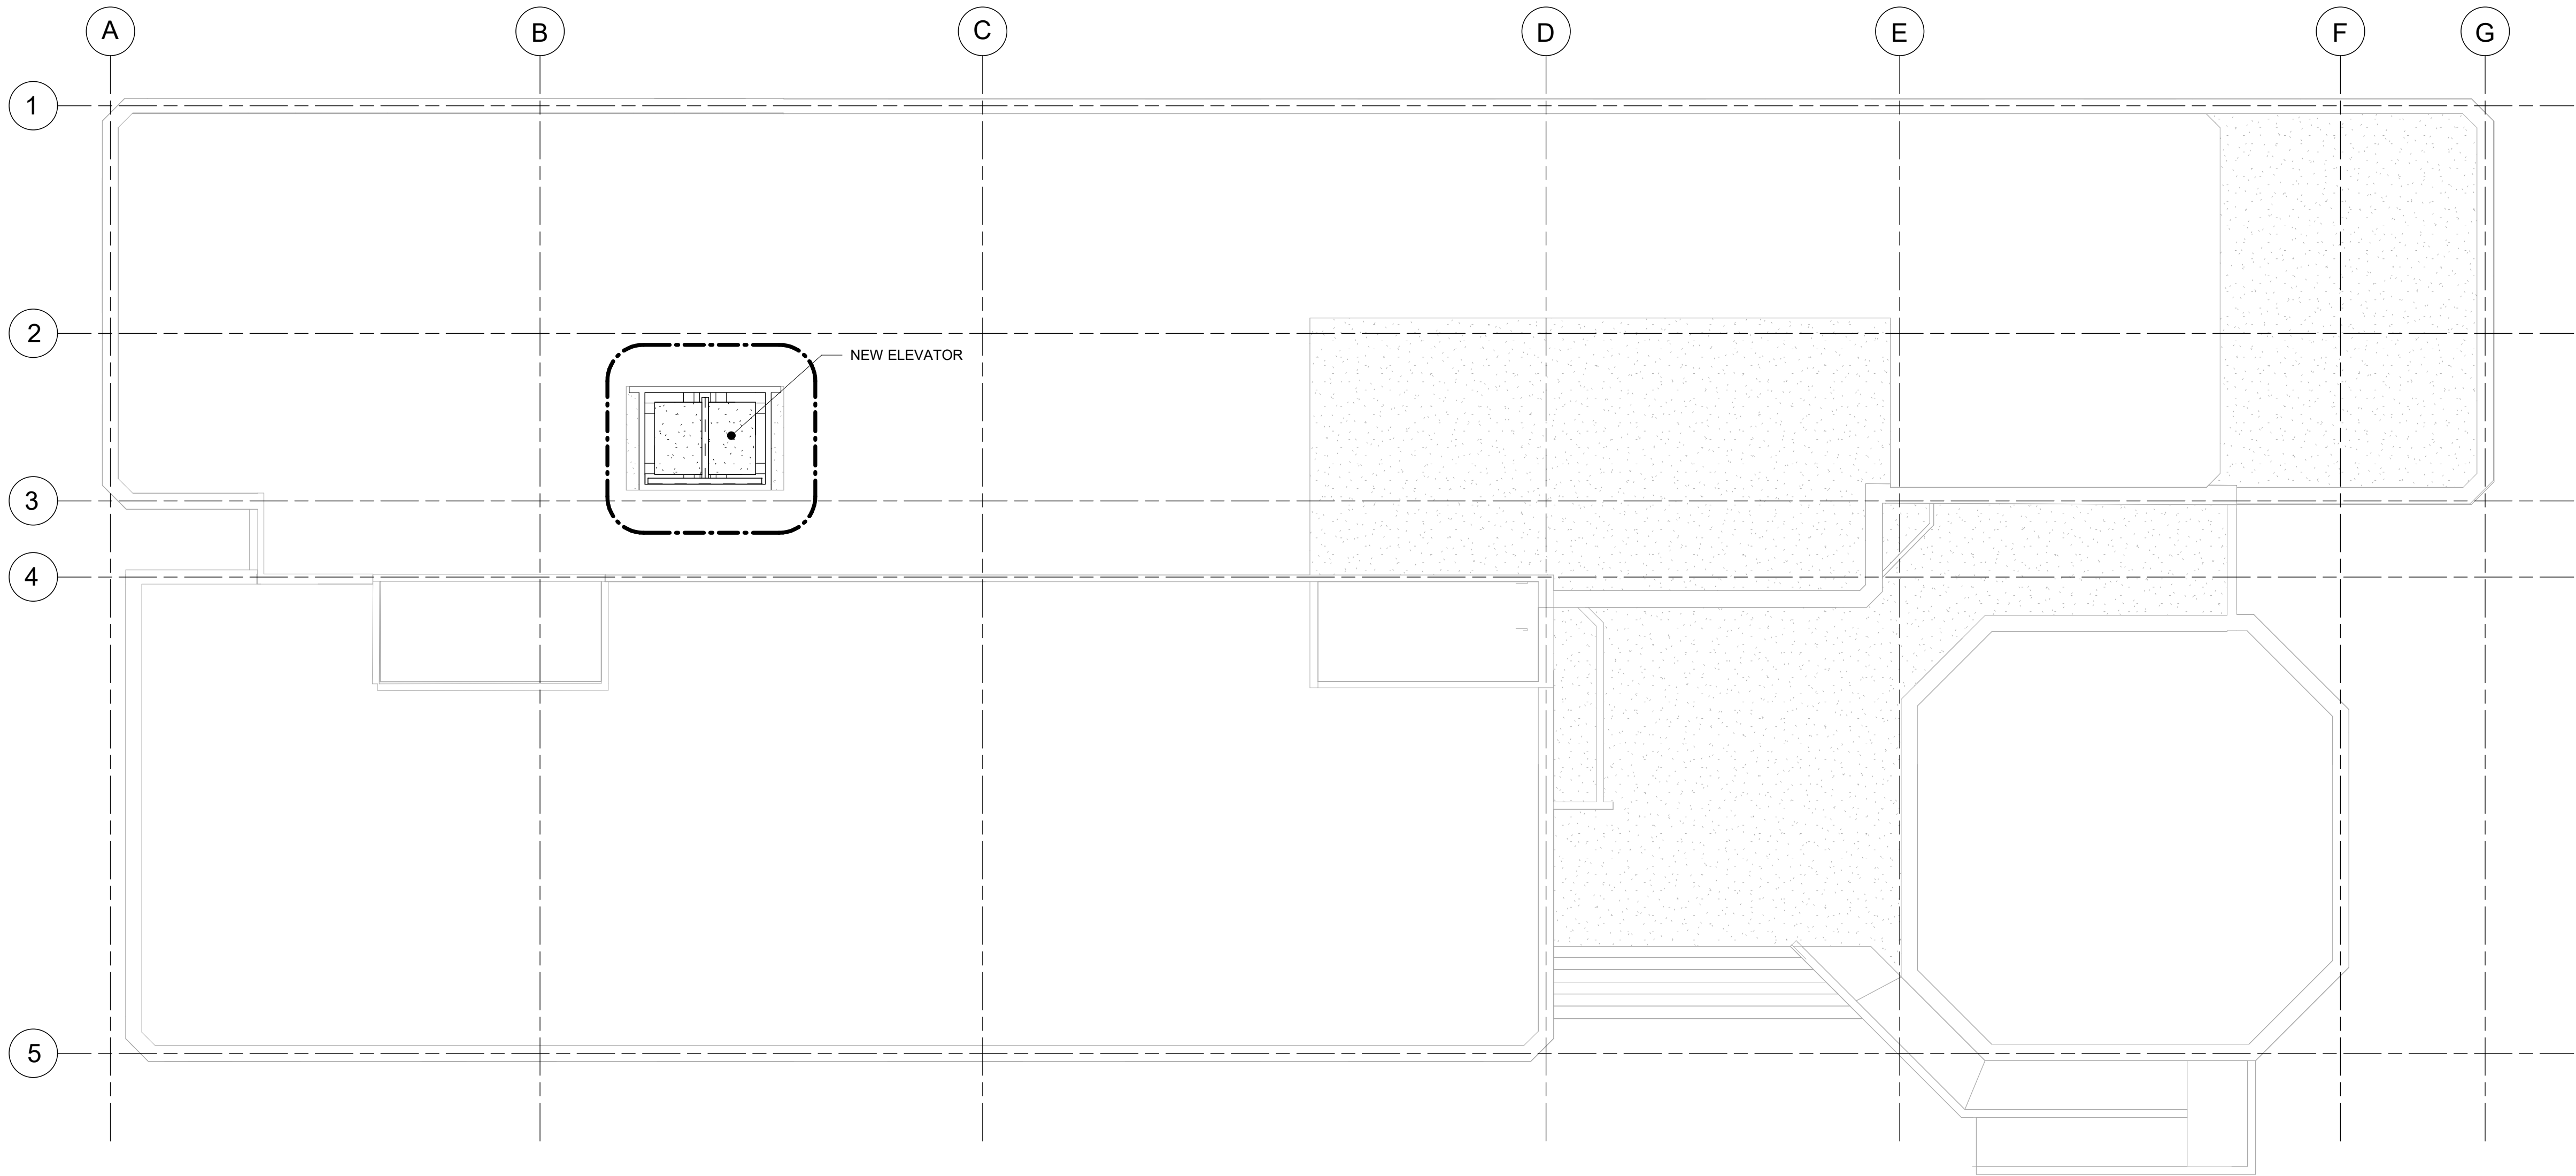

1 SITE PLAN
S1201 Scale: 1 : 100

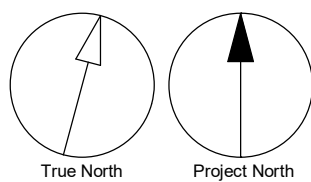

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PROJECT ADDRESS

**POLICE NO. 33 DIVISION
50 UPJOHN RD**

PROJECT NO:
Arcadis 30279056

DRAWN BY:
L. CHATZIGIANNAKOS

CHECKED BY:
M. FAYAZI

PROJECT MGR:
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APPROVED BY:
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SHEET TITLE
SITE PLAN

SHEET NUMBER
S1201

ISSUE
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50 UPJOHN RD

PROJECT NO:
Arcadis 30279056

DRAWN BY:
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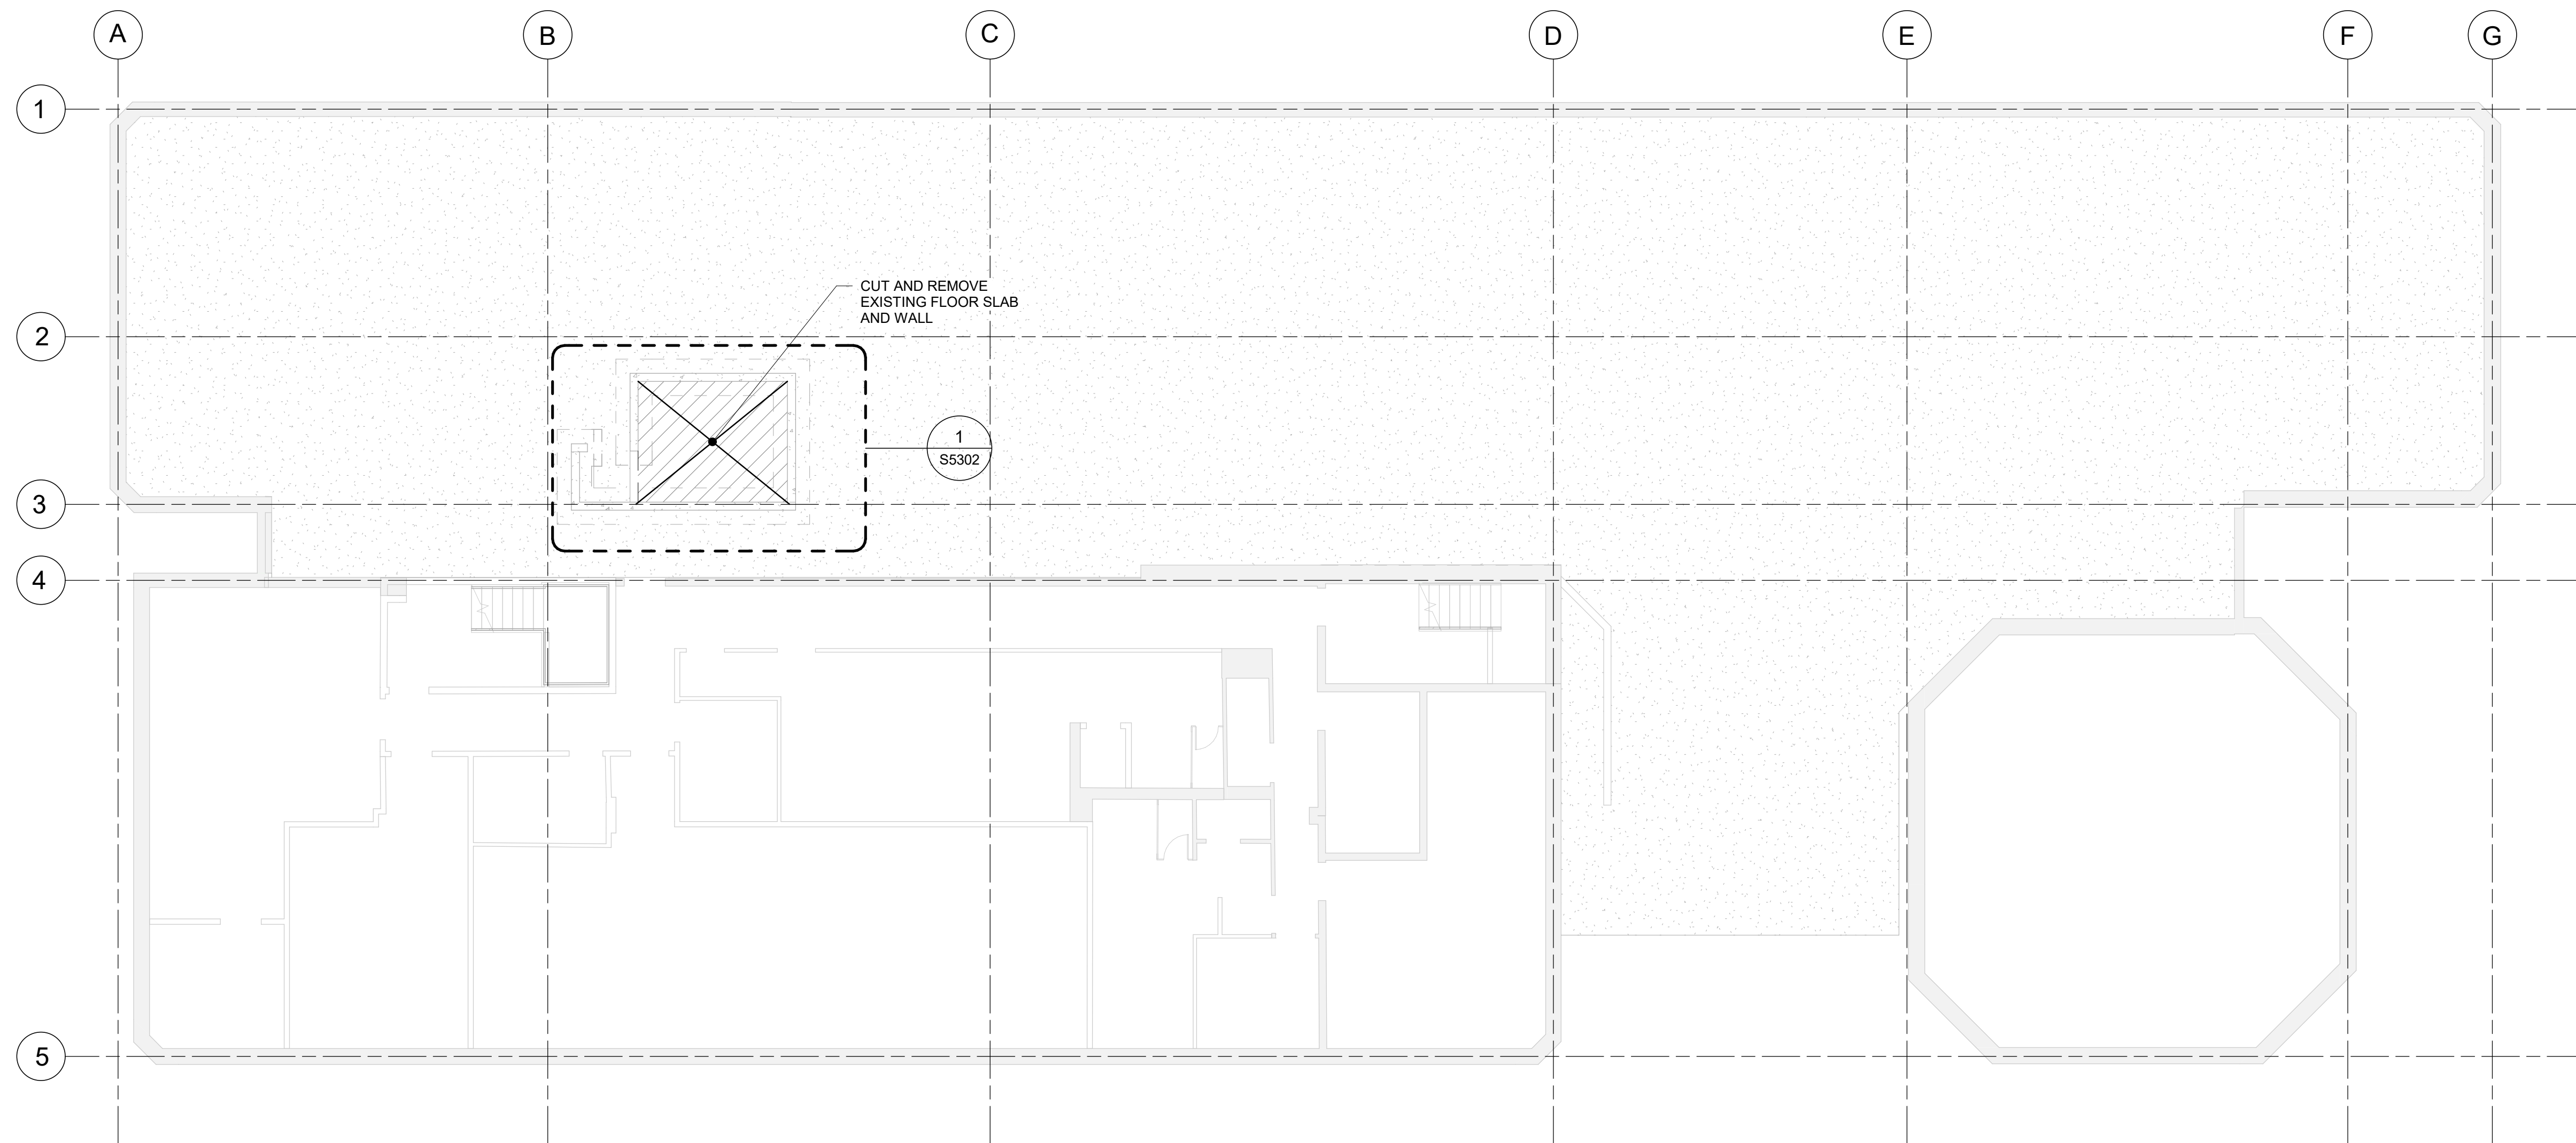
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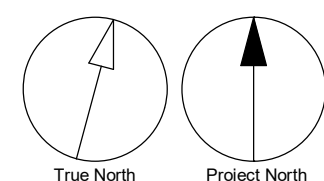
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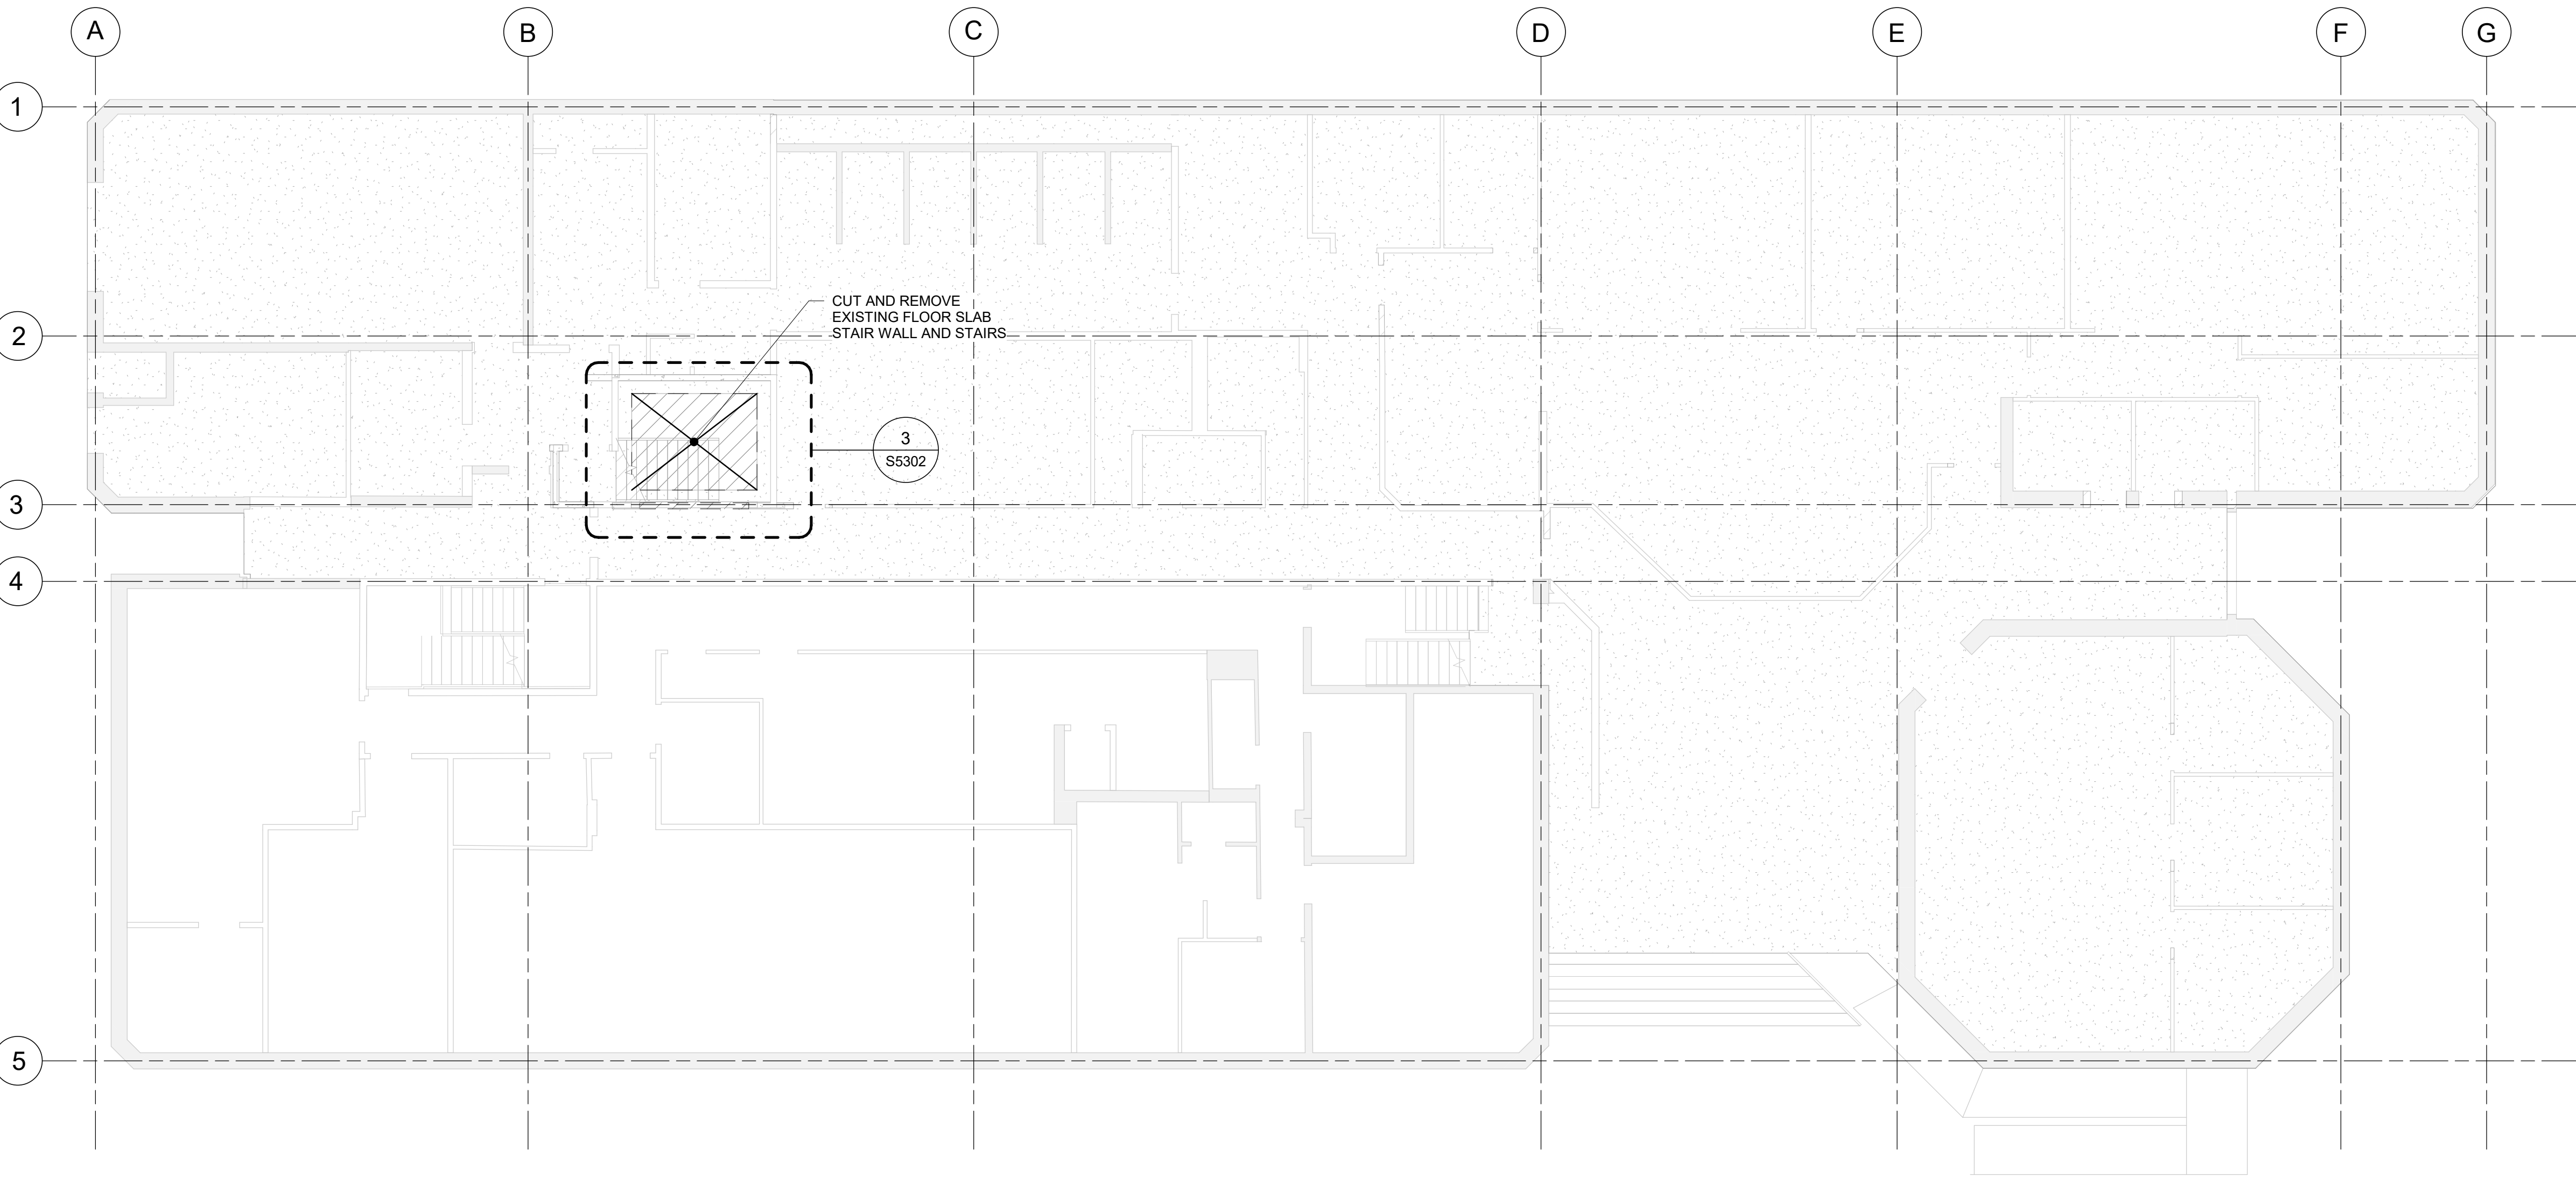
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ISSUE
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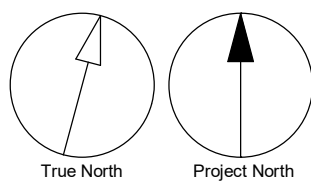


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DEMOLITION PLAN - BASEMENT
Scale: 1 : 100





1 DEMOLITION PLAN - GROUND FLOOR
S2002 Scale: 1 : 100



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SHEET TITLE
DEMOLITION PLAN -
GROUND FLOOR

SHEET NUMBER	ISSUE
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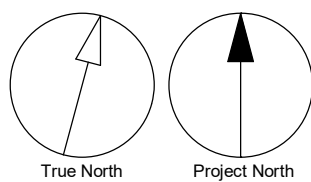
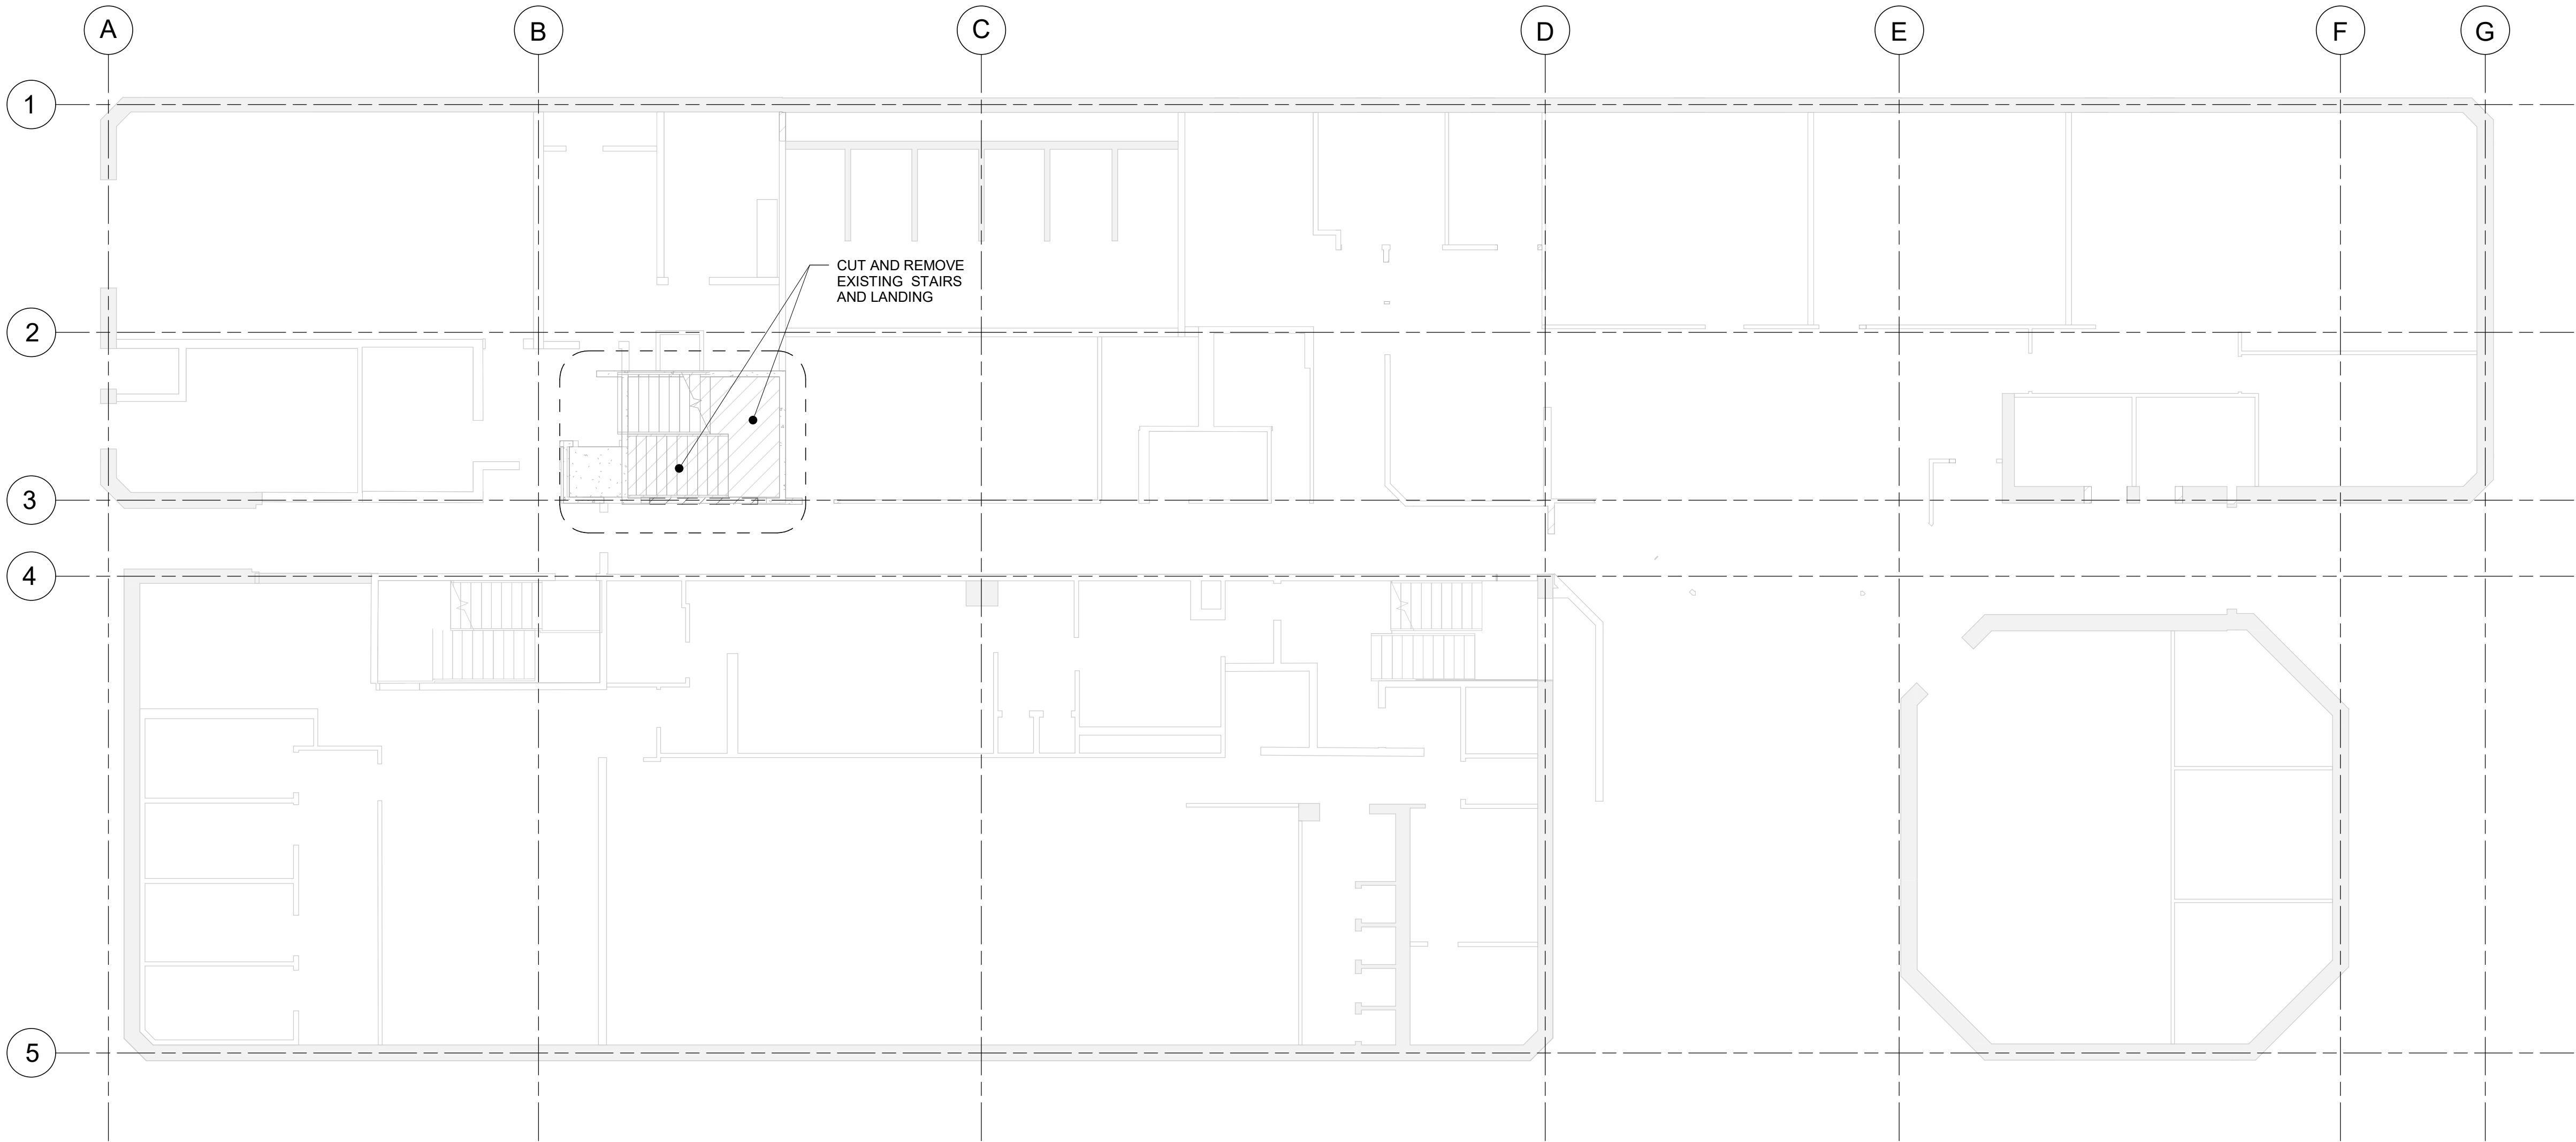
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
DEMOLITION PLAN - SECOND FLOOR

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
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CHECKED BY:

M. FAYAZI

PROJECT MGR:

F. BOLOURIAN

APPROVED BY:

K. ANGER

SHEET TITLE

DEMOLITION PLAN -
SECOND FLOOR


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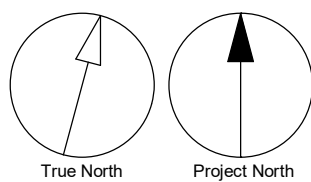
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


1 DEMOLITION PLAN - GROUND UPPER FLOOR
S2004 / Scale: 1 : 100



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
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PROJECT MGR:

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SHEET TITLE

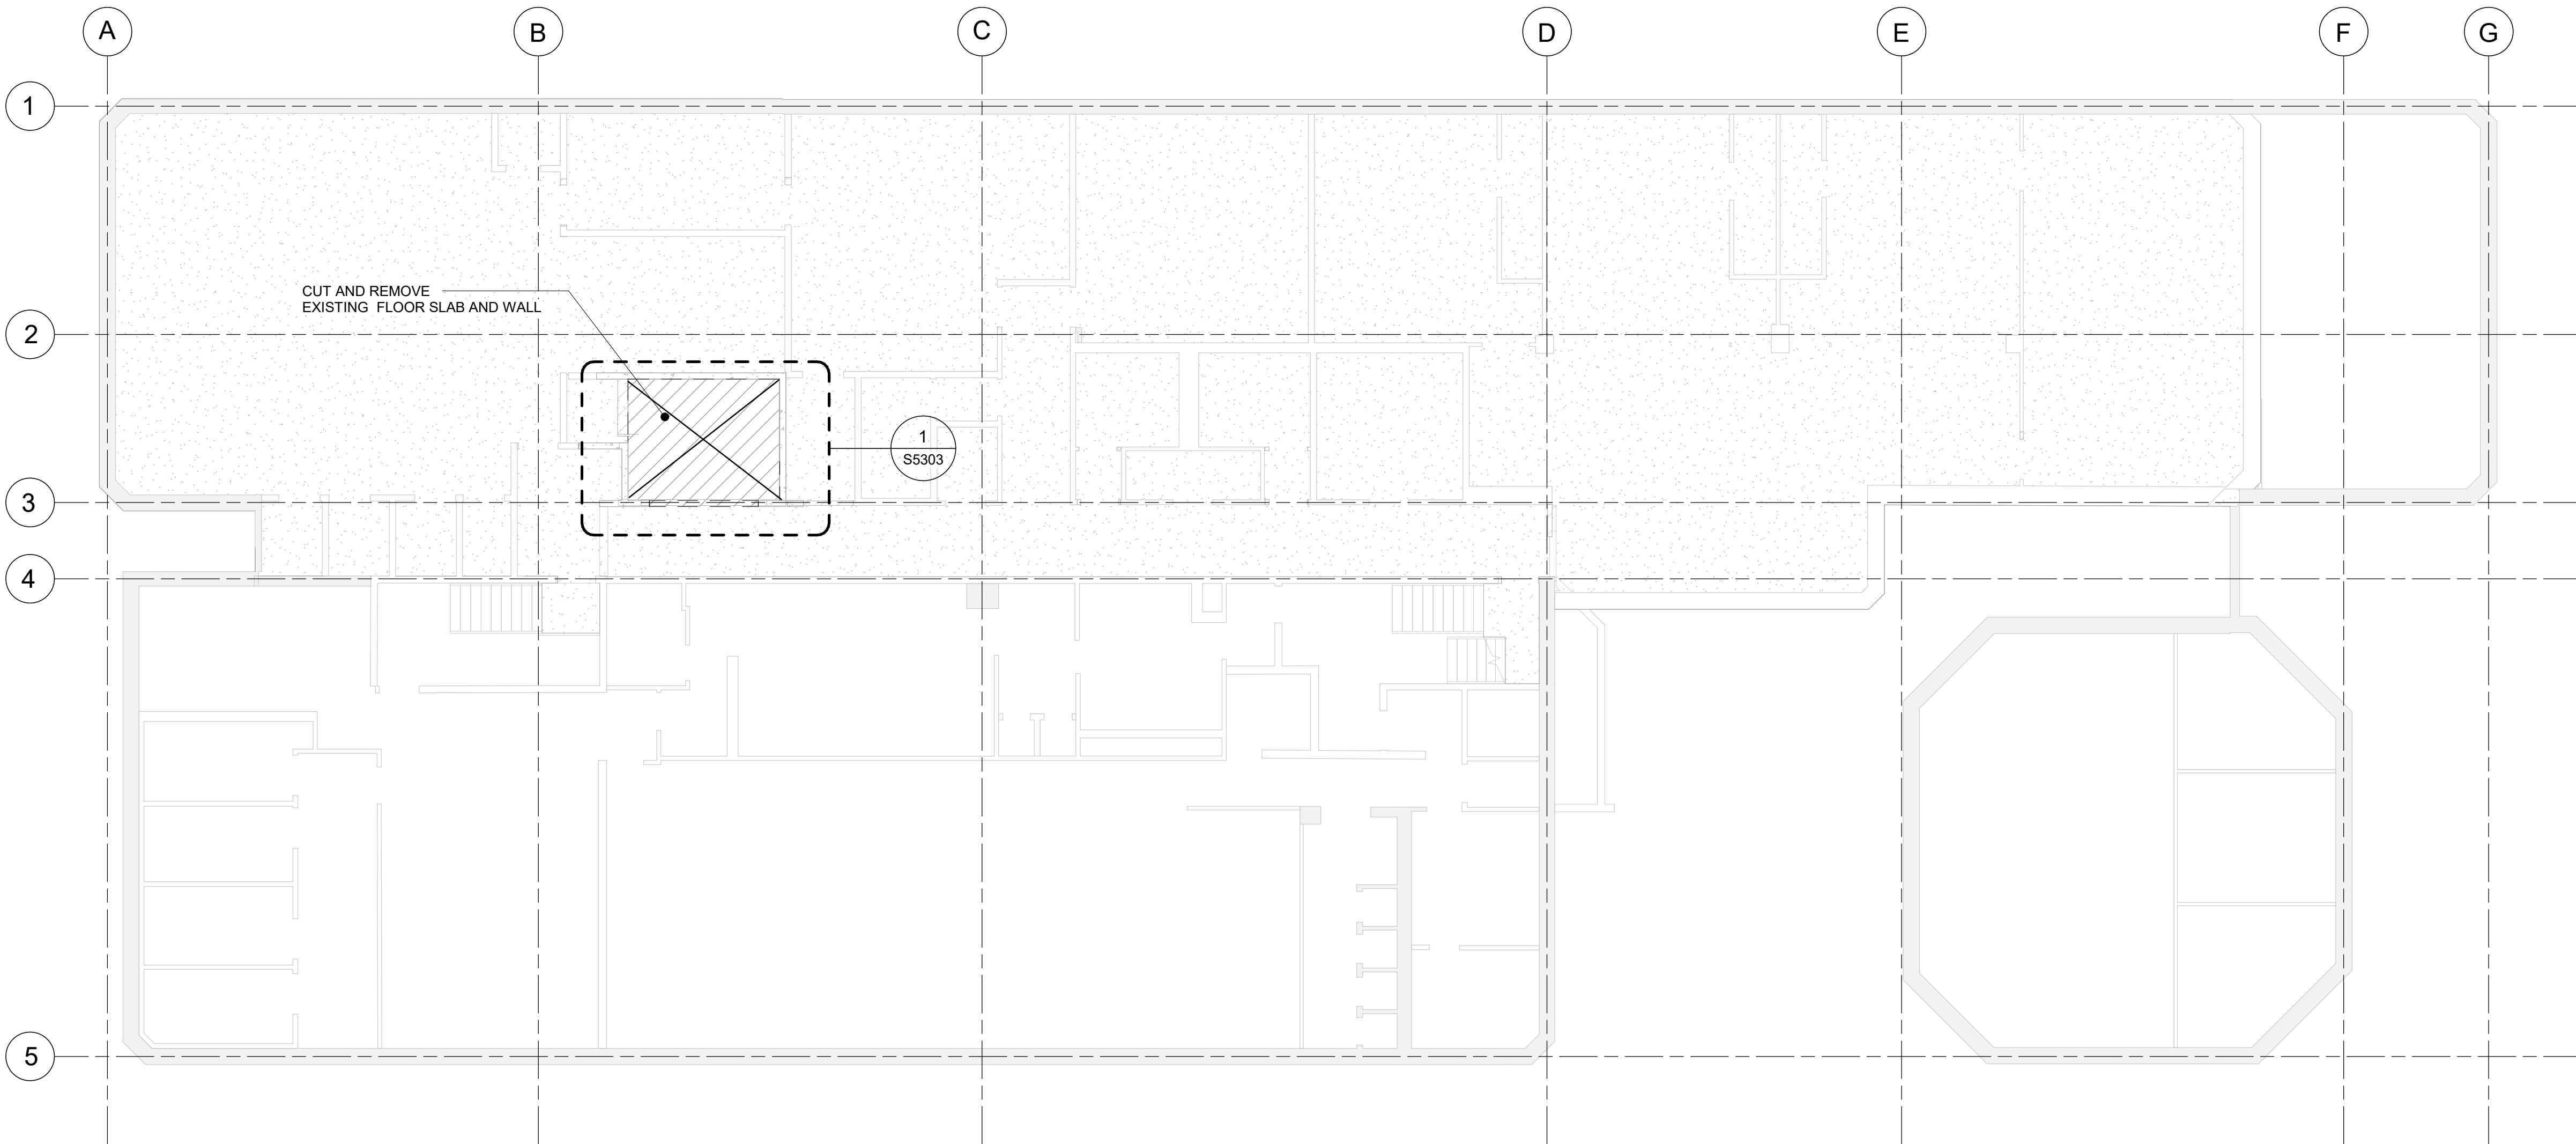DEMOLITION PLAN -
THIRD FLOOR


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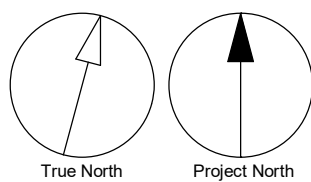
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1 DEMOLITION PLAN - MECHANICAL FLOOR
S2005 Scale: 1 : 100



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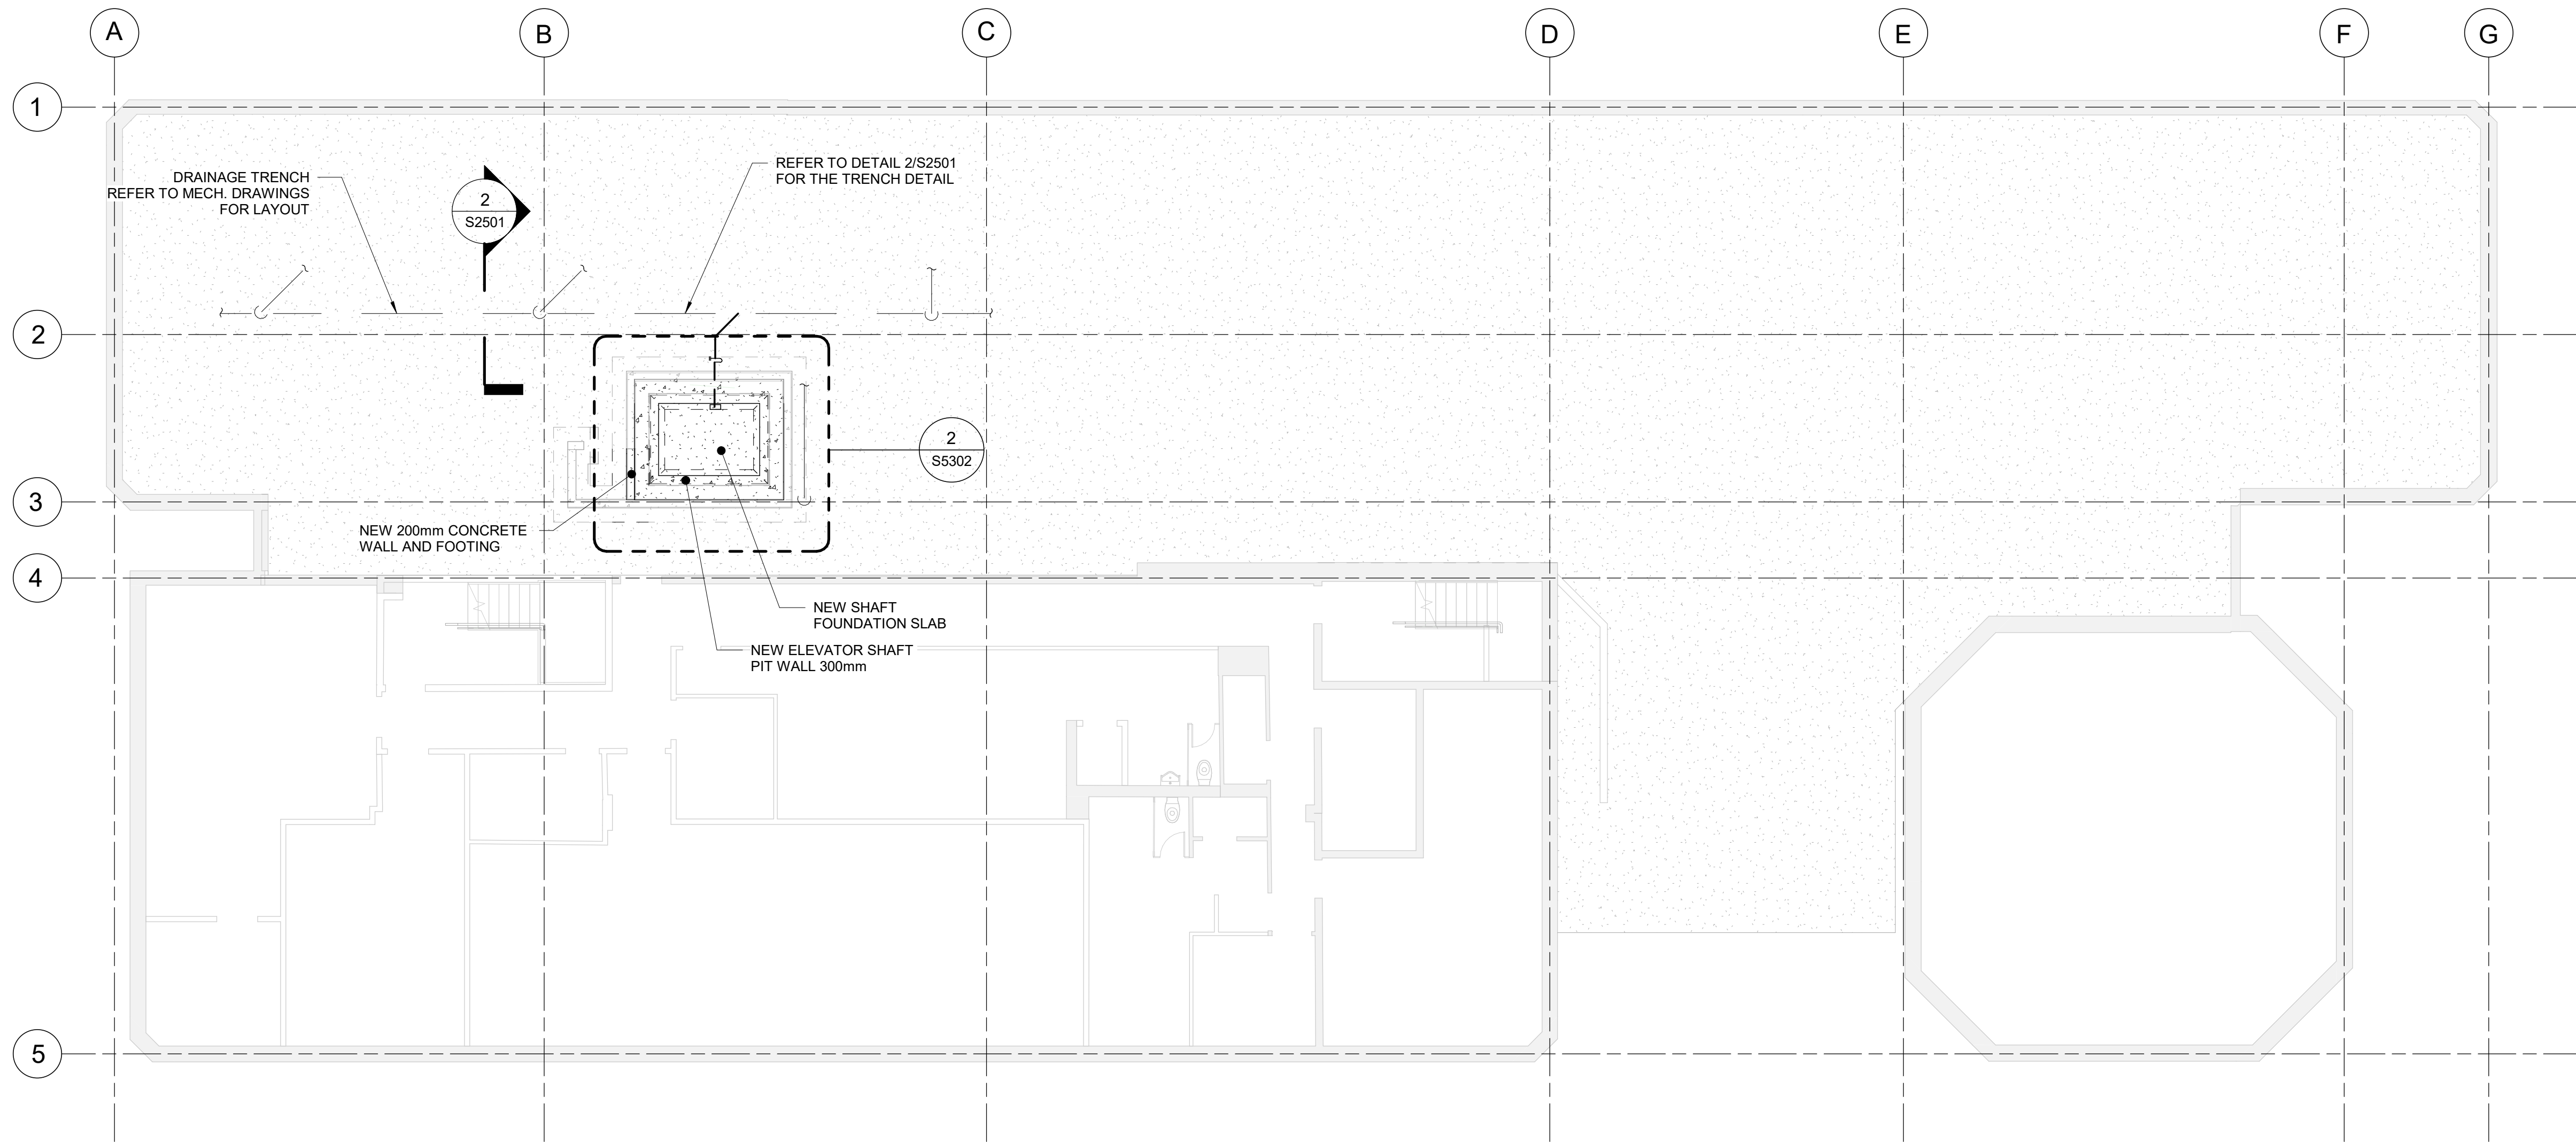
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PROJECT MGR: F. BOLOURIAN	APPROVED BY: K. ANGER


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MECHANICAL FLOOR

SHEET NUMBER	ISSUE
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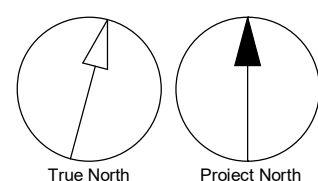
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1 PROPOSED PLAN - BASEMENT
S2501 Scale: 1 : 100

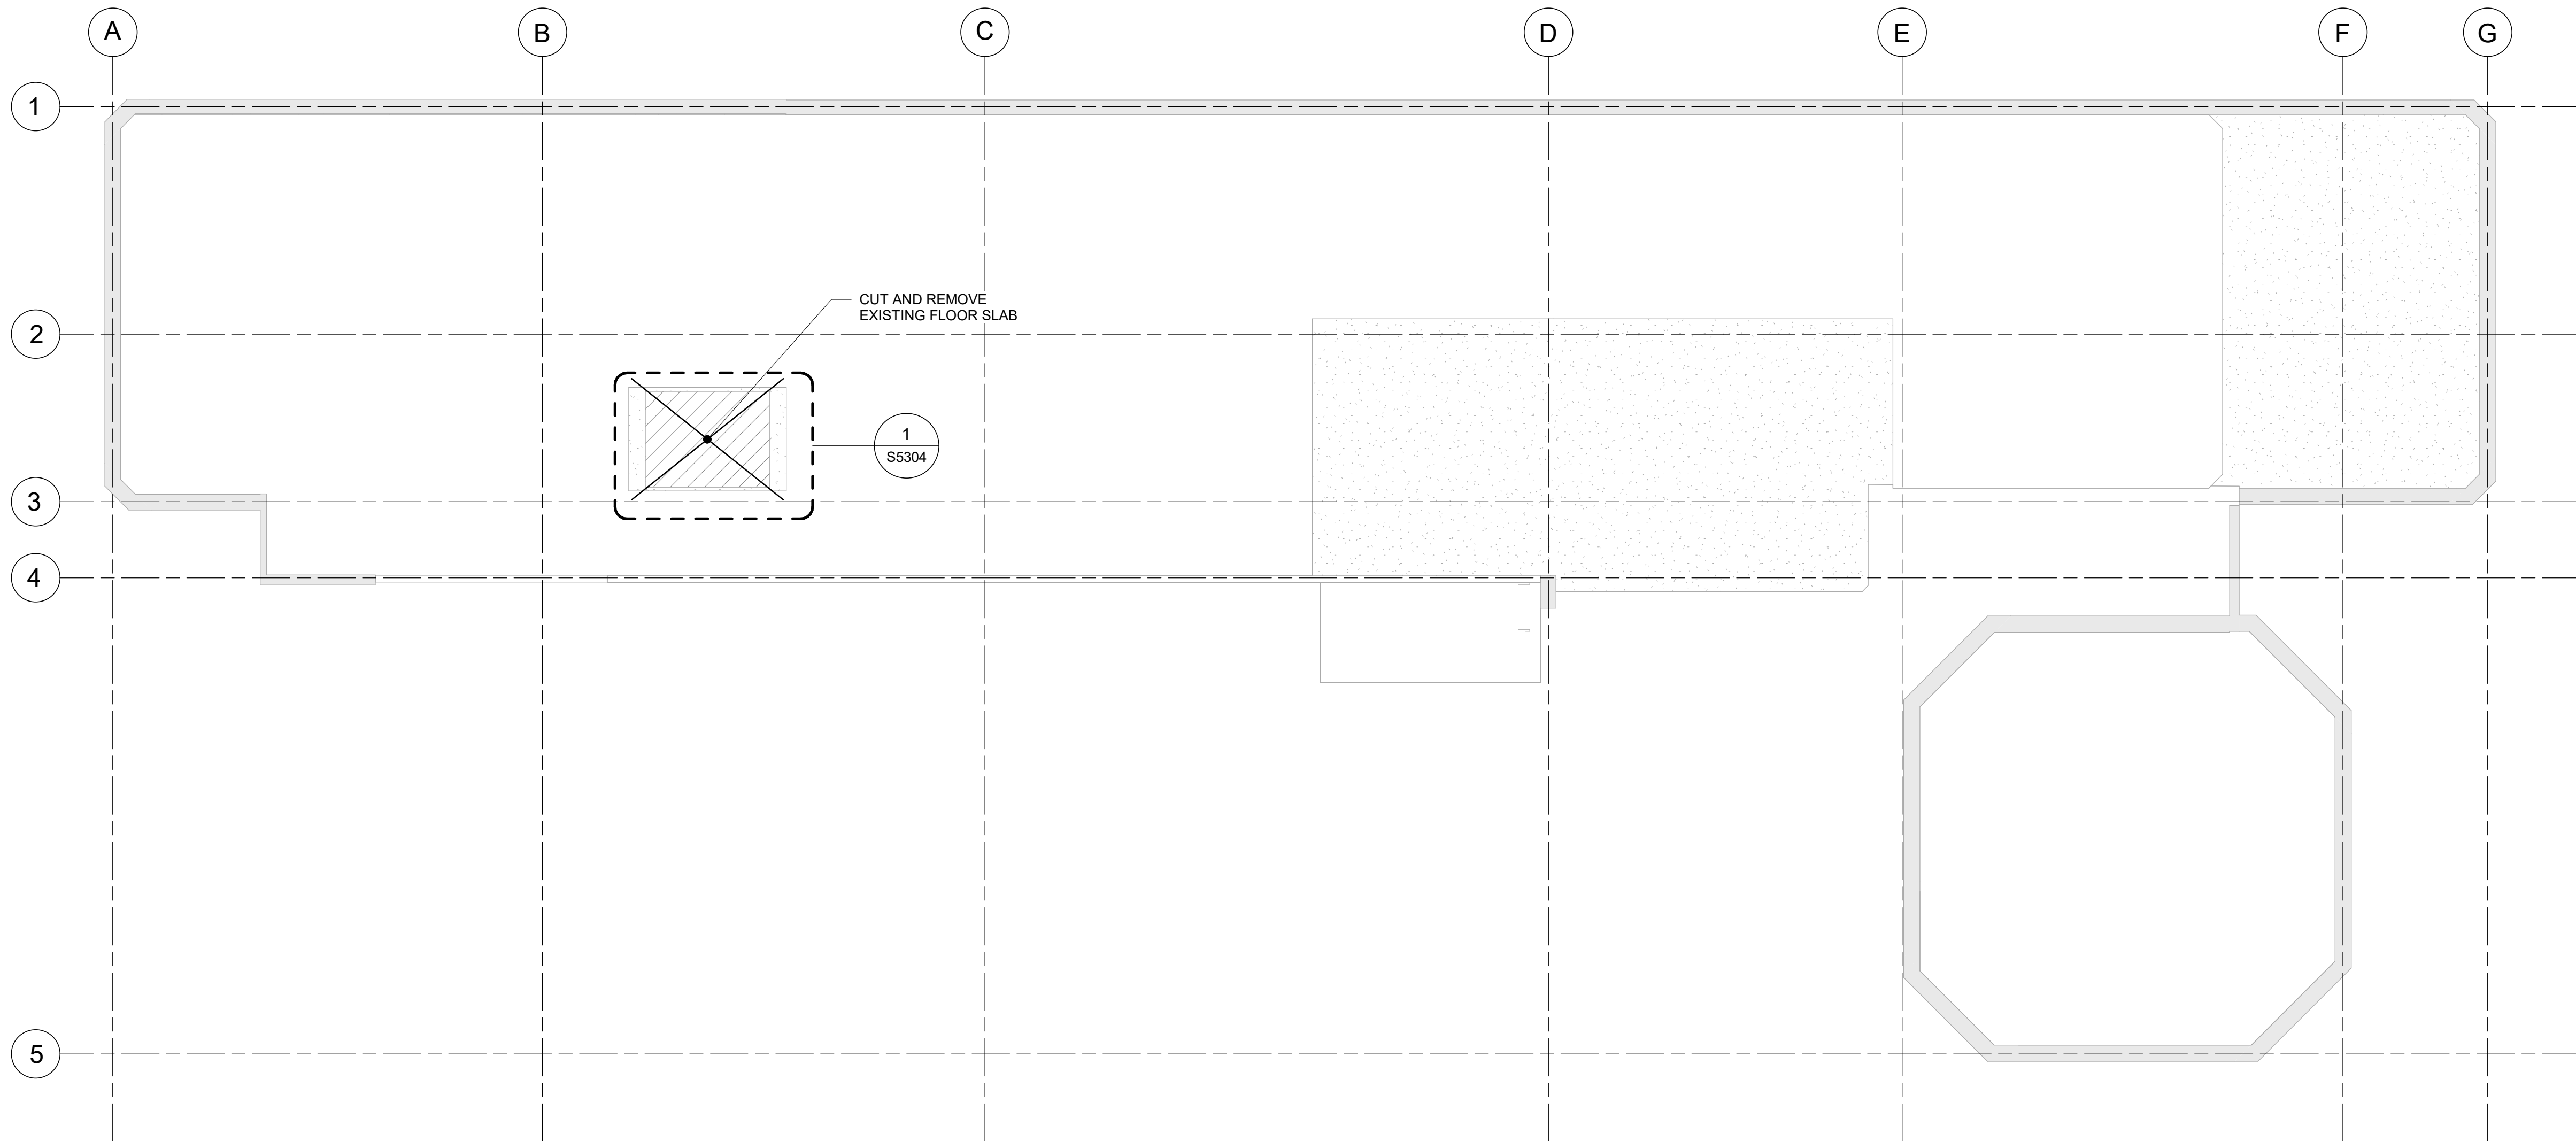

2 TRENCH DETAIL IN EXISTING SLAB - OPTION 2
S2501 Scale: 1 : 10

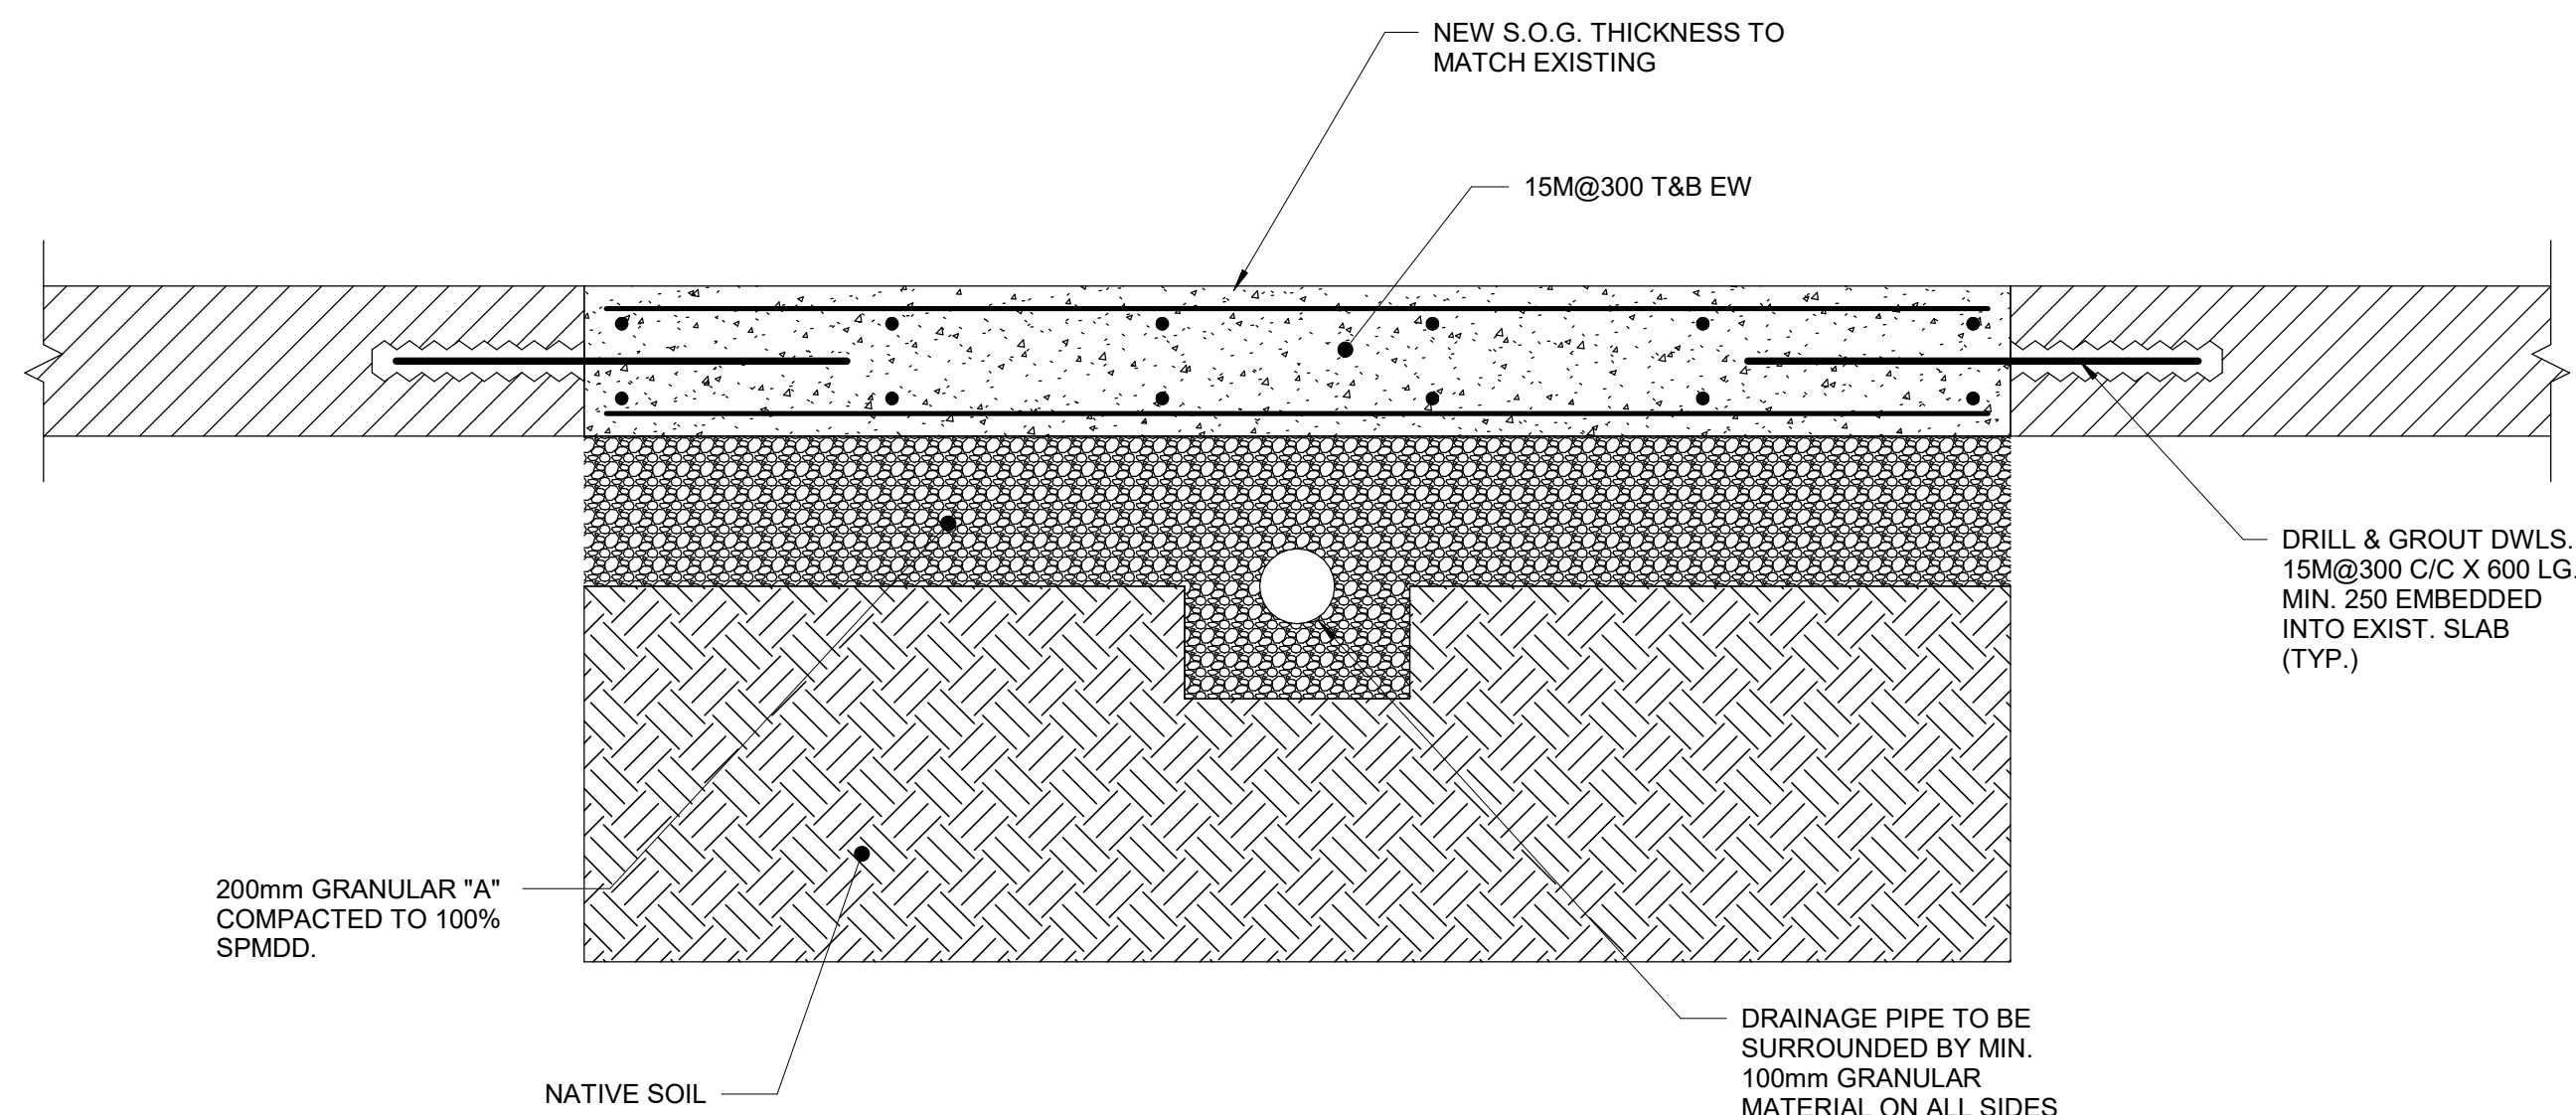

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CHECKED BY:
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PROJECT MGR:
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APPROVED BY:
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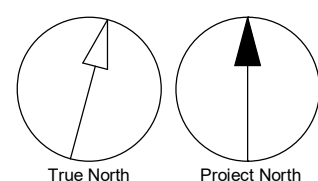
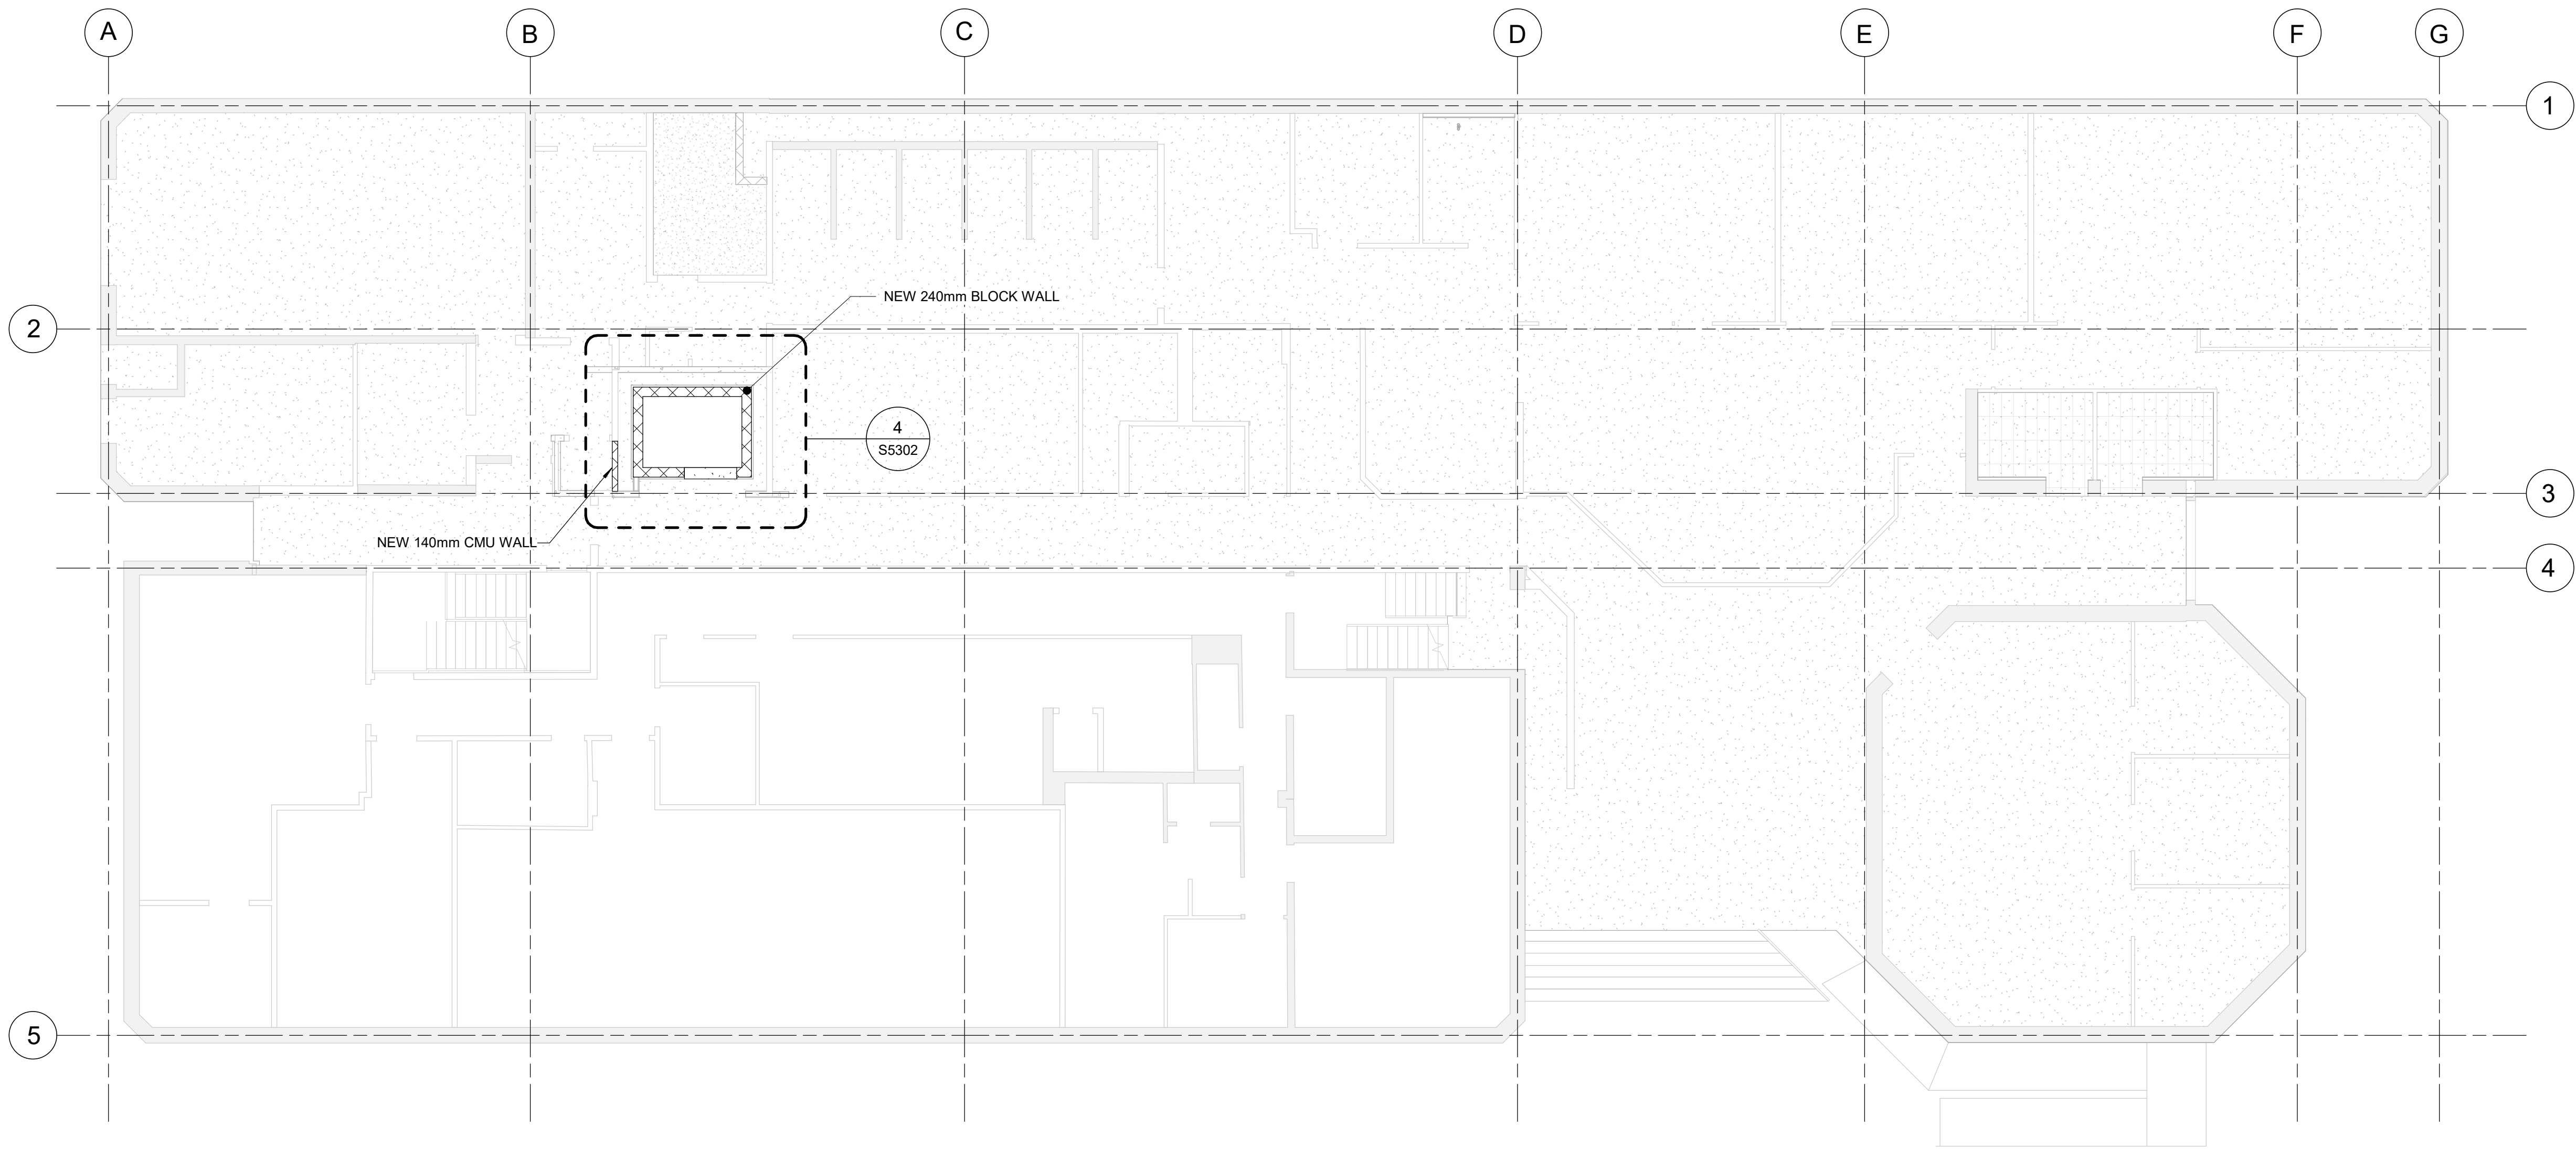
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PROPOSED PLAN -
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PROJECT NO:
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DRAWN BY:
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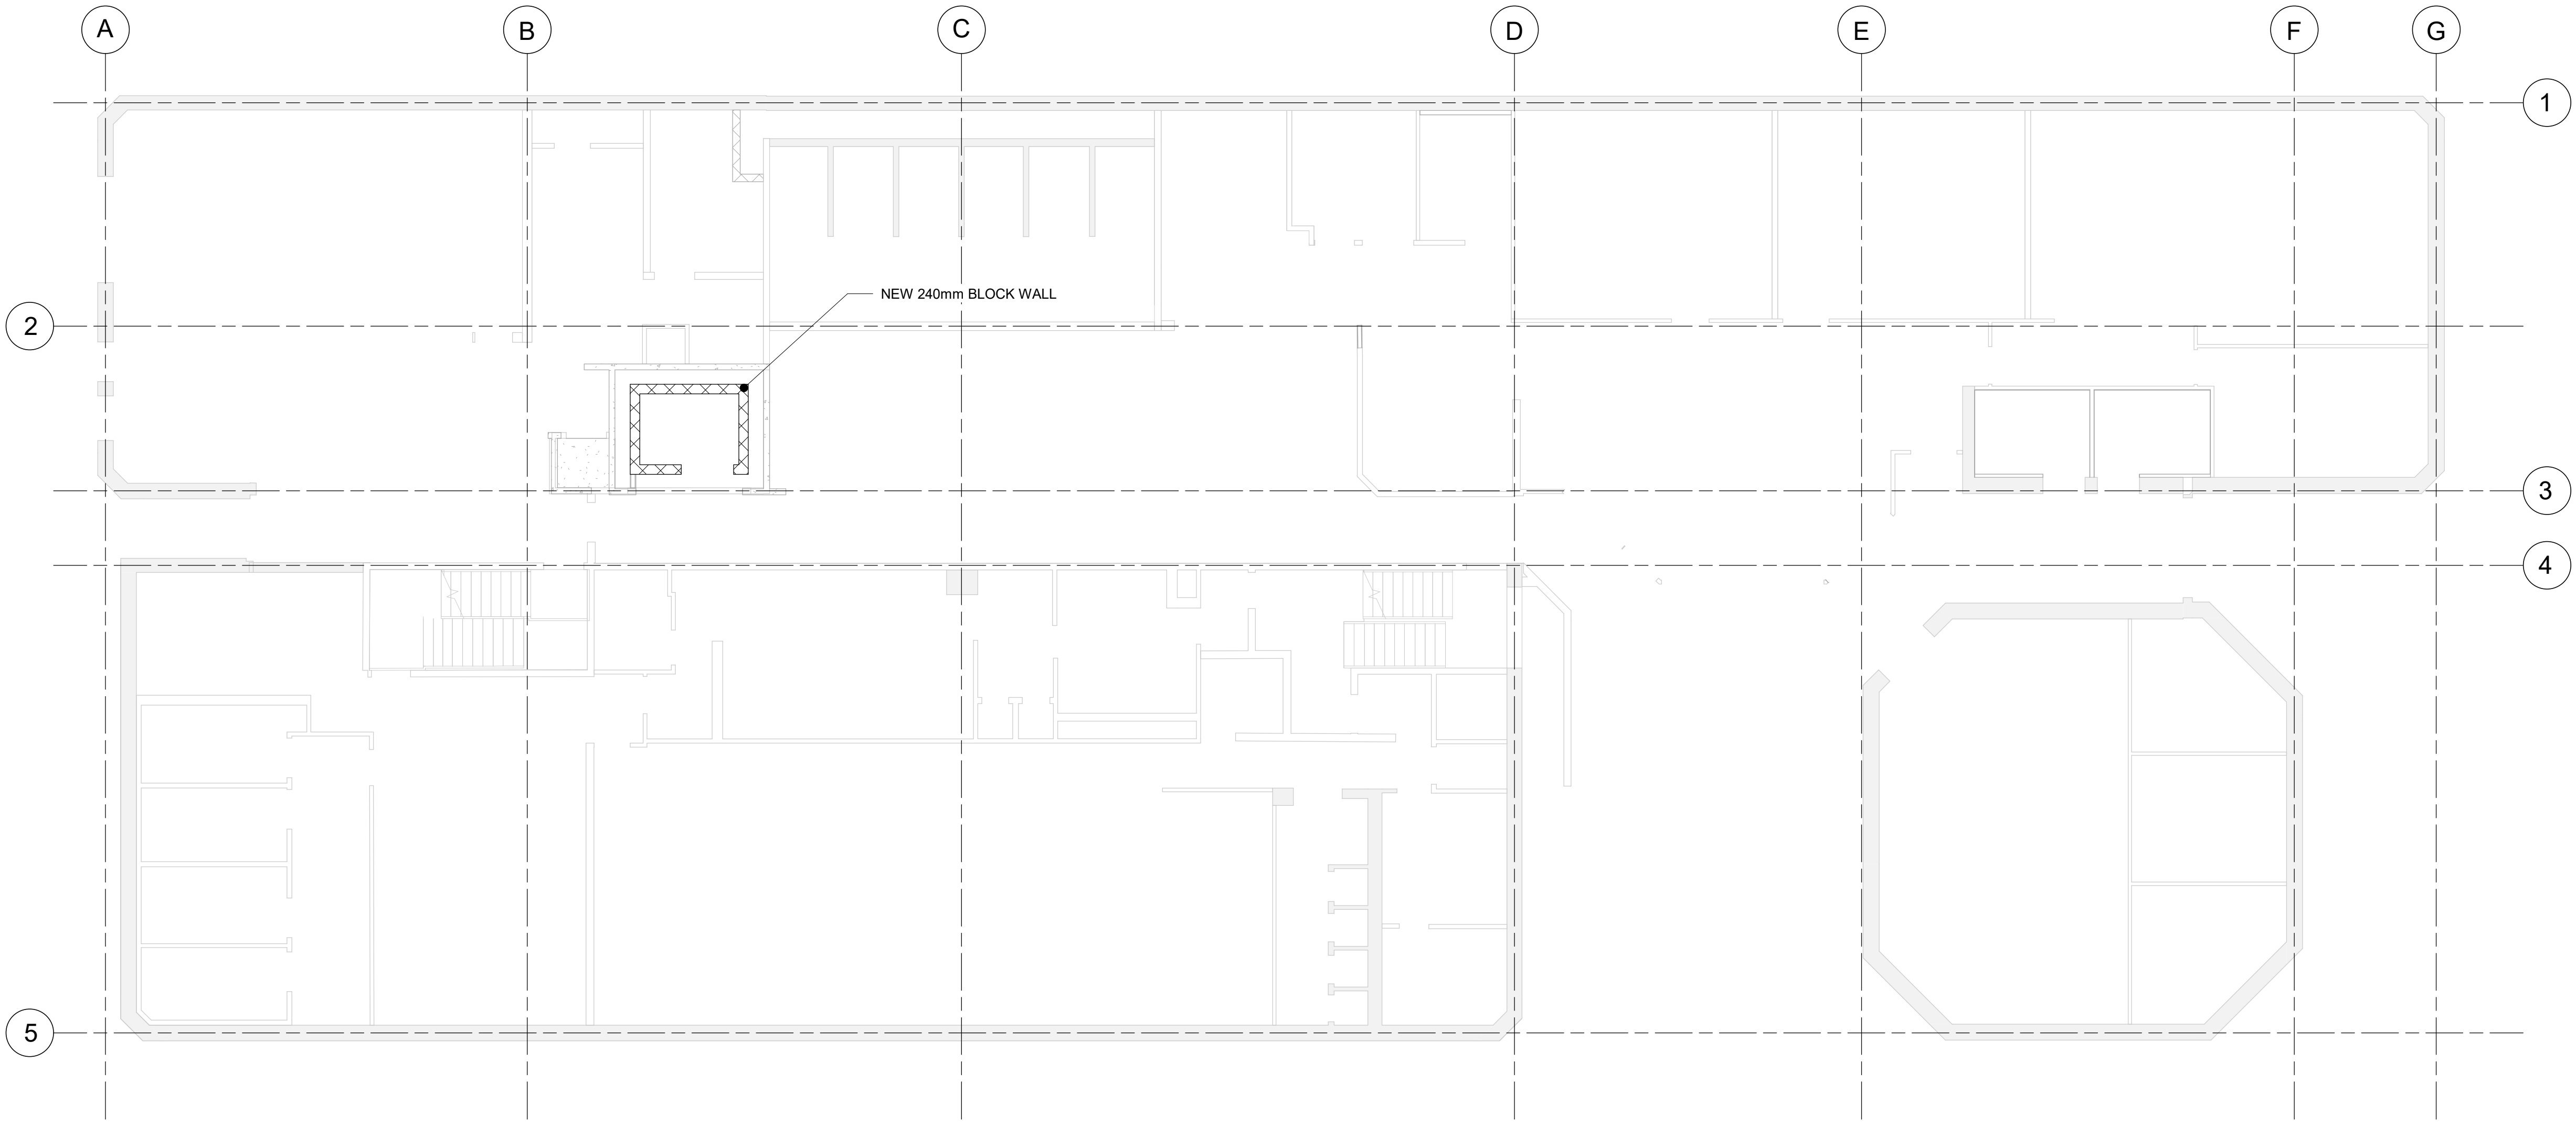
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GROUND FLOOR**


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1 PROPOSED PLAN - SECOND FLOOR
S2503 Scale: 1 : 100



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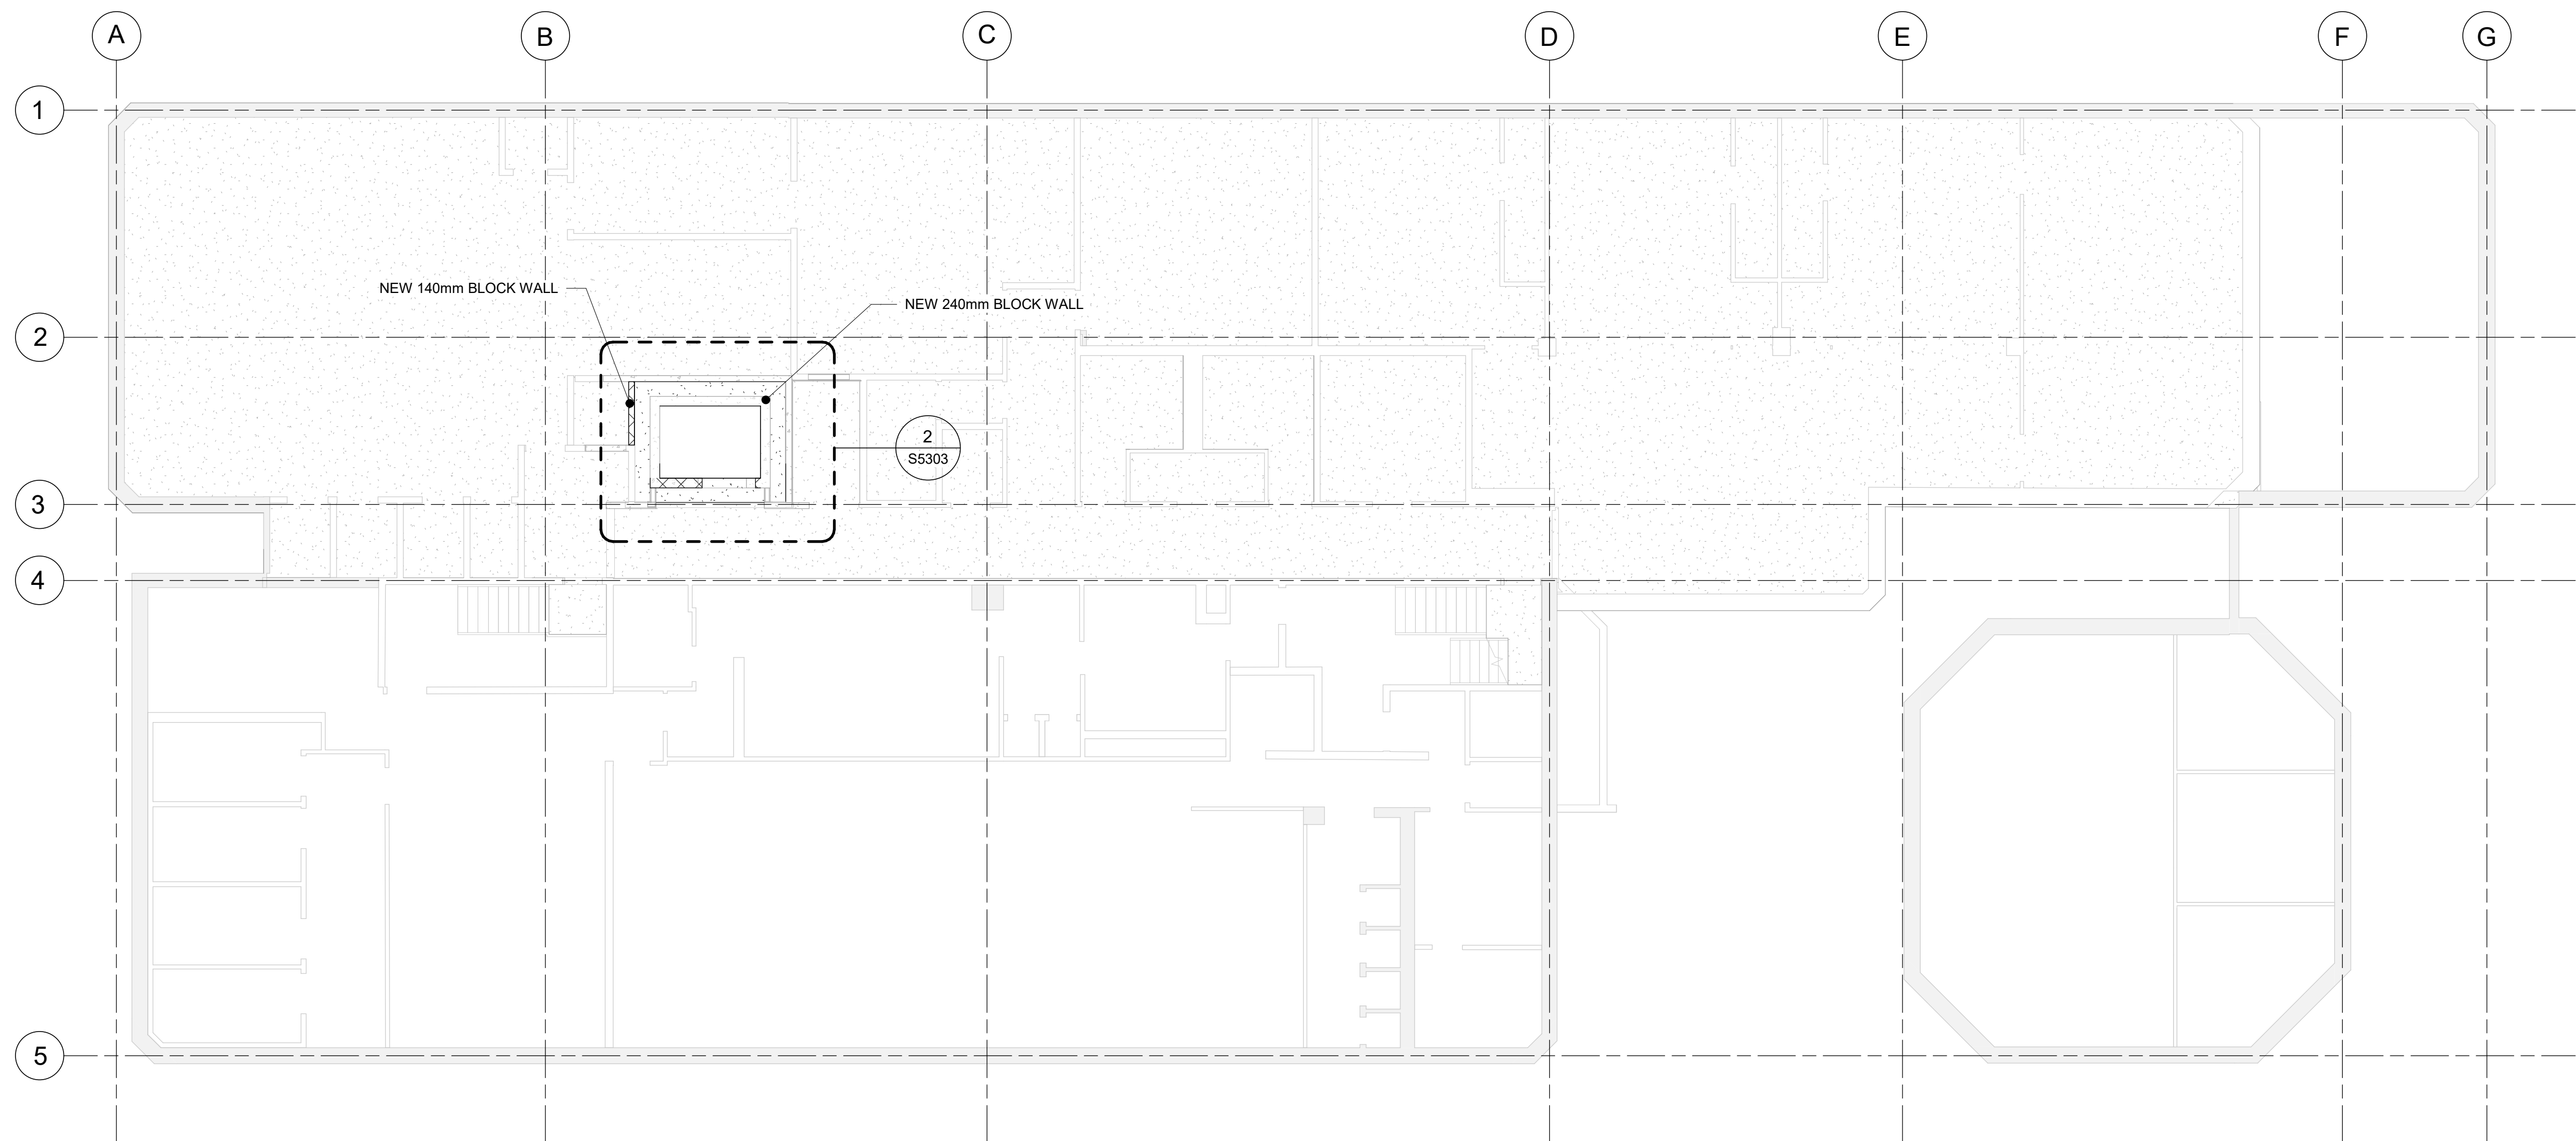
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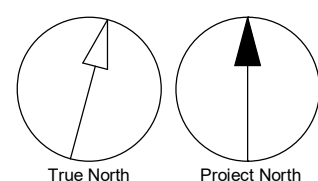
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SECOND FLOOR**

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


1 PROPOSED PLAN - GROUND UPPER FLOOR
S2504 Scale: 1 : 100

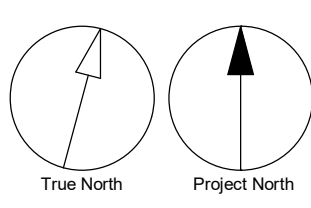

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
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PROJECT NO:

Arcadis 30279056

DRAWN BY:

L. CHATZIGIANNAKOS

CHECKED BY:

M. FAYAZI

PROJECT MGR:

F. BOLOURIAN

APPROVED BY:

K. ANGER

SHEET TITLE

PROPOSED PLAN -
THIRD FLOOR

SHEET NUMBER

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M. FAYAZI

PROJECT MGR:
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APPROVED BY:
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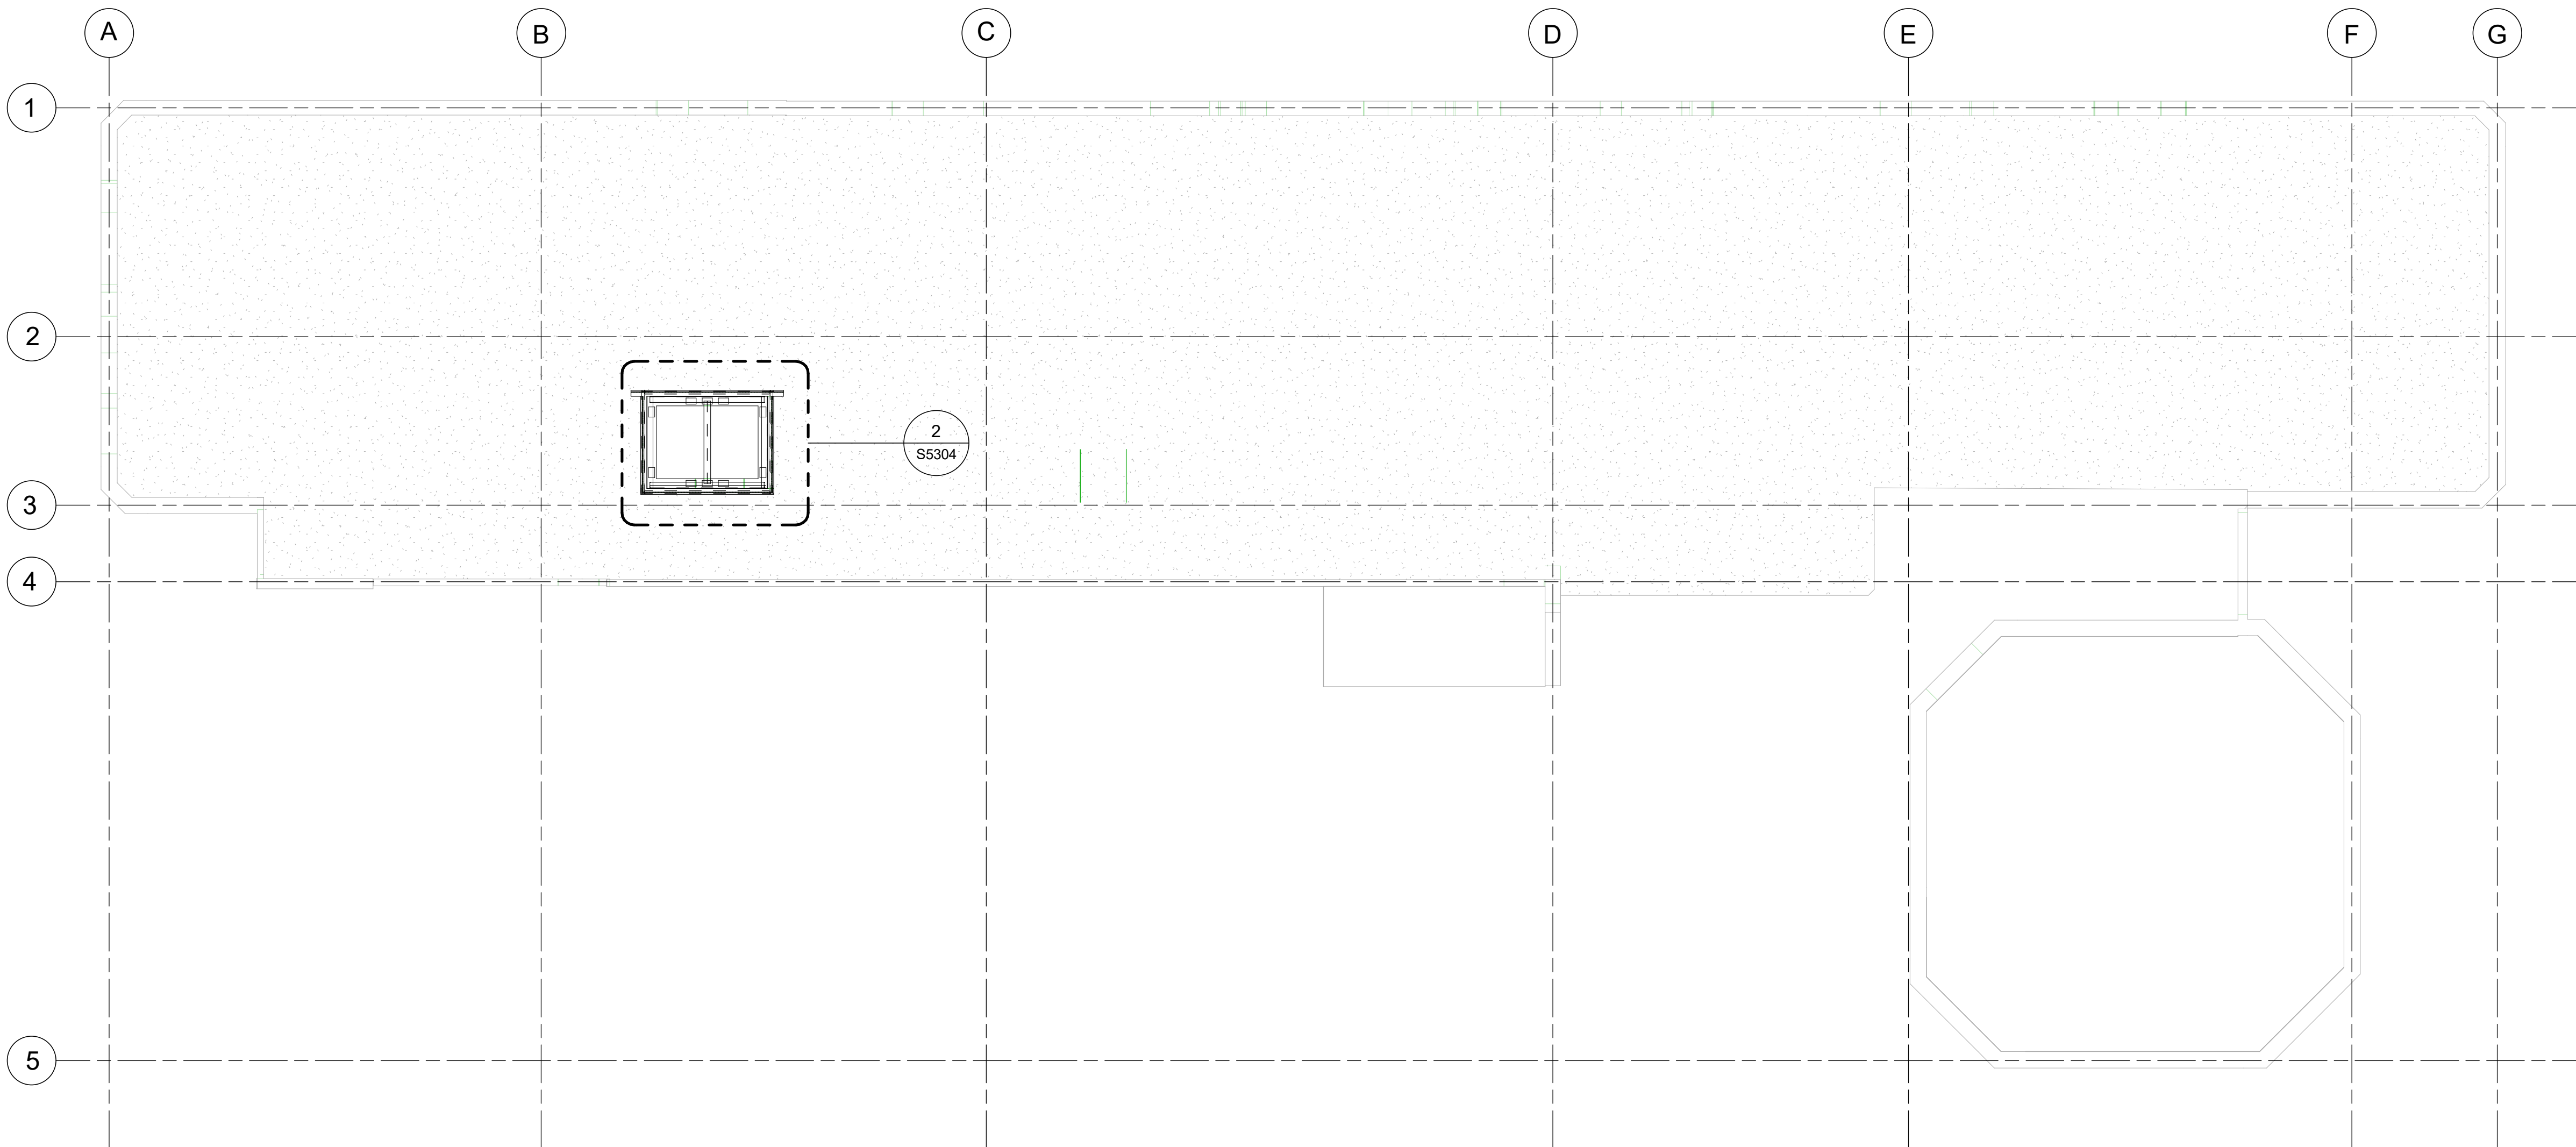
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MECHANICAL FLOOR

SHEET NUMBER


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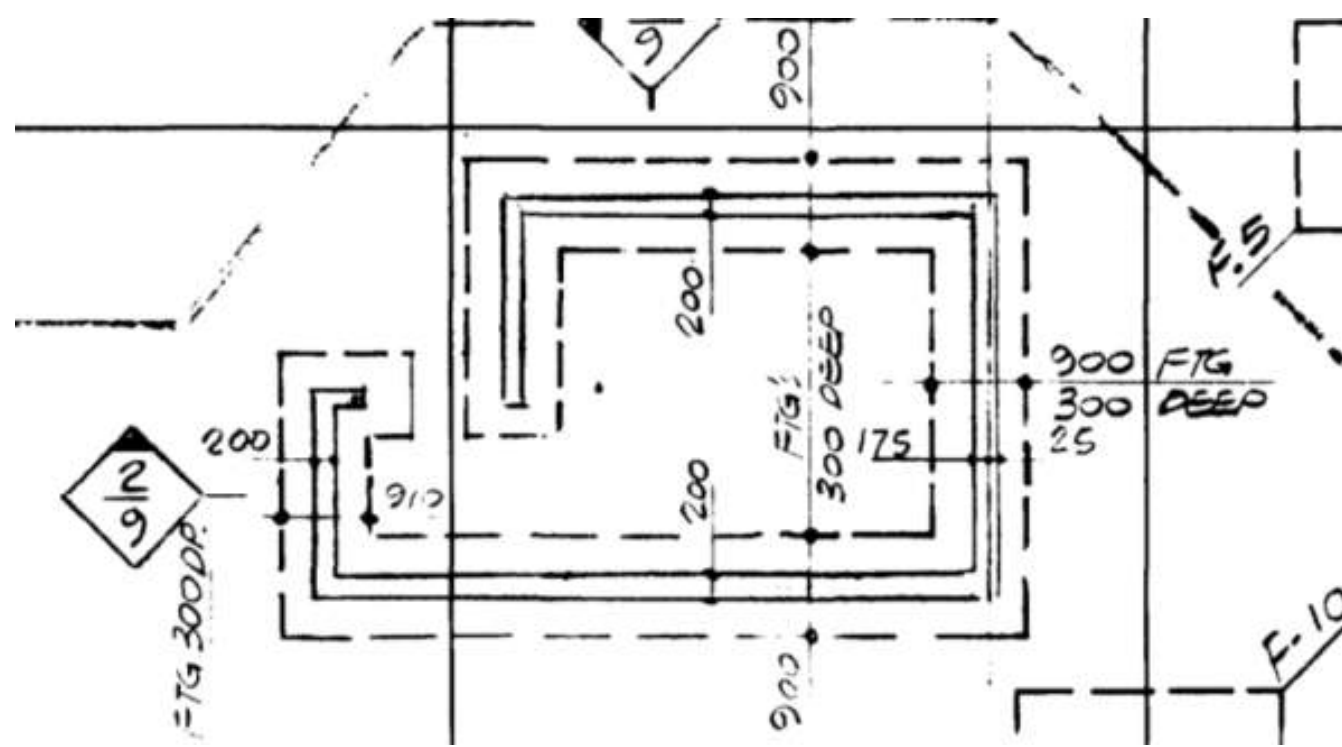
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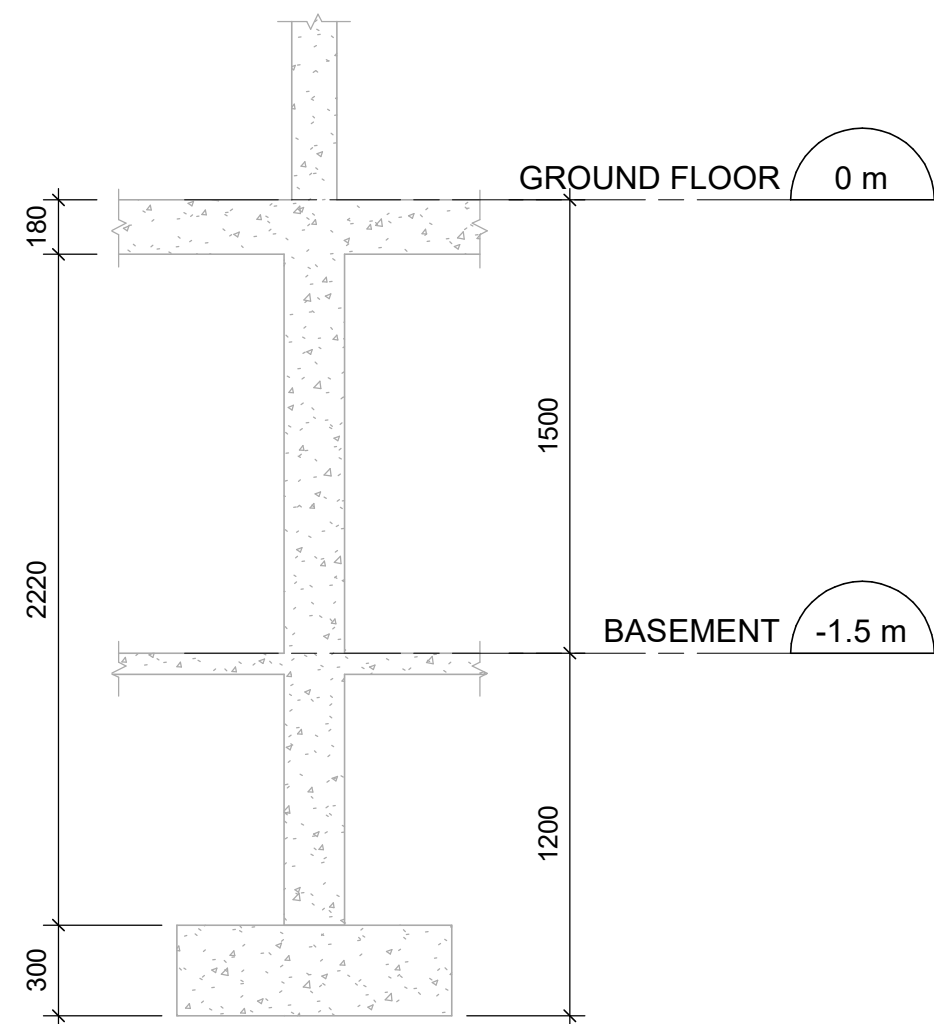


1 PROPOSED PLAN - MECHANICAL FLOOR
S2505 Scale: 1 : 100







6 EXISTING FOUNDATION PLAN
S5301 Scale: 1 : 50

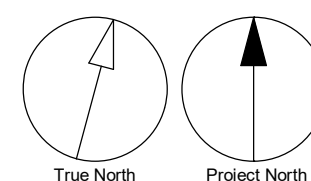


4 EXISTING FOUNDATION ELEVATION
S5301 Scale: 1 : 25

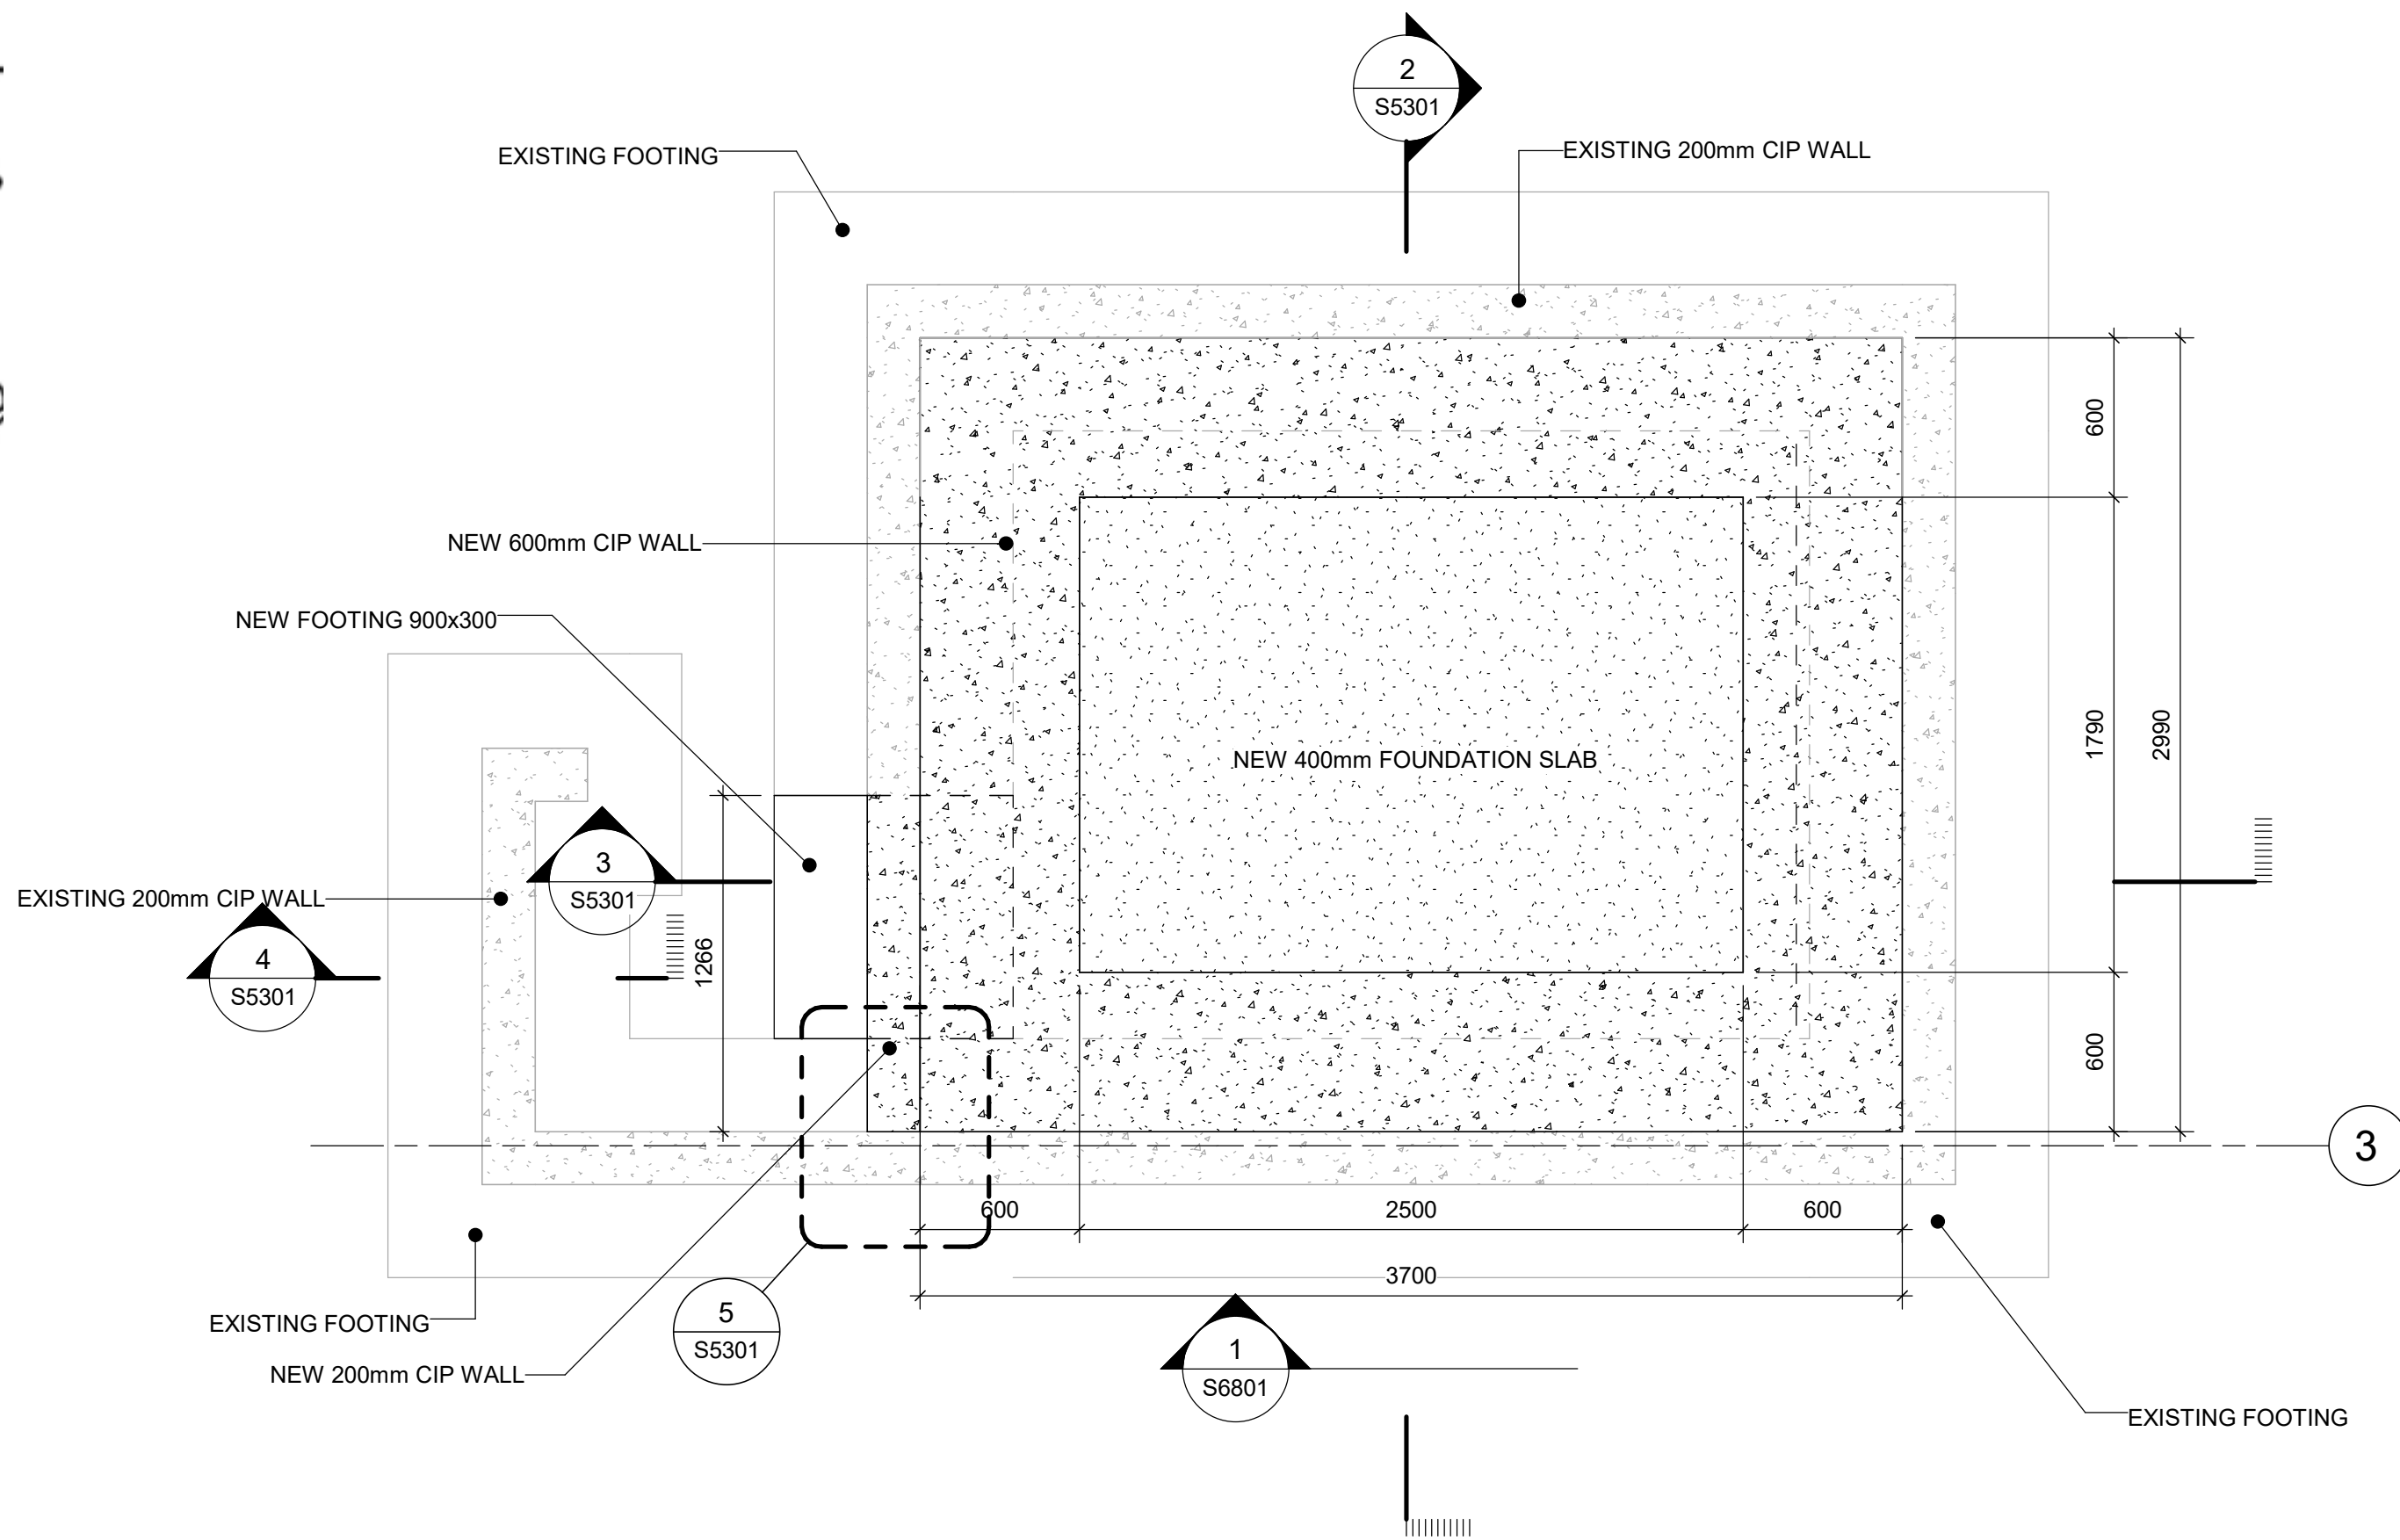

1 PROPOSED PLAN - FOUNDATION
S5301 Scale: 1 : 25

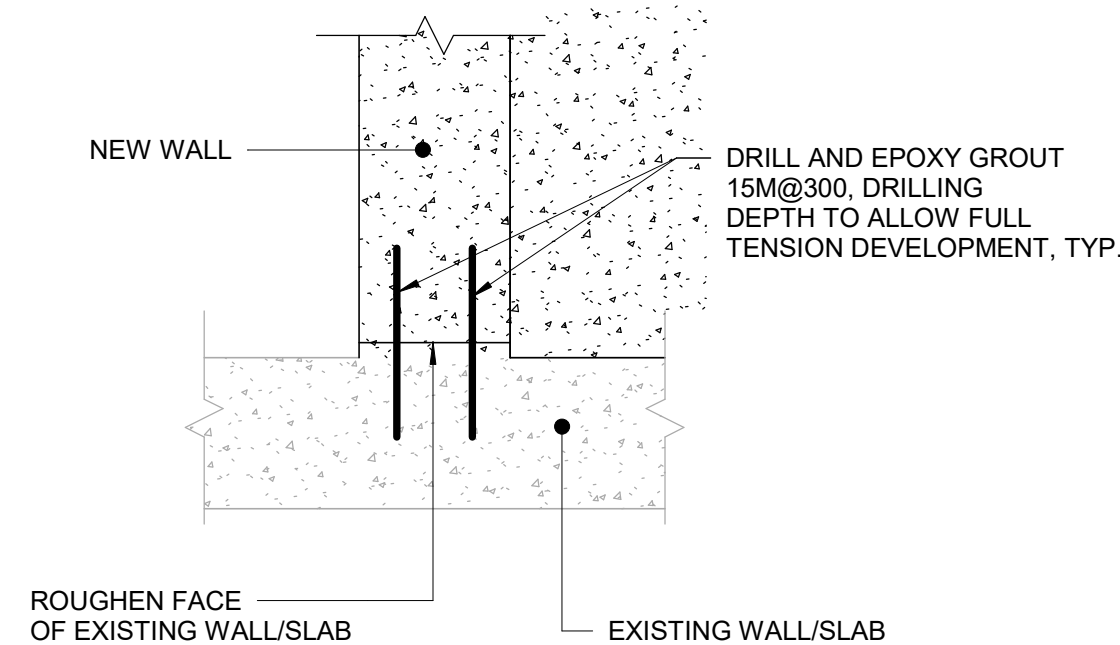


5 DETAIL 1-ELEVATOR PIT - FOUNDATION WALLS CONNECTION DETAIL
S5301 Scale: 1 : 10

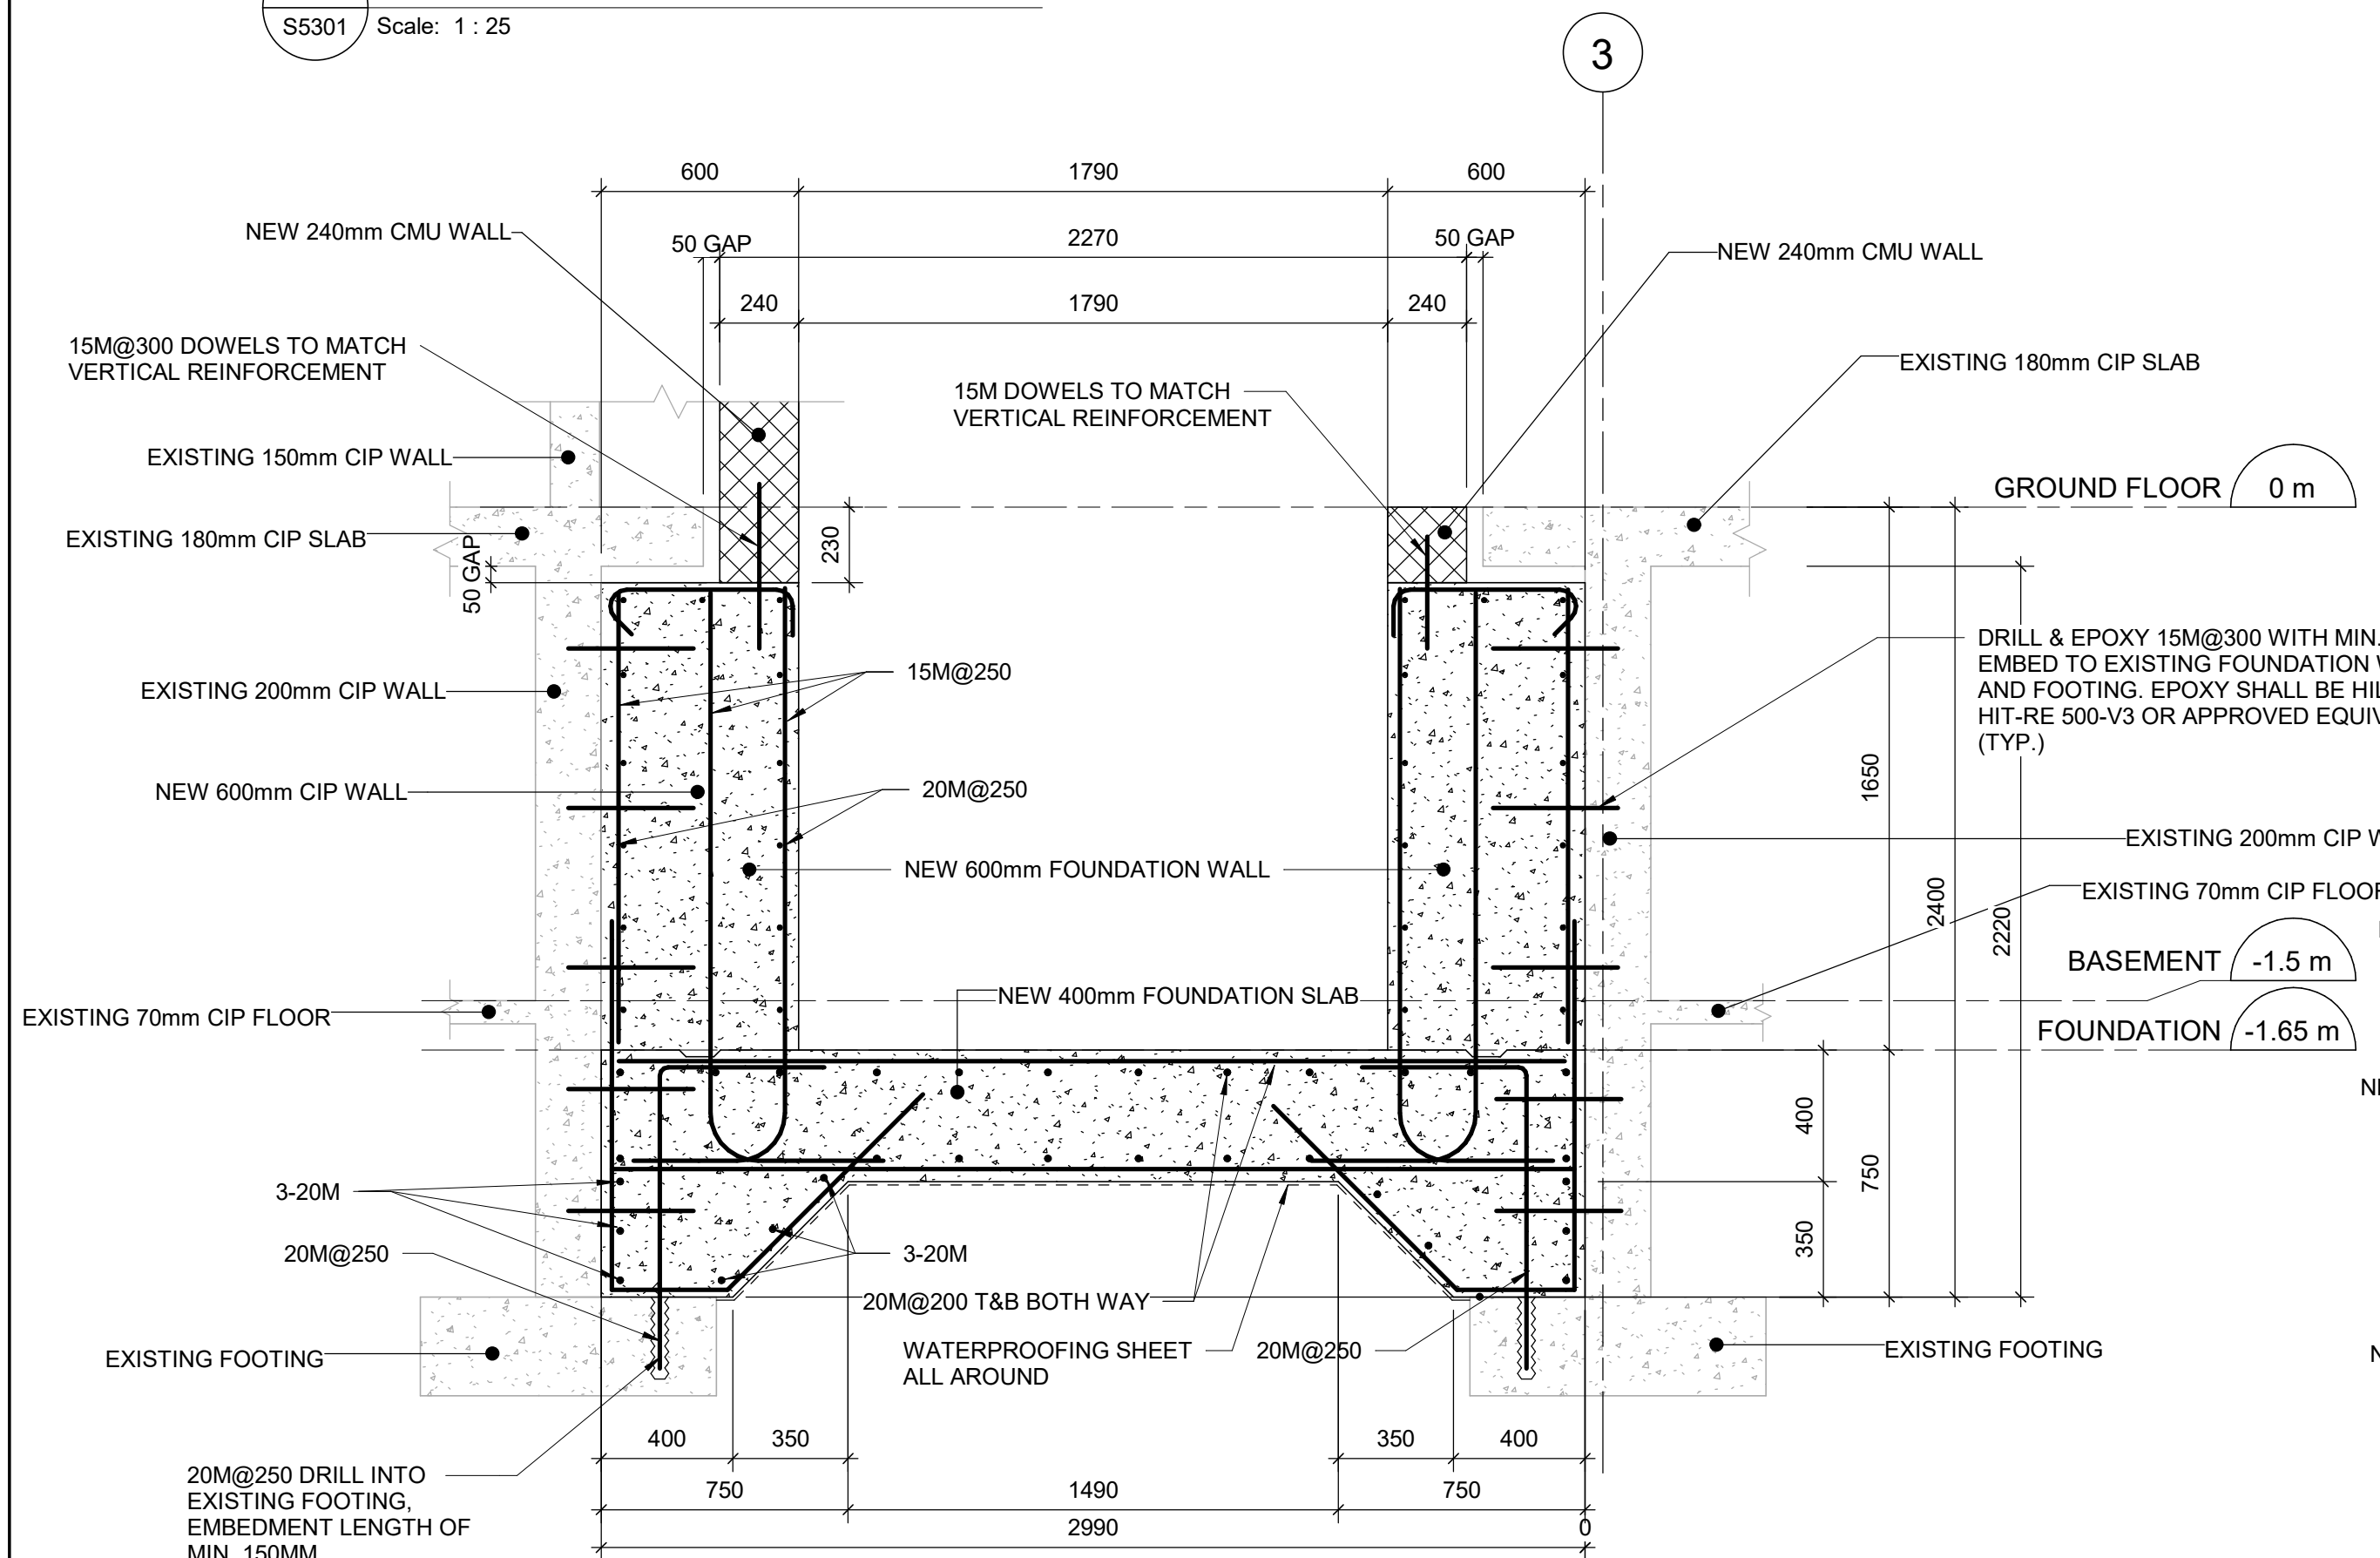


2 SECTION
S5301 Scale: 1 : 20

- NOTE:
- CONTRACTOR TO VERIFY MINIMUM SOIL BEARING CAPACITY AT SLS 200 KPA
 - TEMPORARY SHORING TO BE PROVIDED BY CONTRACTOR FOR THE EXISTING WALLS AND FOUNDATION WALL
 - CONTRACTOR TO VERIFY SITE CONDITION

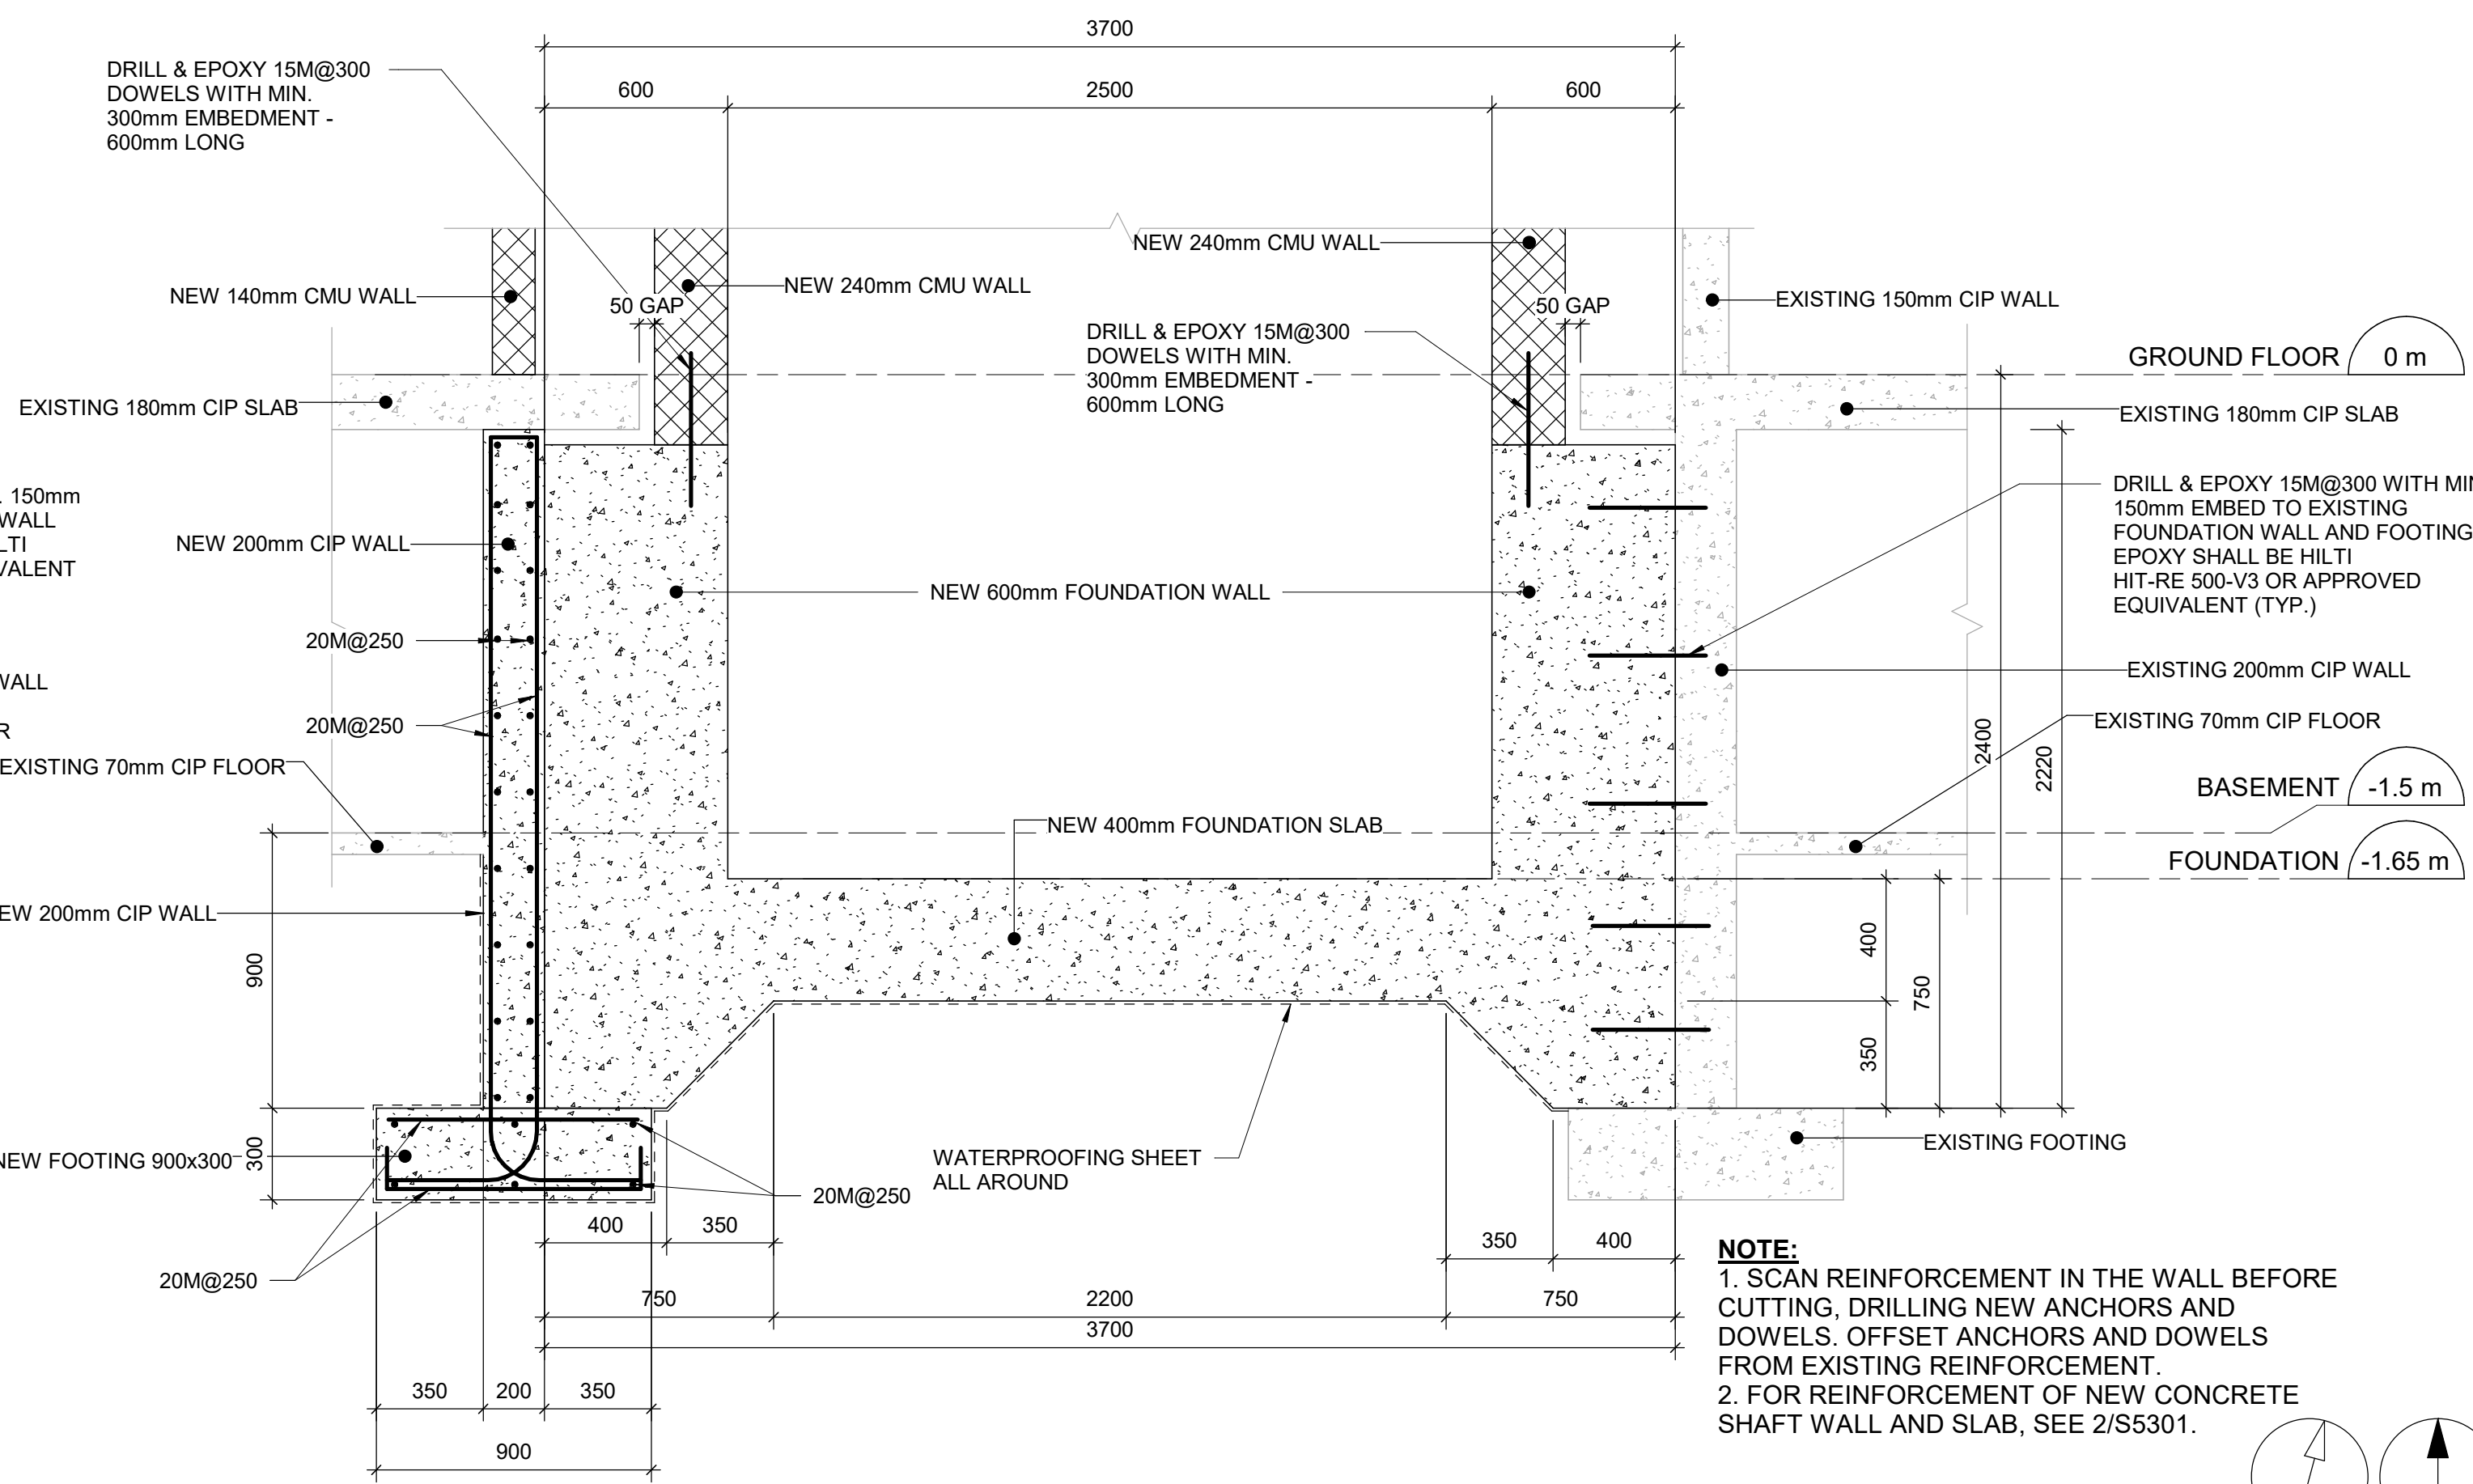

3 SECTION
S5301 Scale: 1 : 20

NOTE:
1. SCAN REINFORCEMENT IN THE WALL BEFORE CUTTING, DRILLING NEW ANCHORS AND DOWELS. OFFSET ANCHORS AND DOWELS FROM EXISTING REINFORCEMENT.
2. FOR REINFORCEMENT OF NEW CONCRETE SHAFT WALL AND SLAB, SEE 2/S5301.

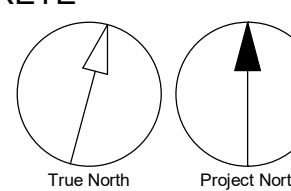

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D	ISSUED FOR TENDER	2022-12-07
E	ISSUED FOR TENDER	2025-04-11

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PROJECT TITLE
**CITY OF TORONTO
ACCESSIBILITY UPGRADES**

PROJECT ADDRESS

**POLICE NO. 33 DIVISION
50 UPJOHN RD**

PROJECT NO:
Arcadis 30279056

DRAWN BY:
L. CHATZIGIANNAKOS

CHECKED BY:
M. FAYAZI

PROJECT MGR:
F. BOLOURIAN

APPROVED BY:
K. ANGER

SHEET TITLE








**ELEVATOR -
FOUNDATION**

SHEET NUMBER

S5301


ISSUE

E

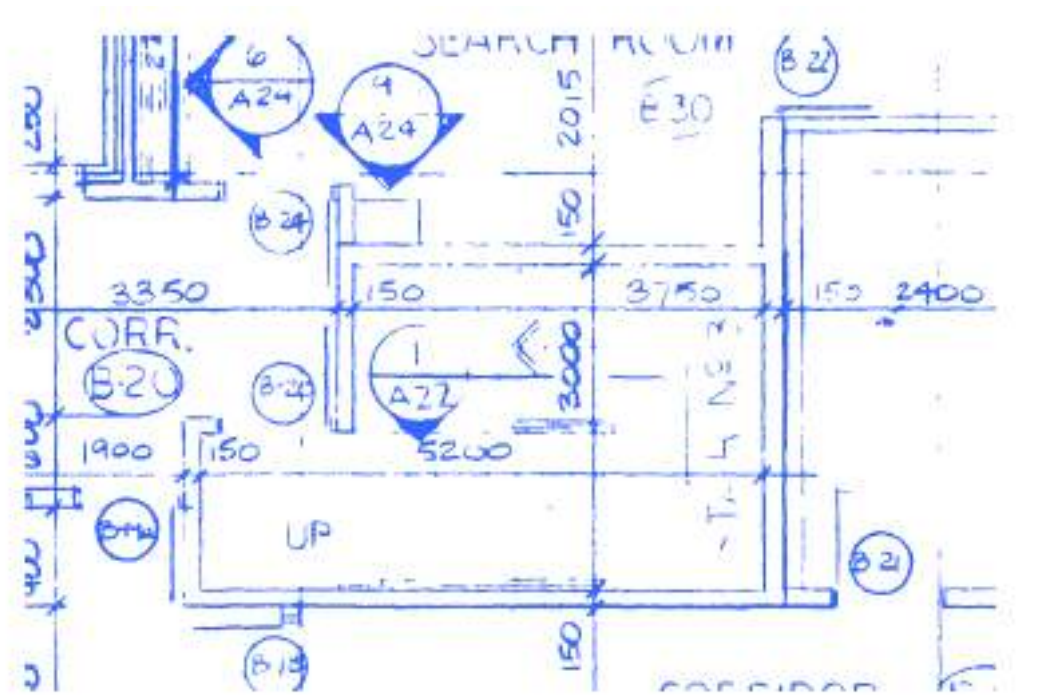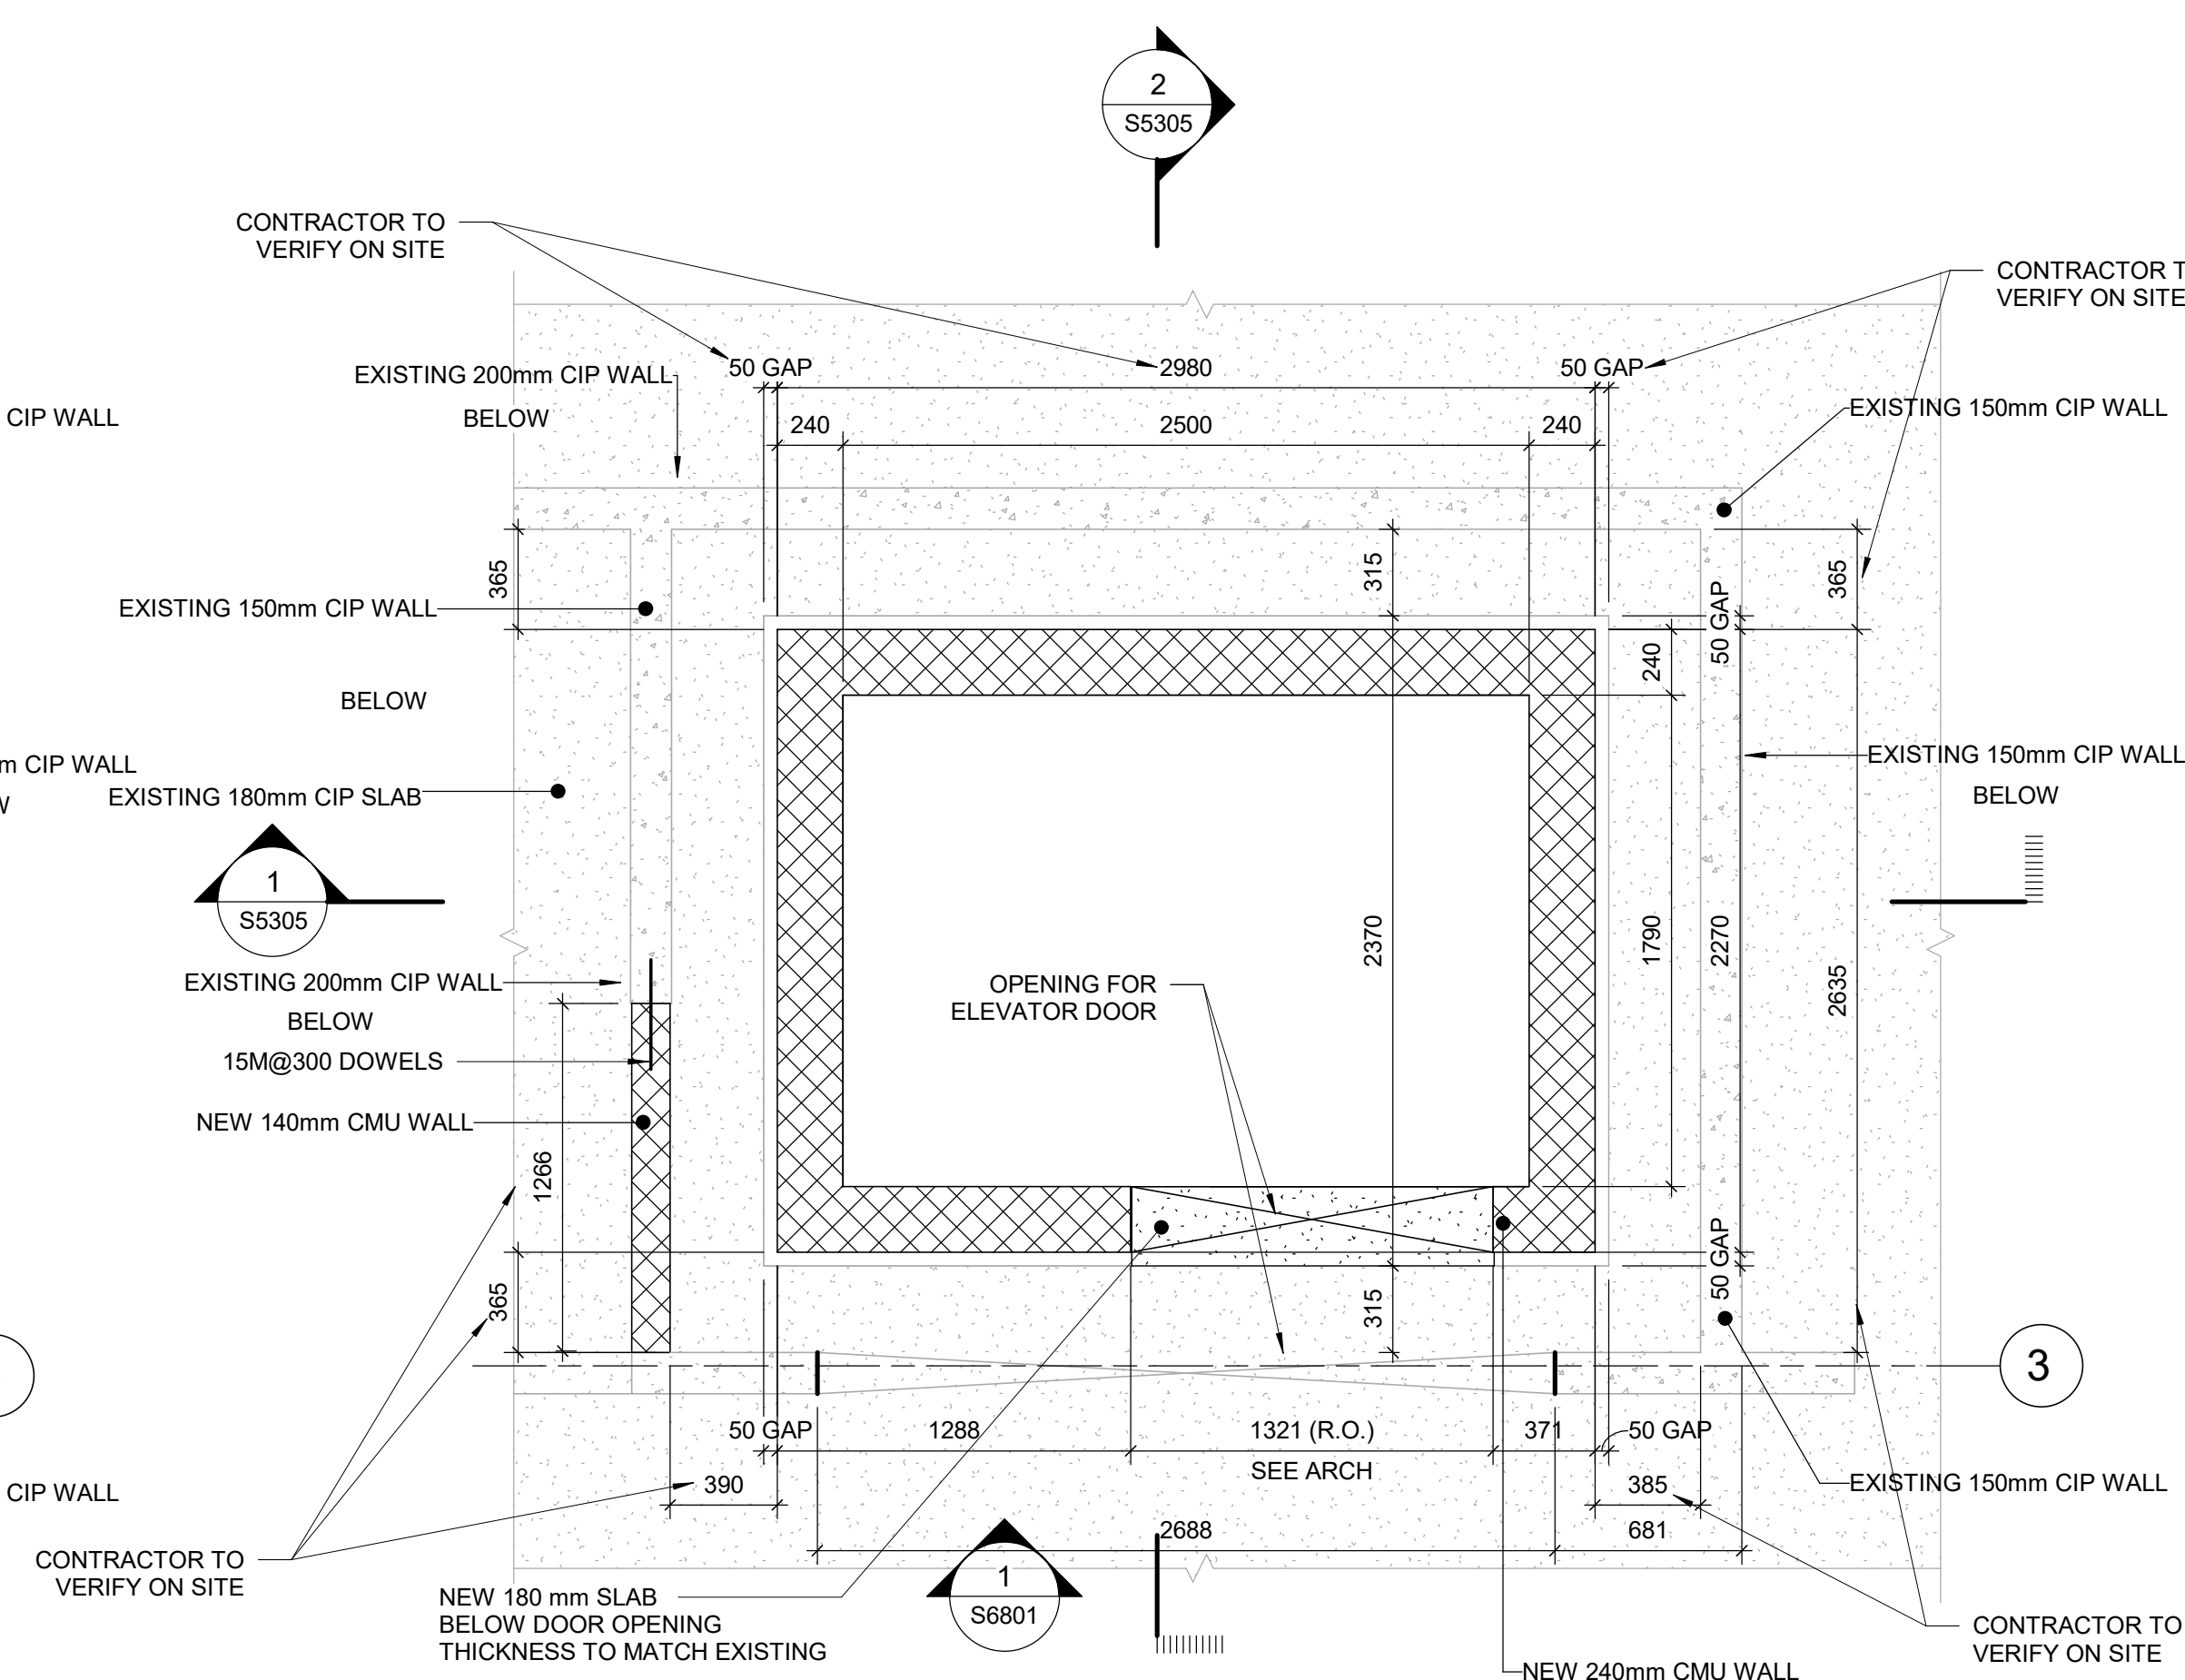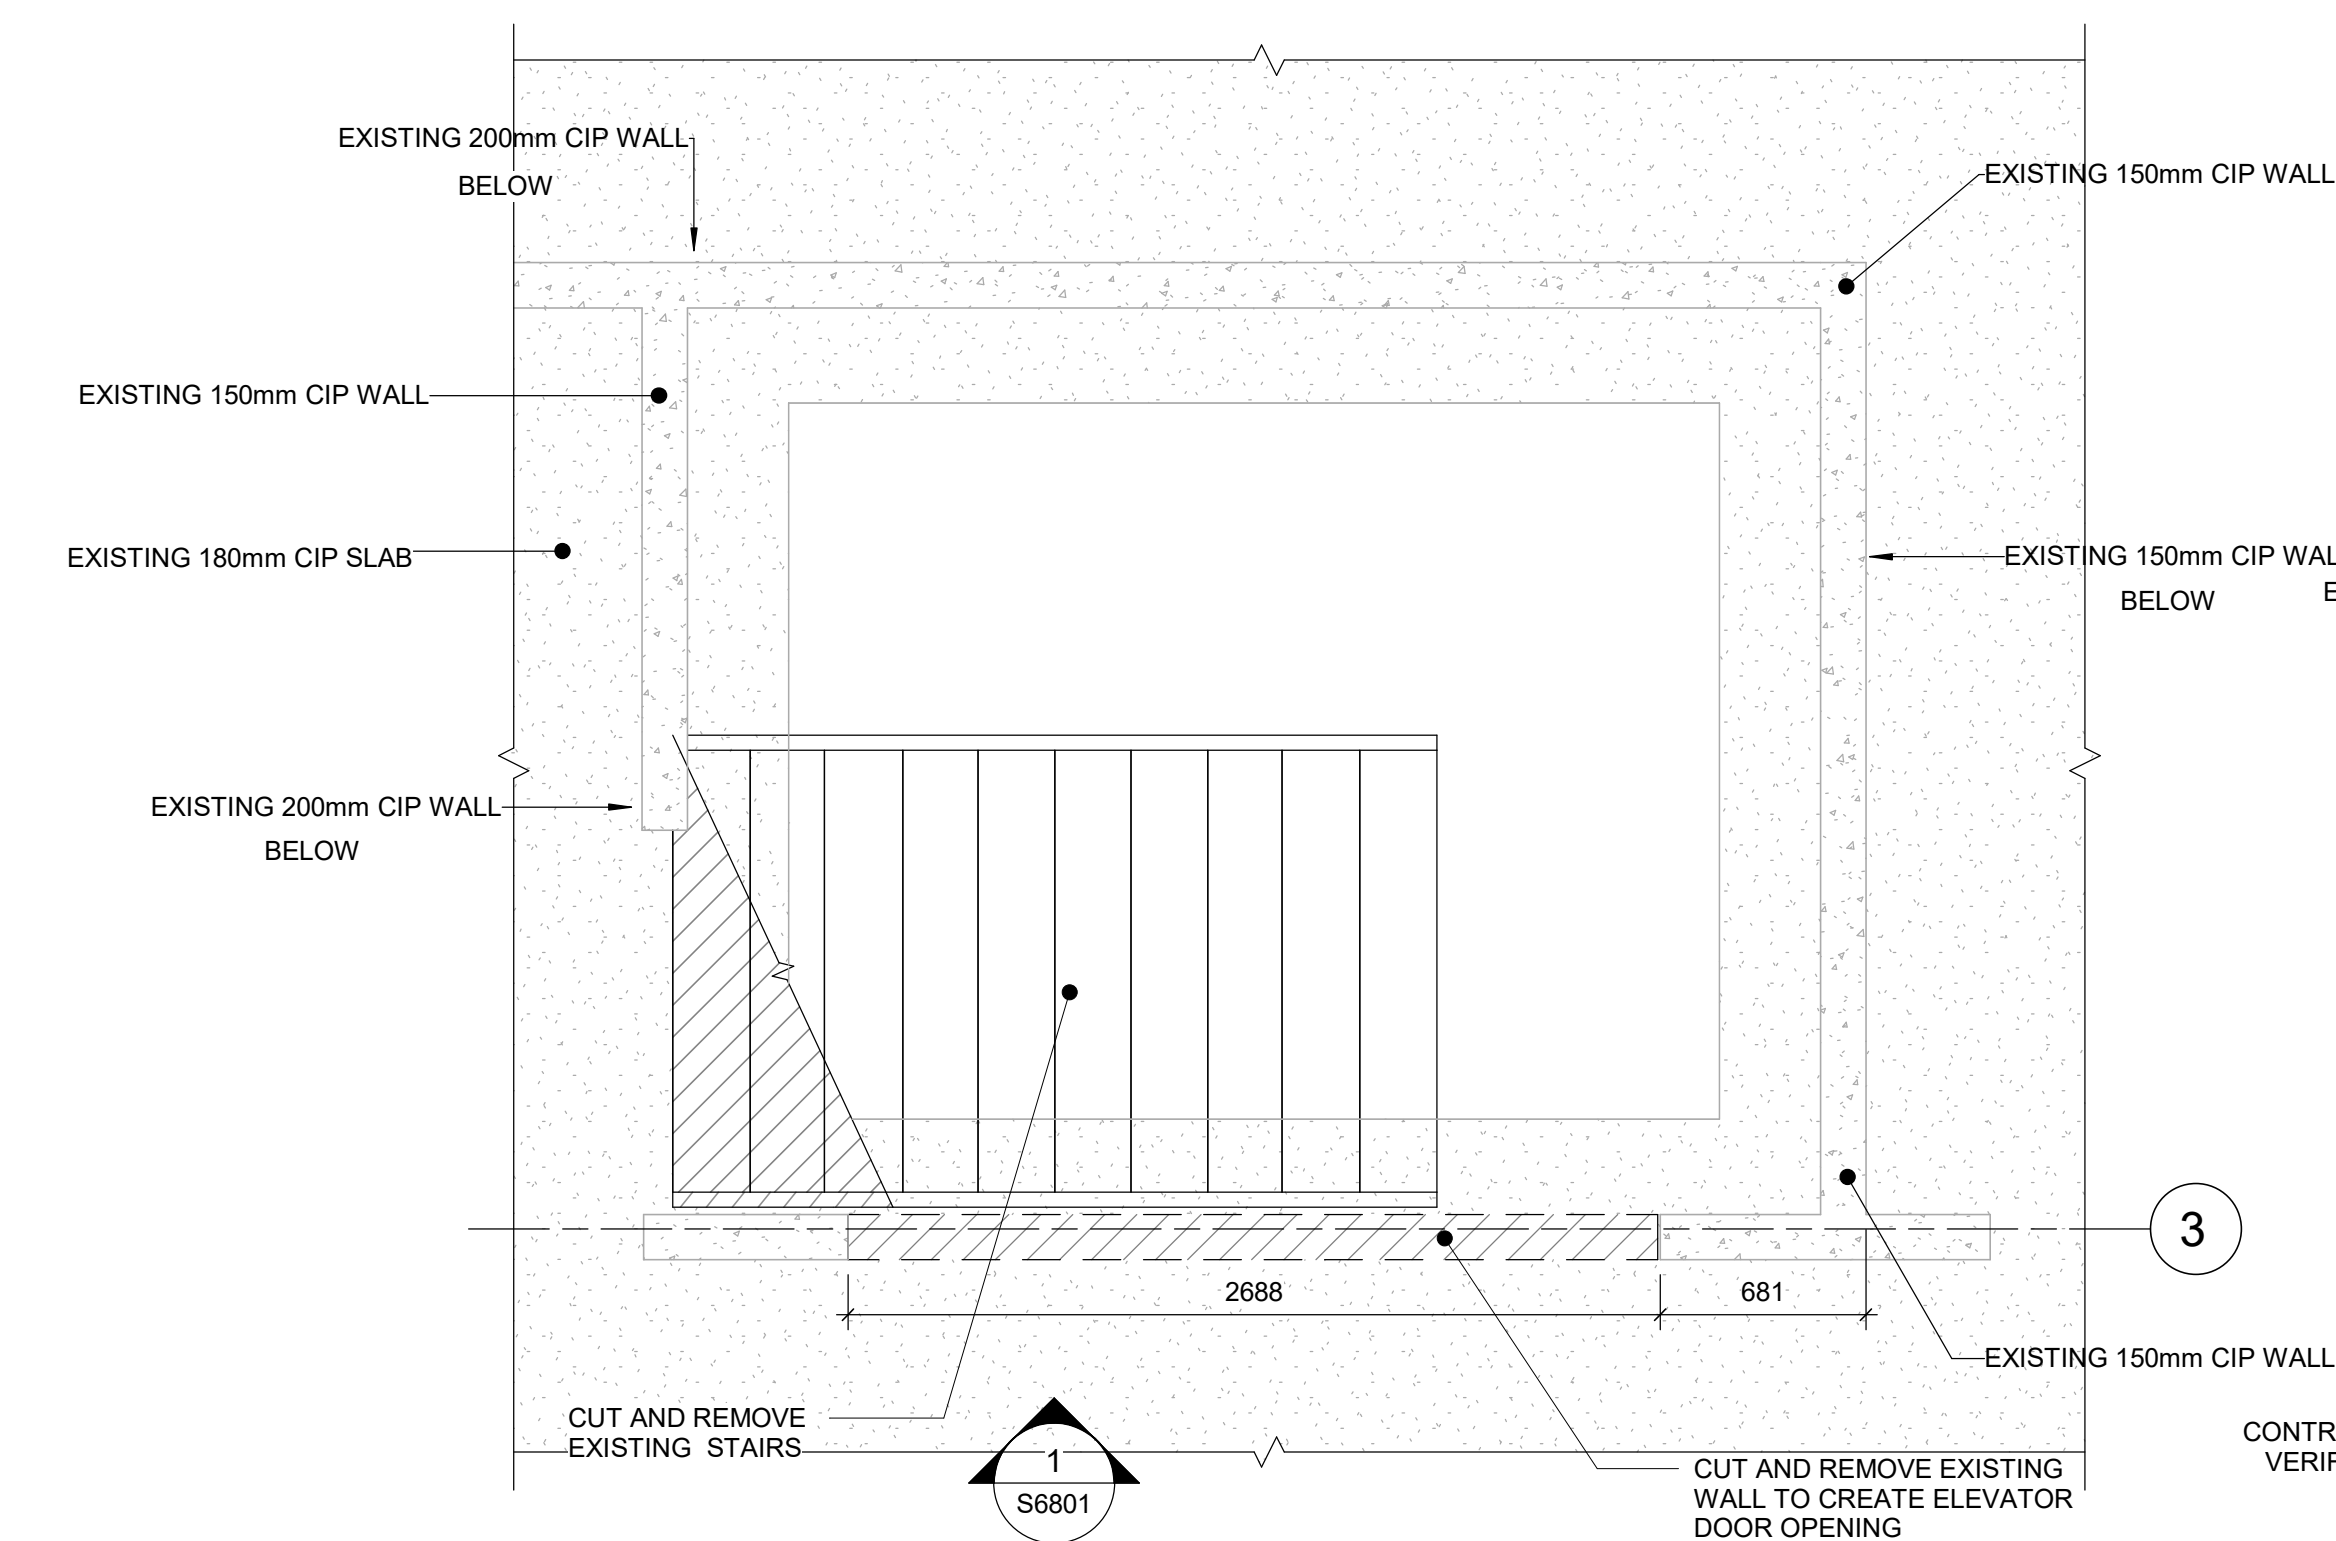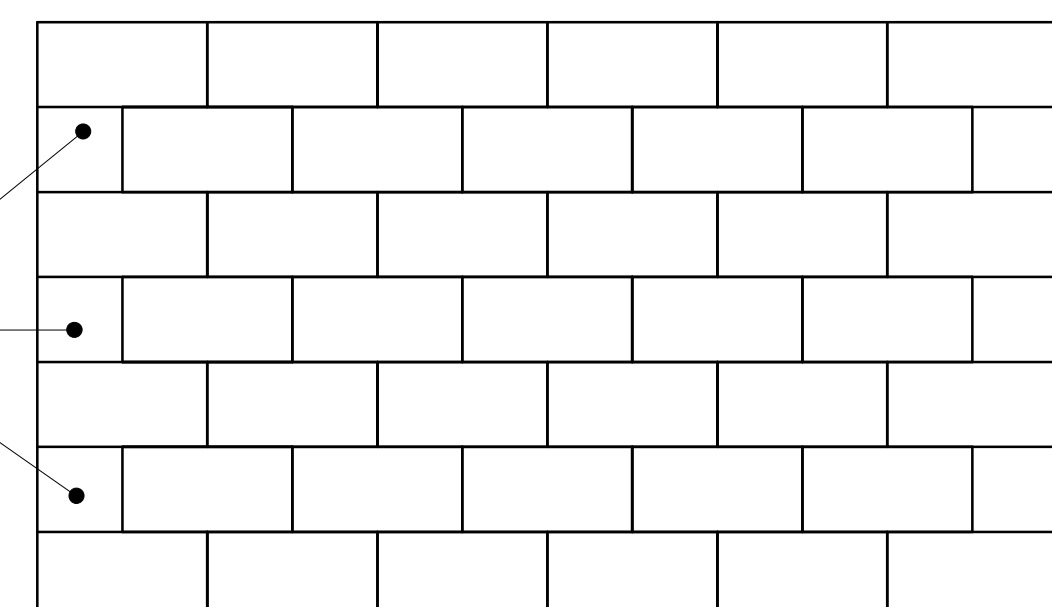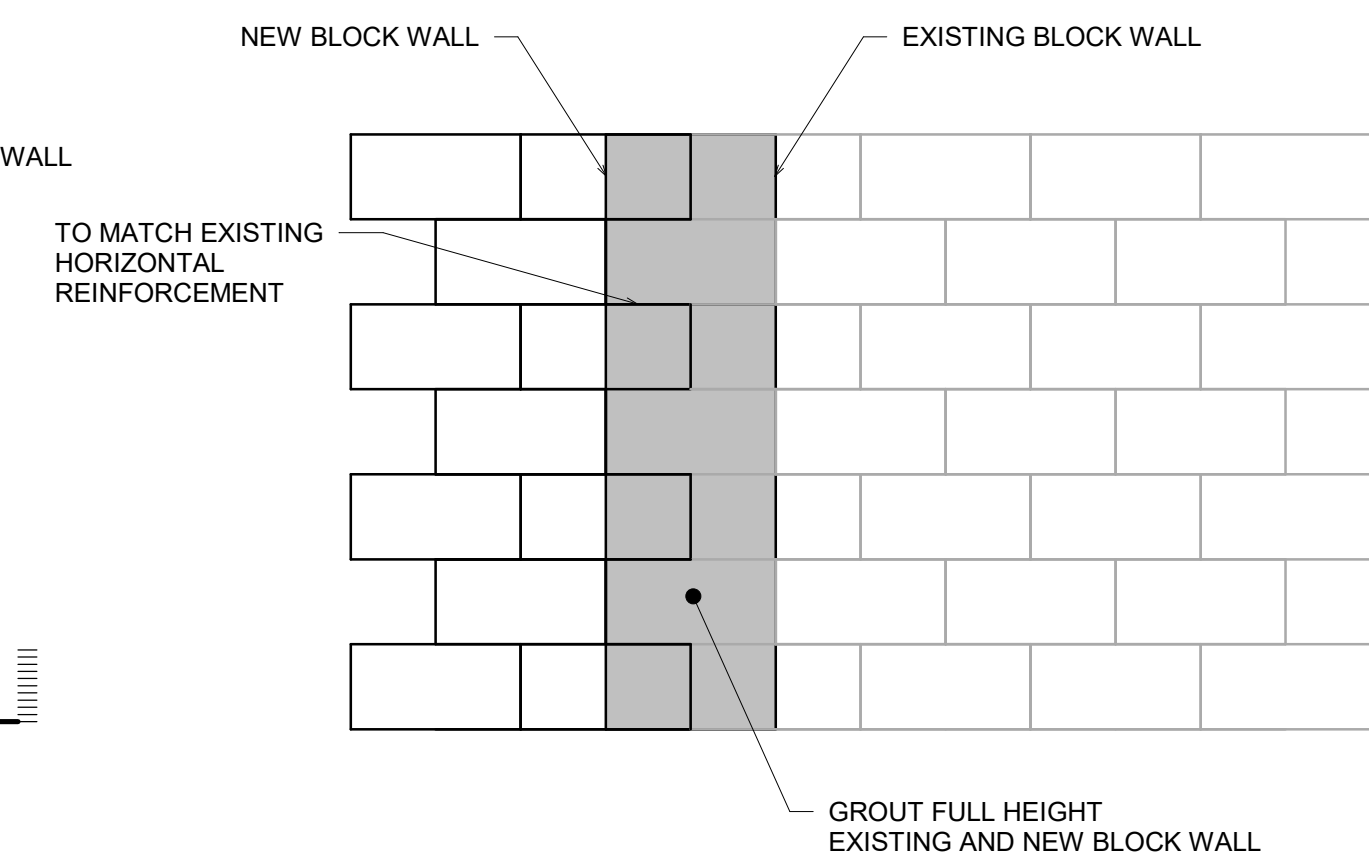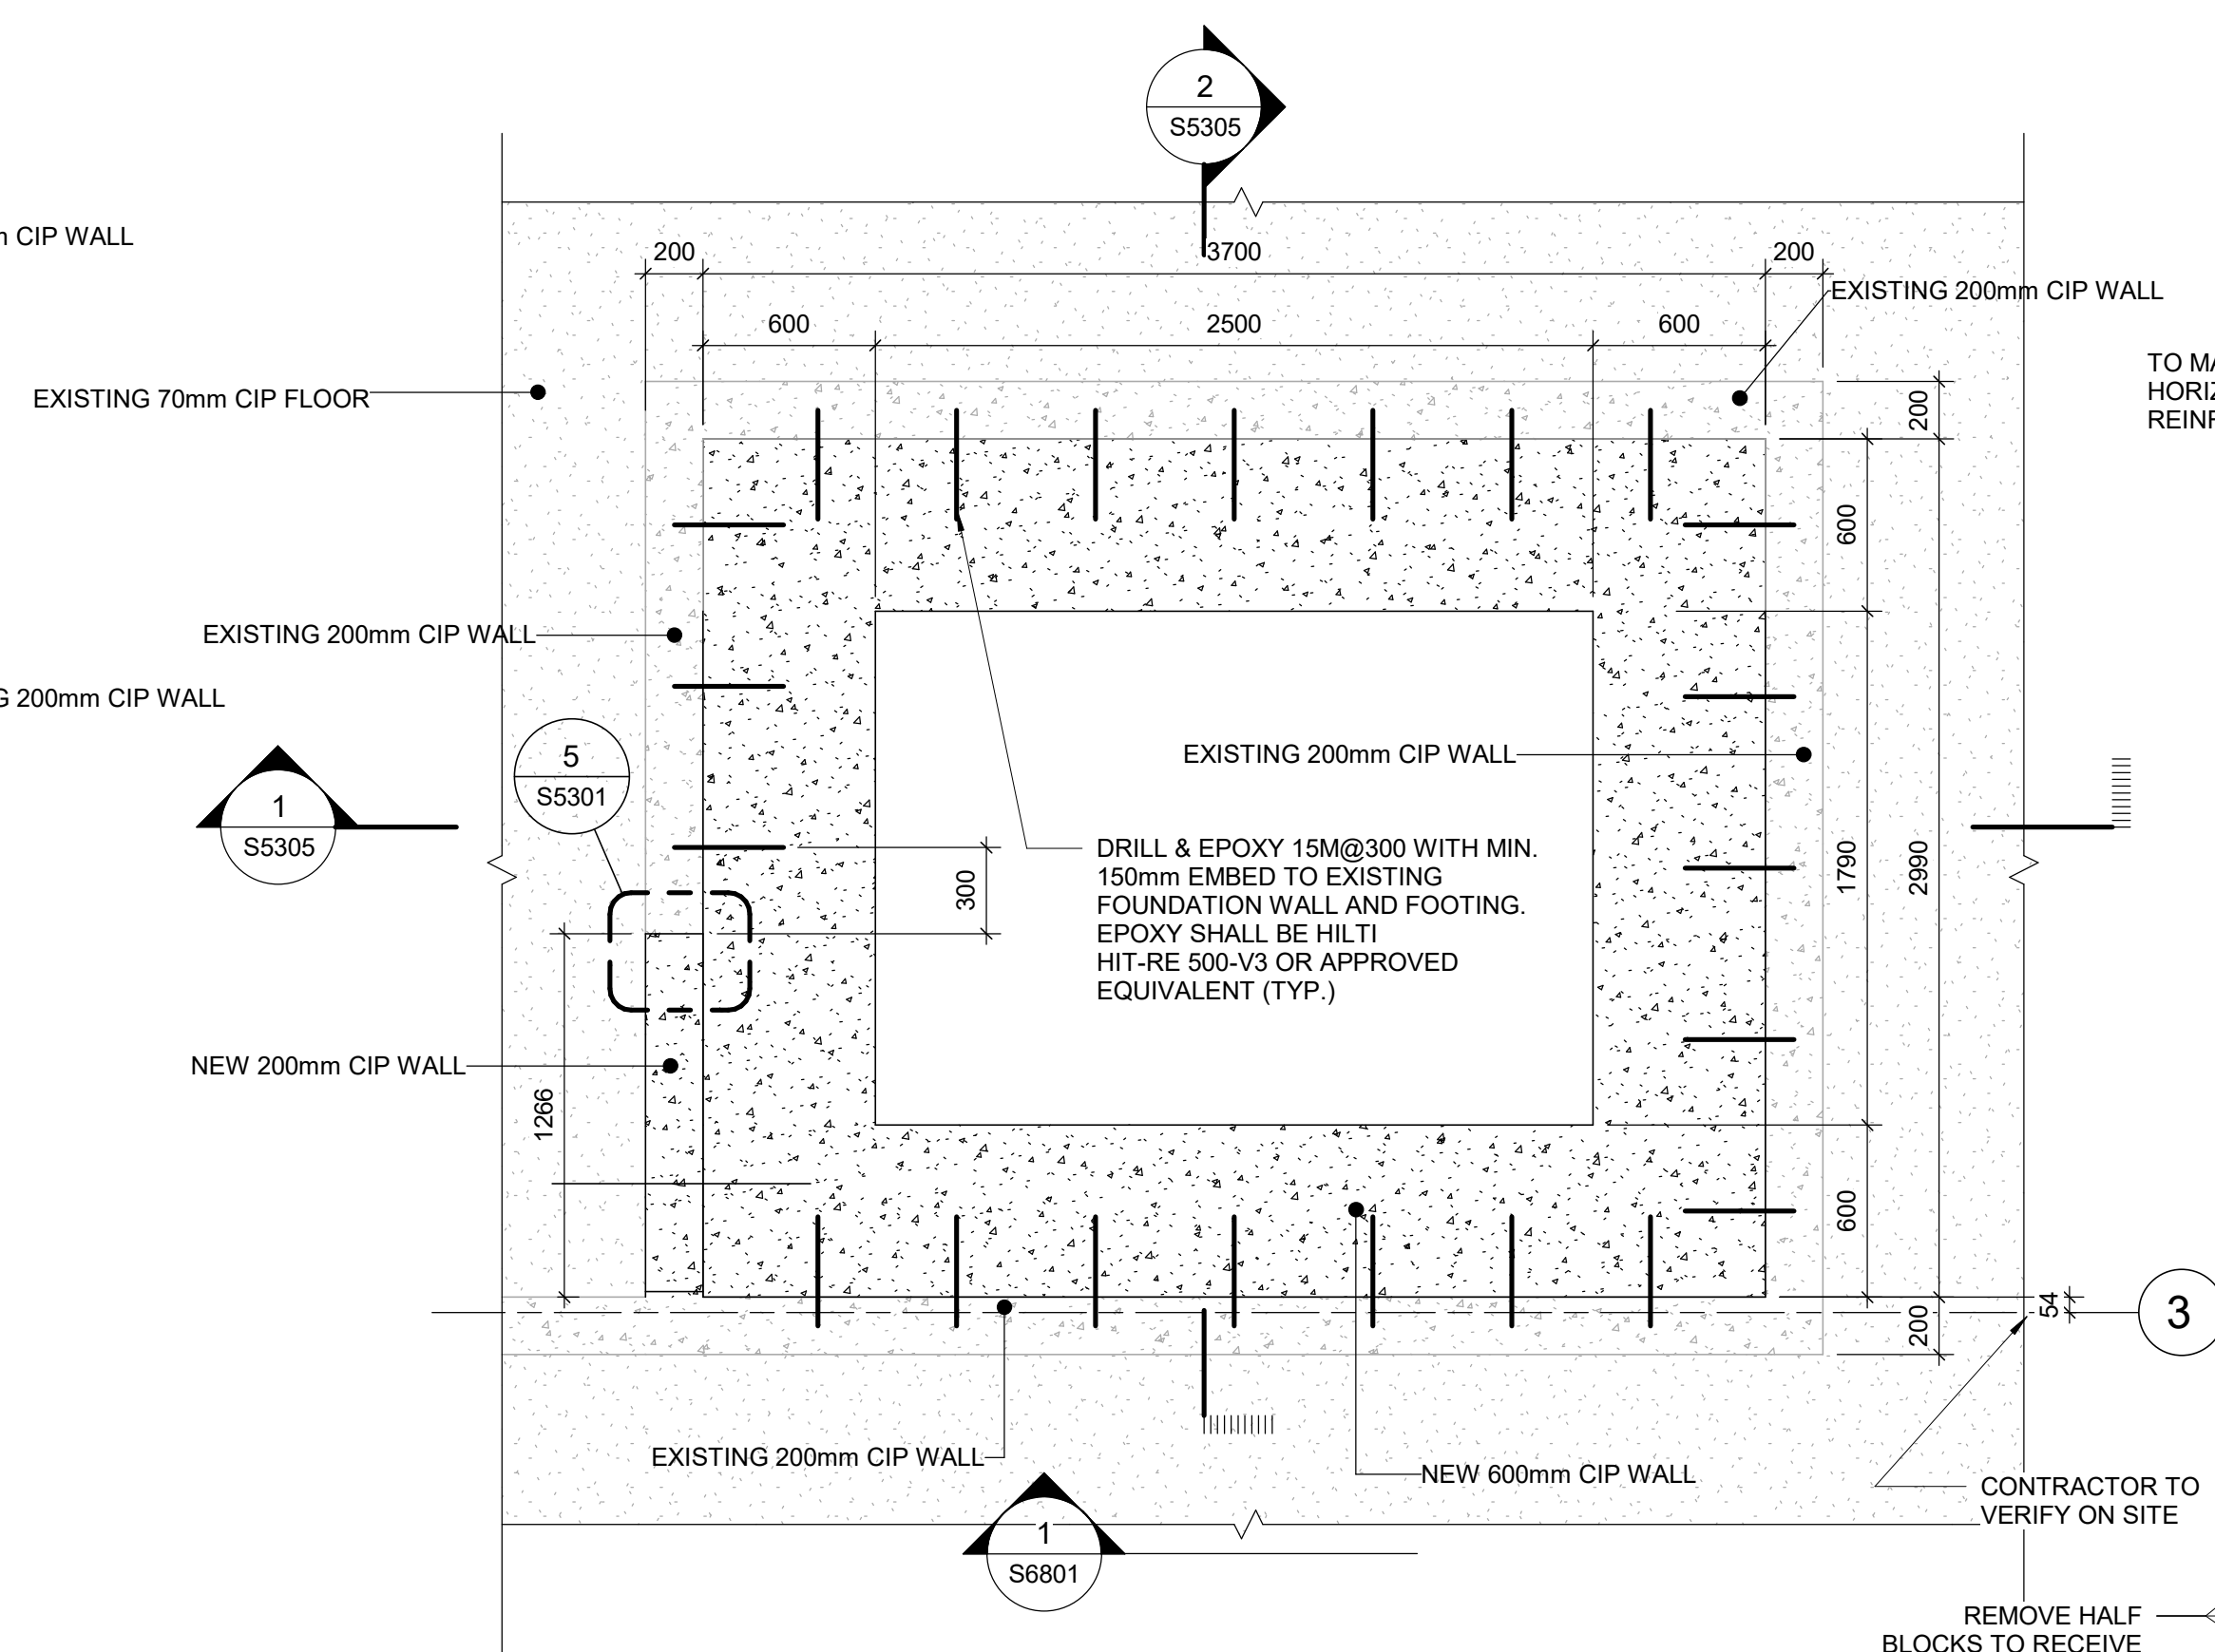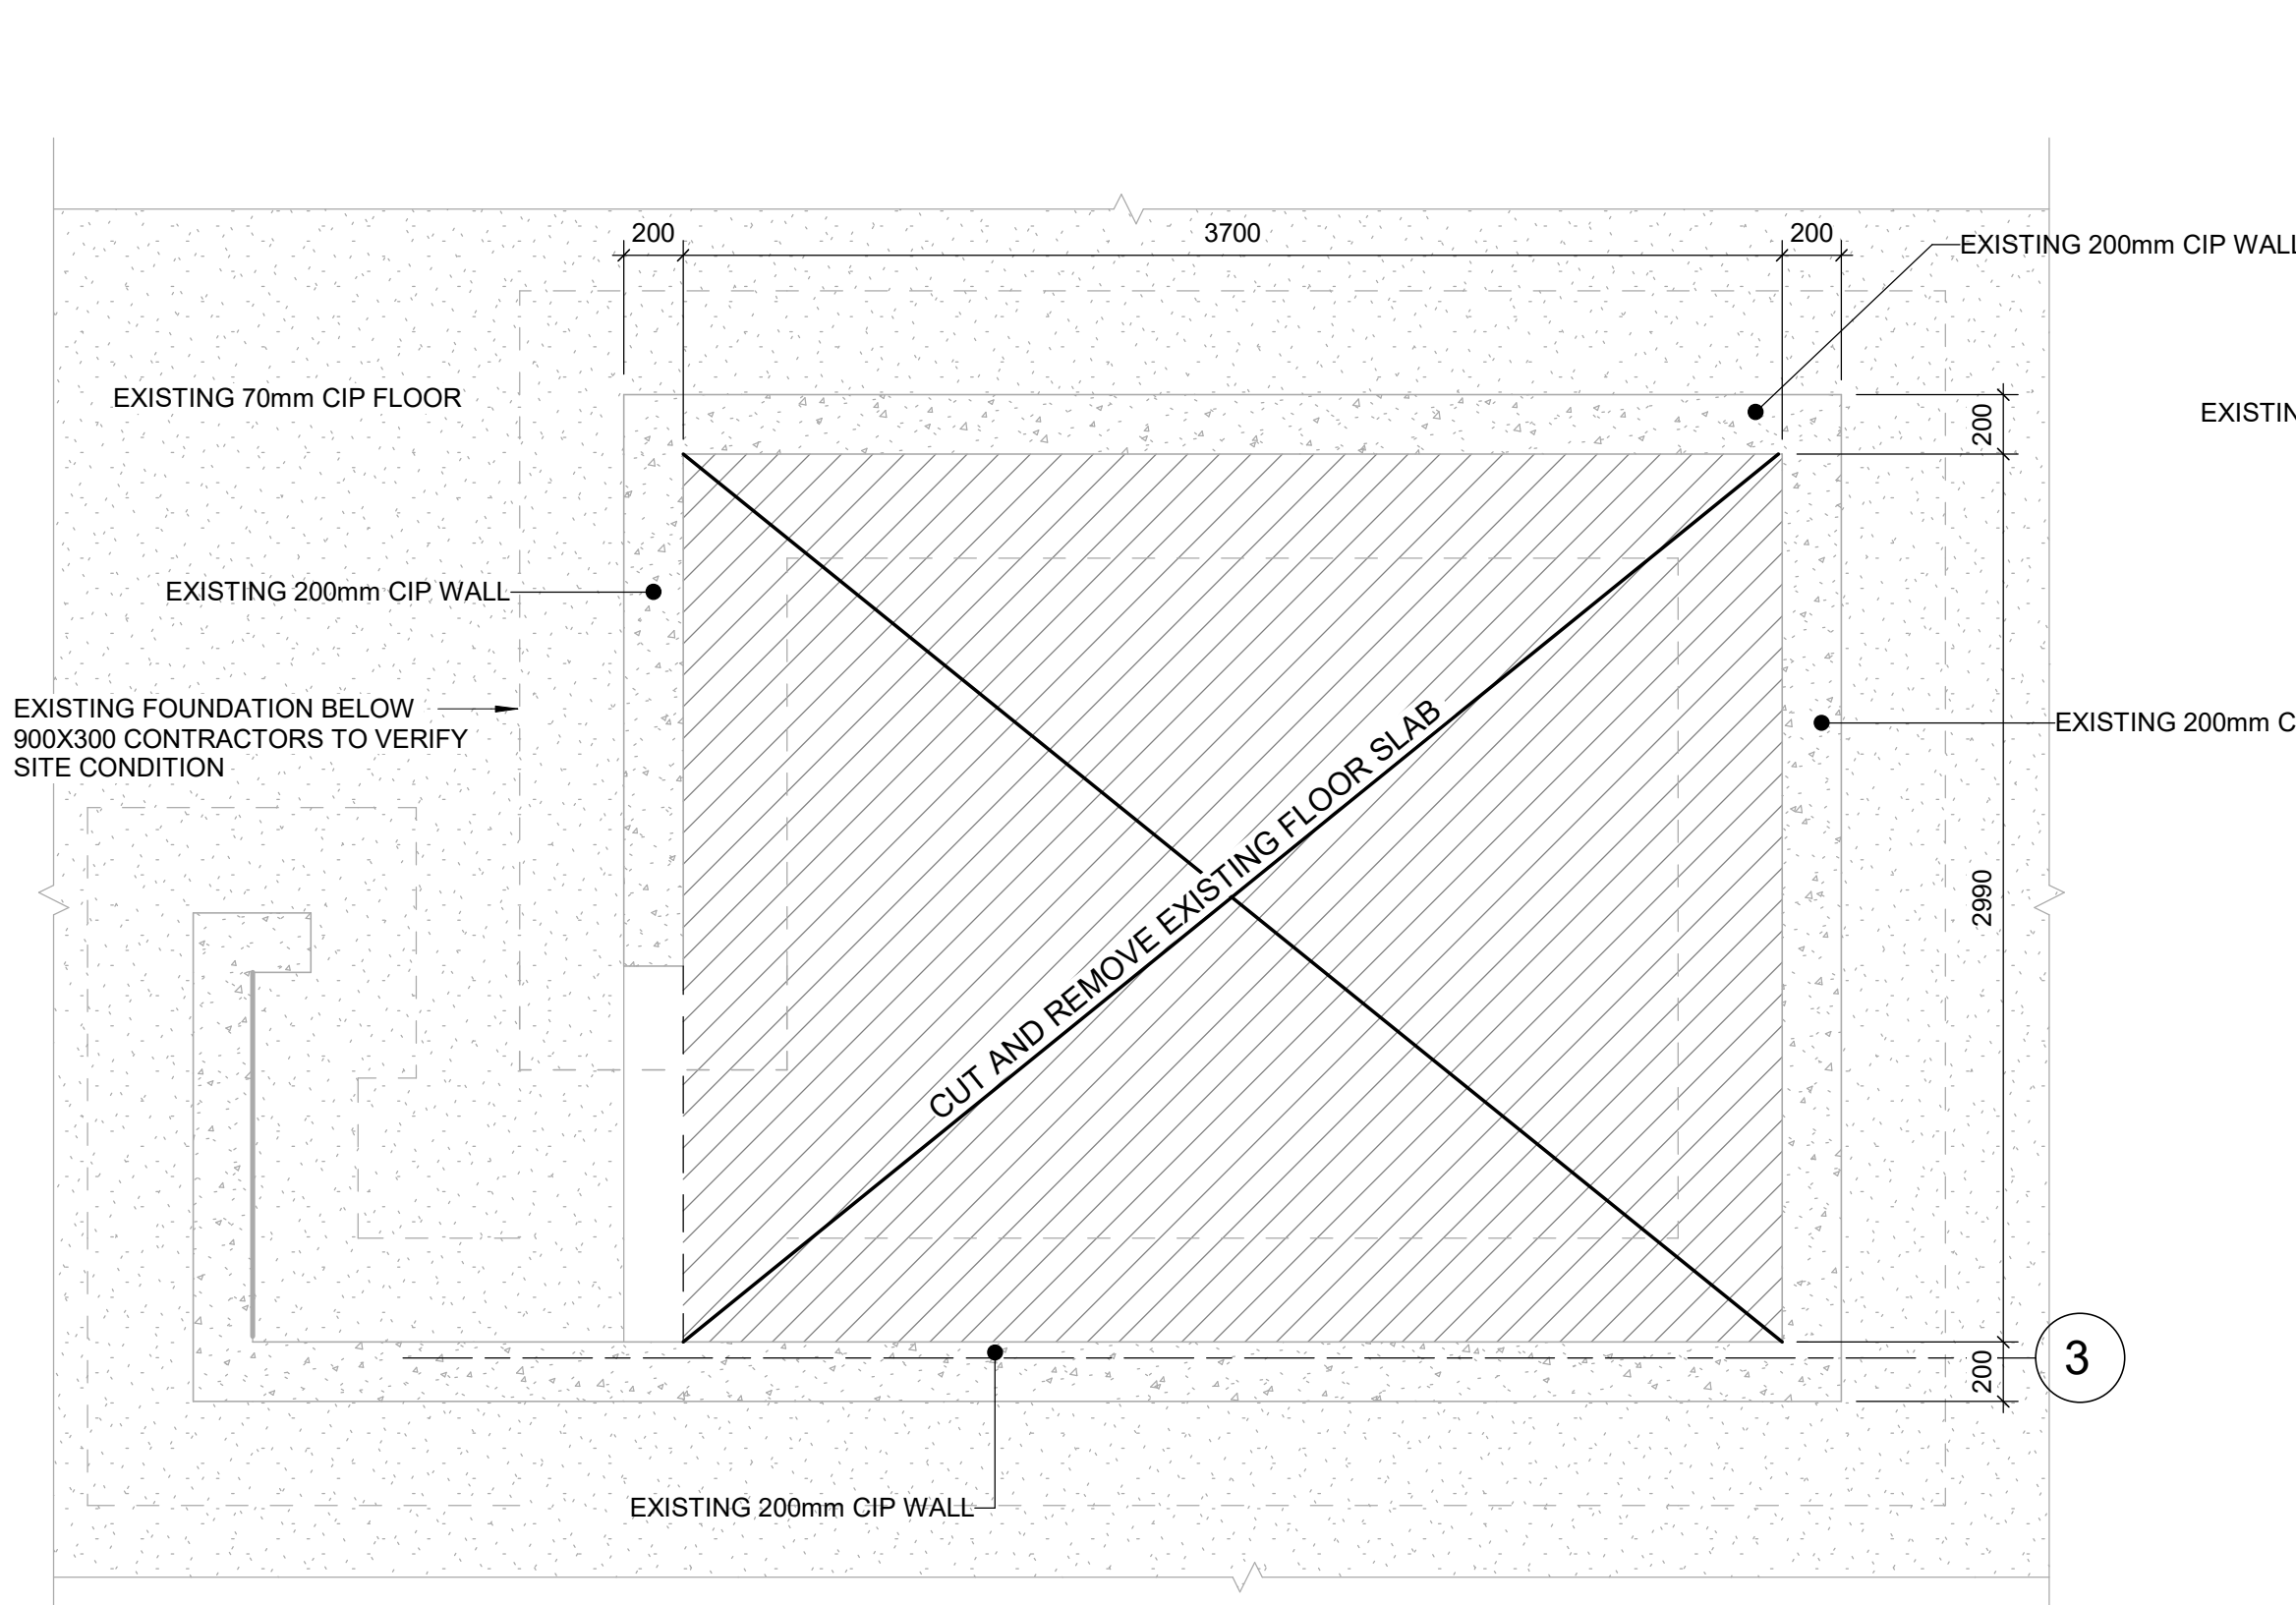


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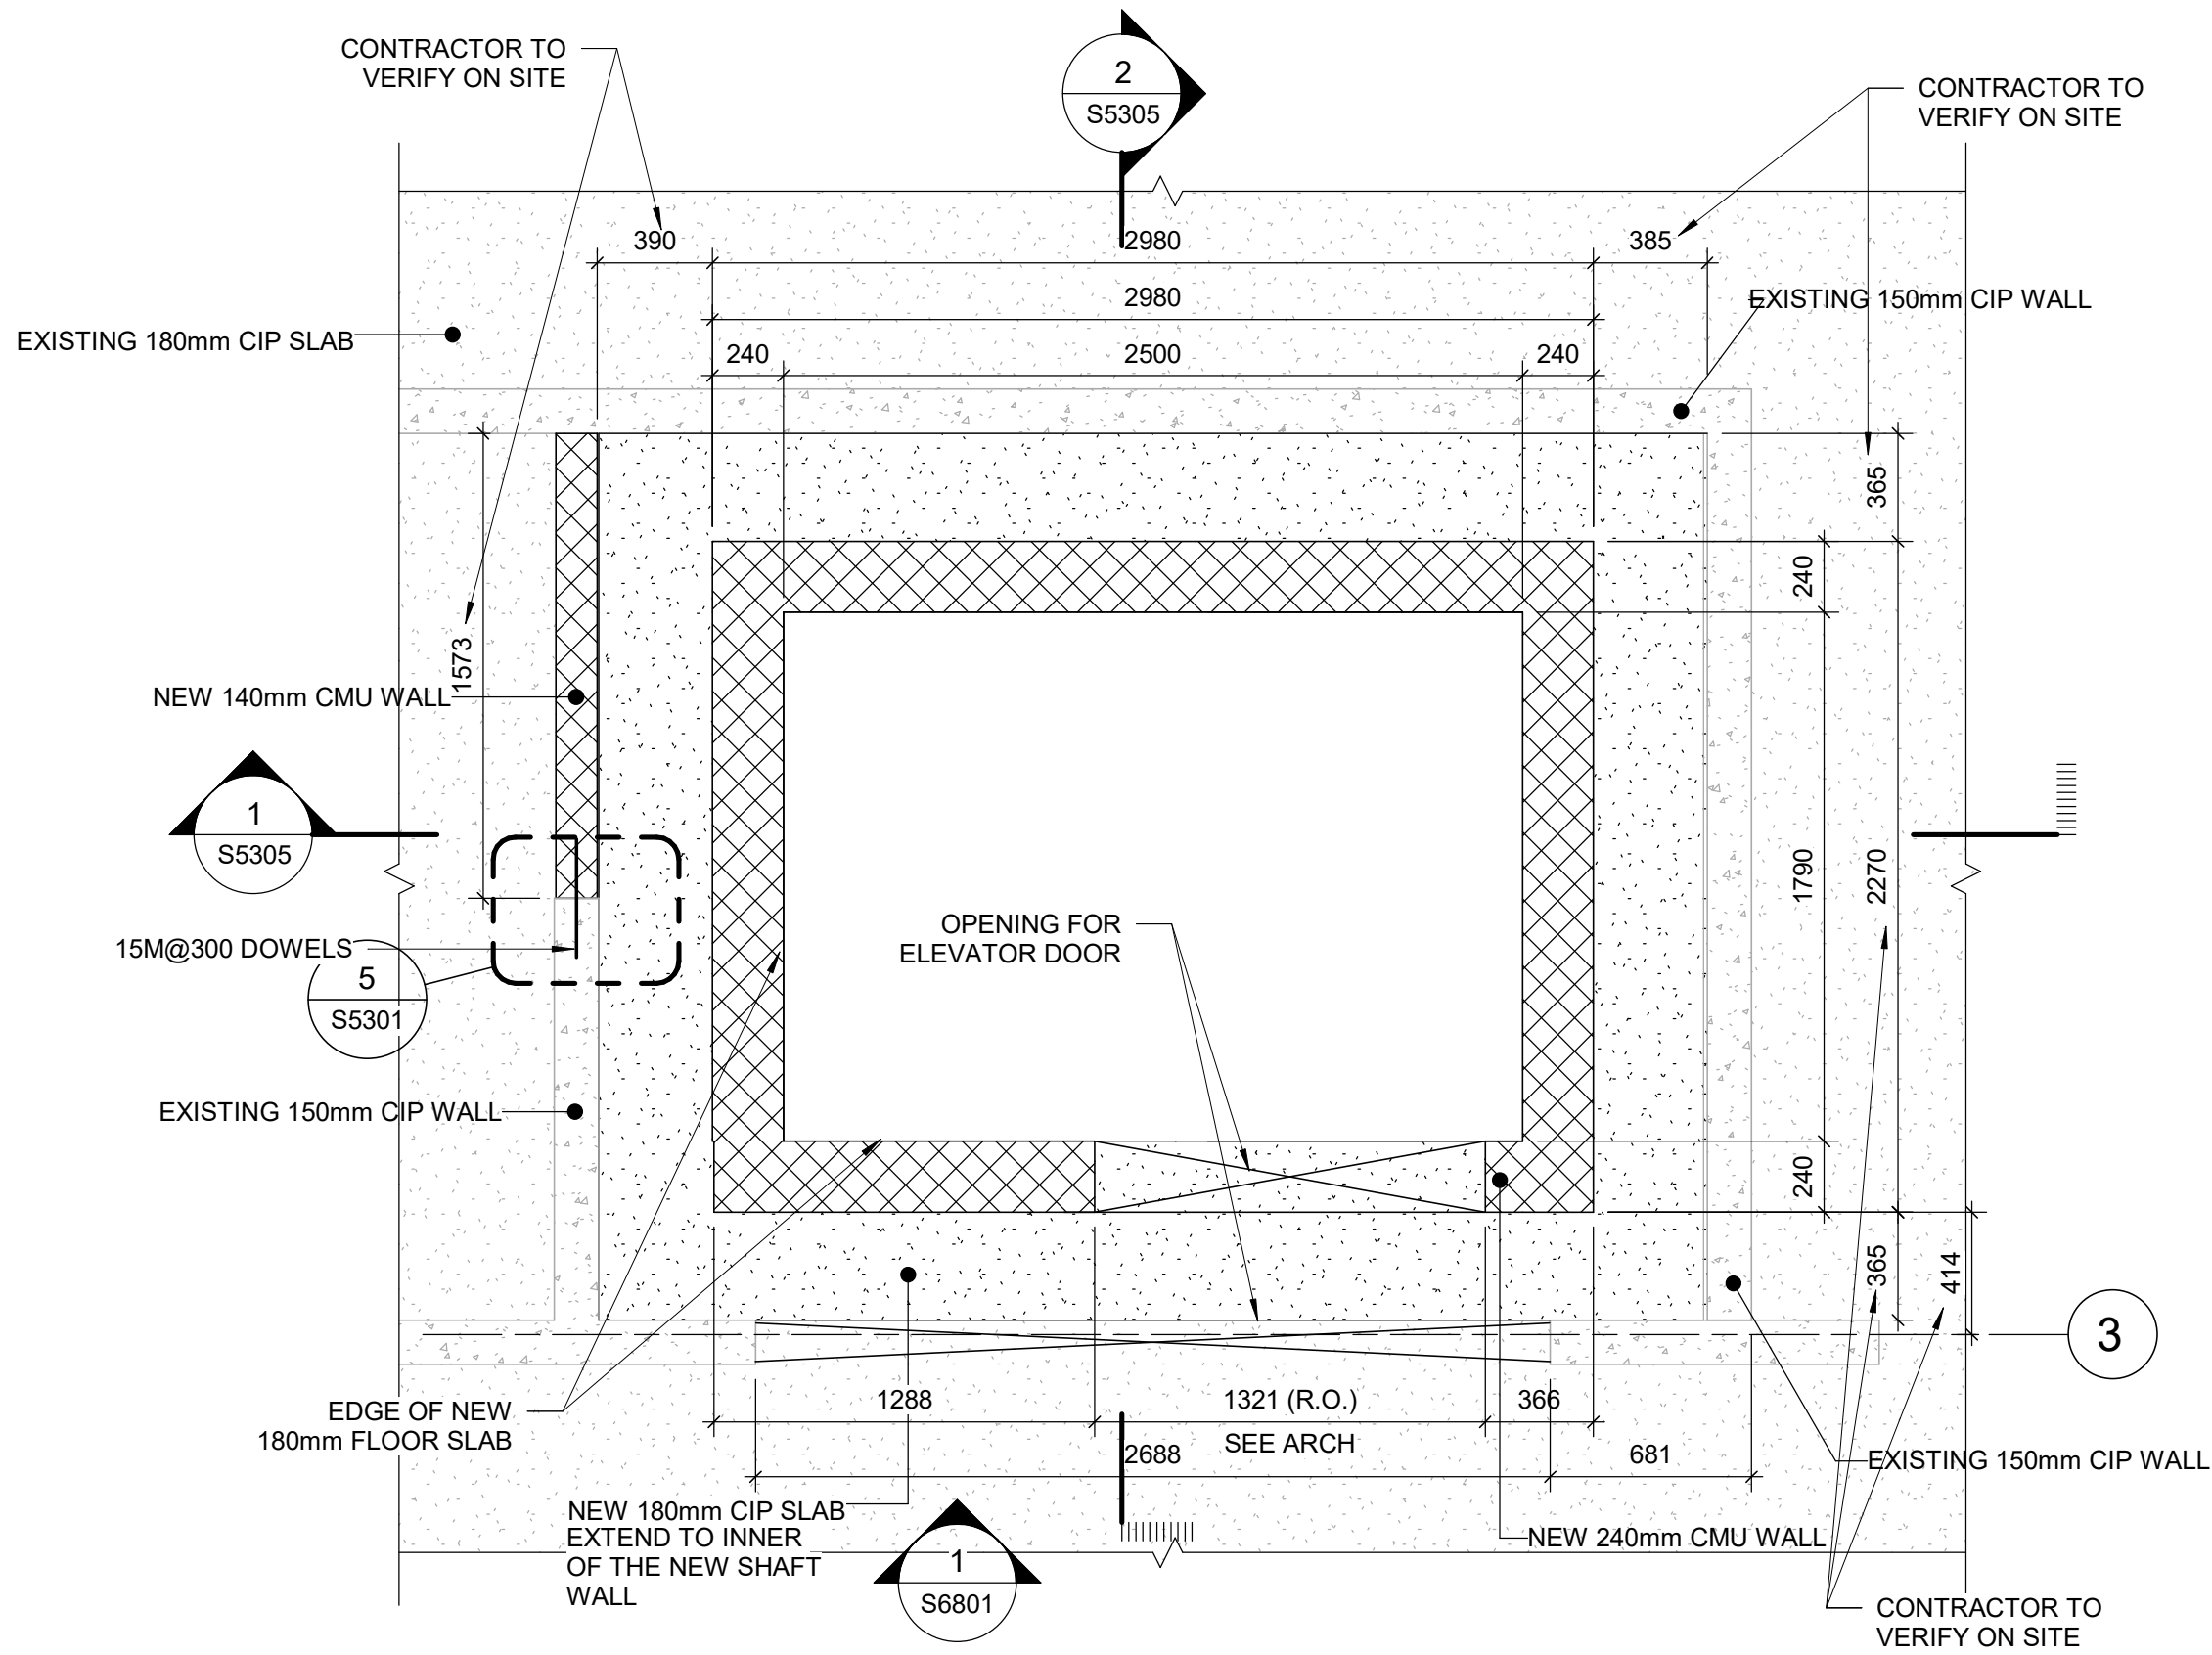
1. MASONRY WALL REINFORCEMENT:
- | | | |
|--|----------------------|----------------------|
| BLOCK SIZE: | 140mm (20 MPa BLOCK) | 240mm (20 MPa BLOCK) |
| VERTICAL: | 15M@400. | VERTICAL: 20M@400. |
| HORIZONTAL: STANDARD TRUSS TYPE HORIZ. JOINT REINF. | | |
| (3.66 mm LONGITUDINAL WIRE, 3.66 CROSS WIRE, MINIMUM)
@ 800, OR APPROVED EQUAL. | | |
2. REINFORCEMENT SHOWN DIAGRAMMATICALLY ONLY.
3. STAGGER SPLICED IN ADJACENT HORIZONTAL BAR IN THE SAME COURSE BY 600.
4. PROVIDE DOWEL BARS IN FOUNDATION TO MATCH ALL VERTICAL REINFORCEMENT.
5. FOR LINTELS SEE TYP. DETAILS.
6. OPENING EDGES SHALL BE REINFORCED WITH 2-15M @ 200 C/C USE MASONRY UNIT STRENGTH 20 MPa.

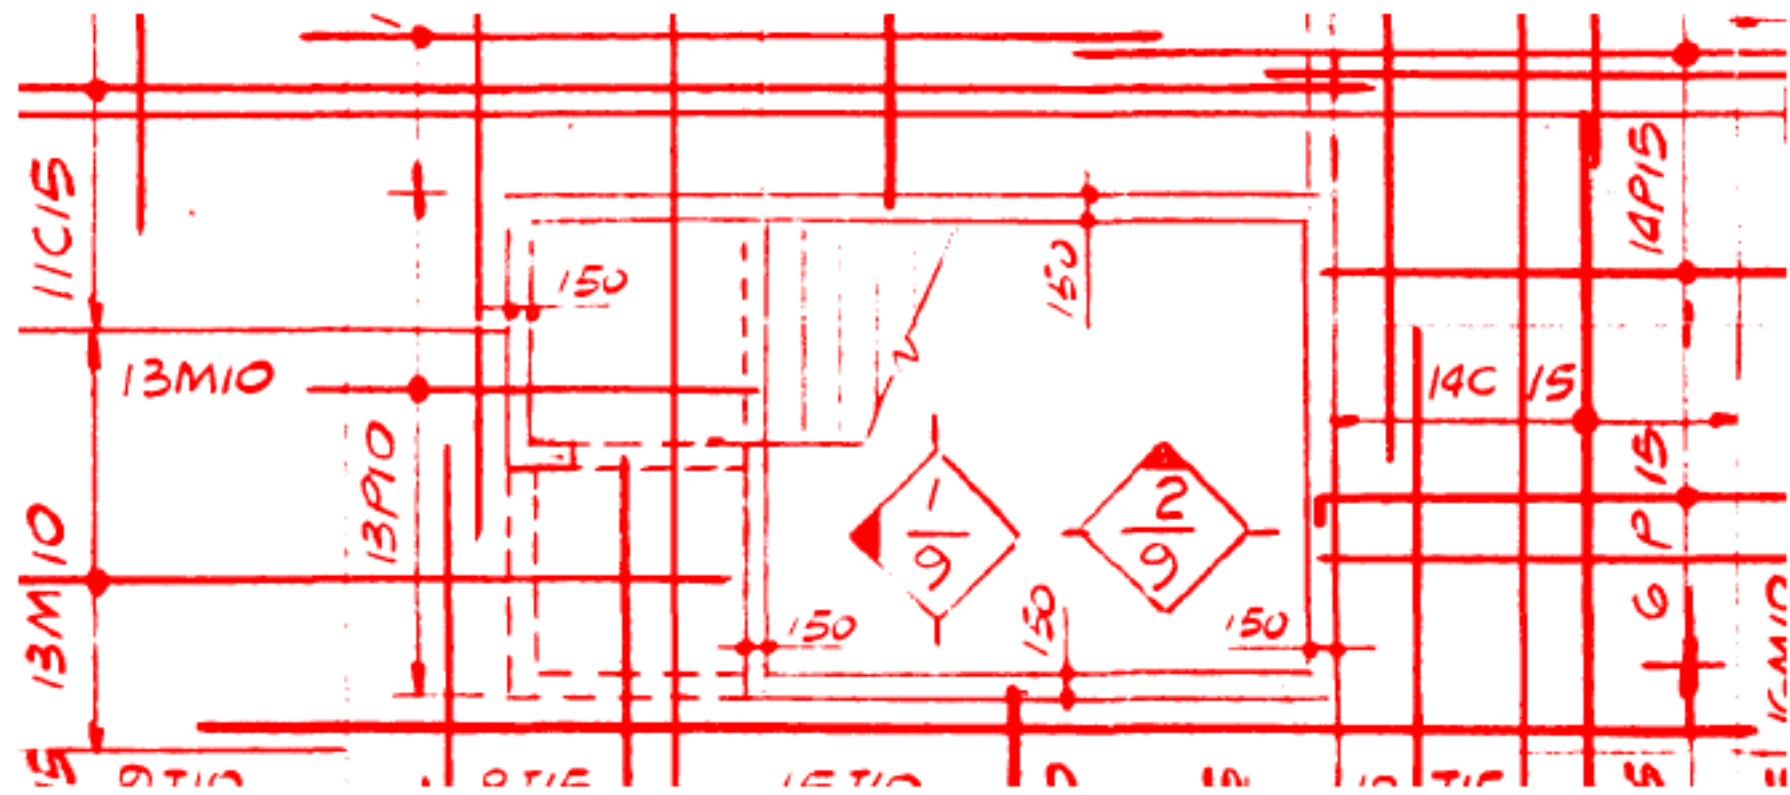


6 EXSITING GROUND UPPER FLOOR PLAN
S5303 / Scale: 1 : 50

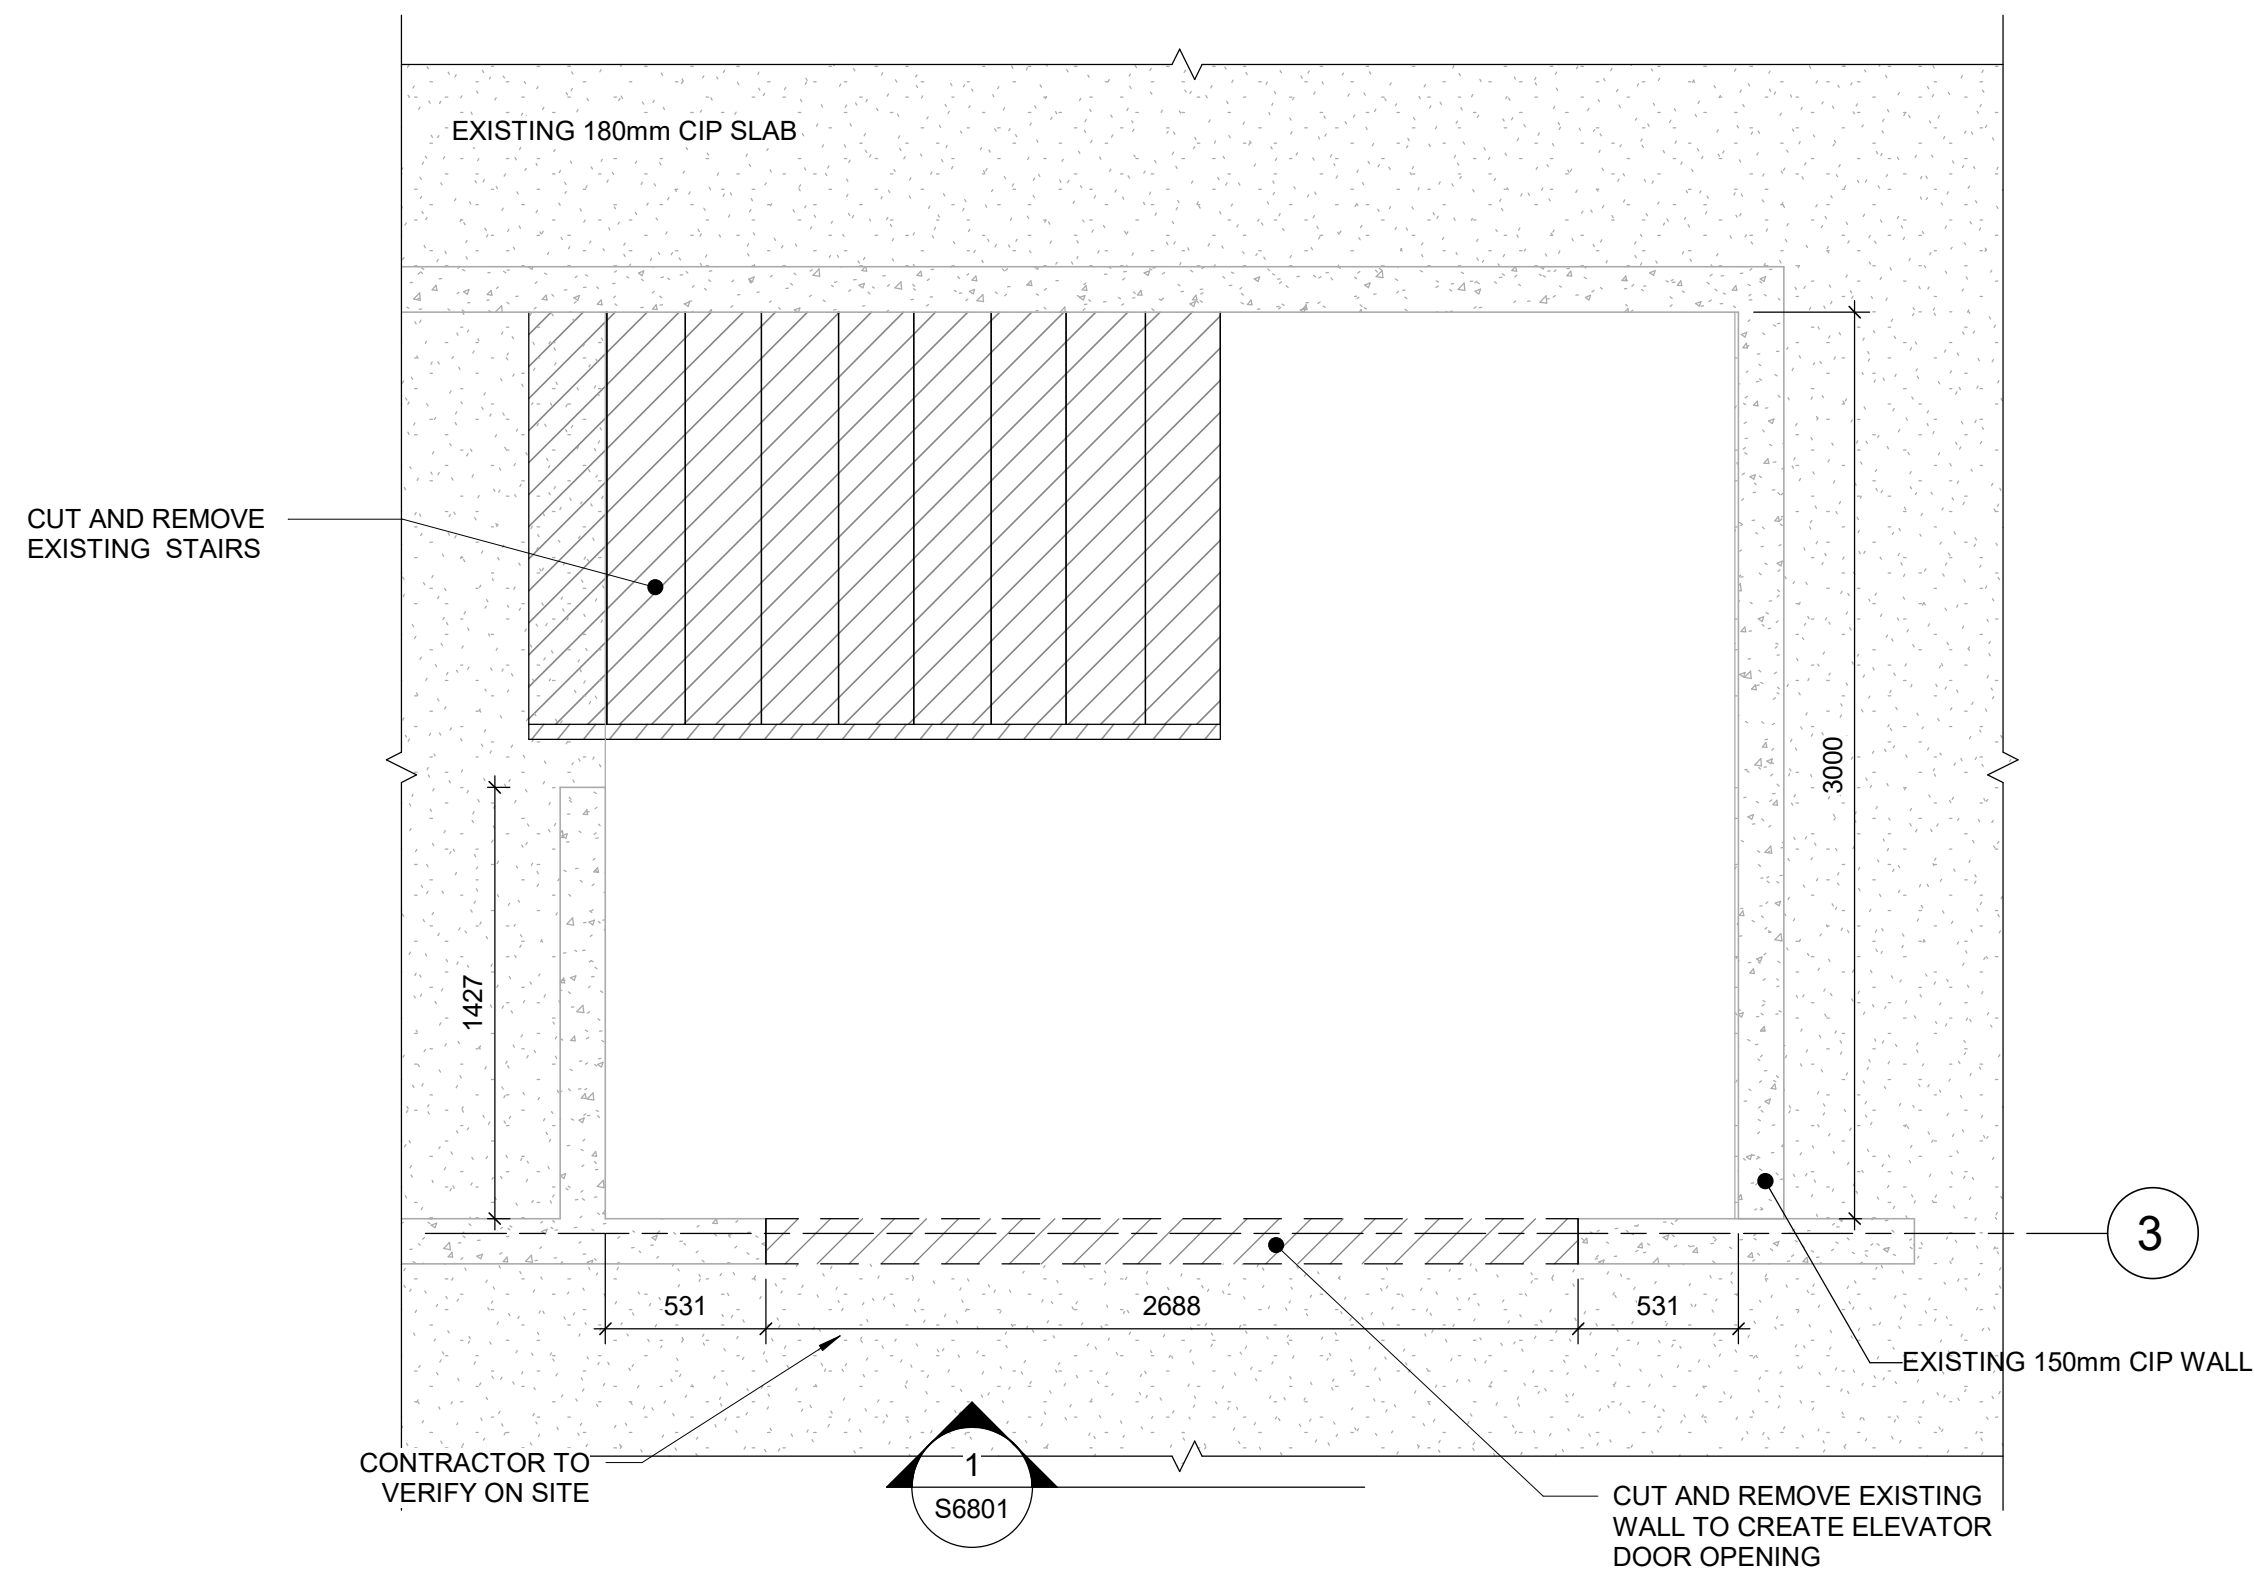

1 ELEVATOR DEMOLITION PLAN - GROUND UPPER FLOOR
S5303 / Scale: 1 : 25



2 ELEVATOR PROPOSED PLAN - GROUND UPPER FLOOR / THIRD FLOOR
S5303 / Scale: 1 : 25

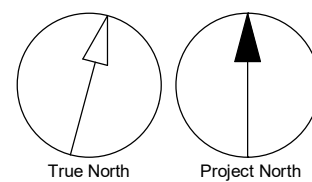

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No.	DESCRIPTION	DATE
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PROJECT TITLE
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ACCESSIBILITY UPGRADES**

PROJECT ADDRESS

**POLICE NO. 33 DIVISION
50 UPJOHN RD**

PROJECT NO:
Arcadis 30279056

DRAWN BY:
L. CHATZIGIANNAKOS

CHECKED BY:
M. FAYAZI

PROJECT MGR:
F. BOLOURIAN


APPROVED BY:
K. ANGER

SHEET TITLE
ELEVATOR - PLANS


SHEET NUMBER
S5303

ISSUE
E


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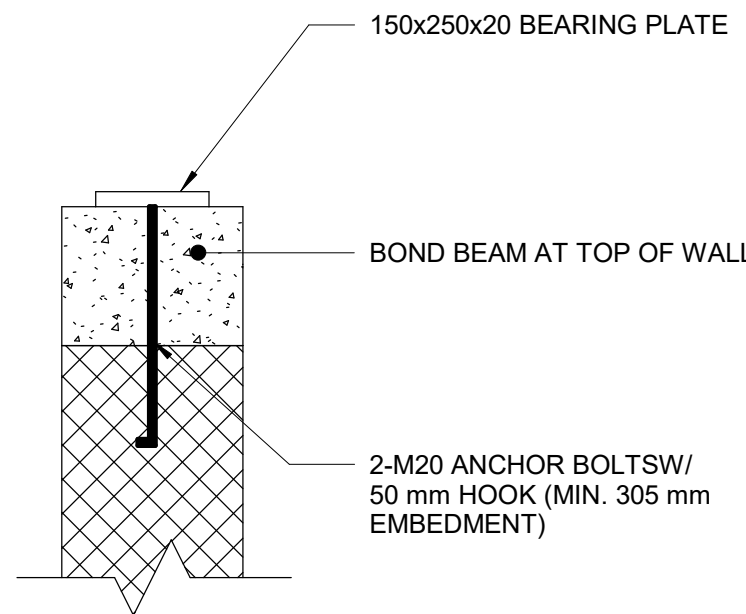
1 ELEVATOR DEMOLITION PLAN - MECHANICAL FLOOR
S5304 Scale: 1 : 25

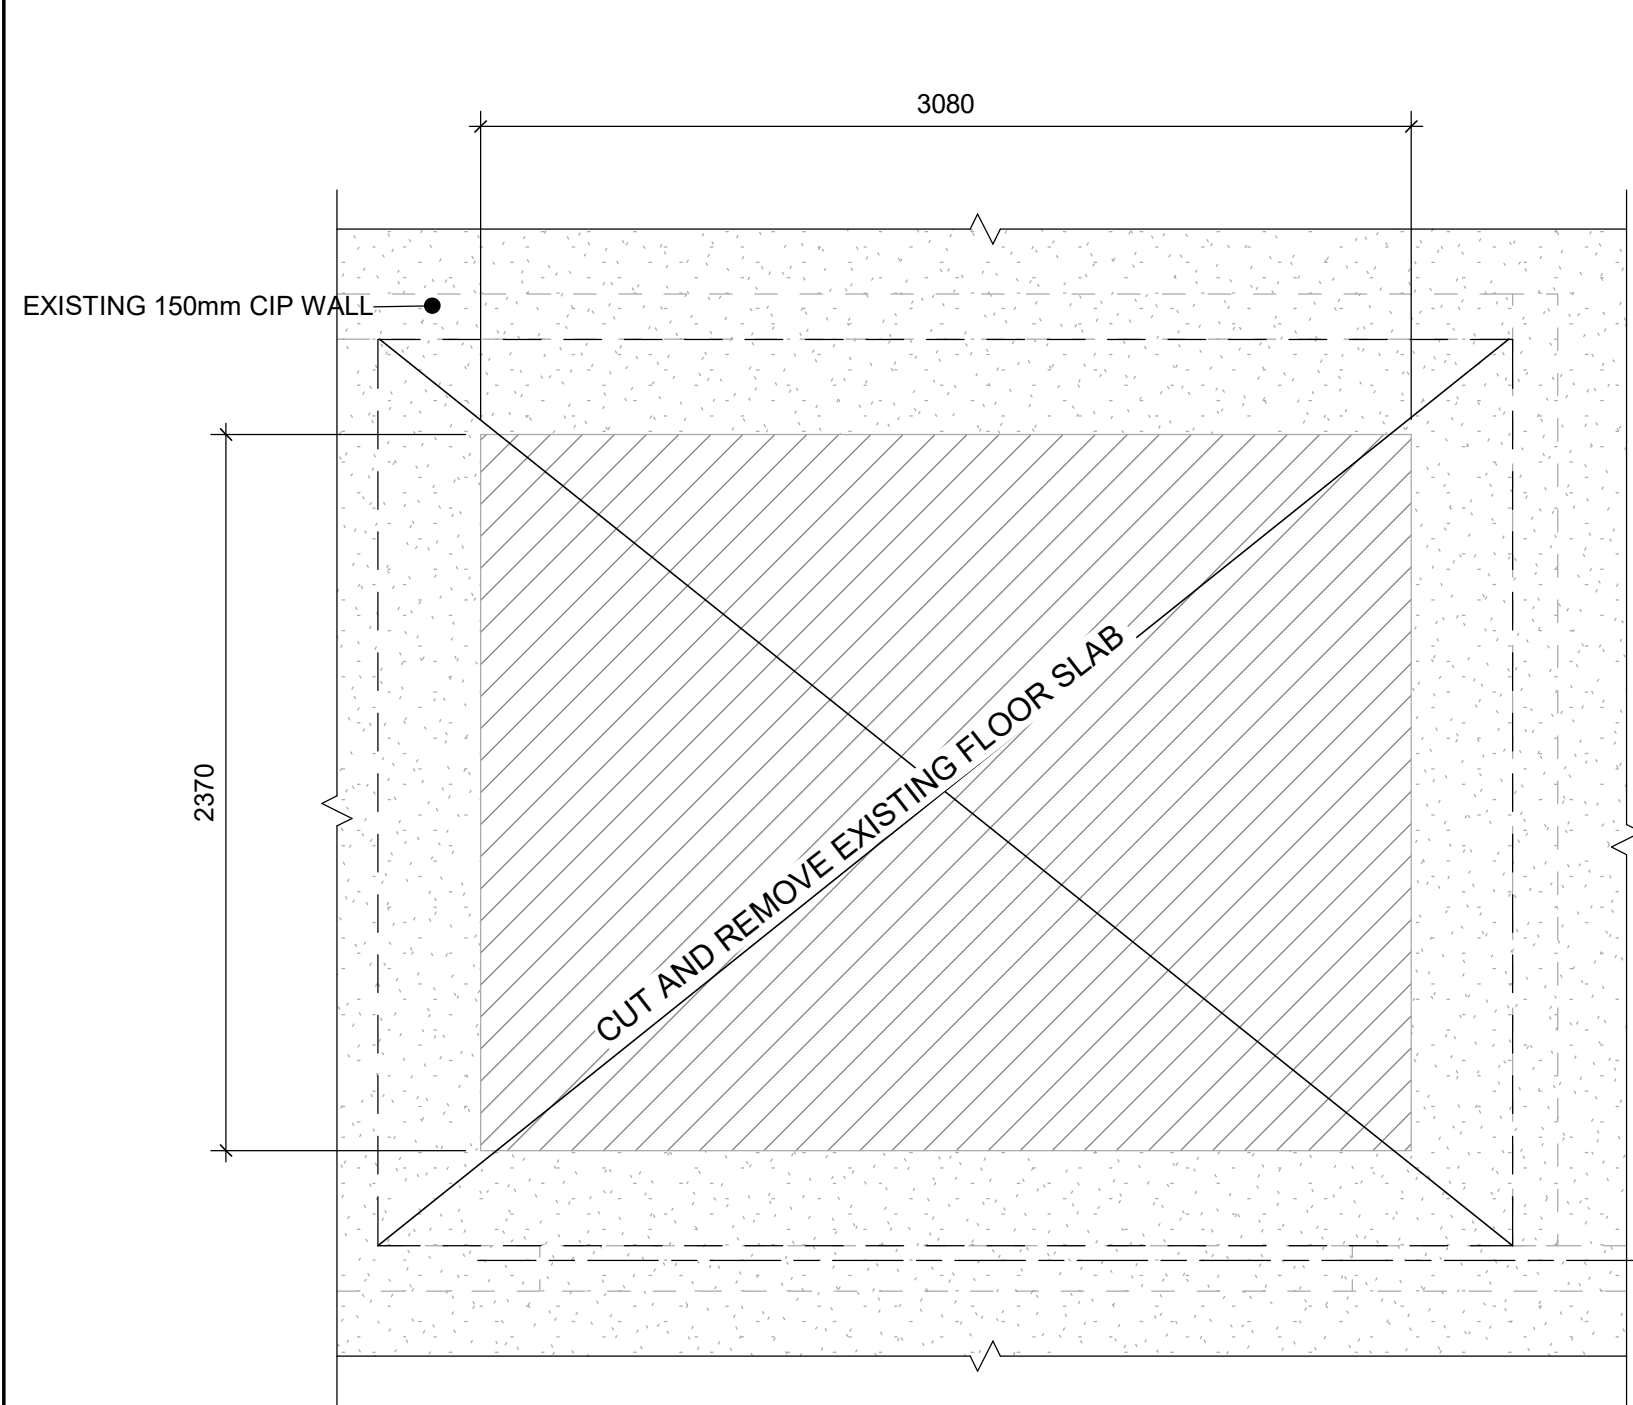

2 ELEVATOR PROPOSED PLAN - MECHANICAL FLOOR
S5304 Scale: 1 : 25

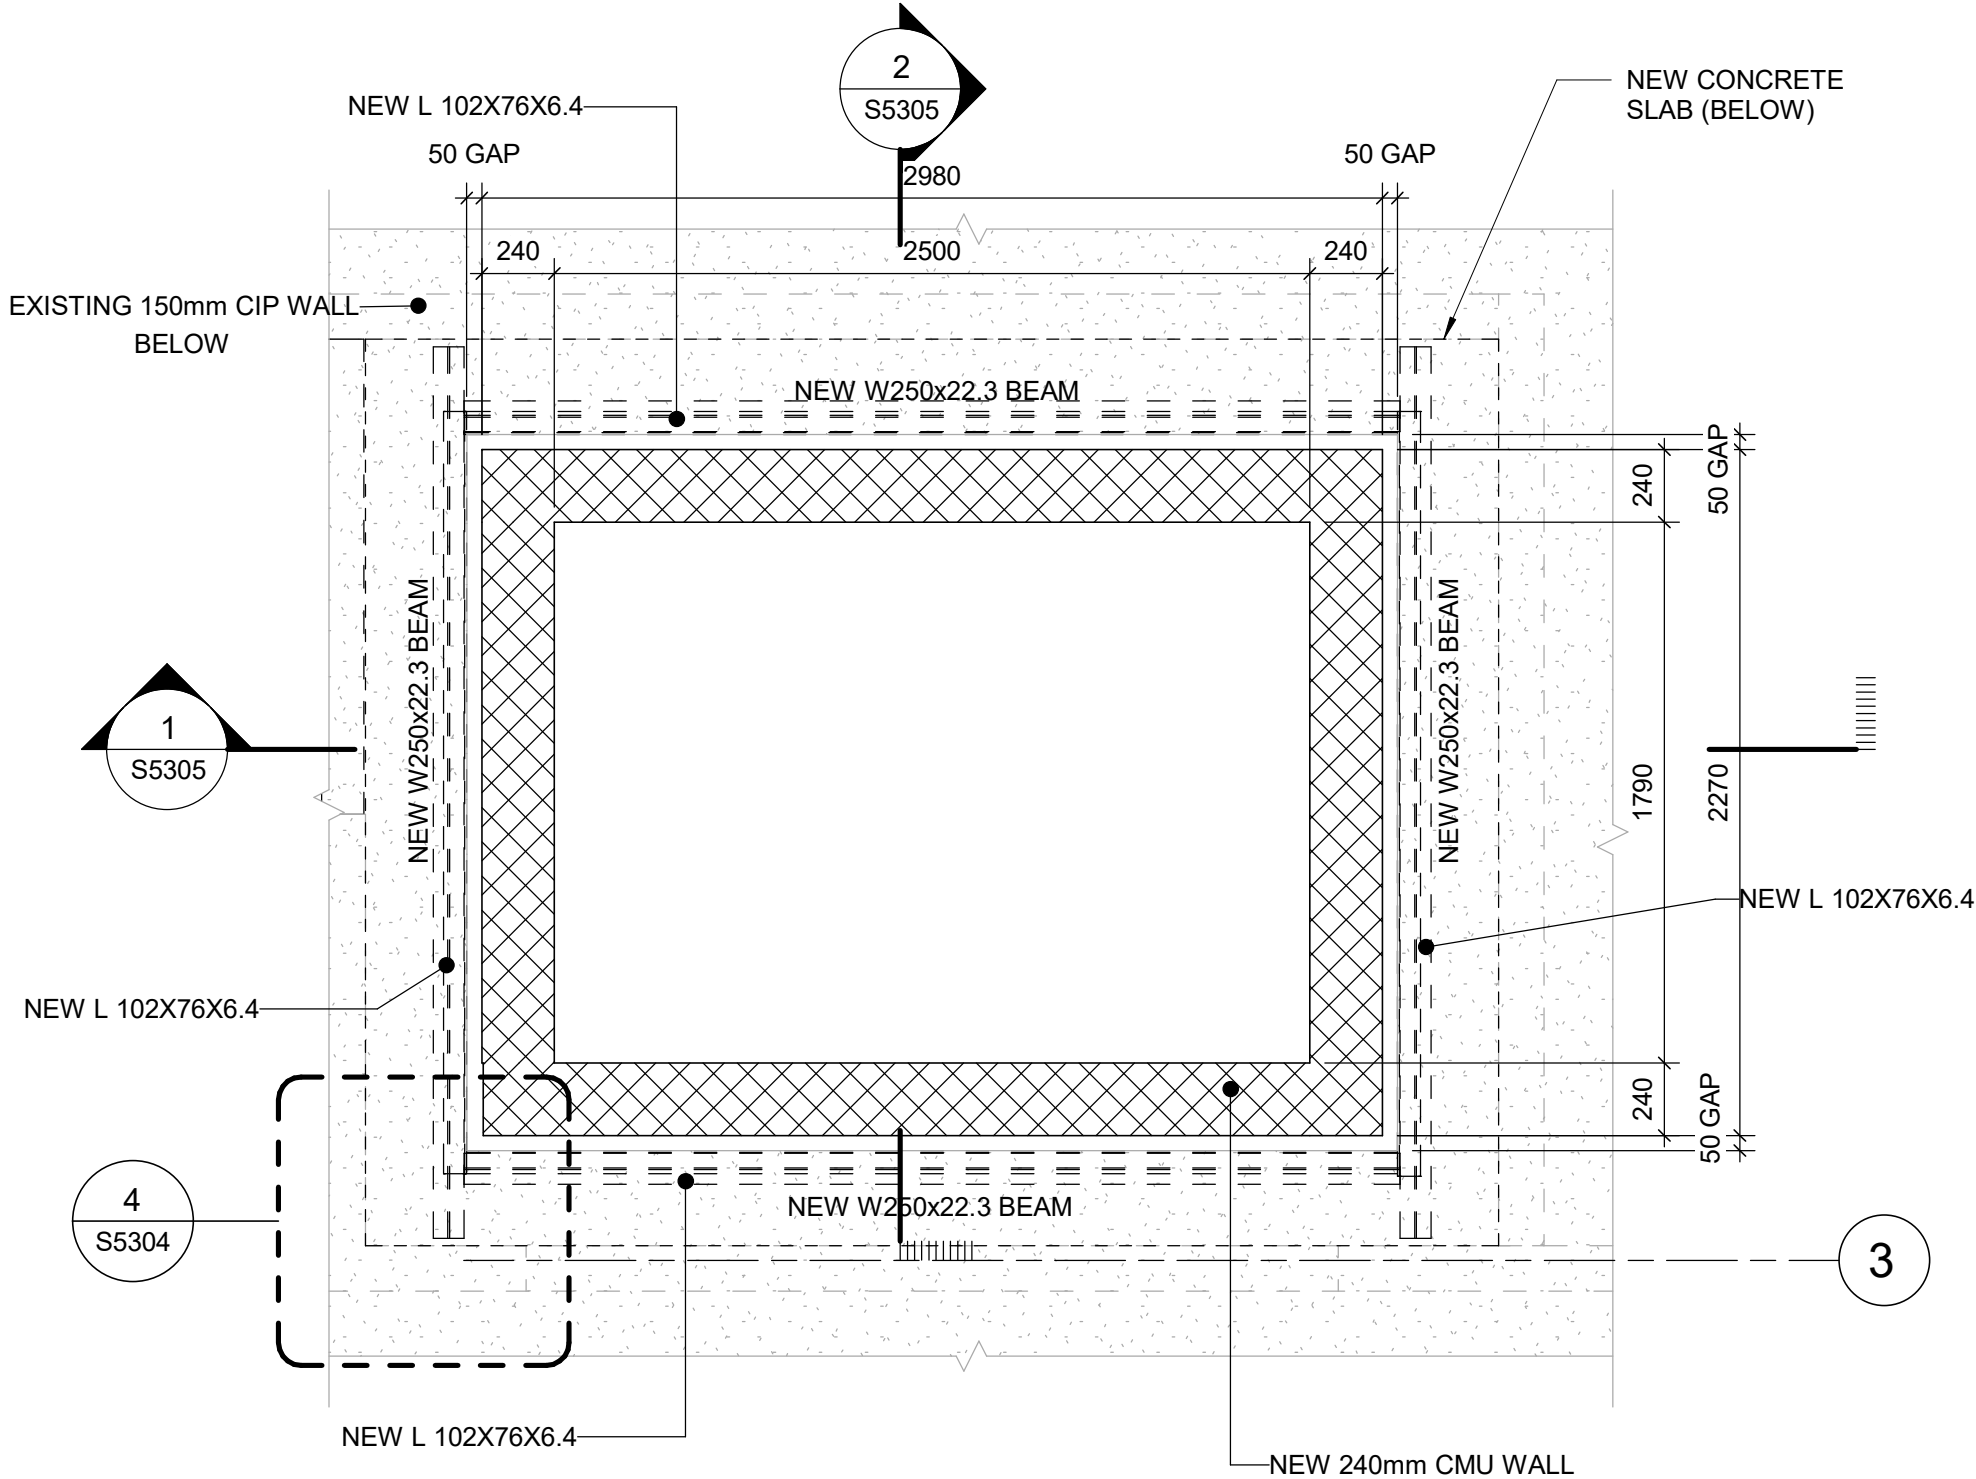


4 DETAIL
S5304 Scale: 1 : 10

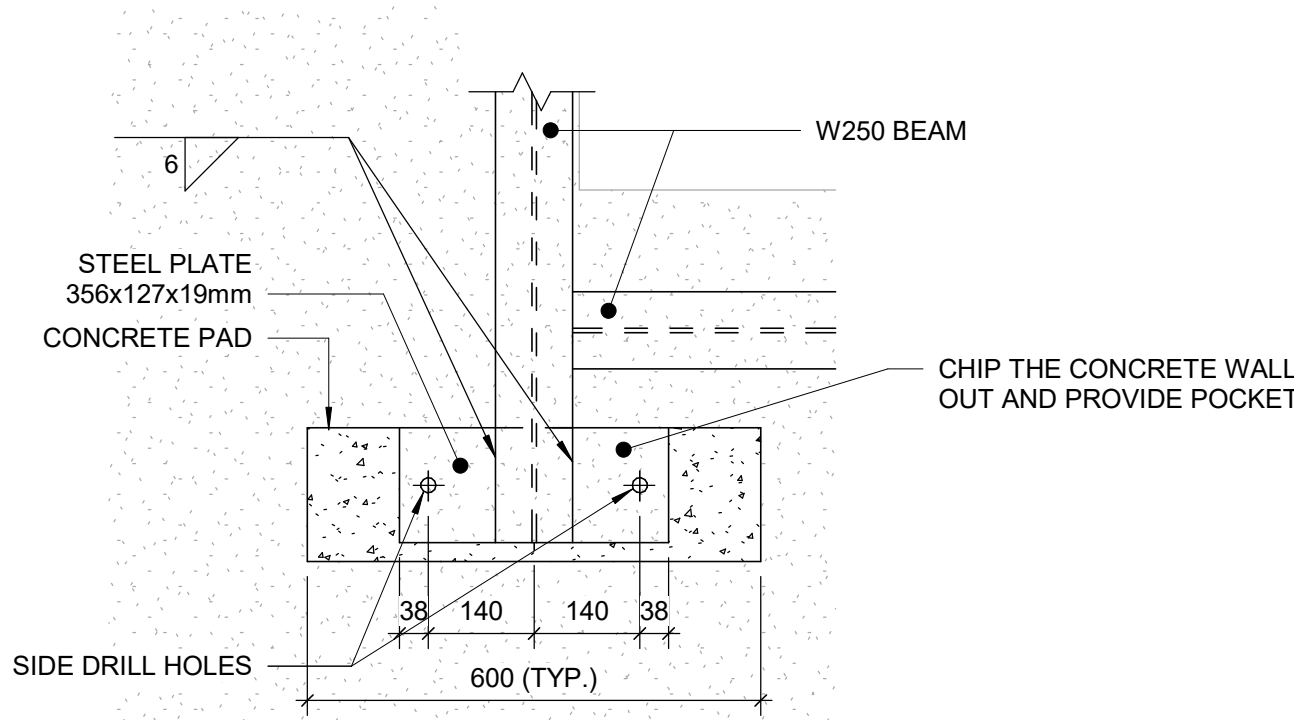


5 DETAIL
S5304 Scale: 1 : 10

NOTE:


1. HOIST BEAM LOCATION TO COORDINATE WITH ELEVATOR VENDOR.
2. PROVIDE STEEL BEARING PLATES AND COORDINATE LOATION WITH ELEVATOR VENDOR.
3. CONTRACTOR TO VERIFY SITE CONDITION AND PROVIDE TEMPORARY SHORING.

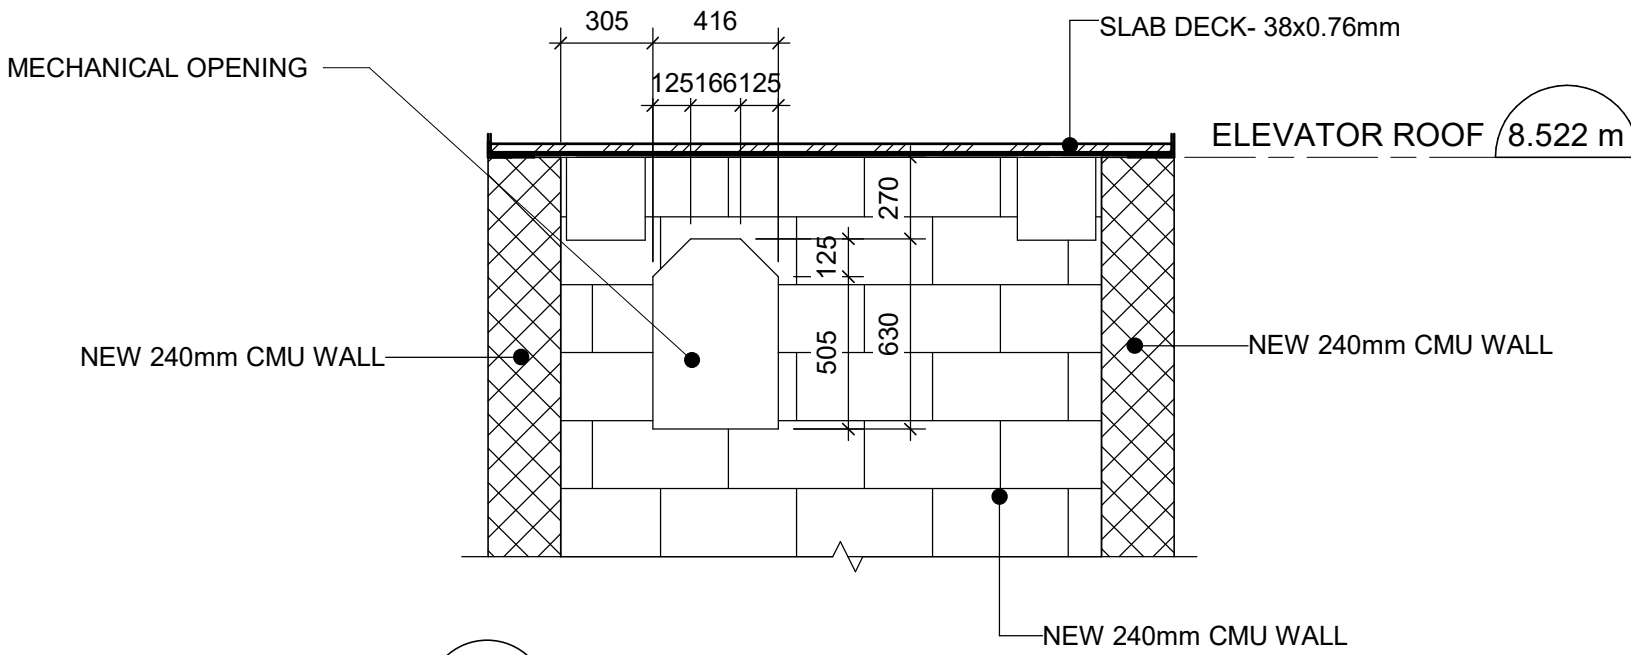

6 ELEVATION
S5304 Scale: 1 : 25

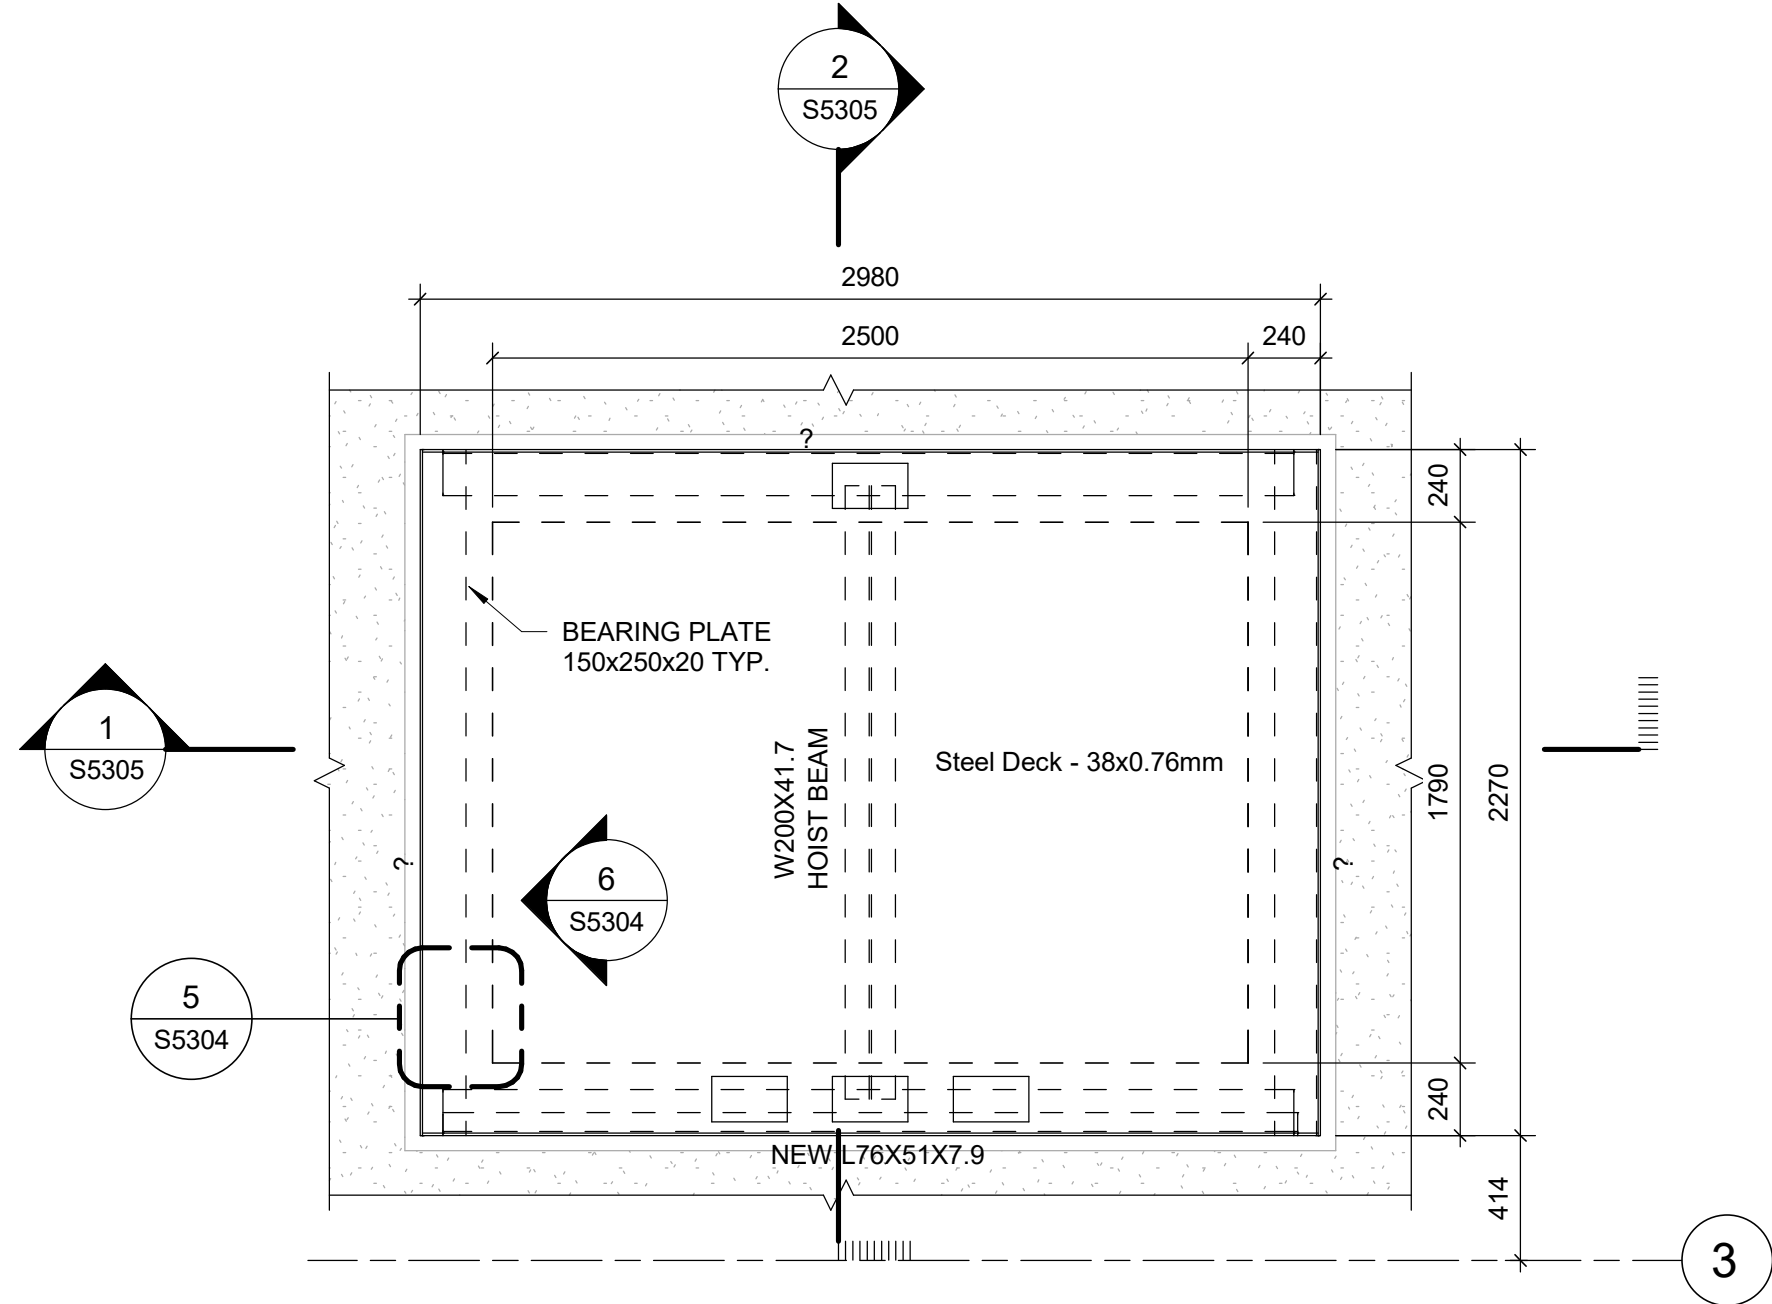

3 ELEVATOR PROPOSED PLAN - ROOF
S5304 Scale: 1 : 25

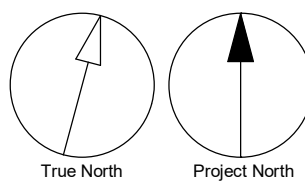

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**POLICE NO. 33 DIVISION
50 UPJOHN RD**

PROJECT NO:
Arcadis 30279056

DRAWN BY:
L. CHATZIGIANNAKOS

CHECKED BY:
M. FAYAZI

PROJECT MGR:
F. BOLOURIAN


APPROVED BY:
K. ANGER

SHEET TITLE
ELEVATOR - ROOF

SHEET NUMBER
S5304

ISSUE
D

4/16/2025 11:01:34 AM

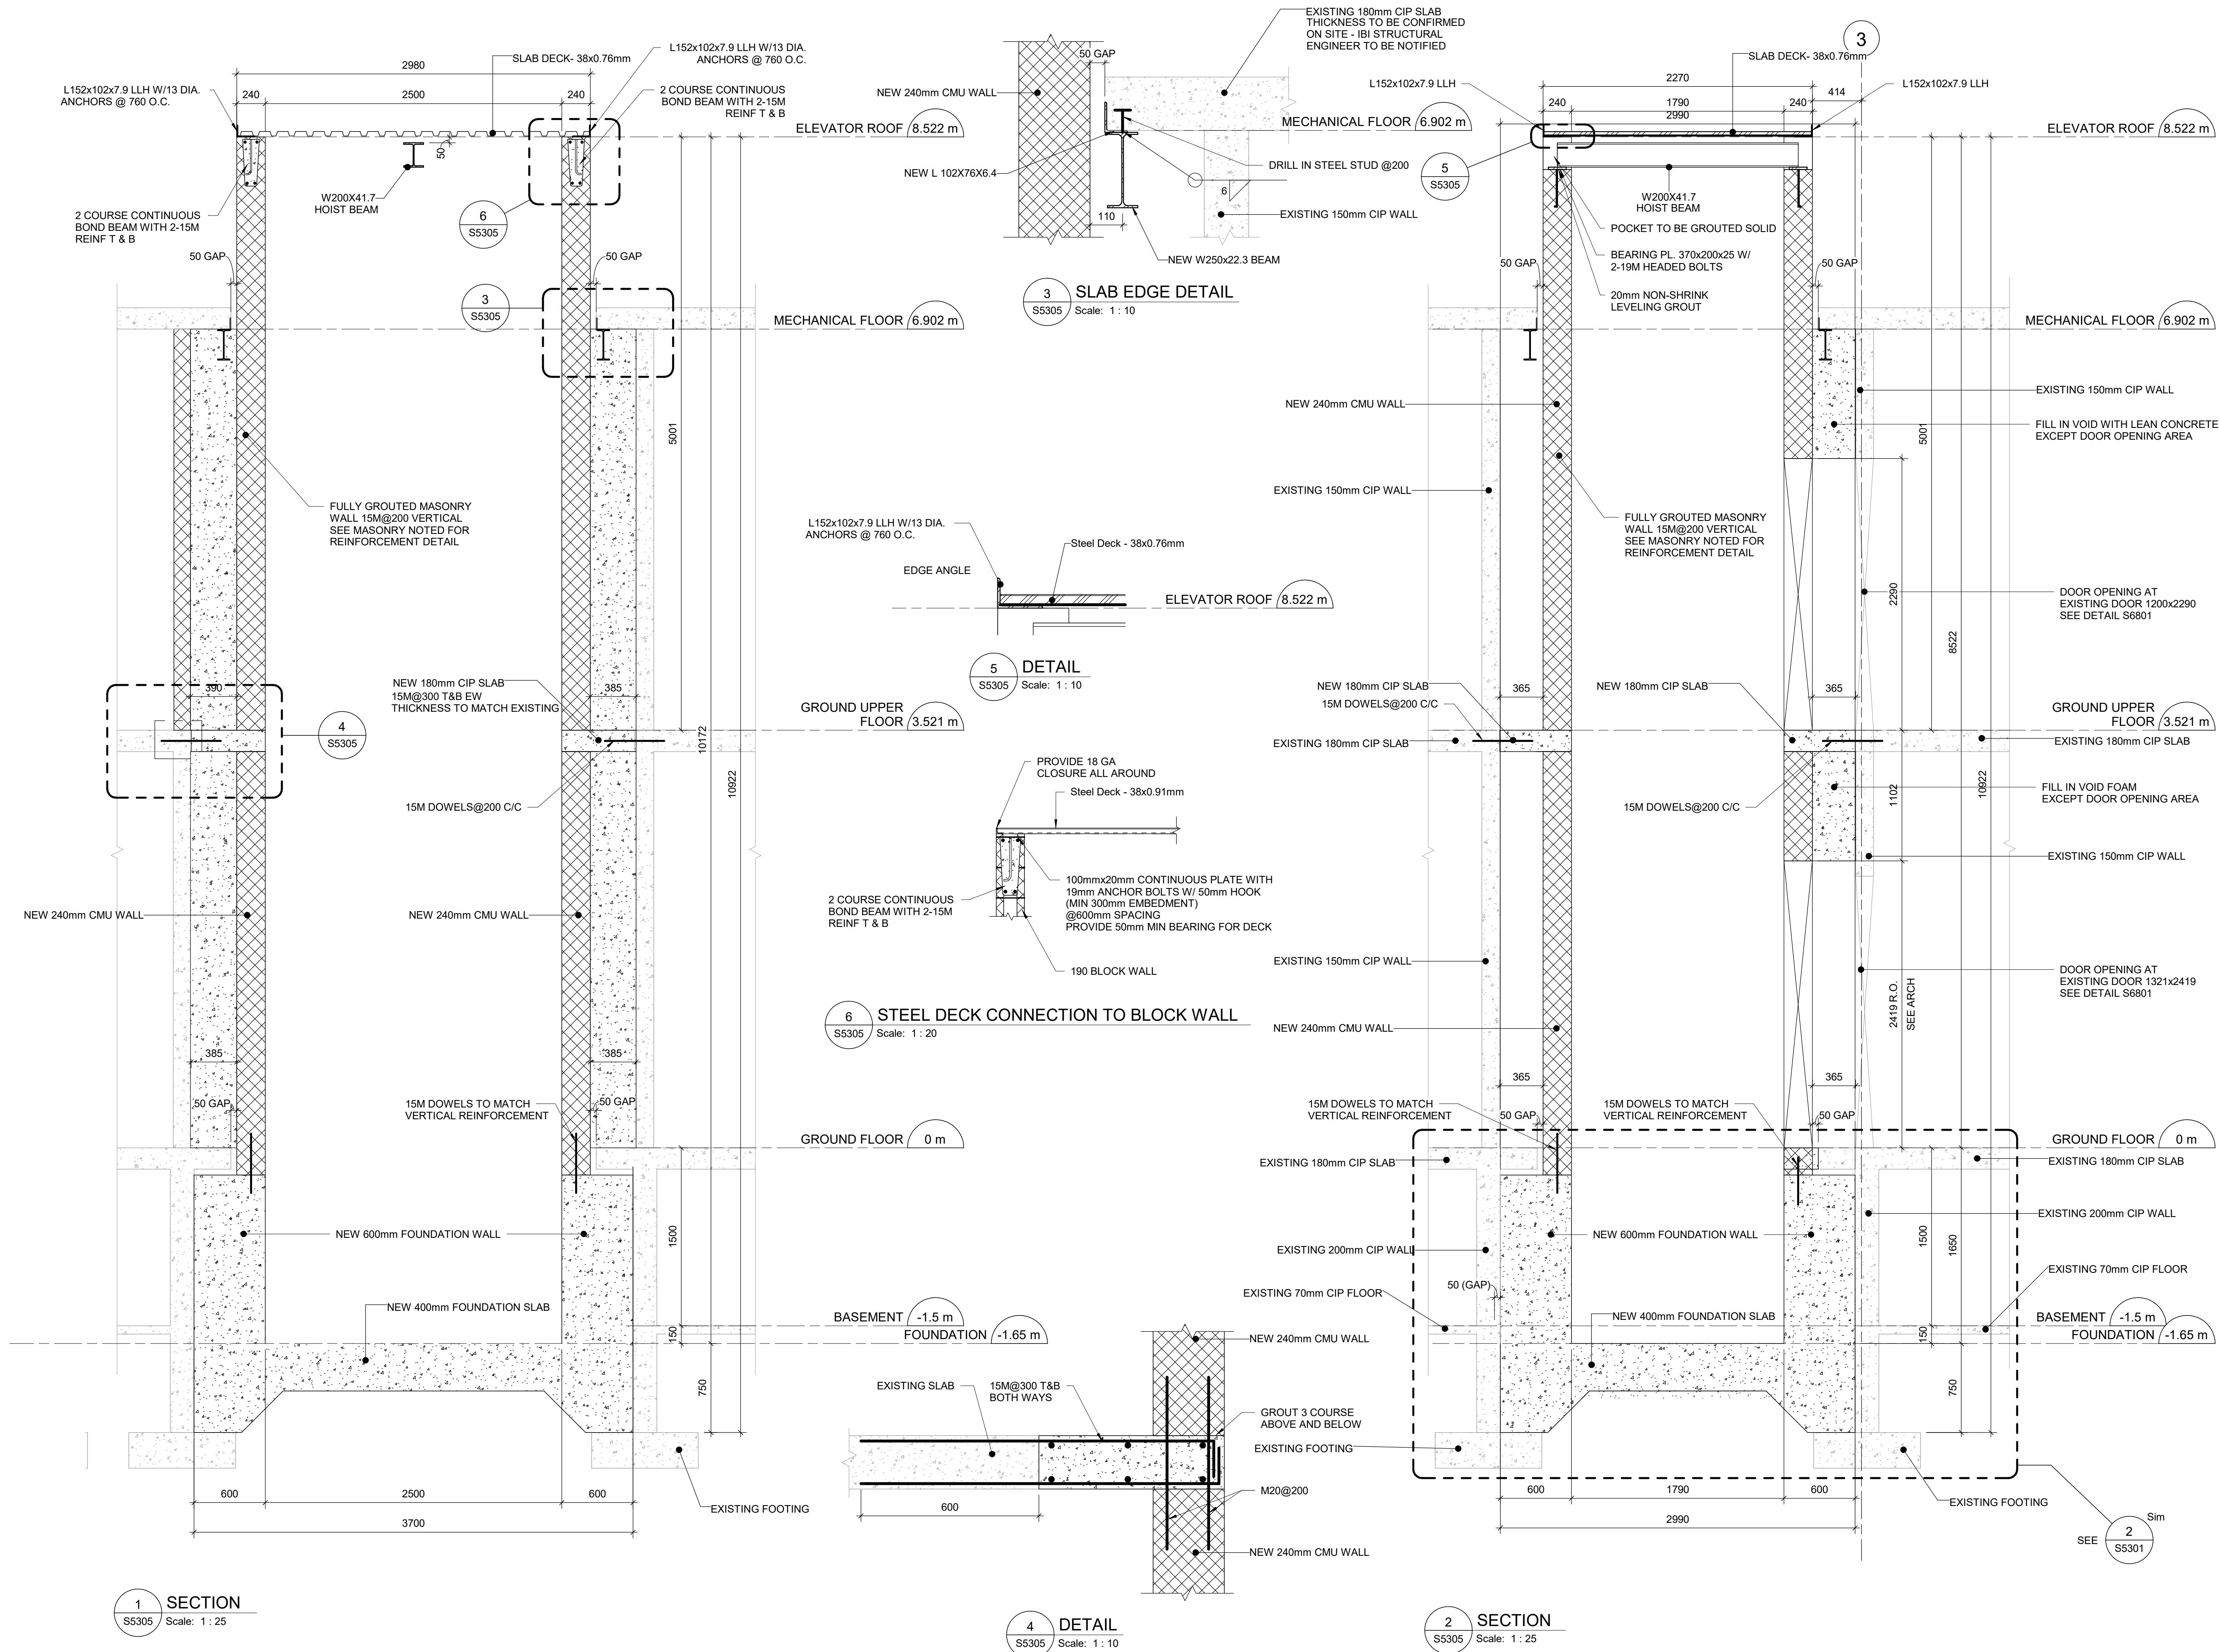

ISSUES		
No.	DESCRIPTION	DATE
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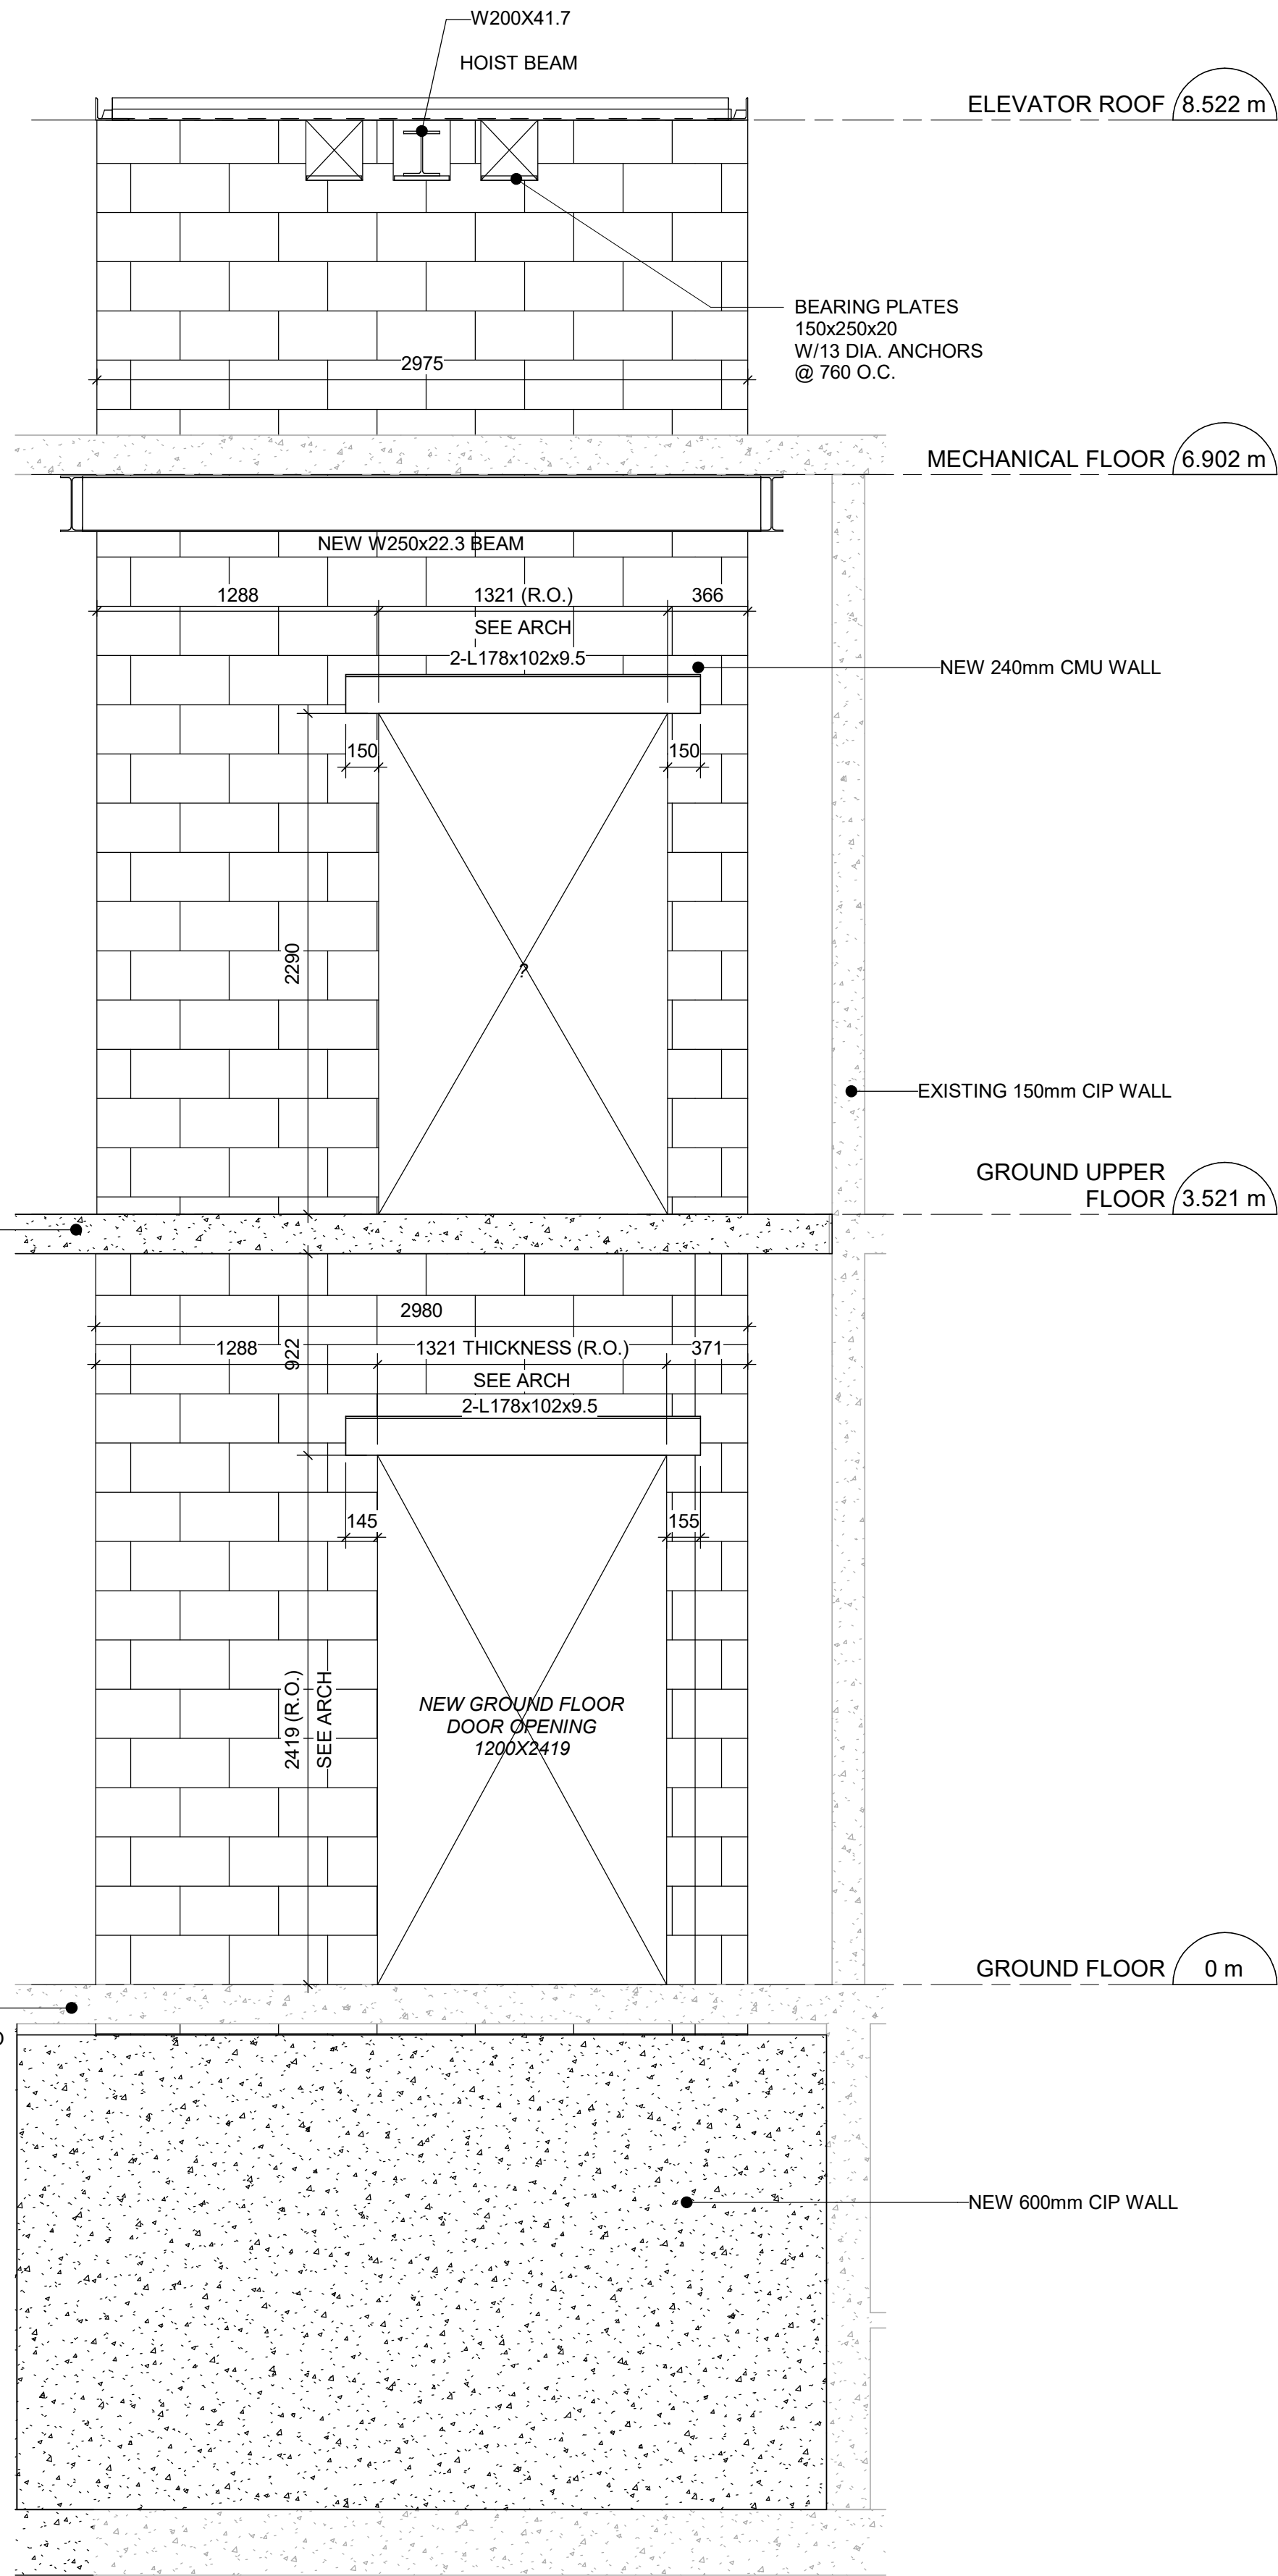
PROJECT TITLE
**CITY OF TORONTO
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PROJECT ADDRESS
**POLICE NO. 33 DIVISION
50 UPJOHN RD**

PROJECT NO:
Arcadis 30279056
DRAWN BY:
L. CHATZIGIANNAKOS
PROJECT MGR:
F. BOLOURIAN
CHECKED BY:
M. FAYAZI
APPROVED BY:
K. ANGER

SHEET TITLE
ELEVATOR - SECTIONS

SHEET NUMBER
S5305
ISSUE
E



1 ELEVATION
S6801 Scale: 1 : 25

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PROJECT MGR:
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CHECKED BY:
M. FAYAZI
APPROVED BY:
K. ANGER

SHEET TITLE
WALL OPENINGS

SHEET NUMBER S6801	ISSUE E
------------------------------	-------------------

MECHANICAL DRAWING LIST	
Sheet Number	Sheet Name
M0001	MECHANICAL DRAWING LIST
M0201	EQUIPMENT SCHEDULE
M1101	DEMOLITION PLAN - GROUND FLOOR
M1102	DEMOLITION PLAN - THIRD FLOOR
M2101	PLUMBING - GROUND FLOOR
M2102	PLUMBING - THIRD FLOOR
M3101	DRAINAGE - BASEMENT
M3102	DRAINAGE - GROUND FLOOR
M3103	DRAINAGE - THIRD FLOOR
M5101	HVAC - BASEMENT
M5102	HVAC - GROUND FLOOR
M5103	HVAC - THIRD FLOOR
M5104	HVAC - ROOF PLAN
M6101	FIRE PROTECTION PLAN

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PROJECT TITLE
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PROJECT ADDRESS

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PROJECT NO:
Arcadis 30279056

DRAWN BY:
K.DURUKAN

CHECKED BY:
B.LIAO

PROJECT MGR:
F. BOLOURIAN

APPROVED BY:
S.LIU

SHEET TITLE
MECHANICAL DRAWING
LIST

SHEET NUMBER

G05-249-M0001

ISSUE

D

SPLIT AIR CONDITIONING UNIT SCHEDULE - INDOOR UNIT													
TAG NO.	SERVICE	LOCATION	MANUFACTURE	MODEL NO.	HEATING OUTPUT KW (MIN / MAX)	COOLING OUTPUT NOMINAL TONS	AIR FLOW (Lo-Hi)	ESP (Pa)	V/Ph/Hz	FAN MOTOR FLA	FAN MOTOR W	NET WEIGHT	REMARK
AC-01	ELEV. CLOSET	ELEV. CONTROL RM	DAIKIN	FTX18UVJU	2.6 / 8	1.5	180 ~ 335 LPS	-	208/1/60	0.37	48	15KG	NOTE 1 ~ 6
NOTE: 1. C/W REFRIGERANT PIPING AND WIRING FOR INDOOR / OUTDOOR UNIT CONNECTION AND ALL NECESSARY VALVES, INSULATION, FITTINGS AND SUPPORT PER MANUFACTURE INSTALLATION REQUIREMENT. 2. HEATING MODEL DOWN TO -25°C OUTDOOR TEMPERATURE. 3. C/W BACNET INTERFACE AND CONNECT TO EXISTING BAS. REFER TO SCHEMATIC ON DWG M5103. 4. C/W WALL MOUNTED 7-DAYS PROGRAMMABLE THERMOSTAT. 5. C/W NECESSARY FITTING TO ALLOW COOLING OPERATION BELOW -5°C. 6. PROVIDE CONDENSATE PUMP 208/1/60, 16W, 2.2G/HR AT 10FT OR EQUAL.													

SPLIT AIR CONDITIONING UNIT SCHEDULE - OUTDOOR UNIT												
TAG NO.	SERVICE	LOCATION	MANUFACTURE	MODEL NO.	HEATING OUTPUT KW (MIN / MAX)	COOLING OUTPUT NOMINAL TONS	OPERATION RANGE	V/Ph/Hz	MCA	MAX FUSE	NET WEIGHT	REMARK
ACCU-01	AC-01	ROOF	MITSUBISHI ELECTRIC	RXL18UMVJUA	2.6 / 8	1.5	-25°C ~ 46°C	208/1/60	18.7	20	60KG	NOTE 1 ~ 4
NOTE: 1. C/W REFRIGERANT PIPING AND WIRING FOR INDOOR / OUTDOOR UNIT CONNECTION AND ALL NECESSARY VALVES, INSULATION, FITTINGS AND SUPPORT PER MANUFACTURE INSTALLATION REQUIREMENT . 2. HEATING MODEL DOWN TO -25°C OUTDOOR TEMPERATURE. 3. C/W NECESSARY FITTING TO ALLOW COOLING OPERATION BELOW -5°C. 4. C/W BACNET INTERFACE AND CONNECT TO EXISTING BAS. REFER TO SCHEMATIC ON DWG M5103.												

EXHAUST FAN SCHEDULE										
TAG NO.	SERVICE	MANUFACTURER/ MODEL NO.	FAN			MOTOR			NOTES	
			CAPACITY (LPS)	S.P. (Pa)	TYPE	W	RPM	V/Ph/Hz		
EF-01	ELEVATOR SHAFT	GREENHECK CUE-070-D	95	75	WALL MOUNTED DIRECT DRIVE	25	1550	115/60/1	C/W HOA STARTER MS-1P OR EQUAL AND CONNECT TO EXISTING BAS, REFER TO SCHEMATIC ON DWG M5103. FAN TO BE CONFIGURED FOR SIDEWALL MOUNTING C/W DISCONNECT, AUTOMATIC DAMPER AND BIRDSCREEN	

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PROJECT TITLE
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PROJECT ADDRESS

50 UPJOHN RD

PROJECT NO: Arcadis 30279056	
DRAWN BY: K.DURUKAN	CHECKED BY: B.LIAO
PROJECT MGR: F. BOLOURIAN	APPROVED BY: S.LIU

SHEET TITLE
EQUIPMENT SCHEDULE

SHEET NUMBER G05-249-M0201	ISSUE D
-------------------------------	------------

EXISTING SECURITY EXHAUST
GRILLE TO BE RELOCATED, EXTEND
DUCTWORK TO SUIT NEW LOCATION

EXISTING WC TO BE REMOVED, CAP
ASSOCIATED PIPING BACK TO MAIN,
MAKE GOOD FINISH

EXISTING HVAC & FIRE PROTECTION
TO REMAIN

EXISTING THERMOSTAT TO BE
RELOCATED TO ACCOMMODATE
DOOR WIDENING WORK, REFER
ARCH DWG FOR EXACT DOOR
REPLACEMENT WORK.
MODIFY/EXTEND EXISTING WIRE
AND BAS CABLE WHEN REQUIRED
TO SUIT NEW LOCATION.

EXISTING SINK TO BE REMOVED, CAP
ASSOCIATED PIPING BACK TO MAIN,
MAKE GOOD FINISH

EXISTING THERMOSTAT TO BE
RELOCATED TO ACCOMMODATE DOOR
WIDENING WORK, REFER ARCH DWG
FOR EXACT DOOR REPLACEMENT
WORK. MODIFY/EXTEND EXISTING
WIRE AND BAS CABLE WHEN
REQUIRED TO SUIT NEW LOCATION.


EXISTING WC TO BE REMOVED, CAP
ASSOCIATED PIPING BACK TO MAIN,
REFER M2101 FOR NEW WC

EXISTING EXHAUST GRILLE TO BE
RELOCATED & RE-INSTALLED ON NEW
CEILING, REFER M5101 (TYP. FOR 2 IN
TWO WASHROOMS)


EXISTING CONCEALED SPRINKLER HEAD &
COVER TO BE RELOCATED & RE-
INSTALLED ON NEW CEILING, REFER
M6101 (TYP. FOR 2 IN TWO WASHROOMS)

EXISTING LAV TO BE REMOVED, CAP
ASSOCIATED PIPING BACK TO MAIN,
REFER M2101 FOR NEW WC

1 DEMOLITION - GROUND FLOOR
M1101 Scale: 1 : 100

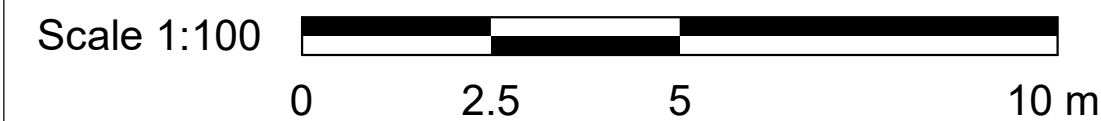


- GENERAL NOTES:
1. CONTRACTOR TO VERIFY SITE CONDITION.
 2. REMOVE AND CAP EXISTING SERVICES AS SHOWN ON THE DRAWING.
 3. ALL EXISTING SERVICES SHALL REMAIN UNLESS OTHERWISE NOTED.
 4. RETAIN BASE BUILDING BAS CONTRACTOR FOR BAS SCOPE OF WORK.

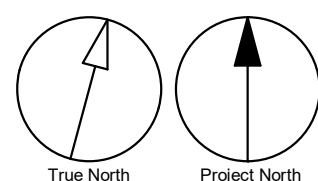

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
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ACCESSIBILITY UPGRADES

PROJECT ADDRESS

50 UPJOHN RD

PROJECT NO:

Arcadis 30279056

DRAWN BY:

K.DURUKAN

CHECKED BY:

B.LIAO

PROJECT MGR:

F. BOLOURIAN

APPROVED BY:

S.LIU

SHEET TITLE

DEMOLITION PLAN -
GROUND FLOOR


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G05-249-M1101


ISSUE

D


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1 DEMOLITION - THIRD FLOOR
M1102 Scale: 1 : 100

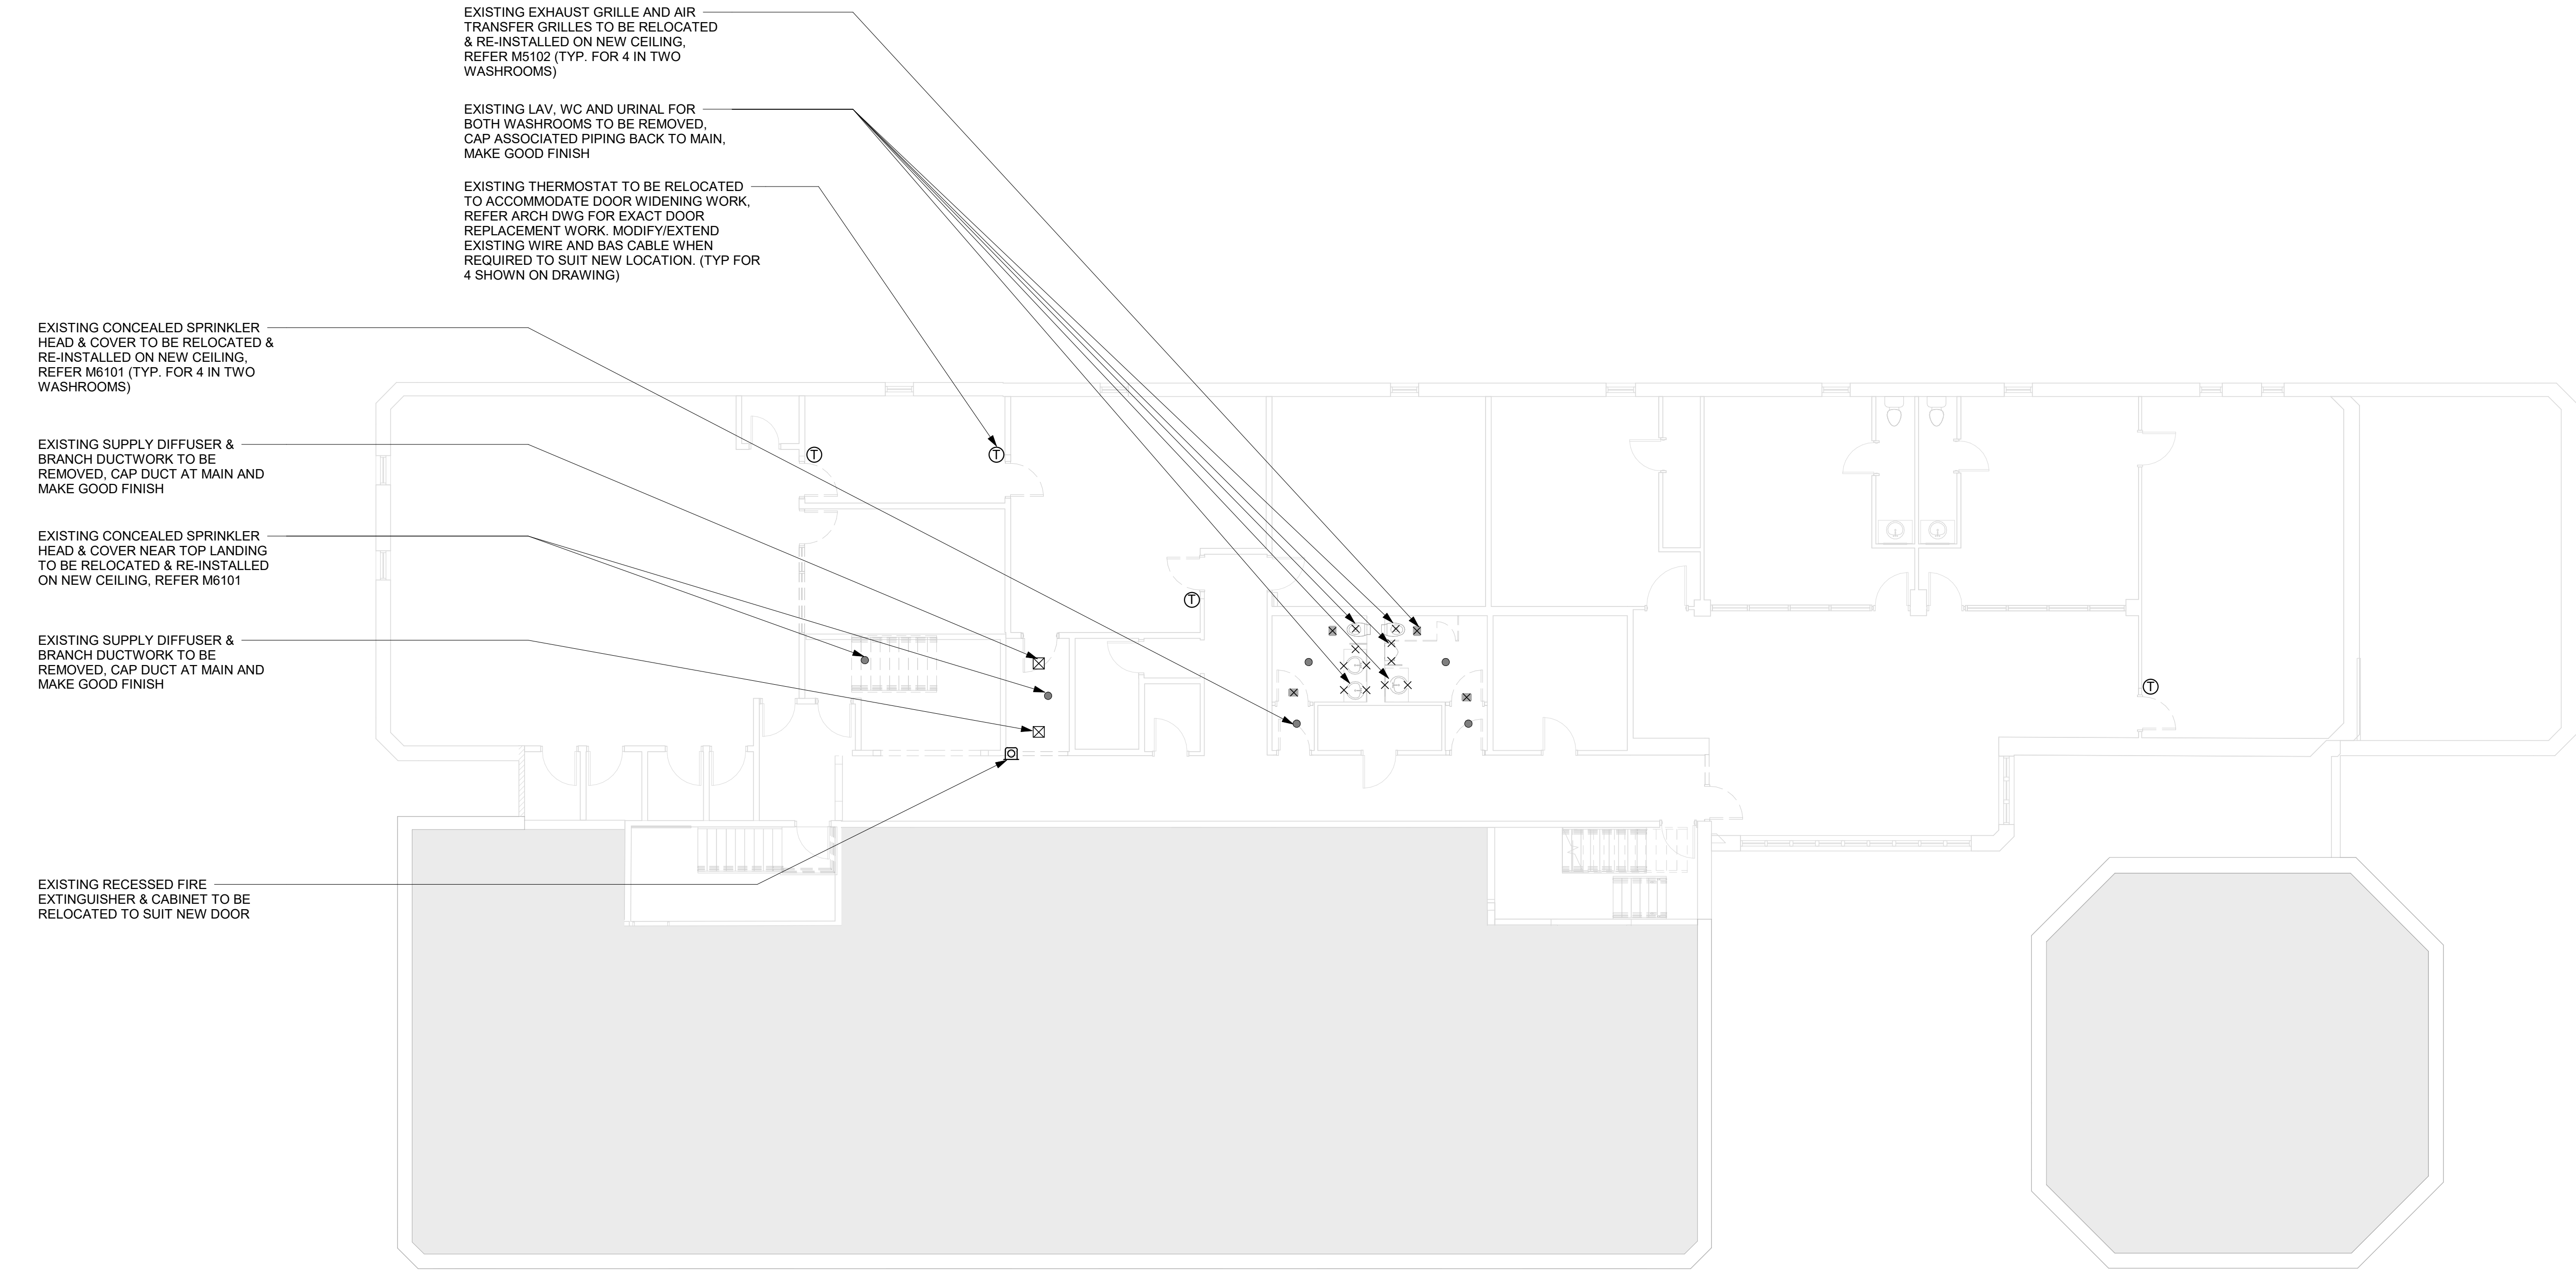

- GENERAL NOTES:
- CONTRACTOR TO VERIFY SITE CONDITION.
 - REMOVE AND CAP EXISTING SERVICES AS SHOWN ON THE DRAWING.
 - ALL EXISTING SERVICES SHALL REMAIN UNLESS OTHERWISE NOTED.
 - RETAIN BASE BUILDING BAS CONTRACTOR FOR BAS SCOPE OF WORK.

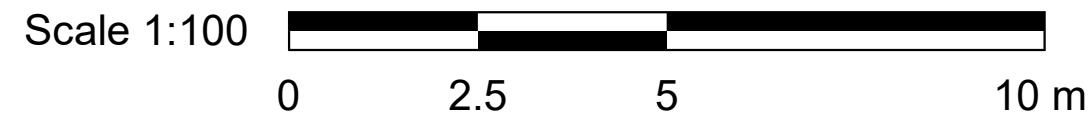

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PROJECT NO:
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DRAWN BY:
K.DURUKAN

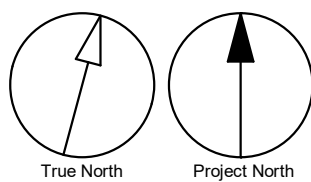CHECKED BY:
B.LIAO

PROJECT MGR:
F. BOLOURIAN

APPROVED BY:
S.LIU

SHEET TITLE
**DEMOLITION PLAN -
THIRD FLOOR**

SHEET NUMBER


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ISSUE


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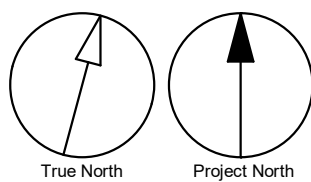
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1 PLUMBING - GROUND FLOOR
M2101 Scale: 1 : 100



- GENERAL NOTES:
- REFER TO SPECIFICATIONS FOR PLUMBING FIXTURE UNIT TYPES.
 - ALL NEW FIXTURES TO BE FITTED WITH ISOLATION VALVES.

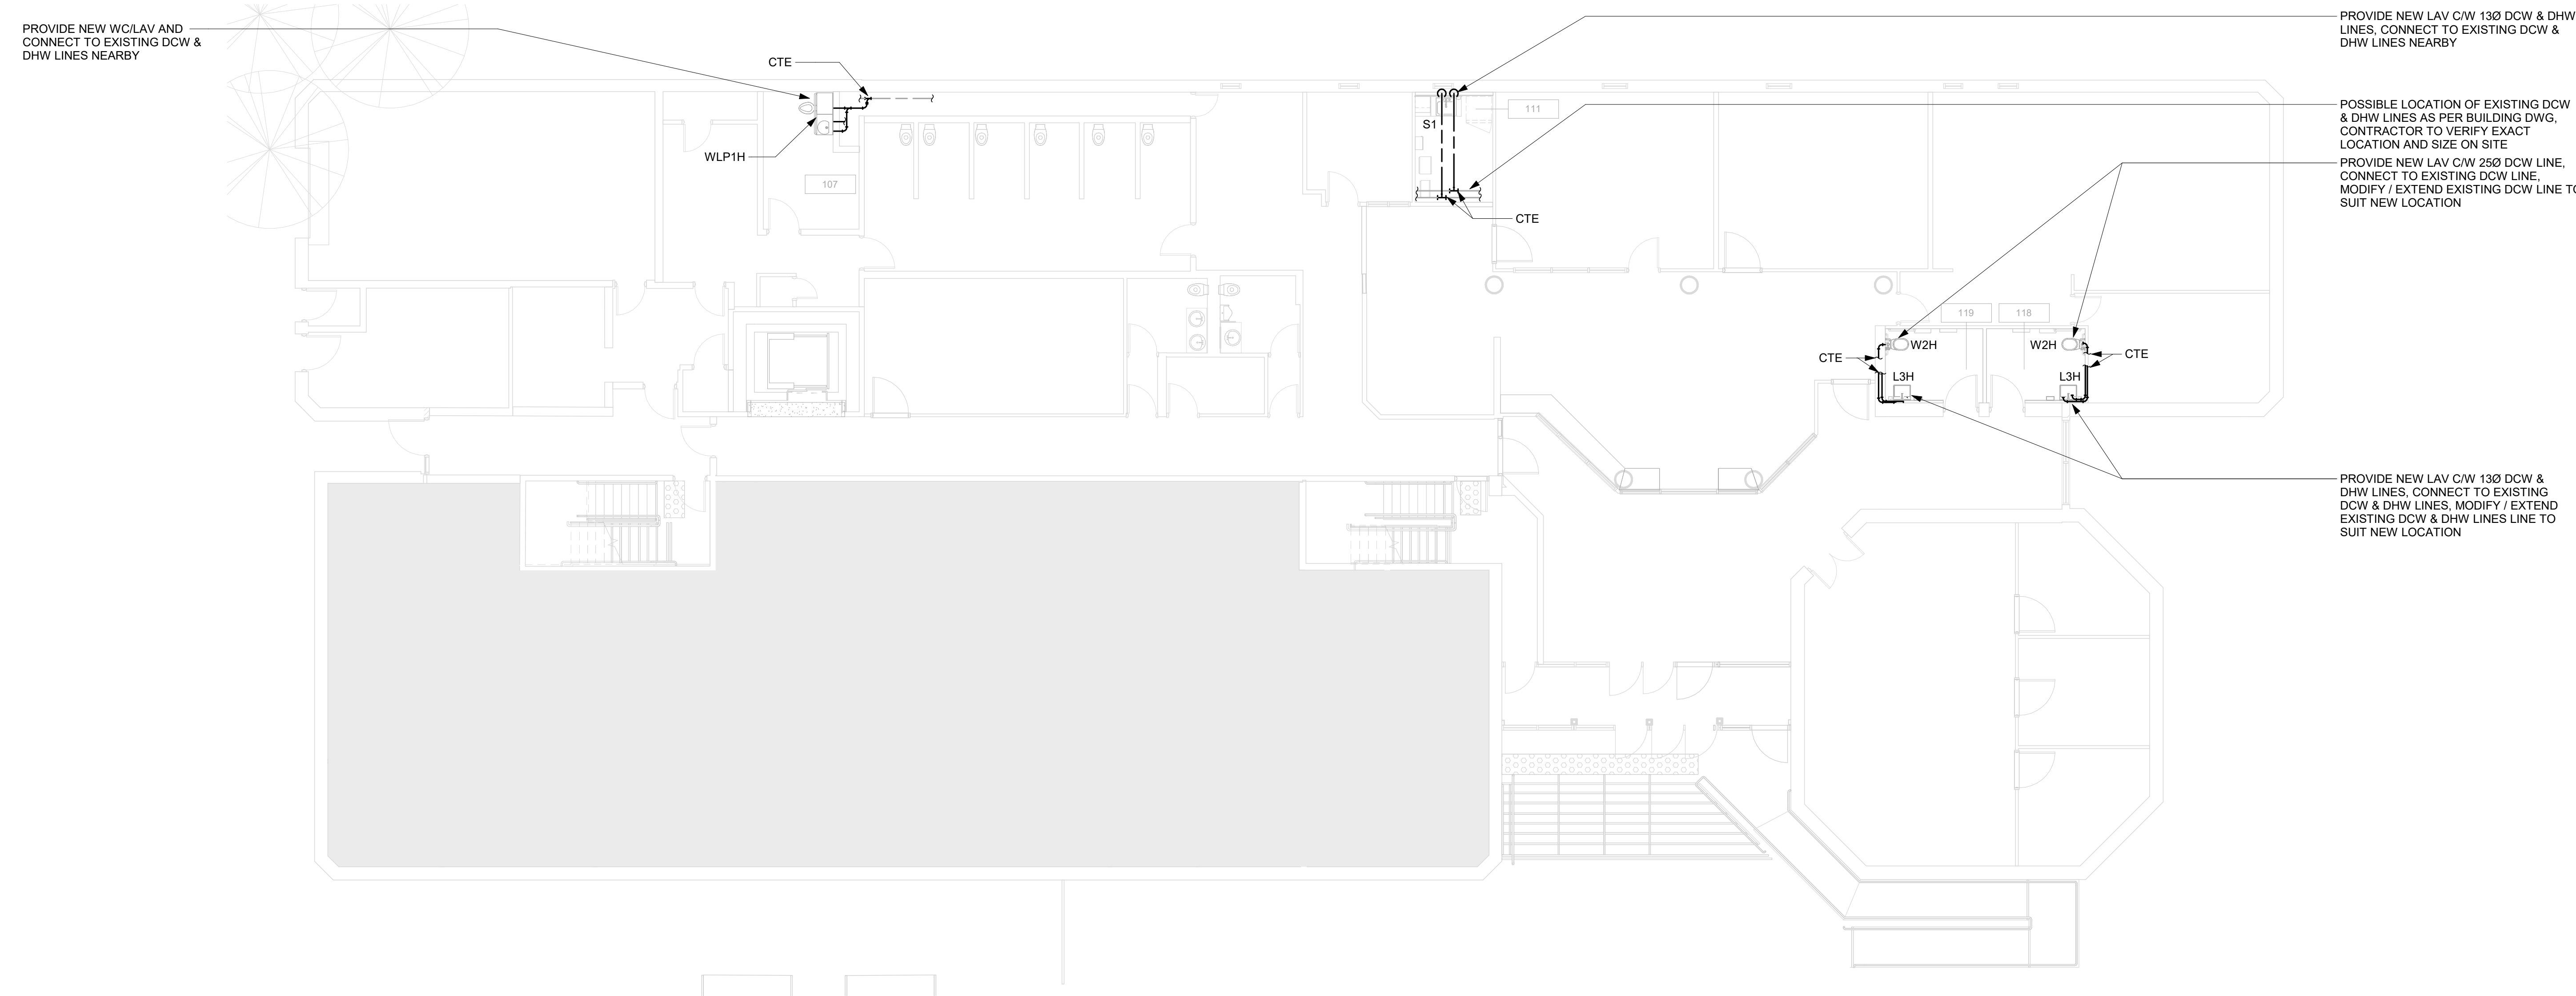

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PROJECT ADDRESS
50 UPJOHN RD

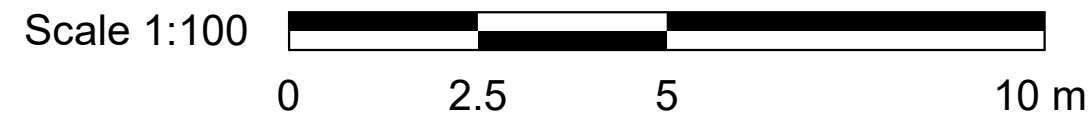PROJECT NO:
Arcadis 30279056

DRAWN BY:
K.DURUKAN

CHECKED BY:
B.LIAO

PROJECT MGR:
F. BOLOURIAN

APPROVED BY:
S.LIU

SHEET TITLE
**PLUMBING - GROUND
FLOOR**


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G05-249-M2101

ISSUE
D

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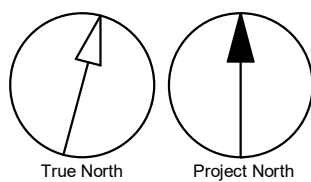
SCALE CHECK
1 m



1 PLUMBING - THIRD FLOOR
M2102 Scale: 1 : 100

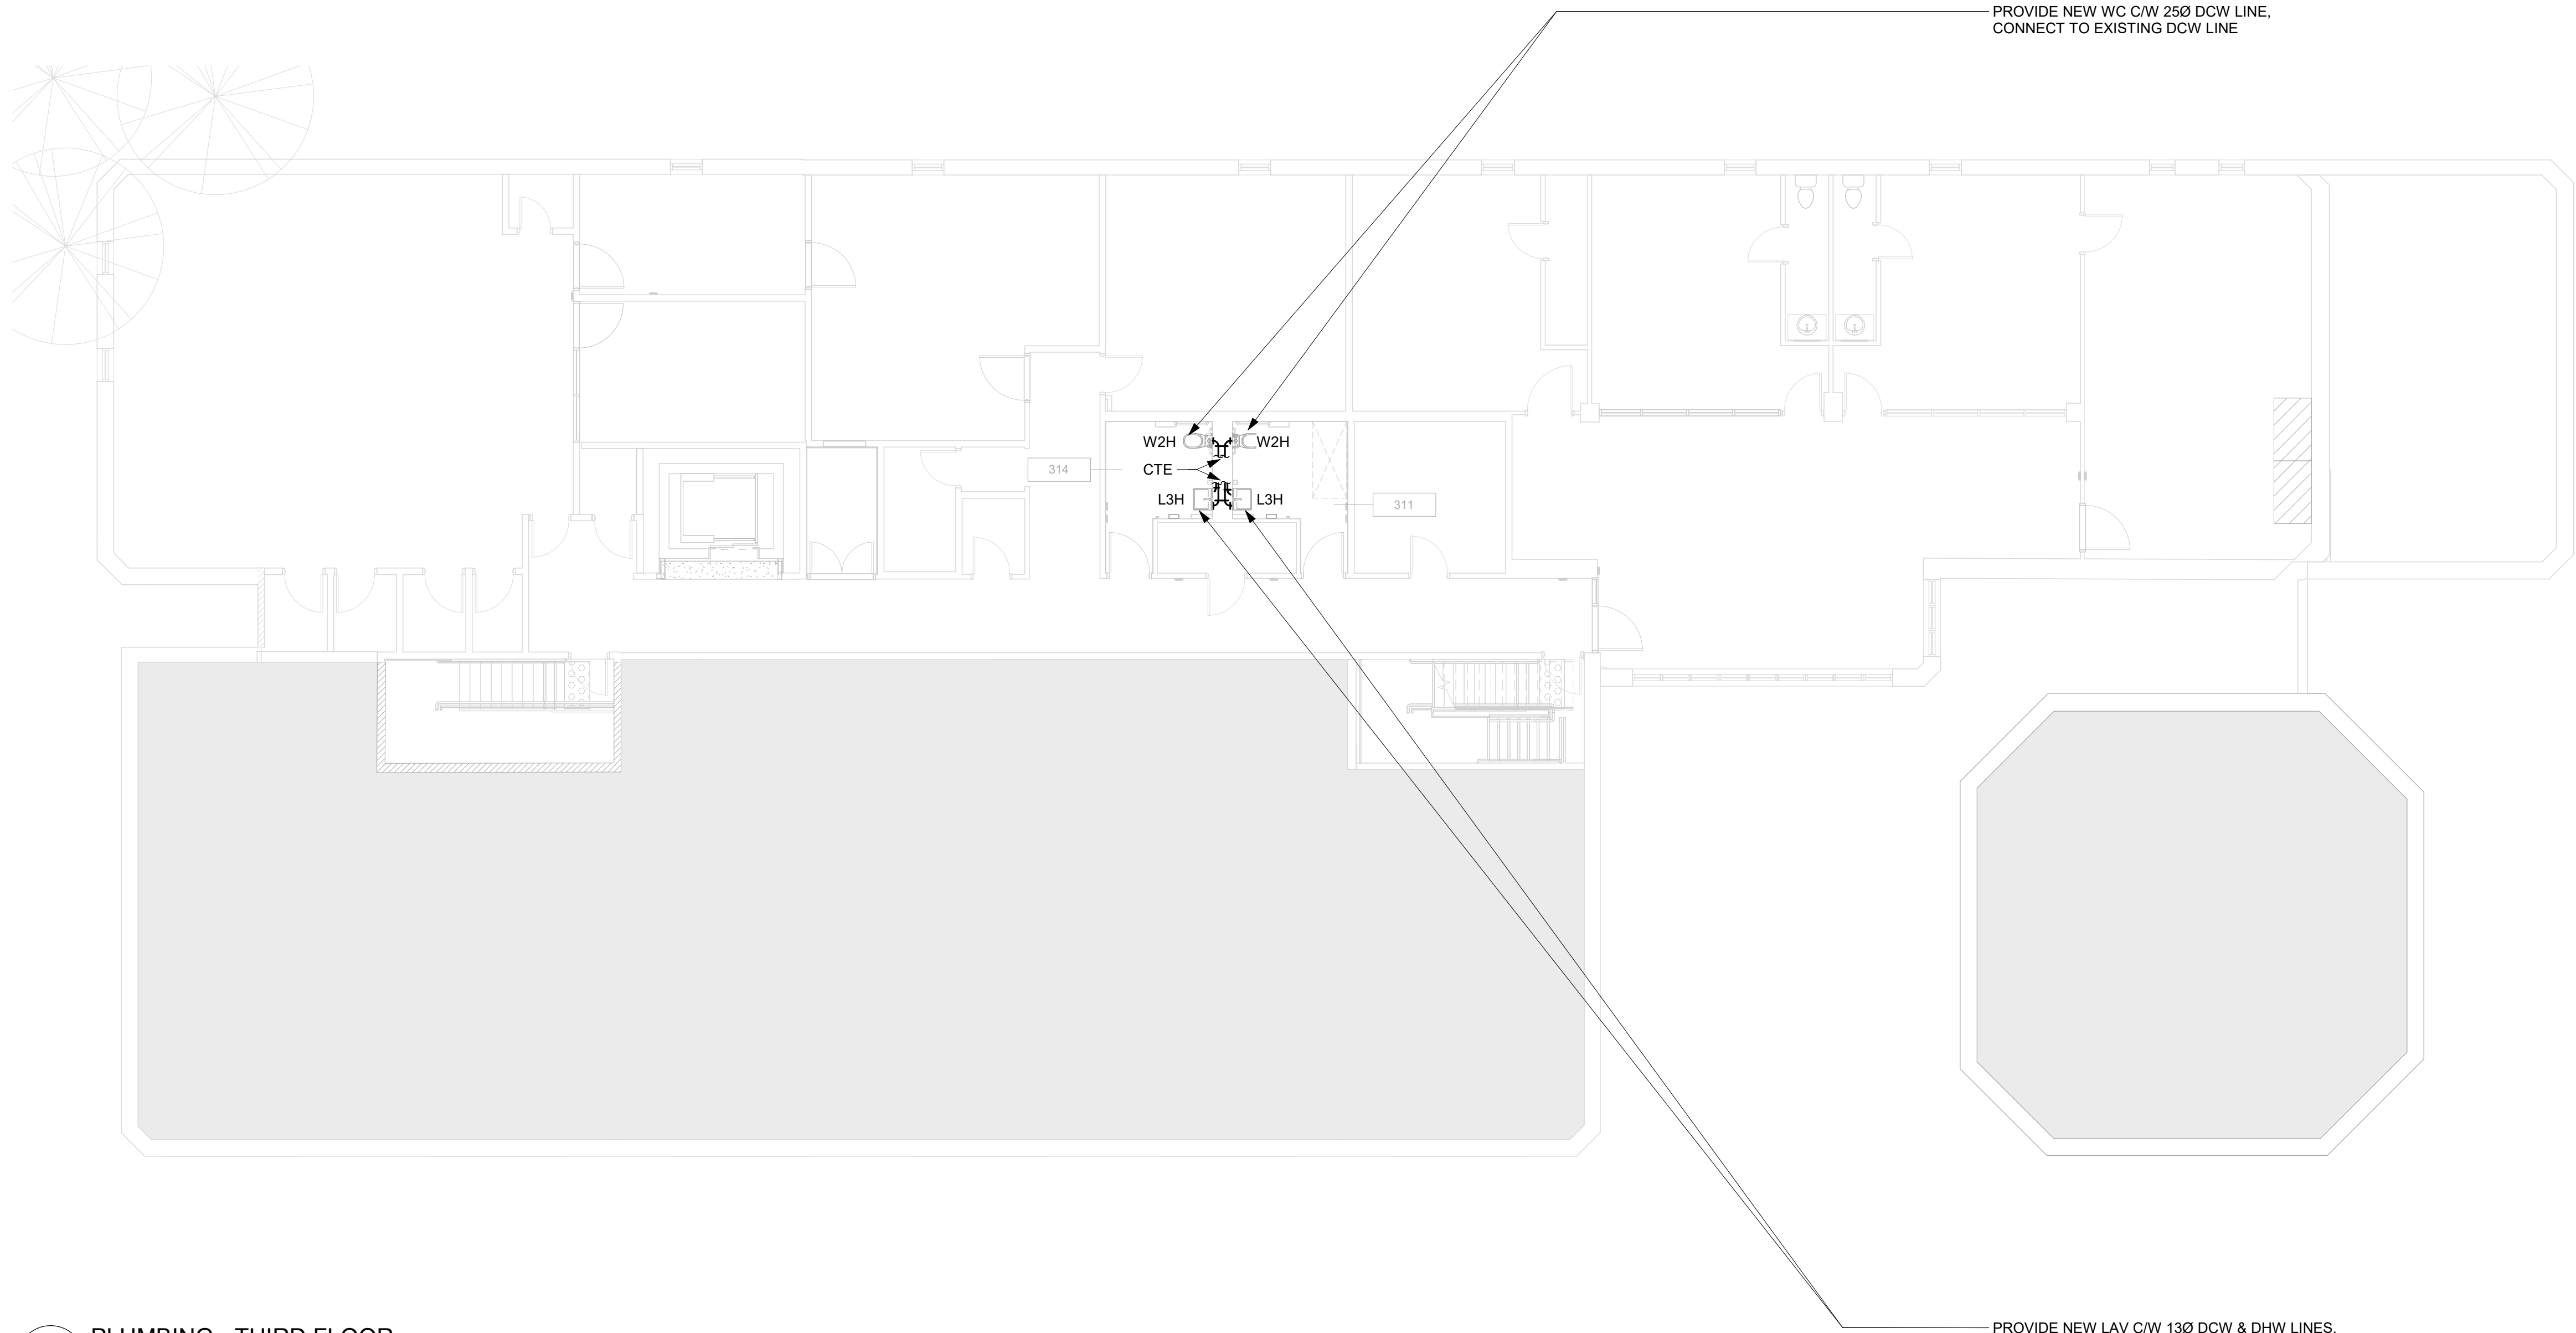Scale 1:100 0 2.5 5 10 m

- GENERAL NOTES:
- REFER TO SPECIFICATIONS FOR PLUMBING FIXTURE UNIT TYPES.
 - ALL NEW FIXTURES TO BE FITTED WITH ISOLATION VALVES.



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PROJECT MGR:
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SHEET TITLE
**PLUMBING - THIRD
FLOOR**

SHEET NUMBER

G05-249-M2102

ISSUE

D

PROVIDE NEW 100Ø SAN LINE SERVING ELEVATOR SHAFT AND CONNECT TO EXISTING SAN MAIN LINE NEARBY. CONTRACTOR SHALL VERIFY EXACT EXISTING LOCATION, SIZE AND INVERT ON SITE. COORDINATE ON SITE FOR EXACT PIPING ROUTE AND PATH / REPAIR CONCRETE SLAB TO MAKE GOOD FINISH

POSSIBLE LOCATION OF EXISTING SAN MAIN LINE BELOW SLAB CONNECTED WITH EXISTING EXPOSED PIPING. CONTRACTOR TO VERIFY / LOCATE EXACT LOCATION, INVERT AND SIZE ON SITE

EXISTING EXPOSED SAN LINE IN CRAWL SPACE AND DOWN TO BELOW GRADE. CONTRACTOR TO VERIFY EXACT FUNCTION, LOCATION, SIZE AND INVERT ON SITE

PROVIDE RUNNING TRAP WITH CLEANOUT

PROVIDE 100Ø SAN LINE AND PIT DRAIN INTERATED BACKFLOW VALVE, WATTS BV-600 OR EQUAL


APPROX. LOCATION OF EXISTING STM LINE DN. TO BELOW SLAB. CONTRACTOR TO VERIFY EXACT LOCATION ON SITE, ADJUST PIPING WHEN REQUIRED TO SUIT NEW ELEVATOR FOUNDATION

EXISTING EXPOSED SAN LINE IN CRAWL SPACE AND DOWN TO BELOW GRADE. CONTRACTOR TO VERIFY EXACT FUNCTION, LOCATION, SIZE AND INVERT ON SITE


EXISTING CRAWL SPACE

CTE


EX

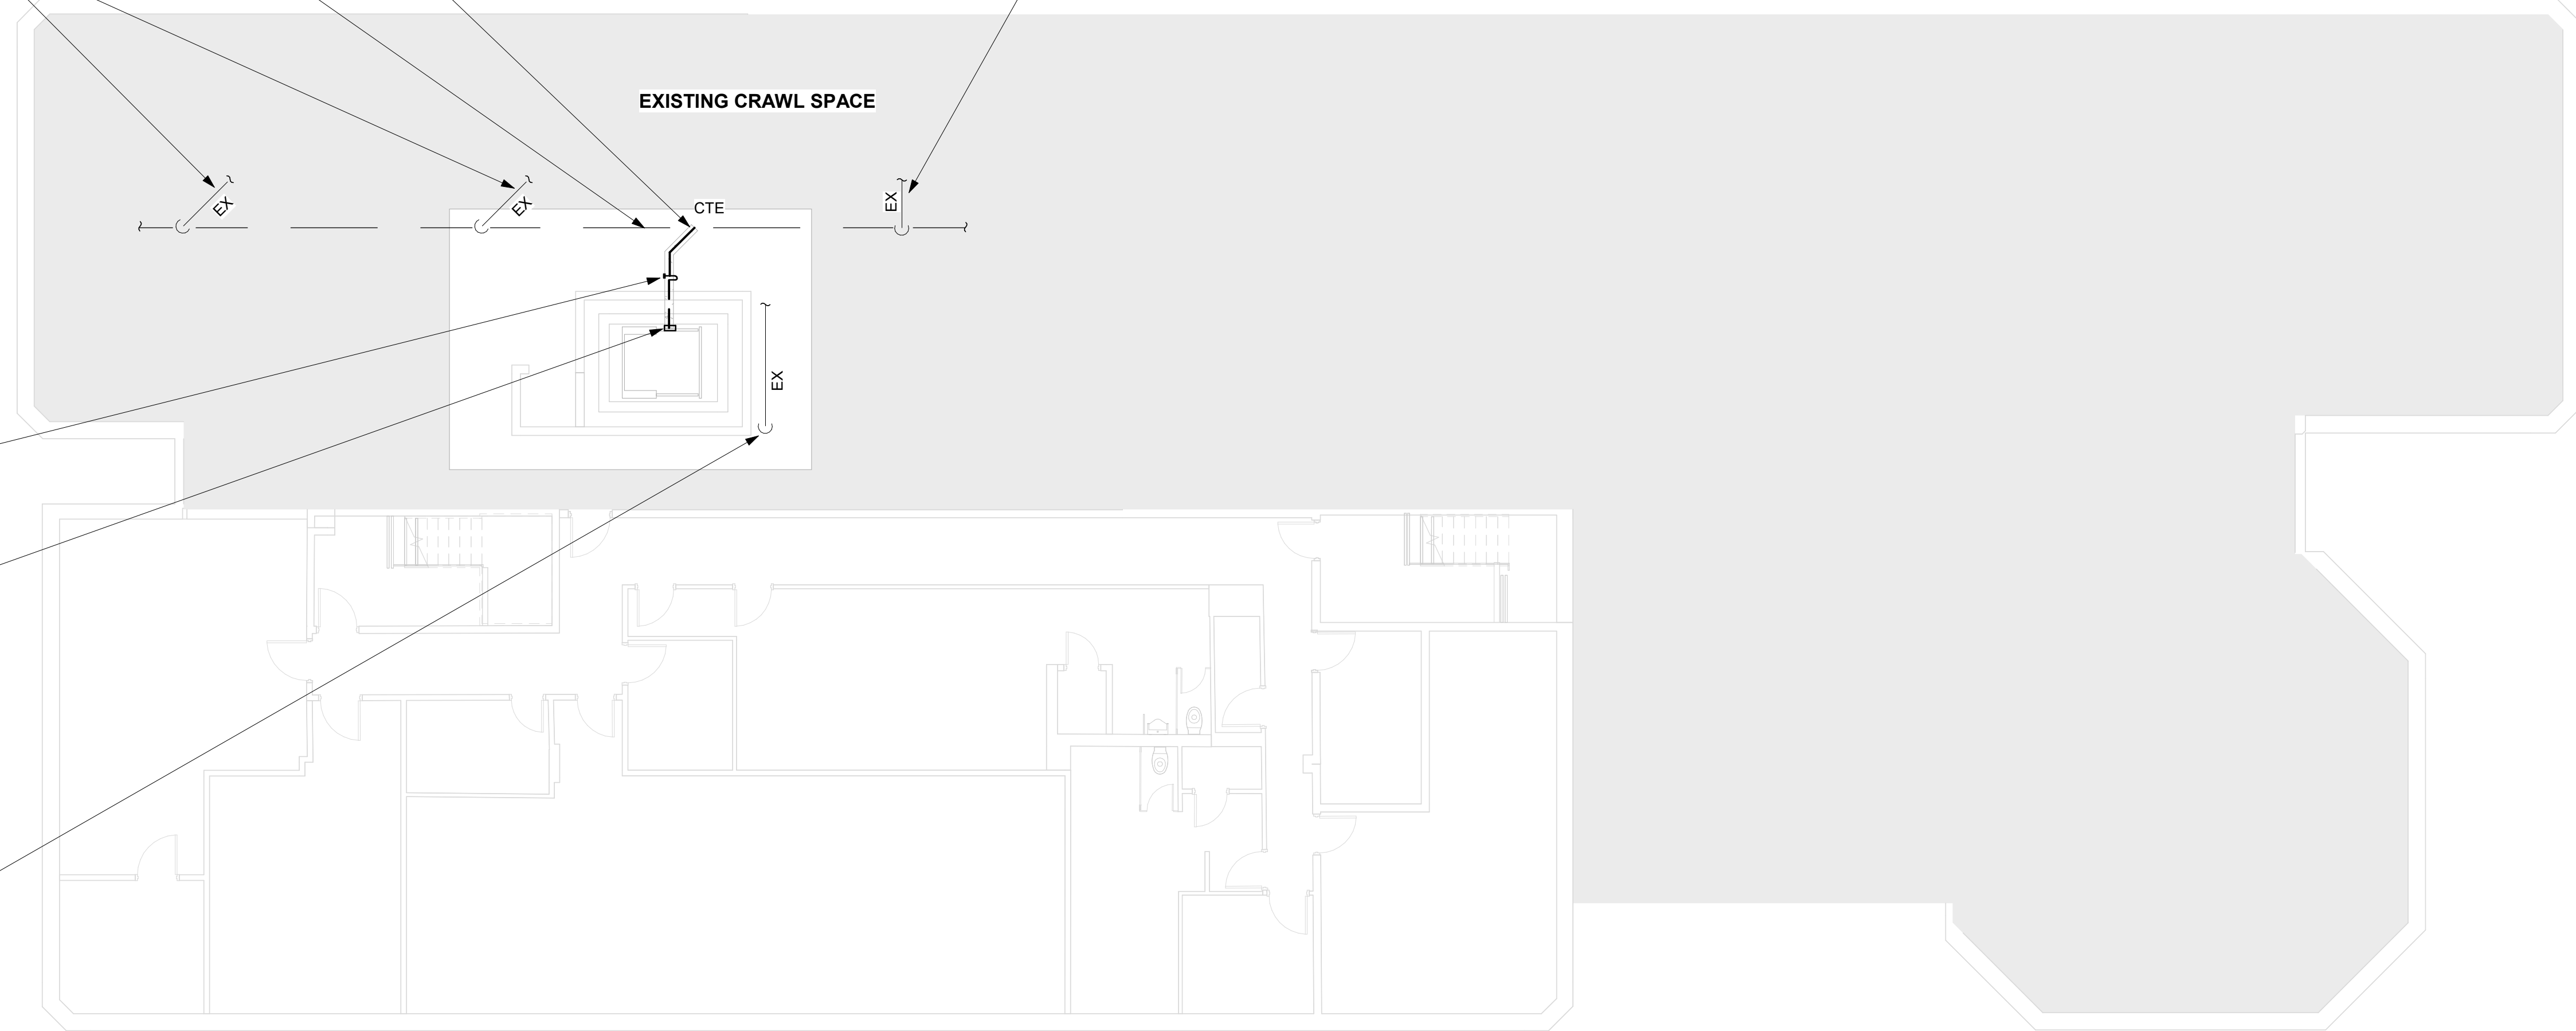

1 DRAINAGE - BASEMENT
M3101 Scale: 1 : 100

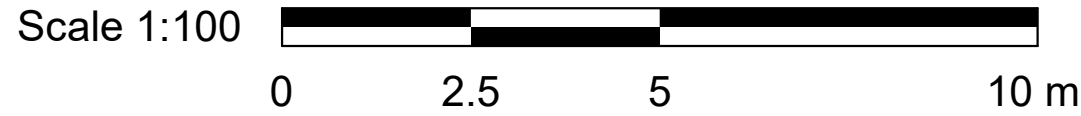

- GENERAL NOTES:
- REFER TO SPECIFICATIONS FOR PLUMBING FIXTURE UNIT TYPES.
 - PROVIDE SANITARY VENT FOR EACH NEW PLUMBING FIXTURE AND CONNECT TO EXISTING SANITARY VENT MAIN.
 - PROVIDE P-TRAP FOR EACH PLUMBING FIXTURE AS PER OBC.
 - ALL NEW FLOOR DRAINS SHALL BE C/W P-TRAP AND PRIMER.
 - PROVIDE FIRE STOP FOR ALL PIPE PENETRATIONS THROUGH FIRE SEPERATIONS.
 - ALL UNDERGROUND SANITARY PIPING SHALL BE MINIMUM 75mmØ UNLESS OTHERWISE NOTED.

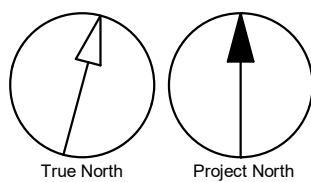

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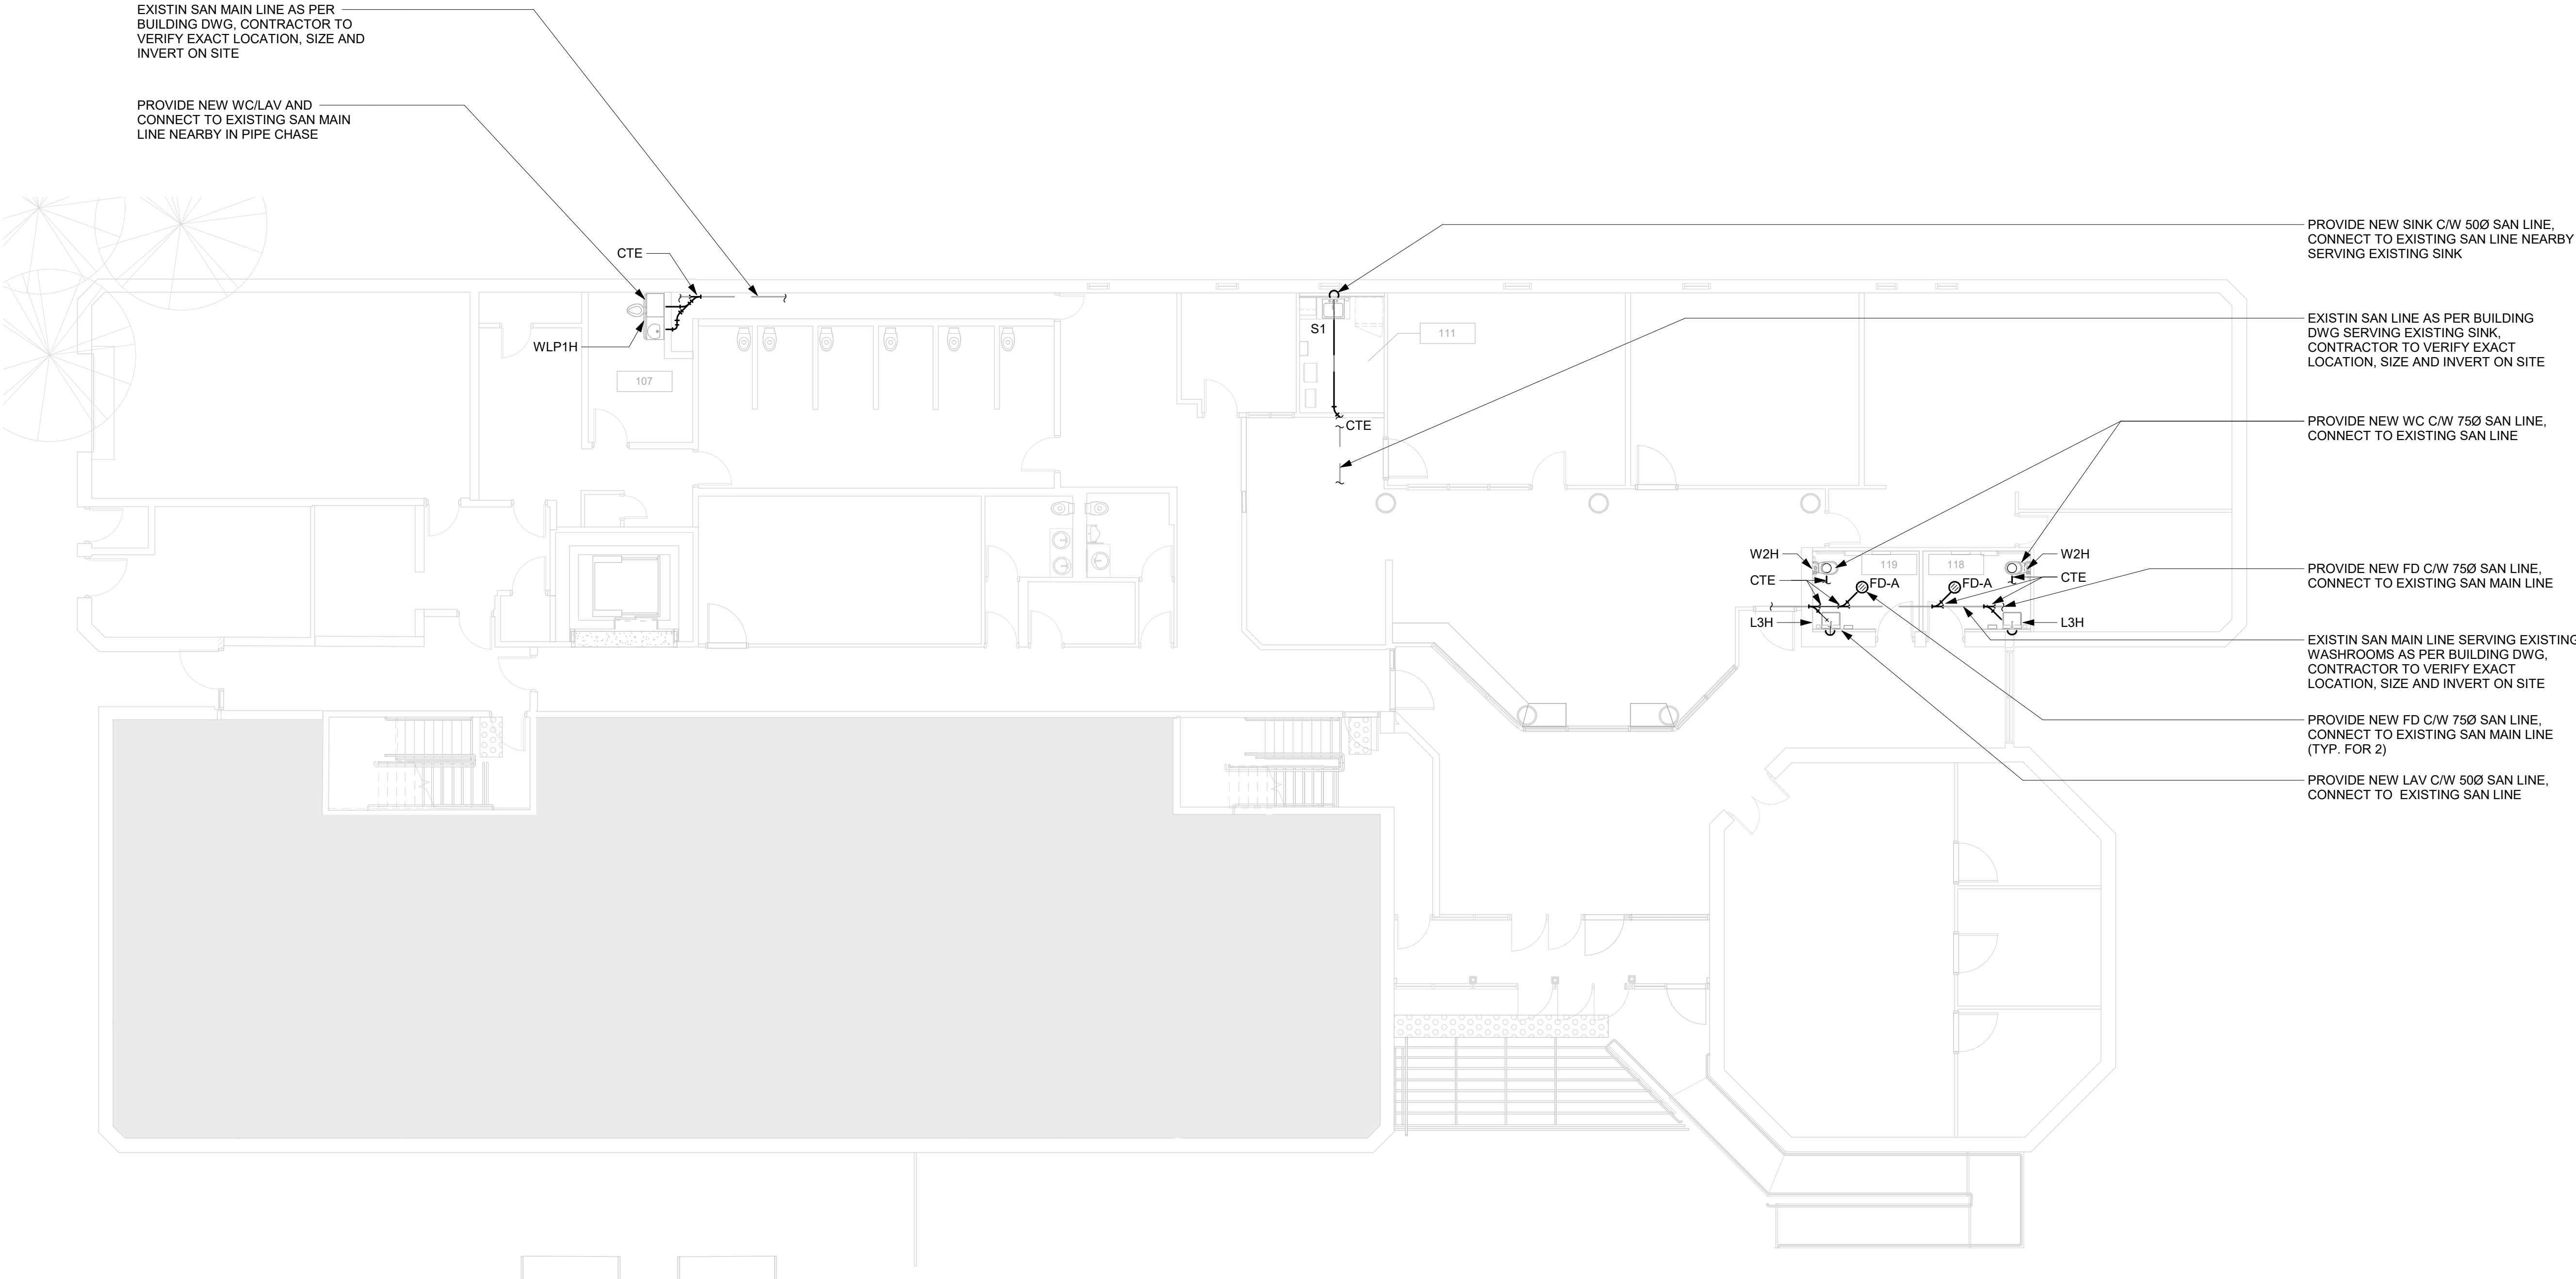
PROJECT TITLE
CITY OF TORONTO
ACCESSIBILITY UPGRADES

PROJECT ADDRESS
50 UPJOHN RD

PROJECT NO: Arcadis 30279056	
DRAWN BY: K.DURUKAN	CHECKED BY: B.LIAO
PROJECT MGR: F. BOLOURIAN	APPROVED BY: S.LIU



SHEET TITLE
DRAINAGE - BASEMENT

SHEET NUMBER G05-249-M3101	ISSUE D
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1 DRAINAGE - GROUND FLOOR
M3102 Scale: 1 : 100

- GENERAL NOTES:
- REFER TO SPECIFICATIONS FOR PLUMBING FIXTURE UNIT TYPES.
 - PROVIDE SANITARY VENT FOR EACH NEW PLUMBING FIXTURE AND CONNECT TO EXISTING SANITARY VENT MAIN.
 - PROVIDE P-TRAP FOR EACH PLUMBING FIXTURE AS PER OBC.
 - ALL NEW FLOOR DRAINS SHALL BE C/W P-TRAP AND PRIMER.
 - PROVIDE FIRE STOP FOR ALL PIPE PENETRATIONS THROUGH FIRE SEPERATIONS.
 - ALL UNDERGROUND SANITARY PIPING SHALL BE MINIMUM 75mmØ UNLESS OTHERWISE NOTED.



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CHECKED BY:
B.LIAO

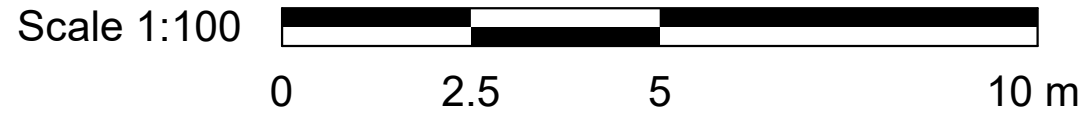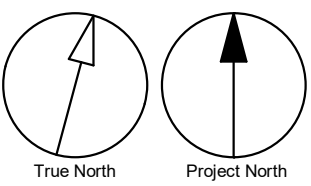PROJECT MGR:
F. BOLOURIAN

APPROVED BY:
S.LIU


SHEET TITLE
**DRAINAGE - GROUND
FLOOR**

SHEET NUMBER


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ISSUE


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1 DRAINAGE - THIRD FLOOR
M3103 Scale: 1 : 100

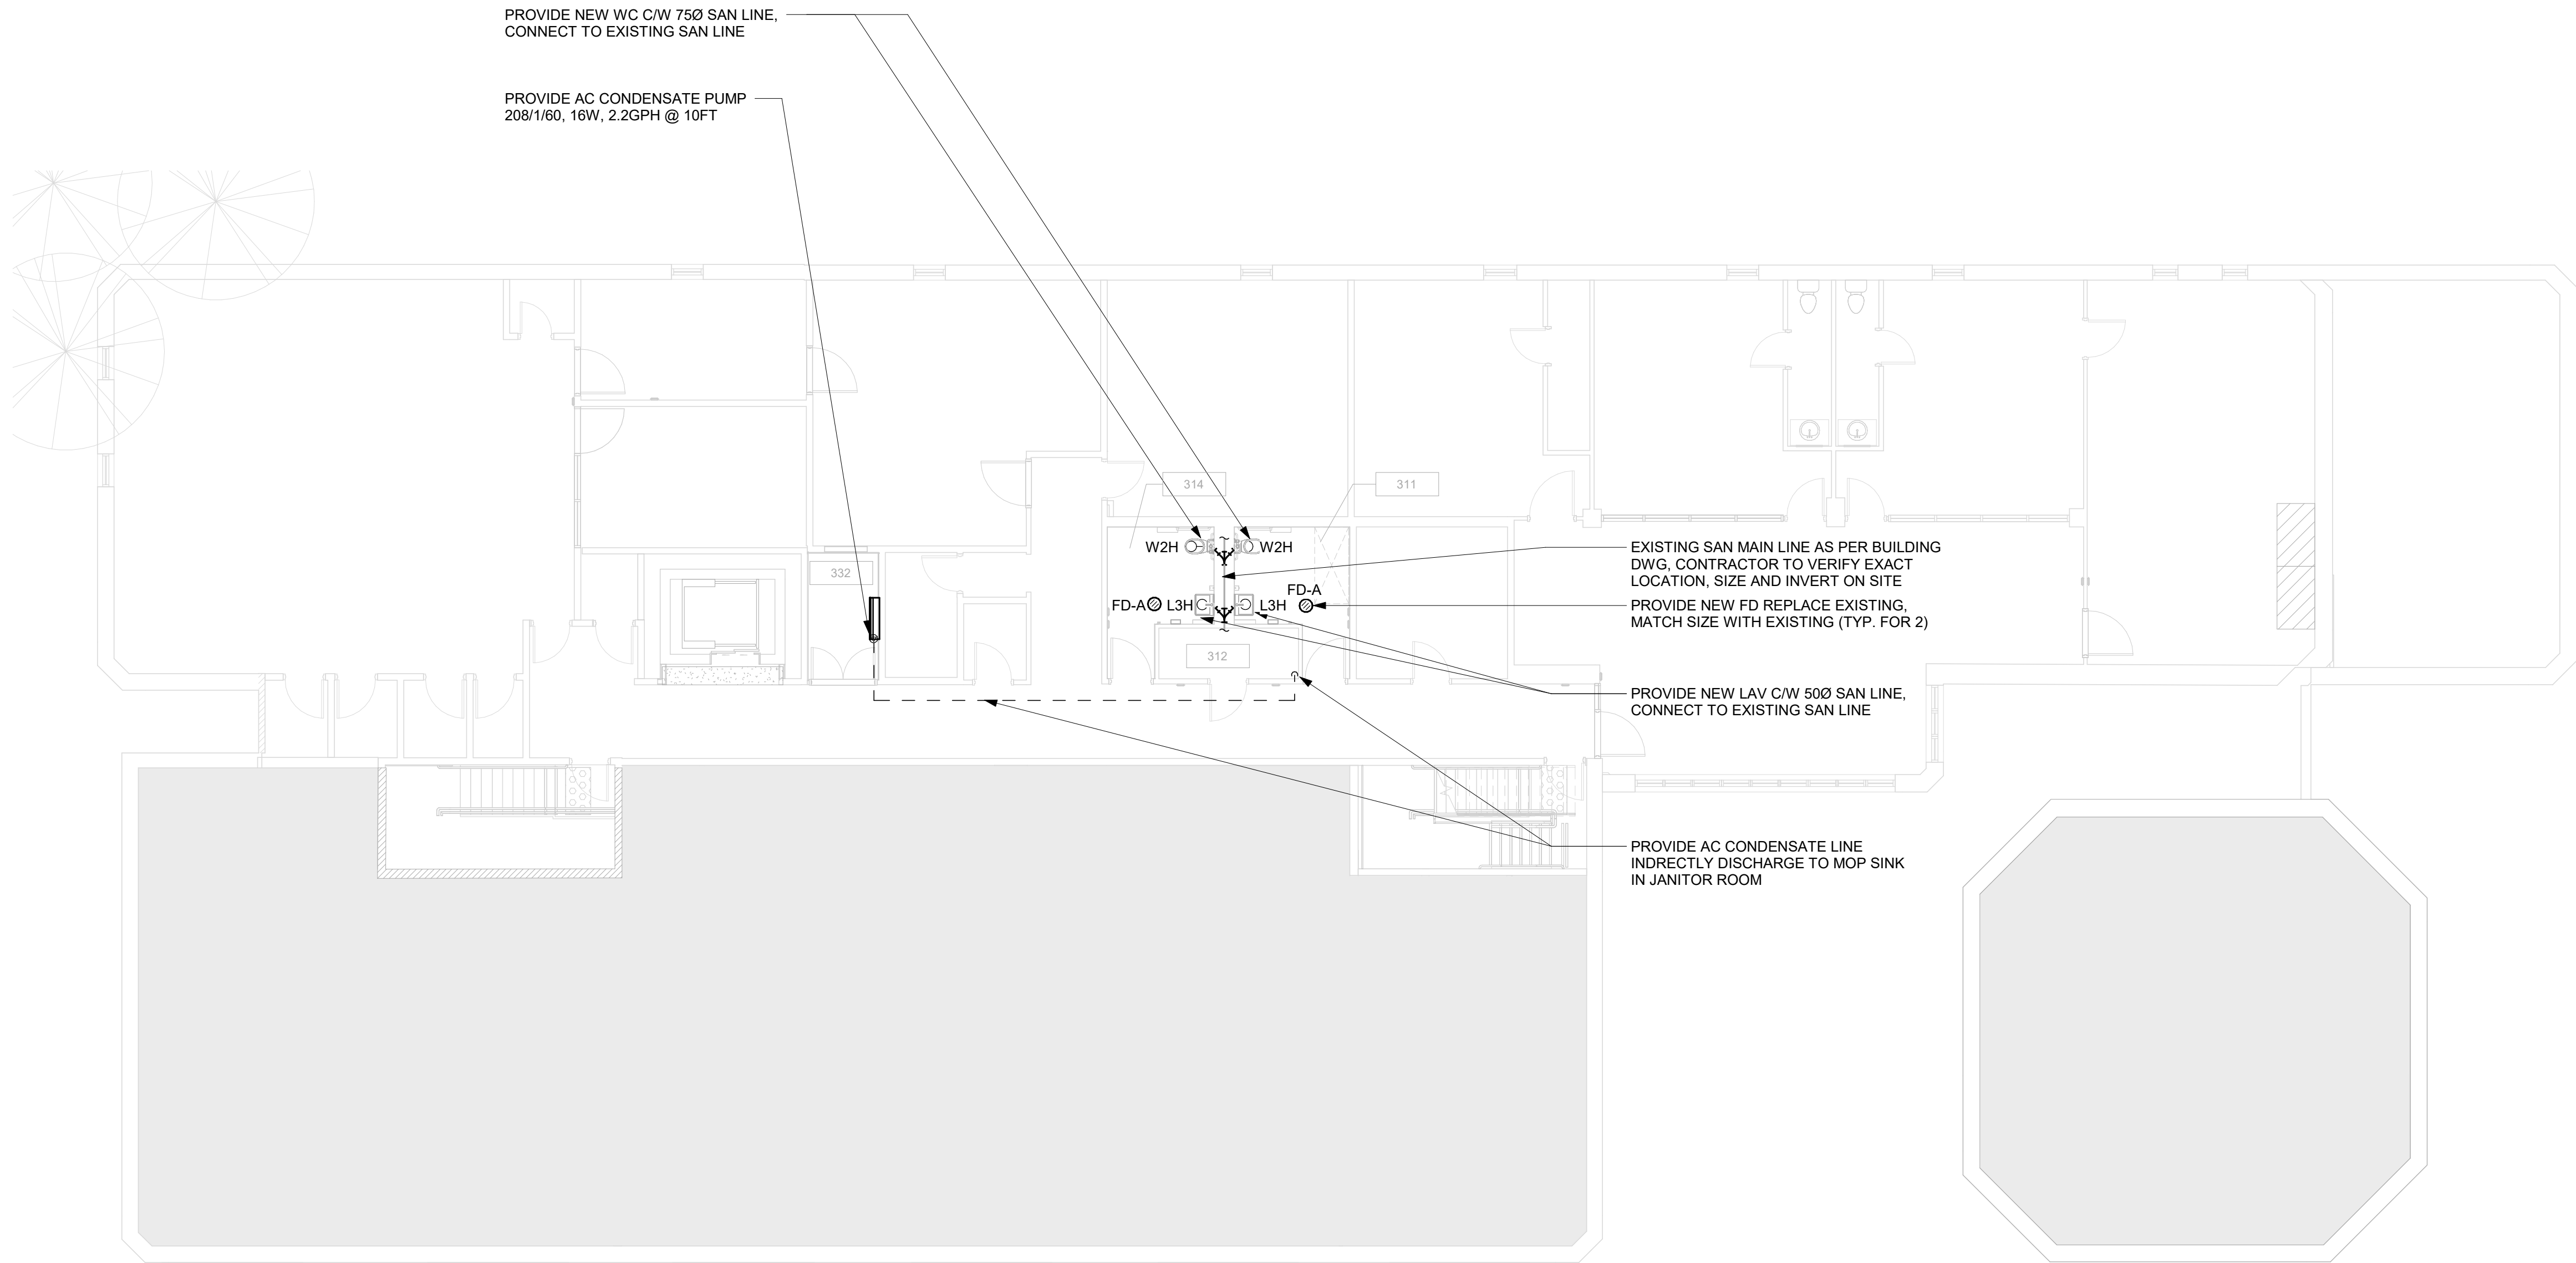

- GENERAL NOTES:
- REFER TO SPECIFICATIONS FOR PLUMBING FIXTURE UNIT TYPES.
 - PROVIDE SANITARY VENT FOR EACH NEW PLUMBING FIXTURE AND CONNECT TO EXISTING SANITARY VENT MAIN.
 - PROVIDE P-TRAP FOR EACH PLUMBING FIXTURE AS PER OBC.
 - ALL NEW FLOOR DRAINS SHALL BE C/W P-TRAP AND PRIMER.
 - PROVIDE FIRE STOP FOR ALL PIPE PENETRATIONS THROUGH FIRE SEPERATIONS.
 - ALL UNDERGROUND SANITARY PIPING SHALL BE MINIMUM 75mmØ UNLESS OTHERWISE NOTED.

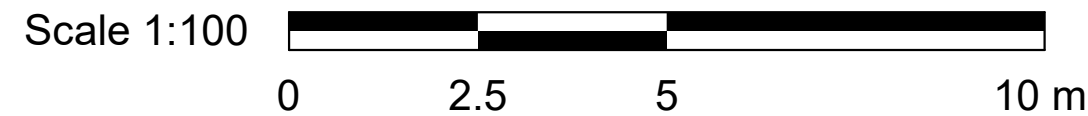

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PROJECT NO:
Arcadis 30279056

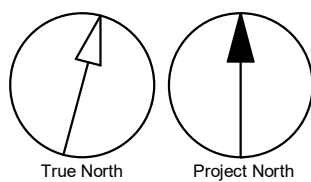DRAWN BY:
K.DURUKAN

CHECKED BY:
B.LIAO

PROJECT MGR:
F. BOLOURIAN

APPROVED BY:
S.LIU

SHEET TITLE
**DRAINAGE - THIRD
FLOOR**


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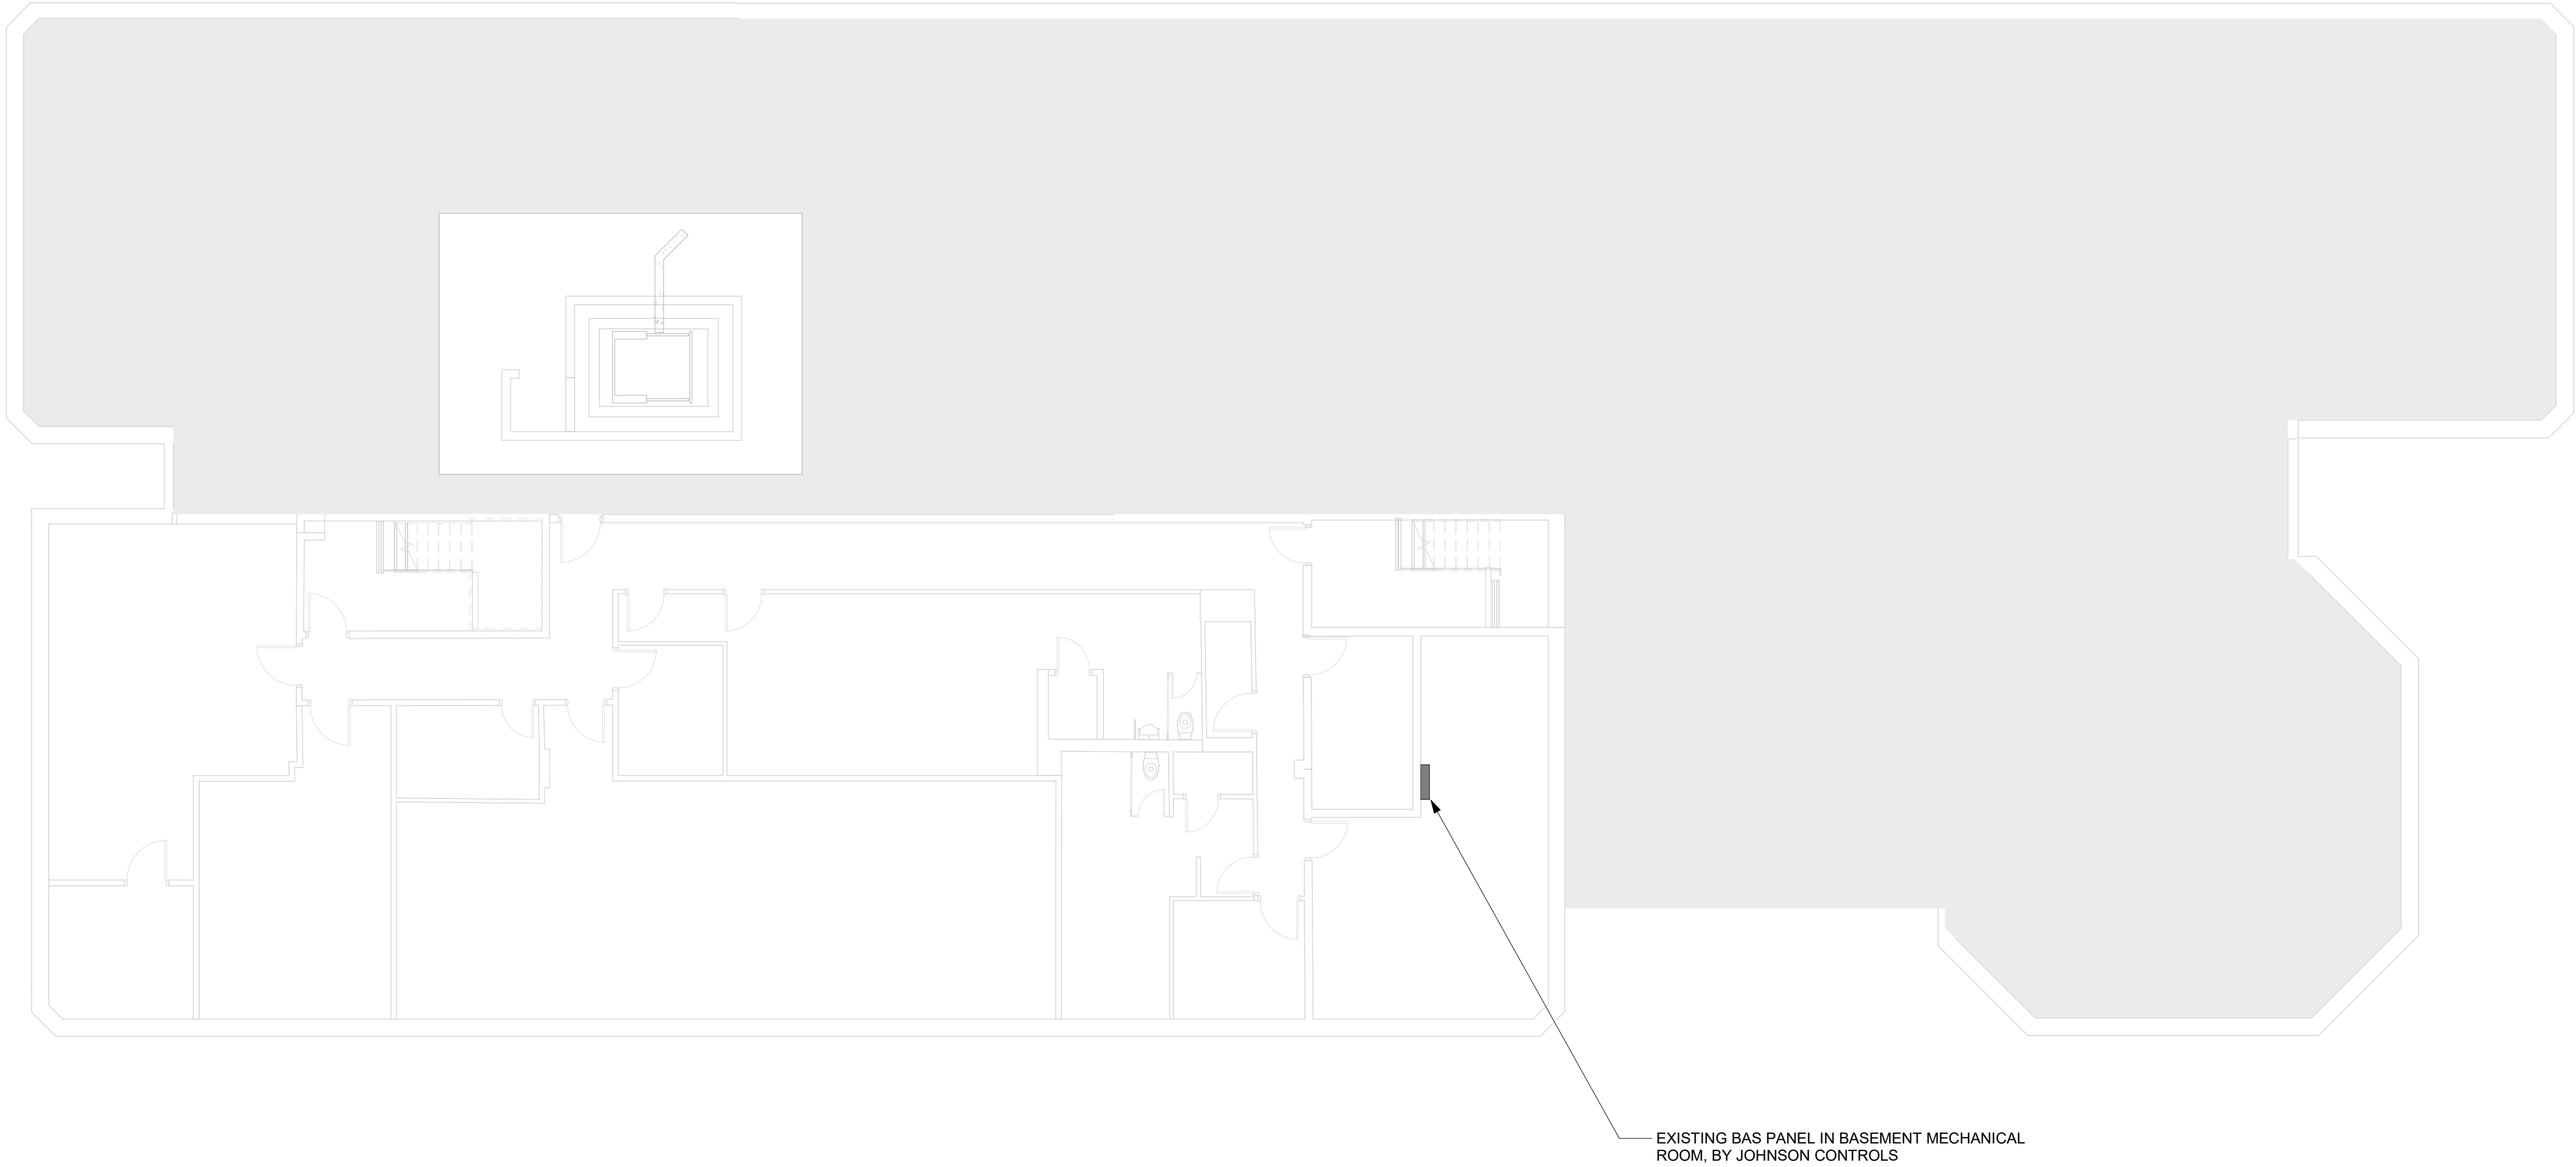
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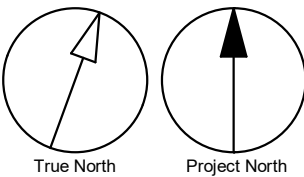
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1 HVAC - BASEMENT
M5101 Scale: 1 : 100



- GENERAL NOTES:
1. ADD AND ADJUST DUCTS TO FIT NEW DIFFUSERS/GRILLES.
 2. THERMOSTATS TO BE MOUNTED AT 1200mm A.F.F.
 3. RETAIN BASE BUILDING BAS CONTRACTOR FOR BAS SCOPE OF WORK.



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tel 416 679 1930 fax 416 675 4620
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PROJECT TITLE
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ACCESSIBILITY UPGRADES
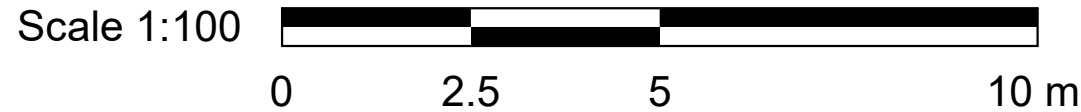
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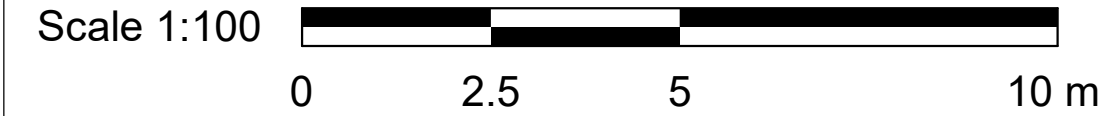
PROJECT NO: Arcadis 30279056	
DRAWN BY: K.DURUKAN	CHECKED BY: B.LIAO
PROJECT MGR: F.BOLOURIAN	APPROVED BY: S.LIU

SHEET TITLE
HVAC - BASEMENT

SHEET NUMBER G05-249-M5101	ISSUE D
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10mm
1 m

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1 HVAC - GROUND FLOOR
M5102 Scale: 1 : 100

RELOCATE EXISTING SECURITY GRILLE ON
PROPOSED WALL. EXTEND EXISTING
DUCTWORK TO SUIT NEW LOCATION

CTE


RE-INSTALL THERMOSTAT
TO ACCOMODATE DOOR
WIDENING WORK. REFER
ARCH DWG FOR EXACT
DOOR REPLACEMENT
WORK. MODIFY/EXTEND
EXISTING WIRE AND BAS
CABLE WHEN REQUIRED
TO SUIT NEW LOCATION.

RE-INSTALL THERMOSTAT TO
ACCOMODATE DOOR WIDENING
WORK. REFER ARCH DWG FOR EXACT
DOOR REPLACEMENT WORK.
MODIFY/EXTEND EXISTING WIRE AND
BAS CABLE WHEN REQUIRED TO SUIT
NEW LOCATION.

RELOCATE & RE-INSTALL EXHAUST GRILLE
AND CONNECT BACK TO EXISTING. MODIFY /
EXTEND EXISTING DUCTWORK TO RE-
CONNECT TO EXISTING IF REQUIRED

PROVIDE 25MM DOOR CUT

- GENERAL NOTES:
1. ADD AND ADJUST DUCTS TO FIT NEW DIFFUSERS/GRILLES.
 2. THERMOSTATS TO BE MOUNTED AT 1200mm A.F.F.
 3. RETAIN BASE BUILDING BAS CONTRACTOR FOR BAS SCOPE OF WORK.

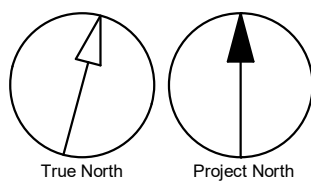

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PROJECT TITLE
**CITY OF TORONTO
ACCESSIBILITY UPGRADES**

PROJECT ADDRESS

50 UPJOHN RD

PROJECT NO:
Arcadis 30279056

DRAWN BY:
K.DURUKAN

CHECKED BY:
B.LIAO

PROJECT MGR:
F. BOLOURIAN

APPROVED BY:
S.LIU

SHEET TITLE
HVAC - GROUND FLOOR

SHEET NUMBER

G05-249-M5102


ISSUE

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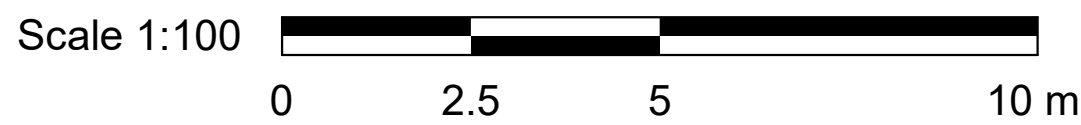
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10mm


SCALE CHECK
1 m



1 HVAC - THIRD FLOOR
M5103 / Scale: 1 : 100

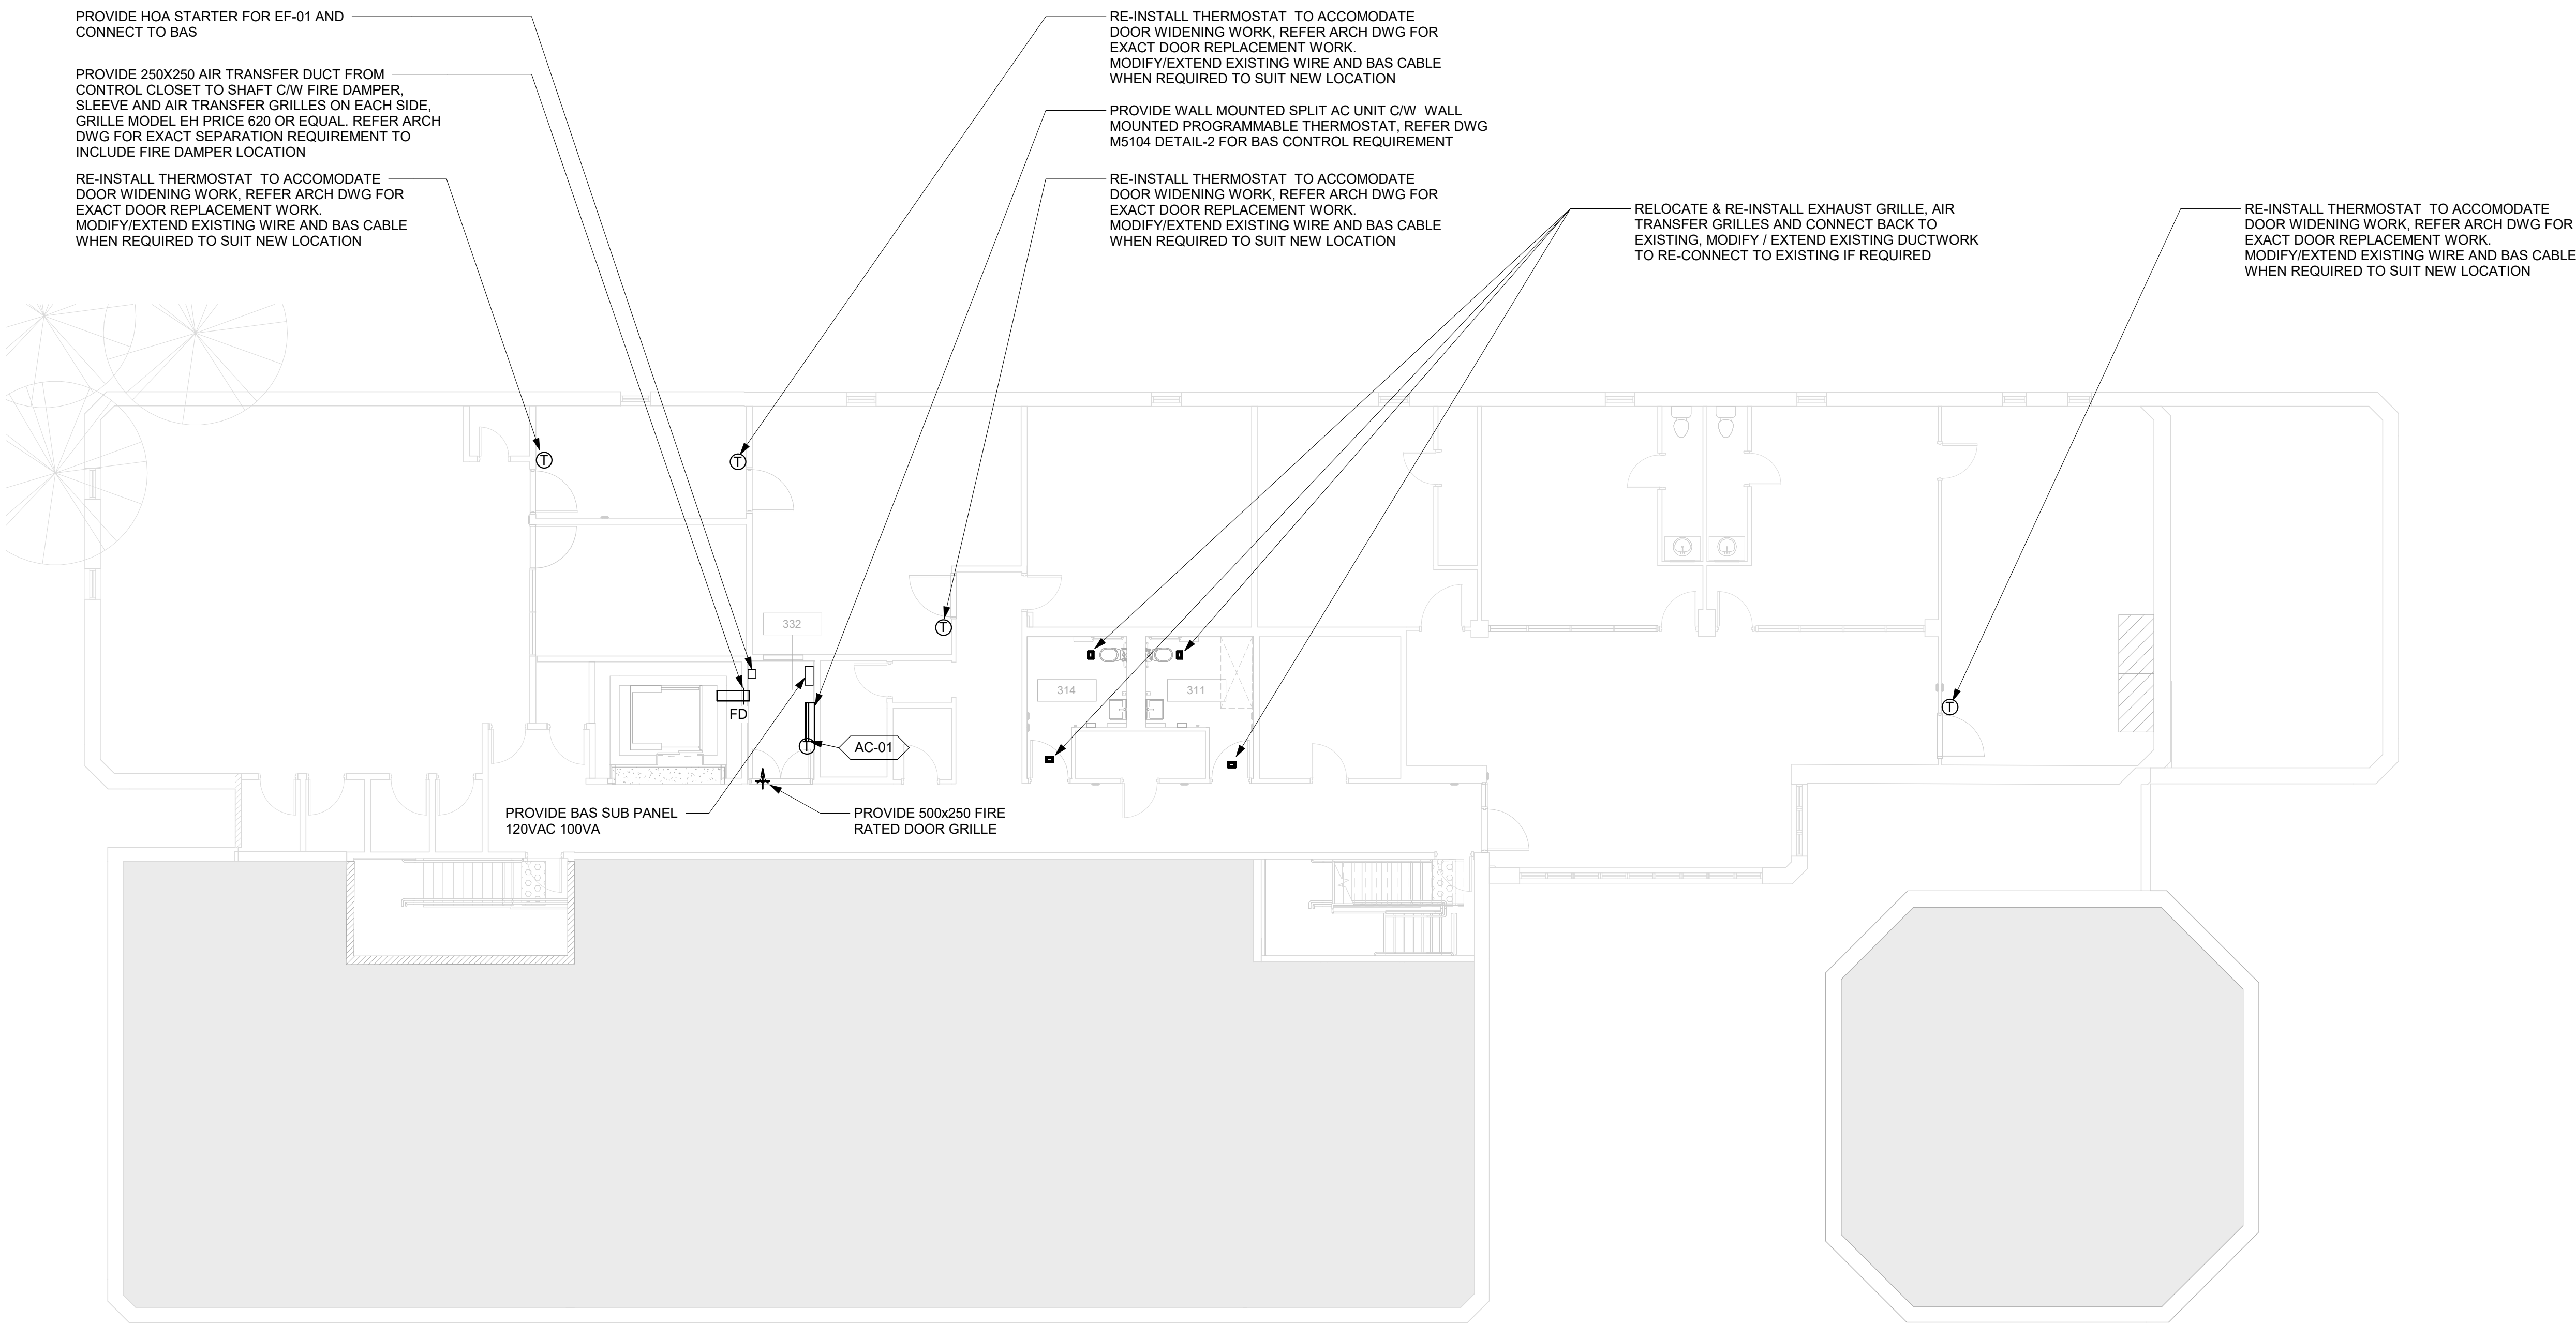

- GENERAL NOTES:
1. ADD AND ADJUST DUCTS TO FIT NEW DIFFUSERS/GRILLES.
 2. THERMOSTATS TO BE MOUNTED AT 1200mm A.F.F.
 3. RETAIN BASE BUILDING BAS CONTRACTOR FOR BAS SCOPE OF WORK.

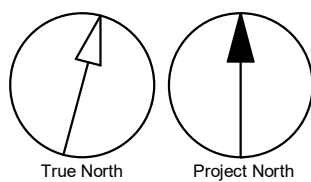

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B.LIAO

PROJECT MGR:
F. BOLOURIAN

APPROVED BY:
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SHEET TITLE
HVAC - THIRD FLOOR


SHEET NUMBER

G05-249-M5103


ISSUE

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1 HVAC - ROOF PLAN
M5104 Scale: 1 : 100

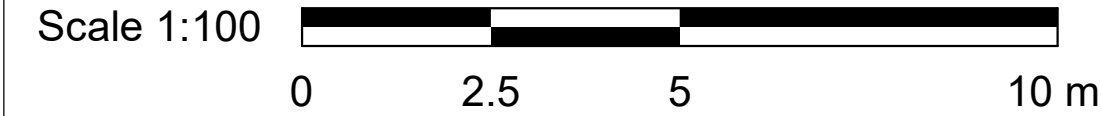

CONTROL SEQUENCES:

HEATING/COOLING CONTROL (ELEVATOR CONTROL CLOSET)

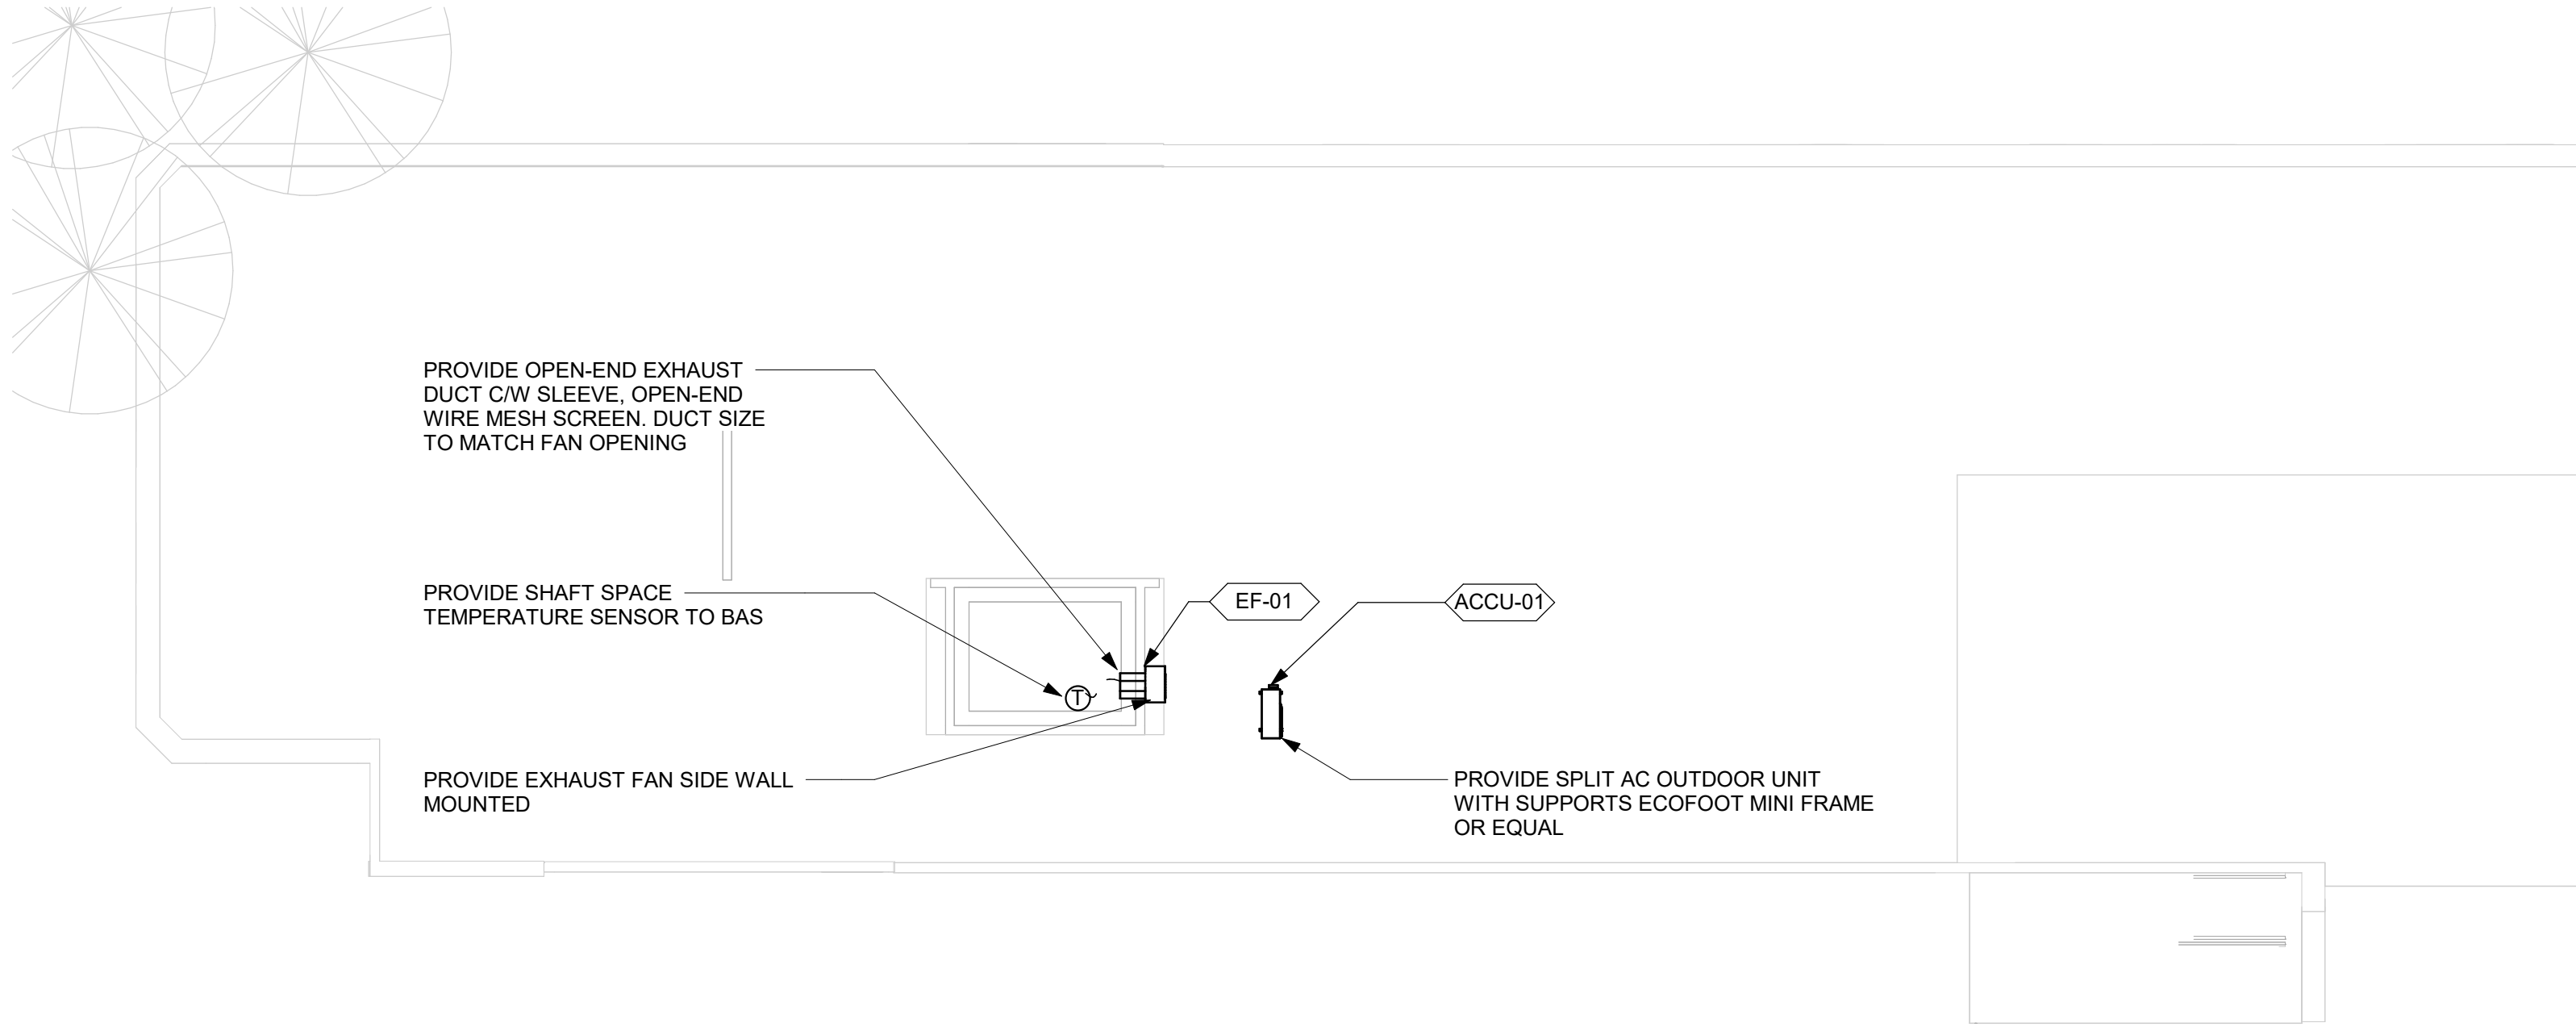SPACE HEATING AND COOLING SUPPLIED BY SPLIT AC OEM CONTROLLER BASED ON SPACE THERMOSTAT SETTING. SPACE TEMPERATURE TO BE MONITORED BY BAS AND AC UNIT OPERATION TO BE MONITORED & CONTROLLED BY BAS.

- COOLING TEMPERATURE SETTING : 24°C (FIELD/BAS ADJUSTABLE)
- HEATING TEMPERATURE SETTING : 22°C (FIELD/BAS ADJUSTABLE)
- BAS ALARM FOR: HIGH TEMPERATURE (ABOVE 30°C, ADJUSTABLE), LOW TEMPERATURE (BELOW 16°C, ADJUSTABLE), AC FAIL.


COOLING CONTROL (ELEVATOR SHAFT)

SPACE COOLING CONTROLLED BY REVERSE ACTING EXHAUST FAN BASED ON SHAFT TEMPERATURE SENSOR READING. SPACE TEMPERATURE TO BE MONITORED BY BAS AND EXHAUST FAN TO BE MONITORED & CONTROLLED BY BAS.

- COOLING TEMPERATURE SETTING, REVERSE ACTING THERMOSTAT EF-01: 24°C (FIELD/BAS ADJUSTABLE)
- BAS ALARM FOR: HIGH TEMPERATURE (ABOVE 30°C, ADJUSTABLE), LOW TEMPERATURE (BELOW 16°C, ADJUSTABLE), FAN FAIL.


EXISTING BAS INTEGRATION

INTEGRATING TO BASE BUILDING BAS SYSTEM: FACILITY EXPLORER BY JOHNSON CONTROLS. INCLUDING BAS PANEL, CONTROLLER, SPACE TEMPERATURE SENSOR, WIRING, TRAINING AND EXISTING GRAPHIC USER INTERFACE UPDATE AND ALL OTHER NECESSARY DEVICES TO FORM A COMPLETE SYSTEM.

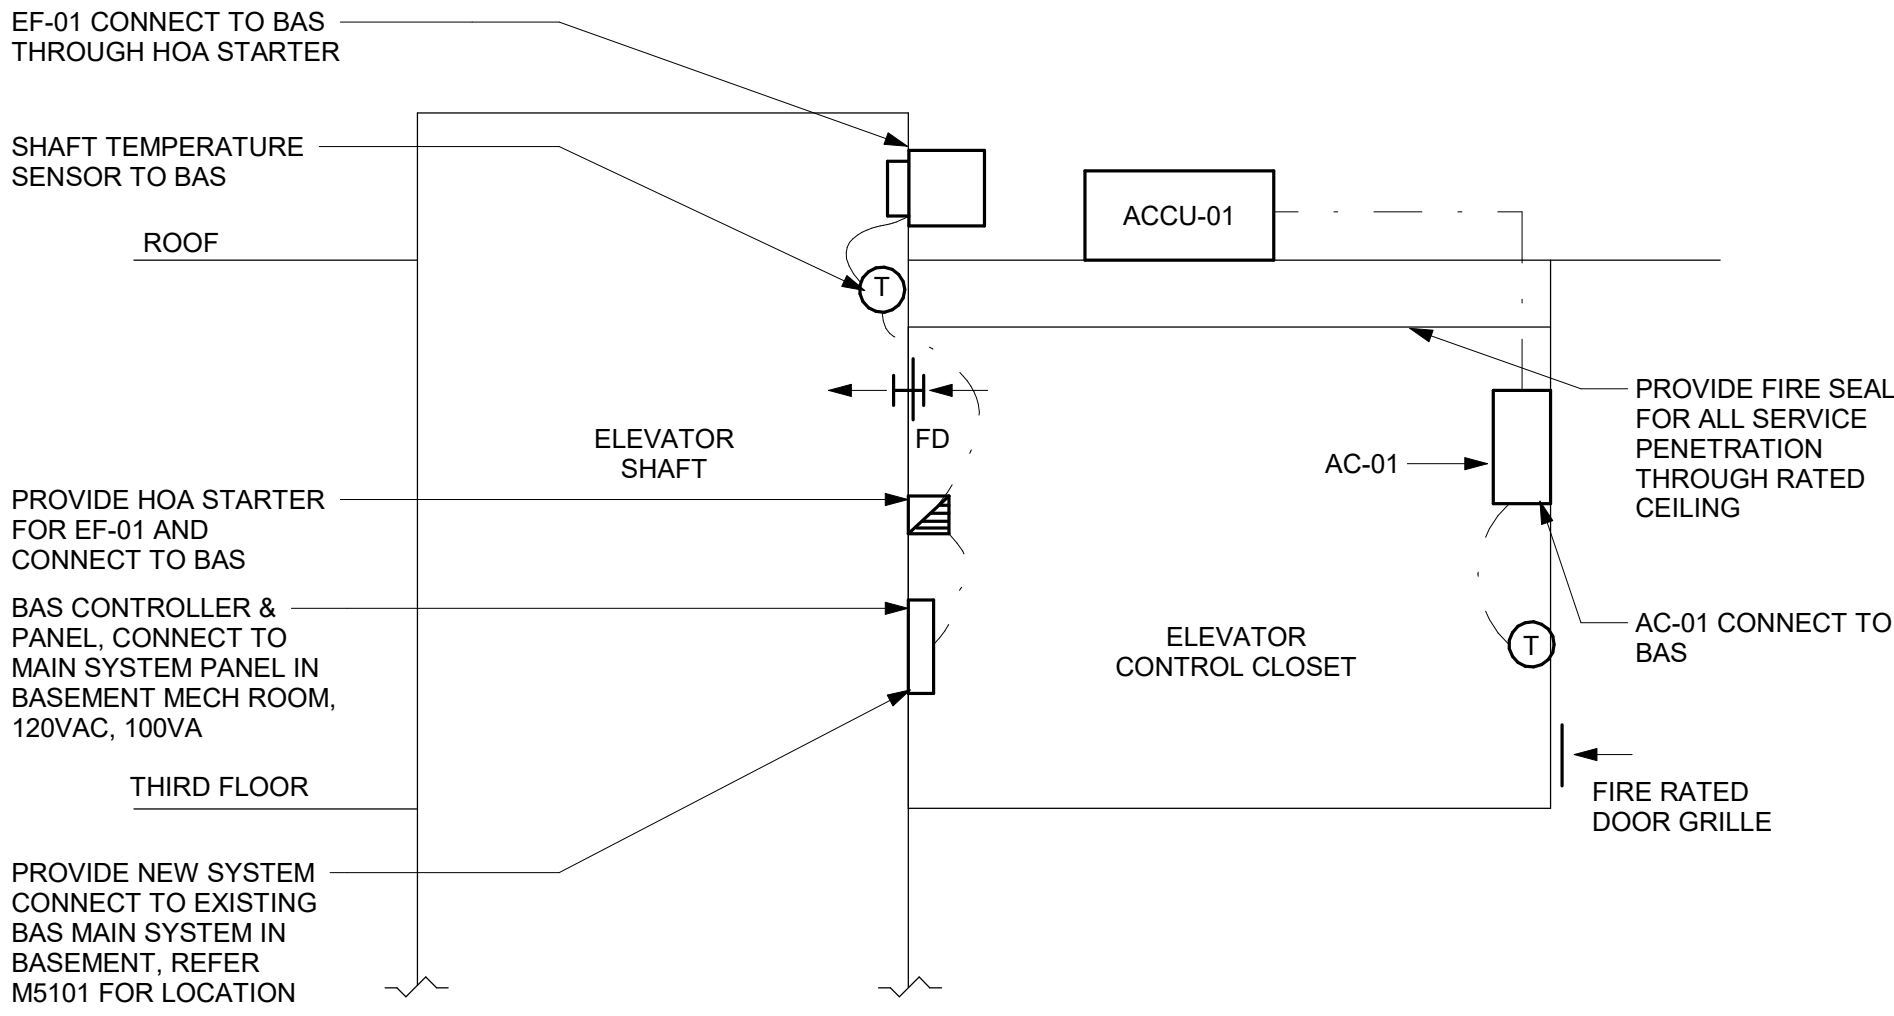

2 ELEVATOR SHAFT AND CONTROL ROOM CONTROL SCHEMATIC
M5104 / Scale: N.T.S

- GENERAL NOTES:
1. ADD AND ADJUST DUCTS TO FIT NEW DIFFUSERS/GRILLES.
 2. THERMOSTATS TO BE MOUNTED AT 1200mm A.F.F.
 3. RETAIN BASE BUILDING BAS CONTRACTOR FOR BAS SCOPE OF WORK.

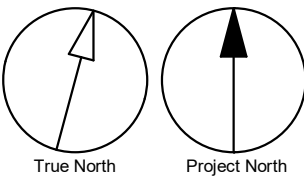

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PROJECT TITLE

**CITY OF TORONTO
ACCESSIBILITY UPGRADES**

PROJECT ADDRESS

50 UPJOHN RD

PROJECT NO: Arcadis 30279056	
DRAWN BY: K.DURUKAN	CHECKED BY: B.LIAO
PROJECT MGR: F. BOLOURIAN	APPROVED BY: S.LIU

SHEET TITLE

HVAC - ROOF PLAN

SHEET NUMBER	ISSUE
G05-249-M5104	D

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PROVIDE NEW CONCEALED SPRINKLER HEAD & COVER, PROVIDE BRANCH PIPING CONNECT TO EXISTING SPRINKLER MAIN LINE. CONTRACTOR SHALL VERIFY EXACT EXISTING PIPING LAYOUT ON SITE

RE-INSTALL CONCEALED SPRINKLER HEAD & COVER ON NEW CEILING, MODIFY/EXTEND BRANCH PIPING TO SUIT NEW LAYOUT WHEN REQUIRED

1 FIRE PROTECTION - GROUND FLOOR
M6101 Scale: 1 : 150

RE-INSTALL CONCEALED SPRINKLER HEAD & COVER ON NEW CEILING, MODIFY/EXTEND BRANCH PIPING TO SUIT NEW LAYOUT WHEN REQUIRED


RE-INSTALL CONCEALED SPRINKLER HEAD & COVER, MODIFY/EXTEND BRANCH PIPING TO SUIT NEW LAYOUT WHEN REQUIRED

PROVIDE NEW SIDEWALL SPRINKLER AT HIGH LEVEL SERVING ELEVATOR SHAFT, PROVIDE BRANCH PIPING CONNECT TO EXISTING SPRINKLER MAIN LINE. CONTRACTOR SHALL VERIFY EXACT EXISTING PIPING LAYOUT ON SITE

RELOCATED RECESSED FIRE EXTINGUISHER & CABINET

2 FIRE PROTECTION - THIRD FLOOR
M6101 Scale: 1 : 150

Scale 1:150 0 3 6 15 m

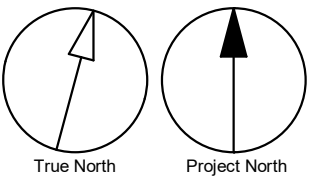

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CHECKED BY:
B.LIAO

PROJECT MGR:
F. BOLOURIAN

APPROVED BY:
S.LIU

SHEET TITLE
FIRE PROTECTION PLAN

SHEET NUMBER
G05-249-M6101

ISSUE
D



ELECTRICAL DRAWING LIST	
Sheet Number	Sheet Name
E0000	DRAWING LIST
E1101	ELECTRICAL DEMOLITION 1ST FLOOR
E1103	ELECTRICAL DEMOLITION 3RD FLOOR
E2101	POWER & SYSTEMS PLAN 1ST FLOOR
E2103	POWER & SYSTEMS PLAN 3RD FLOOR
E2104	POWER & SYSTEMS PLAN ROOF

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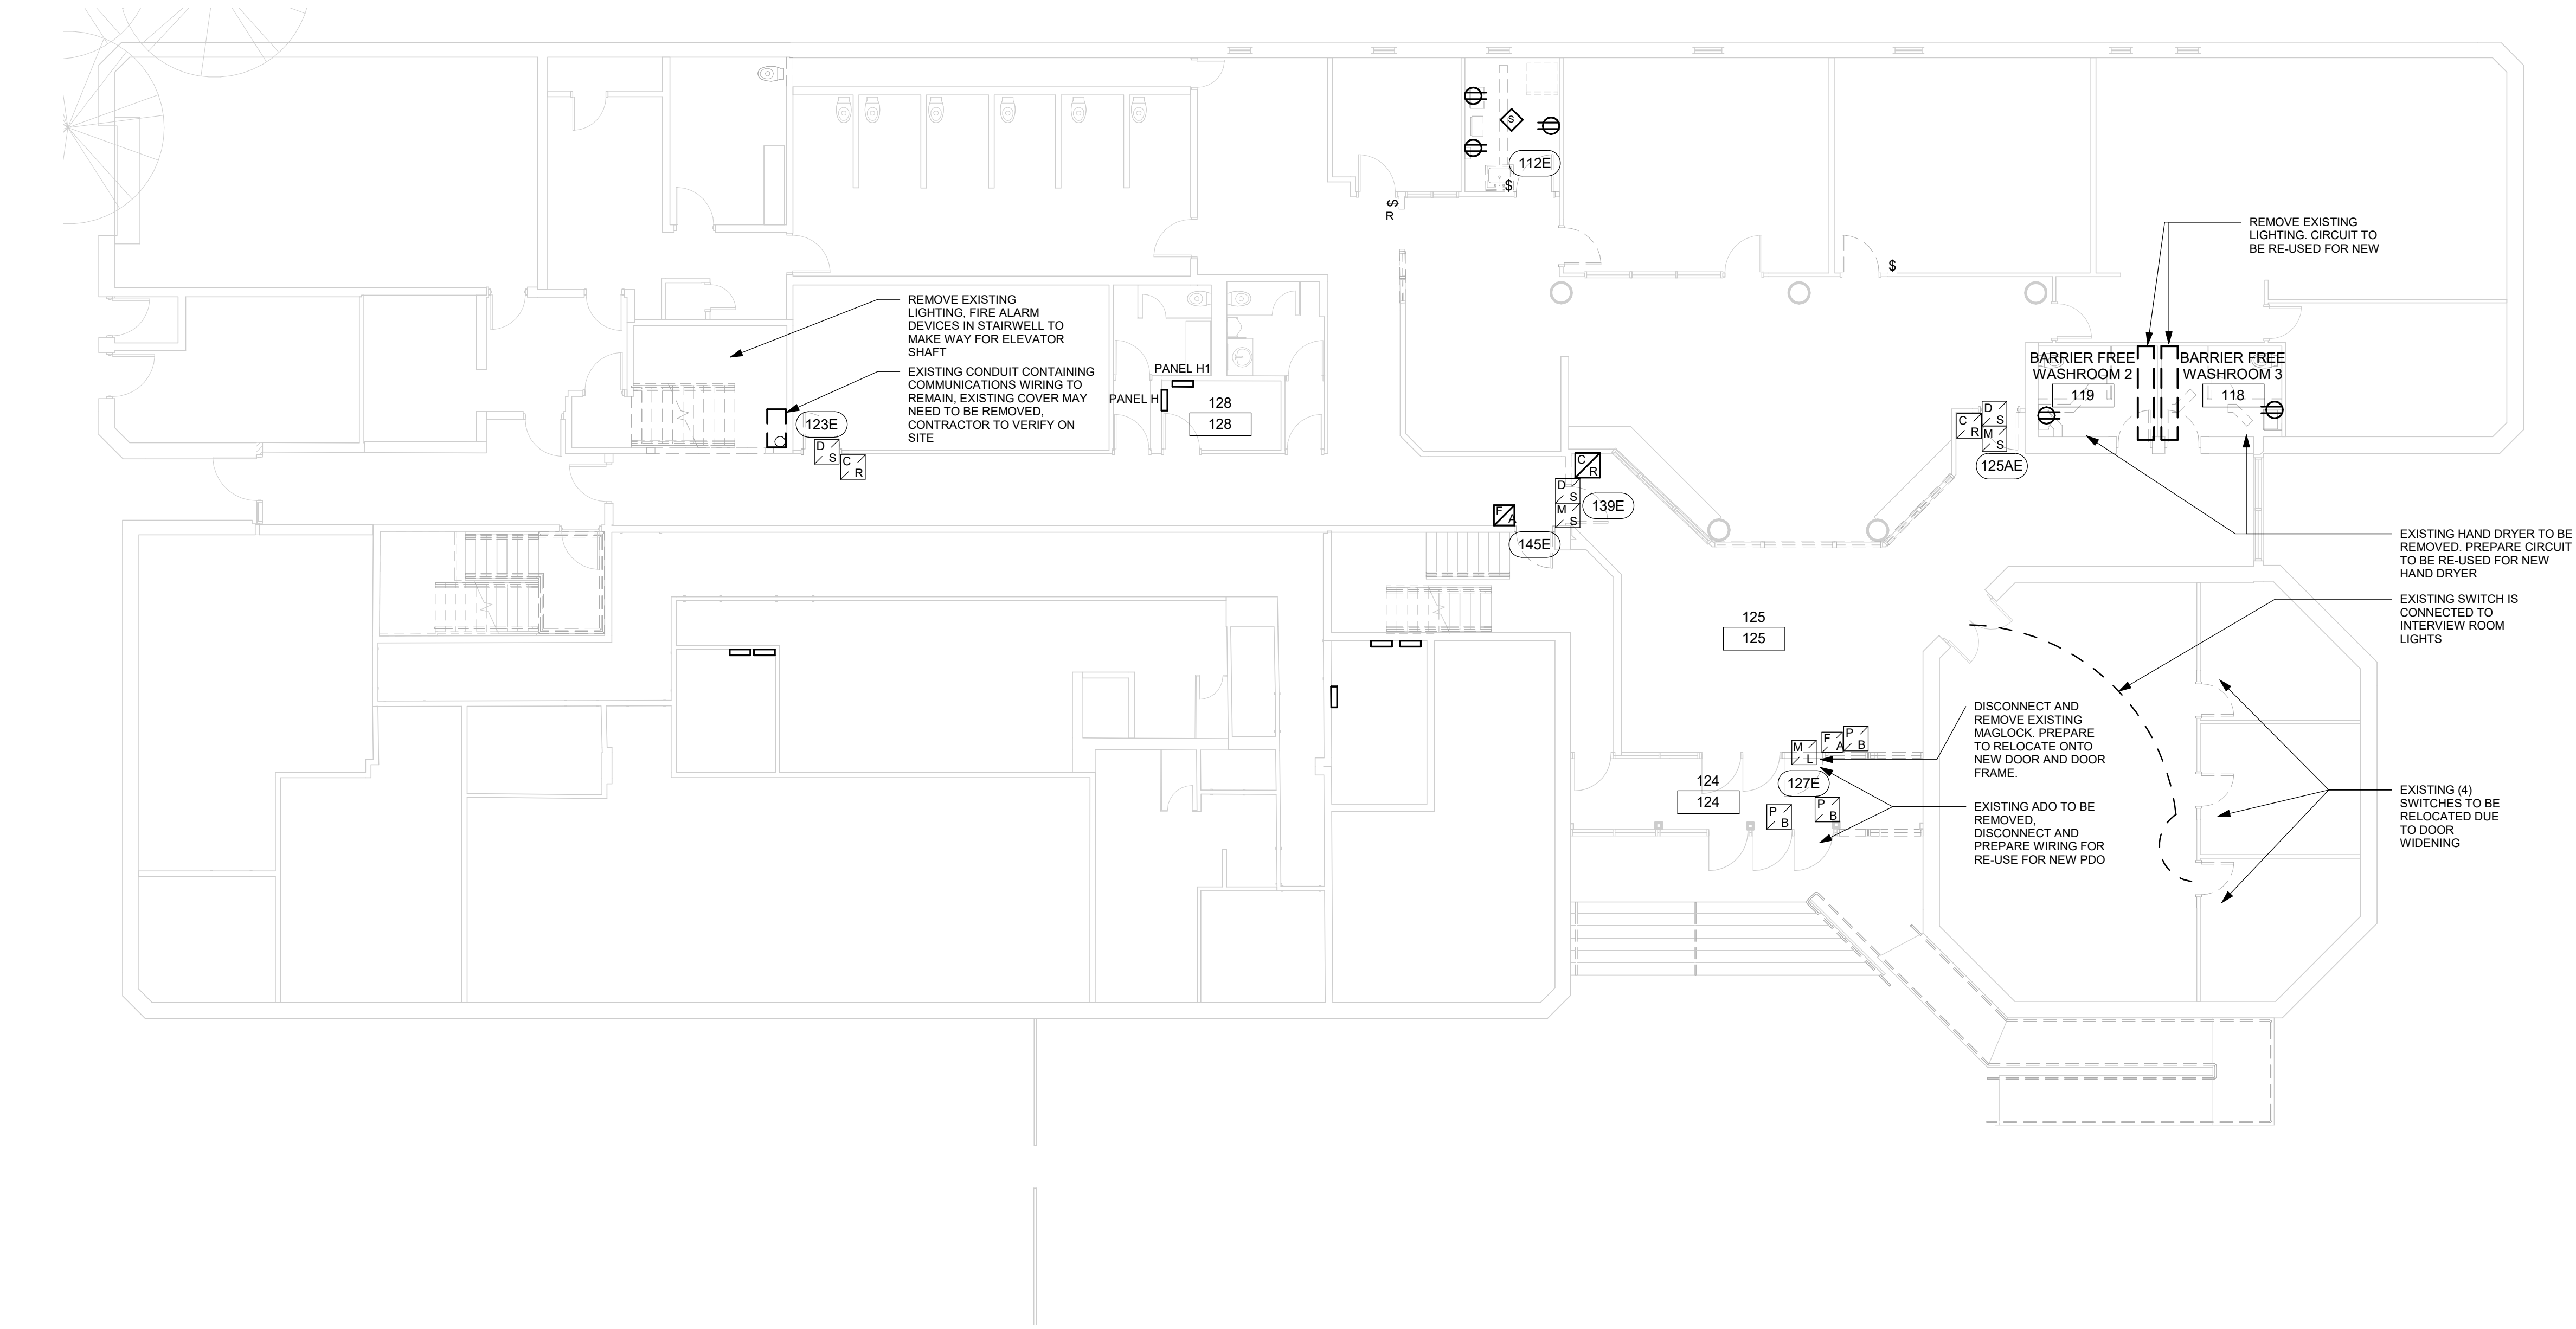
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DRAWN BY: M.Bojic	CHECKED BY: P. WILLIAMS
PROJECT MGR: F.Bolourian	APPROVED BY: P. WILLIAMS

SHEET TITLE
DRAWING LIST

SHEET NUMBER	ISSUE
E0000	E



1 ELECTRICAL DEMOLITION 1ST FLOOR
E1101 Scale: 1 : 100



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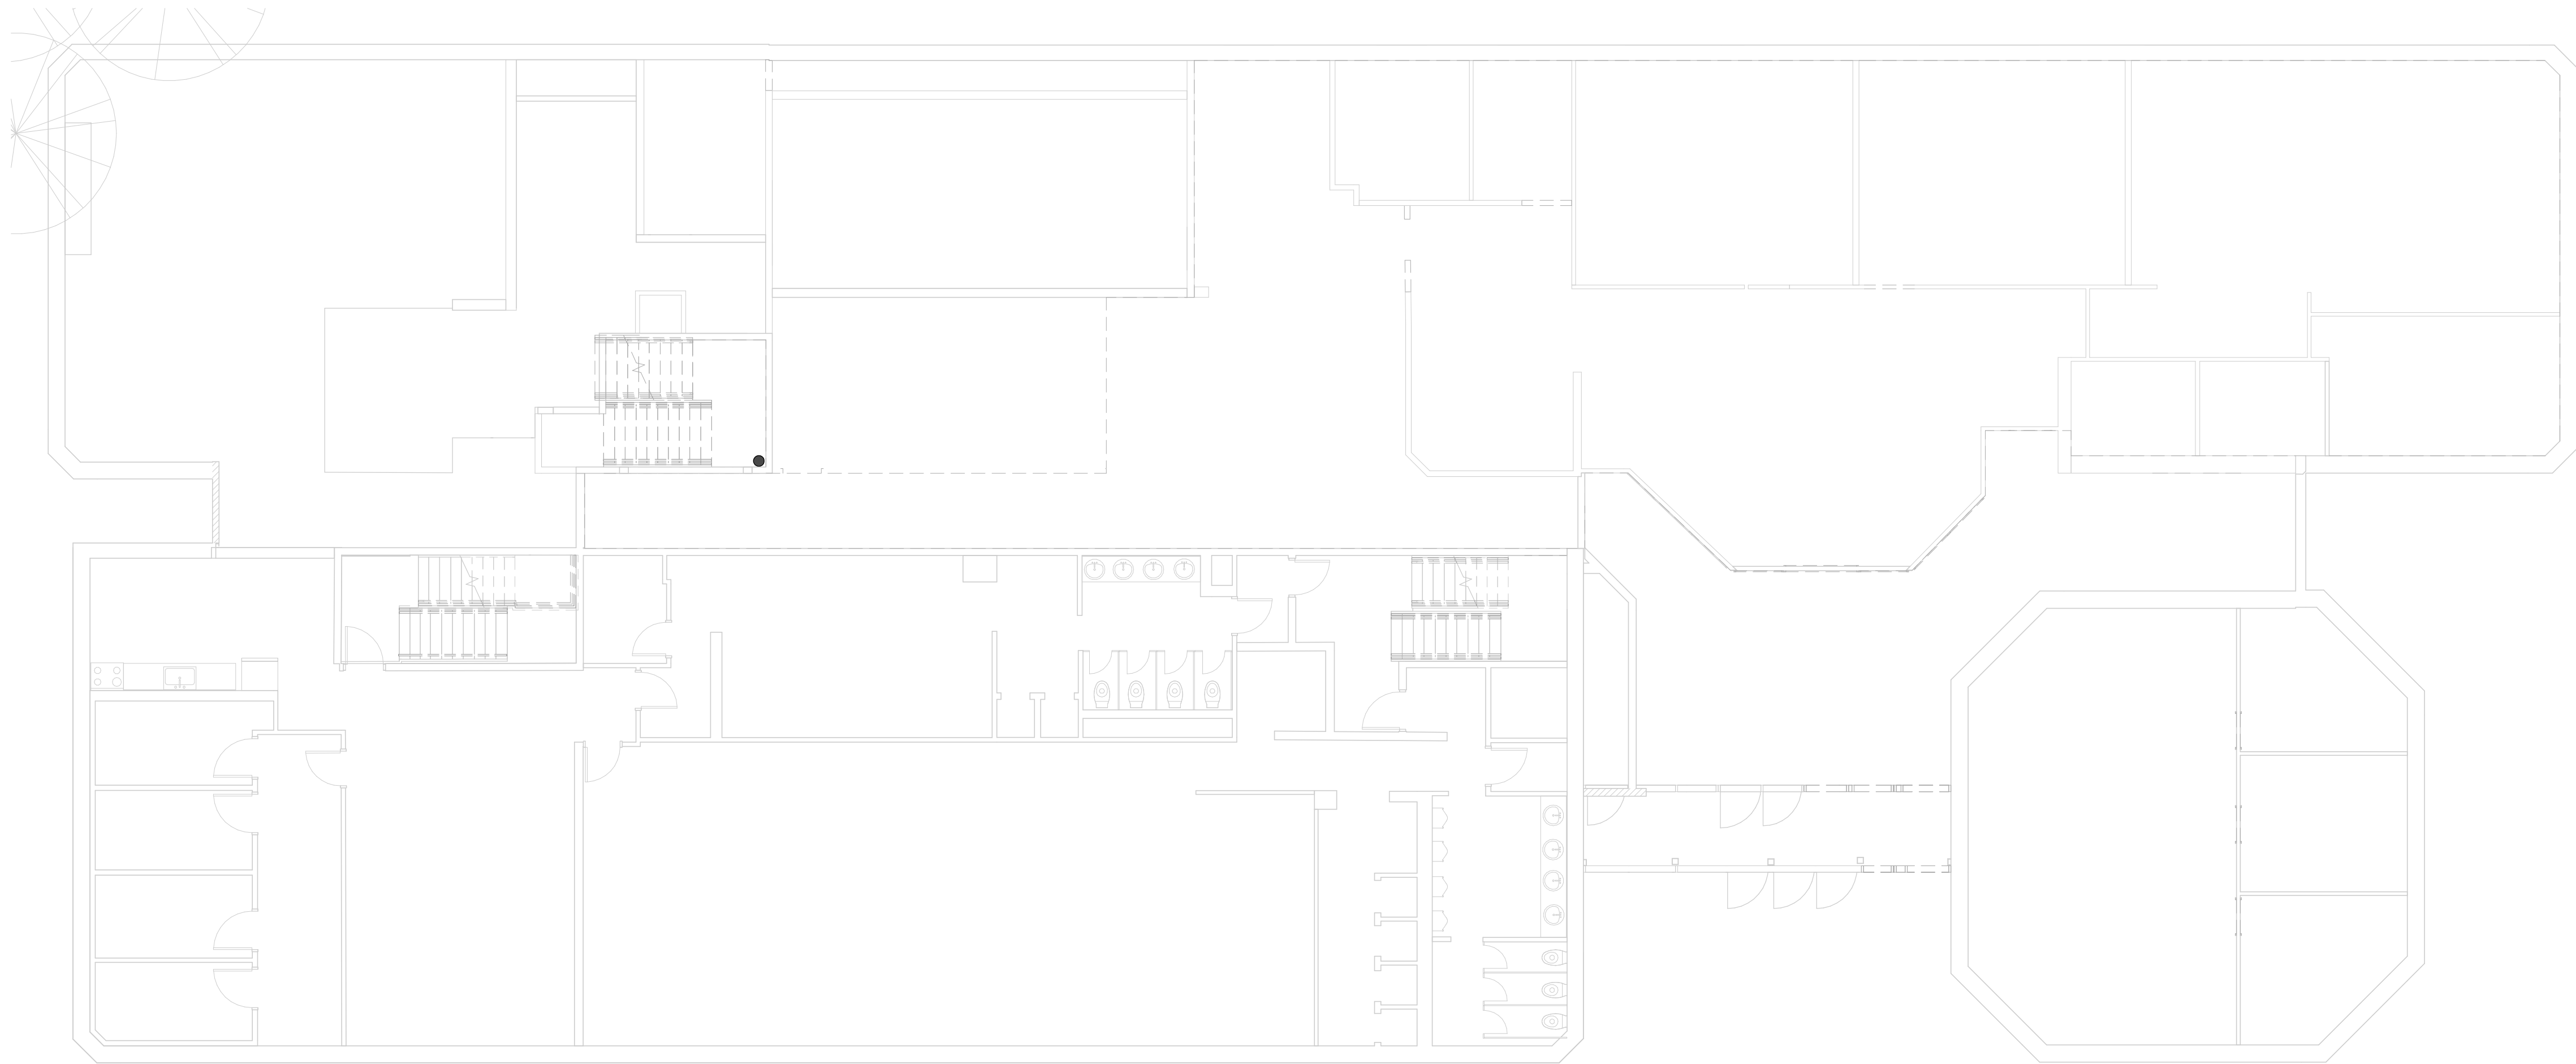
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PROJECT NO: Arcadis 30279056	
DRAWN BY: Author	CHECKED BY: Checker
PROJECT MGR: F.Bolourian	APPROVED BY: Approver

SHEET TITLE
ELECTRICAL
DEMOLITION 1ST FLOOR

SHEET NUMBER E1101	ISSUE E
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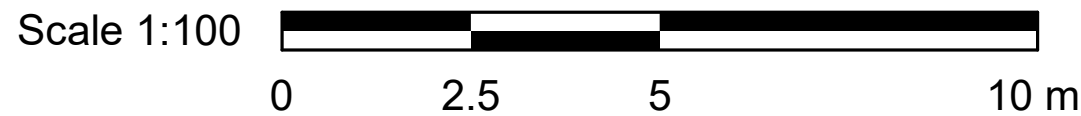
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E1102

ELECTRICAL DEMOLITION 2ND FLOOR

Scale: 1 : 100

- NOTES:
- REMOVE 5 EXIT SIGNS AND PREPARE CIRCUIT FOR RE-USE FOR NEW GREEN RUNNING MAN EXIT SIGNS ON THIS FLOOR.



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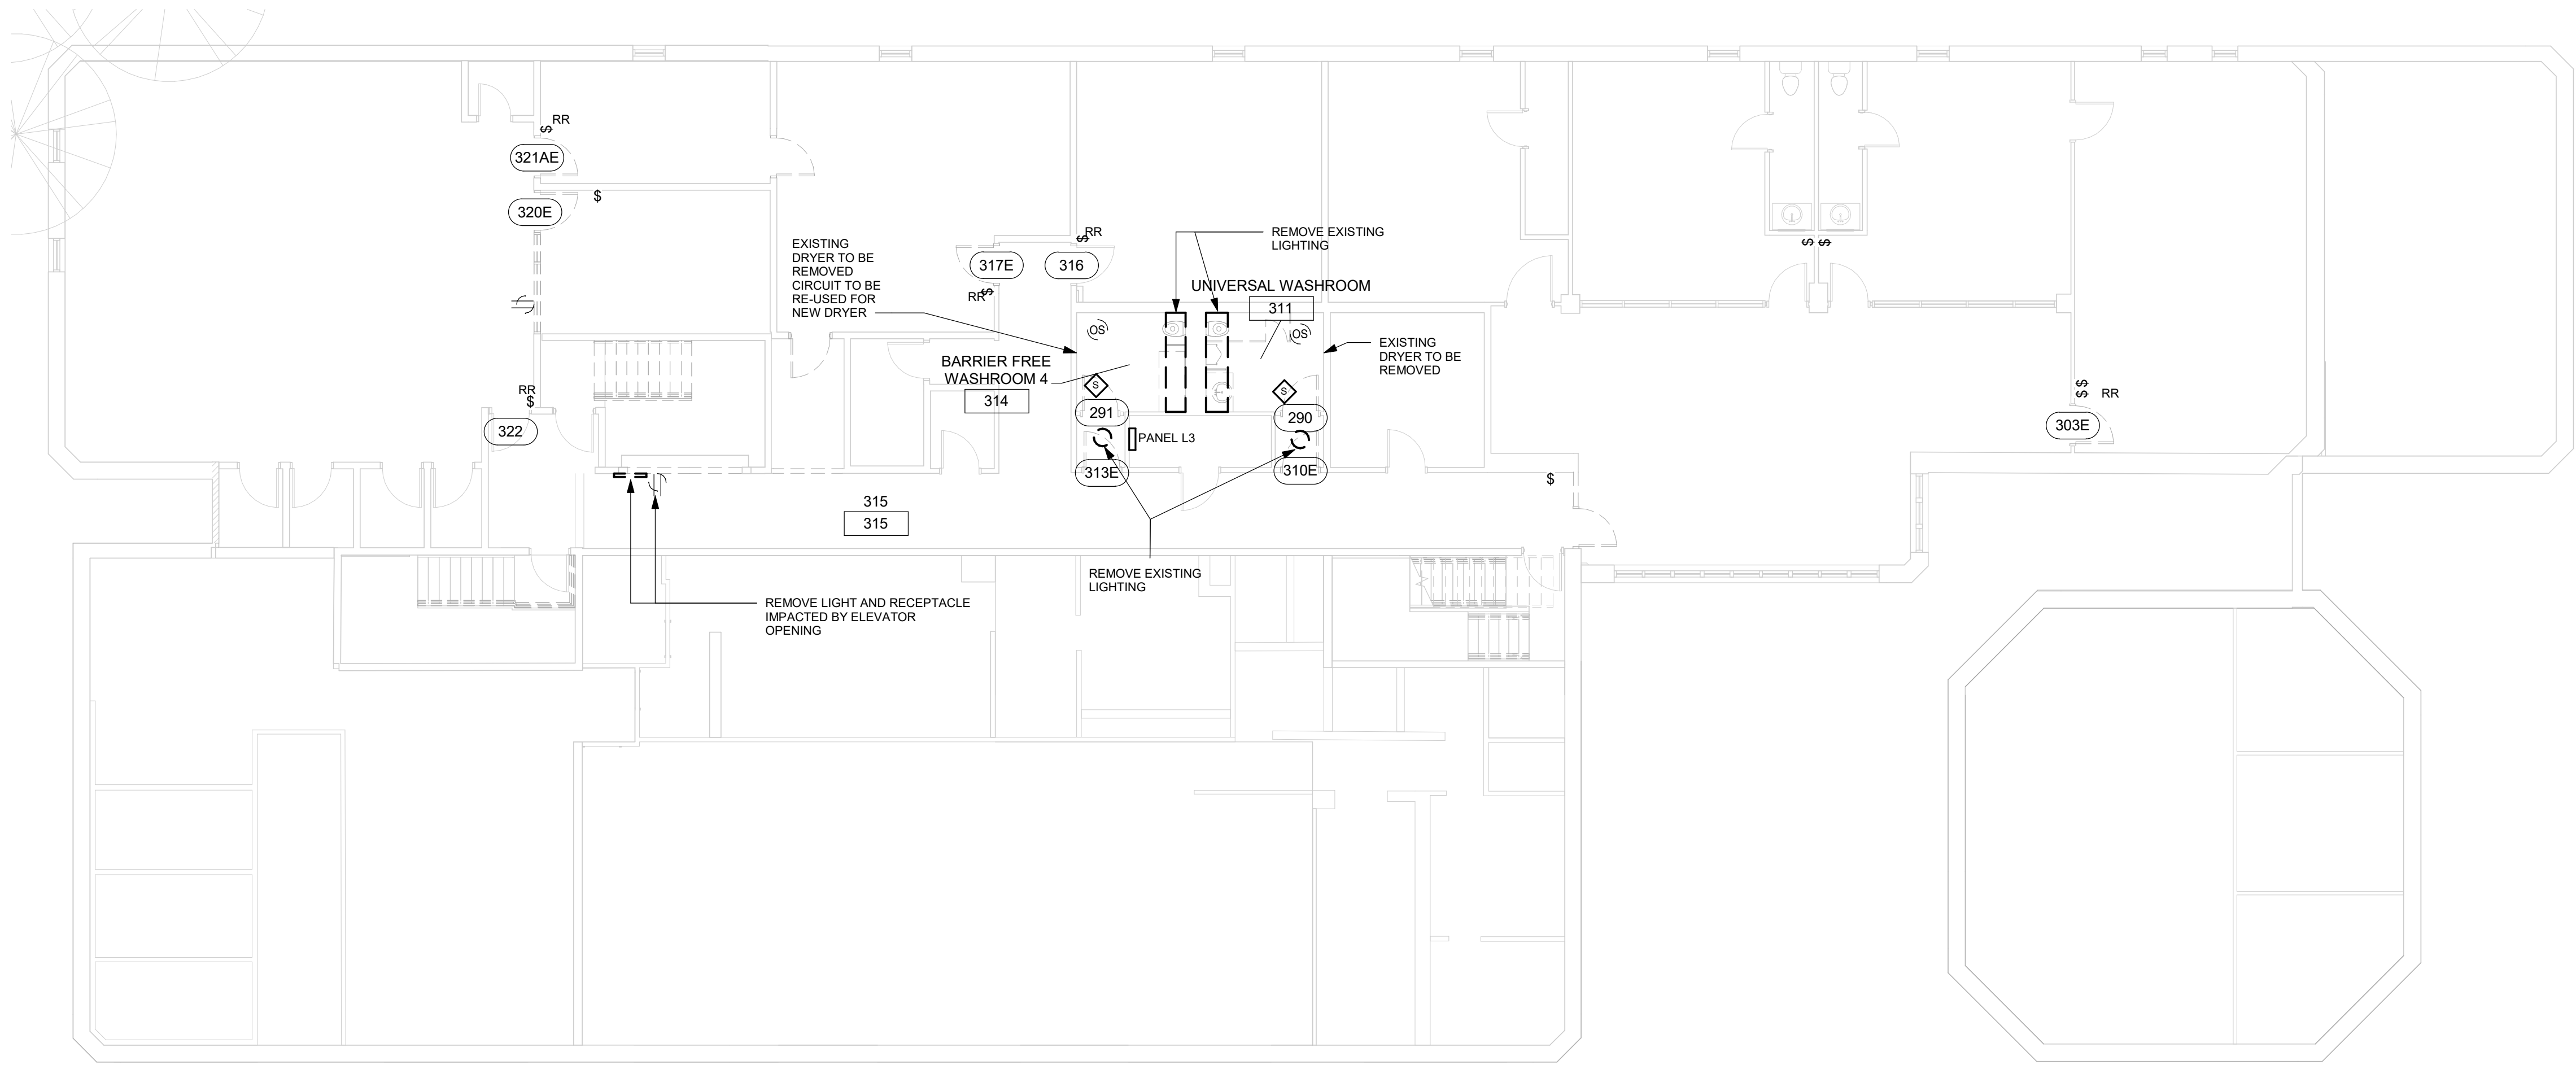
ELECTRICAL
DEMOLITION 2ND FLOOR

SHEET NUMBER

E1102

ISSUE

E



1 ELECTRICAL DEMOLITION 3RD FLOOR
E1103 / Scale: 1 : 100

- NOTES:
1. REMOVE AND RELOCATE EXISTING LIGHT SWITCHES IMPACTED BY DOOR WIDENINGS



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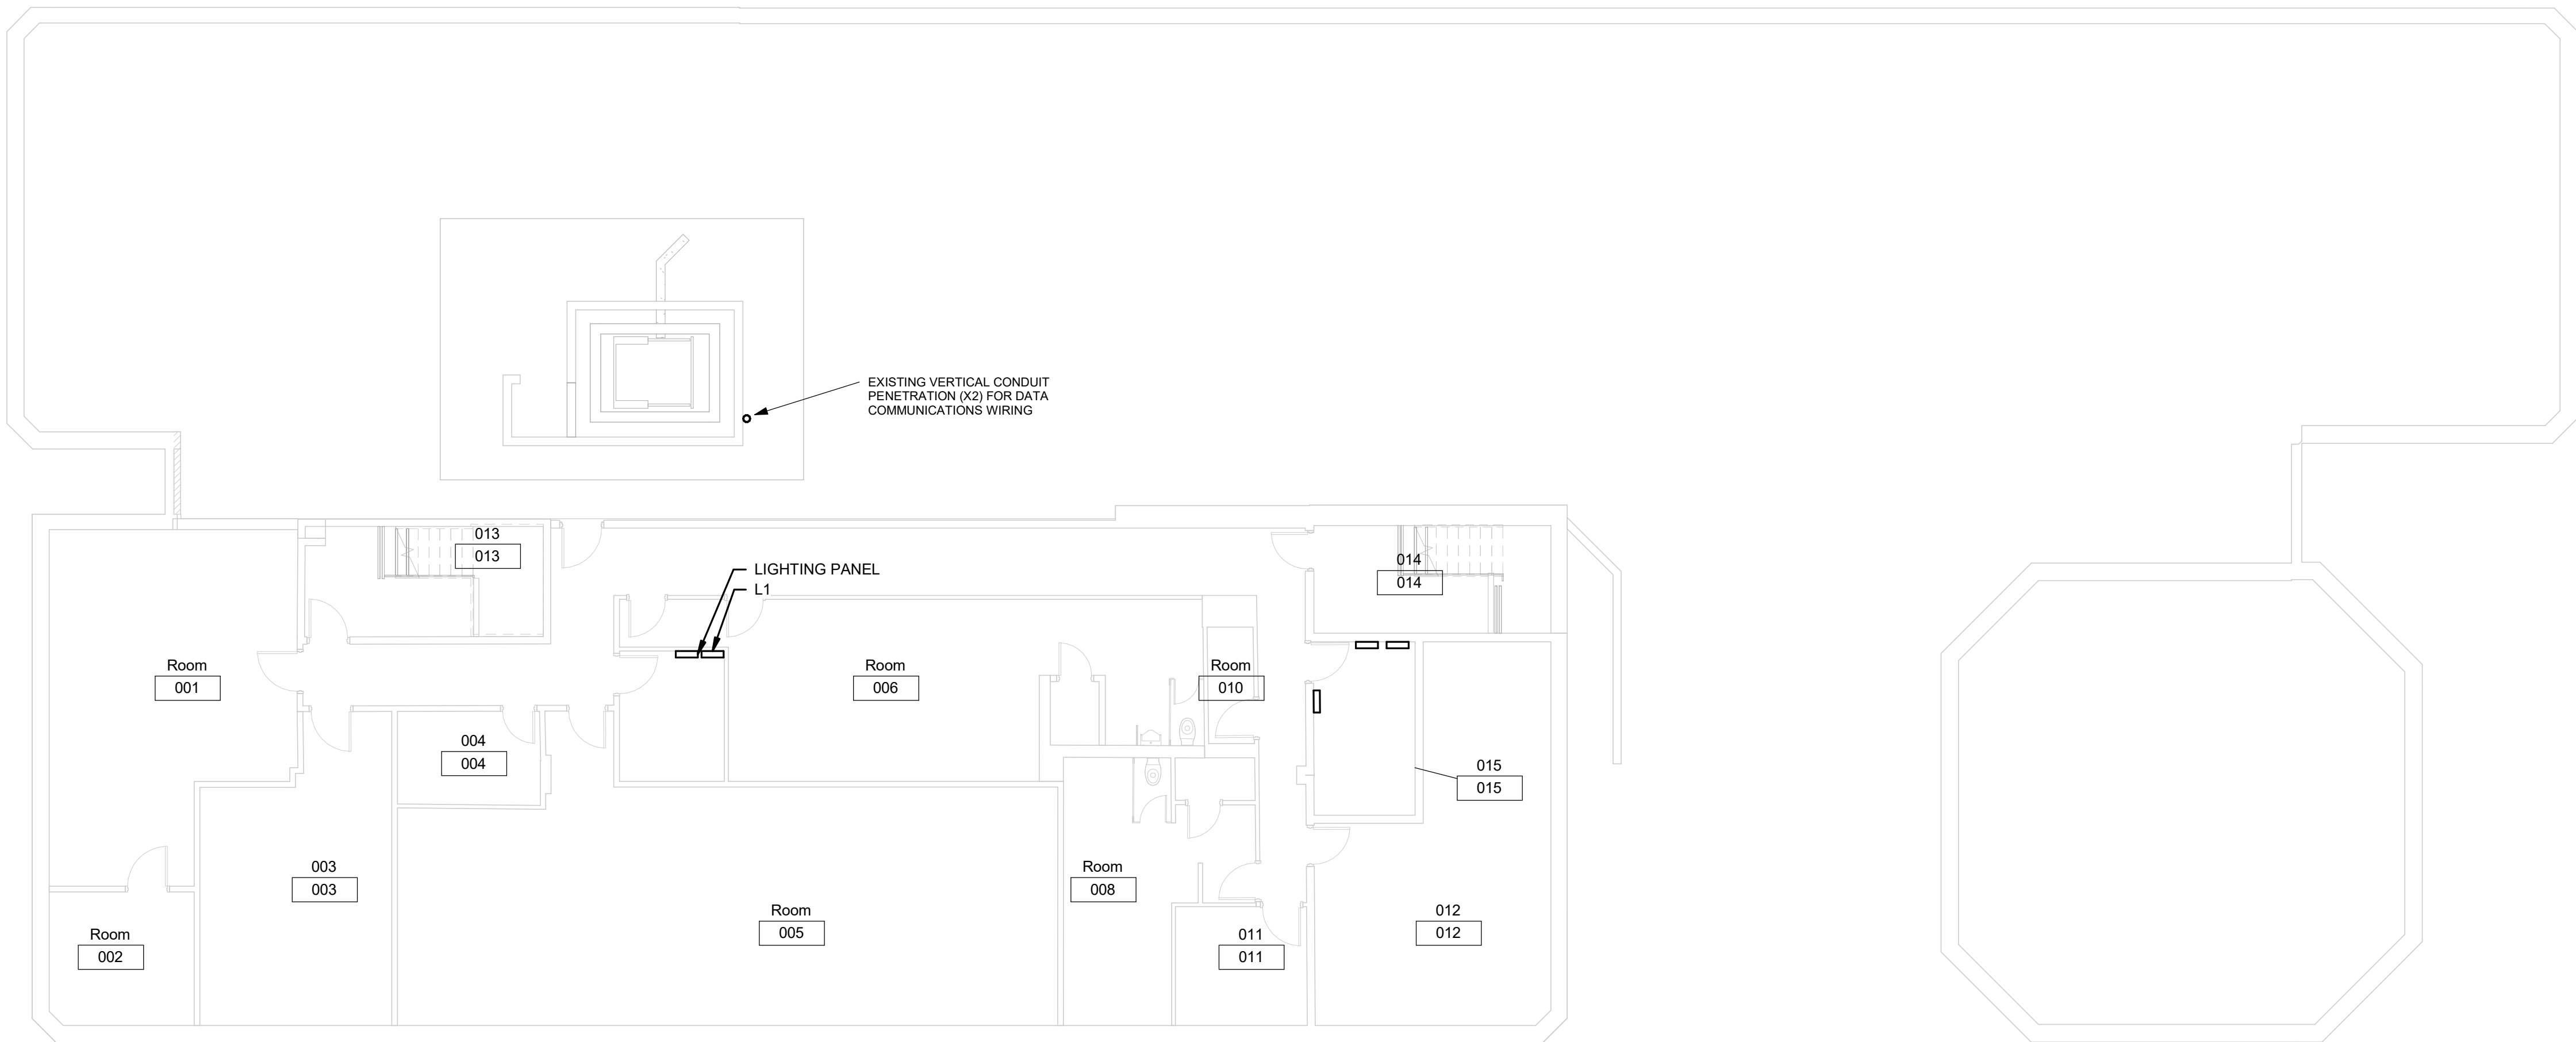
PROJECT MGR:
F.Bolourian

APPROVED BY:
Approver

SHEET TITLE
**ELECTRICAL
DEMOLITION 3RD FLOOR**

SHEET NUMBER
E1103

ISSUE
E



BASEMENT PLAN IS SHOWN FOR REFERENCE



1 ELECTRICAL PLAN BASEMENT
E2100 Scale: 1 : 100

Scale 1:100
0 2.5 5 10 m

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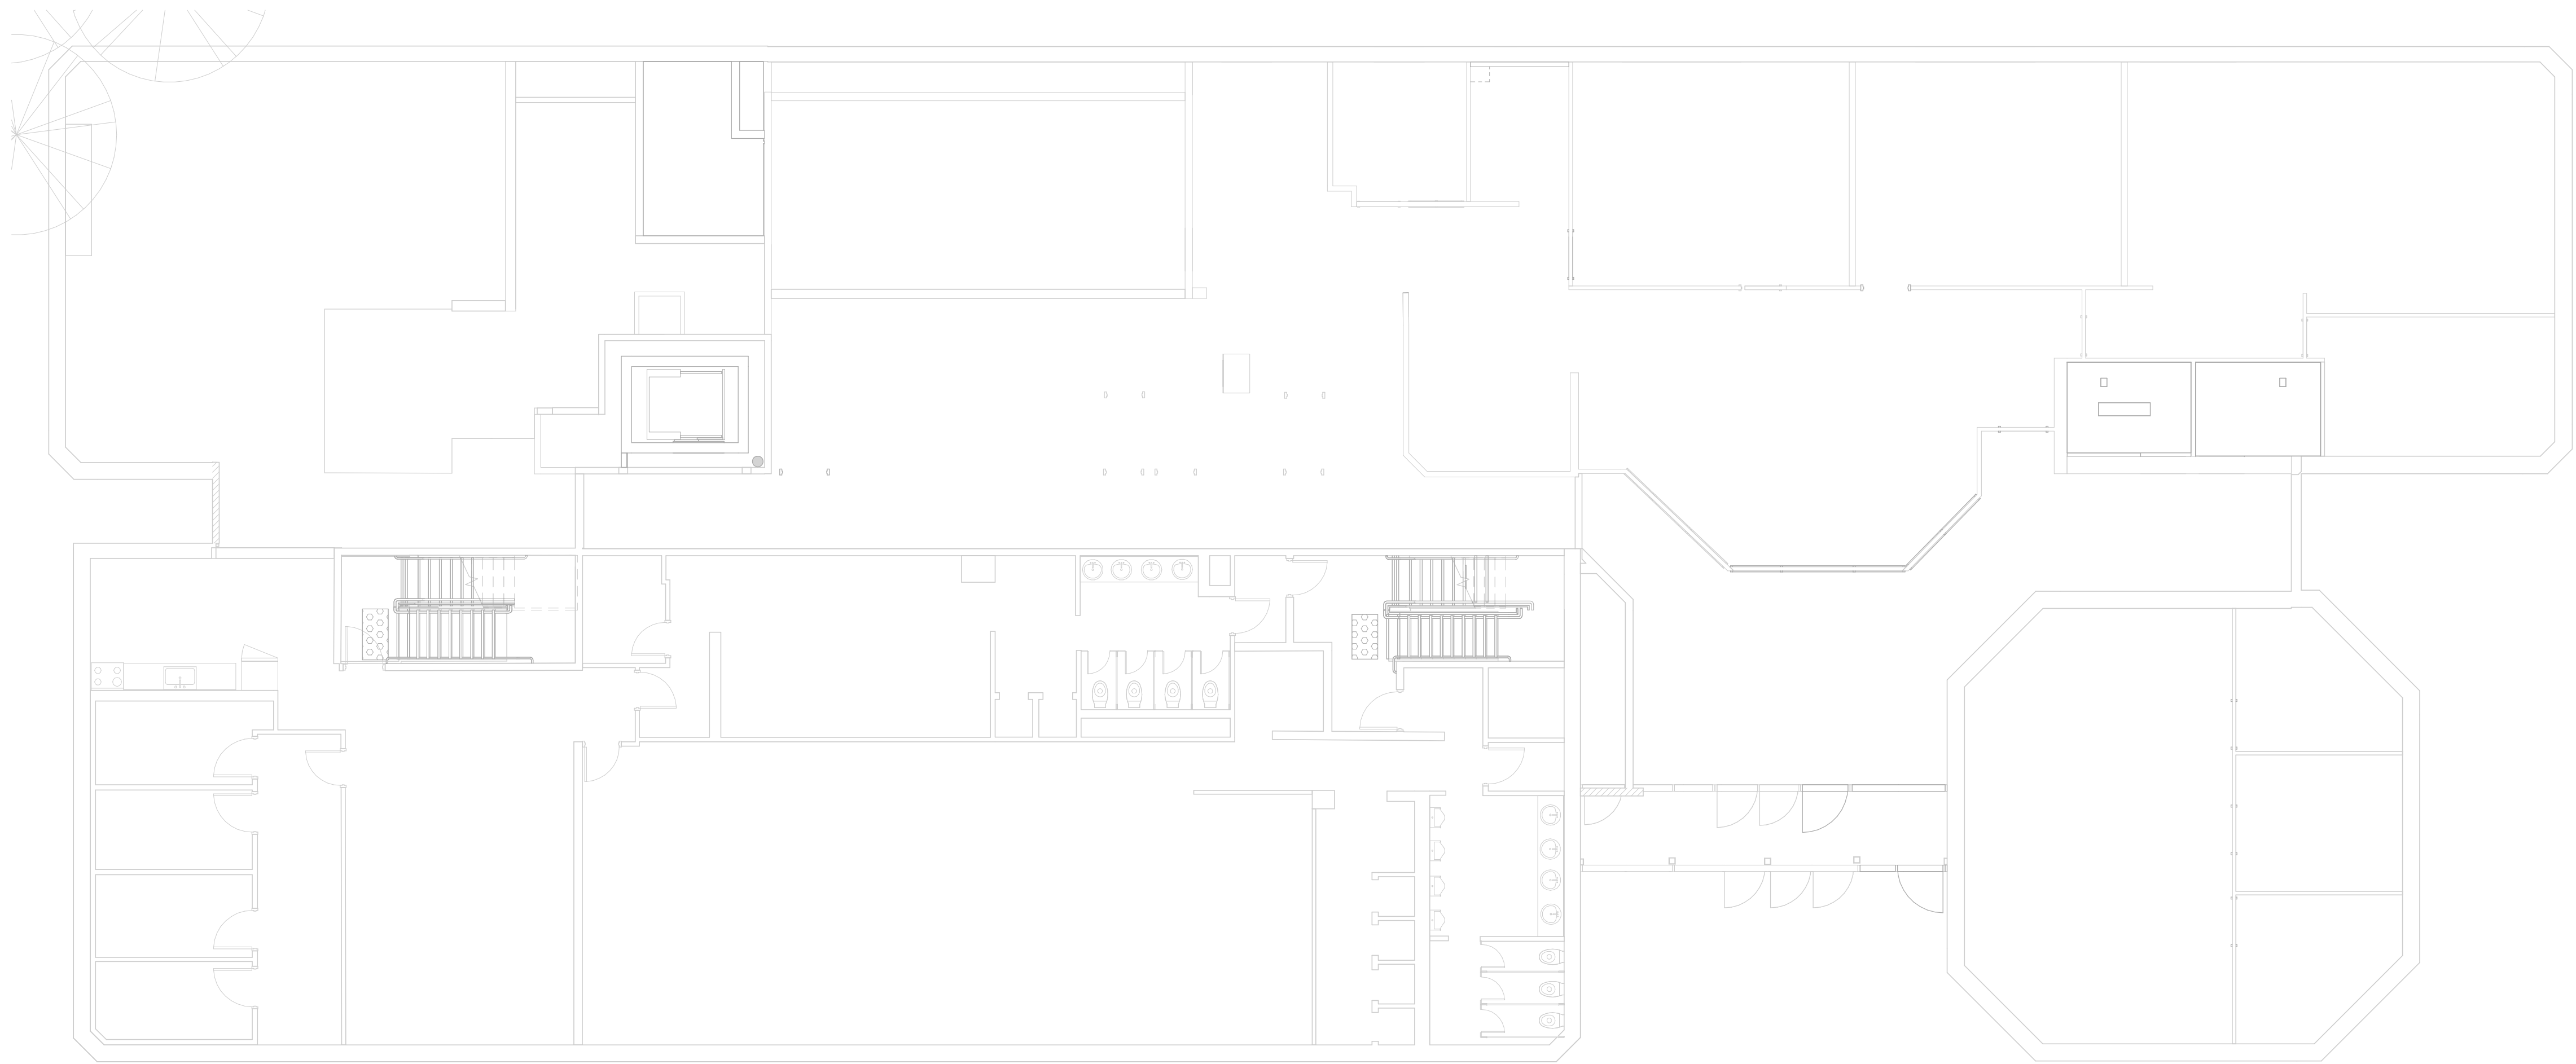
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PROJECT NO:
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DRAWN BY:
M.BOJIC
PROJECT MGR:
F.Bolourian
CHECKED BY:
P. WILLIAMS
APPROVED BY:
P. WILLIAMS

SHEET TITLE
**POWER & SYSTEMS
PLAN BASEMENT**

SHEET NUMBER
E2100
ISSUE
E



1 POWER & SYSTEMS PLAN 2ND FLOOR
E2102 Scale: 1 : 100

NOTES:

1. PROVIDE 5 NEW X01 TYPE GREEN RUNNING MAN SIGNS ON THIS FLOOR, RE-CONNECT TO EXISTING EXIT SIGN CIRCUITS



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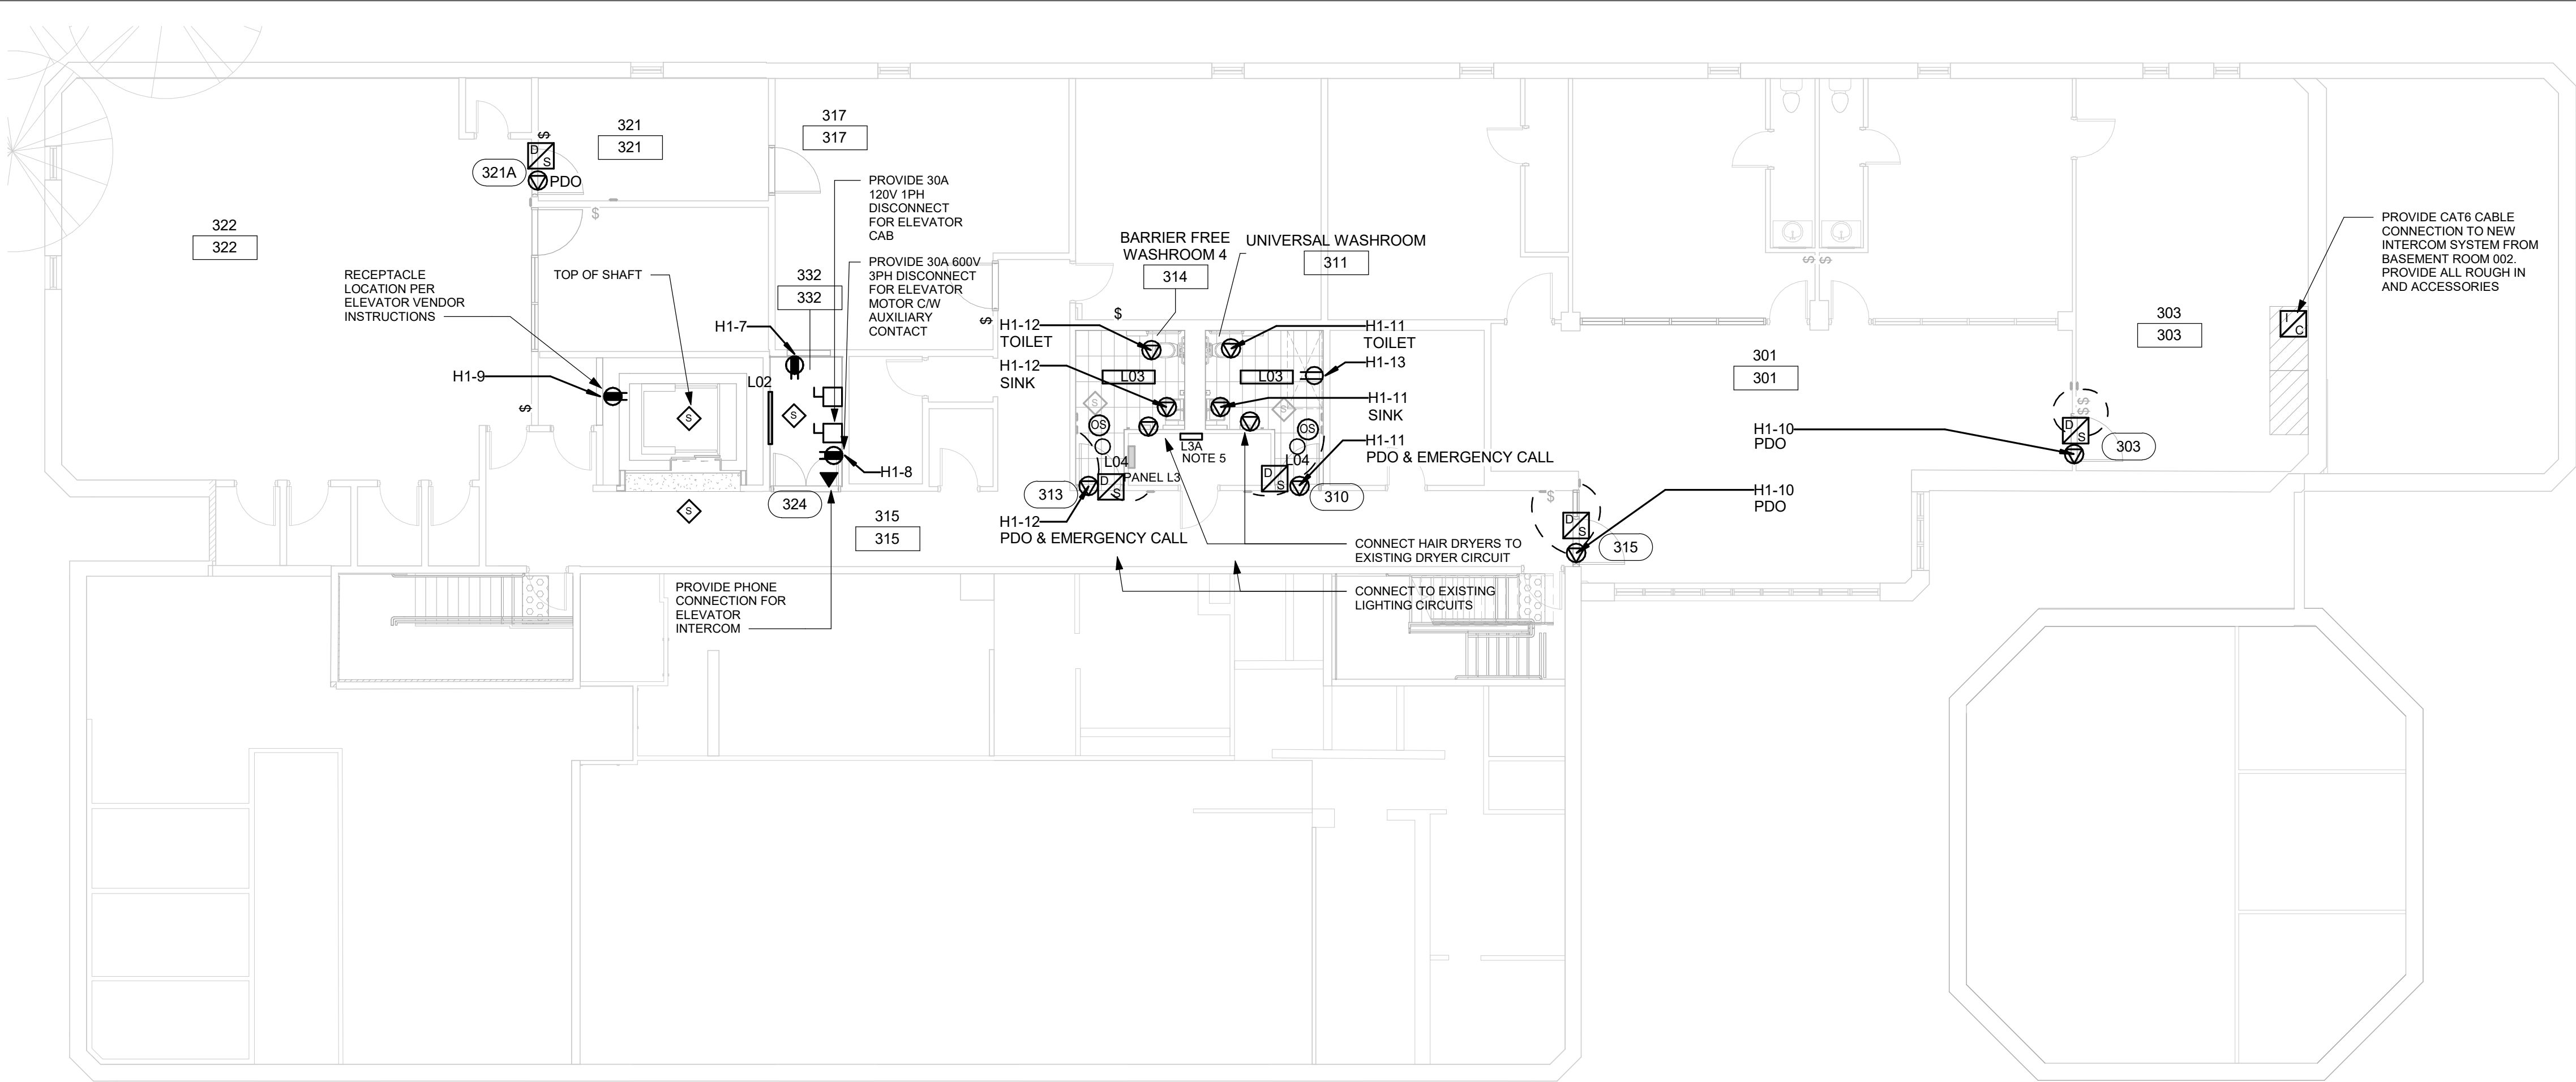
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F.Bolourian

APPROVED BY:
Approver

SHEET TITLE
POWER & SYSTEMS
PLAN 2ND FLOOR

SHEET NUMBER
E2102

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E




1 POWER & SYSTEMS PLAN 3RD FLOOR
E2103 Scale: 1 : 100

- NOTES:
1. PROVIDE SECURITY HARDWARE AS INDICATED ON PLAN. PROVIDE ROUGH IN/CONDUIT/CABLING FOR NEW POWER DOOR OPERATOR PUSH BUTTONS.
 2. CIRCUITING SHOWN IS FOR GROUPING PURPOSES ONLY. PROVIDE NEW 15A BREAKER IN EXISTING PANEL FOR EACH CIRCUIT SHOWN UNLESS OTHERWISE NOTED.
 3. PROVIDE RELOCATED LIGHT SWITCHES IN LOCATIONS SHOWN
 4. RE-USE EXISTING CIRCUIT FOR NEW LIGHTING
 5. PROVIDE NEW PANEL L3A 120/208V 60A 30 POLE PANEL TO BE FED FROM 3 NEW 3 POLE BREAKER IN PANEL L3.



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
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M.BOJIC

CHECKED BY:

PROJECT MGR:

F.Bolourian

APPROVED BY:

Approver

SHEET TITLE

POWER & SYSTEMS
PLAN 3RD FLOOR


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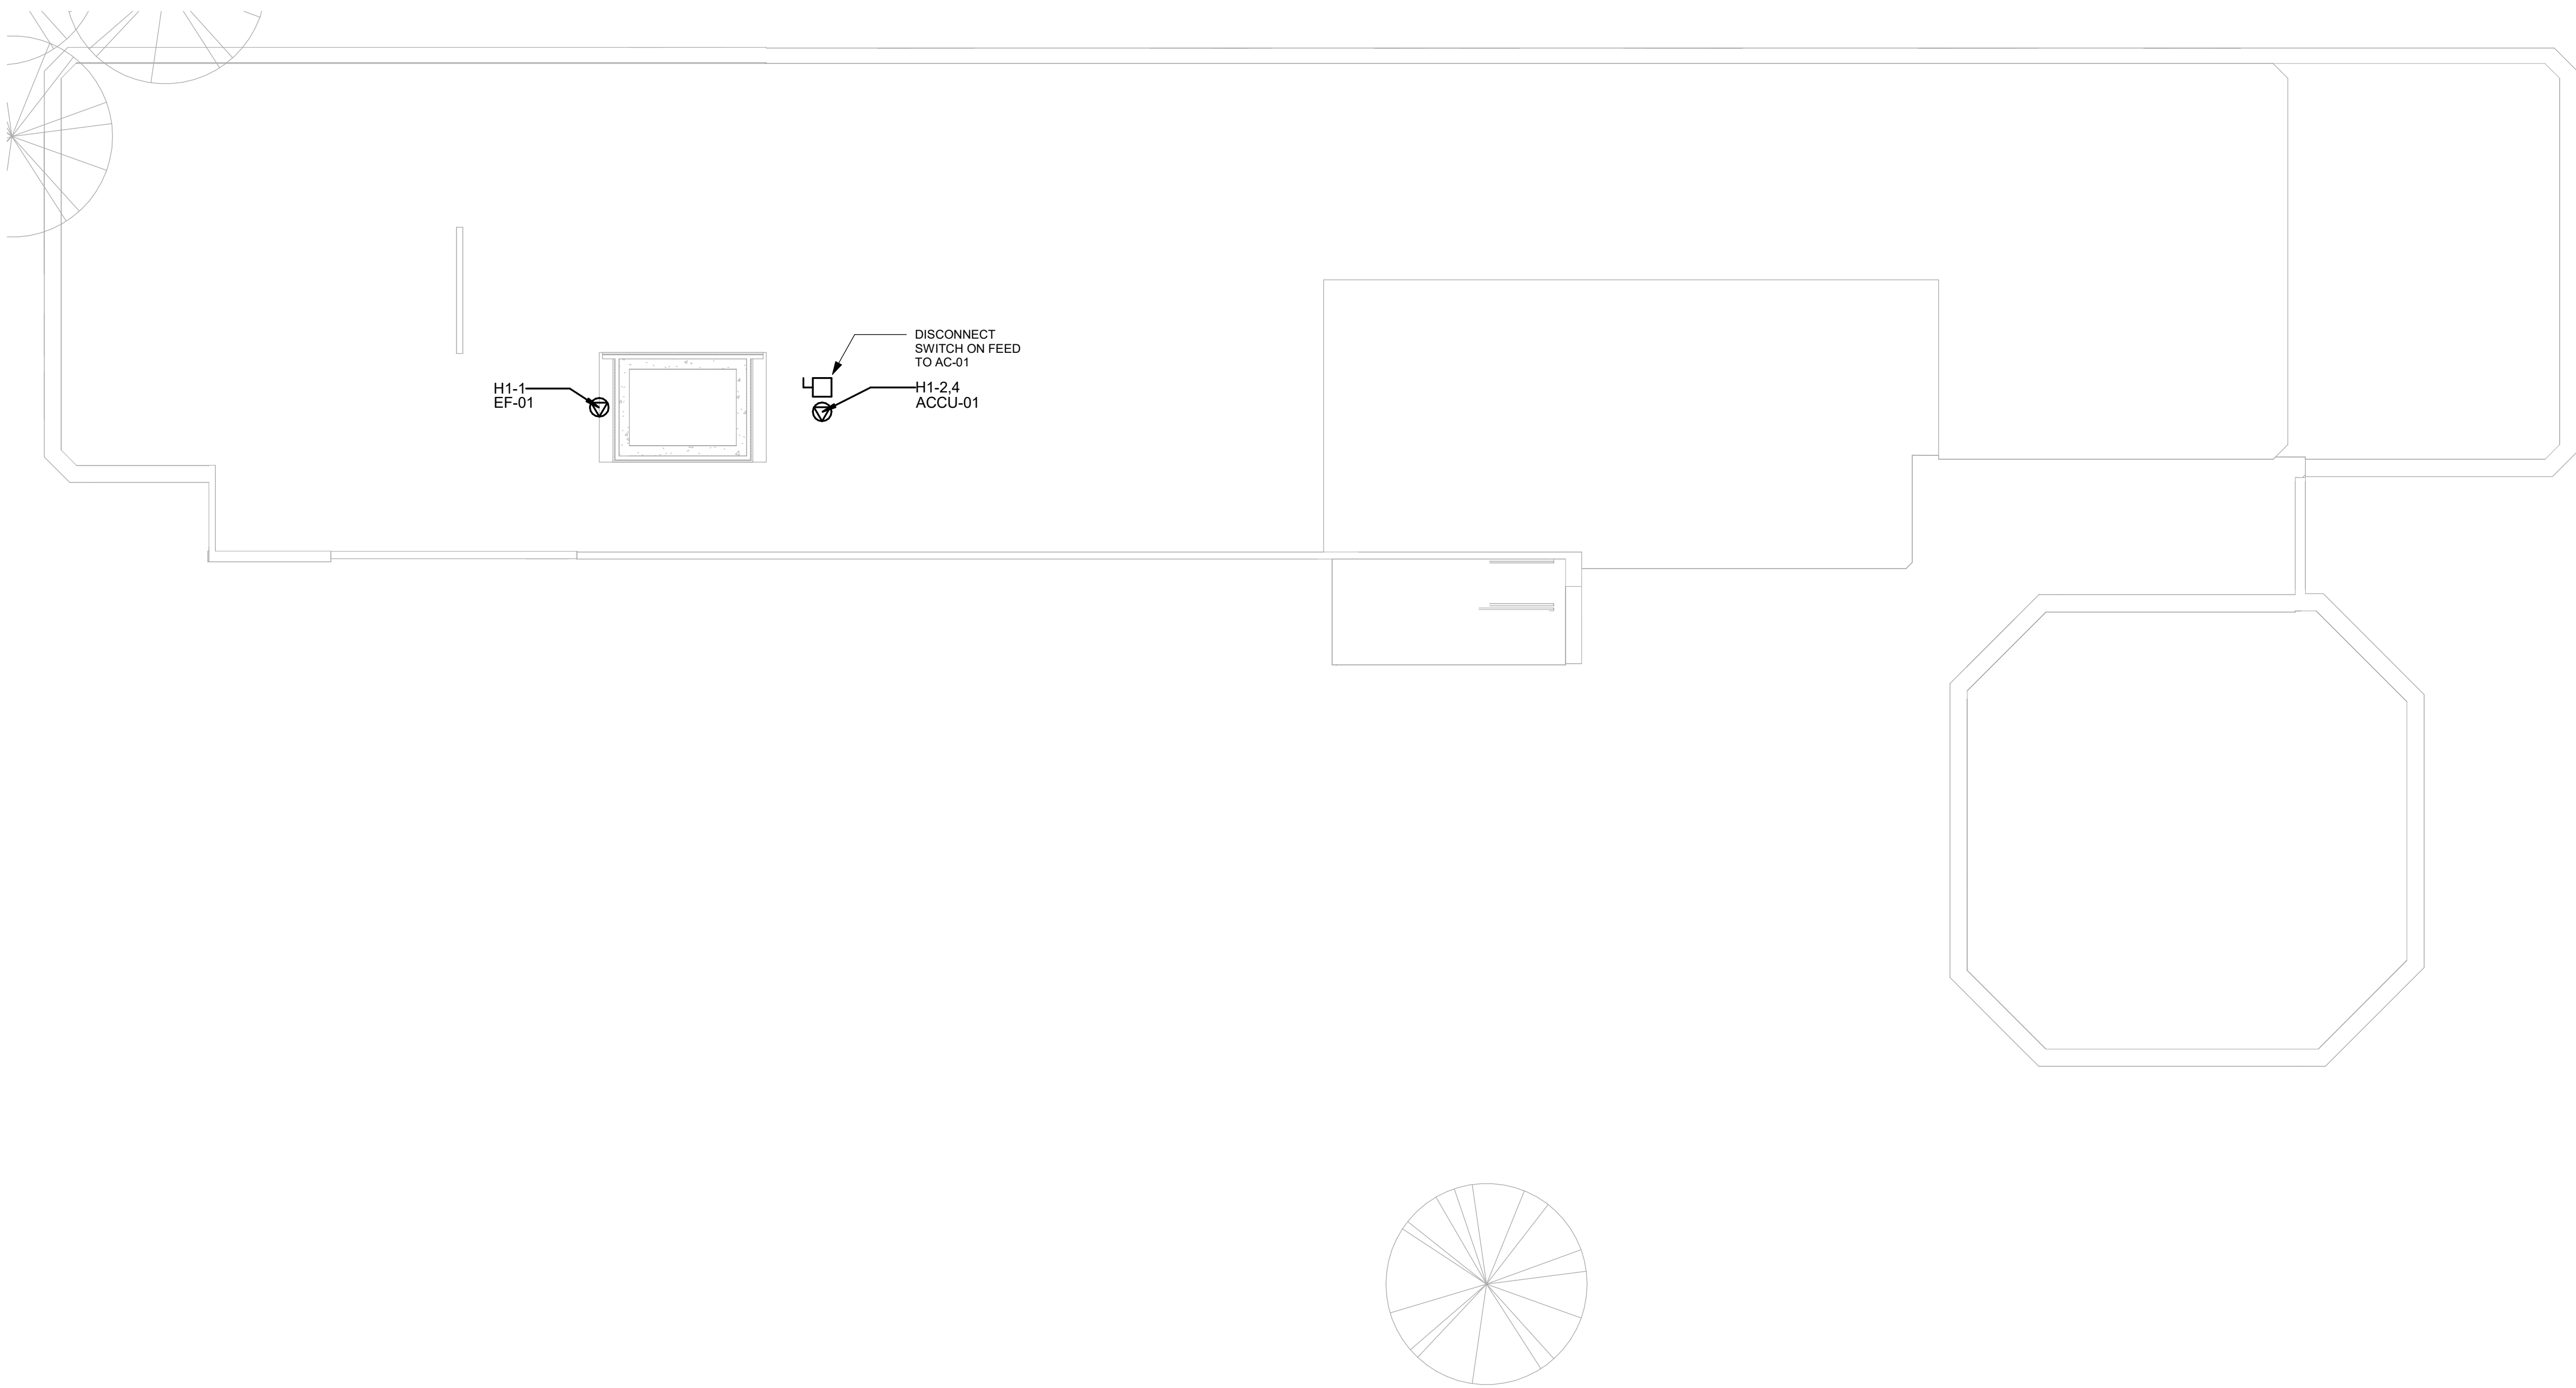


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E2104

POWER & SYSTEMS ROOF PLAN

Scale: 1 : 100

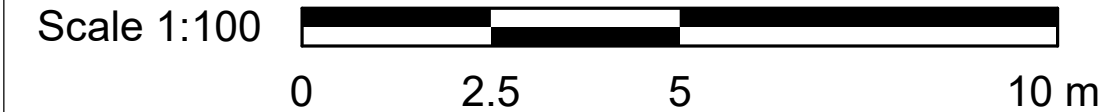

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P. WILLIAMS

PROJECT MGR:
F.Bolourian

APPROVED BY:
P. WILLIAMS

SHEET TITLE
POWER & SYSTEMS
PLAN ROOF

SHEET NUMBER
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