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DETAIL PHOTO OF AREA FOR HERITAGE REHABILITATION H-01 NTS

## ABBREVIATIONS

LEU ACREWDRNQPELHKRTZLLOVTVCD124ARCINIIImOSOBARTYP	ELEVATOR GAUGE CENTER TO CENTER RISER CENTER LINE PLYWOOD FLOOR DRAIN FIRE RESISTANCE RATING DOWN EQUAL UP ELECTRICAL THICKNESS STAIR EXTERIOR RAILING HOUR HEIGHT OFF CONTRACT INTERIOR INVERTED SOUND TRANSMISSION CLASS RATING METERS SQUARE METERS MAXIMUM HANDRAIL MECANICAL MINIMUM MINUTES MIRROR MILLIMETERS ROUGH OPENING FIRE SEPARATION UNLESS OTHERWISE INDICATED SIMILAR STRUCTURE TYPICAL
'YP 'AR	TYPICAL VARIABLE

## TAGS LEGEND

NOM DE LA PIÈCE	ROOM DESCRIPTION ROOM NUMBER ROOM AREA
00	WINDOW TYPE
0000	DOOR NUMBER
	ASSEMBLY TYPE:
W0>	WALL (EXTERIOR SHELL) TYPE
(C0)	CEILING TYPE
(F0)	FLOOR TYPE
(FN0)	FOUNDATION TYPE
R0	ROOF TYPE
	PARTITION TYPE (INTERIOR WALL)
Poh	
	m = REPLACE GYPSUM BY A MOLD AND MILDEW (HUMID ROOM SIDE) c = 150mm ABOVE FINISH CEILING uc = UNDER THE FINISH CEILING d = DWARF WALL
	*UNLESS OTHERWISE STATED, THE PARTITION IF SLAB)
XX# X#	MATERIAL AND FINISH MATERIAL AND ITS PROPERTIES IDENTIFIER FINISH AND ITS PROPERTIES IDENTIFIER
(XX# X#) (XX# X#)	FLOOR MATERIAL AND FINISH BASEBOARD MATERIAL AND FINISH
AC##	ACCESSORY TYPE
EQ##	EQUIPMENT OR FURNITURE TYPE
	REVISION NUMBER

## **UNIVERSITY OF TORONTO HEALTH &** WELLNESS CENTRE AT KOFFLER

214 COLLEGE STREET TORONTO, ON M5T 3A1 UNIVERSITY PROJECT NO.: P143-19-100 EVOQ PROJECT NO.: 9385-20-00

> **ISSUED FOR CONSTRUCTION** ISSUED 2025-04-30

SHEET LIST					
# SHEET NAME REV. # DA					
H-01	COVER	6	2025-04-30		
H-02	HERITAGE PLANS	6	2025-04-30		
H-03	HERITAGE ELEVATIONS AND DETAILS	6	2025-04-30		

## HERITAGE SCOPE SUMMARY

REFER TO COMPLETE SET OF CONTRACT DOCUMENTS FOR TOTAL SCOPE OF WORK IN CONTRACT

- 1. REMOVAL AND SALVAGE REMOVAL OF DETERIORATED STONE CLADDING FOR DUTCHMAN REPAIRS. REMOVAL OF EXISTING WOOD ENTRANCE DOOR FOR REPAIRS AND REINSTALLATION.
- <u>2. MASONRY</u>
  CLEANING AND REPAIRS TO STONE FACADE.
  REPOINTING OF MORTAR JOINTS. RECREATION AND INSTALLATION OF MISSING PROFILES AND
- CARVED STONES. 3. WINDOWS & DOORS MISCELLANEOUS REPAIRS TO EXISTING WOOD WINDOWS AND
- DOORS.
- REFINISHING WOOD WINDOWS AND DOORS. RESETTING OR REPLACEMENT OF GLASS LITES. EXISTING HARDWARE RESTORATION.

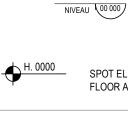


75, SHERBOURNE STREET, SUITE 503 TORONTO (ONTARIO) M5A 2P9 T. 647-723-2030

## PRIME ARCHITECTS / PROJECT MANAGER: ENFORM architects 128S STERLING ROAD, SUITE 302B TORONTO (ONTARIO) M6R 2B7 T. 647-948-7523



#### SYMBOLS LEGEND GRID IDENTIFICATION BUBBLE ΎΧ X EXISTING GRID IDENTIFICATION BUBBLE, GRID XA, XB, XC, X1, X2, X3 GENERAL ELEVATION REFERENCE A-000 GENERAL SECTION REFERENCE A-000 \_ WALL SECTION REFERENCE ∖A-000 1 A000 INTERIOR ELEVATION REFERENCE LD AND MILDEW RESISTANT GYPSUM E PARTITION IF FULL HEIGHT (SLAB TO DETAIL REFERENCE A-101 REFERENCE TO A VIEW <u>1/A101</u> LEVEL BUBBLE IN SECTION OR ELEVATION NIVEAU 00 000 TOP OF NIVEAU 00 000 BOTTOM OF .. APPROXIMATE LEVEL, TOP OF ... NIVEAU ±00 010 \_\_\_\_\_ APPROXIMATE LEVEL, BOTTOM OF ... NIVEAU ±00 010/ LESS IMPORTANT LEVEL OR SPECIFIC ELEMENT LEVEL, TOP OF ... NIVEAU 00 000



LESS IMPORTANT LEVEL OR SPECIFIC ELEMENT LEVEL, BOTTOM OF ...

-FLOOR AND CEILING, IN PLAN

CENTRE LINE

#### SEAL: ASSOC OF **O** ARCHITECTS DIMA COOK LICENCE 7285

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### PROJECT: UNIVERSITY OF TORONTO HEALTH & WELLNESS CENTRE AT KOFFLER

#### DRAWING TITLE: COVER

DESIGNED:	DC	PROJECT Nº:	9385-20-00
DRAWN:	EC/MM	DATE:	2023-10-01
VERIFIED:	DC	SCALE:	As indicated
DRAWING Nº:			H-01

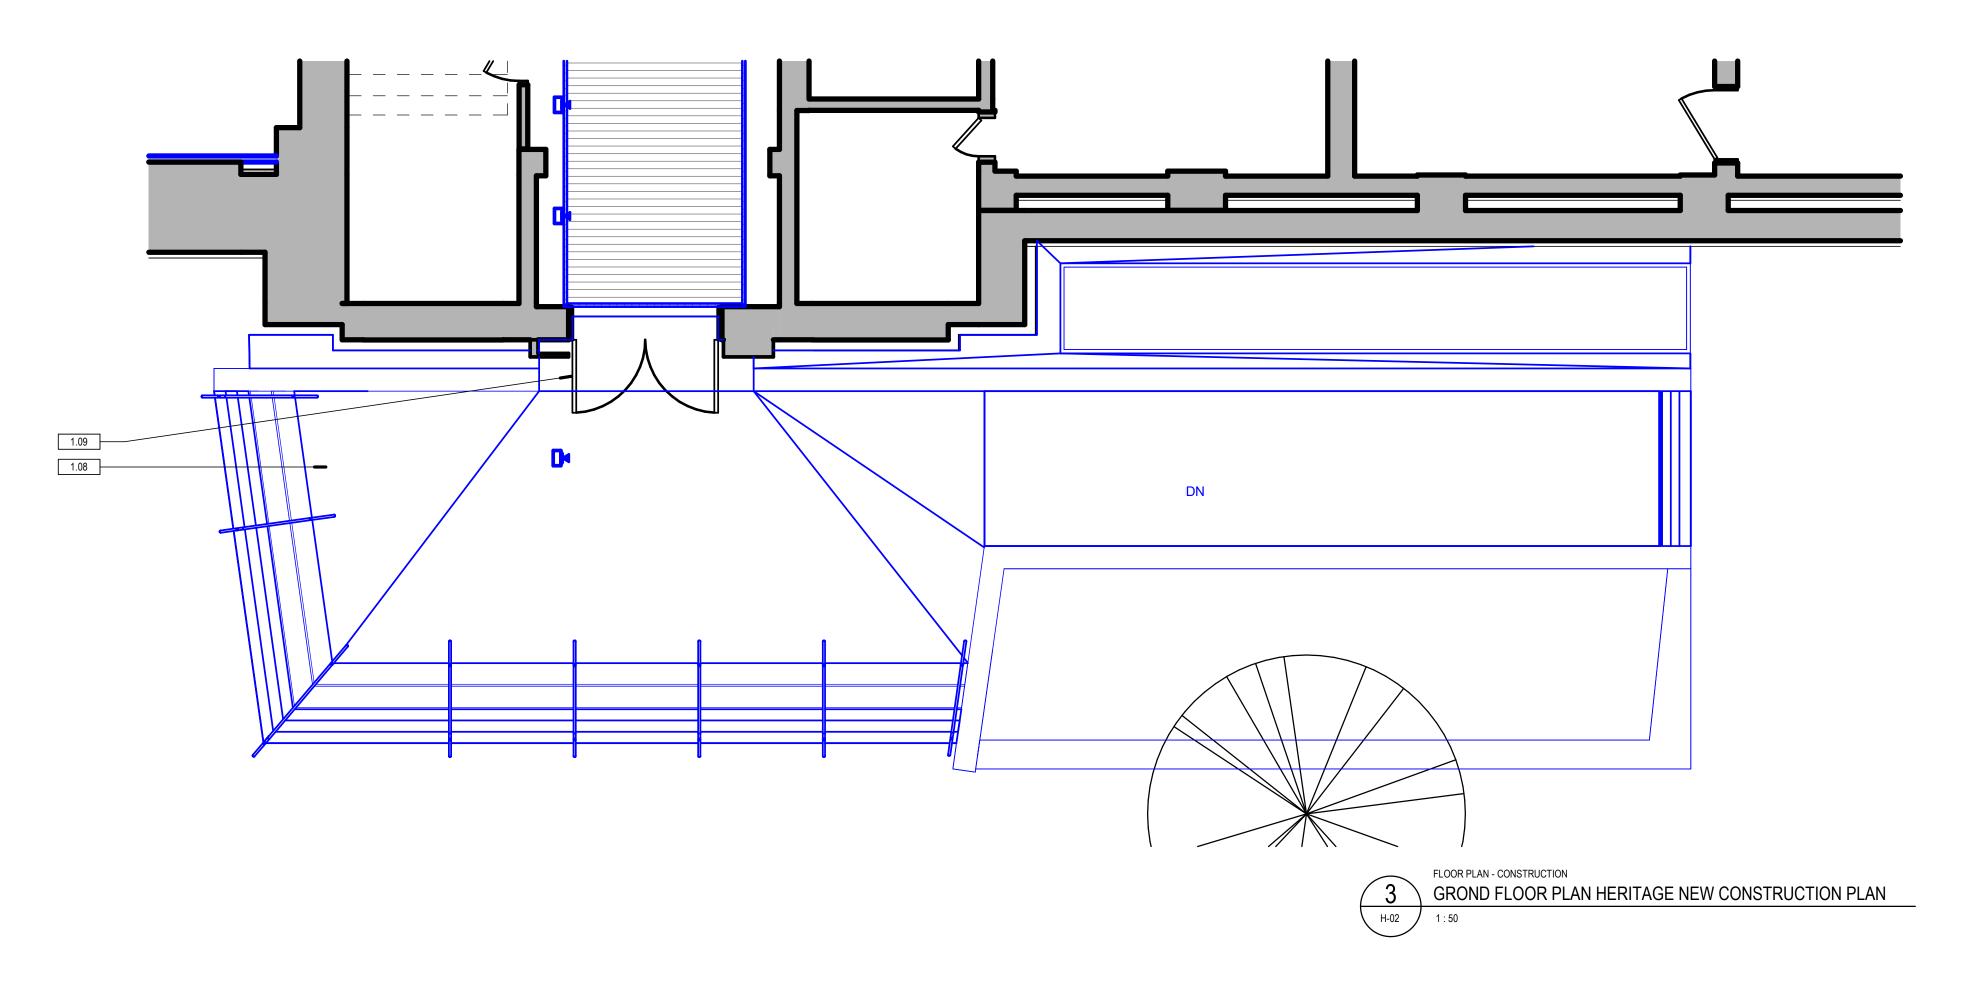
#### ISSUED FOR CONSTRUCTION MM 2025-04-30 MM 2025-01-31 ISSUED FOR BID ISSUED FOR HERITAGE PERMI MM 2024-11-15 MM 2024-11-15 ISSUED FOR BUILDING PERMIT MM 2024-02-16 ISSUED FOR BID PACKAGE #01 ISSUED FOR BUILDING PERMIT MM 2024-02-16 ISSUED FOR COORDINATION MM 2023-10-26 Nº: DESCRIPTION: BY DATE

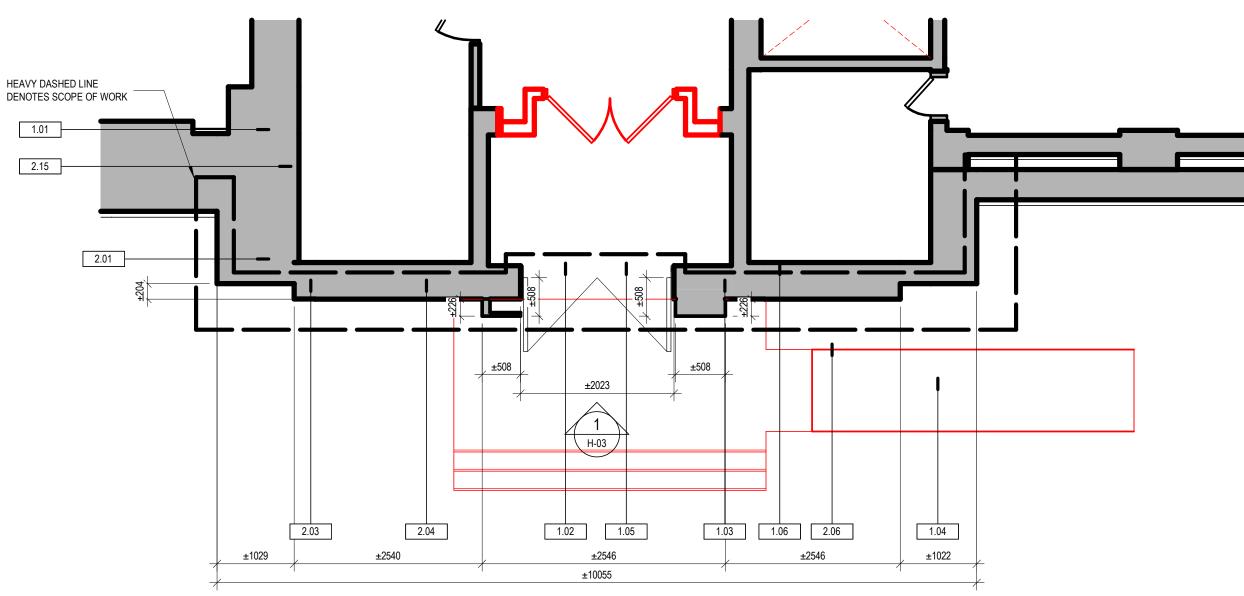
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Architecture inc.



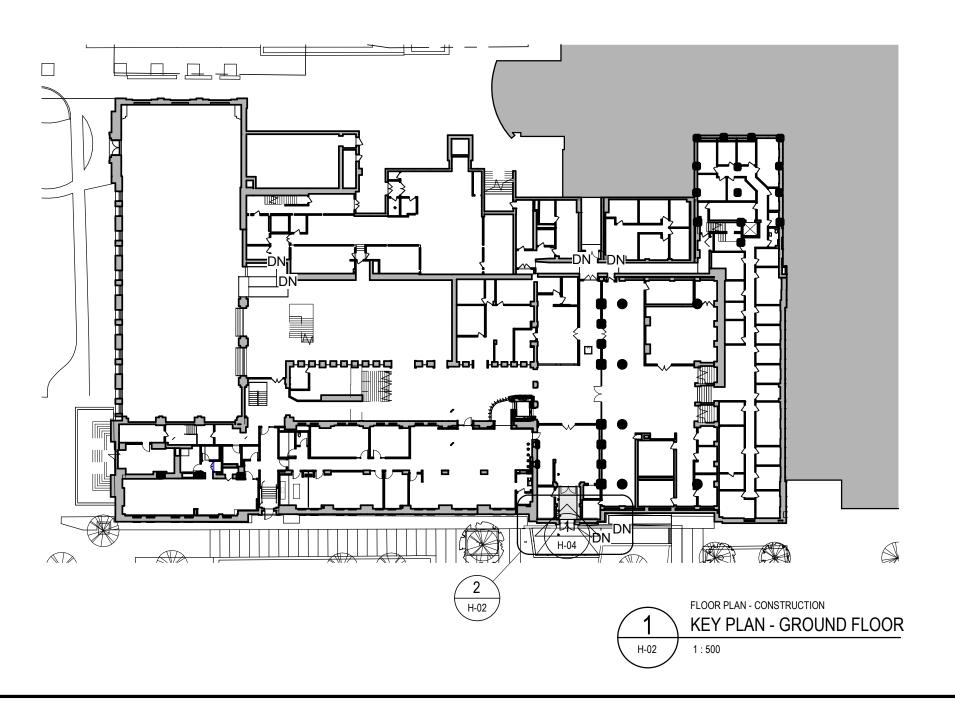


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H-02

FLOOR PLAN - CONSTRUCTION GROUND FLOOR PLAN HERITAGE REHABILITATION PLAN 1:50



#### GENERAL PROTECTION NOTES

- PRIOR TO CONSTRUCTION, ALL EXISTING CONDITIONS ARE TO BE THOROUGHLY
- PHOTOGRAPHED AND DOCUMENTED IN ORDER TO ESTABLISH A RECORD OF THE BUILDING PRIOR TO CONSTRUCTION. THE HERITAGE MATERIALS ARE TO BE TAGGED, CATALOGUED, PHOTOGRAPHED, AND DOCUMENTED PRIOR TO THEIR DISMANTLING. PROTECT ALL HERITAGE MATERIALS REMAINING IN SITU FOR THE DURATION OF CONSTRUCTION.
- 3. PROTECTION MEASURES INCLUDE:
- a. PROVIDE PROTECTION AT ALL INTERIOR PATHS OF TRAVEL DURING CONSTRUCTION. b. PROVIDE LIVE VIBRATION MONITORING SYSTEM TO TRACK CONSTRUCTION-RELATED VIBRATIONS. c. ENSURE STRUCTURAL WORK DOES NOT CAUSE INADVERTENT DAMAGE TO
- DECORATIVE PLASTER.
- d. MAINTAIN TEMPERATURE AND HUMIDITY LEVELS. CAREFUL OVERSIGHT IS REQUIRED DURING THE CONSTRUCTION PROCESS TO PREVENT DAMAGE TO HERITAGE MATERIALS. THIS WILL INCLUDE HERITAGE ELEMENTS LOCATED WITHIN THE PROPOSED AREA OF SCOPE AS WELL AS AREAS OF CONSTRUCTION ACCESS OUTSIDE OF THE PROPOSED SCOPE OF WORK, WHERE THERE ARE EXISTING HERITAGE
- ELEMENTS. SHOULD ANY CONCEALED MATERIALS OR SYSTEMS THAT MAY POTENTIALLY BE HERITAGE IN NATURE BE DISCOVERED WITHIN THE SITE DURING WORK, ACTIVITIES SHOULD BE HALTED AT THAT LOCATION IMMEDIATELY AND THE CONSULTANT SHOULD BE NOTIFIED TO REVIEW.

#### GENERAL DISMANTLING NOTES

- 1. COORDINATE ALL WORK WITH THE DEMOLITION WORK OF THE EXTERIOR RAMP. REFER TO ARCHITECTURAL AND LANDSCAPE DRAWINGS FOR EXTERIOR STAIR SCOPE. DISMANTLE HERITAGE MATERIALS TO BE REMOVED DURING CONSTRUCTION. DO NOT
- DEMOLISH OR DAMAGE. DISMANTLING MEASURES INCLUDE: a. PROPER HANDLING AND STORAGE OF ALL SALVAGED HERITAGE MATERIALS TO BE REINSTALLED ON THE BUILDING SO AS TO NOT INADVERTENTLY DAMAGE THESE MATERIALS DURING THE CONSTRUCTION PROCESS.
- b. CAREFUL DISMANTLING OF THE EXISTING EAST EXIT RAMP AND STAIRS TO MINIMIZE DAMAGE TO THE BUILDING'S STONE WALL.

GENERAL, PROTECTION, & DISMANTLING KEYNOTES

#	Keynote
1.01	PRIOR TO CONSTRUCTION, REVIEW AND IMPLIMENT GENERAL PROTECTION AND DISMANTLING REQUIREMENTS.
1.02	ENSURE PROTECTION MEASURES NOTED IN GENERAL PROTECTION NOTES ARE IMPLEMENTED PRIOR TO PROCEEDING WITH DISMANTLING WORK.
1.03	DISMANTLE MATERIALS TO BE REMOVED DURING CONSTRUCTION WHEN IN RELATION TO HERITAGE SCOPE OF WORK. DO NOT DEMOLISH OR DAMAGE.
1.04	CAREFULLY DISMANTLE EXISTING ENTRANCE RAMP AND STAIRS TO MINIMIZE DAMAGE TO BUILDING'S MASONRY. COORDINATE ALL WORK WITH THE DEMOLITION WORK OF THE EXTERIOR RAMP. REFER TO ARCHITECTURAL AND LANDSCAPE DRAWINGS FOR RAMP AND EXTERIOR STAIR SCOPE.
1.05	EXISTING DOOR AND TRANSOM TO BE REMOVED FOR REHABILITATION IN CONTRACTORS SHOP.
1.06	REMOVE EXISTING DOOR CONTROLS, LIGHT FIXTURES, SIGNAGE, AND OTHER MOUNTED FIXTURES, COORDINATE STORAGE OR DISPOSAL WITH UNIVERSITY.
1.07	INSTALL PARGING, MEMBRANE, AND DRAINAGE BOARD TO SEPARATE PROPOSED NEW RAMP AND STAIR FROM THE EXISTING FOUNDATION WALL BEHIND. REFER TO ARCHITECTURAL AND LANDSCAPE DRAWINGS.
1.08	NEW STAIRS, LANDING, RAMP, HANDRAILS. REFER TO ARCHITECTURAL
1.09	REINSTALL REHABILITED HERITAGE DOOR AND TRANSOM

MASONRY KEYNOTES

#### Kevnote

#	Keynote
2.01	CLEAN 100% OF SCOPE AREA TO REMOVE ALL ATMOSPHERIC SOILING. MULTIPLE PASSES MAY BE REQURIED WHERE HEAVING SOILING PRESENT. ASSUME ENTIRE UPPER PLINTH TO REQUIRE REMOVAL OF HEAVY ATMOSPHERIC SOILING.
2.02	CLEAN ALL GRAFFITTI AND FERRIC STAINING FROM MASONRY WITHIN SCOPE OF WORK AREA.
2.03	REPOINT 100% OF MASONRY JOINTS IN SCOPE AREA.
2.04	SCALE AND RUB BACK TO SOUND SURFACE 100% OF SCOPE AREA TO REMOVE LOOSE STONE FROM SURFACE.
2.05	STAR HATCH DENOTES AREA TO POULTICE FOR SALT REMOVAL. WIDTH AS INDICATE IN PLANS AND TO APPROXIMATELY 1 m IN HEIGHT.
2.06	CONSOLIDATE EXISTING MASONRY FOUNDATION WHERE THE CONCRETE LANDING IS BEING REMOVED.
2.07	REPAIR SMALL HOLES FROM EXISTING FIXTURES BEING DISMANTLED OR OTHERWISE. INCLUDES LIGHTING, SIGNAGE, SECURITY HARDWARE, ACCESS HARDWARE, AND MISCELLANEOUS HOLES, TYP.
2.08	REPAIR EXTERIOR MASONRY WALL BEHIND AND WHERE THE EXISTING ENTRANCE DOOR FRAME IS BEING REMOVED.
2.09	REMOVE CAULKING FROM STONE LEFT BY DOOR JAMBS AND FIXTURES.
2.10	REMOVE PATCH AND COMPLETE DUTCHMAN REPAIR TO REINSTATE PLINTH PROFILE.
2.11	PERFORM DUTCHMAN REPAIR APPROXIMATELY 125 mm x 200 mm x 900 mm IN SIZE, MATCH EXISTING STONE DETAILING.
2.12	PERFORM LOCALIZED SCULPTURAL MORTAR REPAIRS TO DECORATIVE STONEWORK.
2.13	CUT BACK STONE PLINTH 100 mm, REMOVE PATCH THEN COMPLETE DUTCHMAN REPAIR TO REINSTATE PLINTH PROFILE.
2.14	PERFORM CRACK INJECTION REPAIR TO MINOR CRACKS IN STONE.

#### DOOR REHABILITATION KEYNOTES

2.15 REMOVE FRAGMENTED CORNER PLINTH PIECE AND PERFORM DUTCHMAN REPAIR.

#	Keynote
3.01	REPAIR AND REFINISH EXISTING DOORS, TRANSOM, JAMBS, CASING, FRAMES, AND HARDWARE.
3.02	STRIP DOORS, TRANSOM, JAMBS, CASING, & FRAMES OF ALL FINISHES BACK TO BARE WOOD, CLEAN, REPAIR, AND REPAINT OR STAIN TO MATCH ORIGINAL FINISH.
3.03	REPAIR HOLES FROM OLD HARDWARE, TYP.
3.04	REMOVE, CLEAN, AND REINSTALL ALL HARDWARE, TYP.
3.05	REPLACE GLASS AND BUILDING IDENTIFICATION ON DOORS.
3.06	REMOVE, CLEAN, AND REINSTALL GLASS ON NEW PUTTY BED FROM TRANSOM.
3.07	REINSTALL FRAMES, DOORS, AND TRANSOM TO EXISTING LOCATION.
3.08	REPLACE ALL CAULKING AND SEALANTS.
3.09	REPLACE ALL WEATHERSTRIPPING.

# EVGQ

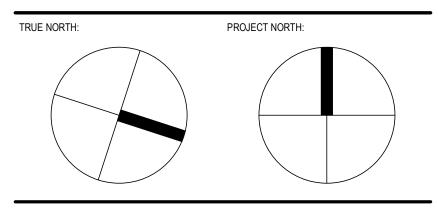
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ARCHITECTS:

OWNER:

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#### PROJECT: UNIVERSITY OF TORONTO HEALTH & WELLNESS CENTRE AT KOFFLER

Architecture inc.

#### DRAWING TITLE: HERITAGE PLANS

DRAWN: EC/MM DATE: 2023-10-01 VERIFIED: DC SCALE: As indicated	
DRAWN: EC/MM DATE: 2023-10-01	
DESIGNED: DC PROJECT N°: 9385-20-00	



EAST ELEVATION - DETAIL PHOTO H-03

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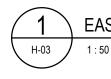
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# 2.01

- 2.07 2.02 2.07 2.09 2.14
- 1.06 2.11 2.10

## 1.04

EAST ELEVATION HERITAGE SCOPE OF WORK AREA

# EVOQ

75. SHERBOURNE STREET. SUITE 503 TORONTO (ONTARIO) M5A 2P9 T. 647-723-2030

ARCHITECTS:

OWNER:

## PRIME ARCHITECTS / PROJECT MANAGER: ENFORM architects 128S STERLING ROAD, SUITE 302B TORONTO (ONTARIO) M6R 2B7 T. 647-948-7523

UNIVERSITY OF TORONTO

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Architecture inc.

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DESIGNED:	DC	PROJECT №:	9385-20-00
DRAWN:	EC/MM	DATE:	2023-10-01
VERIFIED:	DC	SCALE:	N.T.S.icated
DRAWING Nº:			

H-03