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 7. 24.08.16 ISSUED FOR PERMIT
 6. 24.08.02 ISSUED FOR 100% CD COSTING
 5. 24.04.29 ISSUED FOR 80% CD COSTING
 4. 23.12.08 ISSUED FOR DD REVIEW
 3. 23.11.17 ISSUED FOR DD COSTING
 2. 23.10.24 ISSUED FOR 100% DD
 1. 23.08.30 ISSUED FOR DRAFT SD REVIEW

No. Date Issue/Revision

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THIS DRAWING SHALL BE READ IN CONJUNCTION WITH MECHANICAL SPECIFICATION SUBMITTED FOR THIS PROJECT.

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No. Date Issue/Revision

Robarts 5th Floor MDL Renovation

Title: **MECHANICAL DRAWING LIST, LEGENDS AND STANDARD DETAILS**













Project No. 08086.000(MEAVD) Scale AS NOTED
 Drawing No.

M-000

SYMBOL	DESCRIPTION	SYMBOL	DESCRIPTION
[Symbol]	FIRE DAMPER	[Symbol]	SMOKE DAMPER
[Symbol]	MOTOR OPERATED DAMPER	[Symbol]	POSITIVE SEAL DAMPER
[Symbol]	MANUAL DAMPER	[Symbol]	GRAVITY OR BACKDRIFT DAMPER
[Symbol]	BALANCING DAMPER	[Symbol]	SPLITTER DAMPER
[Symbol]	COMBINATION SMOKE AND FIRE DAMPER	[Symbol]	REMOTE OPERATED BALANCING DAMPER
[Symbol]	VOLUME EXTRACTOR		

SYMBOL	DESCRIPTION	SYMBOL	DESCRIPTION
[Symbol]	DETAIL NUMBER	[Symbol]	SECTION NUMBER
[Symbol]	DRAWING NUMBER	[Symbol]	DRAWING NUMBER
[Symbol]	REVISION NUMBER	[Symbol]	REVISION BUBBLE
[Symbol]	ELBOWS	[Symbol]	PIPING SERVICE CONTINUES
[Symbol]	TEE	[Symbol]	REFER TO STANDARD DETAIL DRAWINGS FOR ADDITIONAL REQUIREMENTS OF EQUIPMENT NOTED
[Symbol]	BRANCH OFF BOTTOM OF MAIN	[Symbol]	VENT PIPE REDUCER
[Symbol]	BRANCH OFF TOP OF MAIN	[Symbol]	AIR QUANTITY C.F.M. (L/S)
[Symbol]	DIRECTION OF FLOW	[Symbol]	NAMING OF EXISTING EQUIPMENT

SYMBOL	DESCRIPTION	SYMBOL	DESCRIPTION
[Symbol]	SUPPLY DUCT UP OR FROM ABOVE	[Symbol]	ACOUSTICALLY LINED TRANSFER AIR DUCT
[Symbol]	SUPPLY DUCT DOWN OR FROM BELOW	[Symbol]	SLEENER
[Symbol]	RETURN OR EXHAUST DUCT UP OR FROM ABOVE	[Symbol]	CROSSLALK SILENCER
[Symbol]	RETURN OR EXHAUST DUCT DOWN OR FROM BELOW	[Symbol]	DUCT WITH MINIMUM CLEARANCE FIRE RATED ENCLOSURE
[Symbol]	ROUND DUCT UP OR FROM ABOVE	[Symbol]	DUCT WITH SLEEVE, INSULATION AND DAMPER
[Symbol]	ROUND DUCT DOWN OR FROM BELOW	[Symbol]	CAPPED CONNECTION
[Symbol]	ACUSTIC LINED DUCT	[Symbol]	INSULATION DUCT
[Symbol]	FLEXIBLE CONNECTION	[Symbol]	RISE IN DUCT
[Symbol]	SQUARE ELBOW DUCT WITH TURNING VANE	[Symbol]	SLOPE DUCT
[Symbol]	RADIUS ELBOW WITH TURNING VANES	[Symbol]	CRCP IN DUCT
[Symbol]	AXIAL FAN/INLINE FAN	[Symbol]	SOUND BARRIER
[Symbol]	MIXER FLOW OR CENTRIFUGAL	[Symbol]	PROPELLER FAN WITH PROTECTIVE SCREEN
[Symbol]	CENTRIFUGAL FAN (ONLY IN SCHEMATIC)	[Symbol]	CENTRIFUGAL FAN (ONLY IN SCHEMATIC)
[Symbol]	DIFFUSER GRILLE OR REGISTER TYPE	[Symbol]	LINEAR SLOT DIFFUSER
[Symbol]	ROUND SUPPLY DIFFUSER	[Symbol]	LINEAR SUPPLY AIR DIFFUSER CW FLEXIBLE DUCT
[Symbol]	DUCTED RETURN OR EXHAUST REGISTER OR GRILLE	[Symbol]	LIGHT TROFFER DIFFUSER TOP INLET CW FLEXIBLE DUCT
[Symbol]	SQUARE OR RECTANGULAR DIFFUSER	[Symbol]	LIGHT TROFFER DIFFUSER SIDE INLET CW FLEXIBLE DUCT
[Symbol]	NON DUCTED RETURN OR EXHAUST	[Symbol]	DUCT MOUNTED SUPPLY OR RETURN GRILLE
[Symbol]	NON DUCTED ROUND RETURN OR EXHAUST GRILLE	[Symbol]	LINEAR SUPPLY OR RETURN GRILLE
[Symbol]	SQUARE PLAQUE DIFFUSER	[Symbol]	SPRIN CONNECTION CW BALANCING DAMPER AND FLEX DUCT
[Symbol]	DIFFUSERS WITH BLANK-OFF PORTION (CITY BROWN)	[Symbol]	SPRIN CONNECTION CW BALANCING DAMPER AND RIGID DUCT

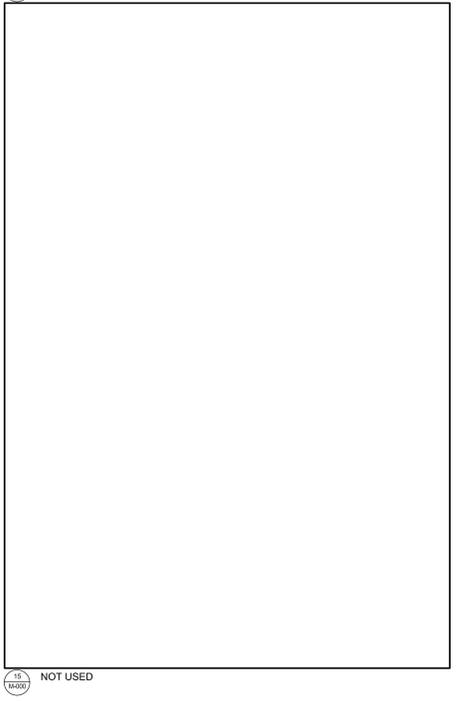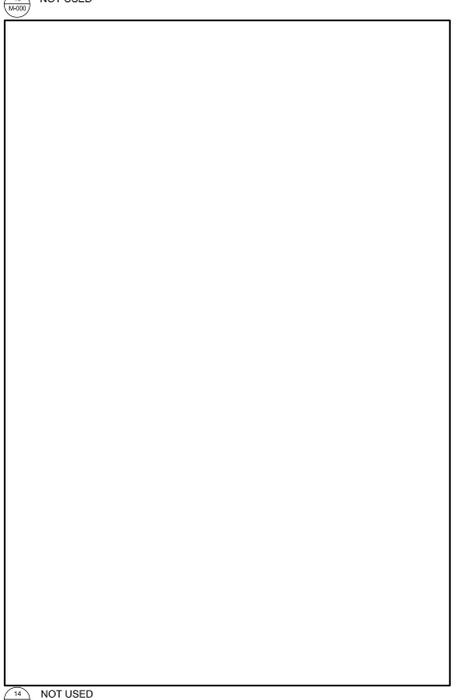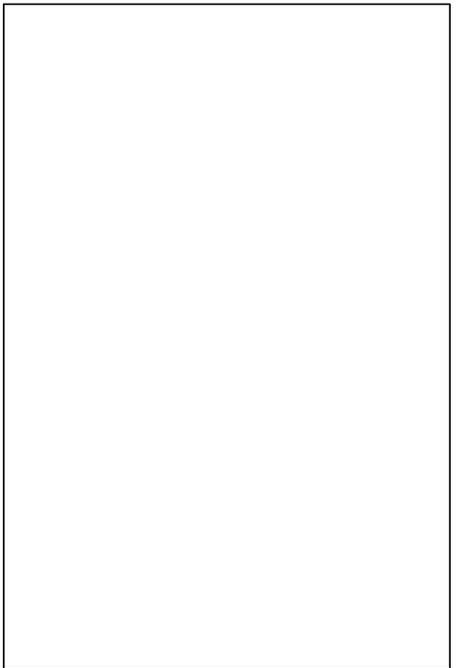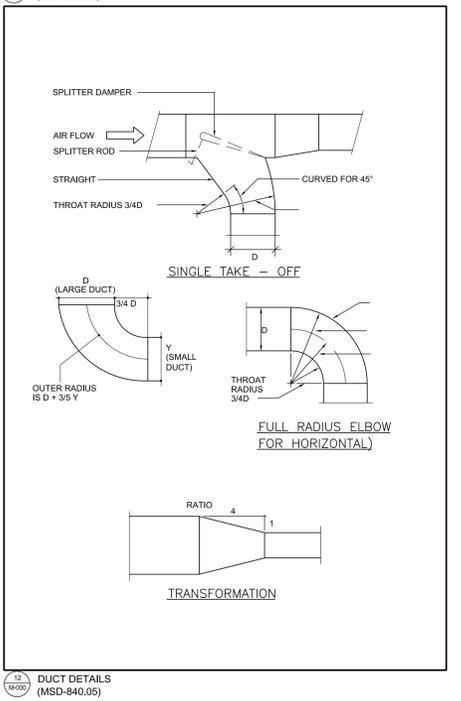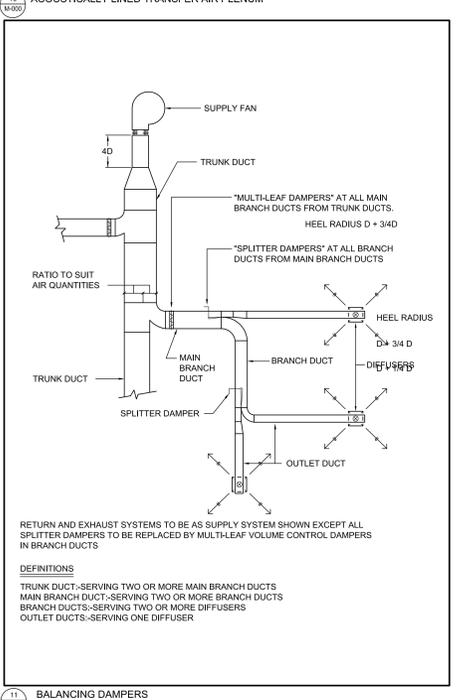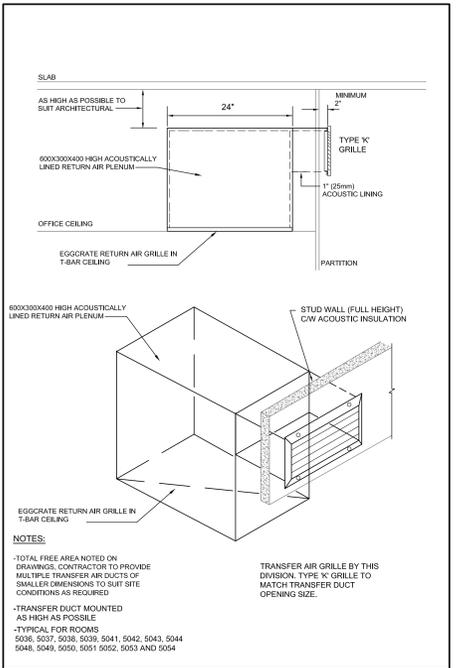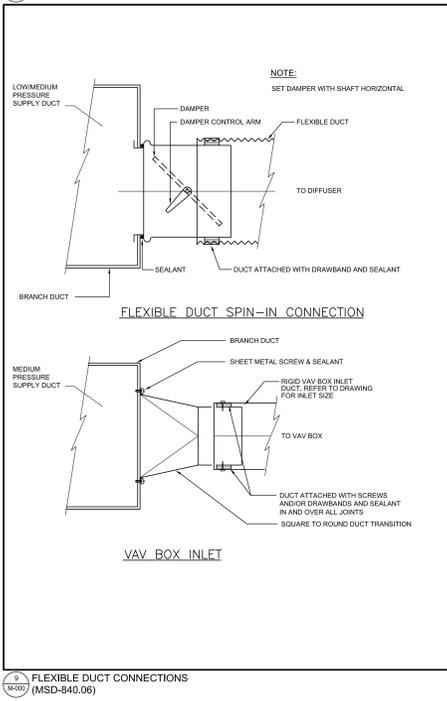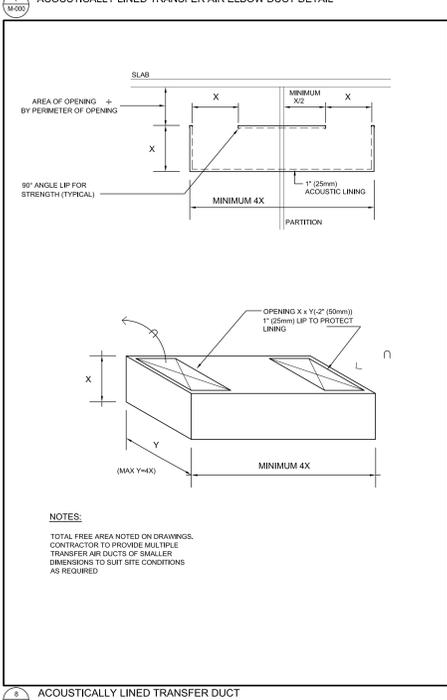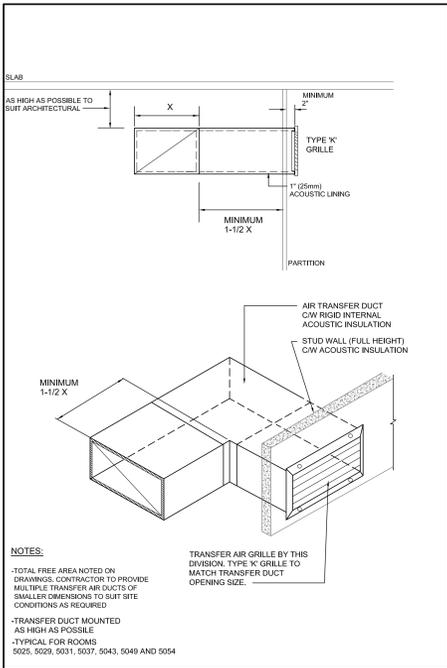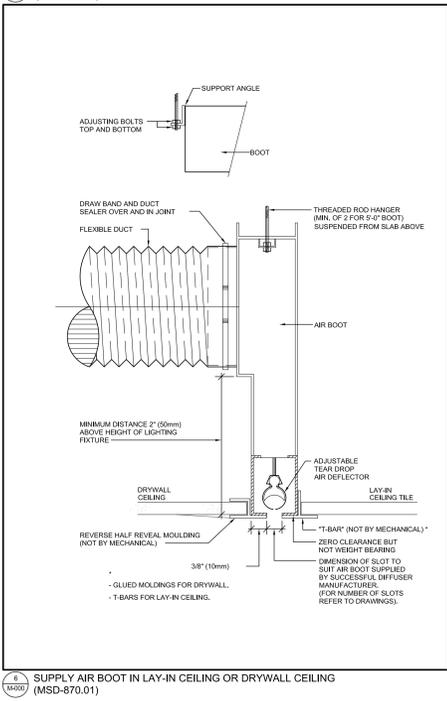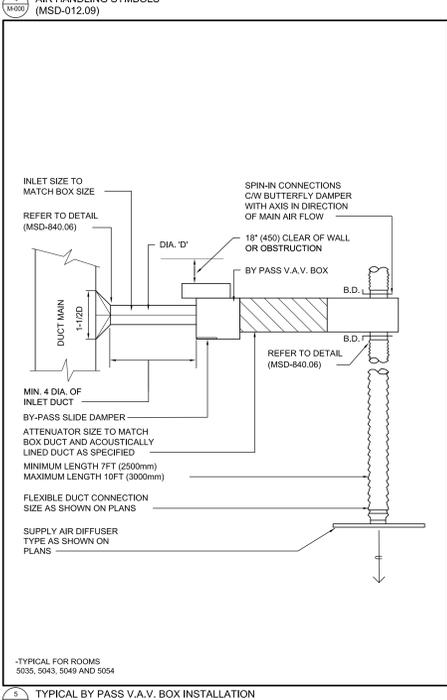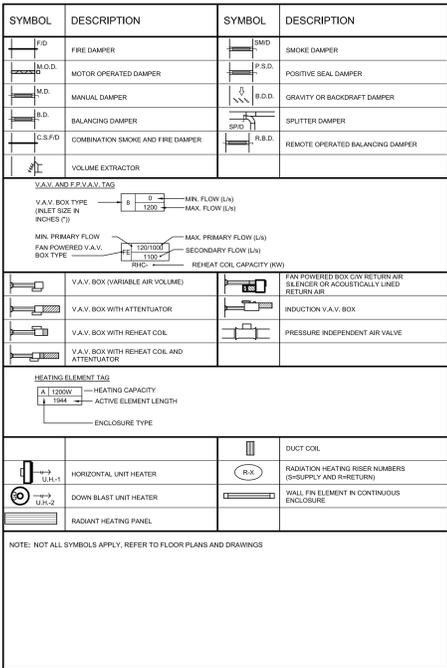

NOT USED

Pneumatic Wireless Thermostats

FLOOR	# OF TSTATS	# OF BAC TSTAT	# OF REPEATERS	# BACNET ROUTER
14	11	0	11	1
13	18	0	18	1
12	17	0	17	1
11	17	0	17	1
10	17	0	17	1
9	20	0	20	1
8	23	0	23	1
7	18	0	18	1
6	29	14	15	1
5	13	0	13	1
4	13	0	13	1
3	13	0	13	1
2	13	0	13	1
1	10	0	10	1
B1	9	0	9	1
B2	8	0	8	1
TOTAL	254	14	110	16

4.21 SPACE THERMOSTATS - MAIN LIBRARY
4.21.1 Space temperature will be replaced with new wireless to pneumatic local thermostats and will control no heat coils valves as before. Wireless communication signals will be done through the Cypress "green box" to adjust setpoint, need current temperature and pneumatic position. Refer to points list for more detail.

Designation	Qty	Part Number	Description
001	1	4092-0644	U of T Roberts Library

WIRELESS THERMOSTATS (EXISTING - FOR INFORMATION ONLY)

AHU-1.3.4.5.7.23.24.25.26.27.28.30.31 Flow Drawing & Sequence

Designation	Qty	Part Number	Description
001	1	4092-0644	U of T Roberts Library

4.3.1 Unit off
4.3.2 Start up indicated by time schedule from the BAS.
4.3.3 Outdoor air and exhaust dampers open to pre-set minimum position. Supply and return fans start.
4.3.4 Temperature Control
4.3.5 Supply and return fans off. Outdoor air and exhaust dampers are closed, recirculation air damper is open. Supply and return fans off. Outdoor air damper is open.
4.3.6 Alarm at the BAS if frost is present at the outdoor air damper in pre-set minimum position. The control set point shall be enabled and modulated to maintain set point.

AIR HANDLING UNITS (EXISTING - FOR INFORMATION ONLY)

BY PASS VAV TERMINAL

ABBREVIATIONS
AI - ANALOG INPUT
AO - ANALOG OUTPUT
AF - AIR FLOW
BD - BINARY DIRECT
SPCT - SPACE TEMPERATURE

BY PASS VAV TERMINAL

People Counter

As the number of people entering the building the people counter will count the number of people and provide that value to the BAS. Depending on the number of people in that zone the speed of the AHU's supply fan and return fan will increase.

Example below:
Step A = 0-50 people = 50% Fan Speed
Step B = 50-100 people = 75% Fan Speed
Step C = 100-200 people = 100% Fan Speed
Step D = 200+ people = 125% Fan Speed
All step changes and fan speed increments are adjustable.

Designation	Qty	Part Number	Description
001	1	4092-0644	U of T Roberts Library

PEOPLE COUNTER (OUTSIDE AIR CONTROLLER) (EXISTING - FOR INFORMATION ONLY)

AHU-6 (F-6 F-17) Flow Drawing & Sequence

Designation	Qty	Part Number	Description
001	1	4092-0644	U of T Roberts Library

4.3.1 Unit off
4.3.2 Start up indicated by time schedule from the BAS.
4.3.3 Outdoor air and exhaust dampers open to pre-set minimum position. Supply and return fans start.
4.3.4 Temperature Control
4.3.5 Supply and return fans off. Outdoor air and exhaust dampers are closed, recirculation air damper is open. Supply and return fans off. Outdoor air damper is open.
4.3.6 Alarm at the BAS if frost is present at the outdoor air damper in pre-set minimum position. The control set point shall be enabled and modulated to maintain set point.

AIR HANDLING UNITS (EXISTING - FOR INFORMATION ONLY)

BAS GRAPHICS SHALL SHOW THE FOLLOWING:

- SPACE TEMPERATURE SET POINT
- SPACE TEMPERATURE PRESENT TEMPERATURE
- DAMPER COMMAND
- DAMPER FEED BACK
- HIGH SPACE TEMPERATURE ALARM
- LOW SPACE TEMPERATURE ALARM
- UPS OPERATING ON BATTERY ALARM
- UPS LOW BATTERY ALARMS

DRAWING NOTES:
1. PROVIDE NEW BACNET BUILDING CONTROLLER.
2. PROVIDE NEW LOCAL EQUIPMENT CONTROLLER (QUANTITY TO BE DETERMINED BY BAS CONTRACTOR TO SUIT INSTALLATION AND SEQUENCE OF OPERATION REQUIREMENTS)
3. PROVIDE NEW BACNET MSTP COMMUNICATIONS CABLE AND ASSOCIATED CONDUIT BETWEEN CONTROLLER AND NETWORK CONTROLLER.
4. PROVIDE NEW CAT5 CABLE AND ASSOCIATED CONDUIT FROM NETWORK CONTROLLER TO EXISTING FAS SWITCH.
5. PROVIDE NEW UPS FOR NEW NETWORK CONTROLLER.
6. CONTROL CONTRACTOR TO PROVIDE PHOTOGRAPHS OF INSTALLATION TO FAS IT GROUP PER U OF T BAS STANDARD.

5TH FLOOR BAS NETWORK CABINET SCHEMATIC

Room Schedule

Box Location	Name	System Name	Mech. Degr.	Rel.	Req'd
Fth Floor	001_0010_CYP_WPT2	WIRELESS PN TSTAT	M10 M111	18	4
Fth Floor	001_0010_CYP_WPT3	WIRELESS PN TSTAT	M10 M111	18	4
Fth Floor	001_0010_CYP_WPT5	WIRELESS PN TSTAT	M10 M111	18	4
Fth Floor	001_0010_CYP_WPT6	WIRELESS PN TSTAT	M10 M111	18	4
Fth Floor	001_0010_CYP_WPT7	WIRELESS PN TSTAT	M10 M111	18	4
Fth Floor	001_0010_CYP_WPT8	WIRELESS PN TSTAT	M10 M111	18	4
Fth Floor	001_0010_CYP_WPT9	WIRELESS PN TSTAT	M10 M111	18	4
Fth Floor	001_0010_CYP_WPT10	WIRELESS PN TSTAT	M10 M111	18	4
Fth Floor	001_0010_CYP_WPT11	WIRELESS PN TSTAT	M10 M111	18	4
Fth Floor	001_0010_CYP_WPT12	WIRELESS PN TSTAT	M10 M111	18	4
Fth Floor	001_0010_CYP_WPT13	WIRELESS PN TSTAT	M10 M111	18	4
Fth Floor	001_0010_CYP_WPT14	WIRELESS PN TSTAT	M10 M111	18	4


ROOM SCHEDULE (EXISTING - FOR INFORMATION ONLY)

Floors 2 to 6 Network Riser

Network riser diagram showing connections between floors 2 to 6, including network switches, patch panels, and cabling.

Designation	Qty	Part Number	Description
001	1	4092-0644	U of T Roberts Library

NETWORK RISER (EXISTING - FOR INFORMATION ONLY)

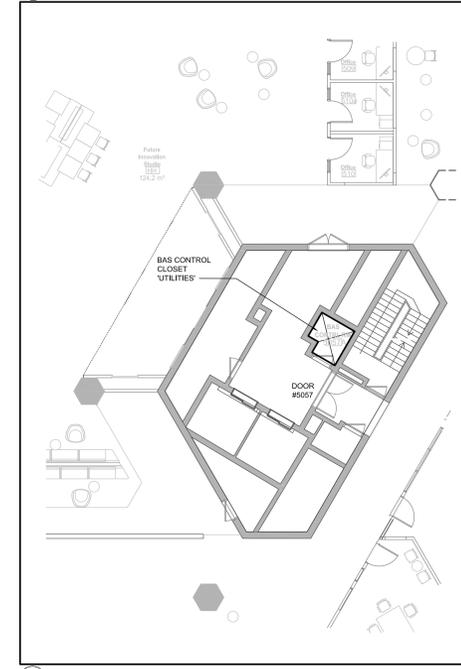

5TH FLOOR BAS NETWORK CABINET ROOM LOCATION

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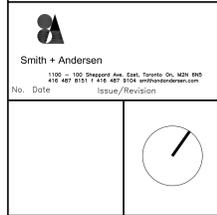


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6.	23.11.17	ISSUED FOR DD COSTING
7.	23.10.24	ISSUED FOR 100% DD
8.	23.08.30	ISSUED FOR DRAFT 5D REVIEW

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Robarts 5th Floor MDL Renovation

Title: BAS CONTROL SCHEMATICS

Project No. 080806.000/MEAVD/ Scale AS NOTED


Drawing No. M-001

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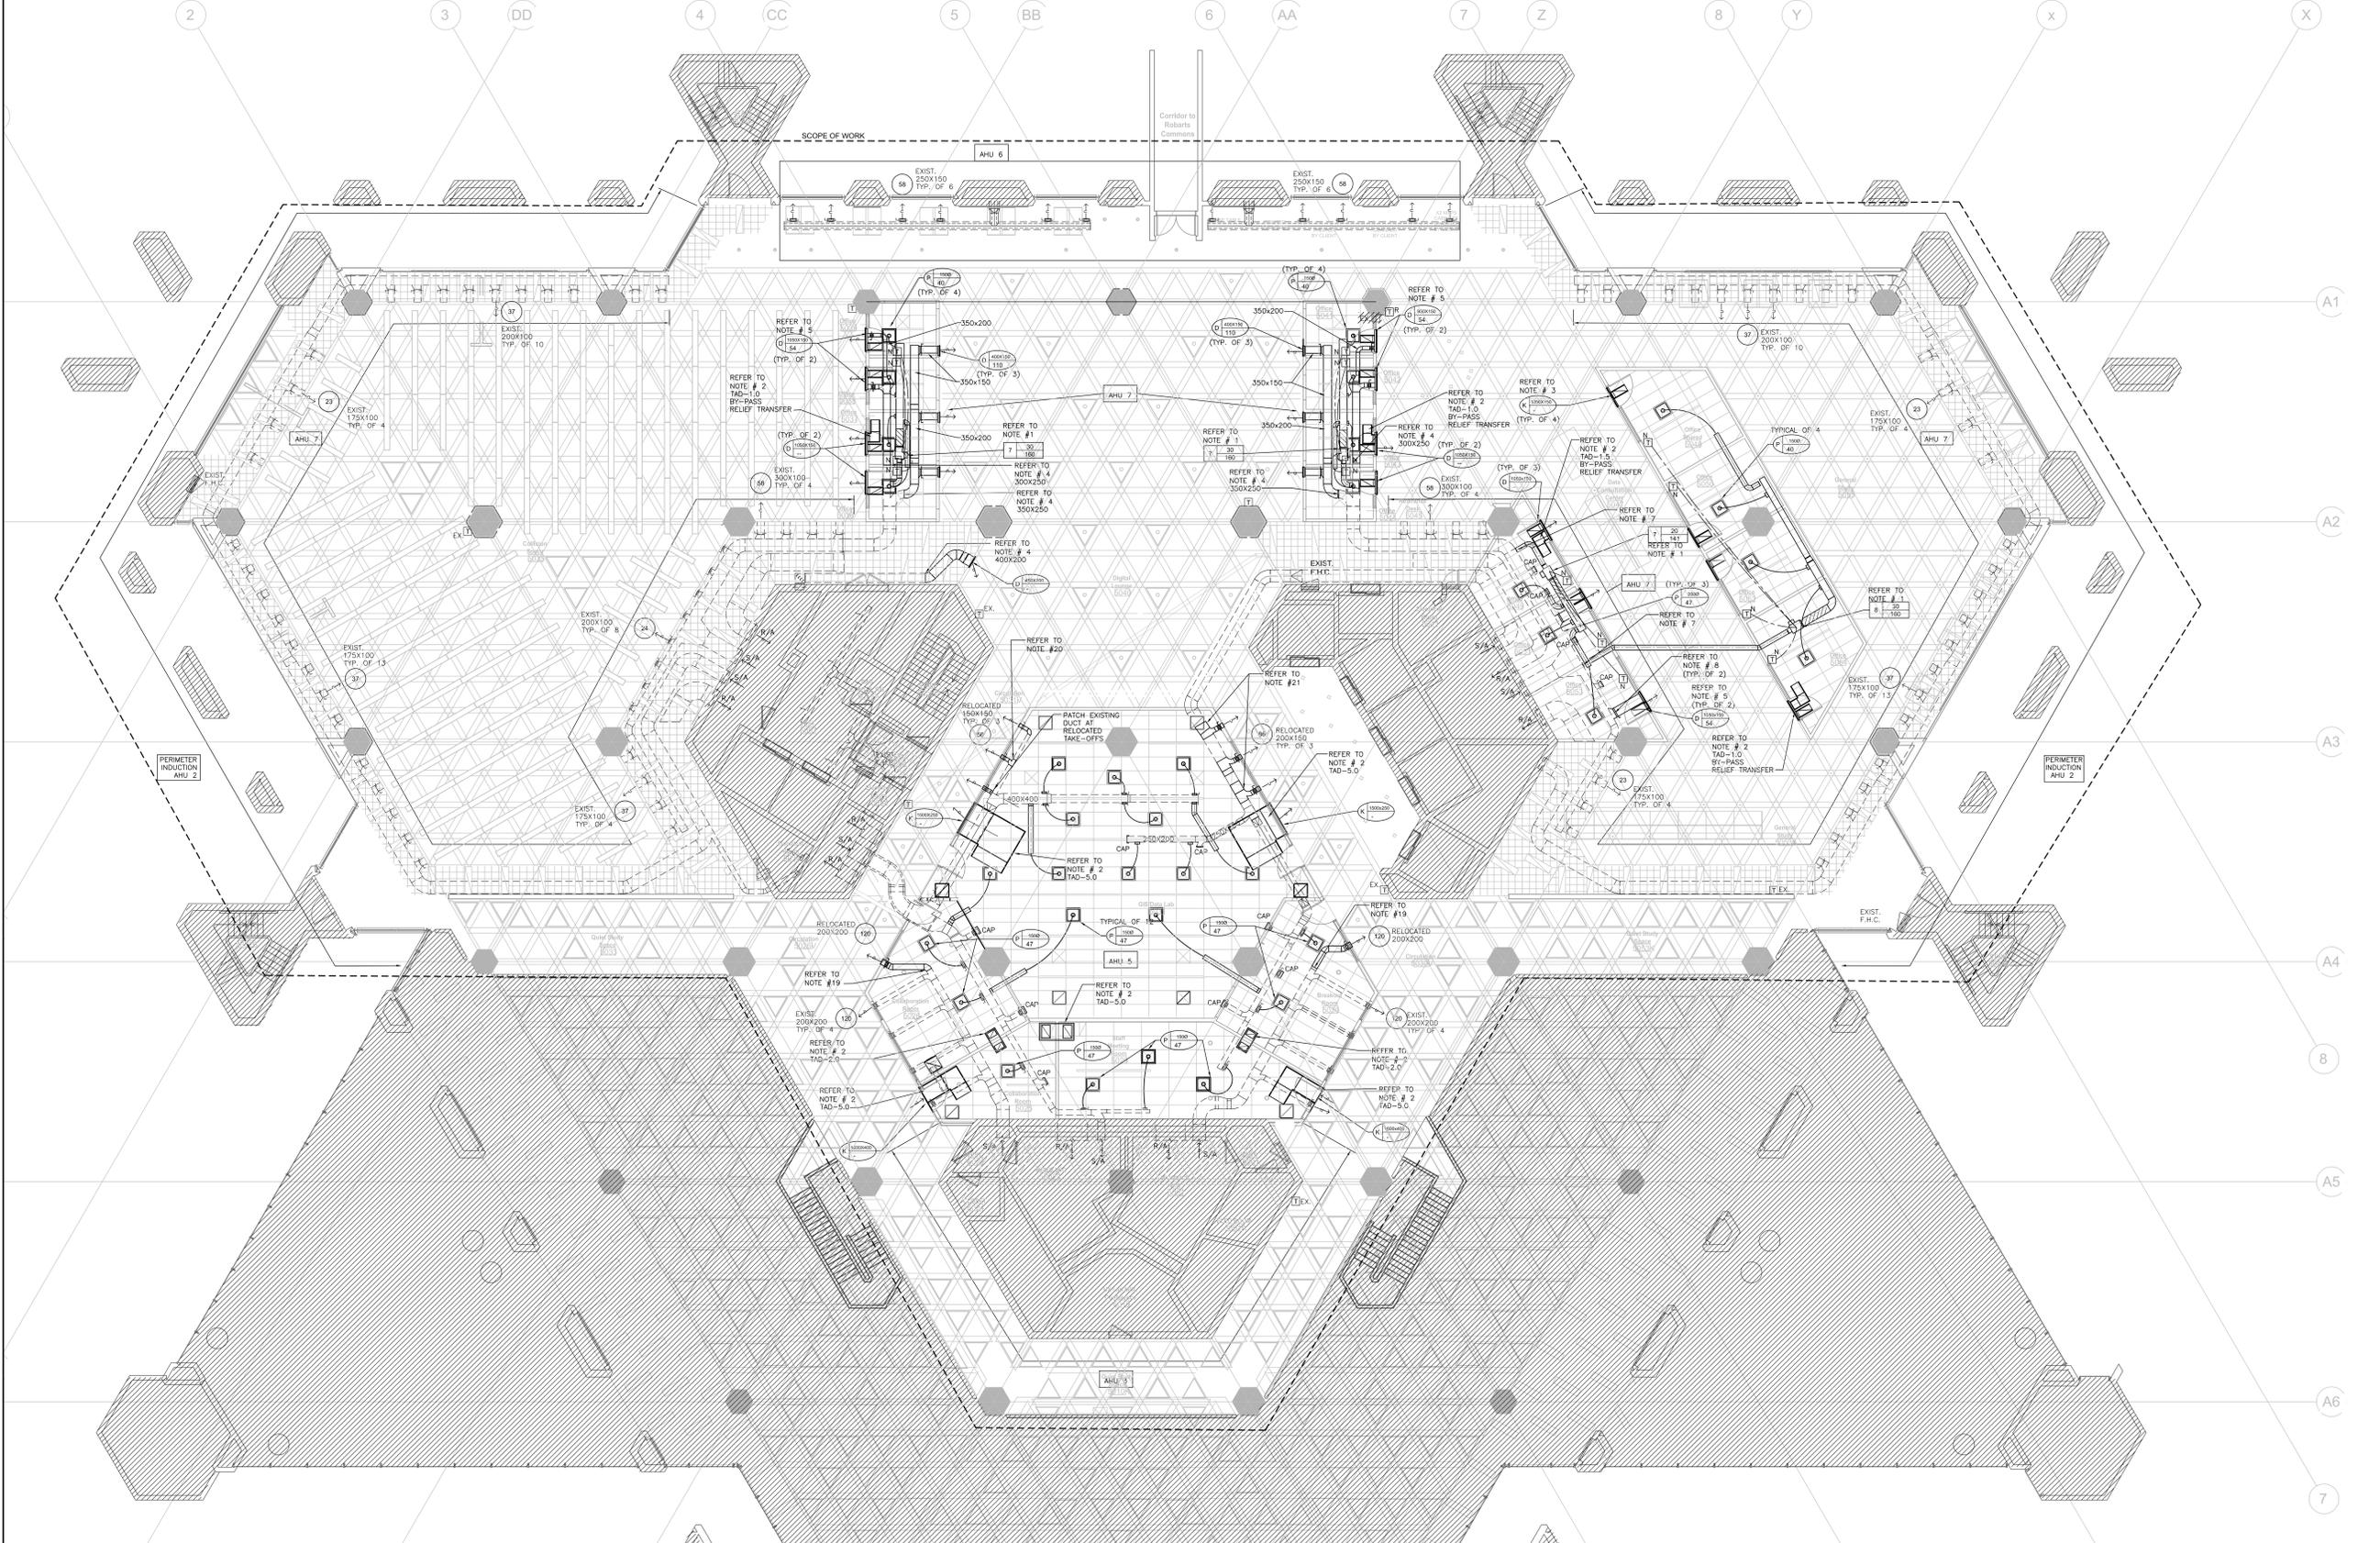
- GENERAL NOTES:**
- DO NOT SCALE DRAWINGS. THE LOCATIONS OF ALL ITEMS SHOWN ON THE DRAWINGS OR SPECIFIED THAT ARE NOT DEFINITELY FIXED BY DIMENSIONS ARE APPROXIMATE. DETERMINE THE EXACT LOCATIONS NECESSARY TO SECURE THE BEST CONDITIONS AND REVISIONS BASED ON THE SITE CONDITIONS. REVIEW ALL REVISIONS WITH THE CONSULTANT.
 - READ FLOOR PLANS IN CONJUNCTION WITH SCHEMATICS. ASSUME INFORMATION SHOWN ON FLOOR PLANS TO BE APPLICABLE TO THE RELATED SYSTEM SCHEMATIC AND VICE-VERSA TO PROVIDE A COMPLETE AND OPERATIONAL SYSTEM.
 - REFER TO STANDARD DETAIL SHEETS AND STANDARD DETAILS FOR ADDITIONAL INFORMATION.
- DEMOLITION NOTES:**
- REMOVE EXISTING ACoustically LINED TRANSFER AIR DUCTS IN APPROXIMATE LOCATIONS SHOWN. CONTRACTOR TO ALLOW FOR AND ADDITION THREE (3) TRANSFER DUCT NOT SHOWN ON DRAWINGS. (TYPICAL).
 - REMOVE EXISTING DIFFUSERS AS INDICATED. REMOVE ALL EXISTING FLEXIBLE OR ROUND RIGID DUCTWORK WHERE DIFFUSERS ARE EITHER REMOVED OR RELOCATED. PROVIDE AND INSTALL NEW FLEXIBLE DUCTS TO RELOCATED DIFFUSERS. (TYPICAL).
 - DISCONNECT EXISTING DUCTWORK AND REMOVE COMPLETE WITH ALL ASSOCIATED HANGERS AND SUPPORTS. REMOVE DUCTWORK FROM SITE. SIZE OF EXISTING DUCTWORK SHALL BE AS INDICATED ON THE DRAWING. ENSURE EXISTING TO REMAIN DUCTWORK IS SECURED IN PLACE. PROVIDE NEW HANGERS AS REQUIRED. (TYPICAL).
 - CONTRACTOR TO MODIFY EXISTING DUCTWORK AND WALL GRILLES. EXISTING WALL GRILLES LOCATIONS ALIGN WITH CENTER LINE OF NEW GLAZING PANELS AND WALL SECTIONS. REFER TO DRAWING M-302 FOR APPROXIMATE LOCATIONS.
 - PRIOR TO CONSTRUCTION, AIR BALANCING CONTRACTOR SHALL RECORD AIR FLOW VALUES SUPPLIED BY ALL ASSOCIATED DIFFUSERS.
 - CAP (PATCH) EXISTING DUCT AND SEAL AIR TIGHT.
 - REMOVE EXISTING SUPPLY AIR TAKE OFF, DUCT AND GRILLE. PATCH AND SEAL DUCTWORK AS REQUIRED. REFER TO DRAWING M-302 FOR NEW DUCTWORK REQUIREMENTS.
 - EXISTING PERIMETER INDUCTION UNITS TO REMAIN. PROVIDE PROTECTION DURING CONSTRUCTION PRIOR TO CONSTRUCTION RECORD THE POSITION OF THE PRIMARY AIR DAMPER AND CLOSE ALL DAMPER IN AREA OF CONSTRUCTION. COVER UNIT COILS WITH FILTER MEDIA TO PROTECT FROM DUST AND DEBRIS AND RECOVER ALL UNITS WITH PLASTIC SHEETING. TIGHTLY FIT AND TAPE TO PROTECT AGAINST THE INTRUSION OF DUST.
 - EXISTING DUCTWORK AND GRILLES TO BE RELOCATED. REFER TO DRAWING M-302 FOR NEW GRILLE LOCATIONS. REUSE OR PROVIDE NEW DUCTWORK AS REQUIRED.

Robarts 5th Floor MDL Renovation

Title:
**5TH FLOOR
 H.V.A.C. DEMOLITION
 LAYOUT**

Project No. 08086.009.MEAVD | Scale 1:100

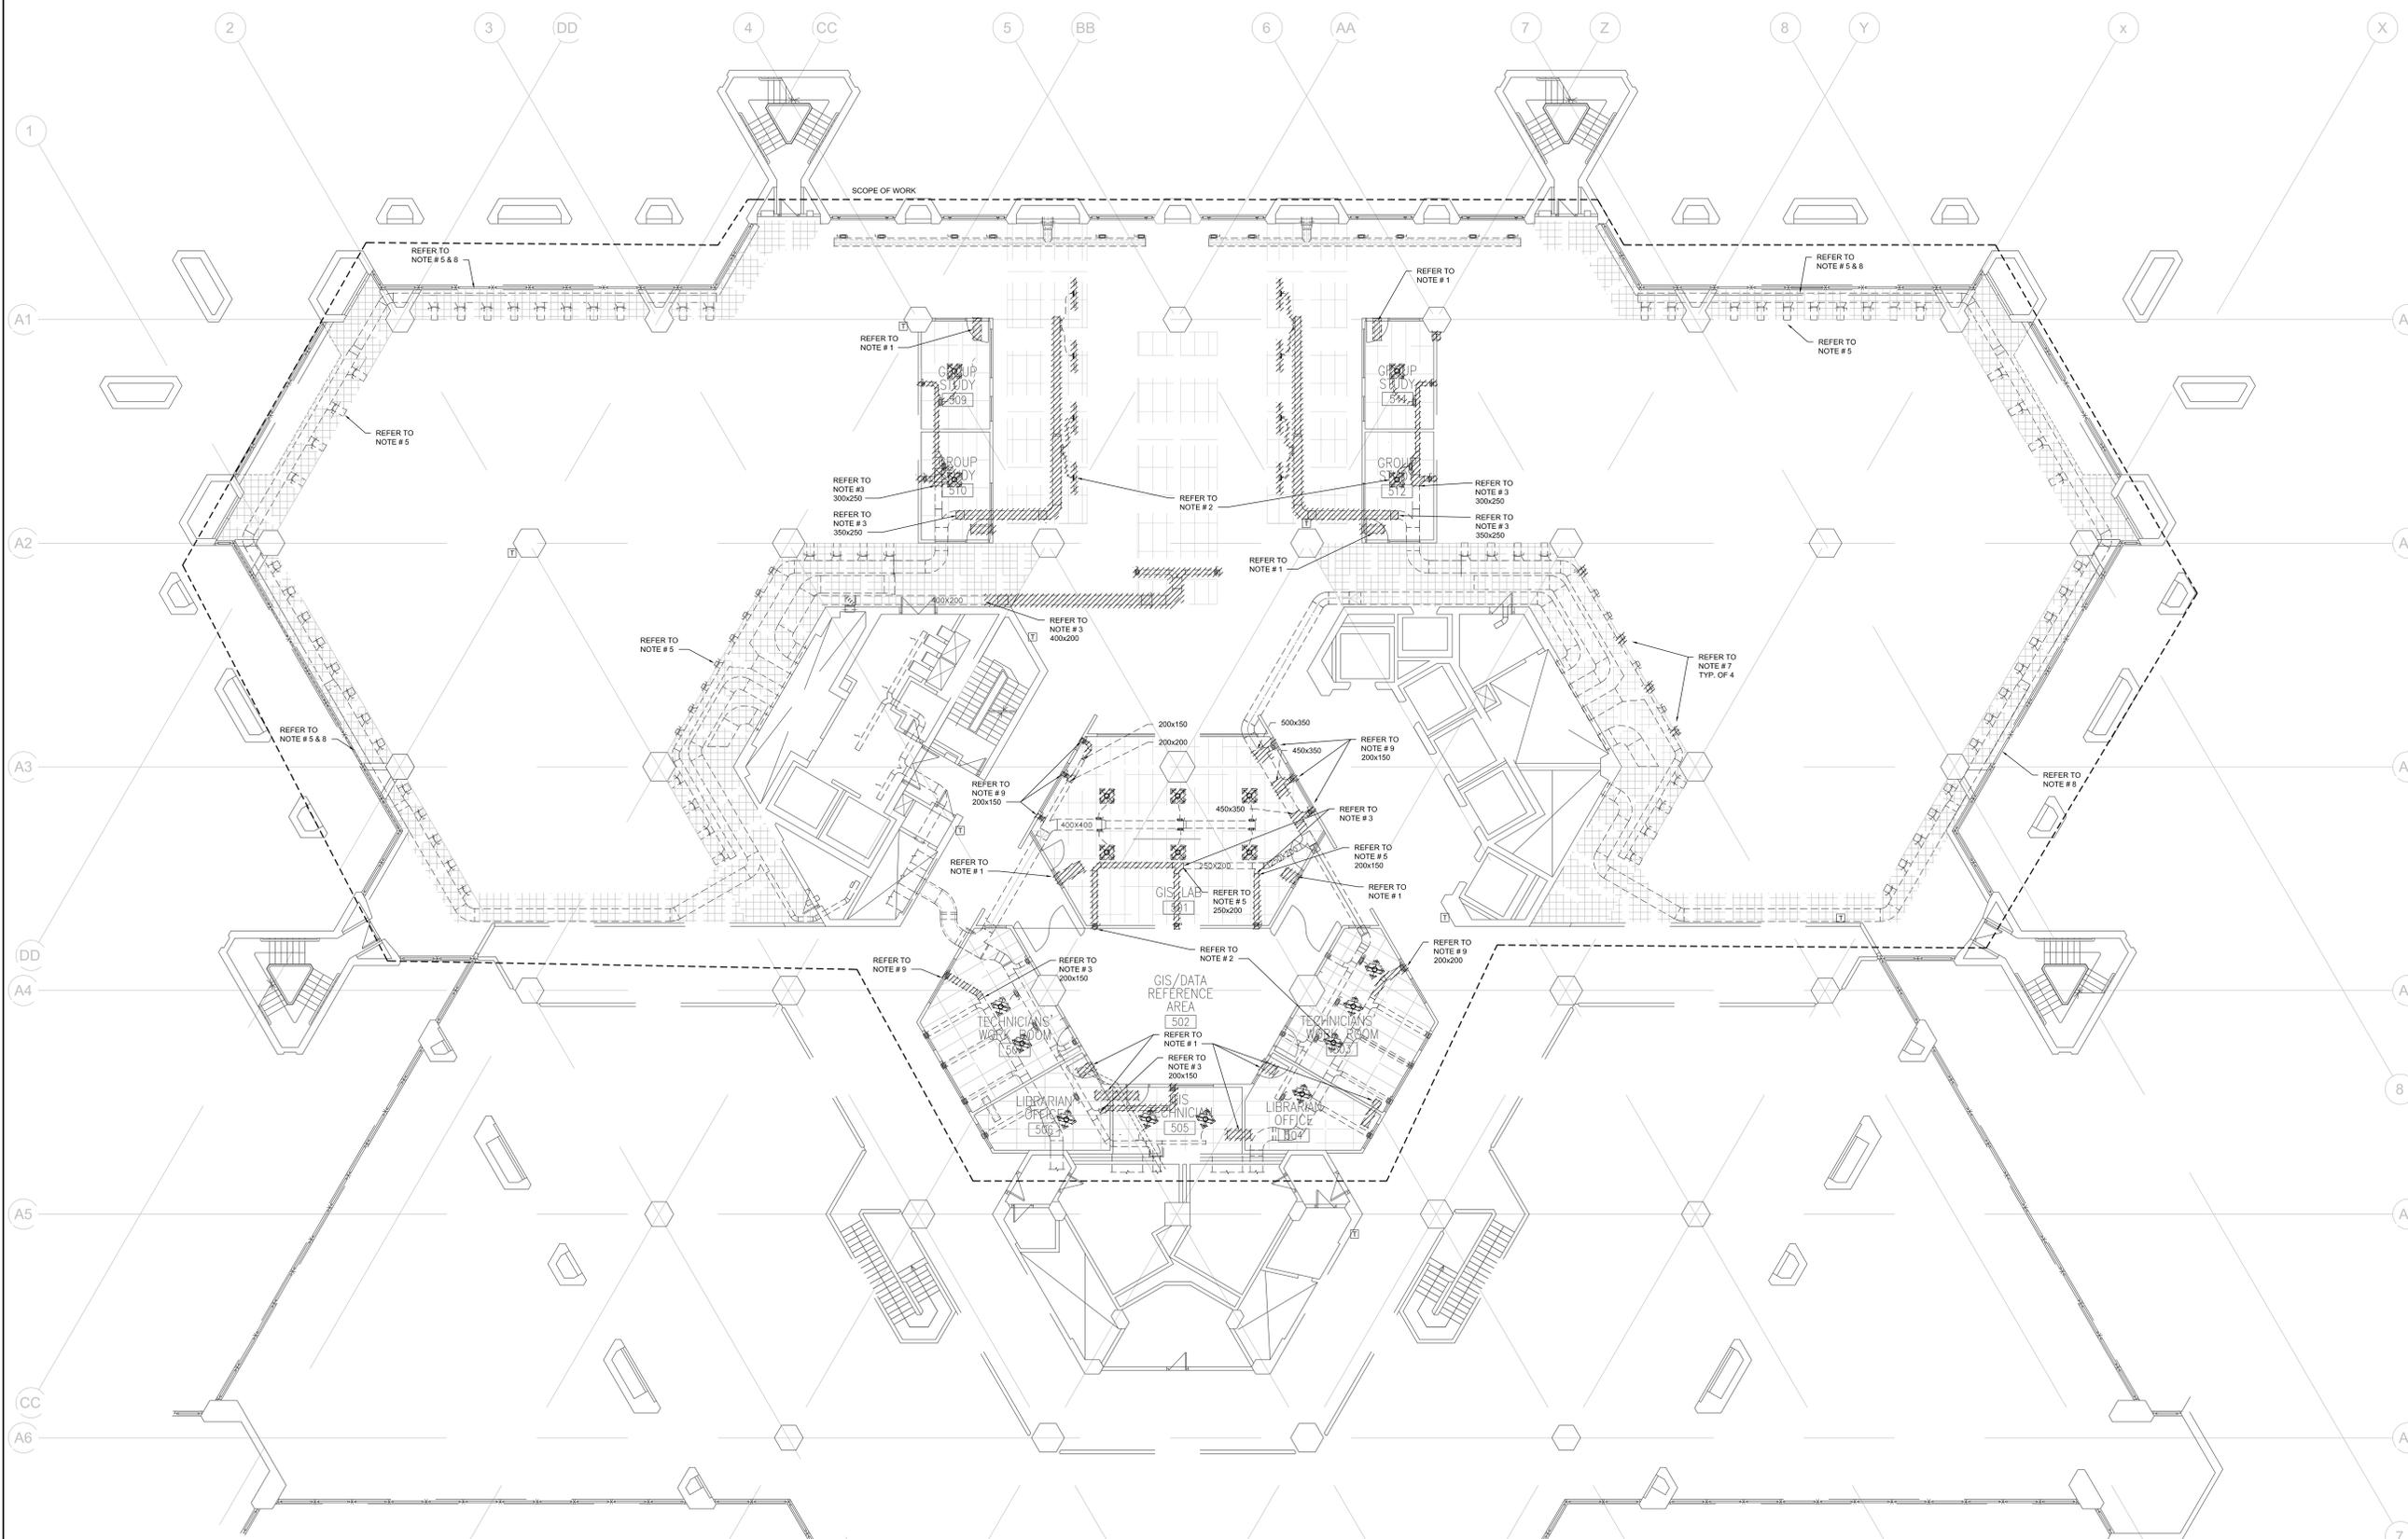Drawing No.
M-301



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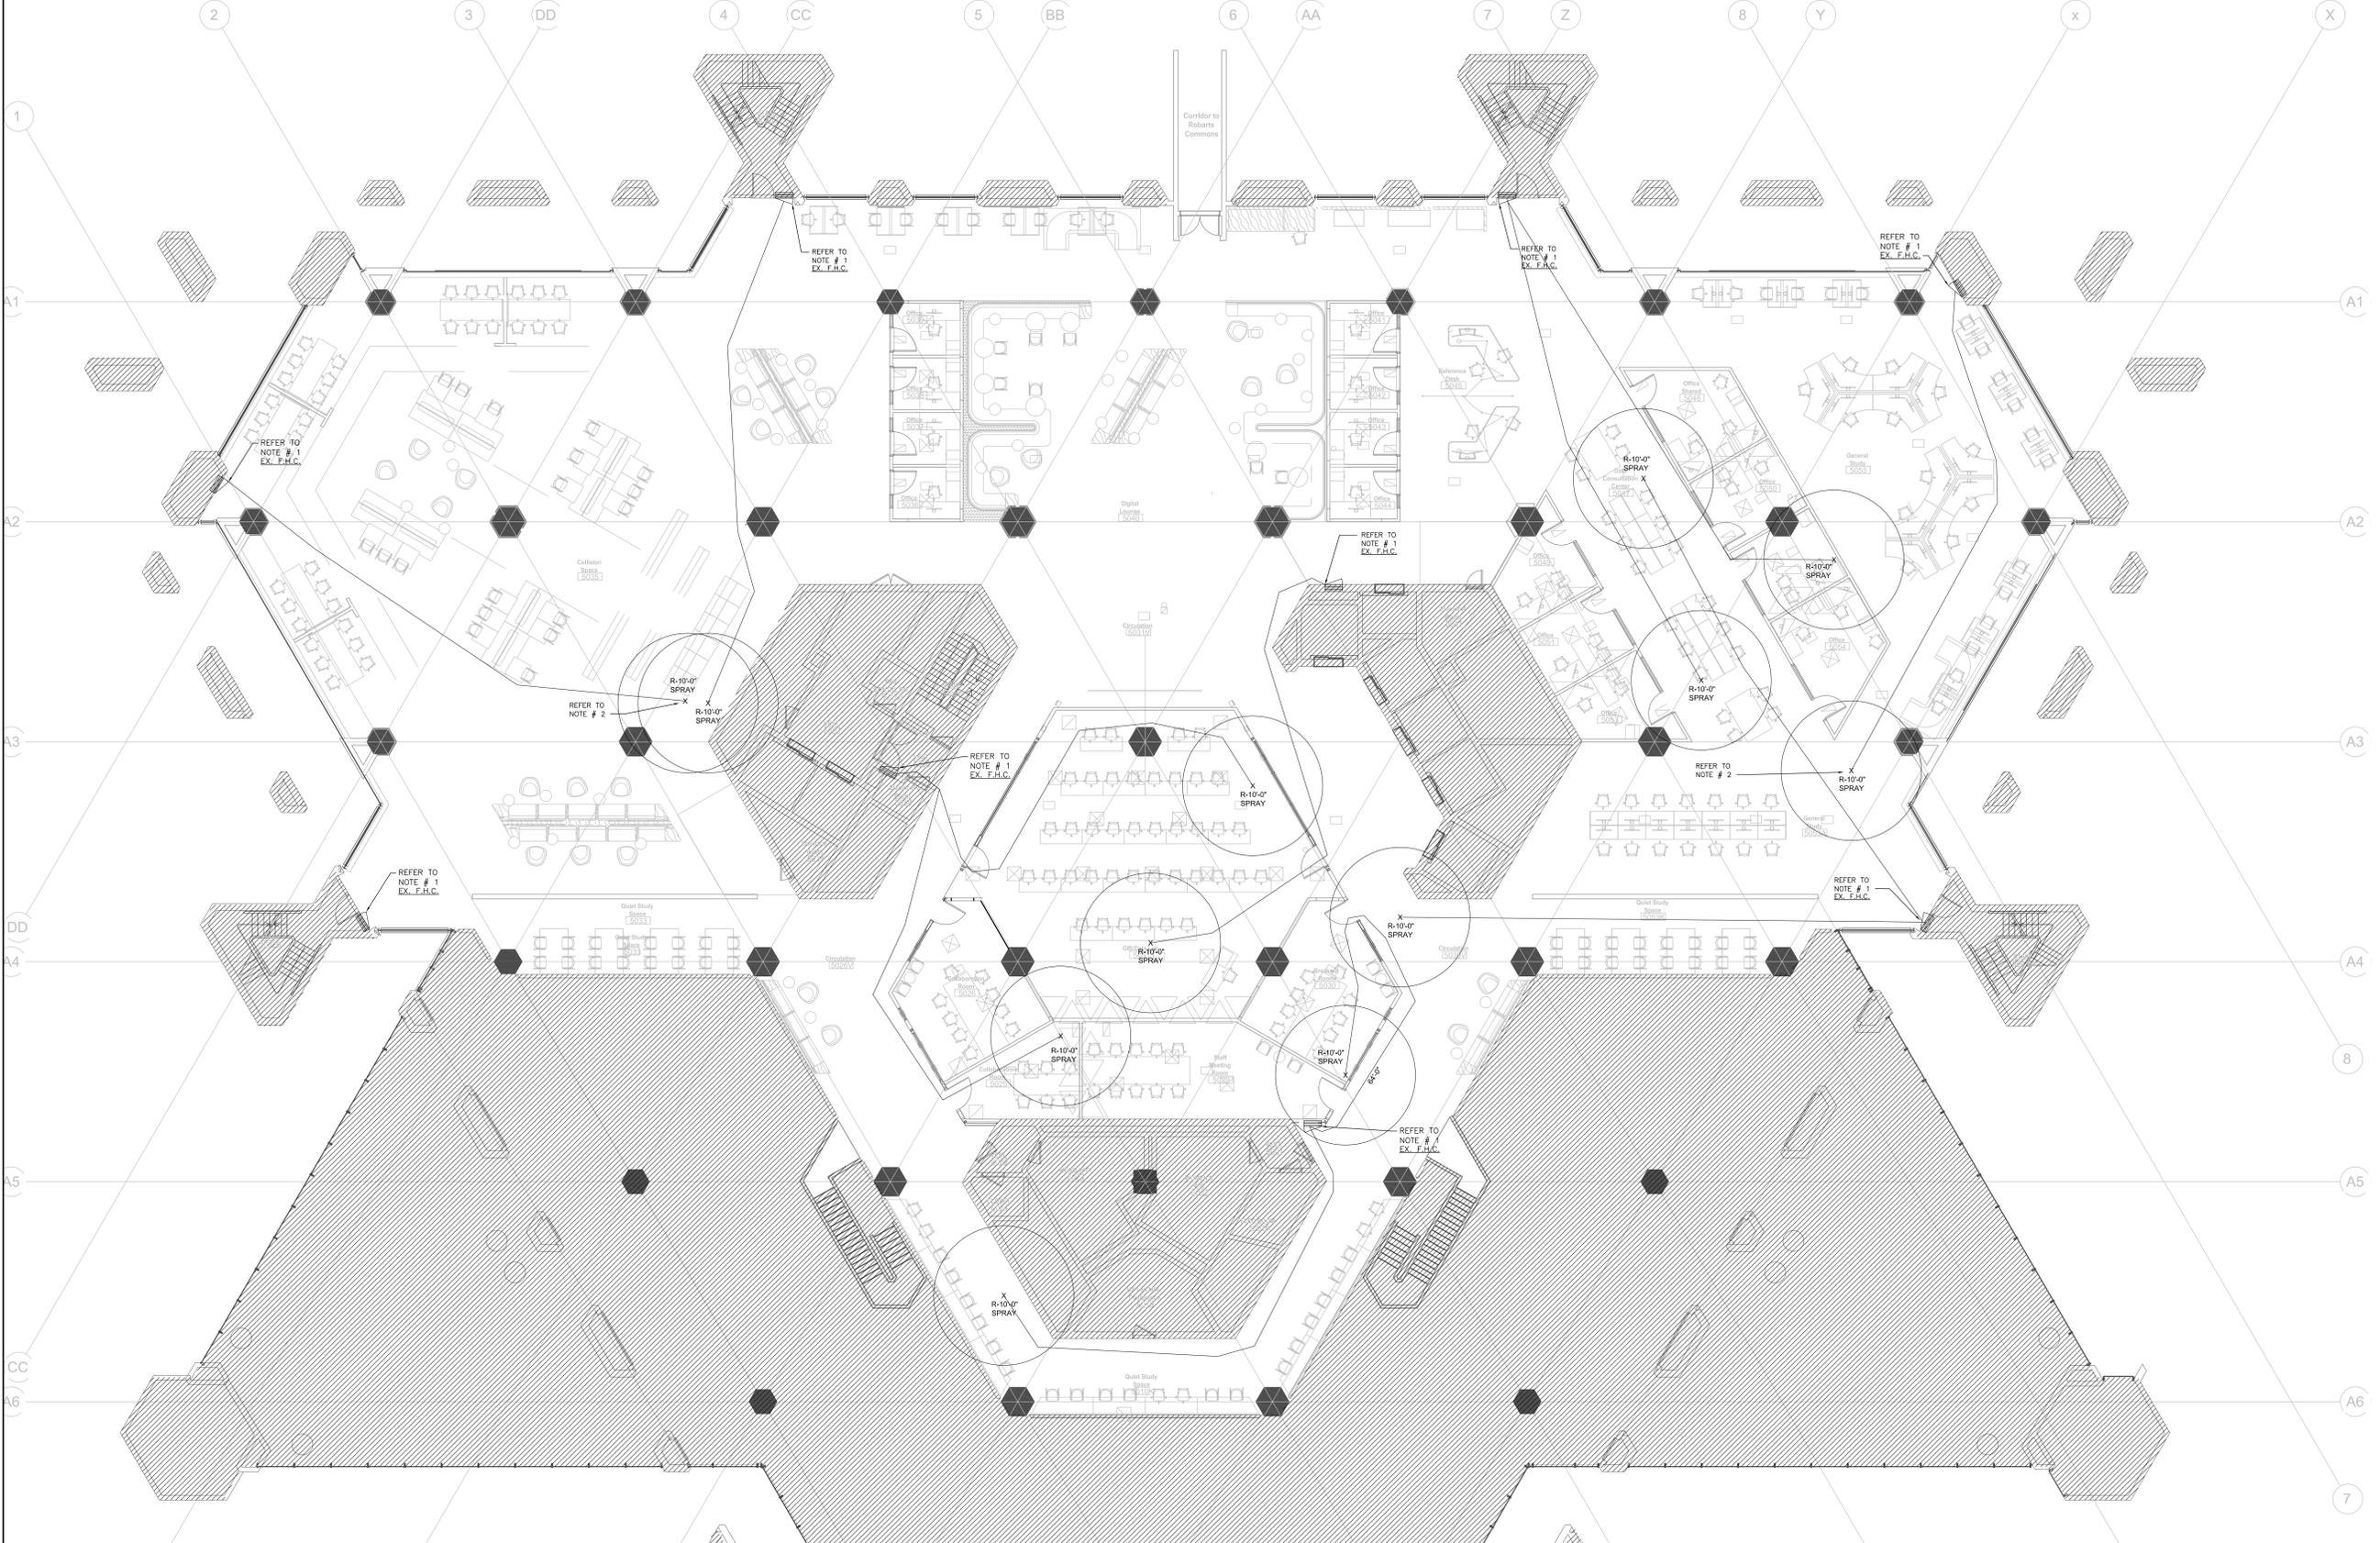
Title: **5TH FLOOR NEW H.V.A.C. LAYOUT**

Project No. 08086.000(MEAVD) Scale AS NOTED

Drawing No.

M-302

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 - REFER TO STANDARD DETAIL SHEETS AND STANDARD DETAILS FOR ADDITIONAL INFORMATION.
- DRAWING NOTES:**
- NEW BY-PASS VAV BOX COMPLETE WITH HANGERS, SUPPORTS, RIGID DUCT, FLEXIBLE DUCT, DIFFUSERS, CONDUITS, CONTROLS, TO PROVIDE A COMPLETE AND OPERATIONAL INSTALLATION. REFER TO DRAWING FOR INLET SIZE.
 - PROVIDE ACOUSTICALLY LINED TRANSFER AIR DUCT IN LOCATION SHOWN. DUCT TO MATCH GRILLE SIZE UNLESS NOTED OTHERWISE OR FREE AREA INDICATED. EXACT LOCATION, QUANTITY AND SIZE TO SUIT CEILING SPACE AND SITE CONDITIONS. REFER TO STANDARD DETAILS/M-000. (TYPICAL)
 - PROVIDE 600X300X400 HIGH ACOUSTICALLY LINED TRANSFER AIR PLENUM OVER +/- 600X300 (LENGTH OF GRILLE TO SUITE AVAILABLE SPACE BETWEEN T-BARS) RETURN AIR GRILLE AT CEILING AND PROVIDE 600X150 ACOUSTICALLY DUCT TO WALL GRILLE AS INDICATED. (TYPICAL)
 - CONNECT NEW DUCT TO EXISTING DUCT OF EQUAL SIZE AND EXTEND AS INDICATED. REFER TO DRAWING EXISTING NEW DUCT SIZES. (TYPICAL)
 - CONNECT NEW SUPPLY AIR DUCT AND TRANSFER/RETURN AIR DUCT TO COMMON GRILLE AS INDICATED. DUCT SIZES SHALL BE AS NOTED. AIR QUANTITY NOTED TO BE TOTAL FOR ACTIVE SECTION OF GRILLE ONLY AND SHALL NOT BE MEASURED ACROSS ENTIRE FACE OF GRILLE. (TYPICAL)
 - COORDINATE WALL GRILLES SIZES AND LOCATIONS WITH ARCHITECTURAL DRAWINGS. UNCOORDINATED INSTALLATIONS WILL NEED TO BE ALTERED TO SUITE ARCHITECTURAL. AT NO ADDITIONAL COST. ALL GRILLES TO BE WHITE FINISH UNLESS NOTED OTHERWISE. PROVIDE MATT BLACK BLANK OFF PLATES OF DIFFUSER FOR NON-ACTIVE SECTIONS OF GRILLES.
 - CONNECT NEW 200x BY-PASS VAV BOX INLET DUCT TO EXISTING SUPPLY AIR DUCT IN CEILING
 - CONNECT NEW 400X150 SUPPLY AIR DUCT TO EXISTING SUPPLY AIR DUCT IN CEILING AND EXTEND TO NEW WALL GRILLE.
 - PROVIDE ALL DUCTWORK DOWNSTREAM OF TERMINAL EQUIPMENT (I.E. FAN COILS, HEAT PUMPS, V.A.V. BOXES AND FAN POWERED BOXES) EQUAL TO THE EQUIPMENT OUTLET SIZE (MINIMUM) OR LARGER AS INDICATED WHERE OUTLET SIZES ARE 600 SIZES. INCREASE THE DUCT SIZE UP TO THE NEAREST EVEN SIZE (I.E. PROVIDE 350X350 FOR 318X318 OR 330X330 OUTLET). PROVIDE TRANSITION DUCTS AS REQUIRED.
 - PROVIDE DIFFUSER DUCT RUN-OUT THE SAME SIZE AS THE DIFFUSER INLET UNLESS INDICATED OTHERWISE.
 - PROVIDE 600X300 RETURN AIR GRILLES UNLESS NOTED OTHERWISE.
 - REMOVE AND RELOCATE EXISTING DIFFUSERS AS INDICATED. REMOVE ALL EXISTING FLEXIBLE DUCTWORK WHERE DIFFUSERS ARE EITHER REMOVED OR RELOCATED. PROVIDE AND INSTALL NEW FLEXIBLE DUCTS TO RELOCATED DIFFUSERS.
 - TEMPERATURE SENSORS ARE LOCATED TO AID IN ZONING ONLY AND ALL REQUIRED SENSORS MAY NOT BE SHOWN (REFER TO SPECIFICATIONS). COORDINATE FINAL LOCATION WITH THE INTERIOR DESIGNER WITHIN 1000mm OF LOCATION SHOWN. ALL RELOCATIONS OUTSIDE OF THIS RANGE SHALL BE REVIEWED WITH THE CONSULTANT.
 - INSTALL TEMPERATURE SENSORS AT NOMINALLY 1200mm A.F.F. ABOVE THE FINISHED FLOOR UNLESS INDICATED OTHERWISE.
 - BALANCE THE AIR FLOW RATES EQUALLY BETWEEN ALL INTERIOR DIFFUSERS BASED ON THE MAXIMUM AIR FLOW RATE SHOWN FOR THE ASSOCIATED BY-PASS VAV BOX. (TYPICAL)
 - CLEAN PERIMETER INDUCTION UNITS AT THE COMPLETION OF CONSTRUCTION. CLEANING INCLUDES, BUT IS NOT LIMITED TO, THE FOLLOWING:
 - REMOVE THE COVERS.
 - VACUUM AND WIRE CLEAN ASSOCIATED COILS AND LINT SCREENS AS REQUIRED.
 - CLEAN SUPPLY AIR NOZZLES WITH HIGH PRESSURE AIR AND STEAM.
 - SET PRIMARY AIR VALVE BACK TO ORIGINAL LOCATION AND VERIFY AIR BALANCE.
 - WASH INDUCTION UNIT COVERS AND INSTALL IN ORIGINAL LOCATION.
 - INSPECT AND VERIFY THE OPERATION OF CONTROL VALVES AND THERMOSTAT/TEMPERATURE SENSORS FOR PERIMETER INDUCTION UNITS. PROVIDE A WRITTEN REPORT IDENTIFYING ALL INOPERATIONAL OR DAMAGED CONTROL DEVICES AND PROVIDE AN ITEMIZED COST ASSOCIATED WITH REPAIR OR REPLACEMENT AS REQUIRED.
 - REFER TO DRAWING FOR ASSOCIATED AHU'S (AIR HANDLING UNITS) SERVING THE 5TH FLOOR:
 - AHU-2 PERIMETER INDUCTION UNITS
 - AHU-3 INTERIOR SOUTH CORE OPEN AREA BALCONY
 - AHU-5 INTERIOR CENTER GIS/DATA LAB
 - AHU-6 INTERIOR/PERIMETER ALONG LINK TO ROBERT'S COMMONS
 - AHU-7 INTERIOR, MAJORITY OF OPEN AREAS, NEW OFFICES AND COLLAB'S 507 AND 509
 - MODIFY EXISTING 200x200 DUCTWORK AS REQUIRED TO CENTER 200x200 DIFFUSERS IN DRYWALL BULKHEAD ABOVE GLAZING PANELS.
 - MODIFY EXISTING 200x150 DUCTWORK AS REQUIRED TO CENTER 200x150 DIFFUSERS IN DRYWALL BULKHEAD ABOVE GLAZING PANELS AS SHOWN.
 - MODIFY EXISTING 500x350 DUCTWORK AS REQUIRED TO CENTER 200x150 DIFFUSERS IN DRYWALL BULKHEAD ABOVE GLAZING PANELS AS SHOWN.



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8.	24.09.27	ISSUED FOR TENDER
7.	24.08.16	ISSUED FOR PERMIT
6.	24.08.02	ISSUED FOR 100% CD COSTING
5.	24.04.29	ISSUED FOR 80% CD COSTING
4.	23.12.08	ISSUED FOR DD REVIEW
3.	23.11.17	ISSUED FOR DD COSTING
2.	23.10.24	ISSUED FOR 100% DD
1.	23.08.30	ISSUED FOR DRAFT SD REVIEW
No.	Date	Issue/Revision

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THIS DRAWING SHALL BE READ IN CONJUNCTION WITH MECHANICAL SPECIFICATION SUBMITTED FOR THIS PROJECT.	

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No. Date Issue/Revision



Robarts 5th Floor MDL Renovation

Title:
5TH FLOOR FIRE HOSE CABINET COVERAGE

Project No. 08086.000 MEAVD | Scale 1:100

Drawing No.

M-302

- GENERAL NOTES:**
- DO NOT SCALE DRAWINGS. THE LOCATIONS OF ALL ITEMS SHOWN ON THE DRAWINGS OR SPECIFIED THAT ARE NOT DEFINITELY FIXED BY DIMENSIONS ARE APPROXIMATE. DETERMINE THE EXACT LOCATIONS NECESSARY TO SECURE THE BEST CONDITIONS AND RESULTS BASED ON THE SITE CONDITIONS. REVIEW ALL REVISIONS WITH THE CONSULTANT.
 - READ FLOOR PLANS IN CONJUNCTION WITH SCHEMATICS. ASSUME INFORMATION SHOWN ON FLOOR PLANS TO BE APPLICABLE TO THE RELATED SYSTEM SCHEMATIC AND VICE-VERSA TO PROVIDE A COMPLETE AND OPERATIONAL SYSTEM.
- DRAWING NOTES:**
1. EXISTING FIRE HOSE CABINET (F.H.C.) COMPLETE WITH 25'-0" (23M) HOSE TO REMAIN (TYPICAL)
 2. R-10'-0" - DENOTES THE ALLOWABLE 10'-0" (3M) SPRAY AT THE END OF THE FIRE HOSE. (TYPICAL)