




PARTITION ASSEMBLY TYPES

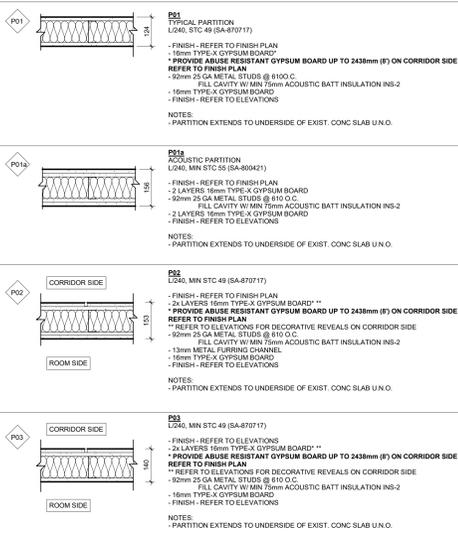


FURRING ASSEMBLY TYPES

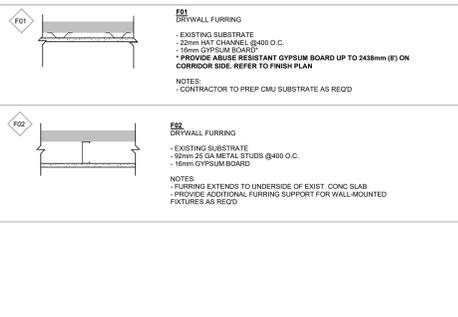

REFURBISHED PARTITION AND FURRING ASSEMBLY TYPES

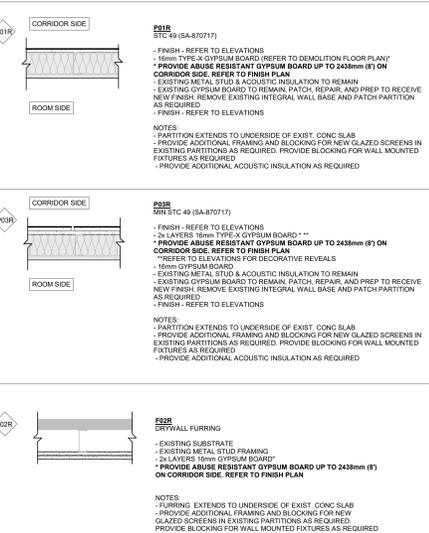

CEILING ASSEMBLY TYPES

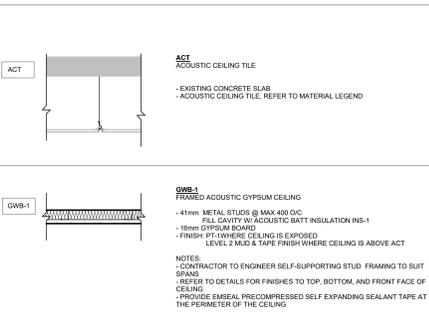


GENERAL NOTES

- 1) THE SIZE, SPACING, AND HEIGHT OF STEEL STUDS FOR NON-LOADBEARING INTERIOR WALLS SHALL CONFORM TO MANUFACTURER'S SPAN TABLES.
2) REFER TO ASSEMBLIES FOR SPECIFIC GAUGE AND SPACING REQUIREMENTS FOR PARTITIONS. IF DISCREPANCY OCCURS BETWEEN ASSEMBLIES, AND MANUFACTURER'S SPAN TABLES, USE THE MORE STRINGENT OF THE TWO.
3) ALL PARTITIONS ARE TO EXTEND FROM TOP OF SLAB TO THE US OF STRUCTURAL SLAB ABOVE U.F.O.
4) PROVIDE CONTINUOUS ACOUSTIC SEALANT AT HEAD, SILL, AND ALL PENETRATIONS OF ALL PARTITIONS AND FURRING ASSEMBLIES.
5) PROVIDE LEVEL 1 FINISH FOR ALL EXPOSED GWS SURFACES. PROVIDE LEVEL 2 FINISH FOR ALL NON-EXPOSED GWS SURFACES.
6) PROVIDE 19mm PLYWOOD BLOCKING AT ALL WALL-MOUNTED FINISHINGS, MILLWORK, ACCESSORIES, EQUIPMENT, ETC. OR AS INDICATED ON PLANS AND/OR INTERIOR ELEVATIONS.
7) PROVIDE ENGINEERED BLOCKING FOR AV SCREEN MOUNTING AS INDICATED ON ELEVATIONS. REFER TO FURNITURE PLANS, MILLWORK DRAWINGS, AND AV DRAWINGS.

Material Legend table with columns: Division, Tag, Product Type, Specification. Lists materials for various divisions including 05 (Steel Fabrications), 06 (Laminates), 07 (Acoustic), 08 (Screens), 09 (Resilient), 10 (Wood).

DOOR SCHEDULE table with columns: DOOR NO., From Room Name, To Room Name, LEAF WIDTH, LEAF HEIGHT, LEAF TYPE, LEAF FINISH, LEAF MATERIAL, LEAF FINISH, GLASS TYPE, SCREEN TYPE, GLASS TYPE, FRAME MATERIAL, FRAME FINISH, FPO, HARDWARE, STC GROUP. Lists door specifications for various rooms like Circulation, Staff Meeting Room, etc.

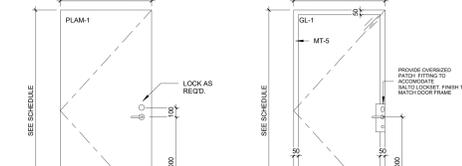

HARDWARE GROUPS

- GROUP A: OFFICE FUNCTION MORTISE LOCKSET...
GROUP B: CLASSROOM FUNCTION MORTISE LOCKSET...
GROUP C: CLASSROOM FUNCTION MORTISE LOCKSET...
GROUP D: CLASSROOM FUNCTION MORTISE LOCKSET...

ABBREVIATED LEGEND

- AL ALUMINUM
HM HOLLOW METAL
SCWD SOLID CORE WOOD DOOR
HW WOOD
PT PAINT
WH WHITE
BK BLACK

STC GROUPS












- GROUP A: SOLID CORE WOOD DOOR W/ 1MM 2000MM W/ 1MM FRAMES FILLED W/ INSULATION AND AUTOMATIC DOOR BOTTOM
GROUP B: SINGLE GLAZED SWING DOOR W/ AUTOMATIC DOOR BOTTOM

GLAZING TYPE SCHEDULE

- GL-1: Single Glazed
GL-2: Double Glazed
GL-3: Reserved

INTERIOR SCREEN NOTES

- 1) ALL ALUMINUM INTERIOR SCREEN FRAMES AND ASSOCIATED DOORS ARE TO BE SUPPLIED BY DEMOUNTABLE PARTITION MANUFACTURER.
2) PROVIDE CONT. ACOUSTIC SEALANT AT ALUMINUM FRAME ON ALL SIDES.
3) CUT FRAMES TO FIT IN GLAZING ON SITE. PROVIDE FULL HEIGHT BY 1" WIDE SAMPLES FOR ARCHES REVIEW ON SITE.
4) PROVIDE 19mm GAUGE METAL ENGINEERED HEADER SUPPORT FOR ALL SCREENS UNDER 3.2m WIDE HORIZONTAL SPAN.
5) PROVIDE ENGINEERED STEEL SUPPORTS FOR ALL GLAZED SCREENS WITH A HORIZONTAL SPAN OVER 3.2m TYPICAL. REFER TO 6/A GDG, TYPICAL JAMB AND HEADER DETAILS.

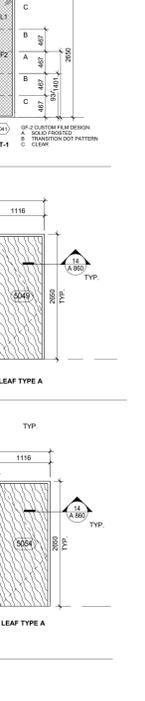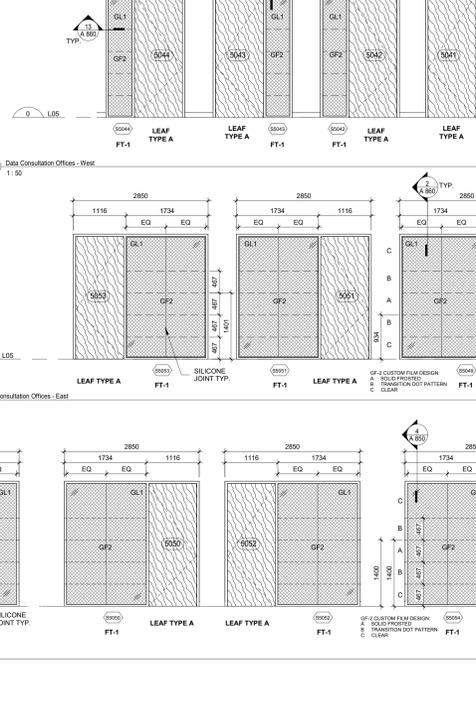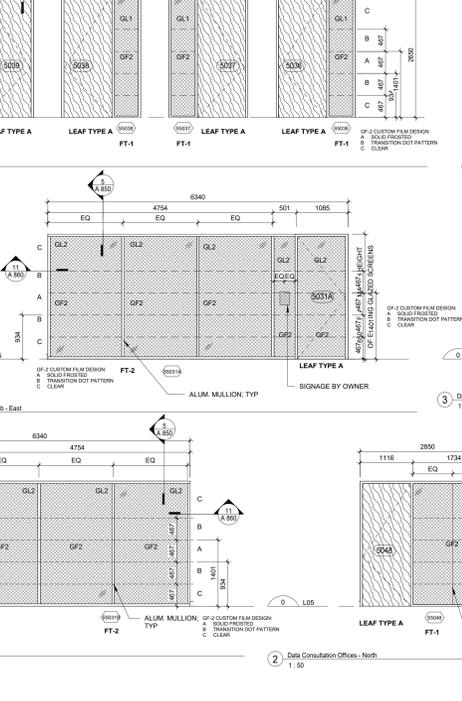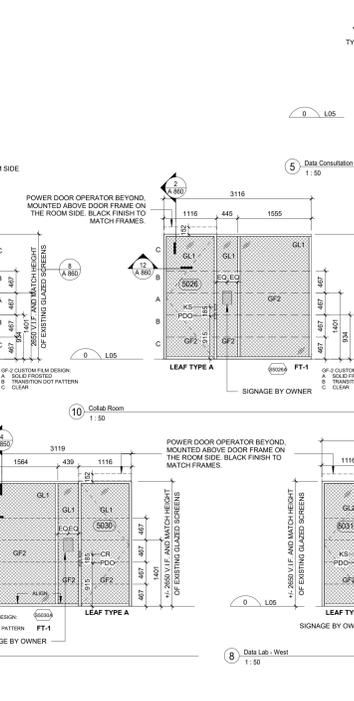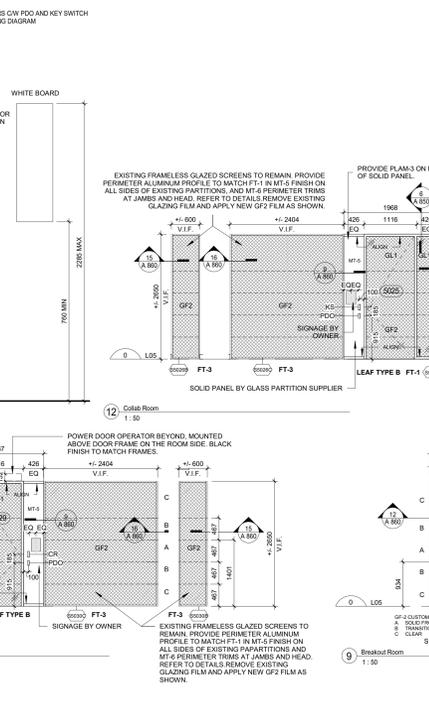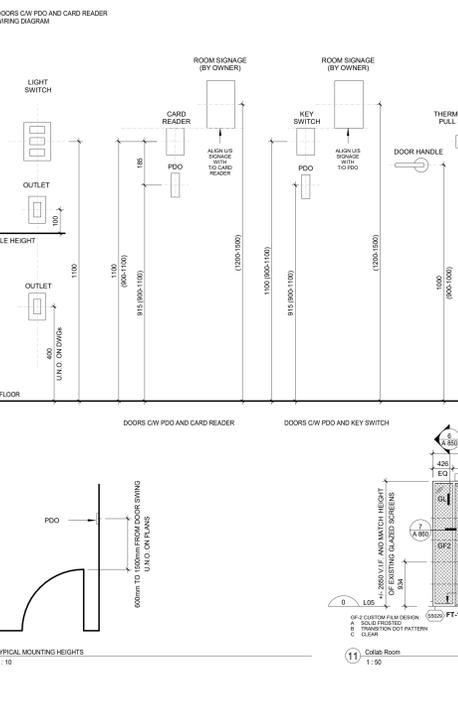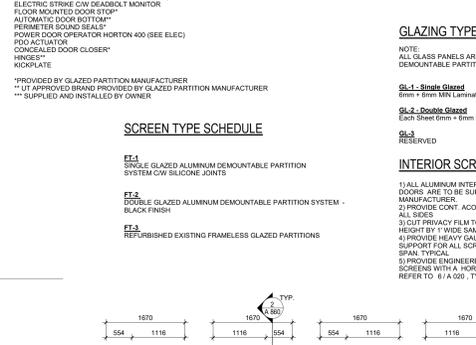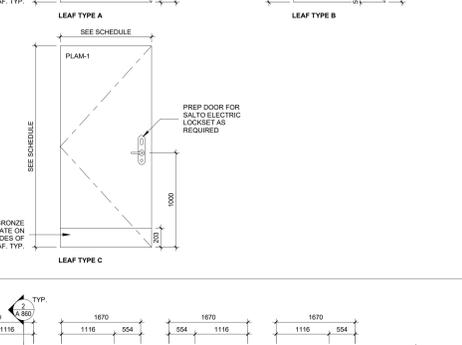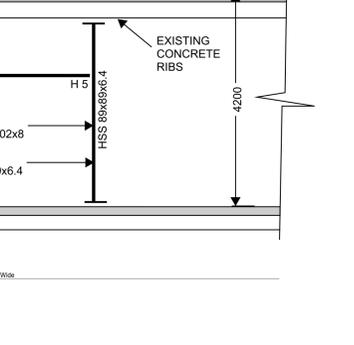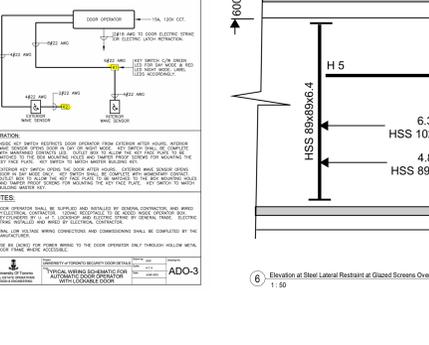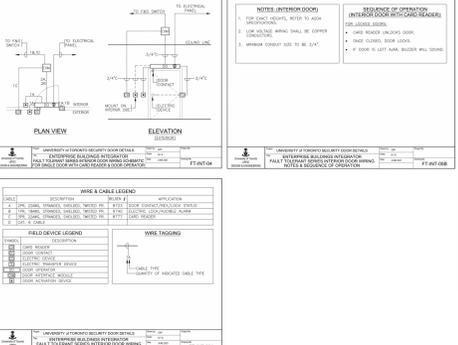


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NOTES:
 T1 - TABLE MOUNTED LAMP (SEE ELEC)
 TOTAL COUNT = 56

POWER PLAN LEGEND:

- 1 FURNITURE/MILLWORK MOUNTED POWER RECEPTACLE REFER TO ELEC.
NOTE: ALL RECEPTACLES TO BE COORDINATED WITH EXISTING RACEWAY SYSTEM & MILLWORK.
 - 2 ELECTRICAL BOX W/ AV/POWER COMBO RECEPTACLE FOR PLUG POWER. REFER TO ELEC.
NOTE: ALL RECEPTACLES TO BE COORDINATED WITH EXISTING RACEWAY SYSTEM & MILLWORK.
 - 3 RECESSED FLOOR BOX FOR HARDWARE POWER CONNECTION & DATA CABLING. REFER TO ELEC.
NOTE: ALL RECEPTACLES TO BE COORDINATED WITH EXISTING RACEWAY SYSTEM & MILLWORK.
 - 4 EXISTING RECESSED FLOOR BOX FOR HARDWARE POWER CONNECTION & DATA CABLING. REFER TO ELEC.
NOTE: ALL RECEPTACLES TO BE COORDINATED WITH EXISTING RACEWAY SYSTEM & MILLWORK.
 - 5 CONDUIT STUBS FOR HARDWARE POWER CONNECTIONS.
NOTE: ALL TO BE COORDINATED WITH EXISTING RACEWAY SYSTEM & MILLWORK.
 - 6 WALL MOUNTED RECEPTACLE. REFER TO ELECTRICAL FOR RECEPTACLE TYPE.
 - 7 EXISTING WALL MOUNTED RECEPTACLE. REFER TO ELECTRICAL.
 - 8 WALL MOUNTED VOICEDATA RECEPTACLE. REFER TO ELECTRICAL.
 - 9 EXISTING WALL MOUNTED VOICEDATA RECEPTACLE. REFER TO ELECTRICAL.
 - 10 LIGHT SWITCH. SEE ELECTRICAL.
 - 11 POWER DOOR OPERATOR ACTUATOR. SEE HARDWARE SCHEDULE & ELECTRICAL.
- NOTE:**
 * DENOTES RECEPTACLE/ELECTRICAL BOXES PROVIDED AS PART OF FURNITURE PACKAGE. CONNECT FURNITURE RECEPTACLES AS REQUIRED. SEE ELEC.
- APPROXIMATE LOCATION OF EXISTING IN-SLAB RACEWAY SYSTEM. SEE ELEC.
 - APPROX EXTENT OF TRENCHING WORK REQUIRED FOR POWER. REFER TO ELECTRICAL.
 - APPROX EXTENT OF ELEC AND/OR AV WIRING INSTALLED WITHIN EXISTING PERIMETER GRILLES. SEE ELEC.
 - APPROX EXTENT OF CEILING MOUNTED WIRING. SEE ELEC.
 - APPROX EXTENT OF SURFACE RACEWAY. SEE ELEC.

POWER PLAN GENERAL NOTES

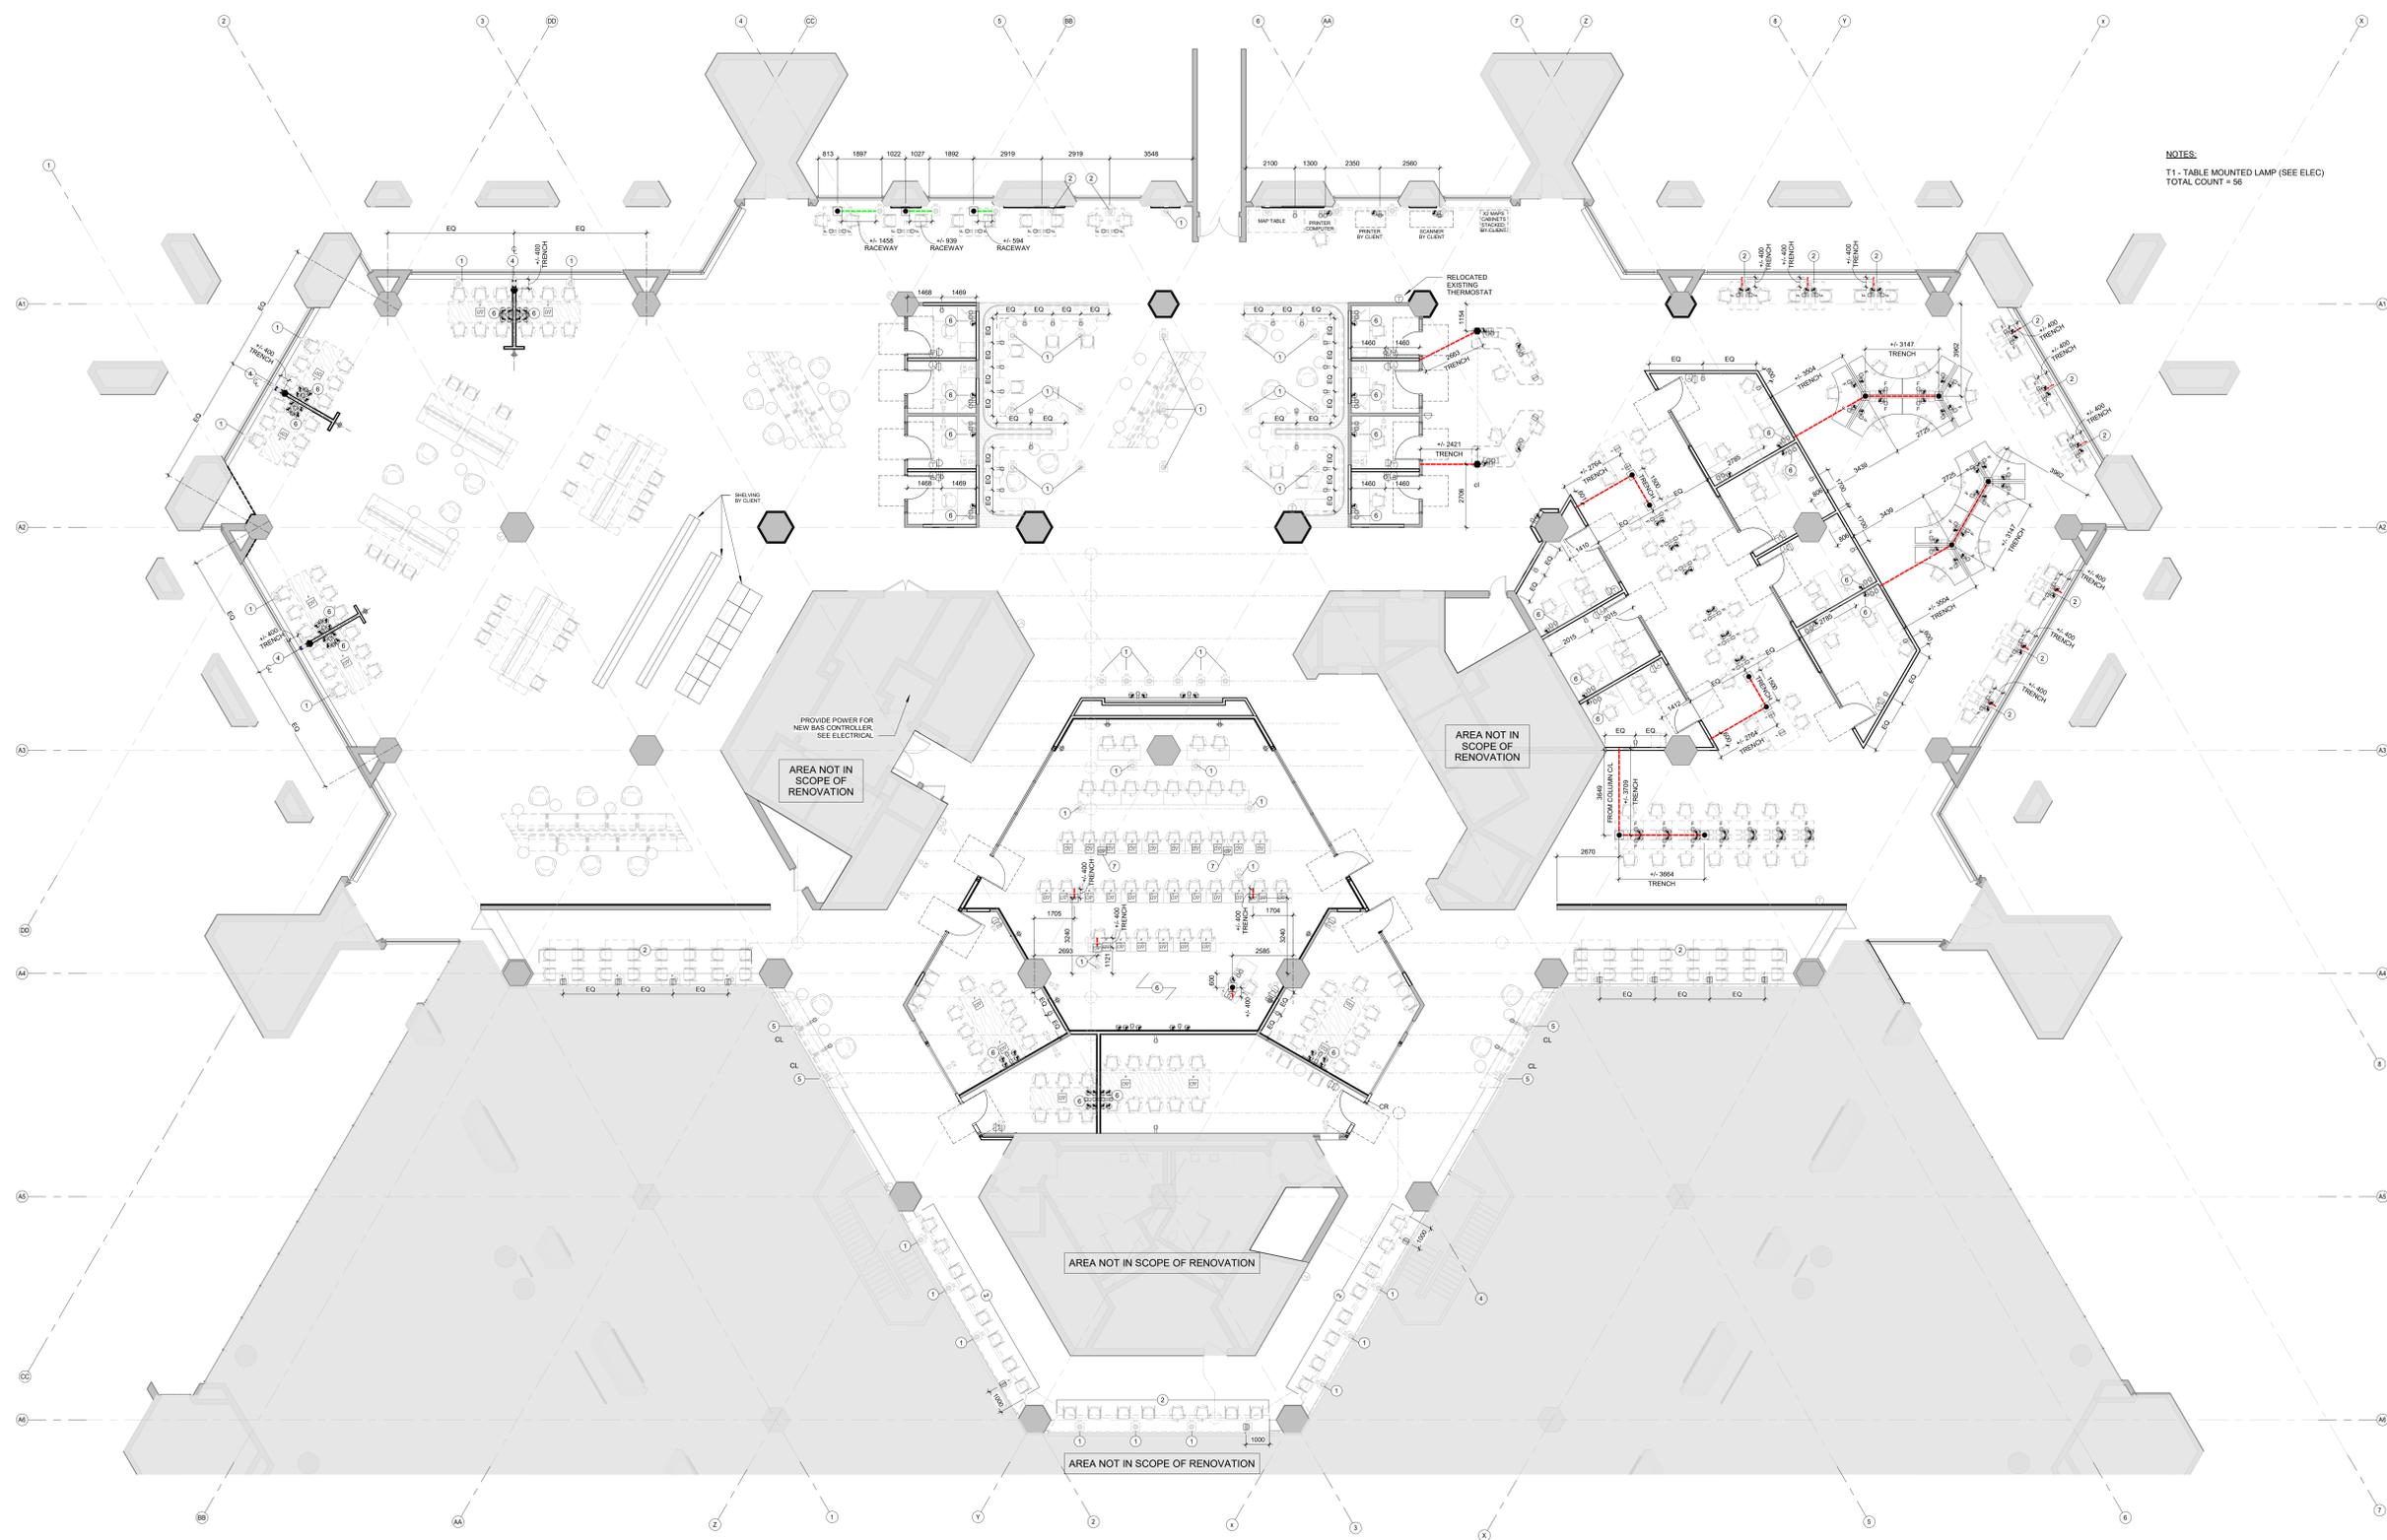- 1) ALL POWER AND DATA REQUIREMENTS ARE TO BE COORDINATED WITH ELECTRICAL AND AV CONSULTANTS.
- 2) GO TO REVIEW EXACT LOCATION OF FLOOR BOXES AND RACEWAY OUTLETS WITH CONSULTANT TEAM PRIOR TO TRENCHING CONCRETE OR CUTTING WIREMESH.
- 3) REFER TO ENLARGED PLANS AND INTERIOR ELEVATIONS FOR SWITCHES, PDD, AND THERMOSTAT LOCATING DIMENSIONS.

POWER PLAN NOTES

- 1 DEMOLISH EXISTING DECOMMISSIONED ELECTRICAL FLOOR BOXES. ALL ASSOCIATED WIRING AND EXPOSED CONDUIT. FULL FLOOR BOX OPENING WITH SELF-LEVELLING CEMENTITIOUS UNDERLAYMENT. REFER TO TYPICAL DETAIL.
- 2 HARDWARE NEW FURNITURE INTO EXISTING ELECTRICAL FLOOR BOXES.
- 3 HARDWARE MILLWORK INTO EXISTING ELECTRICAL FLOOR BOXES. MODIFY FLOOR BOXES AS REQUIRED TO RECEIVE AV/DA CONNECTIONS FROM ADJACENT PERIMETER FLOOR GRILLES. ALLOW FOR TRENCHING TO CONNECT FLOOR BOXES TO ADJACENT PERIMETER GRILLES AS REQUIRED.
- 4 DEMOLISH EXISTING FLOOR BOXES. RE-USE EXISTING POWER CONDUIT RUNNING THROUGH PERIMETER FLOOR GRILLES. PROVIDE TRENCHING FROM PERIMETER FLOOR GRILLES AS REQUIRED FOR NEW COMMUNICATIONS CONDUIT. PROVIDE POWER AND COMMUNICATIONS STUB UPS TERMINATING THESE MILLWORK AS REQUIRED. SEE ELECTRICAL & AV.
- 5 MODIFY EXISTING FLOOR BOXES FOR HARDWIRED POWER AS REQUIRED TO EXTEND OUTLETS TO THE FACE OF MILLWORK. SEE ELECTRICAL.
- 6 SEE INTERIOR ELEVATIONS FOR WALL POWER & COMMUNICATIONS RECEPTACLE LOCATING DIMENSIONS. REFER TO ELECTRICAL, AV, AND TYPICAL MOUNTING HEIGHTS.
- 7 REPLACE EXISTING FLOOR BOX FOR HARDWIRED POWER WITH ELECTRICAL FLOOR BOX FOR PLUG IN POWER. PROVIDE ADDITIONAL TRENCHING AS REQUIRED. REFER TO 2-1A-104 AND SEE ELEC.

No.	Date	Issue/Revision
7	20241021	ISSUED FOR ADDENDUM A-02
6	20240927	ISSUED FOR TENDER
5	20240816	ISSUED FOR BUILDING PERMIT
4	20240806	ISSUED FOR 100% CD
3	20240429	ISSUED FOR 80% CD COSTING
2	20231213	ISSUED FOR DD CLIENT REVIEW
1	20231128	ISSUED FOR DD COSTING & REVIEW




Robarts 5th Floor Renovation


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Project No. 2322 Scale As Indicated Drawing No.

A 104

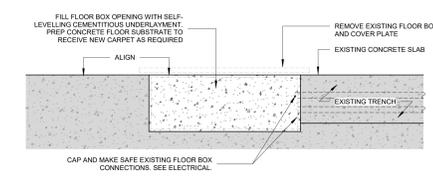


3 Plan Detail - Typical Decommissioned Electrical Floor Box 1:10

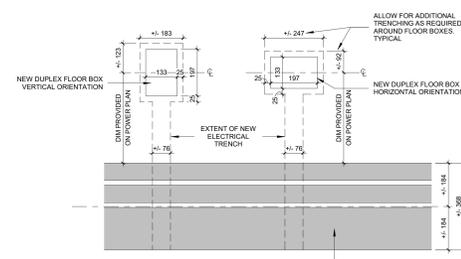


2 Plan Detail - Typical Electrical Trench 1:10

1 L05 Power Plan 1:100


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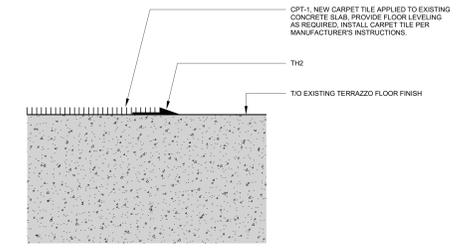
12 Section Detail - Duct Penetration 1:5

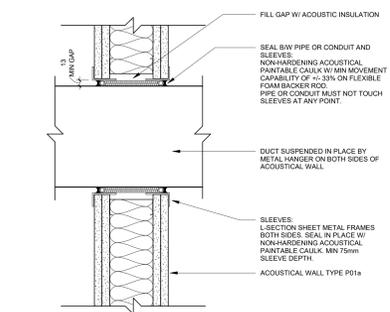


11 Section Detail - Pipe Penetration 1:5

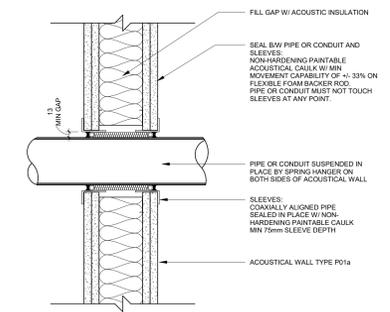


14 Typical Section Detail at Existing CMU Walls 1:1

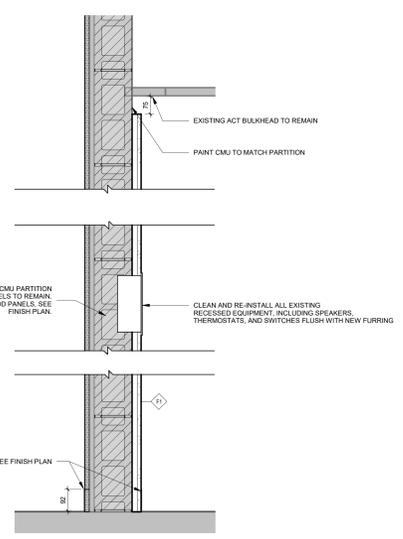


10 Floor Transition TH2 1:1

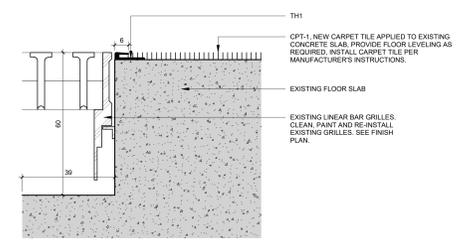


9 Floor Transition TH1 1:1

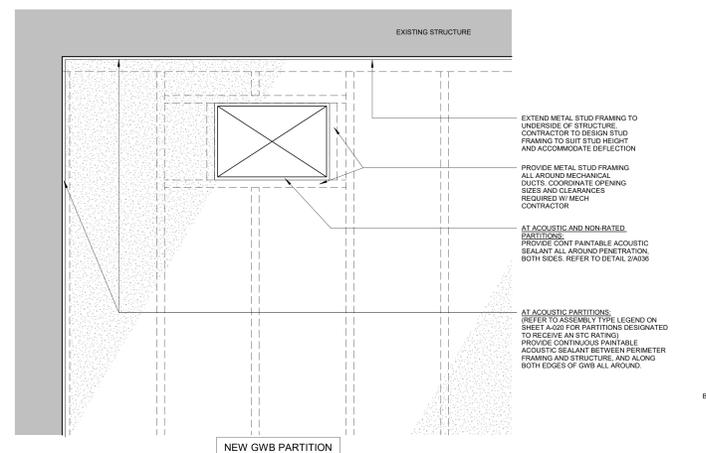


13 Elevation - Duct Penetration in GWB 1:10

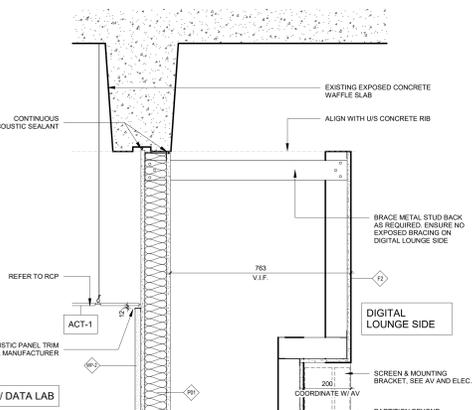


8 Section Detail - GIS Lab Partition Header 1:10

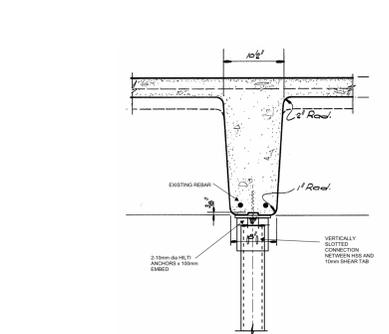


7 Typical Section at Top of HSS Column 1:10

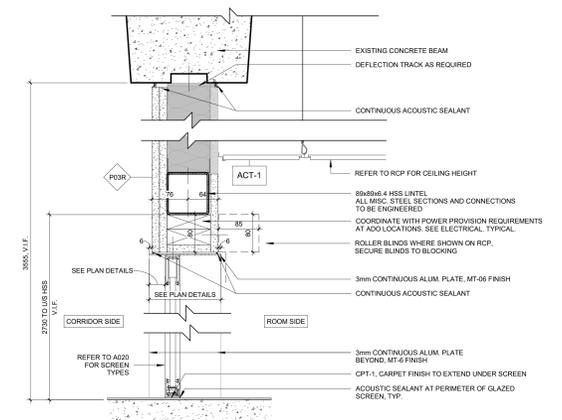


6 Typical Interior Sit & Header Steel Support 1:5

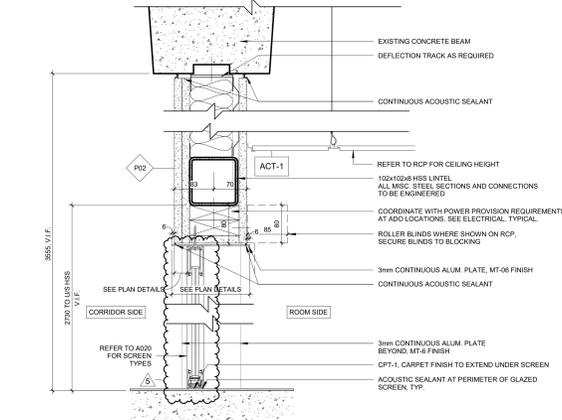


5 Typical Interior Sit & Header Steel Support 1:5

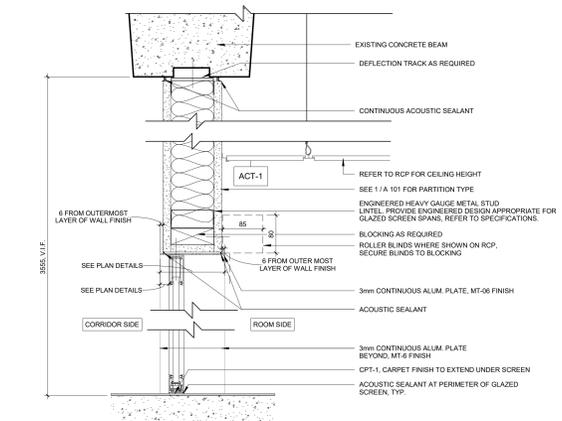


4 Typical Interior Screen Sit and Header 1:5

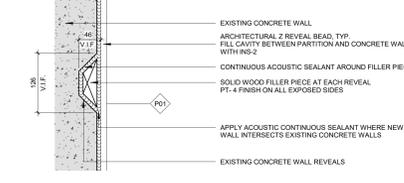

3 New Partition Meets Existing Concrete Wall Section Detail 1:5

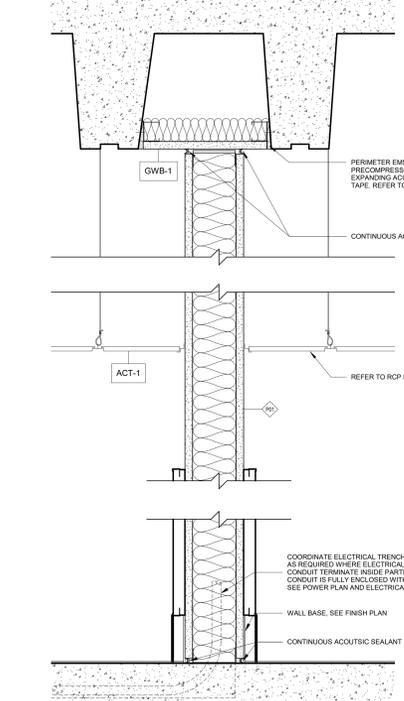

2 Typical Section Detail: Interior Acoustic Panel 1:5

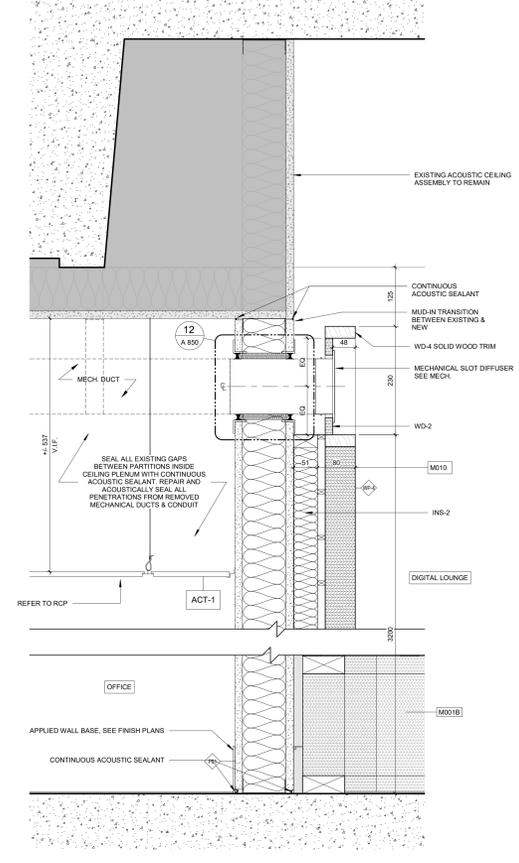


1 Section Detail - Acoustic Partition at Existing Office 1:5

No.	Date	Issue/Revision
5	20241021	ISSUED FOR ADDENDUM A-02
4	20240927	ISSUED FOR TENDER
3	20240816	ISSUED FOR BUILDING PERMIT
2	20240806	ISSUED FOR 100% CD
1	20240429	ISSUED FOR 80% CD COSTING


Robarts 5th Floor Renovation
 Title: Section Details

Project No. 2322 Scale As Indicated
 Drawing No.


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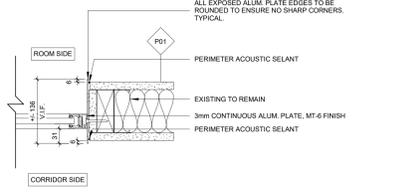
17 Corner Guards Typical Detail
1:5

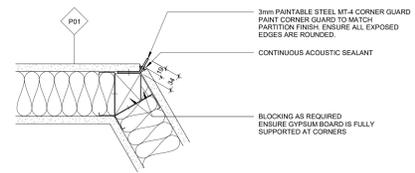


16 Typical Interior Screen Jamb Detail 6 with Steel Support
1:5

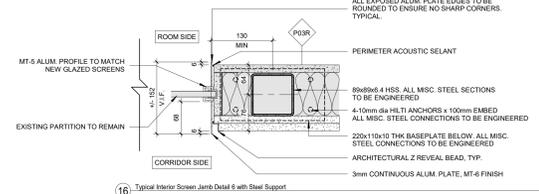


15 Typical Interior Screen Jamb Detail 5
1:5

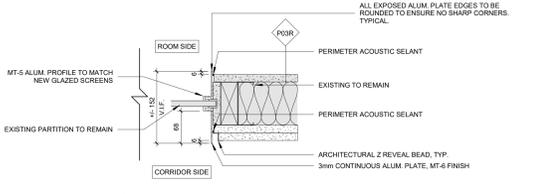


14 Typical Interior Screen Jamb Detail 4
1:5

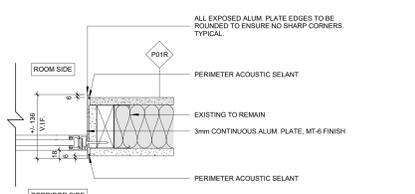


13 Typical Interior Screen Jamb Detail 3
1:5

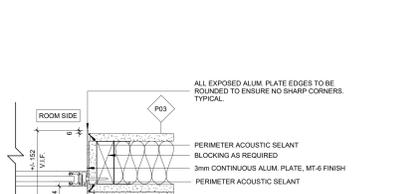


12 Typical Interior Screen Jamb Detail 2
1:5

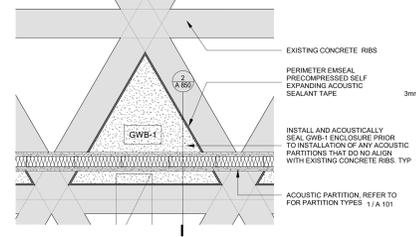


18 Plan Detail - GWB-1 Acoustic Ceiling Enclosure
1:20

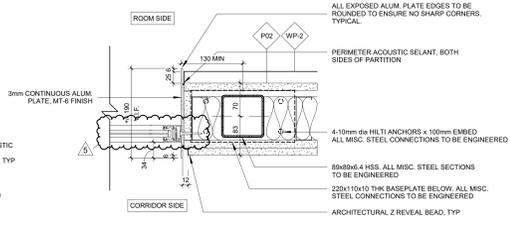


11 Typical Interior Screen Jamb Detail 1 with Steel Support
1:5

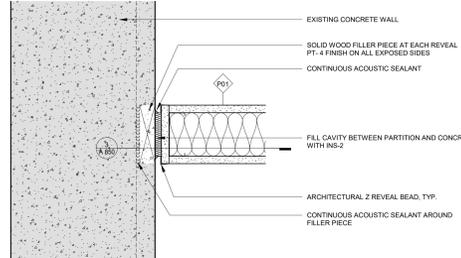


10 New Partition at Existing Walls
1:5

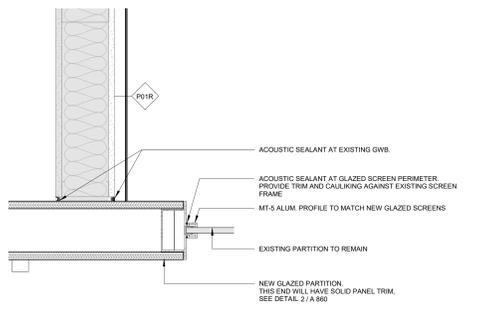


9 New Glazed Screen at Existing Wall Panel
1:5

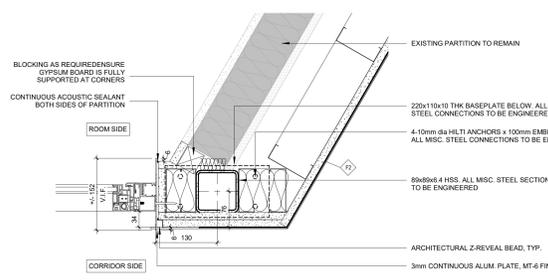


8 New Glazed Screen at Existing Glazed Screen and Furring
1:5

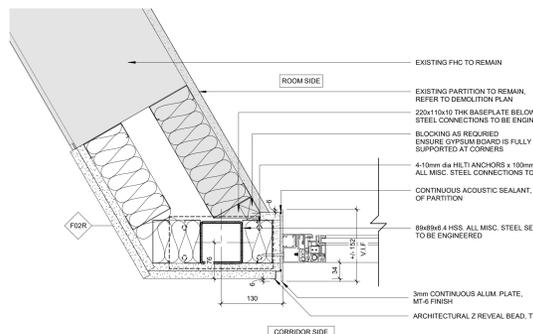


7 New Glazed Screen at Existing Glazed Screen
1:5

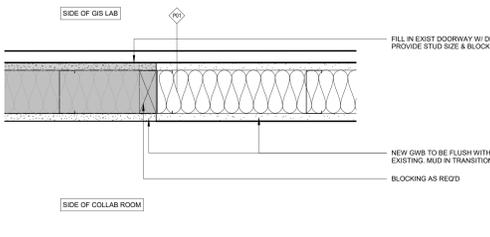


6 Existing Door with Typical Detail
1:5

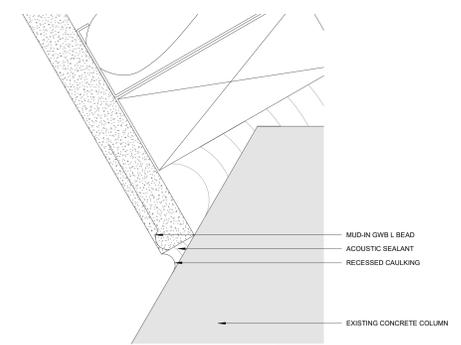


5 Typical GWR Partition at Existing Columns
1:1

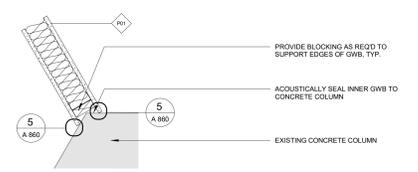


4 Typical GWR Partition at Existing Columns
1:10

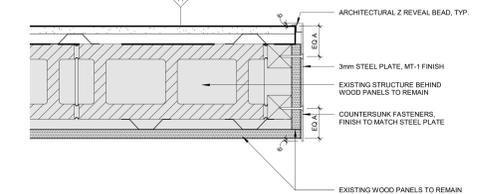

3 Typical Trim at Existing GWR Partition
1:5

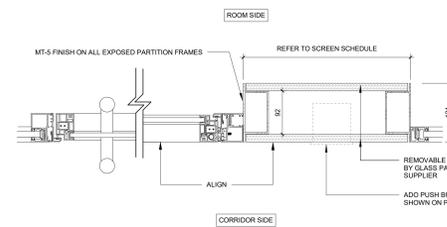

2 Typical Solid Panel at Glazed Screen
1:5

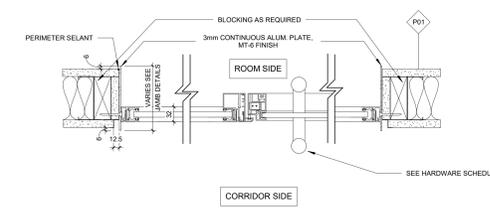

1 Typical Interior Screen Jamb
1:5

















No.	Date	Issue/Revision
5	20241021	ISSUED FOR ADDENDUM A-02
3	20240816	ISSUED FOR BUILDING PERMIT
2	20240806	ISSUED FOR 100% CD
1	20240429	ISSUED FOR 80% CD COSTING

No.	Date	Issue/Revision

Robarts 5th Floor Renovation

Plan Details

Project No. 2322	Scale As Indicated
Drawing No.	

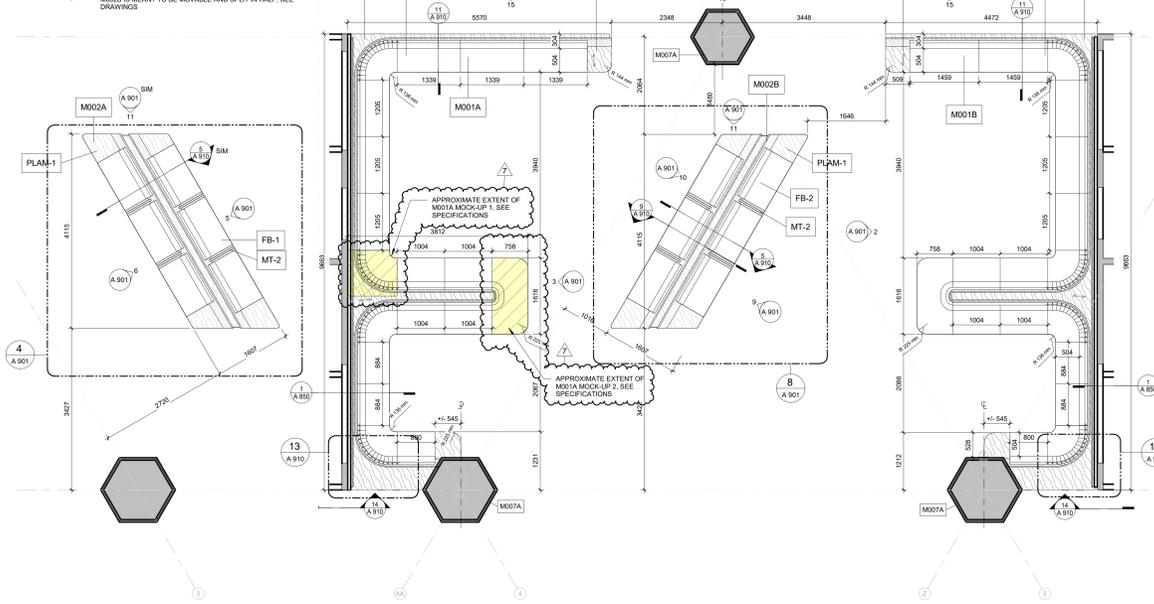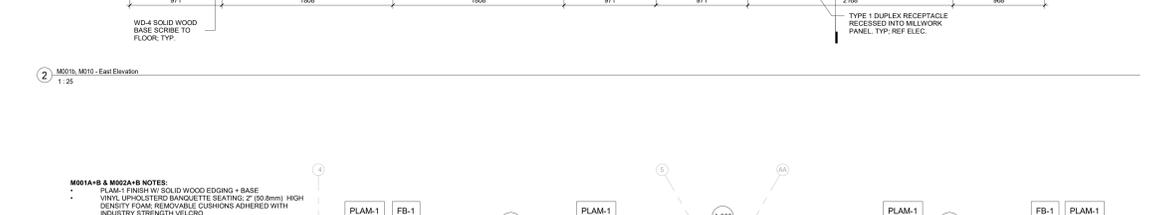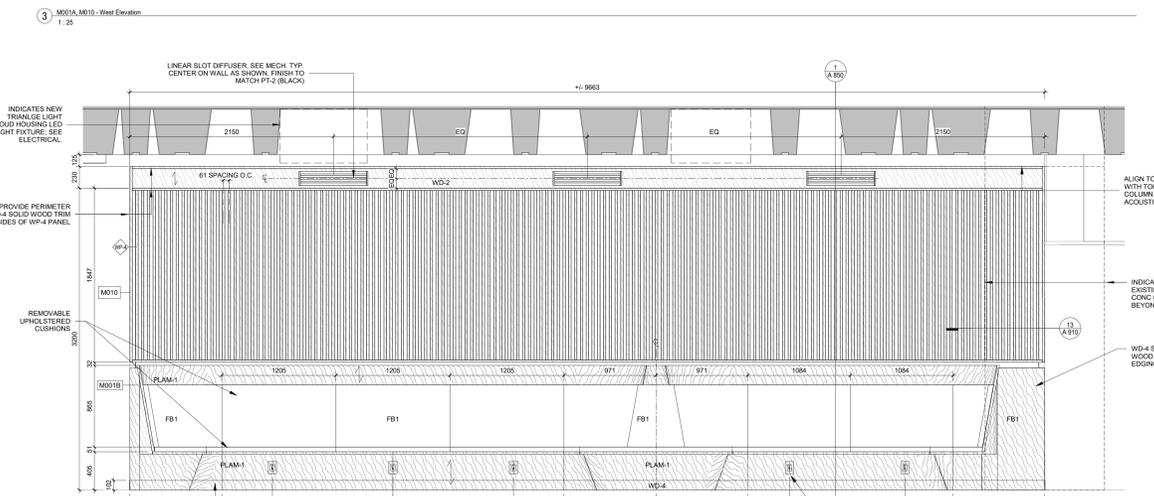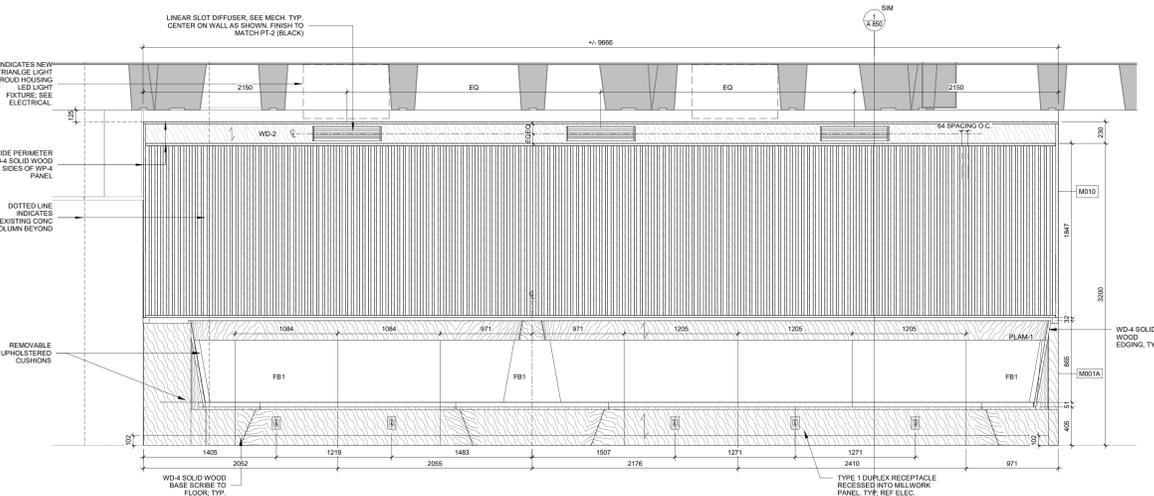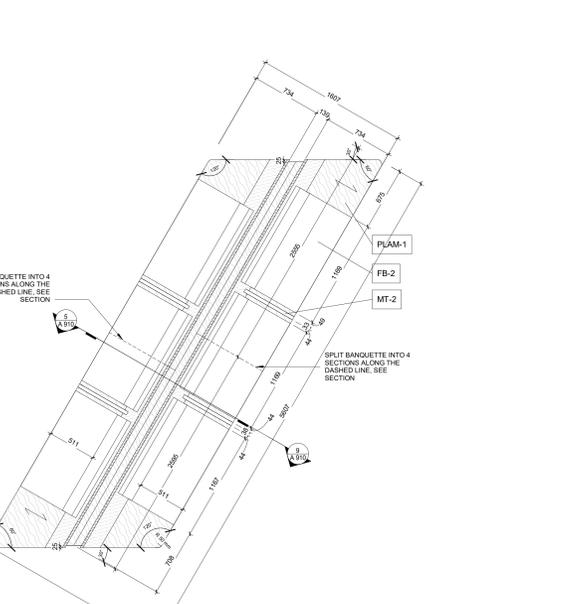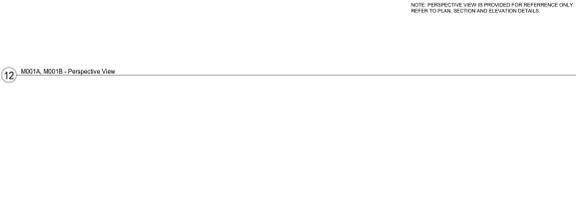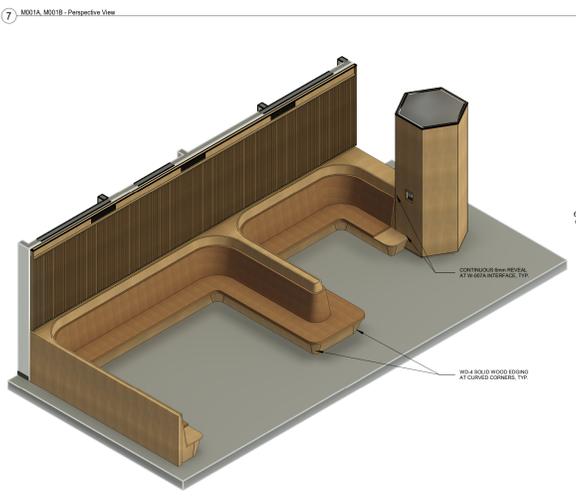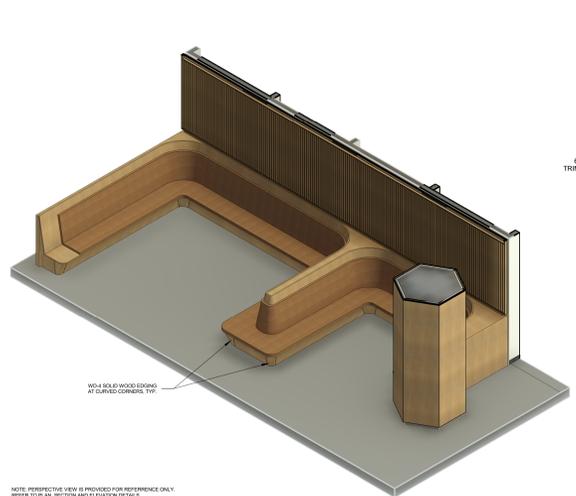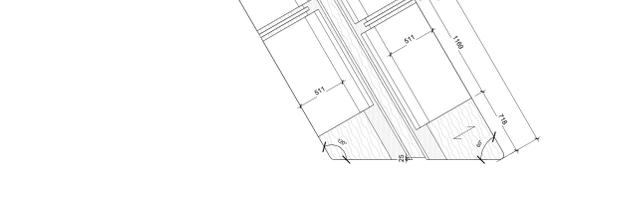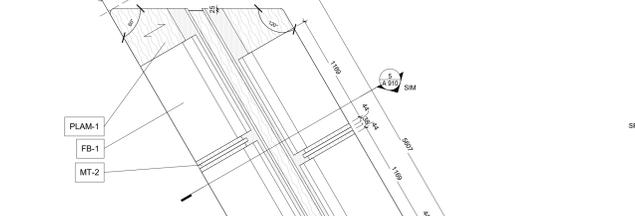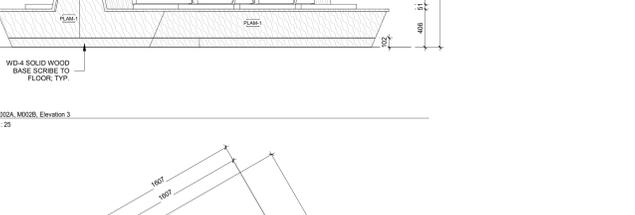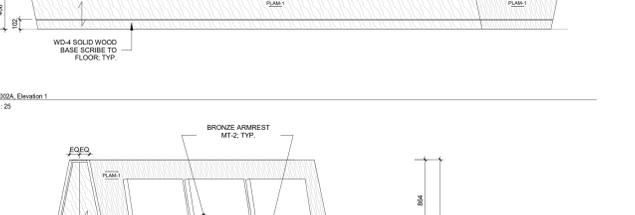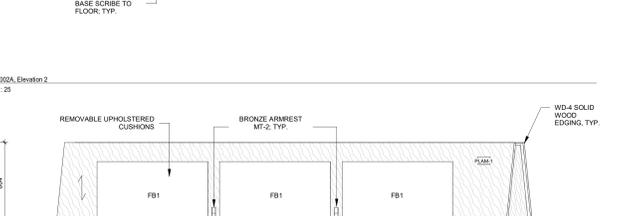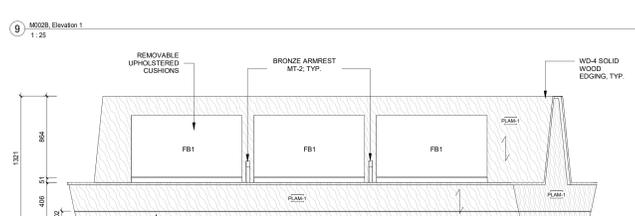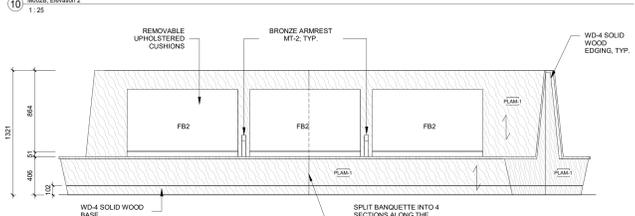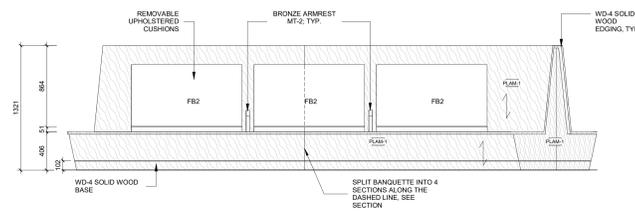

M001A+B & M002A+B NOTES:

- PLAM-1 FINISH W/ SOLID WOOD EDGING + BASE
- VINYL UPHOLSTERED BANQUETTE SEATING, 2" (50.8mm) HIGH DENSITY FOAM, REMOVABLE CUSHIONS ADHERED WITH INDUSTRY STRENGTH VELCRO
- INTEGRATED TYPE 1 POWER PLUGS AT EACH WORK STATION
- MILLWORK POWER REFER TO ELECTRICAL
- M002B IS MEANT TO BE MOVABLE AND SPLIT IN HALF, SEE DRAWINGS

No.	Date	Issue/Revision
7	20241021	ISSUED FOR ADDENDUM A-02
6	20240927	ISSUED FOR TENDER
5	20240816	ISSUED FOR BUILDING PERMIT
4	20240806	ISSUED FOR 100% CD
3	20240429	ISSUED FOR 80% CD COSTING
2	20231213	ISSUED FOR DD CLIENT REVIEW
1	20231122	ISSUED FOR DD COSTING & REVIEW

Robarts 5th Floor Renovation

Title:
Millwork Drawings - M001A+B, M002A+B, M010

Project No. 2322 Scale As indicated
 Drawing No.

A 901

