


ABBREVIATION LIST				ABBREVIATION LIST				ABBREVIATION LIST				ABBREVIATION LIST			
ABBREV.	WORD	ABBREV.	WORD	ABBREV.	WORD	ABBREV.	WORD	ABBREV.	WORD	ABBREV.	WORD	ABBREV.	WORD	ABBREV.	WORD
A	AND	F	FIRE ALARM	M.P	METAL PLATE	S									
Ⓐ	AT	F.A	FIRE ALARM	MAINT	MAINTENANCE	S									
@	AT	FAPS	FIRE ALARM PULL STATION	MAS	MASONRY	S.	SOUTH								
A.F.F	ABOVE FINISH FLOOR	FD	FLOOR DRAIN	MAS	MASONRY	S.C.S.	SOLID CORE STEEL								
AL	ALUMINIUM	FDN	FOUNDATION	MECH	MECHANICAL	S.C.W.	SOLID CORE WOOD								
ARCH	ARCHITECTURAL	FE	FIRE EXTINGUISHER	MED	MEDIUM	S.M	SHEET METAL								
ATC	ACOUSTIC TILE CEILING	FEC	FIRE EXTINGUISHER CABINET	MFG	MANUFACTURING	S.N.D.	SANITARY NAPKIN DISPENSER								
AUTO	AUTOMATIC	FHC	FIRE HOSE CABINET	MFR	MANUFACTURER	S.P.	STEEL PLATE								
		FIN	FINISH	MI	MIRROR	S.S.	STAINLESS STEEL								
B	BOTTOM OF	FLR	FLOOR	MIN	MINIMUM	S.S.K	SERVICE SINK								
B.O	BETWEEN	FRR	FIRE RESISTANCE RATING	MISC	MISCELLANEOUS	S.T.C.	SOUND TRANSMISSION CLASS								
B.W	BETWEEN	FRS	FIRE ROUTE SIGN	MM	MILLIMETER	SC(OT)	SCUPPER - OVERFLOW TYPE								
BAB	ROOF ANCHOR - BOLT AROUND BEAM	FT	FEET, FOOT	MTG COORD	MULTIPLE TRADE COORDINATION REQUIRED	SCHED.	SCHEDULE								
BD	BOARD	FTG	FOOTING	MTD	MOUNTED	SECT.	SECTION								
BF	BARRIER FREE			MTL	METAL	SER	SERVICE								
BIT	BITUMINOUS	G		MWLLB(L)	MURPHY WALL BED - LATERAL	SH.	SHOWER								
BLDG	BUILDING	G.W.B	GYPSUM WALL BOARD	MWLLB(V)	MURPHY WALLBED - VERTICAL	SHLV.	SHELVING								
BLKG	BLOCKING	GA	GAUGE			SIM.	SIMILAR								
BS	BLACK-OUT WINDOW SHADE	GALV	GALVANIZED	N		SPEC.	SPECIFICATION								
		GL	GLAZING	N.S	NORTH	SQ.	SQUARE								
C		GRD	GROUND	N.S	NORTH	SQ.FT.	SQUARE FEET, SQUARE FOOT								
C.B.U	CONCRETE BLOCK UNIT	GR	GRADE	NOT T TO SCALE		SSUR	SOLID SURFACING (MATERIAL)								
C.L	CENTERLINE	GYP	GYPSUM BOARD	NFWH	NON-FREEZE WALL HYDRANT	SSUR(S)	SOLID SURFACE (MATERIAL) FOR ISLAND COUNTERTOPS								
C.M.U	CONCRETE MASONRY UNIT			NIC	NOT IN CONTACT	SSUR(W)	SOLID SURFACE (MATERIAL) FOR WINDOW SILLS								
CW	COMPLETE WITH	H		NO	NUMBER	STD	STANDARD								
CA ITEM	CASH ALLOWANCE ITEM	H.S.P	HOSE STAND PIPE			STN	STATION								
CAB	CABINET	H.V.A.C	HEATING, VENTILATION, AIR CONDITIONING	O		STL	STEEL								
CHAN	CHANNEL	HB	HOSE BIB	O.C.	ON CENTER	STOR.	STORAGE								
CL	CLOSET	HD	HAND DRYER	O.D.	OUTSIDE DIAMETER	STRUCT.	STRUCTURAL								
CLG	CEILING	HDA	HEAVY DUTY ASPHALT	OH.	OVERHEAD	SUSP.	SUSPENDED								
CNTR	COUNTER	HDW	HARDWARE	OPG.	OPENING	SYS	SYSTEM								
COL	COLUMN	HLR	HORIZONTAL LIFELINE FALL PROTECTION SYSTEM -	OPP.	OPPOSITE										
CONC.	CONCRETE	HLW	HORIZONTAL LIFELINE FALL PROTECTION SYSTEM	ORN.	ORNAMENTAL										
CONST	CONSTRUCTION			OZ.	OUNCE	T									
CONT	CONTINUOUS			PL.	PLATE	T.&G.	TONGUE AND GROVE								
CONTR	CONTRACTOR	HM	HOLLOW METAL	PLAM.	PLASTIC LAMINATE	T.D.D	TOILET TISSUE DISPENSER								
CORR	CORRIDOR	HORIZ	HORIZONTAL	PL.F.	PLATFORM	T.T.H.	TOILET TISSUE HOLDER								
CPT	CARPET	HR	HOUR	PNL.	PANEL	T/O	TOP OF								
CR	CARD READER	HT	HEIGHT	PNT	PAINT	TEL	TELEPHONE								
CT	CERAMIC FLOOR TILE			PR.	PAIR	T.P.D.	PAPER TOWEL DISPENSER								
CB	CERAMIC TILE BASE	I		PREFAB	PREFABRICATED	THR.	THRESHOLD								
CWT	CERAMIC WALL TILE	I.D	INSIDE DIAMETER	PRFN	PRE-FINISHED	THRU.	THROUGH								
		IN	INCH, INCHES	PTL	PORCELAIN TILE	TOFM	TOILET - FLOOR MOUNTED								
D		INFO	INFORMATION	PVC.	PUSH TO LOCK	TOWM	TOILET - WALL MOUNTED								
D.F	DRINKING FOUNTAIN	INSUL	INSULATION			TV.	TELEVISION								
D.O	DOOR OPERATOR	INT	INTERIOR			TYP.	TYPICAL								
DET	DETAIL	J				U									
DIA	DIAMETER	J.C	JANITOR CLOSET			U.L.C.	UNDERWRITERS' LABORATORIES CANADA								
DIM	DIMENSION	JT	JOINT			U.N.O.	UNLESS NOTED OTHERWISE								
DN	DOWN					U.O.S.	UNLESS OTHERWISE SPECIFIED								
DR	DOOR	K				UNFIN.	UNFINISHED								
DS	DOWNSPOUT	K.P	KICK PLATE			UR.	URINAL								
DWG	DRAWING														
DWR	DRAWER	L				V.									
		L.F	LINEAR FOOT			V.C.T.	VINYL COMPOSITE TILE								
E		L.H	LEFT HAND			V.P.	VENT PIPE								
E.W	EAST	L.P	LOW POINT			VEST.	VESTIBULE								
EFG	EACH WAY	LAM	LAMINATE			VIF.	VERIFY								
EL	ENTRANCE FLOOR GRILLE	LAV	LAVATORY												
ELECT	ELEVATION	LDA	LIGHT DUTY ASPHALT			R	RADIUS								
		LNO	LINOLEUM			R.D.	ROOF DRAIN								
ELEV	ELEVATOR	LKR	LOCKER			R.H.	RIGHT HAND								
EMERG	EMERGENCY	LNT	LINTEL			R.O.	ROUGH OPENING								
ENCL	ENCLOSURE	LRG	LARGE			R.W.	RAIN WATER								
ENR	ENTRANCE ENTRY	LVL	LEVEL			RCA	REINFORCED CONCRETE APRON								
EQ	EQUAL	LVR	LOUVER			REF.	REFRIGERATOR								
EQUIP	EQUIPMENT	LVR.O	LOUVER OPENING			REQ'D	REQUIRED								
ES	ELECTRIC STRIKE	M				RES.	RESIDENTIAL								
EXIST	EXISTING	M	METER			REX	REQUEST TO EXIT								
EXP	EXPOSED	M.O	MASONRY OPENING			RM.	ROOM								
EXT	EXTERIOR					RSL	RESILIENT								

SPECIFIED ITEMS (BY LOCATION)			SPECIFIED ITEMS (BY LOCATION)		
TAG	DESCRIPTION	QUANTITY	TAG	DESCRIPTION	QUANTITY
LSX250	Solar Panel	221	LOCKER ROOM		
LSX250	Solar Panel	46	CG-T1	CORNER GUARD 2400mm	5
ACCESS CORRIDOR			L	LOCKERS AS SPECIFIED (REFER TO DRAWINGS FOR LAYOUT)	23
WB-2	WHITEBOARD	2	MECHANICAL		
CG-T1	CORNER GUARD 2400mm	8	LSX250	Solar Panel	14
APPARATUS BAY			RECEPTION		
CR	CORD REEL	2	CG-T1	CORNER GUARD 2400mm	1
LSX250	Solar Panel	50	WS	WINDOW SHADE	1
LSX250	Solar Panel	2	SECURITY & I.T		
EW	EYE WASH (FOOT OPERATED)	1	LSX250	Solar Panel	1
HR	HOSE REEL - WALL MOUNTED	1	TRAINING ROOM		
BUNKER GEAR			WB-2	WHITEBOARD	2
BG24	TURNOUT GEAR LOCKERS - 24" WIDTH	24	CG-T1	CORNER GUARD 2400mm	4
CAPTAINS OFFICE			WS	WINDOW SHADE	2
CG-T1	CORNER GUARD 2400mm	2	UNIVERSAL WASHROOM		
L	LOCKERS AS SPECIFIED (REFER TO DRAWINGS FOR LAYOUT)	5	TTDJ	B-2892 SURFACE MOUNTED TWIN JUMBO-ROLL TOILET TISSUE DISPENSER	1
WSBO	WINDOW SHADE c/w BLACKOUT SHADE	1	MI	FLAT MIRROR	1
CREW LOUNGE			RSS	B-5191 FOLDABLE SHOWER SEAT	1
CG-T2	CORNER GUARD (WRAP AROUND)	1	SN	B-270 SANITARY NAPKIN DISPOSAL	1
CG-T1	CORNER GUARD 2400mm	1	CH	COAT HOOK	2
WS	WINDOW SHADE	3	GBR(L)	B-5806.99x40	2
DINING AREA			GBR(M)	B-5806.99x30	2
CG-T1	CORNER GUARD 2400mm	2	GBR/GBR.L SET	GRAB BAR SET (1 STRAIGHT + 1 L-SHAPED)	1
WS	WINDOW SHADE	2	RSPH	12X16 ZITTA BRUSHED STAINLESS STEEL NICHE	1
DORMITORY			SC-R	SHOWER CURTAIN	1
CG-T1	CORNER GUARD 2400mm	5	SD	B-4112 SOAP DISPENSER	1
CH	COAT HOOK	20	SS SHELF	B-295x18 SURFACE MOUNTED STAINLESS STEEL SHELF	1
EXERCISE ROOM			WASHROOM & SHOWER		
MI	FLAT MIRROR	5	PTWR	SEMI-RECESSED CONVERTIBLE PAPER TOWEL DISPENSER AND WASTE RECEPTACLE B-3942	3
WS	WINDOW SHADE	6	TTDJ	B-2892 SURFACE MOUNTED TWIN JUMBO-ROLL TOILET TISSUE DISPENSER	3
KITCHEN			MI	FLAT MIRROR	3
CG-T1	CORNER GUARD 2400mm	2	RSS	B-5191 FOLDABLE SHOWER SEAT	3
WS	WINDOW SHADE	1	SN	B-270 SANITARY NAPKIN DISPOSAL	3
ST-E(I)	30" ELECTRIC STOVE - REFER TO SPECS	1	CH	COAT HOOK	6

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R

TYPICAL DETAILS LIST		
SHEET NUMBER	DIVISION	DETAIL VIEW NAME
Division 0 - Schedules		
A0.3	Division 0 - Schedules	00-0004 - FMH-1 - FIXTURE MOUNTING HEIGHTS
A0.3	Division 0 - Schedules	00-0005 - FMH-2 - FIXTURE MOUNTING HEIGHTS
A0.3	Division 0 - Schedules	00-0006 - FMH-3 - FIXTURE MOUNTING HEIGHTS
A13.6	Division 0 - Schedules	00-0001 - DR-1 - DOOR LEGEND AND FRAME TYPES
Division 1 - Generic Details		
A6.2	Division 1 - Generic Details	BASE OF WINDOW TYP.
A6.2	Division 1 - Generic Details	TOP OF WINDOW TYP.
A13.5	Division 1 - Generic Details	UNISTRUT SUSPENSION MEZZANINE
Division 2 - Site Construction		
A2.2	Division 2 - Site Construction	2-0002 - CF-1 - CONSTRUCTION FENCING
A2.2	Division 2 - Site Construction	2-0003 - CBST-1 - CBST DETAILS
A2.2	Division 2 - Site Construction	2-0004 - CS-1 - CONSTRUCTION SIGN
A2.7	Division 2 - Site Construction	2-0016 - SUR-1 - ASPHALT AND CONCRETE SURFACES
A2.9	Division 2 - Site Construction	2-0008 - AODA PARK-1 - AODA PARKING SPACE DETAILS - FLARED CURB RAMP
A2.9	Division 2 - Site Construction	2-0008 - AODA RAMP-1 AODA PARKING SPACE DETAILS
A2.9	Division 2 - Site Construction	2-0011 - CD-1 - CURB DETAILS
A2.9	Division 2 - Site Construction	2-0012 - CD-2 - CURB AND RAMP DETAILS - SIDEWALKS AND DRIVEWAY ENTRANCES
A2.9	Division 2 - Site Construction	2-0013 - CD-3 - AODA RAMP DETAILS
A2.10	Division 2 - Site Construction	2-0010 - BF-2 - HCP SIGN FIXED POST
A2.10	Division 2 - Site Construction	2-0015 - FP-1 - FLAG POLE BASE
A2.10	Division 2 - Site Construction	2-0018 - LSB-HIGH - LIGHT STANDARD HIGH BASE DETAIL
A2.10	Division 2 - Site Construction	2-0020 - PG - P-GATES
A2.10	Division 2 - Site Construction	2-0021 - TSP - TRAIL SIGN POST & INSTALLATION
A2.10	Division 2 - Site Construction	2-0022 - LS - LIMESTONE SCREENING
A2.10	Division 2 - Site Construction	2-0023 - TSG - TRAIL SIGNAGE GRAPHICS
A2.10	Division 2 - Site Construction	2-0030 - TF-1 - TYPICAL FENCE DETAILS
A2.10	Division 2 - Site Construction	2-0050 - VCS-1 - VEHICLE CHARGING STATION FLO
A2.10	Division 2 - Site Construction	2-0061 - MS - MUNICIPAL SIGNAGE
A2.10	Division 2 - Site Construction	2-0095 - MOVING/SPASH STRIP - PEA GRAVEL
A10.2	Division 2 - Site Construction	2-0001 - CBFP-1 - CARDBOARD TEMPORARY FLOOR PROTECTION
Division 3 - Concrete		
A2.9	Division 3 - Concrete	3-0002 - CAC-1 - CONCRETE TRANSITION APRON TYPICAL (CONCRETE)
A3.1	Division 3 - Concrete	3-0004 - FS-1 - FROST SLAB DETAILS
A3.1	Division 3 - Concrete	3-0005 - SE-1 - SLAB EDGE DETAIL
A3.1	Division 3 - Concrete	3-0006 - SE-2 - SLAB EDGE DETAIL BAY DOORS
A3.2	Division 3 - Concrete	3-0003 - CJ - TYPICAL CONCRETE JOINTS
Division 4 - Masonry		
A6.2	Division 4 - Masonry	4-0011 - MASONRY DETAIL AT WINDOW / DOOR OPENINGS
Division 5 - Metals		
A2.10	Division 5 - Metals	5-0006 - BO-1 - TYPICAL BOLLARD DETAILS
A3.3	Division 5 - Metals	5-0024 - FFD-2 - FOUR FOLD DOOR JAMB DETAIL
A3.3	Division 5 - Metals	5-0025 - FFD-2 - FOUR FOLD DOOR JAMB DETAIL @ CURTAIN WALL
A3.3	Division 5 - Metals	5-0027 - FFD-2 - FOUR FOLD HEAD DETAIL
A3.6	Division 5 - Metals	5-0080 - AL-3 - HANDRAIL WALL-MOUNTED
A3.6	Division 5 - Metals	5-0081 - HANDRAIL STRINGER - MOUNTED
A3.6	Division 5 - Metals	5-0093 - ST-3 - ST-GR
A3.7	Division 5 - Metals	5-0007 - EMSDS-1 - TYPICAL STAINLESS STEEL DECON SINK DETAILS - Radius Edge
A3.7	Division 5 - Metals	5-0021 - FFD SURROUND DETAILS - FOUR FOLD DOORS
Division 6 - Wood and Plastics		
A12.2	Division 6 - Wood and Plastics	6-0010 - MW-WSRVMAN - MILLWORK WASHROOM AODA MONOLITHIC SINK
A12.2	Division 6 - Wood and Plastics	6-0010 - MW-WSRVMAN - MILLWORK WASHROOM VANITY MONOLITHIC SINK
A12.2	Division 6 - Wood and Plastics	6-0016 - CR-2 - CHRMBNGH - BENCH DETAIL
A13.2	Division 6 - Wood and Plastics	6-0003 - WORKSURFACE - SHELF DETAIL
A13.3	Division 6 - Wood and Plastics	6-0001 - MW - K - ZDRZDWR
A13.3	Division 6 - Wood and Plastics	6-0001 - MW - K - ZDRPANTRY
A13.3	Division 6 - Wood and Plastics	6-0001 - MW - K - ZDRPANTRY KITCHEN
A13.3	Division 6 - Wood and Plastics	6-0001 - MW - K - ZDRSNK
A13.3	Division 6 - Wood and Plastics	6-0001 - MW - K - 3DWR
A13.3	Division 6 - Wood and Plastics	6-0001 - MW - K - DSPNCH
A13.3	Division 6 - Wood and Plastics	6-0001 - MW - O - RBNWY
A13.3	Division 6 - Wood and Plastics	6-0002 - COUNTERTOP - SELECT DETAIL
A13.3	Division 6 - Wood and Plastics	6-0002 - HOCKEY BOARD DETAIL
A13.3	Division 6 - Wood and Plastics	6-0007 - MURPHY WALLBED AND CABINET - LATERAL
Division 7 - Thermal and Moisture Protection		
A4.1	Division 7 - Thermal and Moisture Protection	7-0001 - VRA-1 - VRA ROOF DETAILS
A4.1	Division 7 - Thermal and Moisture Protection	7-0002 - VRA-2 - ROOF PAVER DETAIL
A4.1	Division 7 - Thermal and Moisture Protection	7-0007 - SCRP-1 - OVERFLOW TYPE
A4.1	Division 7 - Thermal and Moisture Protection	7-0012 - REL-2 ROOF EXPANSION JOINT DETAILS - TORCH DOWN
A4.1	Division 7 - Thermal and Moisture Protection	7-0015 - ROOF DRAIN SUMP
A4.1	Division 7 - Thermal and Moisture Protection	7-0052 - AB-3 - ROOF TO WALL DETAIL (FRAMED UPSTAND)
A8.1	Division 7 - Thermal and Moisture Protection	7-0050 - AB-1 - AIR BARRIER DETAILS
A9.2	Division 7 - Thermal and Moisture Protection	7-0012 - HOSE TOWER - ROOF DETAIL
A9.2	Division 7 - Thermal and Moisture Protection	7-0012 - HOSE TOWER - OUTSIDE CORNER
A9.2	Division 7 - Thermal and Moisture Protection	7-00

ISSUE OR REVISION		
NO.	ISSUED FOR	DATE
7	SITE PLAN SUBMISSION 1	2022-05-31
10	SPA RE-SUBMISSION	2022-08-30
17	SPA - REVISION	2023-08-30
18	ISSUED FOR PERMIT	2023-09-15
19	ISSUED FOR RFPO	2023-10-19
24	ISSUED FOR CLASS A	2024-02-16
25	CLIENT REVIEW - 100%	2024-03-12
26	T24-253 - IFT	2024-04-15
29	ADDENDUM #4	2024-05-30

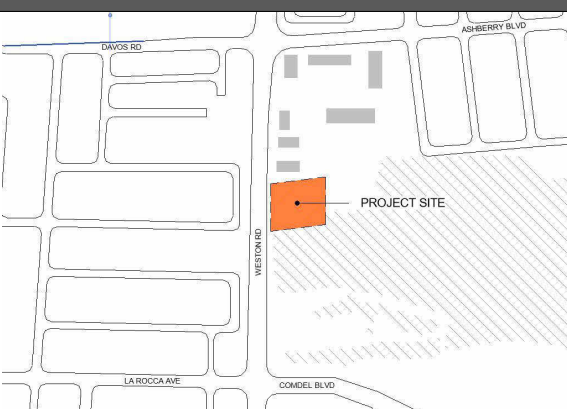

FILE NO. SP.22.V.0191

CITY OF VAUGHAN FIRE STATION 7-12

9511 WESTON ROAD, VAUGHAN

PROJECT :

CLIENT :



THE CONTRACTOR SHALL VERIFY ALL DIMENSIONS PRIOR
TO COMMENCEMENT OF THE WORK. ANY DISCREPANCIES
ARE TO BE REPORTED TO THE CONSULTANT.


ARCHITECT
THOMASBROWNARCHITECTS
197 SPADINA AVENUE, SUITE 500 | TORONTO ONTARIO | M5T 2C8

PROFESSIONAL SEAL

DWG TITLE

GROUND FLOOR PLAN - GENERAL ARRANGEMENT

ORIENTATION

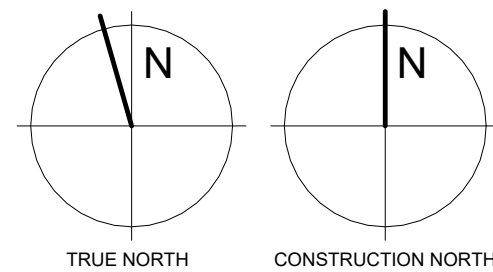


DATE 2021-11-24

SCALE As indicated DRAWN BY SRL

DWG STATUS: TENDER

PROJECT NO. 2104

DRAWING NO. A3.3 REVISION 29

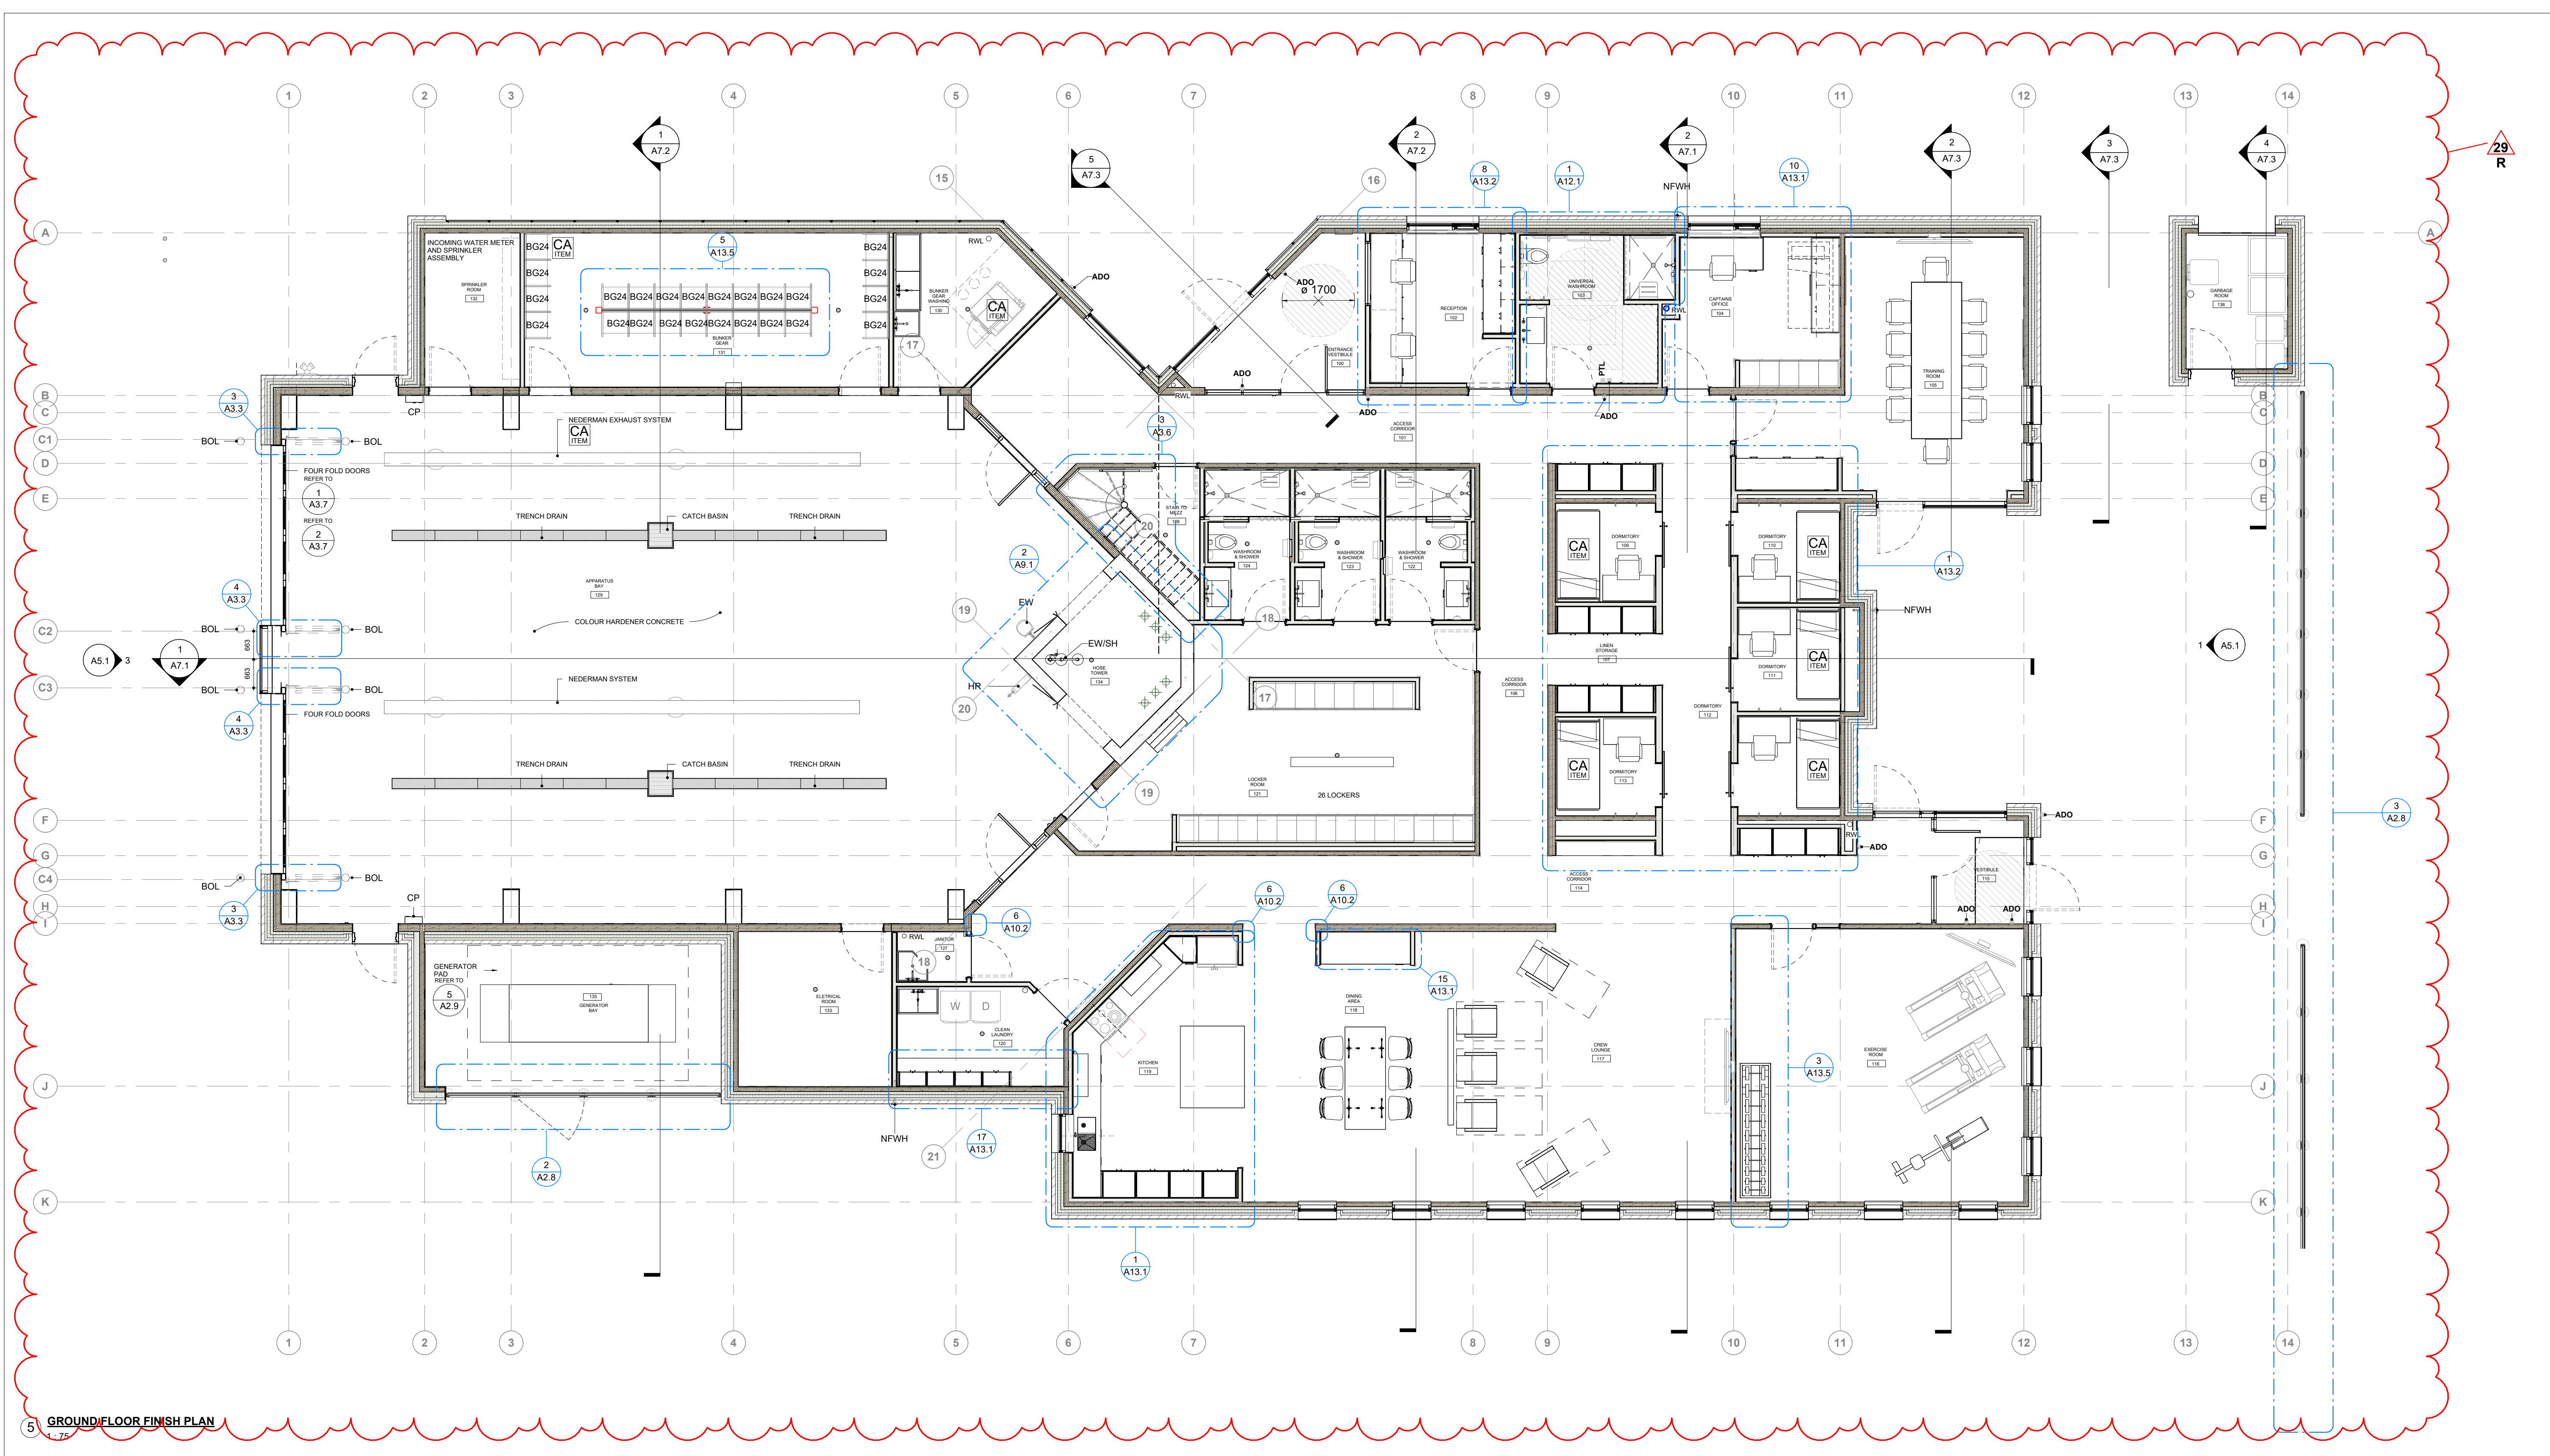

5 GROUND FLOOR FINISH PLAN

4 / A3.3 5-0025 - FFD-2 - FOUR FOLD DOOR JAMB DETAIL @ CURTAIN WALL

REFER TO STRUCTURAL FOR CLOSURE PLATE
FIT ELECTRICAL BOX FOR SENSOR WITHIN CAVITY.
CONFIRM LOCATION PRIOR TO INSTALLATION
DRILL JAMB FOR DOOR SENSOR
SENSOR SHALL BE 600MM A.F.F. COORDINATE WITH
DOOR SUPPLIER FOR SENSOR REQUIREMENTS
OW - OPENING WIDTH
10mm (GALV.) STEEL JAMB PLATE EXTENSION
PREFABRICATED FRAME CONNECTED TO
STEEL JAMB PLATE
PW-L/PW-R
GC COORD
SUBTRADES

NOTES:
1. SURFACE PREP IN ACCORDANCE WITH AESS FINISH NOTED.
2. PROVIDE WEEP HOLES AS REQUIRED AND WHERE PW-L AND
PW-R CLOSE WEB OF COLUMNS
3. CONFIRM FOUR FOLD DOOR MOUNTING REQUIREMENTS WITH
DOOR MANUFACTURER PRIOR TO INSTALLATION.

ALL STEEL GALVANIZED (AESS 3)
ENGINEERED SUBMITTAL (REG'D)
ENGINEERED SIGNOFF (REG'D)

6 / A3.3 5-0027 - FFD(R)-2 - FOUR FOLD DOOR HEAD DETAIL

FACE OF WALL
ANCHOR BOLT
PREFABRICATED FRAME
BOLTED STEEL FRAME @
OPENING.
REFER TO STRUCTURAL
DWGS.
FOUR FOLD DOOR
TRACK ASSEMBLY
FOUR FOLD DOOR
GC COORD
SUBTRADES

NOTES:
1. GRIND SMOOTH ALL WELDS
2. CONFIRM FOUR FOLD DOOR MOUNTING REQUIREMENTS WITH
DOOR MANUFACTURER PRIOR TO INSTALLATION.

ALL STEEL GALVANIZED (AESS 3)
ENGINEERED SUBMITTAL (REG'D)
ENGINEERED SIGNOFF (REG'D)

3 / A3.3 5-0024 - FFD-2 - FOUR FOLD DOOR JAMB DETAIL

WALL ASSEMBLY
FIT ELECTRICAL BOX (SINGLE GANG - 89mm
DEEP) FOR SENSOR AT WALL FACE AT
INTERIOR SIDE WITHIN CAVITY. CONFIRM
LOCATION PRIOR TO EXTERIOR WALL FINISH
INSTALLATION
DRILL JAMB FOR DOOR SENSOR
SENSOR SHALL BE 600MM A.F.F. COORDINATE
WITH DOOR SUPPLIER FOR SENSOR
REQUIREMENTS
LINE OF WALL FACE AT INTERIOR SIDE WITHIN
CAVITY
OW - OPENING WIDTH
PW-L / PW-R
PREFABRICATED FOUR FOLD
DOOR FRAME WELDED TO
STEEL JAMB PLATE
STEEL FRAME
AND PLATE
REFER TO STRUC. DWGS.
GC COORD
SUBTRADES

NOTES:
1. GRIND SMOOTH ALL WELDS
2. CONFIRM FOUR FOLD DOOR MOUNTING REQUIREMENTS WITH
DOOR MANUFACTURER PRIOR TO INSTALLATION.

ALL STEEL GALVANIZED (AESS 3)
ENGINEERED SUBMITTAL (REG'D)
ENGINEERED SIGNOFF (REG'D)

2 / A3.3 A700 GENERAL NOTES - APPARATUS / VEHICLE BAYS

APPARATUS / VEHICLE BAY SLABS ARE REINFORCED CONCRETE SLABS THAT MUST BE
PREPARED PROPERLY PRIOR TO EXECUTION. LISTED BELOW ARE ITEMS THAT MUST BE
COORDINATED TO ENSURE A SUCCESSFUL RESULT.


- WHERE SLABS ABUT A WALL, THE WALL MUST BE SMOOTH AND FREE OF PROJECTIONS SO
THAT THE EXPANSION JOINT SITS DIRECTLY AGAINST THE WALL. THIS ALLOWS FOR A CLEAN
AND CONSISTENT CAULKED JOINT WHEN FINISHED.
- ALL INTERIOR ALUM SCREENS SHALL HAVE GWB AND METAL STUD ASSEMBLIES FROM TOP OF
SCREEN/DOOR FRAME TO UNDERSIDE OF DECK UNLESS A LINTEL HAS BEEN PROVIDED BY
STRUCTURAL WITH BLOCK WALL ABOVE TO USE DECKS. WHERE SCREENS OR DOORS OCCUR WITHIN
WALLS CONSTRUCTED AS FIRE SEPARATIONS, THE WALL ABOVE SUCH SCREENS OR DOORS SHALL
BE CONSTRUCTED TO PROVIDE THE REQUIRED FIRE RESISTANCE RATING INDICATED
ON ALL EXPOSED CORNERS OF EXPOSED MASONRY WALLS PROVIDE BULLNOSE BLOCK AT ALL
COURSES ABOVE THE FIRST COURSE UNLESS NOTED OTHERWISE.
- WHERE SLABS ABUT OVERHEAD DOORS OR DOOR OPENINGS, SLAB MUST BE CROWNED
BENEATH DOOR TO ENSURE FLOW OF WATER FROM EXTERIOR FACE OF DOOR TO EXTERIOR.
AT DOOR OPENINGS EXTEND SLAB TO EXTERIOR FACE OF FOUNDATION WALL. AT OVERHEAD
DOOR OPENINGS, EXTEND SLAB TO MIDDLE OF SUPPORTING FOUNDATION WALL TO ABUT TO
REINFORCED EXTERIOR CONCRETE APRON.
- TRENCH DRAINS MUST BE PROPERLY SET IN ACCORDANCE WITH THE CONTRACT
DOCUMENTS AND MANUFACTURER'S RECOMMENDATIONS PRIOR TO PLACEMENT OF SLABS.
PROVIDE PROPER SPACERS IN TOP OF TRENCH DRAIN TO ENSURE THAT EDGE RAILS DON'T
DEFLECT DURING PLACEMENT / FINISHING OF SLAB. FAILURE TO DO THIS MAY RESULT IN
IMPROPER FIT OF TRENCH DRAIN GRATES.
- COORDINATE SAWCUTTING OF SLAB TO PREVENT EXCESSIVE RAVELING (TOO EARLY) OR
CRACKING (TOO LATE).

GC COORD
SUBTRADES

1 / A3.3 A700 GENERAL NOTES - FLOOR PLAN

- DIMENSIONS SHOWN ARE TAKEN TO FACE OF CMU, POURED CONCRETE, OR WALL STUD UNLESS
NOTED OTHERWISE. ALL GWB OR CMU PARTITIONS TO EXTEND TIGHT TO U/S OF ROOF DECKS
UNLESS NOTED OTHERWISE.
- REFER TO STRUCTURAL DRAWINGS FOR LATERAL SUPPORT AT THE TOP OF CMU WALLS.
- ALL INTERIOR ALUM SCREENS SHALL HAVE GWB AND METAL STUD ASSEMBLIES FROM TOP OF
SCREEN/DOOR FRAME TO UNDERSIDE OF DECK UNLESS A LINTEL HAS BEEN PROVIDED BY
STRUCTURAL WITH BLOCK WALL ABOVE TO USE DECKS. WHERE SCREENS OR DOORS OCCUR WITHIN
WALLS CONSTRUCTED AS FIRE SEPARATIONS, THE WALL ABOVE SUCH SCREENS OR DOORS SHALL
BE CONSTRUCTED TO PROVIDE THE REQUIRED FIRE RESISTANCE RATING INDICATED
ON ALL EXPOSED CORNERS OF EXPOSED MASONRY WALLS PROVIDE BULLNOSE BLOCK AT ALL
COURSES ABOVE THE FIRST COURSE UNLESS NOTED OTHERWISE.
- WHERE DUCTS, PIPES, AND CONDUITS PENETRATE EXPOSED MASONRY PARTITIONS, CUT BLOCKS TO
SUIT REQUIRED OPENINGS TO MINIMIZE PATCHING.
- REFER TO ELECTRICAL DRAWINGS FOR LOCATIONS OF PANELS, DOOR CONTROLS, SECURITY
DEVICES ETC. NOT SHOWN ON ARCHITECTURAL DRAWINGS.

ISSUE OR REVISION		
NO.	ISSUED FOR	DATE
16	DD CLIENT REVIEW	2023-07-24
18	ISSUED FOR PERMIT	2023-09-15
19	ISSUED FOR RFPQ	2023-10-19
24	ISSUED FOR CLASS A	2024-02-16
28	T24-253 - IFT	2024-04-15
28	ADDENDUM #3	2024-05-22
29	ADDENDUM #4	2024-05-30

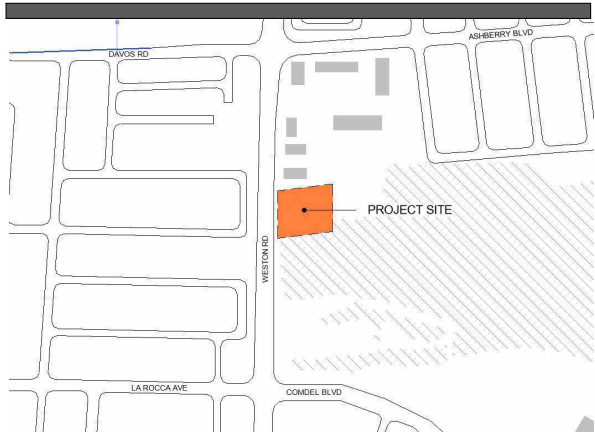

FILE NO. SP.22.V.0191

CITY OF VAUGHAN FIRE STATION 7-12

9511 WESTON ROAD, VAUGHAN

PROJECT :

CLIENT :



VAUGHAN

THE CONTRACTOR SHALL VERIFY ALL DIMENSIONS PRIOR
TO COMMENCEMENT OF THE WORK. ANY DISCREPANCIES
ARE TO BE REPORTED TO THE CONSULTANT.


ARCHITECT
THOMASBROWNARCHITECTS
197 SPADINA AVENUE, SUITE 500 | TORONTO ONTARIO | M5T 2C8

PROFESSIONAL SEAL

DWG TITLE

CLADDING, GLAZING
AND LOUVER
ELEVATIONS

ORIENTATION

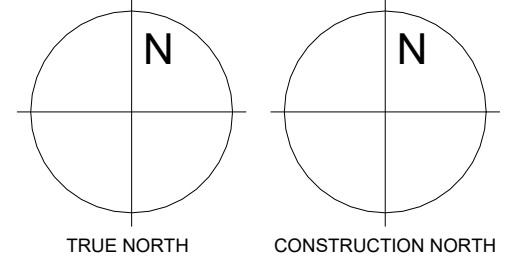

DATE 2021-11-24

SCALE As indicated DRAWN BY SRL

DWG STATUS :

TENDER

PROJECT No.


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DRAWING No.


A6.1

REVISION


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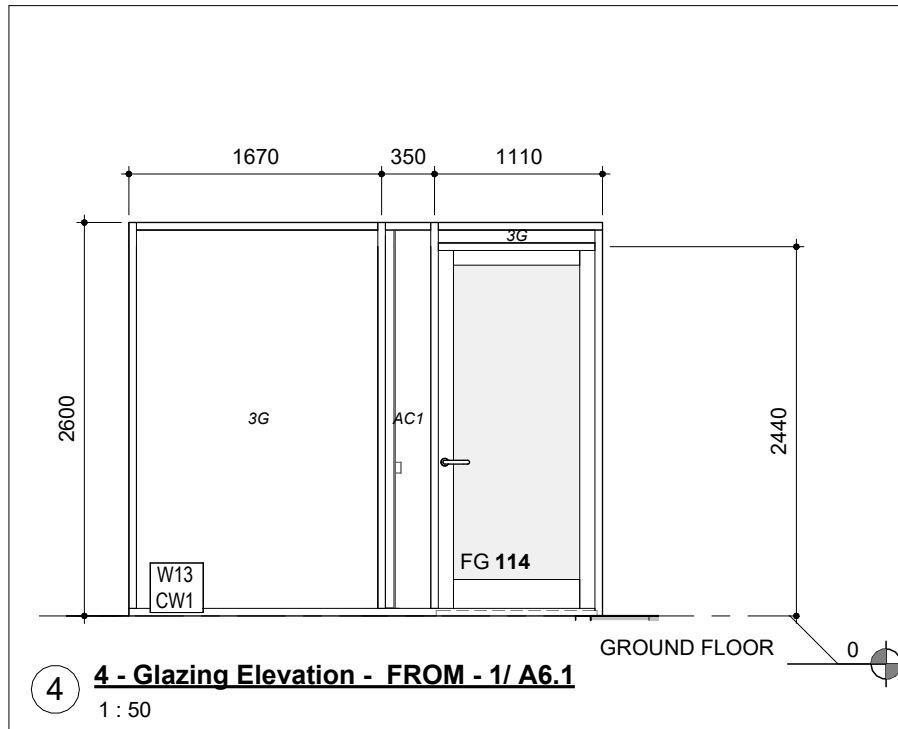
1 GROUND FLOOR PLAN - GLAZING AND CLADDING KEY PLAN
1: 150

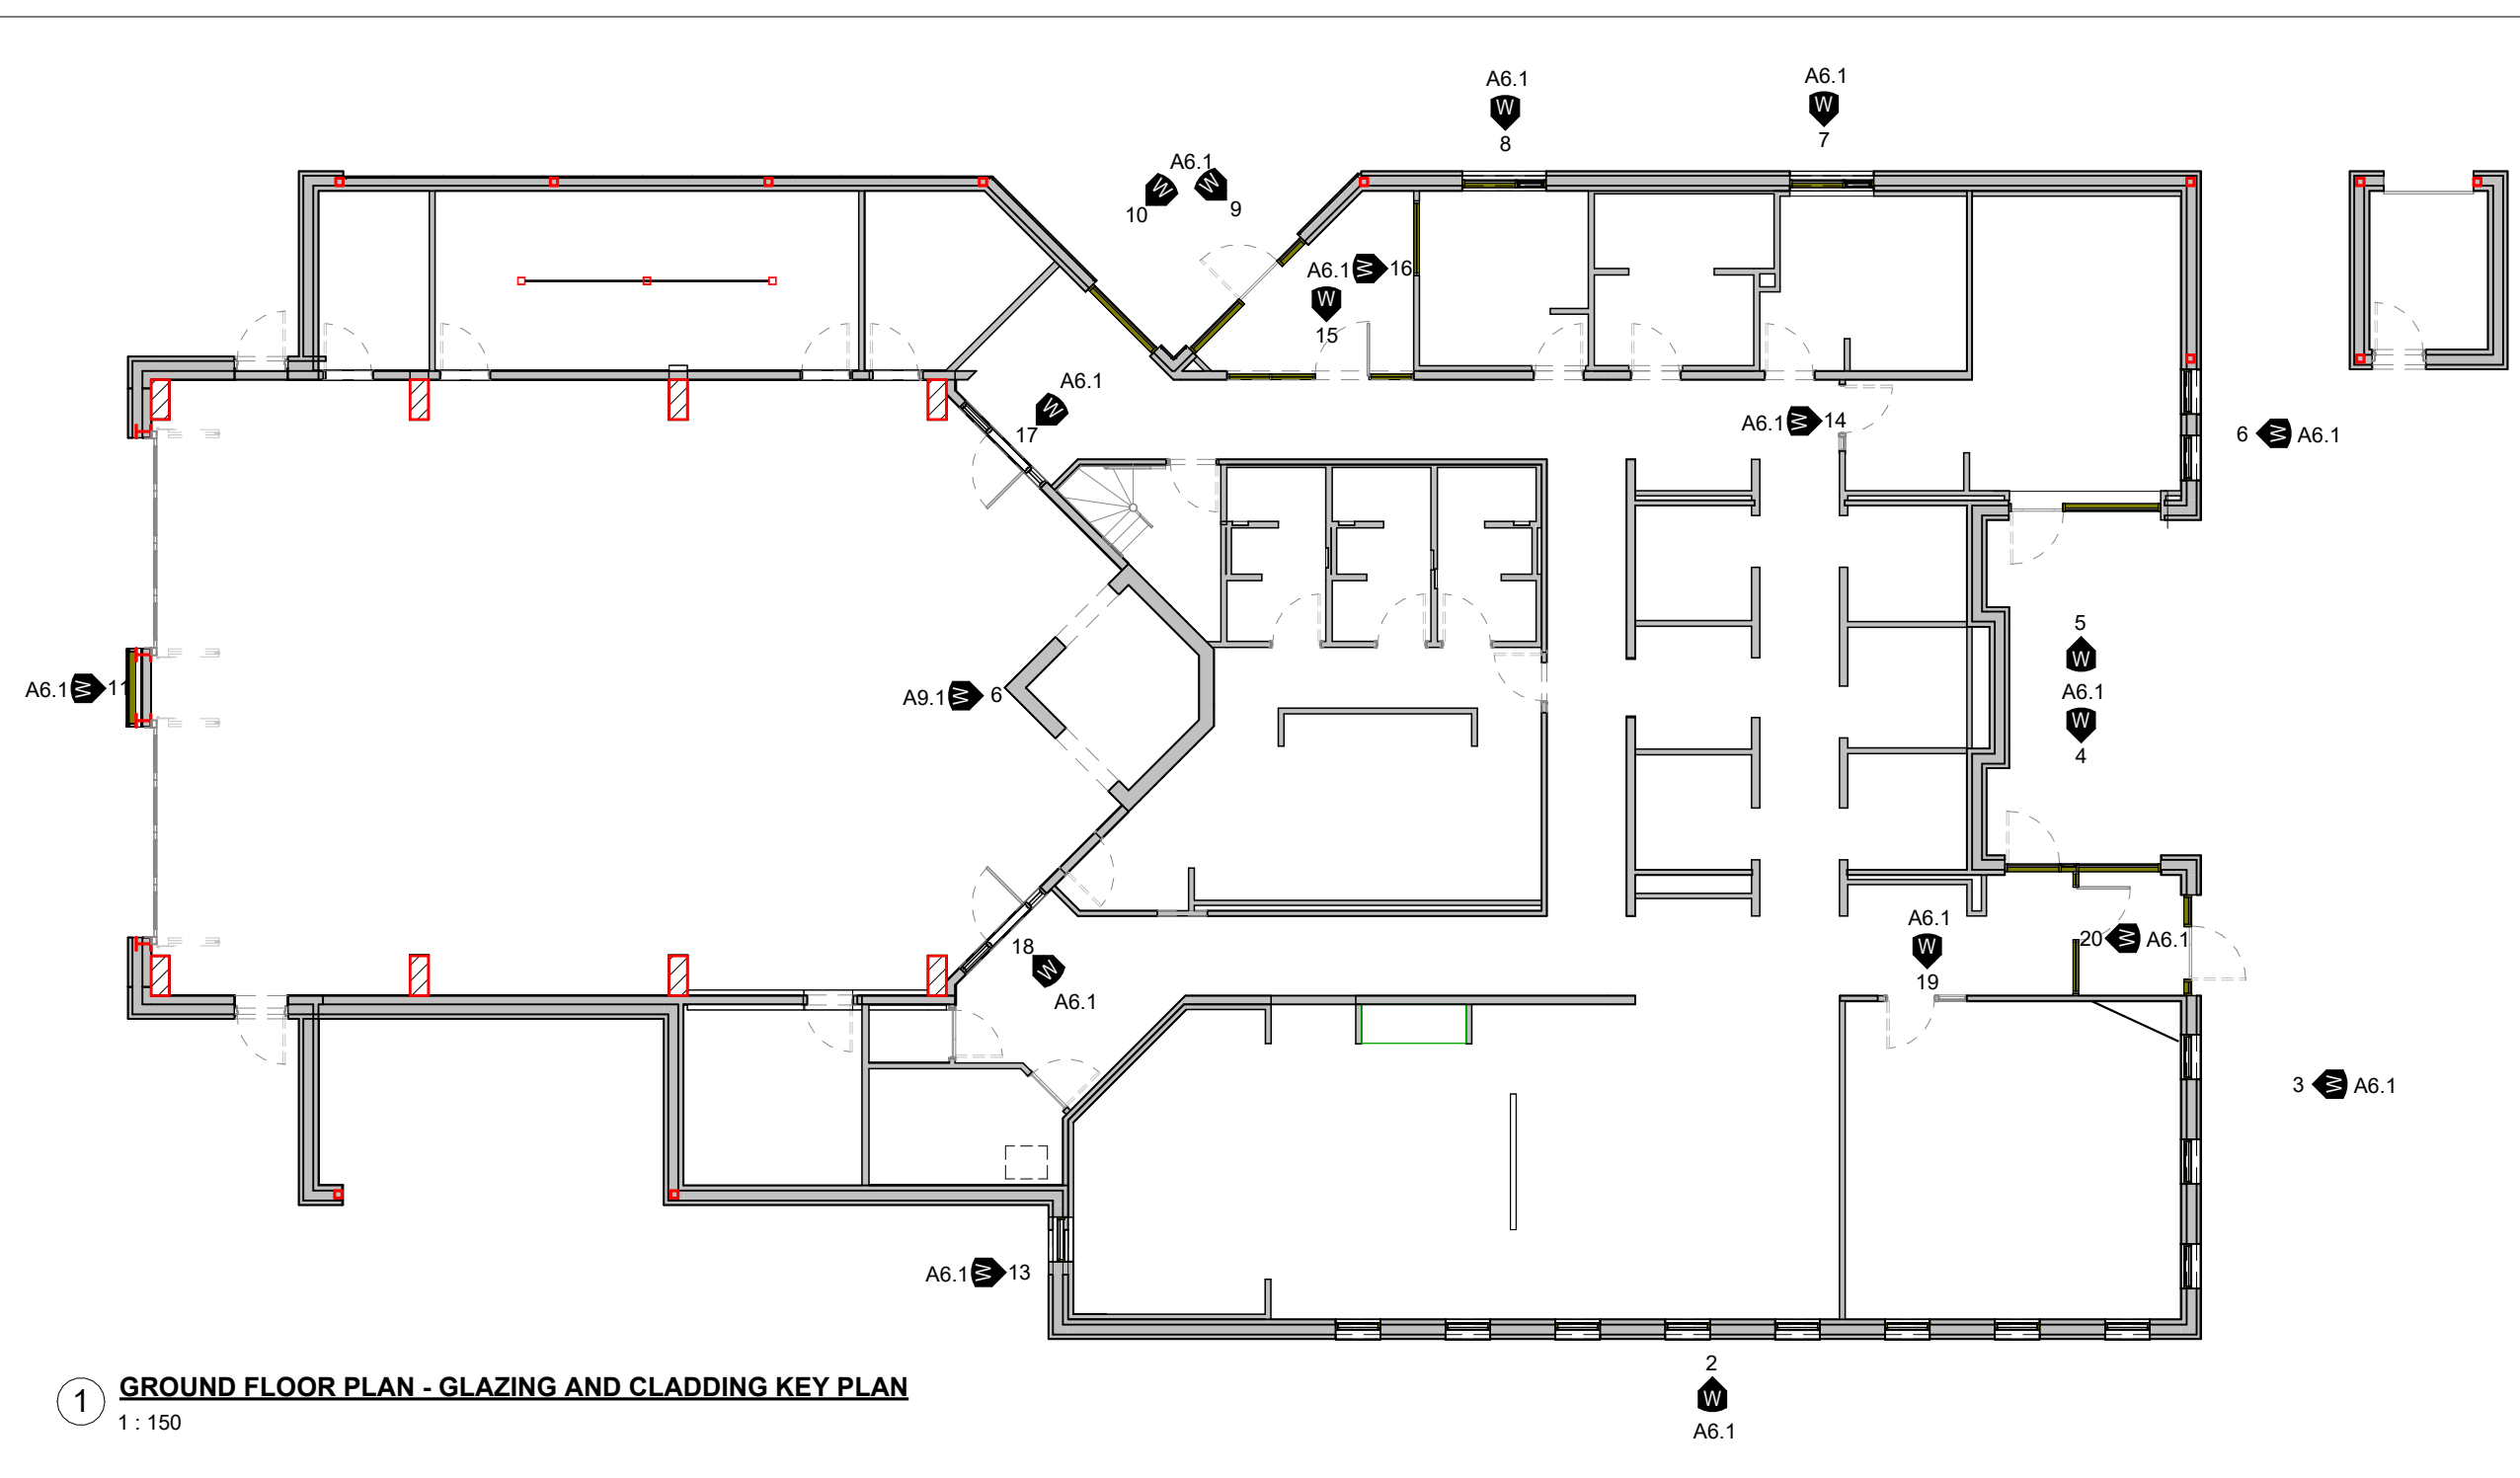


2 4 - Glazing Elevation - FROM - 1/ A6.1
1: 50

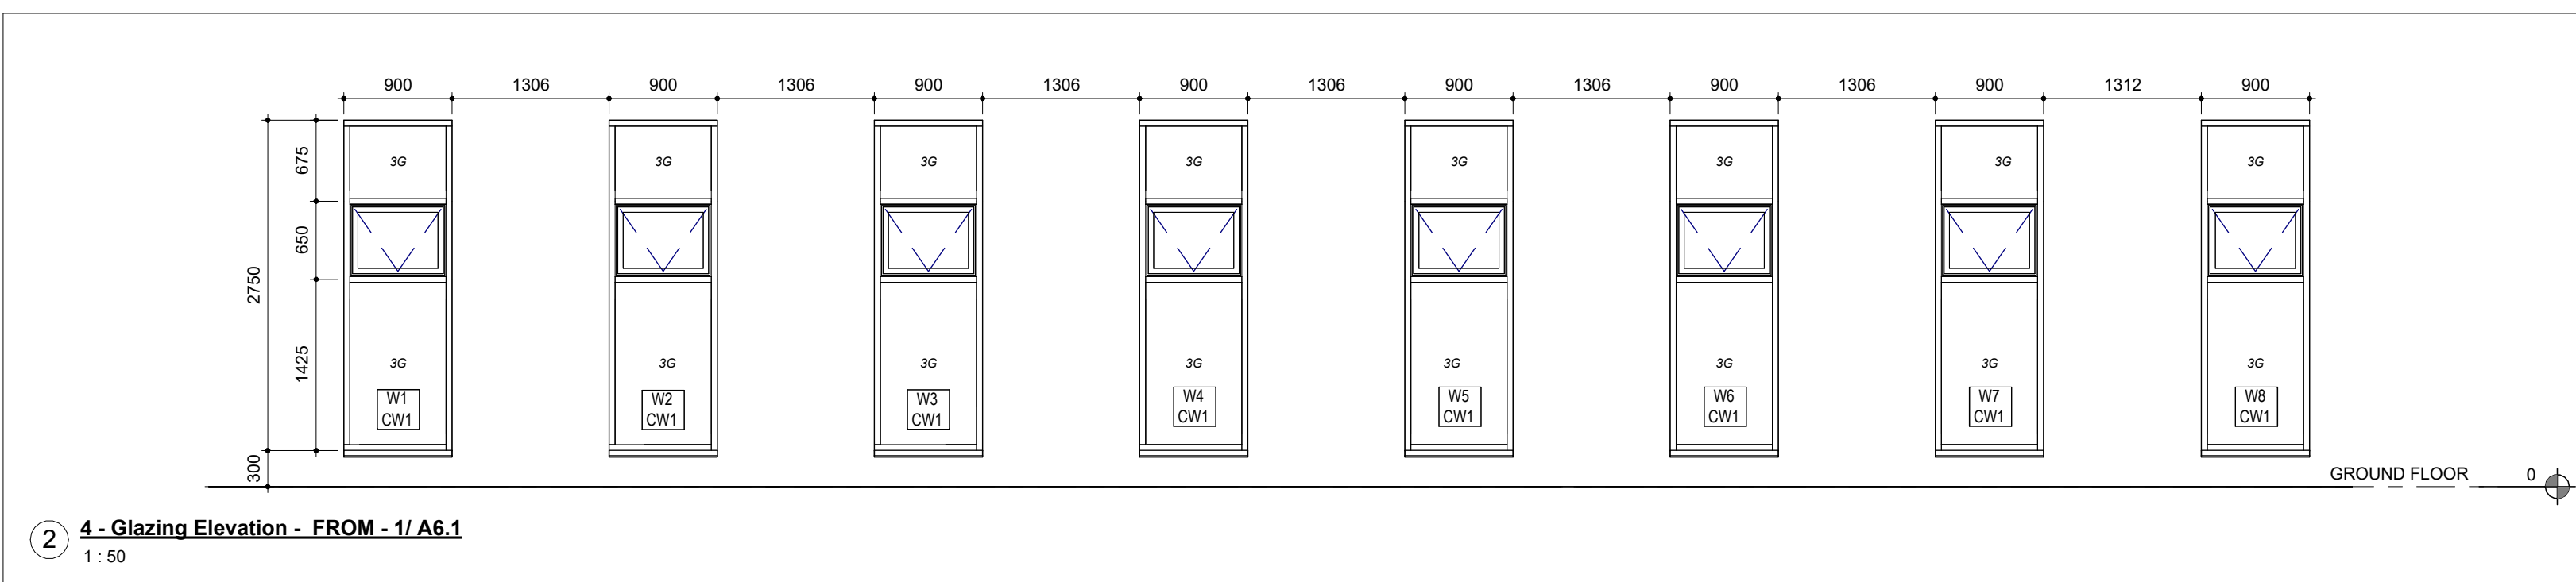


3 4 - Glazing Elevation - FROM - 1/ A6.1
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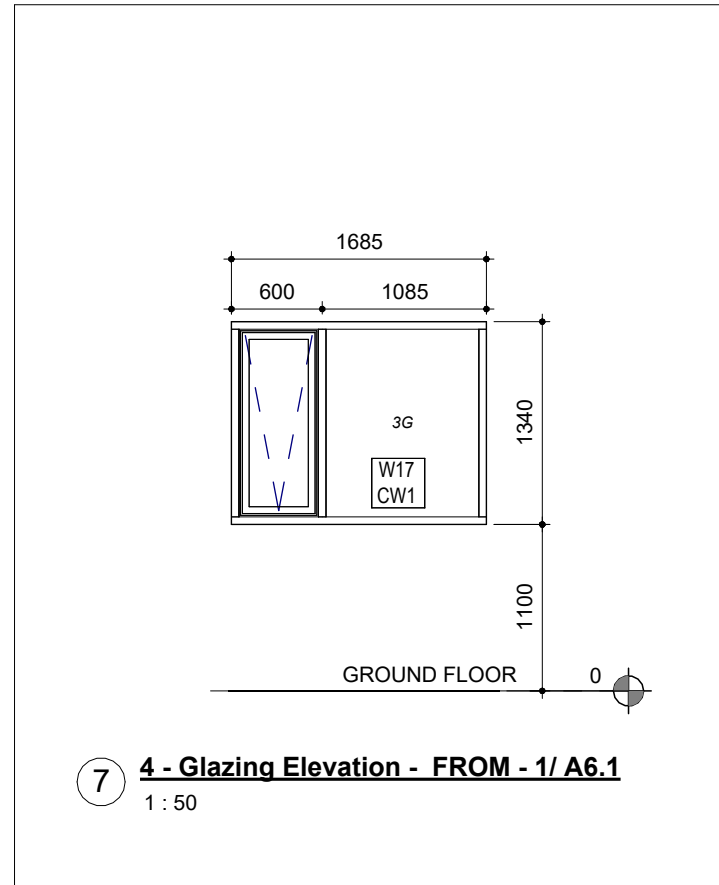
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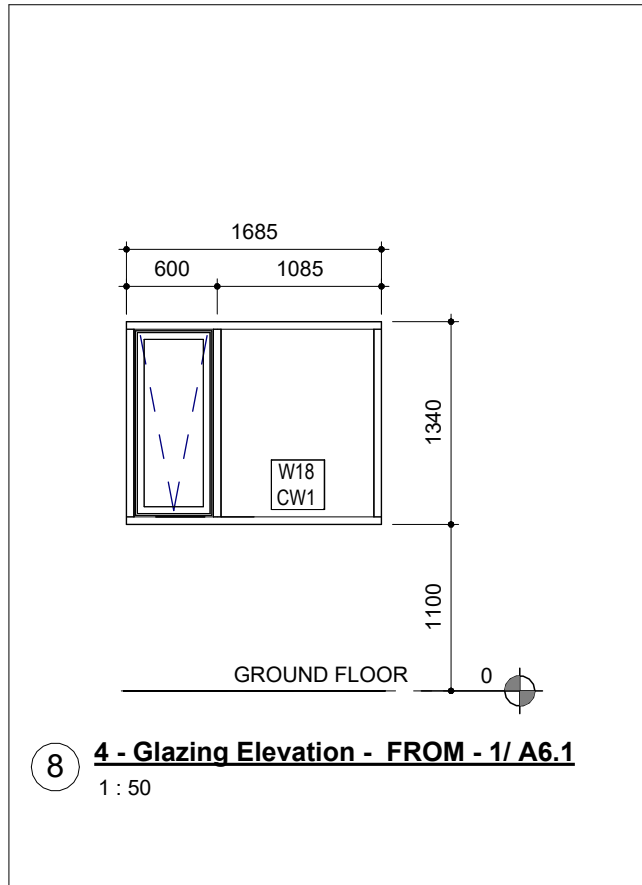
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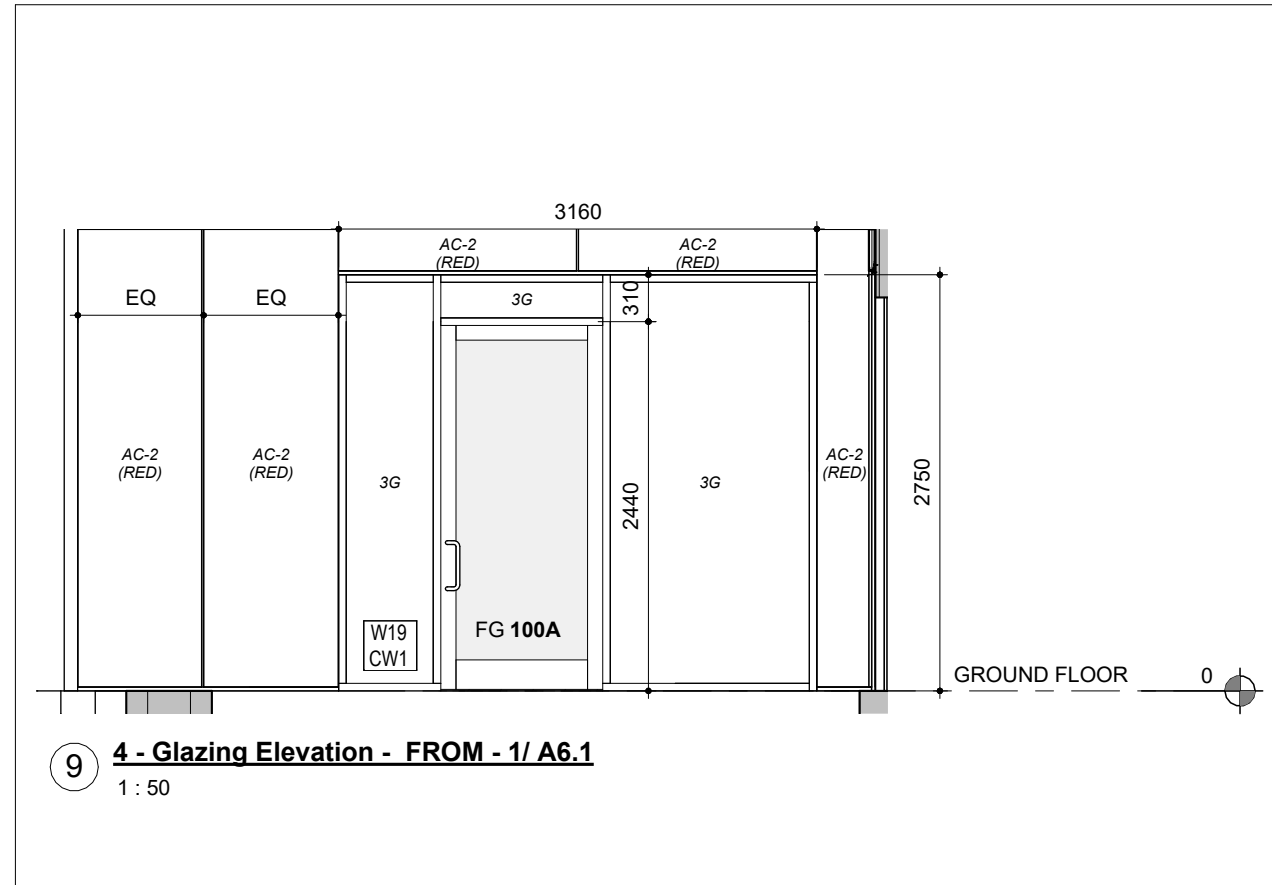
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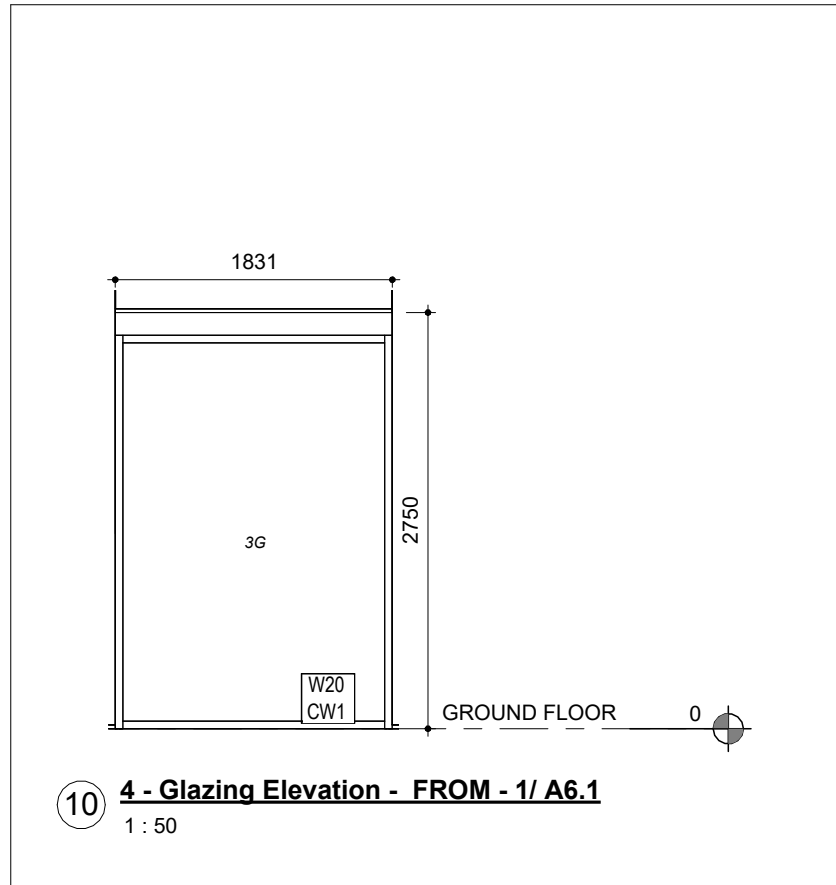
7 4 - Glazing Elevation - FROM - 1/ A6.1
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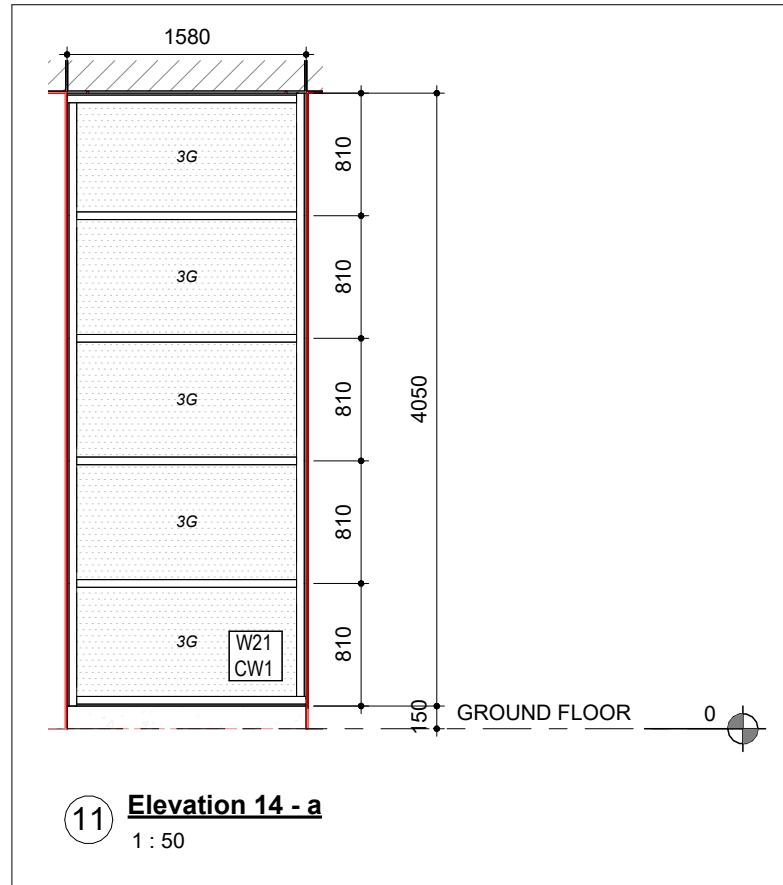
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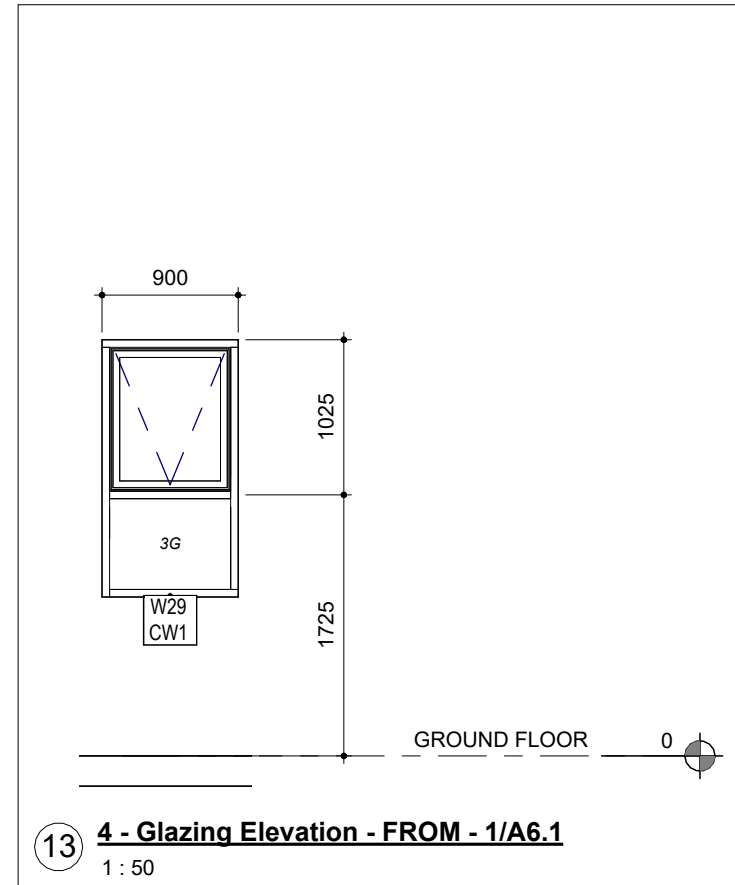
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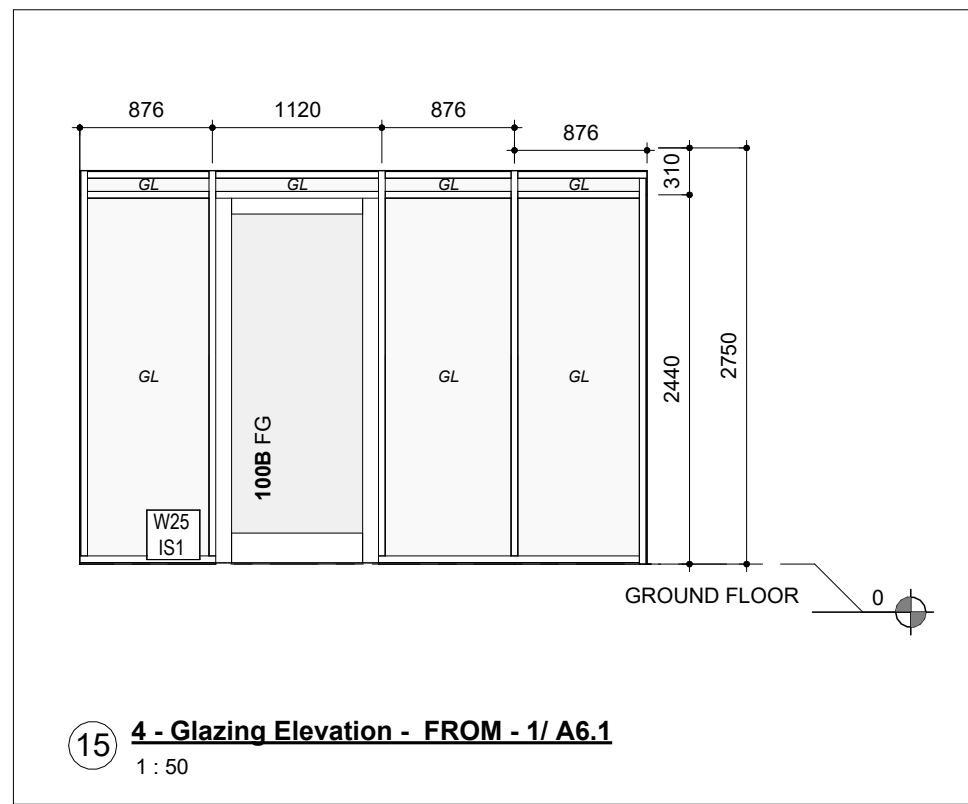
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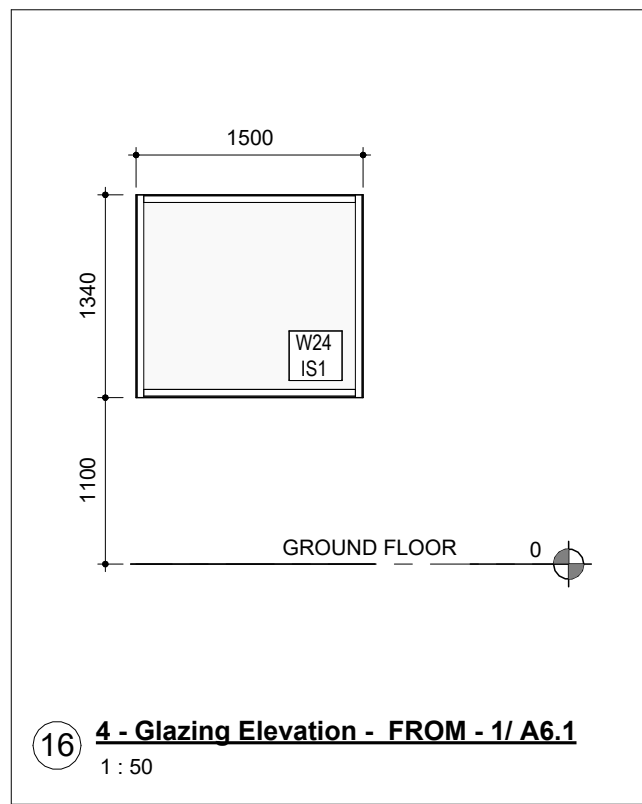
11 Elevation 14 - a
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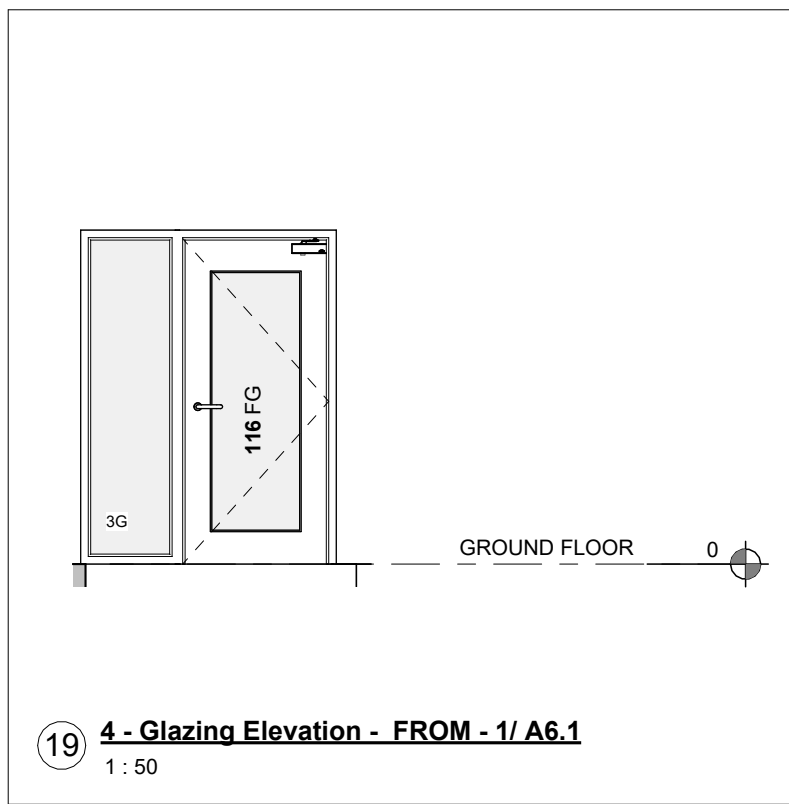
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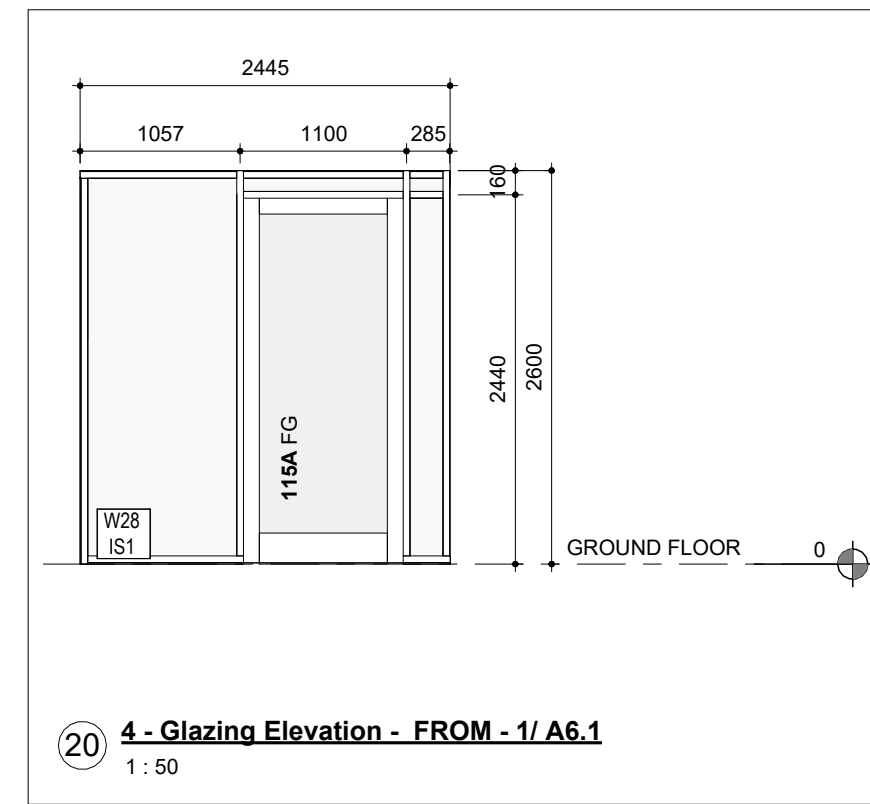
15 4 - Glazing Elevation - FROM - 1/ A6.1
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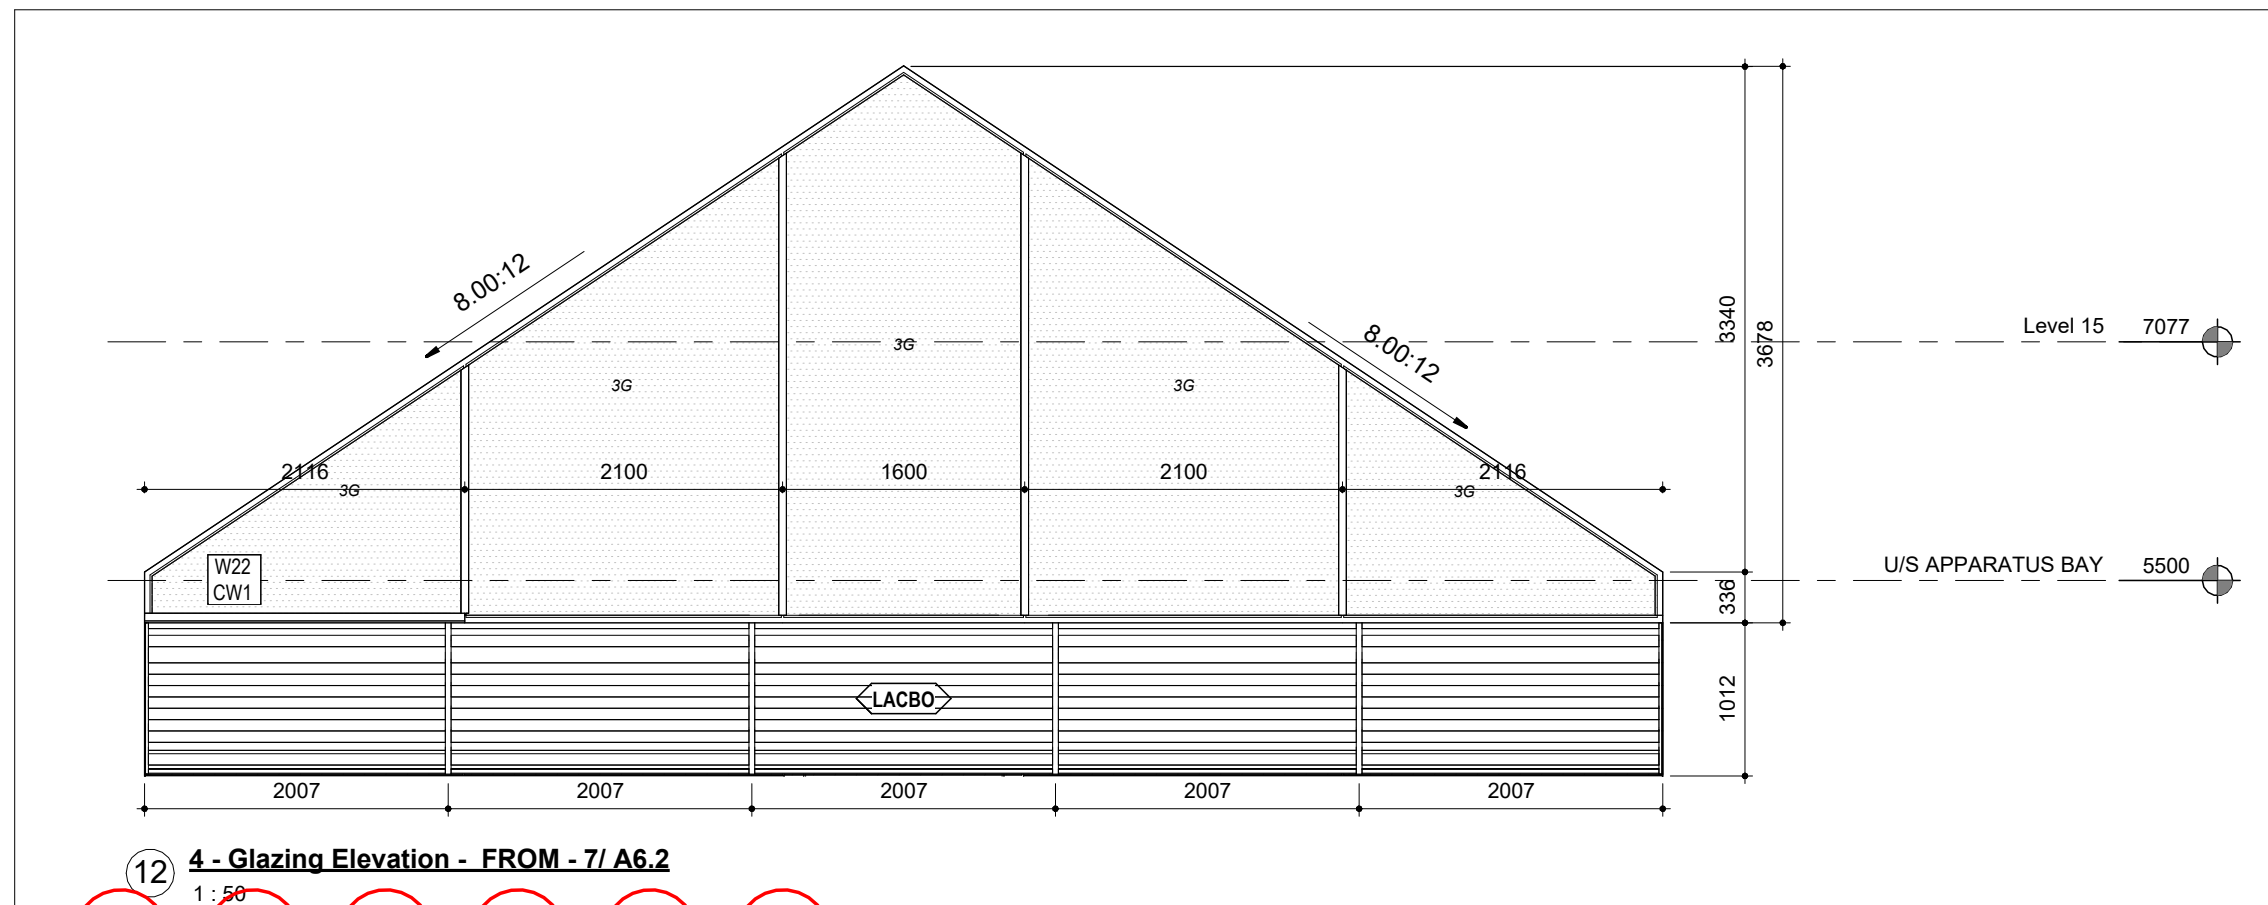
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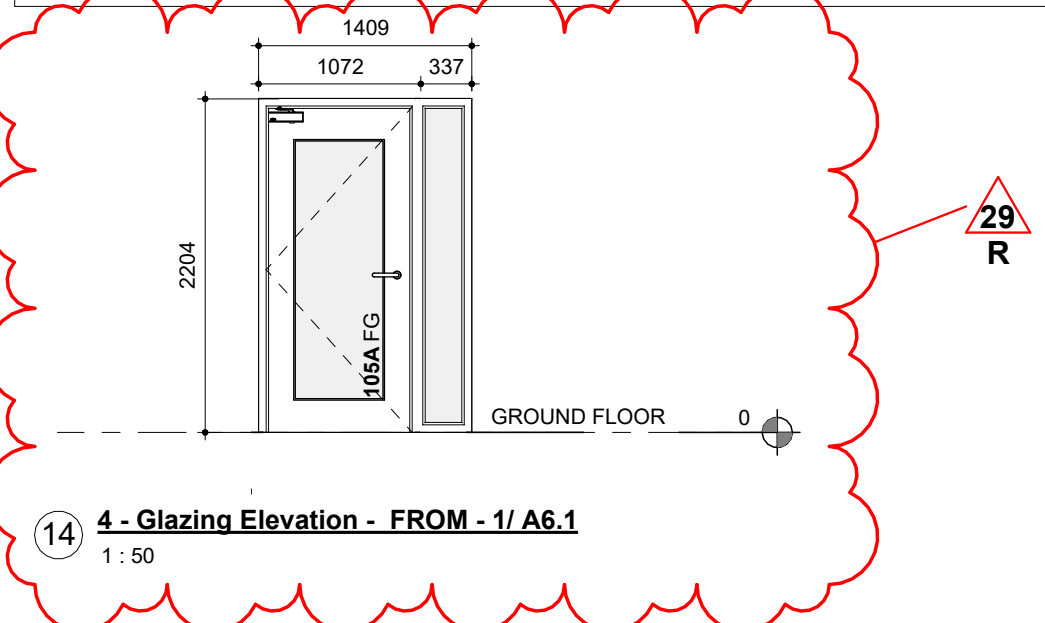
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1: 50

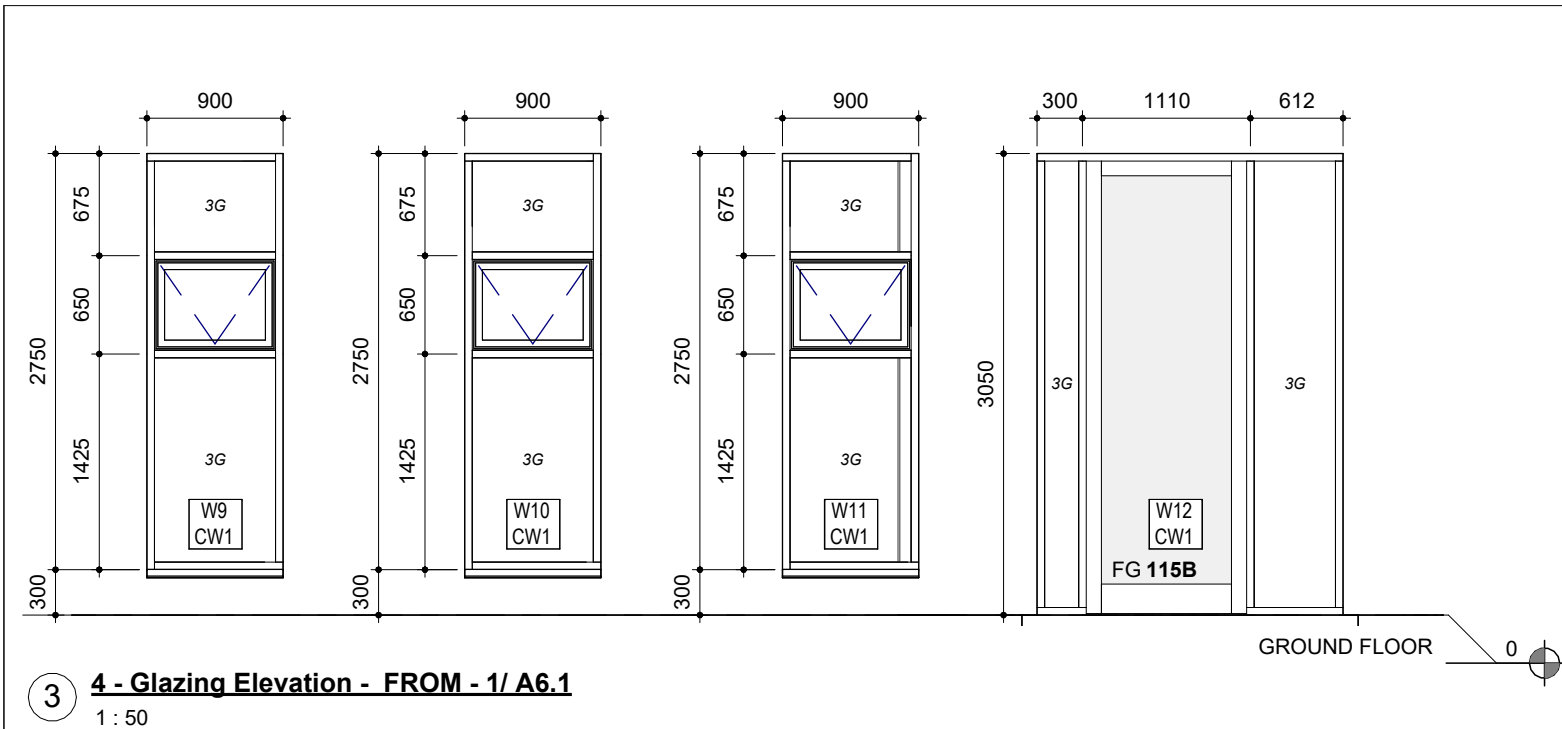

20 4 - Glazing Elevation - FROM - 1/ A6.1
1: 50

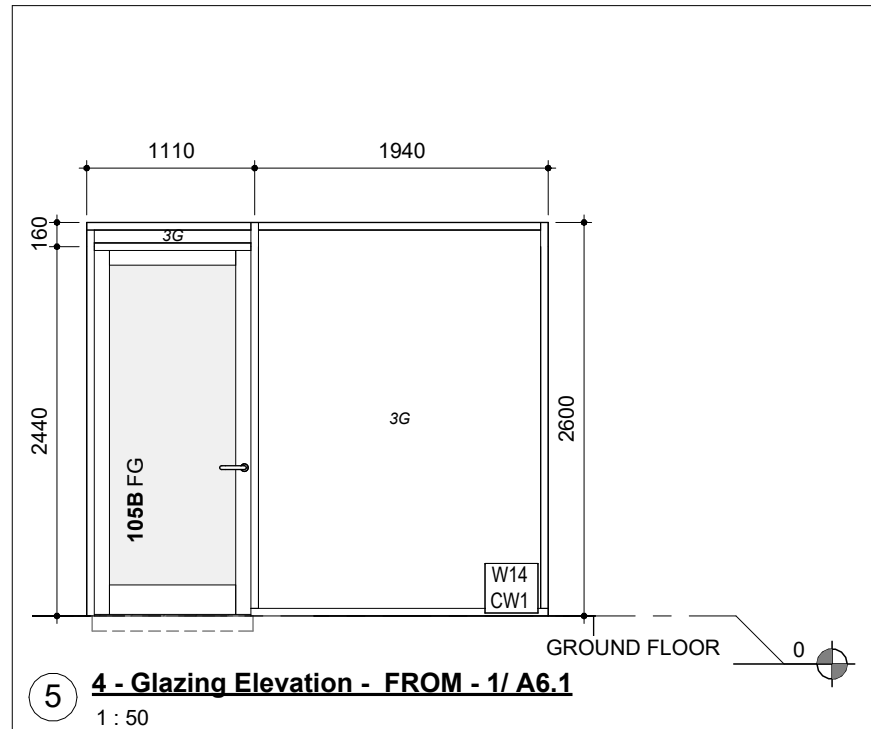


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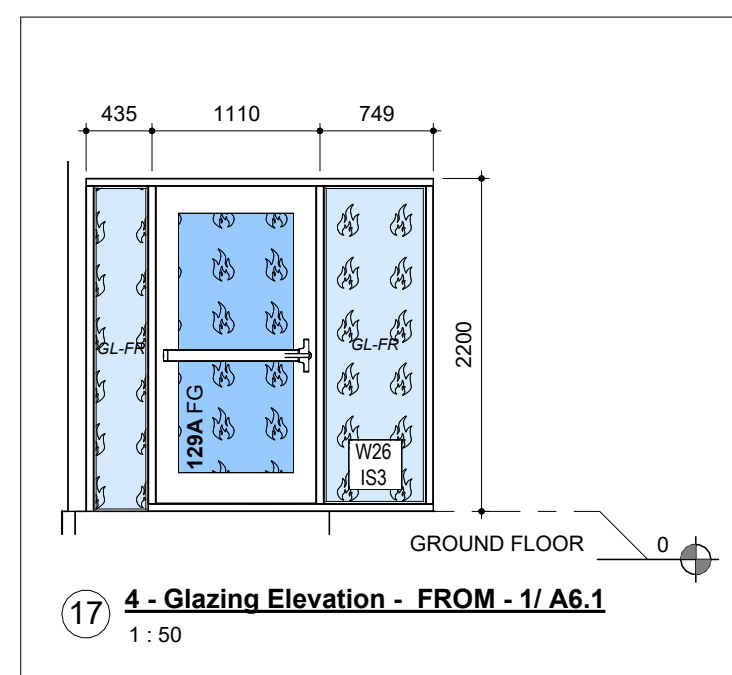
14 4 - Glazing Elevation - FROM - 1/ A6.1
1: 50

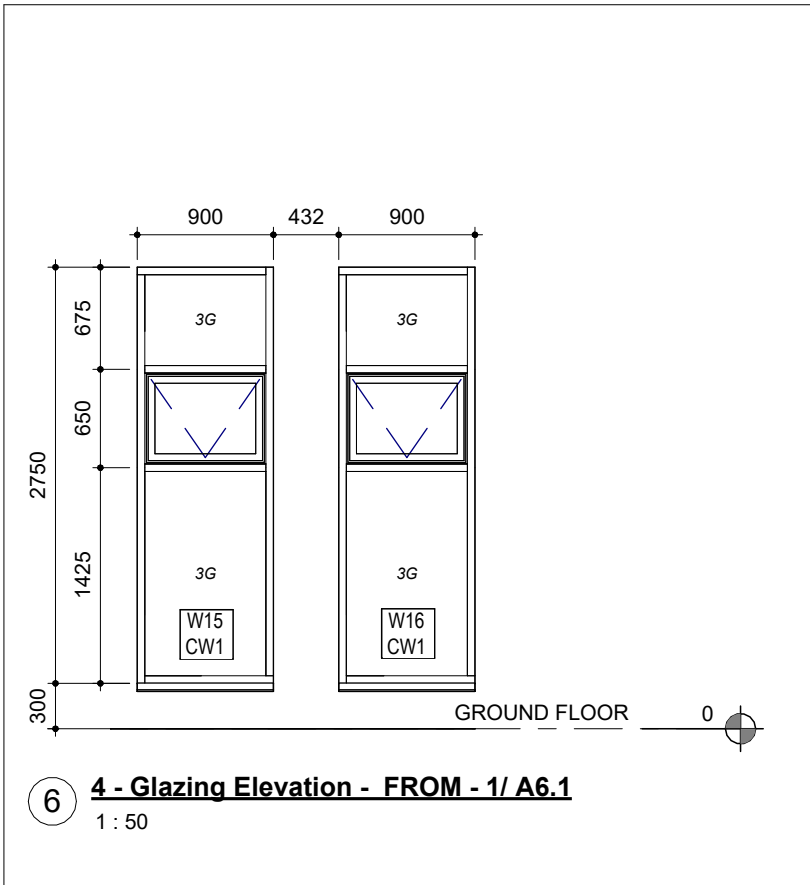S-04 - Schedule - Window - Basis of Design


TYPE	SPECIFIED BASIS OF DESIGN
W1	ALUMICOR TW2200 OR EQUIVALENT
W2	ALUMICOR TW2200 OR EQUIVALENT
W3	ALUMICOR TW2200 OR EQUIVALENT
W4	ALUMICOR TW2200 OR EQUIVALENT
W5	ALUMICOR TW2200 OR EQUIVALENT
W6	ALUMICOR TW2200 OR EQUIVALENT
W7	ALUMICOR TW2200 OR EQUIVALENT
W8	ALUMICOR TW2200 OR EQUIVALENT
W9	ALUMICOR TW2200 OR EQUIVALENT
W10	ALUMICOR TW2200 OR EQUIVALENT
W11	ALUMICOR TW2200 OR EQUIVALENT
W12	ALUMICOR TW2200 OR EQUIVALENT
W13	ALUMICOR TW2200 OR EQUIVALENT
W14	ALUMICOR TW2200 OR EQUIVALENT
W15	ALUMICOR TW2200 OR EQUIVALENT
W16	ALUMICOR TW2200 OR EQUIVALENT
W17	ALUMICOR TW2200 OR EQUIVALENT
W18	ALUMICOR TW2200 OR EQUIVALENT
W19	ALUMICOR TW2200 OR EQUIVALENT
W20	ALUMICOR TW2200 OR EQUIVALENT
W21	ALUMICOR TW2200 OR EQUIVALENT
W22	ALUMICOR TW2200 OR EQUIVALENT
W24	BASIS OF DESIGN KAWNEER 451 OR EQUIVALENT
W25	BASIS OF DESIGN KAWNEER 451 OR EQUIVALENT
W26	BASIS OF DESIGN FLEMING TYPE 'D' FRAME OR EQUIVALENT
W27	BASIS OF DESIGN FLEMING TYPE 'D' FRAME OR EQUIVALENT
W28	BASIS OF DESIGN KAWNEER 451 OR EQUIVALENT
W29	ALUMICOR TW2200 OR EQUIVALENT
W30	ALUMICOR TW2200 OR EQUIVALENT




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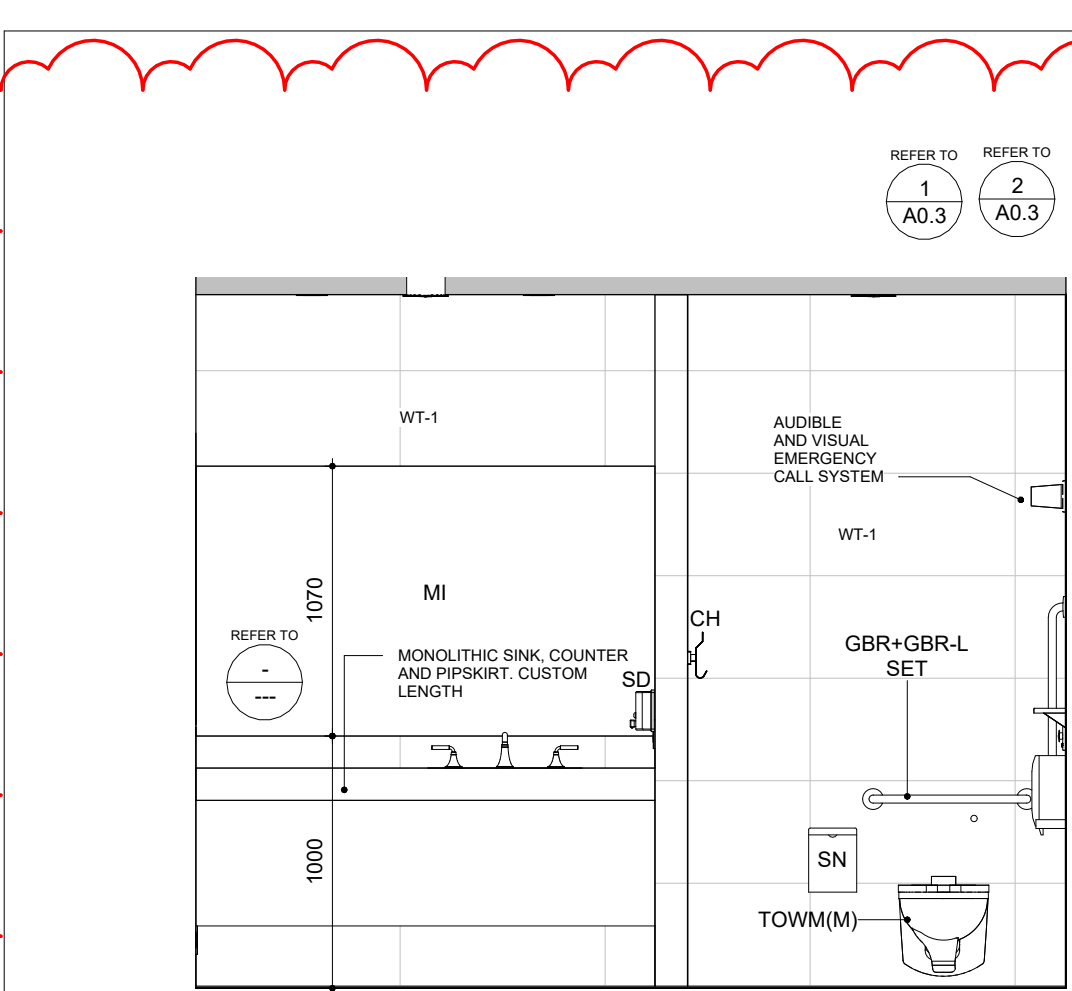
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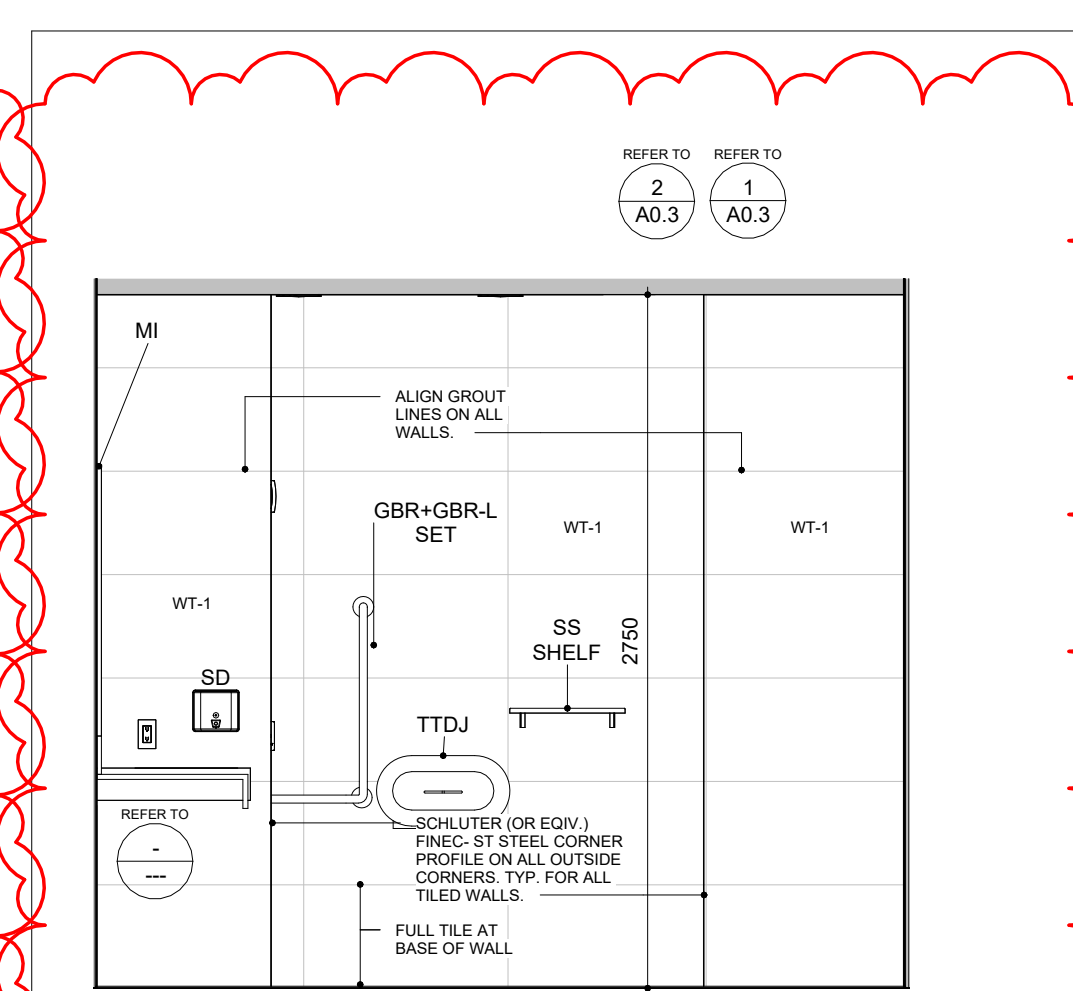
2 - Floor Plans - FROM - 5/ A3.3
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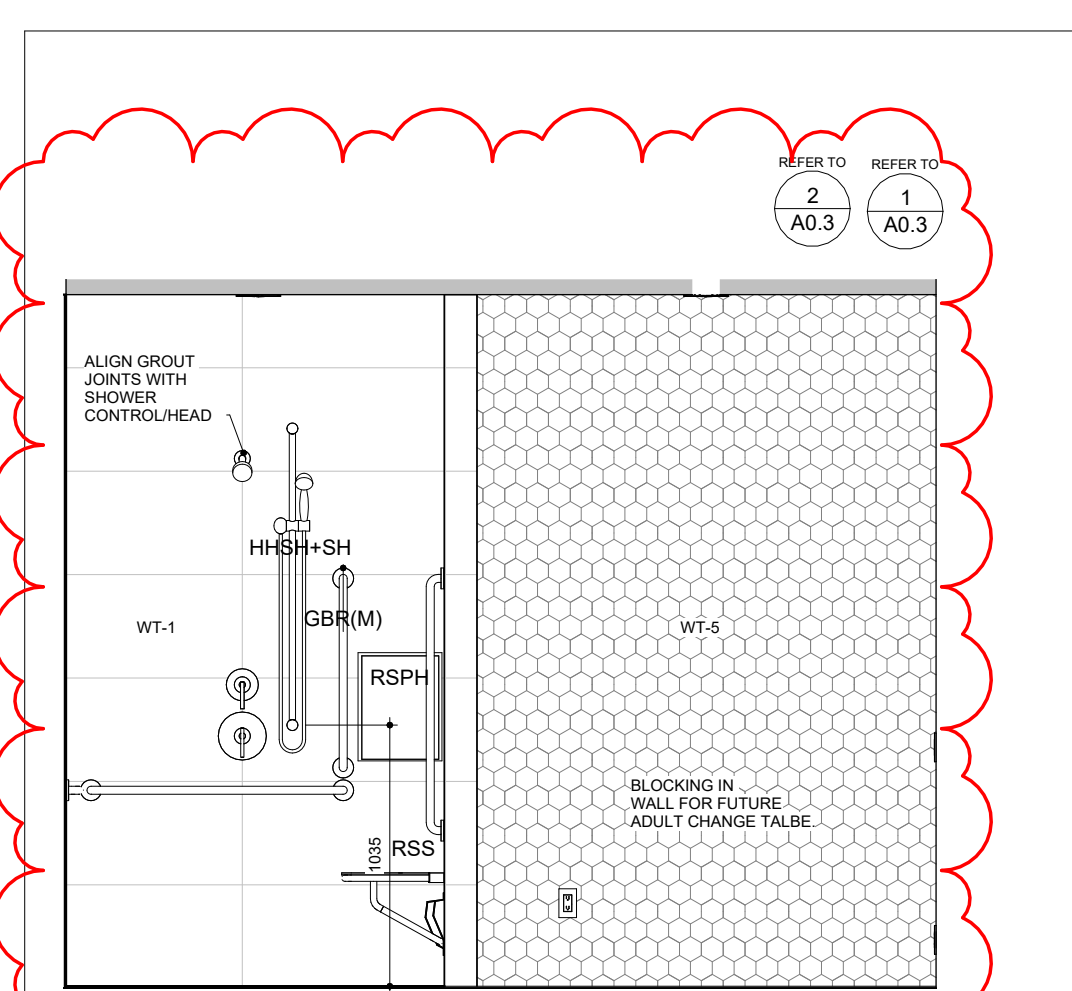
2 - Floor Plans -
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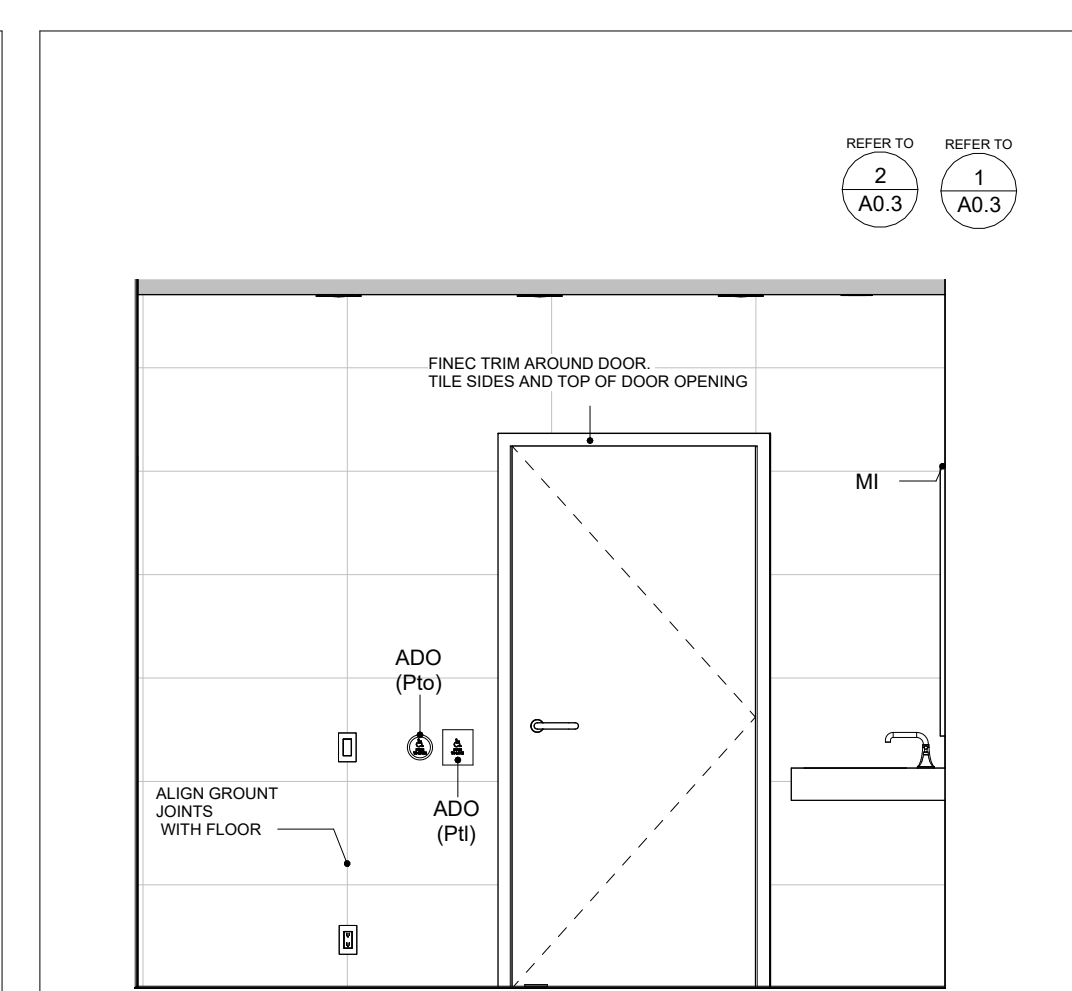
6 - Interior Elevation - FROM - 1/ A12.1
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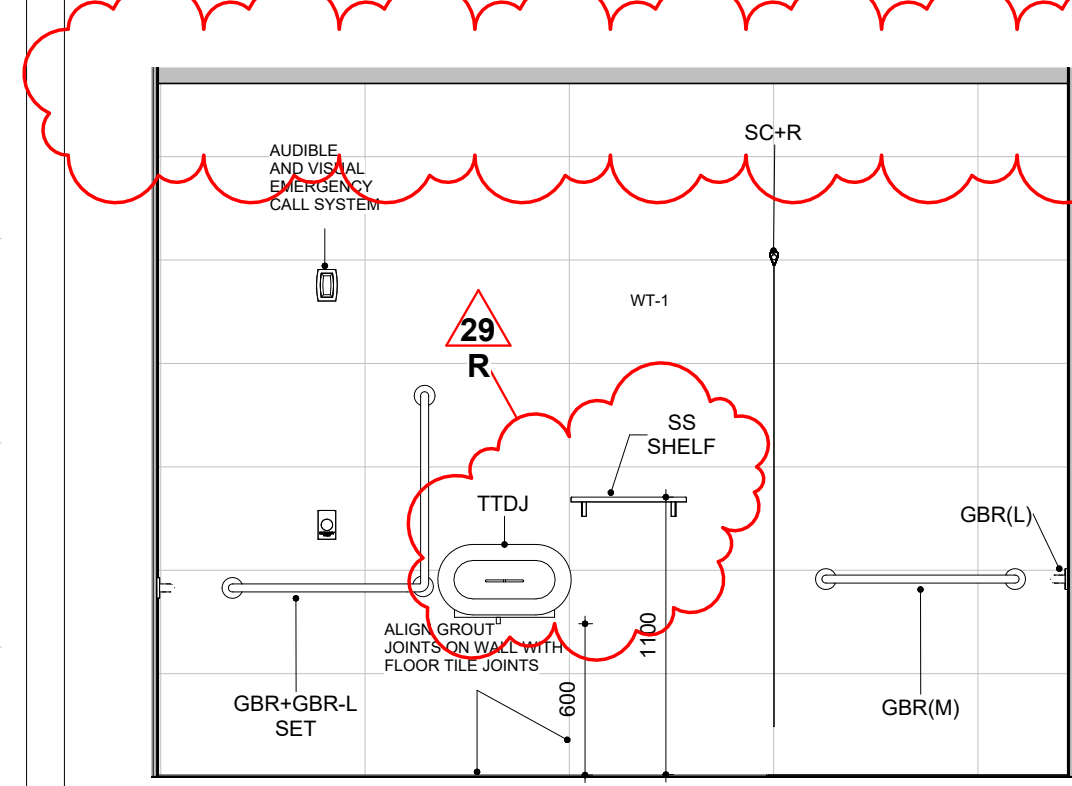
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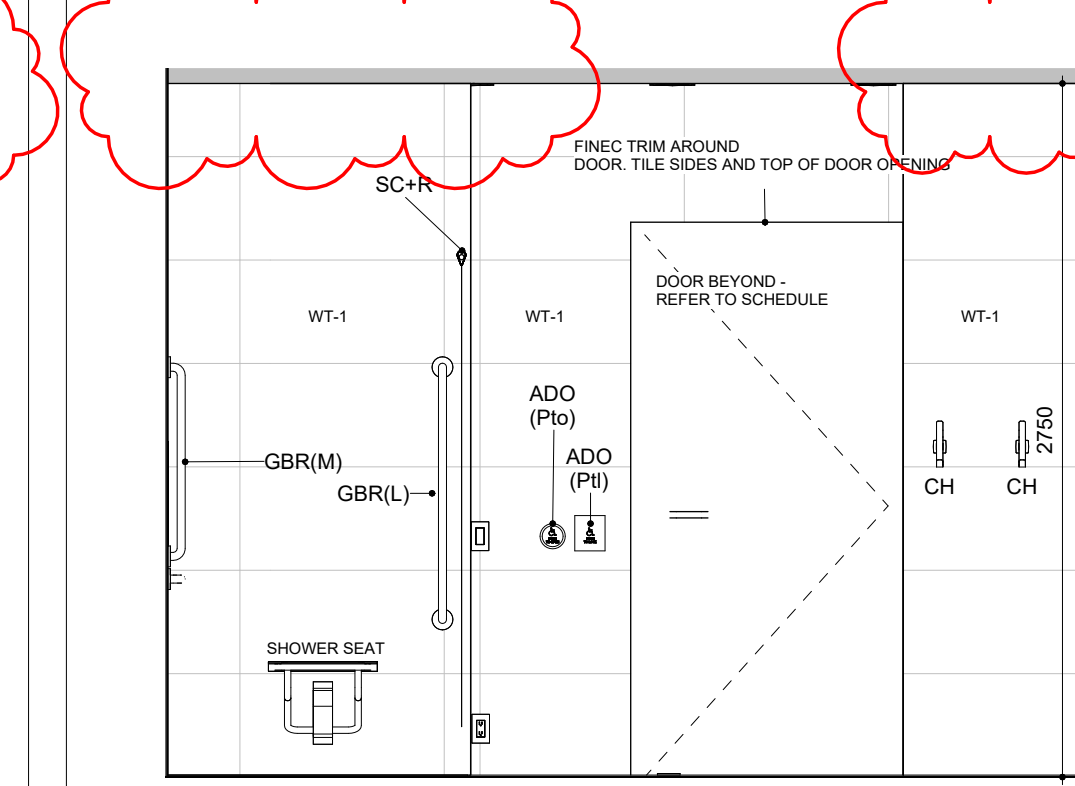
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6 - Interior Elevation - FROM - 1/ A12.1
1:30

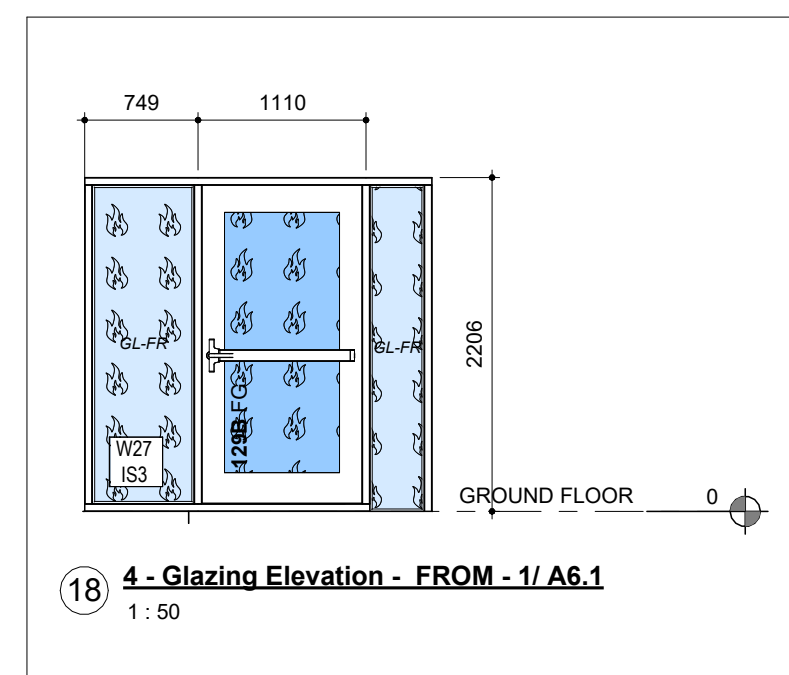


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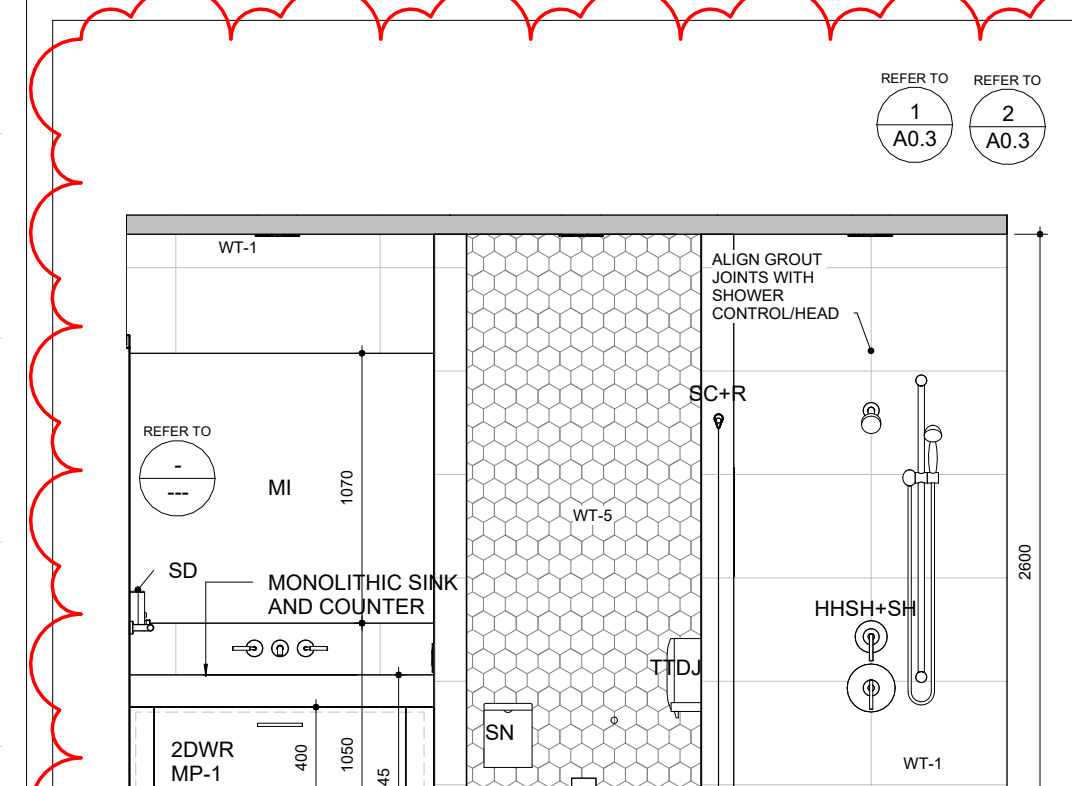
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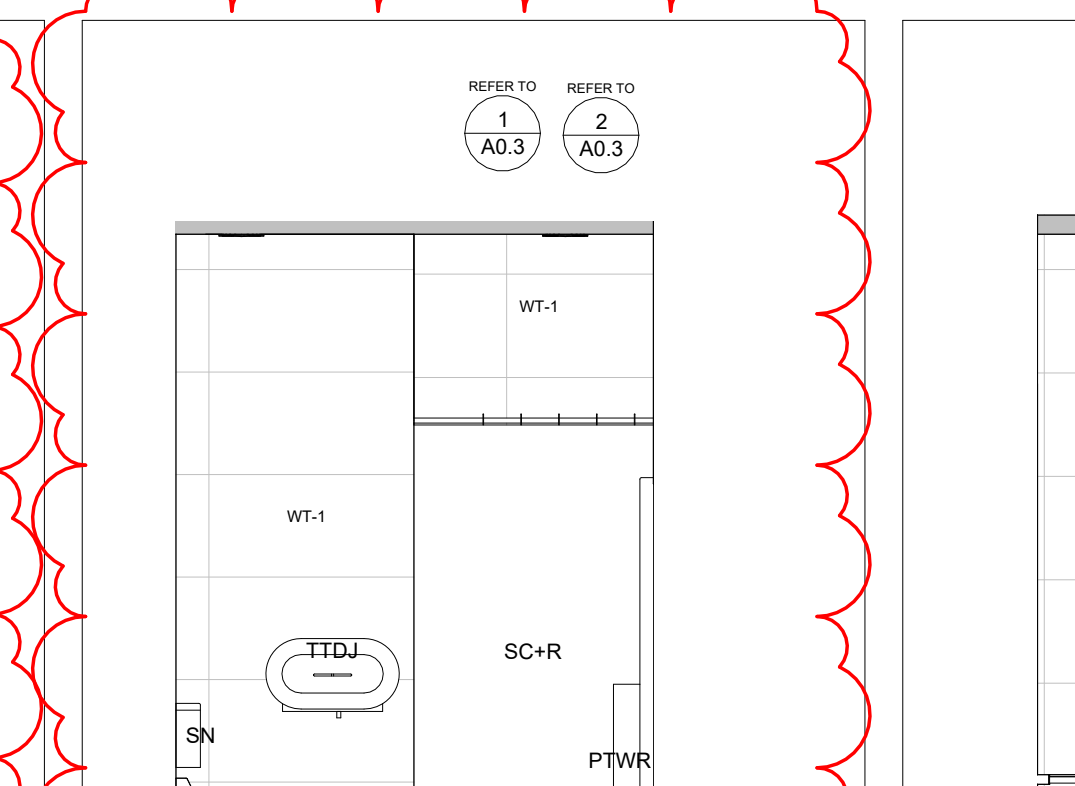
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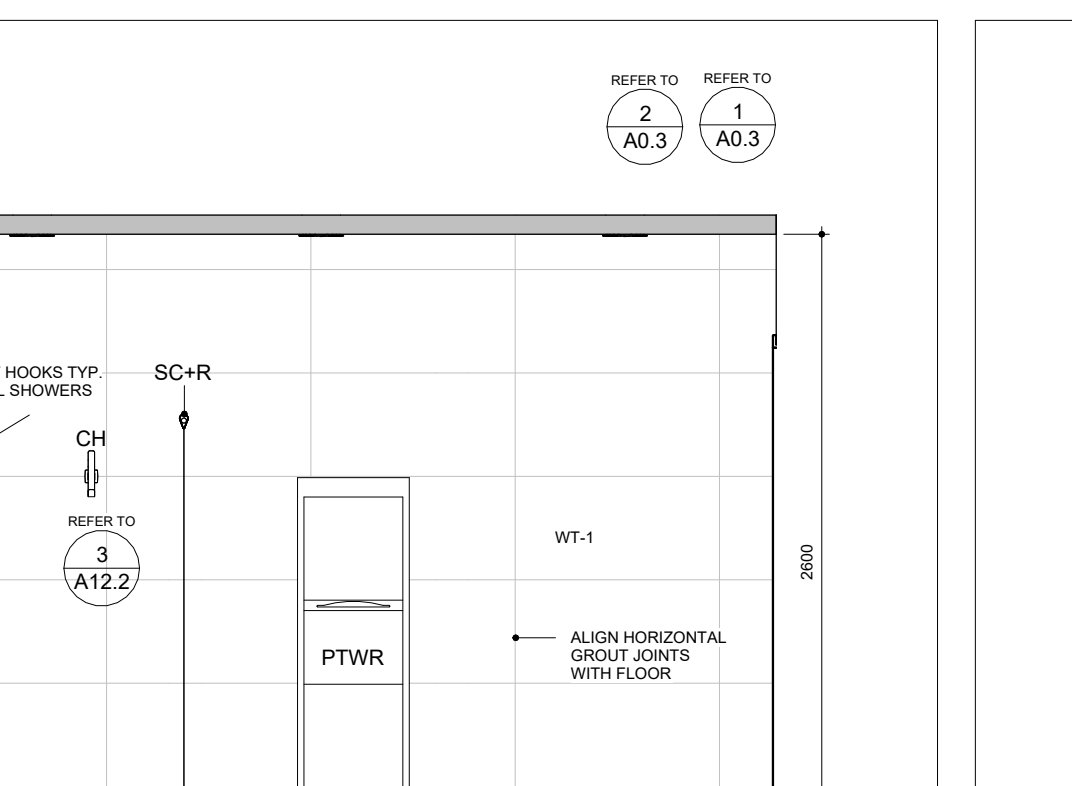
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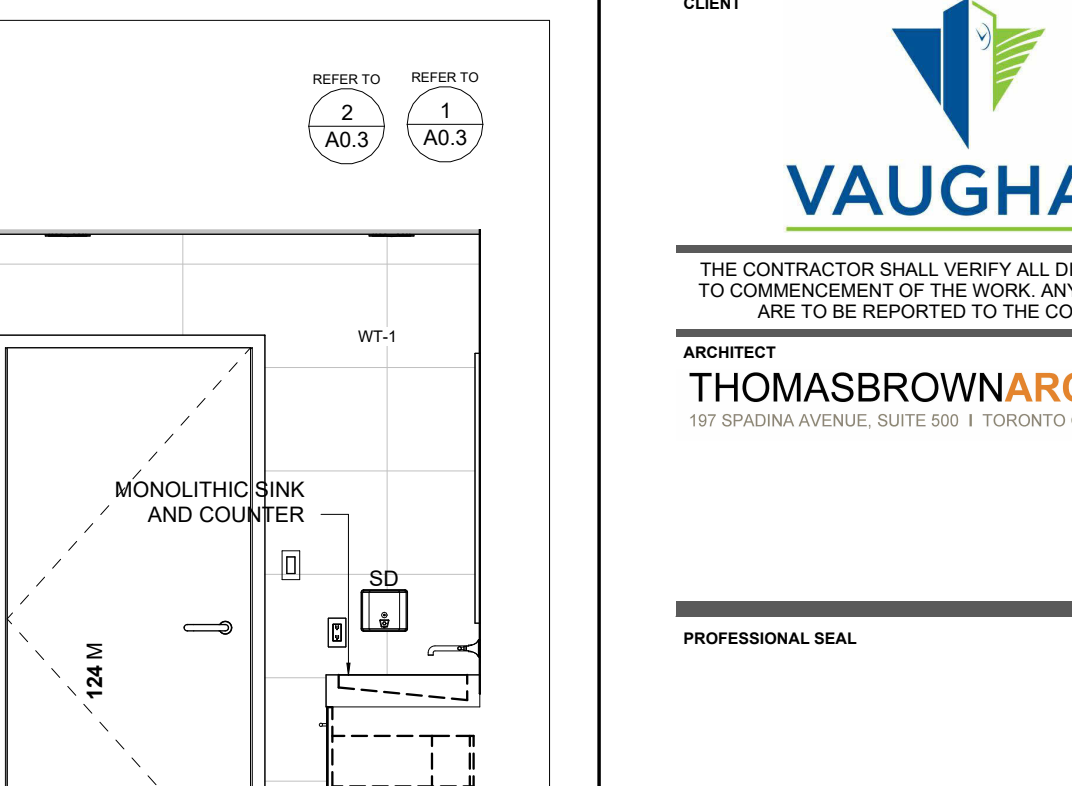
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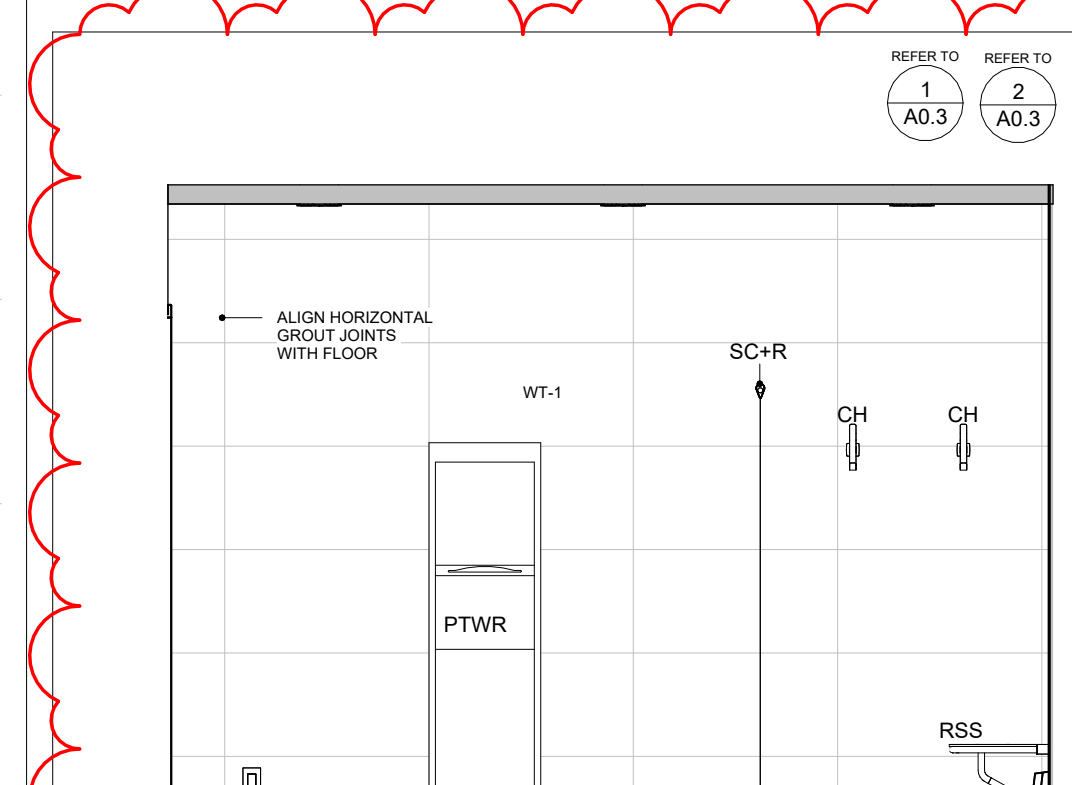
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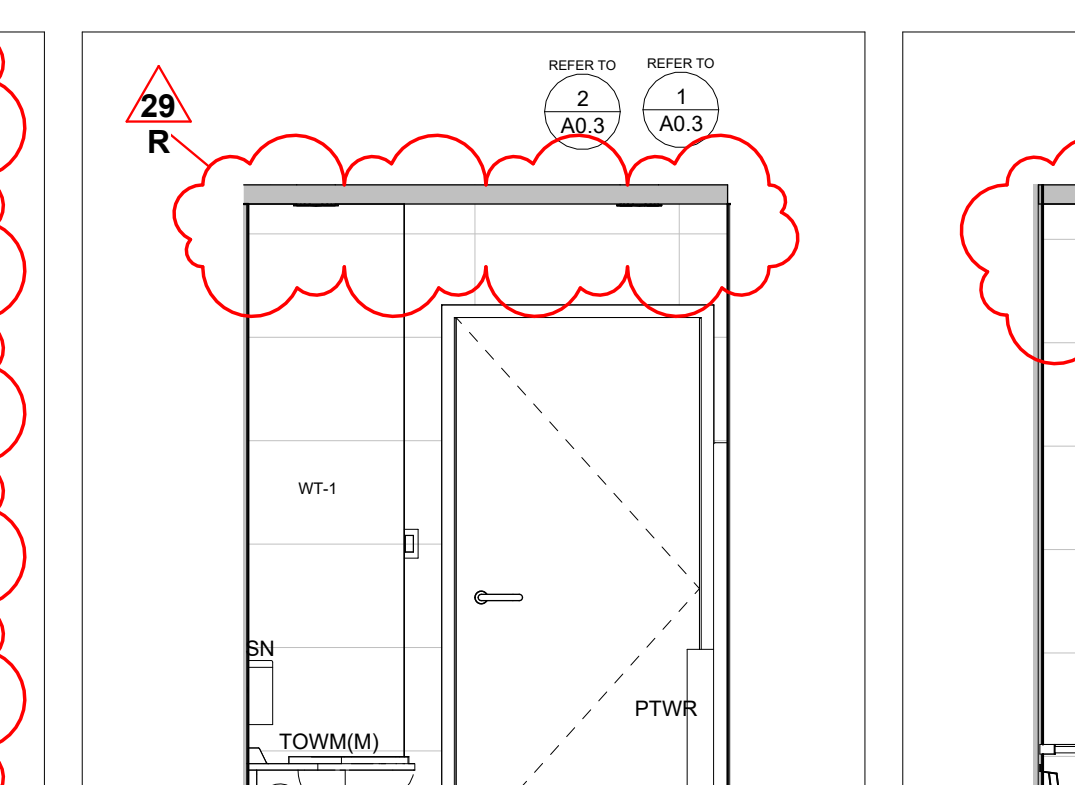
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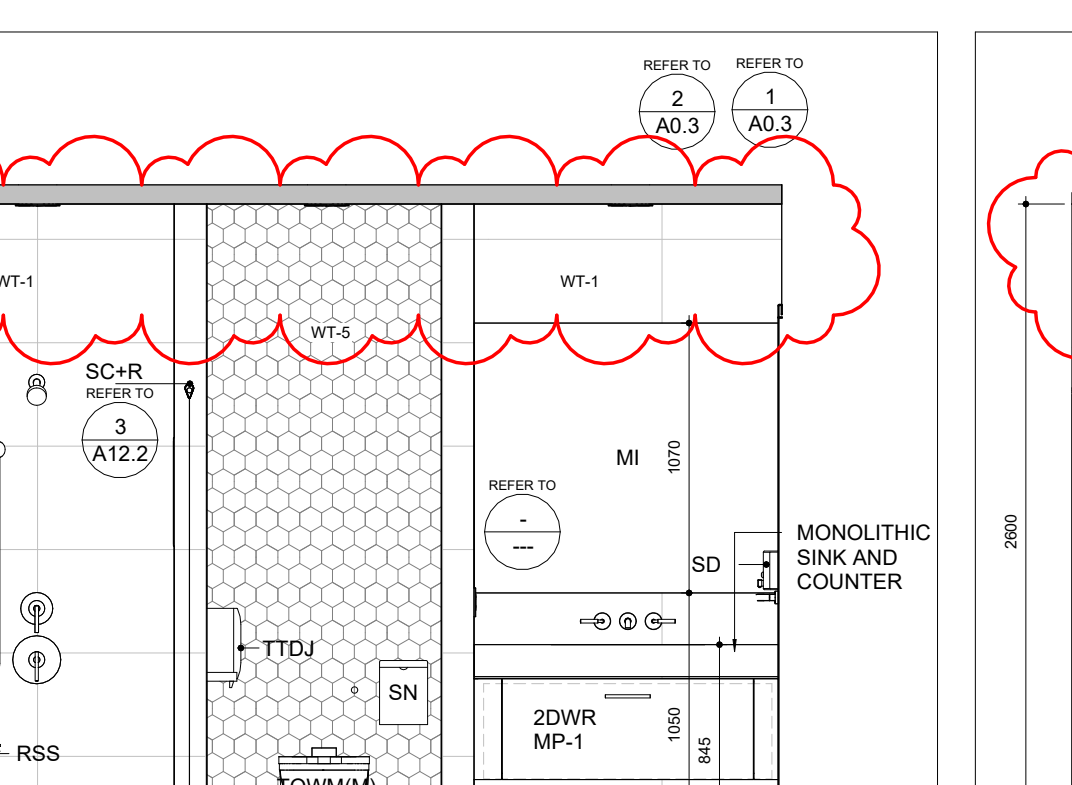
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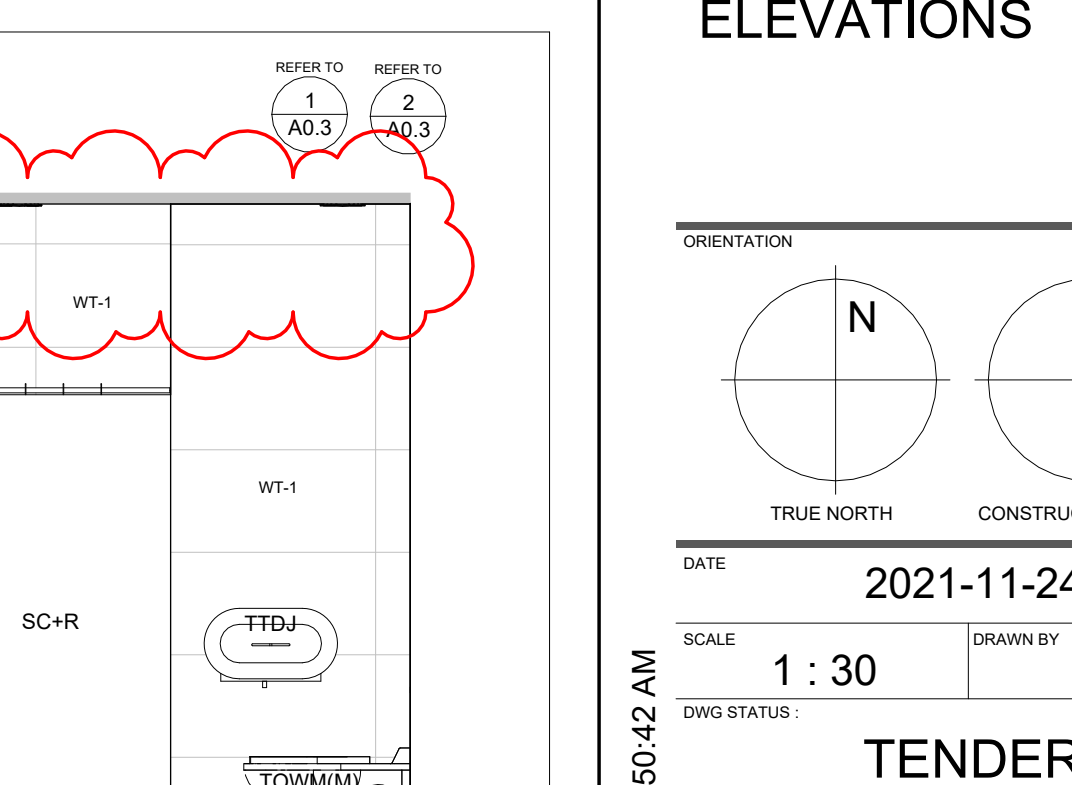
6 - Interior Elevation - FROM - 7/ A12.1
1:30

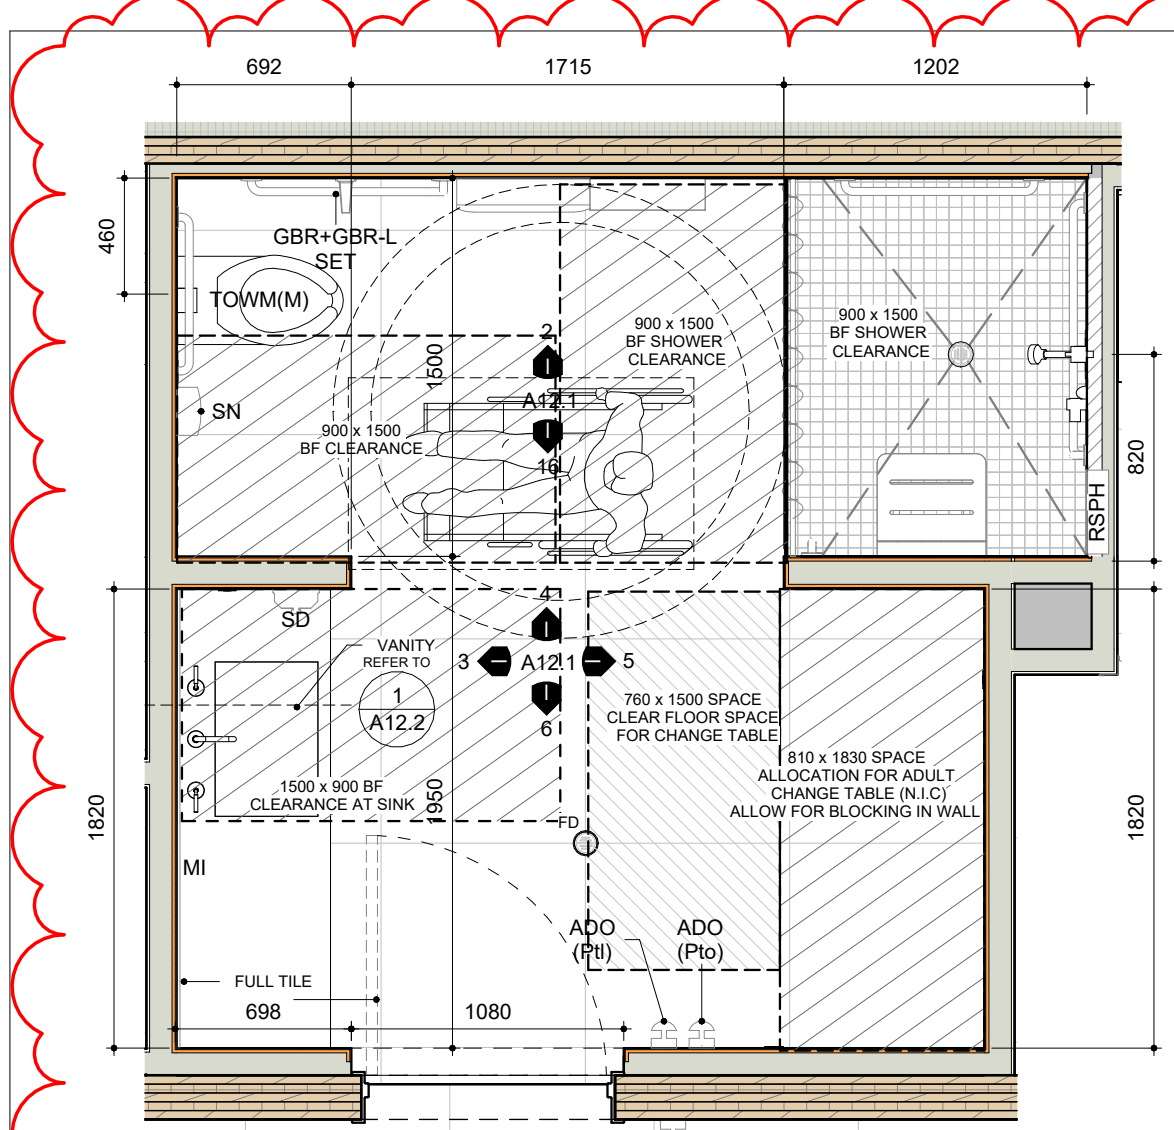

6 - Interior Elevation - FROM - 7/ A12.1
1:30

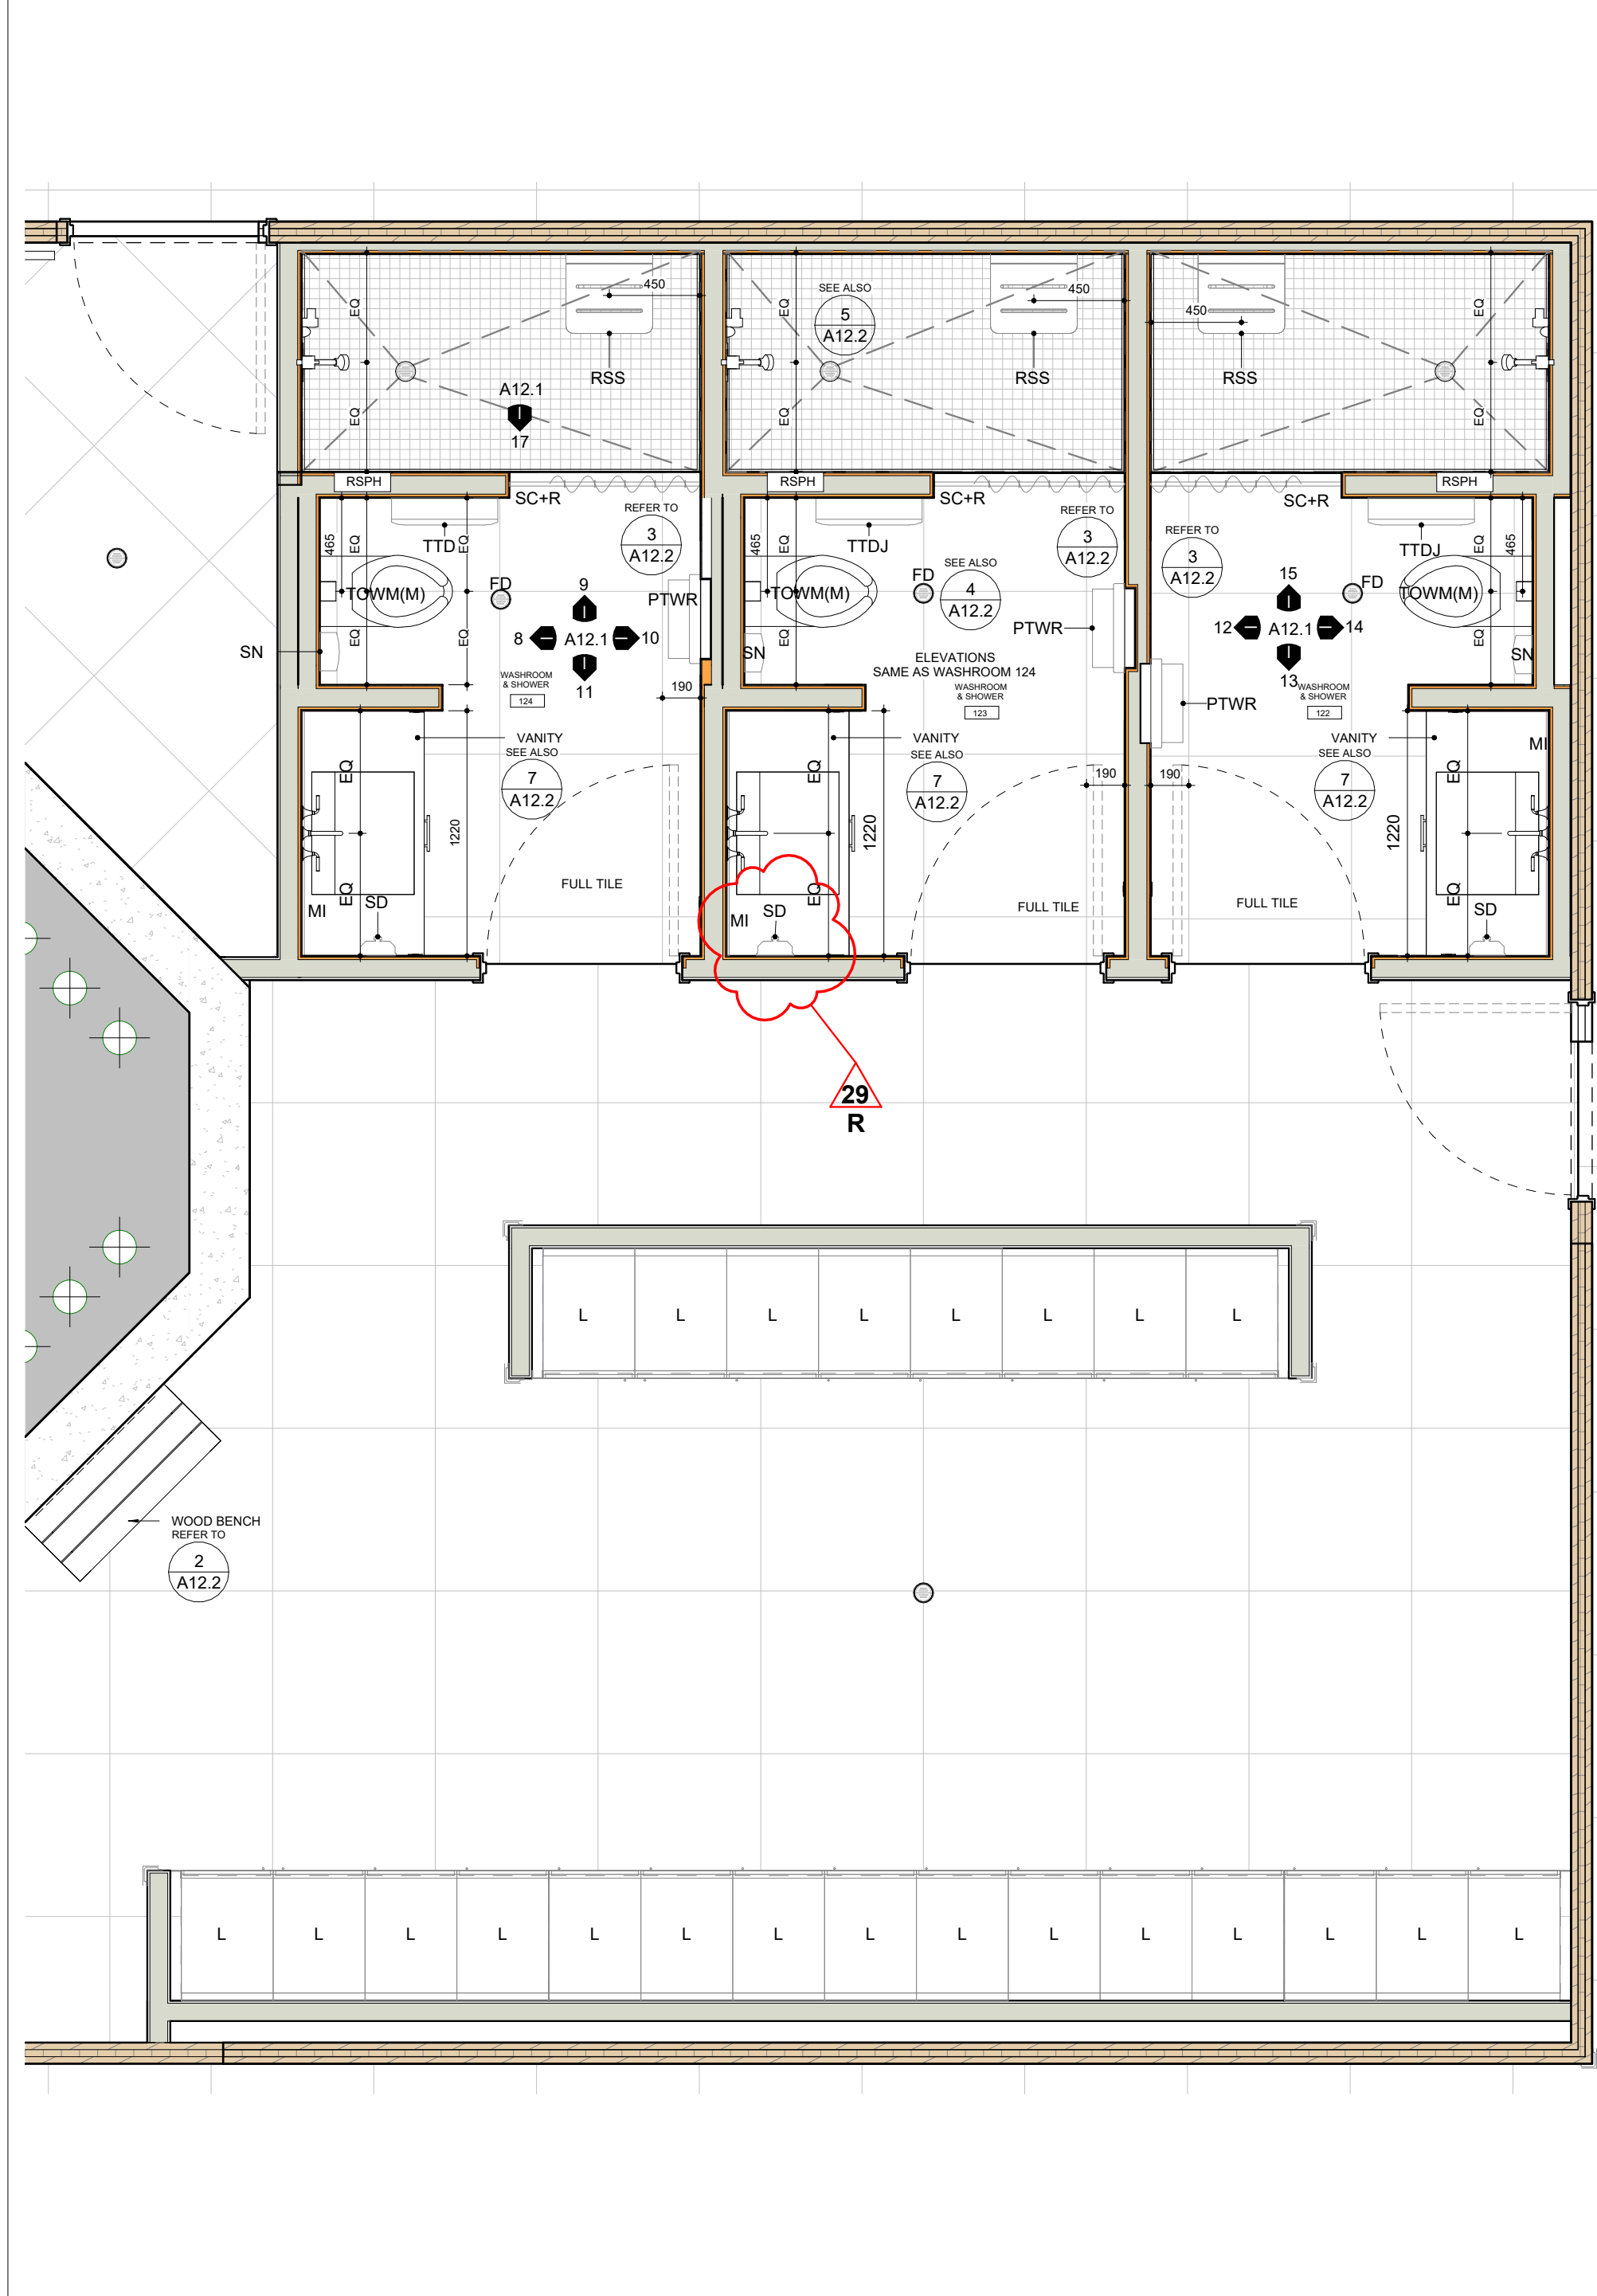

6 - Interior Elevation - FROM - 7/ A12.1
1:30

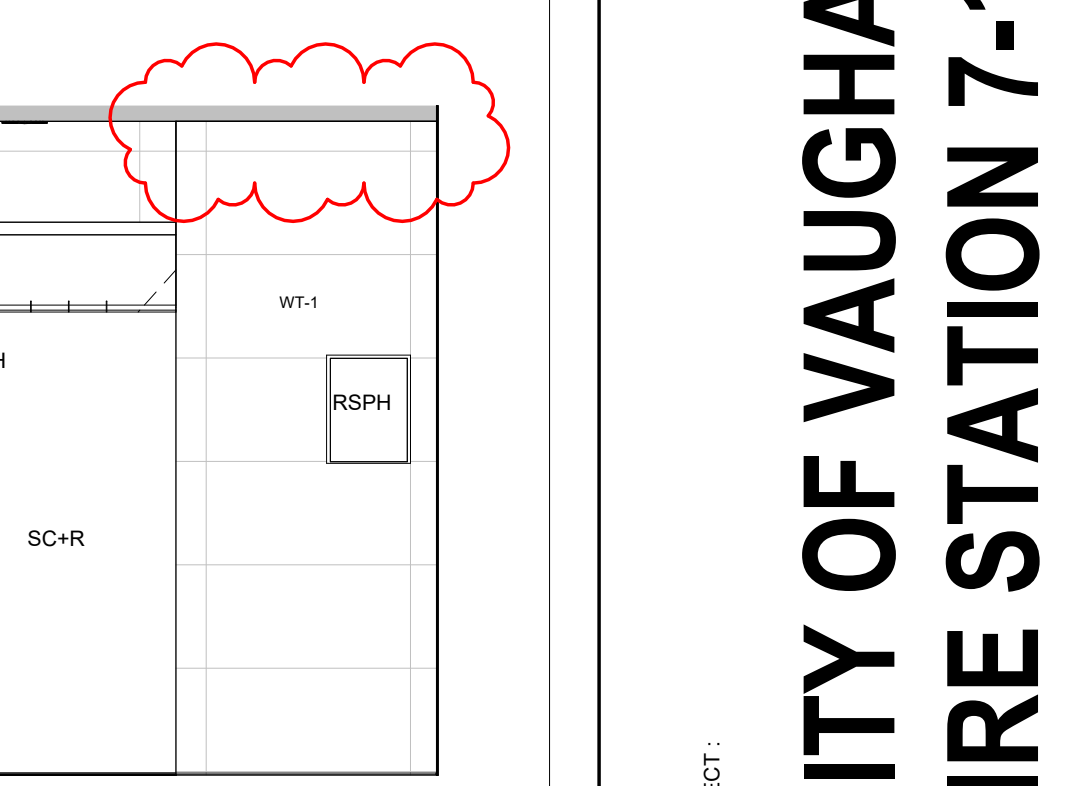

6 - Interior Elevation - FROM - 7/ A12.1
1:30

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THOMAS BROWN ARCHITECT INC.
AND MUST BE RETURNED UPON COMPLETION OF THE WORK.

ISSUE OR REVISION		
NO.	ISSUED FOR	DATE
17	SPA - REVISION	2023-08-30
18	ISSUED FOR PERMIT	2023-09-15
19	ISSUED FOR RFPQ	2023-10-19
24	ISSUED FOR CLASS A	2024-02-16
26	124-253 - JET	2024-04-15
29	ADDENDUM #4	2024-05-30



FILE NO. SP.22.V.0191

CITY OF VAUGHAN FIRE STATION 7-12

9511 WESTON ROAD, VAUGHAN

PROJECT :

CLIENT :


VAUGHAN

THE CONTRACTOR SHALL VERIFY ALL DIMENSIONS PRIOR TO COMMENCEMENT OF THE WORK. ANY DISCREPANCIES ARE TO BE REPORTED TO THE CONSULTANT.

ARCHITECT
THOMASBROWNARCHITECTS
197 SPADINA AVENUE, SUITE 500 | TORONTO ONTARIO | M5T 2C8

PROFESSIONAL SEAL

DWG TITLE WASHROOM PLAN & ELEVATIONS

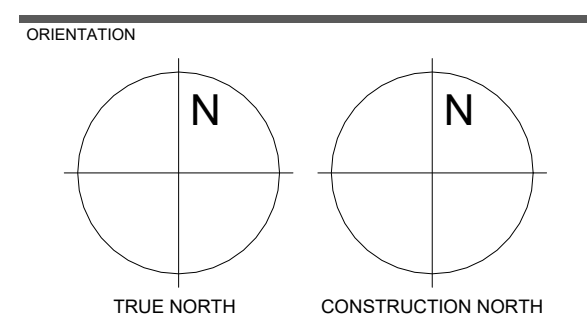

DATE	2021-11-24
SCALE	1:30
DWG STATUS:	TENDER
PROJECT No.	2104
DRAWING No.	A12.1
REVISION	29

DRAWN BY: SRL