

ARCHITECTURAL ADDENDUM No. 1

Project:	SHN Dialysis Care Unit	Project / File No:	240065
Project Address:	SHN General Hospital 3050 Lawrence Ave E Scarborough, ON, Canada	Date:	June 12, 2024
		Total No. of pages including attachments and cover:	38 Pages

This Addendum shall form part of, and be included in, the contract drawings and specifications originally issued for the above-named project and no consideration will be given to request for extras to this Contract due to the Contractor not being familiar with the Addendum. Please acknowledge receipt of the Addendum on the Bid Form.

The following attached information forms part of this Addendum:

Item:	Description:	No of Pages:
1.0	General Requirements	--
2.0	Architectural Drawings	18
3.0	Architectural Specifications	12
4.0	FF&E – Bill of Quantity	3

Kasian Architecture Ontario Incorporated

Veronica Rodriguez, Senior Project Architect/Associate

June 7, 2024

Name and Title of Person Signing

Signature

Date

**KASIAN
ARCHITECTURE
ONTARIO
INCORPORATED**

TORONTO
85 Hanna Avenue
Suite 300
Toronto
Ontario
Canada M6K 3S3

t 416 583 3600
f 416 583 3610
www.kasian.com

Calgary
Edmonton
Toronto
Vancouver

Doha

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1.0 General Requirements – Nothing issued in this Addendum

2.0 Architectural Specifications

Reference Document 'Project Manual – Scarborough Health Network General Hospital Dialysis Care Unit

2.0.1 Specification Addendum 1 Added and Revised as noted

2.1 Architectural Drawings

2.1.1 Reference drawing COVER SHEET

Added A-511G to list of drawings

Revised sheet titleblock

Delete from drawing list the following drawings

A-102H ARCHIVE PHASING PLANS - LEVEL 2 copy 1

A-102PHASE DRAFT PHASING PLANS DRAFT - LEVEL 2

2.1.2 Reference drawing A-001G

Added prescribed access by the owner to the west wing from grade level.

Added 2 photographs showing location prescribed location at existing west wing entrance for work in west wing level 2

2.1.3 Reference drawing A-101G

Added note from A-001G for space at grade level for access to West Wing

Deleted internal access from West Wing Entrance through to elevators, corridors and mechanical room, Level 0 and Level 1 respectively

2.1.4 Reference drawing A-102G

Revised note to sub Phase 3A-5

"BUILD HOARDING / HOARDING VESTIBULE/CEILING HOARDING WITH WALLS TO SUPPORT AND WITH ACCESS PANELS TO WORK IN EXISTING CEILING SPACE ABOVE CORRIDOR."

Revised suggested hoarding to west wing during Phase 2B

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2.1.5 Reference drawing A-110G

Revised Notes D39 and D45

Added tag reference to glazing on north wall of the West Wing

Added Interior photograph of proposed location for glass removal.

2.1.6 Reference dwg A-130G

Added wall type FW01 for all exposed to view sides of existing columns at exterior walls

Added PARTITION/WALL LEGEND

2.1.7 Reference drawing A-131G

Added PARTITION/WALL LEGEND

2.1.8 Reference drawing A-141G

Revised Ceiling heights and added bulkhead locations

2.1.9 Reference drawing A-150G

Revised lines to clarify differences in WP(Wall Protection) and **Added** WP tags to show

Revised flooring to align within room partitions

Revised finishes in Soiled utility rooms and washrooms to be finished in epoxy product

Revised notes and legends

Revised finishes represented in coloured tones to hatches

Deleted 'sloped' from Floor Finishes Notes

2.1.10 Reference drawing A-160G

Revised lines to clarify differences in WP(Wall Protection) ON PLAN AND WALL PROTECTION LEGEND and **Added** WP tags to show types and locations.

Added CG-1 tags to locations.

Revised WALL PROTECTION NOTES.

Added WP-01 to water treatment room and CG-1 as shown

Added WP-03 and CG-1 to wall in clean supply room as shown

Revised extent of Wall Protection for partitions in Crockford Wing to extend to existing window frames

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2.1.11 Reference drawing A-300G

Added building section 9/A-300G THROUGH EAST SIDE OF WEST WING with reference to details

Added reference to new detail 9/A-510G

Added reference to details to building section 5 and 1/A-300G

2.1.12 Reference drawing A-400G (NOT INCLUDED)

Revised to clarify A-99, is handrail. Handrail Detail 1 found on A-510G

Length = 600mm typical all locations unless noted otherwise

2.1.13 Reference drawing A-402G

Revised plan 3/A-402G MED ROOM and INTERIOR ELEVATIONS 3A – 3D.

FFE items have been relocated

2.1.14 Reference drawing A-403G

Revised all pipe railings, posts, handrails and brackets to be stainless steel.

Revised elevations to extend WP to floor at ramp locations. No coved bases at these locations

2.1.15 Reference drawing A-402C

Added 4/A-402C INTERIOR ELEVATION – TECH ROOM

Added 5/A-402C INTERIOR ELEVATION – TECH ROOM

2.1.16 Reference drawing A-500G

Added Plan Detail 7/A-500G

2.1.17 Reference drawing A-510G

Revised Sheet name

Added details for epoxy flooring and bases

Added ceiling details

Added ceiling expansion joint detail

Added corner guard detail

PPE cabinet section relocated to new sheet A-511G

2.1.18 Reference drawing A-511G

Added this new sheet

Added PPE plans, elevations and details

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Added details for millwork in MEDS room

2.1.20 Reference drawing A-600G

Revised REMARKS notes for epoxy flooring and sheet flooring – safety

2.1.20 Reference drawing A-601G

Deleted stop from cased/single rabbet opening frame detail 3

Revised TSG to TGL in DOOR/FRAME LEGENDS ABBREVIATIONS and INTERIOR SCREEN ELEVATIONS

Added Detail 4 – Single Rabbet opening frame – Sliding door

Revised DOOR AND FRAME SCHEDULE – NEW, Door 2.723 frame detail to 4

3.0 FF&E – Bill of Quantity

Reference document “**SHN Centenary Dialysis FF&E BOQ - w-Installed by 2024-05-2.pdf**”

Added new column for clarification; “Installed by”

End of Architectural Addendum 1

CLIENT



Scarborough Health Network - Centenary
2867 Ellesmere Road
Scarborough, ON, M1E 4B9
Tel: 416.284.8131

ARCHITECT



Kasian Architecture Ontario Incorporated
85 Hanna Avenue, Suite 300
Toronto, ON, M6K 3S3
Tel: 416.583.3600
Fax: 416.583.3610

FUNCTIONAL PROGRAMMING
CONSULTANT



Resource Planning Group Incorporated
PO Box 10030 RPO Henley Gardens
Scarborough, ON, M1N 0A6
Tel: 416.498.5205
Fax: 604.736.4079

STRUCTURAL ENGINEERING



RJC Engineers
100 University Avenue, North Tower, Suite 300
Toronto, ON, M5J 1V6
Tel: 416.977.5335

MECHANICAL / ELECTRICAL /

ICAT / SECURITY / AV



EXP Engineering
220 Commerce Valley Drive West, Suite 110
Markham, ON, L3T 0A8
Tel: 905.695.3217

ACOUSTIC / VIBRATION ENGINEERS



Aercoustics Engineering Limited
1004 Middlegate Road, Suite 1100
Mississauga, ON, L4Y 0G1
Tel: 647.363.6937
Fax: 416.249.3613

SHN RETAINED CONSULTANTS

- Dialysis Vendor - Baxter

FF+E



Insight Health Tech Planning Incorporated
5484 Tomken Road, Unit Z3
Mississauga, ON, L4W 2Z6
Tel: 289.814.0314

BUILDING CODE



Muniak Enterprises Incorporated
99 Riverwood Parkway
Toronto, ON, M8Y 4E4
Tel: 647.971.1625

ACCESSIBILITY



Human Space
8 Spadina Ave, Suite 2100
Toronto, ON, M5V 0S8
Tel: 416.593.4342

SIGNAGE + WAYFINDING



Cygnus Design Group
145 Front Street East, Suite 303
Toronto, ON, M5A 1E3
Tel: 416.728.3847

DOOR HARDWARE



Spyder SC Independent Architectural Hardware Consultants
26 Dale Crescent
Bradford West Gwillimbury, ON, L0L 1L0
Tel: 647.271.6489


COST CONSULTANT




Marshall & Murray
120 Carlton Street, Suite 413
Toronto, ON, M5A 4K2
Tel: 416.928.1993
Fax: 416.928.0895



SYMBOL LEGEND

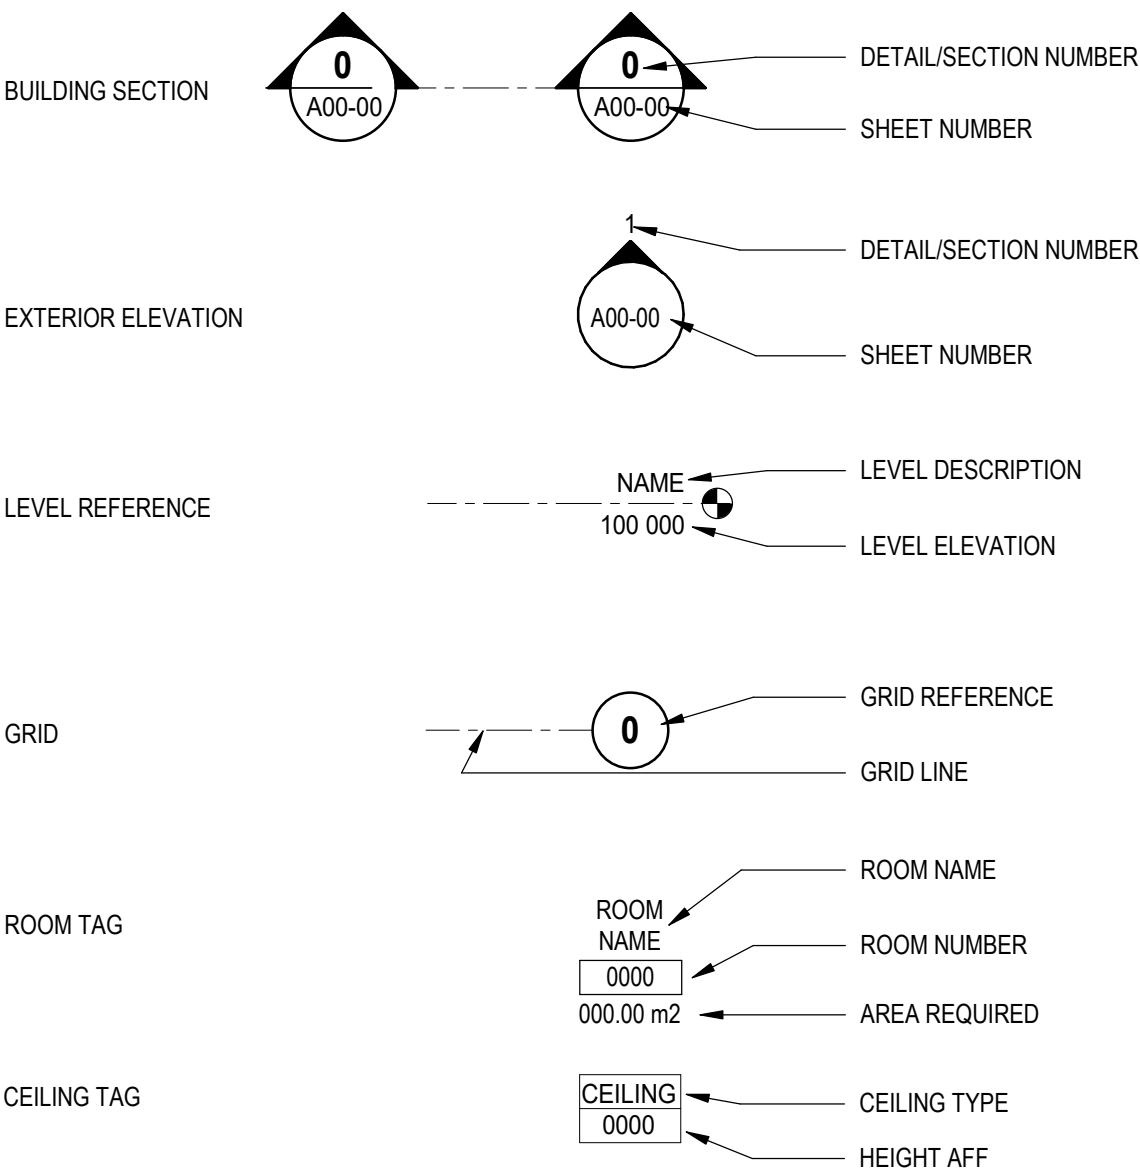

BARRIER-FREE SYMBOL

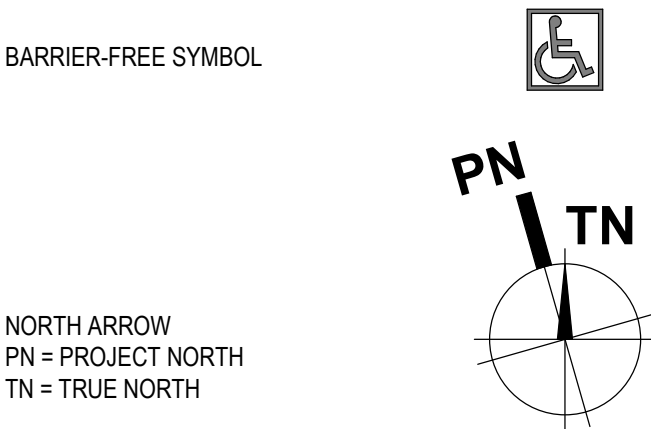

NORTH ARROW
PN = PROJECT NORTH
TN = TRUE NORTH


EXISTING TO REMAIN



EXISTING TO DEMOLISH



INTERIOR FURR OUT TAG

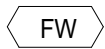


INTERIOR PARTITION TAG



WINDOW AND CURTAIN WALL TAG
(REFER TO WINDOW SCHEDULE FOR
WINDOW AND CURTAIN WALL TYPES)




DOOR TAG

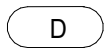

DRAWING LIST - ARCHITECTURAL -

SHEET NUMBER

SHEET NAME

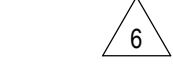


A-000G	COVER PAGE / PROJECT DIRECTORY
A-001G	SITE PLAN/CONSTRUCTION ACCESS AND HOARDING
A-002G	BUILDING CODE / LIFE SAFETY
A-003G	CONSTRUCTION ASSEMBLIES/TYPICAL PARTITION DETAILS
A-004G	TYPICAL MOUNTING HEIGHTS
A-101G	CONTEXT FLOOR PLANS
A-102G	PHASING PLANS - LEVEL 2
A-105G	PROGRAM FLOOR PLAN - LEVEL 2
A-110G	FLOOR PLAN - LEVEL 2 - DEMOLITION
A-120G	REFLECTED CEILING PLAN - LEVEL 2 - DEMOLITION
A-130G	FLOOR PLAN - LEVEL 2 CROCKFORD WING
A-131G	FLOOR PLAN - LEVEL 2 WEST WING
A-140G	REFLECTED CEILING PLAN - LEVEL 2 CROCKFORD WING
A-141G	REFLECTED CEILING PLAN - LEVEL 2 WEST WING
A-150G	FLOOR FINISH PLAN - LEVEL 2
A-160G	WALL PROTECTION AND FINISHES PLANS - LEVEL 2
A-300G	BUILDING SECTIONS/ WALL SECTIONS
A-400G	ENLARGED FLOOR PLANS AND INTERIOR ELEVATIONS
A-401G	ENLARGED FLOOR PLANS AND INTERIOR ELEVATIONS - CROCKFORD WING
A-402G	ENLARGED FLOOR PLANS AND INTERIOR ELEVATIONS - WEST WING
A-403G	INTERIOR ELEVATIONS AND DETAILS
A-500G	PLAN AND SECTION DETAILS
A-510G	INTERIOR FINISHES DETAILS
A-511G	MILLWORK DETAILS
A-600G	INTERIOR FINISHES MATRIX
A-601G	DOOR AND FRAME TYPES AND SCHEDULE



Kasian Architecture
Ontario Incorporated

85 Hanna Avenue, Suite 300
Toronto, ON Canada M6K 3S3
T 416 583 3600 F 416 583 3610
www.kasian.com

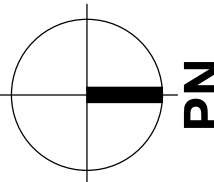

6	2024-06-12	ISSUED FOR ARCH LADDENDUM 1	
5	2024-04-22	ISSUED FOR TENDER	
4	2024-04-03	ISSUED FOR CO-ORDINATION	
3	2023-12-05	ISSUED FOR MOH STAGE 2.3 SUBMISSION	
2	2023-11-17	ISSUED FOR COORDINATION	
1	2023-06-28	90% ISSUED FOR COSTING	
REV	YYYY-MM-DD	REVISION / DRAWING ISSUE	REVIEW

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PROJECT

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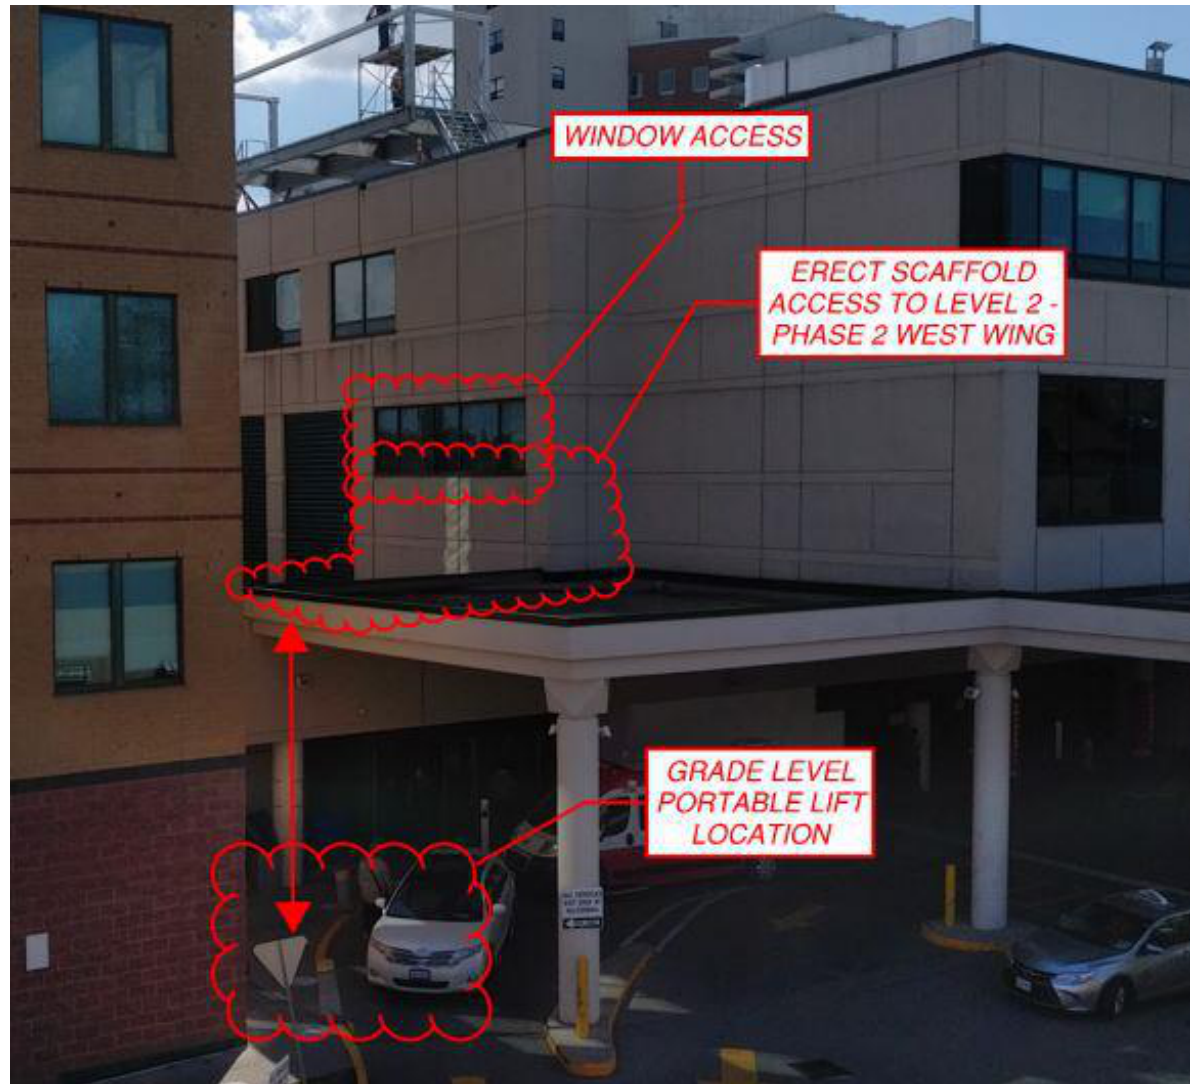
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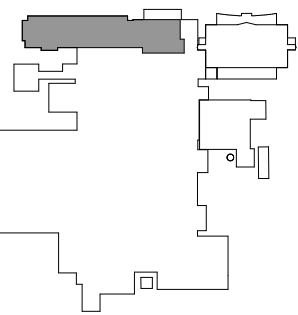
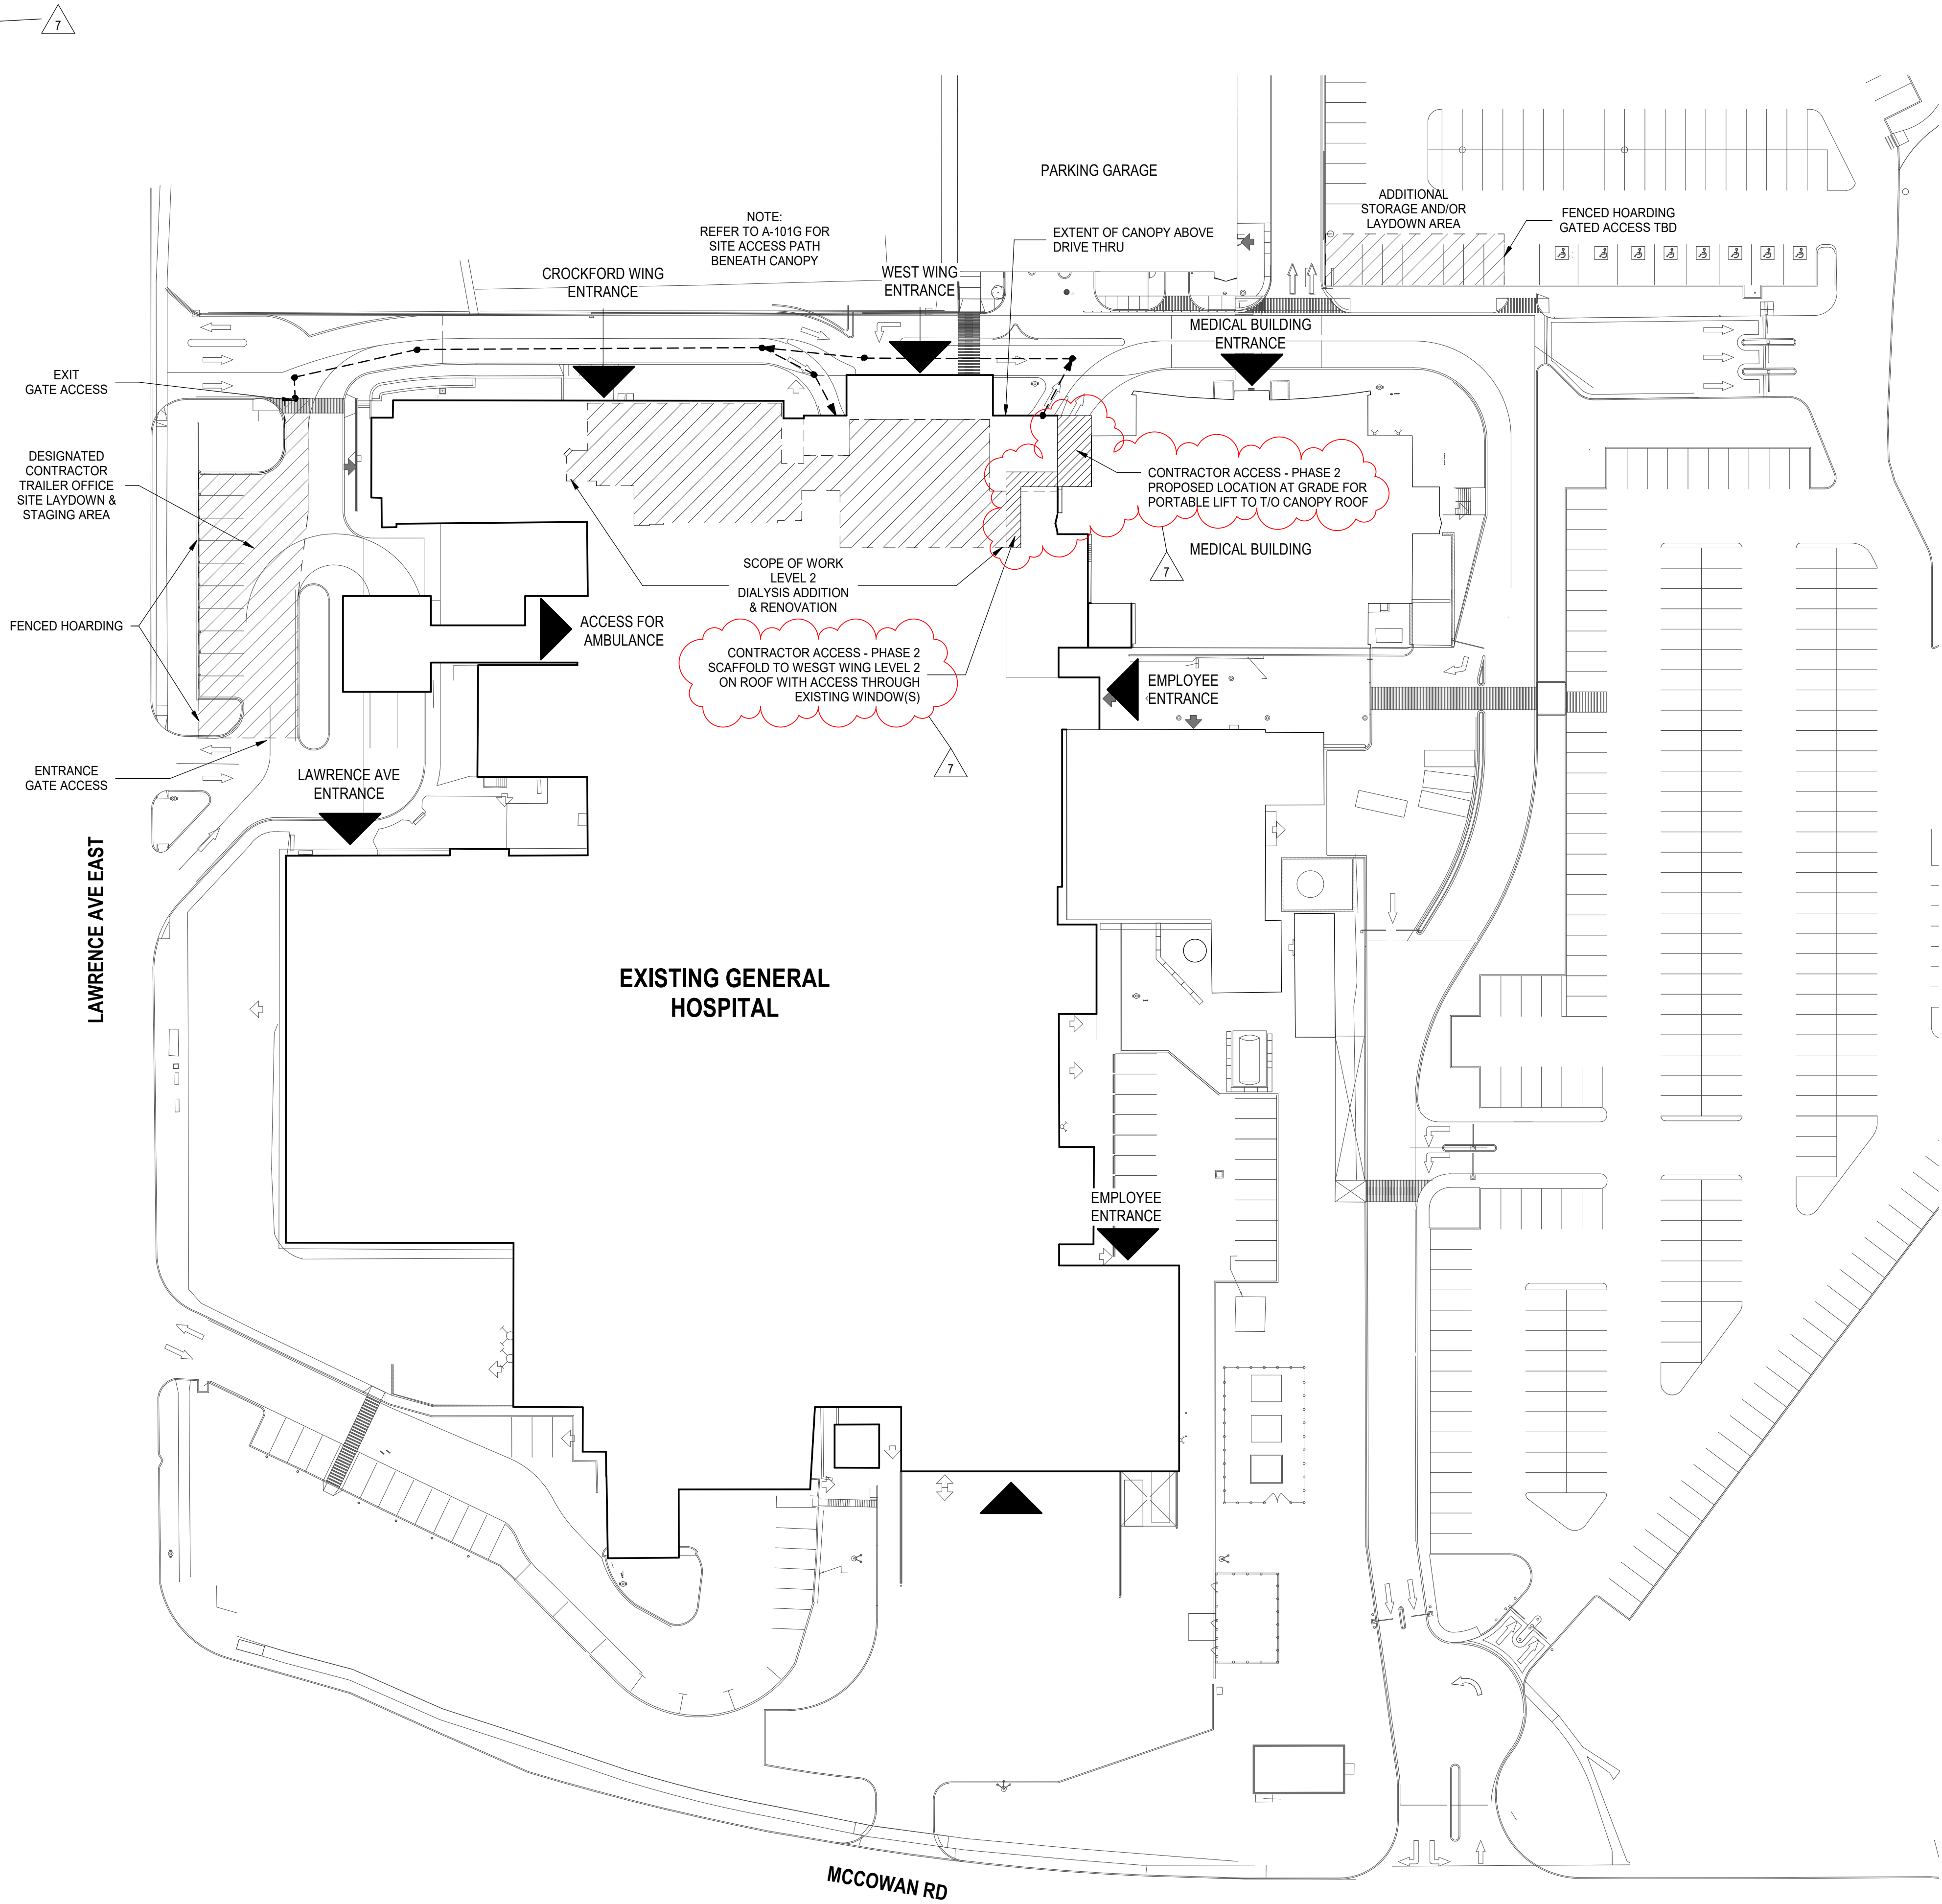
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240065	SCALE	1 : 50	@ ARCH D	REVIEWED
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VIEW OF EXISTING MAIN ENTRANCE DROP OFF
PROPOSED CONTRACTOR ACCESS TO LEVEL 2
WEST WEST



VIEW AT GRADE OF EXISTING MAIN ENTRANCE DROP OFF
PROPOSED CONTRACTOR ACCESS TO LEVEL 2
WEST WEST



7	2024-06-12	ISSUED FOR ARCHIT. ADDENDUM 1
6	2024-04-22	ISSUED FOR TENDER
5	2024-04-03	ISSUED FOR CO-ORDINATION
4	2023-12-05	ISSUED FOR MOH STAGE 2.3 SUBMISSION
3	2023-11-17	ISSUED FOR COORDINATION
2	2023-08-28	80% ISSUED FOR COSTING
1	2023-12-22	ISSUED FOR DD COSTING
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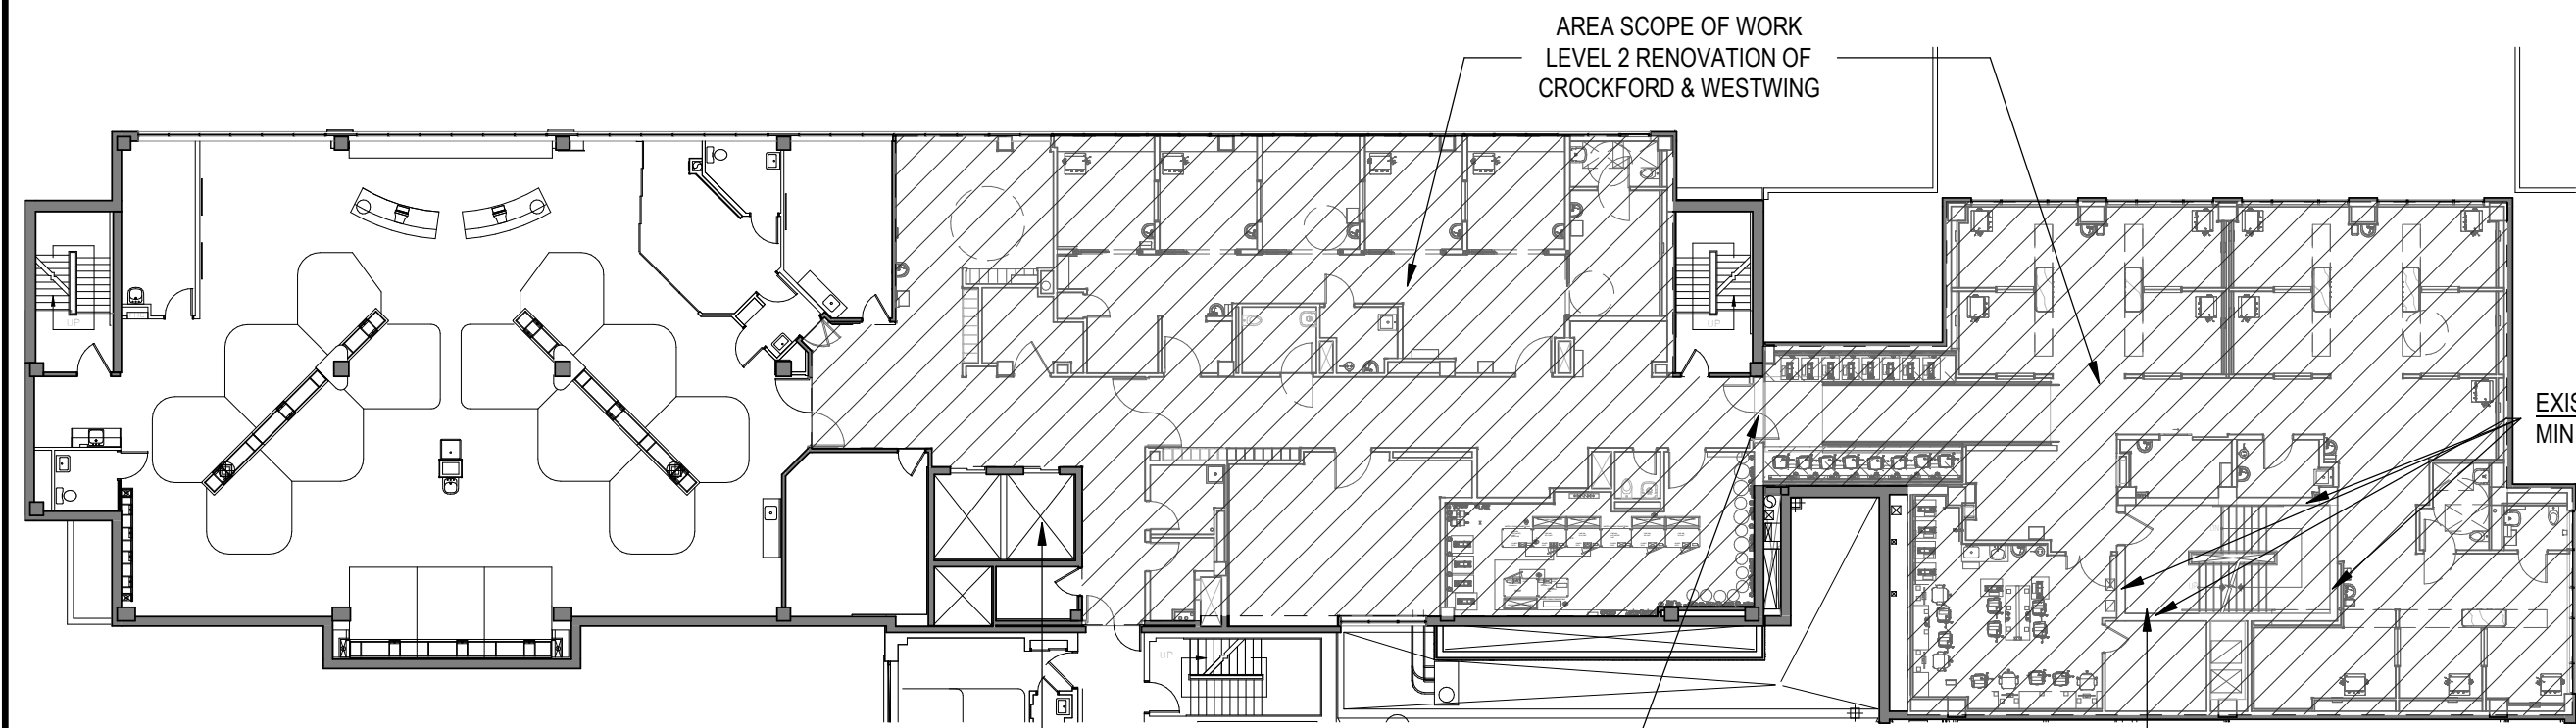
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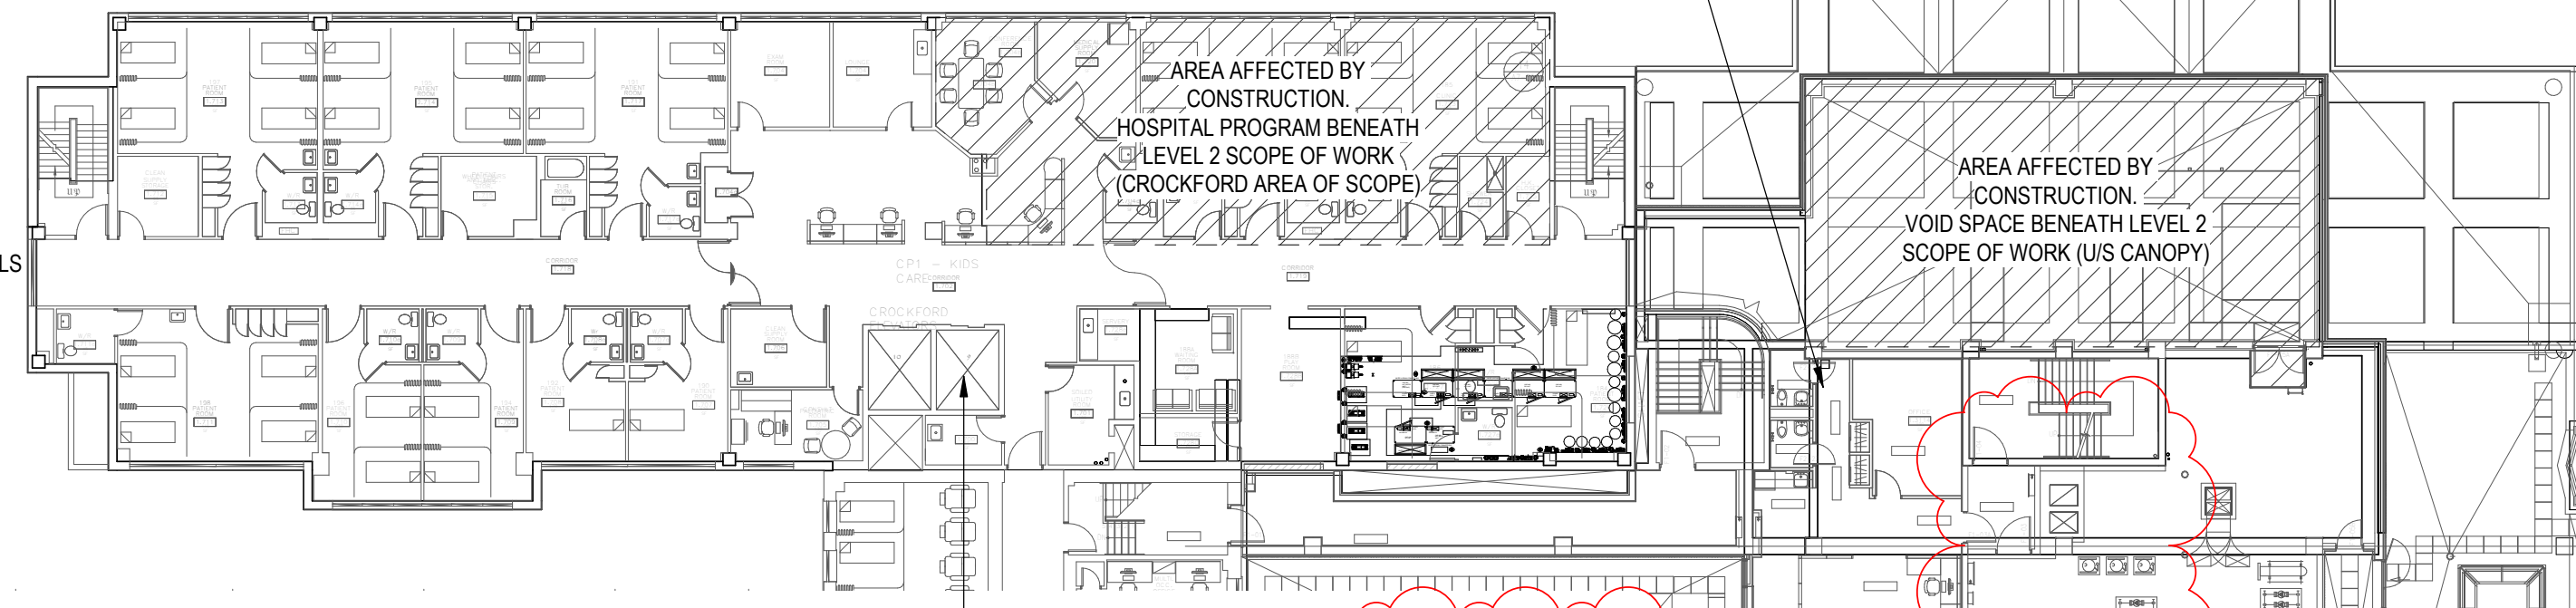
SITE PLAN/CONSTRUCTION ACCESS AND HOARDING

DRAWING ISSUE


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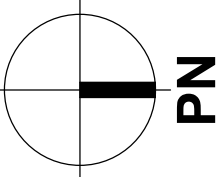
3 LEVEL 2 - CROCKFORD AND WEST WING
A-101G SCALE: 1:250



2 LEVEL 1 - FLOOR PLAN
A-101G SCALE: 1:250



1 LEVEL 0 GROUND FLOOR PLAN
A-101G SCALE: 1:250

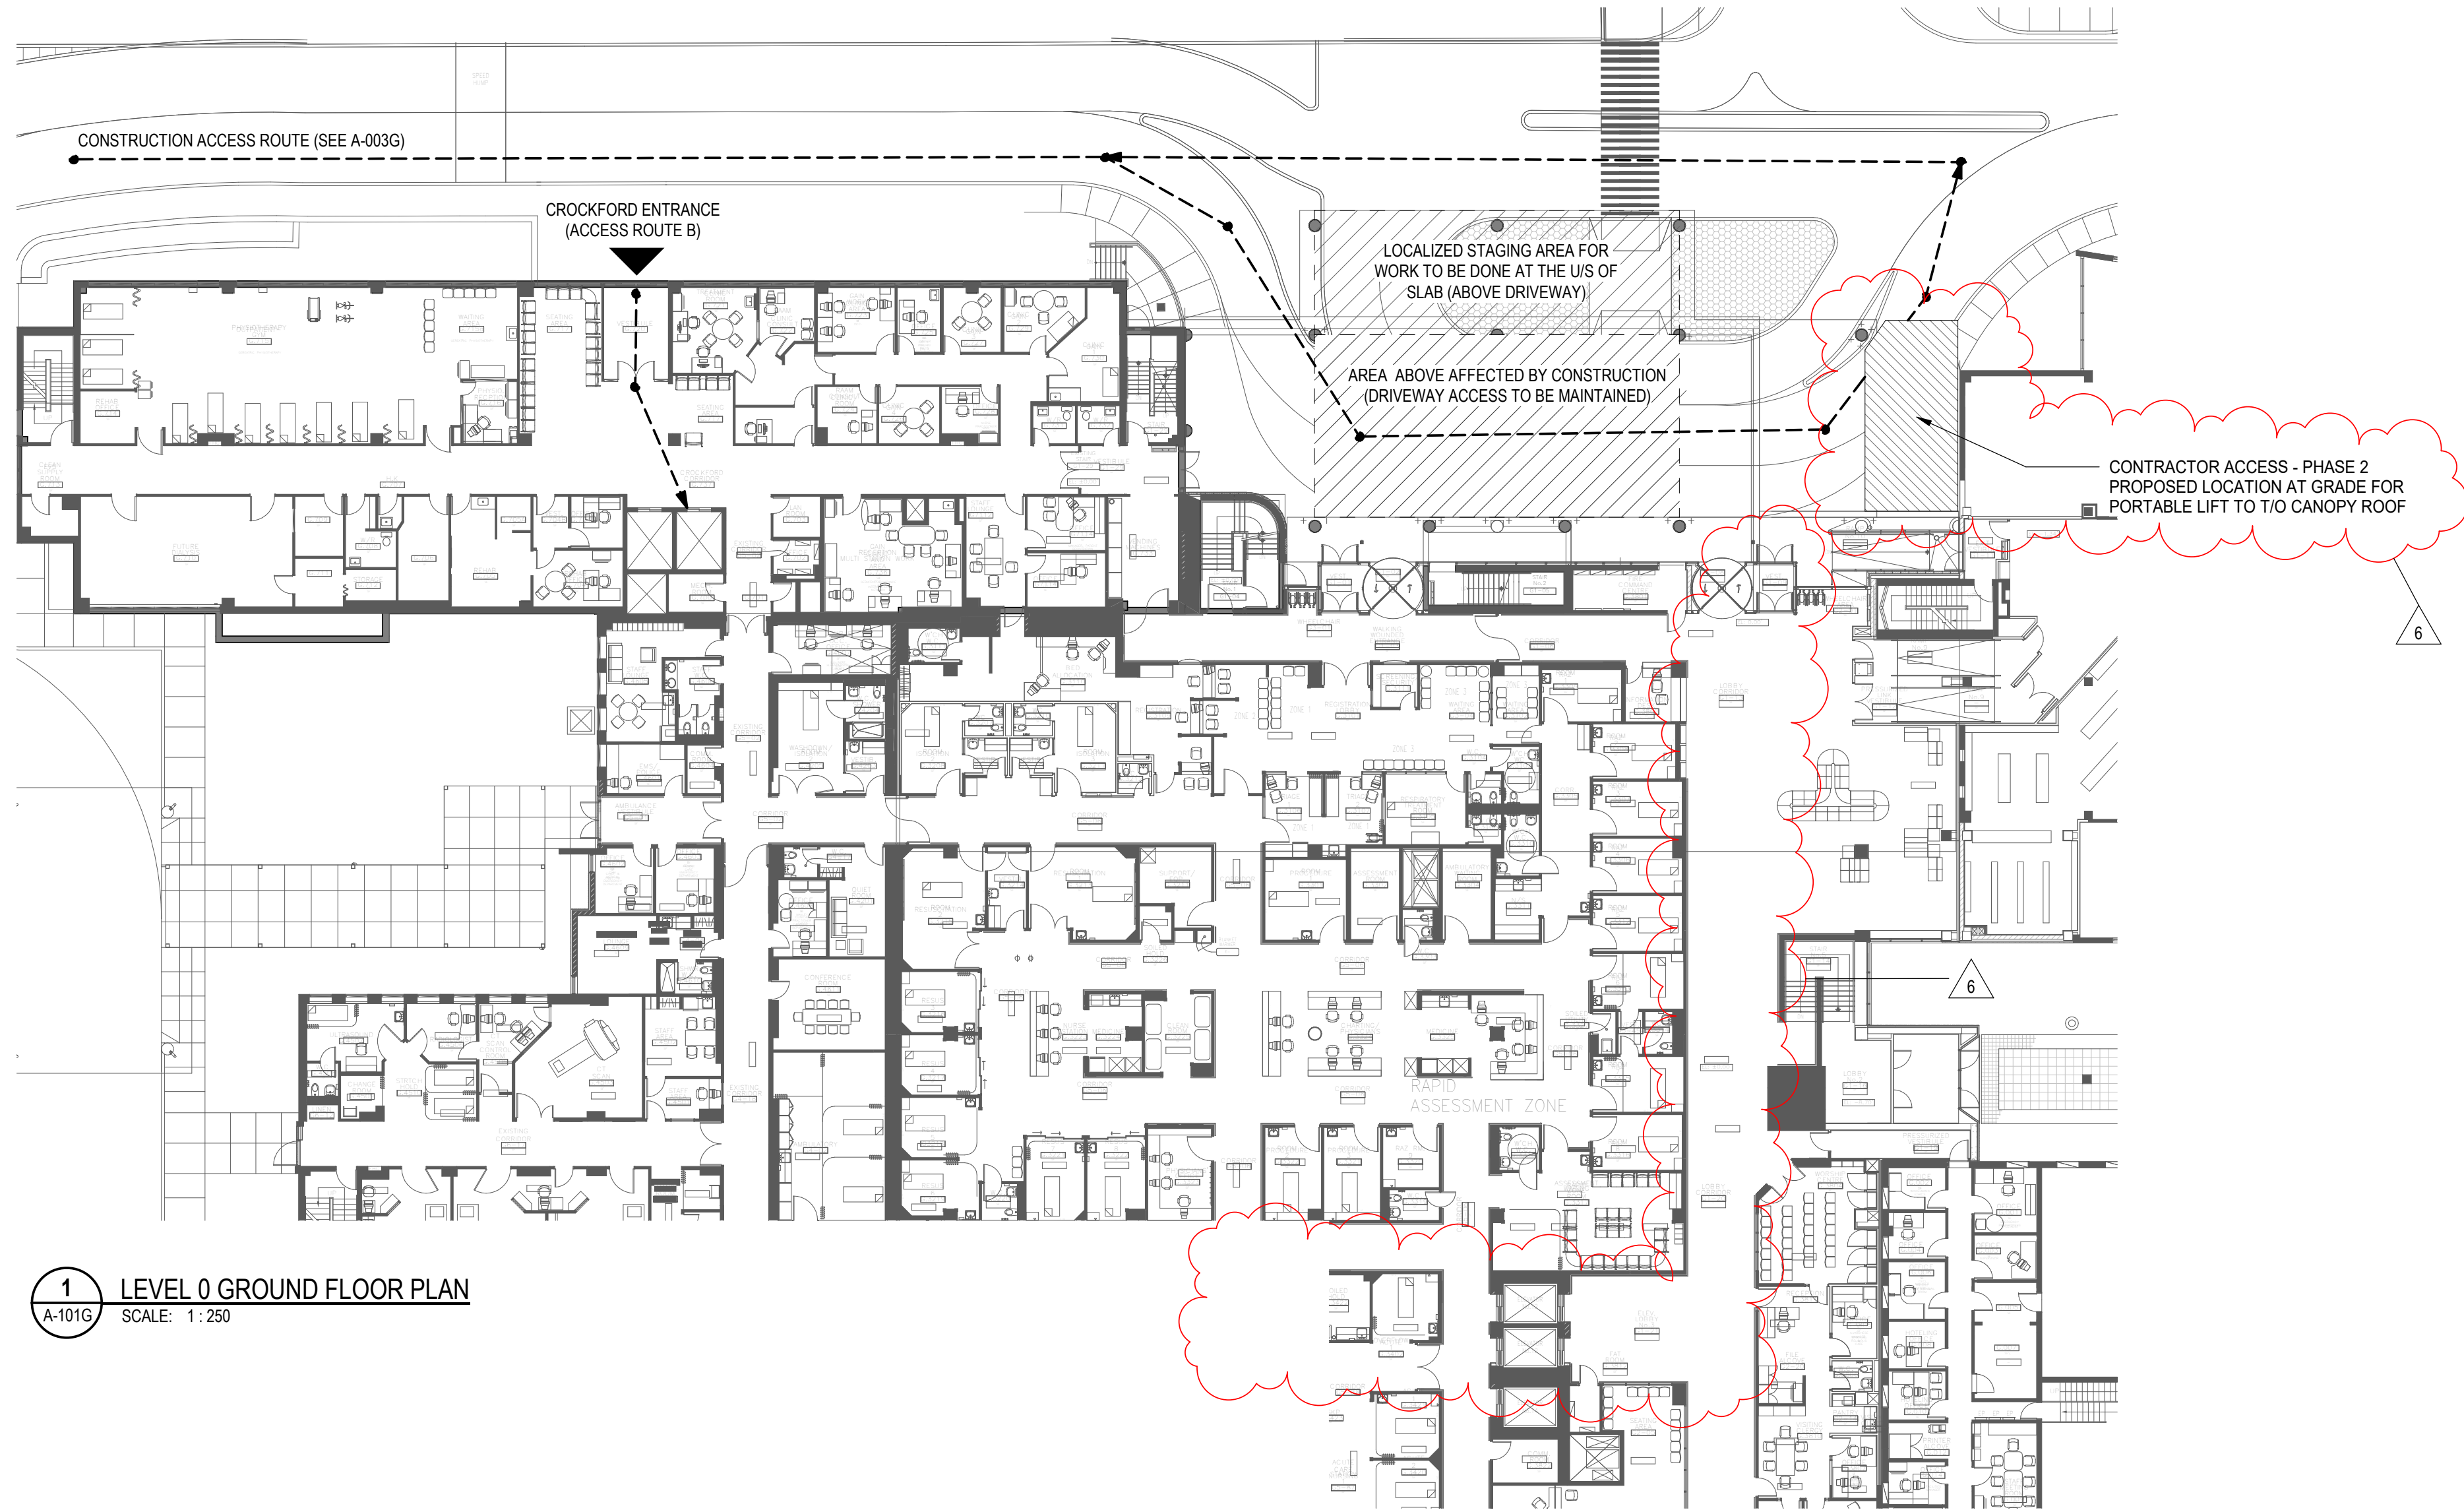

6	2024-06-12	ISSUED FOR ARCH LADDENDUM 1	
5	2024-04-22	ISSUED FOR TENDER	
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3	2023-12-05	ISSUED FOR MOH STAGE 2.3 SUBMISSION	
2	2023-11-17	ISSUED FOR COORDINATION	
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PROJECT

SHN DIALYSIS CARE UNIT - GENERAL HOSPITAL

SCARBOROUGH, ONTARIO, CANADA


DRAWING TITLE

CONTEXT FLOOR PLANS

DRAWING ISSUE

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DRAWING NO.	A-101G	REVISION	6
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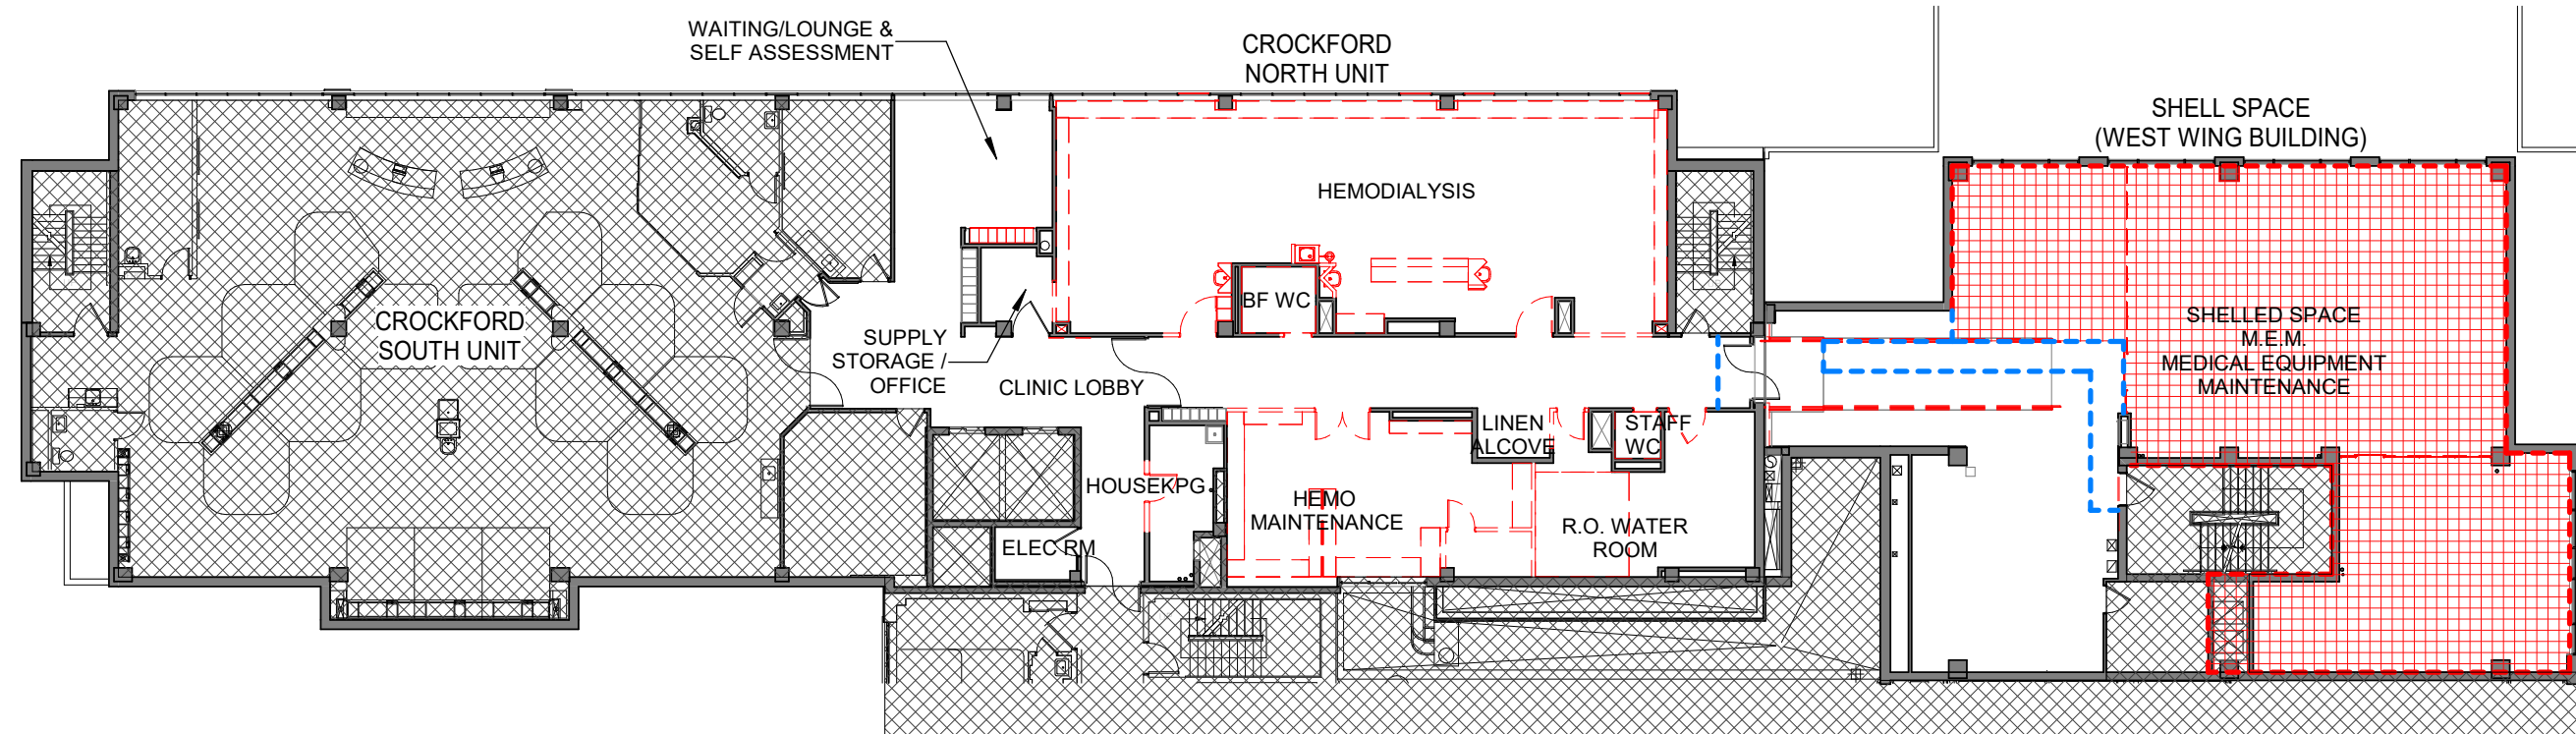


1A PHASE 1A - DEMOLITION FLOOR PLAN

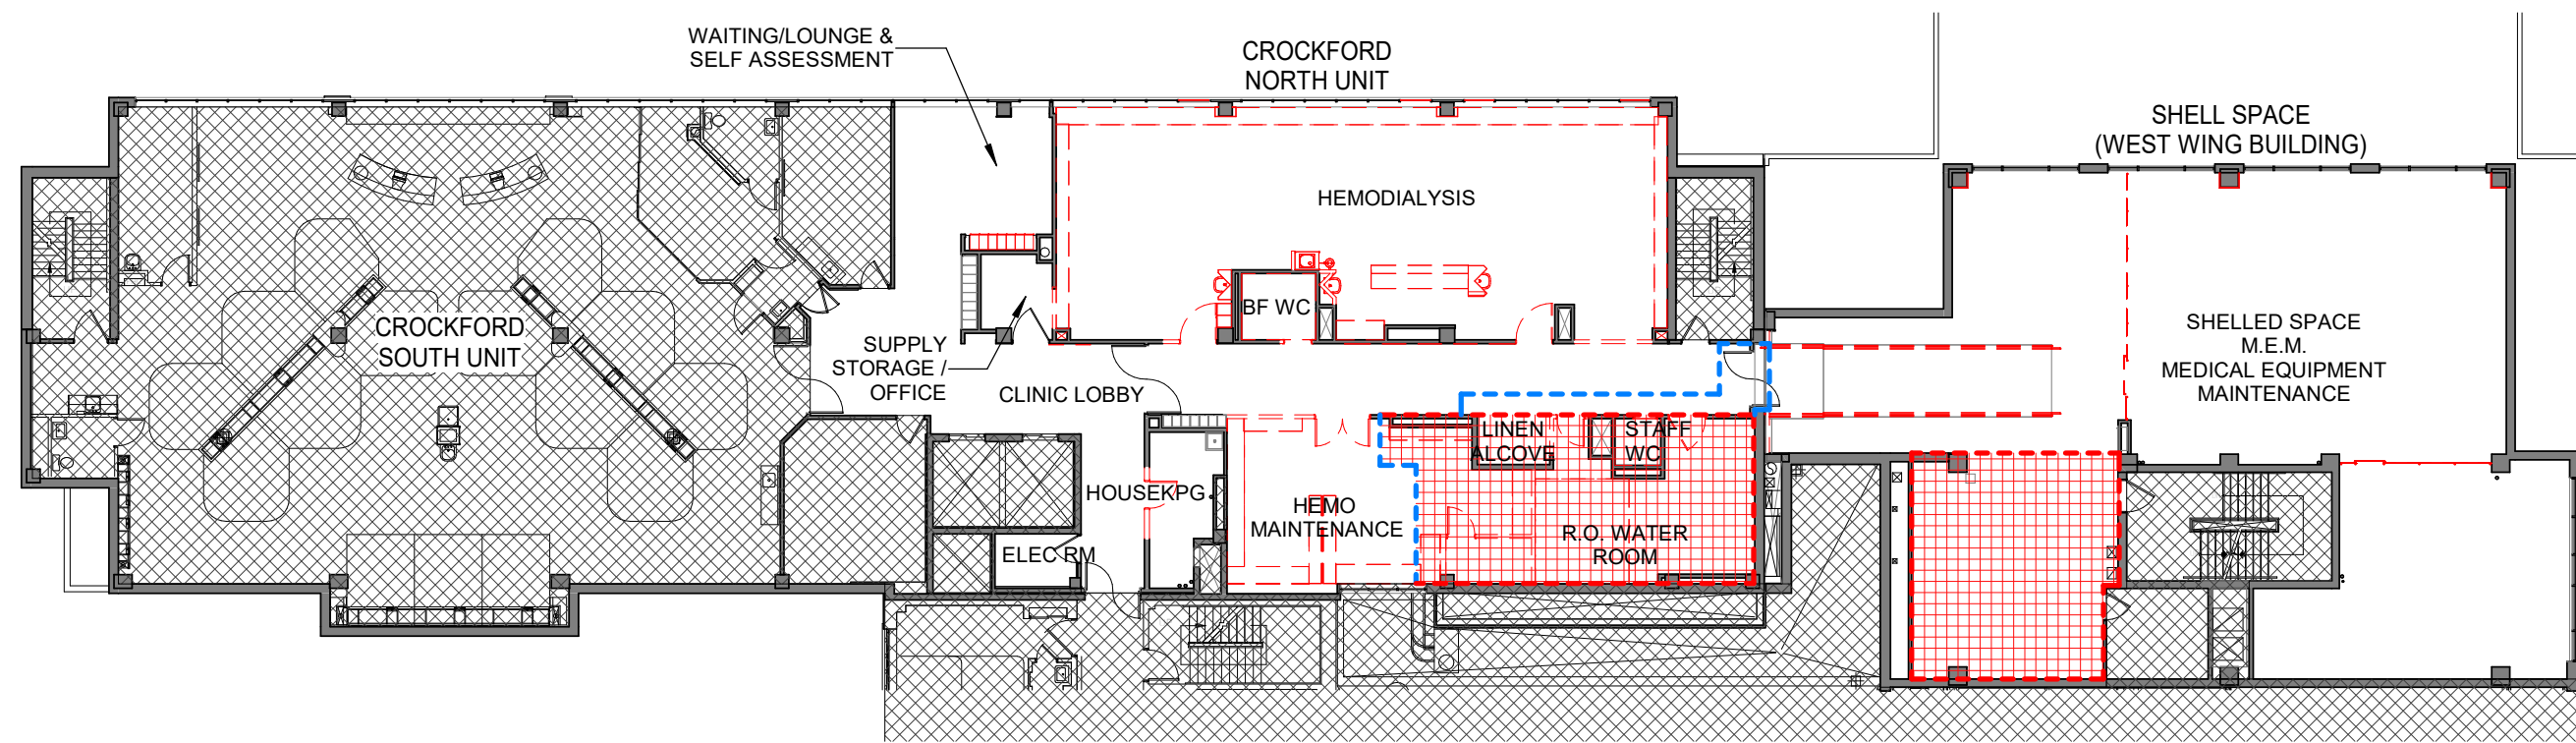SCALE: 1:250

PHASE 1A NOTES

1. BUILD HOARDING / HOARDING VESTIBULE
2. DEMOLITION SCOPE OF EXISTING R.O. WATER TREATMENT ROOM. EXISTING EQUIPMENT AND SYSTEM TO BE OPERATIONAL AT ALL TIMES.
3. PARTIAL DEMOLITION SCOPE OF EXISTING HEMO MAINTENANCE ROOM. REMAINDER OF DEMOLITION TO BE DONE IN SUB PHASE 3A-2.
4. DEMOLITION SCOPE OF EXISTING STAFF WASHROOM & ADJACENT CORRIDOR
5. DEMOLITION SCOPE OF SHELL SPACE AREA OF FUTURE TECH WORKROOM
6. DEMOLITION SCOPE OF RAMP & ADJACENT RAMP STORAGE




2A PHASE 2A - DEMOLITION FLOOR PLAN

SCALE: 1:250

PHASE 2A NOTES

1. REMOVE GLAZING IN EXISTING WINDOW(S) FOR ACCESS FROM EXTERIOR
2. BUILD HOARDING / HOARDING VESTIBULE
3. DEMOLITION SCOPE OF EXISTING SHELL SPACE
- 3- ACCESS TO NEW TECH WORKROOM TO BE MAINTAINED AT ALL TIMES. RESTRICTED TO STAFF ONLY.

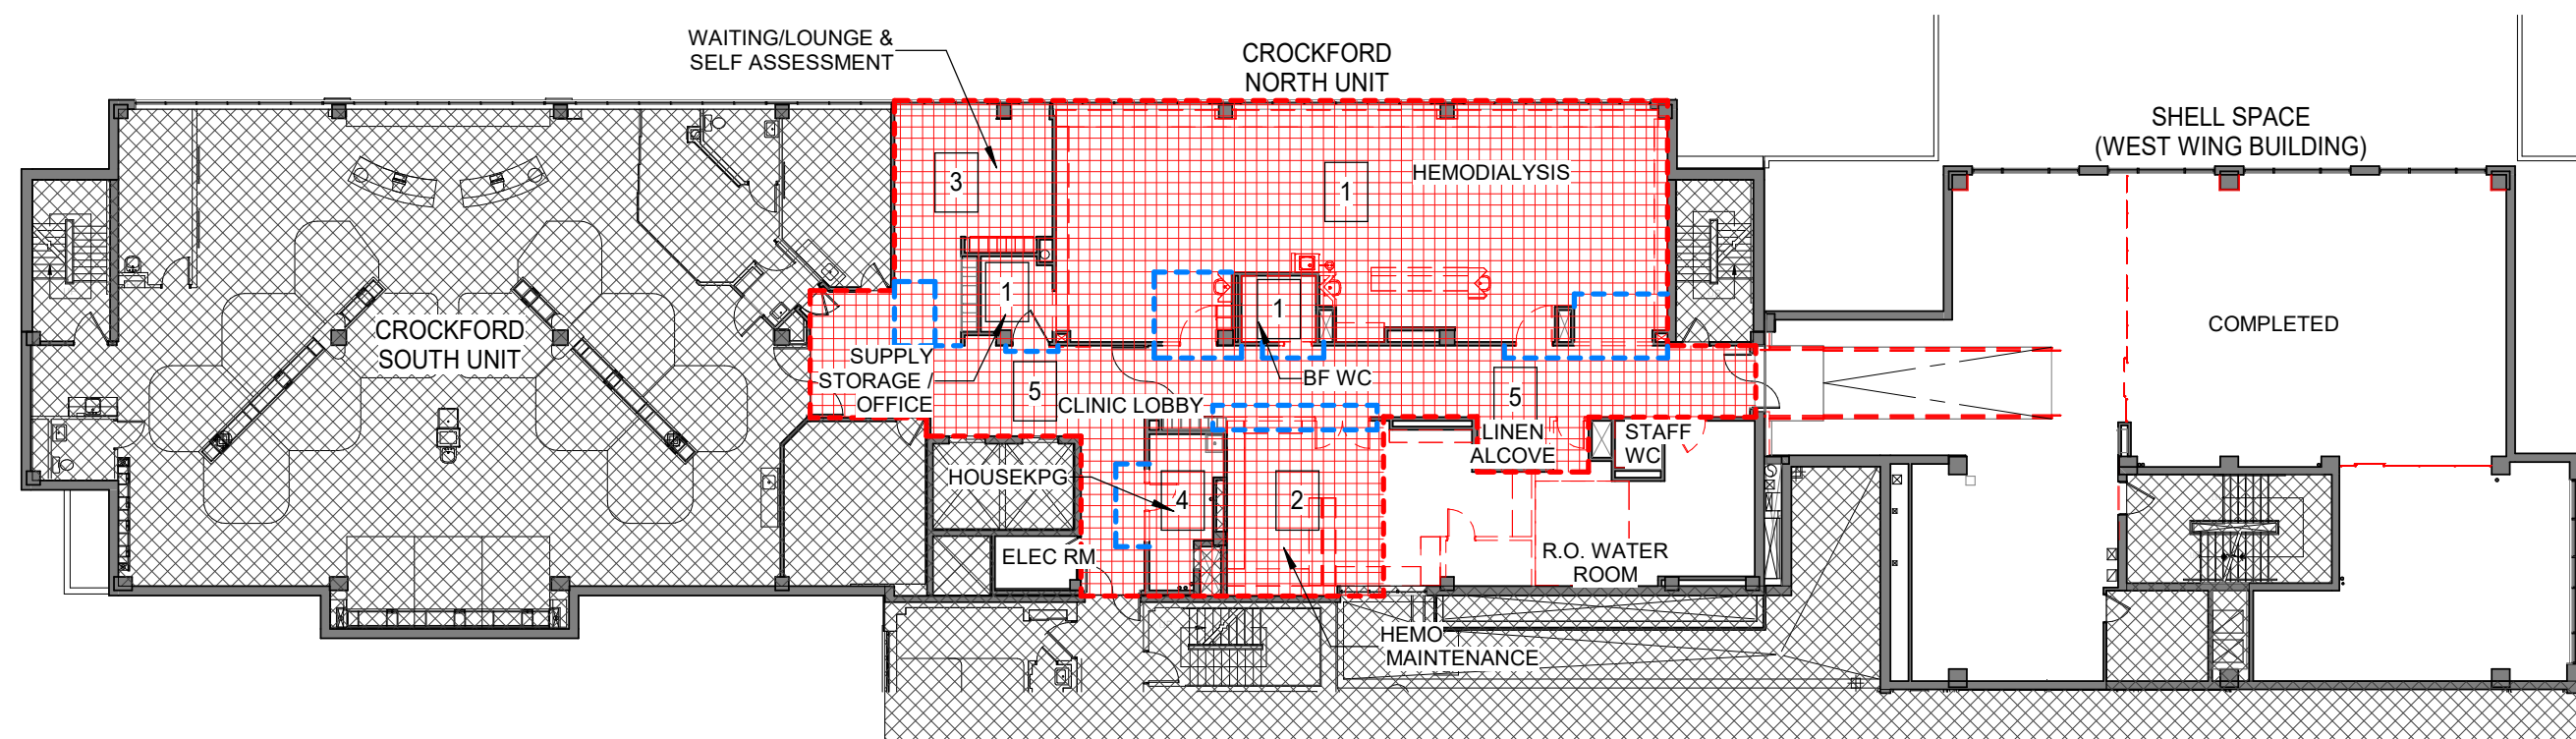

3A PHASE 3A - DEMOLITION PLAN

SCALE: 1:250

PHASE 3A NOTES

THIS PHASE REQUIRES SUB PHASING TO MAINTAIN CONTINUOUS ACCESS TO EXISTING DIALYSIS UNIT (SOUTH UNIT) AND NEW DIALYSIS UNIT EXPANSION.

SUB PHASE 3A-1

1. CO-ORDINATE WITH R.O. WATER TREATMENT VENDOR FOR DECOMMISSION OF EXISTING CROCKFORD NORTH UNIT UNIT SYSTEM
2. BUILD HOARDING / HOARDING VESTIBULE
3. DEMOLITION SCOPE OF EXISTING MAIN DIALYSIS UNIT
4. DEMOLITION SCOPE OF EXISTING SUPPLY STORAGE / OFFICE
5. DEMOLITION SCOPE OF EXISTING BARRIER FREE WASHROOM

SUB PHASE 3A-2

1. BUILD HOARDING / HOARDING VESTIBULE
2. DEMOLITION SCOPE FOR REMAINDER OF THE EXISTING HEMO MAINTENANCE ROOM

SUB PHASE 3A-3


1. BUILD HOARDING / HOARDING VESTIBULE
2. DEMOLITION SCOPE OF EXISTING WAITING AREA

SUB PHASE 3A-4

1. BUILD HOARDING / HOARDING VESTIBULE
2. DEMOLITION SCOPE OF EXISTING HOUSEKEEPING ROOM

SUB PHASE 3A-5

1. BUILD HOARDING / HOARDING VESTIBULE/CEILING HOARDING WITH WALLS TO SUPPORT AND WITH ACCESS PANELS TO WORK IN EXISTING CEILING SPACE ABOVE CORRIDOR.
2. DEMOLITION SCOPE OF EXISTING ELEVATOR LOBBY AND CORRIDOR

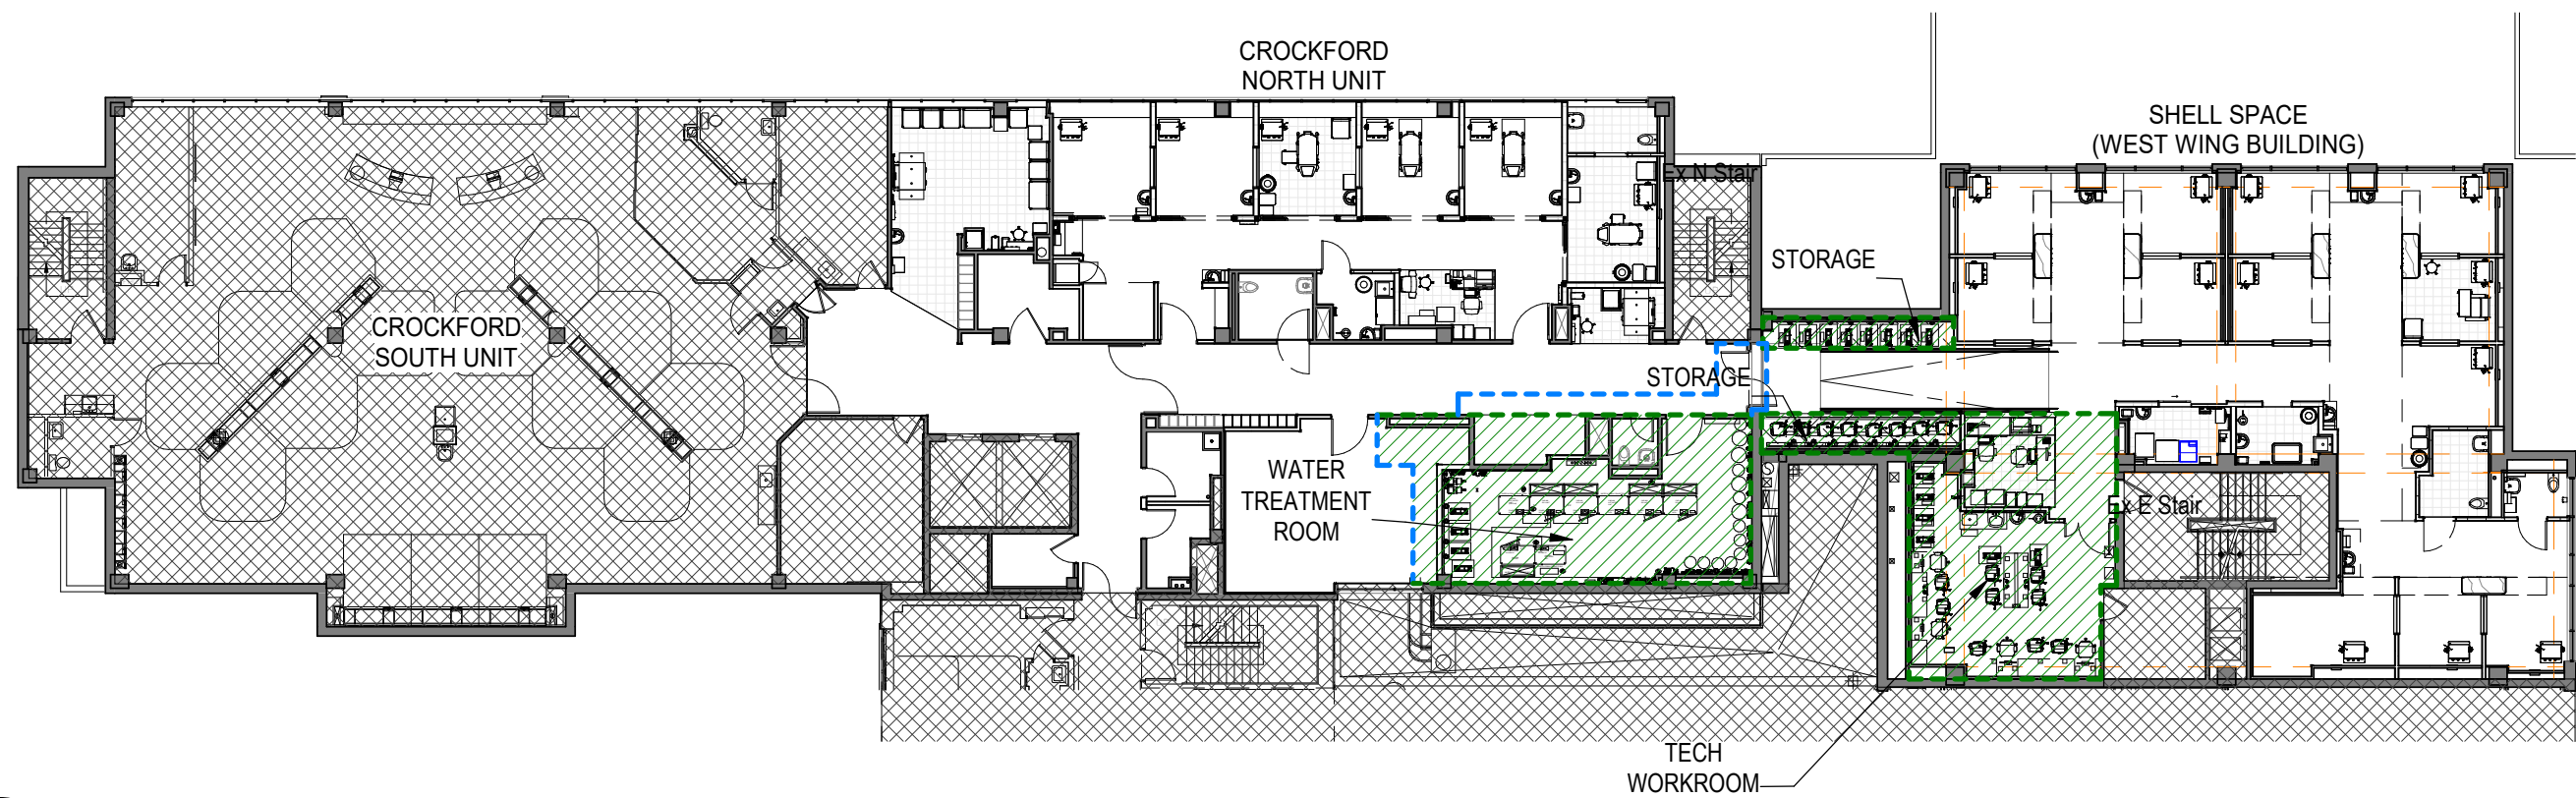


1B PHASE 1B - NEW CONSTRUCTION PLAN

SCALE: 1:250

PHASE 1B NOTES

1. CONSTRUCTION / RECONFIGURATION OF EXISTING R.O. WATER TREATMENT ROOM. NEW DOOR AND DOOR HARDWARE. PROVIDE FUTURE WATER TREATMENT EQUIPMENT & SYSTEM CONNECTION TO FUTURE FIT OUT OF SHELL SPACE.
2. PROVIDE NEW FINISHES FOR EXISTING STAFF WASHROOM. INSTALL PREVIOUSLY STORED EXISTING DOOR HARDWARE TO BE INSTALLED INTO NEW DOOR AND DOOR FRAME.
3. CONSTRUCTION OF RAMP STORAGE AREA
4. CONSTRUCTION OF TECH. WORK ROOM. TEMPORARY DOOR AND DOOR HARDWARE TO TECH WORKROOM TO ACCOMMODATE HOARDING PLAN IN NEXT PHASE.
5. CONSTRUCTION OF COMMAND STATION. ASSOCIATED EQUIPMENT AND FURNITURE TO BE INSTALLED IN PHASE 2B WORK.

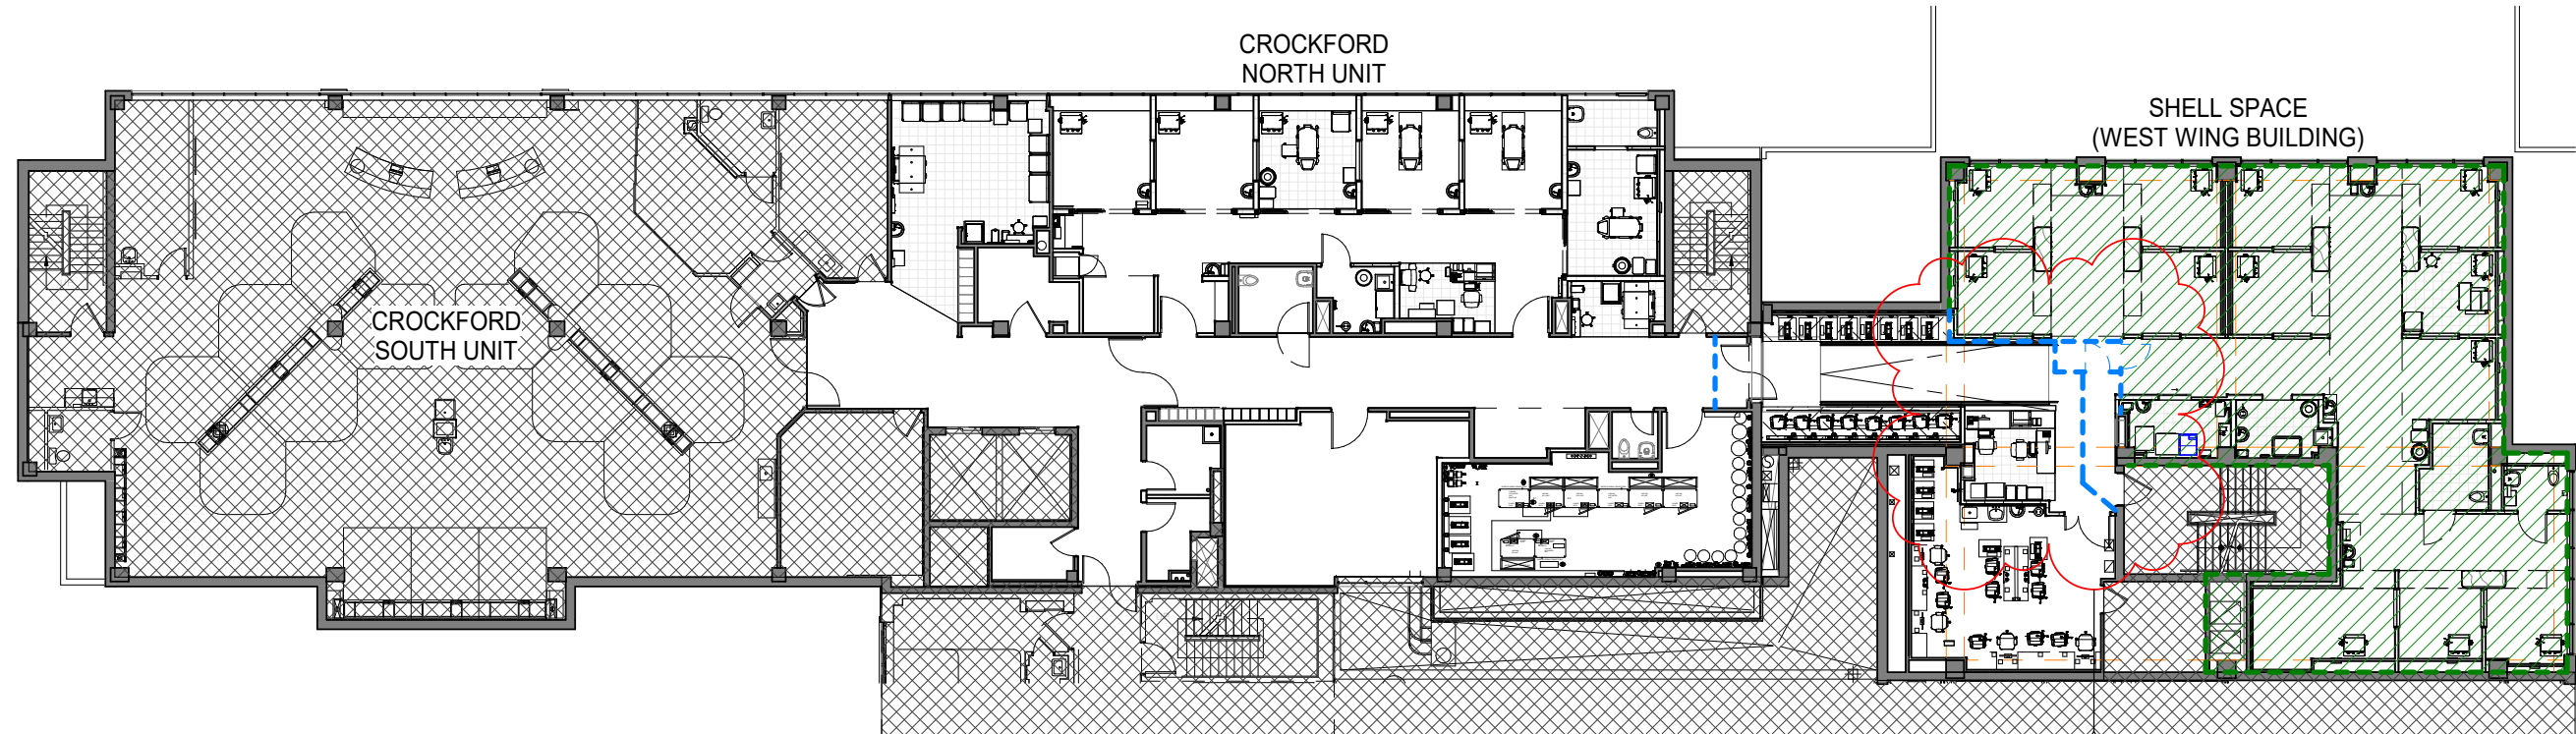


2B PHASE 2B - NEW CONSTRUCTION PLAN

SCALE: 1:250

PHASE 2B NOTES

1. CONSTRUCTION OF DIALYSIS UNIT EXPANSION. CO-ORDINATE WITH R.O. WATER TREATMENT VENDOR FOR CONNECTION TO NEW LOOPS AND FINAL TIE-INS
2. FINAL FINISHES OF RAMP AND RAMP STORAGE AREA
3. COMMAND STATION EQUIPMENT AND FURNITURE TO BE INSTALLED
4. FINAL DOOR AND DOOR HARDWARE TO BE INSTALLED FOR TECH WORKROOM
5. CO-ORDINATE WITH R.O. WATER TREATMENT VENDOR FOR COMMISSIONING OF SYSTEM. CO-ORDINATE WITH OWNER FOR PATIENT TRANSFER PROCESS TO NEW UNIT PRIOR TO START OF NEXT PHASE

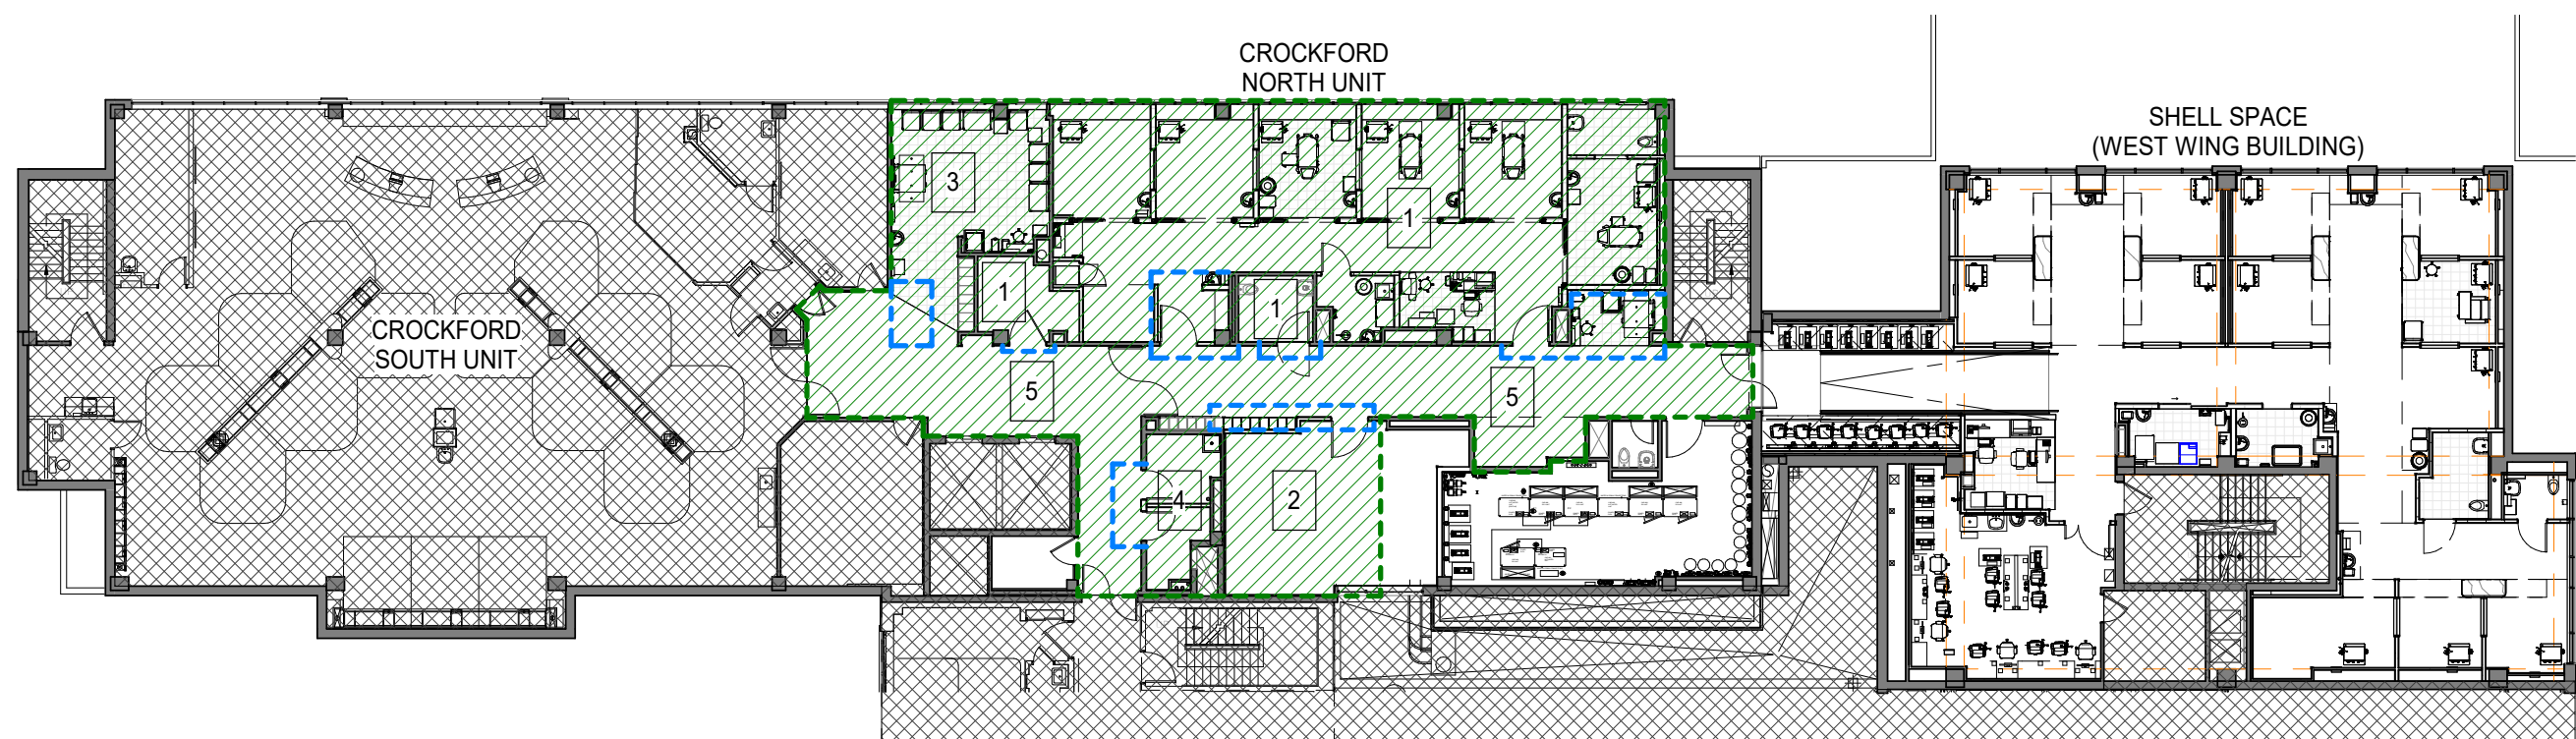

3B PHASE 3B - NEW CONSTRUCTION PLAN

SCALE: 1:250

PHASE 3B NOTES

THIS PHASE REQUIRES SUB PHASING TO MAINTAIN CONTINUOUS ACCESS TO EXISTING DIALYSIS UNIT (SOUTH UNIT) AND NEW DIALYSIS UNIT EXPANSION.

SUB PHASE 3B-1

1. CONSTRUCTION / RENOVATION OF DIALYSIS SEGREGATION UNIT. CO-ORDINATE WITH R.O. WATER TREATMENT VENDOR FOR CONNECTION TO NEW LOOPS AND FINAL TIE-INS
2. RENOVATION OF SUPPLY STORAGE / OFFICE
3. PROVIDE NEW FINISHES FOR EXISTING BARRIER FREE WASHROOM. INSTALL NEW DOOR AND DOOR HARDWARE
4. CO-ORDINATE WITH R.O. WATER TREATMENT VENDOR FOR COMMISSIONING OF SYSTEM

SUB PHASE 3B-2

1. CONSTRUCTION / RENOVATION OF CLEAN SUPPLY ROOM. INSTALL NEW DOOR AND DOOR HARDWARE
2. CONSTRUCTION AND INSTALLATION OF NEW PATIENT LOCKERS

SUB PHASE 3B-3

1. CONSTRUCTION / RENOVATION OF WAITING AREA / LOUNGE AND SELF ASSESSMENT ZONE

SUB PHASE 3B-4

1. CONSTRUCTION AND RENOVATION OF HOUSEKEEPING CLOSET AND SOILED UTILITY / BIOHAZARD ROOM. INSTALL NEW DOORS AND DOOR HARDWARE

SUB PHASE 3B-5

1. CONSTRUCTION AND RENOVATION OF ELEVATORY LOBBY AND CORRIDOR

PHASE LEGEND - SCOPE OF WORK

AREA OF DEMOLITION WORK



AREA OF NEW WORK

EXTENT OF HOARDING / HOARDING VESTIBULE

AREA NOT IN SCOPE OF WORK

GENERAL NOTES - PHASING PLANS

1. LINES ON PLANS REPRESENTING HOARDING ARE SCHEMATIC. FINAL LOCATIONS TO BE DETERMINED ON SITE IN CONSULTATION WITH OWNER AND INFECTION PREVENTION AND CONTROL AUTHORITY STANDARDS.
2. FINAL HOARDING LOCATIONS TO BE CO-ORDINATED WITH OWNER WHERE EXISTING DEVICES ARE TO BE OPERATIONAL DURING CONSTRUCTION.
3. FINAL HOARDING LOCATIONS TO BE CO-ORDINATED WITH OWNER WHERE EXISTING ENTRY/EXIT ARE TO REMAIN ACCESSIBLE DURING CONSTRUCTION.
4. MAINTAIN CLEAR WIDTH OF 1100mm IN CORRIDOR AREA OR AREAS DEEMED TO BE TEMPORARY CORRIDOR TO ACCOMMODATE PHASING.
5. PHASING NOTES REPRESENT GENERAL INTENT OF DEMOLITION / NEW WORK SCOPE. ALL ASSOCIATED WORK TO BE READ IN CONJUNCTION WITH DEMOLITION DRAWINGS AND NEW WORK DRAWINGS.
6. PHASING OF DEMOLITION AND NEW WORK TO BE CO-ORDINATED WITH MECHANICAL AND ELECTRICAL WORK.

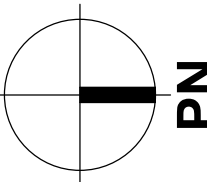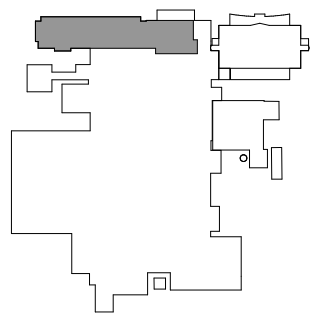

7	2024-06-12	ISSUED FOR ARCH. ADDENDUM 1	
6	2024-04-22	ISSUED FOR TENDER	
5	2024-04-03	ISSUED FOR CO-ORDINATION	
4	2023-12-05	ISSUED FOR MOH STAGE 2.3 SUBMISSION	
3	2023-11-17	ISSUED FOR COORDINATION	
2	2023-08-28	80% ISSUED FOR COSTING	
1	2023-12-22	ISSUED FOR CO-COSTING	
REV	YYYY-MM-DD	REVISION / DRAWING ISSUE	REVIEW

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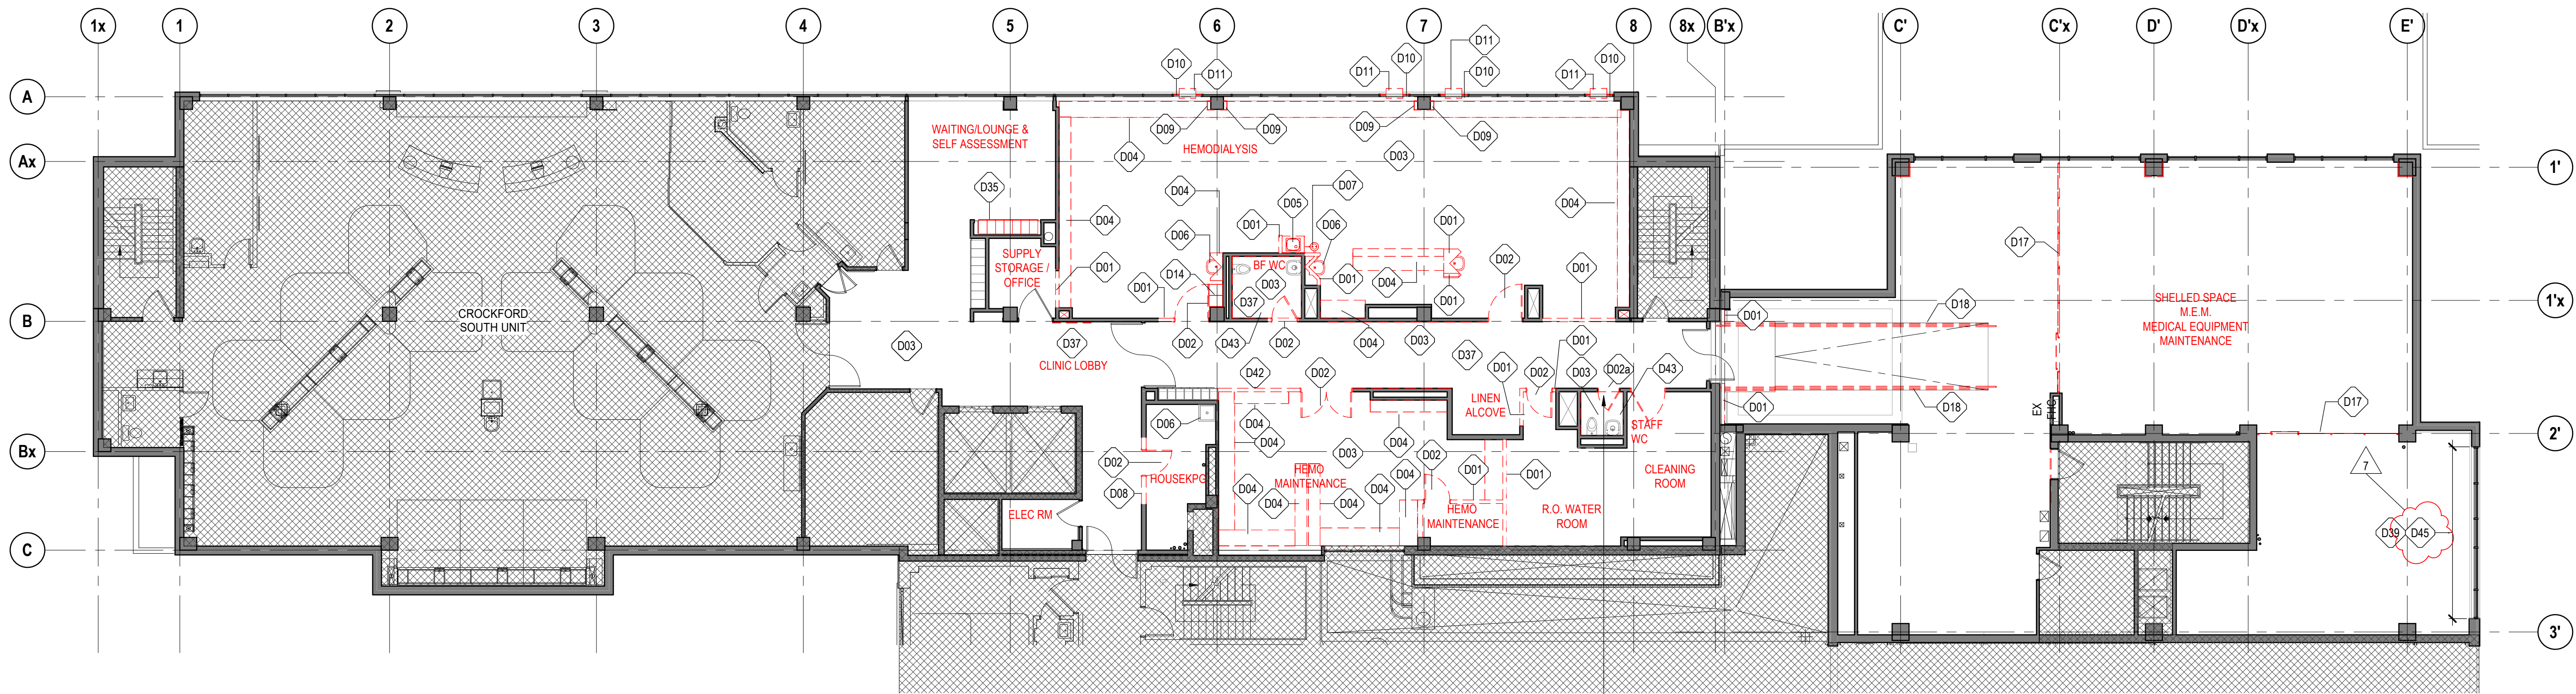
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PHASING PLANS - LEVEL 2

DRAWING ISSUE

PROJECT NO.	PLOT DATE	2023-11-17	DRAWN	Author
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A-102G	7



1 LEVEL 2 - DEMOLITION FLOOR PLAN
A-110G SCALE: 1:125

SIMILAR NOTE TO D02 BUT TO MAINTAIN HARDWARE

DEMOLITION LEGEND

- EXISTING TO REMAIN
- EXISTING TO BE DEMOLISHED
- AREA NOT IN SCOPE OF WORK

DEMOLITION FLOOR PLAN NOTES LEGEND	
Key Value	Keynote Text
D01	REMOVE AND DISPOSE OF EXISTING METAL STUD AND GYPSUM BOARD PARTITION AND/OR FURRING, FULL HEIGHT
D02	REMOVE AND DISPOSE OF EXISTING SINGLE, PAIR OR SLIDING DOORS, FRAME, SCREEN AND SIDELITE AS SHOWN COMPLETE WITH ALL CLIPS, ANCHORS AND HARDWARE
D02a	REMOVE AND DISPOSE OF EXISTING SINGLE DOOR PANEL. MAINTAIN & MAKE GOOD EXISTING FRAME. REMOVE AND STORE ALL CLIPS, ANCHORS AND HARDWARE TO BE RE-INSTALLED IN NEW DOOR PANEL
D03	REMOVE AND DISPOSE OF EXISTING RESILIENT SHEET FLOORING COMPLETE WITH BASES AND TRIMS. TYPICAL ALL LOCATIONS UNLESS NOTED OTHERWISE
D04	REMOVE AND DISPOSE OF EXISTING CASEWORK AND COUNTERTOP COMPLETE WITH ALL MECHANICAL EQUIPMENT AND ELECTRICAL DEVICES
D05	REMOVE AND DISPOSE OF EXISTING STAINLESS STEEL SINK COMPLETE.
D06	REMOVE AND DISPOSE OF EXISTING PLUMBING FIXTURE C/W ALL PIPING, ACCESSORIES, ETC BACK TO WALL.
D07	REMOVE AND DISPOSE OF EXISTING EYE WASH FIXTURE C/W ALL PIPING, ACCESSORIES, ETC BACK TO WALL.
D08	REMOVE AND DISPOSE OF EXISTING CONCRETE MASONRY UNIT WALL. WHERE NOT EXPOSED TO VIEW REMOVAL OF FURRING INCLUDED.
D09	REMOVE AND DISPOSE OF EXISTING FURRED ASSEMBLY COMPLETE TOP TO BOTTOM
D10	REMOVE AND DISPOSE OF EXISTING GLASS AND SPANDREL ASSEMBLY WITHIN SURROUNDING FRAME. REMOVE INTERIOR GLAZING STOPS. EXTERIOR GLAZING LEG TO REMAIN
D11	REMOVE AND DISPOSE OF EXISTING A/C WINDOW UNIT COMPLETE WITH ALL SUPPORTS. PATCH HOLES ON EXTERIOR TO MATCH EXISTING BRICK
D14	REMOVE EXISTING CABINET STORAGE
D17	REMOVE AND DISPOSE OF EXISTING INTERIOR CHAIN LINK FENCE ASSEMBLY, C/W POSTS, HARDWARE, SLIDING RAILS, BASE PLATES AND RELATED MECHANISMS
D18	REMOVE AND DISPOSE OF EXISTING FLOOR MOUNTED PIPE RAILING COMPLETE TO T/O FLOOR/RAMP
D35	REMOVE AND DISPOSE OF EXISTING LOCKERS C/W BASE AND TRIMS
D37	REMOVE AND DISPOSE OF EXISTING WALL PROTECTION PANELS. PATCH AND REPAIR WHERE DAMAGED. PREPARE FOR NEW FINISHES!
D39	REMOVE EXISTING PLEXI-GLASS PANELS C/W FASTENERS. REPAIR AT FORMER FASTENER LOCATIONS. REFER TO SPECIFICATIONS.
D42	REMOVE AND DISPOSE OF EXISTING CONCRETE BLOCK WITH LAMINATE GYPSUM BOARD WALL.
D43	REMOVE AND RE-INSTALL EXISTING PLUMBING FIXTURES AND WALL MOUNTED ACCESSORIES
D45	REMOVE EXISTING GLAZING AS REQUIRED FOR ACCESS TO CONSTRUCTION ZONE FROM EXTERIOR SCAFFOLDING. RE-INSTALL ONCE WORK IN THIS PHASE IS COMPLETED.

GENERAL NOTES - DEMOLITION IMAGES


- IMAGES PROVIDED ARE FROM THE SITE PRIOR TO TENDER. ITEMS SHOWN MAY HAVE BEEN ALTERED, REMOVED OR RELOCATED. IMAGES ARE TO VISUALLY ASSIST WITH BUT NOT LIMITED TO THE WRITTEN DESCRIPTION SHOWN HERE. CO-ORDINATE WITH THE FULL SCOPE OF WORK.
- ALL WORK TO BE CO-ORDINATED WITH MECHANICAL AND ELECTRICAL DEMOLITION WORK.
- ALL WORK TO BE CO-ORDINATED WHERE EXISTING WATER TREATMENT EQUIPMENT AND SYSTEM WILL BE AFFECTED DEMOLITION WORK.



HEMODIALYSIS
D03 D04



HEMODIALYSIS
D001 D03 D04

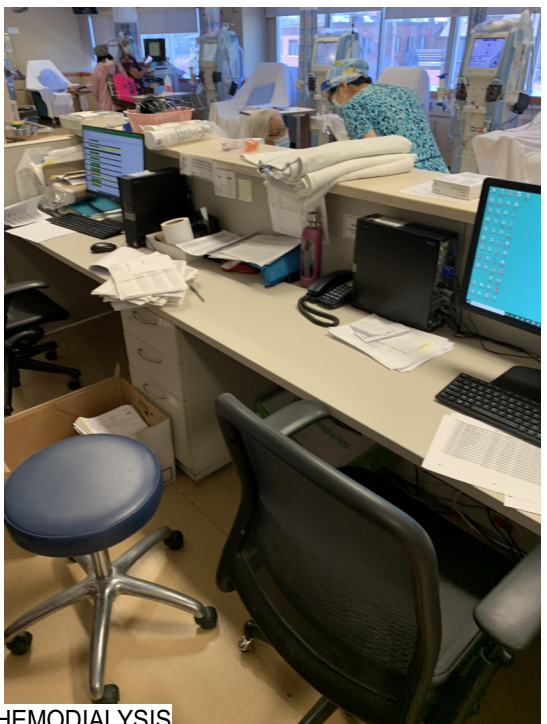

HEMODIALYSIS
D03 D04



HEMODIALYSIS
D03 D04 D09 D15




HEMODIALYSIS
D01 D03 D04 D06



EXISTING A/C IN WINDOW
D10



CORRIDOR
D03

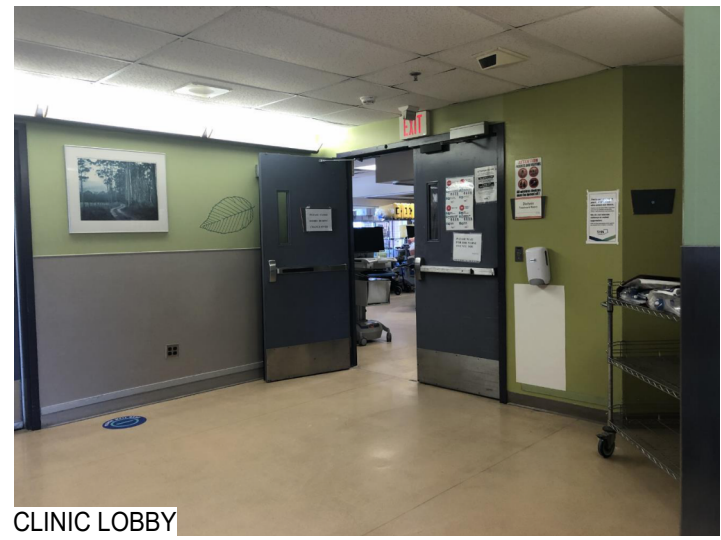

CLINIC LOBBY
D03




CLINIC LOBBY
D03



WAITING/LOUNGE AND SELF ASSESSMENT
D03



EXISTING A/C IN WINDOW EXTERIOR
D11

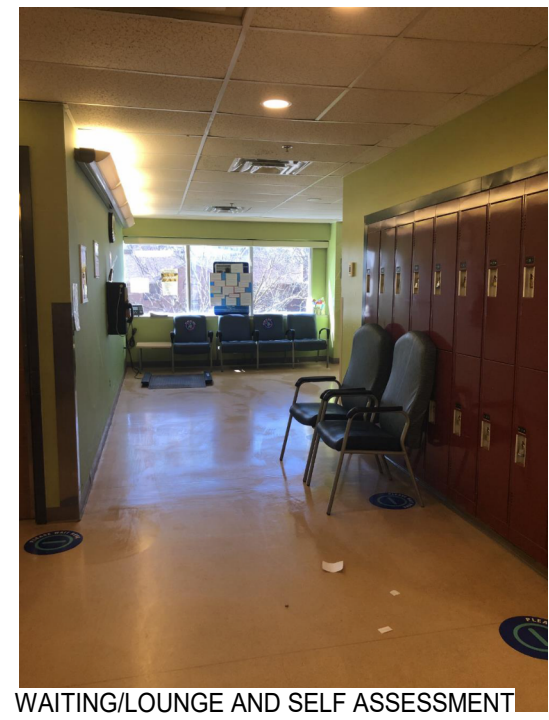

WAITING/LOUNGE AND SELF ASSESSMENT
D03



WAITING/LOUNGE AND SELF ASSESSMENT
D03 D05



BF WC
D03 D43



SHELLED SPACE M.E.M. MEDICAL
EQUIPMENT MAINTENANCE
D18





SHELLED SPACE M.E.M. MEDICAL
EQUIPMENT MAINTENANCE
D17



PROPOSED ACCESS TO WEST WING
CONSTRUCTION ZONE PHASE 2
D37, D45

2 DEMOLITION PLAN REFERENCE IMAGES
A-110G SCALE: 1:150

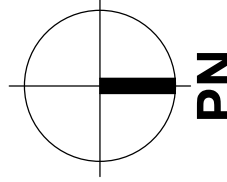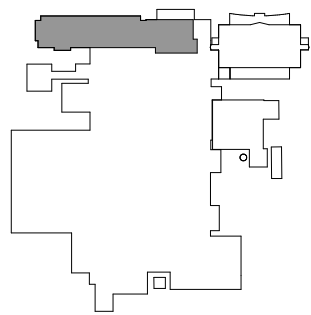

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1	2023-12-22	ISSUED FOR DD COSTING	
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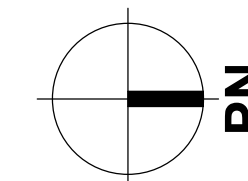
FLOOR PLAN - LEVEL 2 - DEMOLITION

DRAWING ISSUE

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A-110G


7



PARTITION / WALL LEGEND

- EXISTING WALL
- NEW WALL
- AREA NOT IN SCOPE OF WORK
- ROLLER SHADE (RS) WHERE SHOWN

KEY PLAN - DIALYSIS LEVEL 2

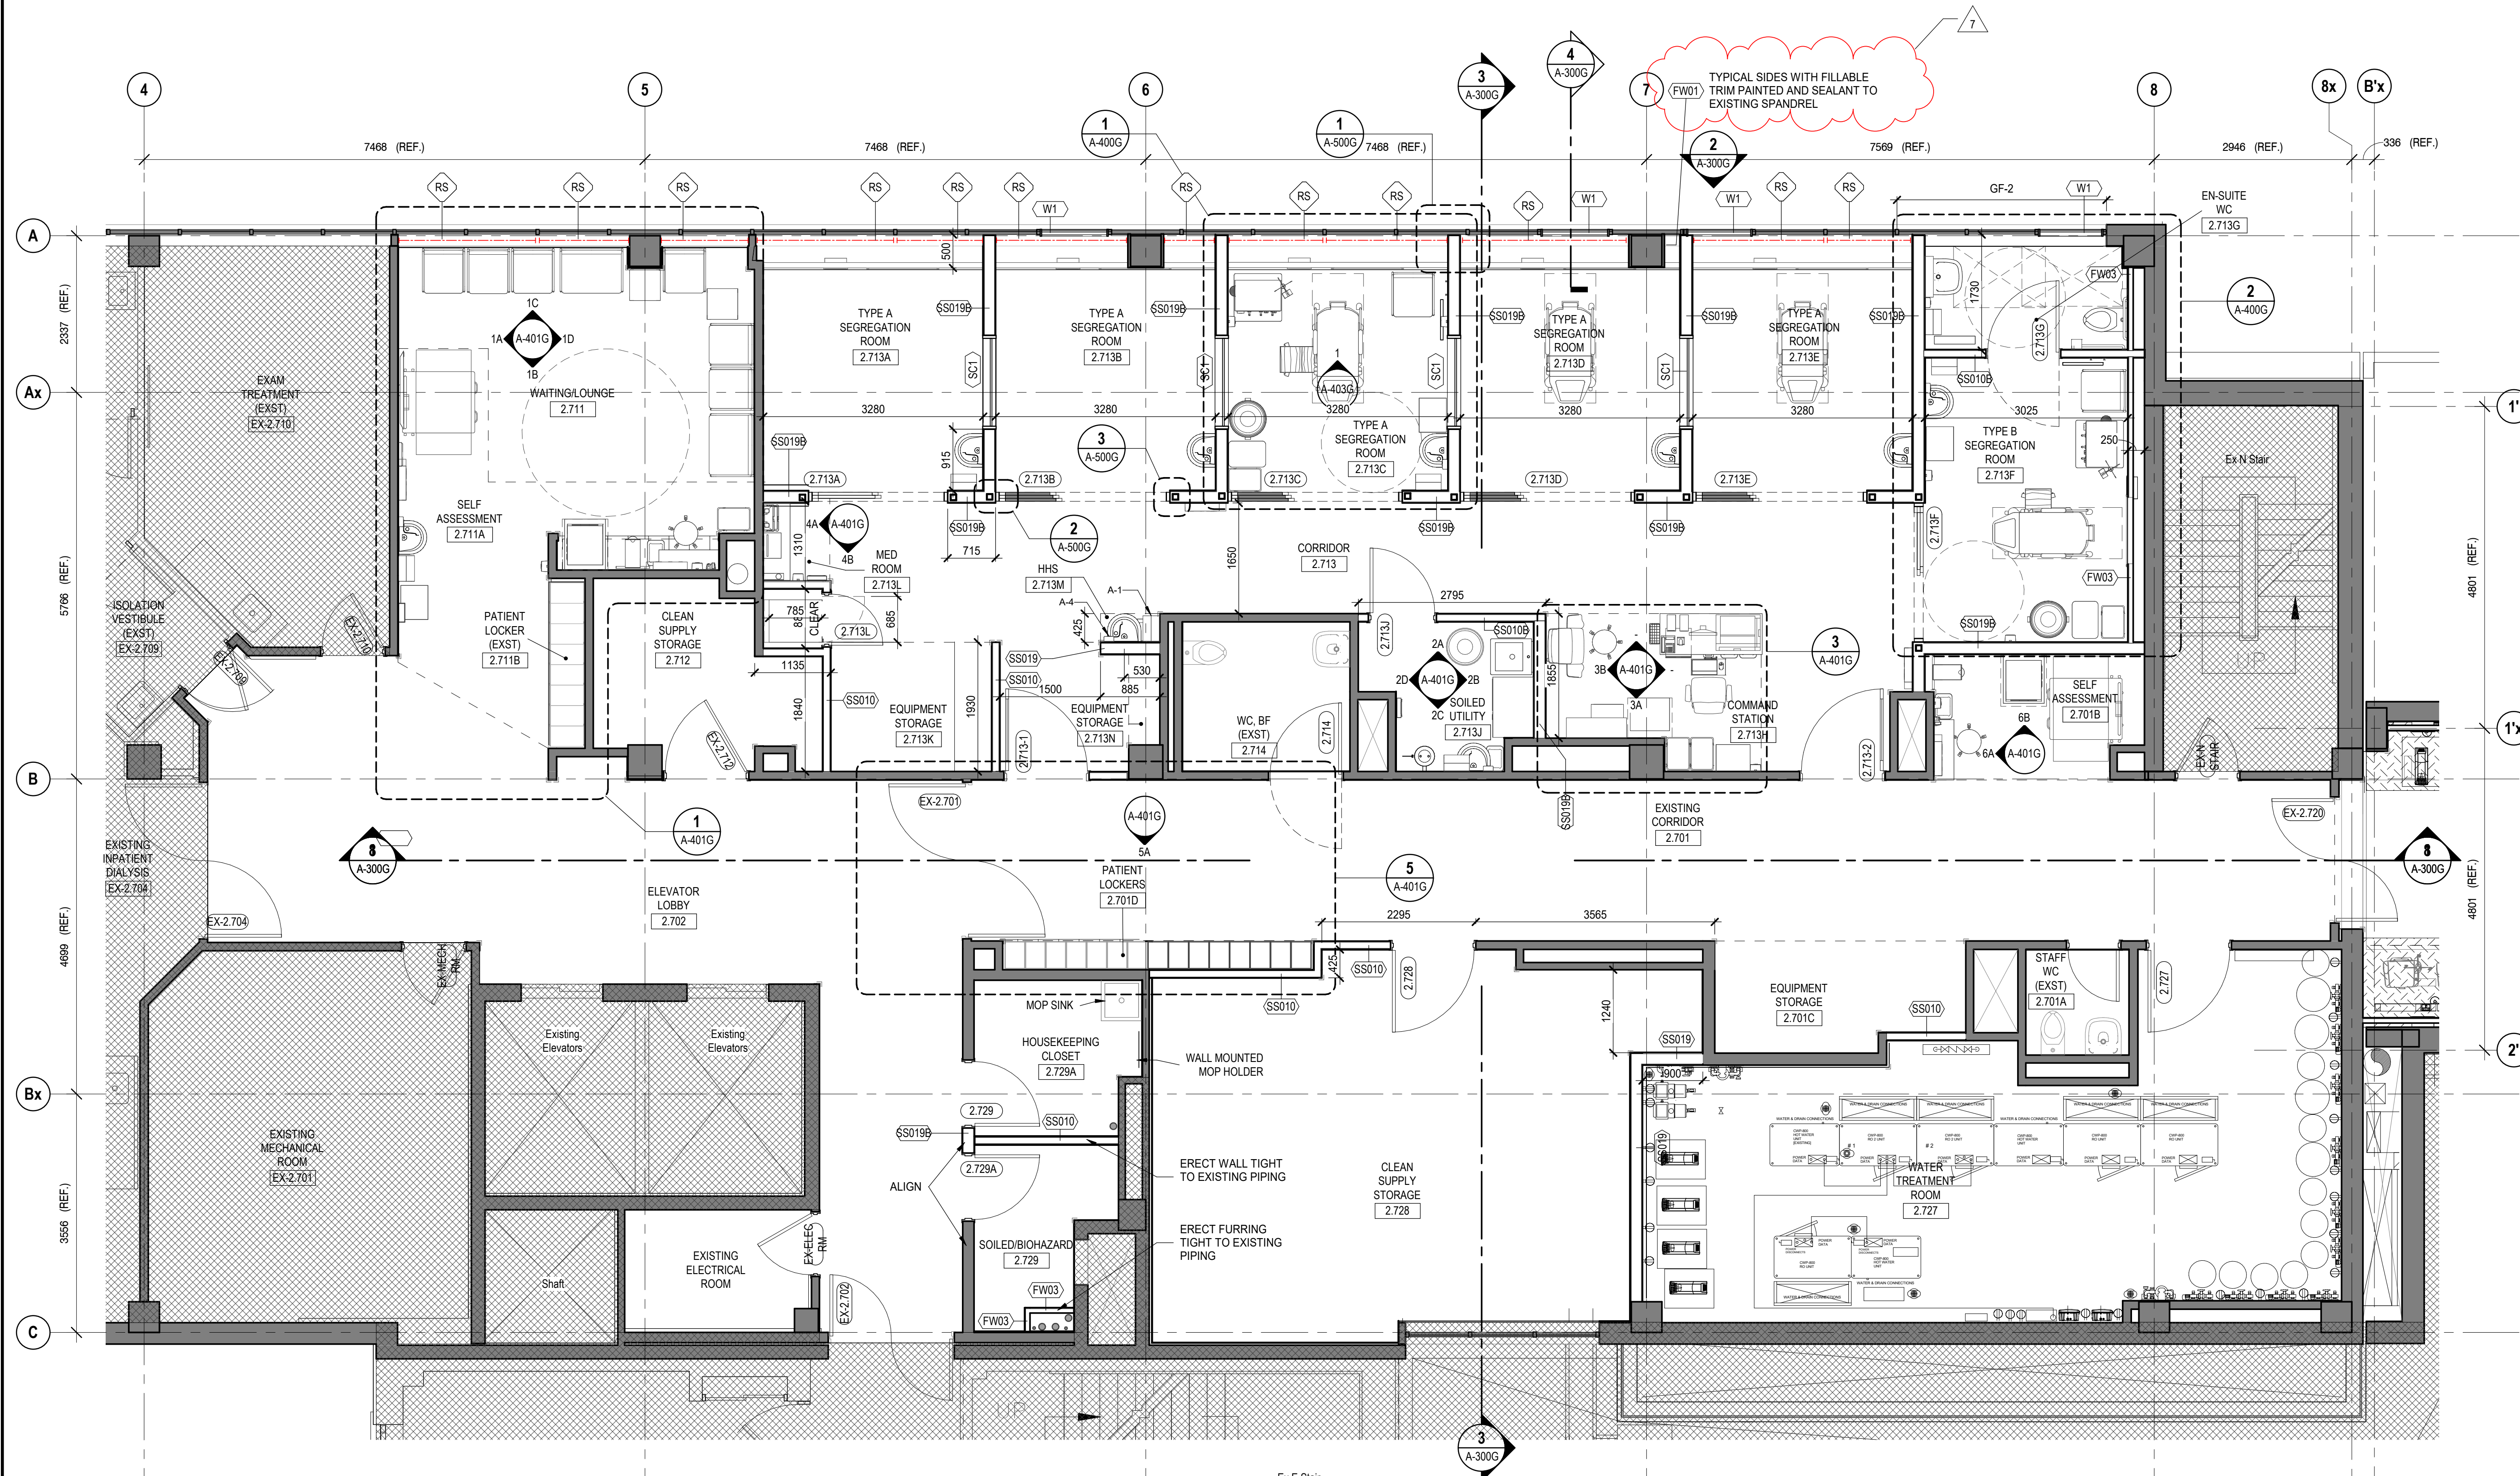PART FLOOR PLAN LEVEL 2 NEW CONSTRUCTION -
CROCKFORD WING

SCALE: 1:50

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7	2024-06-12	ISSUED FOR ARCHIT. ADDENDUM 1		
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3	2023-11-17	ISSUED FOR CO-ORDINATION		
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1	2023-12-22	ISSUED FOR CO-ORDINATION		

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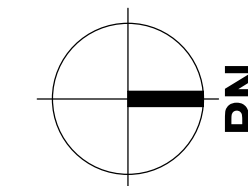
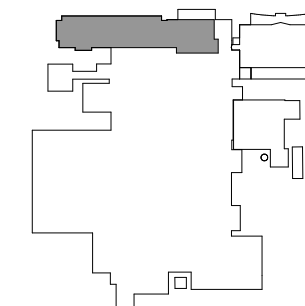
FLOOR PLAN - LEVEL 2 CROCKFORD
WING

DRAWING ISSUE

PROJECT NO.	PLOT DATE	DRAWN	AUTHOR
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A-130G	@ ARCH D		

A-130G

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7	2024-06-12	ISSUED FOR ARCHIT. ADDENDUM 1	
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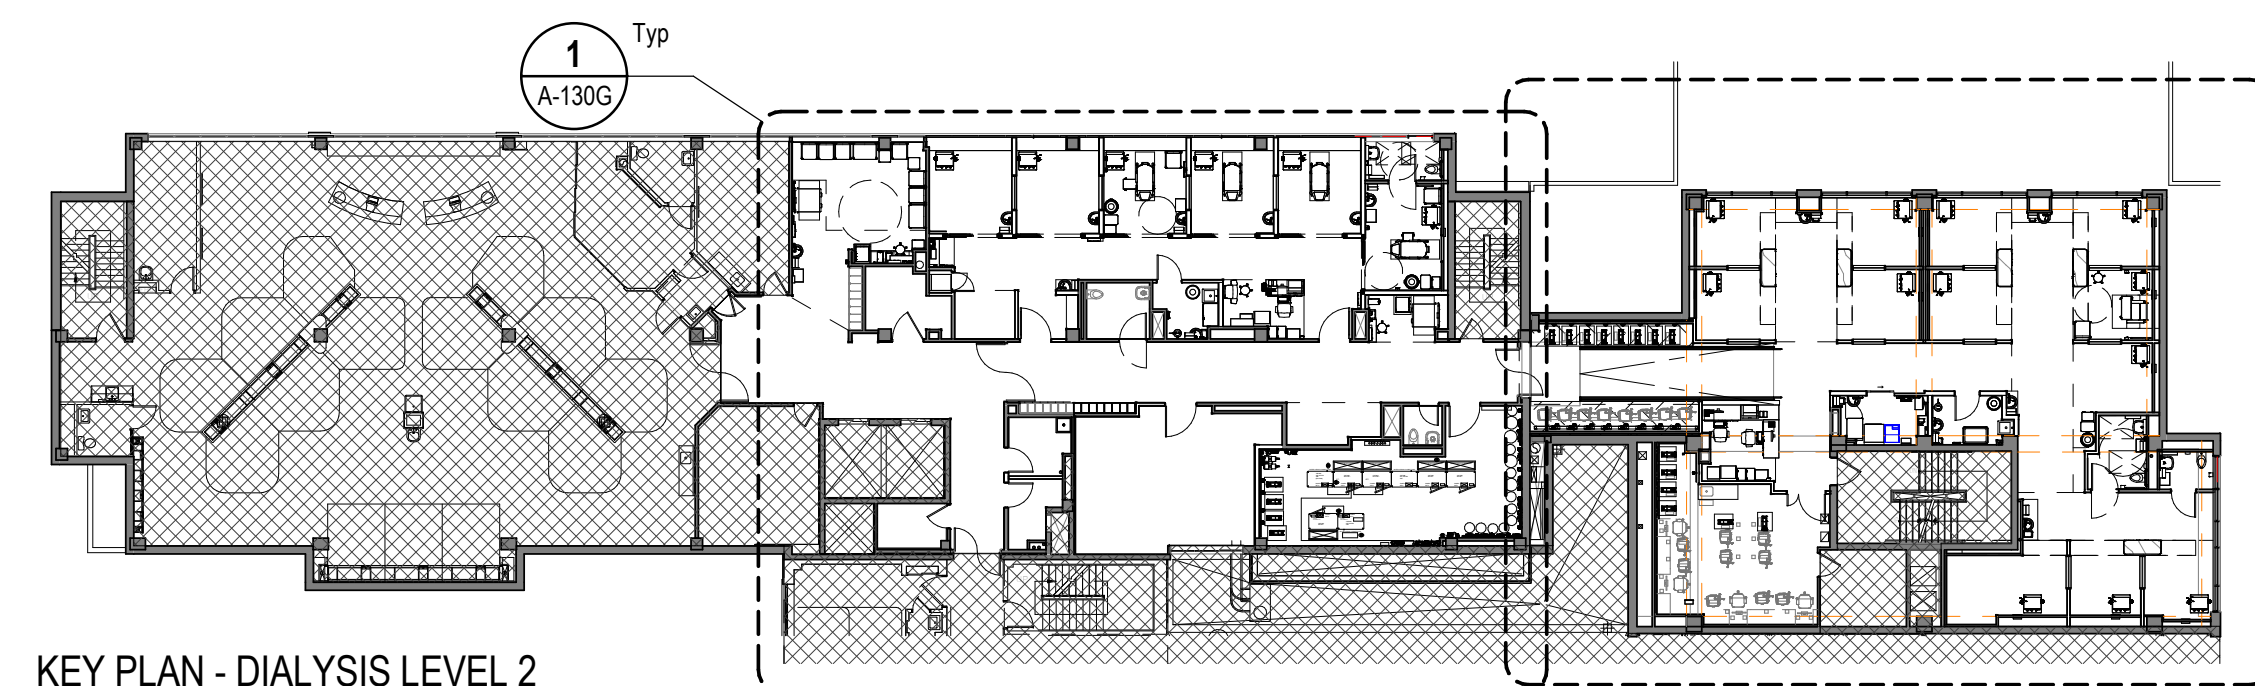
FLOOR PLAN - LEVEL 2 WEST WING

DRAWING ISSUE


PROJECT NO.	PLOT DATE	2023-11-17	DRAWN	Author
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A-131G

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KEY PLAN - DIALYSIS LEVEL 2




3 CRAWL SPACE BELOW WEST WING LEVEL 2 PLAN


A-131G SCALE: 1:150

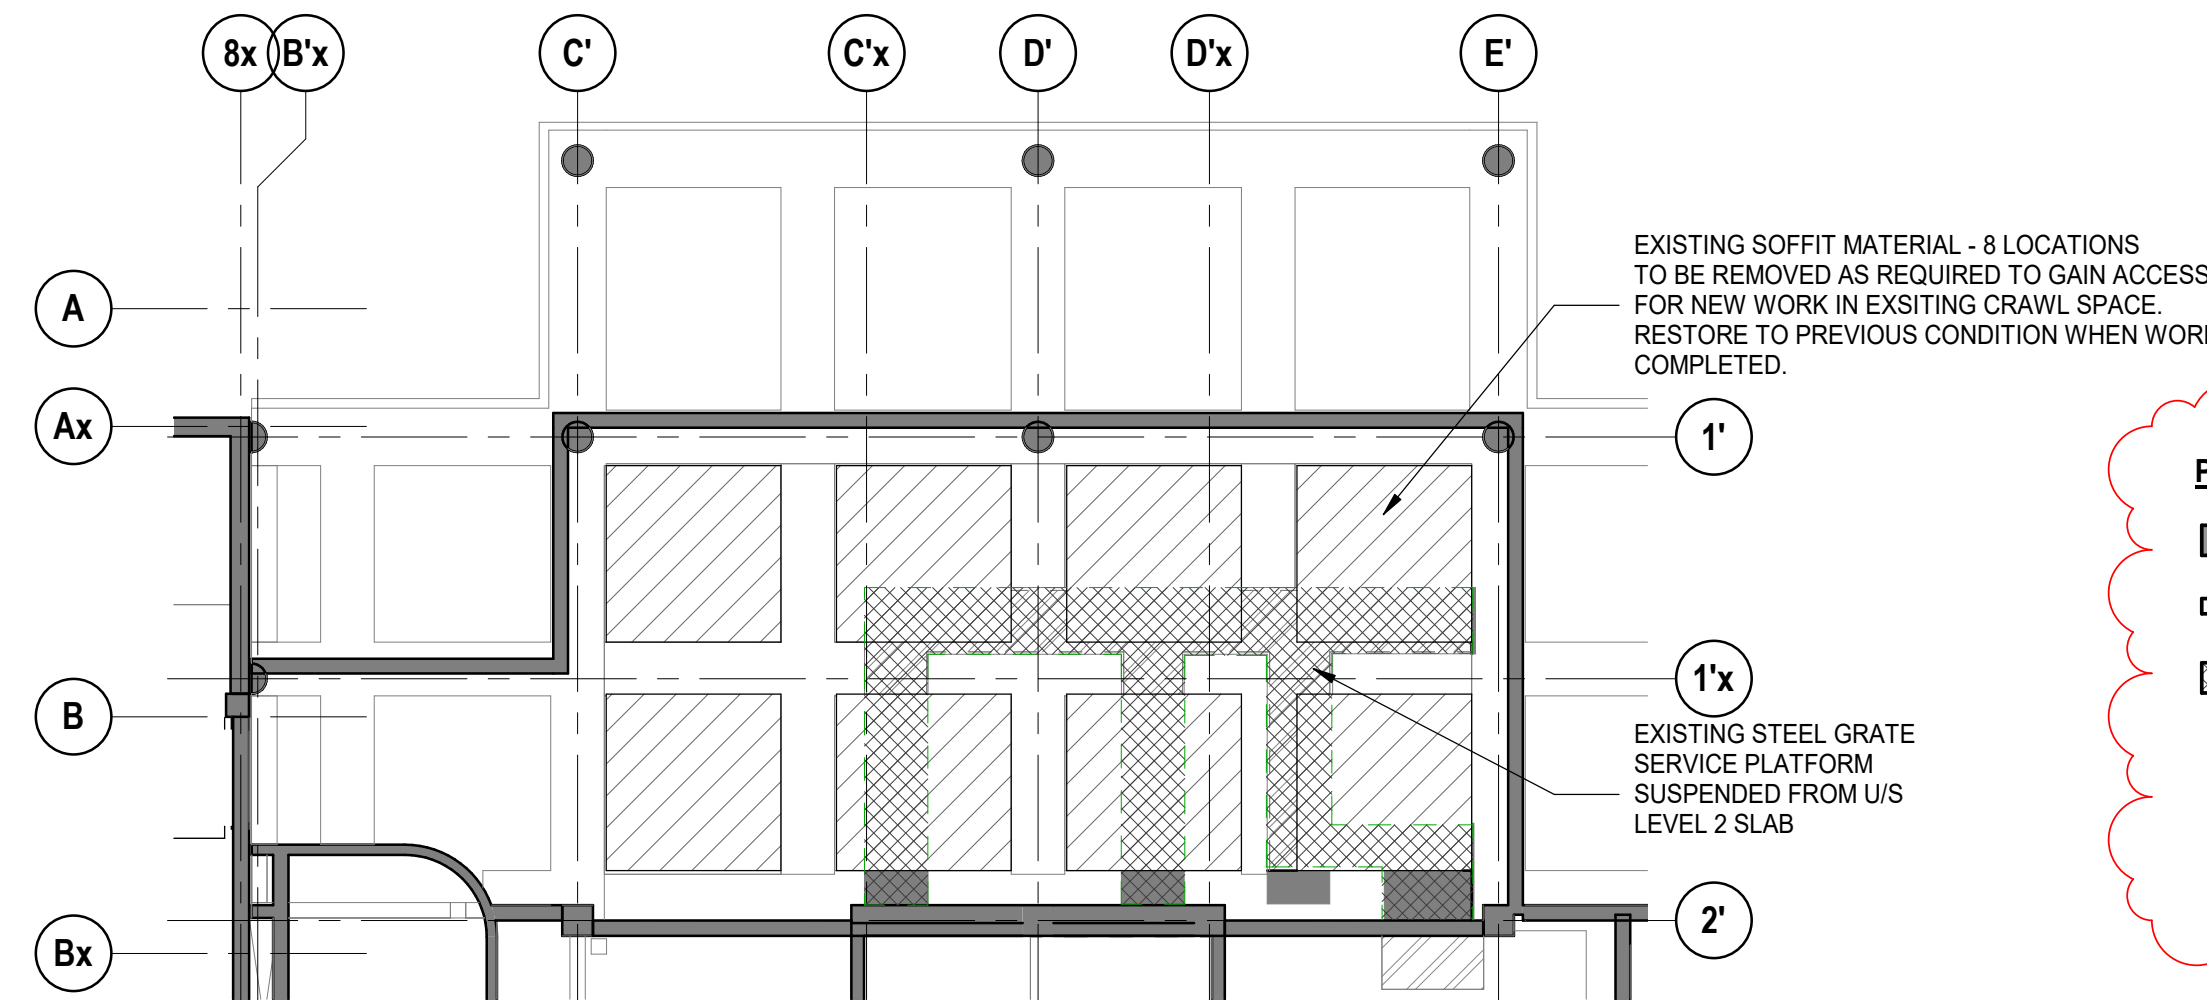PARTITION / WALL LEGEND

	EXISTING WALL
	NEW WALL
	AREA NOT IN SCOPE OF WORK
	ROLLER SHADE (RS) WHERE SHOWN




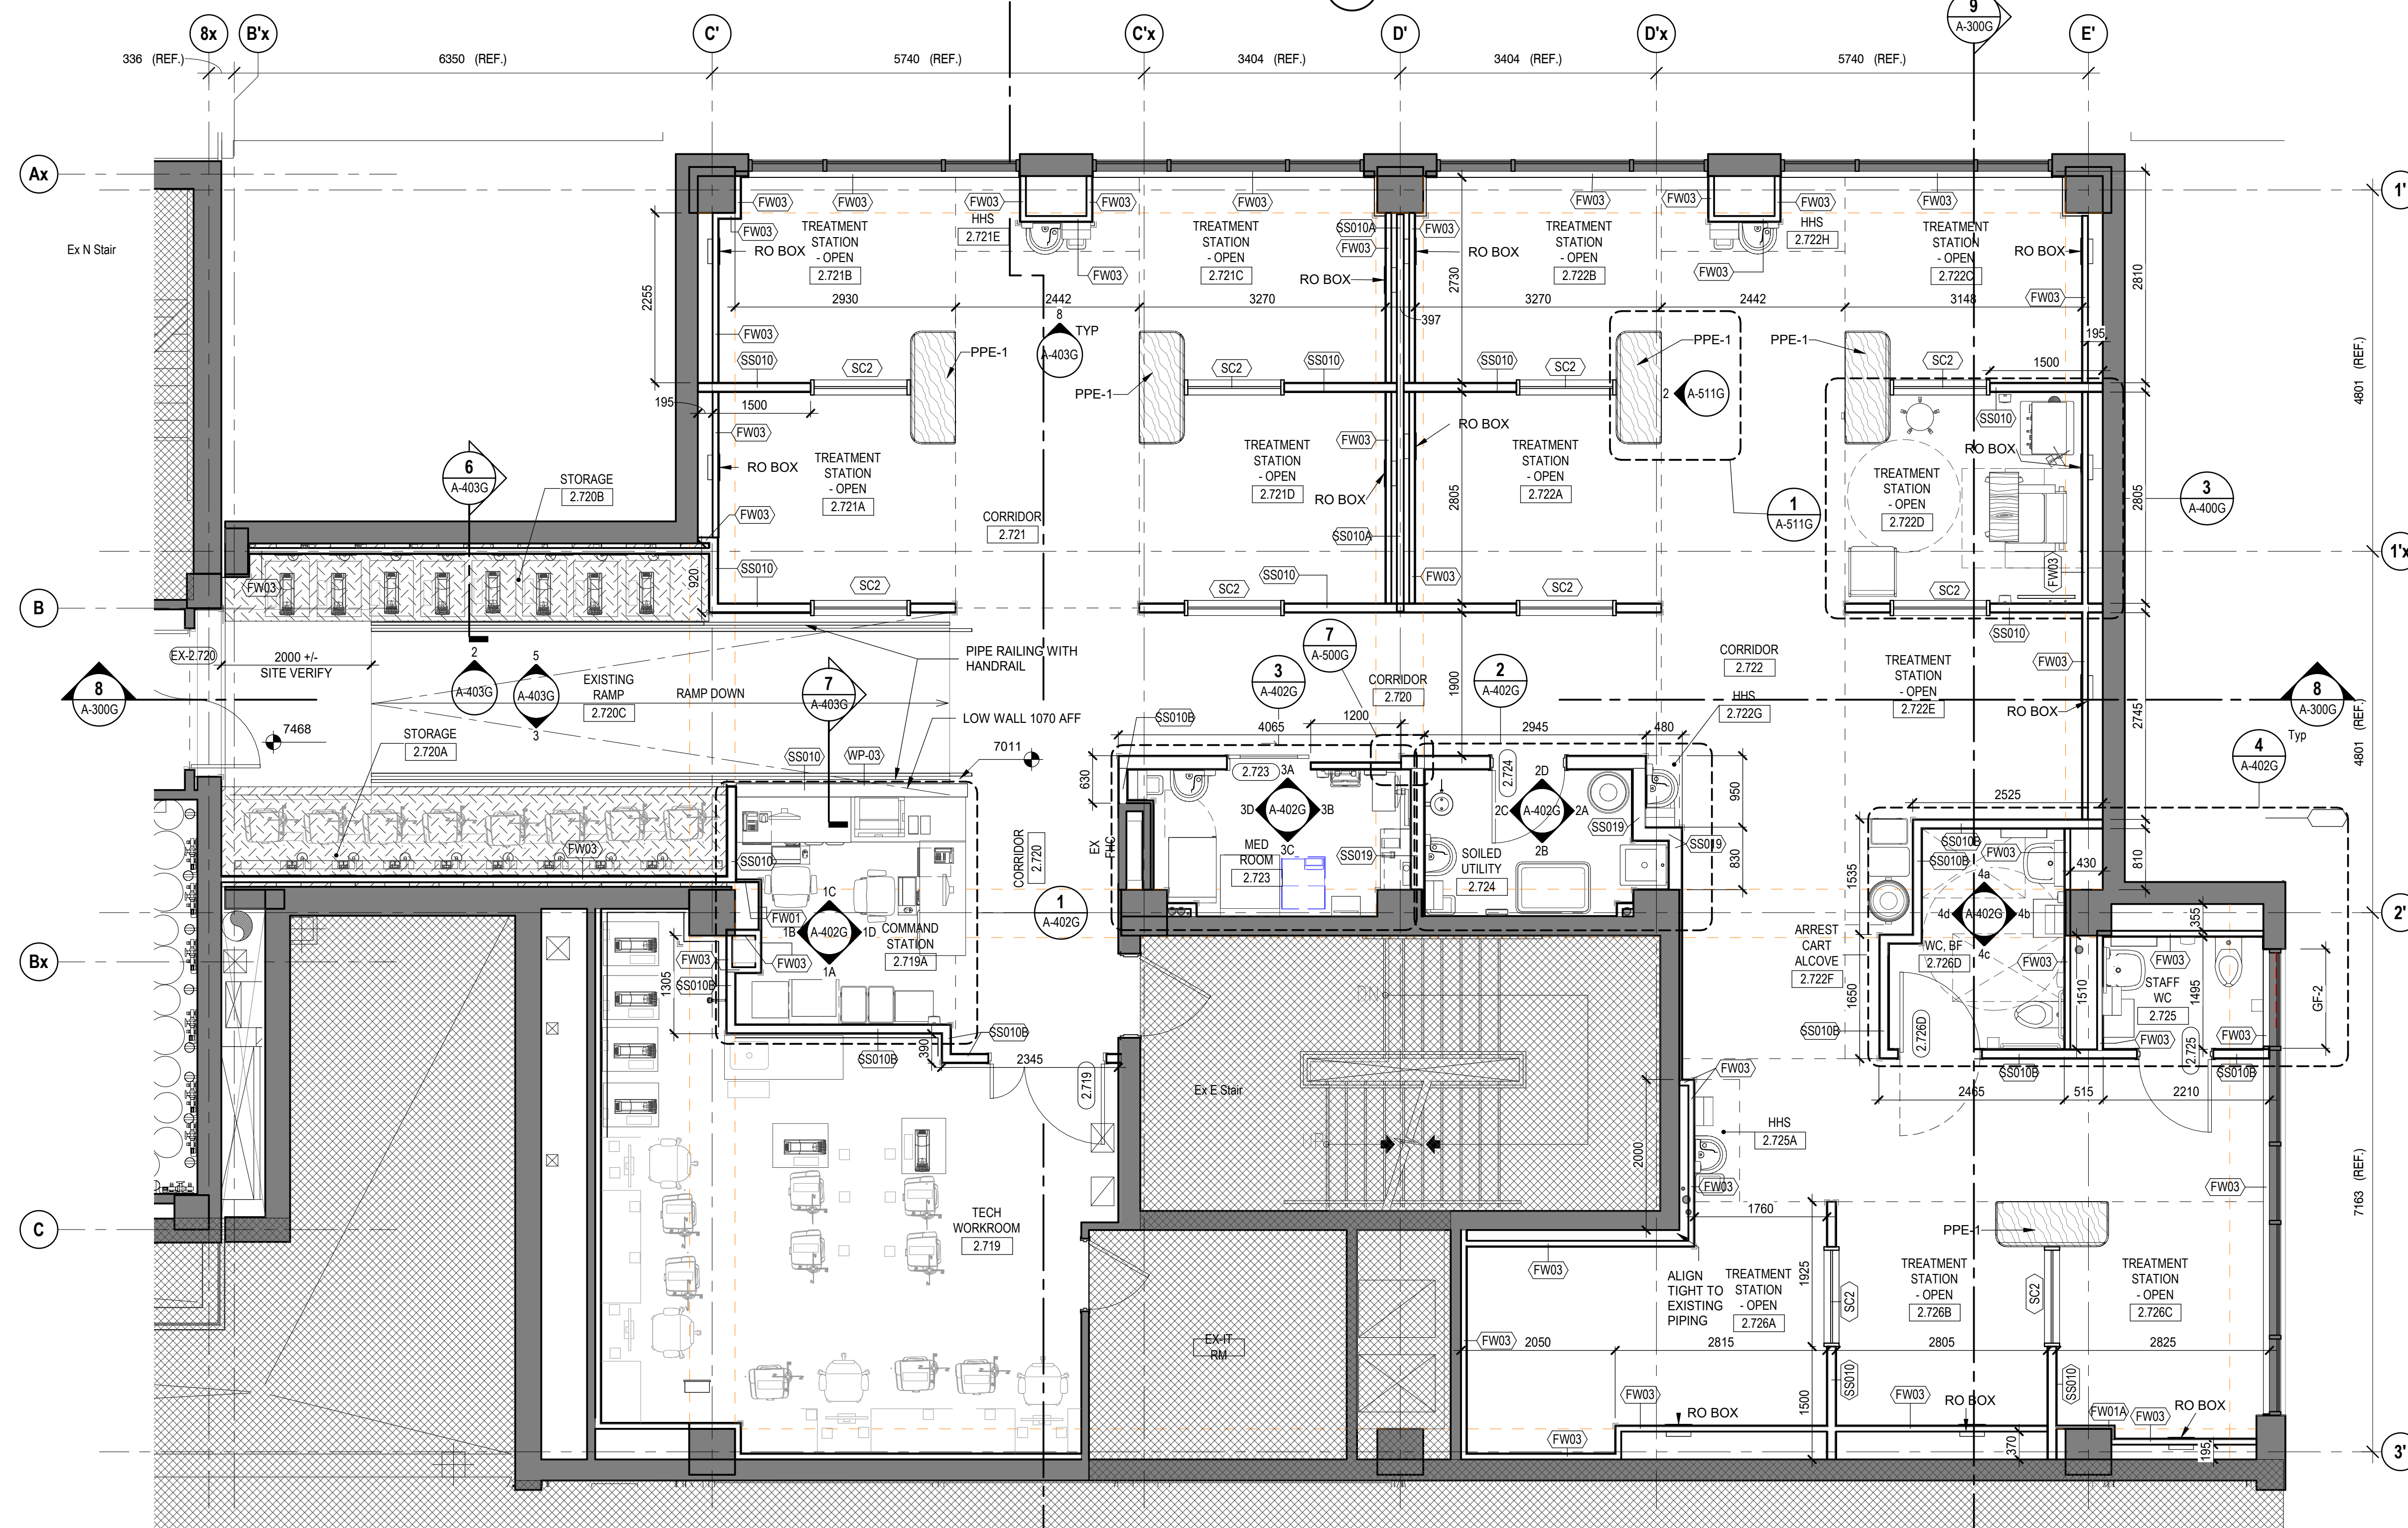
PART FLOOR PLAN LEVEL 2 NEW CONSTRUCTION -
WEST WING

A-131G SCALE: 1:50

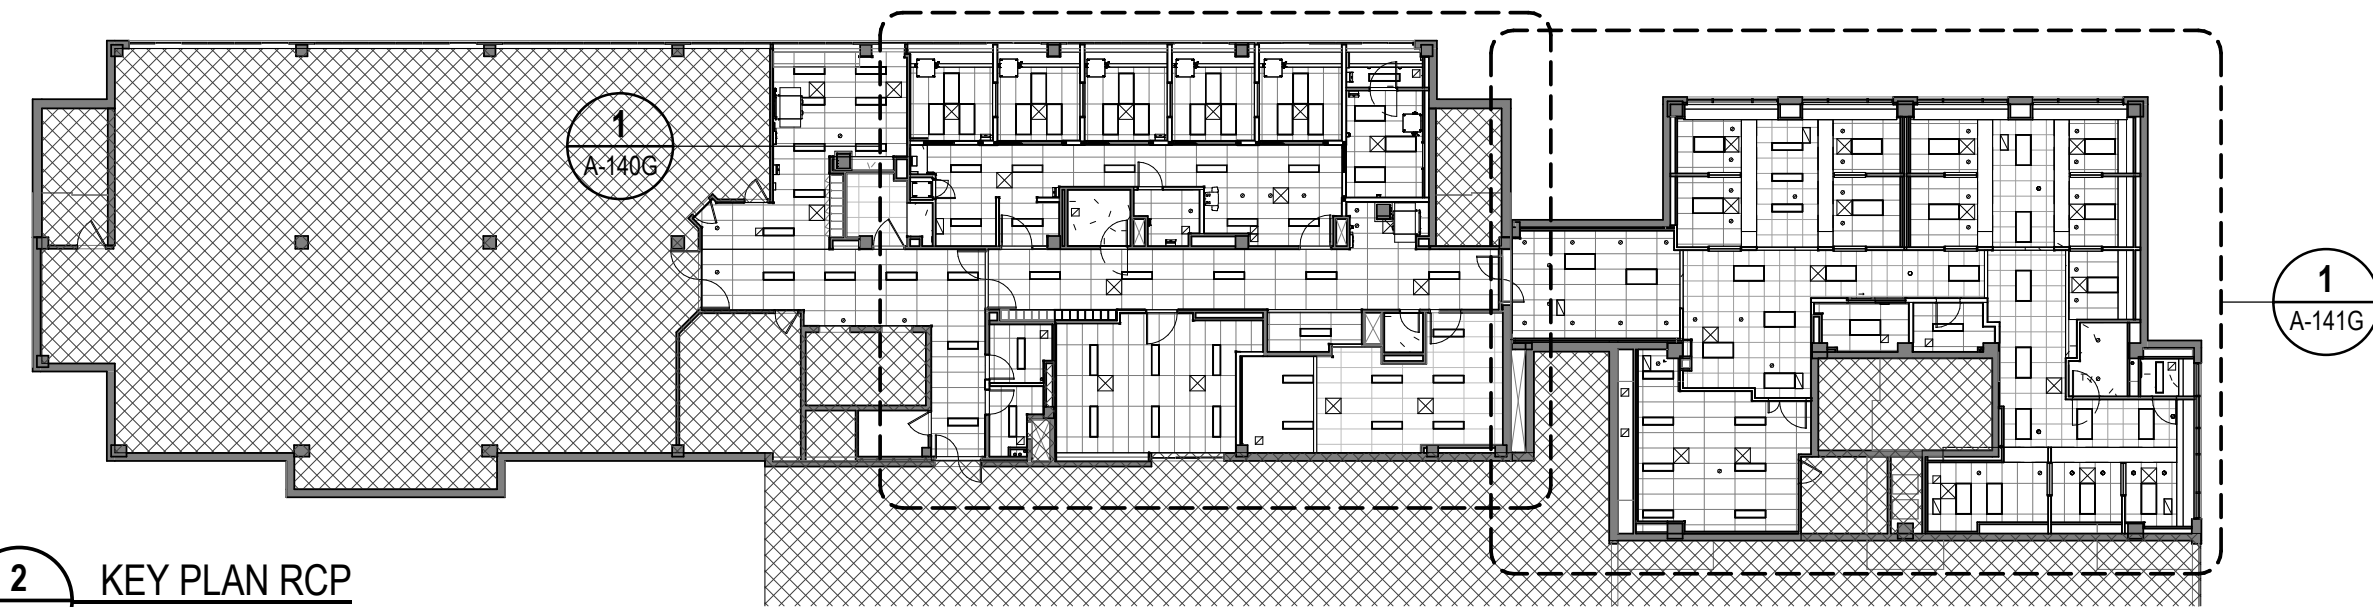

2 KEY PLAN RCP
SCALE: 1:300

PARTITION / WALL / CEILING LEGEND	
	EXISTING WALL
	NEW WALL
	NEW 610x1220 SUSPENDED T-BAR CEILING ACT2
	NEW SUSPENDED GYPSUM BOARD CEILING GWB
	RECESSED 1200 x 1200 LIGHT FIXTURE
	RECESSED ROUND DOWNLIGHT FIXTURE
	SUPPLY AIR DIFFUSER
	RETURN AIR DIFFUSER
	ROLLER SHADE (RS)

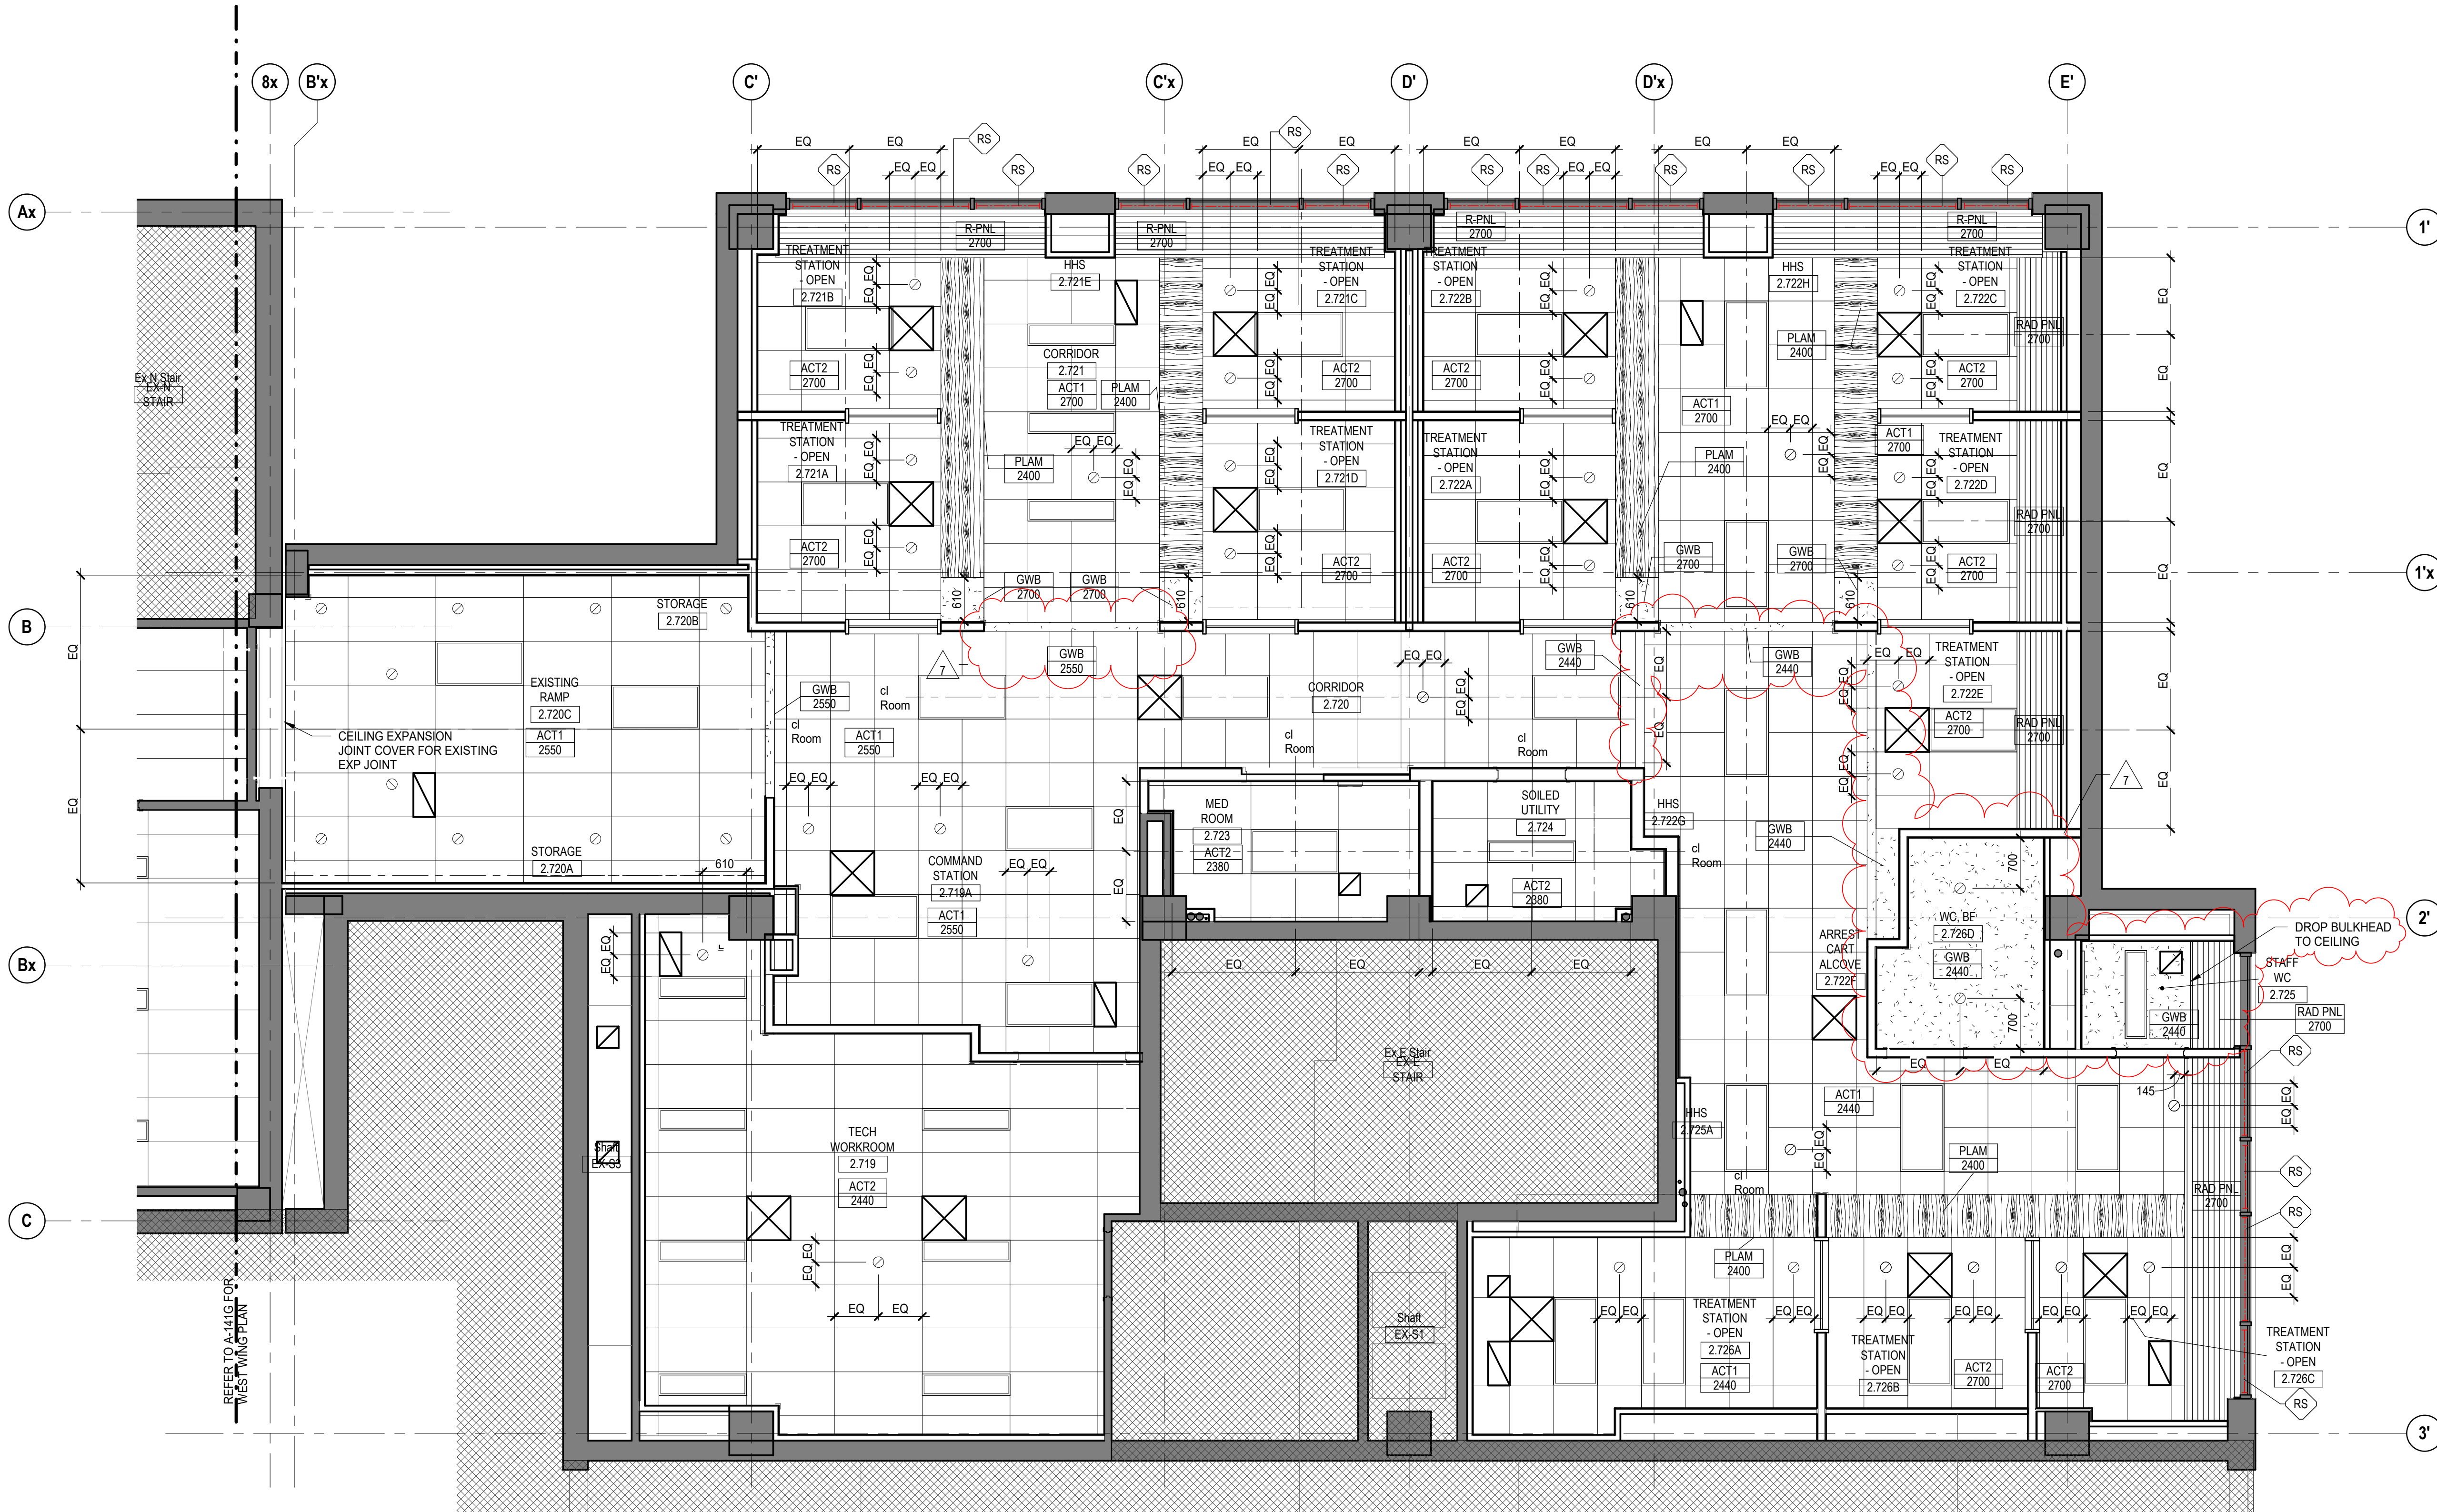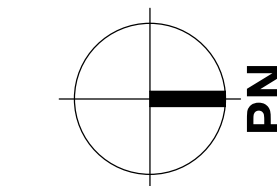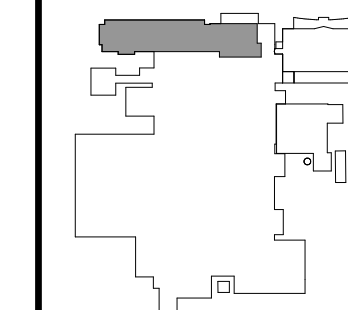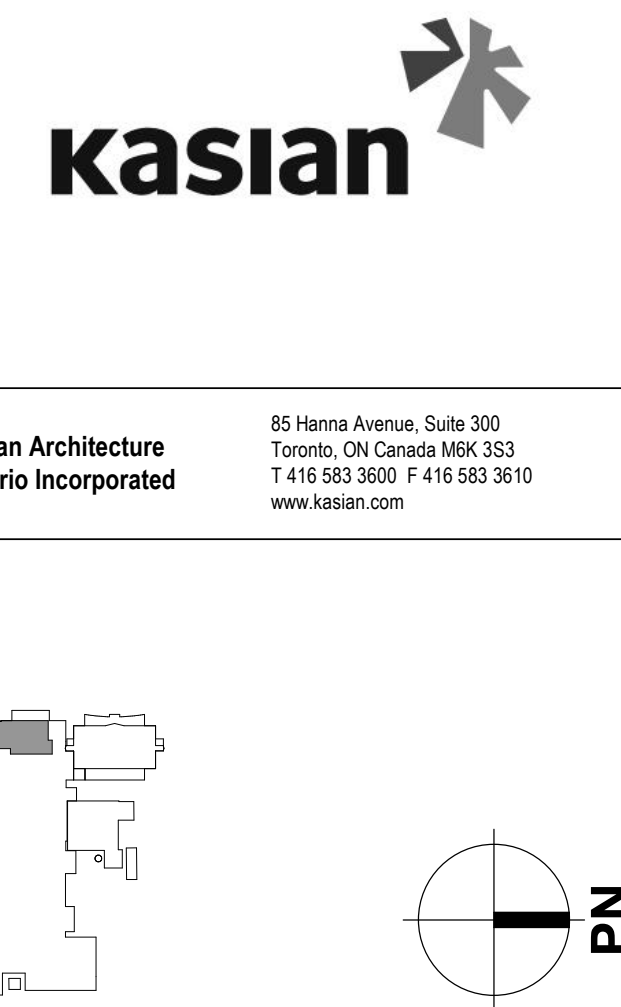

1 REFLECTED CEILING PLAN - WEST WING
SCALE: 1:50

7	2024-06-12	ISSUED FOR ARCHIT. ADDENDUM 1	
6	2024-04-22	ISSUED FOR TENDER	
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2	2023-08-28	80% ISSUED FOR COSTING	
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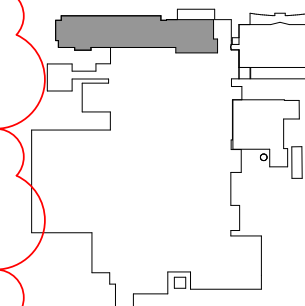
REFLECTED CEILING PLAN - LEVEL 2 WEST WING

DRAWING ISSUE



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A-141G

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PN

**1 LEVEL 2 - WALL PROTECTION PLAN**
A-160G SCALE: 1:125**2 LEVEL 2 - WALL FINISHES PLAN**
A-160G SCALE: 1:125**WALL PROTECTION LEGEND**

- WP-01 | HYGIENIC WALL PROTECTION @ 1370mm AFF
TYPICAL UNLESS NOTED OTHERWISE
- WP-02 | HYGIENIC WALL PROTECTION BEHIND HHS @ 1675mm AFF
- WP-03 | HYGIENIC WALL PROTECTION @ FULL HEIGHT
- WP-04 | STAINLESS STEEL WALL PROTECTION @ FULL HEIGHT
- WP-05 | HYGIENIC WALL PROTECTION @ 915mm AFF
- WP-06 | HYGIENIC WALL PROTECTION BELOW WINDOW SILL @ 750+/-mm
- CG-1 | STAINLESS STEEL CORNER GUARD @1235mm AFF
- CG-2 | STAINLESS STEEL CORNER GUARD @1235mm AFF

WALL PROTECTION NOTES

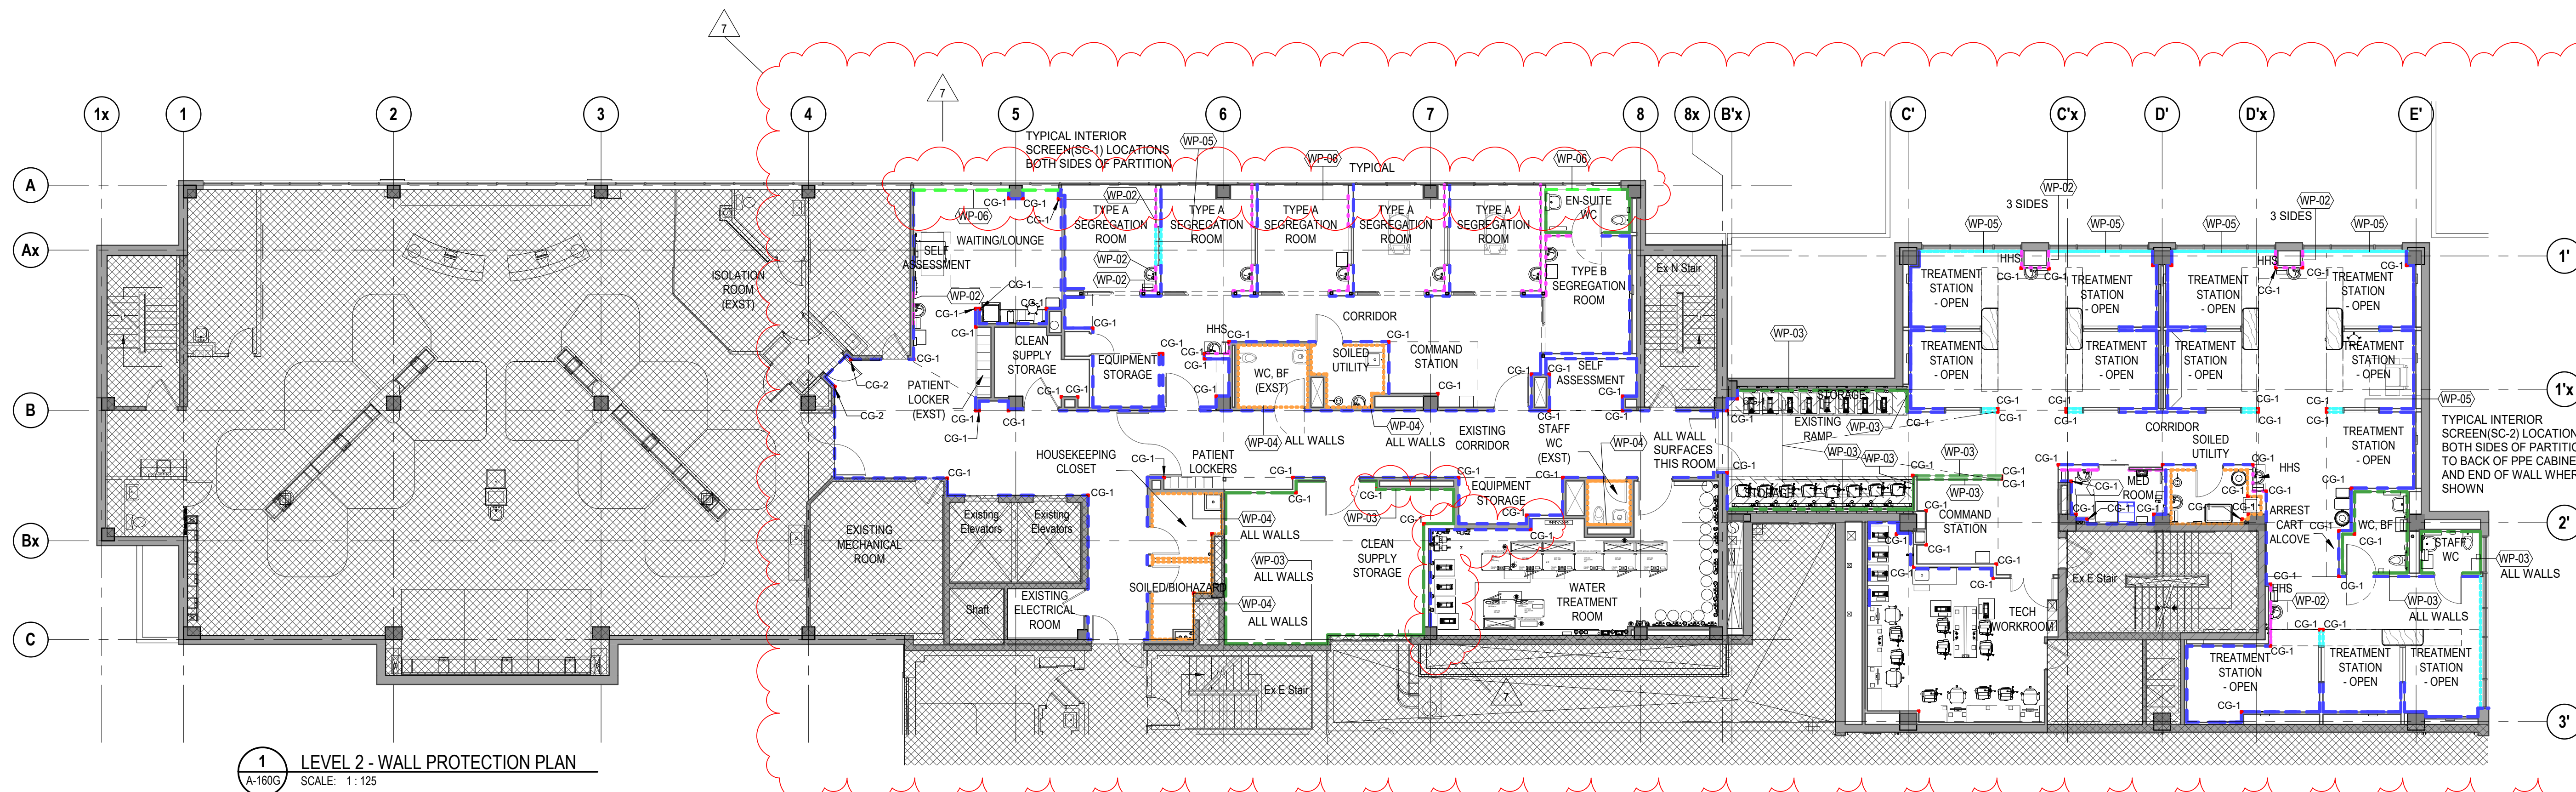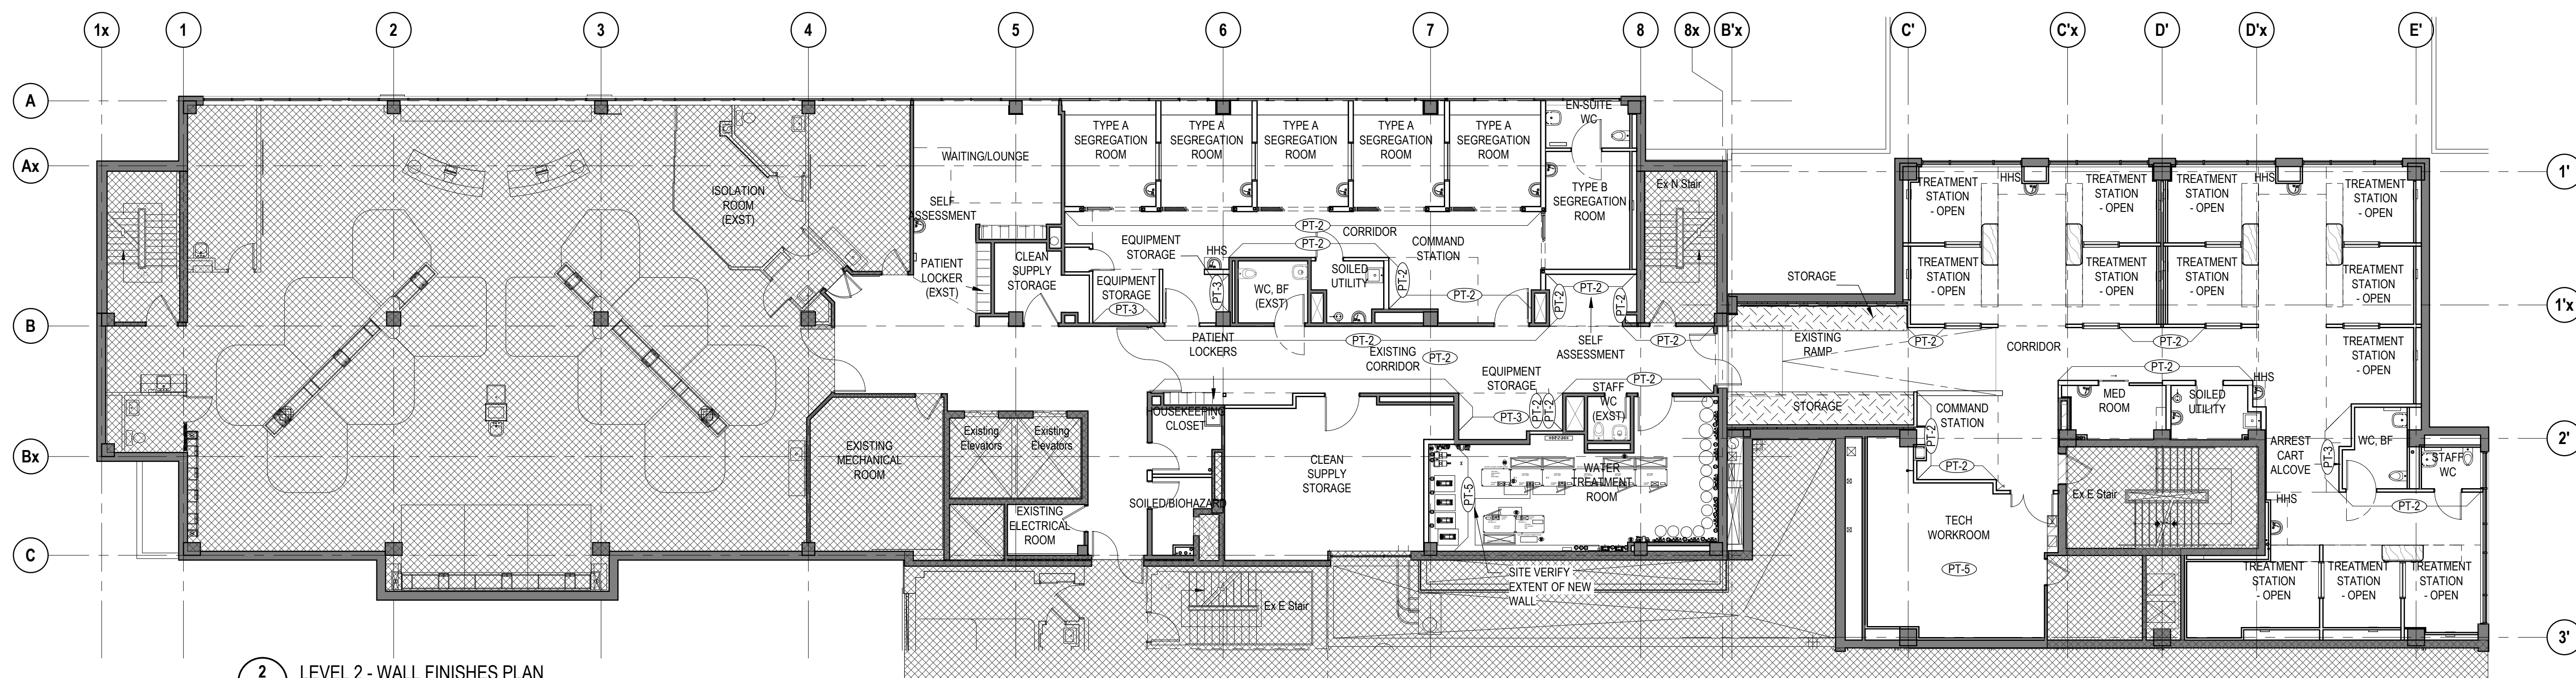1. REFER TO DETAILS FOR INSTALLATION METHOD A-510G
2. ALL WALL HYGIENIC WALL PROTECTION SEAMS TO BE HEAT WELDED
3. WHERE EXPOSED, TOP EDGES OF WALL PROTECTION TO BE CAPPED WITH ONE-PART COLOUR MATCHING START AND EDGE TRIM
4. WHERE NOTED IN WALL PROTECTION LEGEND ALL FULL HEIGHT WALL PROTECTION TO ALIGN WITH INTERIOR DOOR HEIGHT.
5. ALL EXPOSED GYPSUM WALL BOARD SURFACES ABOVE ALL WALL PROTECTION PANELS TO BE PAINTED. REFER TO WALL FINISHES PLAN FOR PAINT TYPE AND LOCATIONS
6. ALL CORNER GUARDS TO BE INSTALLED 150mm AFF @ HEIGHT AS NOTED
7. WHERE 2 CORNER GUARDS ARE USED ON A WALL END, PAINT THE WALL STRIP UNCOVERED BETWEEN THE 2 CORNER GUARDS TO MATCH WALL PROTECTION COLOUR.
8. SITE VERIFY ALL WALL PROTECTION PANELS FOR HEIGHT TO UNDERSIDE OF EXISTING WINDOW SILLS AND NEW INTERIOR SCREENS

WALL FINISHES NOTES

1. REFER TO INTERIOR FINISHES MATRIX FOR COLOURS AND DETAILS (A-600G).
2. ALL EXPOSED GYPSUM WALL SURFACES ABOVE WALL PROTECTION TO BE PAINTED PT-1, UNLESS NOTED OTHERWISE.

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1	2023-12-22	ISSUED FOR DD COSTING	
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PROJECT

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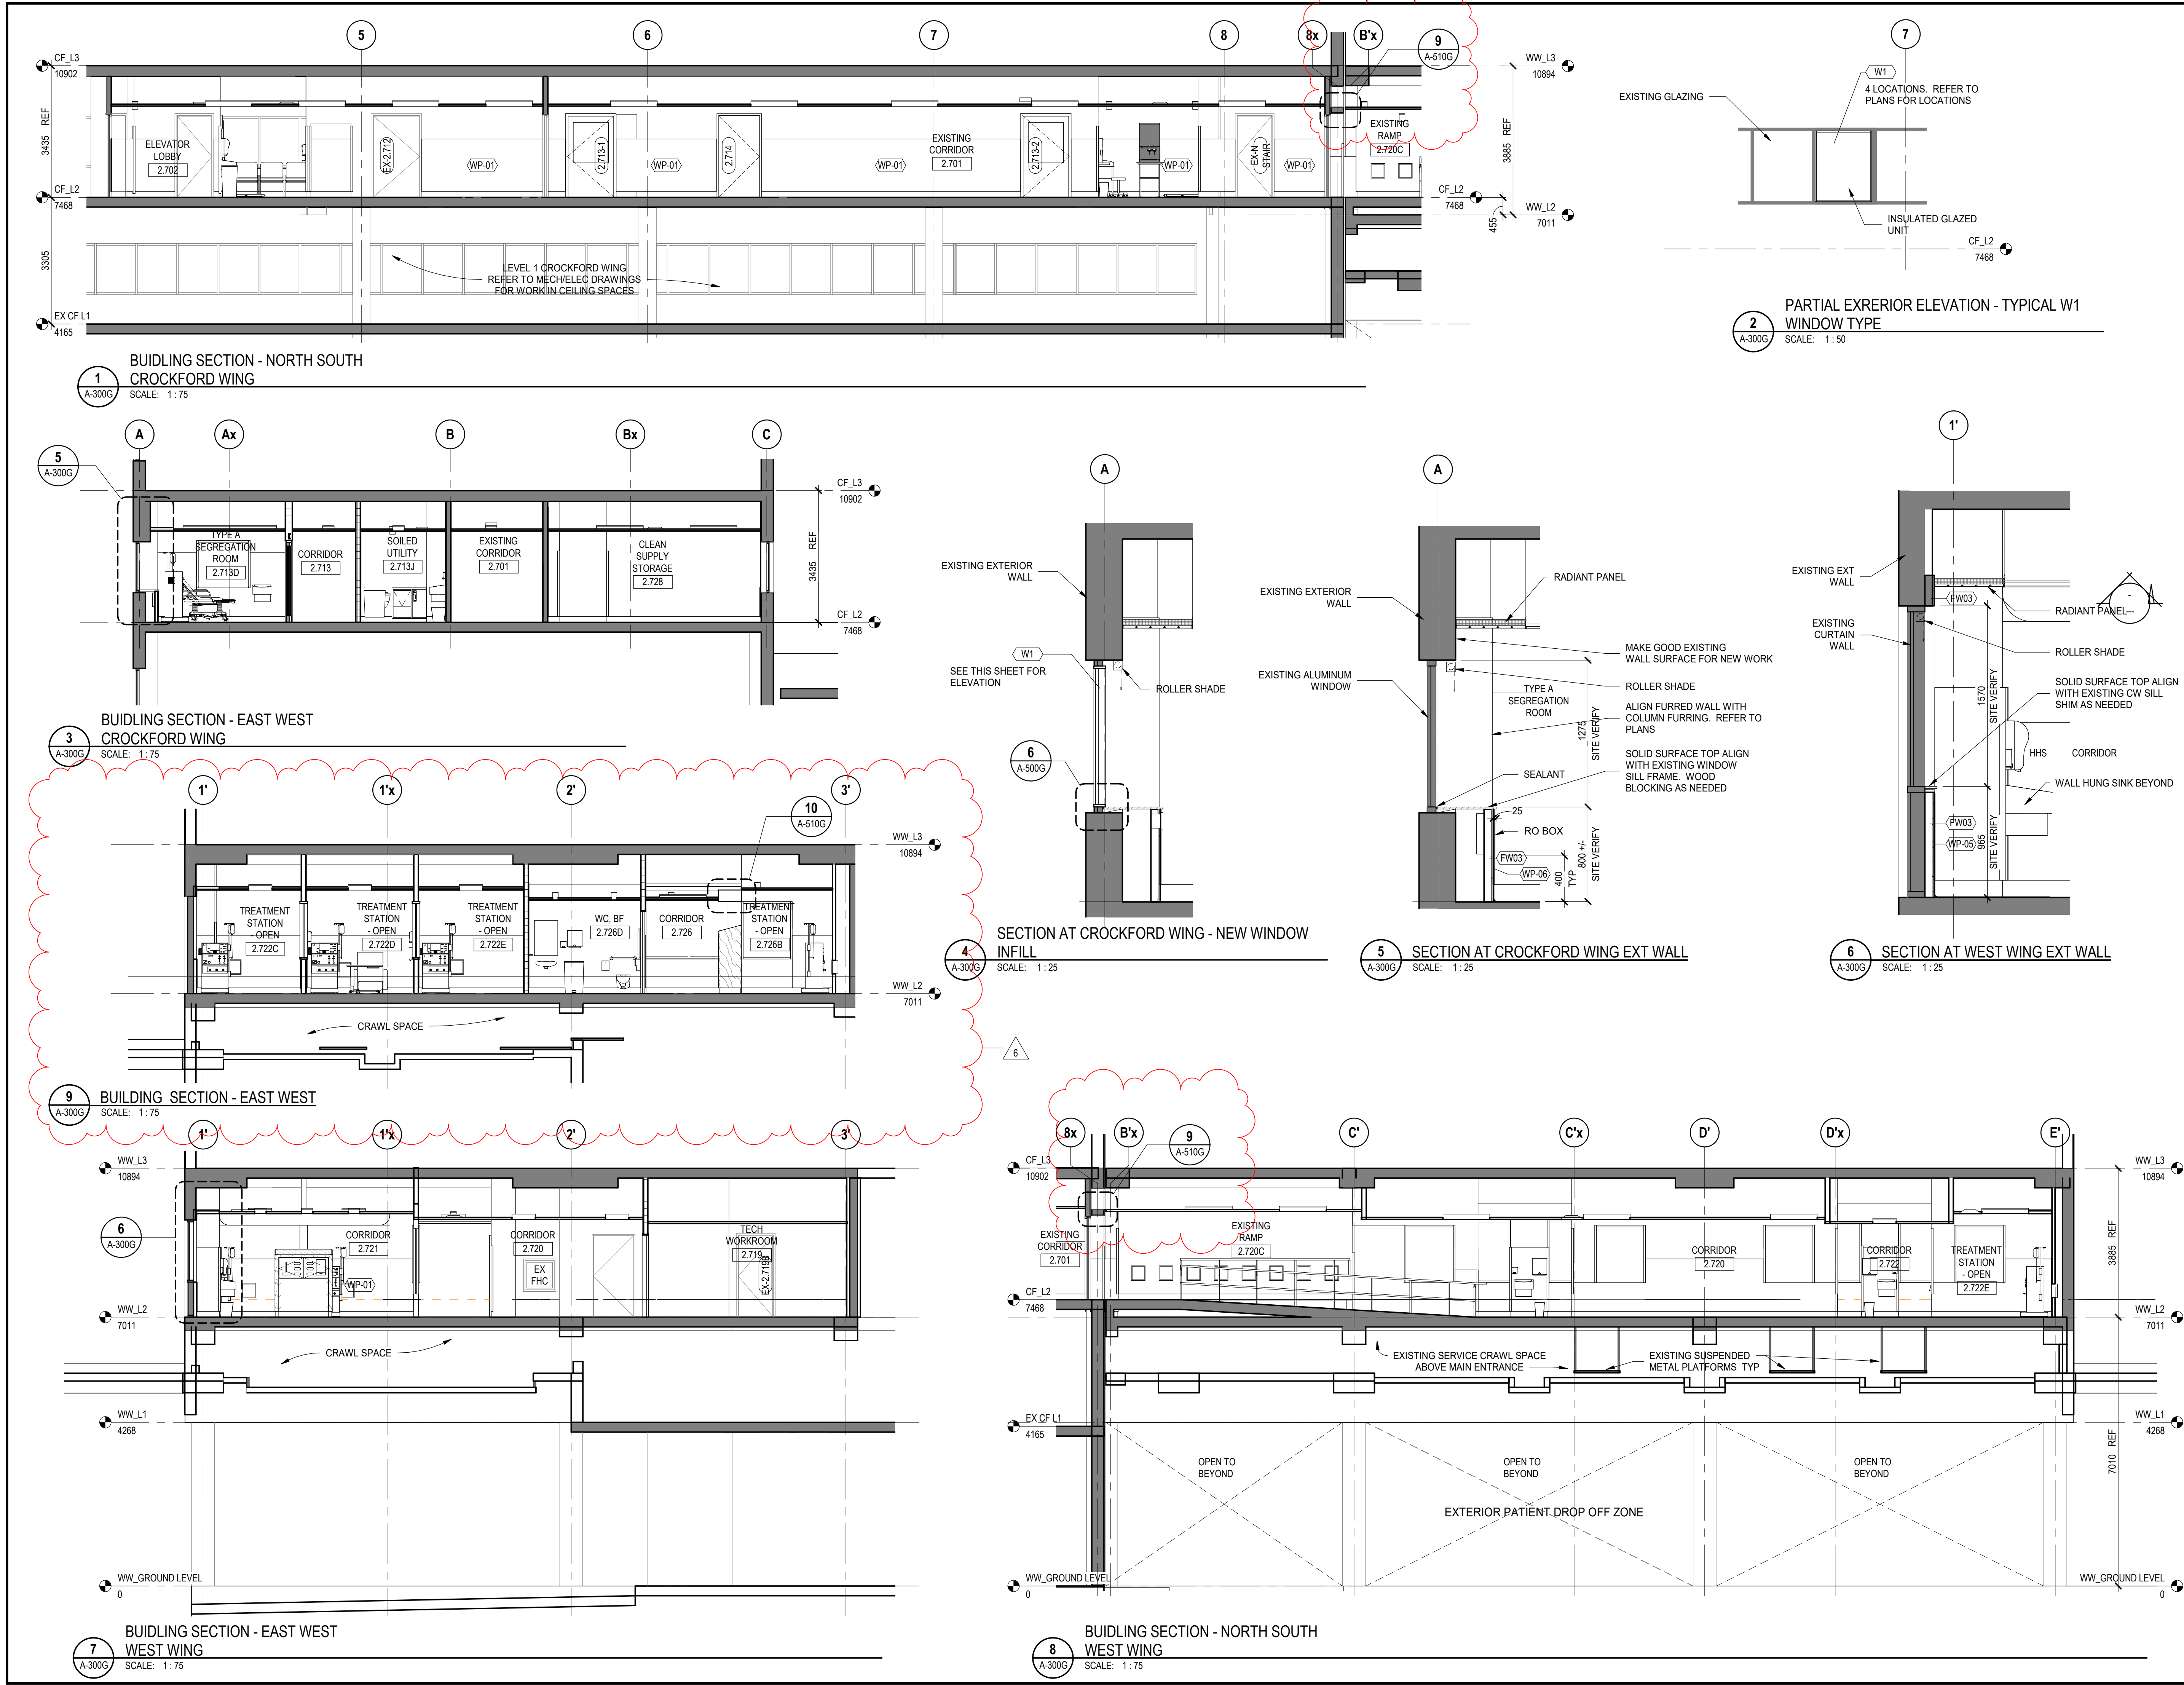
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DRAWING TITLE

**WALL PROTECTION AND FINISHES
PLANS - LEVEL 2**

DRAWING ISSUE

PROJECT NO.	PLOT DATE	2023-11-17	DRAWN	Author
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DRAWING NO.	A-160G			REVISION
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6	2024-06-12	ISSUED FOR ARCH LADDENDUM 1	
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PROJECT
SHN DIALYSIS CARE UNIT - GENERAL HOSPITAL





SCARBOROUGH, ONTARIO, CANADA


DRAWING TITLE

**BUILDING SECTIONS/
WALL SECTIONS**

DRAWING ISSUE


PROJECT NO.	PLOT DATE	2023-11-17	DRAWN	Author
240065	SCALE	As indicated	REVIEWED	Checker
DRAWING NO.	A-300G			REVISION
				6

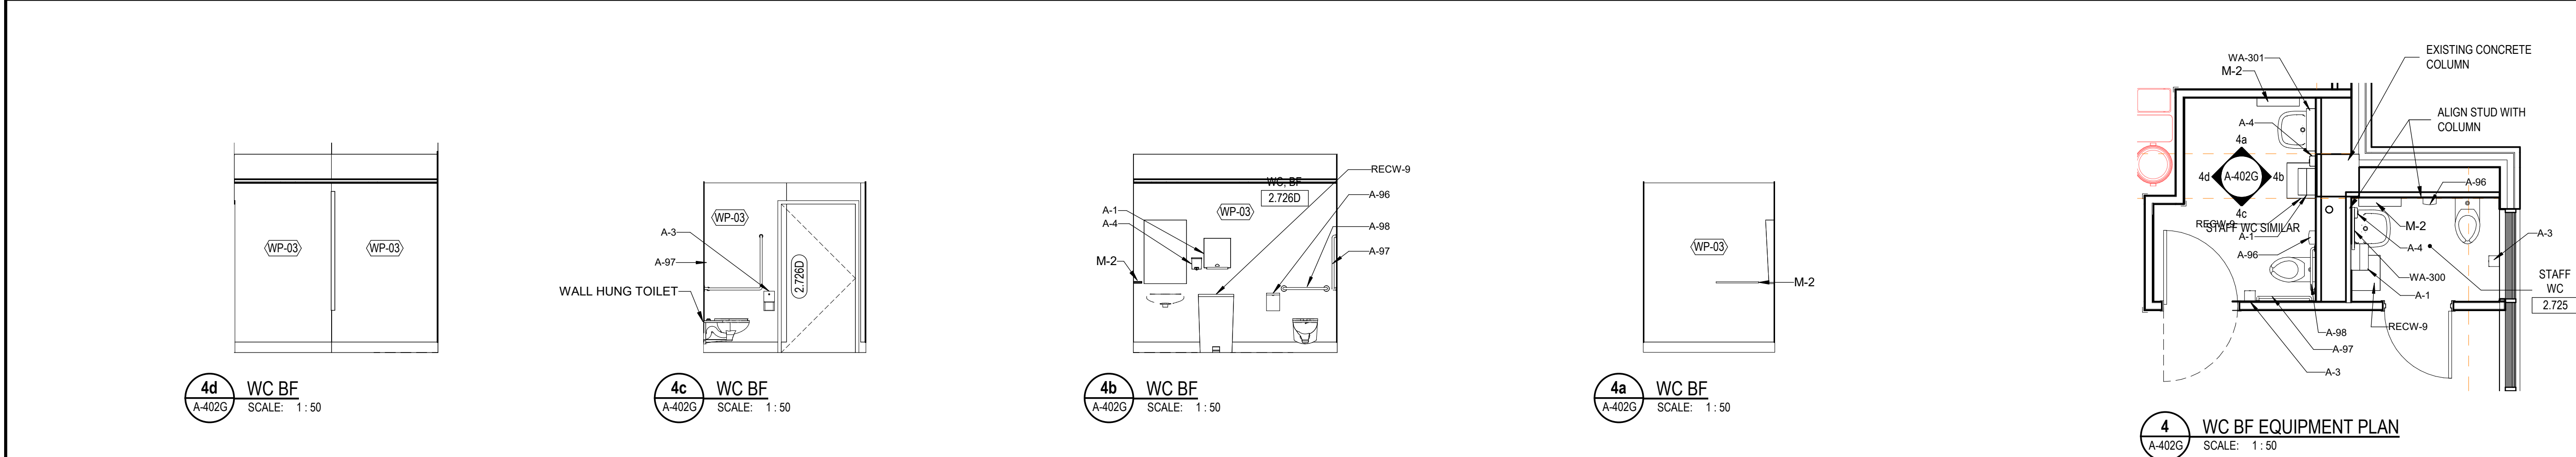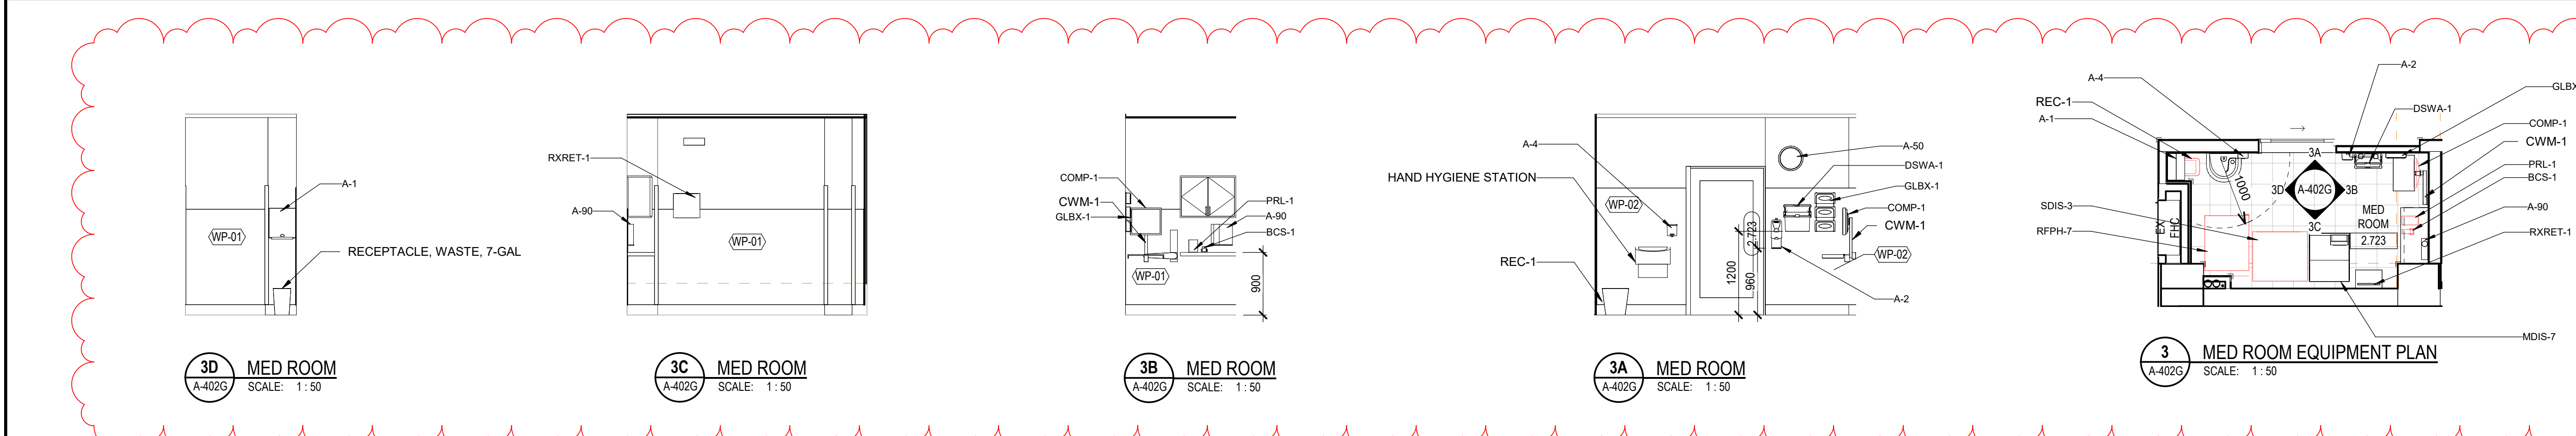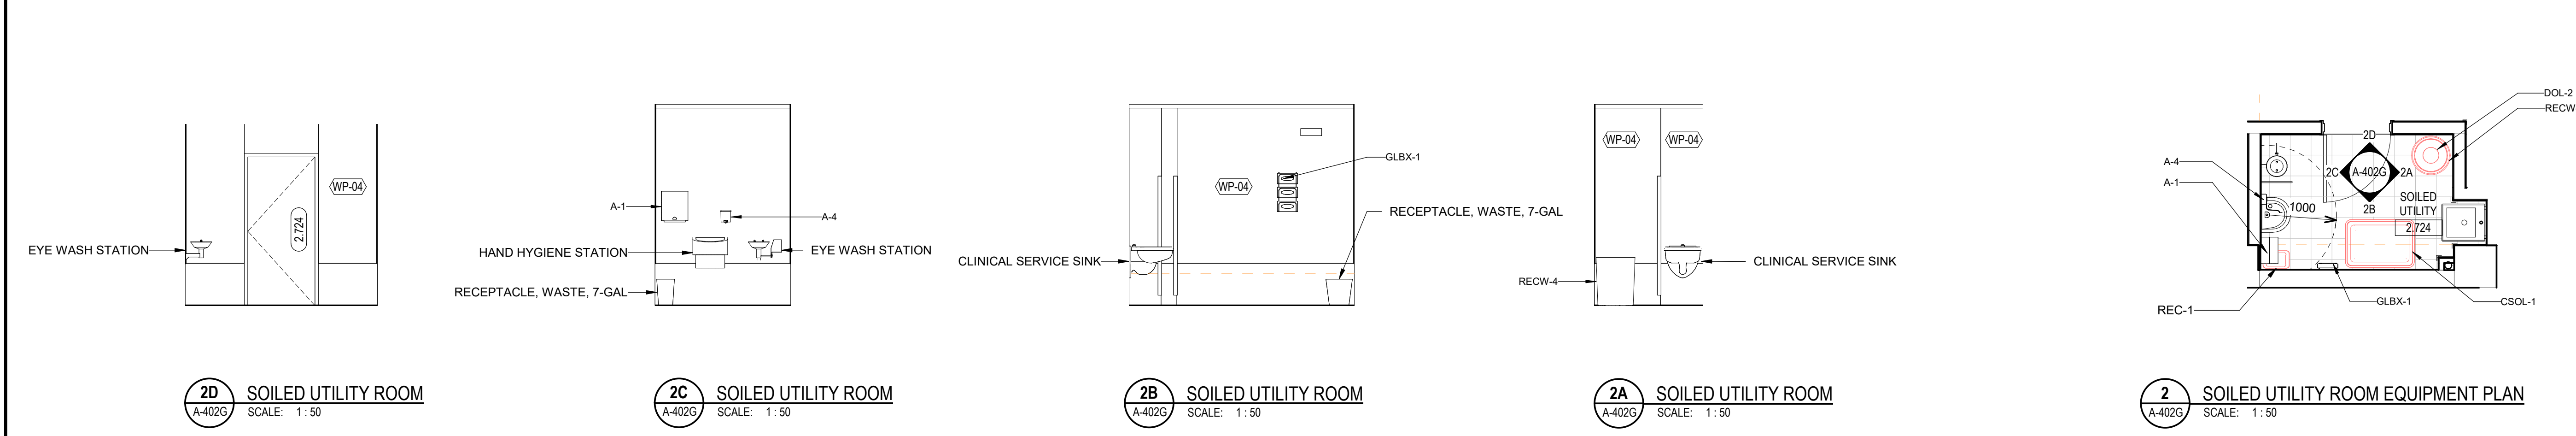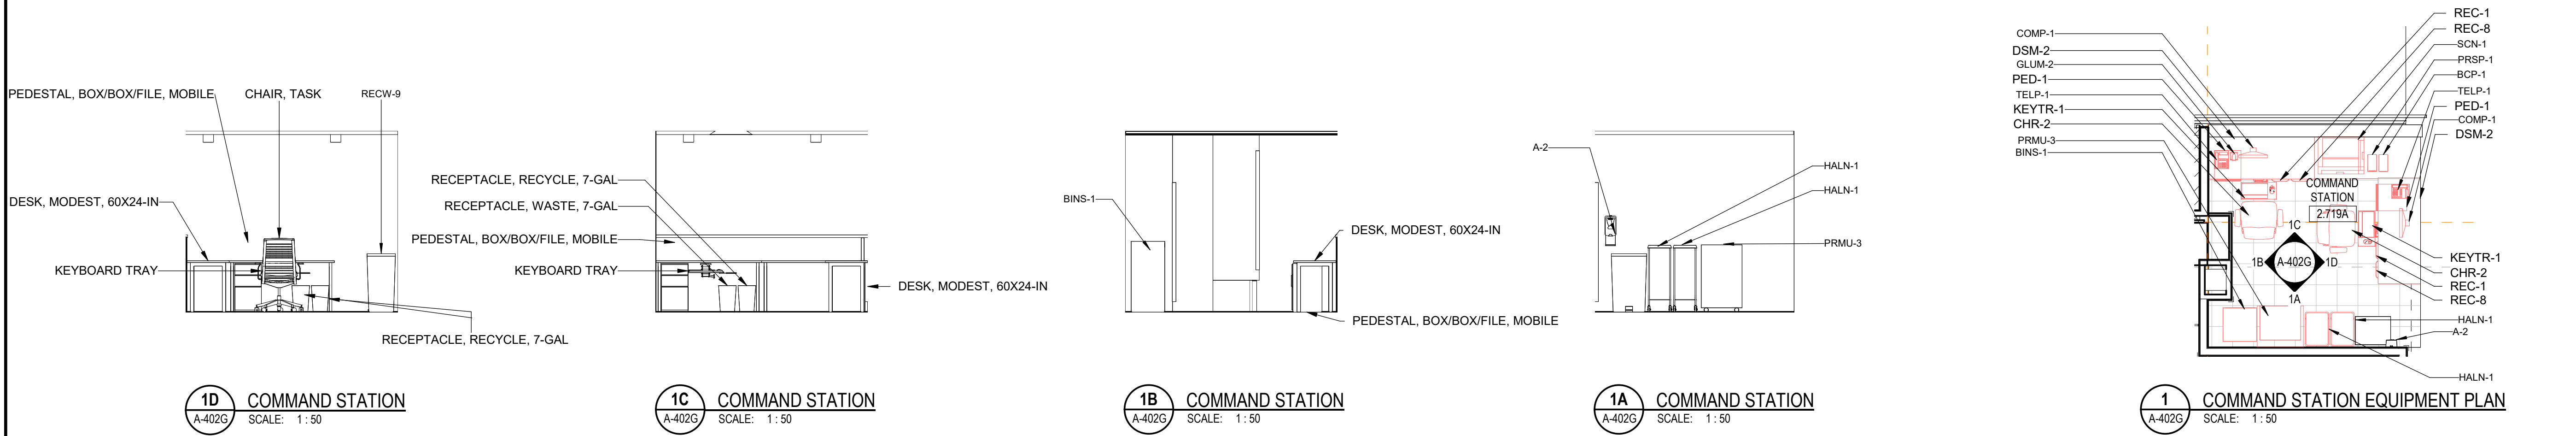



Kasian Architecture
Ontario Incorporated

85 Hanna Avenue, Suite 300
Toronto, ON Canada M8K 3S3
T 416 583 3600 F 416 583 3610
www.kasian.com

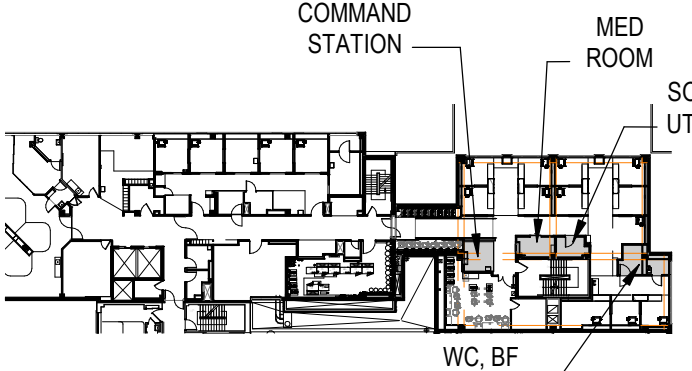

COMMAND STATION
MED ROOM
SOILED UTILITY
WC, BF

7	2024-06-12	ISSUED FOR ARCHIT. ADDENDUM 1	
6	2024-04-22	ISSUED FOR TENDER	
5	2024-04-03	ISSUED FOR CO-ORDINATION	
4	2023-12-05	ISSUED FOR MOH STAGE 2.3 SUBMISSION	
3	2023-11-17	ISSUED FOR COORDINATION	
2	2023-08-28	80% ISSUED FOR COSTING	
1	2023-12-22	ISSUED FOR DD COSTING	
REV	YYYY-MM-DD	REVISION / DRAWING ISSUE	REVIEW

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PROJECT

SHN DIALYSIS CARE UNIT - GENERAL HOSPITAL

SCARBOROUGH, ONTARIO, CANADA

DRAWING TITLE

ENLARGED FLOOR PLANS AND INTERIOR ELEVATIONS - WEST WING

DRAWING ISSUE

PROJECT NO.	PLOT DATE	2023-11-17	DRAWN	Author
240065	SCALE	As indicated	@ ARCH D	CHECKER
DRAWING NO.	A-402G			REVISION
				7

REV	DATE	DESCRIPTION	REVISION / DRAWING ISSUE	REVIEW
7	2024-06-12	ISSUED FOR ARCH'L ADDENDUM 1		
6	2024-04-22	ISSUED FOR TENDER		
5	2024-04-03	ISSUED FOR CO-ORDINATION		
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1	2023-12-22	ISSUED FOR CO-ORDINATION		
REV	YYYY-MM-DD			

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PROJECT

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SCARBOROUGH, ONTARIO, CANADA

DRAWING TITLE


INTERIOR ELEVATIONS AND DETAILS

DRAWING ISSUE

PROJECT NO.	PLOT DATE	2023-11-17	DRAWN	Author
240065	SCALE	As indicated	@ ARCH D	CHECKER
DRAWING NO.				REVISION


A-403G

7

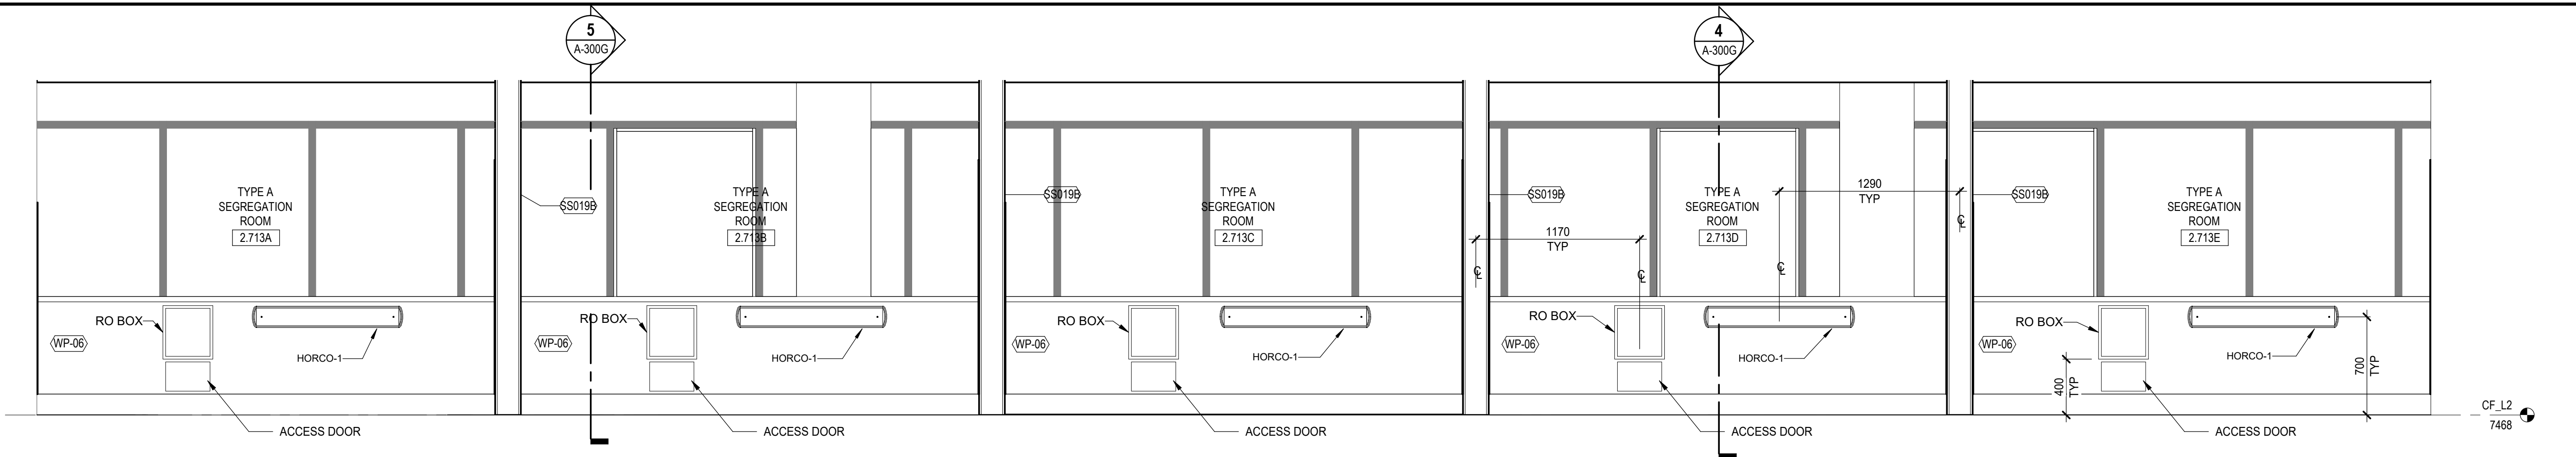


**1 INTERIOR ELEVATION - CROCKFORD WING
EXTERIOR WALL TREATMENT ROOMS**

1
A-403G
SCALE: 1:25

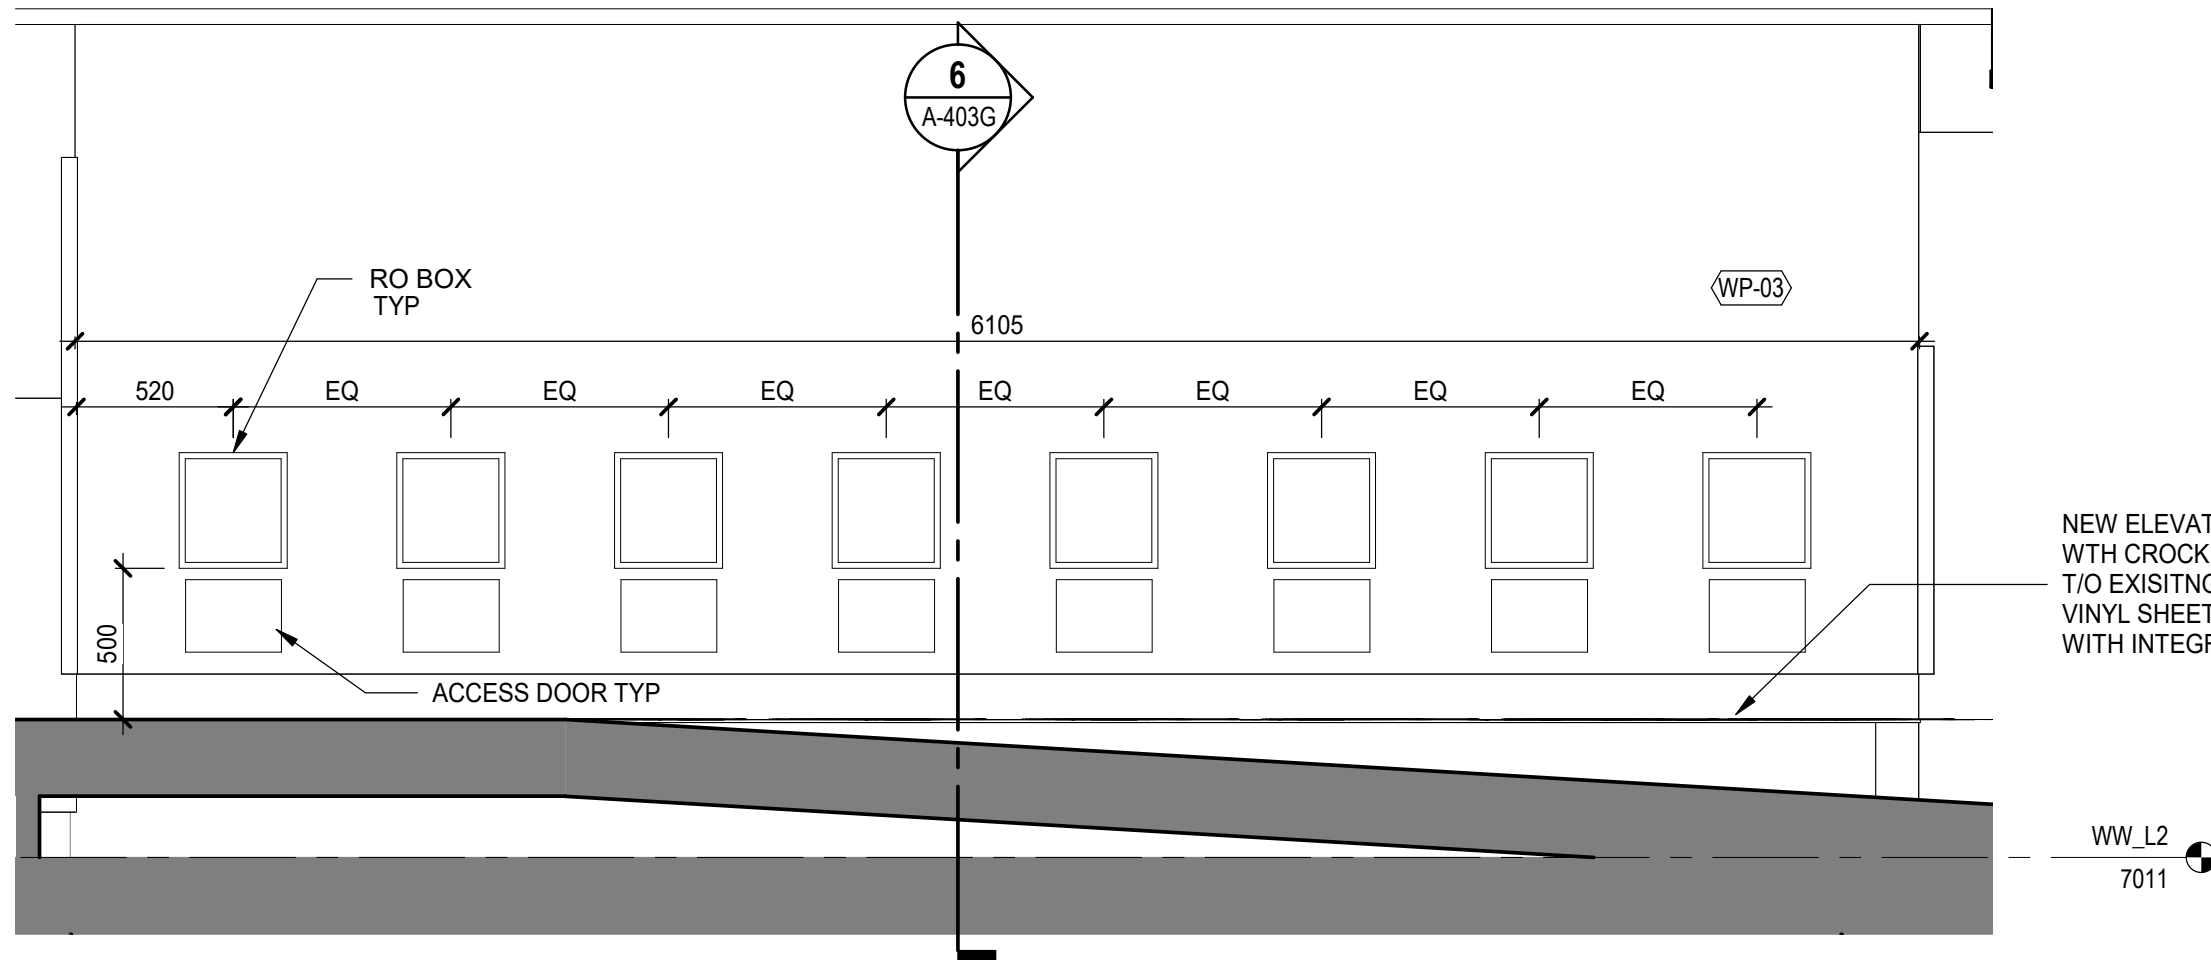


**2 WALL ELEVATION AT EXSITING RAMP -
OPPOSITE SIDE SIM**

2
A-403G
SCALE: 1:25

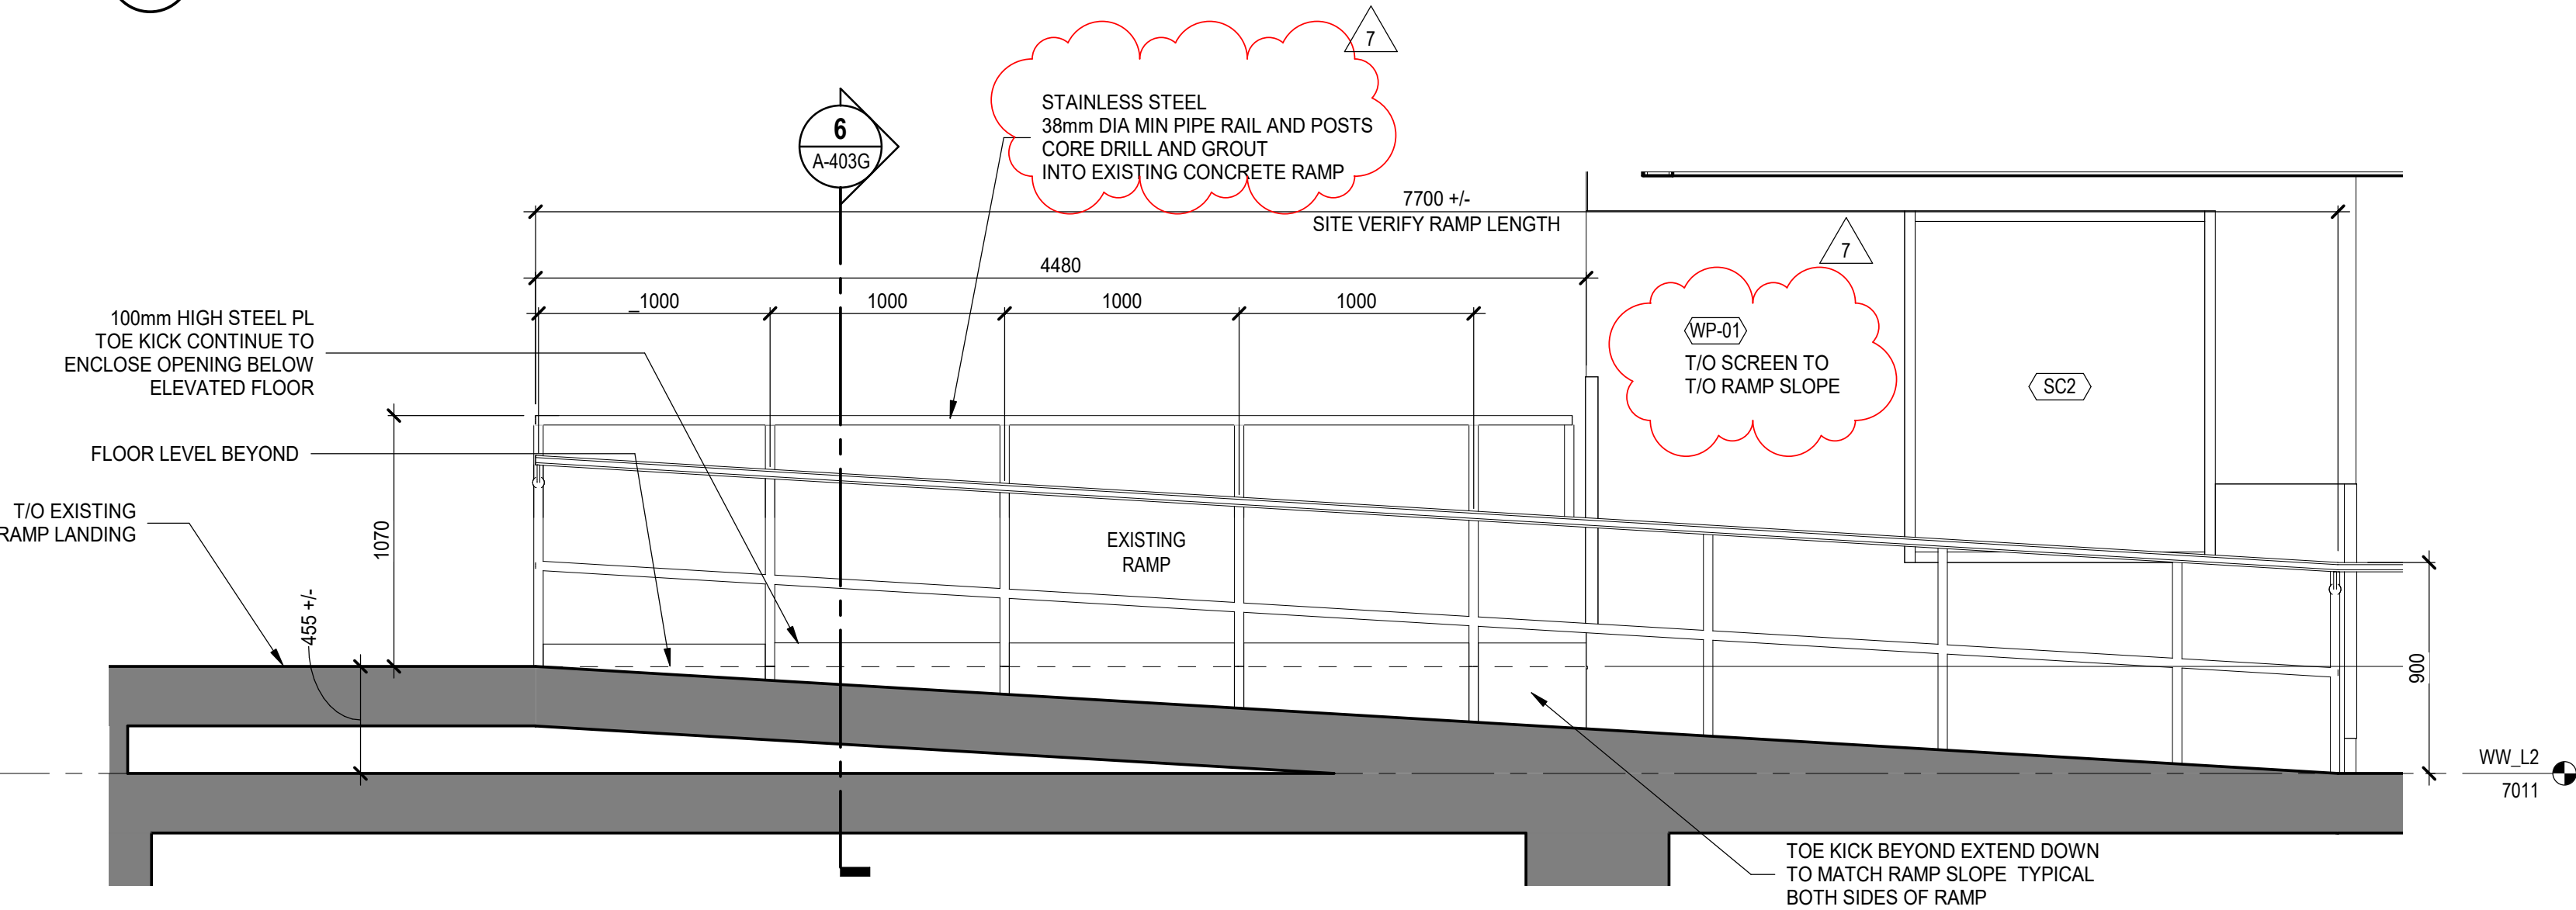


5 RAILING ELEVATION BOTH SIDES EXISTING RAMP

5
A-403G
SCALE: 1:25

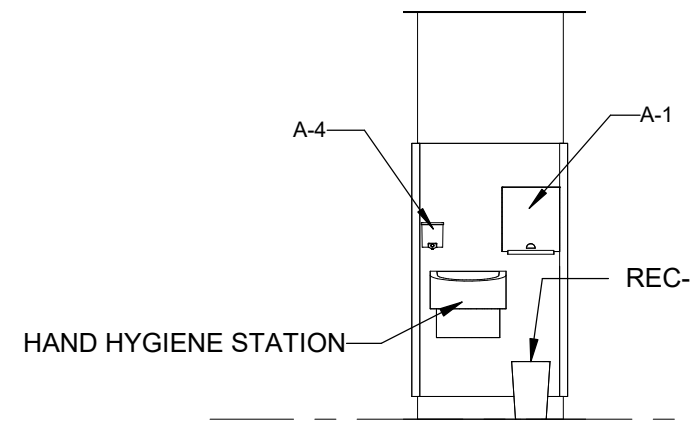


8 TYPICAL HHS ELEVATION

8
A-403G
SCALE: 1:50

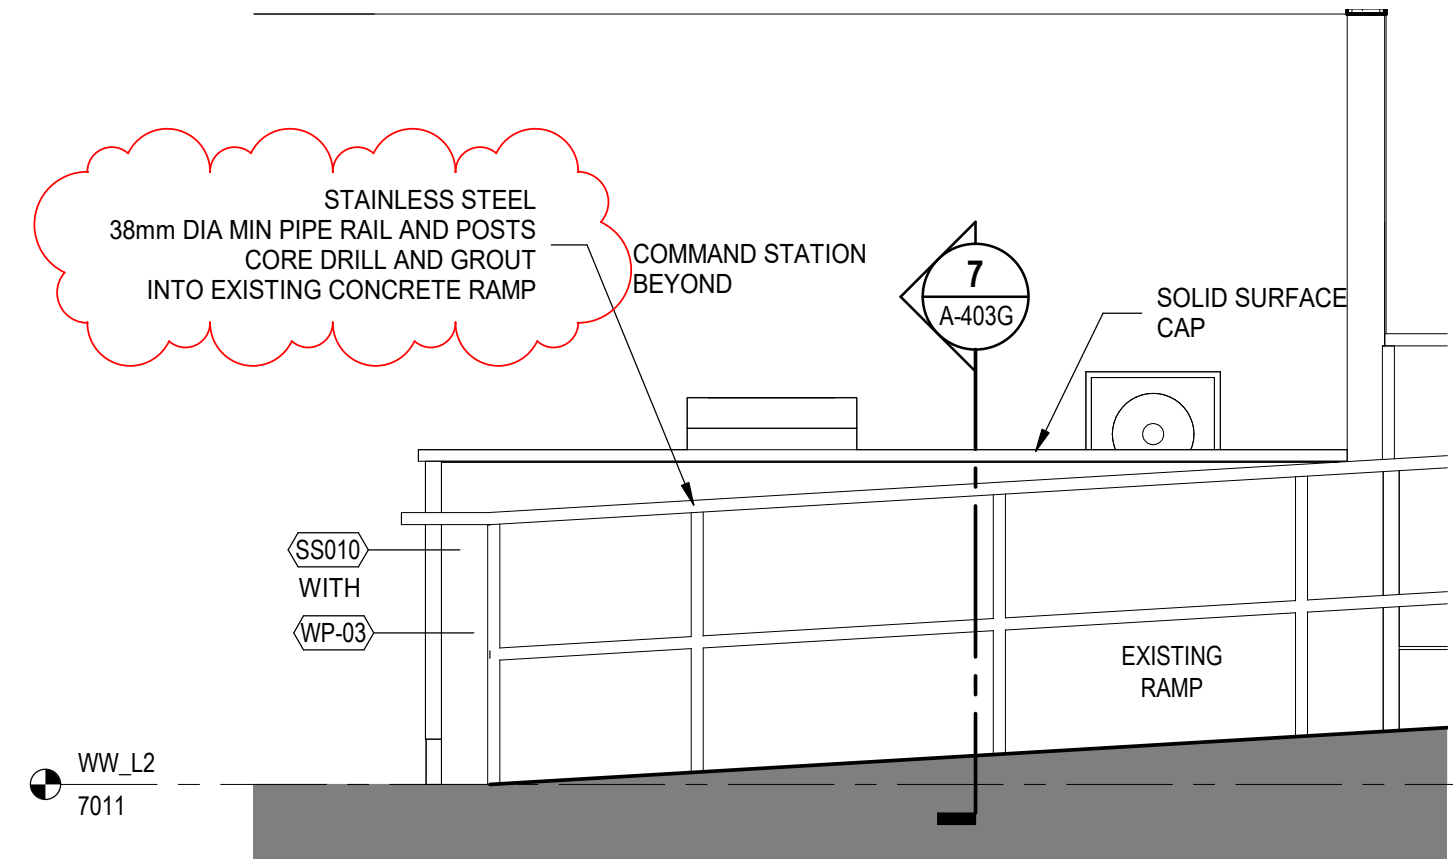


3 PART RAILING ELEVATION AT COMMAND STATION

3
A-403G
SCALE: 1:25

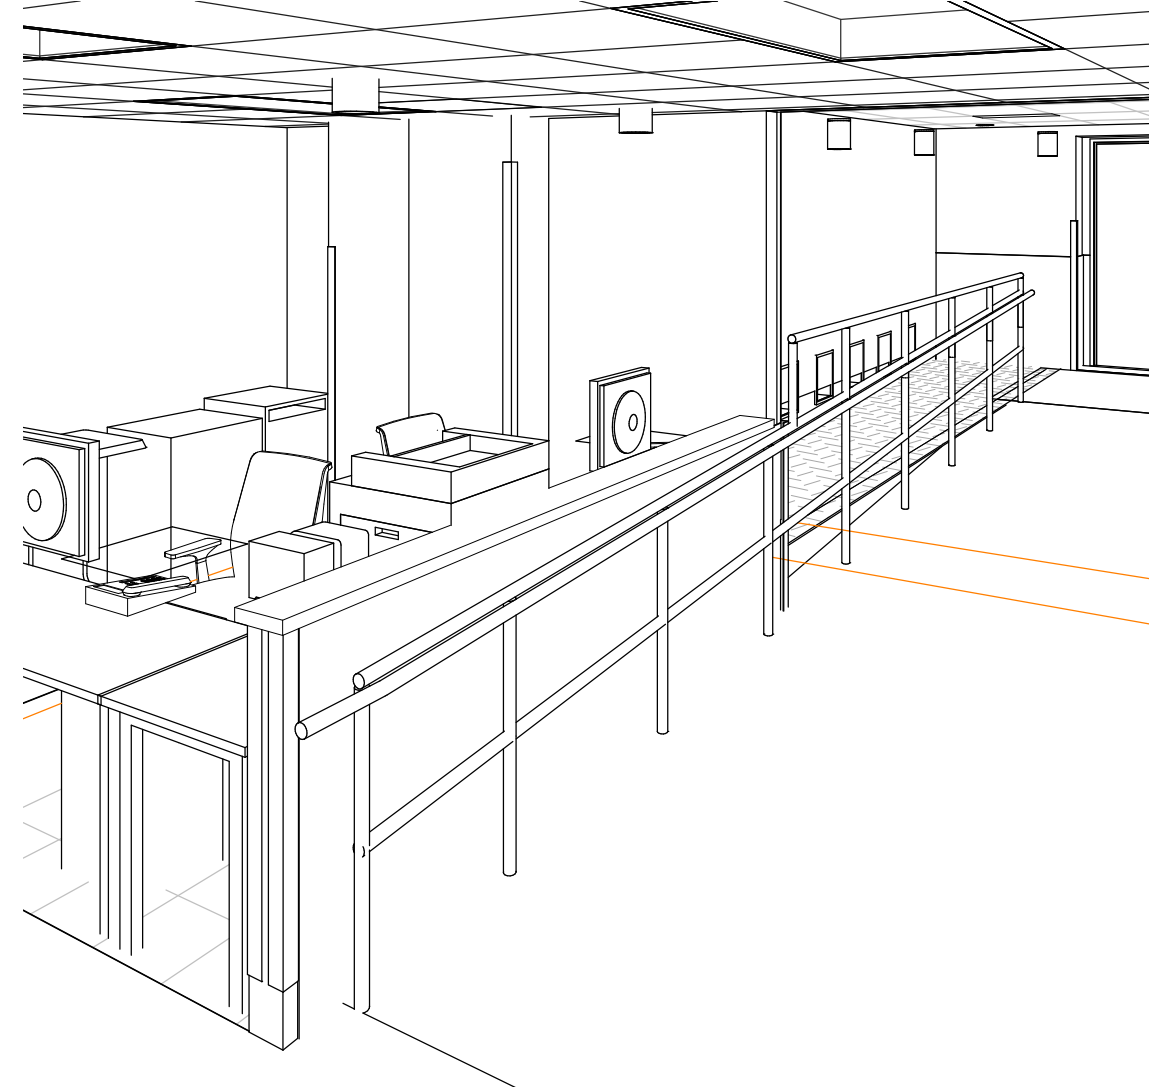

**4 BASE OF RAMP AT COMMAND STATION - WEST
WING**

4
A-403G
SCALE:

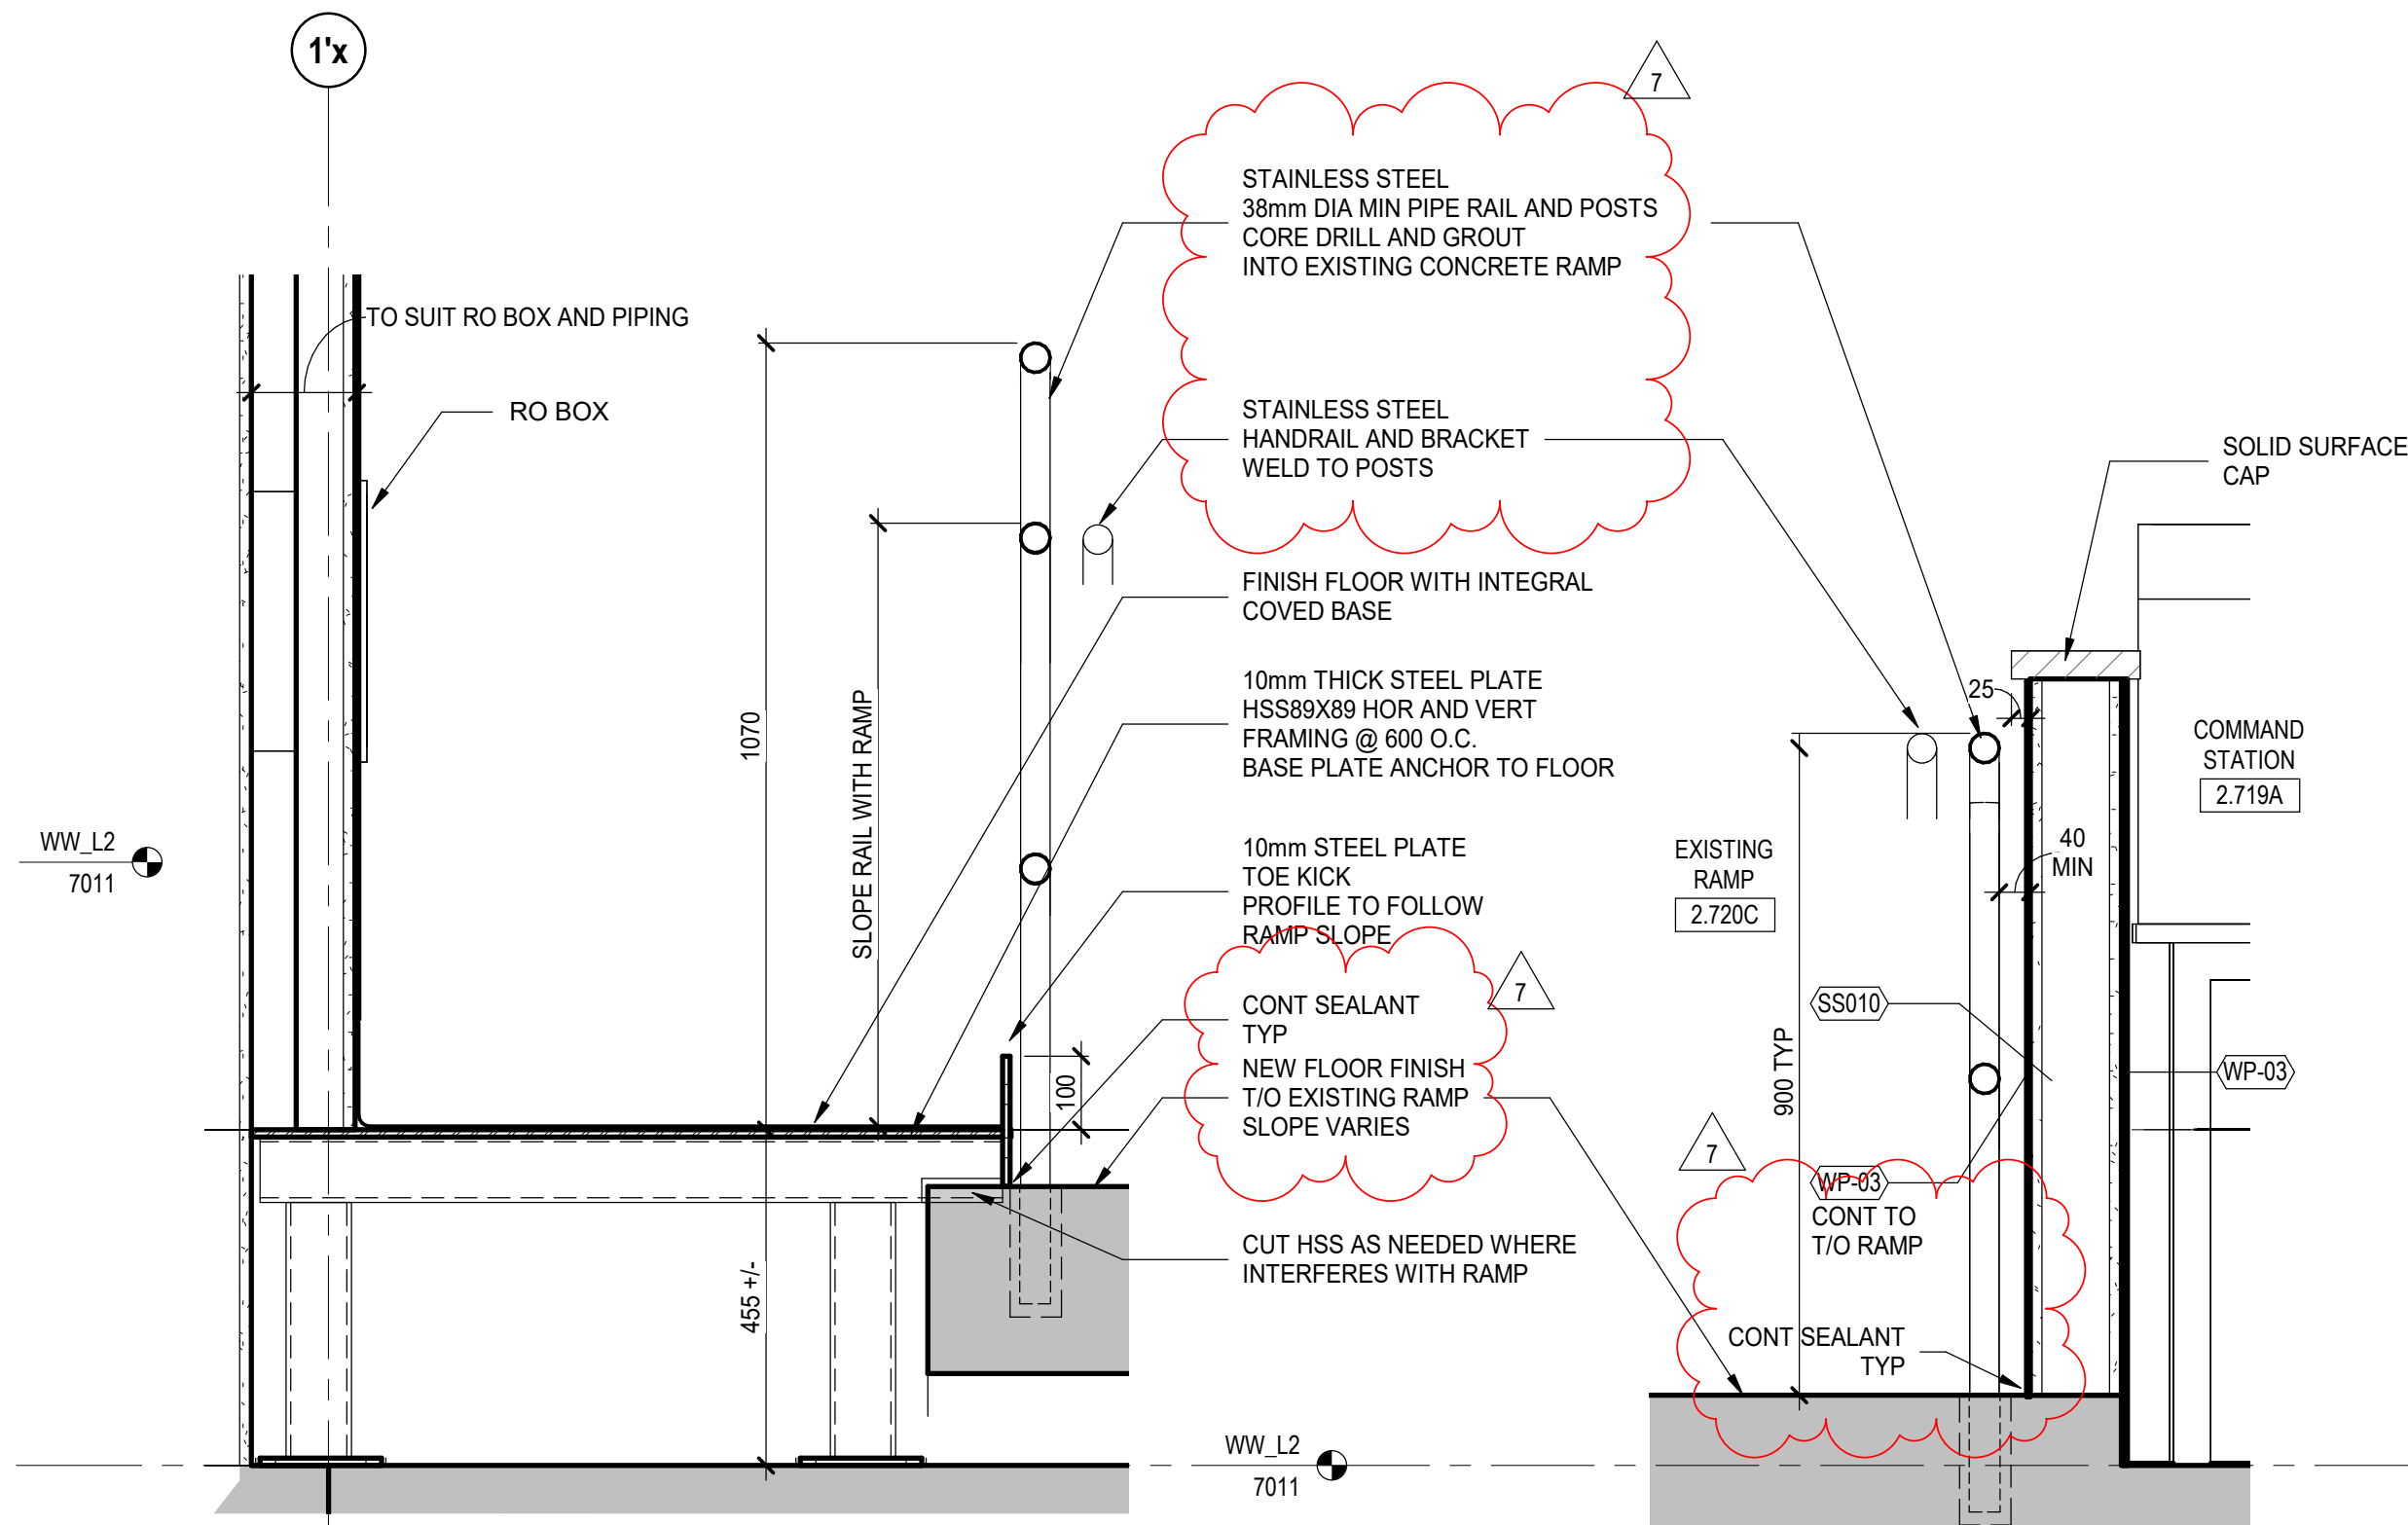


6 DETAIL AT RAMP SIDES - ELEVATED FLOOR


6
A-403G
SCALE: 1:10

7 DETAIL AT RAMP SIDE AND LOW WALL


7
A-403G
SCALE: 1:10

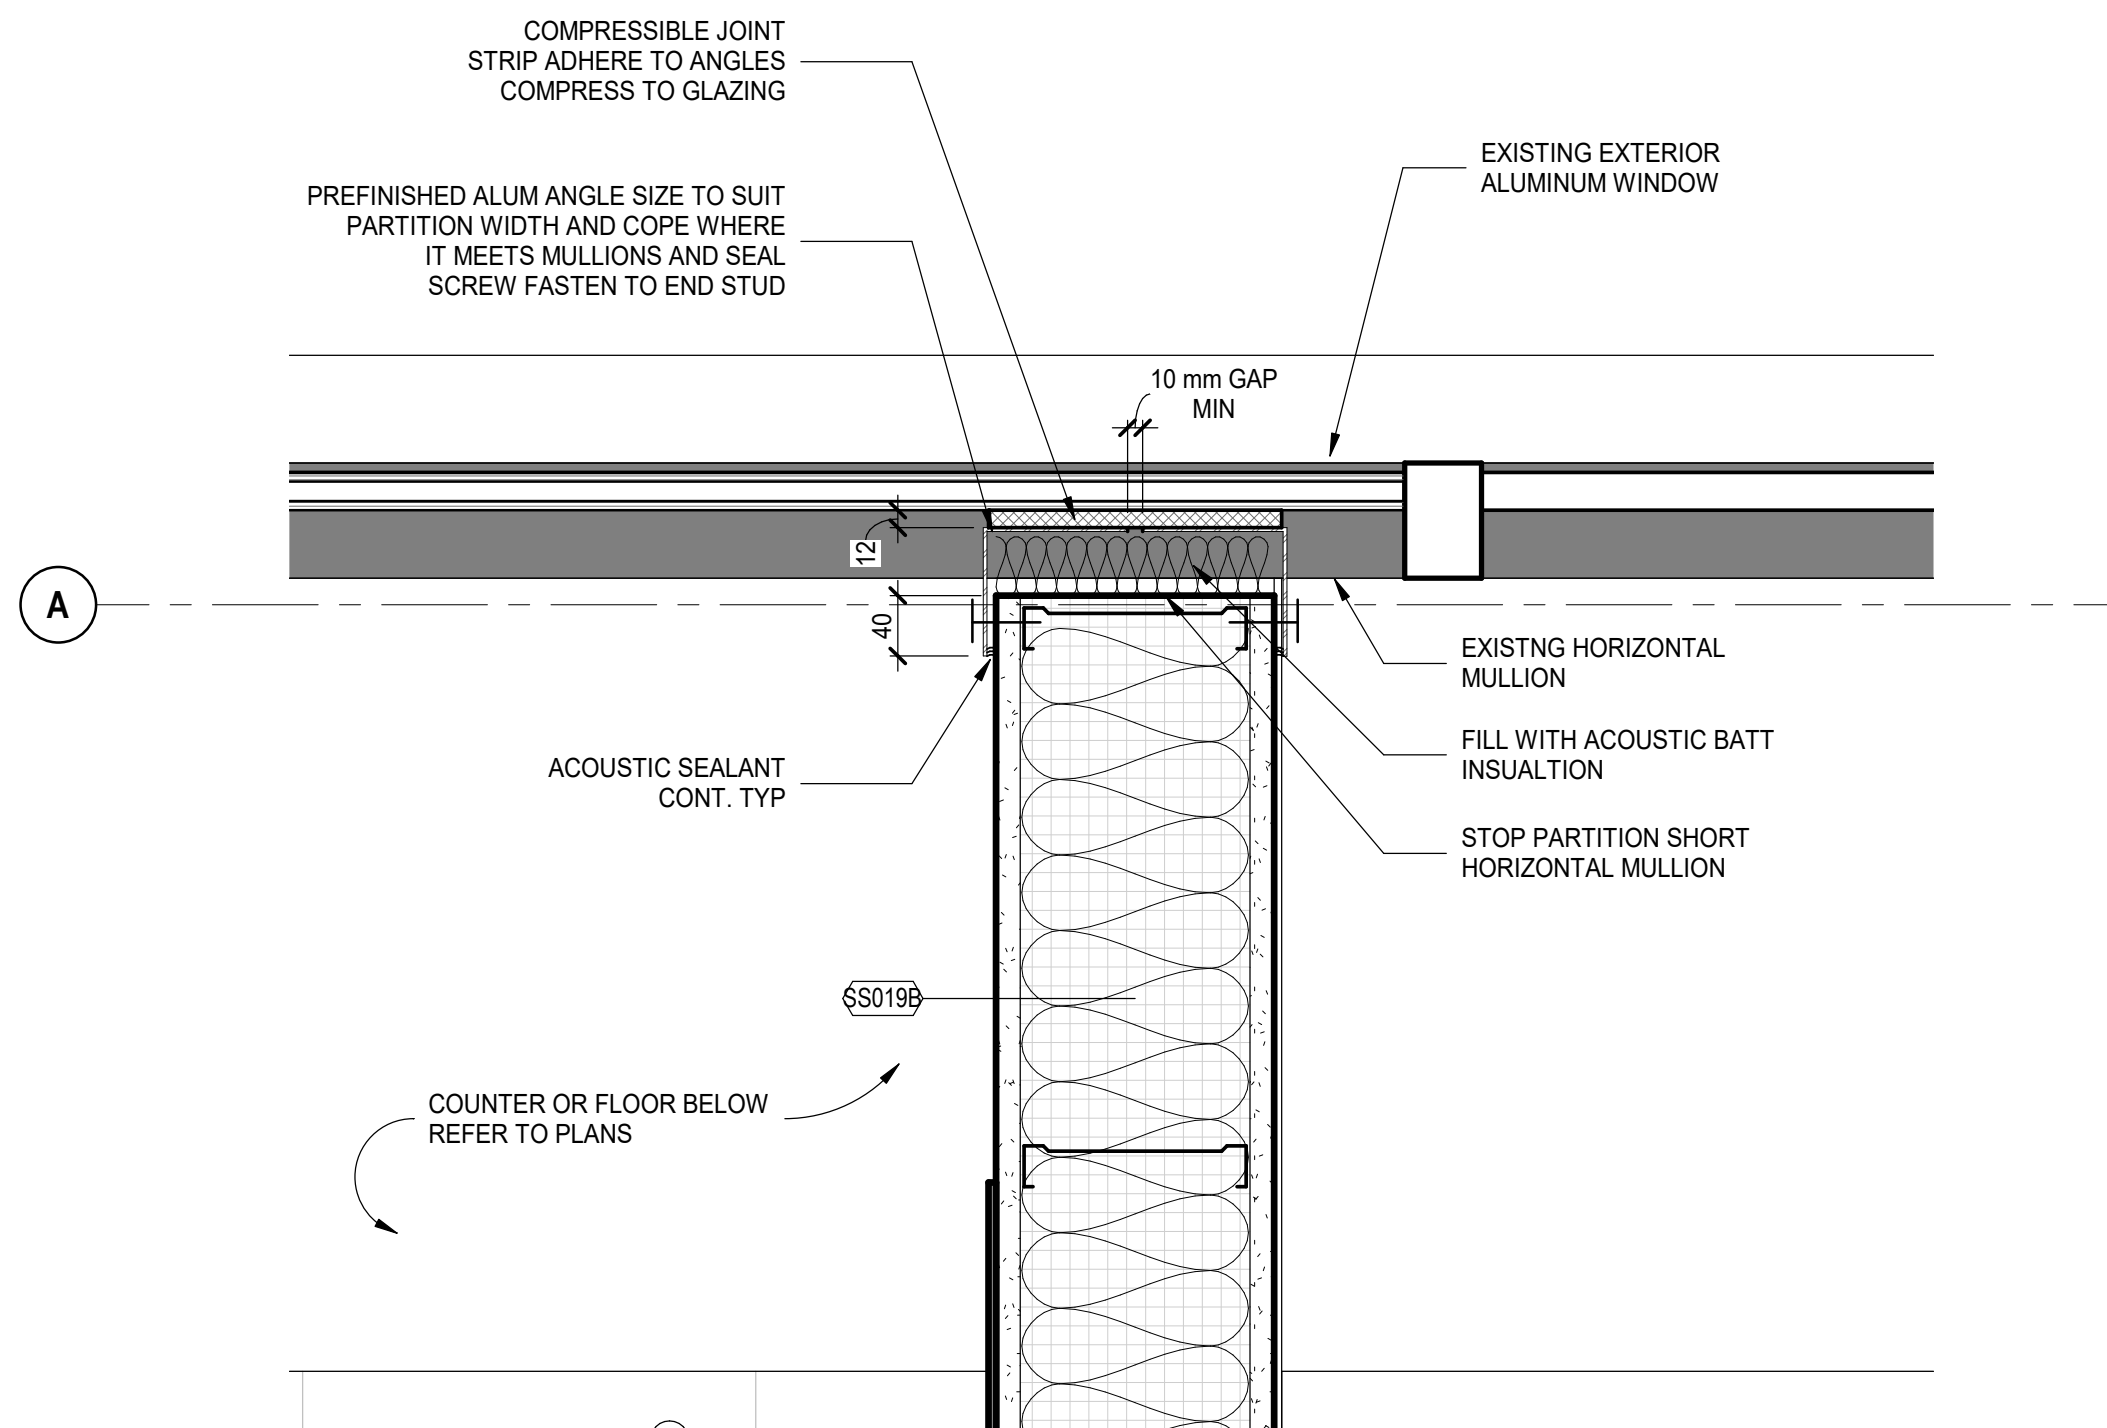PLAN DETAIL - EXISTING EXTERIOR GLAZING AND
INTERIOR PARTITION

SCALE: 1:5

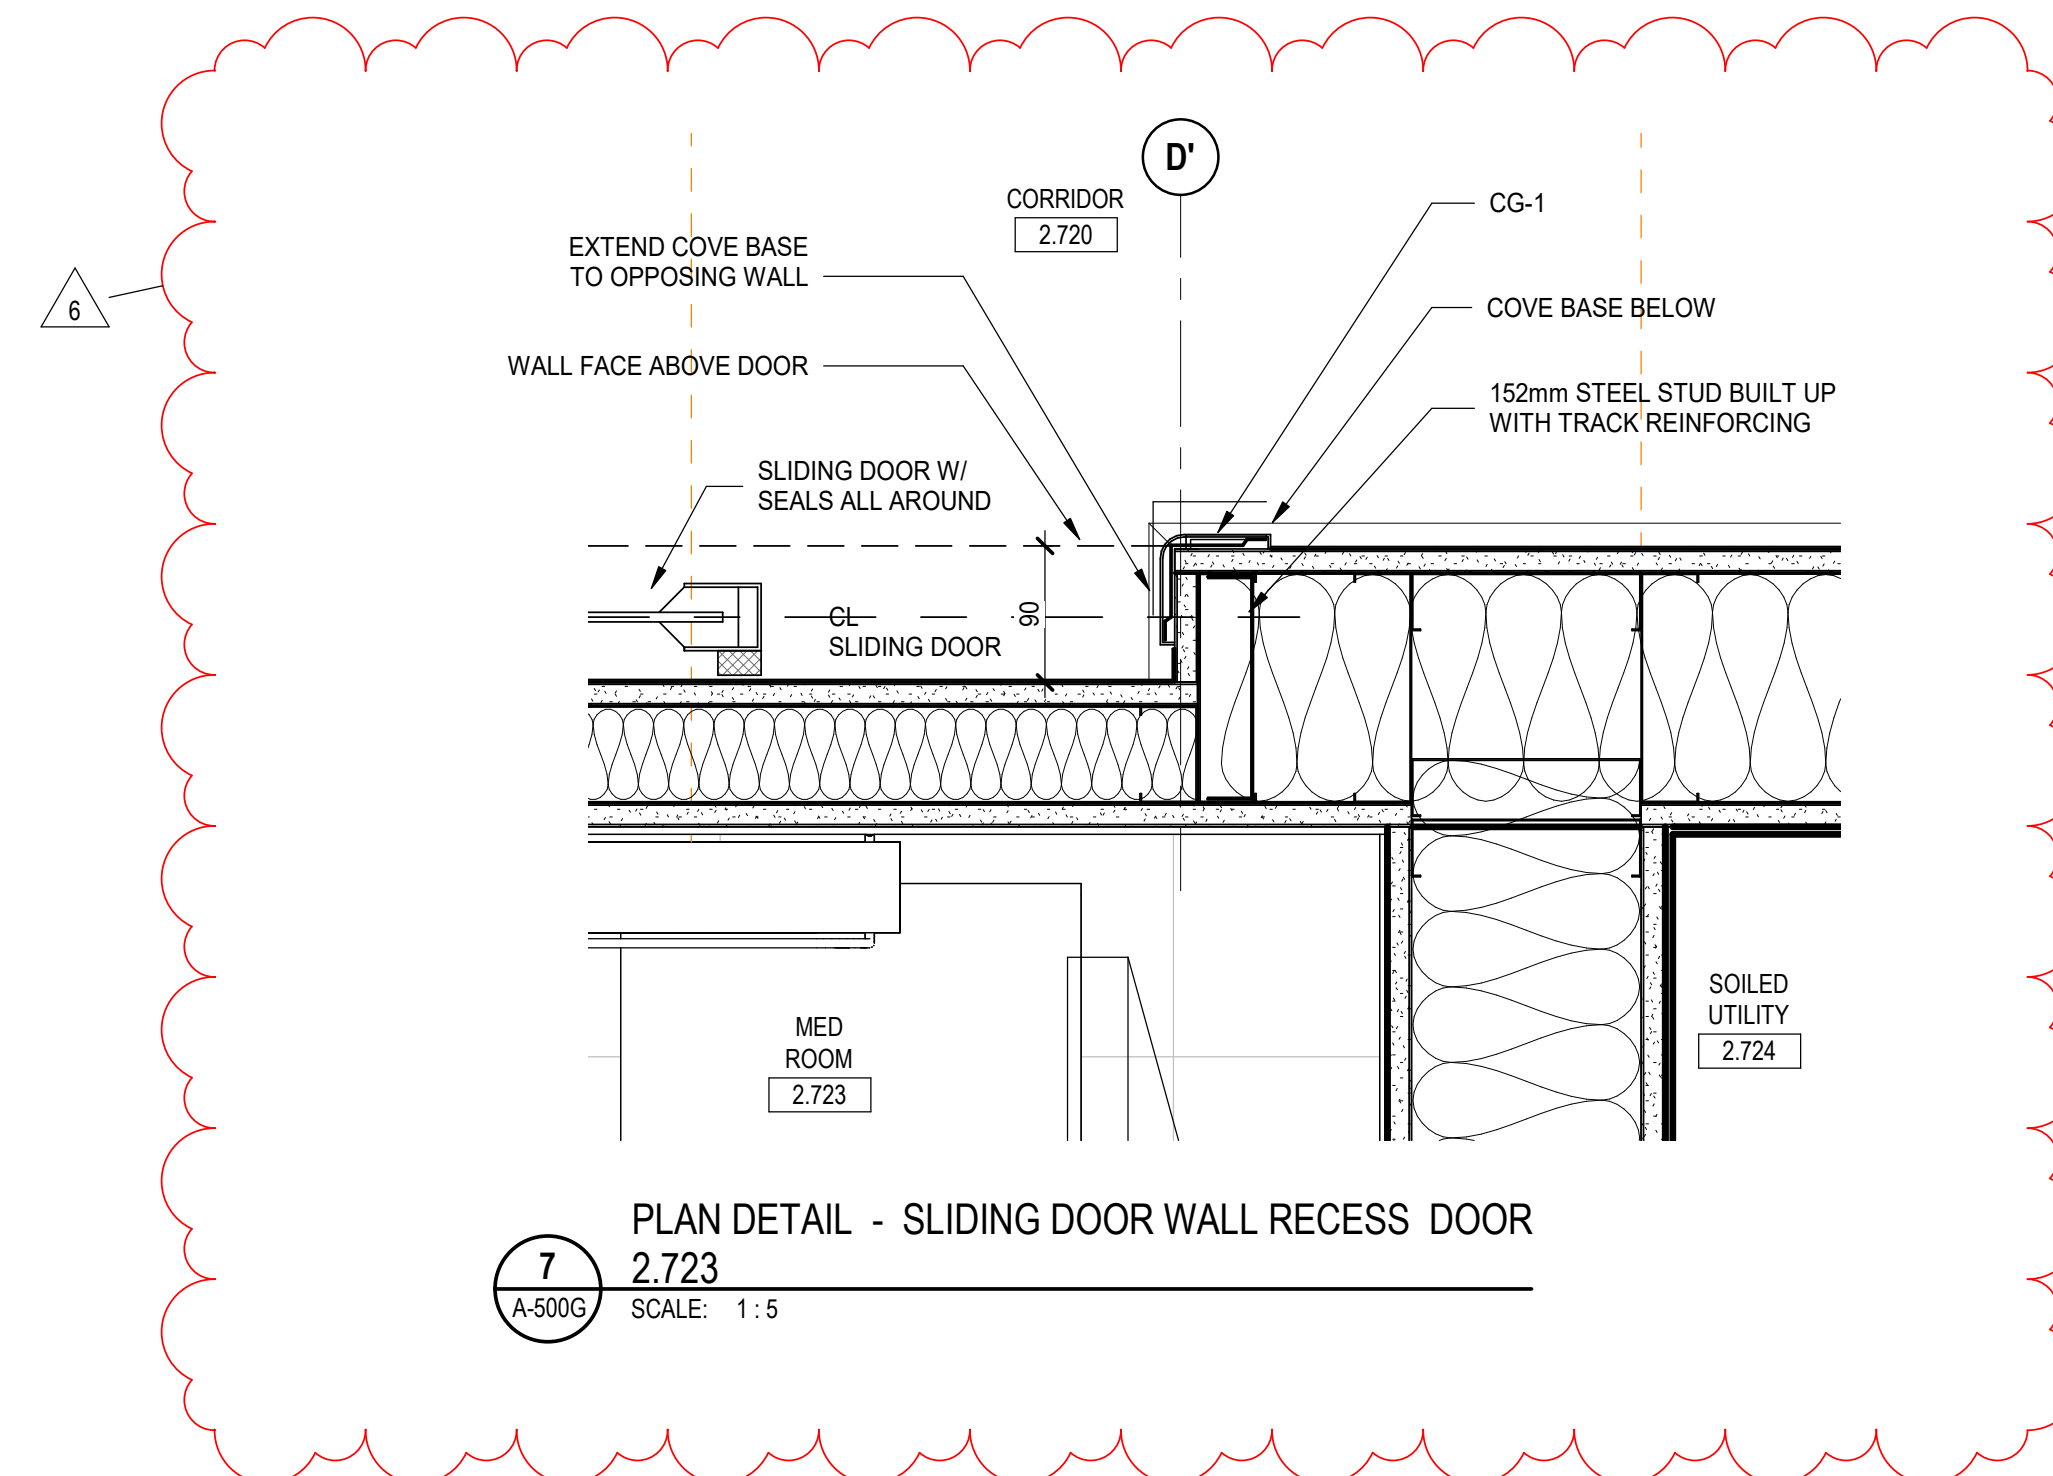
PLAN DETAIL - SLIDING DOOR WALL RECESS DOOR
2.723

SCALE: 1:5

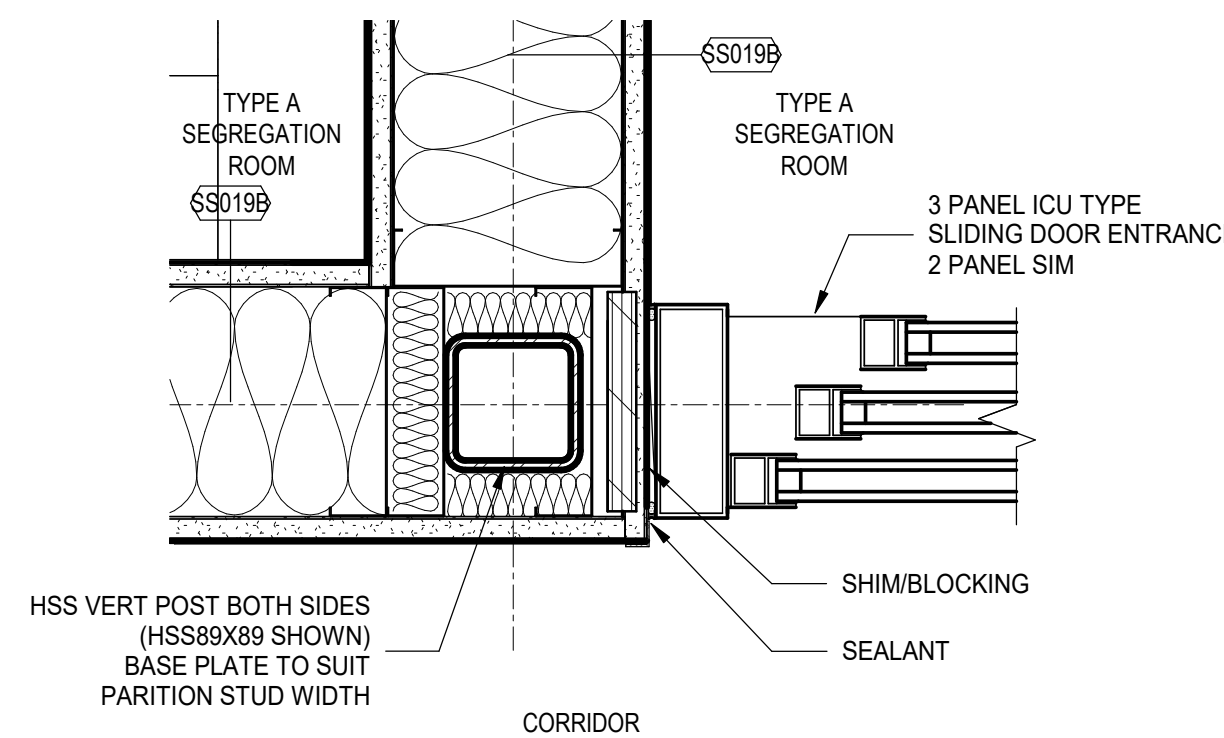


PLAN DETAIL - SEG RM SLIDING DOOR JAMB

SCALE: 1:5

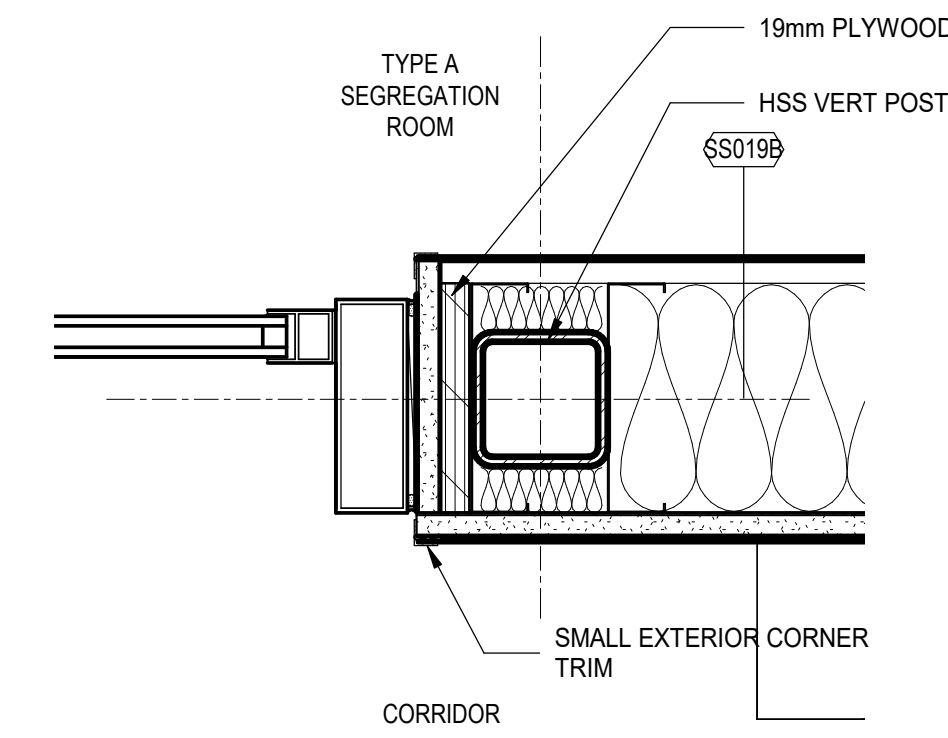


PLAN DETAIL - SEG RM SLIDING DOOR JAMB

SCALE: 1:5

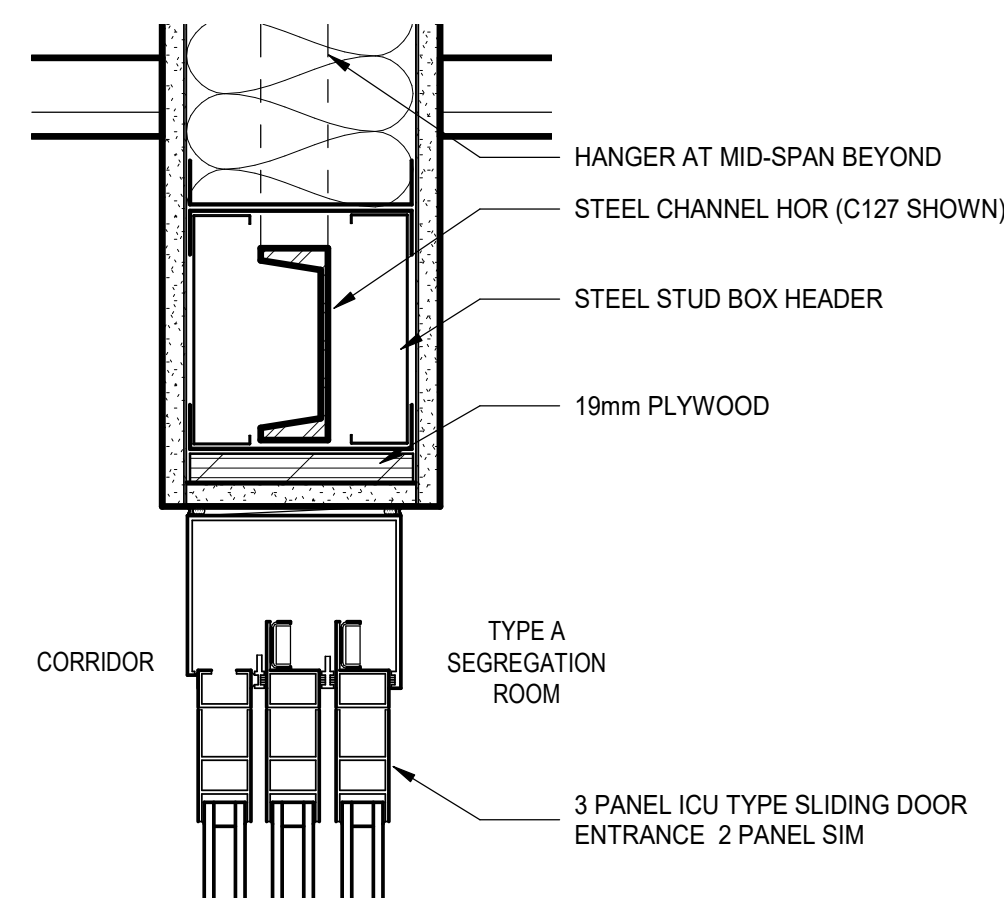


SECTION DETAIL - SEG RM SLIDING DOOR HEAD

SCALE: 1:5

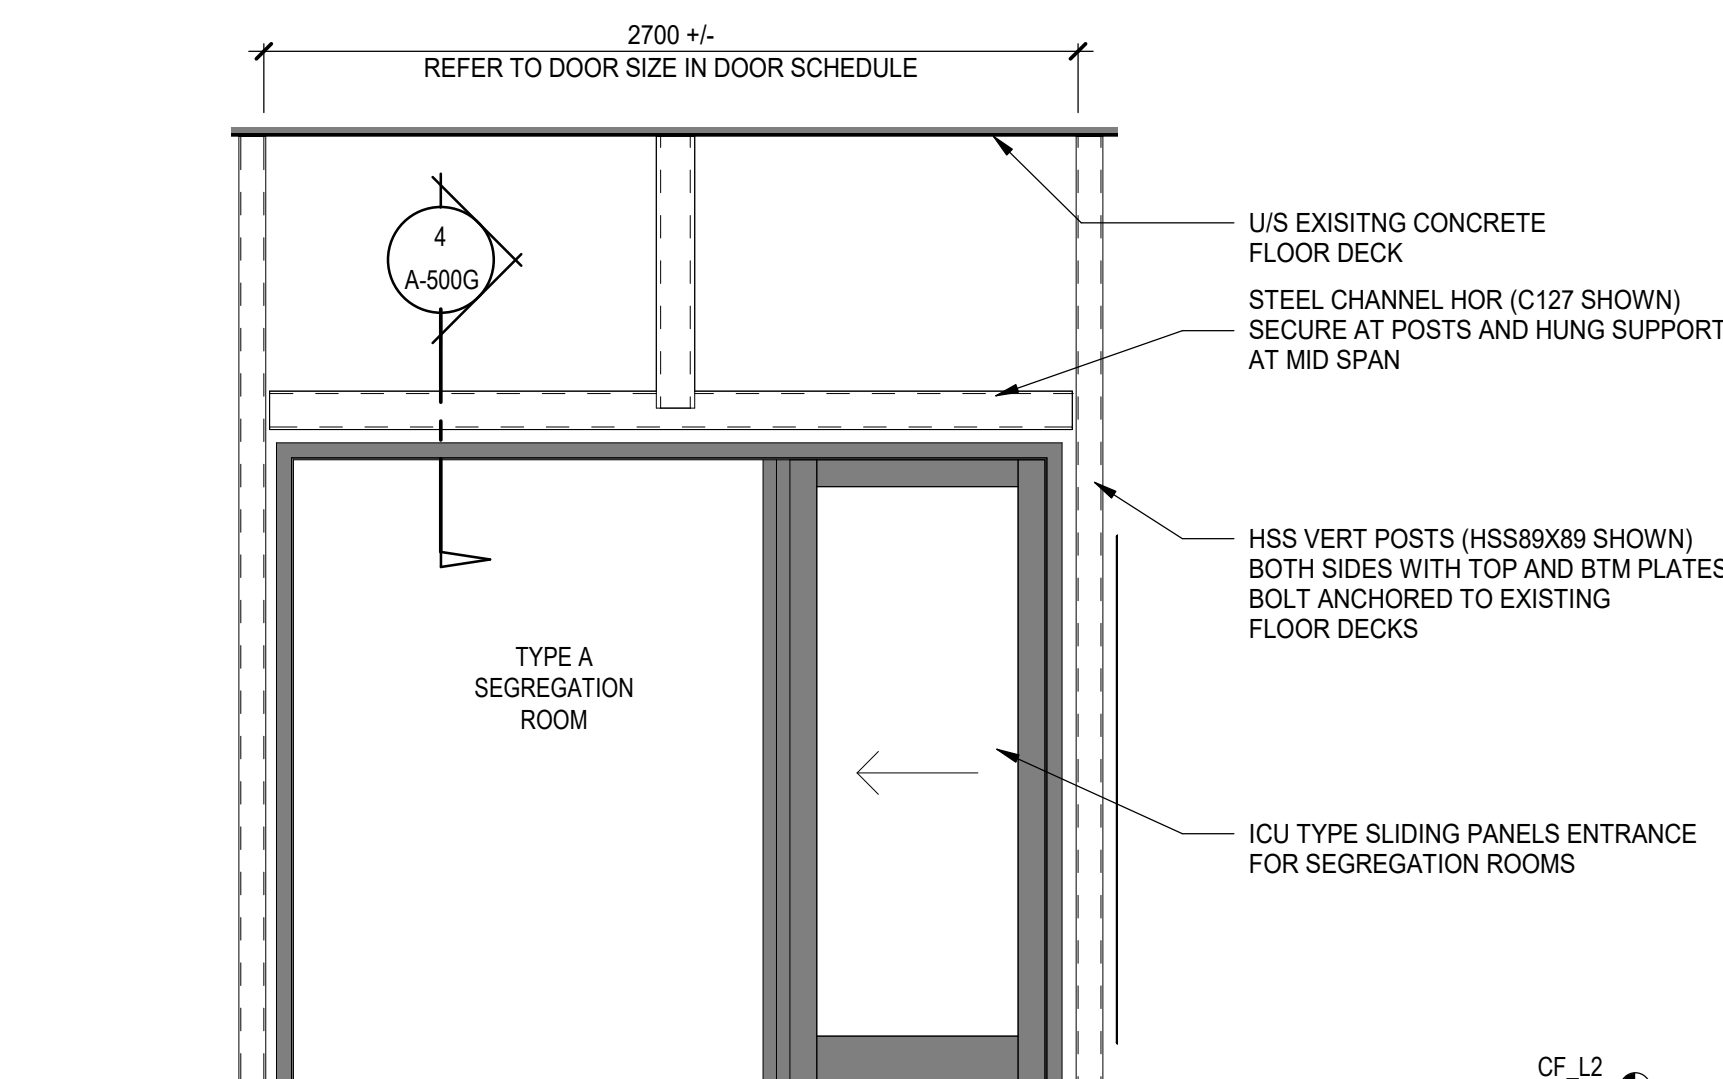

SEGREGATION ROOM DOOR FRAMING

SCALE: 1:25

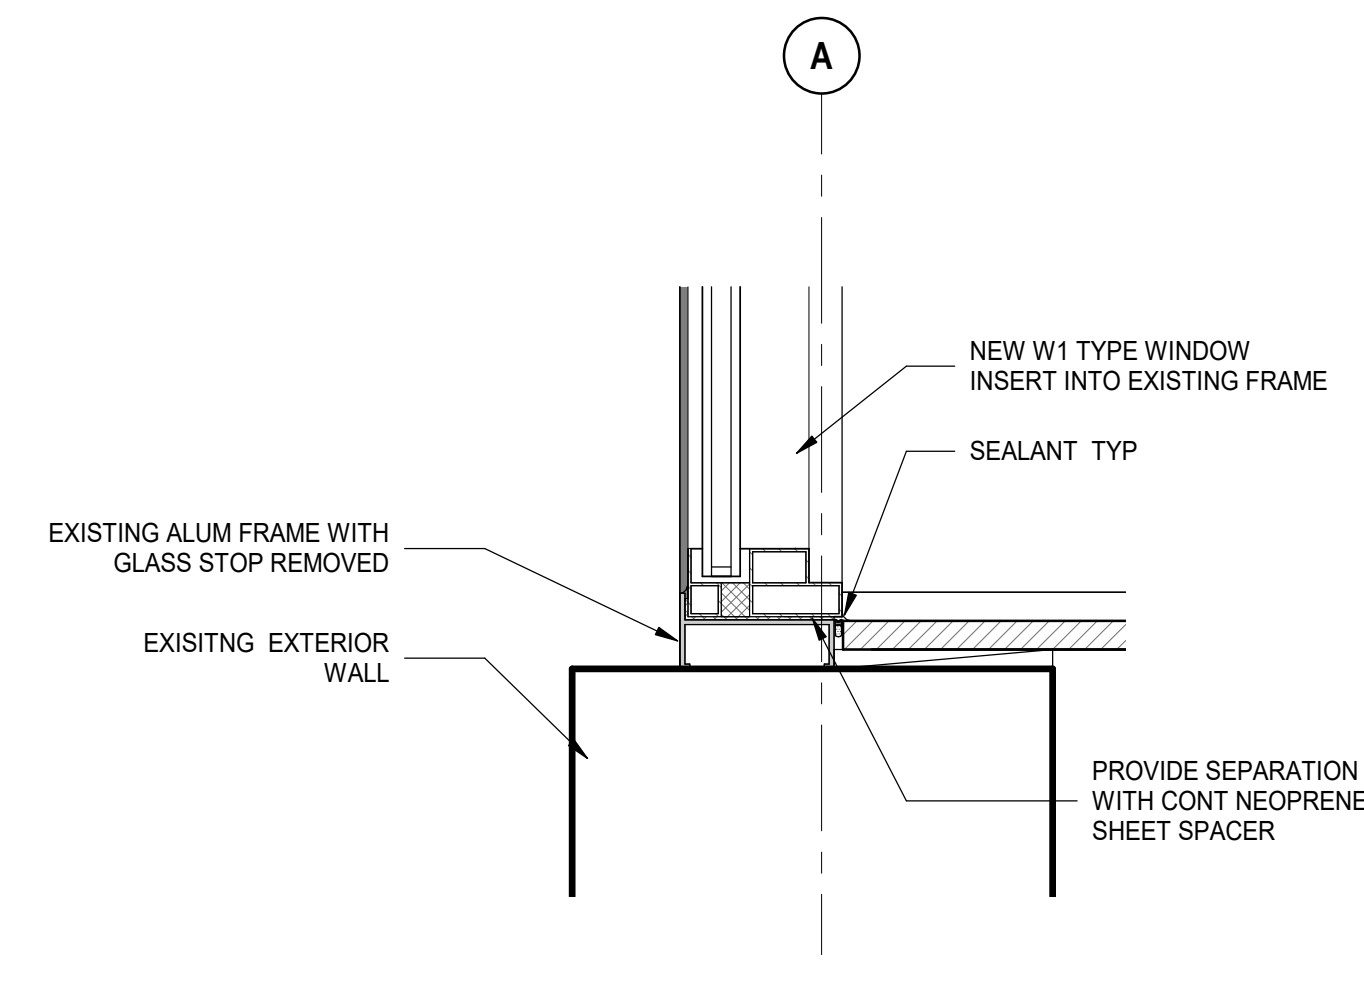SECTION AT CROCKFORD WING EXT WALL - NEW
WINDOW SILL

SCALE: 1:5

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REV	YYYY-MM-DD	REVISION / DRAWING ISSUE

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HOSPITAL

SCARBOROUGH, ONTARIO, CANADA

DRAWING TITLE

PLAN AND SECTION DETAILS

DRAWING ISSUE

PROJECT NO.	PLOT DATE	2023-11-17	DRAWN	Author
240065	SCALE	As indicated	@ ARCH D	CHECKER
DRAWING NO.	REVISION	6		

A-500G

6	2024-06-12	ISSUED FOR ARCH LADDENDUM 1	
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PROJECT

**SHN DIALYSIS CARE UNIT - GENERAL
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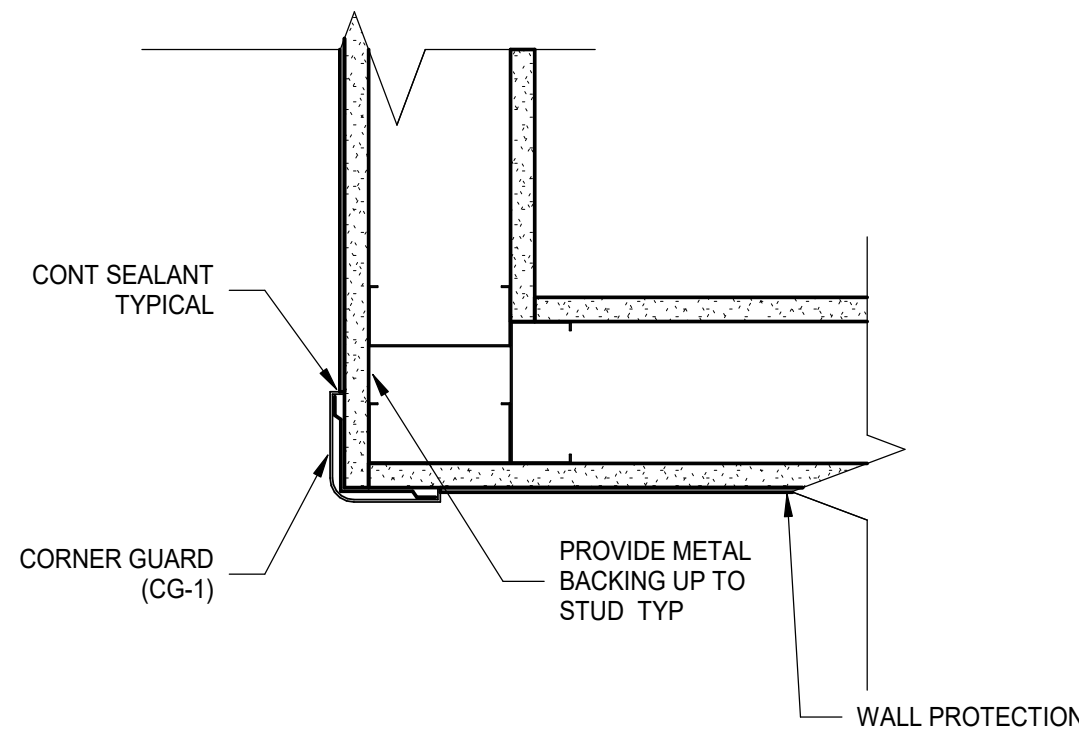
SCARBOROUGH, ONTARIO, CANADA

DRAWING TITLE


INTERIOR FINISHES DETAILS

DRAWING ISSUE


PROJECT NO.	PLOT DATE	2023-11-17	DRAWN	Author
240065	SCALE	As indicated	REVIEWED	Checker
DRAWING NO.	A-510G			REVISION



1 TYPICAL CORNER GUARD DETAIL
SCALE: 1:5

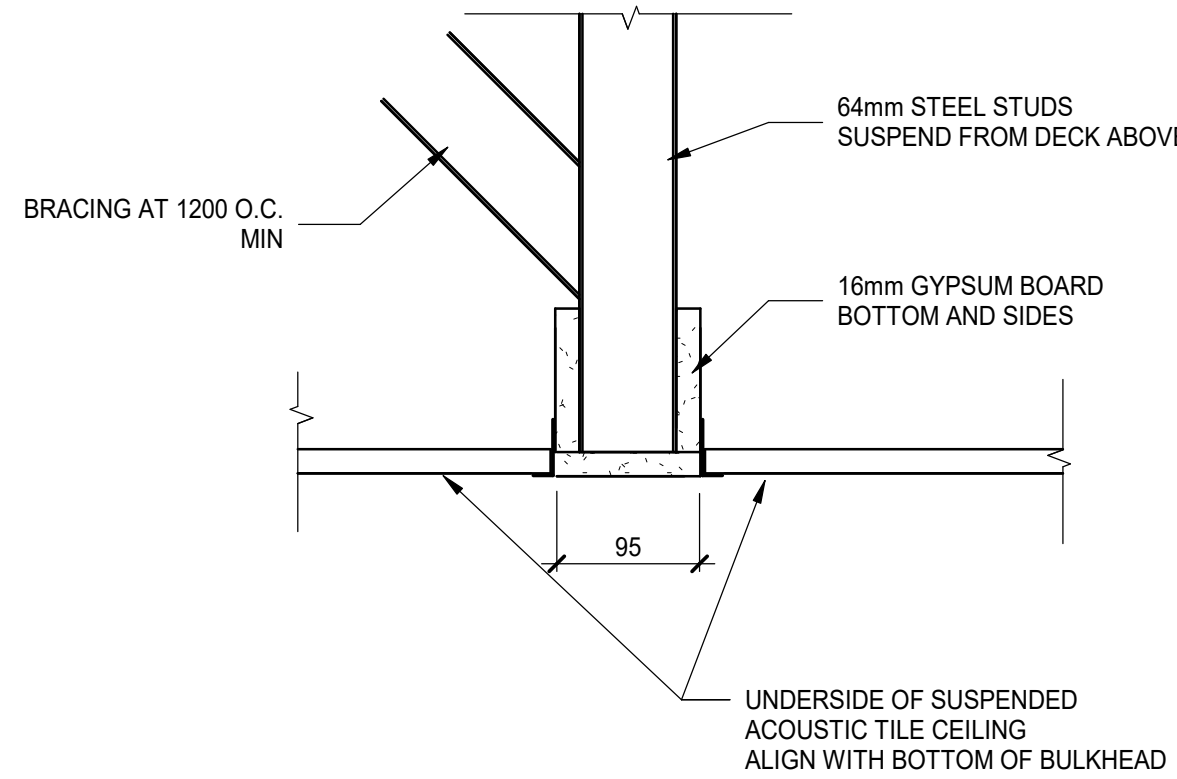


3 ACT CEILING TO BULKHEAD BOTH SIDES - TYPICAL
SCALE: 1:5

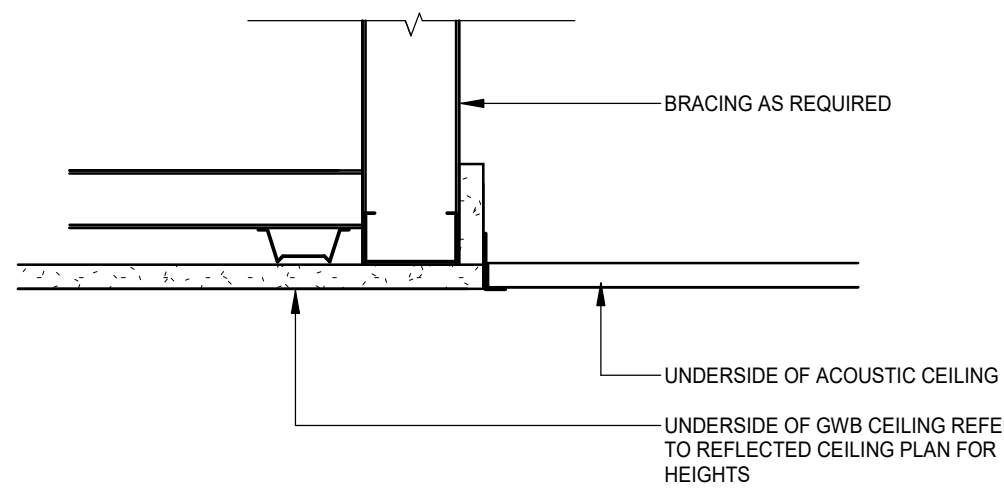


5 ACT CEILING TO BULKHEAD ONE SIDE - TYPICAL
SCALE: 1:5




EXISTING EXPANSION JOINT EXPOSED

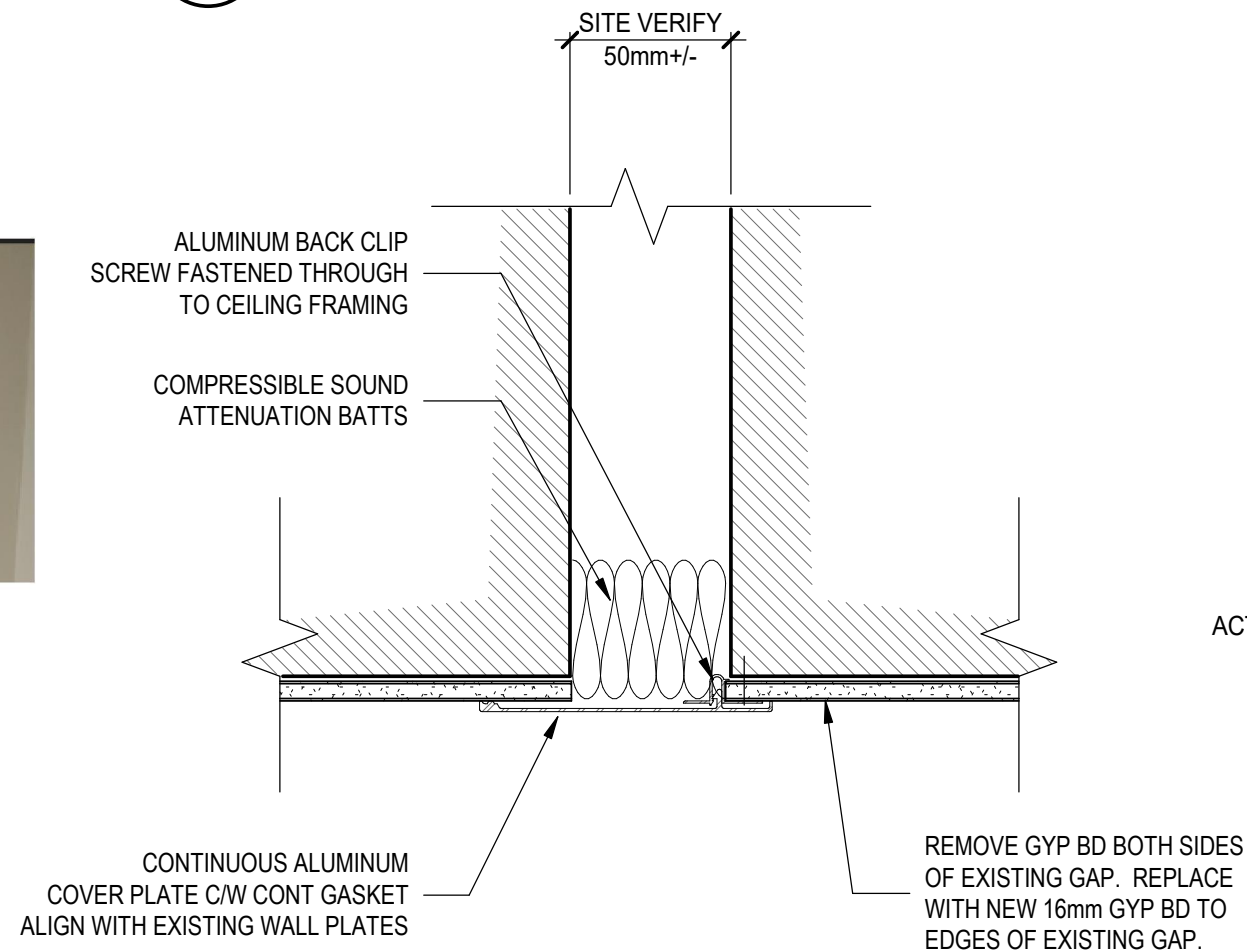


9 EXP JT COVER AT T/O RAMP
SCALE: 1:5

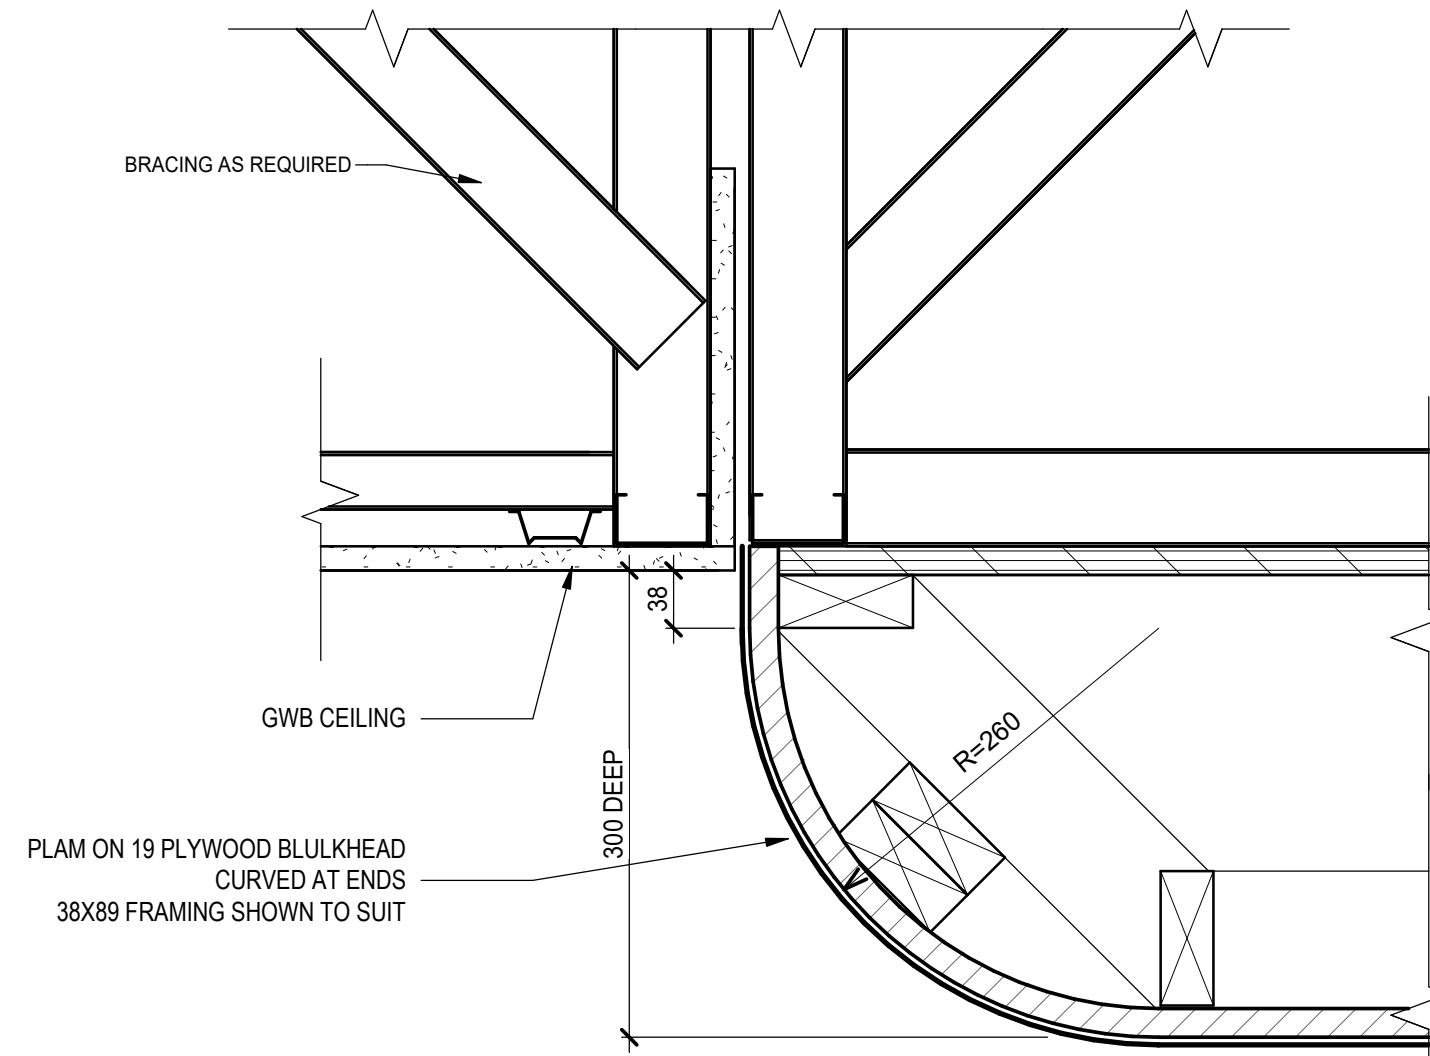


6 PLAM WOOD LOOK BULKHEAD AT ROUNDED ENDS
SCALE: 1:5

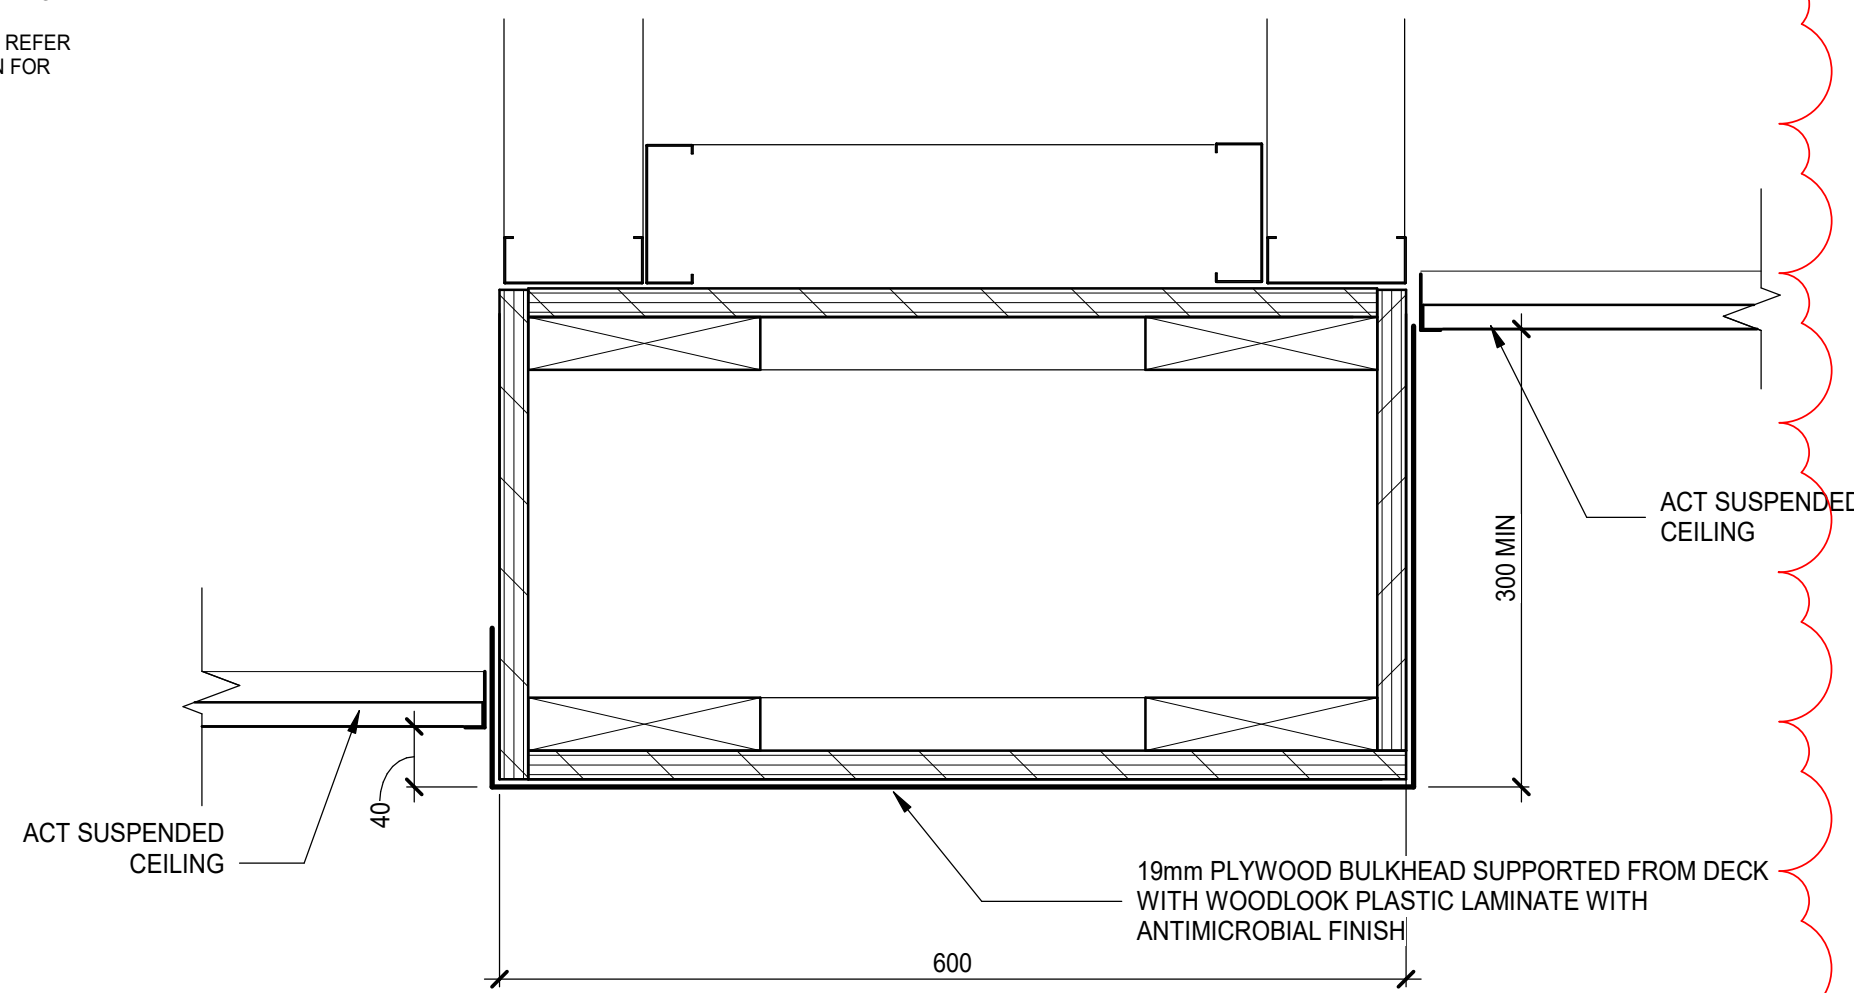


10 PLAM WOOD LOOK BULKHEAD ABOVE PPE STATIONS
SCALE: 1:5

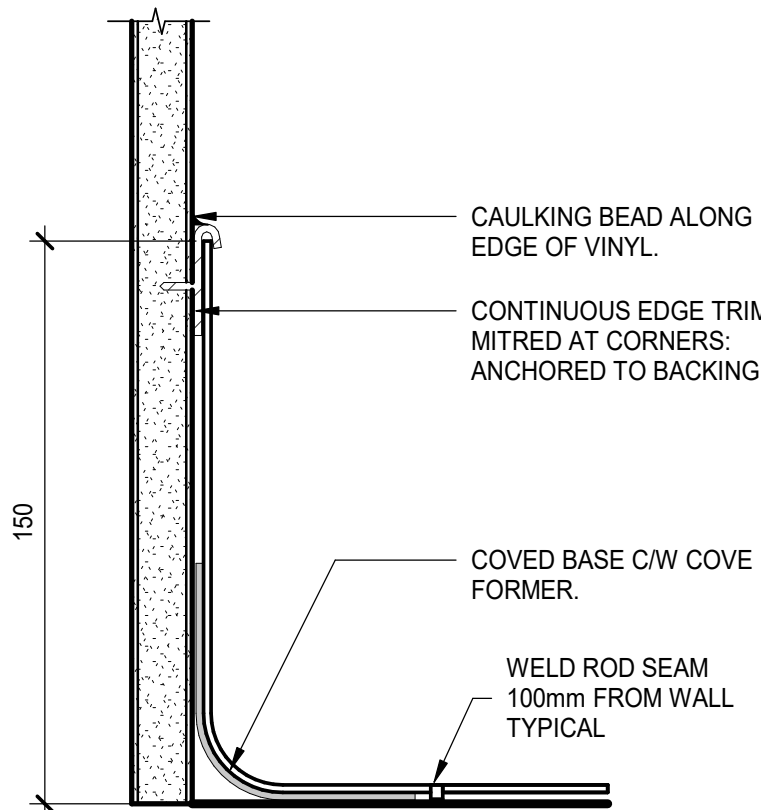


1A BASE DETAIL 1
SCALE: 1:2

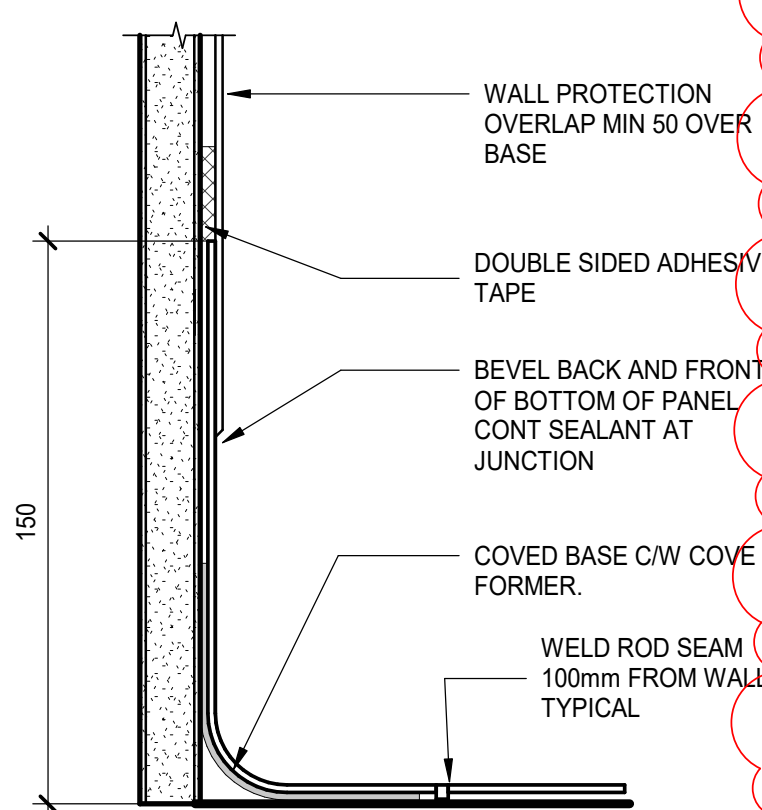


1B BASE DETAIL 2
SCALE: 1:2

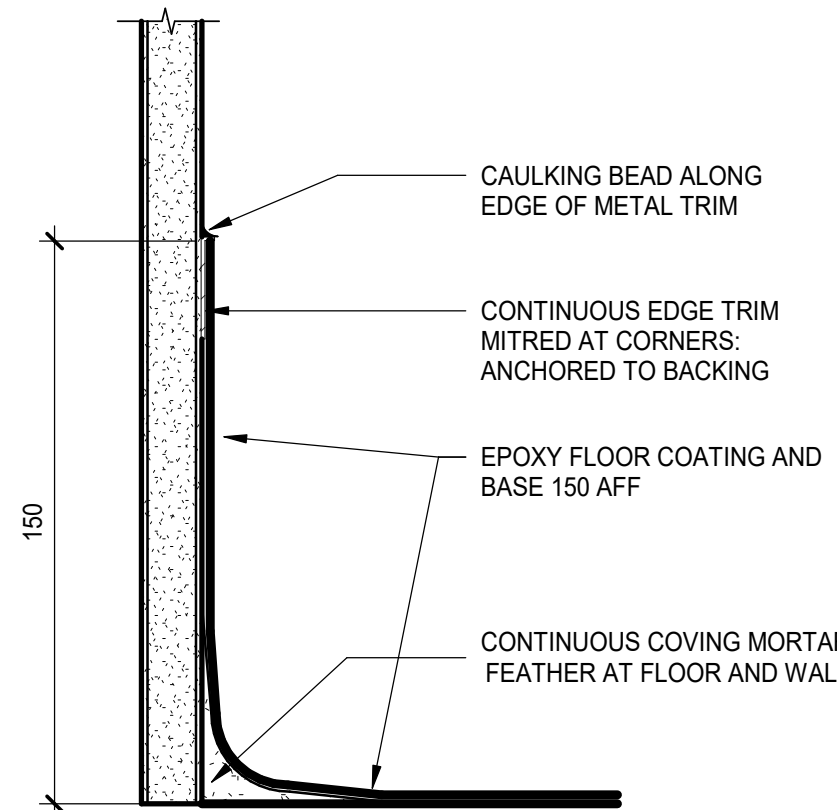

2A EPOXY BASE DETAIL 1
SCALE: 1:2

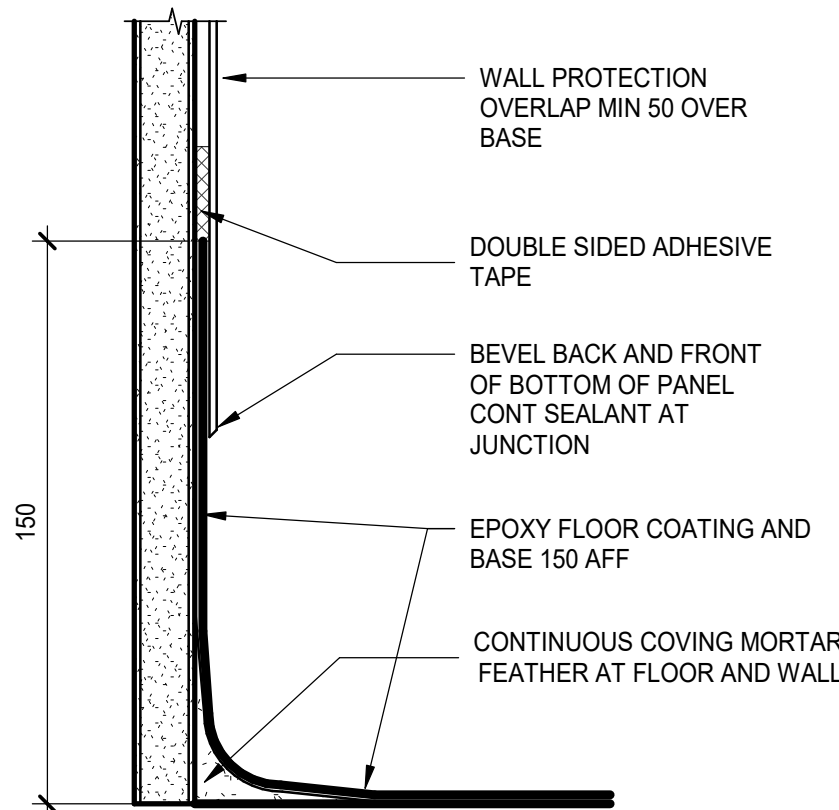

2B EPOXY BASE DETAIL 2
SCALE: 1:2

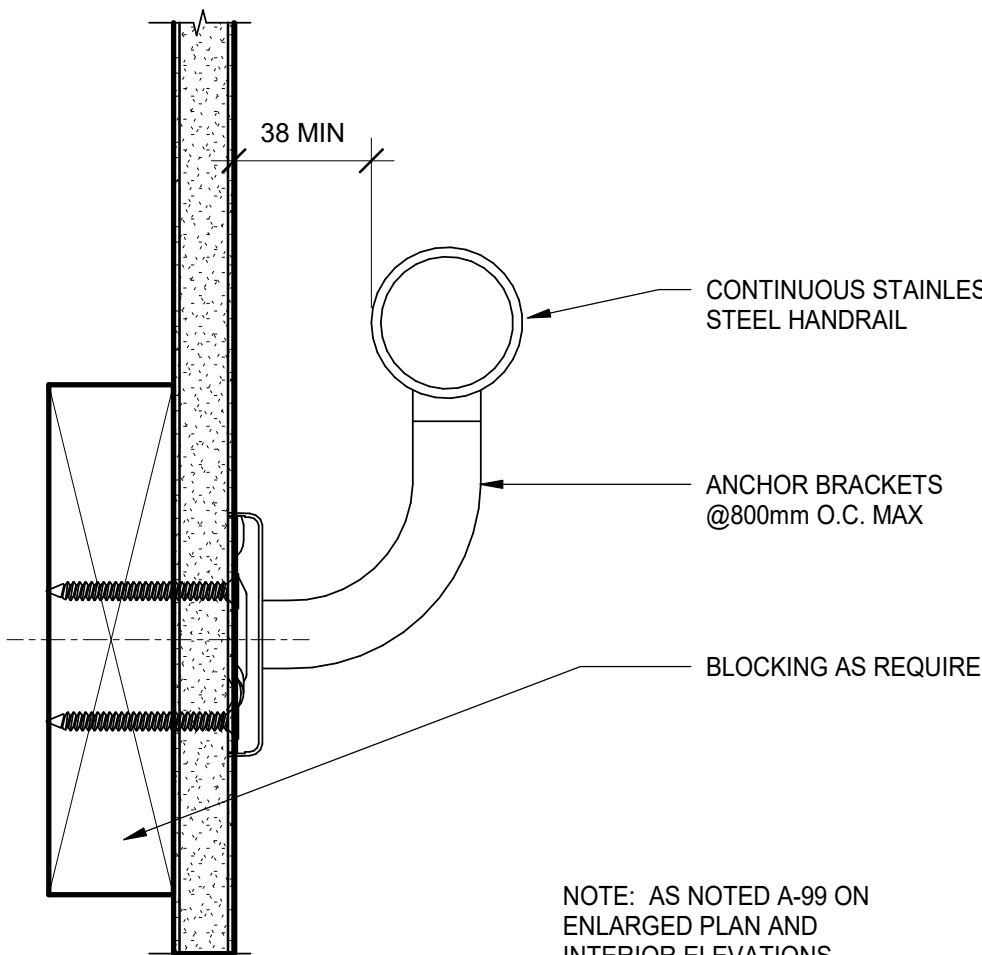

8 HANDRAIL DETAIL 1
SCALE: 1:2

NOTE: AS NOTED A-99 ON
ENLARGED PLAN AND
INTERIOR ELEVATIONS

REV	YYYY-MM-DD	REVISION / DRAWING ISSUE	REVIEW
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PROJECT

**SHN DIALYSIS CARE UNIT - GENERAL
HOSPITAL**

SCARBOROUGH, ONTARIO, CANADA

DRAWING TITLE


MILLWORK DETAILS

DRAWING ISSUE


PROJECT NO. 240065 PLOT DATE 2023-11-17 DRAWN Author

SCALE As indicated @ ARCH D REVIEWED Checker


DRAWING NO. A-511G REVISION 6

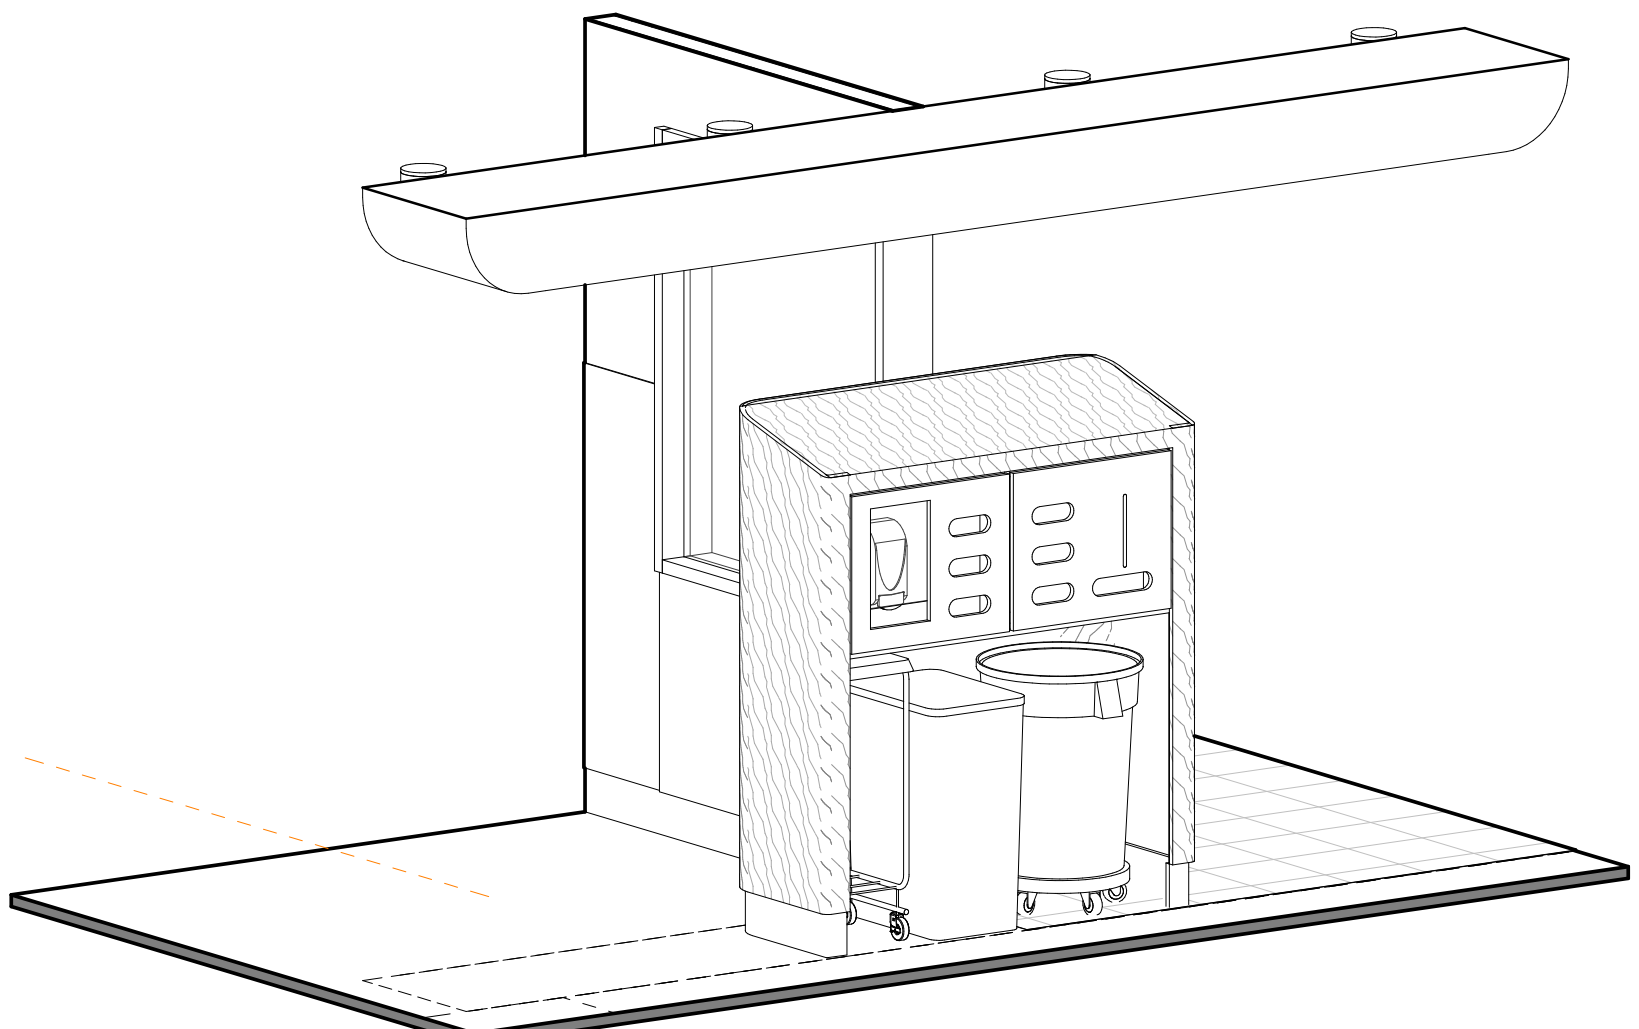


4 PPE CABINET - 3D VIEW
SCALE: 1:25

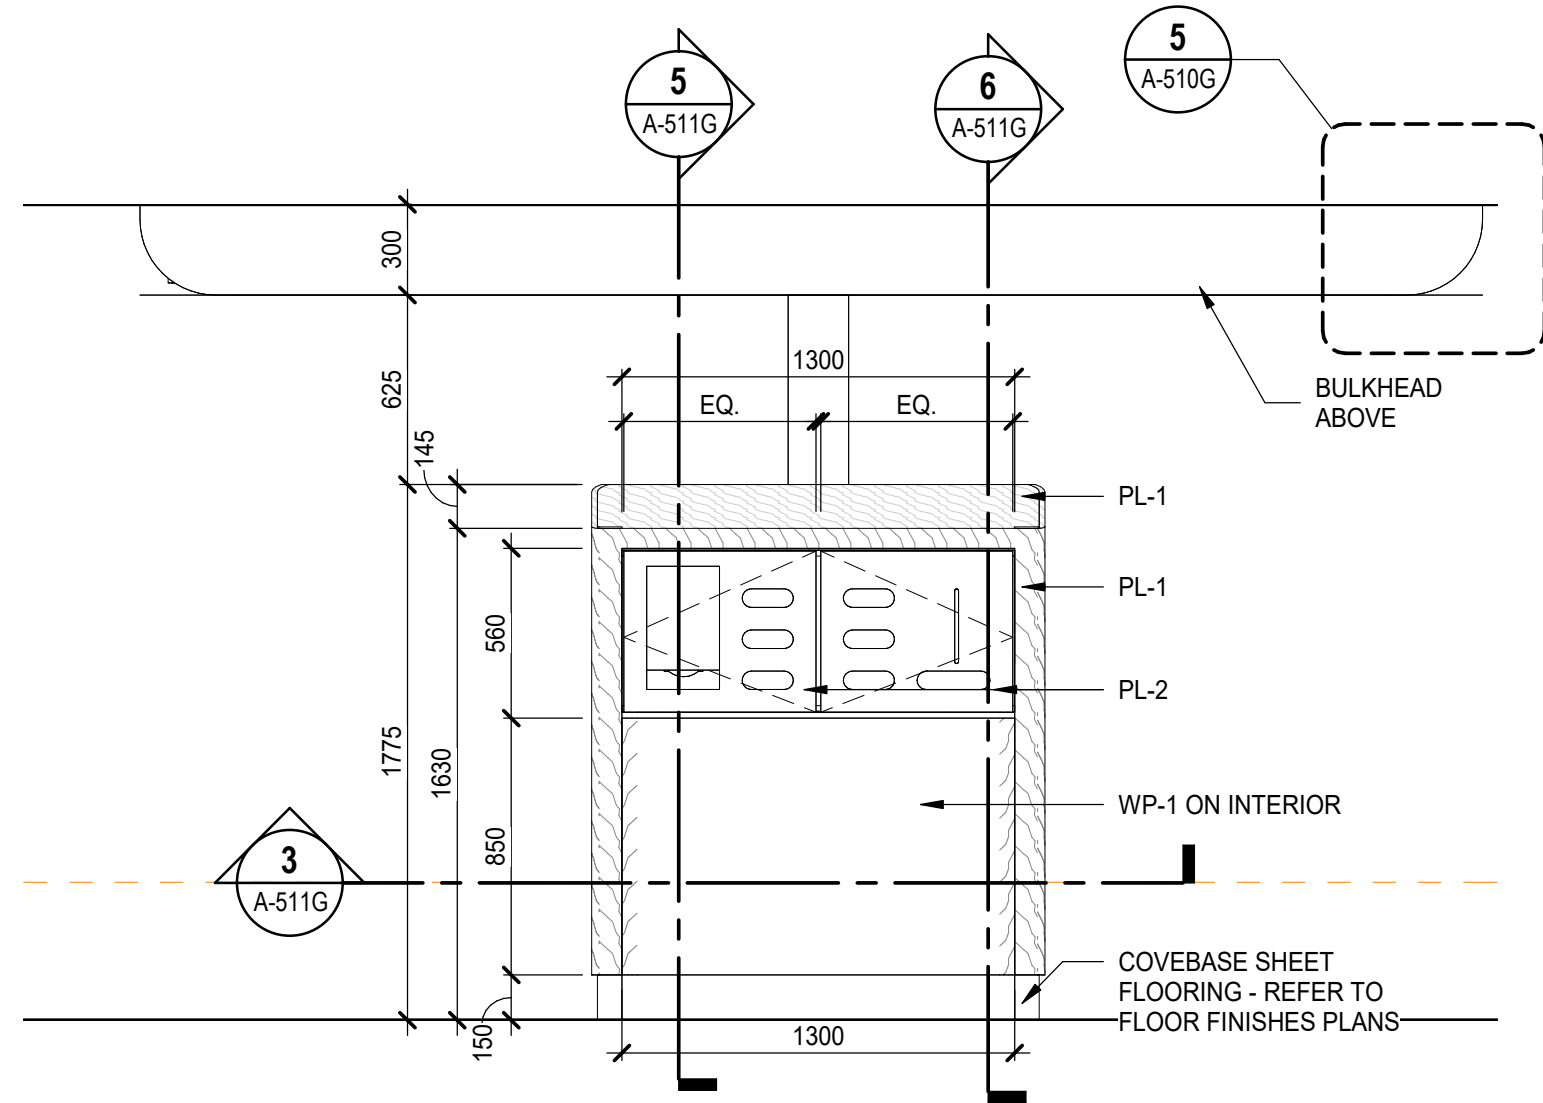


2 PPE CABINET - FRONT ELEVATION
SCALE: 1:25

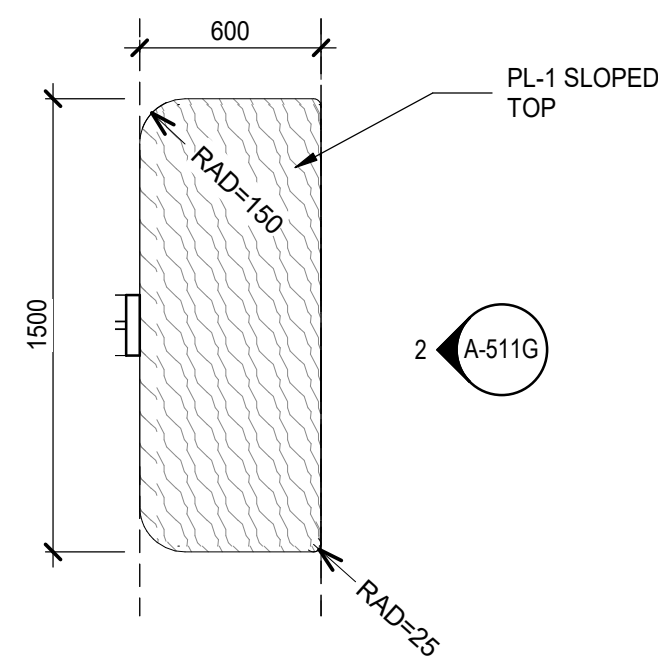


1 PPE CABINET - PLAN VIEW
SCALE: 1:25

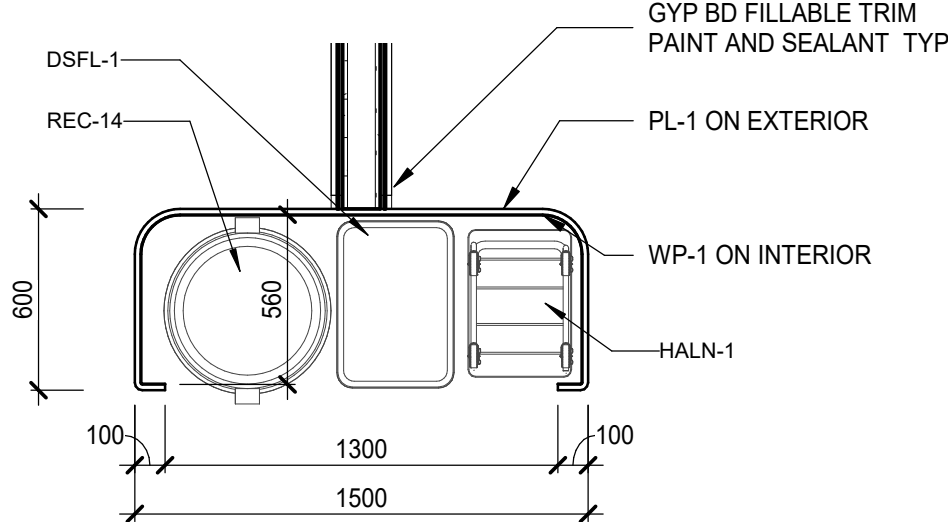


3 PPE CABINET - HORIZONTAL CROSS SECTION
SCALE: 1:25

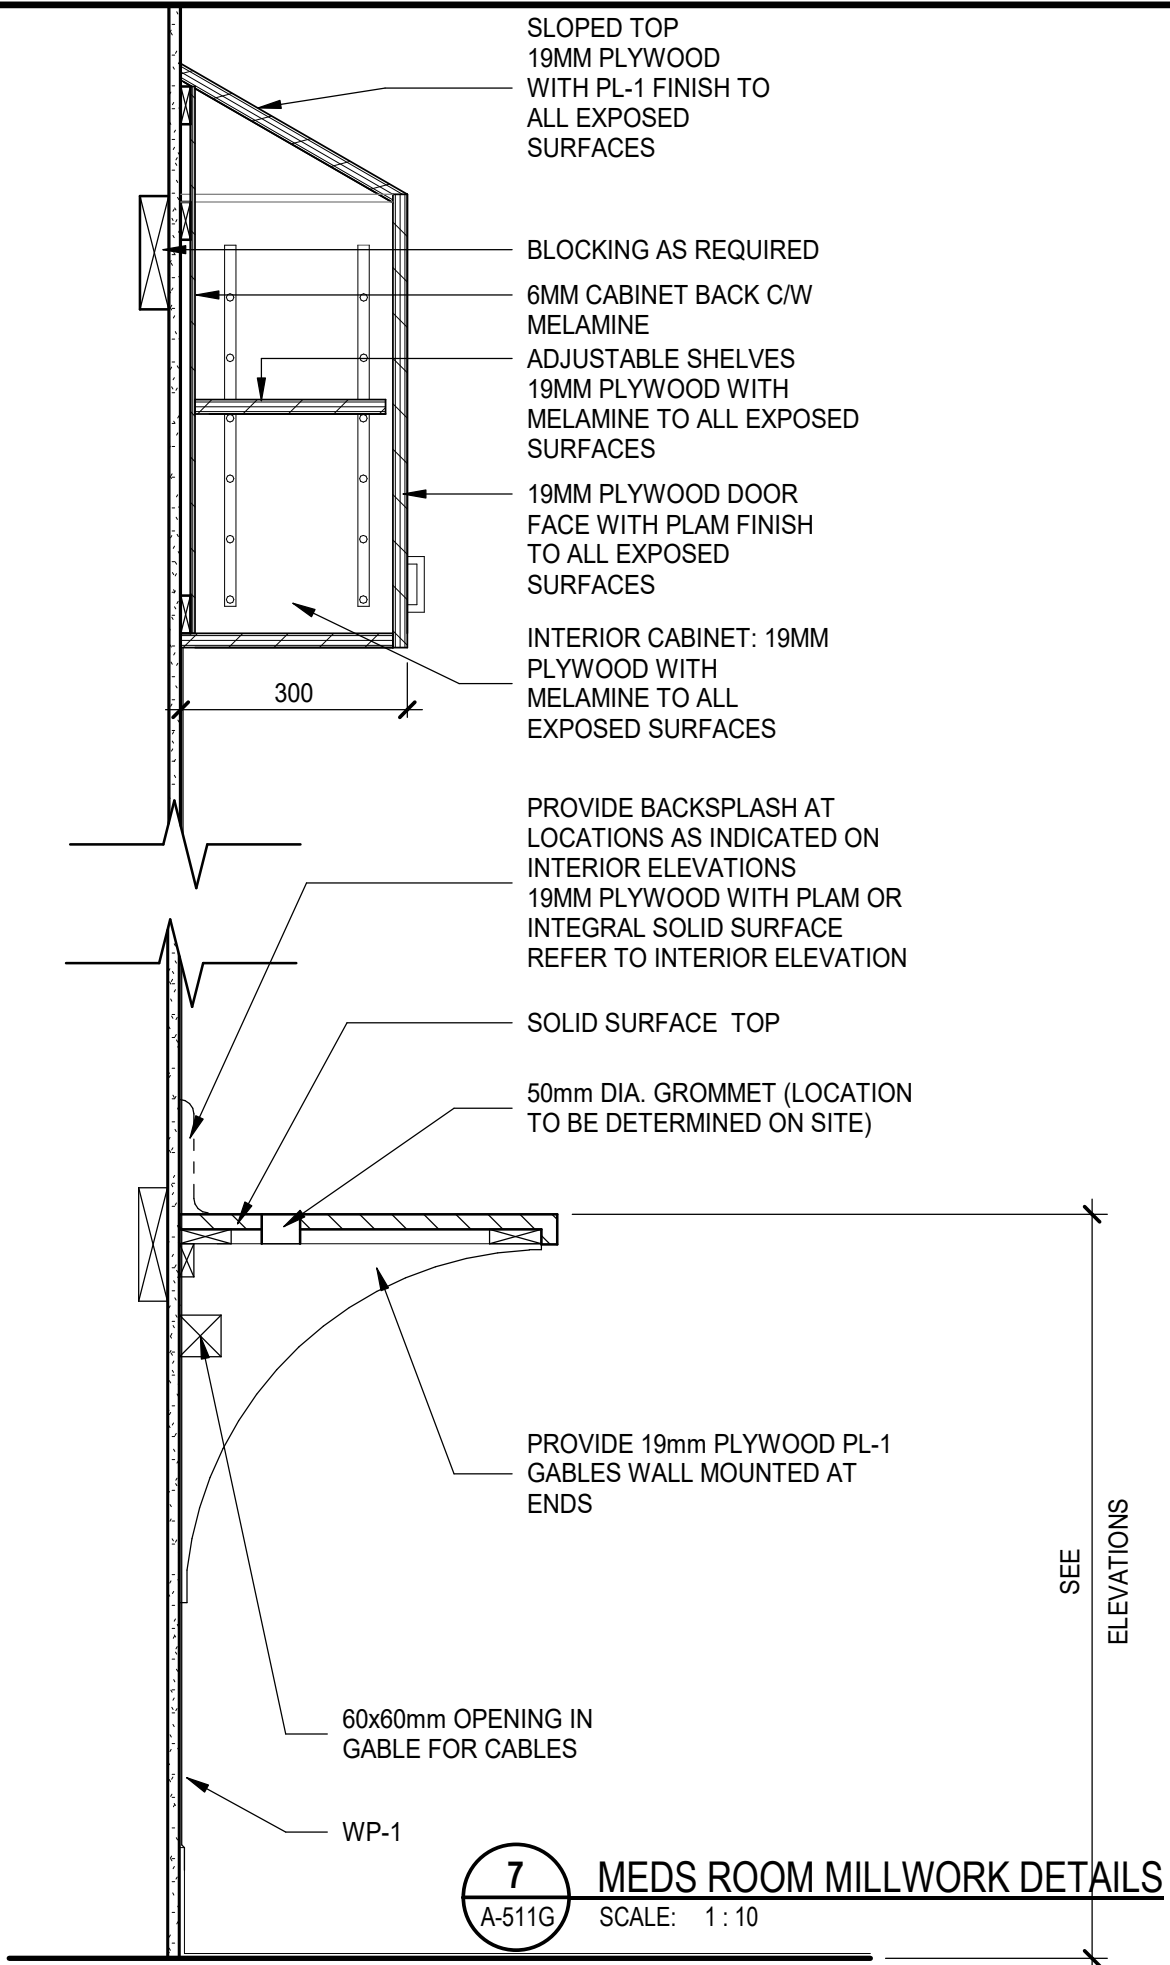

7 MEDS ROOM MILLWORK DETAILS
SCALE: 1:10

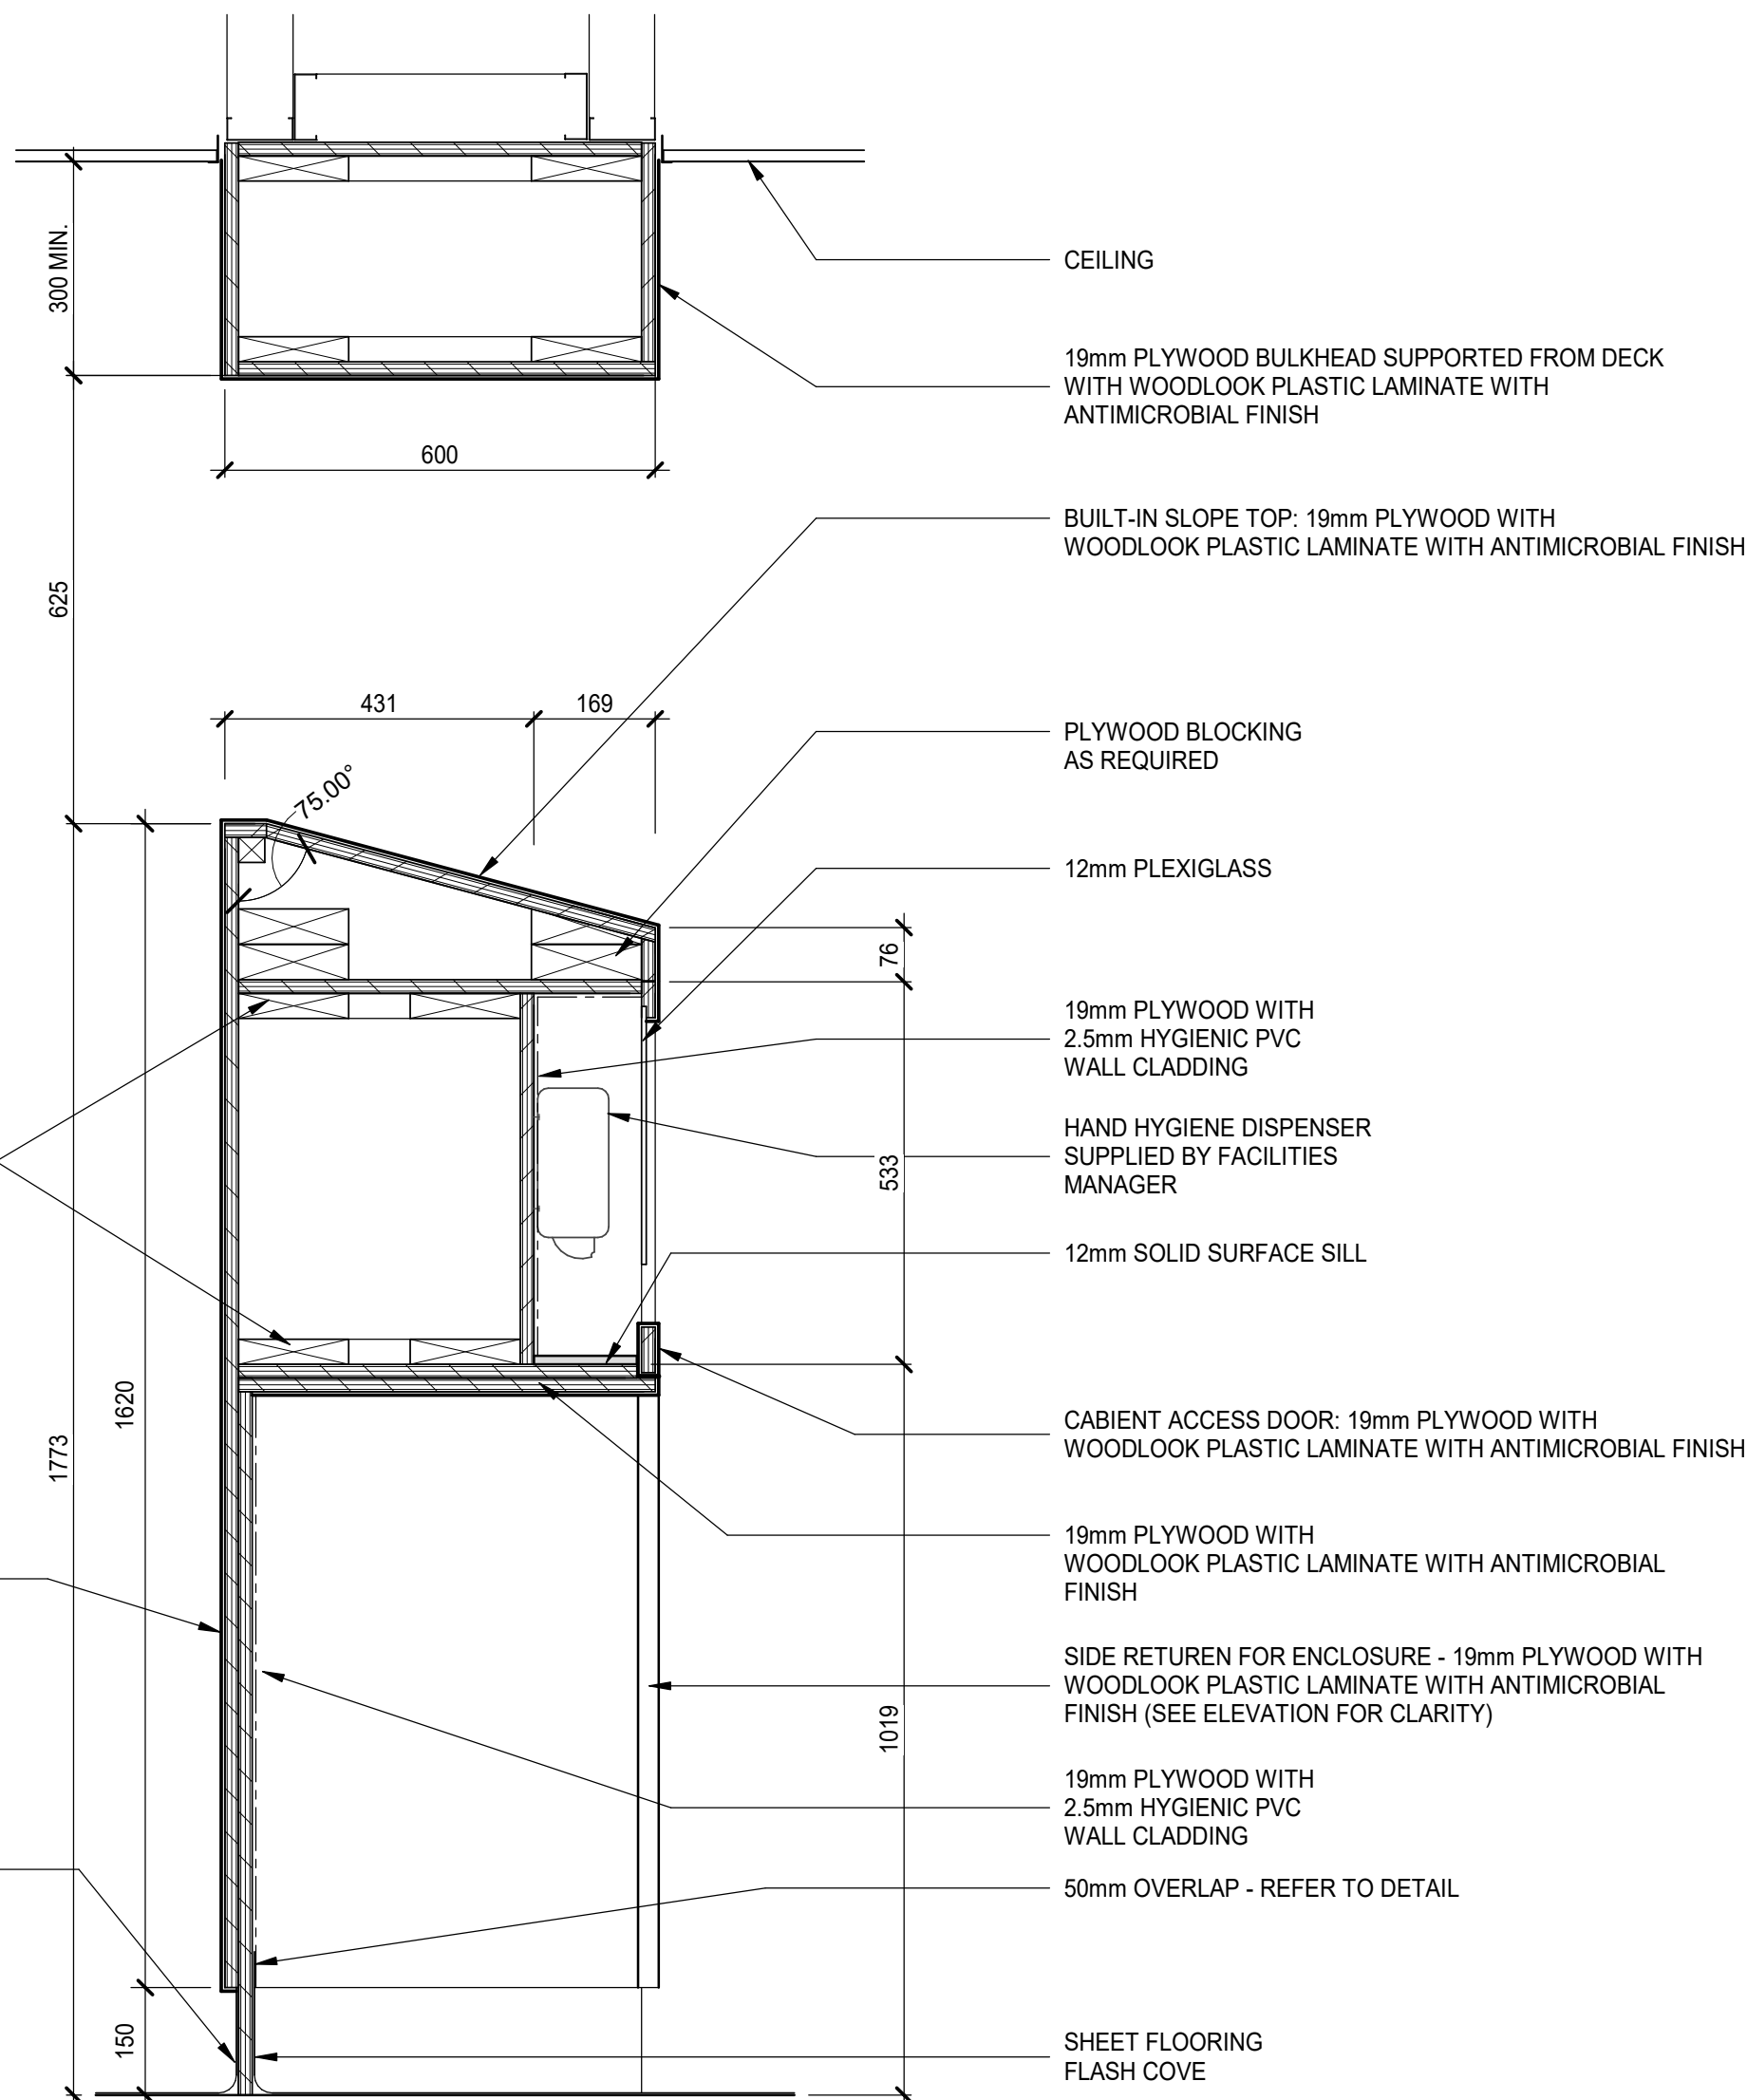


**5 PPE CABINET - SECTION AT HAND SANITIZER
COMPARTMENT**
SCALE: 1:10

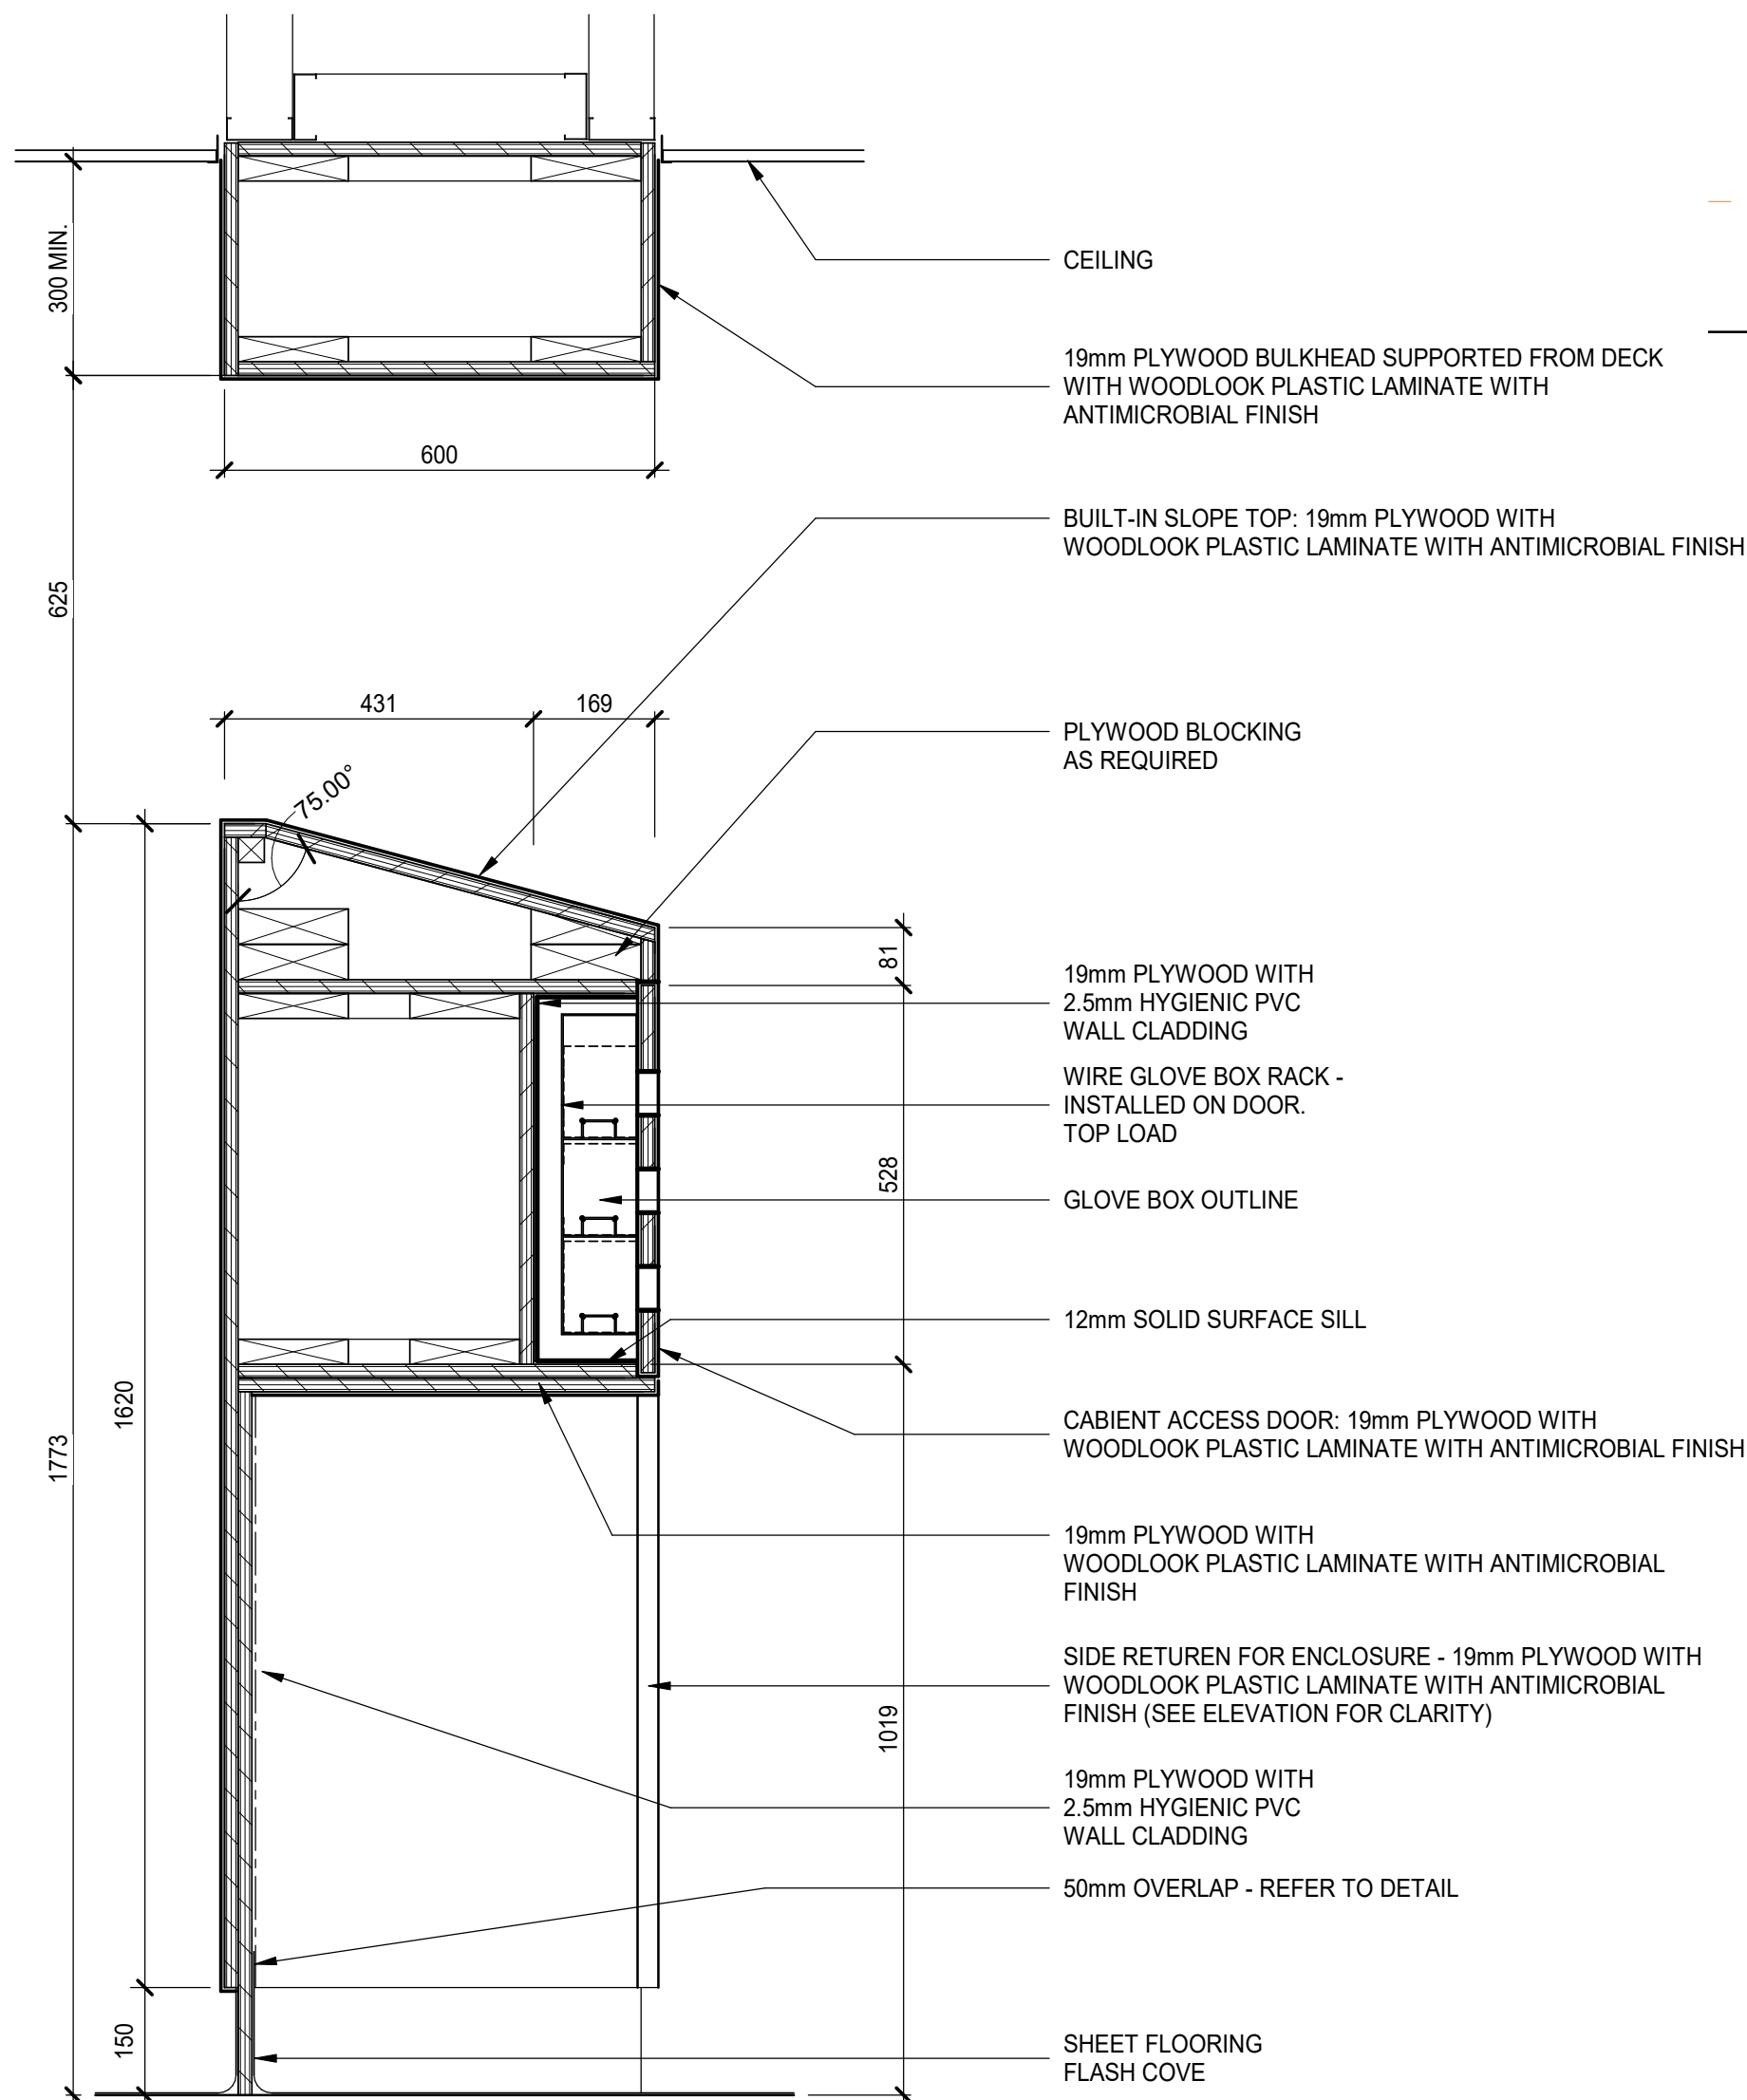

6 PPE CABINET - SECTION AT GLOVE COMPARTMENT
SCALE: 1:10

INTERIOR FINISHES MATERIALS MATRIX						
FINISH CODE	MANUFACTURER	PRODUCT/SERIES	MODEL	COLOUR/FINISH	DIMENSIONS	REMARKS
ACOUSTIC CEILING TILE						
ACT-1	CGC INC.	CLIMAPLUS PERFORMANCE	MARS SQ. - 86115	050 FLAT WHITE	2' X 2' X 1"	TYPICAL CEILING TILE FINISHFINE SURFACE FINISH.
ACT-2	CGC INC.	CLIMAPLUS PERFORMANCE	MARS SQ. - 88115	050 FLAT WHITE	2' X 4' X 1"	TYPICAL CEILING TILE FINISHFINE SURFACE FINISH.
ACT-3	CGC INC.	CLIMAPLUS PERFORMANCE	MARS CLEAN ROOM SQ. - 56099	050 FLAT WHITE	2' X 2' X ¾"	CLEAN ROOM CEILING TILE FOR SOILED UTILITY ROOMS, MED ROOMS
EPOXY FLOORING						
EF-1	SIKA	SIKA FLOOR	QUARTZITE TROWEL SYSTEM	COLOUR 100	3mm	WATER TREATMENT ROOM, TECH WORKROOM, WASHROOMS AND SOILED UTILITY ROOMS
GLAZING FILM						
GF-1	3M	SCOTCHCAL	CLEAR VIEW GRAPHIC FILM (J8150)	TRANSPARENT	54"	GLAZING FILM APPLICATION @ TREATMENT BAYS WITH CUSTOM GRAPHIC PRINT - FINAL IMAGE TBD
GF-2	3M	FASARA FROST/MATTE	MILKY WHITE (SH2MAML)	WHITE	1270 mm x 30 m	PRIVACY GLAZING FILM AT EXTERIOR WINDOWS
PAINT						
PT-1	BENJAMIN MOORE	N/A	N/A	OC-65: CHANTILLY LACE	N/A	GENERAL - WHITE FIELD PAINT
PT-2	BENJAMIN MOORE	N/A	N/A	861: SHALE	N/A	GENERAL - MEDIUM NEUTRAL FIELD
PT-3	BENJAMIN MOORE	N/A	N/A	CC-630: BACKWOODS	N/A	ACCENT - MEDIUM TONE GREEN
PT-4	BENJAMIN MOORE	N/A	N/A	OC-64: PURE WHITE	N/A	GENERAL - CEILING PAINT (FLAT) FOR ALL GYPSUM CEILING AREAS
PT-5	DULUX	X-PERT	N/A	11000: WHITE	N/A	INTERIOR LATEX PRIMER/SEALER FOR WATER TREATMENT ROOM & WORKROOM
PLASTIC LAMINATE						
PL-1	WILSONART	PREMIUM	FAWN CYPRESS (8208K-60)	MATTE	4'X8'	AEON SCRATCH RESISTANCE. WOOD LOOK.
PL-2	WILSONART	SOLIDS	DESIGNER WHITE (D354-60)	MATTE	4'X8'	AEON SCRATCH RESISTANCE. SOLID COLOUR. AT UPPER CABINETS ONLY.
SHEET FLOORING - SAFETY						
SFS-1	ALTRO	AQUARIUS	N/A	TERRAPIN (AQI2009)	2.00 mm	SHEET VINYL-SAFETY FOR MEDICATION ROOM AND CLEAN SUPPLY ROOM
SFS-2	ALTRO	AQUARIUS	N/A	ABALONE (AQI2028)	2.00 mm	SHEET VINYL-SAFETY FOR SOILED UTILITY ROOM, HOUSEKEEPING ROOM, WATER TREATMENT ROOM
SOLID SURFACE						
SS-1	DUPONT	CORIAN	N/A	LIMESTONE PRIMA	¾" THK.	SOLID SURFACE-RECEPTION DESK
VINYL SHEET FLOORING						
VF-1	TARKETT	IQ EMINENT	N/A	WHITE 0904	2.00 mm	SHEET VINYL- MAIN
VF-2	TARKETT	IQ EMINENT UNISENSE	N/A	DUSTY SAND 0928	2.00 mm	SHEET VINYL - ACCENT
WALL AND DOOR PROTECTION						
WP-1	ALTRO	WHTEROCK	SATINS	LINEN (WSR 41) (W136/41)	8' X 4'	HYGIENIC WALL PROTECTION C/W ONE-PART START AND EDGE TRIM IN MATCHING COLOUR. REFER TO WALL PROTECTION LEGEND FOR HEIGHTS
WP-2	ALTRO	WHTEROCK	SATINS	LINEN (WSR 41) (W136/41)	8' X 4'	HYGIENIC WALL PROTECTION C/W ONE-PART START AND EDGE TRIM IN MATCHING COLOUR. REFER TO WALL PROTECTION LEGEND FOR HEIGHTS
WP-3	ALTRO	WHTEROCK	SATINS	LINEN (WSR 41) (W136/41)	8' X 4'	HYGIENIC WALL PROTECTION C/W ONE-PART START AND EDGE TRIM IN MATCHING COLOUR. REFER TO WALL PROTECTION LEGEND FOR HEIGHTS
WP-4	CONSTRUCTION SPECIALTIES	STAINLESS STEEL WALL PROTECTION	N/A	N/A	16 GAUGE	STAINLESS STEEL WALL PROTECTION. REFER TO WALL PROTECTION LEGEND FOR HEIGHTS
WP-5	ALTRO	WHTEROCK	SATINS	LINEN (WSR 41) (W136/41)	8' X 4'	HYGIENIC WALL PROTECTION C/W ONE-PART START AND EDGE TRIM IN MATCHING COLOUR. REFER TO WALL PROTECTION LEGEND FOR HEIGHTS
WP-6	ALTRO	WHTEROCK	SATINS	LINEN (WSR 41) (W136/41)	8' X 4'	HYGIENIC WALL PROTECTION C/W ONE-PART START AND EDGE TRIM IN MATCHING COLOUR. REFER TO WALL PROTECTION LEGEND FOR HEIGHTS
WP-7	ALTRO	WHTEROCK	SATINS	MOCHA/FAWN (W6FR/206)	8' X 4'	HYGIENIC PVC CLADDING FOR CUSTOM PPE CABINETS

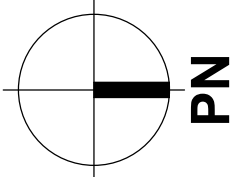

7	2024-06-12	ISSUED FOR ARCH. ADDENDUM 1
6	2024-04-22	ISSUED FOR TENDER
5	2024-04-03	ISSUED FOR CO-ORDINATION
4	2023-12-05	ISSUED FOR MOH STAGE 2.3 SUBMISSION
3	2023-11-17	ISSUED FOR COORDINATION
2	2023-08-28	80% ISSUED FOR COSTING
1	2023-12-22	ISSUED FOR DD COSTING
REV	YYYY-MM-DD	REVISION / DRAWING ISSUE
REVIEW		

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PROJECT

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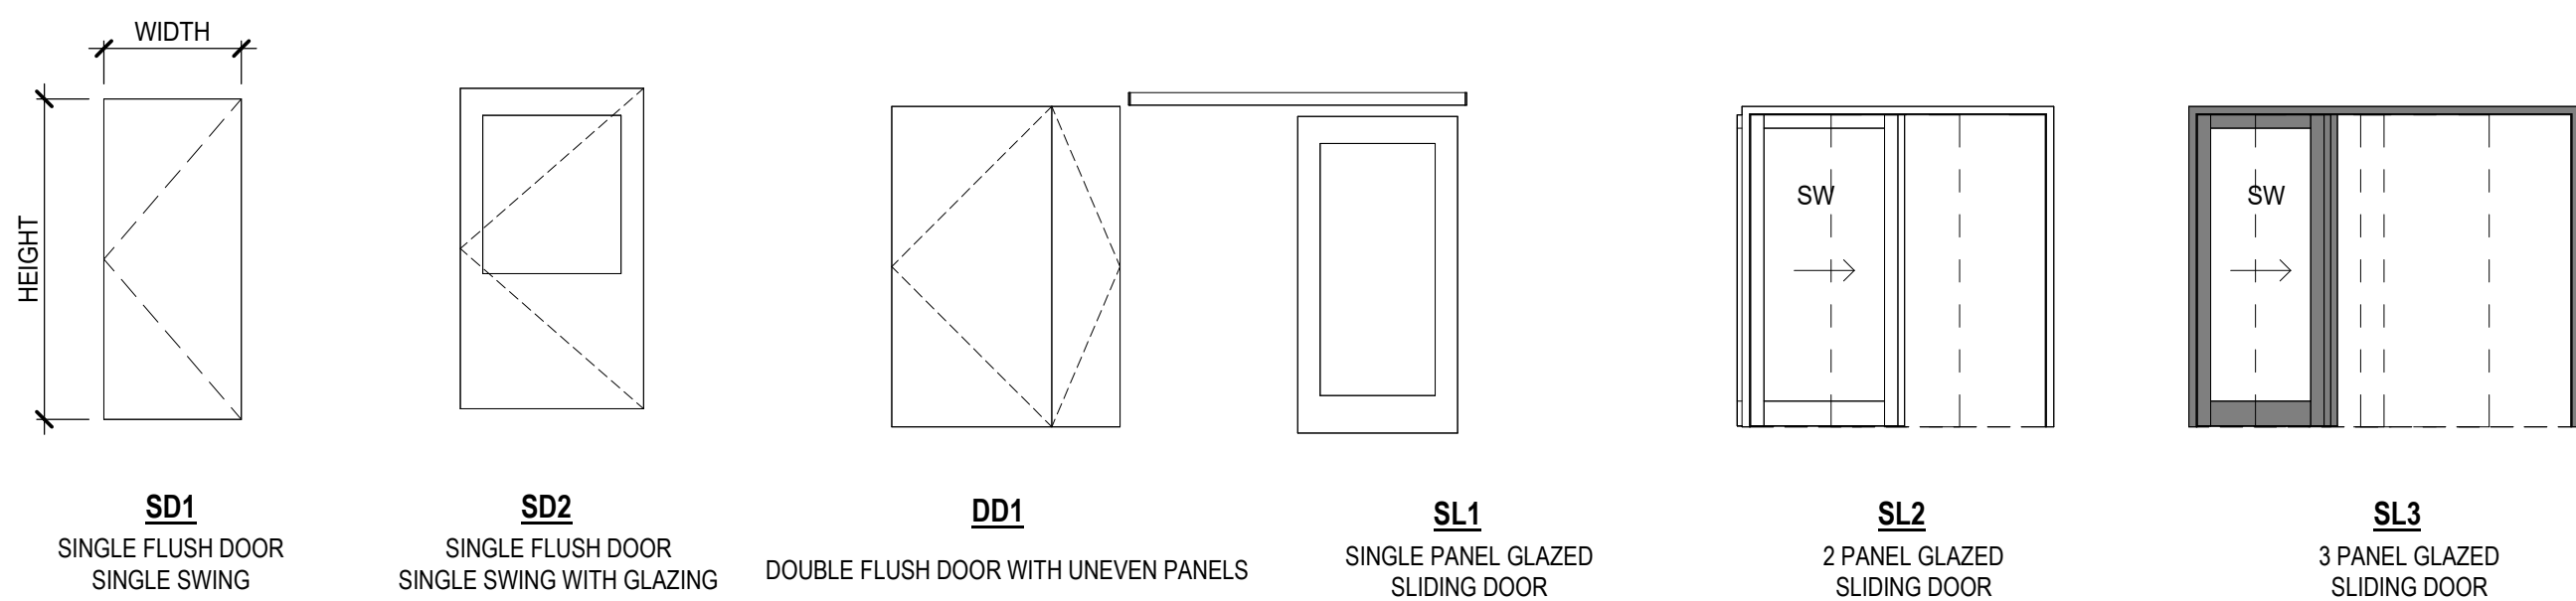
SCARBOROUGH, ONTARIO, CANADA

DRAWING TITLE

INTERIOR FINISHES MATRIX

DRAWING ISSUE

PROJECT NO.	PLOT DATE	2023-11-17	DRAWN	Author
240065	SCALE	@ ARCH D	REVIEWED	Checker
DRAWING NO.	A-600G			REVISION
				7





SINGLE SWING DOOR TYPES

DOUBLE SWING DOOR TYPES



FRAME TYPES

DOOR & FRAME SCHEDULE - NEW																
DOOR PARAMETERS								FRAME PARAMETERS				OPENING PARAMETERS				
DOOR NO.	TYPE	DIMENSIONS			MATL	GLASS TYPE	FINISH	FRAME TYPE	MATL	INSUL	FINISH	FRAME DETAIL	HDWR GROUP	ADO	CARD READER	DOOR CONTACT
		WIDTH	HEIGHT	THK												
2.701A	SD1	762	2135	45	SCW		PLAM	F1	PS		PTD	1	2			
2.713-1	SD2	1220	2135	45	HM	CLR	PTD	F1	PS		PTD	1	2	X		
2.713-2	SD2	1220	2135	45	HM	CLR	PTD	F1	PS		PTD	1	2	X		
2.713A	SL2	2075	2135	45	ALUM	SG	ANOD		ALUM		ANOD	1	3			
2.713B	SL3	2600	2135	45	ALUM	SG	ANOD		ALUM		ANOD	1	3			
2.713C	SL3	2600	2135	45	ALUM	SG	ANOD		ALUM		ANOD	1	3			
2.713D	SL3	2600	2135	45	ALUM	SG	ANOD		ALUM		ANOD	1	3			
2.713E	SL3	2600	2135	45	ALUM	SG	ANOD		ALUM		ANOD	1	3			
2.713F	SL2	2075	2135	45	ALUM	SG	ANOD		ALUM		ANOD	1	4			
2.713G	SD1	1065	2135	45	SCW		PLAM	F3	PS		PTD	3	5			
2.713J	SD1	965	2135	45	HM		PTD	F1	PS		PTD	1	6		X	X
2.713L	SD1	762	2135	45	HM		PTD	F1	PS		PTD	1	7			
2.714	SD1	1065	2135	45	SCW		PLAM	F3	PS		PTD	3	11	X		
2.719	DD1	1520	2135	44	HM		PTD	F2	PS		PTD	1	8		X	X
2.723	SL1	1065	2135	45	ALUM	CLR	ANOD		ALUM		ANOD	4	9		X	X
2.724	SD1	965	2135	45	HM		PTD	F1	PS		PTD	1	6		X	X
2.725	SD1	965	2135	45	SCW		PLAM	F1	PS		PTD	1	10	X	X	X
2.726D	SD1	1065	2135	45	SCW		PLAM	F3	PS		PTD	3	11	X		
2.727	SD1	1220	2135	45			PTD	F1	PS		PTD	1	12		X	X
2.728	SD1	1220	2135	45	HM		PTD	F1	PS		PTD	1	12			
2.729	SD1	965	2135	45	HM		PTD	F1	PS		PTD	1	1		X	X
2.729A	SD1	965	2135	45	HM		PTD	F1	PS		PTD	1	13			



DOOR & FRAME SCHEDULE - EXISTING						
DOOR NO.	DOOR FINISH	FRAME FINISH	OPENING PARAMETERS			COMMENTS
			HDWR GROUP	ELEC	ACCESS CONTROL	
EX-2.701	PTD	PTD				EXISTING
EX-2.702	PTD	PTD				EXISTING
EX-2.704	PTD	PTD				EXISTING
EX-2.709	PTD	PTD				EXISTING
EX-2.710	PTD	PTD				EXISTING
EX-2.712	PTD	PTD				EXISTING
EX-2.719B	PTD	PTD				EXISTING
EX-2.720	PTD	PTD				EXISTING
EX-2.727	PTD	PTD				EXISTING
EX-ELEC RM	PTD	PTD				EXISTING
EX-MECH RM	PTD	PTD				EXISTING
EX-N STAIR	PTD	PTD				EXISTING

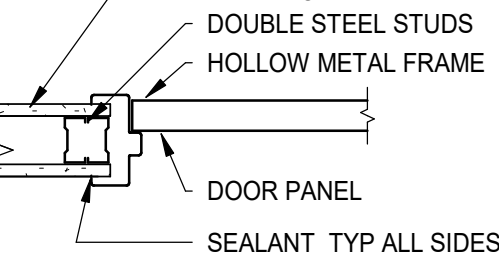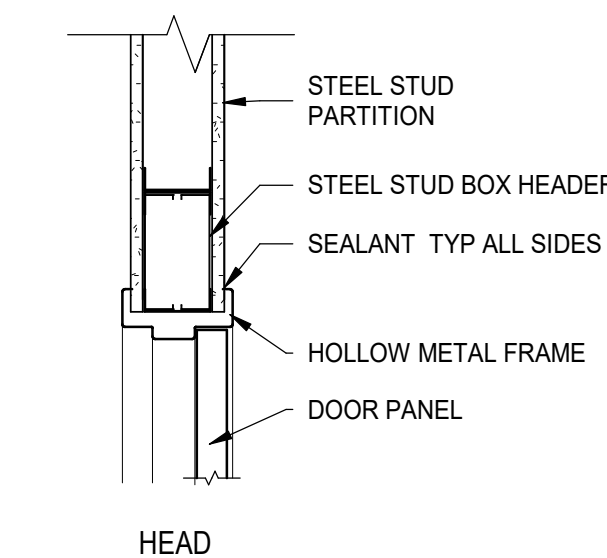



DOUBLE RABBET FRAME
DETAIL 1

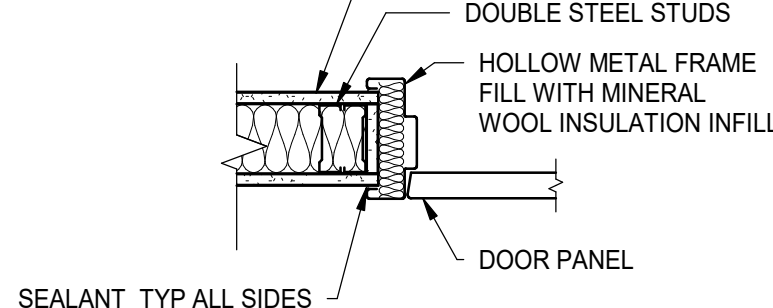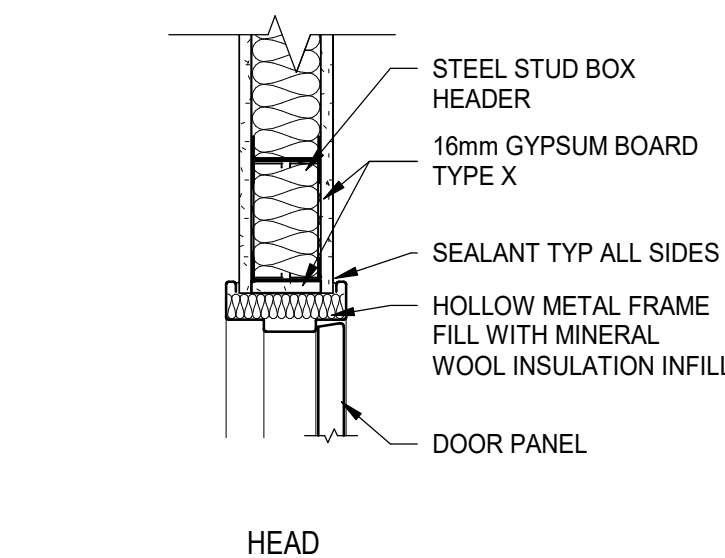


DOUBLE RABBET FRAME
FIRE RESISTANCE RATED
DETAIL 2

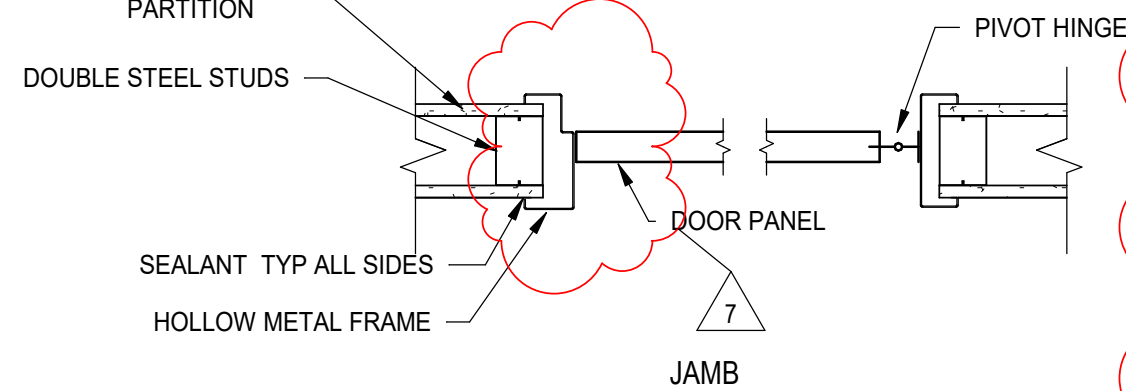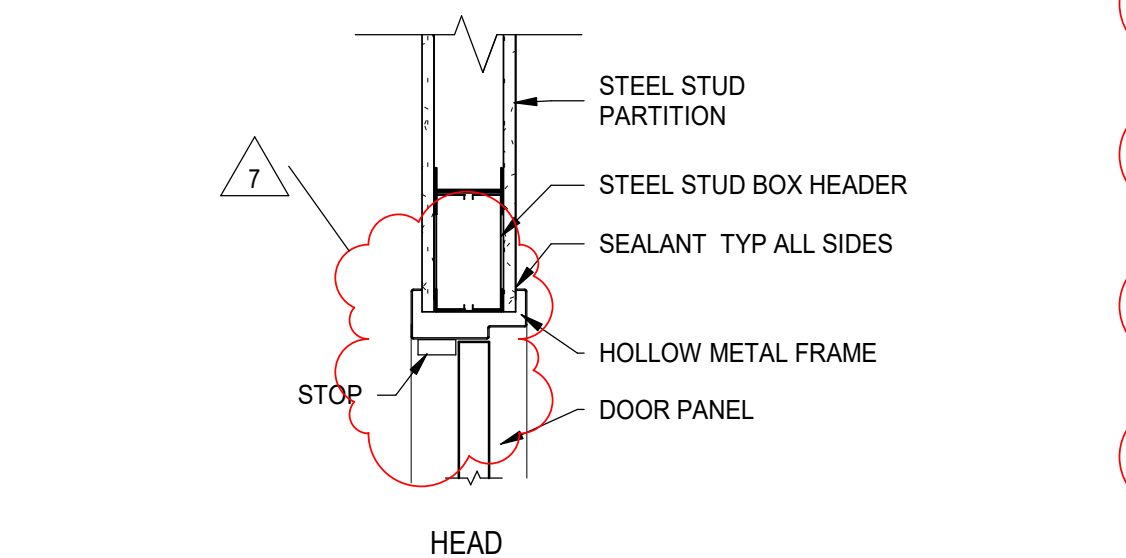



CASED/SINGLE RABBET
OPENING FRAME
DETAIL 3

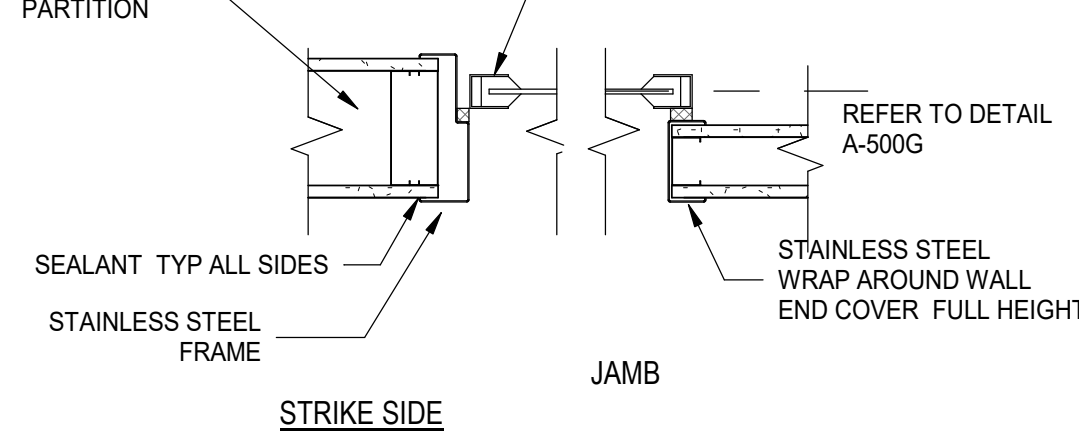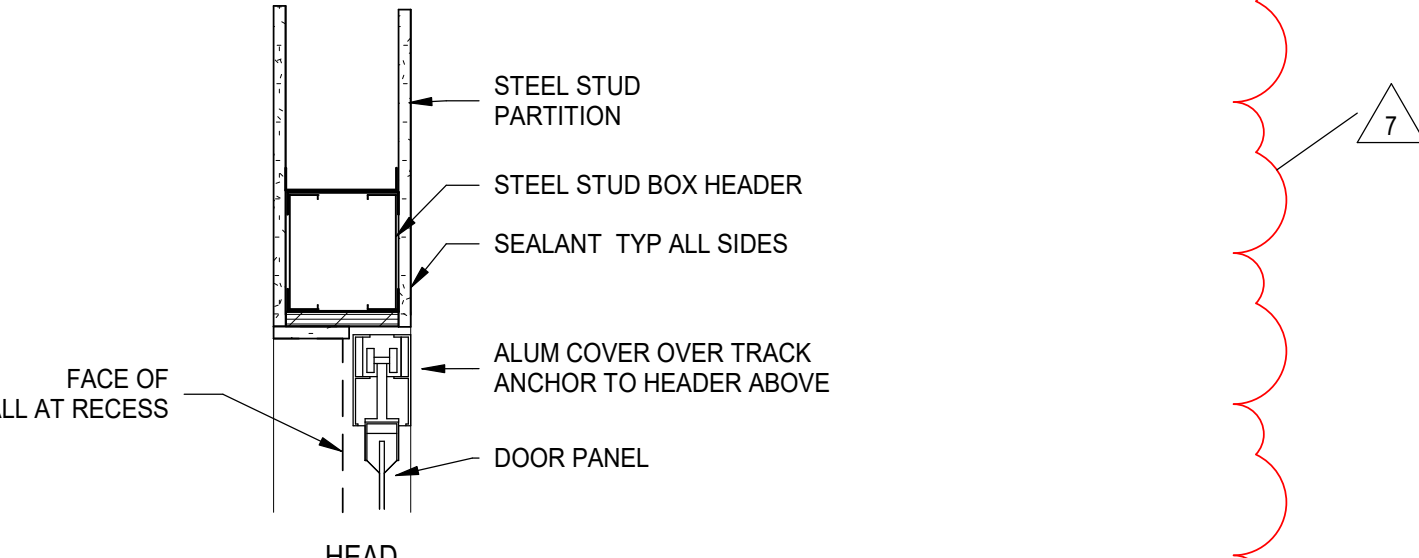


SINGLE RABBET OPENING
FRAME - SLIDING DOOR
DETAIL 4

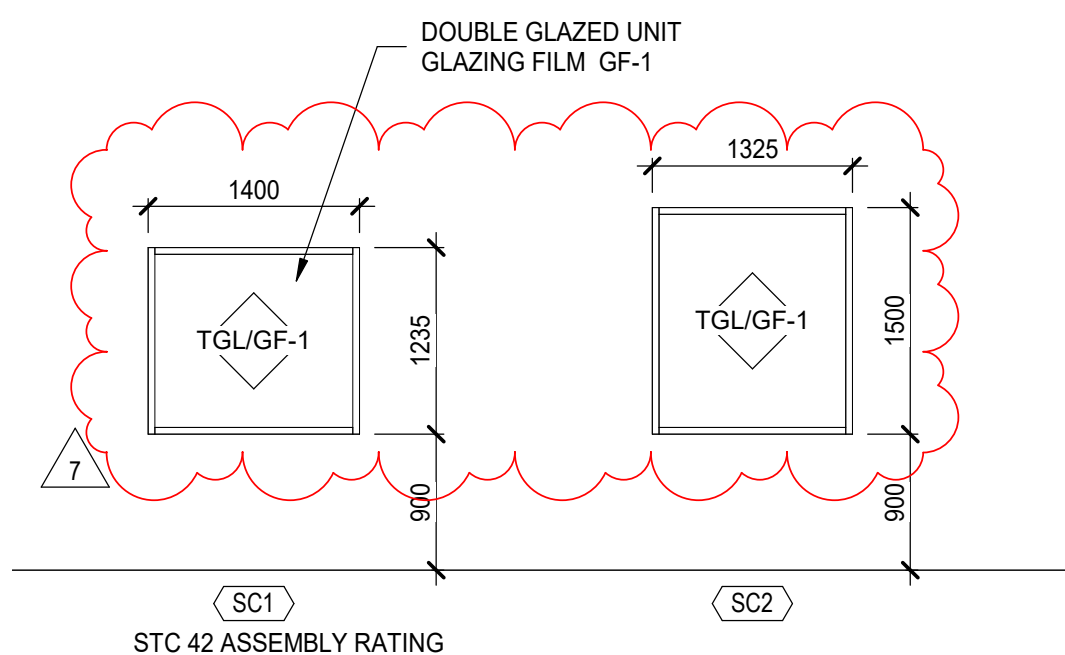


2 INTERIOR SCREENS
SCALE: 1:50

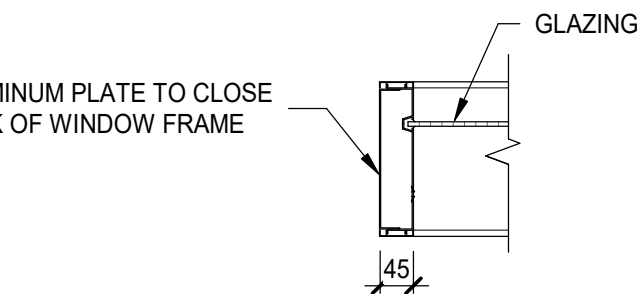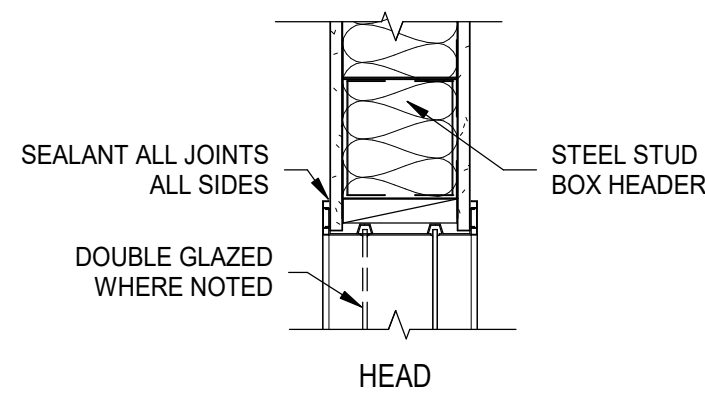

JAMB ABOVE PPE CABINET
AT TREATMENT ROOMS

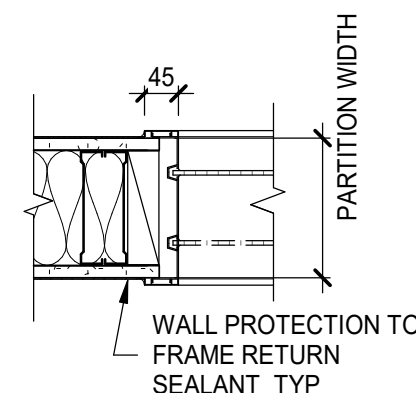

JAMB

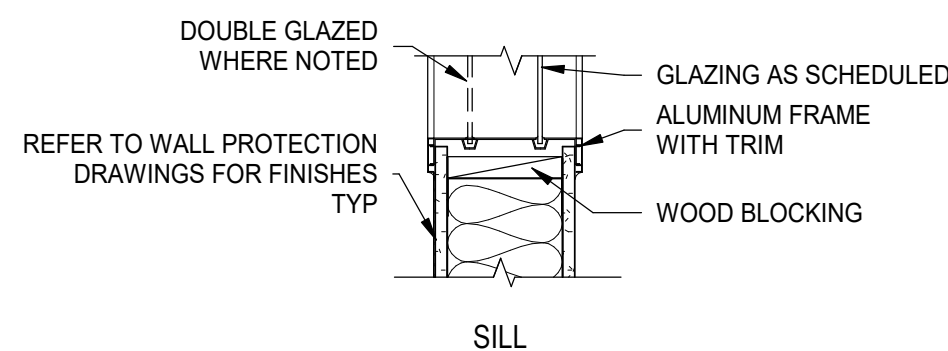

SILL

3 SCREEN FRAME DETAILS
SCALE: 1:10

1 DOOR AND FRAME DETAILS - STEEL STUD
SCALE: 1:10

NOTE: FILL FRAMES WITH SOUND ATTENUATION
BATT INSULATION WHERE REQUIRED WITH ACOUSTIC
RATED PARTITIONS

NOTE: FILL FRAMES WITH SOUND ATTENUATION
BATT INSULATION WHERE REQUIRED WITH ACOUSTIC
RATED PARTITIONS

DOOR / FRAME LEGENDS & ABBREVIATIONS

LEGEND / ABBREVIATIONS

ALUM ALUMINUM
ANOD ANODIZED
CLR CLEAR
DCRON DURACRON
DNAR DURANAR
EXT EXTERIOR
F FRAME
FLM FILM
FRCGL FIRE RATED CERAMIC GLAZING
GL GLASS (typ)
GF GLAZING FILM
GA GLAZED ALUMINUM
GALV GALVANIZED
HCW HOLLOW CORE WOOD
HM HOLLOW METAL
HR HOUR
INSUL INSULATED
MIN MINUTE
N/A NOT APPLICABLE
NF NO FRAME (FRAMELESS)
PLAM PLASTIC LAMINATE
PC POWDER COAT
PS PRESSED STEEL
PTD PAINTED
SCW SOLID CORE WOOD
SG SWITCHABLE GLASS
SS STAINLESS STEEL
STL STEEL
TGL TEMPERED SAFETY GLASS
WD WOOD
WV WOOD VENEER

DUTY LEGEND

MED MEDIUM
STD STANDARD
HVV HEAVY
X-HVV EXTRA HEAVY

DOOR TYPES LEGEND

BF BIFOLD DOOR
CD COLING DOOR
CS COUNTER SHUTTER
DD DOUBLE SWING DOOR
GA GLAZED ALUMINUM DOOR
GL GLASS DOOR
HD HANGAR DOOR
ID IMPACT DOOR
OH OVERHEAD DOOR
RE REVOLVING DOOR
RO ROLLING DOOR
RR RAPID ROLL DOOR
SD SINGLE SWING DOOR
SL SLIDING DOOR
SP SPECIAL DOOR (define and detail)

CORE LEGEND

GYP GYPSUM
HC HOLLOW CORE
HO HONEY-COMB
ISO POLYISOCYANURATE
MF MINERAL FIBRE
PO POLYSTYRENE
SC SOLID CORE
UR POLYURETHANE


DOOR AND FRAME GENERAL NOTES

- REFER TO SPECIFICATIONS OR FINISH IDENTIFICATION SCHEDULE FOR DESCRIPTION OF FINISHES AND COLOURS
- CO-ORDINATE WITH FINISH HARDWARE SCHEDULE

kasian

Kasian Architecture
Ontario Incorporated

85 Hanna Avenue, Suite 300
Toronto, ON Canada M8K 3S3
T 416 583 3600 F 416 583 3610
www.kasian.com

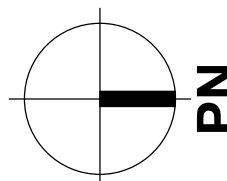

7	2024-06-12	ISSUED FOR ARCH. ADDENDUM 1
6	2024-04-22	ISSUED FOR TENDER
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1	2023-12-22	ISSUED FOR CO COSTING
REV	YYYY-MM-DD	REVISION / DRAWING ISSUE

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PROJECT

SHN DIALYSIS CARE UNIT - GENERAL HOSPITAL

SCARBOROUGH, ONTARIO, CANADA

DRAWING TITLE

DOOR AND FRAME TYPES AND SCHEDULE

DRAWING ISSUE

PROJECT NO.	PLOT DATE	2023-11-17	DRAWN	Author
240065	SCALE	As indicated	@ ARCH D	REVIEWED
DRAWING NO.	A-601G			REVISION

7

Specification Addendum 1

1. Replace Section 00 01 10 – Table of Contents with revised Section 00 01 10 – Table of Contents, attached.
2. Section 00 01 10 - Table of Contents. Revise Section number, “08 81 00” to read, “08 80 00 – Glass and Glazing”.
3. Section 01 73 00 – Execution. Revise sentence 1.7.2 to read as follows:

“1.7.2. Hoarding and Dust Screens: Refer to Section 01 50 00 - Temporary Facilities and Controls for stud framing and gypsum board sheathing materials.”
4. Section 01 73 00 – Execution. Add new paragraphs 1.9.7. as follows:

“1.9.7. Remove plexiglass panels from windows where noted on drawings. Reinstall screw fasteners into holes in the aluminum frame. Paint touch-up screw heads to match colour of aluminum frames.
5. Section 06 40 00 – Architectural Woodwork. Revise sentences 2.5.2.4. and 2.5.2.5. to read as follows:

“2.5.2.4. PL-1: “Premium” by Wilsonart, “Fawn Cypress” 8208K-60, matte finish.
2.5.2.5. PL-2: “Solids” by Wilsonart, “Designer White” D354-60, matte finish.”
6. Add new Section 08 41 13 – Aluminum Framed Screens, attached.
7. Section 08 14 23 – Plastic Laminate Faced Wood Doors. Revise the Section number in the header from, “18 14 23” to read, “08 14 23”.
8. Section 08 81 00 – Glass and Glazing.
 1. Insert new Sentence 1.2.1.6. as follows:

“1.2.1.6. Switchable glass.”
 2. Insert new sentence 1.5.3.4. as follows:

“1.5.3.1.4. Switchable glass.”
 3. Add the following sentence to the end of sentence 1.6.1.: “Ensure to include copies of ESA inspection reports, 1 for each switchable glass location.”
 4. Add the following paragraph 1.7.4.5. as follows:

“1.7.4.5. Construct mock-ups to include switchable glass and resin panel glazing. Coordinate with work of other sections.”

5. Add new section 2.3.10. as follows:

- “2.3.10. Switchable Glass: Glass changing from frosted, translucent panel to transparent panel when electric current is applied having following characteristics:
 - 2.3.10.1. Maximum switching speeds:
 - 2.3.10.1.1. Clear to obscure: less than 1 second.
 - 2.3.10.1.2. Obscure to clear: less than 1 second.
 - 2.3.10.2. Electrical Components: Provide switchable glass panels with a bus bar (location which can be customized). Generally, it appears along 1 edge of glass panel with a 4572 mm (15') long flexible 18 gauge wire exiting centre of bus bar edge and conduit connector. Ensure electrical components are CSA approved and ESA inspected.
 - 2.3.10.3. Operating Voltage: 110 – 120 VAC / 50 – 60 Hz.
 - 2.3.10.4. Operating Current: 0.012 Amps (12mA/sq ft).
 - 2.3.10.5. Power Consumption: Less than 1 watt/sq ft of privacy glass.
 - 2.3.10.6. Laminating interlayers block out over 99% of UV Rays
 - 2.3.10.7. Ensure films and interlayers are hermetically sealed around edges; protected from moisture and components/electrical connectors are concealed and isolated from user.
 - 2.3.10.8. Glass Type: Heat-strengthened. [
 - 2.3.10.9. Thickness: 11.1 mm (7/16”).
 - 2.3.10.10. Operating temperature range: -18 deg C to 71 deg C (0 deg F to 150 deg F) (at low temp switching speed impacted).
 - 2.3.10.11. Haze: 5% - 7% depending on substrates specified.
 - 2.3.10.12. Specular Light Transmittance:
 - 2.3.10.12.1. On: 75%.
 - 2.3.10.12.2. Off: 0.01%.
 - 2.3.10.13. Parallel Light Transmittance:
 - 2.3.10.13.1. On: 70%.
 - 2.3.10.13.2. Off: 5%.
 - 2.3.10.14. Total Light Transmittance:
 - 2.3.10.14.1. On: 80%.
 - 2.3.10.14.2. Off: 75%.
 - 2.3.10.15. Acceptable Products: “LC Privacy Glass” by Innovative Glass Corporation, “Polyvision™ Switchable Privacy Glass” by Polytronix, Inc. or “Switchable Privacy Glass” by Smartglass International.”

6. Add new section 3.2.1.3. as follows:

- “3.2.1.3. Switchable Glass:
 - 3.2.1.3.1. Coordinate requirements ESA inspection(s), for power supply, conduit, fuses, circuit breakers, electrical boxes and enclosures, and switches.
 - 3.2.1.3.2. Switchable glass panels must be installed on a circuit protected by a ground fault circuit interrupter (GFCI).
 - 3.2.1.3.3. Prior to installation, verify proper type of power source, location of conduit, boxes and protection by GFCI.
 - 3.2.1.3.4. Verify framing to receive switchable glass is accurately sized, structurally sound, square and without bow. Verify surfaces of glazing channels and recesses are clean, free of obstructions and ready to receive glazing.
 - 3.2.1.3.5. Drill oversized holes in frame for electric power source. Accurately align with centre line of switchable glass conduit connector.
 - 3.2.1.3.6. Immediately prior to glazing clean contact surfaces with solvent and wipe dry.”

7. Add new sentence 3.4.1.2. as follows:

“3.4.1.2. Test each switchable glass panel unit by ESA. Verify performance and control switching. Ensure electrical components will not be exposed to moisture.”

8. Section 09 29 00 – Gypsum Board. Add new paragraph 2.2.26. as follows:

“2.2.26. Surface mounted aluminum ceiling expansion joint cover:

8.2.1.6. Finish: clear anodized

8.2.1.7. Concealed fasteners

2.2.26.3 Basis of Design: model “ASM-200” by C/S Construction Specialties.”

9. Add new section 3.7. as follows:

“3.7 **CLOSEOUT ACTIVITIES**

3.7.1. Demonstration: Demonstrate operation and maintenance of switchable glass system to Owner's representatives.”

9. Section 10 28 00 – Washroom Accessories. Revise paragraph 2.3.12. to read as follows:

“2.3.12. Shelves: surface mounted, stainless steel shelf. Stainless steel support brackets welded to shelf. Satin finish.

2.3.12.1. M-1: 900 mm long x 300 mm wide, model 7512 by Bradley.

2.3.12.2. M-2: 456 mm long x 100 mm wide, model 755 by Bradley.”

10. Add new Section 10 26 26 – Handrails, attached.

	Pages	Date Issued
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00 00 01 Cover.....	1	April 17, 2024
00 01 05 Professional Certifications	3	April 17, 2024
00 01 10 Table of Contents.....	2	June 12, 2024
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00 31 01 Scarborough Health Network Contractor Procedure Manual.....	23	August, 2022
CONTRACTING REQUIREMENTS		
00 63 13 Request for Interpretation Form.....	1	April 17, 2024
00 63 16 Sign Off for Construction Work Area Form	1	April 17, 2024
00 63 25 Substitution Request Form.....	2	April 17, 2024
00 63 69 Electronic Release Form	3	April 17, 2024
00 65 37 Maintenance Material Form	1	April 17, 2024
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01 14 00 Work Restrictions	4	April 17, 2024
01 20 00 Price and Payment Procedures	3	April 17, 2024
01 25 00 Substitution Procedures	2	April 17, 2024
01 30 00 Administrative Requirements	7	April 17, 2024
01 31 13 Project Coordination.....	5	April 17, 2024
01 32 16 Construction Scheduling	3	April 17, 2024
01 33 00 Submittal Procedures.....	6	April 17, 2024
01 35 33 Infection Control Procedures.....	6	April 17, 2024
01 40 00 Quality Requirements.....	9	April 17, 2024
01 50 00 Temporary Facilities and Controls	11	April 17, 2024
01 60 00 Product Requirements	5	April 17, 2024
01 73 00 Execution	13	April 17, 2024
01 75 16 Start-Up Procedures	10	April 17, 2024
01 77 00 Closeout Procedures.....	6	April 17, 2024
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02 41 19 Selective Demolition.....	10	April 17, 2024
Division 03 - Concrete		
03 35 00 Concrete Finishing	9	April 17, 2024
Division 04 – Masonry		
04 22 00 Concrete Unit Masonry	9	April 17, 2024
Division 05 – Metals		
05 50 00 Metal Fabrications.....	9	April 17, 2024

	Pages	Date Issued
Division 06 – Wood, Plastics, and Composites		
06 10 00 Rough Carpentry	7	April 17, 2024
06 40 00 Architectural Woodwork	9	April 17, 2024
06 61 16 Solid Surfacing Fabrications	6	April 17, 2024
06 90 00 General Installations	5	April 17, 2024
Division 07 - Thermal and Moisture Protection		
07 26 16 Underslab Vapour Retarder	4	April 17, 2024
07 81 16 Cementitious Fire Protection	7	April 17, 2024
07 84 00 Firestopping and Smoke Seals	13	April 17, 2024
07 92 00 Joint Sealants	14	April 17, 2024
Division 08 - Openings		
08 11 13 Hollow Metal Doors and Frames	11	April 17, 2024
08 14 23 Plastic Laminate Faced Wood Doors	6	April 17, 2024
08 31 13 Access Doors and Frames	6	April 17, 2024
08 42 43 Intensive Care Unit Entrances	6	April 17, 2024
08 41 13 Aluminum Framed Screens	3	June 12, 2024
08 51 13 Aluminum Windows	12	April 17, 2024
08 80 00 Glass and Glazing	10	June 12, 2024
08 87 33 Decorative Film	3	April 17, 2024
Division 09 – Finishes		
09 22 16 Non-Structural Metal Framing	11	April 17, 2024
09 29 00 Gypsum Board	11	April 17, 2024
09 51 13 Acoustical Panel Ceilings	9	April 17, 2024
09 65 16 Resilient Sheet Flooring	9	April 17, 2024
09 67 23 Resinous Epoxy Flooring	10	April 17, 2024
09 91 00 Painting	17	April 17, 2024
Division 10 – Specialties		
10 26 13 Corner Guards	3	April 17, 2024
10 26 23 Protective Wall Covering	6	April 17, 2024
10 26 26 Handrails	3	June 12, 2024
10 28 00 Washroom Accessories	5	April 17, 2024
10 51 29 Phenolic Lockers	4	April 17, 2024
Division 12 – Furnishings		
12 24 13 – Roller Window Shades	7	April 17, 2024

END OF THIS SECTION

PART 1 - GENERAL

1.1. GENERAL INSTRUCTIONS

1.1.1. Read and conform to:

- 1.1.1.1. CCDC 2 – 2020, Stipulated Price Contract as amended in the Contract Documents.
- 1.1.1.2. Division 01 requirements and documents referred to therein.

1.2. SUMMARY

1.2.1. Section Includes: Provide glazed screens including but not limited to following:

- 1.2.1.1. Aluminum frames
- 1.2.1.2. Sliding door SL1
- 1.2.1.3. Glass and glazing

1.2.2. Related Sections: Following description of work is included for reference only and shall not be presumed complete:

- 1.2.2.1. Sealants: Section 07 92 00

1.3. REFERENCES

1.3.1. Abbreviations and Acronyms:

- 1.3.1.1. AA: Aluminum Association; www.aluminum.org

1.3.2. Reference Standards:

- 1.3.2.1. ASTM B221M-21 - Standard Specification for Aluminum and Aluminum-Alloy Extruded Bars, Rods, Wire, Profiles, and Tubes
- 1.3.2.2. ASTM D2240-15(2021) - Standard Test Method for Rubber Property - Durometer Hardness

1.4. ADMINISTRATIVE REQUIREMENTS

1.4.1. Coordination:

- 1.4.1.1. Coordinate frame reinforcing, and cut outs required for hardware installation.
- 1.4.1.2. Obtain templates from hardware supplier. Provide frame reinforcing, drill holes, and provide cut-outs as required.

1.5. SUBMITTALS

1.5.1. Product Data:

- 1.5.1.1. Submit catalogue details for each type of door and frame illustrating profiles, dimensions and methods of assembly.
- 1.5.1.2. Submit manufacturer's printed product literature, specifications and data sheets
- 1.5.1.3. Submit two copies of WHMIS MSDS Material Safety Data Sheets. Indicate VOC's for caulking materials during application.

1.5.2. Shop drawings: indicate materials and profiles and provide full-size details of components for each type of door and frame. Indicate:

- 1.5.2.1. Interior trim and exterior junctions with adjacent construction.
- 1.5.2.2. Junctions between combination units.
- 1.5.2.3. Elevations of units.

- 1.5.2.4. Core thicknesses of components.
- 1.5.2.5. Type and location of exposed finishes, method of anchorage, number of anchors, supports, reinforcement, and accessories.
- 1.5.2.6. Location of caulking.
- 1.5.2.7. Each type of door system including location.
- 1.5.2.8. Arrangement of hardware and required clearances.
- 1.5.3. Samples:
 - 1.5.3.1. Submit duplicate 100 x 200 mm (4 x 8 inch) samples of aluminum finish.

1.6. CLOSEOUT SUBMITTALS

- 1.6.1. Provide maintenance data for cleaning and maintenance of aluminum finishes for incorporation into operations and maintenance manual specified.

1.7. DELIVERY, STORAGE AND HANDLING

- 1.7.1. Deliver frames wrapped to provide protection during transit and storage at project site.
- 1.7.2. Inspect frames upon delivery for damage.
 - 1.7.2.1. Replace frames that cannot be satisfactorily repaired.
- 1.7.3. Store Frames at project site under cover and as near as possible to final installation location. Do not use covering material that will cause discoloration of aluminum finish.

1.8. WARRANTY

- 1.8.1. Provide manufacturers warranty against defects in manufacture and installation to include cracking, flaking, chalking, non-uniformity in colour, opening up of joints, twisting or movement in the framing, and loose caps for a period of 7 years.

PART 2 - PRODUCTS

2.1. MANUFACTURER

- 2.1.1. Provide products manufactured by Partition Components Incorporated; www.pc350.com
- 2.1.2. Framing system: PC 350 Elite

2.2. MATERIALS

- 2.2.1. Aluminum extrusions: ASTM B221 6063 T5 anodizing quality. Framing wall thicknesses shall be 3.2 mm (0.125") for exposed section and 4.75 mm (0.187") on internal members.
- 2.2.2. Steel reinforcement: galvanized steel plate.
- 2.2.3. Fasteners: cadmium plated steel, finished to match adjacent material.
- 2.2.4. Isolation coating: alkali resistant.
- 2.2.5. Glass: 6 mm laminated clear glass
- 2.2.6. Glazing Materials
 - 2.2.6.1. All glazing materials, products, primers and cleaning solvents: Mutually compatible.
 - 2.2.6.2. Setting blocks: Neoprene 80-90 Shore A durometer hardness to ASTM D2240, minimum 100 mm x width of glazing rabbet space minus 1.5 mm x height.
 - 2.2.6.3. Spacer shims: Neoprene 50-60 Shore A durometer hardness to ASTM D2240, 75 mm long x one half height of glazing stop x thickness to suit application. Self adhesive on one face.

- 2.2.6.4. Glazing gaskets: Extruded neoprene or EPDM of approved profile. Tensile strength of 1500 psi; Durometer A hardness of 50 plus/minus 5; 25% maximum permanent set; 300% minimum elongation at break; and resistant to ozone, showing no cracks.

2.3. FABRICATION

- 2.3.1. Machine cut extrusions in shop for assembly on site. Corners to be butt joints, not mitered.
- 2.3.2. Provide corner reinforcement and alignment plates for tight fitting hairline joints when assembled.
- 2.3.3. Provide concealed structural steel reinforcement as required.
- 2.3.4. Fit joints tightly and secure mechanically.
- 2.3.5. Concealed fastenings.
- 2.3.6. Isolate aluminum from direct contact with dissimilar metals, concrete and masonry.
- 2.3.7. Sliding Door:
 - 2.3.7.1. Aluminum frame size: 89 mm (3 ½") wide bottom rail, 50 mm (2") side and top stiles x 44 mm (1 ¾") thick
 - 2.3.7.2. Surface mounted top rail. No floor track.
 - 2.3.7.3. Soft opening and closing
- 2.3.8. Finishes:
 - 2.3.8.1. Clear Anodized Finish: Ensure aluminum finish is clear anodized in accordance with Aluminum Association Finish Designation AA-M12-C22-A31, Class II, 0.4 to 0.7 mil thick.

PART 3 - EXECUTION

3.1. GENERAL

- 3.1.1. Compliance: comply with manufacturer's written data, including product technical bulletins, product catalogue installation instructions, product carton installation instructions, and data sheets.

3.2. INSTALLATION

- 3.2.1. Set frames plumb, square, level at correct elevation in alignment with adjacent work.
- 3.2.2. Anchor securely using concealed clips and fasteners provided by the manufacturer. No exposed fasteners permitted unless in locations where these are necessary and shown on the shop drawings and accepted.
- 3.2.3. Install sections full length of opening without joints or seems.
- 3.2.4. Adjust operable parts for correct function. Ensure joints are tightly butted and uniform hairline joints.
- 3.2.5. Make allowances for deflection of structure to ensure that structural loads are not transmitted to frames.
- 3.2.6. Install glass using dry gasket glazing system. Maintain 19 mm (3/4") air space between lites.

3.3. CLEANING

- 3.3.1. Perform cleaning of aluminum components in accordance with AAMA 609.1 - Voluntary Guide Specification for Cleaning and Maintenance of Architectural Anodized Aluminum.
- 3.3.2. Perform cleaning as soon as possible after installation to remove construction and accumulated environmental dirt.
- 3.3.3. Clean aluminum with damp rag and approved non-abrasive cleaner.
- 3.3.4. Remove traces of primer, caulking, epoxy and filler materials.

- 3.3.5. Clean glass and glazing materials with approved non-abrasive cleaner.
- 3.3.6. Upon completion of installation, remove surplus materials, rubbish, tools and equipment barriers.

END OF SECTION

PART 1 - GENERAL

1.1. GENERAL INSTRUCTIONS

1.1.1. Read and conform to:

- 1.1.1.1. Division 01 requirements and documents referred to therein.

1.2. SUMMARY

1.2.1. Section Includes:

- 1.2.1.1. Handrails (A99).

1.2.2. Related Sections: Following description of work is included for reference only and shall not be presumed complete:

- 1.2.2.1. Provision of corner guards: Section 10 26 13, Corner Guards.
- 1.2.2.2. Provision of vinyl wall protection covering: Section 10 26 23, Protective Wall Covering.

1.3. ADMINISTRATIVE REQUIREMENTS

1.3.1. Coordination:

- 1.3.1.1. Coordinate requirements for partition blocking and provide mounting locations to Section 09 22 16 before erection of stud framing.

1.3.2. Preinstallation Meeting:

- 1.3.2.1. Prior to start of work, arrange for site meeting of parties associated with work of this Section. Presided over by Contractor, Subcontractor, and manufacturer's representative.
- 1.3.2.2. Review work included under this Section and determine complete understanding of requirements and responsibilities relative to work included, storage and handling of materials to be used, installation, methods and procedures, quality control, Project staffing, restrictions on areas of work and other matters affecting construction, to permit compliance with intent of this Section.

1.4. SUBMITTALS

1.4.1. Submittals in accordance with Division 01 General Requirements.

1.4.2. Product Data:

- 1.4.2.1. Product data for each system component and installation accessory required
- 1.4.2.2. Installation methods for each type of substrate

1.4.3. Shop drawings:

- 1.4.3.1. Showing locations, extent and installation details
- 1.4.3.2. Show methods of attachment to adjoining construction

1.4.4. Samples:

- 1.4.4.1. If requested by Consultant submit samples of Products.
- 1.4.4.2. Submit samples for verification of color, finish and end cap attachment and alignment.
- 1.4.4.3. 12" (304.8mm) long sample of each model specified including end cap and mounting hardware

1.5. CLOSEOUT SUBMITTALS

- 1.5.1. Operational and Maintenance Data: Submit maintenance instructions in accordance with Section 01 70 00.

1.6. QUALITY ASSURANCE

- 1.6.1. Qualifications:

- 1.6.1.1. Manufacturers: Provide continuous handrailings, bumper railings and crash railing from 1 manufacturer.
- 1.6.1.2. Installer qualifications: Engage an installer who has no less than 3 years experience in installation of systems similar in complexity to those required for this project

1.7. DELIVERY, STORAGE, AND HANDLING

- 1.7.1. Deliver materials to the project site in unopened original factory packaging clearly labeled to show manufacturer and product.
- 1.7.2. Storage: Store wall protection products in original packaging. Protect from weather, extreme temperatures, and moisture.
- 1.7.2.1. Maintain temperature during storage between 4°- 38°C (40°- 100°F).
- 1.7.2.2. Store materials flat to prevent twisting or sagging of cartons.
- 1.7.3. Handling: Take adequate measure to prevent damage to materials. Avoid exposure of products to direct sunlight.

1.8. SITE CONDITIONS

- 1.8.1. Ambient Conditions: Do not install wall protection products until installation areas are enclosed and weatherproof. HVAC system must be operational and maintaining temperature at 18°-24°C (65°-75°F) for at least 72 hours prior to installation.

PART 2 - PRODUCTS

2.1. DESIGN AND PERFORMANCE CRITERIA

2.2. MATERIALS

- 2.2.1. Stainless Steel Components: type 304 stainless steel with #4 satin finish
- 2.2.2. Aluminum: Extruded aluminum should be 6063-T6 alloy, nominal 2.29 mm (0.090") thick retainer. Minimum strength and durability properties as specified in ASTM B221.
- 2.2.3. Molded Accessories: Injection molded thermoplastic.
- 2.2.4. Impact Cushion: Extruded thermoplastic, 70 durometer Shore A.
- 2.2.5. Fasteners: All necessary fasteners to be supplied by the manufacturer, appropriate for wall construction.

2.3. MANUFACTURERS

- 2.3.1. Manufacturer List: Products of following manufacturers are acceptable subject to conformance to requirements of Drawings, Schedules and Specifications:
- 2.3.1.1. Construction Specialties Ltd.; www.c-sgroup.com
- 2.3.1.2. IPC Door Wall Protection Systems; www.inprocorp.com
- 2.3.1.3. Koroseal Wall Protection Systems; www.korogard.com
- 2.3.1.4. Pawling Corporation; www.pawling.com

2.4. MANUFACTURED UNITS

2.4.1. Continuous Handrailing:

2.4.1.1. Surface mounted assembly consisting of stainless steel handrail, 133mm (5 ¼") high stainless steel rail assembly including stainless steel end caps and brackets.

2.4.1.2. Basis of Design: Model HRS-6C by Construction Specialties

2.4.2. Fabrication:

2.4.2.1. Verify dimensions on site before fabrication.

2.4.2.2. Accurately fit joints and intersecting members in true planes with adequate fastening.

2.4.2.3. Fit and assemble work of this Section in shop where possible. Where shop fabrication is not possible, execute trial assembly in shop.

2.4.2.4. Fabricate finished work free from distortion, weld splatter and defects detrimental to appearance and performance.

2.4.2.5. Provide exposed metal fastenings and accessories of the same material, texture, colour and finish as the base metal to which they are applied or fastened, unless otherwise specified.

2.4.2.6. Do not expose trademarks or labels on finished surfaces.

PART 3 - EXECUTION

3.1. EXAMINATION

3.1.1. Verification of Conditions: Verify actual site dimensions and location of adjacent materials prior to commencing work. Notify Consultant in writing of any conditions which would be detrimental to the installation.

3.1.2. Evaluation and Assessment: Commencement of work implies acceptance of previously completed work.

3.2. PREPARATION

3.2.1. Surface preparation: clean substrate to remove dirt, debris and loose particles. Perform additional preparation procedures as required by manufacturer's instructions.

3.3. INSTALLATION

3.3.1. Conform to manufacturer's printed instructions for accurate, secure installation. Ensure proper operation.

3.3.2. Installation Height Above Finished Floor: As directed by Consultant.

3.3.3. Provide work of this Section true to dimensions, square, plumb, level and free from distortion or defects detrimental to appearance and performance.

3.3.4. Provide necessary reinforcing including but not limited to steel stud backup and securely fasten components to suit design requirements. Ensure proper reinforcing has been provided as necessary.

3.4. PROTECTION

3.4.1. Cover finished surfaces and protect exposed corners and areas vulnerable to damage by persons or by movement of materials, tools or equipment.

END OF SECTION

SHN General Hospital Dialysis - FFE Bill of Quantity (BOQ)

2023-08-28 • Generated by Insight Health Tech Planning • Sorted by Plan ID Description (Ascending)



Plan ID	Plan ID Description	Edge	BOQ: Record Type	ASE	Total Qty	Unit Cost	Extended Price	IC/NIC	Status	Installed By
FLDIS-2	FLUSHER, DISINFECTOR UNDERCOUNTER	NO	Equipment Planning	YES	1	\$26,000.00	\$26,000.00	IN CONTRACT (IC)	NEW	CONTRACTOR
HORCO-1	HORIZONTAL CONSOLE, MEDICAL SERVICE UNIT, RECESSED	NO	Equipment Planning	YES	19	\$4,000.00	\$76,000.00	IN CONTRACT (IC)	NEW	CONTRACTOR
CHS-3	CHAIR, STACKING, BARIATRIC, W/ARMS	NO	Furniture Planning	NO	2	\$1,100.00	\$2,200.00	IN CONTRACT (IC)	NEW	VENDOR (POI)
CHS-2	CHAIR, STACKING, W/ARMS	NO	Furniture Planning	NO	18	\$480.00	\$8,640.00	IN CONTRACT (IC)	NEW	VENDOR (POI)
CHR-2	CHAIR, TASK	NO	Furniture Planning	NO	3	\$720.00	\$2,160.00	IN CONTRACT (IC)	NEW	VENDOR (POI)
CPUH-1	CPU HOLDER	NO	Furniture Planning	NO	4	\$170.00	\$680.00	IN CONTRACT (IC)	NEW	VENDOR (POI)
DSM-1	DESK, MODEST, 36X24-IN	NO	Furniture Planning	NO	1	\$650.00	\$650.00	IN CONTRACT (IC)	NEW	VENDOR (POI)
DSM-2	DESK, MODEST, 60X24-IN	NO	Furniture Planning	NO	4	\$710.00	\$2,840.00	IN CONTRACT (IC)	NEW	VENDOR (POI)
KEYTR-1	KEYBOARD TRAY	NO	Furniture Planning	NO	5	\$250.00	\$1,250.00	IN CONTRACT (IC)	NEW	VENDOR (POI)
PED-1	PEDESTAL, BOX/BOX/FILE, MOBILE	NO	Furniture Planning	NO	4	\$380.00	\$1,520.00	IN CONTRACT (IC)	NEW	VENDOR (POI)
TLC-2	TABLE, LOUNGE, 18X18-IN	NO	Furniture Planning	NO	2	\$500.00	\$1,000.00	IN CONTRACT (IC)	NEW	VENDOR (POI)
BAWI-1	BASKET, WIRE, WALL MOUNTED, 18WX6DX8H-IN	NO	Equipment Planning	YES	2	\$145.00	\$290.00	NOT IN CONTRACT (NIC)	NEW	CONTRACTOR
CWM-1	BRACKET, FOR COMPUTER WORKSTATION, WALL, 1-SCREEN	NO	Equipment Planning	YES	1	\$760.00	\$760.00	NOT IN CONTRACT (NIC)	NEW	CONTRACTOR
TVBR-3	BRACKET, TV, ARTICULATING FOR 32-80-IN	NO	Equipment Planning	YES	1	\$150.00	\$150.00	NOT IN CONTRACT (NIC)	NEW	CONTRACTOR
PPEW-3	DISPENSER, PPE, WALL MOUNT	NO	Equipment Planning	YES	16	\$335.00	\$5,360.00	NOT IN CONTRACT (NIC)	NEW	CONTRACTOR
GLBX-1	GLOVE BOX HOLDER, TRIPLE	NO	Equipment Planning	YES	10	\$50.00	\$500.00	NOT IN CONTRACT (NIC)	NEW	CONTRACTOR
ICDIS-1	ICE/WATER DISPENSER, 50-LB STORAGE, COUNTER	NO	Equipment Planning	YES	2	\$11,300.00	\$22,600.00	NOT IN CONTRACT (NIC)	NEW	CONTRACTOR
RACKM-1	RACK, MOP, WALL MOUNTED	NO	Equipment Planning	YES	1	\$160.00	\$160.00	NOT IN CONTRACT (NIC)	NEW	CONTRACTOR
DSWA-1	RECEPTACLE, DISPOSAL, SHARPS, W/ WALL MOUNT	NO	Equipment Planning	YES	2	\$70.00	\$140.00	NOT IN CONTRACT (NIC)	NEW	CONTRACTOR
RAWH-1	SHELF, WIRE, WALL, 48X16-IN, 2-TIER	NO	Equipment Planning	YES	2	\$2,500.00	\$5,000.00	NOT IN CONTRACT (NIC)	NEW	CONTRACTOR
RECN-1	RECEPTACLE, SANITARY NAPKIN	NO	Furniture Planning	NO	6	\$110.00	\$660.00	NOT IN CONTRACT (NIC)	NEW	CONTRACTOR
ALRE-1	ALARM, REMOTE, FRIDGE/FREEZER	NO	Equipment Planning	YES	1	\$1,602.00	\$1,602.00	NOT IN CONTRACT (NIC)	NEW	OWNER
BIOBU-1	ALLOWANCE, TOOLS, BIOMED	NO	Equipment Planning	NO	1	\$50,000.00	\$50,000.00	NOT IN CONTRACT (NIC)	NEW	OWNER
BINS-1	BIN, SHREDDING, SECURE	NO	Equipment Planning	NO	2	\$450.00	\$900.00	NOT IN CONTRACT (NIC)	NEW	OWNER
MOPO-9	BLOOD PRESSURE MONITOR, AUTOMATED, MULTI-USER	NO	Equipment Planning	NO	2	\$5,100.00	\$10,200.00	NOT IN CONTRACT (NIC)	NEW	OWNER
CBST-1	CABINET, BIN STORAGE, 36WX18DX84H	NO	Equipment Planning	NO	1	\$1,250.00	\$1,250.00	NOT IN CONTRACT (NIC)	NEW	OWNER
CHSKP-4	CART, HOUSEKEEPING	NO	Equipment Planning	NO	1	\$550.00	\$550.00	NOT IN CONTRACT (NIC)	NEW	OWNER
CWIR-1	CART, LINEN, 60X24X80-IN, ENCLOSED	NO	Equipment Planning	NO	3	\$610.00	\$1,830.00	NOT IN CONTRACT (NIC)	NEW	OWNER
CPRO-5	CART, PROCEDURE, 14X19X27-IN	NO	Equipment Planning	NO	2	\$860.00	\$1,720.00	NOT IN CONTRACT (NIC)	NEW	OWNER
CRSUS-1	CART, RESUSCITATION, 27WX20DX40.50-IN	NO	Equipment Planning	NO	1	\$1,940.00	\$1,940.00	NOT IN CONTRACT (NIC)	NEW	OWNER
CSOL-1	CART, SOILED LINEN & WASTE TRANSPORT, 43WX31DX33H	NO	Equipment Planning	NO	2	\$510.00	\$1,020.00	NOT IN CONTRACT (NIC)	NEW	OWNER
CAUT-1	CART, SS, UTILITY, 3 SHELF, 24WX15DX32.75H-IN	NO	Equipment Planning	NO	2	\$450.00	\$900.00	NOT IN CONTRACT (NIC)	NEW	OWNER
CSUPS-2	CART, SUPPLY, SMALL, 36WX18DX36H	NO	Equipment Planning	NO	8	\$2,350.00	\$18,800.00	NOT IN CONTRACT (NIC)	NEW	OWNER
TOCA-1	CART, TOOL, 27WX18DX40H-IN	NO	Equipment Planning	NO	1	\$1,280.00	\$1,280.00	NOT IN CONTRACT (NIC)	NEW	OWNER
CWIR-2	CART, WIRE, OPEN, 60WX24DX80H-IN	NO	Equipment Planning	NO	9	\$610.00	\$5,490.00	NOT IN CONTRACT (NIC)	NEW	OWNER
CWIR-4	CART, WIRE, OPEN, 72WX24DX80H-IN	NO	Equipment Planning	NO	5	\$940.00	\$4,700.00	NOT IN CONTRACT (NIC)	NEW	OWNER

CHRC-1	CHAIR, RECLINER	NO	Equipment Planning	NO	17	\$3,500.00	\$59,500.00	NOT IN CONTRACT (NIC)	NEW	OWNER
DFMN-2	DEFIBRILLATOR / MONITOR	NO	Equipment Planning	NO	1	\$18,900.00	\$18,900.00	NOT IN CONTRACT (NIC)	NEW	OWNER
DIAMA-1	DIALYSIS MACHINE	NO	Equipment Planning	YES	23	\$44,000.00	\$1,012,000.00	NOT IN CONTRACT (NIC)	NEW	OWNER
CHDIS-1	DISPENSER, CHEMICAL	NO	Equipment Planning	YES	1	\$850.00	\$850.00	NOT IN CONTRACT (NIC)	NEW	OWNER
DIP-2	DISPENSER, INFECTION PREVENTION, WALL	NO	Equipment Planning	YES	1	\$130.00	\$130.00	NOT IN CONTRACT (NIC)	NEW	OWNER
MDIS-7	DISPENSER, MEDICATION, AUTO, 6-DRAWER MAIN	NO	Equipment Planning	YES	1	\$122,640.00	\$122,640.00	NOT IN CONTRACT (NIC)	NEW	OWNER
DOL-1	DOLLY, HAND TRUCK, CONVERTIBLE, 800-LBS	NO	Equipment Planning	NO	3	\$560.00	\$1,680.00	NOT IN CONTRACT (NIC)	NEW	OWNER
DOL-2	DOLLY, RECEPTACLES, 20-55-GAL	NO	Equipment Planning	NO	15	\$61.00	\$915.00	NOT IN CONTRACT (NIC)	NEW	OWNER
REG-FLO-3	FLOWMETER, OXYGEN	NO	Equipment Planning	NO	19	\$45.00	\$855.00	NOT IN CONTRACT (NIC)	NEW	OWNER
METFL-1	FLOWMETER, RENAL, TRANSONIC	NO	Equipment Planning	NO	1	\$39,750.00	\$39,750.00	NOT IN CONTRACT (NIC)	NEW	OWNER
GLUM-1	GLUCOMETER	NO	Equipment Planning	NO	2	\$250.00	\$500.00	NOT IN CONTRACT (NIC)	NEW	OWNER
HALN-1	HAMPER, LINEN W/O LID	NO	Equipment Planning	NO	24	\$130.00	\$3,120.00	NOT IN CONTRACT (NIC)	NEW	OWNER
USVAS-3	IMAGING, ULTRASOUND SYSTEM VASCULAR SURGICAL	NO	Equipment Planning	NO	2	\$34,500.00	\$69,000.00	NOT IN CONTRACT (NIC)	NEW	OWNER
PLIFT-1	LIFT, PATIENT, MOBILE W/ SCALE	NO	Equipment Planning	NO	1	\$6,200.00	\$6,200.00	NOT IN CONTRACT (NIC)	NEW	OWNER
MDISR-1	MEDICATION REFRIGERATOR LOCK, W/ REMOTE TEMPERATURE MONITOR	NO	Equipment Planning	NO	1	\$11,760.00	\$11,760.00	NOT IN CONTRACT (NIC)	NEW	OWNER
RXRET-1	PHARMACY RETURN BIN, LARGE, PYXIS	NO	Equipment Planning	YES	2	\$0.00	\$0.00	NOT IN CONTRACT (NIC)	NEW	OWNER
IVIP-1	PUMP, INFUSION, IV	NO	Equipment Planning	NO	8	\$4,500.00	\$36,000.00	NOT IN CONTRACT (NIC)	NEW	OWNER
RACKE-1	RACK, STORAGE, MULTI-TANK, E SIZE	NO	Equipment Planning	NO	3	\$180.00	\$540.00	NOT IN CONTRACT (NIC)	NEW	OWNER
RACKE-2	RACK, STORAGE, MULTI-TANK, E SIZE, MOBILE	NO	Equipment Planning	NO	1	\$320.00	\$320.00	NOT IN CONTRACT (NIC)	NEW	OWNER
REC-10	RECEPTACLE, BIOHAZARD, WASTE, FLOOR, 14-GAL	NO	Equipment Planning	NO	1	\$140.00	\$140.00	NOT IN CONTRACT (NIC)	NEW	OWNER
REC-14	RECEPTACLE, BIOHAZARD WASTE, YELLOW, 32 GALLON	NO	Equipment Planning	NO	12	\$48.00	\$576.00	NOT IN CONTRACT (NIC)	NEW	OWNER
DSFL-1	RECEPTACLE, DISPOSAL, SHARPS, MOBILE	NO	Equipment Planning	NO	16	\$150.00	\$2,400.00	NOT IN CONTRACT (NIC)	NEW	OWNER
RECW-4	RECEPTACLE, WASTE, PLASTIC, OPEN TOP, 32-GAL	NO	Equipment Planning	NO	6	\$220.00	\$1,320.00	NOT IN CONTRACT (NIC)	NEW	OWNER
RECW-9	RECEPTACLE, WASTE, PLASTIC, STEP-ON, W/ LID, 23-GAL	NO	Equipment Planning	NO	22	\$313.00	\$6,886.00	NOT IN CONTRACT (NIC)	NEW	OWNER
RFPH-7	REFRIGERATOR, PHARMACY, FULL HEIGHT, 1-DOOR, 13.3 CU FT	NO	Equipment Planning	YES	2	\$6,995.00	\$13,990.00	NOT IN CONTRACT (NIC)	NEW	OWNER
REG-FLO-5	REGULATOR, SUCTION, ADULT, INTERMITTENT/CONTINUOUS	NO	Equipment Planning	NO	12	\$580.00	\$6,960.00	NOT IN CONTRACT (NIC)	NEW	OWNER
SCL-3	SCALE, CLINICAL WHEELCHAIR	NO	Equipment Planning	YES	2	\$2,900.00	\$5,800.00	NOT IN CONTRACT (NIC)	NEW	OWNER
IVS-1	STAND, IV	NO	Equipment Planning	NO	8	\$600.00	\$4,800.00	NOT IN CONTRACT (NIC)	NEW	OWNER
STEX-1	STOOL, EXAM/WORK	NO	Equipment Planning	NO	18	\$450.00	\$8,100.00	NOT IN CONTRACT (NIC)	NEW	OWNER
SHSO-2	STORAGE, SHELVING, 4-TIER, 48WX24DX85H-IN	NO	Equipment Planning	NO	1	\$650.00	\$650.00	NOT IN CONTRACT (NIC)	NEW	OWNER
STRET-1	STRETCHER, ADULT	NO	Equipment Planning	NO	1	\$6,510.00	\$6,510.00	NOT IN CONTRACT (NIC)	NEW	OWNER
STRET-4	STRETCHER, EYE CHAIR ADULT	NO	Equipment Planning	NO	4	\$12,000.00	\$48,000.00	NOT IN CONTRACT (NIC)	NEW	OWNER
SUCP-1	SUCTION PUMP, PORTABLE	NO	Equipment Planning	NO	1	\$1,120.00	\$1,120.00	NOT IN CONTRACT (NIC)	NEW	OWNER
SDIS-3	SUPPLY DISPENSING SYSTEM SINGLE COLUMN	NO	Equipment Planning	NO	1	\$49,500.00	\$49,500.00	NOT IN CONTRACT (NIC)	NEW	OWNER
TOB-1	TABLE, OVERBED	NO	Equipment Planning	NO	19	\$350.00	\$6,650.00	NOT IN CONTRACT (NIC)	NEW	OWNER
TAIN-9	TABLE, STAINLESS STEEL, WITH SHELF, 30WX24D	NO	Equipment Planning	NO	2	\$250.00	\$500.00	NOT IN CONTRACT (NIC)	NEW	OWNER
TOX-1	TANK, OXYGEN, SIZE E	NO	Equipment Planning	NO	9	\$0.00	\$0.00	NOT IN CONTRACT (NIC)	NEW	OWNER
TV49-1	TELEVISION, LED, 49 INCH, 4K	NO	Equipment Planning	YES	1	\$1,050.00	\$1,050.00	NOT IN CONTRACT (NIC)	NEW	OWNER
THW-1	THERMOMETER, ELECTRONIC	NO	Equipment Planning	NO	2	\$610.00	\$1,220.00	NOT IN CONTRACT (NIC)	NEW	OWNER
TBH-1	TOTE, BIOHAZARD, SUPPLIED BY THIRD PARTY	NO	Equipment Planning	NO	6	\$0.00	\$0.00	NOT IN CONTRACT (NIC)	NEW	OWNER
WAROP-3	WATER SYSTEM, REVERSE OSMOSIS, PORTABLE	NO	Equipment Planning	YES	3	\$8,400.00	\$25,200.00	NOT IN CONTRACT (NIC)	NEW	OWNER
WCAD-8	WHEELCHAIR, ADULT, FOLDING	NO	Equipment Planning	NO	2	\$1,400.00	\$2,800.00	NOT IN CONTRACT (NIC)	NEW	OWNER

WBML-1	WORKBENCH W/ TASK LIGHT, 2-TIER, 72WX30D-IN	NO	Equipment Planning	NO	1	\$1,650.00	\$1,650.00	NOT IN CONTRACT (NIC)	NEW	OWNER
PPS-1	PRIVACY SCREEN, MOBILE FOLDING ON TROLLEY	NO	Furniture Planning	NO	2	\$3,215.00	\$6,430.00	NOT IN CONTRACT (NIC)	NEW	OWNER
REC-8	RECEPTACLE, RECYCLE, 7-GAL	NO	Furniture Planning	NO	4	\$90.00	\$360.00	NOT IN CONTRACT (NIC)	NEW	OWNER
REC-1	RECEPTACLE, WASTE, 7-GAL	NO	Furniture Planning	NO	9	\$50.00	\$450.00	NOT IN CONTRACT (NIC)	NEW	OWNER
BCP-1	BARCODE PRINTER, PATIENT WRISTBANDS	YES	Equipment Planning	NO	2	\$1,100.00	\$2,200.00	NOT IN CONTRACT (NIC)	NEW	OWNER
BCS-1	BARCODE SCANNER	YES	Equipment Planning	NO	1	\$250.00	\$250.00	NOT IN CONTRACT (NIC)	NEW	OWNER
COMP-1	COMPUTER, DESKTOP, SINGLE MONITOR	YES	Equipment Planning	NO	5	\$2,000.00	\$10,000.00	NOT IN CONTRACT (NIC)	NEW	OWNER
KIOR-3	KIOSK, CHECK-IN, FLOOR	YES	Equipment Planning	YES	1	\$39,000.00	\$39,000.00	NOT IN CONTRACT (NIC)	NEW	OWNER
TELP-1	PHONE, MULTI-LINE	YES	Equipment Planning	YES	4	\$220.00	\$880.00	NOT IN CONTRACT (NIC)	NEW	OWNER
PRMU-3	PRINT/COPY/FAX, MULTIFUNCTION, FLOOR	YES	Equipment Planning	YES	2	\$2,500.00	\$5,000.00	NOT IN CONTRACT (NIC)	NEW	OWNER
PRL-1	PRINTER, LABEL, 2-IN RIBBON, INDUSTRIAL, TABLE-TOP	YES	Equipment Planning	YES	1	\$2,450.00	\$2,450.00	NOT IN CONTRACT (NIC)	NEW	OWNER
PRSP-1	PRINTER, THERMAL, BARCODE SPECIMAN LABEL	YES	Equipment Planning	NO	2	\$2,000.00	\$4,000.00	NOT IN CONTRACT (NIC)	NEW	OWNER
SCN-1	SCANNER	YES	Equipment Planning	NO	2	\$350.00	\$700.00	NOT IN CONTRACT (NIC)	NEW	OWNER
WOW-1	WORKSTATION ON WHEELS (WOW)	YES	Equipment Planning	NO	7	\$9,600.00	\$67,200.00	NOT IN CONTRACT (NIC)	NEW	OWNER
Total							\$1,980,144.00			