


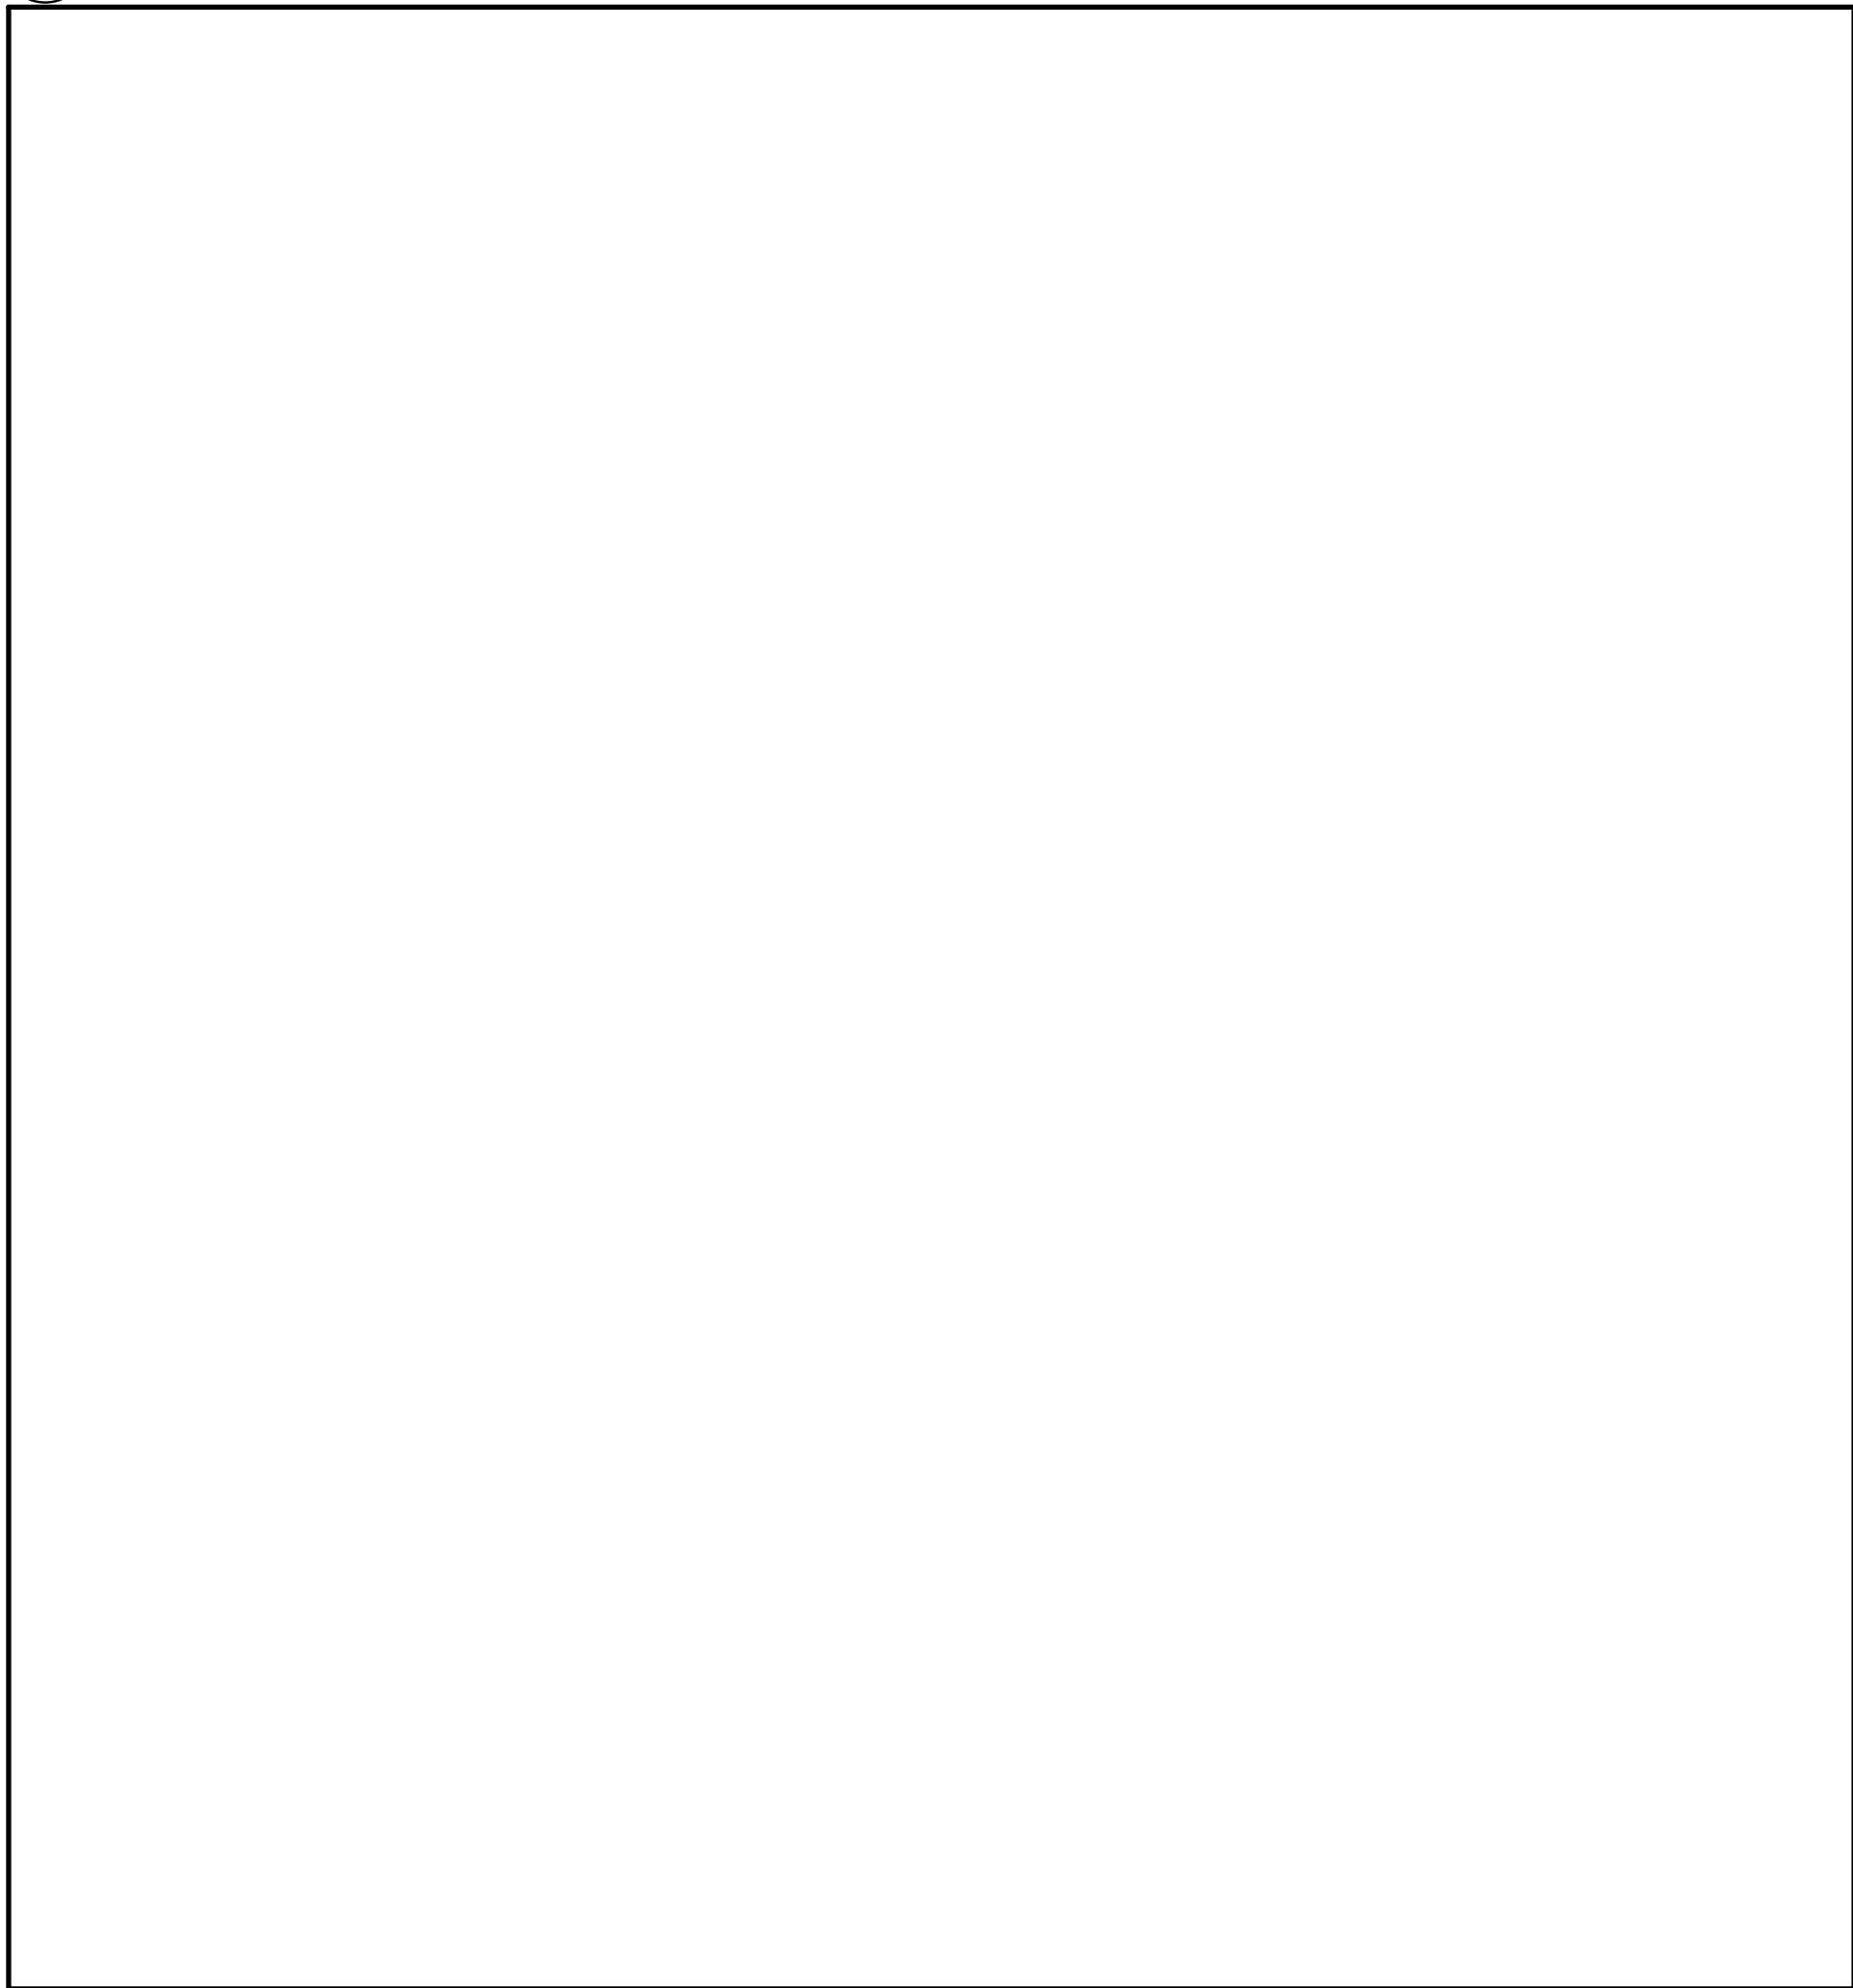


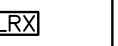

































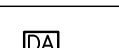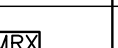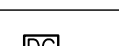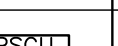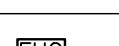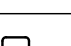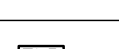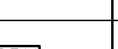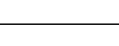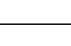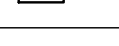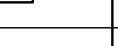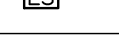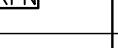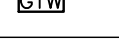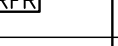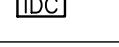







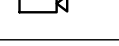
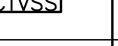

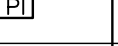






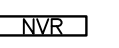
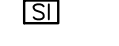


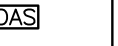


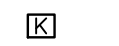
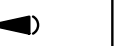


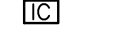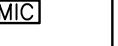5 KEY PLAN
TSE-0.1 SCALE 1:400

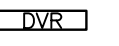

SYMBOL	DESCRIPTION	SYMBOL	DESCRIPTION
ACCESS CONTROL			
	ACCESS CONTROL SYSTEM PANEL		KEY SWITCH
	ACCESS CONTROL SYSTEM SERVER		LATCH BOLT MONITOR
	AUTOMATIC DOOR OPERATOR		LATCH BOLT MONITOR REQUEST TO EXIT
	BIOMETRIC READER		MAGLOCK KEY RESET SWITCH
	CARD READER		MAGNETIC DOOR HOLD/OPEN DEVICE
	CENTRAL MANAGEMENT STATION		MAGNETIC LOCK
	DOOR ALARM		MOTION REQUEST TO EXIT
	DOOR CONTACT		POWER SUPPLY CONTROL UNIT
	ELECTRIC DOOR HOLD/OPEN DEVICE		PUSH BUTTON DOOR OPERATOR
	ELECTRIC LATCH RETRACTION		PUSH BUTTON REQUEST TO EXIT
	ELECTRIC MORTISE LOCK		REMOTE RELEASE
	ELECTRIC STRIKE		RF NODE
	GATEWAY		RF RECEIVER
	IP DOOR CONTROLLER		SECURITY DOOR TAG. XX DENOTES TYPE
	KEY ENCODER		WIRELESS LOCK
REAL TIME LOCATING SYSTEM (RTLs)			
	LOW FREQUENCY EXCITER		RF READER MASTER
	INFRARED READER		RF READER
	REMOTE DISPLAY UNIT		RF ETHERNET READER
	LOCAL AREA RECEIVER		RF LONG RANGE READER
NOTE: NOT ALL SYMBOLS APPLY, REFER TO FLOOR PLANS AND DRAWINGS			

3 SECURITY LEGEND 1 OF 2
TSE-0.1

SYMBOL	DESCRIPTION	SYMBOL	DESCRIPTION
ELECTRONIC PERSONAL PROTECTION			
	EMERGENCY PHONE STATION		DURESS ALARM STATION
	STROBE LIGHT		PANIC ALARM RECEIVER
	PANIC BUTTON		ASSISTANCE REQUIRED SIGN
INTERCOM LEGEND			
	INTERCOM		MASTER INTERCOM
	ENTRY PHONE CONSOLE		
CCTV			
	FIXED CAMERA		CCTV SYSTEM SERVER
	PAN-TILT-ZOOM CAMERA		POWER INJECTOR
	PERSONAL COMPUTER		VIDEO MONITOR
	COMPUTER MONITOR		FIXED CCTV CAMERA HORIZONTAL ANGLE OF VIEW
	DIGITAL VIDEO RECORDER		LCD MONITOR, SIZE AS INDICATED
	NETWORK VIDEO RECORDER		
INTRUSION DETECTION			
	SIREN		INTRUSION DETECTION SYSTEM PANEL
	BREAK GLASS SENSOR		POWER SUPPLY
	MOISTURE SENSOR		WALL MOUNTED SECURITY MOTION SENSOR
	KEYPAD		CEILING MOUNTED SECURITY 360° MOTION SENSOR
NOTE: NOT ALL SYMBOLS APPLY, REFER TO FLOOR PLANS AND DRAWINGS			

4 SECURITY LEGEND 2 OF 2
TSE-0.1

SECURITY DRAWING LIST	
Sheet Number	Sheet Title
TSE-0.1	DRAWING LIST, ABBREVIATIONS AND LEGENDS
TSE-0.2	SECURITY RISER DIAGRAM
TSE-0.3	SECURITY DETAILS 1
TSE-0.4	SECURITY DETAILS 2
TSE-1.0	GROUND FLOOR - SECURITY LAYOUT

1 SECURITY DRAWING LIST
TSE-0.1

ABBREVIATIONS	
E	EXISTING TO REMAIN
ER	EXISTING TO BE REMOVED
R	EXISTING TO BE RELOCATED
WP	EXTERIOR/WEATHERPROOF
JB	JUNCTION BOX
AFF	ABOVE FINISHED FLOOR
TYP	TYPICAL - TO BE INTERPRETED AS EXACTLY THE SAME AS COMPARABLE FEATURES.
V	VOLTS
KW	KILOWATTS
X	EXPLOSION PROOF DEVICE
WM XXX AFF	WALL MOUNTED AT XXXXmm AFF. XXXX INDICATES SPECIFIC HEIGHT
CM	CEILING MOUNT
CNR XXX AFF	CORNER MOUNT AT XXXXmm AFF. XXXX INDICATES SPECIFIC HEIGHT
PM XXX AFF	PENDANT MOUNT AT XXXXmm AFF. XXXX INDICATES SPECIFIC HEIGHT
PTM XXX AFF	PARAPET MOUNT AT XXXXmm AFF. XXXX INDICATES SPECIFIC HEIGHT
TYPE-XX	DEVICE TYPE. XX INDICATES SPECIFIC TYPE. REFER TO RELATIVE SPECIFICATIONS AND OR SCHEDULES FOR ADDITIONAL DETAILS
FUNC.-XX	FUNCTION TYPE. XX INDICATES SPECIFIC FUNCTION DESCRIPTION. REFER TO RELATIVE SPECIFICATIONS AND OR SCHEDULES FOR ADDITIONAL DETAILS
NOTE: NOT ALL SYMBOLS APPLY. CONTRACTOR TO REFER TO FLOOR PLANS.	

2 SECURITY ABBREVIATIONS
TSE-0.1

G.Bruce Stratton Architects

217 Richmond Street West, Suite 300
Toronto Ontario M5V 1W2
telephone: 416.351.8145




SUBMISSION	DATE	DESCRIPTION
1	2020-10-14	ISSUED FOR 60% REVIEW
2	2021-07-06	ISSUED FOR 90% REVIEW
3	2023-11-16	ISSUED FOR REVIEW
4	2023-11-17	ISSUED FOR TENDER
5	2024-03-15	ISSUED FOR CONSTRUCTION

PROJECT CONTACT

NAME: SAL RAMO
TEL: 647-406-8585
EMAIL: salwan.ramo@smithandandersen.com

THIS DRAWING SHALL BE READ IN CONJUNCTION WITH COMMUNICATIONS SPECIFICATION SUBMITTED FOR THIS PROJECT.

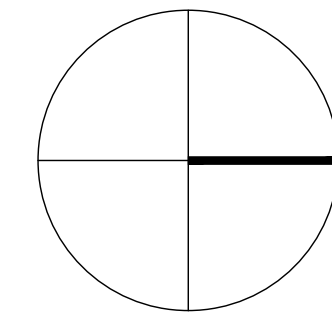

Smith + Andersen

1100 - 100 Sheppard Ave. East, Toronto On, M2N 6N5
416 487 8151 T 416 487 8104 smithandandersen.com

DEPARTMENT: BUILDING & FACILITIES

FLOOR: GROUND

BASE DATE: JULY 2020

PROJECT:

PROJECT # 14008.012

YORK REGION

Administrative Centre
17250 Yonge Street
Newmarket, Ontario

SCALE: AS SHOWN

DRAWN BY: SR


SUBMITTED TO: MUNICIPALITYOF YORK

SHEET TITLE:

DRAWING LIST,
ABBREVIATIONS AND
LEGENDS

SHEET NUMBER:

TSE-0.1

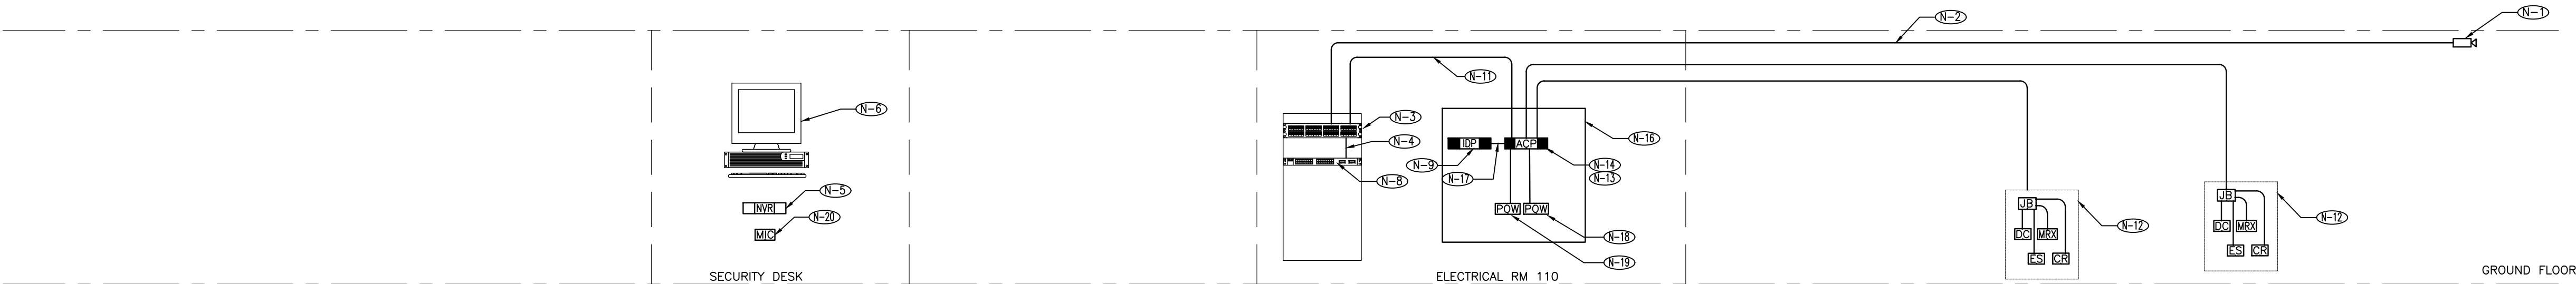

GENERAL NOTES:

1. THIS DRAWING SHALL BE READ IN CONJUNCTION WITH THE PROJECT RELATED DOOR HARDWARE SCHEDULE AS WELL AS THE PROJECT RELATED ARCHITECTURAL ELECTRICAL AND MECHANICAL DRAWINGS.
2. ALL ITEMS SHOWN ARE BY THE SECURITY CONTRACTOR UNLESS OTHERWISE NOTED. ALL PROVIDE ALL ITEM SHOWN UNLESS UNLESS OTHERWISE NOTED.
3. LOCATIONS OF DEVICES SHOWN ARE APPROXIMATE. COORDINATE THE EXACT LOCATION OF EACH DEVICE ON SITE WITH OTHER TRADES.
4. COORDINATE THE INSTALLATION AND INTERFACING WITH ALL ELECTRIFIED LOCKS AND DOOR CONTACTS WITH THE DOOR HARDWARE CONTRACTOR.
5. COORDINATE THE INSTALLATION AND INTERFACING WITH ALL POWER CIRCUITS WITH THE ELECTRICAL CONTRACTOR.
6. COORDINATE EXACT MOUNTING HEIGHTS AND LOCATIONS OF CCTV CAMERAS ON SITE WITH ELECTRICAL CONTRACTOR. PROVIDE ALL MOUNTING BRACKETS TO ENSURE THAT ALL OBSTRUCTIONS ARE AVOIDED AND CLEAR VIEW OF TARGET AREAS IS ATTAINED.
7. ALL CABLES SHALL BE HOME RUN IN CONDUITS. CABLE SPLICES SHALL NOT BE ACCEPTABLE. WHERE CABLES ARE GROUPED AND INSTALLED IN A SINGLE CONDUIT THE CONDUIT SHALL BE SIZED TO MAXIMUM 40% FILL.

DRAWING NOTES:

- (N-1) TYPICAL CCTV CAMERA. REFER TO FLOOR PLANS FOR QUANTITY AND LOCATIONS.
- (N-2) CATEGORY 6A DATA CABLE IN 21MM CONDUIT. CABLE BY COMMUNICATIONS CONTRACTOR CONDUIT BY ELECTRICAL CONTRACTOR (TYP).
- (N-3) PATCH PANEL BY COMMUNICATIONS CONTRACTOR.
- (N-4) CATEGORY 6A PATCH CABLES BY COMMUNICATIONS CONTRACTOR.
- (N-5) ACCESS TO EXISTING NETWORK VIDEO RECORDER IN SECURITY OFFICE.
- (N-6) PROVIDE VIDEO MANAGEMENT SOFTWARE AND LICENSES AND INSTALL ON OWNER PROVIDED COMPUTER THAT IS CONNECTED TO CORPORATE NETWORK TO FACILITATE MANAGEMENT AND VIEWING OF VIDEO STREAMS FROM INSTALLED CCTV CAMERAS.
- (N-7) PROVIDE POWER OVER ETHERNET INJECTORS TO FACILITATE POWERING OF CCTV CAMERAS IF REQUIRED.
- (N-8) ETHERNET SWITCH BY COMMUNICATIONS CONTRACTOR.
- (N-9) INTRUSION DETECTION SYSTEM PANEL.
- (N-10) CATEGORY 6 DATA CABLE IN 21MM CONDUIT. CABLE BY COMMUNICATIONS CONTRACTOR CONDUIT BY ELECTRICAL CONTRACTOR. PROVIDE ALL HARDWARE, WIRING AND CONFIGURATIONS TO FACILITATE REMOTE RELEASE OF MAIN ENTRY DOOR FROM MASTER INTERCOM STATIONS.
- (N-11) CATEGORY 6 CABLE FROM ACCESS CONTROL PANEL TO PATCH PANEL.
- (N-12) ACCESS CONTROL SYSTEM DEVICE WIRING IN 27MM CONDUIT. WIRING BY SECURITY CONTRACTOR CONDUIT BY ELECTRICAL CONTRACTOR.
- (N-13) ACCESS CONTROL SYSTEM PANEL. QUANTITY OF ACCESS CONTROL SYSTEM PANEL SHOWN REPRESENTS GENERAL CONNECTIVITY REQUIREMENTS ONLY. PROVIDE ACCESS CONTROL PANELS AND CONTROLLERS AS REQUIRED FOR COMPLETE OPERATION OF ALL ACCESS CONTROL SYSTEM DEVICES AND AS SPECIFIED IN SPECIFICATIONS (TYP).
- (N-14) ACCESS CONTROL PANEL.
- (N-15) EXISTING 1219mm W x 2438 H x 19mm D FIRE RETARDANT PLYWOOD BACKBOARD.
- (N-16) CONTACT ELECTRONIC SECURITY VENDORS OF RECORD, OBTAIN AND INCLUDE ALL COST FOR ALL WIRING IN CONDUIT, ALL HARDWARE, SOFTWARE LICENSES AND CONFIGURATION AS REQUIRED AND INTEGRATE ALL NEW ACCESS CONTROL SYSTEM DEVICES INCLUDING ALL NEW PANELS AND CONTROLLERS WITH THE EXISTING ACCESS CONTROL SYSTEM.
- (N-17) PROVIDE ALL HARDWARE AND WIRING BETWEEN ACCESS CONTROL AND INTRUSION DETECTION SYSTEMS TO RELAY ALL ALARMS FROM ACCESS CONTROL TO INTRUSION DETECTION SYSTEM.
- (N-18) EXISTING ACCESS CONTROL CONTROLLER AND ELECTRIC STRIKE POWER SUPPLY.
- (N-19) EXISTING MAGLOCK POWER SUPPLY.
- (N-20) EXISTING INTERCOM STATION.

G.Bruce Stratton Architects

217 Richmond Street West, Suite 300
Toronto Ontario M5V 1W2
telephone: 416.351.8145




SUBMISSION	DATE	DESCRIPTION
1	2020-10-14	ISSUED FOR 60% REVIEW
2	2021-07-06	ISSUED FOR 90% REVIEW
3	2023-11-16	ISSUED FOR REVIEW
4	2023-11-17	ISSUED FOR TENDER
5	2024-03-15	ISSUED FOR CONSTRUCTION

PROJECT CONTACT

NAME: SAL RAMO
TEL: 647-406-8585
EMAIL: salwan.ramo@smithandandersen.com

THIS DRAWING SHALL BE READ IN CONJUNCTION WITH COMMUNICATIONS SPECIFICATION SUBMITTED FOR THIS PROJECT.

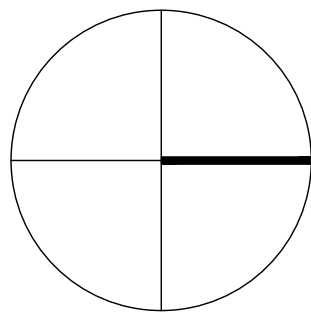

Smith + Andersen

1100 - 100 Sheppard Ave. East, Toronto On, M2N 6N5
416 487 8151 F 416 487 9104 smithandandersen.com

DEPARTMENT: BUILDING & FACILITIES

FLOOR: GROUND

BASE DATE: JULY 2020

PROJECT:

PROJECT # 14008.012

YORK REGION

Administrative Centre
17250 Yonge Street
Newmarket, Ontario

SCALE: N.T.S.

DRAWN BY: SR


SUBMITTED TO: MUNICIPALITY OF YORK

SHEET TITLE:


SECURITY RISER
DIAGRAM

SHEET NUMBER:


TSE-0.2

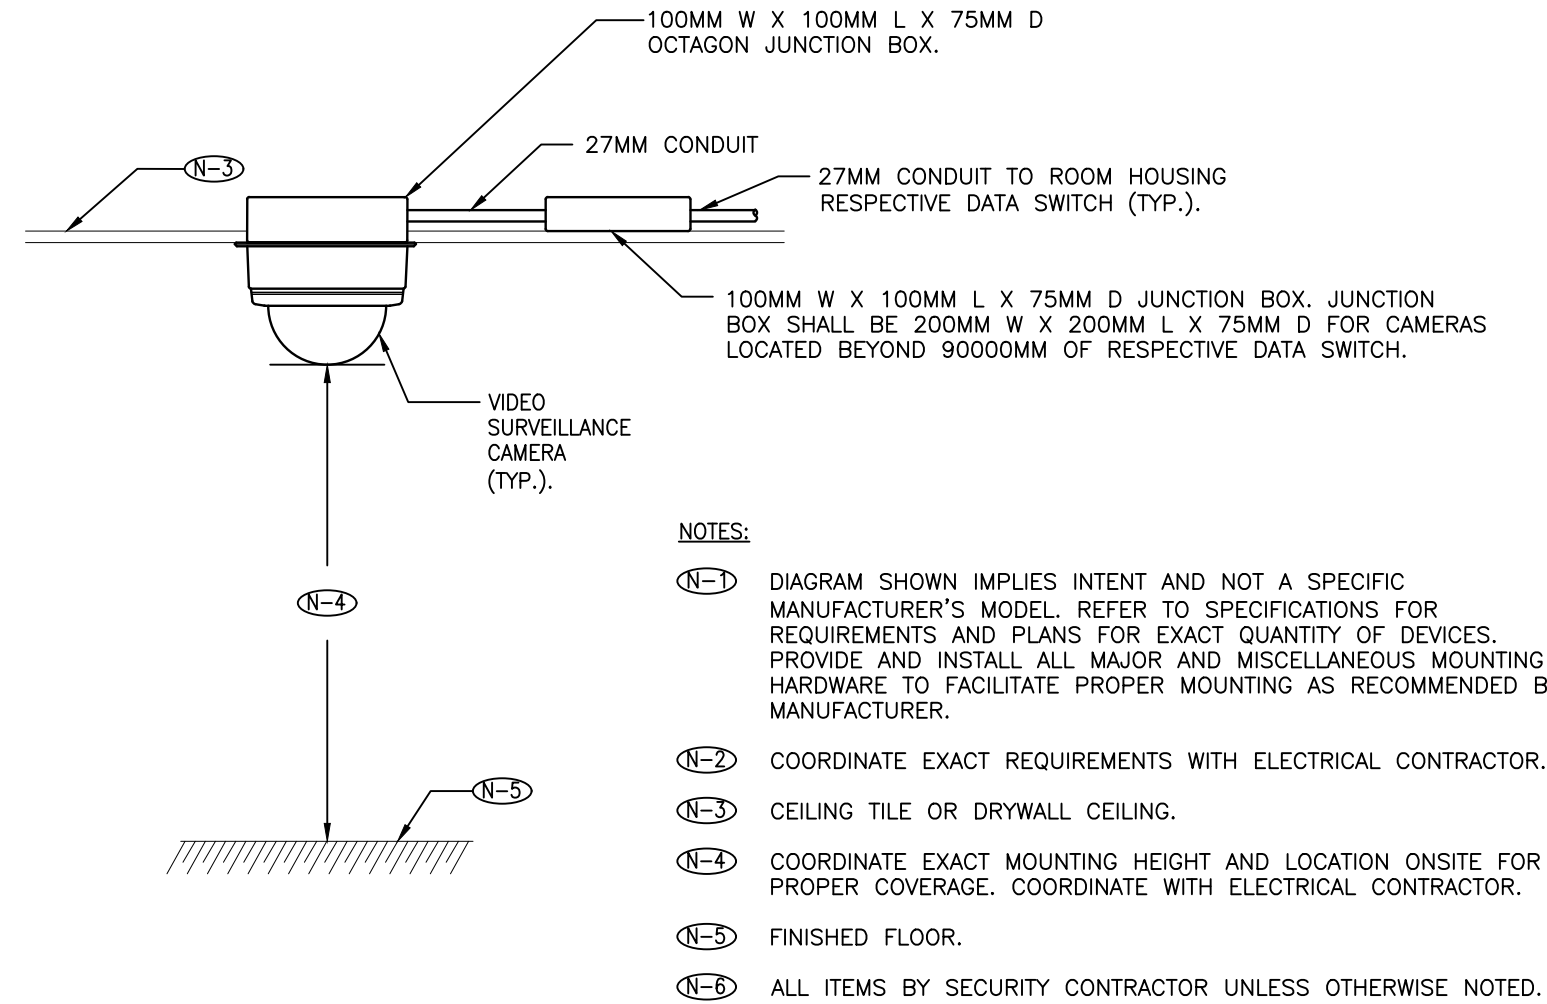

3 TYPICAL FLUSH CEILING MOUNTED INDOOR FIXED
TSE-0.3

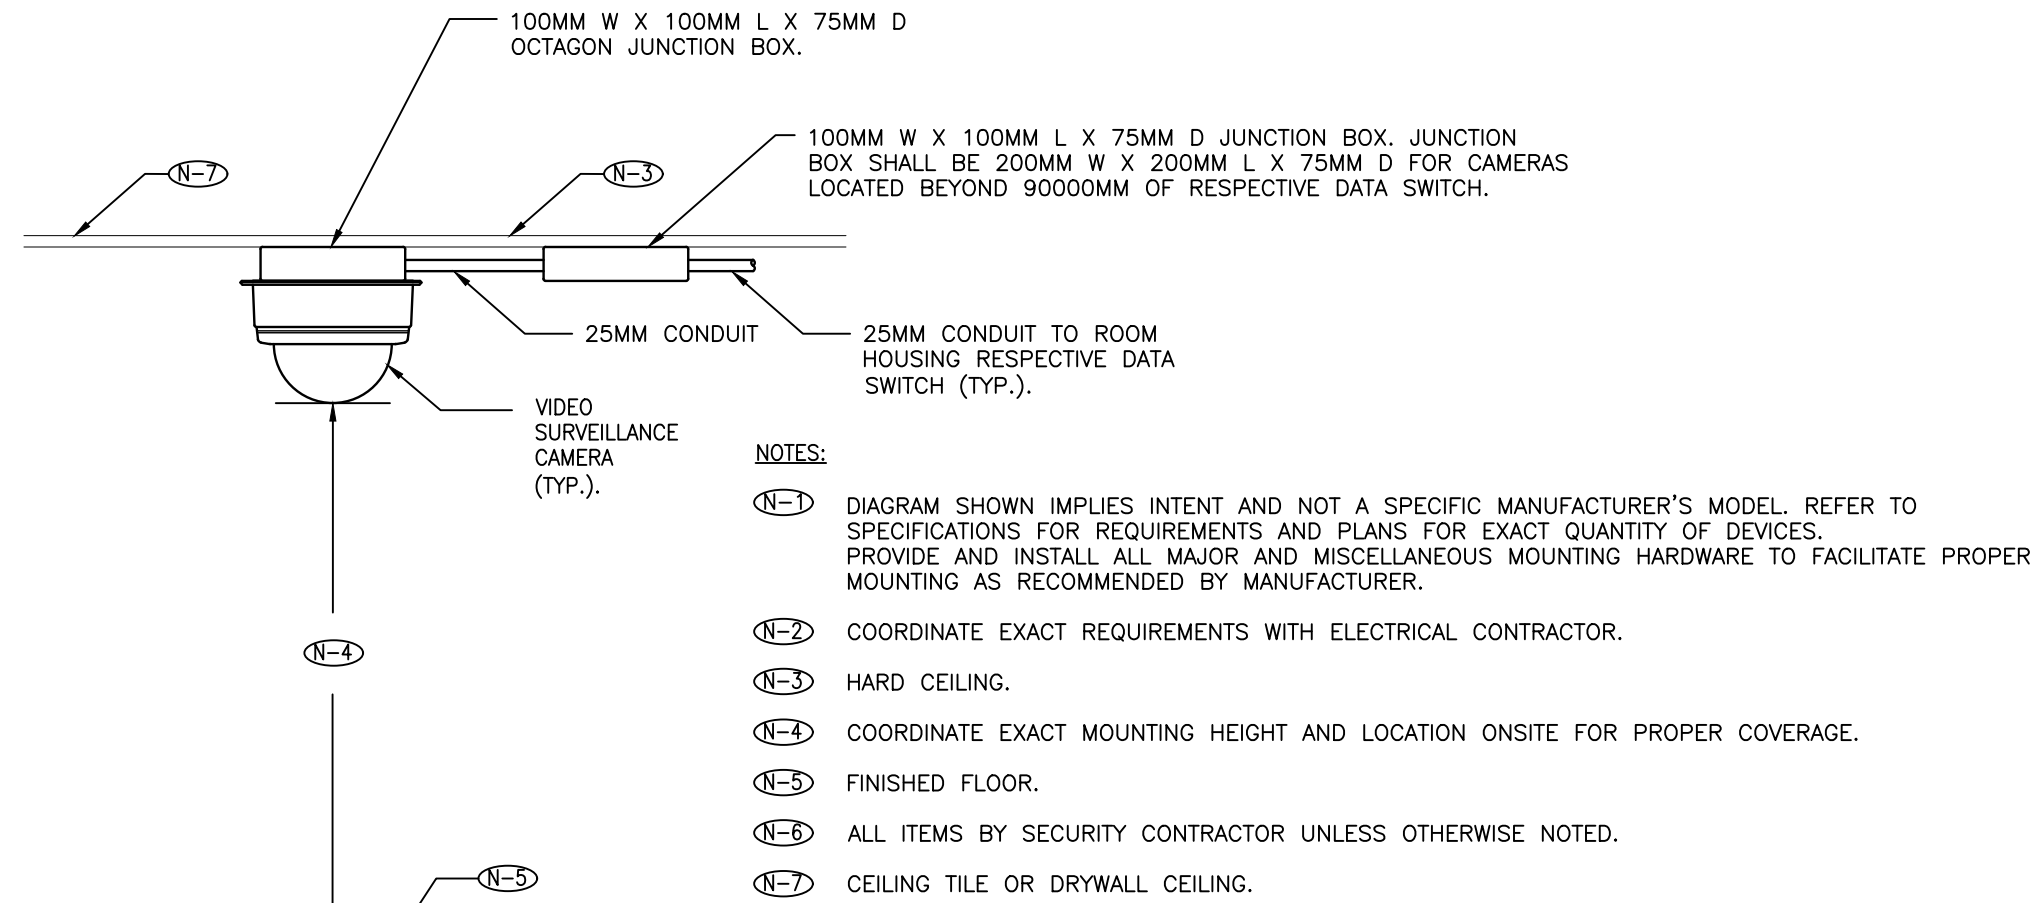

1 TYPICAL SURFACE CEILING MOUNTED INDOOR FIXED OR PTZ DOME CAMERA
TSE-0.3

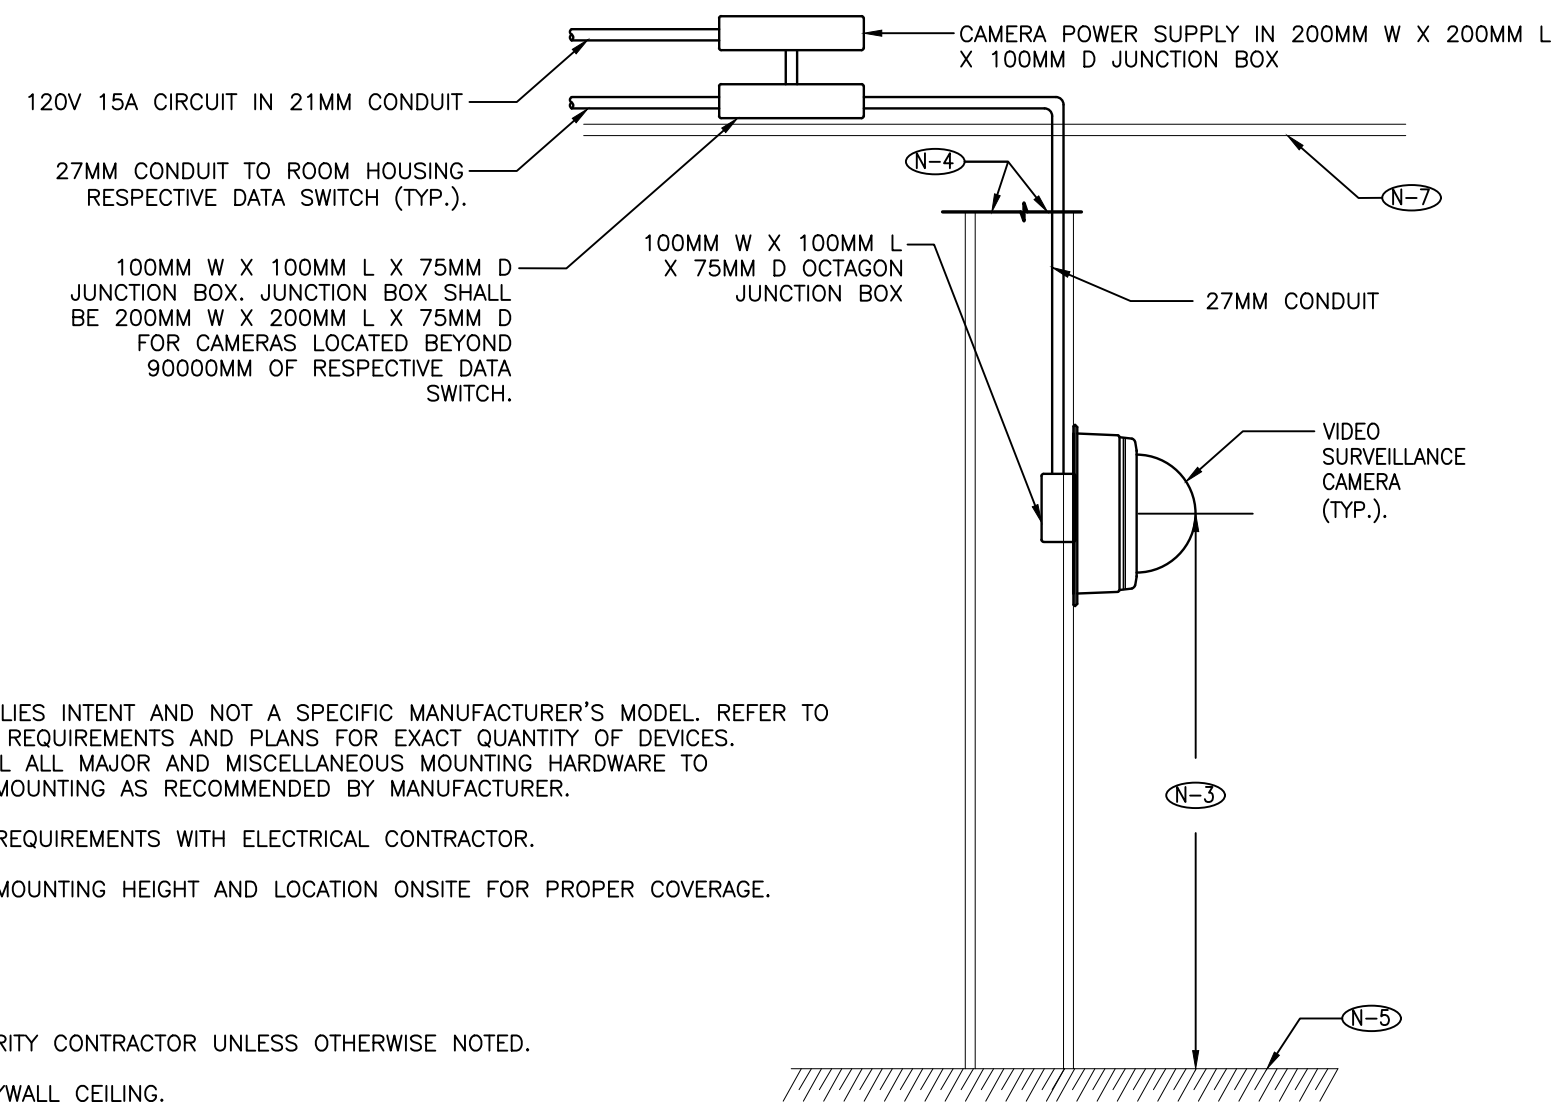

2 TYPICAL WALL MOUNTED INDOOR FIXED OR PTZ DOME CAMERA
TSE-0.3

4 NOT USED
TSE-0.3

G.Bruce Stratton Architects

217 Richmond Street West, Suite 300
Toronto Ontario M5V 1W2
telephone: 416.351.8145




PROPERTY SERVICES

SUBMISSION	DATE	DESCRIPTION
1	2020-10-14	ISSUED FOR 60% REVIEW
2	2021-07-06	ISSUED FOR 90% REVIEW
3	2023-11-16	ISSUED FOR REVIEW
4	2023-11-17	ISSUED FOR TENDER
5	2024-03-15	ISSUED FOR CONSTRUCTION

PROJECT CONTACT

NAME: SAL RAMO
TEL: 647-406-8585
EMAIL: salwan.ramo@smithandandersen.com

THIS DRAWING SHALL BE READ IN CONJUNCTION WITH COMMUNICATIONS SPECIFICATION SUBMITTED FOR THIS PROJECT.

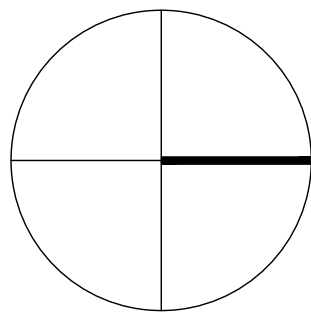

Smith + Andersen

1100 - 100 Sheppard Ave. East, Toronto On, M2N 6N5
416 487 8151 T 416 487 9104 smithandandersen.com

DEPARTMENT: BUILDING & FACILITIES

FLOOR: GROUND

BASE DATE: JULY 2020

PROJECT:

PROJECT # 14008.012

YORK REGION

Administrative Centre
17250 Yonge Street
Newmarket, Ontario

SCALE: N.T.S.

DRAWN BY: SR

SUBMITTED TO: MUNICIPALITY OF YORK

SHEET TITLE:

SECURITY DETAILS 1

SHEET NUMBER:


TSE-0.3

NOTE	DEVICE BY	CONDUIT BY	WIRING BY	COMMENTS
W-1	DOOR HARDWARE CONTRACTOR	ELECTRICAL CONTRACTOR	SECURITY CONTRACTOR	SECURITY CONTRACTOR SHALL PROVIDE ALL WIRING FROM THE ACCESS CONTROL SYSTEMS CONTROLLER TO THE TERMINAL STRIP AND FROM THE TERMINAL STRIP TO RESPECTIVE DEVICES. ALL WIRING FOR ALL ELECTRIFIED LOCKS INCLUDING BUT NOT LIMITED TO ELECTRIC STRIKES, ELECTRIC LATCH RETRACTION, ELECTRIC MORTISE LOCKS AND MAGLOCKS SHALL INCLUDE MINIMUM ONE (1) SPARE PAIR OF CONDUCTORS FOR LATCH MONITORING OR FUTURE USE.
W-2	SECURITY CONTRACTOR	ELECTRICAL CONTRACTOR	SECURITY CONTRACTOR	SECURITY CONTRACTOR SHALL PROVIDE ALL CONTROLLERS AND CONFIGURE THE ACCESS CONTROL SYSTEM CONTROLLERS TO ACHIEVE REQUIRED MODES OF DOOR OPERATION. THE TERMINAL STRIP SHALL BE EQUIPPED WITH QUANTITY OF TERMINALS TO FACILITATE INTERFACING OF ALL DEVICE WIRING. ALL TERMINAL STRIPS BY SECURITY CONTRACTOR.
W-3	ELECTRICAL CONTRACTOR	ELECTRICAL CONTRACTOR	ELECTRICAL CONTRACTOR	WIRING FROM FIRE ALARM PULL STATION TO FIRE MAGNETIC LOCK.
W-4	ELECTRICAL CONTRACTOR	ELECTRICAL CONTRACTOR	ELECTRICAL CONTRACTOR	WIRING FROM FIRE ALARM PULL STATION TO FIRE ALARM PANEL.
W-5	N/A	ELECTRICAL CONTRACTOR	ELECTRICAL CONTRACTOR	WIRING FROM 120VAC POWER SUPPLY SOURCE.
W-6	DOOR HARDWARE CONTRACTOR	ELECTRICAL CONTRACTOR	ELECTRICAL CONTRACTOR	N/A

DEVICE	MOUNTING HEIGHT	DEVICE	MOUNTING HEIGHT
CR	1100 mm (43 IN.) AFF	MR	WALL OR CEILING MOUNT ABOVE DOOR AS RECOMMENDED BY MANUFACTURER
PR	1100 mm (43 IN.) AFF	DA	CEILING MOUNT ABOVE DOOR
FOR ALL OTHER DEVICES REFER TO RESPECTIVE DISCIPLINE CONTRACT DESIGN DOCUMENT.			


GENERAL NOTES:

- REFER TO SECURITY PLAN DRAWINGS, ELECTRICAL DRAWINGS AND DOOR HARDWARE SCHEDULE FOR ADDITIONAL DETAILS.
- COORDINATE EXACT LOCATIONS OF DEVICES ON SITE WITH ELECTRICAL AND DOOR HARDWARE CONTRACTOR.
- ALL TERMINAL STRIPS SHALL BE PROVIDED AND INSTALLED BY THE SECURITY CONTRACTOR.
- THIS DIAGRAM SHALL BE READ IN CONJUNCTION WITH THE DOOR AND HARDWARE SCHEDULE.
- ALL WIRING SHALL BE INSTALLED IN CONDUITS. ALL CONDUIT SHALL BE 19mm UNLESS OTHERWISE NOTED.
- PRIOR TO INTERFACING WITH DEVICES AND DEVICE ASSOCIATED WIRING THAT ARE PROVIDED BY ELECTRICAL AND DOOR AND HARDWARE (D.H.) CONTRACTORS, COORDINATE WITH THE ELECTRICAL AND DOOR AND HARDWARE (D.H.) CONTRACTORS AND ENSURE THAT ALL DEVICES AND WIRING PROVIDED ARE CERTIFIED BY THE RESPECTIVE TRADE TO BE IN PROPER WORKING ORDER.
- PROVIDE ALL ACTIVE AND PASSIVE HARDWARE, ALL WIRING AND PROGRAMING OF SECURITY SYSTEM SOFTWARE TO FACILITATE EACH MODE OF OPERATION FOR EACH DOOR.
- ALL DOOR HARDWARE DEVICES PROVIDED SHALL MEET ALL REQUIREMENTS LISTED IN THE ACCESSIBILITY FOR ONTARIANS WITH DISABILITIES ACT (AODA).
- FOR ALL DOORS THAT ARE EQUIPPED WITH AUTOMATIC DOOR OPERATORS PROVIDE ALL ACCESS CONTROL CONTROLLERS AND WIRING REQUIRED TO INTEGRATE THE AUTOMATIC DOOR OPERATORS AND PUSH BUTTON OPERATORS WITH THE ACCESS CONTROL CONTROLLERS TO FACILITATE THE SEQUENCE OF OPERATION.

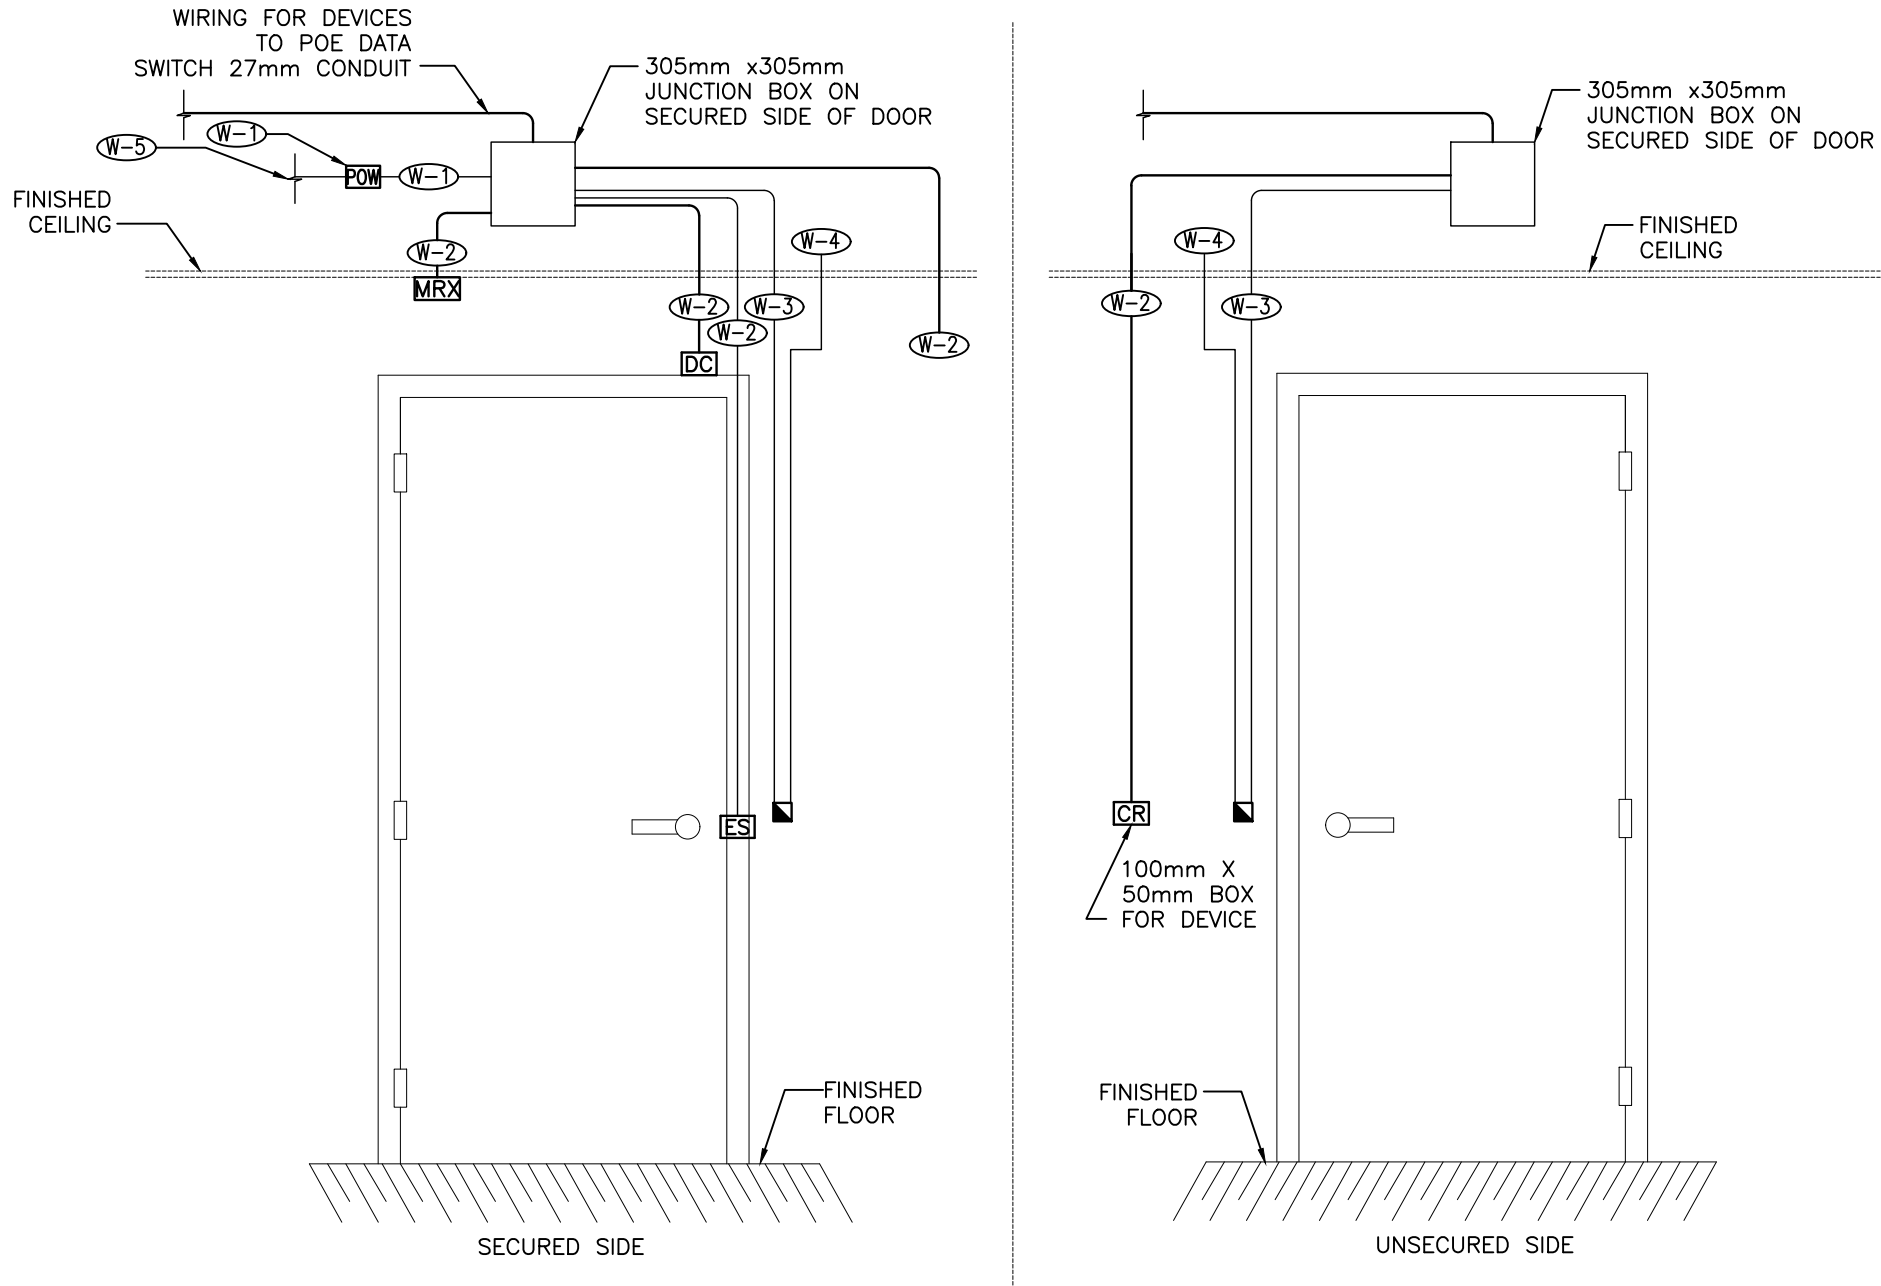

GENERAL NOTES:

- REFER TO DOOR DETAIL NOTES FOR ADDITIONAL INFORMATION.
- DOOR HANDLES SHOWN ARE DIAGRAMMATIC. REFER TO DOOR HARDWARE SCHEDULE FOR EXACT DOOR HANDLE TYPE.

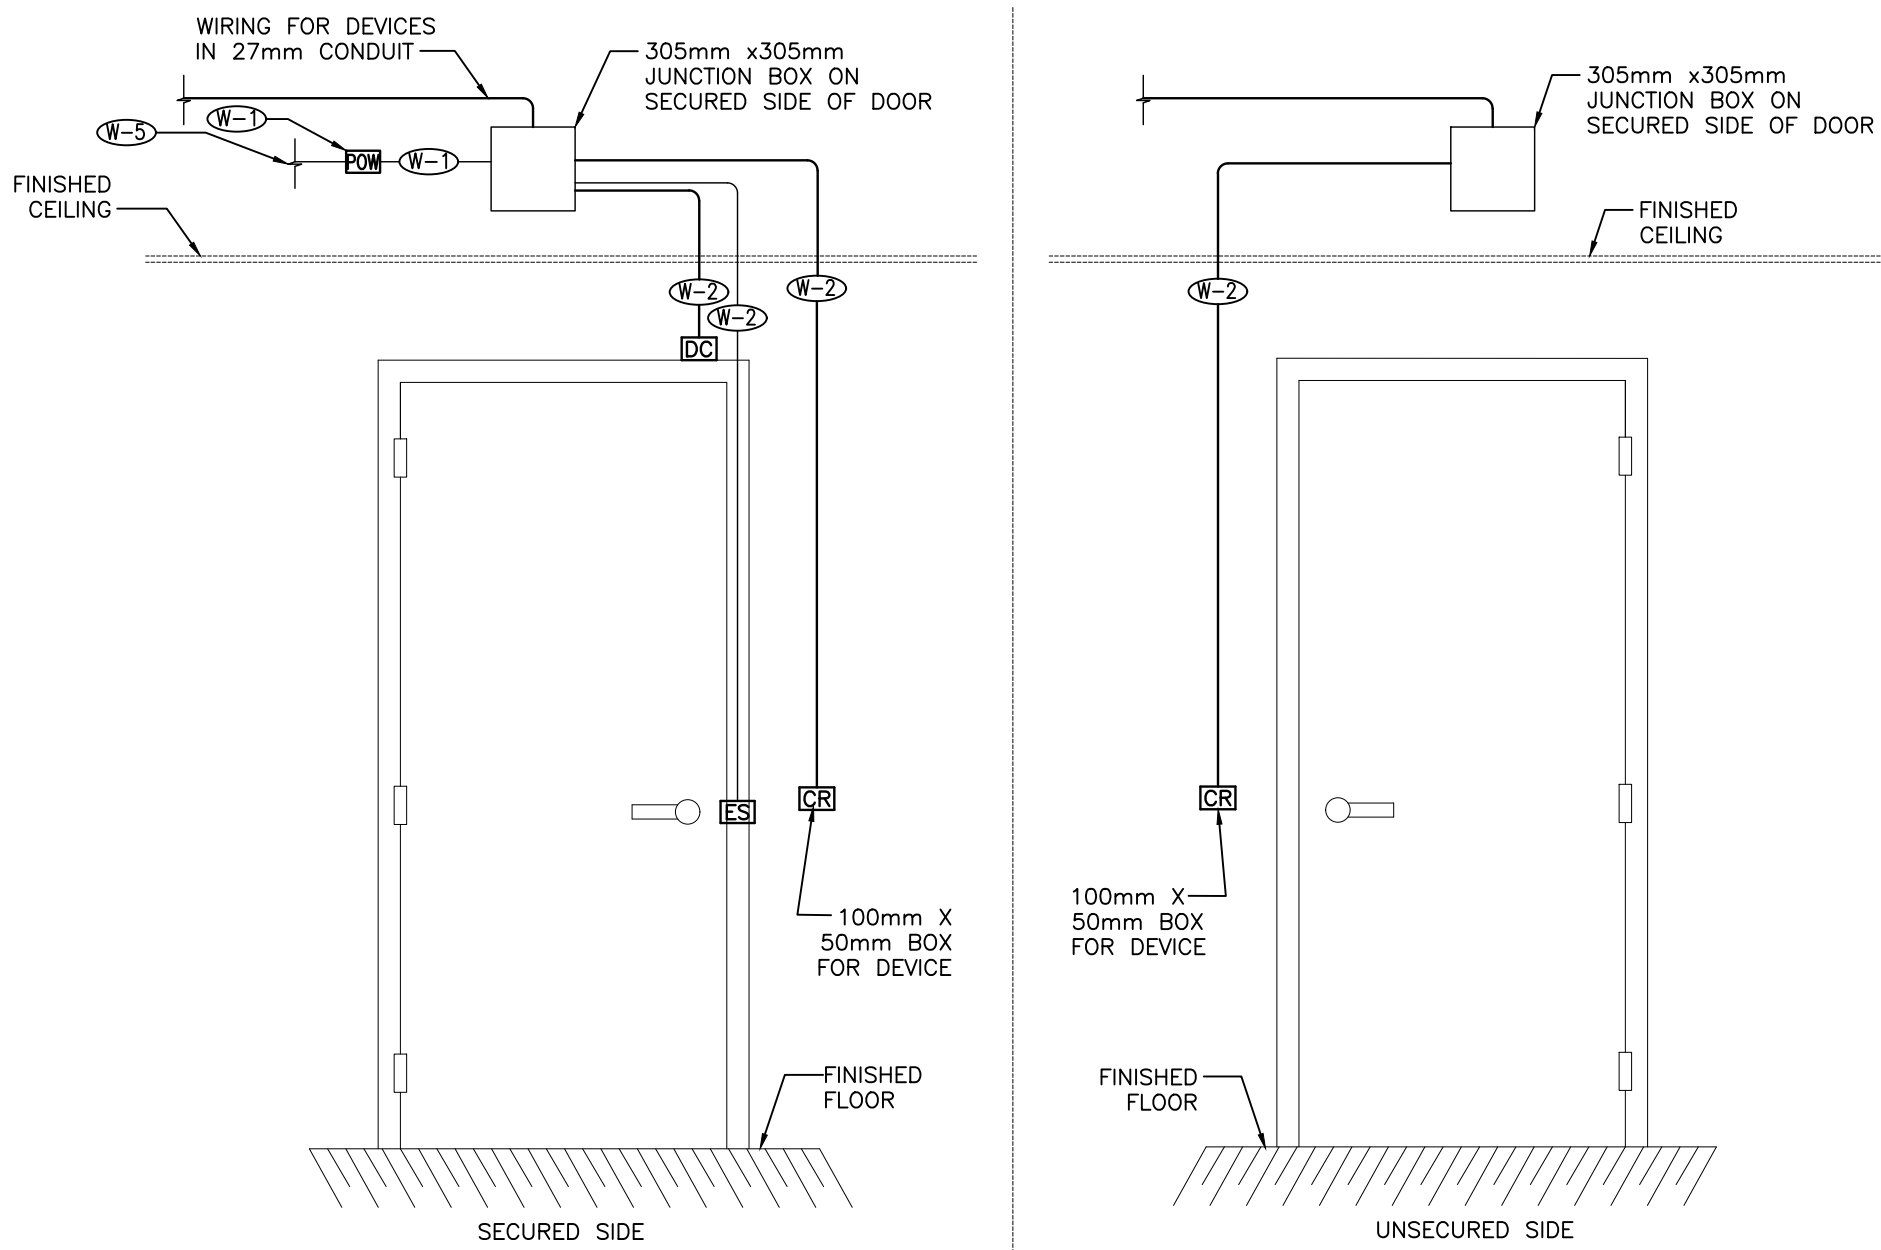

GENERAL NOTES:

- REFER TO DOOR DETAIL NOTES FOR ADDITIONAL INFORMATION.
- DOOR HANDLES SHOWN ARE DIAGRAMMATIC. REFER TO DOOR HARDWARE SCHEDULE FOR EXACT DOOR HANDLE TYPE.

G.Bruce Stratton Architects

217 Richmond Street West, Suite 300
Toronto Ontario M5V 1W2
telephone: 416.351.8145


York Region
PROPERTY SERVICES

SUBMISSION	DATE	DESCRIPTION
1	2020-10-14	ISSUED FOR 60% REVIEW
2	2021-07-06	ISSUED FOR 90% REVIEW
3	2023-11-16	ISSUED FOR REVIEW
4	2023-11-17	ISSUED FOR TENDER
5	2024-03-15	ISSUED FOR CONSTRUCTION

PROJECT CONTACT

NAME: SAL RAMO
TEL: 647-406-8585
EMAIL: salwan.ramo@smithandandersen.com

THIS DRAWING SHALL BE READ IN CONJUNCTION WITH COMMUNICATIONS SPECIFICATION SUBMITTED FOR THIS PROJECT.

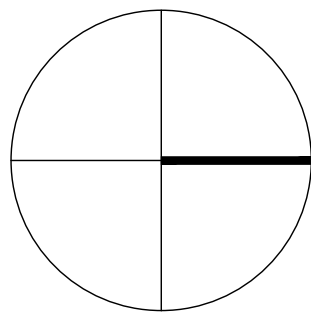

Smith + Andersen

1100 - 100 Sheppard Ave. East, Toronto On, M2N 6N5
416 487 8151 T 416 487 8104 smithandandersen.com

DEPARTMENT: BUILDING & FACILITIES

FLOOR: GROUND

BASE DATE: JULY 2020

PROJECT:

PROJECT # 14008.012

YORK REGION

Administrative Centre
17250 Yonge Street
Newmarket, Ontario

SCALE: N.T.S.

DRAWN BY: SR

SUBMITTED TO: MUNICIPALITY OF YORK

SHEET TITLE:

SECURITY DETAILS 2

SHEET NUMBER:

TSE-0.4

3 DOOR DETAIL NOTES

TSE-0.4

1 SINGLE DOOR SECURITY TYPE 1

TSE-0.4

4 NOT USED.

TSE-0.4

2 SINGLE DOOR SECURITY TYPE 2

TSE-0.4



- GENERAL NOTES:**
1. THIS DRAWING SHALL BE READ IN CONJUNCTION WITH THE PROJECT RELATED DOOR HARDWARE SCHEDULE AS WELL AS THE PROJECT RELATED ARCHITECTURAL ELECTRICAL AND MECHANICAL DRAWINGS.
 2. ALL ITEMS SHOWN ARE BY THE SECURITY CONTRACTOR UNLESS OTHERWISE NOTED.
 3. LOCATIONS OF DEVICES SHOWN ARE APPROXIMATE. COORDINATE THE EXACT LOCATION OF EACH DEVICE ON SITE WITH OTHER TRADES.
 4. COORDINATE THE INSTALLATION AND INTERFACING WITH ALL ELECTRIFIED LOCKS AND DOOR CONTACTS WITH THE DOOR HARDWARE CONTRACTOR.
 5. COORDINATE THE INSTALLATION AND INTERFACING WITH ALL POWER CIRCUITS WITH THE ELECTRICAL CONTRACTOR.
 6. COORDINATE EXACT MOUNTING HEIGHTS AND LOCATIONS OF CCTV CAMERAS ON SITE WITH ELECTRICAL CONTRACTOR. PROVIDE ALL MOUNTING BRACKETS TO ENSURE THAT ALL OBSTRUCTIONS ARE AVOIDED AND CLEAR VIEW OF TARGET AREAS IS ATTAINED.
 7. ALL CABLES SHALL BE HOME RUN IN CONDUITS. CABLE SPLICES SHALL NOT BE ACCEPTABLE. WHERE CABLES ARE GROUPED AND INSTALLED IN A SINGLE CONDUIT THE CONDUIT SHALL BE SIZED TO MAXIMUM 40% FILL.

- DRAWING NOTES:**
- (S-D) TYPICAL SECURED DOOR. DEVICES SHOWN INDICATES GENERAL CONNECTIVITY REQUIREMENTS ONLY, REFER TO FLOOR PLANS FOR EXACT QUANTITY AND TYPES OF DEVICES AT EACH DOOR. REFER TO DOOR ELEVATION DRAWINGS FOR DEVICE AND CONDUIT REQUIREMENTS AT SECURED DOORS.(TYP).
 - (F-D) EXISTING FIXED CCTV CAMERA TO BE RELOCATED.

G.Bruce Stratton Architects

217 Richmond Street West, Suite 300
Toronto Ontario M5V 1W2
telephone: 416.351.8145




SUBMISSION	DATE	DESCRIPTION
1	2020-10-14	ISSUED FOR 60% REVIEW
2	2021-07-06	ISSUED FOR 90% REVIEW
3	2023-11-16	ISSUED FOR REVIEW
4	2023-11-17	ISSUED FOR TENDER
5	2024-03-15	ISSUED FOR CONSTRUCTION

PROJECT CONTACT

NAME: SAL RAMO
TEL: 647-406-8585
EMAIL: salwan.ramo@smithandandersen.com

THIS DRAWING SHALL BE READ IN CONJUNCTION WITH COMMUNICATIONS SPECIFICATION SUBMITTED FOR THIS PROJECT.

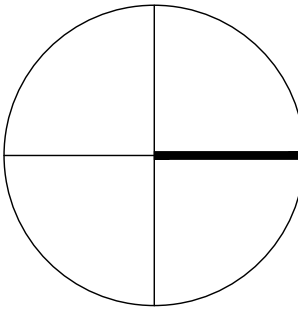

Smith + Andersen

1100 - 100 Sheppard Ave. East, Toronto On, M2N 6N5
416 487 8151 T 416 487 9104 smithandandersen.com

DEPARTMENT: BUILDING & FACILITIES

FLOOR: GROUND

BASE DATE: JULY 2020

PROJECT:

PROJECT # 14008.012

YORK REGION

Administrative Centre
17250 Yonge Street
Newmarket, Ontario

SCALE: 1:100

DRAWN BY: SR


SUBMITTED TO: MUNICIPALITY OF YORK

SHEET TITLE:

GROUND FLOOR -
SECURITY LAYOUT

SHEET NUMBER:

TSE-1.0

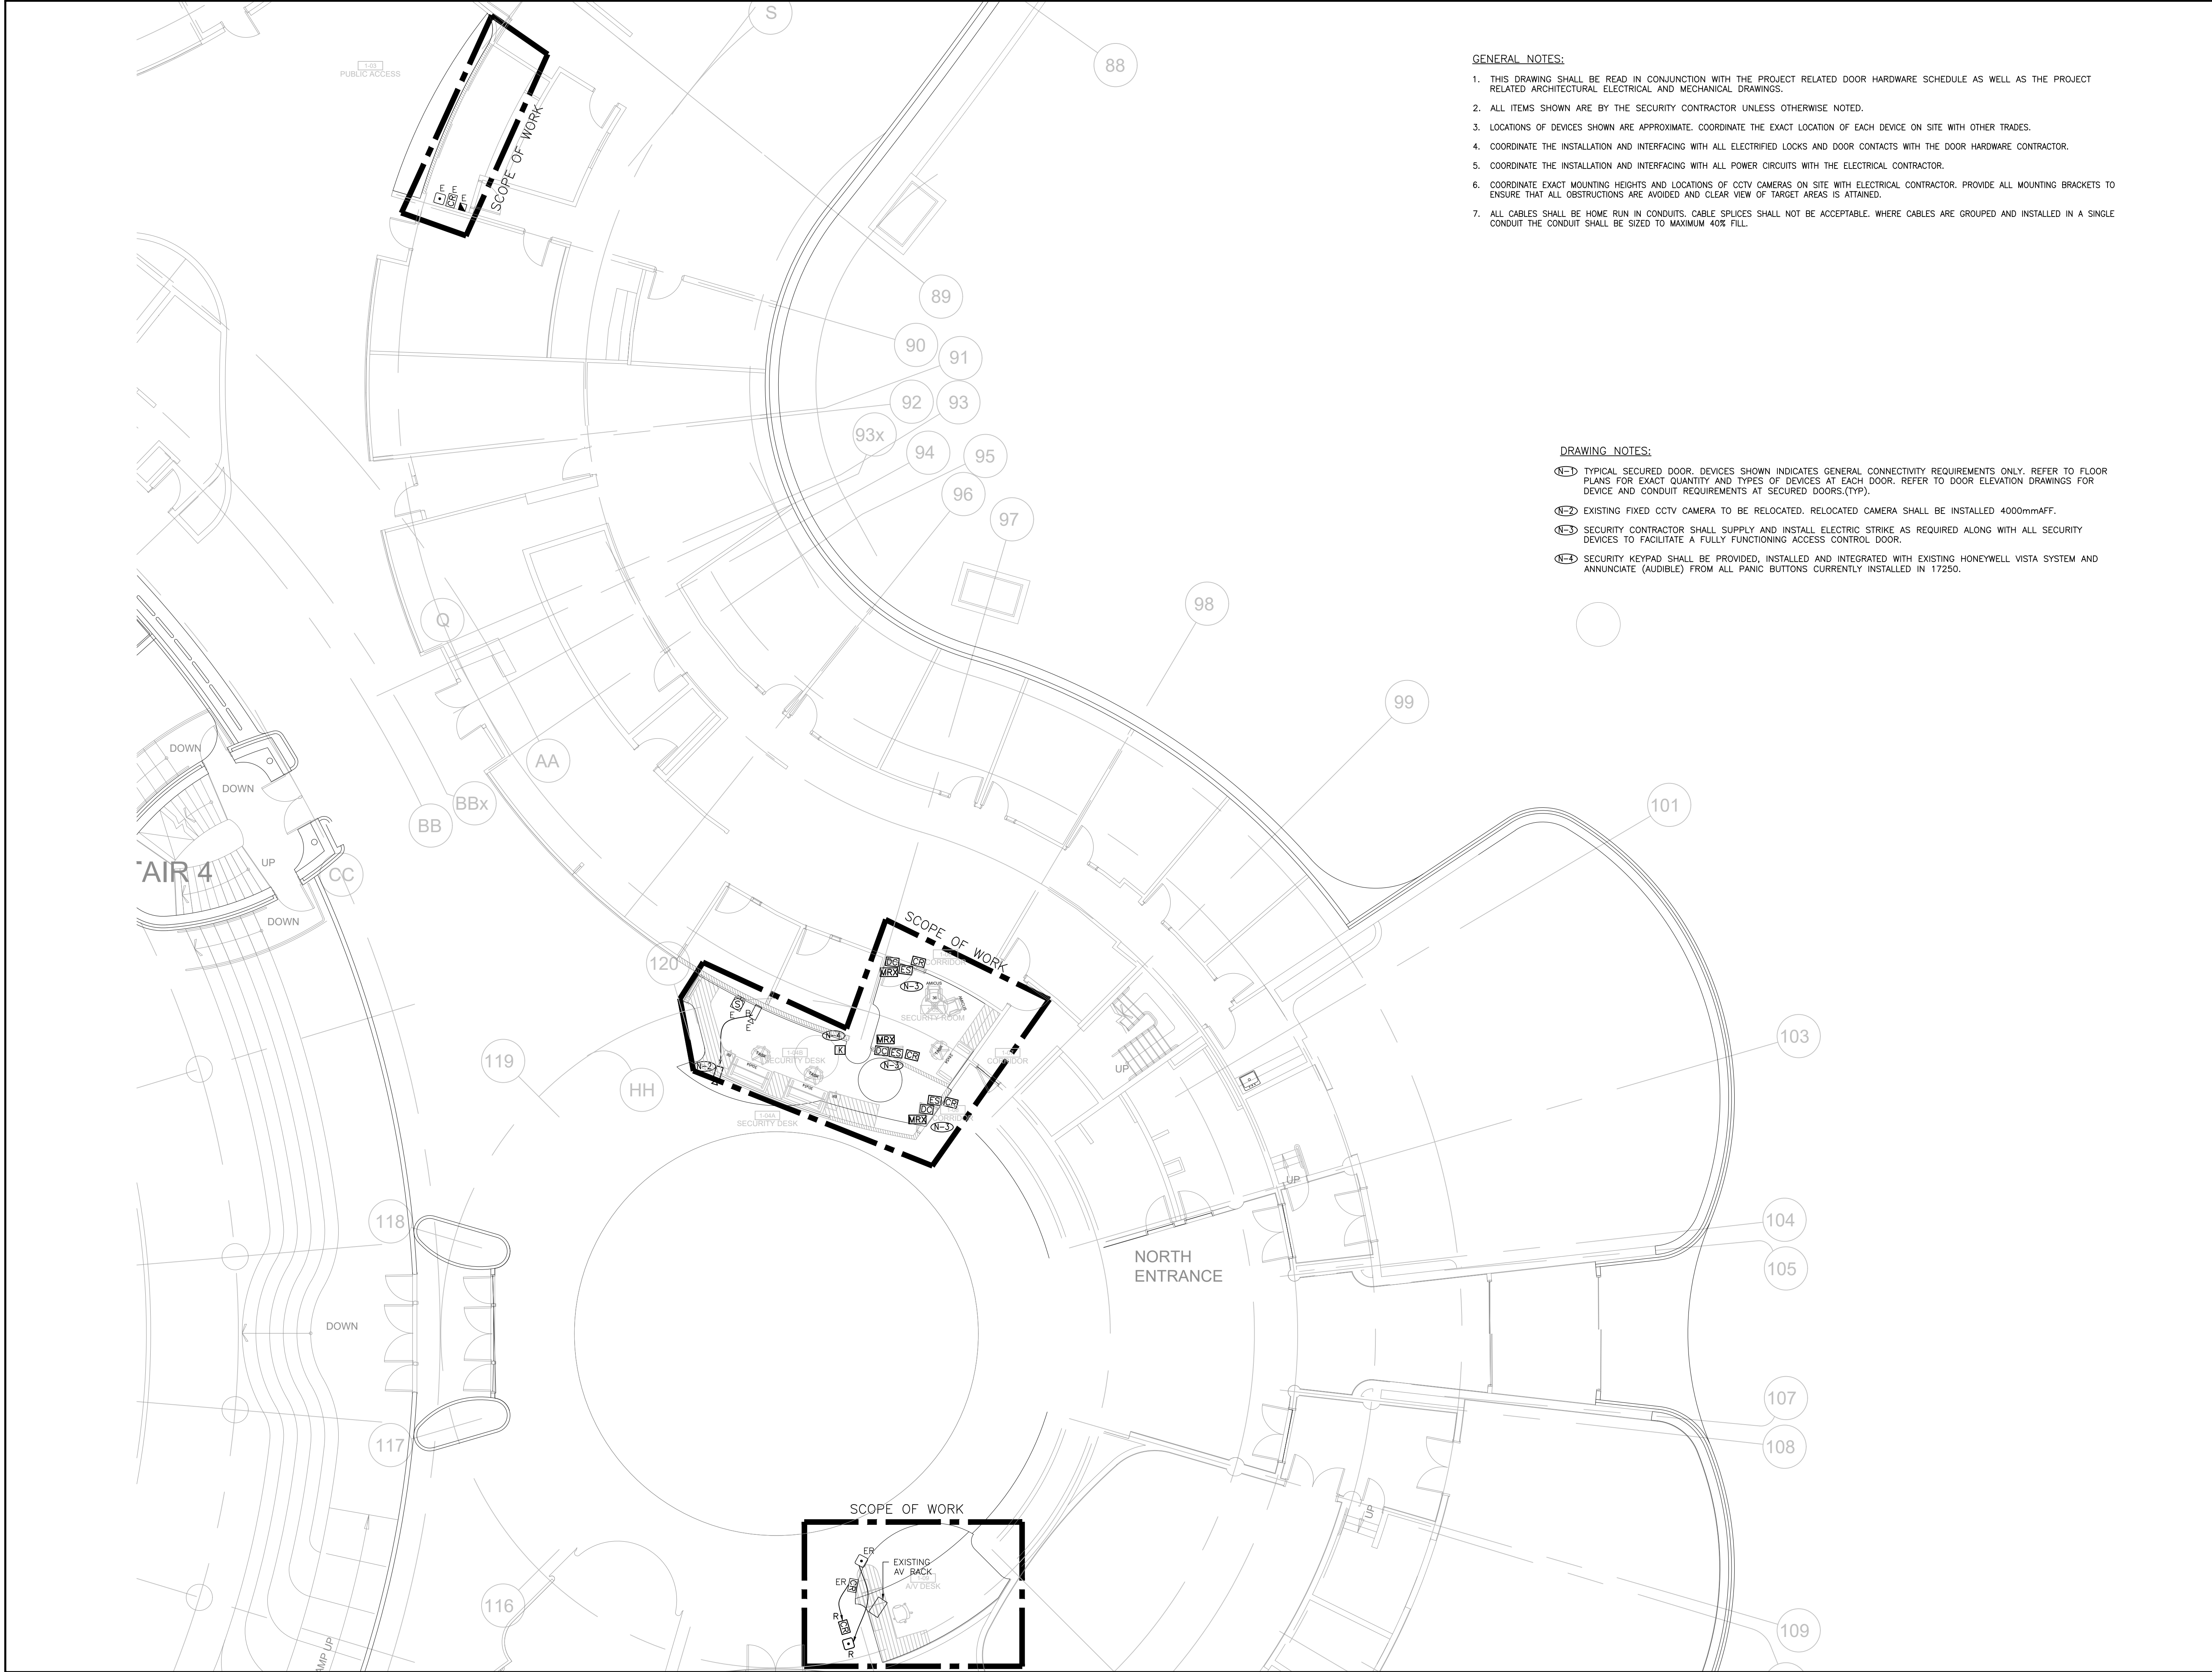

- GENERAL NOTES:**
1. THIS DRAWING SHALL BE READ IN CONJUNCTION WITH THE PROJECT RELATED DOOR HARDWARE SCHEDULE AS WELL AS THE PROJECT RELATED ARCHITECTURAL ELECTRICAL AND MECHANICAL DRAWINGS.
 2. ALL ITEMS SHOWN ARE BY THE SECURITY CONTRACTOR UNLESS OTHERWISE NOTED.
 3. LOCATIONS OF DEVICES SHOWN ARE APPROXIMATE. COORDINATE THE EXACT LOCATION OF EACH DEVICE ON SITE WITH OTHER TRADES.
 4. COORDINATE THE INSTALLATION AND INTERFACING WITH ALL ELECTRIFIED LOCKS AND DOOR CONTACTS WITH THE DOOR HARDWARE CONTRACTOR.
 5. COORDINATE THE INSTALLATION AND INTERFACING WITH ALL POWER CIRCUITS WITH THE ELECTRICAL CONTRACTOR.
 6. COORDINATE EXACT MOUNTING HEIGHTS AND LOCATIONS OF CCTV CAMERAS ON SITE WITH ELECTRICAL CONTRACTOR. PROVIDE ALL MOUNTING BRACKETS TO ENSURE THAT ALL OBSTRUCTIONS ARE AVOIDED AND CLEAR VIEW OF TARGET AREAS IS ATTAINED.
 7. ALL CABLES SHALL BE HOME RUN IN CONDUITS. CABLE SPLICES SHALL NOT BE ACCEPTABLE. WHERE CABLES ARE GROUPED AND INSTALLED IN A SINGLE CONDUIT THE CONDUIT SHALL BE SIZED TO MAXIMUM 40% FILL.

- DRAWING NOTES:**
- (N-1) TYPICAL SECURED DOOR. DEVICES SHOWN INDICATES GENERAL CONNECTIVITY REQUIREMENTS ONLY. REFER TO FLOOR PLANS FOR EXACT QUANTITY AND TYPES OF DEVICES AT EACH DOOR. REFER TO DOOR ELEVATION DRAWINGS FOR DEVICE AND CONDUIT REQUIREMENTS AT SECURED DOORS.(TYP).
 - (N-2) EXISTING FIXED CCTV CAMERA TO BE RELOCATED. RELOCATED CAMERA SHALL BE INSTALLED 4000mm AFF.
 - (N-3) SECURITY CONTRACTOR SHALL SUPPLY AND INSTALL ELECTRIC STRIKE AS REQUIRED ALONG WITH ALL SECURITY DEVICES TO FACILITATE A FULLY FUNCTIONING ACCESS CONTROL DOOR.
 - (N-4) SECURITY KEYPAD SHALL BE PROVIDED, INSTALLED AND INTEGRATED WITH EXISTING HONEYWELL VISTA SYSTEM AND ANNUNCIATE (AUDIBLE) FROM ALL PANIC BUTTONS CURRENTLY INSTALLED IN 17250.

G.Bruce Stratton Architects

217 Richmond Street West, Suite 300
Toronto Ontario M5V 1W2
telephone: 416.351.8145

York Region


PROPERTY SERVICES

SUBMISSION	DATE	DESCRIPTION
1	2020-10-14	ISSUED FOR 60% REVIEW
2	2021-07-06	ISSUED FOR 90% REVIEW
3	2023-11-16	ISSUED FOR REVIEW
4	2023-11-17	ISSUED FOR TENDER
5	2024-03-15	ISSUED FOR CONSTRUCTION

PROJECT CONTACT

NAME: SAL RAMO
TEL: 647-406-8585
EMAIL: salwan.ramo@smithandandersen.com

THIS DRAWING SHALL BE READ IN CONJUNCTION WITH COMMUNICATIONS SPECIFICATION SUBMITTED FOR THIS PROJECT.

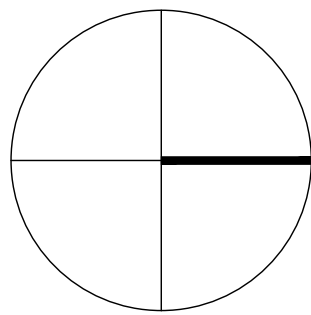

Smith + Andersen
1100 - 100 Sheppard Ave. East, Toronto On, M2N 6N5
416 487 8151 F 416 487 9104 smithandandersen.com

DEPARTMENT: BUILDING & FACILITIES

FLOOR: GROUND

BASE DATE: JULY 2020

PROJECT:

PROJECT # 14008.012

YORK REGION

Administrative Centre
17250 Yonge Street
Newmarket, Ontario

SCALE: 1:100

DRAWN BY: SR

SUBMITTED TO: MUNICIPALITY OF YORK

SHEET TITLE:

GROUND FLOOR -
SECURITY LAYOUT

SHEET NUMBER:

TSE-1.1