

ELECTRICAL DRAWING LIST	
Sheet Number	Sheet Name
E0000	DRAWING LIST
E1101	ELECTRICAL DEMOLITION PLAN 1ST FLOOR
E2101	POWER & SYSTEMS PLAN 1ST FLOOR

CLIENT

CITY OF TORONTO



55 John ST.  
TORONTO, ON  
M5V 3C6

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ISSUES		
No.	DESCRIPTION	DATE
0	ISSUED FOR CONSTRUCTION	2023-03-13

CONSULTANTS

SEAL



PRIME CONSULTANT



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PROJECT TITLE

CITY OF TORONTO  
ACCESSIBILITY UPGRADES

PROJECT ADDRESS

FIRE HALL NO.225  
3600 DANFORTH AVE


PROJECT NO: 122260	
DRAWN BY: <b>V. MAC</b>	CHECKED BY: <b>M. BOJIC</b>
PROJECT MGR: <b>F. BOLOURIAN</b>	APPROVED BY: <b>P. WILLIAMS</b>

SHEET TITLE

DRAWING LIST

SHEET NUMBER	ISSUE
G28-203-E0000	0

- NOTES:
1. REMOVE CONDUITS CONNECTED TO DATA AND POWER OUTLETS.
  2. PULL BACK WIRING TO NEAREST JUNCTION BOX AND PREPARE FOR RE-USE (TYPICAL FOR RECEPTACLES, SPEAKERS, LIGHT SWITCHES, AND LIGHTS, AS SHOWN ON ELECTRICAL DEMOLITION PLAN). PULL BACK DATA OUTLET WIRING TO SOURCE AND PRESERVE WIRING FOR RE-USE.
  3. COORDINATE WITH CORPORATE SECURITY BEFORE DISCONNECTING AND RELOCATING SECURITY DEVICES.

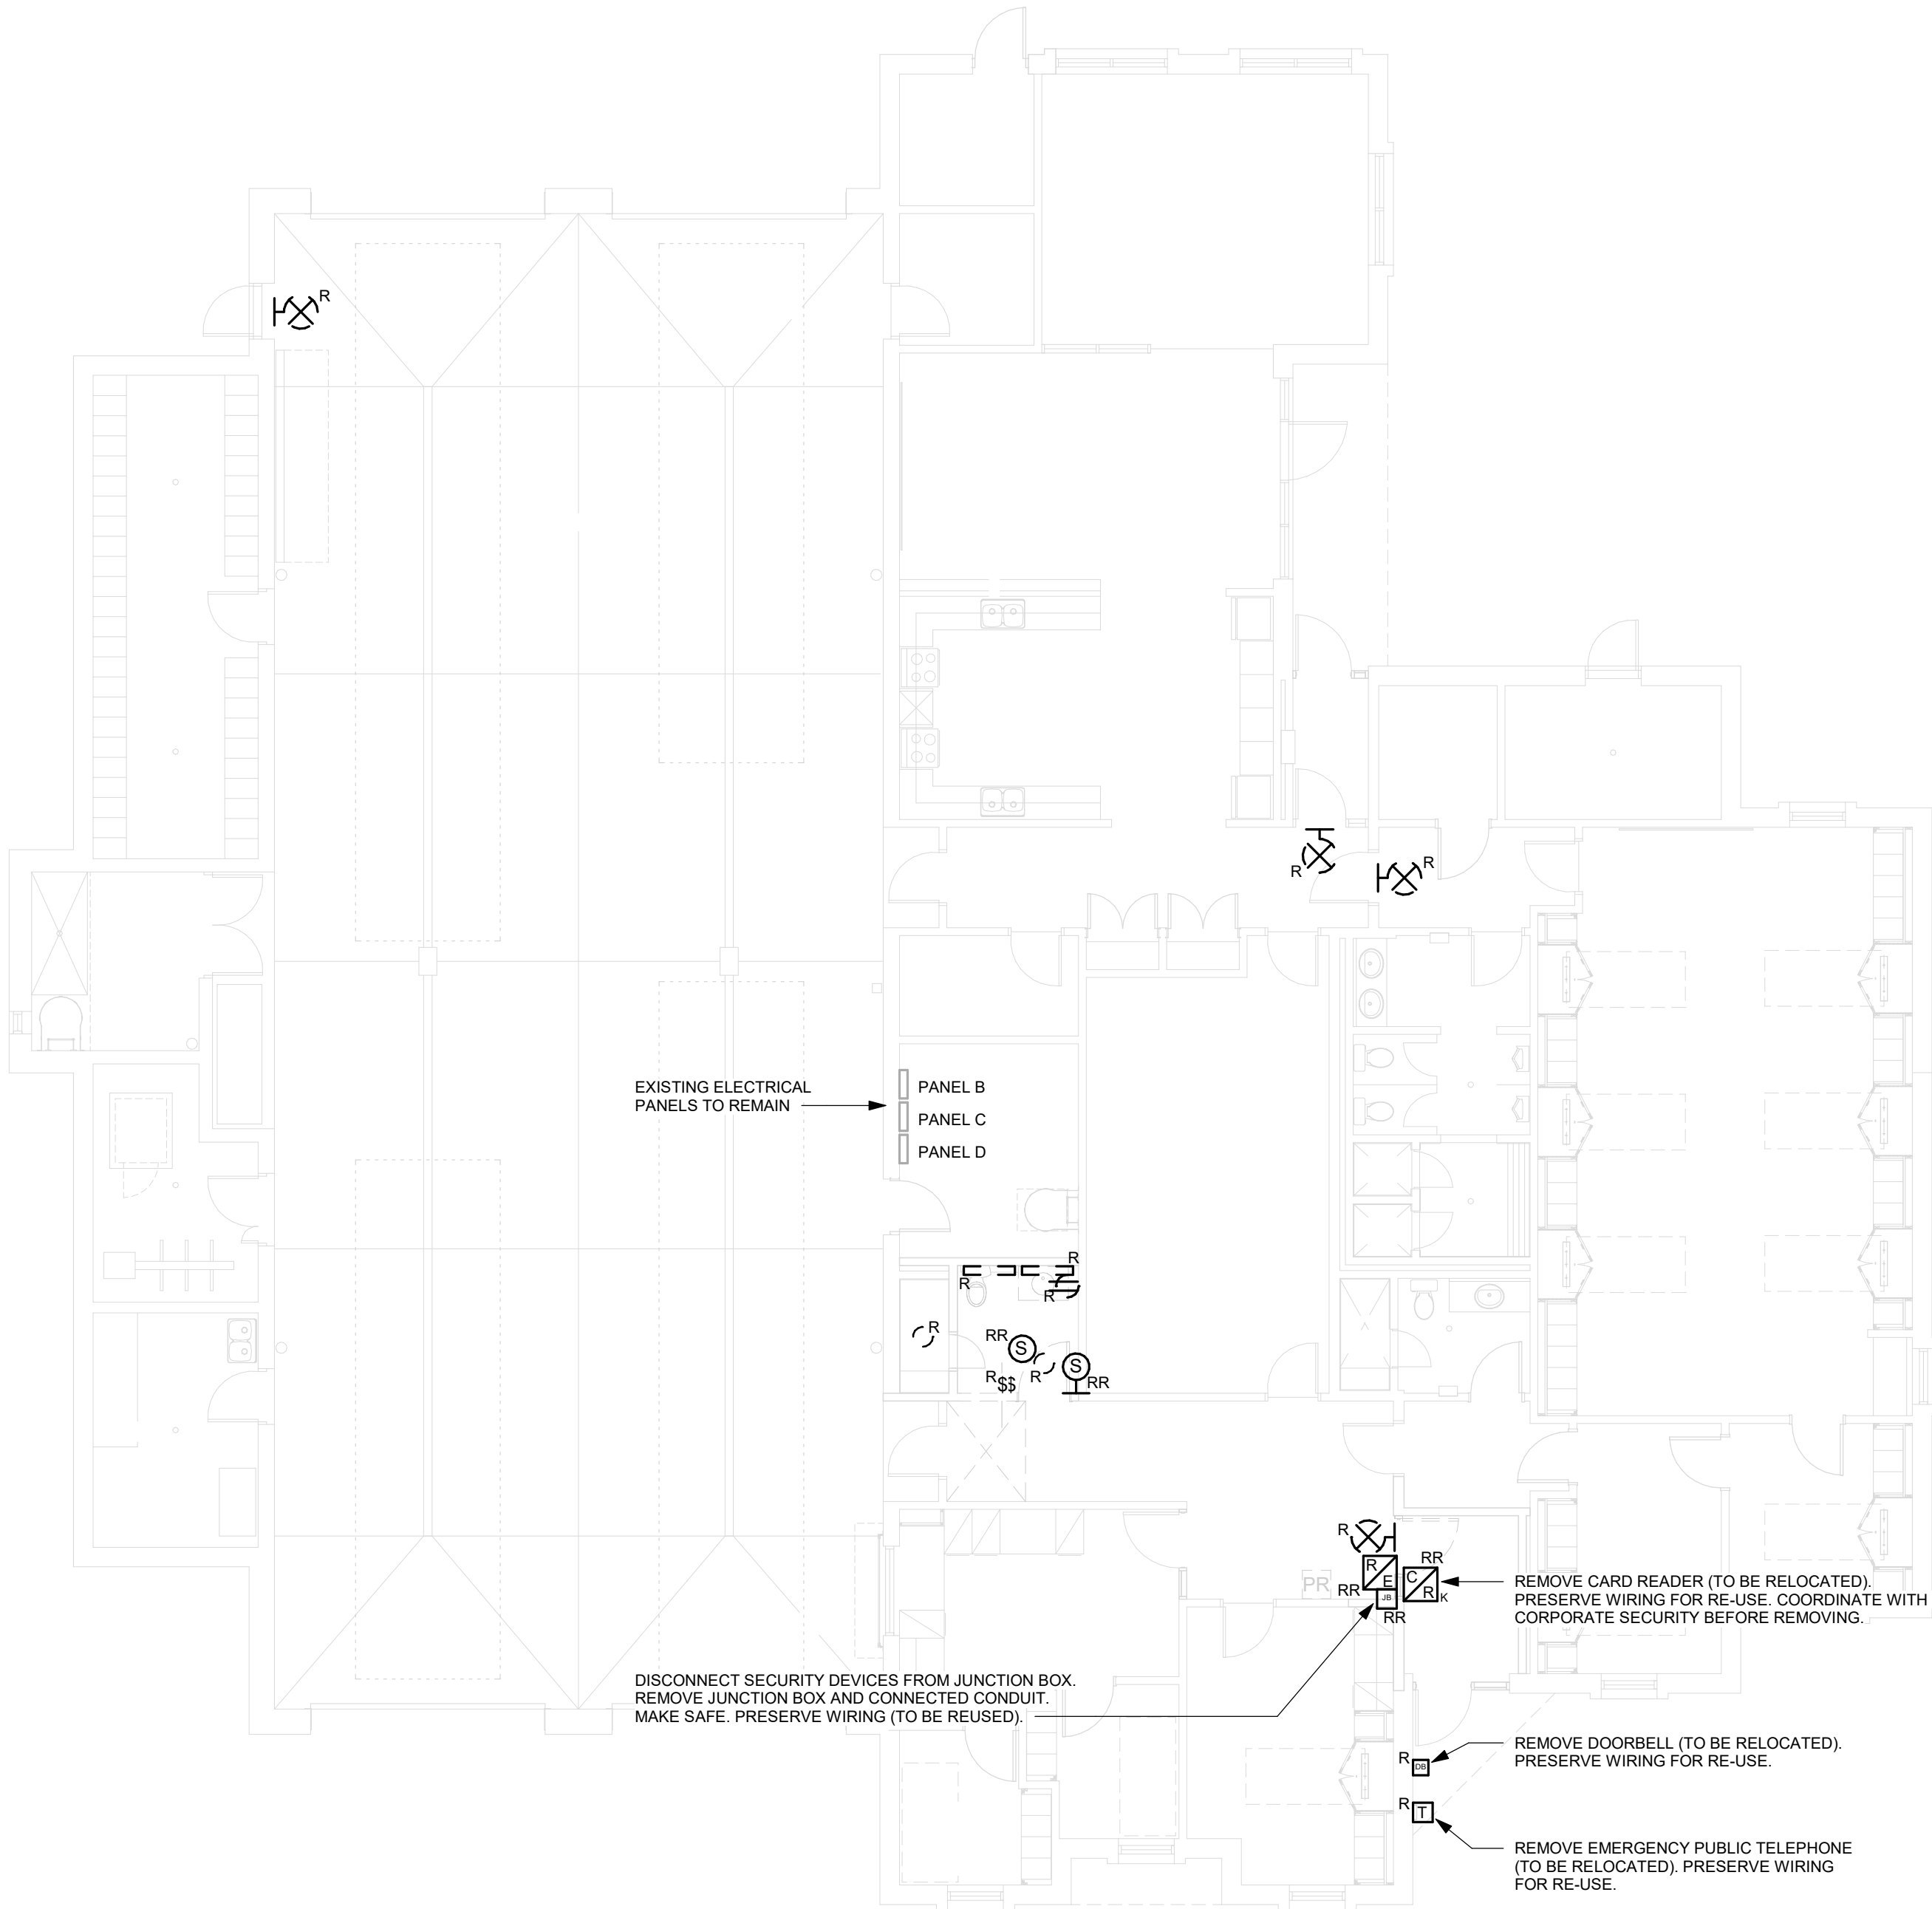

1 POWER AND SYSTEMS DEMOLITION PLAN FIRST FLOOR  
E1101 Scale: 1 : 100

Scale 1:100 0 2.5 5 10 m

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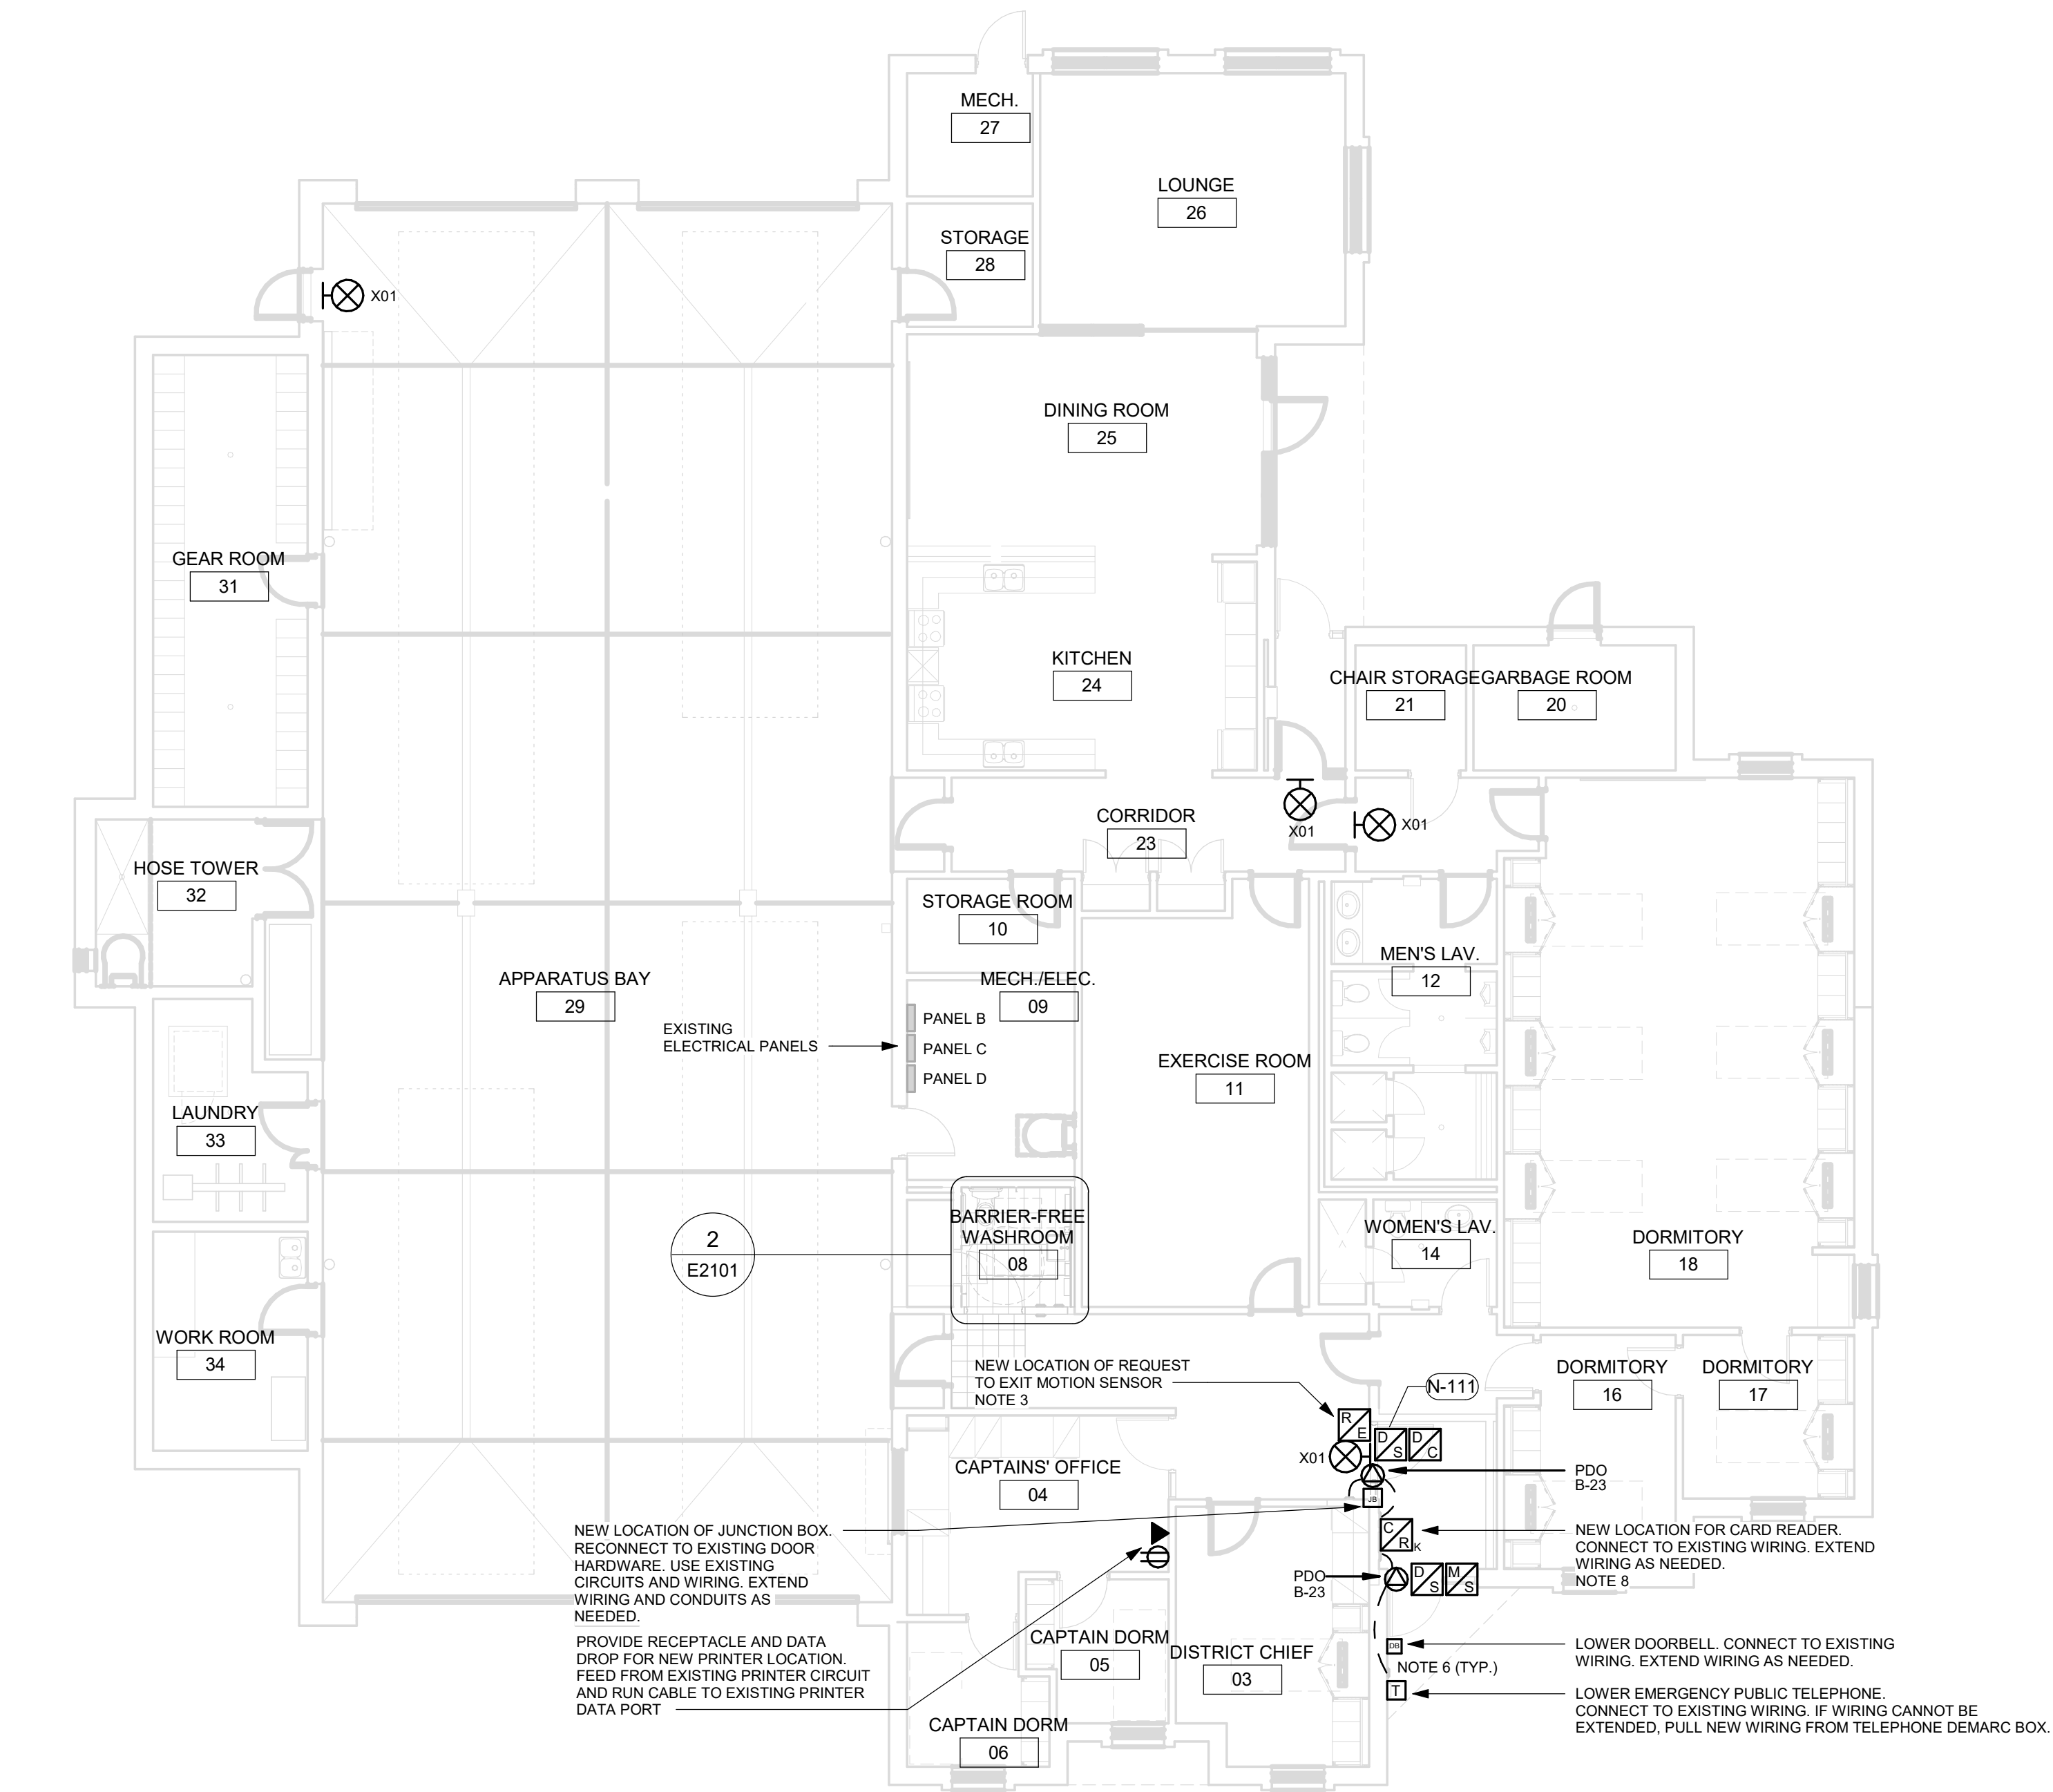
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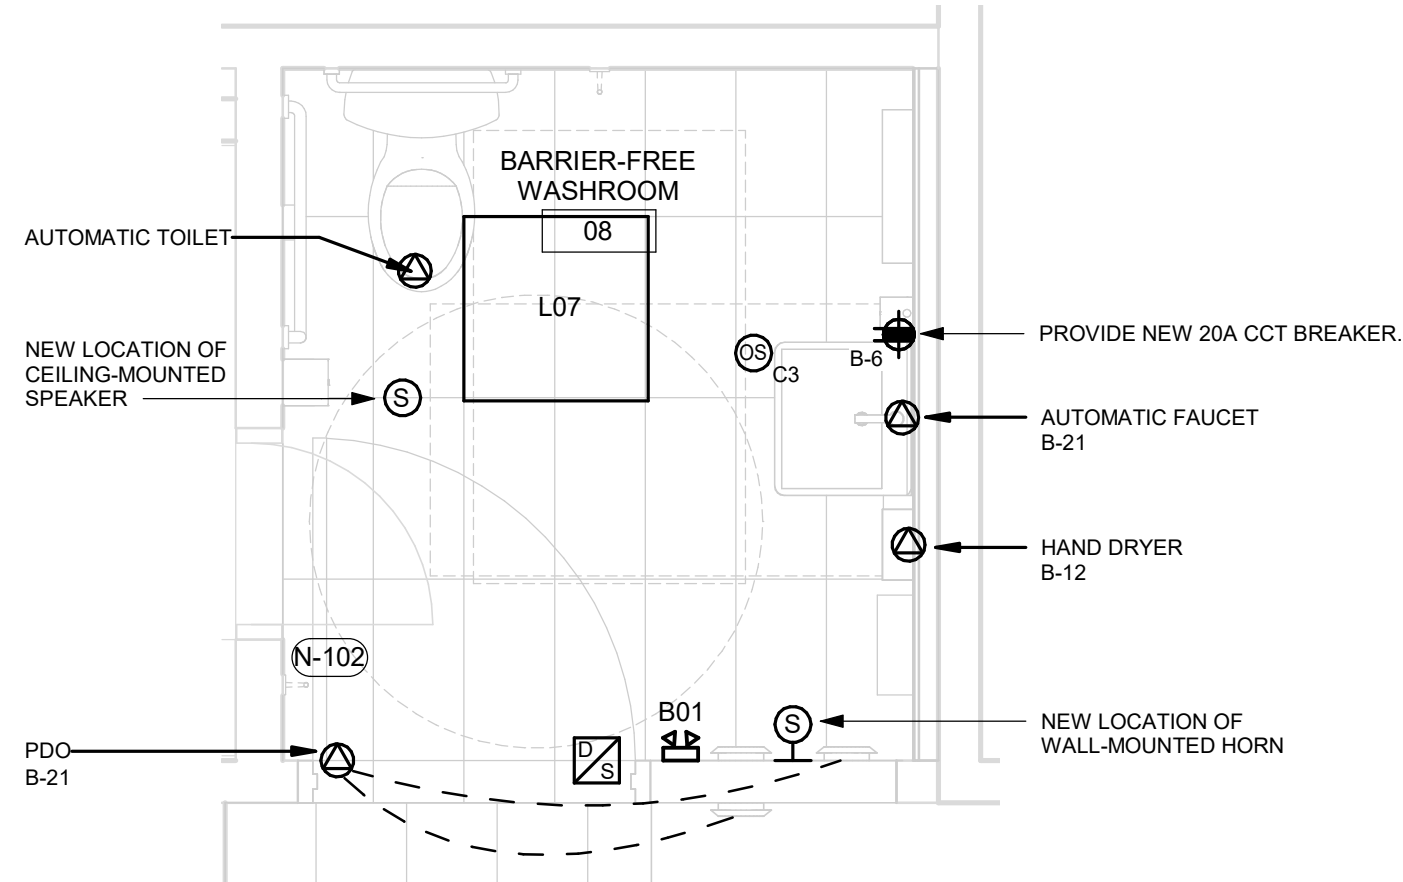
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ELECTRICAL  
DEMOLITION PLAN 1ST  
FLOOR

SHEET NUMBER  
G28-203-E1101  
ISSUE  
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1 POWER AND SYSTEMS PLAN FIRST FLOOR  
E2101 Scale: 1 : 100


- NOTES:**
- CIRCUIT NUMBERS SHOWN FOR GROUPING PURPOSES ONLY. ALLOCATE CIRCUITS TO EXISTING PANELS AS SPACE ALLOWS. ASSUME 15A, 120V CIRCUIT BREAKER UNLESS OTHERWISE NOTED. PROVIDE NEW CIRCUIT BREAKERS COMPATIBLE WITH EATON PANEL. UPDATE PANEL SCHEDULE WITH NEW LOADS. SUBMIT NEW PANEL SCHEDULE AS SHOP DRAWING.
  - CONNECT NEW LUMINAIRES TO EXISTING LOCAL LIGHTING CIRCUIT.
  - RECONNECT ALL NEW DOOR HARDWARE TO EXISTING WIRING. EXTEND WIRING AND CONDUITS AS NEEDED.
  - CONNECT NEW POWER RECEPTACLES TO EXISTING LOCAL RECEPTACLE CIRCUIT. UNLESS OTHERWISE NOTED. EXTEND WIRING AND CONDUITS AS NEEDED. CONNECT DATA OUTLETS TO EXISTING SOURCE. UNLESS OTHERWISE NOTED. PULL NEW WIRING FROM SOURCE. MOUNT POWER AND DATA OUTLETS ACCORDING TO MOUNTING HEIGHTS SCHEDULE ON SHEET GAL-G4003.
  - REMOVE AND REPLACE ALL EXIT SIGNS WITH LUMINAIRE TYPE X01 AS SPECIFIED IN LUMINAIRE SCHEDULE. CONNECT TO EXISTING CIRCUITS.
  - MOUNT PUBLIC EMERGENCY TELEPHONE AND DOORBELL AT 1050mm AFF FROM CENTER OF DEVICE. CONNECT TO EXISTING CIRCUITS. EXTEND WIRING AND CONDUITS AS NEEDED.
  - CONNECT ANY RELOCATED EXISTING MECHANICAL EQUIPMENT TO EXISTING CIRCUITS. EXTEND WIRING AND CONDUITS AS NEEDED.
  - MOUNT CARD READERS AT 1050mm AFF. EXISTING WIRING AND CONDUITS TO BE REUSED. EXTEND WIRING AND CONDUITS AS NEEDED. COORDINATE WITH CORPORATE SECURITY BEFORE RELOCATING SECURITY DEVICES.



2 POWER AND SYSTEMS PLAN FIRST FLOOR - BARRIER-FREE WASHROOM  
E2101 Scale: 1 : 25

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
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