


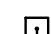





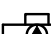
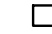










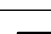


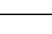
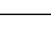



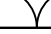

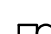
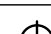
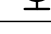


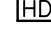
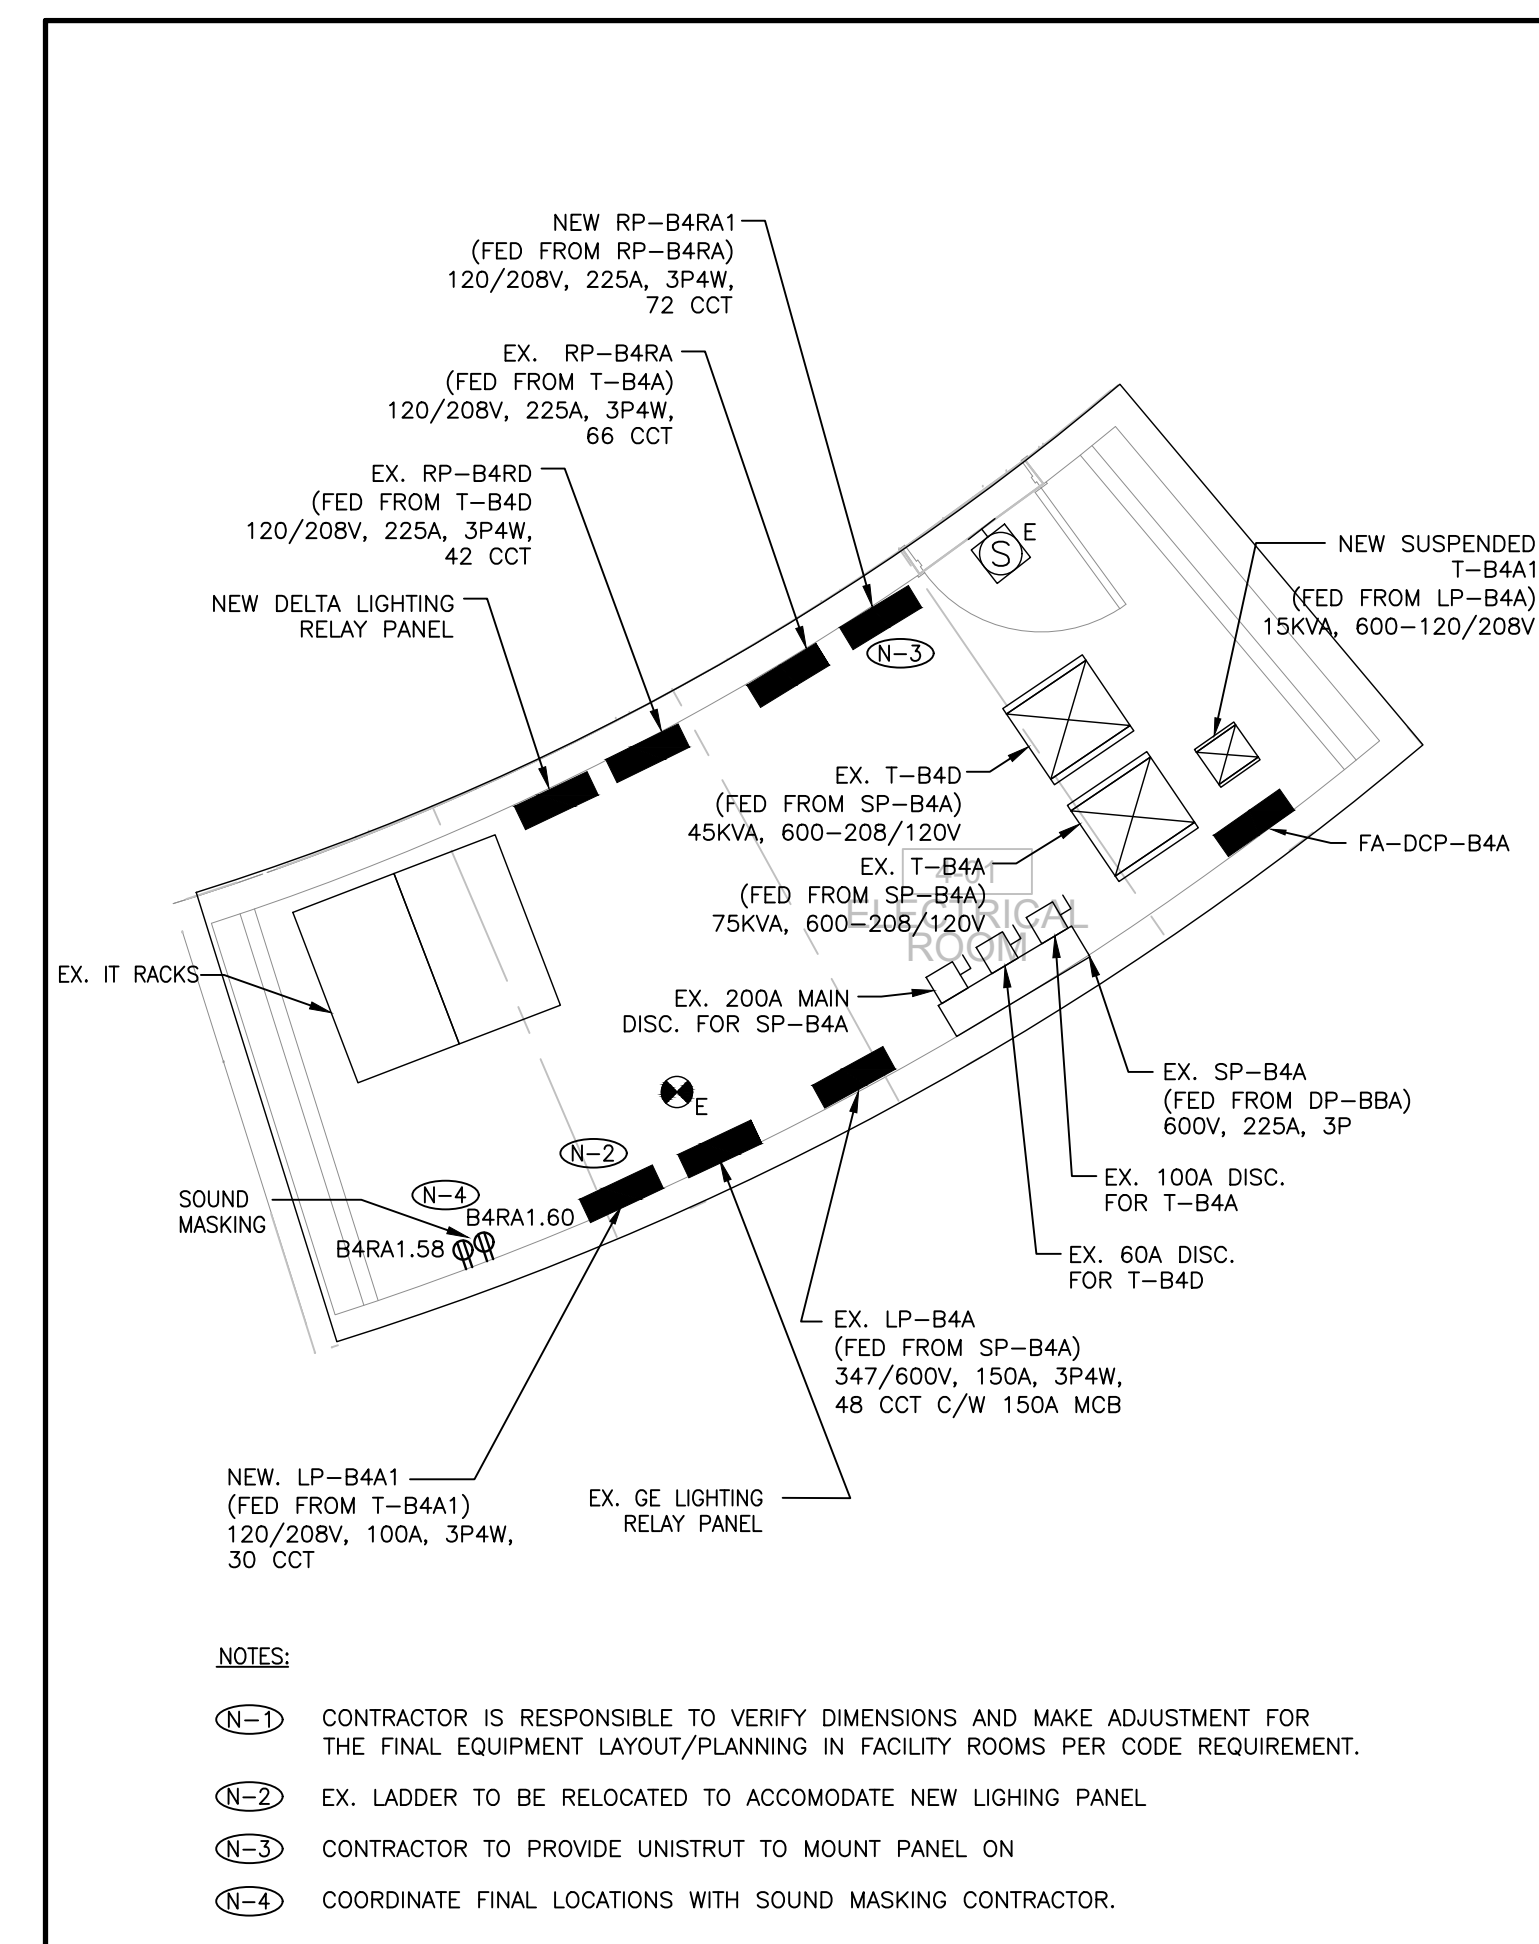
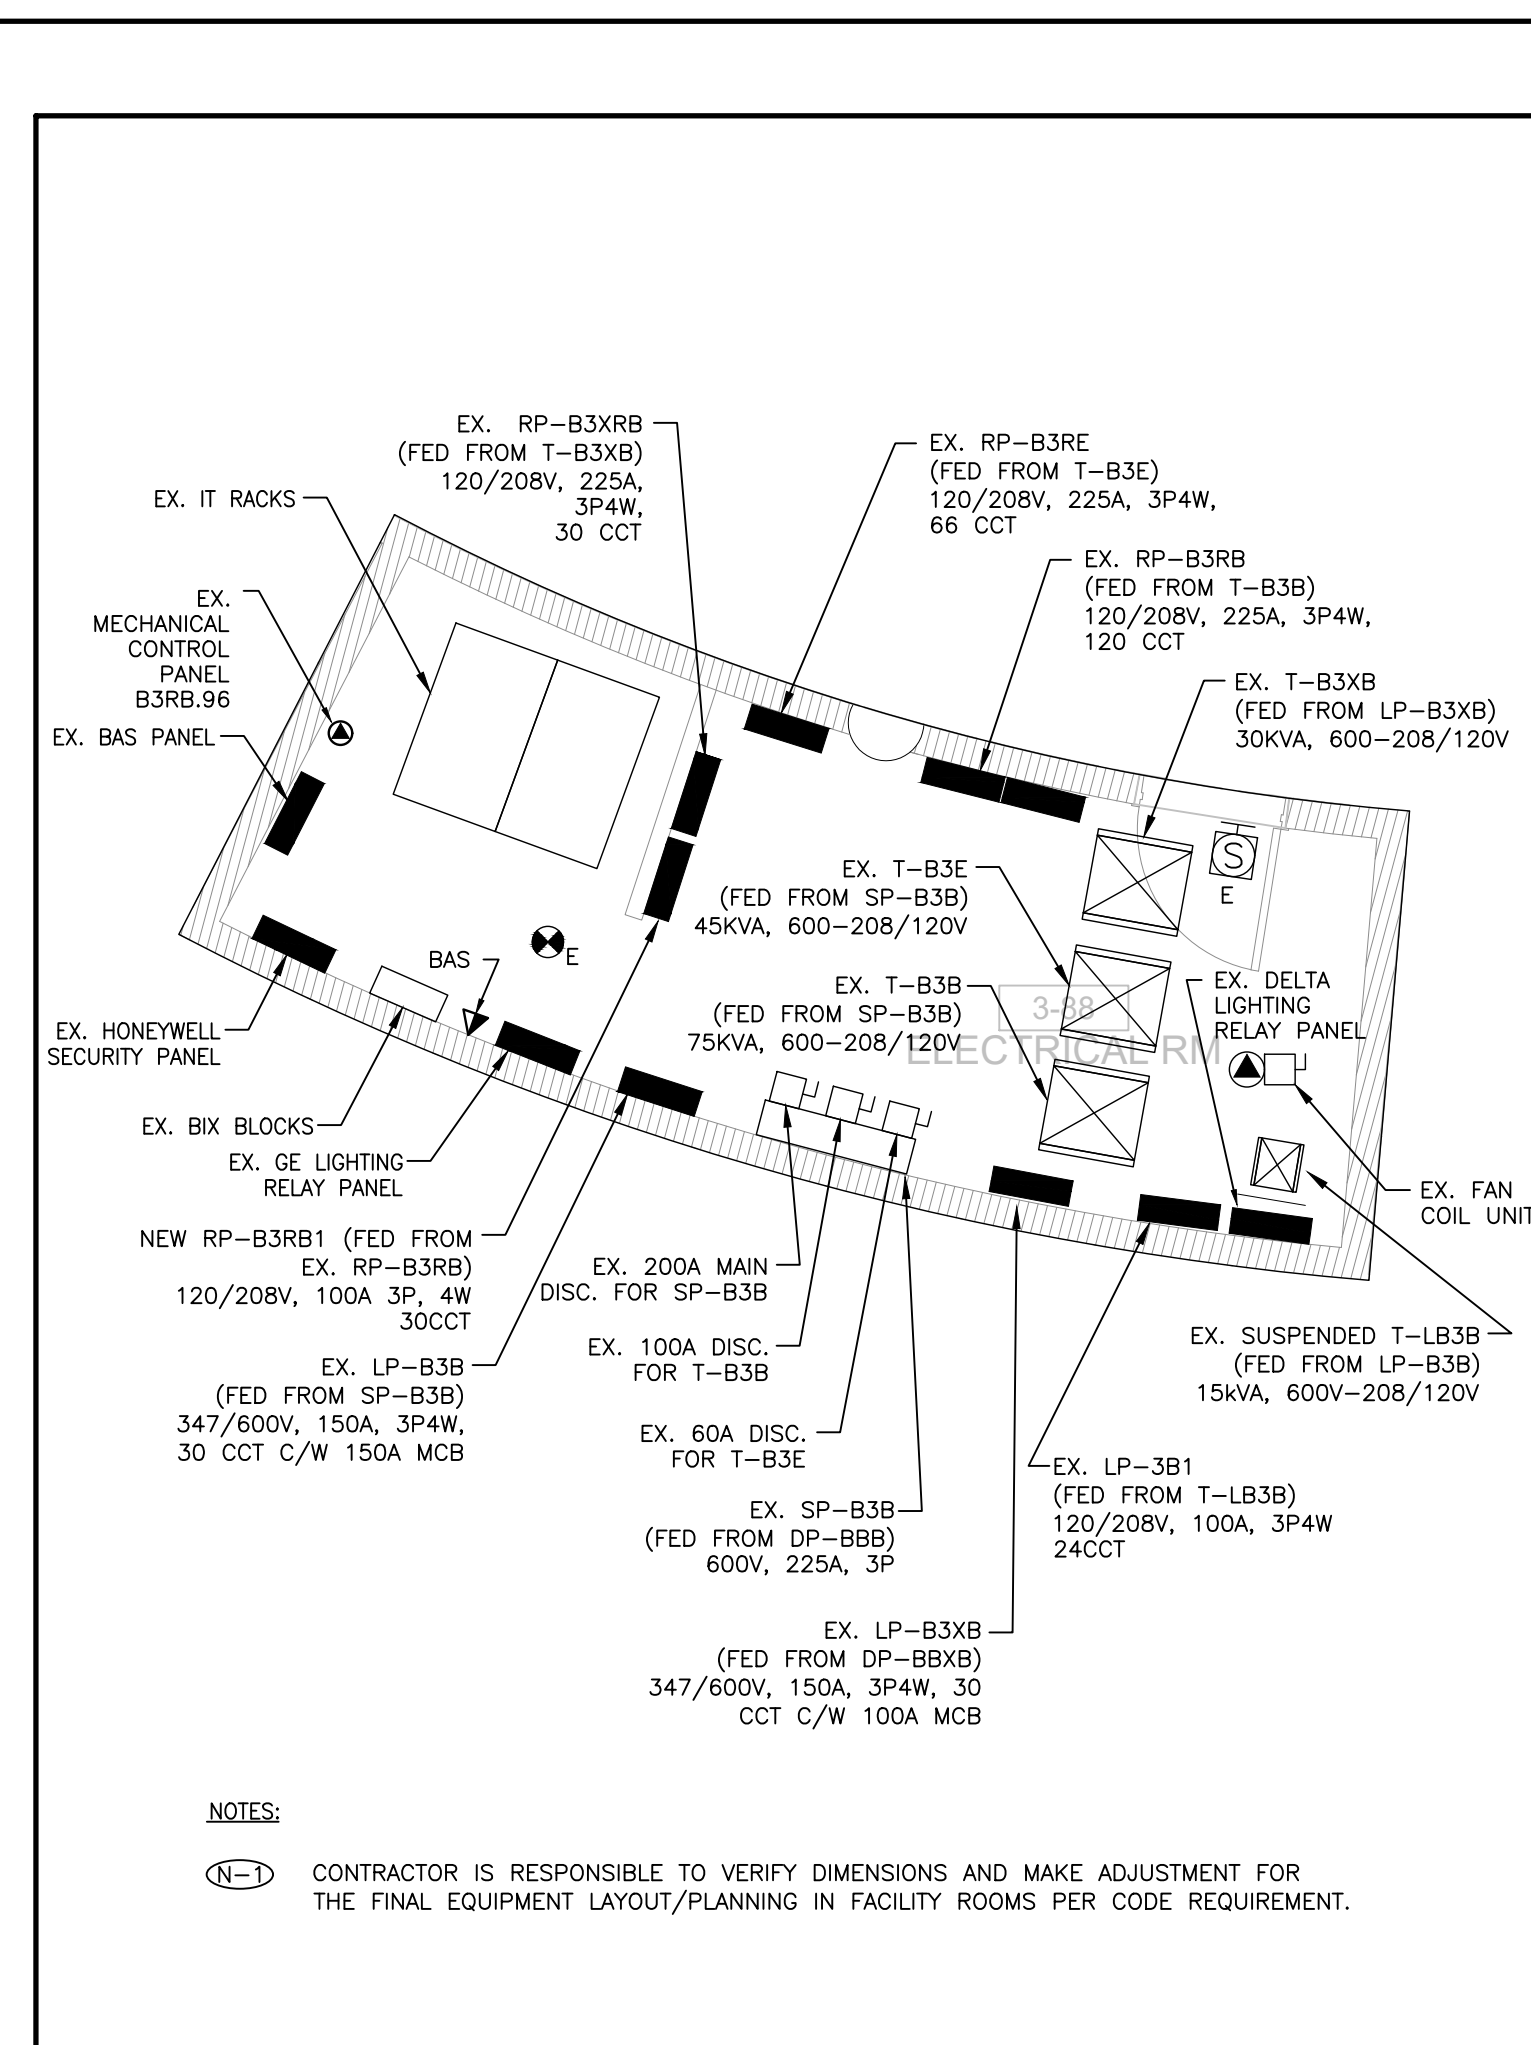
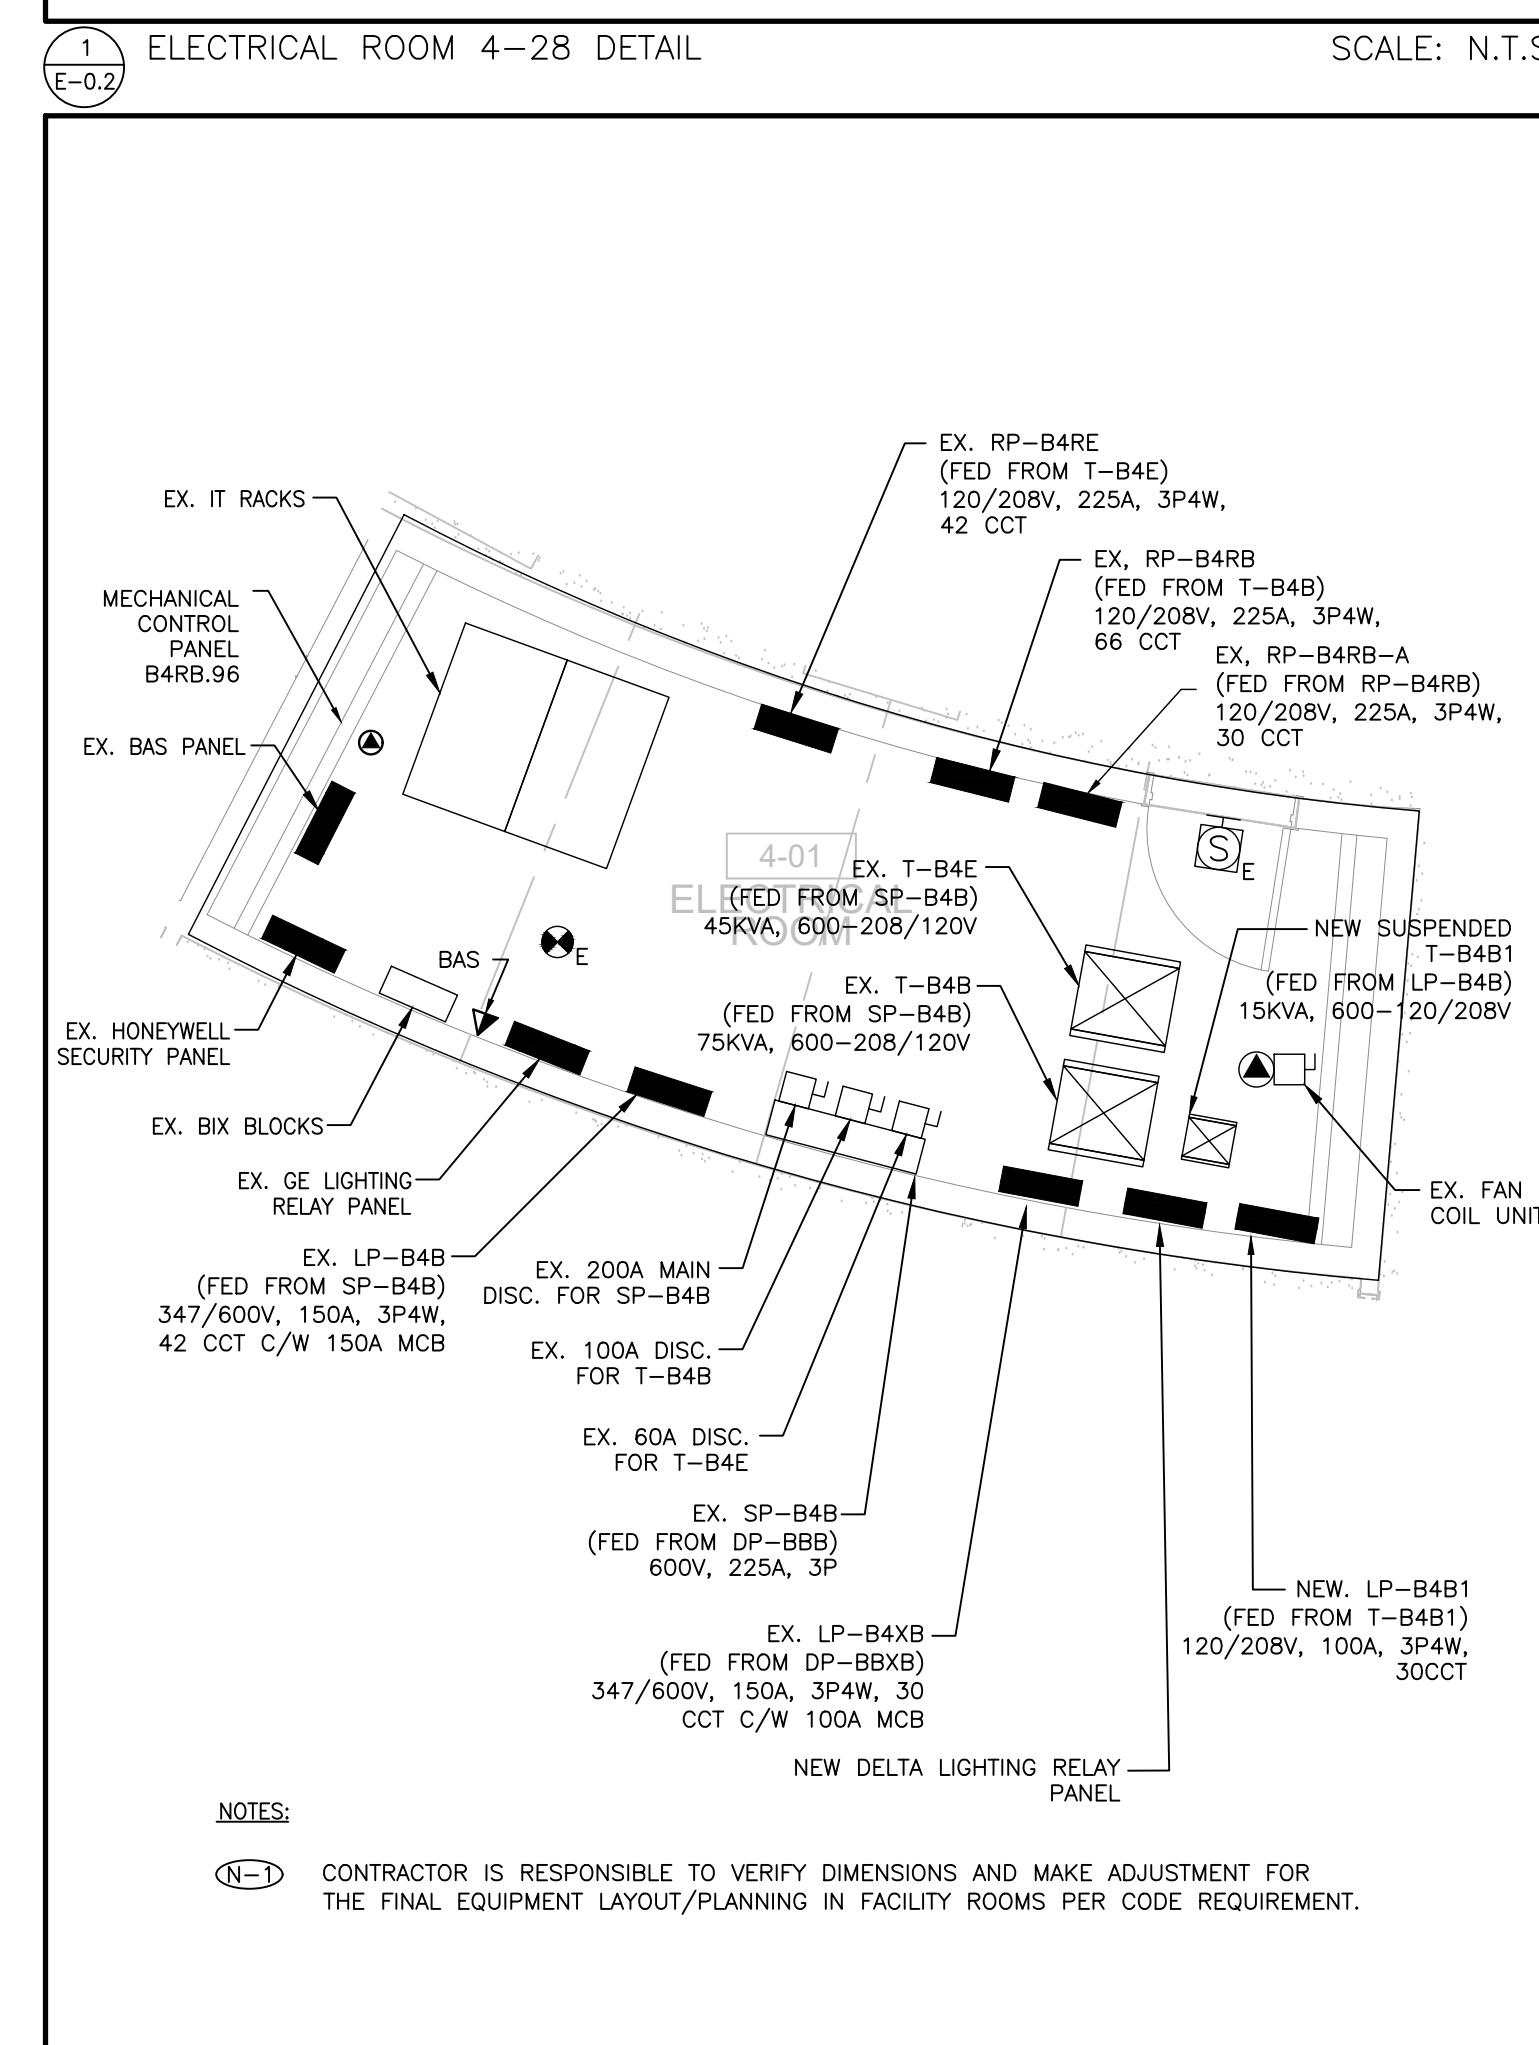
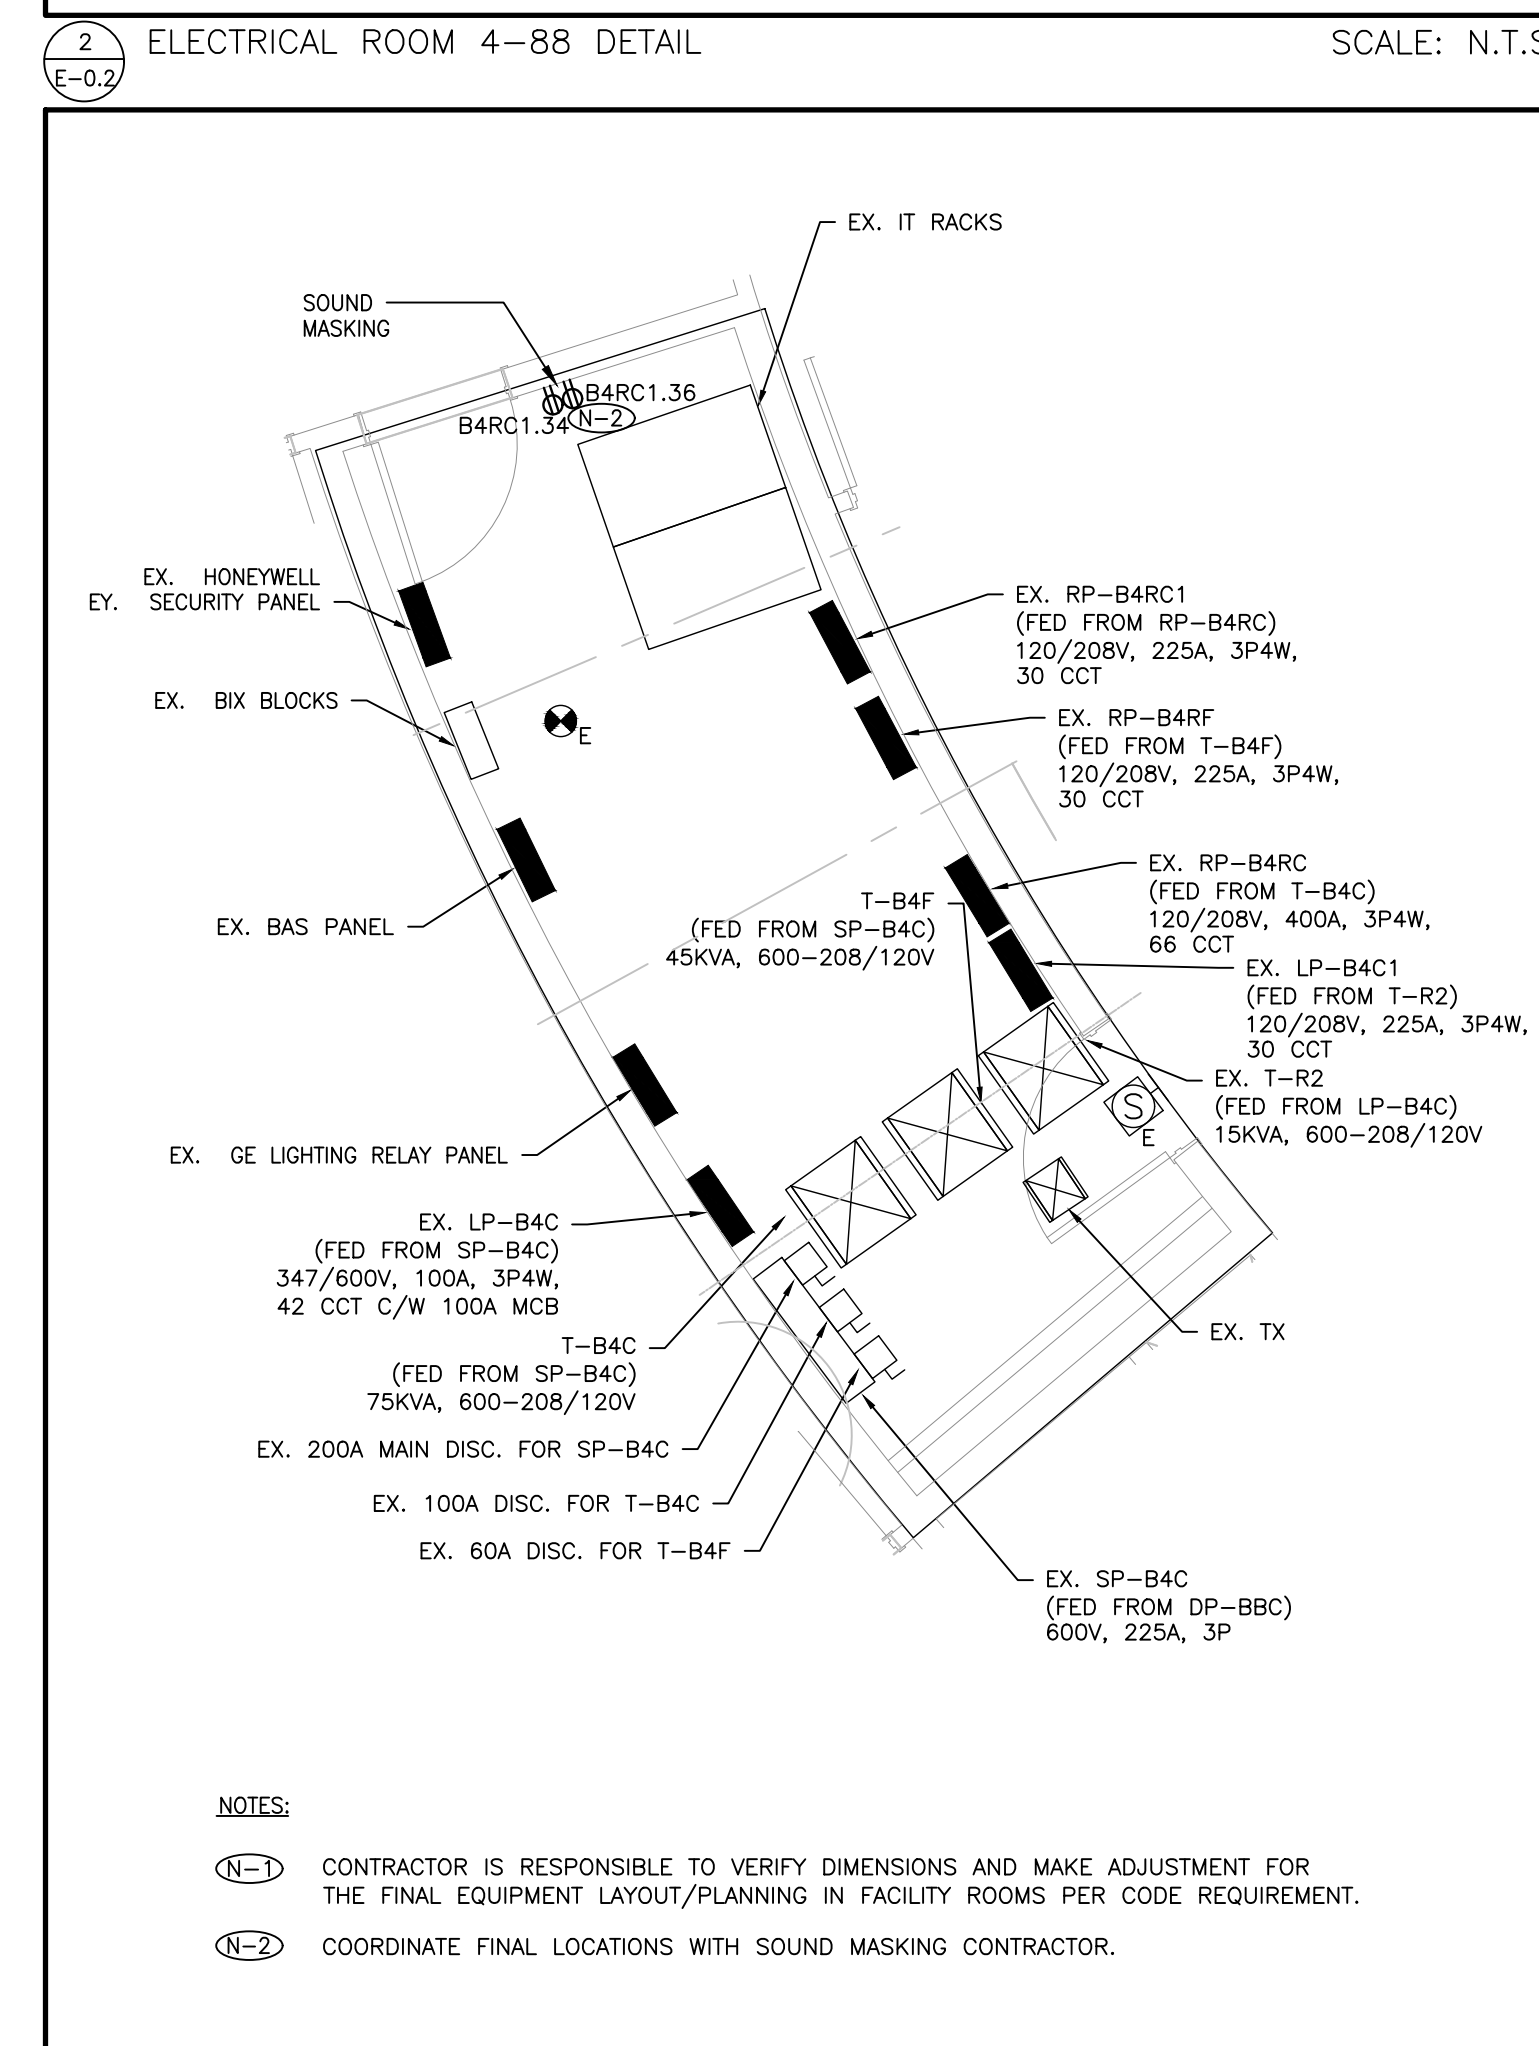
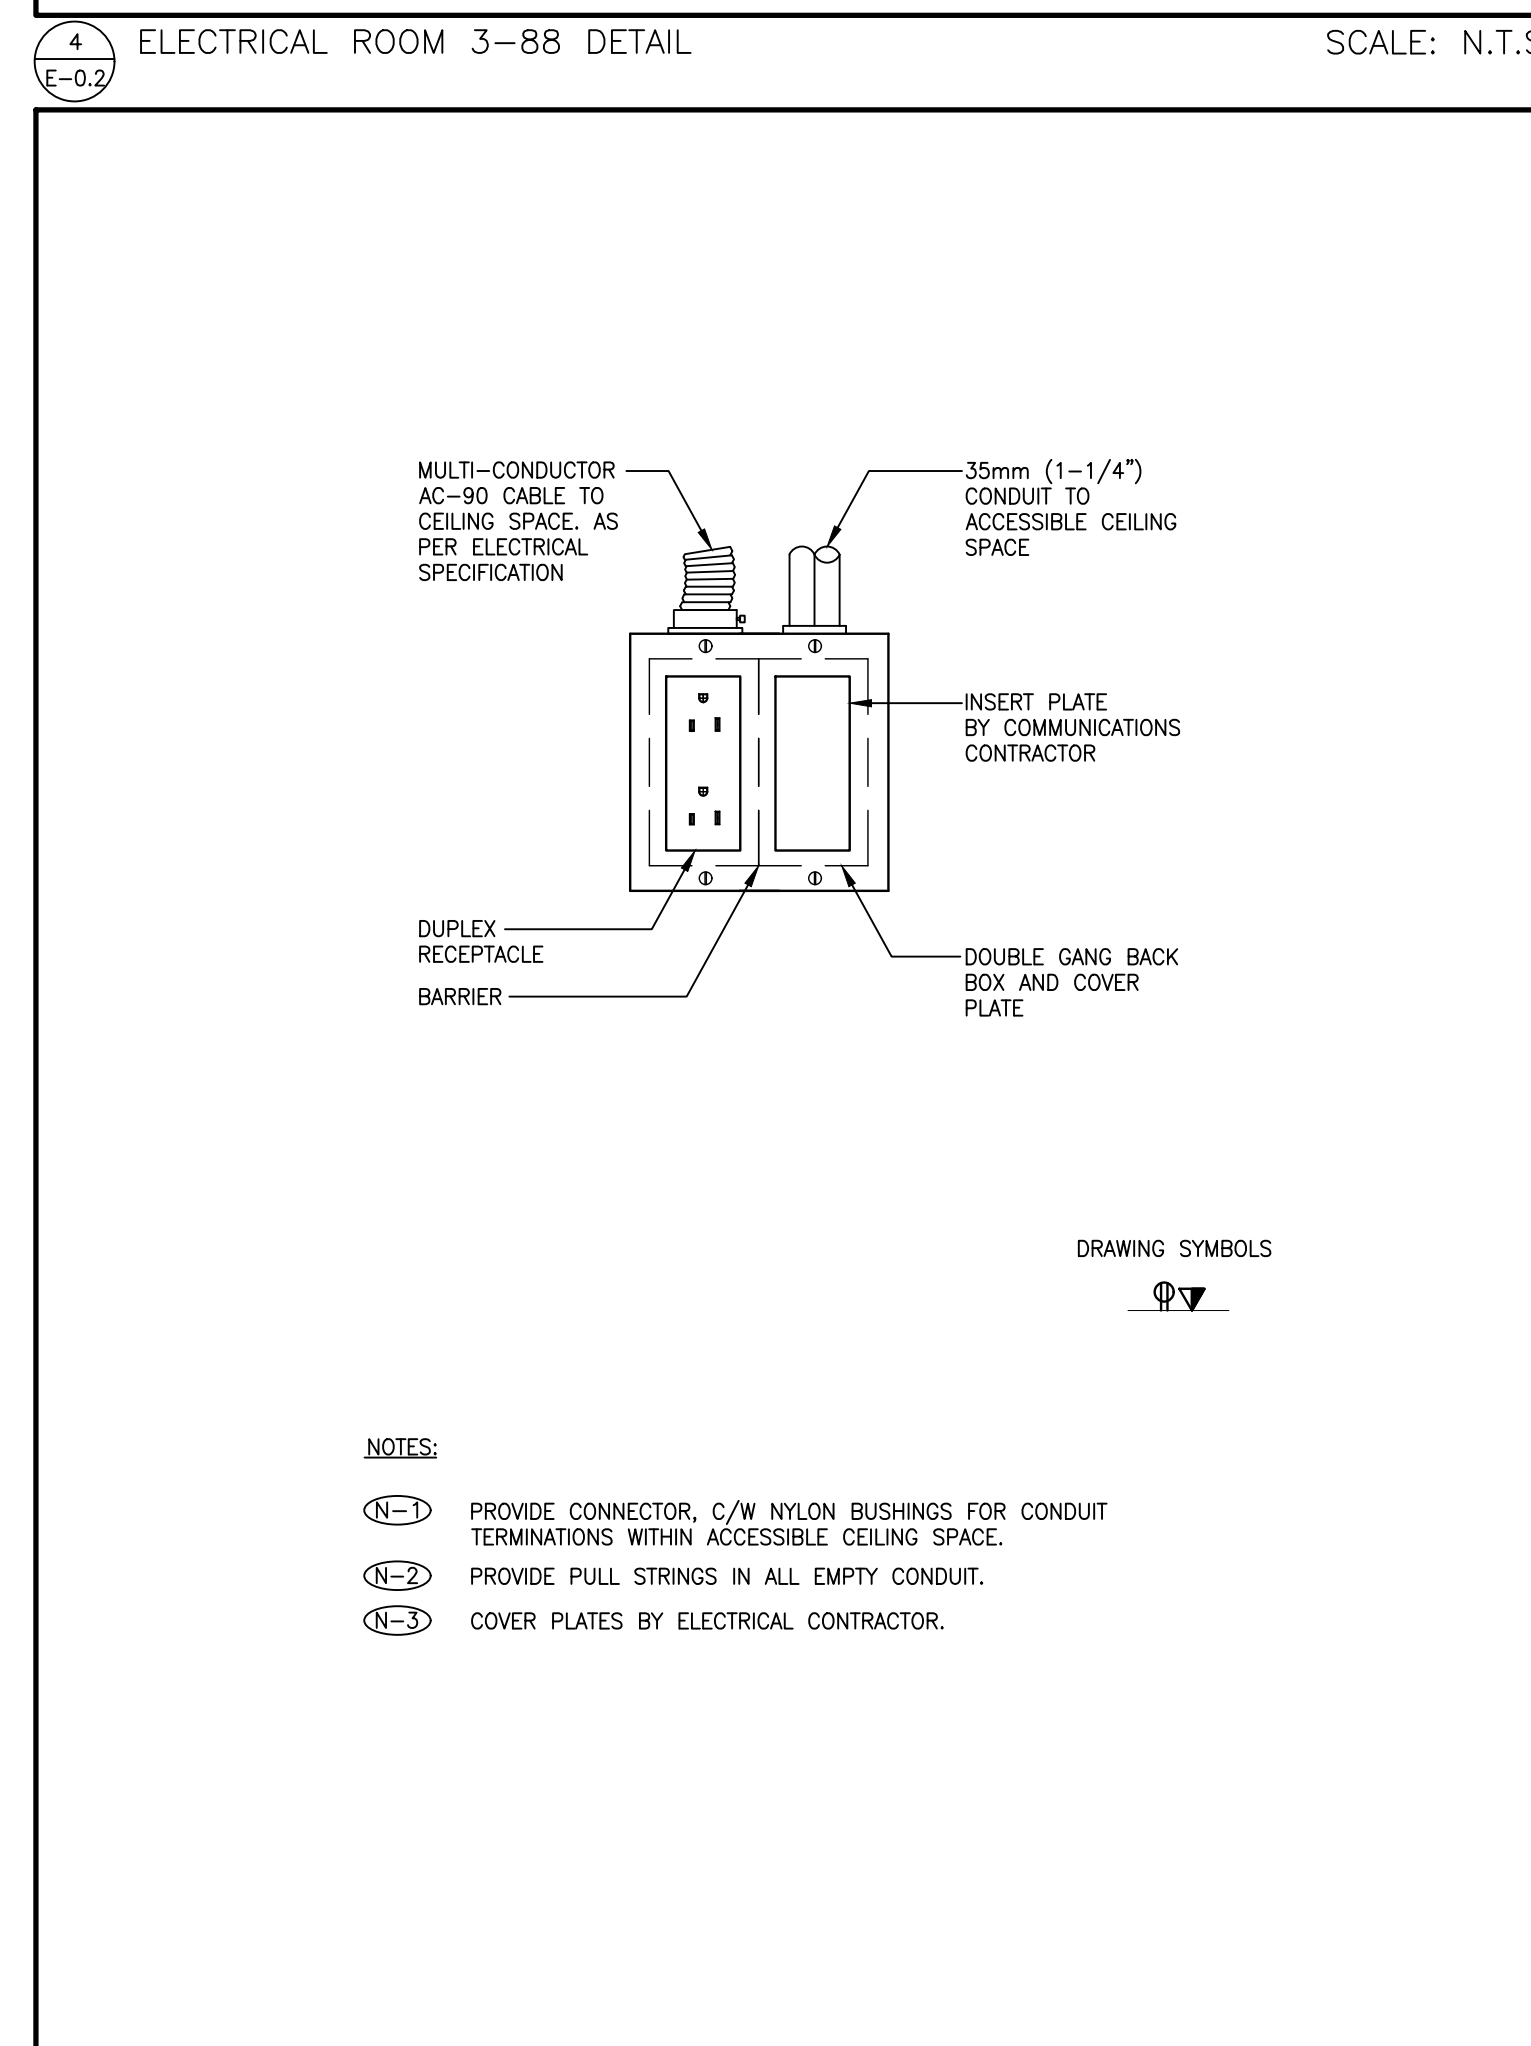
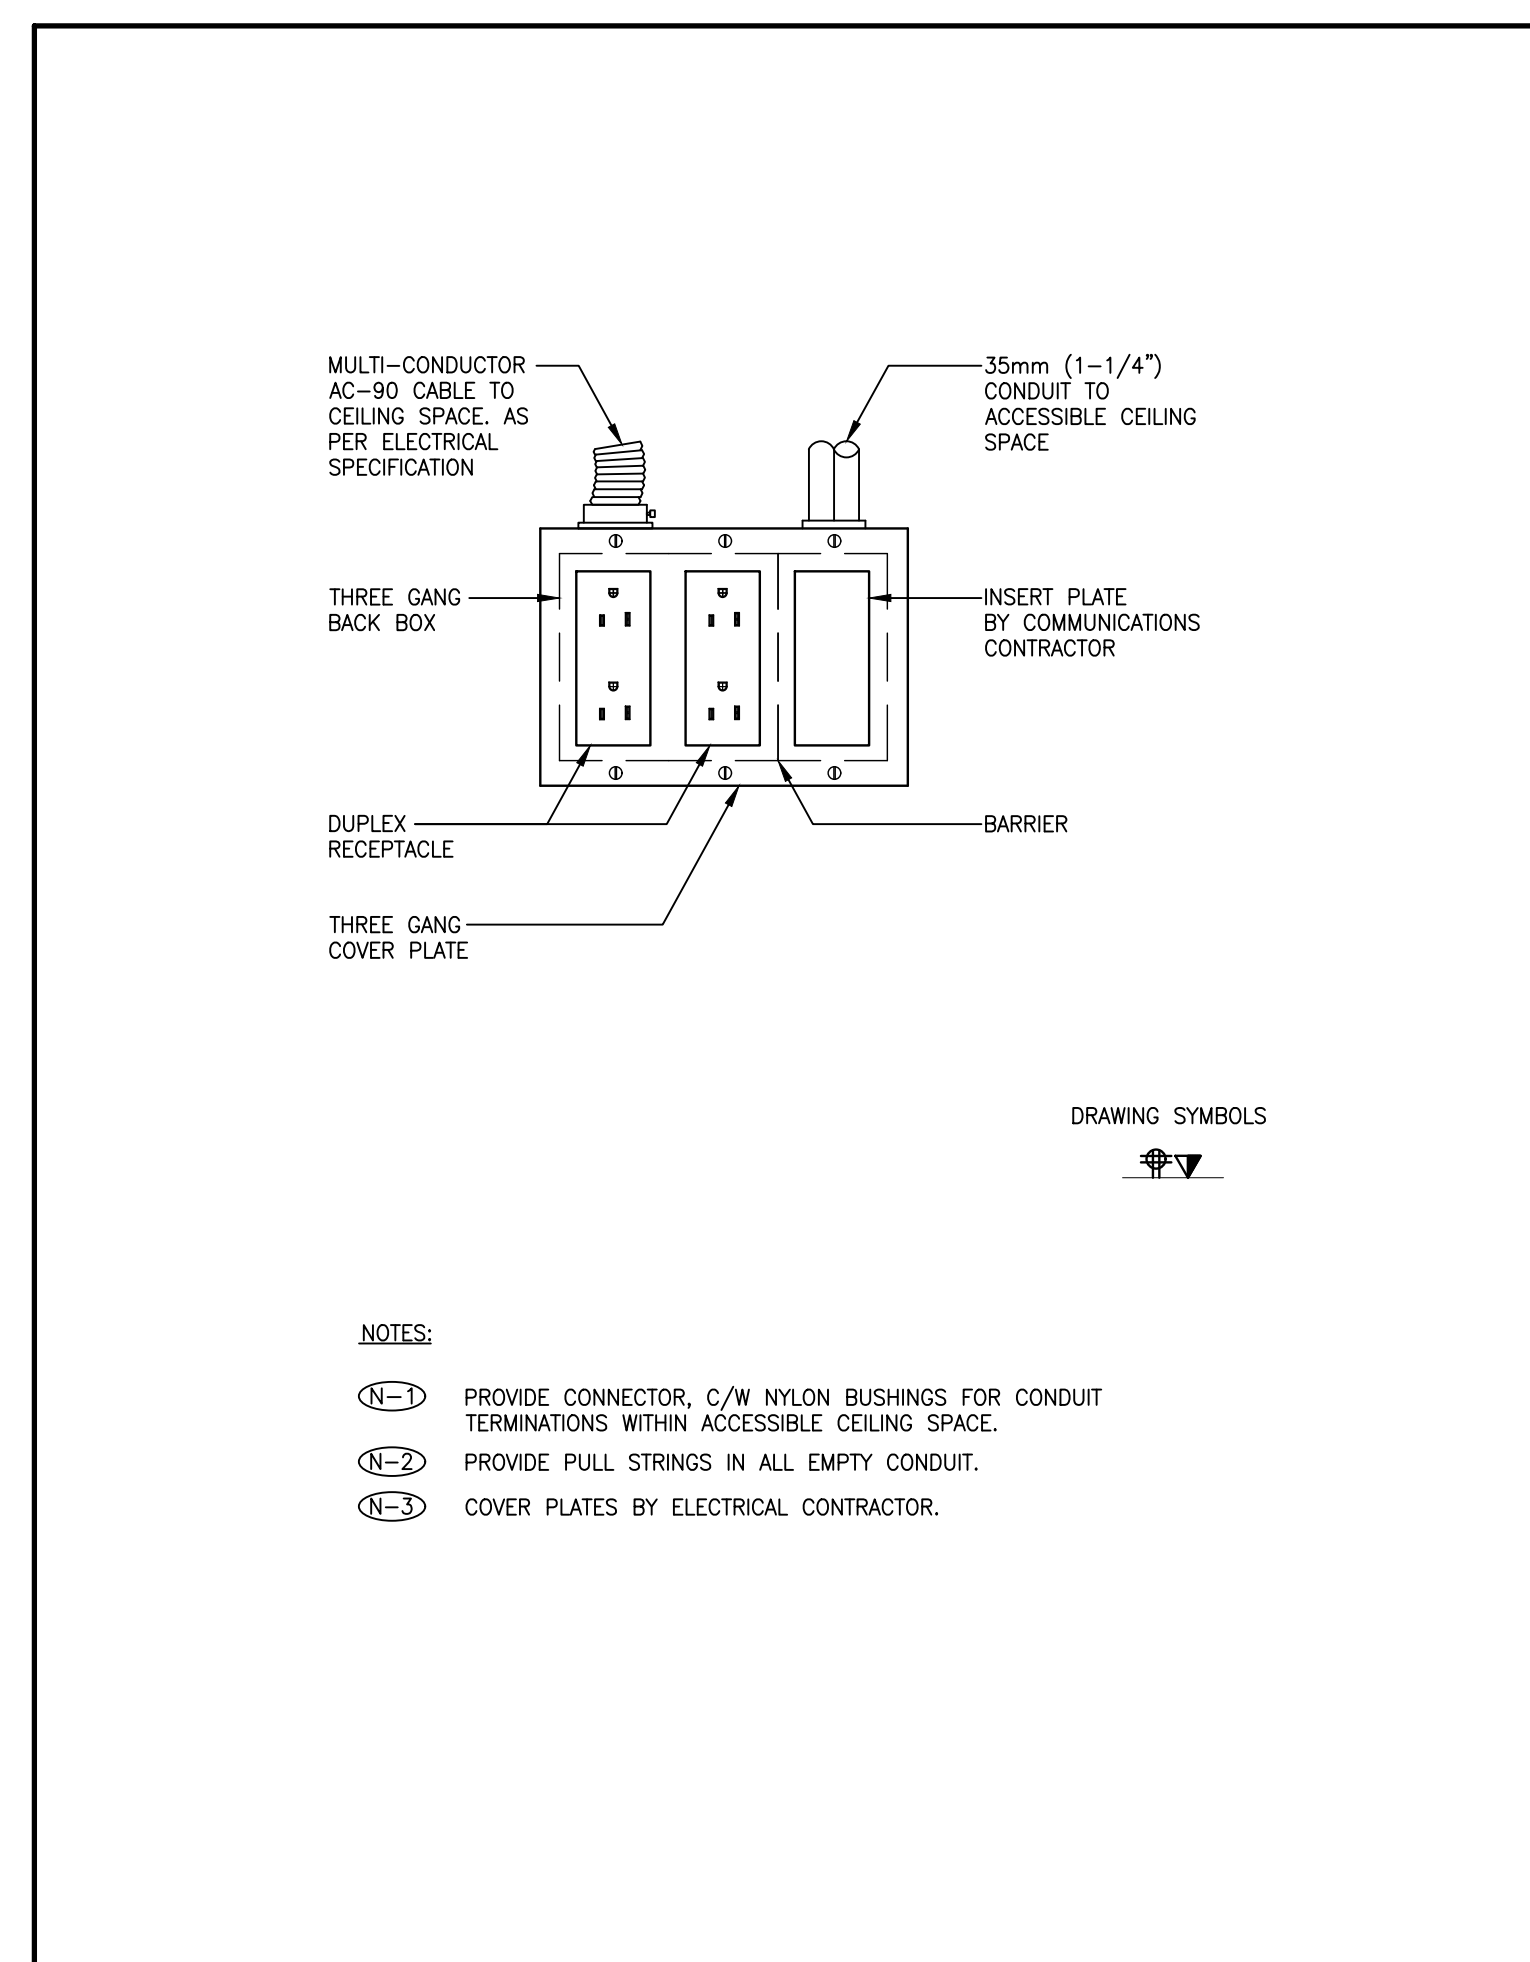
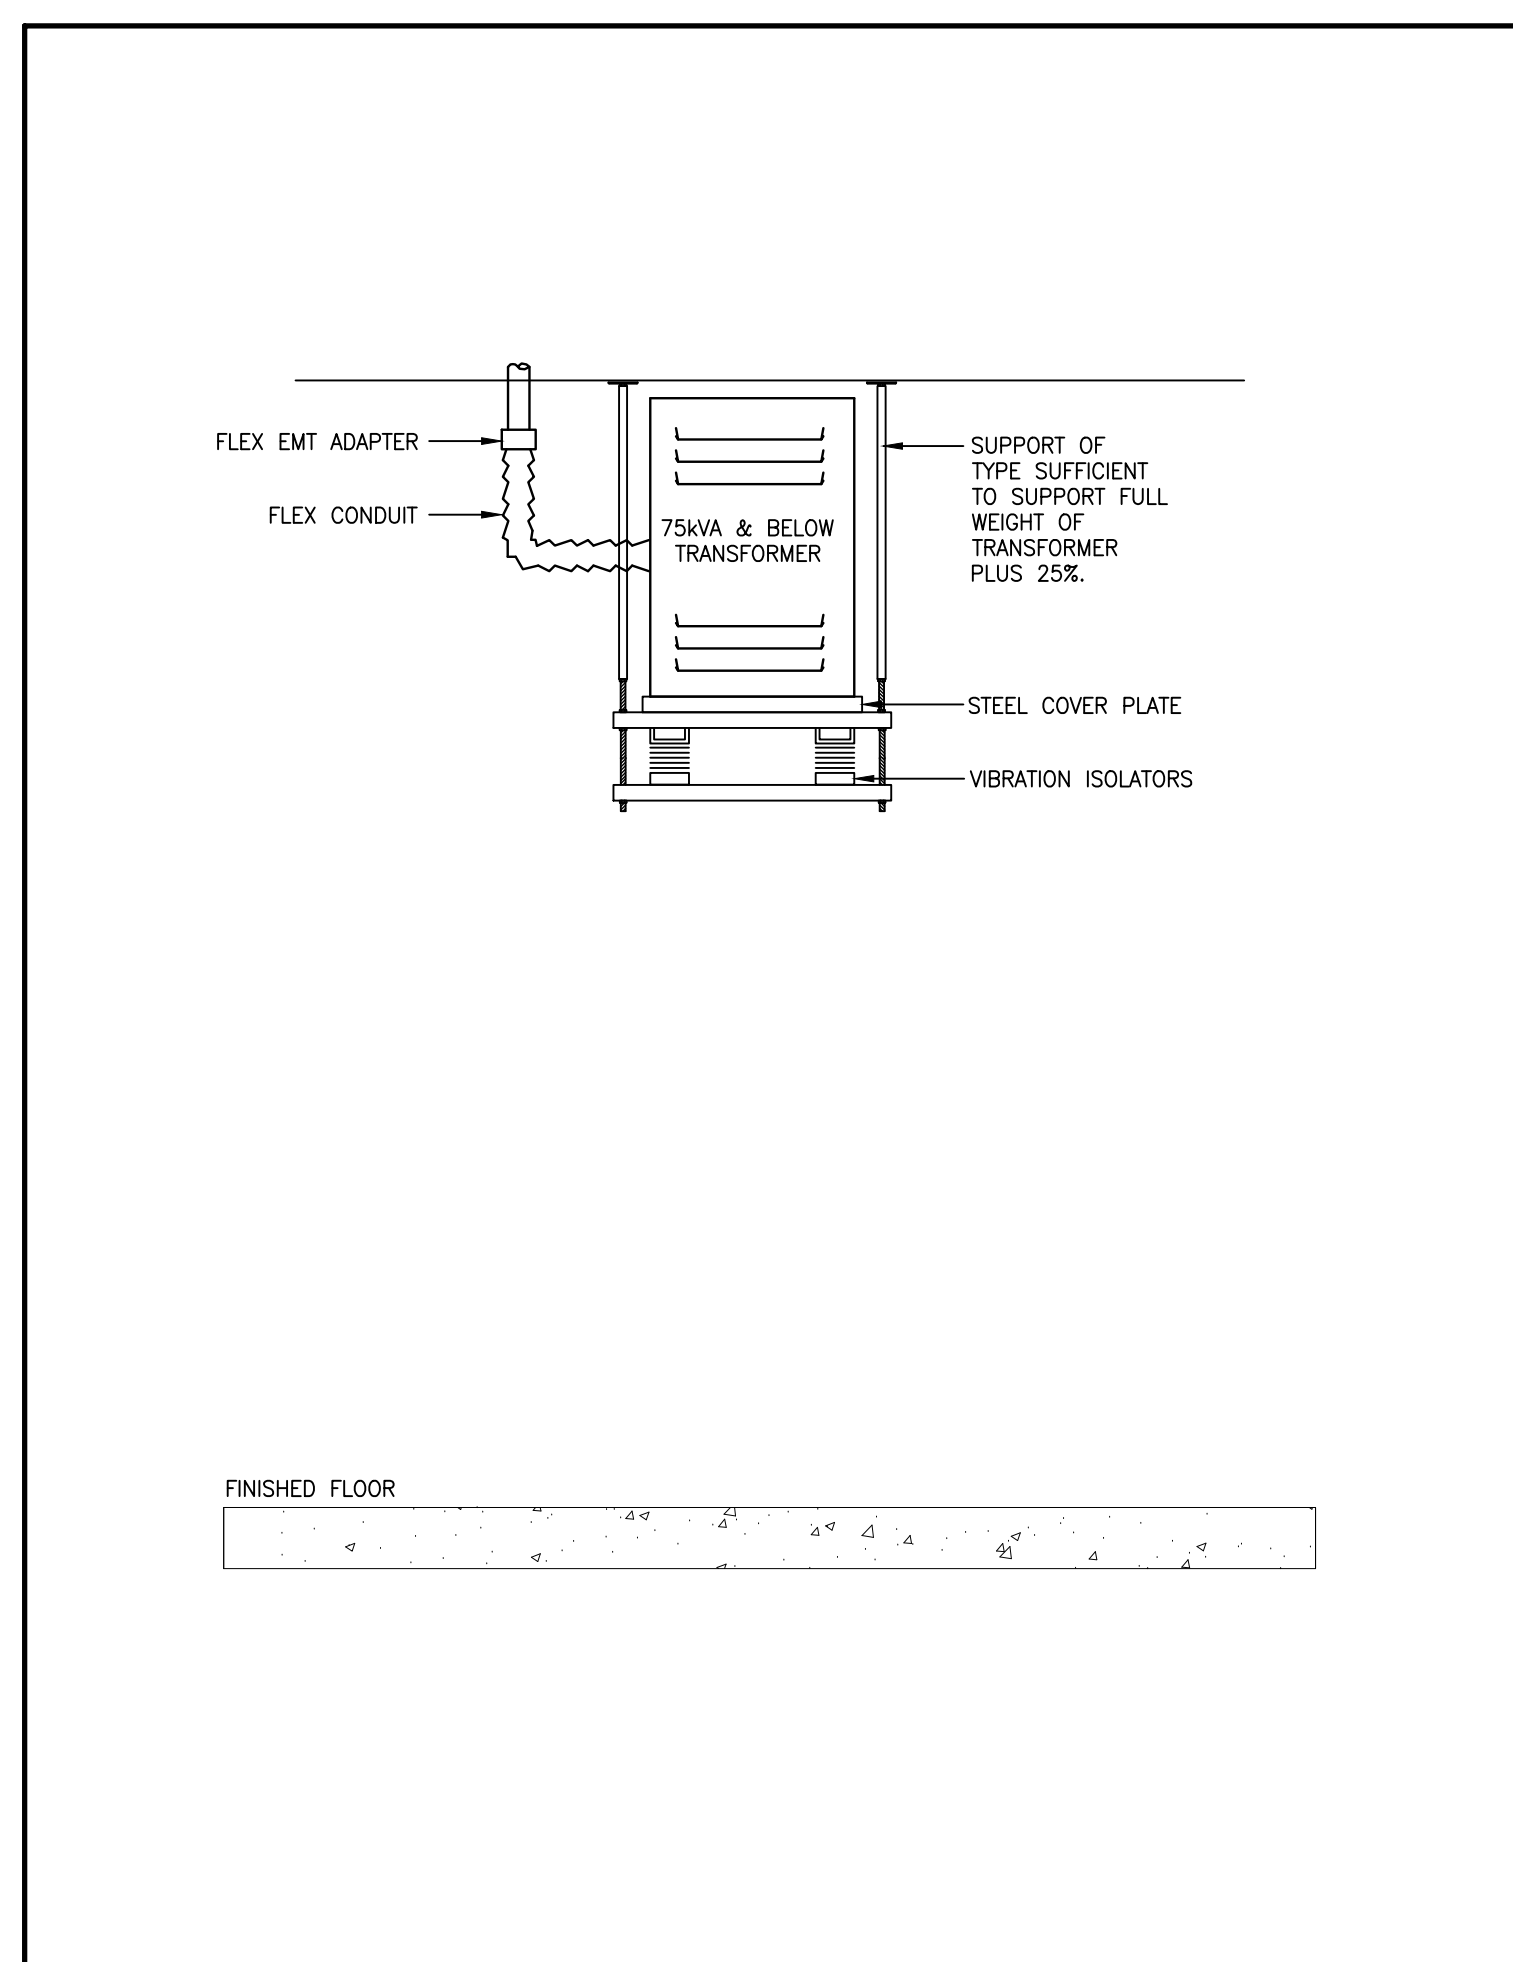
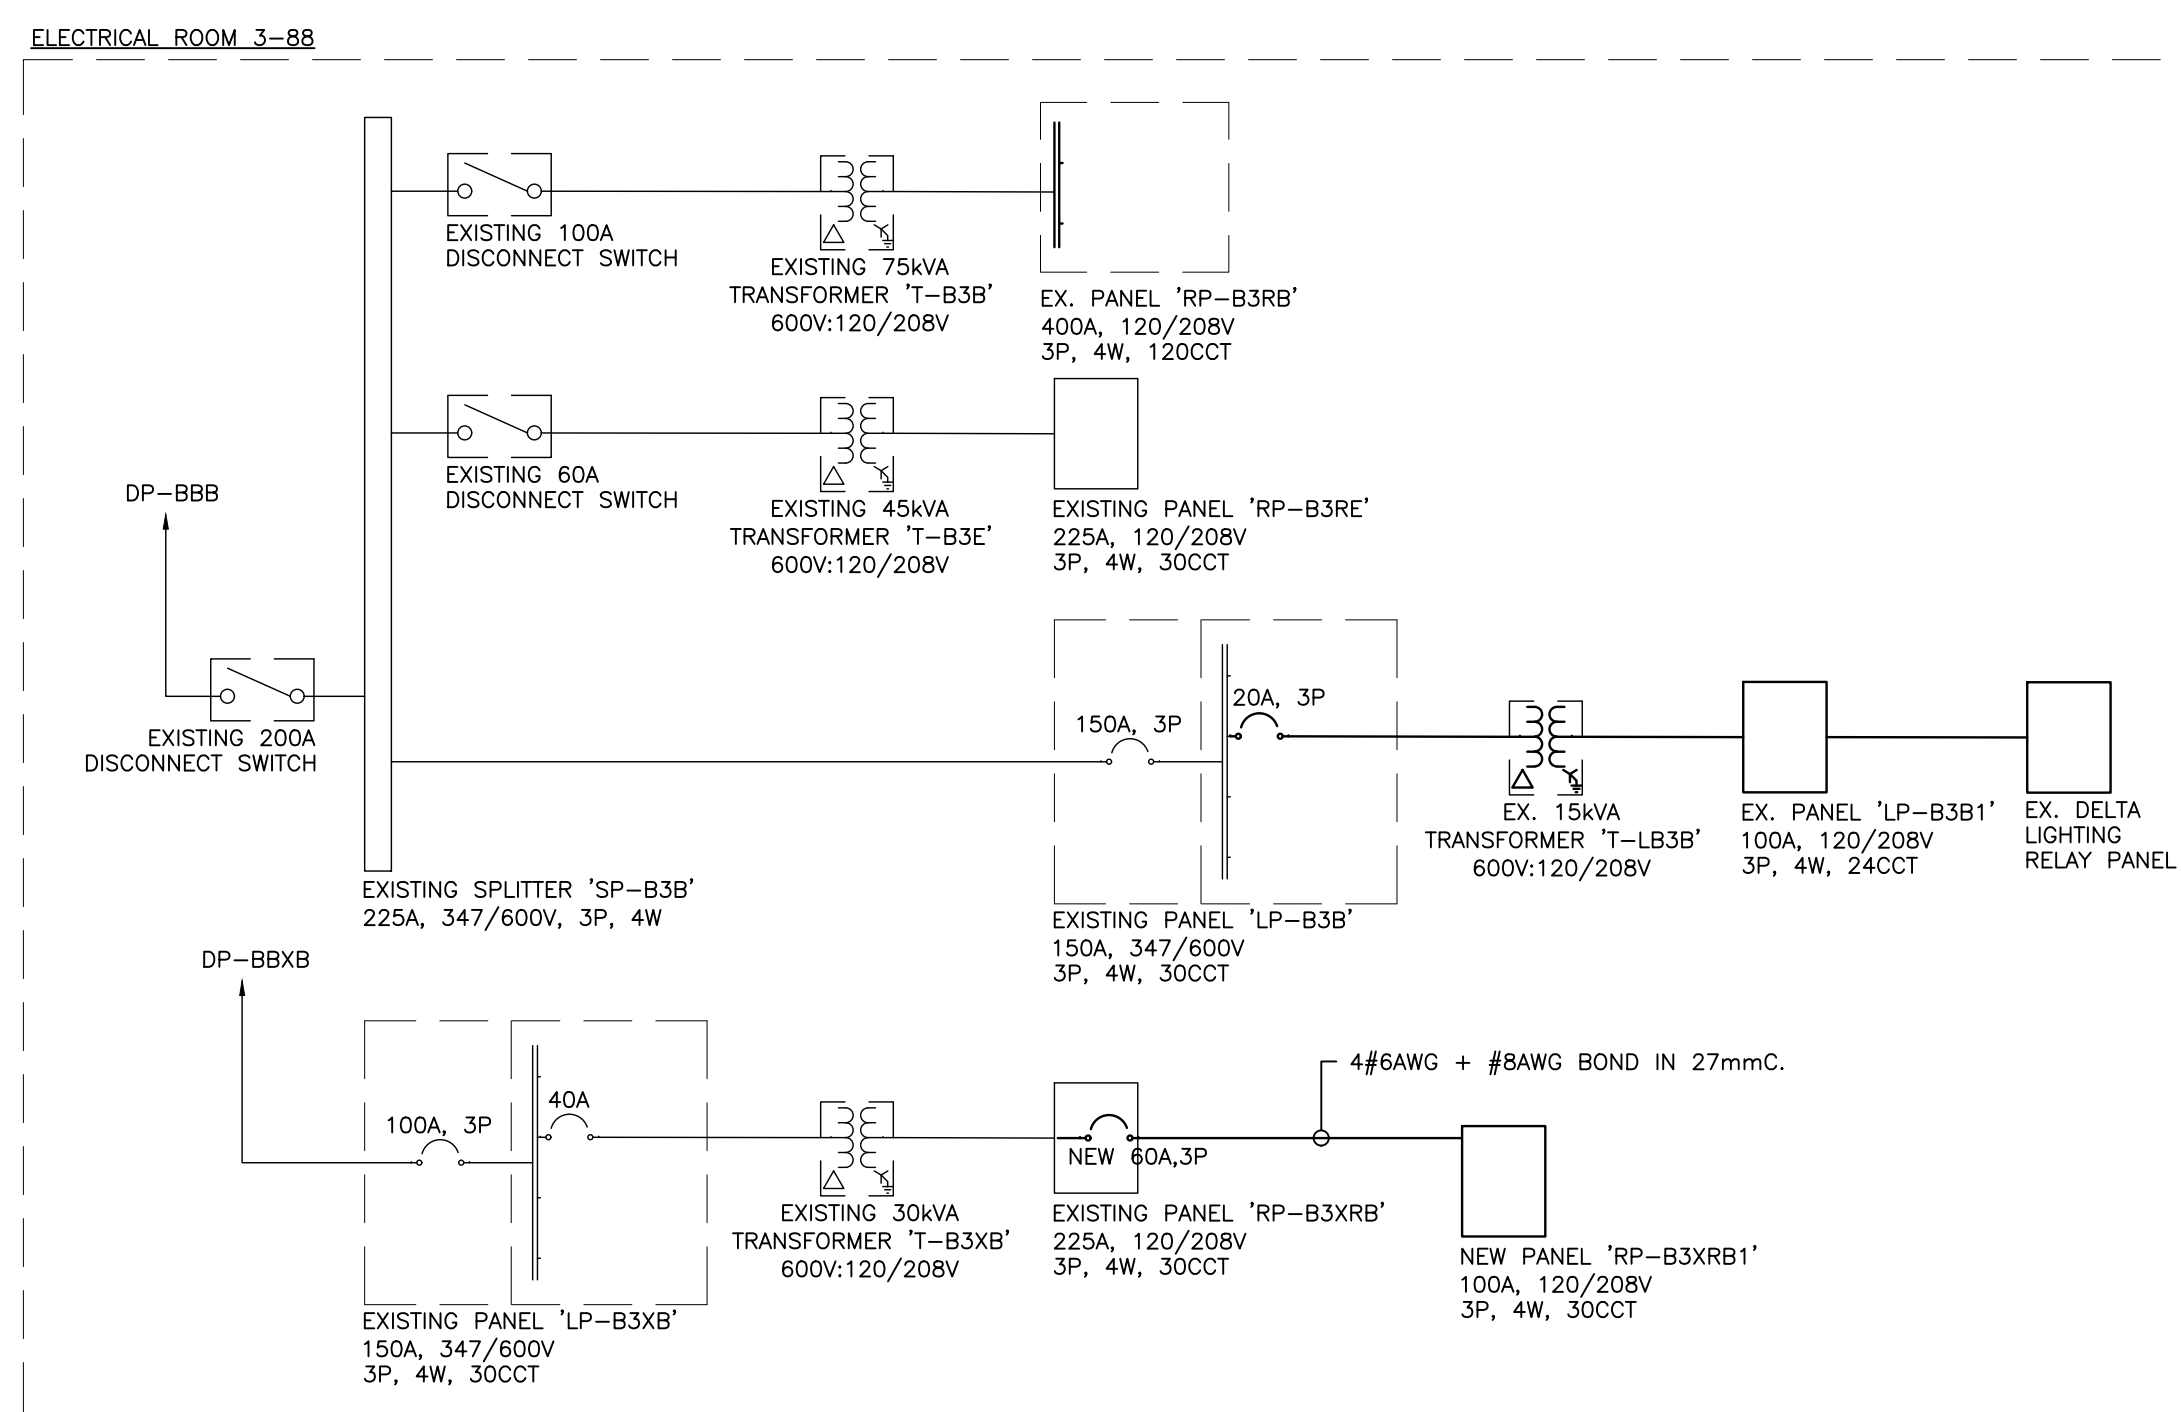
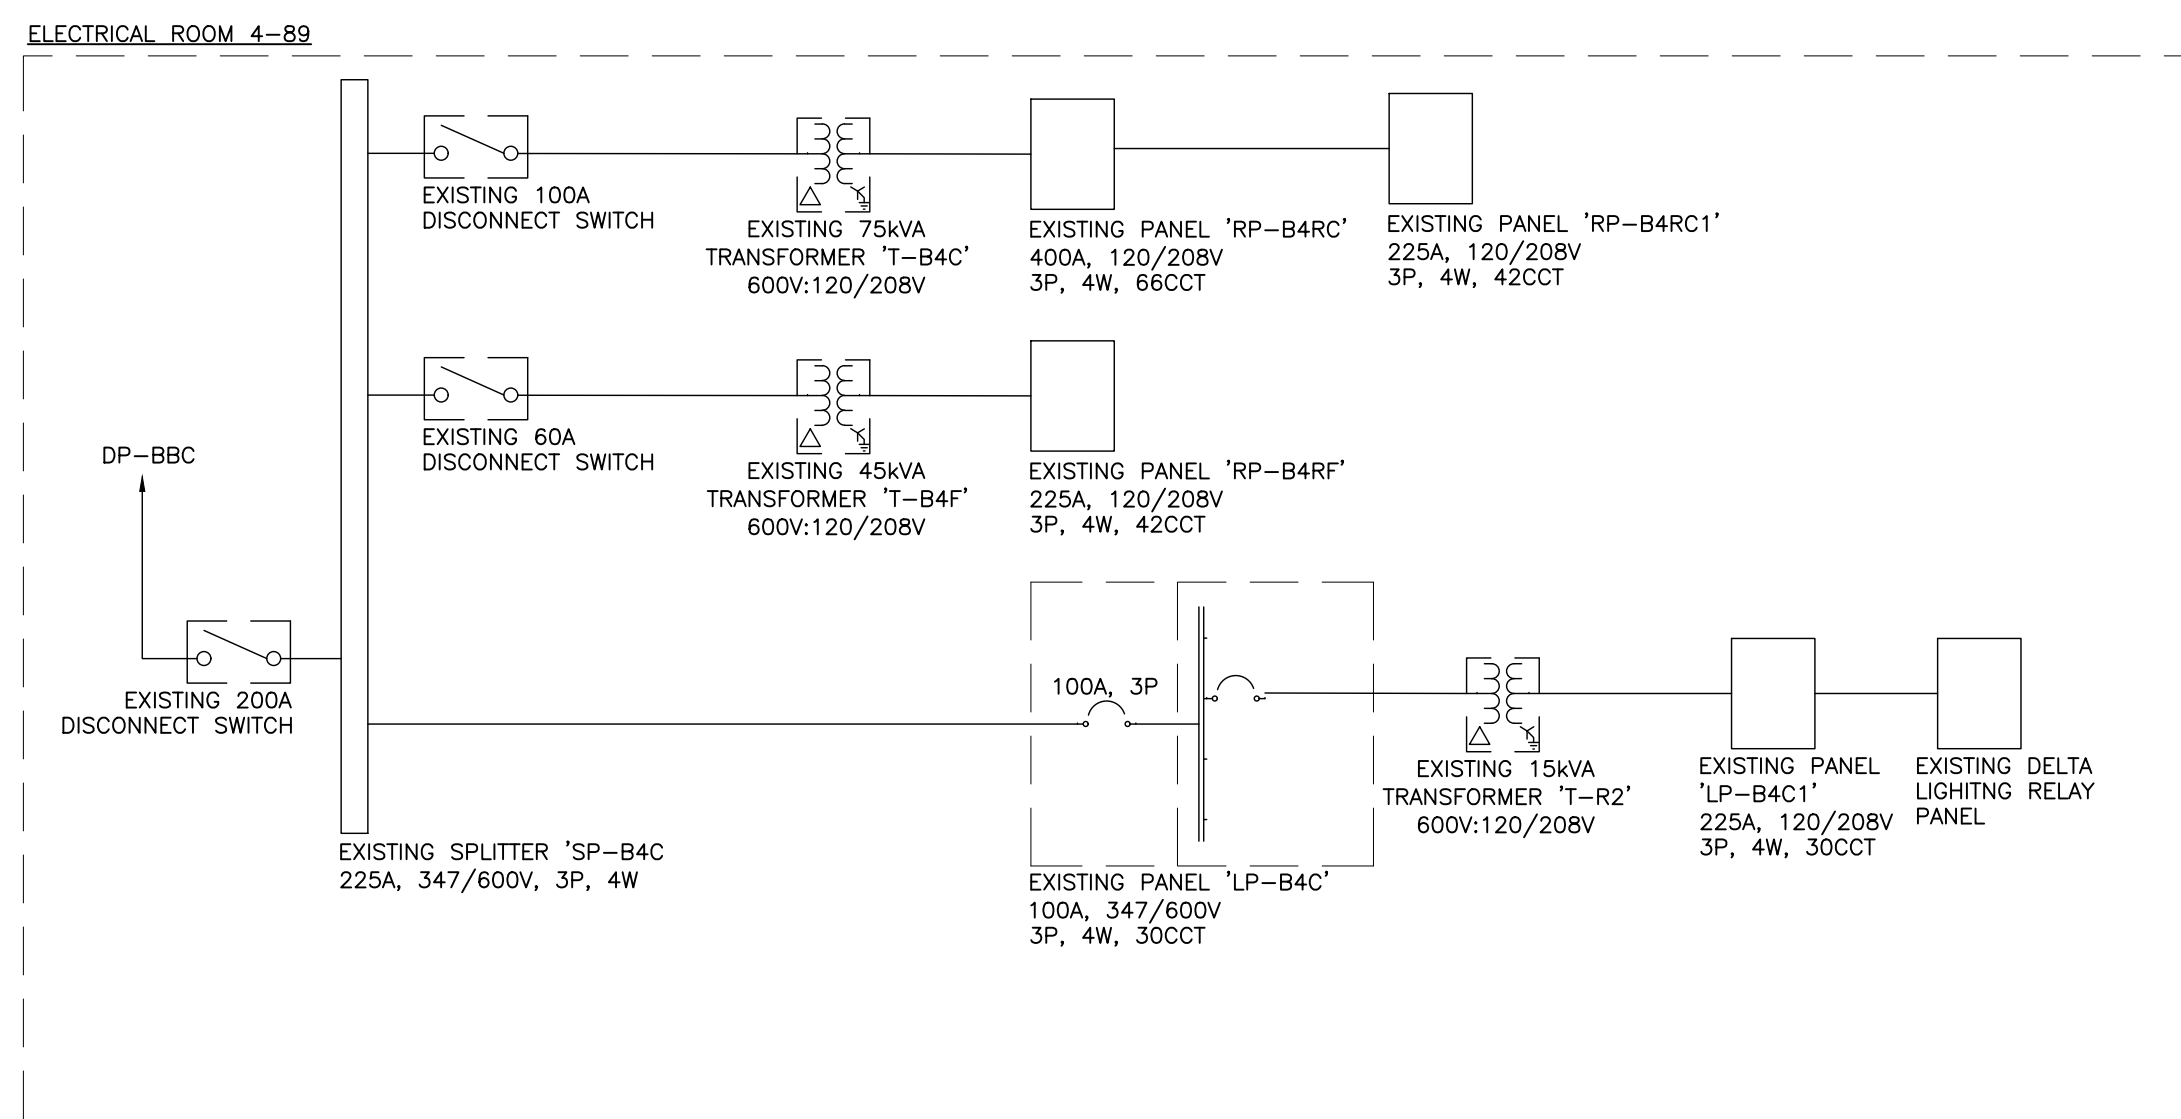
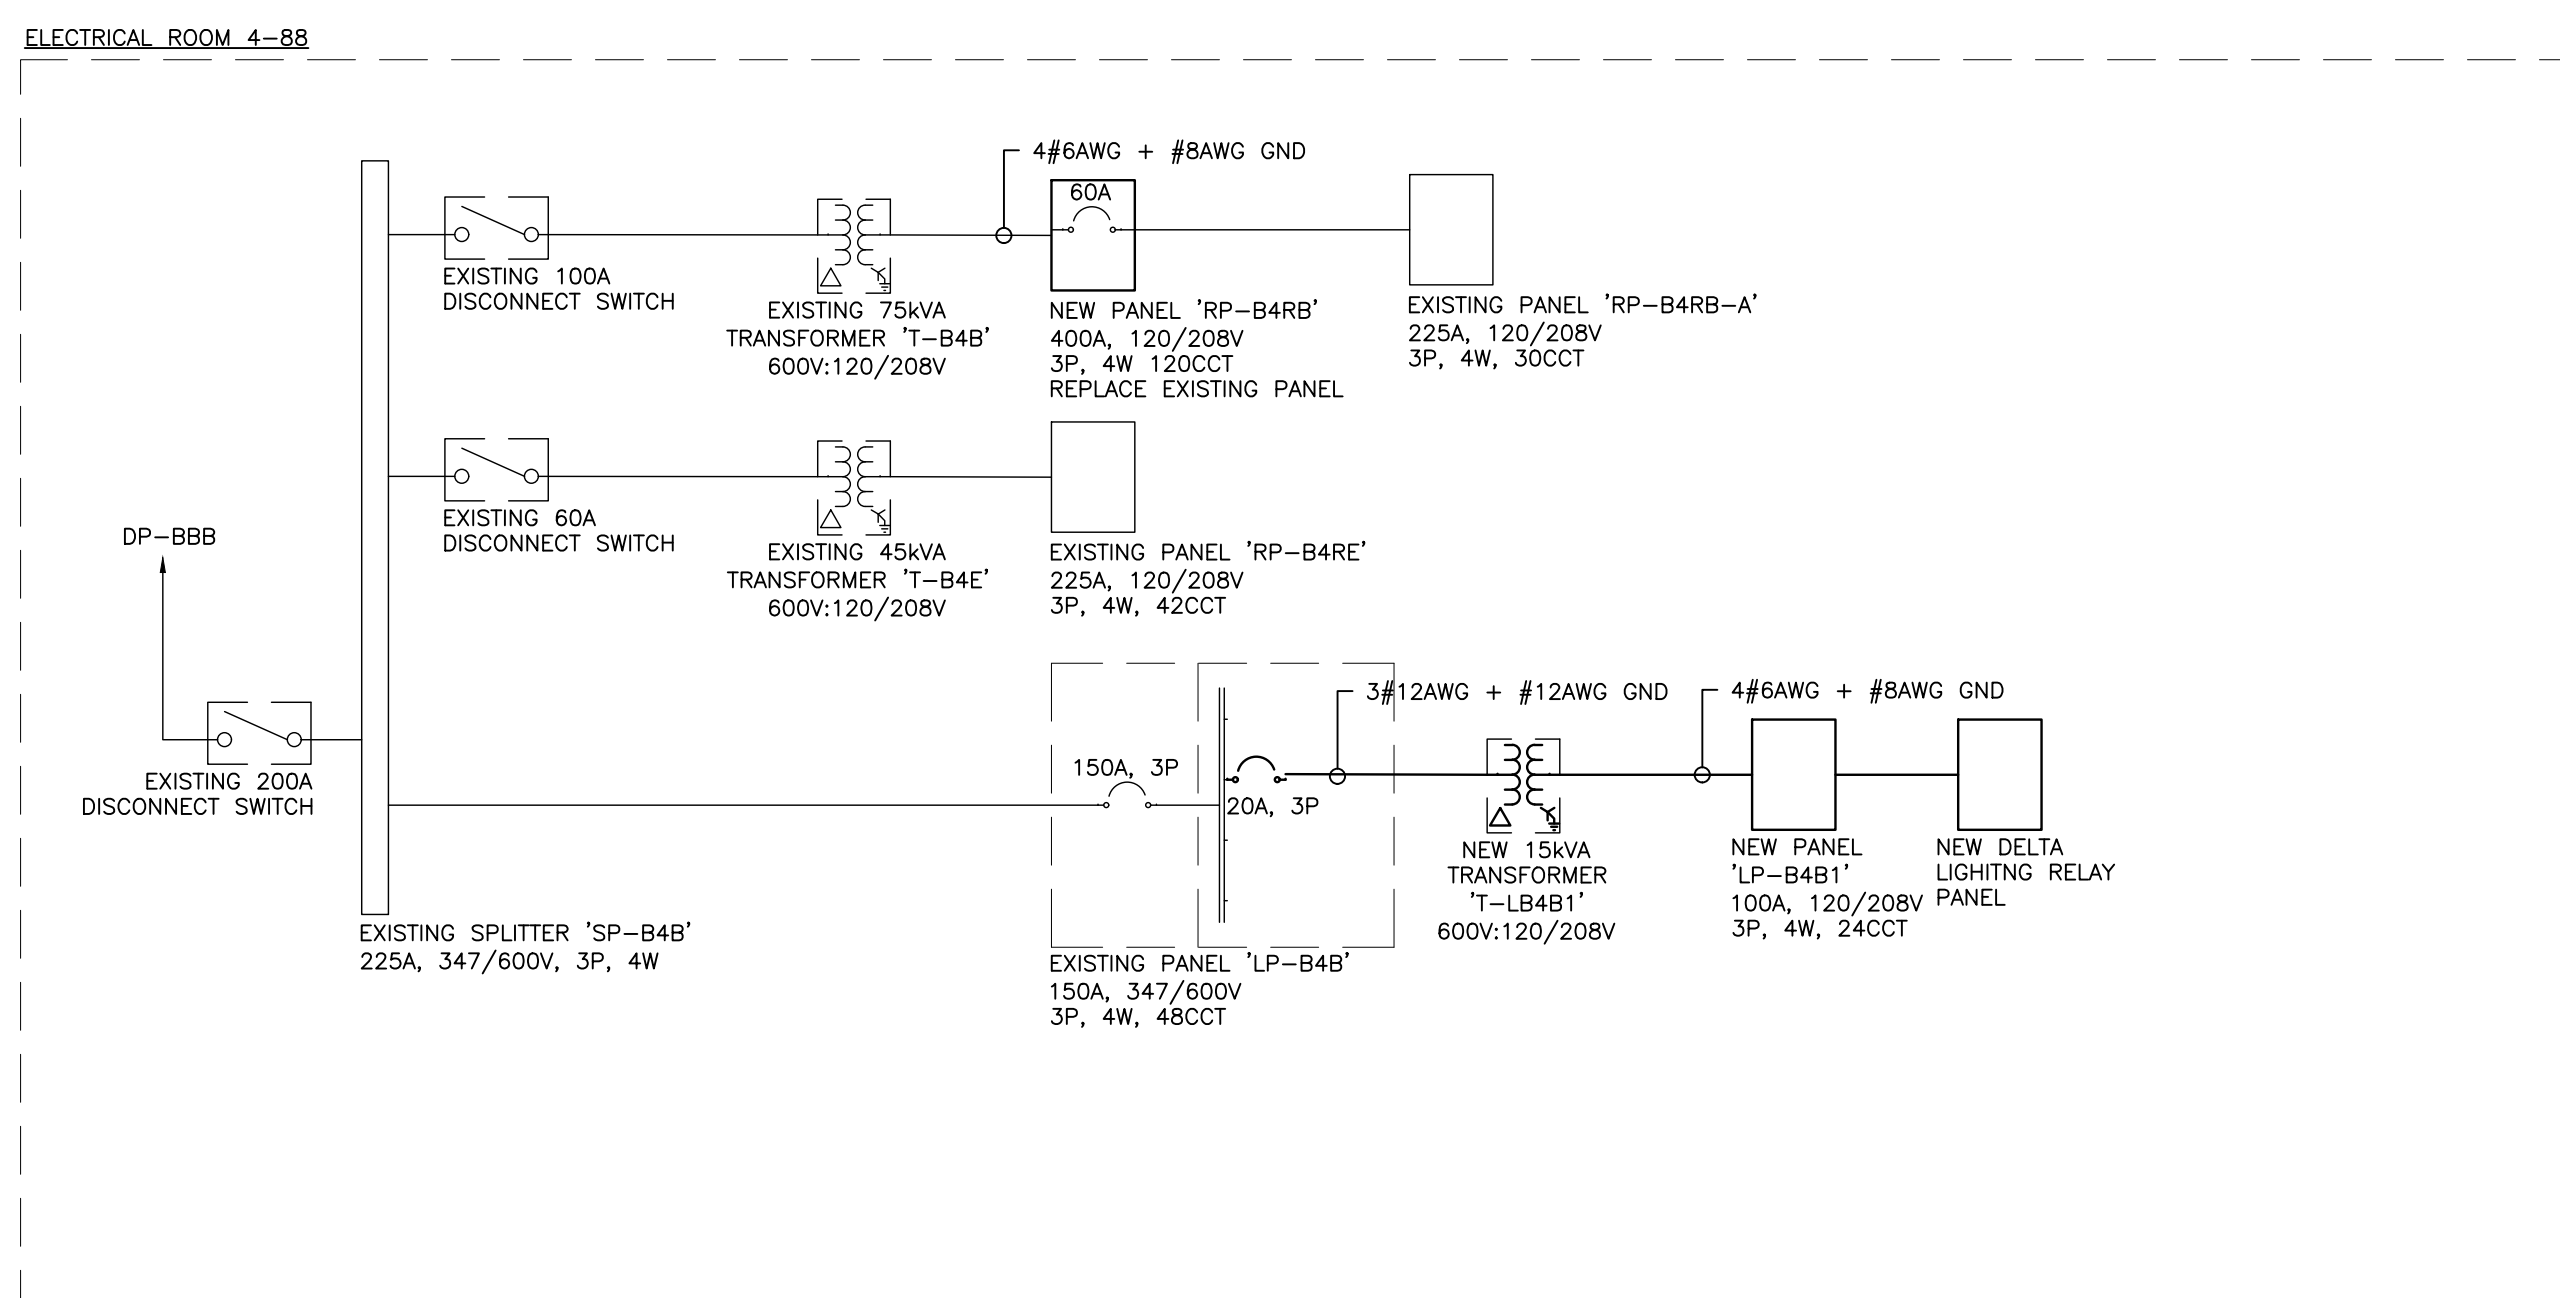
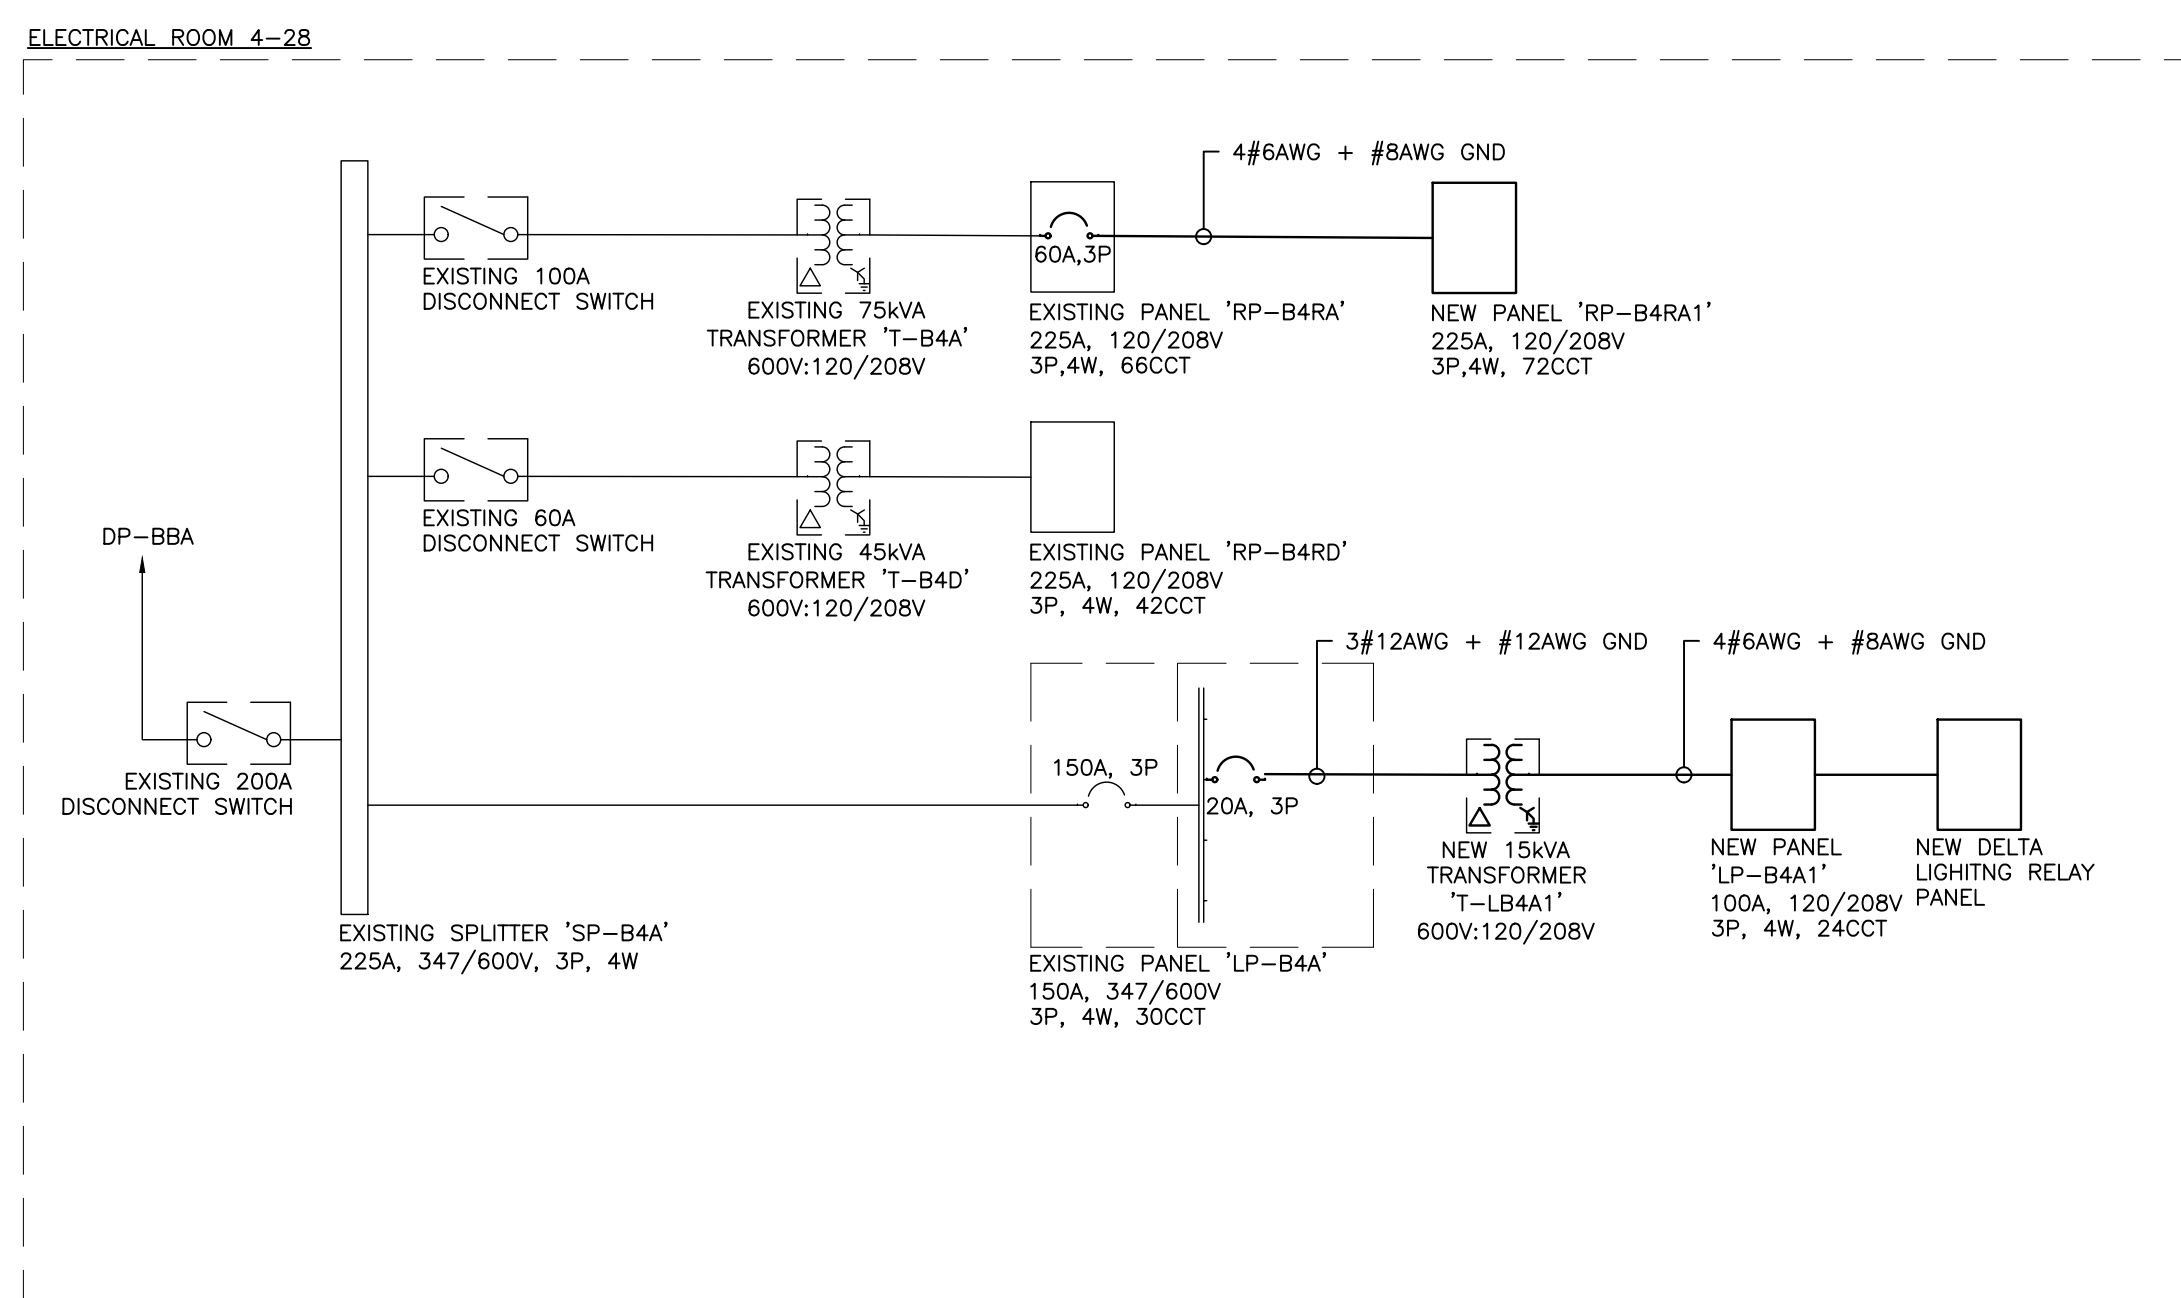
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POWER LEGEND 1 OF 2		POWER LEGEND 2 OF 2	
SYMBOL	DESCRIPTION	SYMBOL	DESCRIPTION
	FLOOR MOUNTED SINGLE TUB PANEL RATING AS NOTED ON SINGLE LINE/PANEL SCHEDULE		CONTACTOR
	FLOOR MOUNTED DOUBLE TUB PANEL RATING AS NOTED ON SINGLE LINE/PANEL SCHEDULE		GROUND ROD WITH INSPECTION PIT
	SURFACE MOUNTED SINGLE TUB PANEL RATING AS NOTED ON SINGLE LINE/PANEL SCHEDULE		THERMOSTAT-16mm (1/2") CONDUIT TO ACCESSIBLE CEILING SPACE
	SURFACE MOUNTED DOUBLE TUB PANEL RATING AS NOTED ON SINGLE LINE/PANEL SCHEDULE		JUNCTION BOX (SIZE SPECIFIED ON DRAWING)
	TRANSFORMER (SIZE NOTED ON SINGLE LINE DIAGRAM)		ELECTRIC UNIT HEATER
	DISCONNECT		ELECTRIC BASEBOARD HEATER. "X" DENOTES TYPE. REFER TO BASEBOARD HEATER SCHEDULE.
	COMBINATION MANUAL STARTER WITH INTEGRAL DISCONNECT		GROUND BAR
	COMBINATION STARTER WITH INTEGRAL DISCONNECT		HAND DRYER HARD WIRED CONNECTION
	DIRECT CONNECTION		METER
	DIRECT CONNECTION C/W DISCONNECT		RELAY
	MOTOR C/W DISCONNECT		PULL BOX
	MOTOR C/W RELAY DISCONNECT DISCONNECT		GROUND BUS
	MOTOR C/W COMBINATION STARTER WITH INTEGRAL DISCONNECT		DENOTES RECEPTACLE TYPE. REFER TO RECEPTACLE SCHEDULE.
	VARIABLE FREQUENCY DRIVE AND VFD CABLE CONNECTION TO MOTOR. LINE AND LOAD SIDE WIRING OF HARMONIC FILTER AND VFD BY ELECTRICAL CONTRACTOR. MOTOR, VFD AND HARMONIC FILTER SUPPLIED BY MECHANICAL DIVISION.		UTILITY METERING CABINET
	VARIABLE FREQUENCY DRIVE, LINE AND LOAD SIDE WIRING OF HARMONIC FILTER AND VFD BY ELECTRICAL CONTRACTOR. LOAD SIDE WIRING OF VFD TO BE VFD CABLE. VFD AND HARMONIC FILTER SUPPLIED BY MECHANICAL DIVISION.		DOOR BELL/CHIME
	HARMONIC FILTER (SUPPLIED BY MECH. CONTRACTOR UNLESS NOTED OTHERWISE.) LINE AND LOAD SIDE WIRING OF HARMONIC FILTER BY ELECTRICAL CONTRACTOR.		CLOCK WALL MOUNTED
			CLOCK CEILING MOUNTED
			PUSH BUTTON
			MOTOR

NOTE: NOT ALL SYMBOLS APPLY, REFER TO FLOOR PLANS AND DRAWINGS

[illegible]

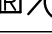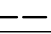1 GENERAL AND SYMBOLS AND ABBREVIATIONS
E-0.1



G.Bruce Stratton Architects

217 Richmond Street West, Suite 300
Toronto Ontario M5V 1W2
telephone: 416.351.8145
facsimile: 416.351.8146

[illegible]

PROJECT CONTACT

NAME: COLIN HODDER
TEL: 416-487-8151
EMAIL: Colin.Hodder@smithandandersen.com

THIS DRAWING SHALL BE READ IN CONJUNCTION
WITH MECHANICAL SPECIFICATION SUBMITTED FOR
THIS PROJECT.

STAMP:

NORTH:

ENGINEER



Smith + Andersen

1100 - 100 Sheppard Ave. East, Toronto On, M2N 6K1
416 487 8151 f 416 487 9104 smilthond@ndersen.com

PROJECT

YORK REGION

Administrative Centre
17250 Yonge Street
Newmarket, Ontario

SCALE: NTS

DRAWN BY: CH

REVIEWED BY: NC

SHEET TITLE:
ELECTRICAL DETAILS

SHEET NUMBER:

TE-0.2

10
E-0.3

11 PANEL SCHEDULE SCALE: N.T.S.

SPACE				15	27	B	28	15			SPACE					
SPACE				15	29	C	30	15			SPACE					
PANEL OPTIONS:				LOADS: 5000				2.5				PHASE VOLTAGE: 201				120

12 PANEL SCHEDULE SCALE: N.T.S.

7 LIGHTING CONTROL SCHEDULE SCALE: N.T.S.

8 PANEL SCHEDULE SCALE: N.T.S.

EXISTING CCT				15	33	B	34	15	175	250	70	SOUND MA SIKING
EXISTING CCT				15	35	C	36	15	175	250	70	SOUND MA SIKING
ER 4-92 & 4-93 - ADO	80	200	240	15	37	A	38					SPACE

9 PANEL SCHEDULE SCALE: N.T.S.

NOTES

(N-1) ALL FIXTURES SHALL BE APPROVED FOR USE IN CANADA (E.G. CSA, ULC).

(N-2) FIXTURES C/W ALL REQUIRED MOUNTING ACCESSORIES.

(N-3) CONFIRM ALL FINISHES AND MOUNTING HEIGHTS WITH ARCHITECTURAL DRAWINGS PRIOR TO ORDERING.

(N-4) PROVIDE YORK REGION AN EXTRA TWENTY FIVE (25) TYPE L1 LAMPS AT THE COMPLETION

LUMINAIRE SCHEDULE	SCALE
--------------------	-------

PANEL	SCHEDULE	SCALE
-------	----------	-------

ING CCT			15	45	B	46	15	480	600	80	REC - PRV/ATE OFFICE - 4-01	
			2P	47	C	48	15	320	400	80	REC - GROUP ZONE	
FOCUS ROOM - 4-01	80	600	480	15	49	A	50	15	320	400	80	REC - Huddle Room - 4-01

PANEL SCHEDULE	SCALE
----------------	-------

C POLE SYSTEM FURNITURE FEED SCALE: N.T.S.

CONNECTRAC RACEWAY SYSTEM AND MEETING ROOM SCALE

LOAD A [KW]:	2.2	PHASE VOLTAGE [V]:	
--------------	-----	--------------------	--

INTEL SCHEDULE	SCALE
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G.Bruce Stratton Architects

217 Richmond Street West, Suite 300
Toronto Ontario M5V 1W2
telephone: 416.351.8145
facsimile: 416.351.8146

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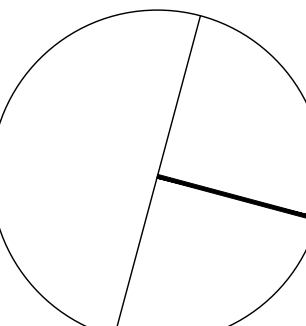
PROJECT CONTACT

NAME: COLIN HODDER
TEL: 416-487-8151
EMAIL: Colin.Hodder@smithandandersen.com

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THIS PROJECT.

STAMP:

NORTH:



1100 = 100 Sheppard Ave. East, Toronto On, M2N 6K1
416 487 8151 | 416 487 9104 smithandandersen.com

PROJECT

SCALE: NTS

DRAWN BY: CH

REVIEWED BY: NC

SHEET TITLE:
ELECTRICAL DETAILS

SHEET NUMBER:

TE-0.3

G.Bruce Stratton Architects

217 Richmond Street West, Suite 300
Toronto Ontario M5V 1W2
telephone: 416.351.8145
facsimile: 416.351.8146

SUBMISSION	DATE	DESCRIPTION
1	2022-05-31	ISSUED FOR 97% REVIEW
2	2022-06-13	ISSUED FOR TENDER


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TEL: 416-487-8151
EMAIL: Colin.Hodder@smithandandersen.com


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WITH MECHANICAL SPECIFICATION SUBMITTED FOR
THIS PROJECT.

STAMP:

NORTH:

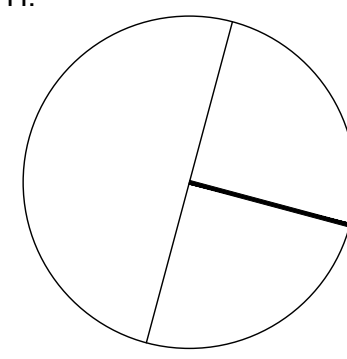

ENGINEER:

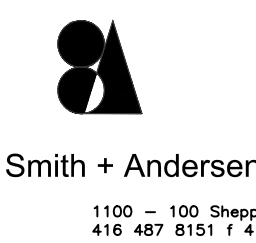

PROJECT:

YORK REGION

Administrative Centre
17250 Yonge Street
Newmarket, Ontario

SCALE:

NTS

DRAWN BY:

CH

REVIEWED BY:

NC


SHEET TITLE:

ELECTRICAL DETAILS

SHEET NUMBER:

TE-0.4

PANEL: EXISTING RP-BARD										LOCATION: BLED RM-4-28		Smith + Andersen			
PROJECT NAME: YORK REGION 4TH FL RENOVATION										BUDGET FROM:		REVISED FROM: T-BAD			
PROJECT # 14028.015 E.001															
TYPE	DESCRIPTION	D/F	CONN	DEMAND	WIRING	WIRING	WIRING	WIRING	WIRING	WIRING	WIRING	WIRING	WIRING	WIRING	WIRING
INFO	DESCRIPTION	D/F	CONN	DEMAND	WIRING	WIRING	WIRING	WIRING	WIRING	WIRING	WIRING	WIRING	WIRING	WIRING	WIRING
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PAN COOL UNIT		70	800	800	SP 44	A	44	44	44	44	44	44	44	44	44
PAN COOL UNIT		70	800	800	SP 45	A	45	45	45	45	45	45	45	45	45
PAN COOL UNIT		70	800	800	SP 46	A	46	46	46	46	46	46	46	46	46
PAN COOL UNIT		70	800	800	SP 47	A	47	47	47	47	47	47	47	47	47
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PAN COOL UNIT		70	800	800	SP 49	A	49	49	49	49	49	49	49	49	49
PAN COOL UNIT		70	800	800	SP 50	A	50	50	50	50	50	50	50	50	50
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PAN COOL UNIT		70	800	800	SP 52	A	52	52	52	52	52	52	52	52	52
PAN COOL UNIT		70	800	800	SP 53	A	53	53	53	53	53	53	53	53	53
PAN COOL UNIT		70	800	800	SP 54	A	54	54	54	54	54	54	54	54	54
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PAN COOL UNIT		70	800	800	SP 92	A	92	92	92	92	92	92	92	92	92
PAN COOL UNIT		70	800	800	SP 93	A	93	93	93	93	93	93	93	93	93
PAN COOL UNIT		70	800	800	SP 94	A									

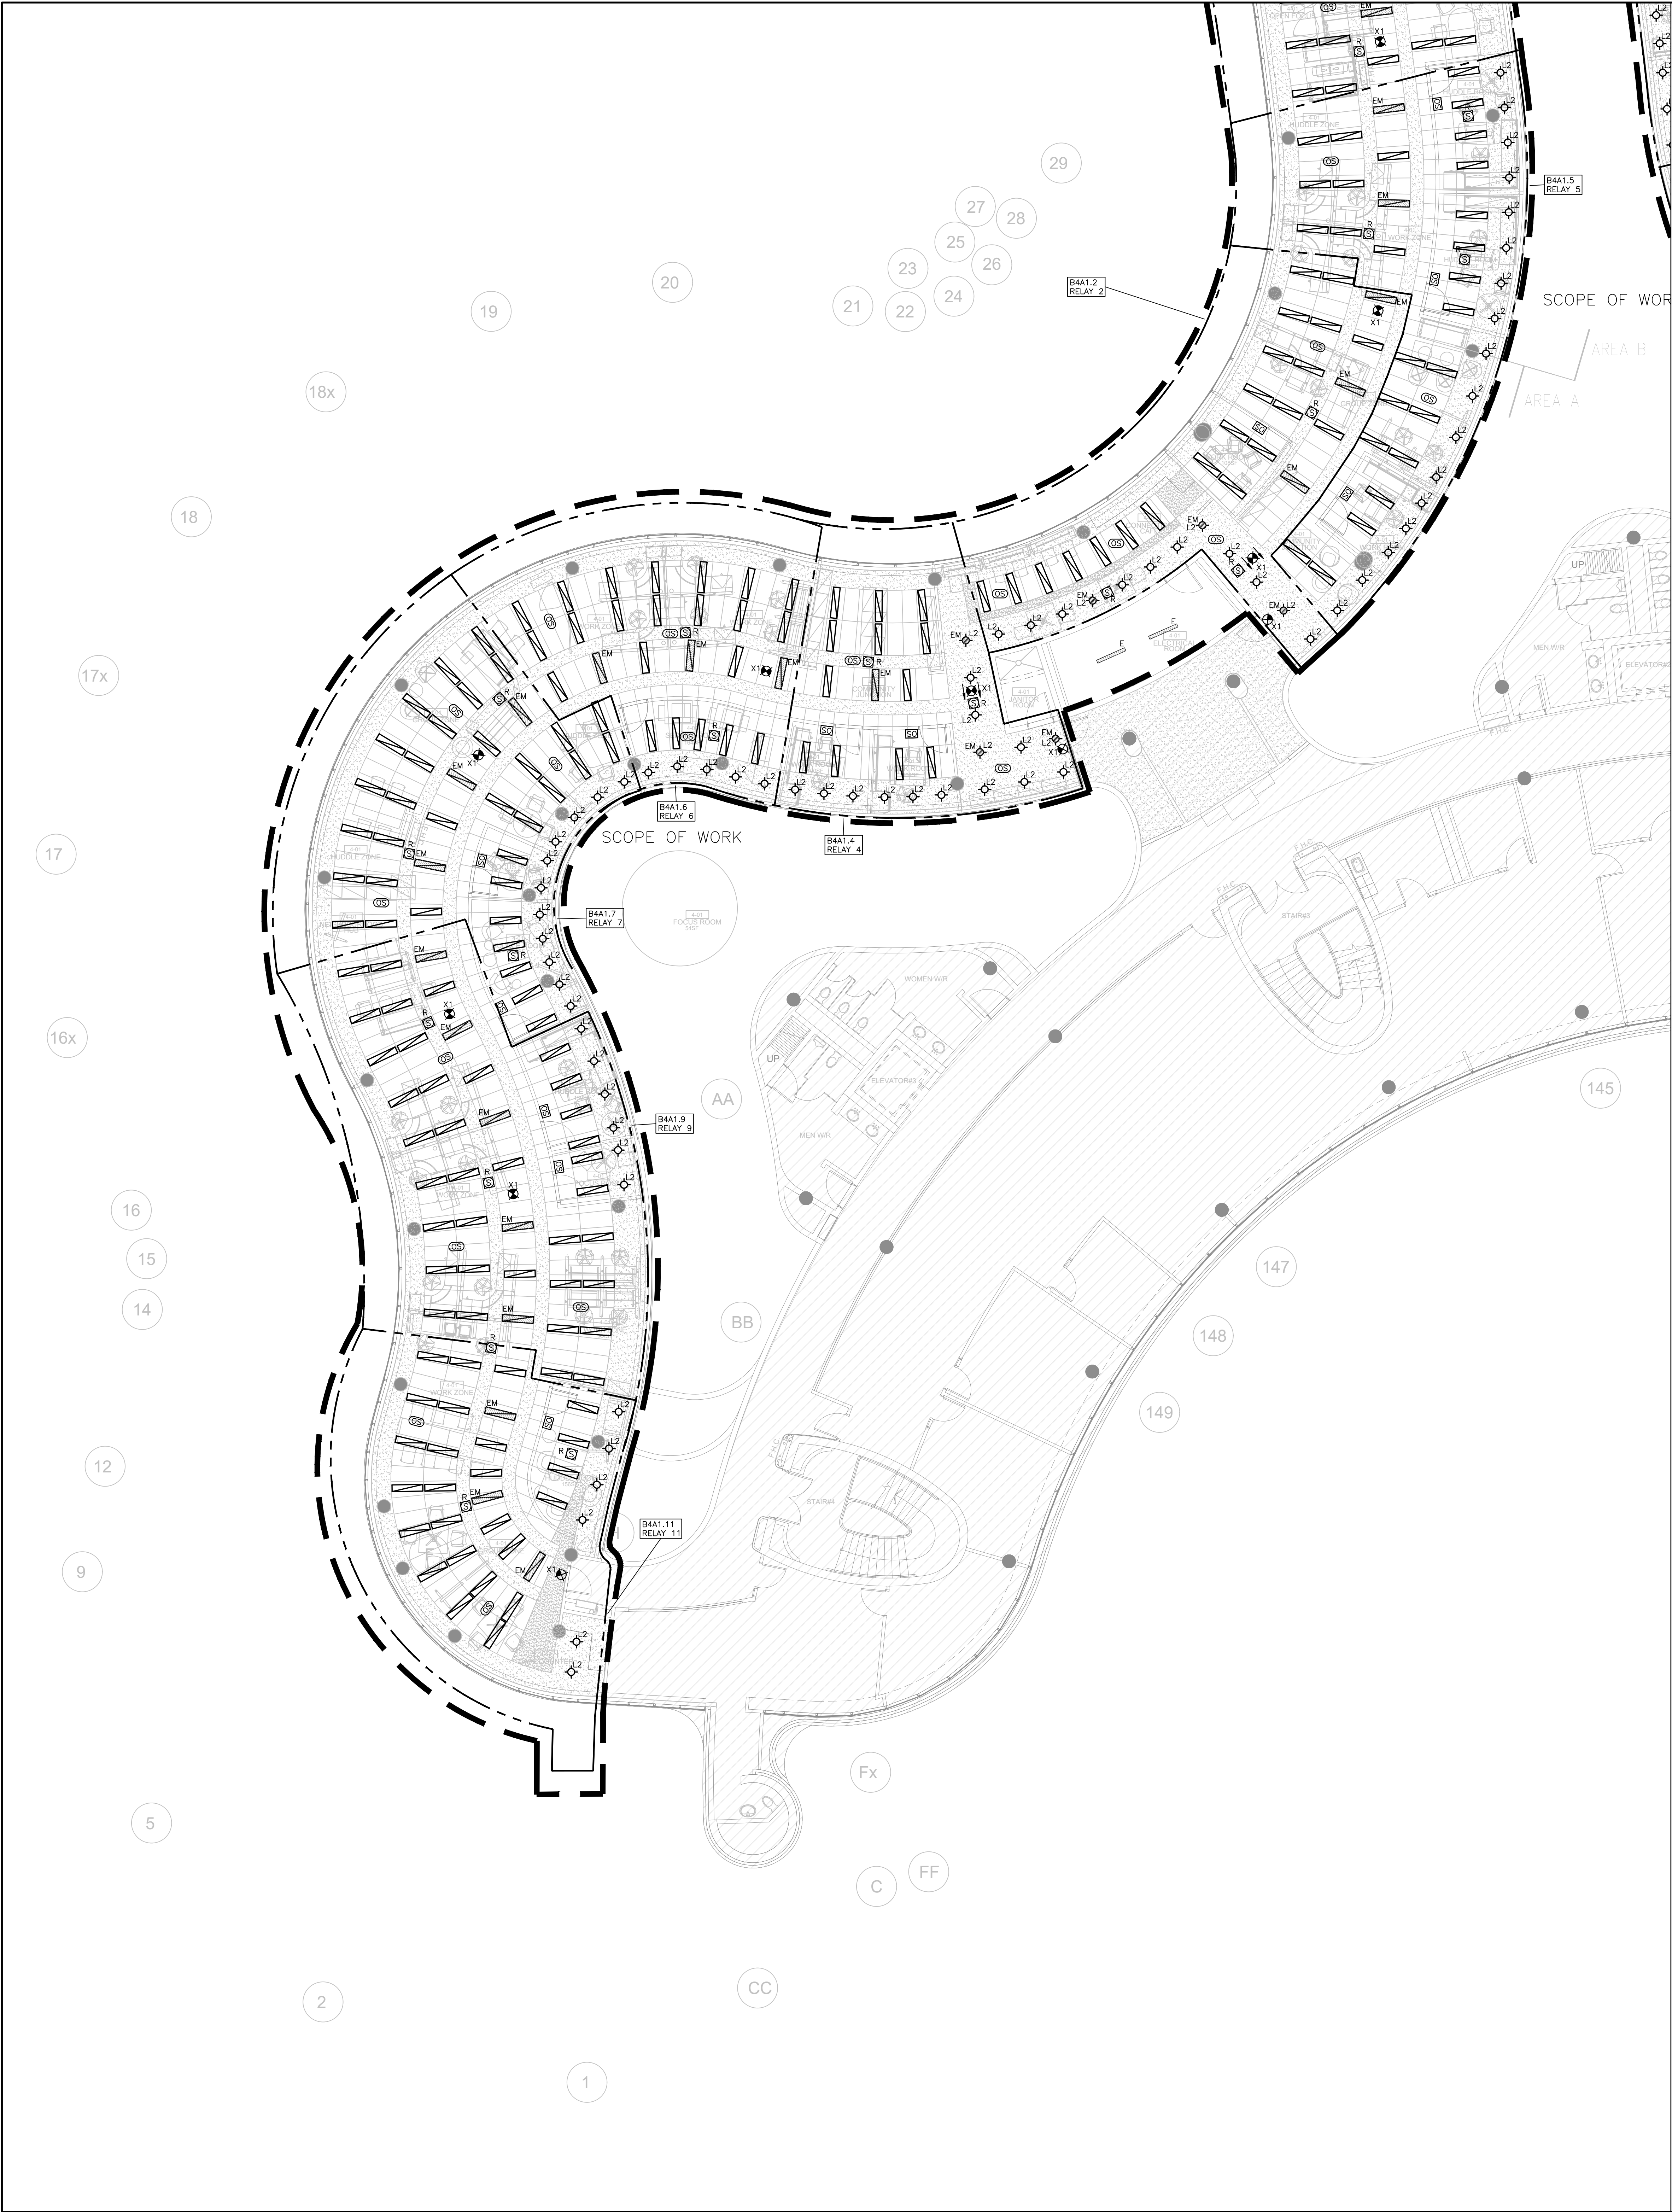

- GENERAL NOTES:
1. THESE DRAWINGS SHALL BE READ IN CONJUNCTION WITH ARCHITECT'S DRAWINGS FOR DIMENSIONS, HEIGHTS, CONSTRUCTION DETAILING, FINISHES AND COLOURS.
 2. CIRCUITING IN PART IS DIAGRAMMATIC INTENDED TO SHOW GENERAL CIRCUIT ARRANGEMENT AND PANEL DESIGNATION.
 3. REFER TO LIGHTING LAYOUT SHOWN FOR FINAL LOCATION ONLY. VISIT THE SITE AND COORDINATE EXACT QUANTITY OF LIGHTING LUMINAIRES TO BE NEW, RELOCATED AND/OR RETAINED IN EXISTING LOCATION. PROVIDE NEW LUMINAIRES TO MATCH EXISTING WHERE INSUFFICIENT QUANTITY EXISTS TO SUIT. ALL RELOCATED LUMINAIRES SHALL HAVE WIRING EXTENDED TO SUIT NEW LOCATION. OFFER ALL UNUSED EXISTING LUMINAIRES TO THE REGION AND SIGN OVER ALL SELECTED LUMINAIRES AT A PLACE DESIGNATED BY THE REGION. DISPOSE OF ALL LUMINAIRES REJECTED BY THE REGION.
 4. ALL NEW/RELOCATED BASE BUILDING STANDARD LUMINAIRES AND NEW RECESSED DOWN LIGHTS SHALL BE CHAIN HUNG AND SUPPORTED FROM THE SLAB ABOVE. PROVIDE LETTER TO BE INCLUDED AS PART OF CLOSE-OUT DOCUMENT SUBMITTAL PACKAGE.
 5. REWORK EXISTING EMERGENCY LIGHTING TO ACHIEVE NEW EMERGENCY LIGHTING AS SHOWN. CONNECT NEW AND/OR RELOCATED LUMINAIRES TO NEAREST EMERGENCY LIGHTING CIRCUITS ON THIS FLOOR. IF NEW EMERGENCY BRANCH CIRCUITS ARE REQUIRED FOR EMERGENCY LIGHTING AND EXISTING EMERGENCY LIGHTING PANEL IS LOCATED ON A DIFFERENT STOREY (i.e. NOT LOCATED ON SAME FLOOR), THEN NEW BRANCH CIRCUIT WIRING SHALL BE 2-HOUR FIRE RATED (i.e. W/ CABLE) TO FIRST EMERGENCY LIGHT FLOOR. IF EXISTING EMERGENCY LIGHTING PANEL IS LOCATED ON THE SAME STOREY, THE NEW BRANCH CIRCUIT WIRING DOES NOT NEED TO BE FIRE RATED. PROVIDE LOCK-ON BREAKERS TO SUIT.
 6. MEASURE THE ILLUMINATION OF THE FLOOR AT NIGHT WITH EMERGENCY LIGHTING ON ONLY, AND SEND A DRAWING SHOWING THE MAXIMUM AND MINIMUM LEVEL OF ILLUMINATION, TO THE CONSULTING ENGINEER FOR REVIEW. PROVIDE WRITTEN CONFIRMATION THAT EMERGENCY LIGHTING HAS BEEN INSTALLED IN ACCORDANCE WITH CONTRACT DOCUMENTS AND LATEST EDITION OF THE ONTARIO BUILDING CODE SECTIONS 3.2.7.3 AND 3.2.7.4. LETTER TO BE INCLUDED AS PART OF CLOSE-OUT DOCUMENT SUBMITTAL PACKAGE.
 7. PROVIDE NEW PICTOGRAM (RUNNING MAN) TYPE EXIT SIGNS, EQUAL TO THOMAS AND BETTS EA SERIES COMPLETE WITH BRUSHED ALUMINUM FINISH, FACES AND INDICATOR ARROWS AS PER DRAWINGS AND UNIVERSAL 120V-240V VOLTAGE INPUT UNLESS OTHERWISE NOTED. OR - MATCH EXISTING BASE BUILDING STANDARD UNLESS OTHERWISE NOTED. CONNECT NEW EXIT SIGNS TO THE NEAREST AVAILABLE SPARE EXIT LIGHTING CIRCUIT. DO NOT OVERLOAD THE CIRCUIT. ALLOW FOR THREE (3) ADDITIONAL EXIT SIGNS (COMPLETE WITH MATERIAL AND LABOUR) TO BE INSTALLED AS PER BUILDING INSPECTORS REQUIREMENTS UPON FINAL INSPECTION.
 8. LOCATE AND POSITION EXIT SIGNS SUCH THAT THEY DO NOT INTERFERE WITH ADJACENT EXIT SIGNS AND EMERGENCY LIGHTING COVERAGE.
 9. ALL MODIFICATIONS TO FIRE ALARM SYSTEM AND DEVICES TO BE COMPLETED BY BASE BUILDING FIRE ALARM CONTRACTOR AND VENDOR/MANUFACTURER. BASE BUILDING FIRE ALARM CONTRACTOR/VENDOR/MANUFACTURER IS RESPONSIBLE TO ENSURE THAT ALL ADDITIONAL COMPONENTS (MATERIAL, SOFTWARE, INCLUDING ANY LABOUR TO INSTALL OR MODIFY FIRE ALARM DEVICES) ARE INCLUDED FOR BASED ON ISSUED DRAWINGS. ELECTRICAL CONTRACTOR TO ALLOW FOR ALL ASSOCIATED COSTS. NEW FIRE ALARM SPEAKER/STROBES ARE TO MATCH EXISTING AND BE CONNECTED TO NEAREST AVAILABLE SPARE EMERGENCY ZONE CIRCUIT(S). CONNECT NEW SPEAKER/STROBES TO EXISTING CIRCUITS, WHERE THERE IS SPARE CAPACITY ON RESPECTIVE CIRCUITS. IF THERE IS NO CAPACITY ON EXISTING CIRCUITS, PROVIDE NEW FIRE ALARM CIRCUITS. ALLOW FOR ALL ASSOCIATED COSTS INCLUDING BUT NOT LIMITED TO ASSOCIATED EQUIPMENT, DEVICES, PROGRAMMING, TESTING AND VERIFICATION TO MAKE SYSTEM OPERATIONAL AND CODE COMPLIANT. ALL FIRE ALARM VERIFICATION SHALL CONFORM TO CAN/ULC-5537 LATEST EDITION. FIRE ALARM SYSTEM SHALL BE INSTALLED IN CONFORMANCE WITH CAN/ULC-5524 LATEST EDITION. INCLUDE IN THE COST TO PROVIDE TWO (2) ADDITIONAL FIRE ALARM SPEAKERS AND ONE (1) ADDITIONAL AUDIBILITY VERIFICATION.
 10. ENSURE THAT ALL LIGHTING FIXTURES ARE CLEAN AND ILLUMINATED BY END OF PROJECT.
 11. REWORK EXISTING SWITCHING TO ACCOMMODATE THE NEW LIGHTING LAYOUT WITHIN THE TENANT SPACE.
 12. THE ELECTRICAL CONTRACTOR SHALL PROVIDE POWER EXTENDERS ON ALL DIMMERS AS REQUIRED. REFER TO SPECIFICATIONS FOR DETAILS ON DIMMER RATINGS.
 13. REUSE EXISTING CIRCUIT FOUND IN CEILING SPACE FOR ALL NEW LIGHTING FIXTURES UNLESS OTHERWISE NOTED. CONTRACTOR TO PROVIDE ADDITIONAL CIRCUITS WHERE REQUIRED. NEW LOW VOLTAGE SWITCH ARRANGEMENT OF LIGHTING TO BE CO-ORDINATED WITH THE REGION AND REARRANGED TO SUIT NEW LAYOUT. ALL LIGHTING, EXCLUDING EMERGENCY, WITHIN THE TENANT PREMISES TO BE ON A SEPARATE LIGHTING ZONE AND TO BE CONTROLLED BY BASE BUILDING LIGHTING CONTROL SYSTEM. PROVIDE ALL NECESSARY RELAYS, CONTACTORS, RELAY PANELS, AND DRY INTERFACES REQUIRED FOR SUCH CONTROL. INCLUDE COST IN THIS CONTRACT.
 14. PROVIDE NEW LUMINAIRE DISCONNECTS THAT COMPLY WITH REQUIREMENTS SPECIFIED IN OESC PART 1, RULE 30-308(4) LATEST EDITION FOR ALL LIGHT FIXTURES THAT EXCEED 150V SHOWN AS NEW AND/OR RELOCATED. ALL NEW AND RELOCATED FIXTURES THAT EXCEED 150V SHALL BE MARKED IN A CONSPICUOUS, LEGIBLE, AND PERMANENT MANNER ADJACENT TO THE DISCONNECTING MEANS, IDENTIFYING THE SPECIFIC PURPOSE.
 15. LIGHTING FIXTURES IDENTIFIED AS EMERGENCY ARE TO BE CONNECTED SO THAT UNDER NORMAL CONDITIONS THEY WORK IN CONJUNCTION WITH THE SWITCHING AS IDENTIFIED. IN THE EVENT OF AN EMERGENCY, THESE LIGHTS ARE TO BE FORCED ON WITH THE USE OF A UL-124 LISTED RELAY. UPON POWER FAILURE THE RELAY IS TO ACTIVATE THE LIGHTS TO FULL BRIGHTNESS. REFER TO DETAIL 10/E-0.3 FOR REQUIREMENTS.
 16. COORDINATE INSTALLATION OF FIXTURES WITH MECHANICAL EQUIPMENT, ELECTRICAL EQUIPMENT, SPRINKLERS AND DUCT WORK WITH OTHER TRADES PRIOR TO WORK COMMENCING.
 17. ALL CEILING MOUNTED OCCUPANCY SENSORS PROVIDED AS PART OF THIS SCOPE OF WORK MUST BE LOCATED AT LEAST 6'0" AWAY FROM ANY SUPPLY AIR DIFFUSER AND RETURN AIR GRILLE AS PER MANUFACTURER'S RECOMMENDATION. COORDINATE INSTALLATION ON SITE WITH MECHANICAL CONTRACTOR PRIOR TO COMMENCING WORK.

- DRAWING NOTES:
- (L1) ALL LIGHT FIXTURES ARE TYPE "L1" UNLESS OTHERWISE NOTED.
 - (L2) MIRROR LIGHT TO BE CONNECTED TO THE SAME CIRCUIT AS L2 FIXTURES IN THE SAME ROOM, AND CONTROLLED VIA THE LOCAL SWITCH.
 - (L3) FINAL LOCATIONS OF POTLIGHTS TO BE COORDINATED ON-SITE.

G.Bruce Stratton Architects

217 Richmond Street West, Suite 300
Toronto Ontario M5V 1W2
telephone: 416.351.8145
facsimile: 416.351.8146

SUBMISSION	DATE	DESCRIPTION
1	2022-03-14	ISSUED FOR 60% REVIEW
2	2022-04-27	ISSUED FOR 80% REVIEW
3	2022-05-31	ISSUED FOR 97% REVIEW
4	2022-06-13	ISSUED FOR TENDER


PROJECT CONTACT

NAME: COLIN HODDER
TEL: 416-487-8151
EMAIL: Colin.Hodder@smithandandersen.com

THIS DRAWING SHALL BE READ IN CONJUNCTION WITH MECHANICAL SPECIFICATION SUBMITTED FOR THIS PROJECT.

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NORTH:

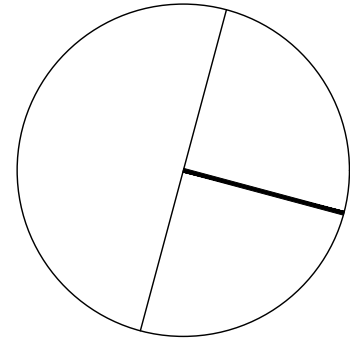

ENGINEER:



Smith + Andersen

1100 - 100 Sheppard Ave. East, Toronto, ON, M2N 6N5
416 487 8151 | 416 487 9104 | smithandandersen.com

PROJECT:

YORK REGION

Administrative Centre
17250 Yonge Street
Newmarket, Ontario

SCALE: 1:100


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REVIEWED BY: NC

SHEET TITLE:
PARTIAL LEVEL 4 -
LIGHTING & FIRE ALARM
LAYOUT (PART A)

SHEET NUMBER:

TE-4.1A

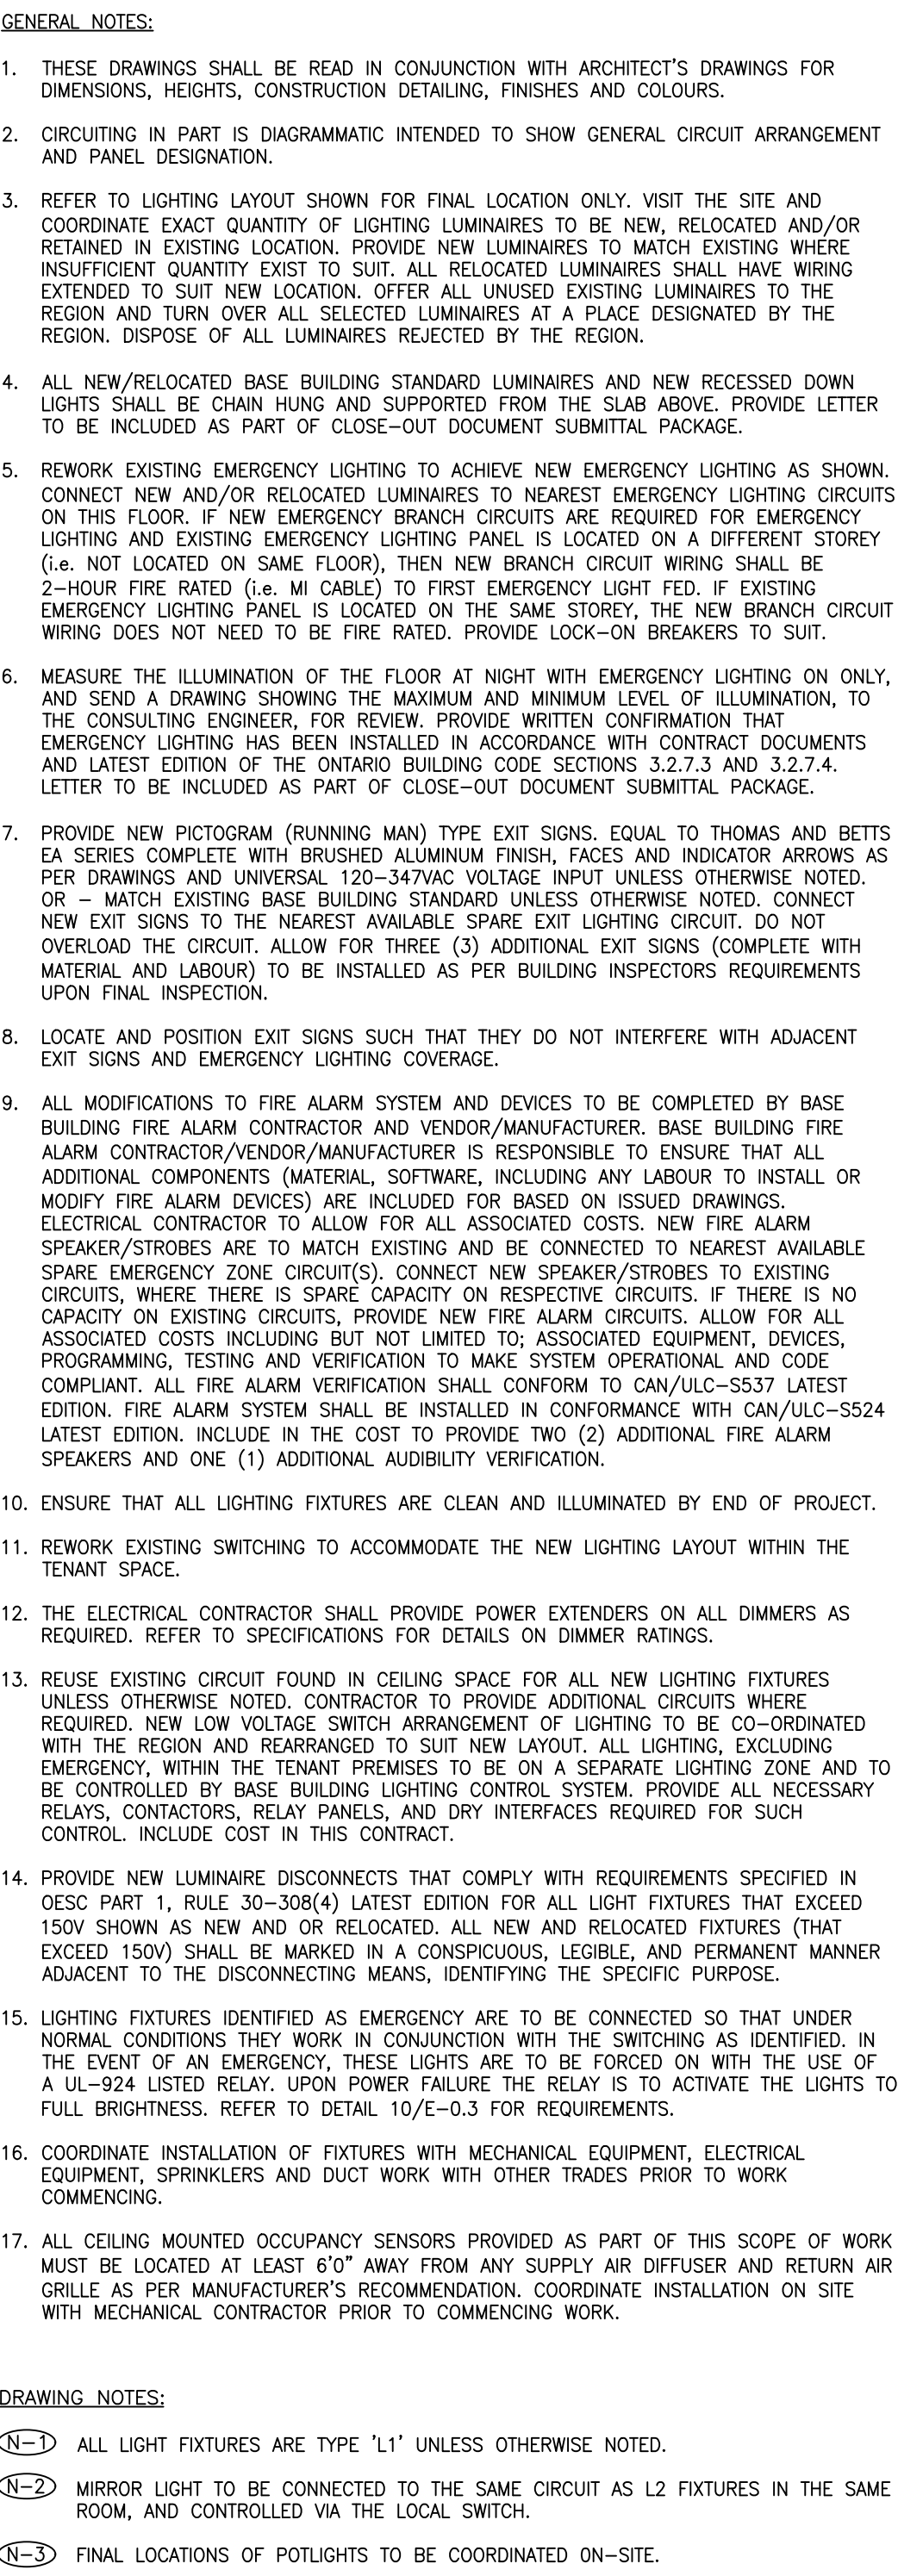

217 Richmond Street West, Suite 300
Toronto Ontario M5V 1W2
telephone: 416.351.8145
facsimile: 416.351.8146


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NAME: COLIN HODDER
TEL: 416-487-8151
EMAIL: Colin.Hodder@smithandandersen.com

THIS DRAWING SHALL BE READ IN CONJUNCTION
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THIS PROJECT.

STAMP

NORTH:

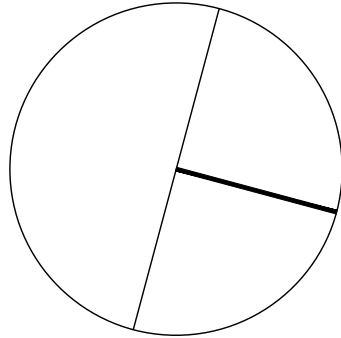

ENGINEER



Smith + Andersen

1100 - 100 Sheppard Ave. East, Toronto On, M2N 6N
416 487 8151 f 416 487 9104 smithyardgardens.com

PROJECT:

Administrative Centre
17250 Yonge Street
Newmarket, Ontario

SCALE: 1:100


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REVIEWED BY: NC

SHEET TITLE:
PARTIAL 4TH FLOOR -
LIGHTING & FIRE LARM
LAYOUT (PART B)

SHEET NUMBER:

TE-4.1B

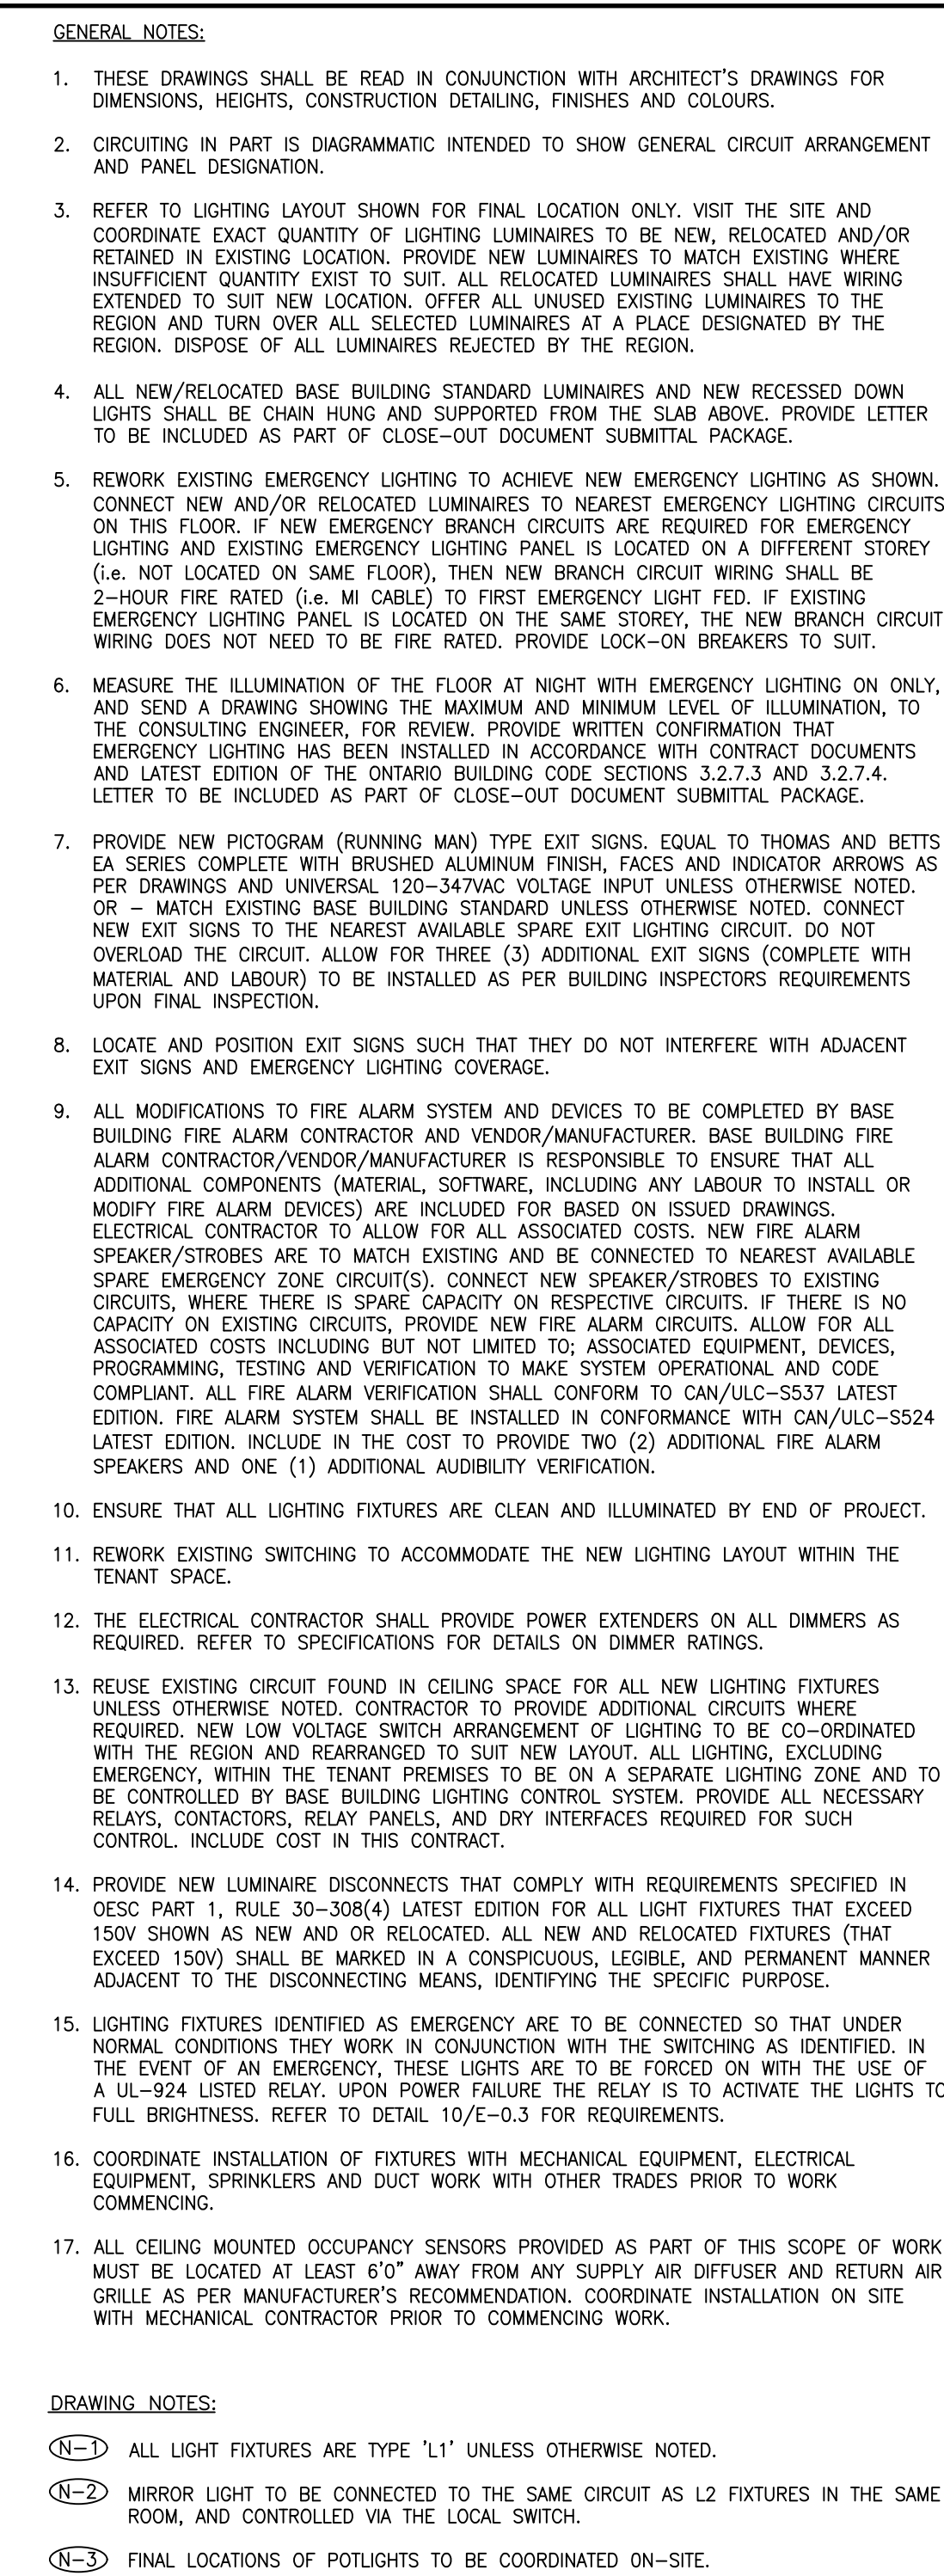

217 Richmond Street West, Suite 300
Toronto Ontario M5V 1W2
telephone: 416.351.8145
facsimile: 416.351.8146

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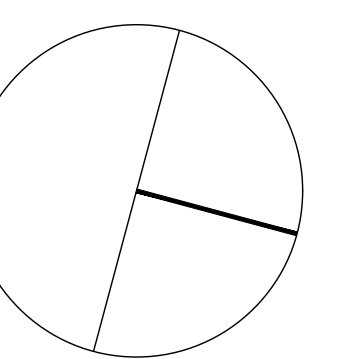
NAME: COLIN HODDER

TEL: 416-487-8151

EMAIL: Colin.Hodder@smithandandersen.com

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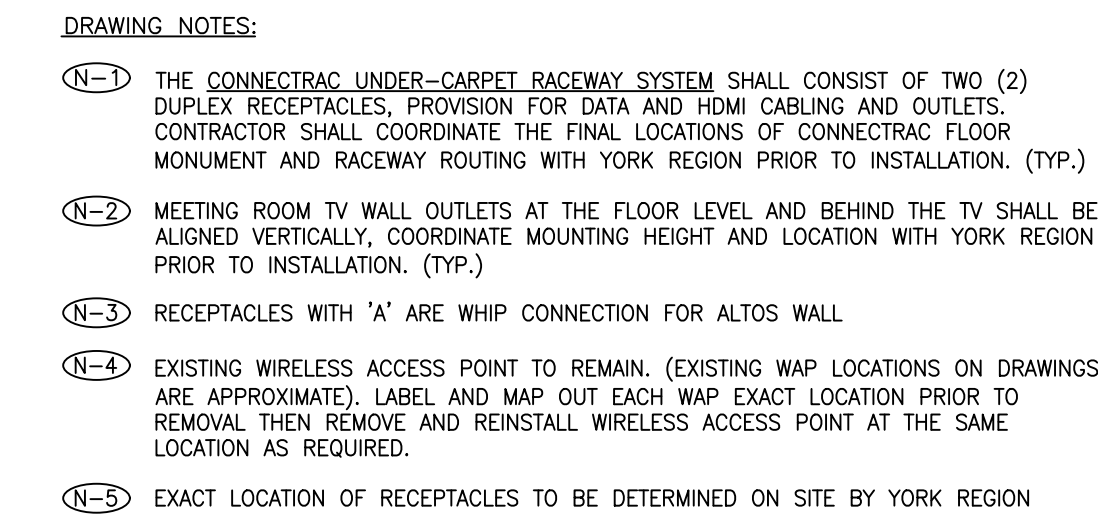


Smith + Andersen
1100 - 100 Sheppard Ave. East, Toronto, ON, M2N 6N5
416.487.8151 | 416.487.8108 | smith@smithandersen.com

Administrative Centre
17250 Yonge Street
Newmarket, Ontario

SHEET TITLE:
PARTIAL 4TH FLOOR –
LIGHTING & FIRE LARM
LAYOUT (PART C)

TE-4.1C




217 Richmond Street West, Suite 300
Toronto Ontario M5V 1W2
telephone: 416.351.8145
facsimile: 416.351.8146

PROJECT CONTACT	
NAME:	COLIN HODDER
TEL:	416-487-8151
E-MAIL:	Colin.Hodder@smithandandersen.com


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ENGINEER:



Smith + Andersen

1100 + 100 Sheppard Ave. East, Toronto, ON, M2N 6N5
416 487 8151 f 416 487 9104 smith@smithandandersen.com

PROJECT:

YORK REGION


Administrative Centre
17250 Yonge Street
Newmarket, Ontario

SCALE:	1:100
DRAWN BY:	CH
REVIEWED BY:	NC

SHEET TITLE:
PARTIAL LEVEL 4 - POWER
& SYSTEMS LAYOUT (PART
A)

SHEET NUMBER:

TE-4.2A

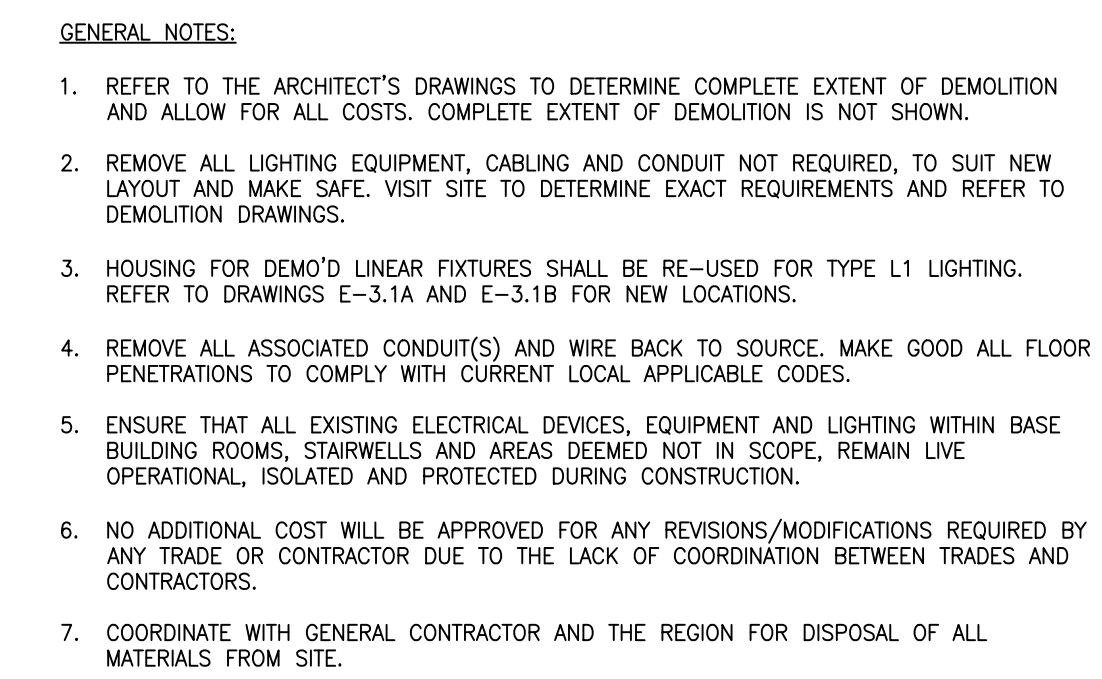


217 Richmond Street West, Suite 300
Toronto Ontario M5V 1W2
telephone: 416.351.8145
facsimile: 416.351.8146

[illegible]

NAME: COLIN HODDER
TEL: 416-487-8151
EMAIL: Colin.Hodder@smithandandersen.com


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A circular diagram divided into three sectors by two radii and a chord. The sectors are labeled 1, 2, and 3. Sector 1 is the largest, occupying approximately 150 degrees. Sector 2 is the smallest, occupying approximately 30 degrees. Sector 3 is the middle sector, occupying approximately 90 degrees. The radii are labeled 'r' and the chord is labeled 'c'.

ENGINEER:



Smith + Andersen

1100 - 100 Sheppard Ave. East, Toronto, On, M2N 6N5
416 487 0151 | 416 487 3104 info@smithandersen.com

PROJECT:

YORK REGION


Administrative Centre
17250 Yonge Street
Newmarket, Ontario

SCALE:	1:100
DRAWN BY:	CH
REVIEWED BY:	NC

SHEET TITLE:
PARIAL LEVEL 4 -
LIGHTING & FIRE ALARM
DEMOLITION LAYOUT PART
A

SHEET NUMBER:

TE-4.3A

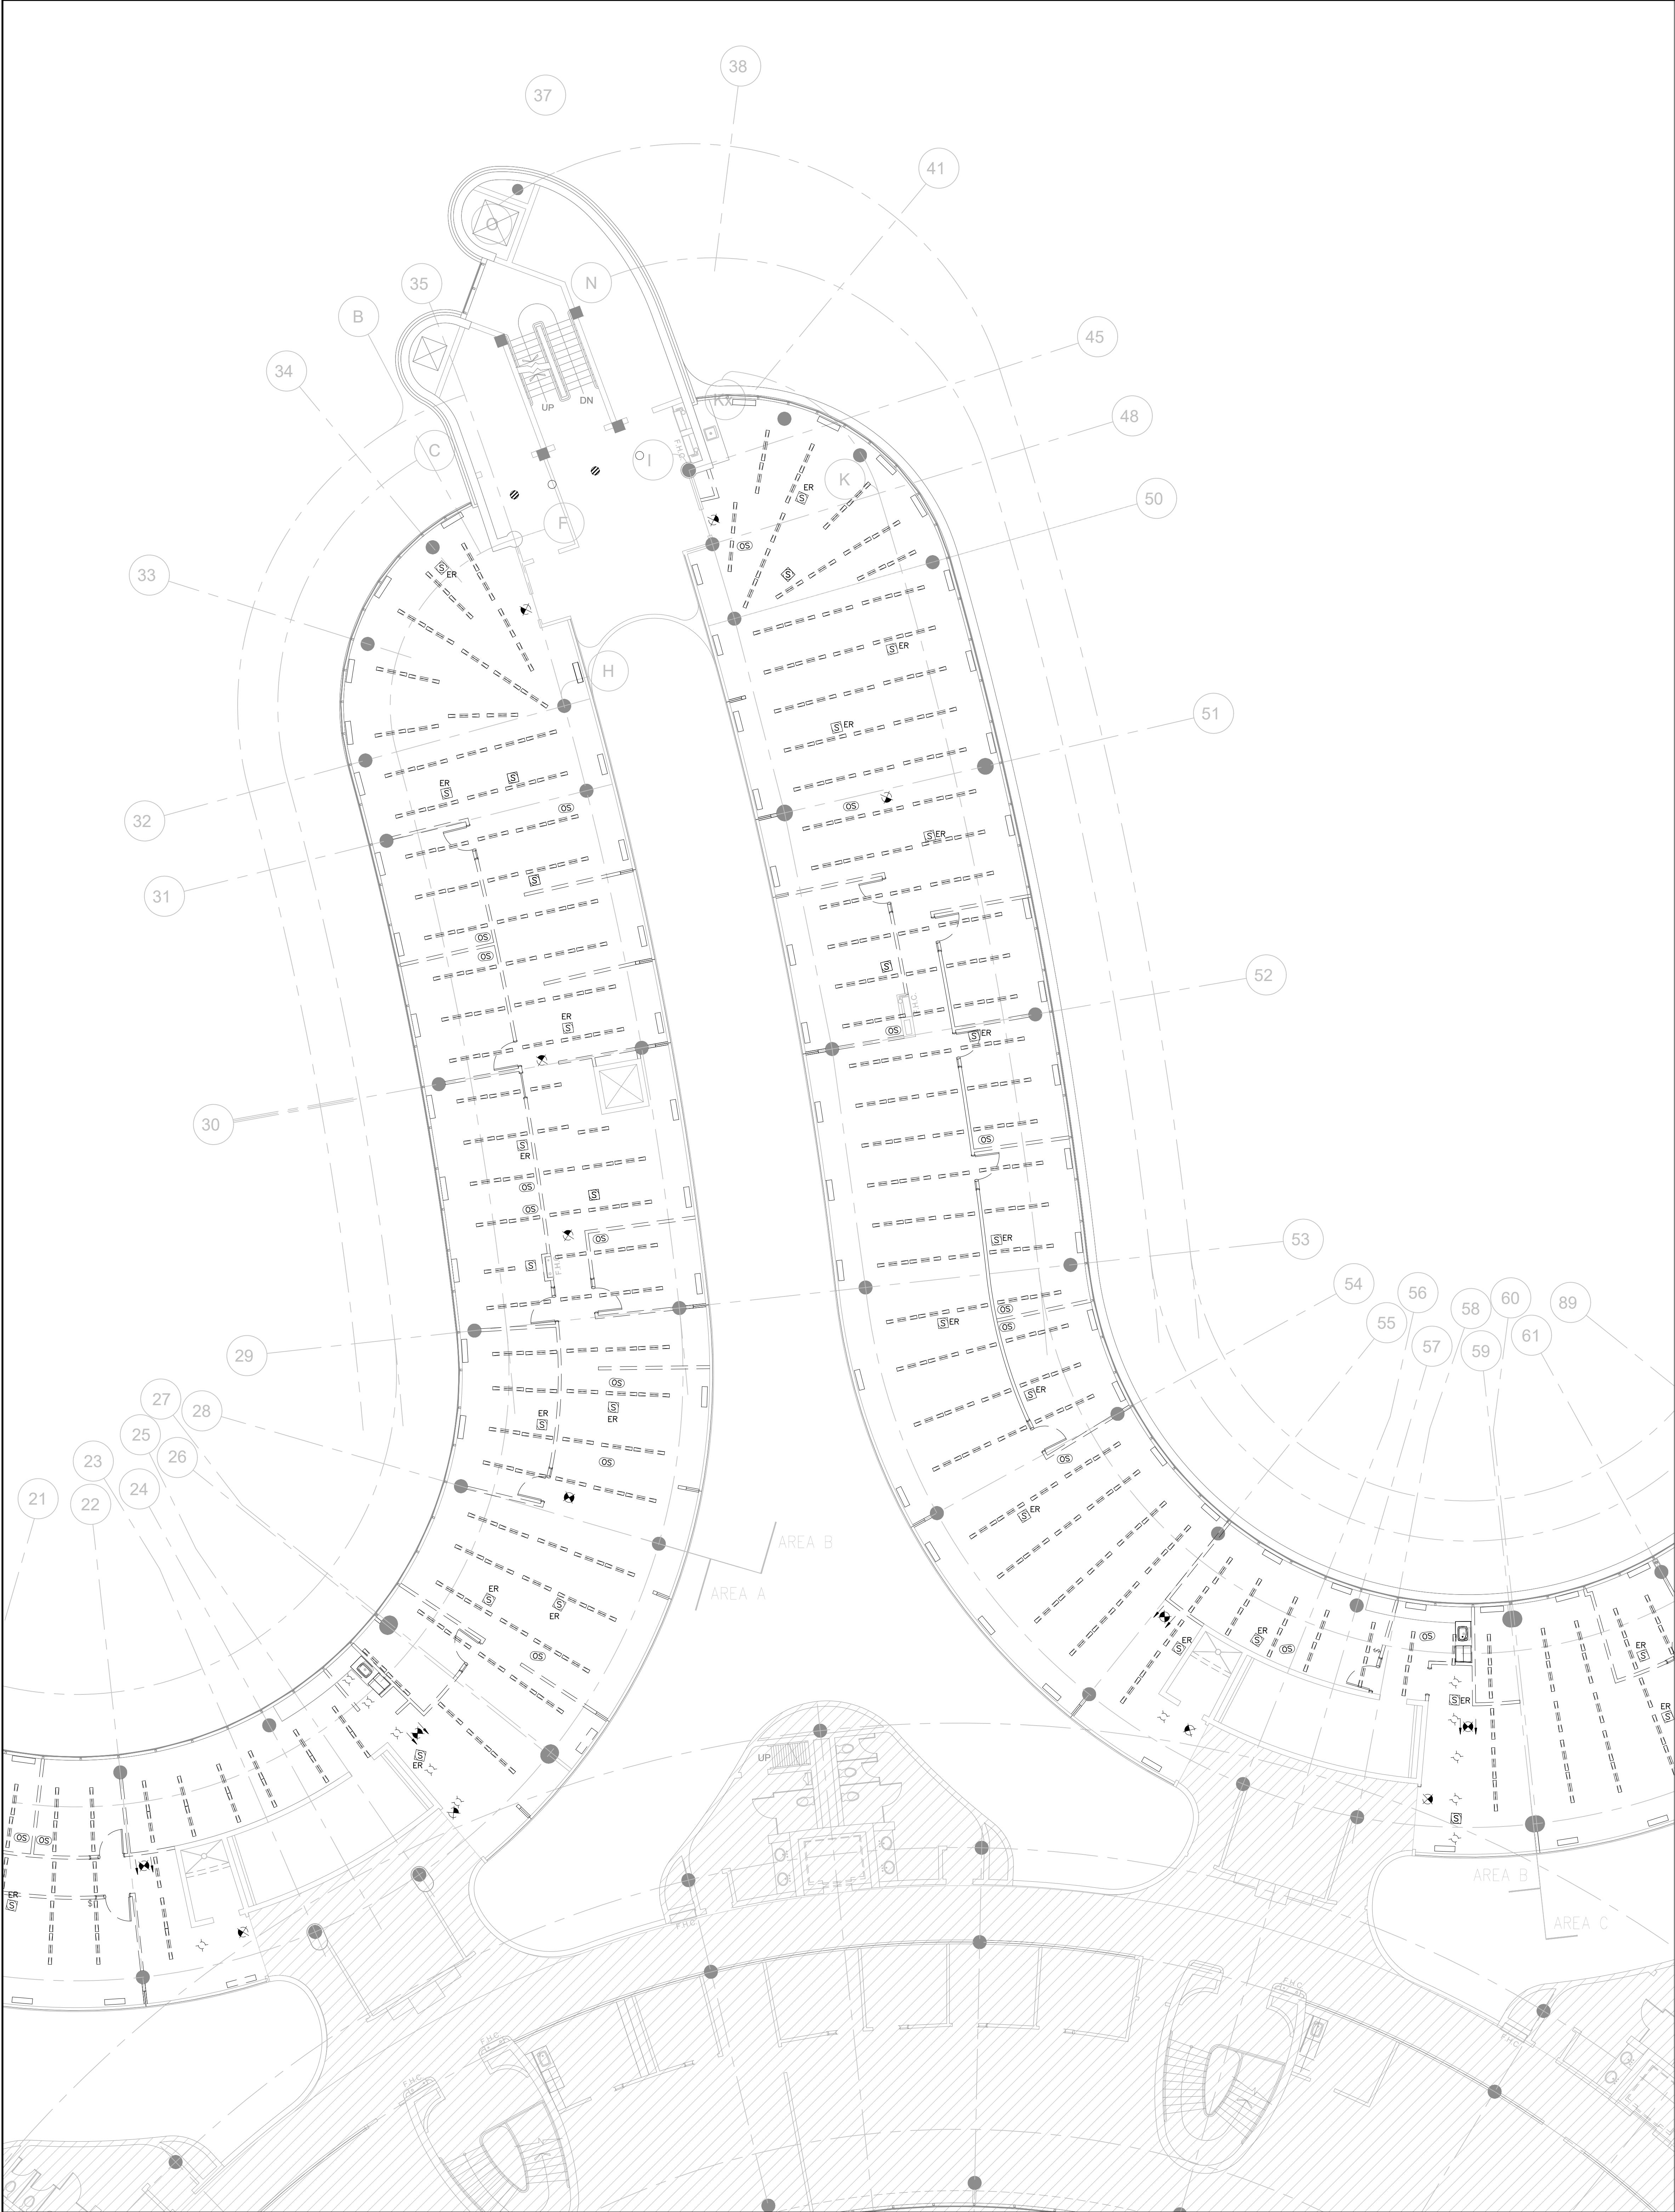

- GENERAL NOTES:
1. REFER TO THE ARCHITECT'S DRAWINGS TO DETERMINE COMPLETE EXTENT OF DEMOLITION AND ALLOW FOR ALL COSTS. COMPLETE EXTENT OF DEMOLITION IS NOT SHOWN.
 2. REMOVE ALL LIGHTING EQUIPMENT, CABLING AND CONDUIT NOT REQUIRED, TO SUIT NEW LAYOUT AND MAKE SAFE. VISIT SITE TO DETERMINE EXACT REQUIREMENTS AND REFER TO DEMOLITION DRAWINGS.
 3. HOUSING FOR DEMO'D LINEAR FIXTURES SHALL BE RE-USED FOR TYPE L1 LIGHTING. REFER TO DRAWINGS E-3.1A AND E-3.1B FOR NEW LOCATIONS.
 4. REMOVE ALL ASSOCIATED CONDUIT(S) AND WIRE BACK TO SOURCE. MAKE GOOD ALL FLOOR PENETRATIONS TO COMPLY WITH CURRENT LOCAL APPLICABLE CODES.
 5. ENSURE THAT ALL EXISTING ELECTRICAL DEVICES, EQUIPMENT AND LIGHTING WITHIN BASE BUILDING ROOMS, STAIRWELLS AND AREAS DEEMED NOT IN SCOPE, REMAIN LIVE OPERATIONAL, ISOLATED AND PROTECTED DURING CONSTRUCTION.
 6. NO ADDITIONAL COST WILL BE APPROVED FOR ANY REVISIONS/MODIFICATIONS REQUIRED BY ANY TRADE OR CONTRACTOR DUE TO THE LACK OF COORDINATION BETWEEN TRADES AND CONTRACTORS.
 7. COORDINATE WITH GENERAL CONTRACTOR AND THE REGION FOR DISPOSAL OF ALL MATERIALS FROM SITE.

G.Bruce Stratton Architects

217 Richmond Street West, Suite 300
Toronto Ontario M5V 1W2
telephone: 416.351.8145
facsimile: 416.351.8146

SUBMISSION	DATE	DESCRIPTION


PROJECT CONTACT

NAME: COLIN HODDER
TEL: 416-487-8151
EMAIL: Colin.Hodder@smithandandersen.com

THIS DRAWING SHALL BE READ IN CONJUNCTION WITH MECHANICAL SPECIFICATION SUBMITTED FOR THIS PROJECT.

STAMP:

NORTH:

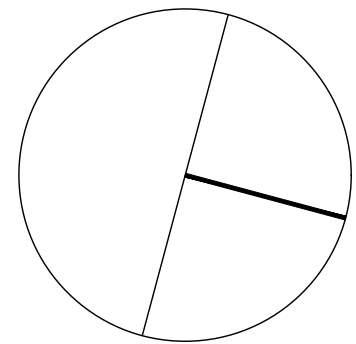

ENGINEER:

Smith + Andersen
1100 - 100 Sheppard Ave. East, Toronto, ON, M2N 6N5
416 487 8151 F 416 487 9104 smithandandersen.com

PROJECT:

YORK REGION

Administrative Centre
17250 Yonge Street
Newmarket, Ontario

SCALE: 1:100


DRAWN BY: CH

REVIEWED BY: NC

SHEET TITLE:
PARTIAL LEVEL 4 -
LIGHTING & FIRE ALARM
DEMOLITION LAYOUT (PART
B

SHEET NUMBER:

TE-4.3B

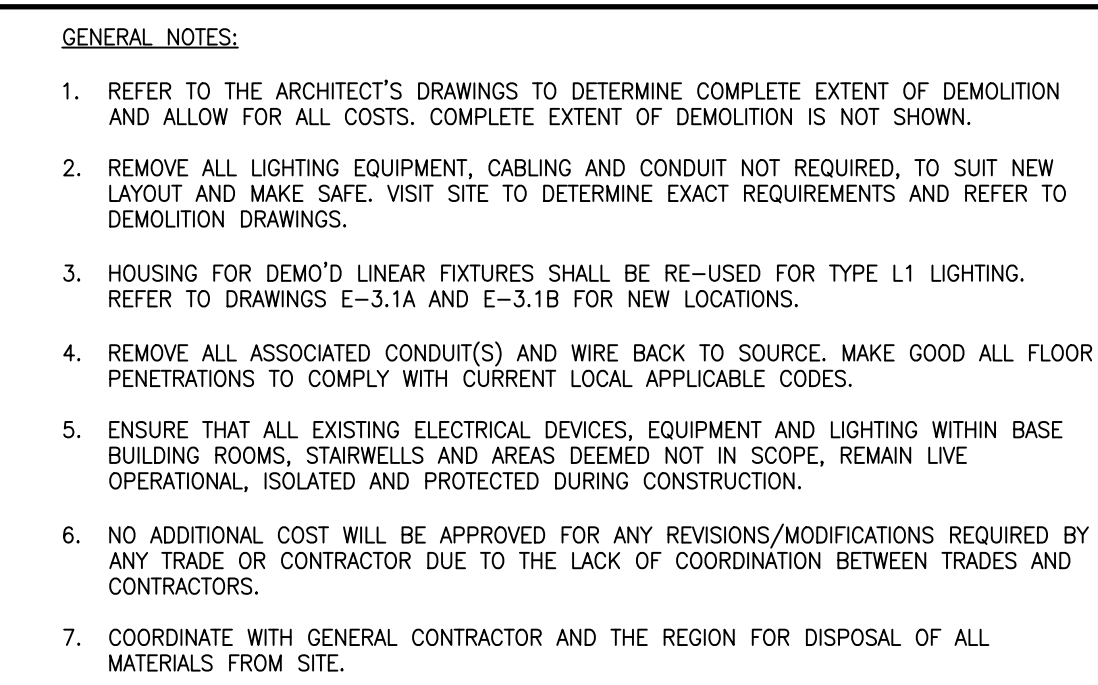

217 Richmond Street West, Suite 300
Toronto Ontario M5V 1W2
telephone: 416.351.8145
facsimile: 416.351.8146


[illegible]

NAME: COLIN HODDER

TEL: 416-487-8151

EMAIL: Colin.Hodder@smithandandersen.com

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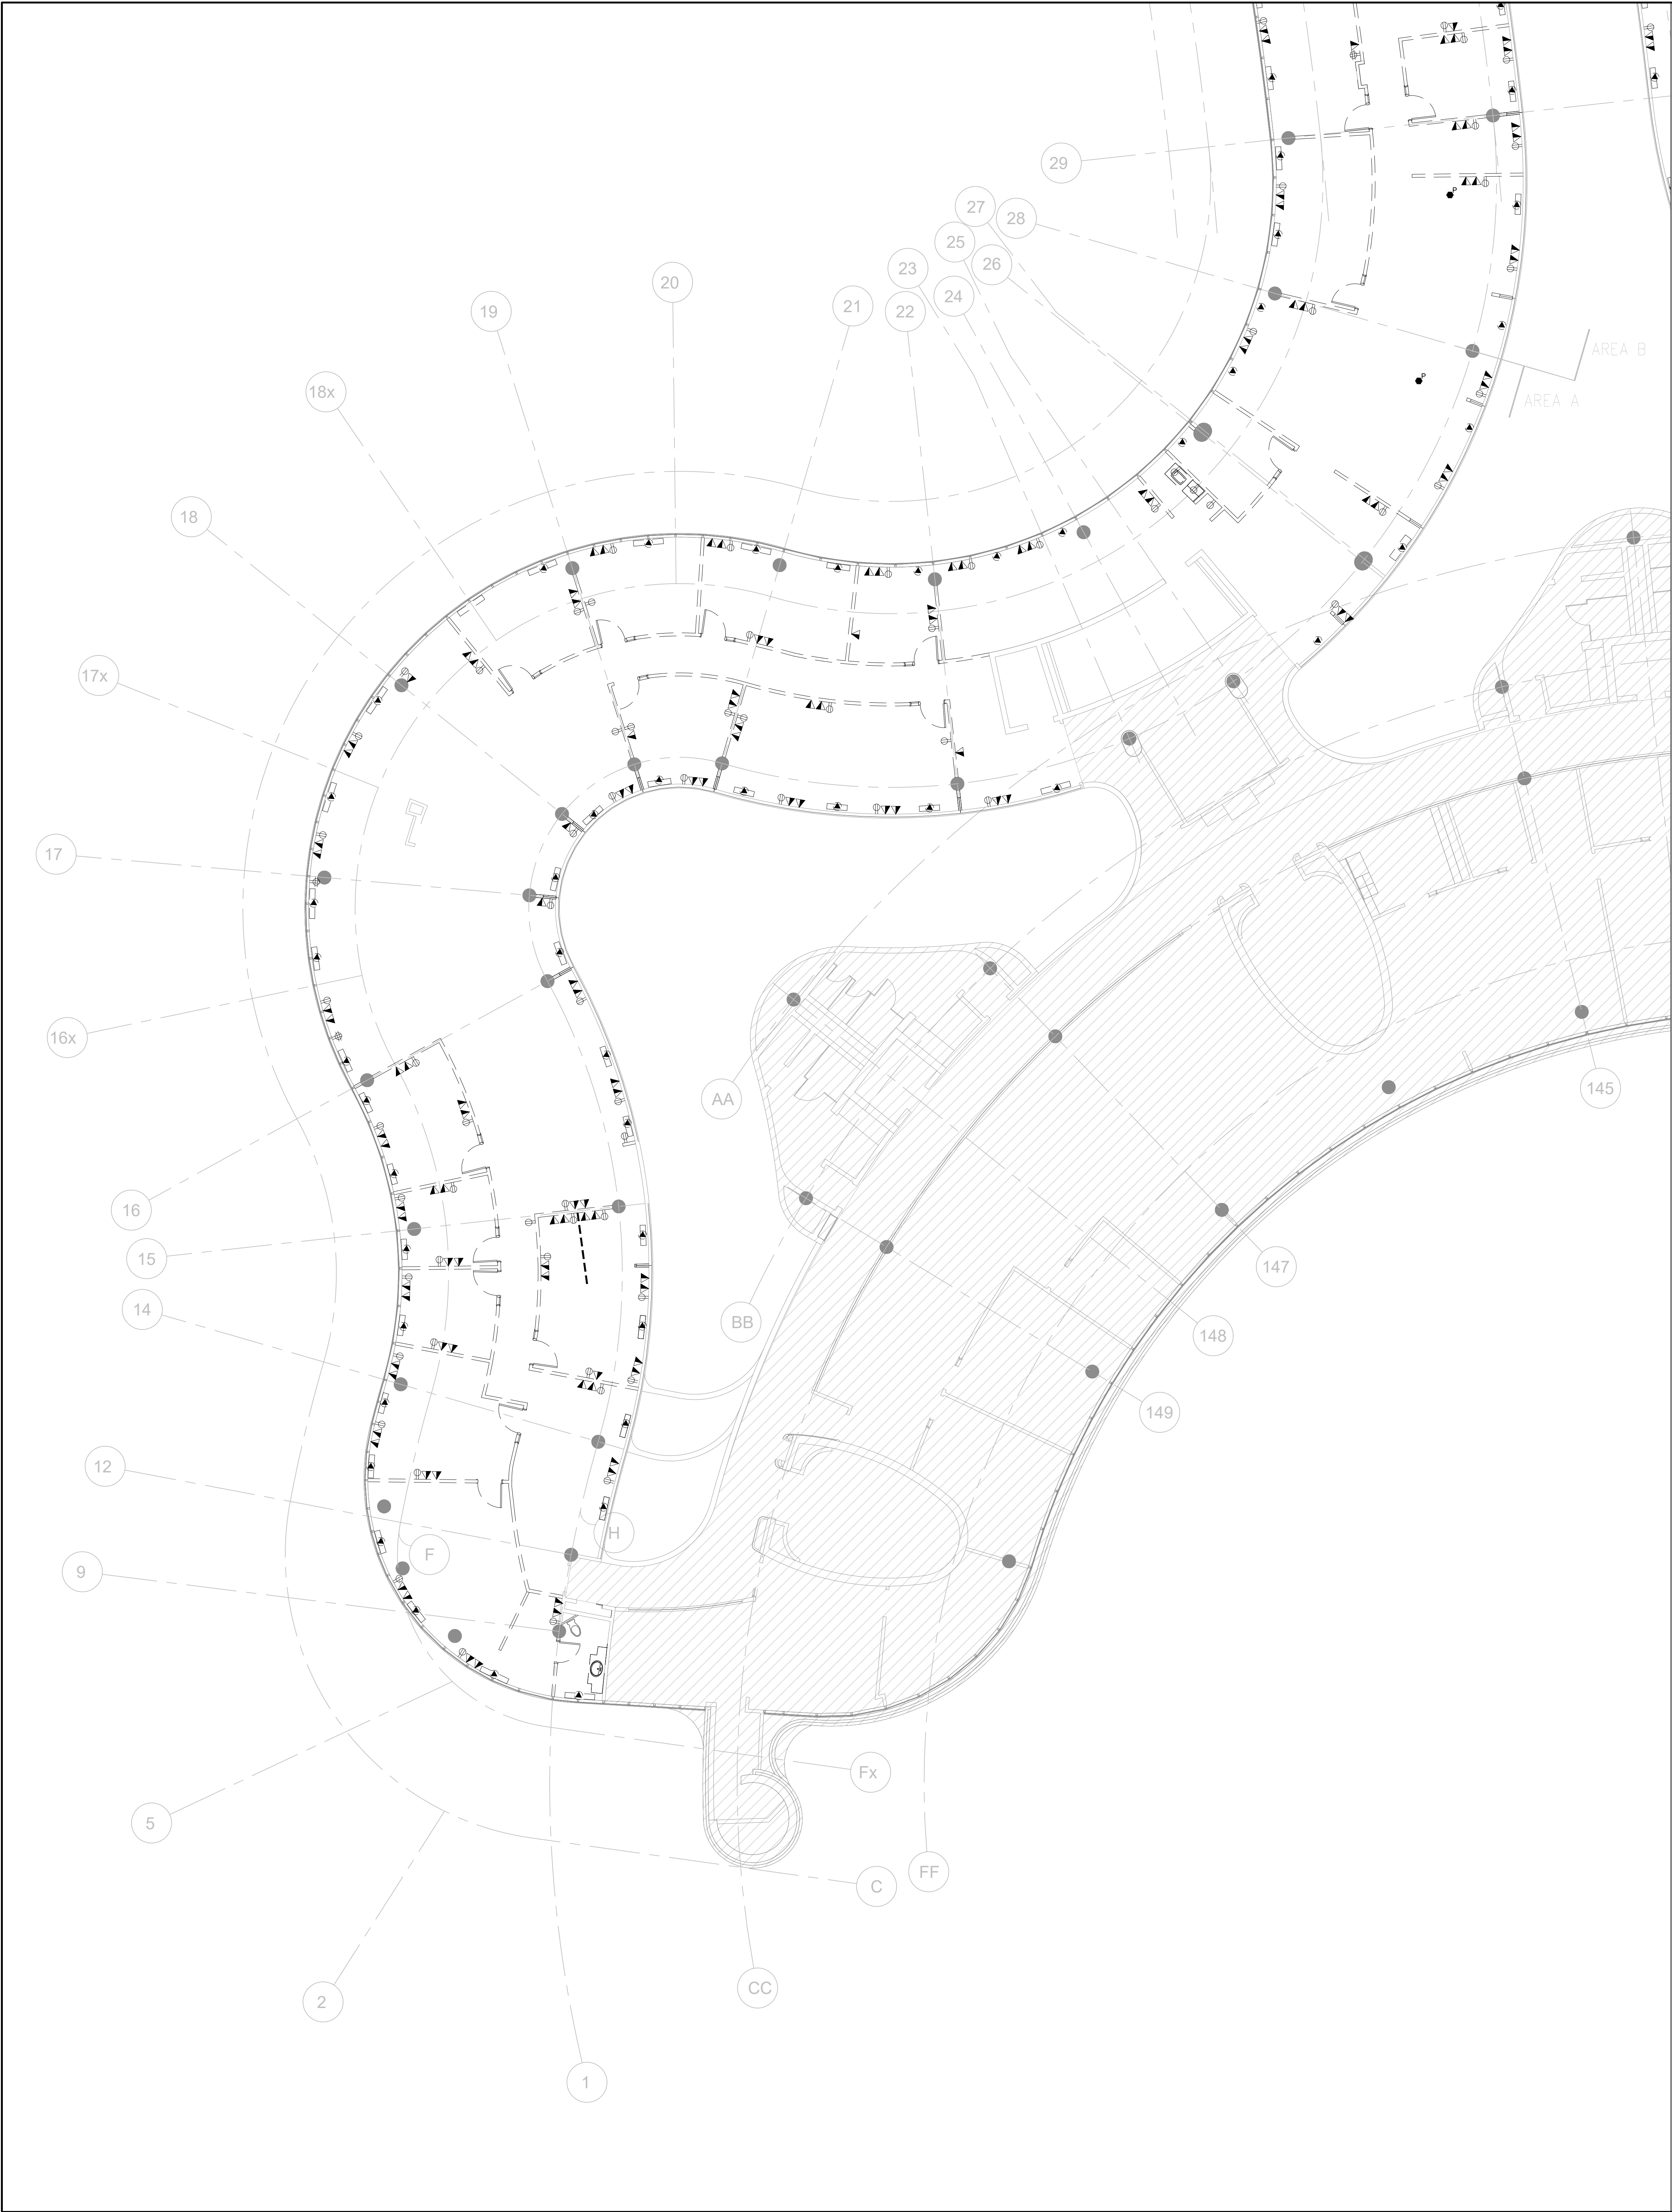


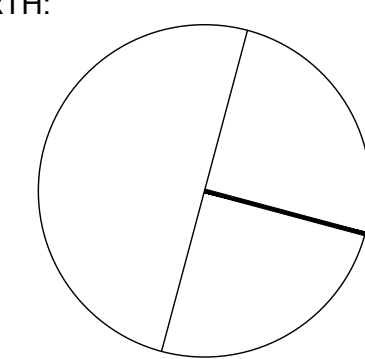Smith + Andersen
1100 - 100 Sheppard Ave. East, Toronto On, M2N 6N5
416.467.8151 f 416.467.9104 smithandandersen.com

Administrative Centre
17250 Yonge Street
Newmarket, Ontario

SHEET TITLE:
PARTIAL LEVEL 4 -
LIGHTING & FIRE ALARM
DEMOLITION LAYOUT (PART
C

TE-4.3C



- GENERAL NOTES:
1. REFER TO THE ARCHITECT'S DRAWINGS TO DETERMINE COMPLETE EXTENT OF DEMOLITION AND ALLOW FOR ALL COSTS. COMPLETE EXTENT OF DEMOLITION IS NOT SHOWN.
 2. REMOVE ALL FLOOR, COLUMN, CEILING, AND WALL MOUNTED POWER, TELEPHONE/DATA OUTLETS, AND CONDUIT NOT REQUIRED, TO SUIT NEW LAYOUT AND MAKE SAFE. VISIT SITE TO DETERMINE EXACT REQUIREMENTS AND REFER TO DEMOLITION DRAWINGS.
 3. REMOVE ALL HORIZONTAL DATA/VOICE CABLING.
 4. EXISTING COMMUNICATION FIBRE CABLES AND COMMUNICATION MULTIPAIR COPPER CABLES TO REMAIN AS IS.
 5. MAKE GOOD ALL CORE HOLES FROM ELECTRICAL EQUIPMENT AND DEVICES DISCONNECTED, RELOCATED AND OR REMOVED IN THIS PROJECT.
 6. REMOVE FLOOR MONUMENT(S) AND ALL ASSOCIATED CONDUIT(S) AND WIRE BACK TO SOURCE. MAKE GOOD ALL FLOOR PENETRATIONS TO COMPLY WITH CURRENT LOCAL APPLICABLE CODES.
 7. ENSURE THAT ALL EXISTING ELECTRICAL DEVICES, EQUIPMENT AND LIGHTING WITHIN BASE BUILDING ROOMS, STAIRWELLS AND AREAS DEEMED NOT IN SCOPE, REMAIN LIVE OPERATIONAL, ISOLATED AND PROTECTED DURING CONSTRUCTION.
 8. NO ADDITIONAL COST WILL BE APPROVED FOR ANY REVISIONS/MODIFICATIONS REQUIRED BY ANY TRADE OR CONTRACTOR DUE TO THE LACK OF COORDINATION BETWEEN TRADES AND CONTRACTORS.
 9. COORDINATE WITH GENERAL CONTRACTOR AND THE REGION FOR DISPOSAL OF ALL MATERIALS FROM SITE.

G.Bruce Stratton Architects

217 Richmond Street West, Suite 300
Toronto Ontario M5V 1W2
telephone: 416.351.8145
facsimile: 416.351.8146

SUBMISSION	DATE	DESCRIPTION
1	2022-03-14	ISSUED FOR 60% REVIEW
2	2022-04-27	ISSUED FOR 80% REVIEW
3	2022-04-31	ISSUED FOR 97% REVIEW
4	2022-06-13	ISSUED FOR TENDER

PROJECT CONTACT

NAME: COLIN HODDER
TEL: 416-487-8151
EMAIL: Colin.Hodder@smithandandersen.com

THIS DRAWING SHALL BE READ IN CONJUNCTION WITH MECHANICAL SPECIFICATION SUBMITTED FOR THIS PROJECT.

STAMP:	NORTH:
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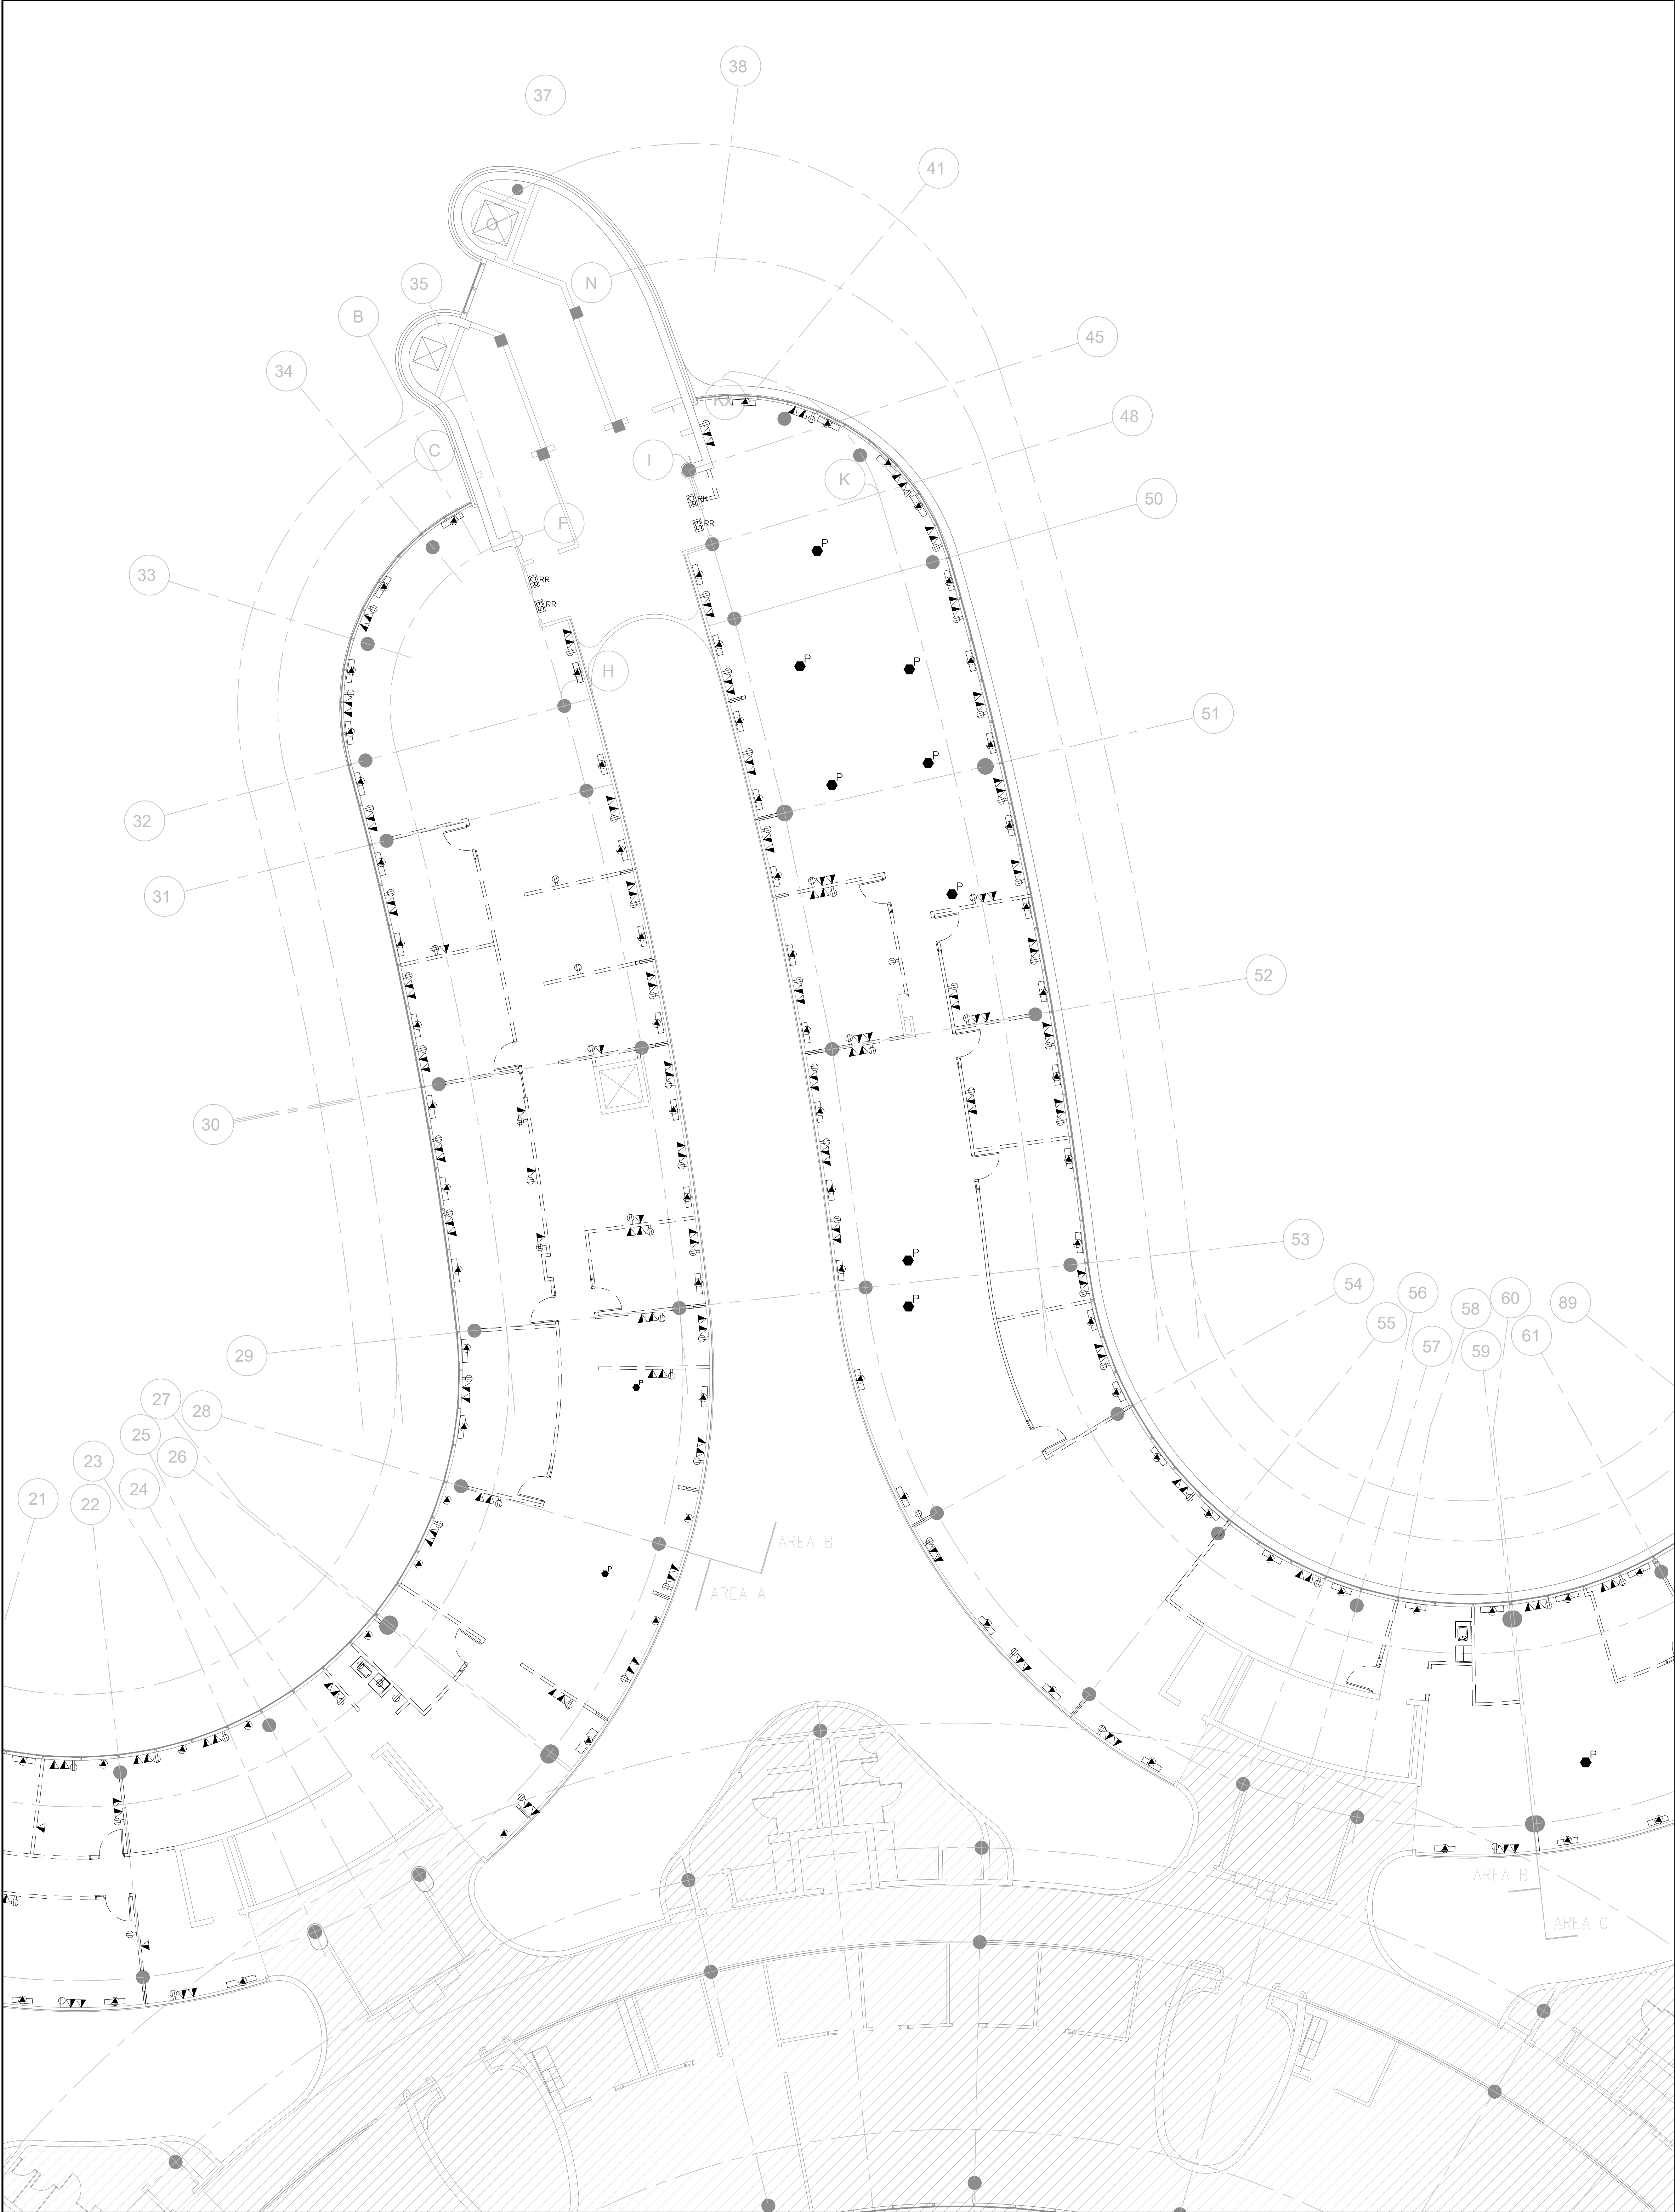
ENGINEER:


Smith + Andersen
1100 - 100 Sheppard Ave. East, Toronto, ON, M2N 6N5
416 487 8151 | 416 487 9104 | smithandandersen.com

PROJECT:

YORK REGION
Administrative Centre
17250 Yonge Street
Newmarket, Ontario

SCALE:	1:100
DRAWN BY:	CH
REVIEWED BY:	NC
SHEET TITLE:	PARTIAL LEVEL 4 - POWER & SYSTEMS DEMOLITION LAYOUT (PART A)
SHEET NUMBER:	TE-4.4A



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Smith + Andersen
1100 — 1105 Sheppard Ave. East, Toronto, ON, M2N 6N5
416 487 8151 F 416 487 9104 smithandandersen.com

PROJECT:

YORK REGION

Administrative Centre
17250 Yonge Street
Newmarket, Ontario

SCALE:

1:100

DRAWN BY:

CH

REVIEWED BY:


NC

SHEET TITLE:

PARTIAL LEVEL 4 — POWER
& SYSTEMS DEMOLITION
LAYOUT (PART B)

SHEET NUMBER:

TE-4.4B

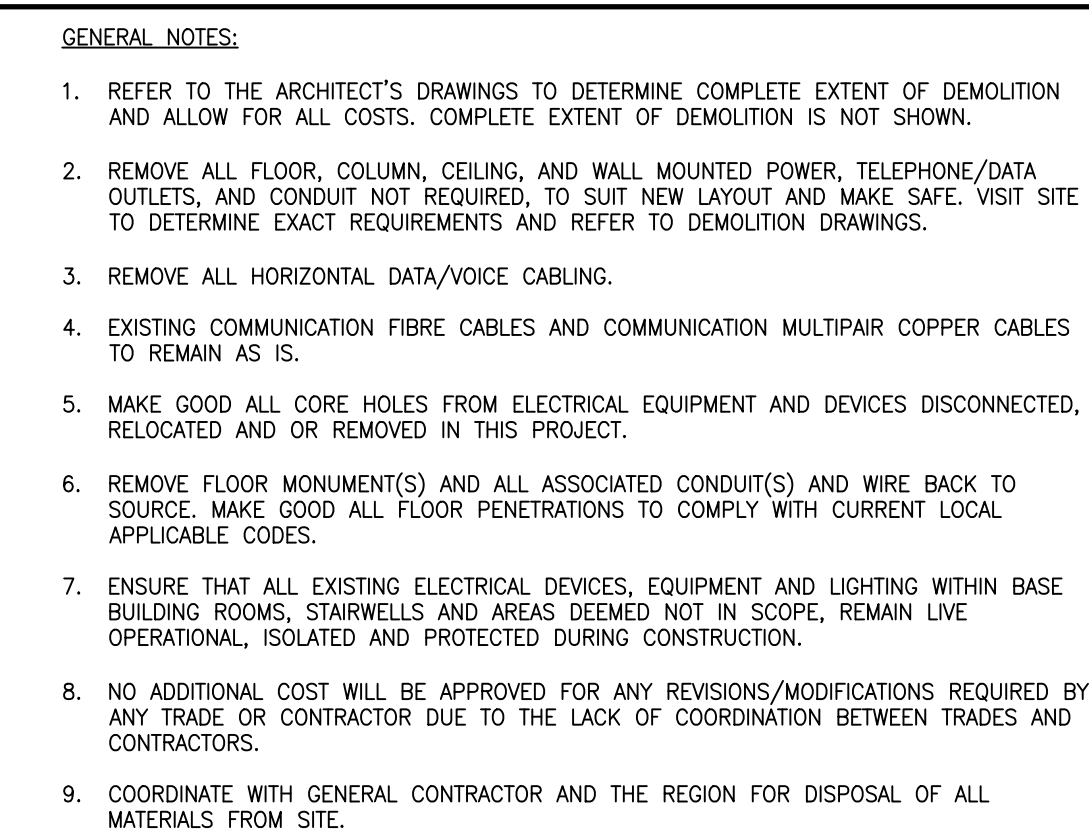

G.Bruce Stratton Architects

217 Richmond Street West, Suite 300
Toronto Ontario M5V 1W2
telephone: 416.351.8145
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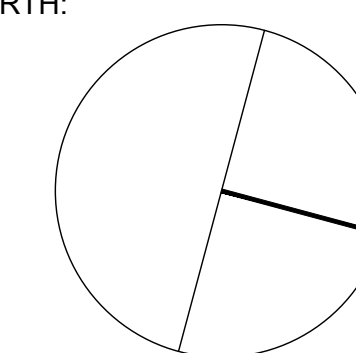
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Smith + Andersen
1100 - 100 Sheppard Ave. East, Toronto On, M2N 6N5
416 487 8151 f 416 487 8104 smithandandersen.com

PROJECT:

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Administrative Centre
17250 Yonge Street
Newmarket, Ontario

SCALE: 1:100

DRAWN BY: CH


REVIEWED BY: NC

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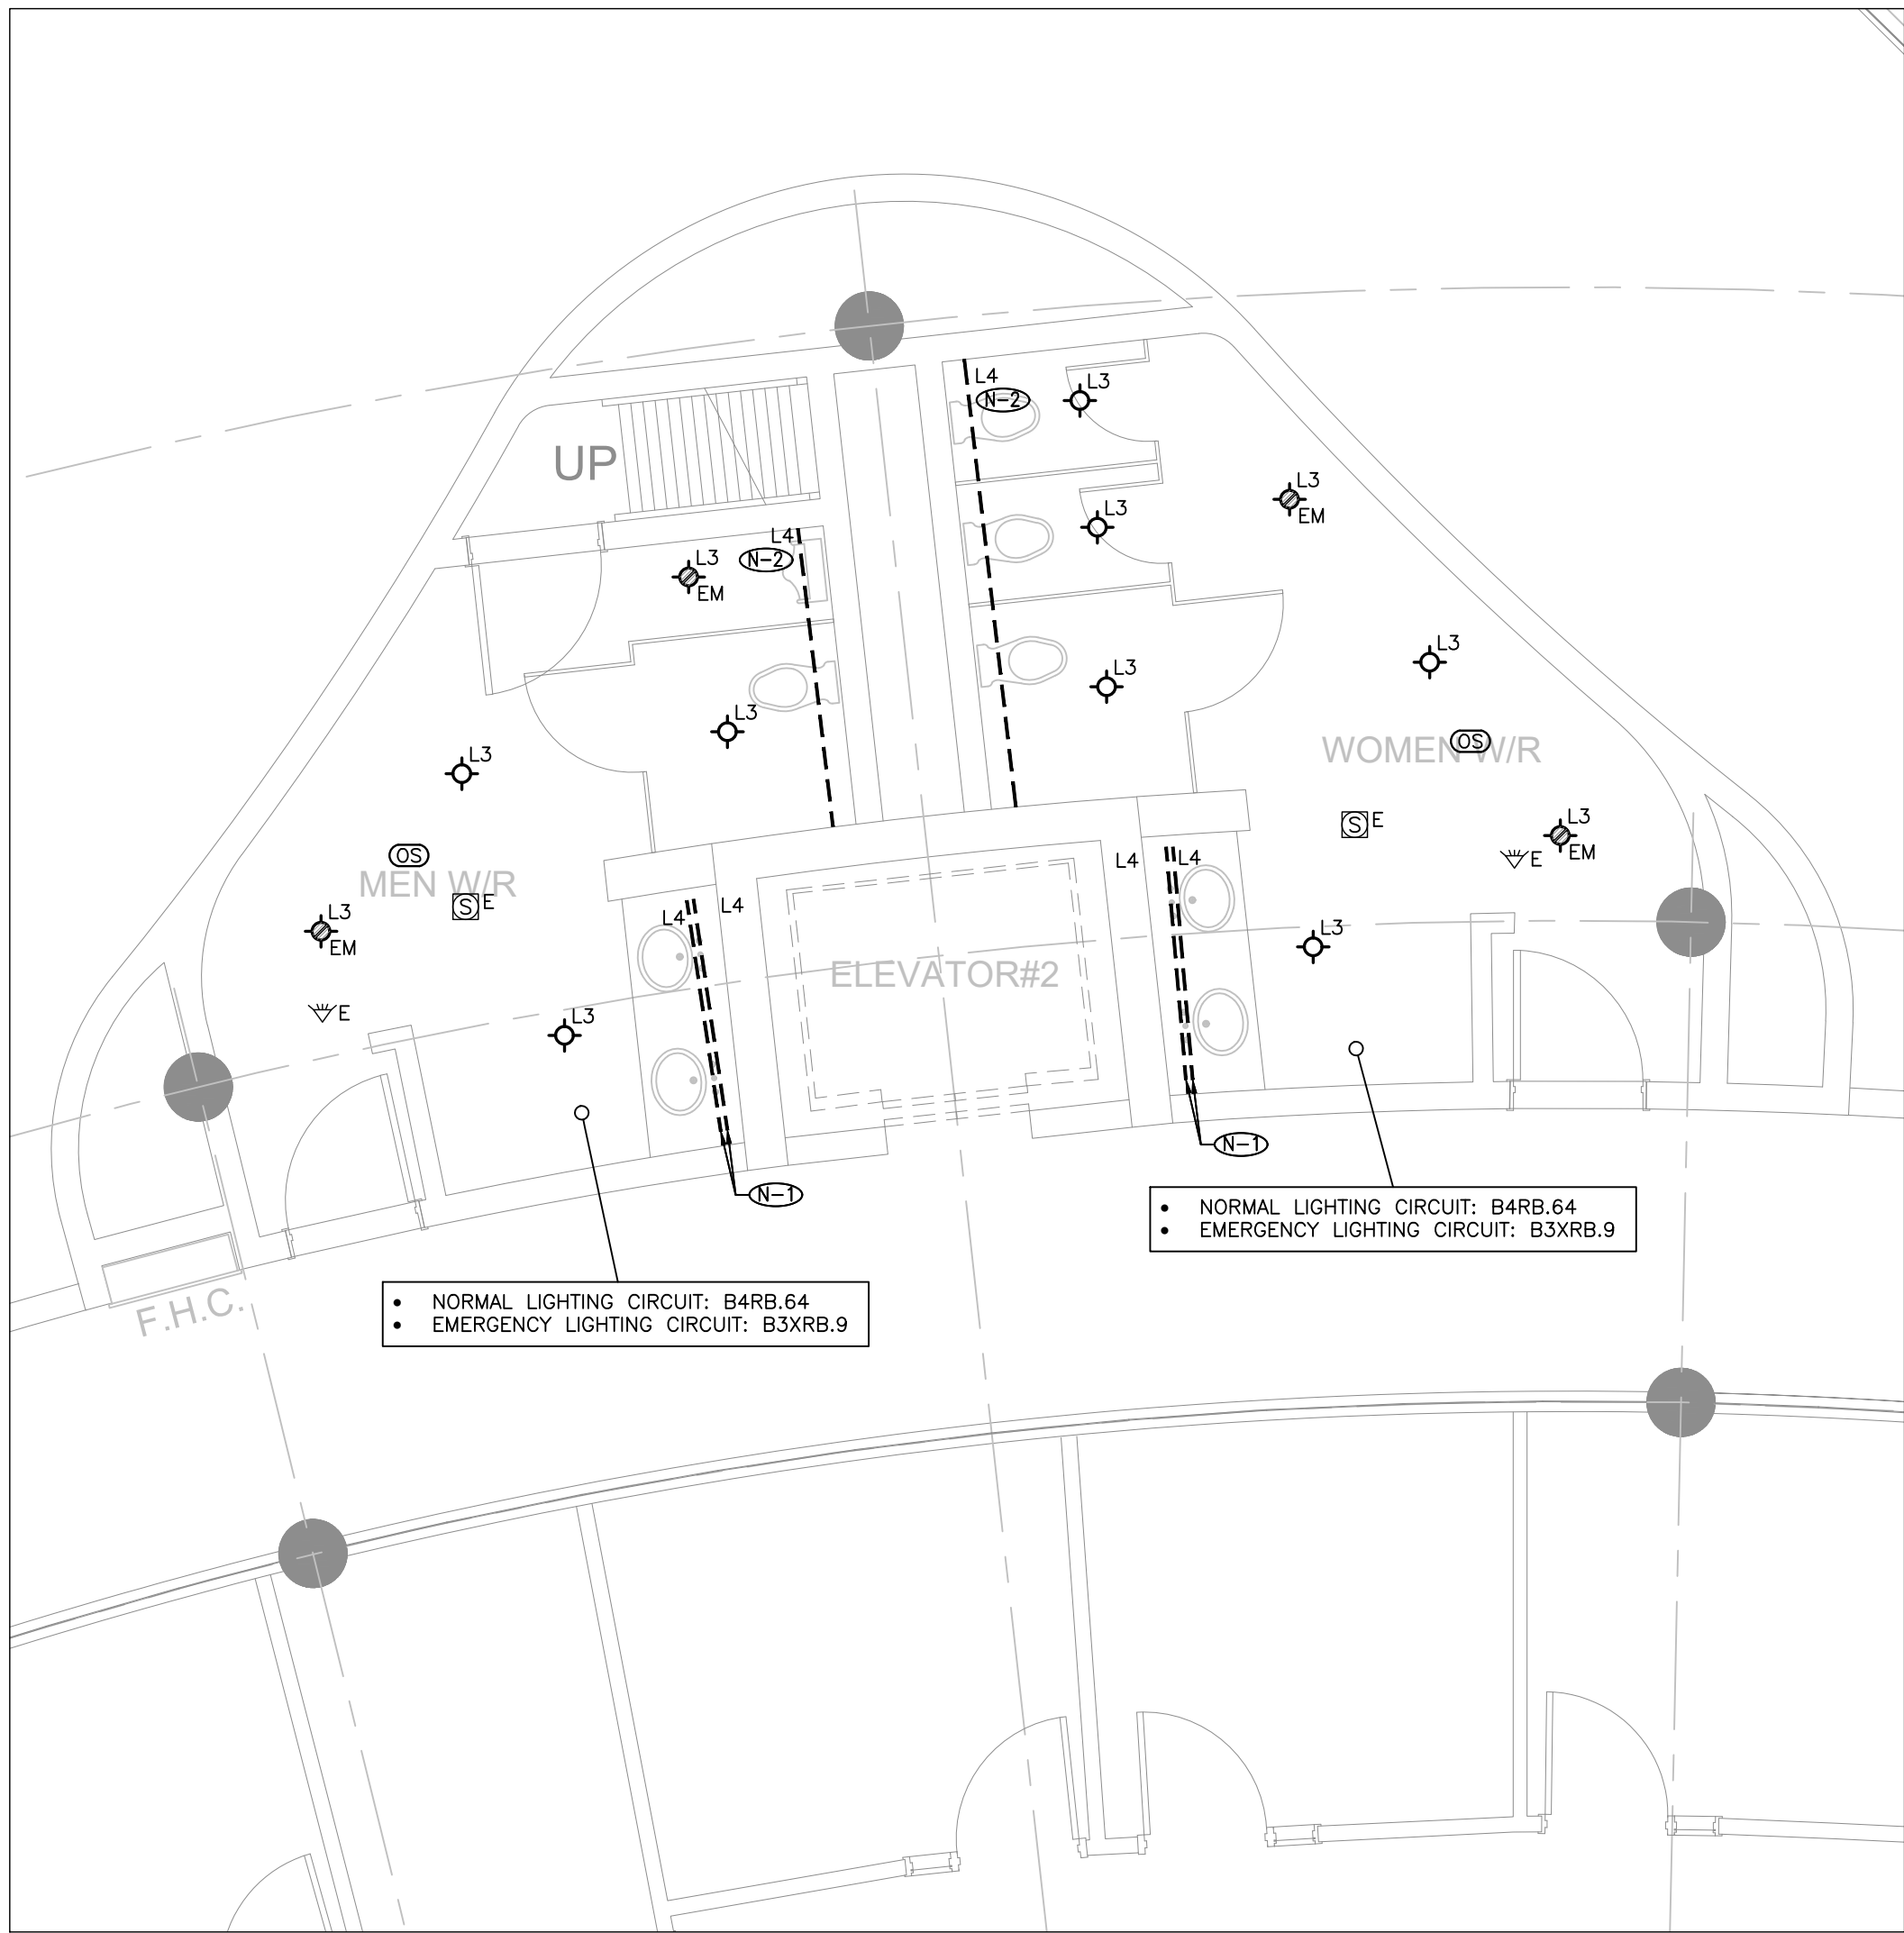
PARTIAL LEVEL 4 - POWER
& SYSTEMS DEMOLITION
LAYOUT (PART C)

SHEET NUMBER:


TE-4.4C

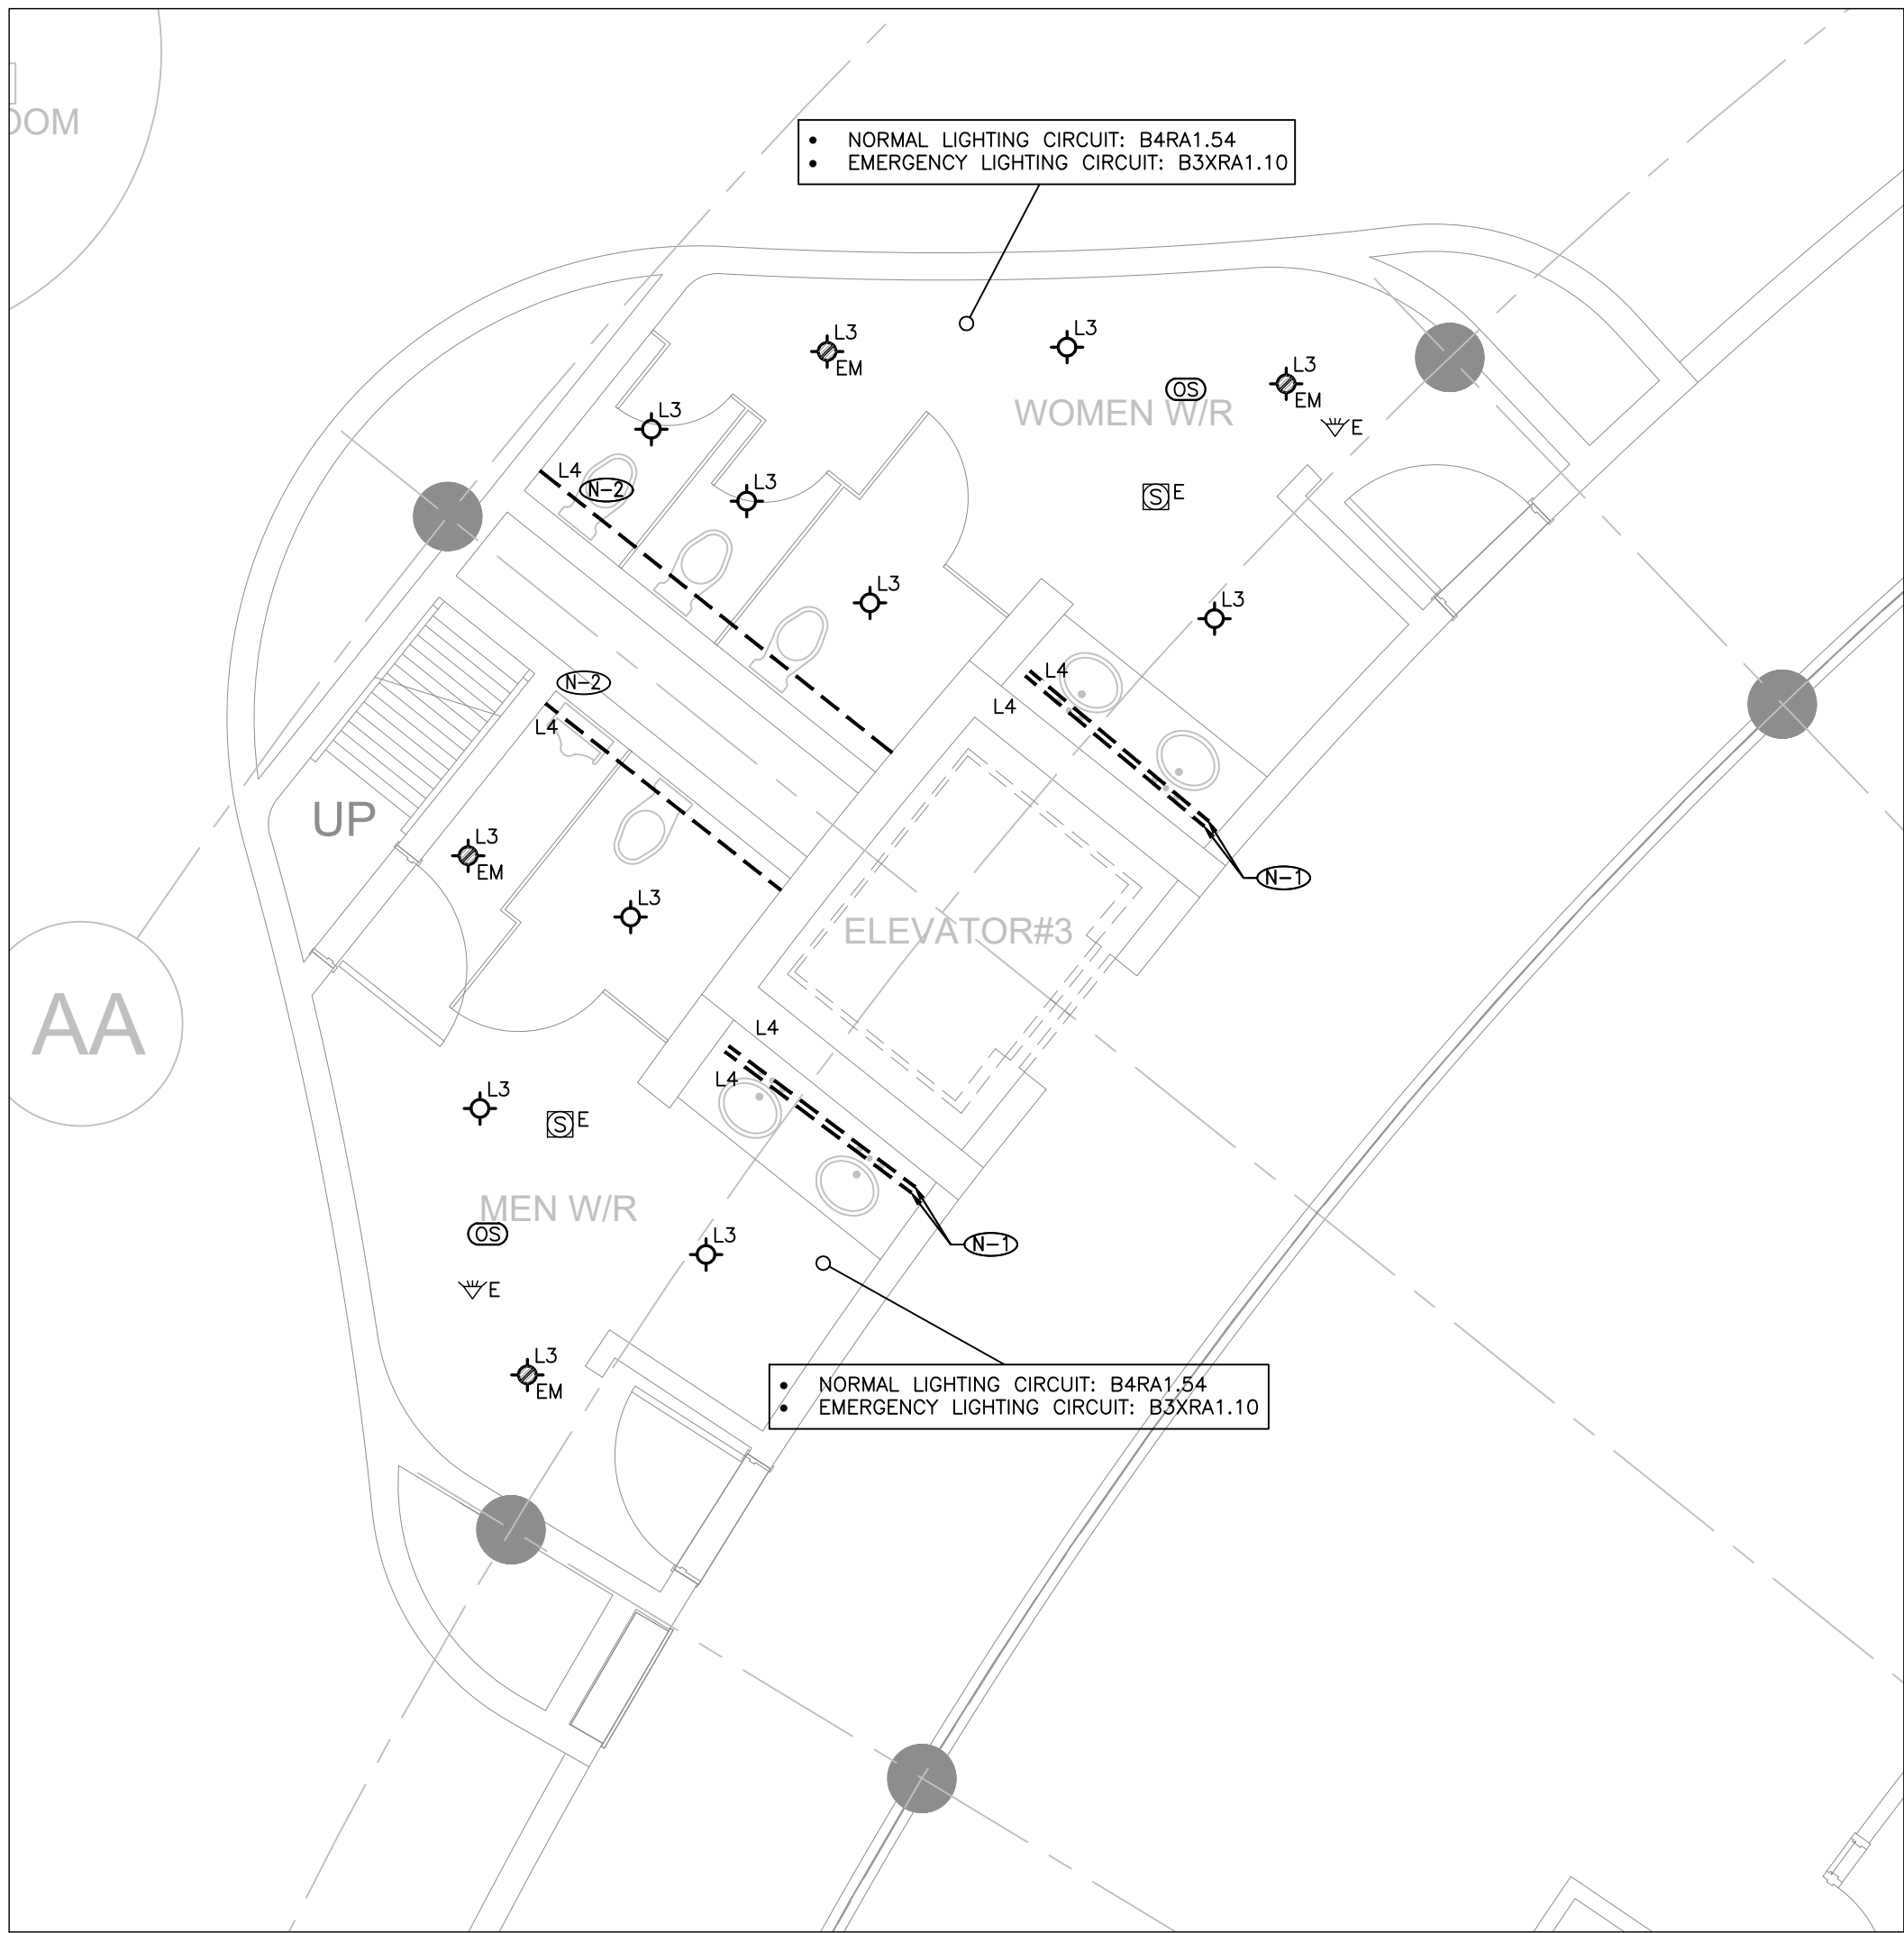

3 LEVEL 4 CEILING PLAN – W/R'S 4-88 & 4-89
E-4.5 SCALE: 1:50



2 LEVEL 4 CEILING PLAN – W/R'S 4-90 & 4-91
E-4.5 SCALE: 1:50

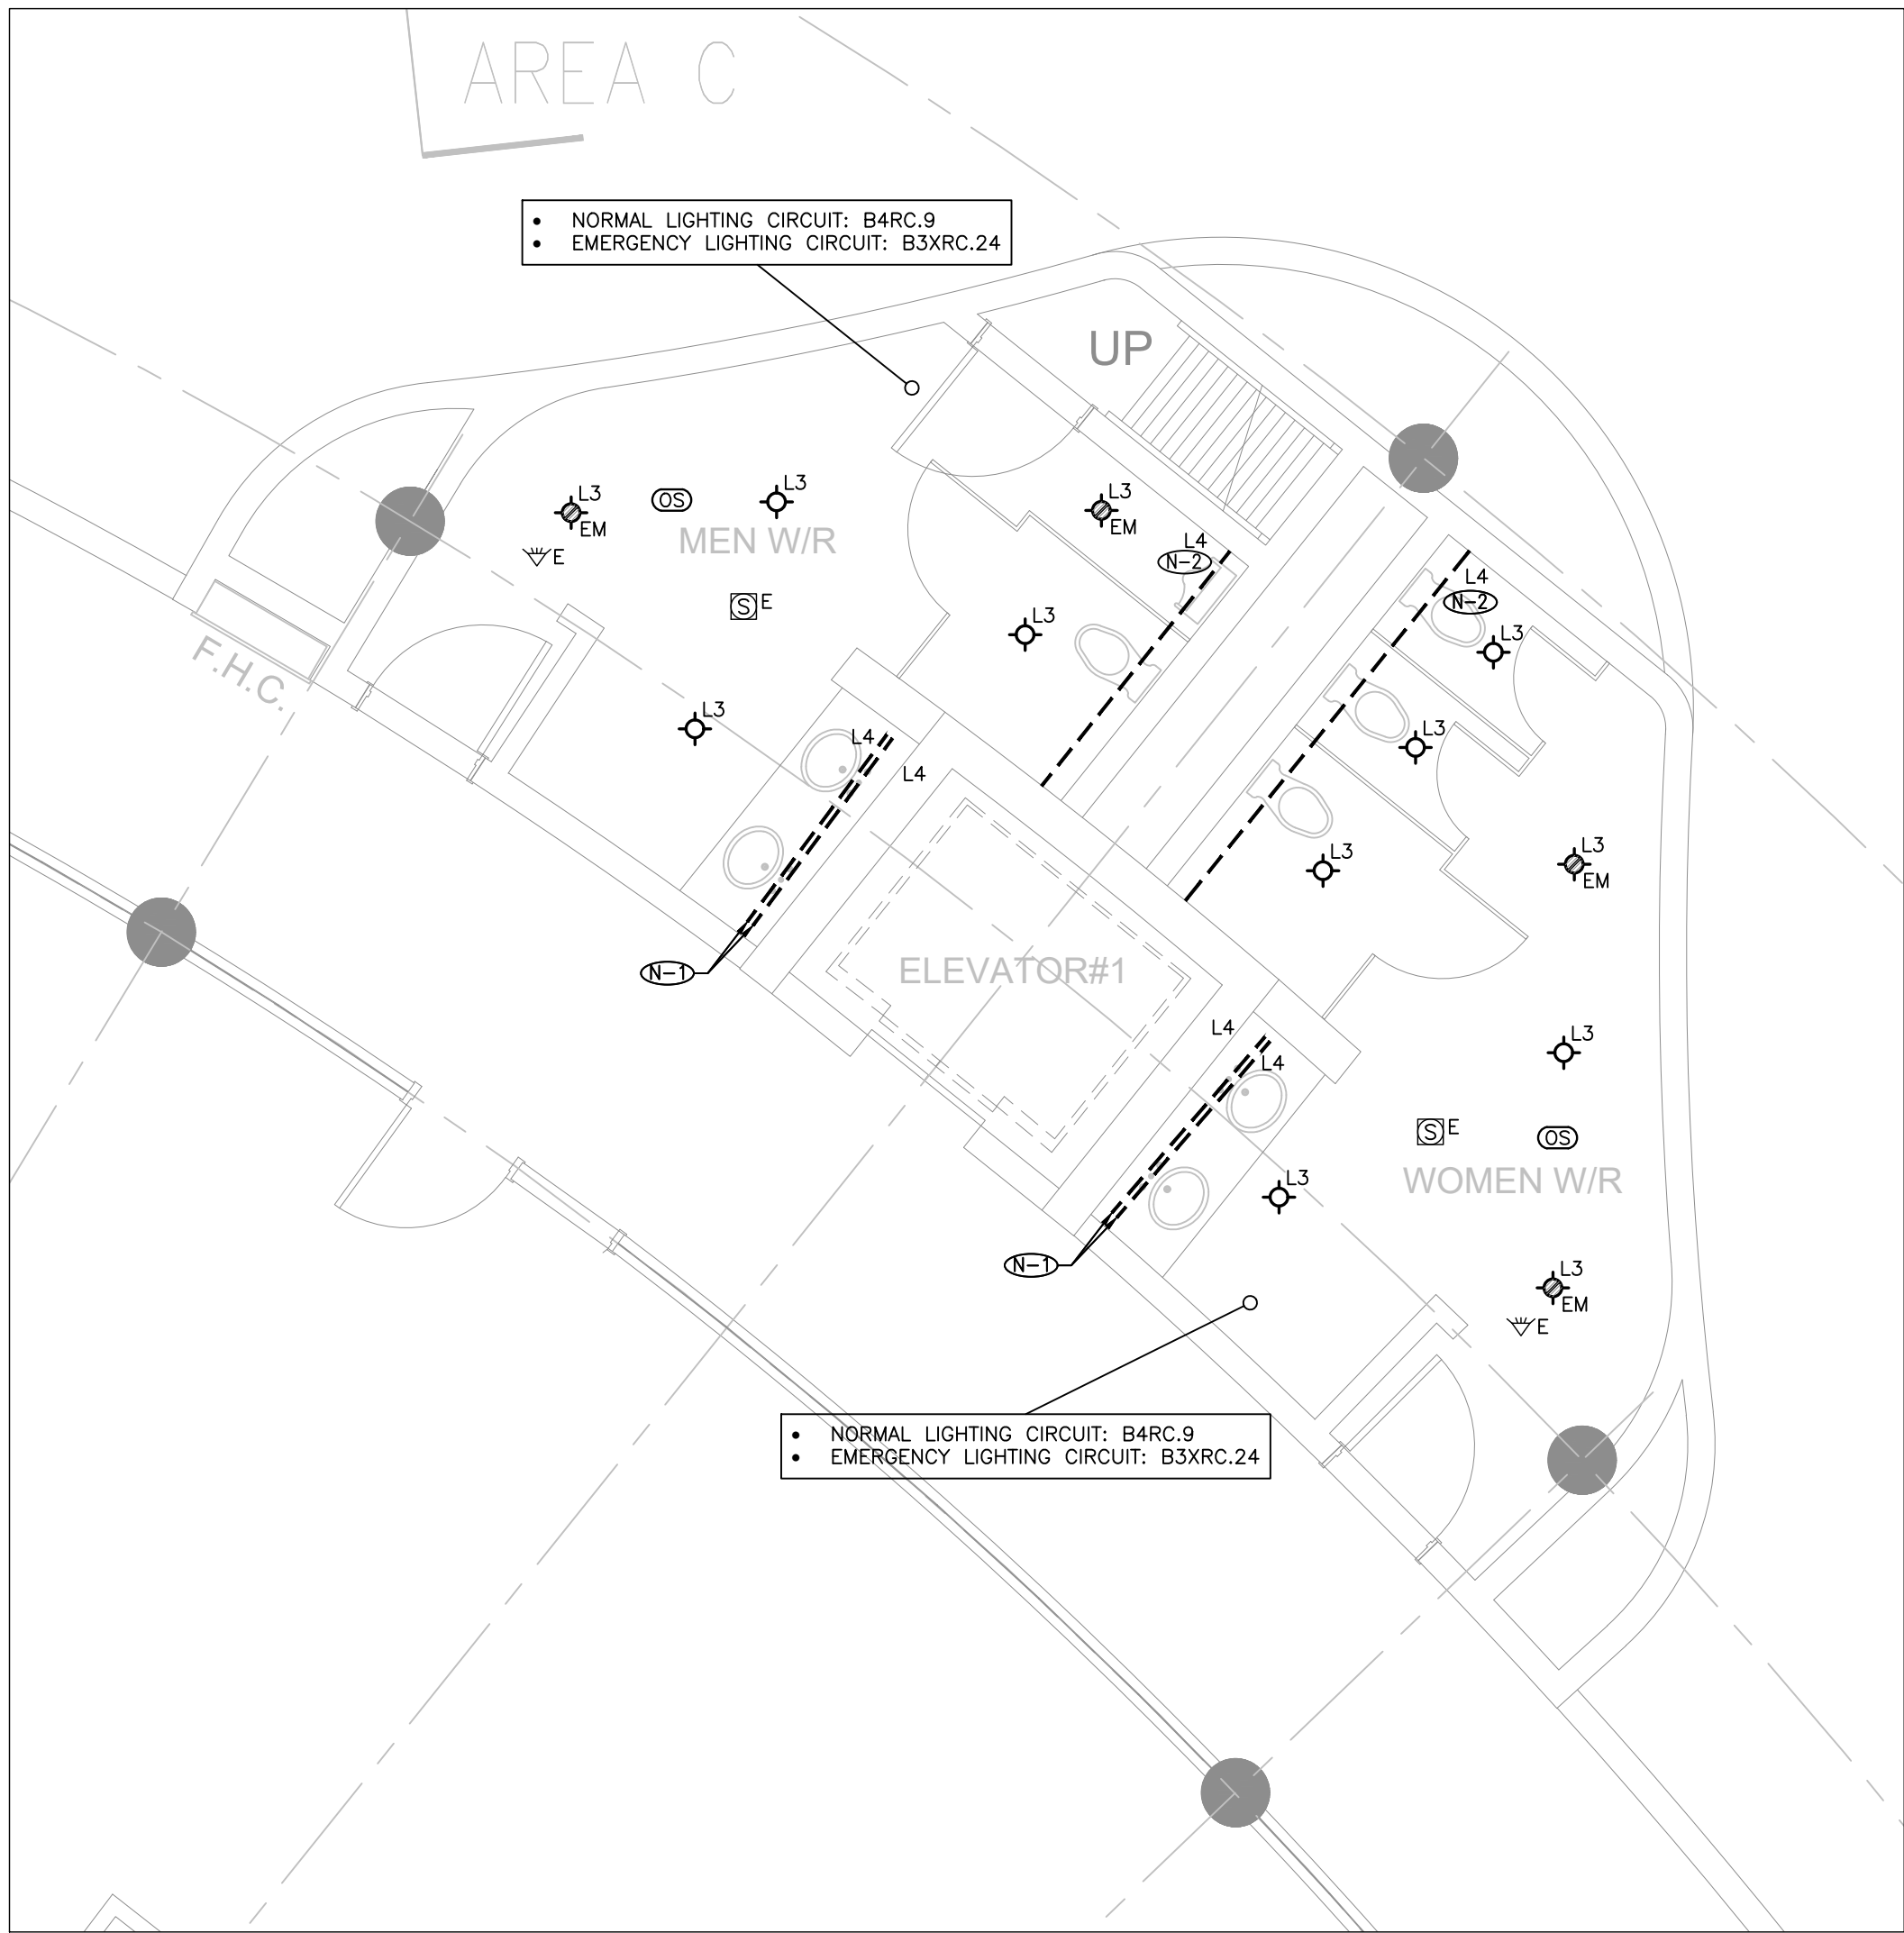

1 LEVEL 4 CEILING PLAN – W/R'S 4-92 & 4-93
E-4.5 SCALE: 1:50

- GENERAL NOTES:**
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 2. CIRCUITING IN PART IS DIAGRAMMATIC INTENDED TO SHOW GENERAL CIRCUIT ARRANGEMENT AND PANEL DESIGNATION.
 3. RE-USE CIRCUITS OBTAINED THROUGH DEMOLITION.
 4. ALL NEW LED LUMINAIRES SHALL BE CHAIN HUNG AND SUPPORTED FROM THE SLAB ABOVE. PROVIDE LETTER TO BE INCLUDED AS PART OF CLOSE-OUT DOCUMENT SUBMITTAL PACKAGE.
 5. REWORK EXISTING EMERGENCY LIGHTING TO ACHIEVE NEW EMERGENCY LIGHTING AS SHOWN. CONNECT NEW AND/OR RELOCATED LUMINAIRES TO NEAREST EMERGENCY LIGHTING CIRCUITS ON THIS FLOOR. IF NEW EMERGENCY BRANCH CIRCUITS ARE REQUIRED FOR EMERGENCY LIGHTING AND EXISTING EMERGENCY LIGHTING PANEL IS LOCATED ON A DIFFERENT STOREY (i.e. NOT LOCATED ON SAME FLOOR), THEN NEW BRANCH CIRCUIT WIRING SHALL BE 2-HOUR FIRE RATED (i.e. MI CABLE) TO FIRST EMERGENCY LIGHT FED. IF EXISTING EMERGENCY LIGHTING PANEL IS LOCATED ON THE SAME STOREY, THE NEW BRANCH CIRCUIT WIRING DOES NOT NEED TO BE FIRE RATED. PROVIDE LOCK-ON BREAKERS TO SUIT.
 6. MEASURE THE ILLUMINATION OF THE FLOOR AT NIGHT WITH EMERGENCY LIGHTING ON ONLY, AND SEND A DRAWING SHOWING THE MAXIMUM AND MINIMUM LEVEL OF ILLUMINATION. TO THE CONSULTING ENGINEER, FOR REVIEW. PROVIDE WRITTEN CONFIRMATION THAT EMERGENCY LIGHTING HAS BEEN INSTALLED IN ACCORDANCE WITH CONTRACT DOCUMENTS AND LATEST EDITION OF THE ONTARIO BUILDING CODE SECTIONS 3.2.7.3 AND 3.2.7.4. LETTER TO BE INCLUDED AS PART OF CLOSE-OUT DOCUMENT SUBMITTAL PACKAGE.
 7. ALL MODIFICATIONS TO FIRE ALARM SYSTEM AND DEVICES TO BE COMPLETED BY BASE BUILDING FIRE ALARM CONTRACTOR AND VENDOR/MANUFACTURER. BASE BUILDING FIRE ALARM CONTRACTOR/VENDOR/MANUFACTURER IS RESPONSIBLE TO ENSURE THAT ALL ADDITIONAL COMPONENTS (MATERIAL, SOFTWARE, INCLUDING ANY LABOUR TO INSTALL, OR MODIFY FIRE ALARM DEVICES) ARE INCLUDED FOR BASED ON ISSUED DRAWINGS. ELECTRICAL CONTRACTOR TO ALLOW FOR ALL ASSOCIATED COSTS. NEW FIRE ALARM SPEAKERS/STROBES ARE TO MATCH EXISTING AND BE CONNECTED TO NEAREST AVAILABLE SPARE EMERGENCY ZONE CIRCUIT(S). CONNECT NEW SPEAKERS/STROBES TO EXISTING CIRCUITS, WHERE THERE IS SPARE CAPACITY ON RESPECTIVE CIRCUITS. IF THERE IS NO CAPACITY ON EXISTING CIRCUITS, PROVIDE NEW FIRE ALARM CIRCUITS. ALLOW FOR ALL ASSOCIATED COSTS INCLUDING BUT NOT LIMITED TO: ASSOCIATED EQUIPMENT, DEVICES, PROGRAMMING, TESTING AND VERIFICATION TO MAKE SYSTEM OPERATIONAL AND CODE COMPLIANT. ALL FIRE ALARM VERIFICATION SHALL CONFORM TO CAN/ULC-5524 LATEST EDITION. FIRE ALARM SYSTEM SHALL BE INSTALLED IN CONFORMANCE WITH CAN/ULC-5524 LATEST EDITION. INCLUDE IN THE COST TO PROVIDE TWO (2) ADDITIONAL FIRE ALARM SPEAKERS AND ONE (1) ADDITIONAL AUDIBILITY VERIFICATION.
 8. ENSURE THAT ALL LIGHTING FIXTURES ARE CLEAN AND ILLUMINATED BY END OF PROJECT.
 9. REUSE EXISTING CIRCUIT FOUND IN CEILING SPACE FOR ALL NEW LIGHTING FIXTURES UNLESS OTHERWISE NOTED. CONTRACTOR TO PROVIDE ADDITIONAL CIRCUITS WHERE REQUIRED, NEW LOW VOLTAGE SWITCH ARRANGEMENT OF LIGHTING TO BE CO-ORDINATED WITH THE REGION AND REARRANGED TO SUIT NEW LAYOUT. ALL LIGHTING, EXCLUDING EMERGENCY, WITHIN THE TENANT PREMISES TO BE ON A SEPARATE LIGHTING ZONE AND TO BE CONTROLLED BY BASE BUILDING LIGHTING CONTROL SYSTEM. PROVIDE ALL NECESSARY RELAYS, CONTACTORS, RELAY PANELS, AND DRY INTERFACES REQUIRED FOR SUCH CONTROL. INCLUDE COST IN THIS CONTRACT.
 10. COORDINATE INSTALLATION OF FIXTURES WITH MECHANICAL EQUIPMENT, ELECTRICAL EQUIPMENT, SPRINKLERS AND DUCT WORK WITH OTHER TRADES PRIOR TO WORK COMMENCING.
 11. ALL CEILING MOUNTED OCCUPANCY SENSORS PROVIDED AS PART OF THIS SCOPE OF WORK MUST BE LOCATED AT LEAST 4'0" AWAY FROM ANY SUPPLY AIR DIFFUSER AND RETURN AIR GRILLE AS PER MANUFACTURER'S RECOMMENDATION. COORDINATE INSTALLATION ON SITE WITH MECHANICAL CONTRACTOR PRIOR TO COMMENCING WORK.

- DRAWING NOTES:**
- ① ONE (1) SECTION OF TYPE 'L3' LED COVE LIGHT TO RUN ABOVE AND BEHIND THE MIRROR, AND ONE (1) SECTION TO RUN BELOW AND BEHIND MIRROR FOR ACCENT LIGHTING. (TYP.)
 - ② PROVIDE ONE (1) 250VA, 347V-120V, 1ø STEP DOWN TRANSFORMER INSTALLED IN THE CEILING SPACE FOR ALL THE TYPE 'L3' LED STEP LIGHT (COVE AND MIRROR) 120V REMOTE DRIVER IN EACH WASHROOM. COORDINATE EXACT TRANSFORMER MOUNTING LOCATION ON SITE. (TYP.)
 - ③ RE-USE CIRCUITS OBTAINED THROUGH DEMOLITION WHERE POSSIBLE. CIRCUITING SHOWN ON THE PLAN ARE FOR REFERENCE ONLY. INCLUDE IN THE COST TO UTILIZE TWIN BREAKERS WHERE NECESSARY DUE TO LIMITED BRANCH SPACE AVAILABLE ON THE EXISTING PANEL. (TYP.)

G.Bruce Stratton Architects

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Toronto Ontario M5V 1W2
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1	2022-04-27	ISSUED FOR 80% REVIEW
2	2022-05-31	ISSUED FOR 97% REVIEW
3	2022-06-13	ISSUED FOR TENDER

PROJECT CONTACT

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416 487 8151 | 416 487 9104 smithandandersen.com

PROJECT:

YORK REGION
Administrative Centre
17250 Yonge Street
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SCALE:	1:50
DRAWN BY:	CH
REVIEWED BY:	NC


SHEET TITLE:
4TH FLOOR WASHROOM
LIGHTING & FIRE ALARM
LAYOUT

SHEET NUMBER:
TE-4.5



3
E-4.6

LEVEL 4 PARTITION PLAN - W/R'S 4-88 & 4-89
SCALE: 1:50

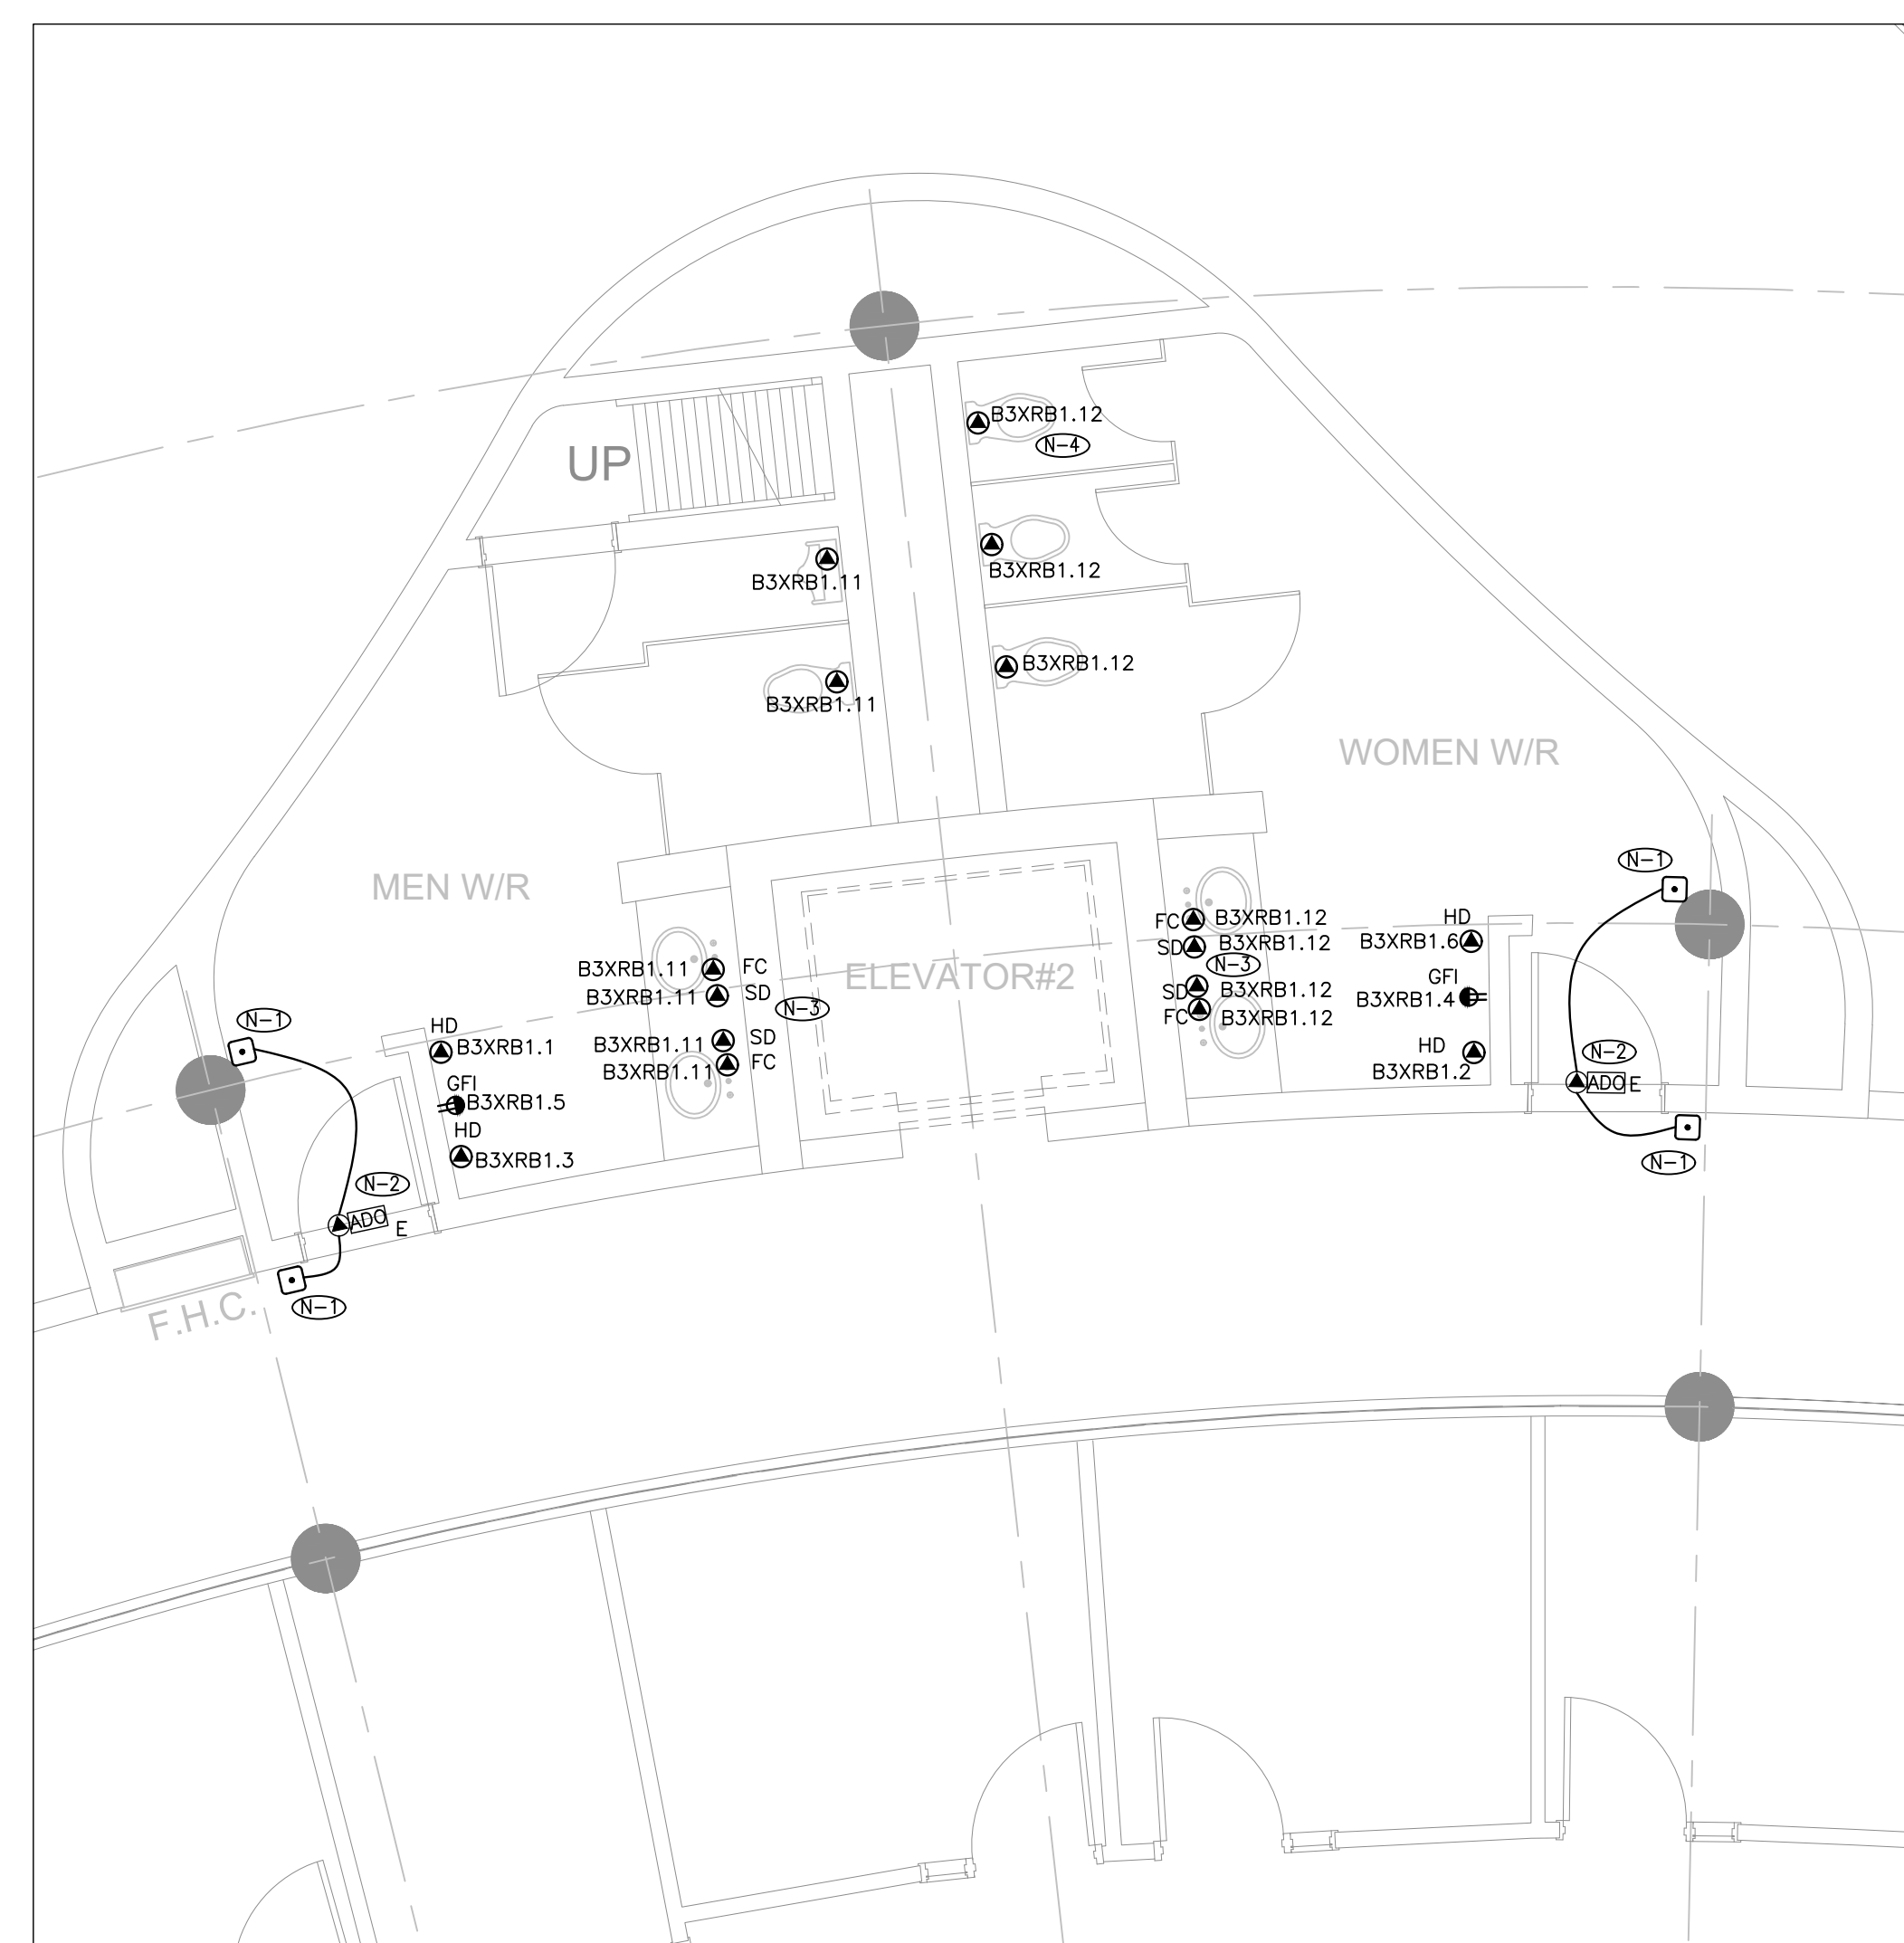

2
E-4.6

LEVEL 4 PARTITION PLAN - W/R'S 4-90 & 4-91
SCALE: 1:50



1
E-4.6

LEVEL 4 PARTITION PLAN - W/R'S 4-92 & 4-93
SCALE: 1:50

- ### GENERAL NOTES:
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 2. CIRCUITING IN PART IS DIAGRAMMATIC INTENDING TO SHOW GENERAL CIRCUIT ARRANGEMENT AND PANEL DESIGNATION.
 3. REUSE CIRCUITS OBTAINED THROUGH DEMOLITION IS ACCEPTABLE.
 4. REFER TO ARCHITECT'S DRAWINGS FOR THE COLOUR OF COVERPLATES AND MOUNTING HEIGHTS.
 5. MARK UP OUTLET AND DEVICE LOCATIONS AND OBTAIN APPROVAL BY DESIGN CONSULTANT PRIOR TO INSTALLATION.
 6. PROVIDE SUPPLY LABELS ON ALL RECEPTABLES AND SYSTEM FURNITURE FEEDS. LABELS TO INCLUDE BOTH PANEL AND CIRCUIT DESIGNATION, REVIEW LABEL SIZE AND TYPE WITH CONSULTANT PRIOR TO INSTALLATION.
 7. TRACE ALL EXISTING OUTLETS, NOTING AS EXISTING, AND IDENTIFY ON AS-BUILT DRAWING AS PER SPECIFICATION.
 8. CONFIRM ELECTRICAL REQUIREMENTS AND EXIST LOCATION OF ALL MECHANICAL EQUIPMENT WITH MECHANICAL DRAWINGS AND CONTRACTOR PRIOR TO ROUTING.
 9. ROUTE ALL CABLE SYSTEMS AROUND DUCT WORK, BEAMS AND PIPING AS REQUIRED TO ACCOMMODATE LAYOUT SHOWN. REFER TO MECHANICAL DRAWINGS AND ARCHITECTURAL DRAWINGS FOR ADDITIONAL DETAILS.
 10. PROVIDE FIRE STOPPING AS REQUIRED. PROVIDE PULL STRINGS IN EMPTY CONDUIT. COORDINATE ROUTING AND TERMINATION POINTS OF ALL CONDUITS WITH GENERAL.

DRAWING NOTES:

- ④ PROVIDE NEW CADDIS 800V-335/40W TOUCHLESS AUTOMATIC DOOR OPERATOR FOR WASHROOM INTERIOR. PROVIDE NEW CADDIS 40V-45/4 PUSH BUTTON AUTOMATIC DOOR OPERATOR FOR WASHROOM EXTERIOR. COORDINATE INSTALLATION WITH THE DRYWALL CONTRACTOR ON SITE. (TYP.)
- ④ RECONNECT NEW TOUCHLESS AUTOMATIC DOOR OPERATOR TO THE EXISTING AUTOMATIC DOOR OPERATOR TO ENSURE FULL FUNCTIONALITY.
- ④ VERIFY EXIST WORK REQUIREMENTS AND RECEPTACLE TYPES FOR SPECIAL EQUIPMENT. PROVIDE MANUFACTURE PULL BOXES FOR THE FOLLOWING: HARDWARE CONNECTIONS FOR AUTOMATIC WATER FAUCET "30", SOAP DISPENSER "30", AND HAND DRYER "40", ETC. IN LIEU OF RECEPTABLES OR VICE VERSA, AS REQUIRED.
- ④ PROVIDE TANDEN BREAKERS FOR CIRCUITS SHOWN AS A/B. (TYP.)

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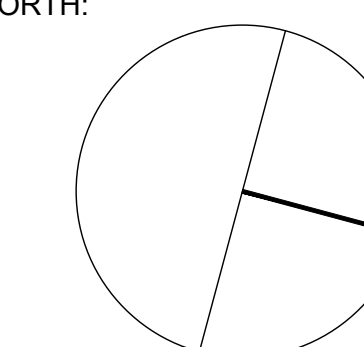
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	NORTH:
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ENGINEER:



Smith + Andersen

1100 - 100 Sheppard Ave. East, Toronto On, M2N 6P1
416 487 8151 / 416 487 2104 smith@onderson.com

PROJECT:

YORK REGION

Administrative Centre
17250 Yonge Street
Newmarket, Ontario

SCALE: 1:50

DRAWN BY: CH

REVIEWED BY: NC

SHEET TITLE:
4TH FLOOR WASHROOMS
POWER & SYSTEMS LAYOUT

SHEET NUMBER:


TE-4.6



3 LEVEL 4 CEILING DEMOLITION – W/R’S 4-88 & 4-89
E-4.7 SCALE: 1:50



2 LEVEL 4 CEILING DEMOLITION – W/R’S 4-90 & 4-91
E-4.7 SCALE: 1:50

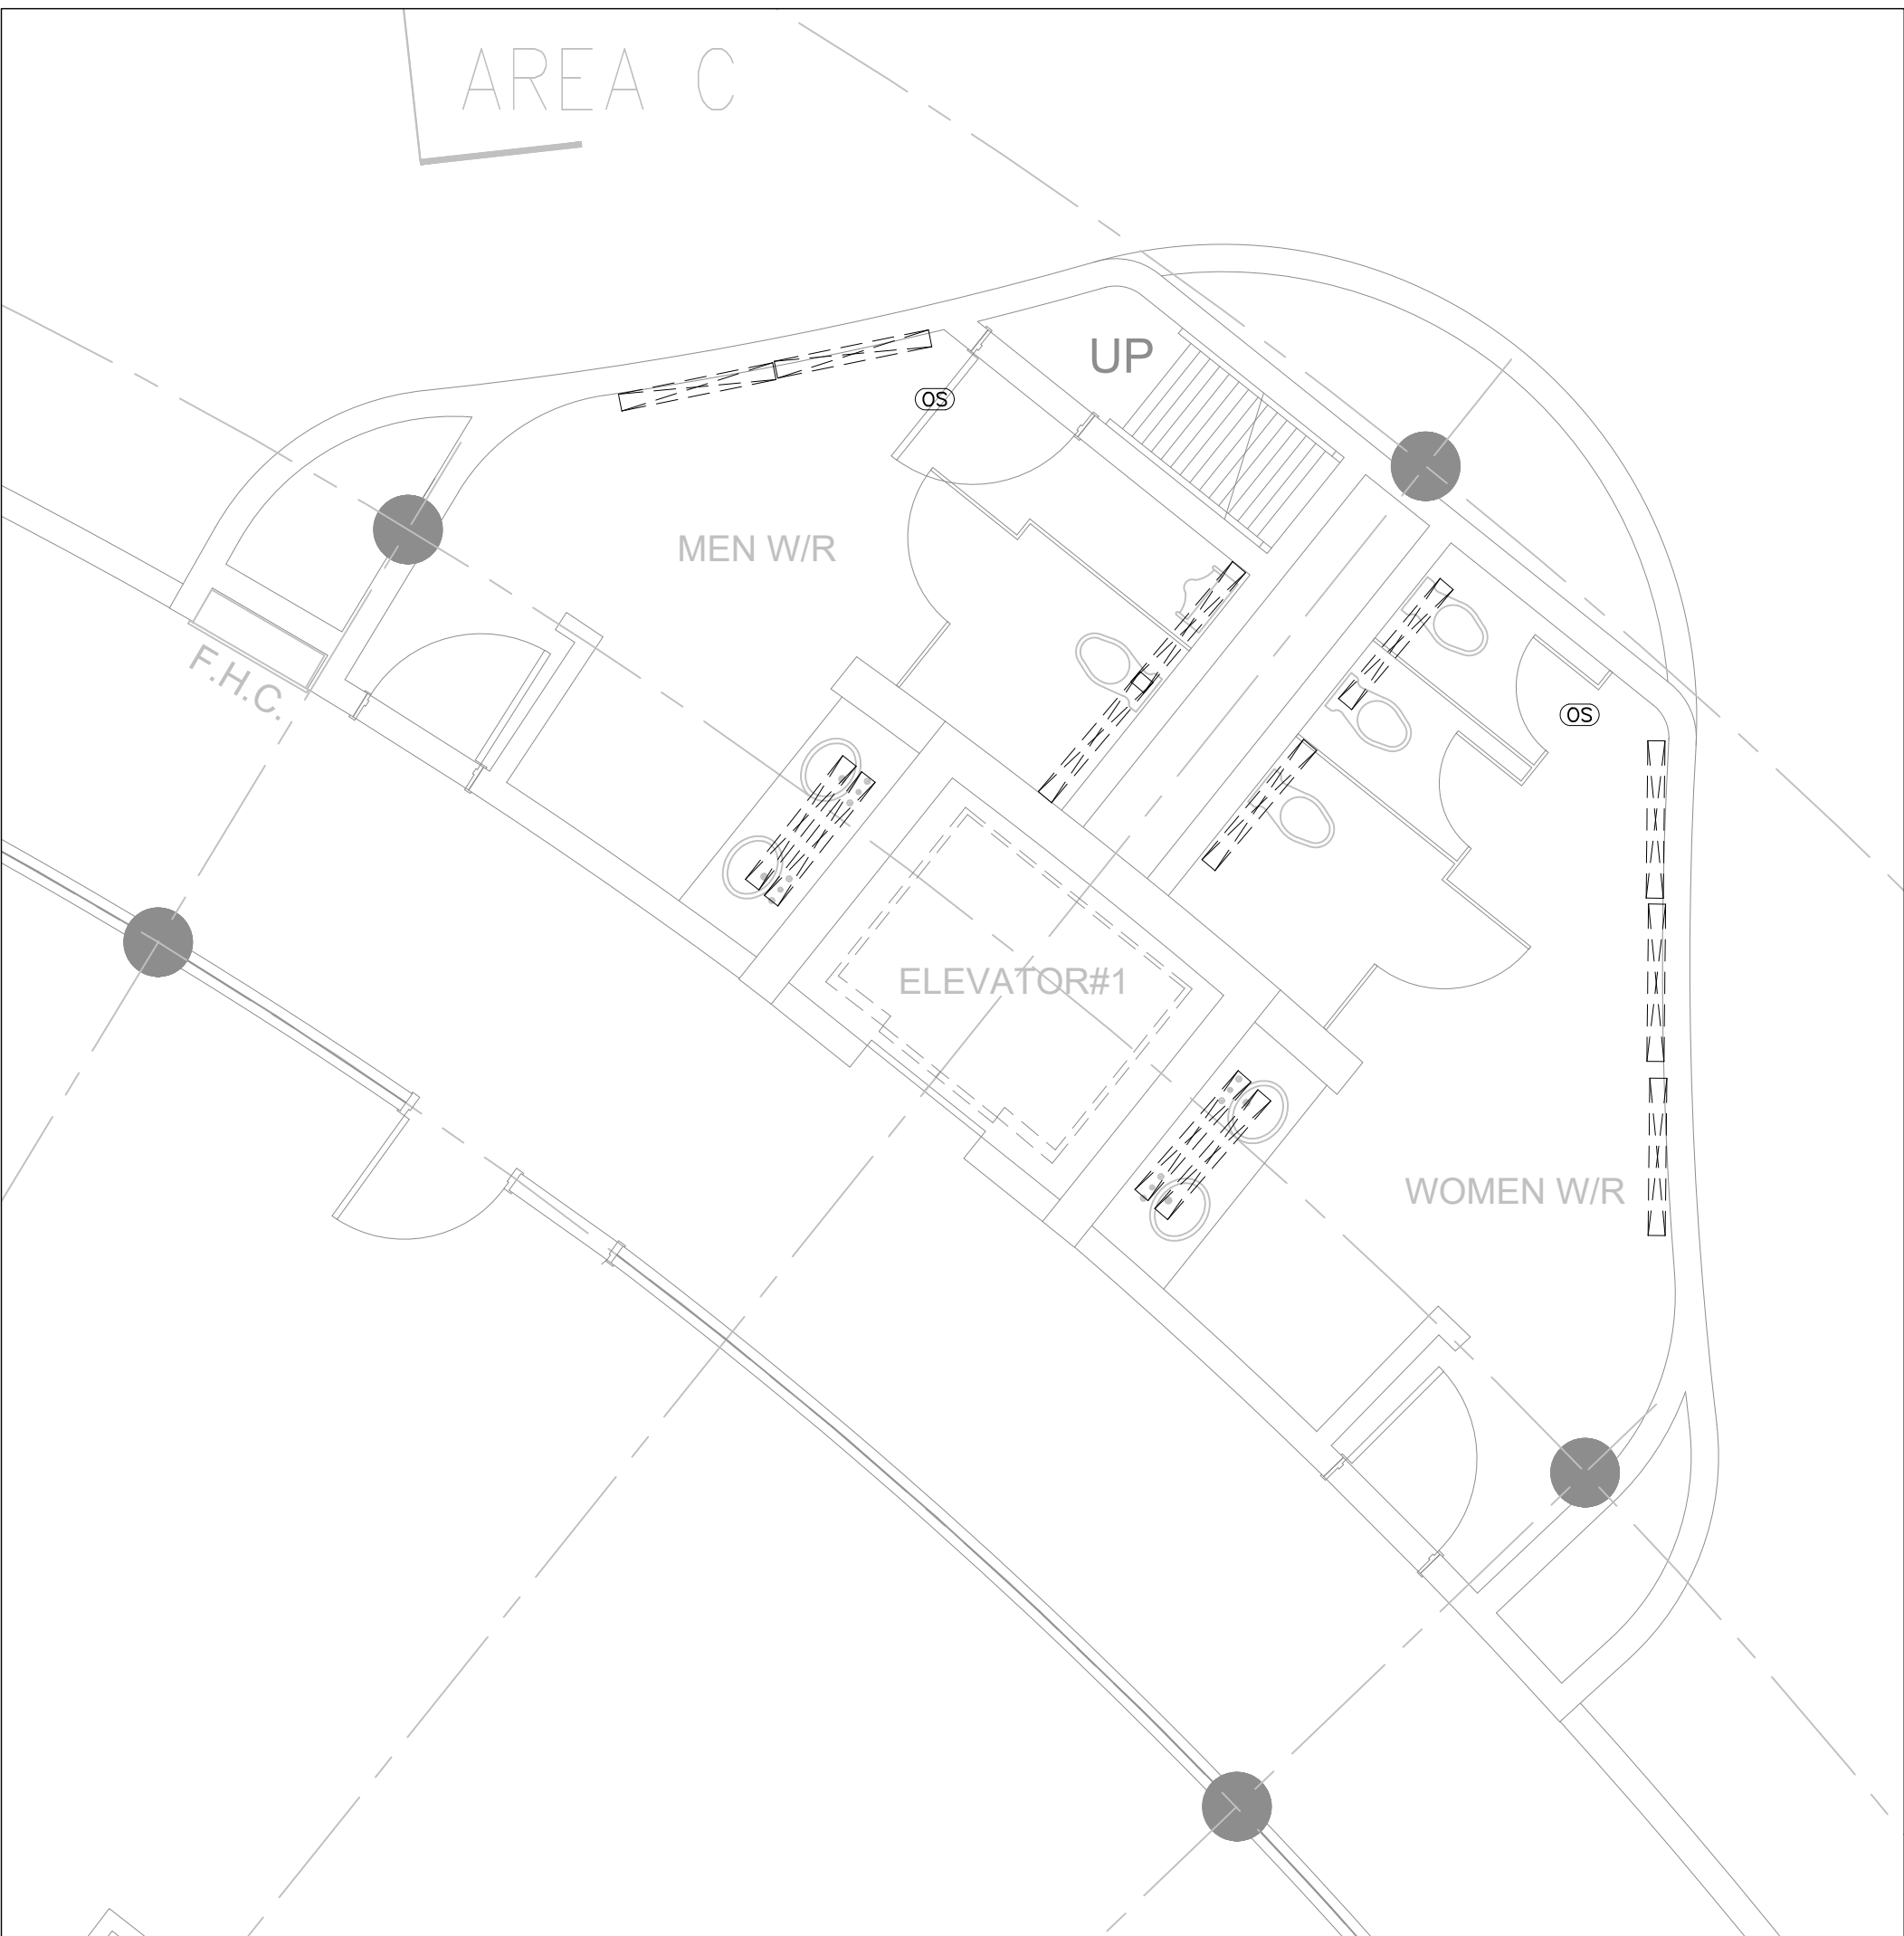

1 LEVEL 4 CEILING DEMOLITION – W/R’S 4-92 & 4-93
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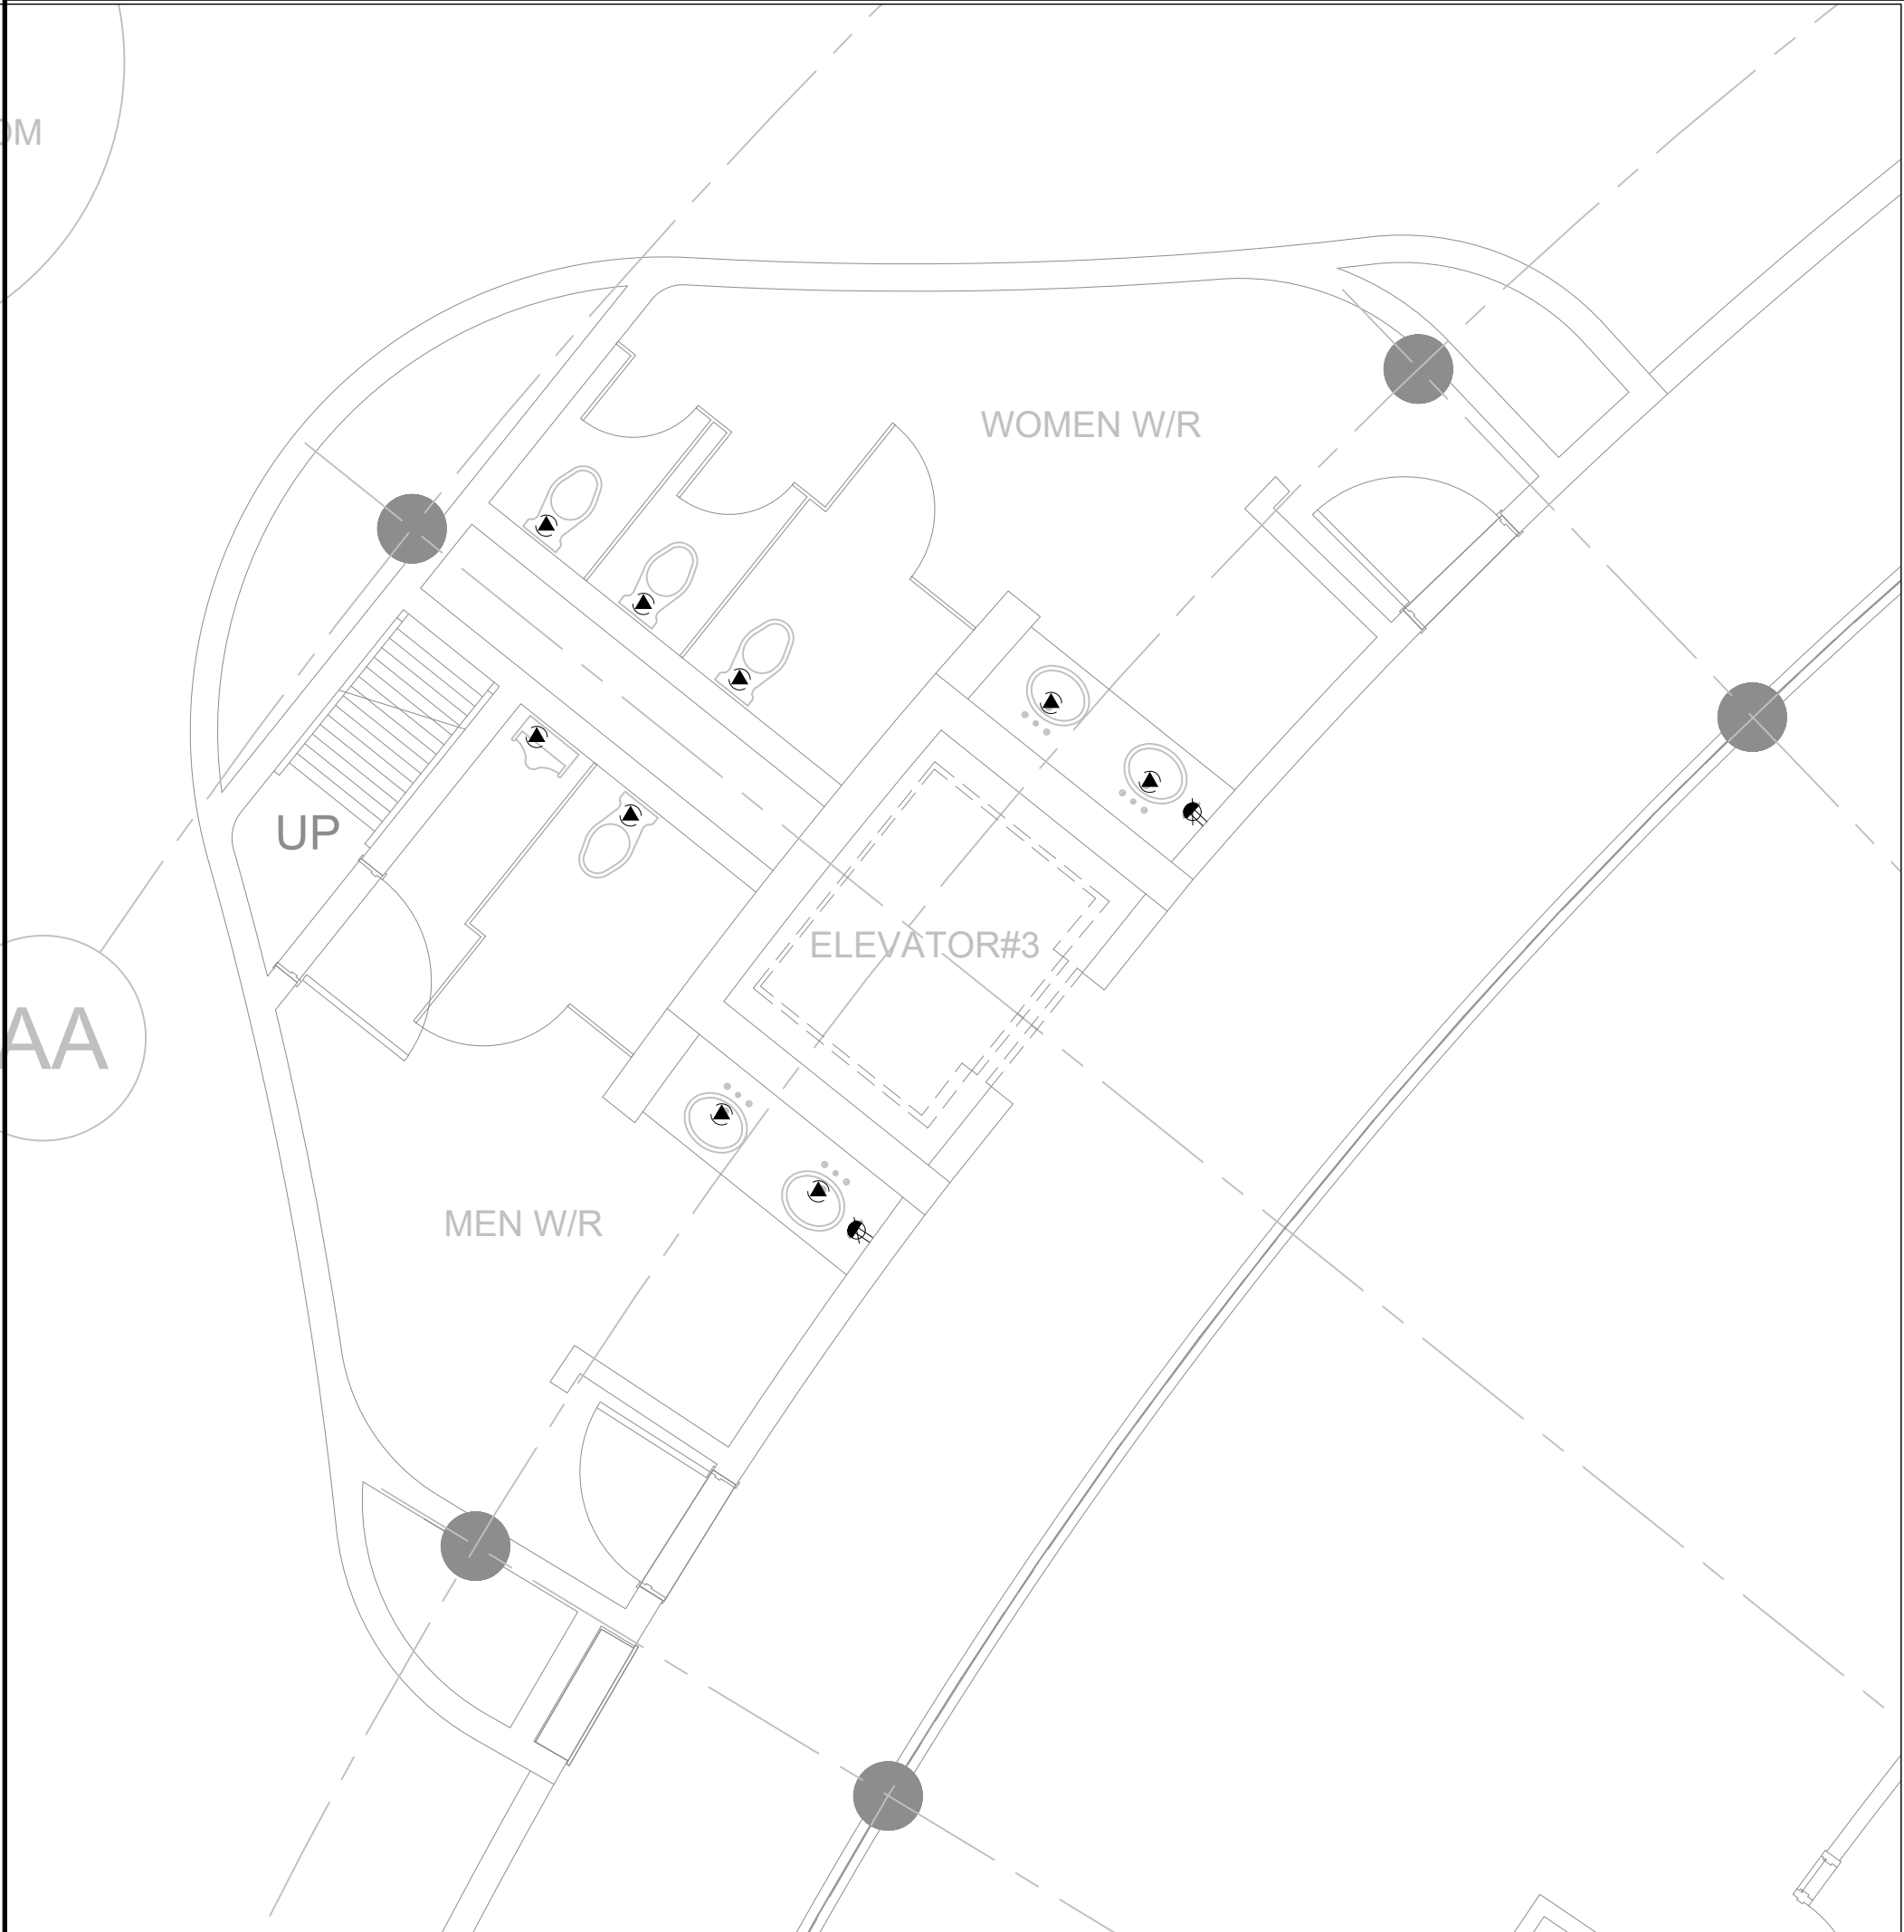
DRAWN BY: CH

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SHEET TITLE:
4TH FLOOR WASHROOMS
LIGHTING & FIRE ALARM
DEMOLITION LAYOUT

SHEET NUMBER:

TE-4.7



3
E-4.8

LEVEL 4 DEMOLITION PLAN – W/R’S 4-88 & 4-89
SCALE: 1:50



2
E-4.8

LEVEL 4 DEMOLITION PLAN – W/R’S 4-90 & 4-91
SCALE: 1:50



1
E-4.8

LEVEL 4 DEMOLITION PLAN – W/R’S 4-92 & 4-93
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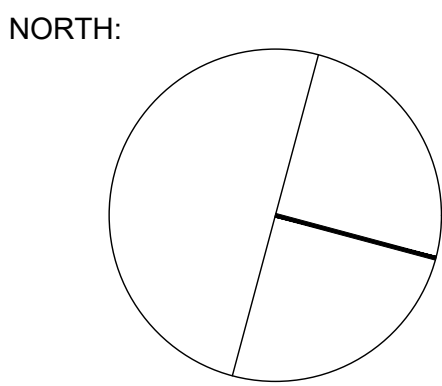
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4TH WASHROOMS POWER &
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LAYOUT

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TE-4.8