



RHC


SYMBOLS			
	MOTOR OPERATER RAMPER		
MD	MOTOR OPERATED DAMPER		
— <b>⋖</b> F/D	FIRE DAMPER		
□ S/D	SMOKE DAMPER		
— <b>∢</b> FS/D	COMBINATION FIRE & SMOKE DAMPER		
<b>⊕</b> FE	FIRE EXTINGUISHER		
FE (CO2)	FIRE EXTINGUISHER, CO2		
	DOUBLE CHECK BACKFLOW PREVENTER		
	DRAINS ABOVE		
o co	FLOOR CLEANOUT		
——————————————————————————————————————	CLEANOUT PLUG		
$\boxtimes$	FLOOR DRAIN		
₩	ROOF DRAIN		

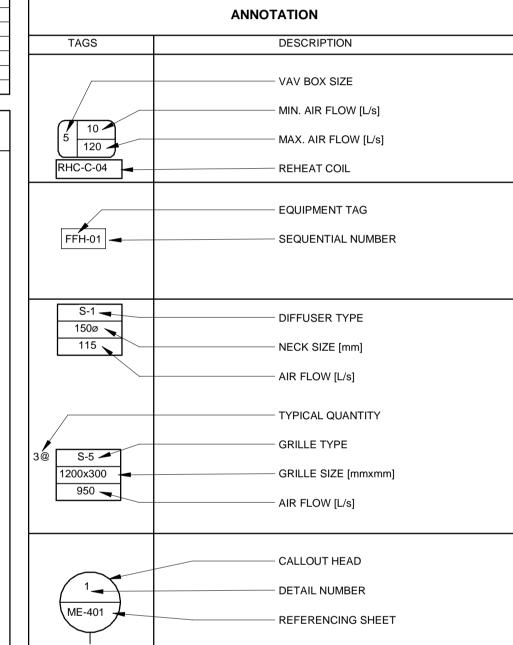

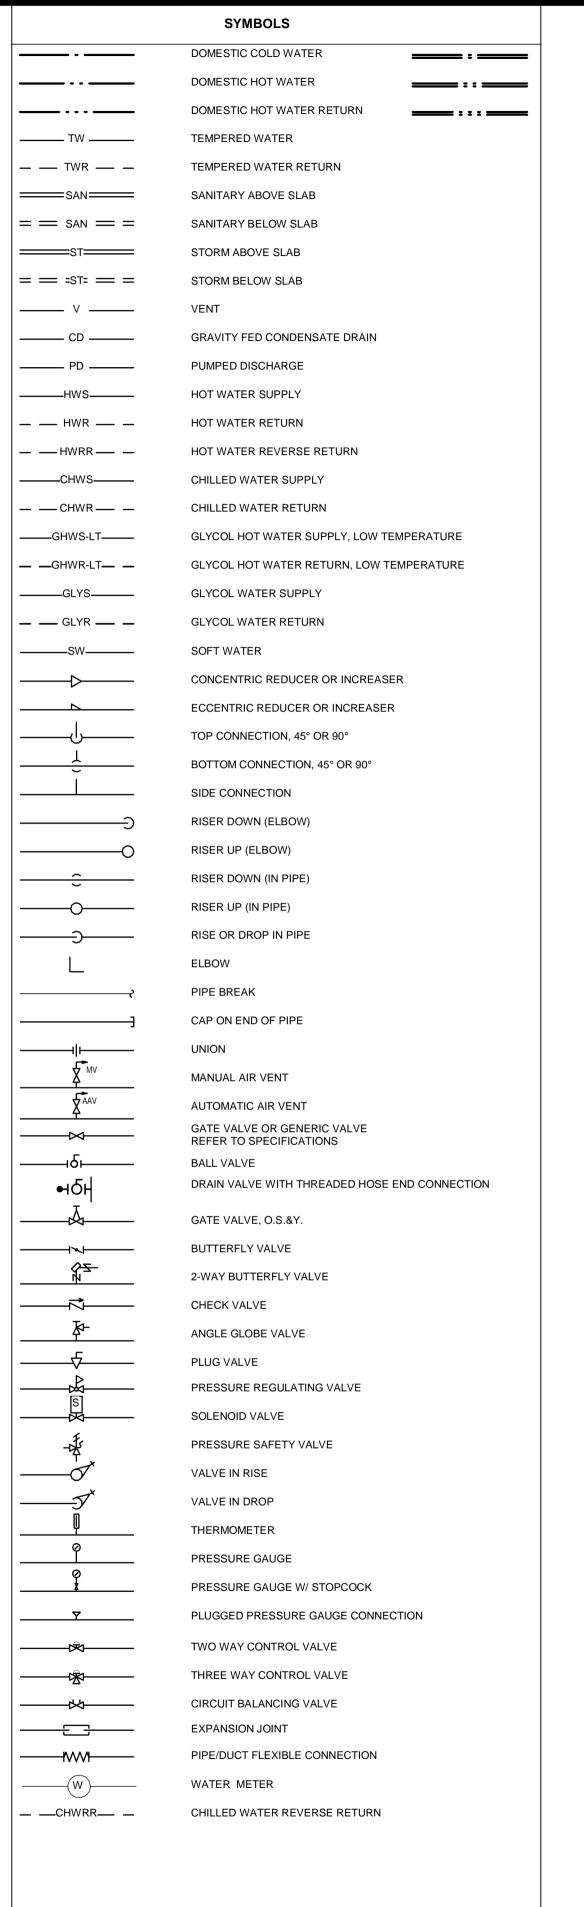

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DESIGN BY: JB SCALE: NTS

DRAWN BY: VM DATE: 2020.04.17

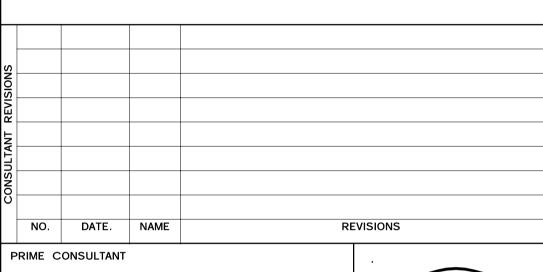CHECKED BY: KA CONSULTANT PROJECT NO. 60611569

APPROVED BY: JC

CLIENT FILE No.: 811/20

CLIENT FILE No.: 811/20

CLIENT FILE No.: 811/20

INDICATE NAME

CLIENT FILE No.: 811/20

CLIENT FILE No.: 811/20




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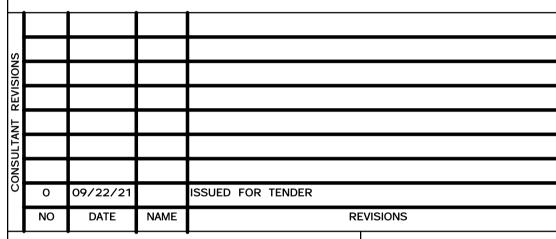
DESIGN, CONSTRUCTION & ASSET MANAGEMENT

NEW SEATON PARAMEDIC STATION
AND TRAINING FACILITY IN PICKERING
MECHANICAL LEGENDS AND DRAWING
LIST

PROPERTY NO.	FACILITIES CODE	FACILITIES PROJECT NO. P061-18-01
CONTRACT NO.	DRAWING NO.	SHEET NO.
T- 1160- 2021	M- 000	



KEY PLAN

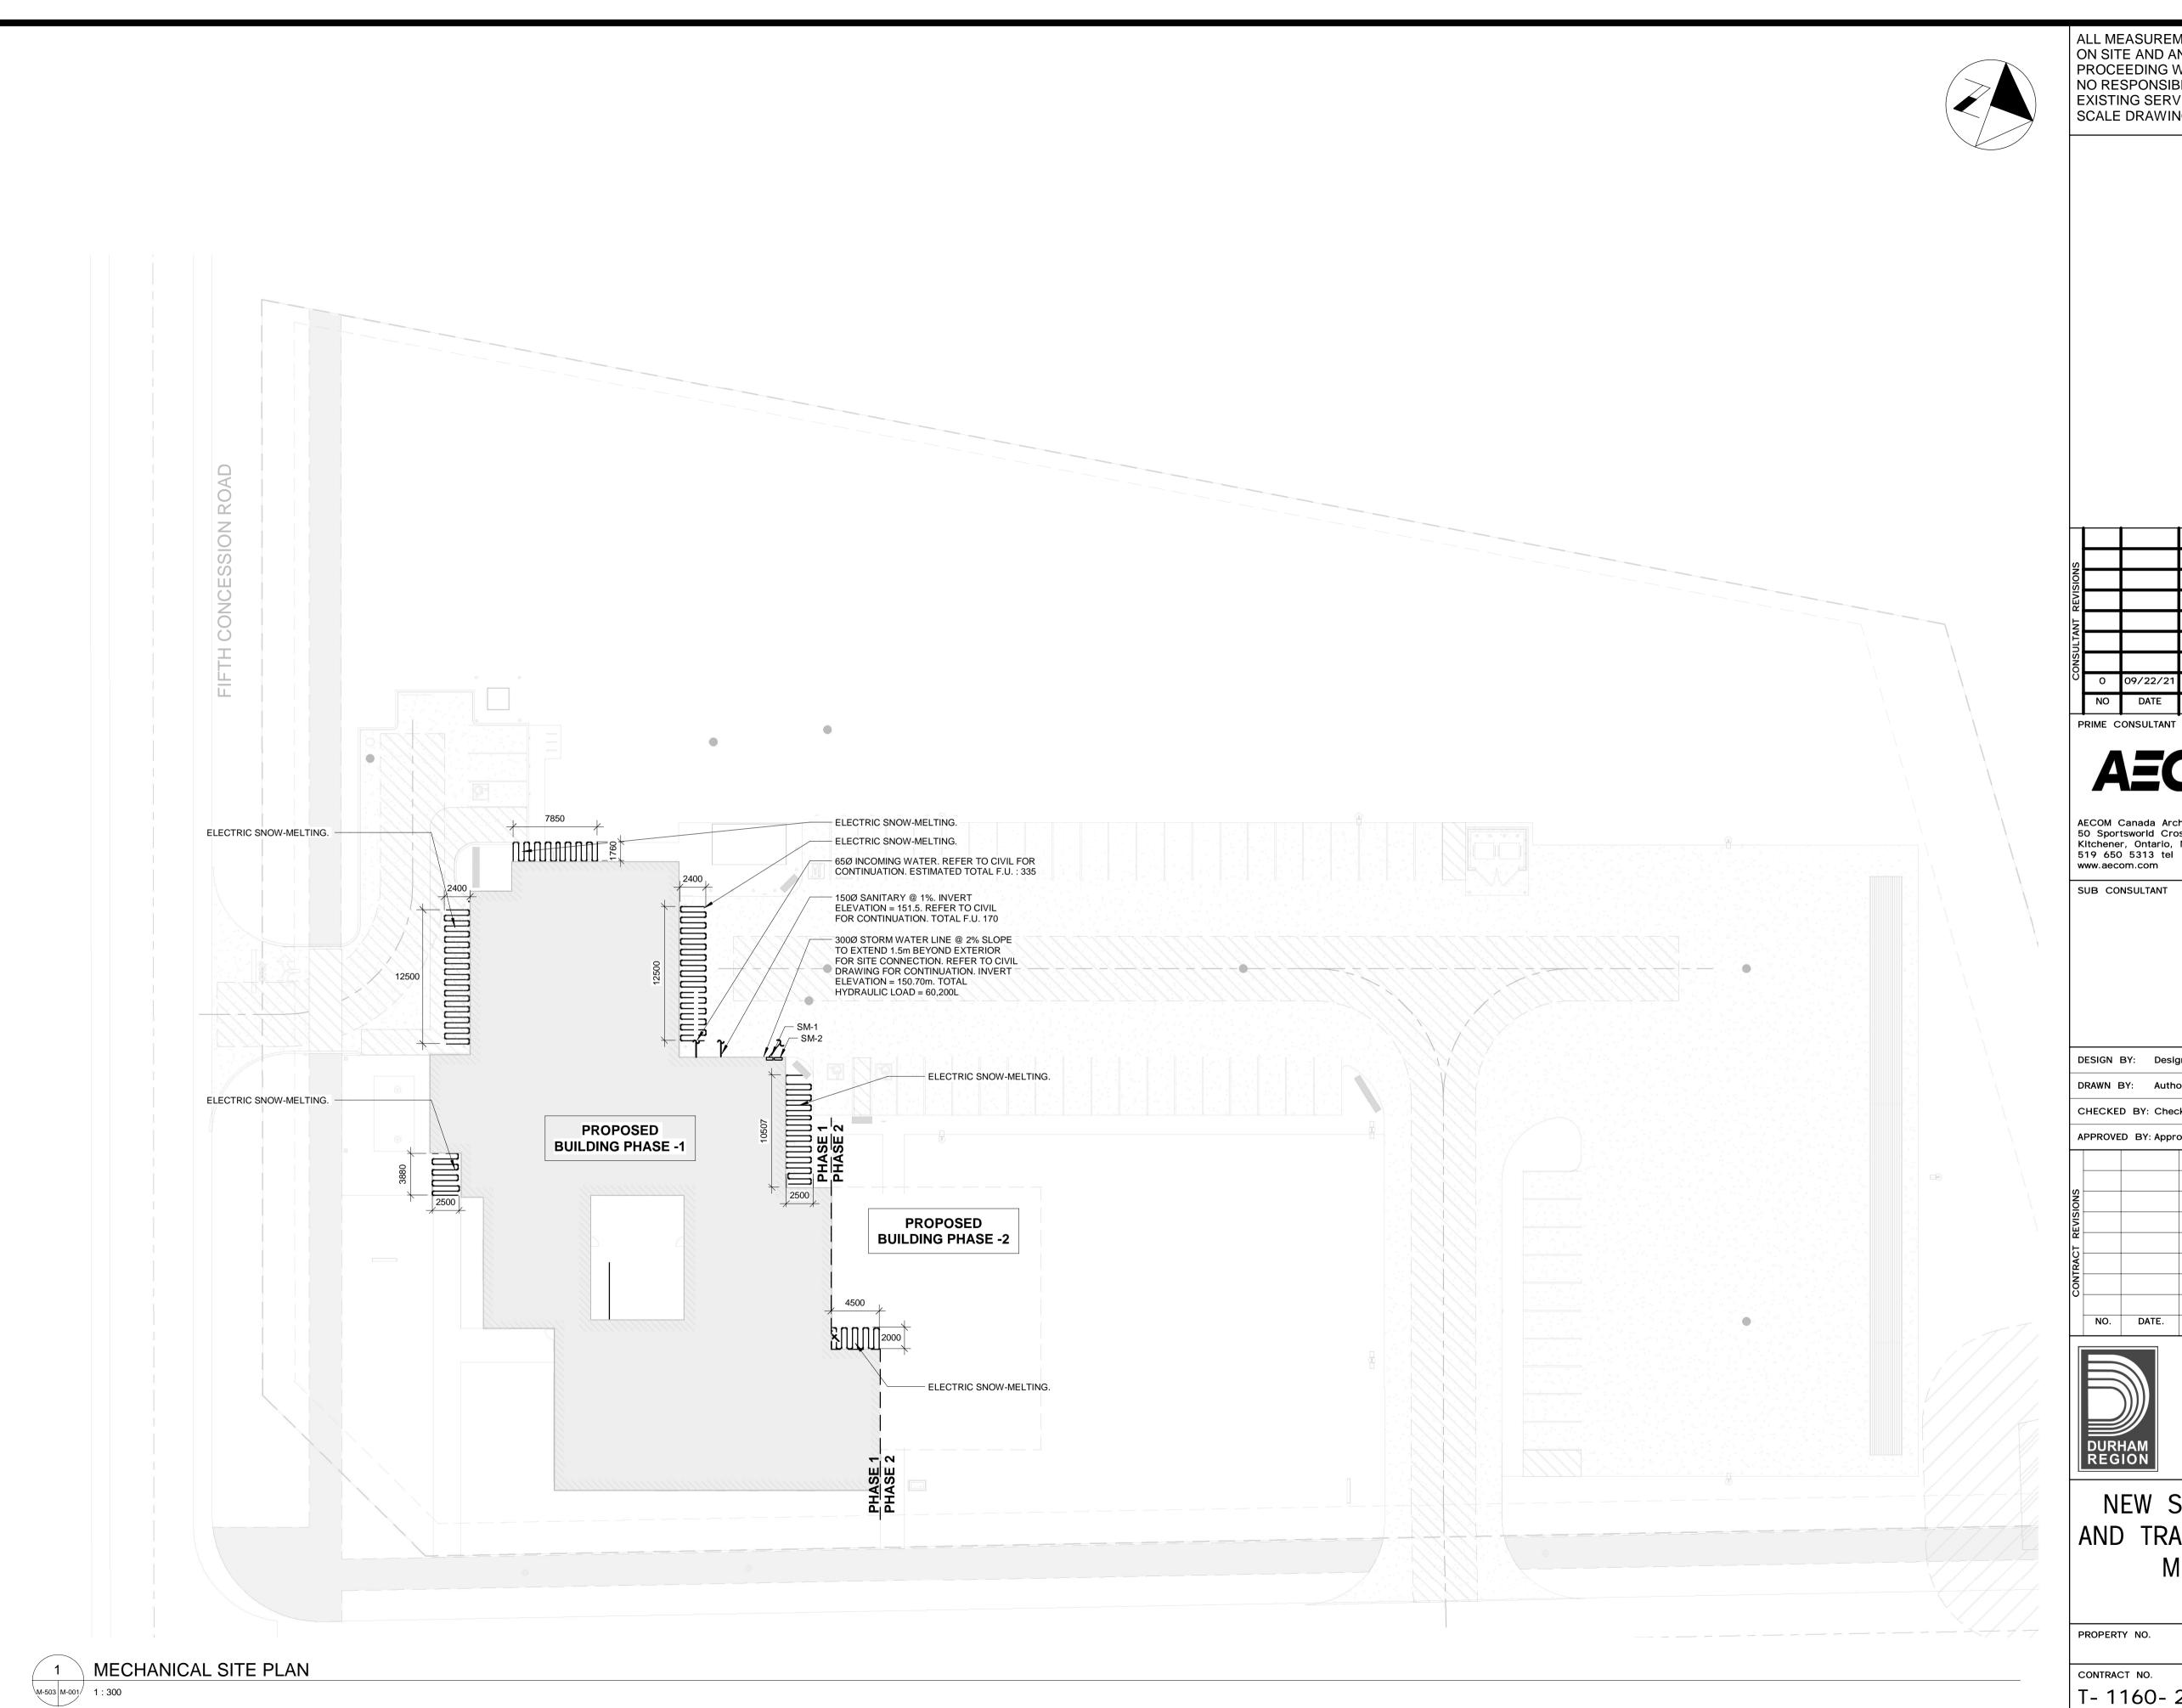

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DRAWN BY: Author	DATE: 11/11/20
CHECKED BY: Checker	CONSULTANT PROJECT NO. 60611569
APPROVED BY: Approver	

REVISIONS



THE REGIONAL MUNICIPALITY OF DURHAM


WORKS DEPARTMENT


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CONTRACT NO.	DRAWING NO.	SHEET NO.
T- 1160- 2021	M- 001	


#### PLUMBING AND DRAINAGE NOTES


M-503 M-100 / 1 : 125

- 1. PROVIDE MINIMUM OF 75Ø PIPING FOR UNDERGROUND SANITARY.
- 2. PROVIDE APPROVED BACKFLOW PREVENTOR FOR ALL TRAP SEAL PRIMER SYSTEMS.
- 3. PROVIDE MINUMUM 100Ø PIPING FOR UNDERGROUND STORMWATER DRAINAGE.
- 4. INSTALL ALL PIPING OVERHEAD, TIGHT TO UNDESIDE OF THE STRUCTURE WITH SUFFICIENT ROOM FOR INSULATION UNLESS INDICATED OTHERWISE. ROUTE PIPING WITHIN STRUCTURE STEEL STRATA OR THROUGH CONCRETE BEAMS WHERE PRACTICAL.SUPPLY DUCT OF FAN COILS FC-3,4,8,9,10,11,13,19 SHALL BE ACOUSTICALLY LINED FOR MINIMUM LENGTH OF 3 METERS.
- 5. PROVIDE SHUT-OFF VALVE ON ALL MIN RISERS AND AT EACH CONNECTION TO THE EQUIPMENT FOR FLOW CONTROL IN TIME OF MAINTANANCE.
- 6. PROVIDE COMPLETE VENTING SYSTEM IN ACCORDANCE WITH THE ONTARIO BUILDING CODE.
- 7 PROVIDE A CLEANOUT AT THE BOTTOM OF EVERY SANITARY AND STORM STACK THAT CONNECTS TO A HORIZONTAL PIPE.
- 8 PLUMBING CONTRACTOR SHALL BE RESPONSIBLE FOR ROUTING FIXTURE VENTS TO INDICATED BUILDING VENT TERMINATEION(S)
- 8 ALL PLUMBING FIXTURES AND DRAINS SHALL BE P-TRAPPED AND VENTED IN ACCORDANCE WITH THE
- 9 THE CONTRACTOR SHALL PROVIDE A TRAP SEAL PRIMER AS SPECIFIED FOR ALL FLOOR DRAINS, FUNNEL FLOOR DRAINS, PIT DRAINS AND HUB DRAINS AS MAY BE APPLICABLE. COORDINATE ELECTRICAL TRAP SEAL PRIMERS WITH THE ELECTRICAL TRADE(S).
- 10. PIPING SHALL NOT PASS DIRECTLY ABOVE THE ELECTRICAL EQUIPMENT. CONTRACTOR SHALL PROVIDE DRAINAGE PAN BELOW THE PIPING AND PROVIDE DISCHARGE FROM THE DRAINAGE PAN

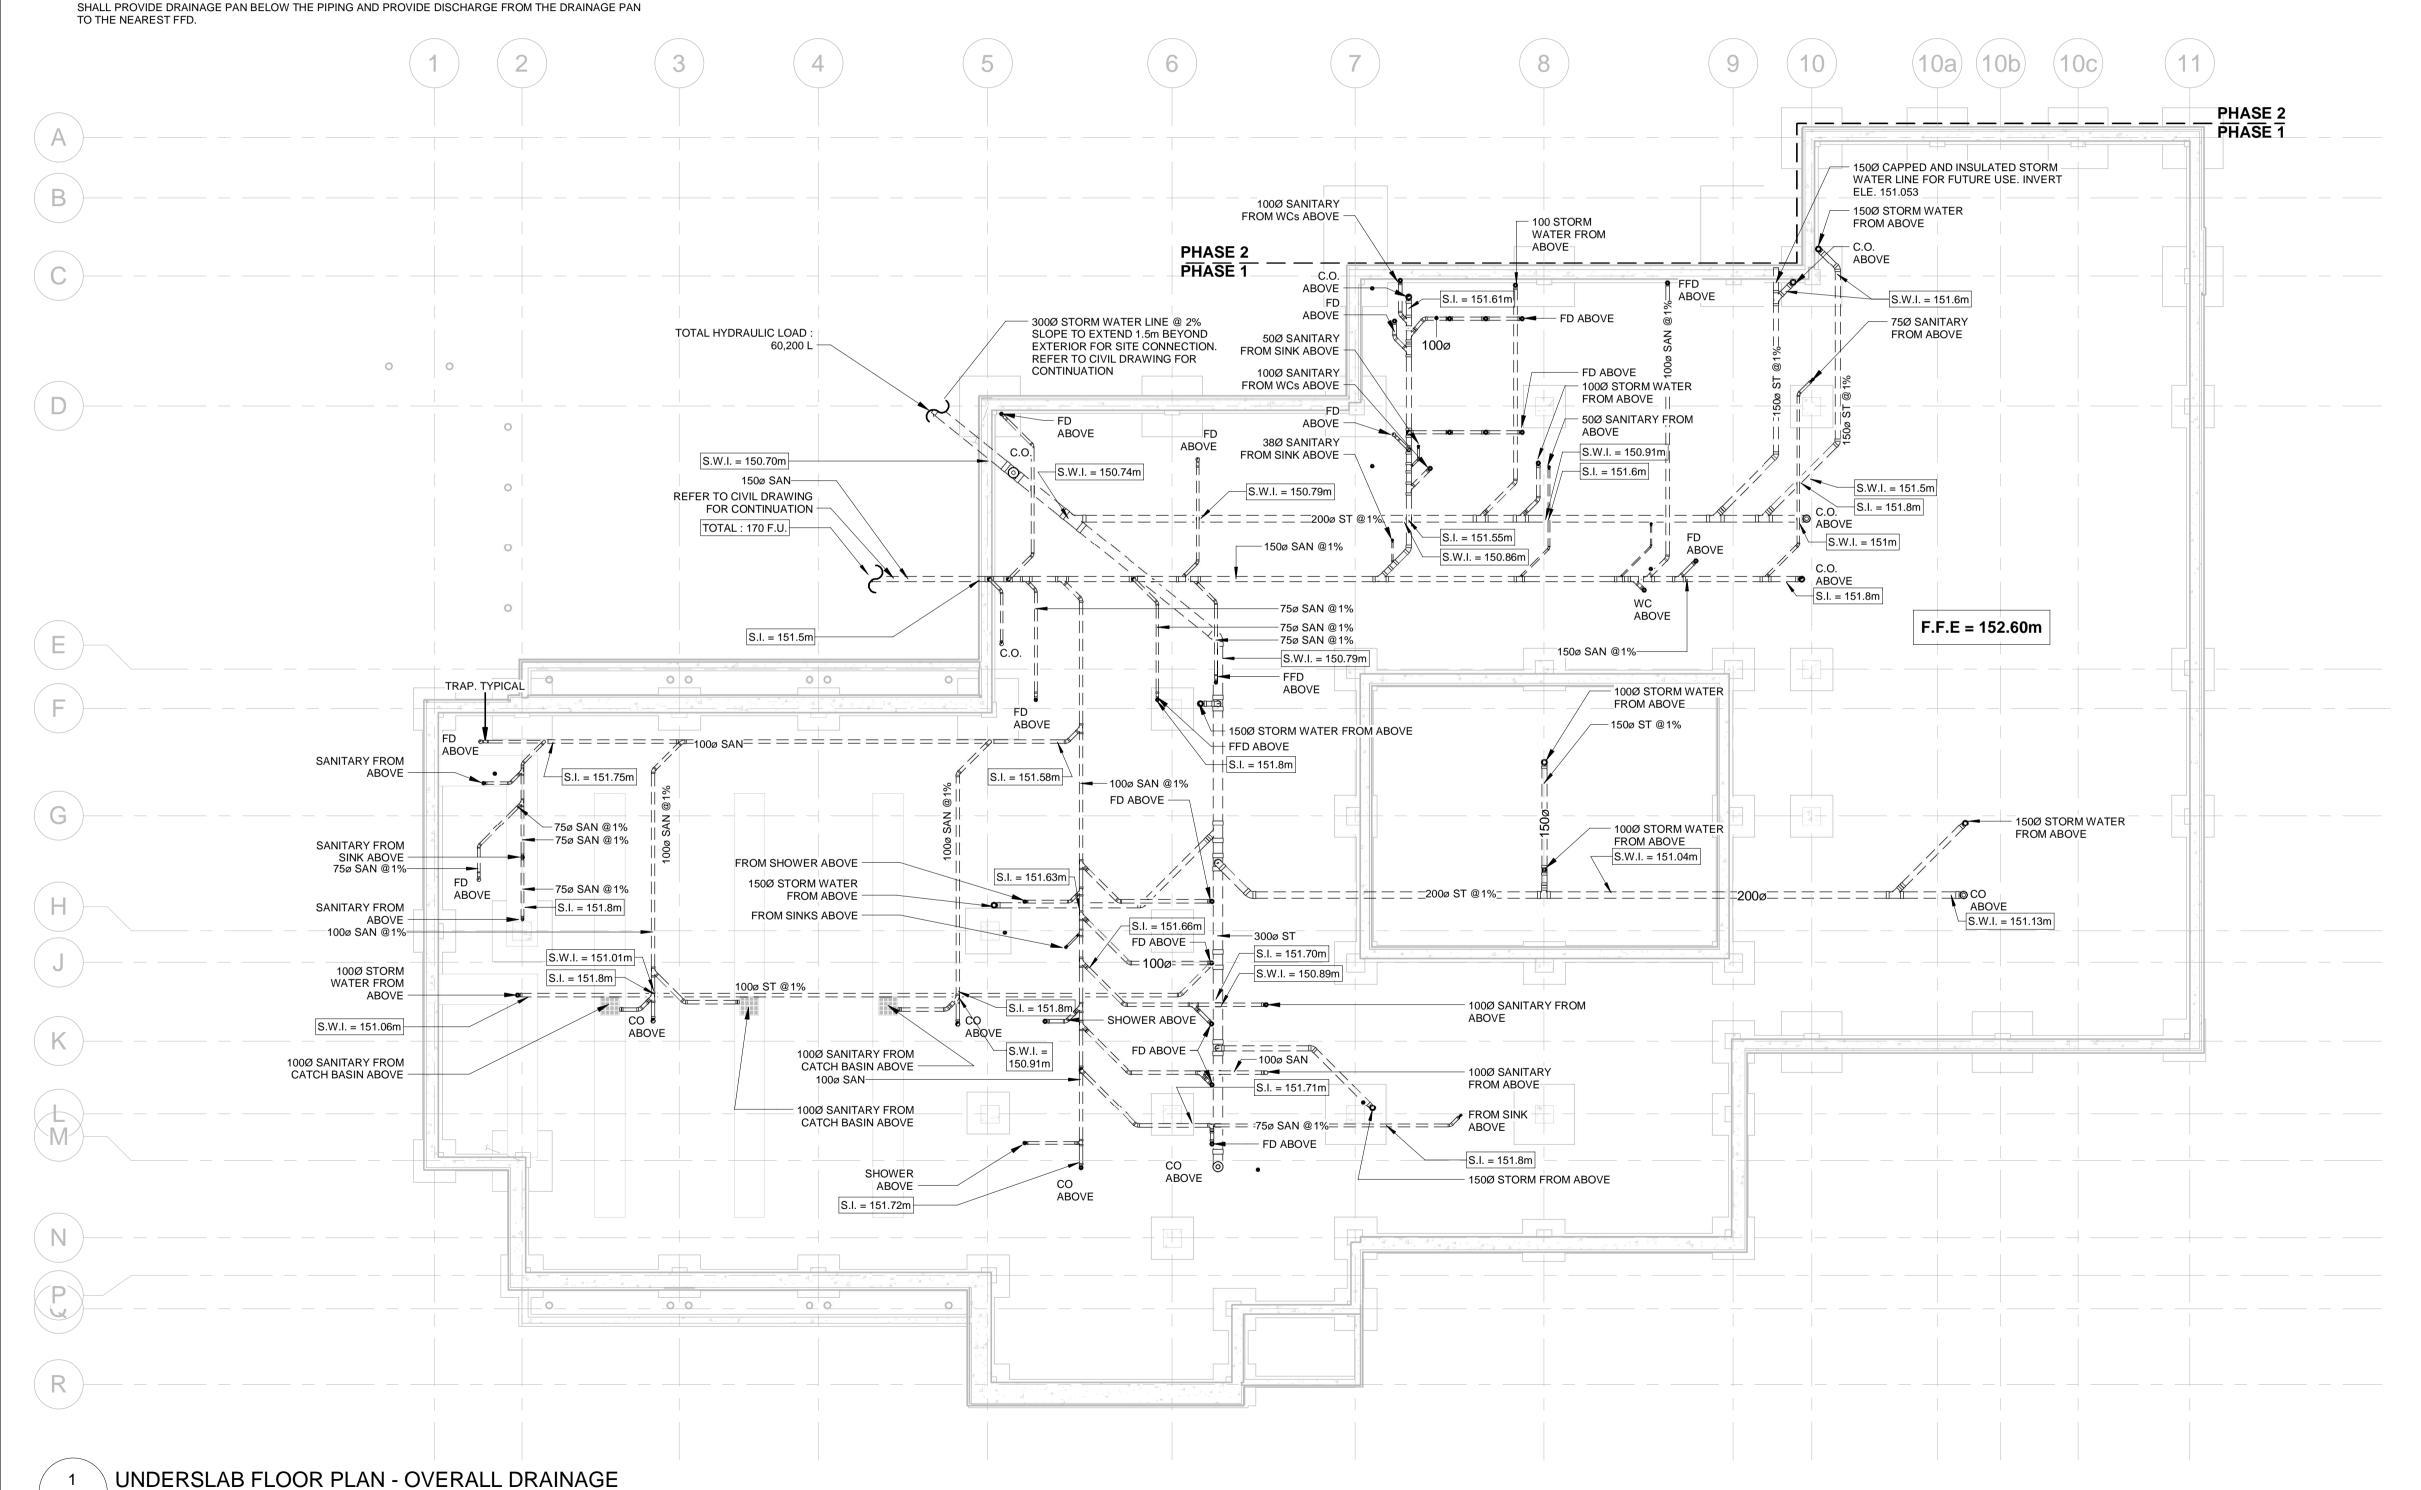

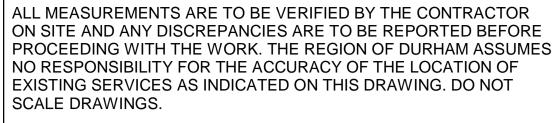

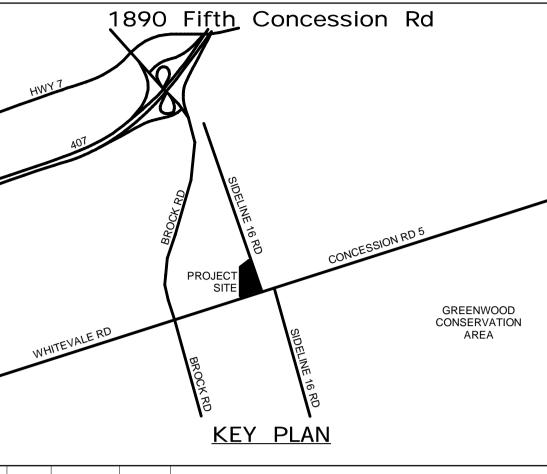

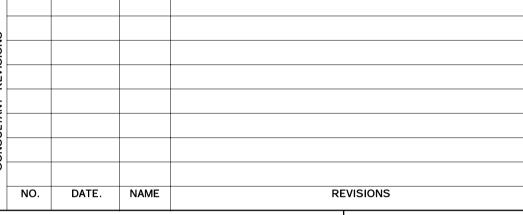

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DRAWN BY: Author

DATE: 10/27/20

CHECKED BY: Checker

CONSULTANT PROJECT NO. 60611569

APPROVED BY: Approver

CLIENT FILE No.: 811/20

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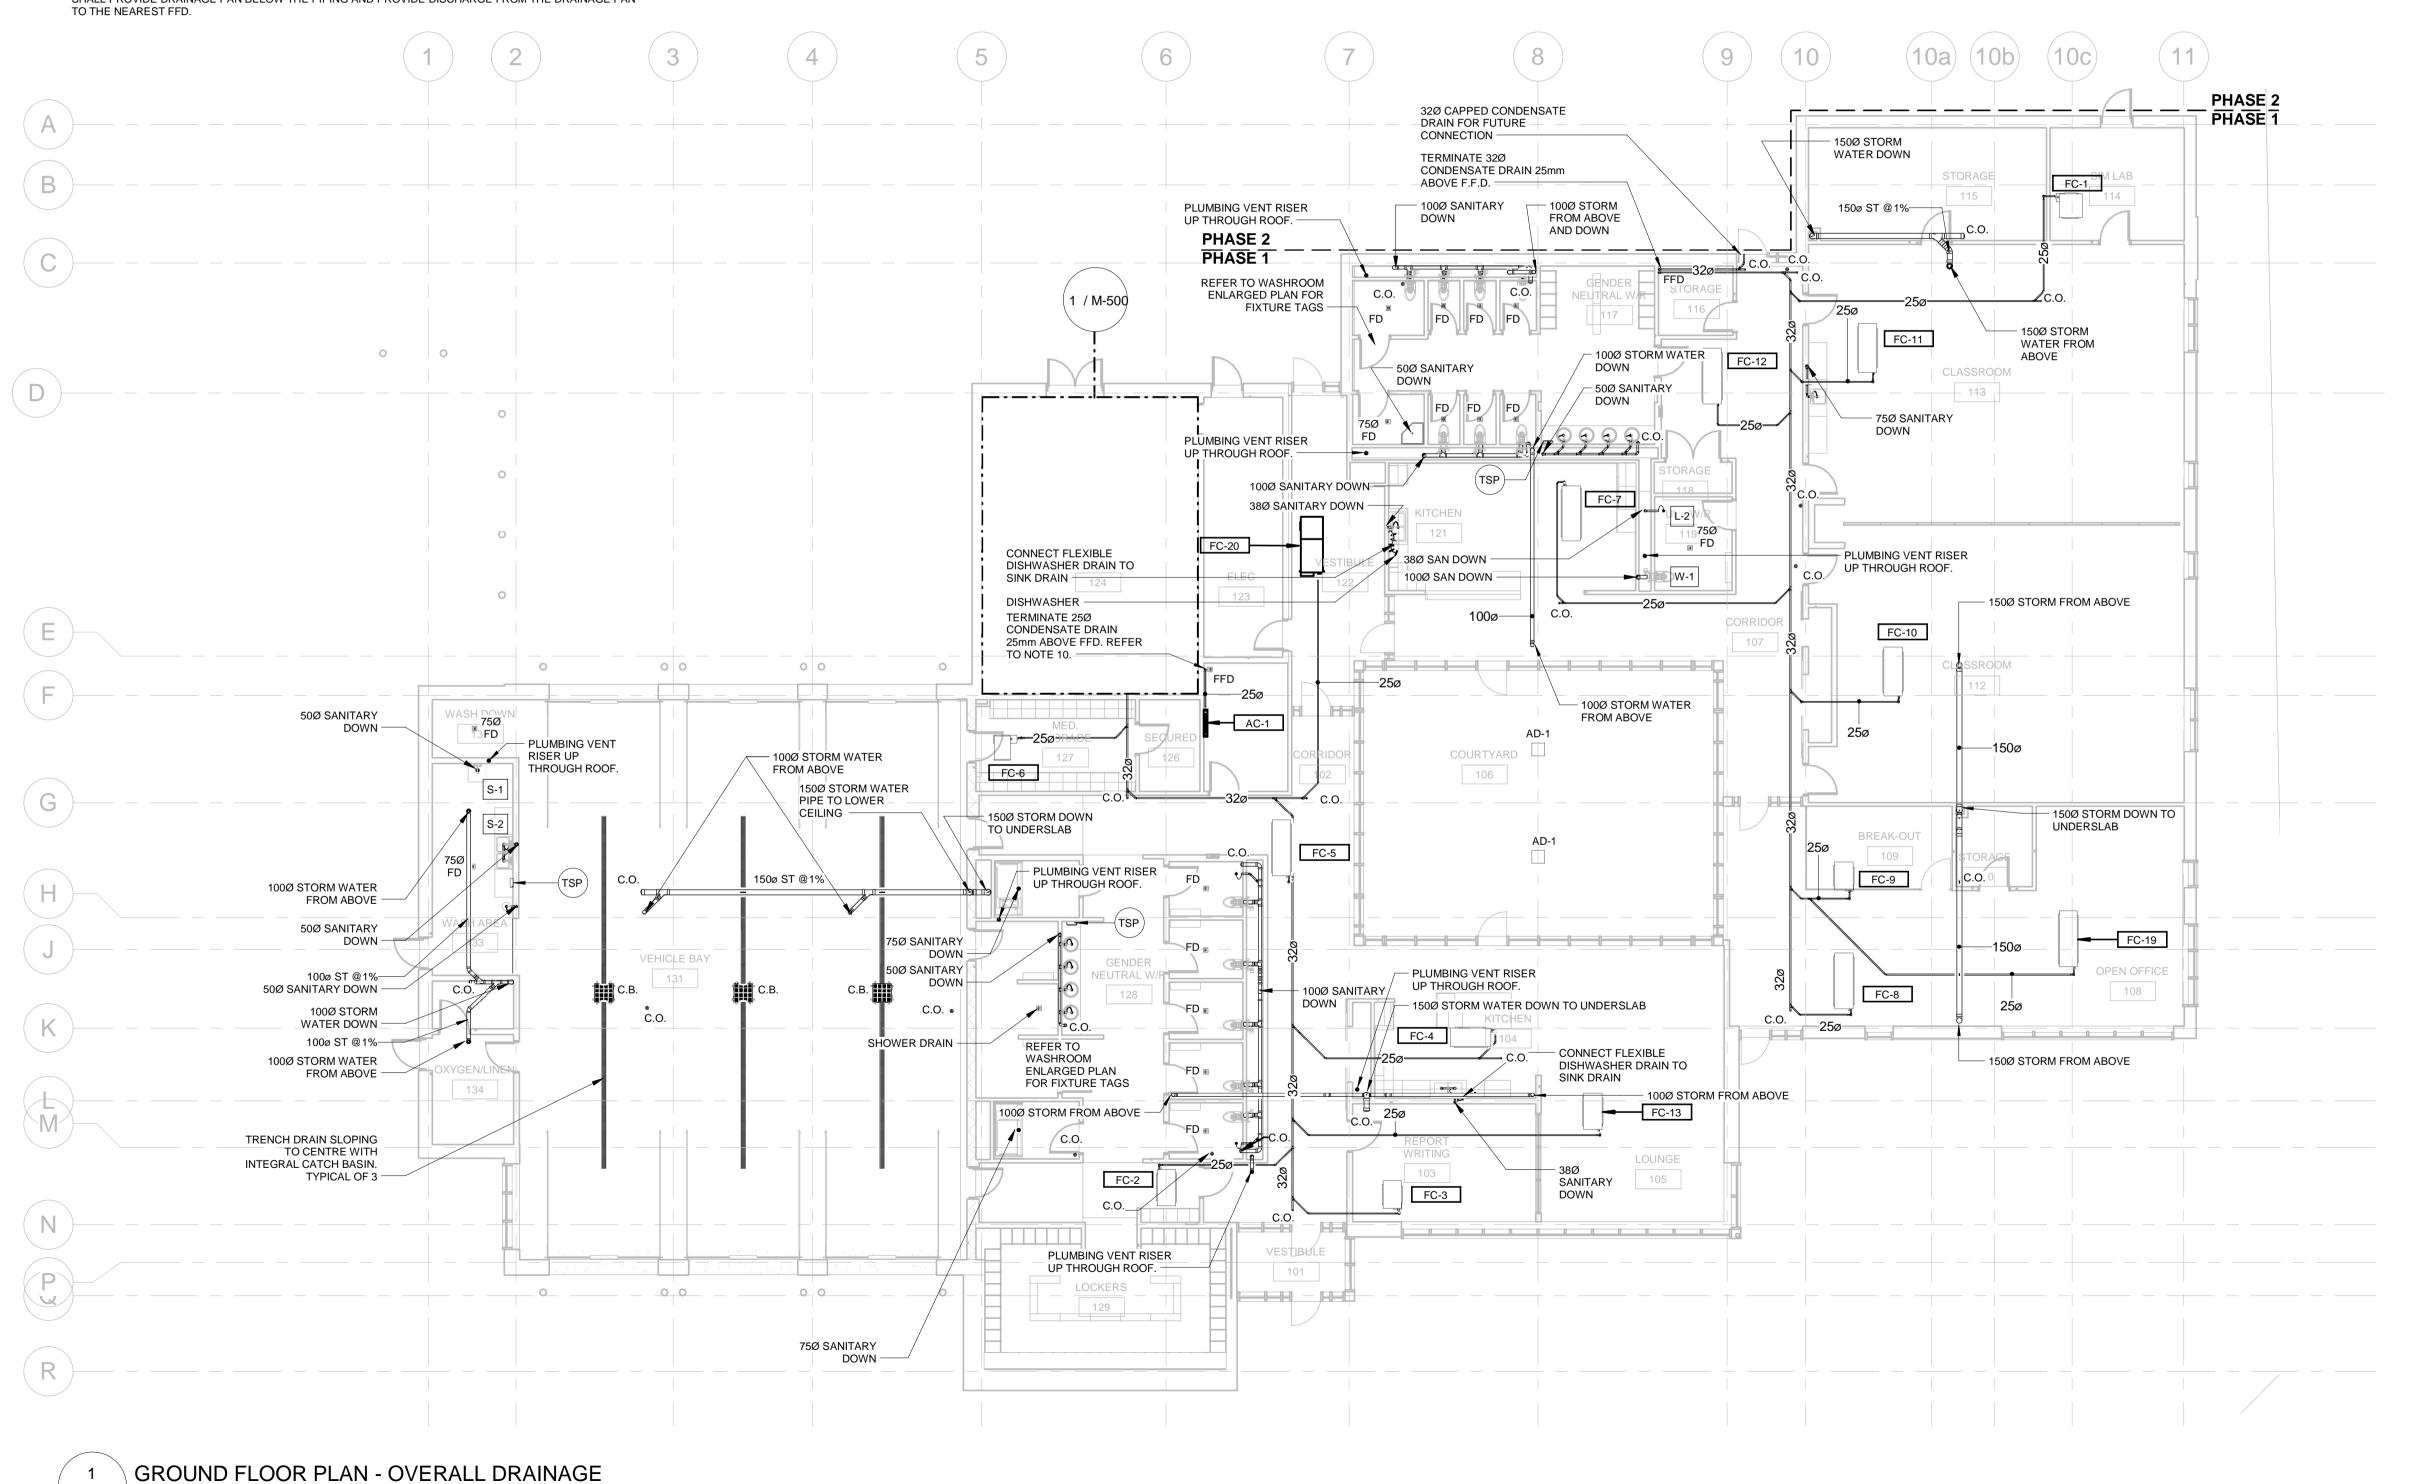
NEW SEATON PARAMEDIC STATION AND TRAINING FACILITY IN PICKERING UNDERSLAB PLAN - DRAINAGE

PROPERTY NO.	FACILITIES CODE	FACILITIES PROJECT NO. P061-18-01
CONTRACT NO.	DRAWING NO.	SHEET NO.
T- 1160- 2021	M- 100	


## **PLUMBING AND DRAINAGE NOTES** 3. PROVIDE MINUMUM 100Ø PIPING FOR UNDERGROUND STORMWATER DRAINAGE.


M-503 M-101 1 : 125

- 1. PROVIDE MINIMUM OF 75Ø PIPING FOR UNDERGROUND SANITARY.
- 2. PROVIDE APPROVED BACKFLOW PREVENTOR FOR ALL TRAP SEAL PRIMER SYSTEMS.
- 4. INSTALL ALL PIPING OVERHEAD, TIGHT TO UNDESIDE OF THE STRUCTURE WITH SUFFICIENT ROOM FOR INSULATION UNLESS INDICATED OTHERWISE. ROUTE PIPING WITHIN STRUCTURE STEEL STRATA OR THROUGH CONCRETE BEAMS WHERE PRACTICAL.SUPPLY DUCT OF FAN COILS FC-3,4,8,9,10,11,13,19 SHALL BE ACOUSTICALLY LINED FOR MINIMUM LENGTH OF 3 METERS.
- 5. PROVIDE SHUT-OFF VALVE ON ALL MIN RISERS AND AT EACH CONNECTION TO THE EQUIPMENT FOR FLOW CONTROL IN TIME OF MAINTANANCE.
- 6. PROVIDE COMPLETE VENTING SYSTEM IN ACCORDANCE WITH THE ONTARIO BUILDING CODE.
- 7 PROVIDE A CLEANOUT AT THE BOTTOM OF EVERY SANITARY AND STORM STACK THAT CONNECTS TO A
- 8 PLUMBING CONTRACTOR SHALL BE RESPONSIBLE FOR ROUTING FIXTURE VENTS TO INDICATED BUILDING VENT TERMINATEION(S)
- 8 ALL PLUMBING FIXTURES AND DRAINS SHALL BE P-TRAPPED AND VENTED IN ACCORDANCE WITH THE ONTARIO BUILDING CODE.
- 9 THE CONTRACTOR SHALL PROVIDE A TRAP SEAL PRIMER AS SPECIFIED FOR ALL FLOOR DRAINS, FUNNEL FLOOR DRAINS, PIT DRAINS AND HUB DRAINS AS MAY BE APPLICABLE. COORDINATE ELECTRICAL TRAP SEAL PRIMERS WITH THE ELECTRICAL TRADE(S).
- 10. PIPING SHALL NOT PASS DIRECTLY ABOVE THE ELECTRICAL EQUIPMENT. CONTRACTOR SHALL PROVIDE DRAINAGE PAN BELOW THE PIPING AND PROVIDE DISCHARGE FROM THE DRAINAGE PAN



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CLIENT FILE No.: 811/20 APPROVED BY: Approve 0 09/22/21 ISSUED FOR TENDER NO DATE REVISIONS

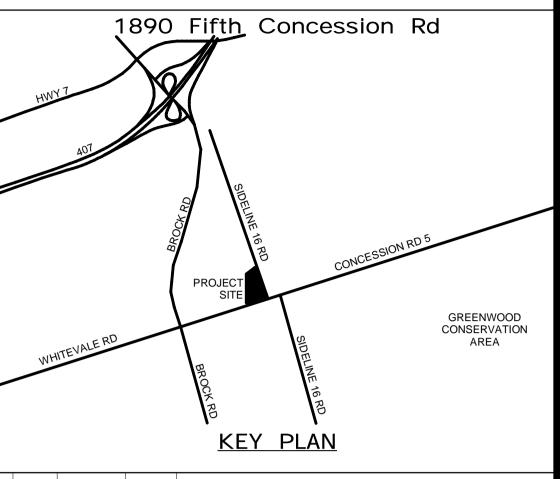


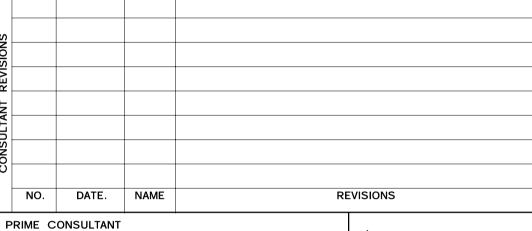
#### THE REGIONAL MUNICIPALITY OF DURHAM

WORKS DEPARTMENT DESIGN, CONSTRUCTION & ASSET MANAGEMENT

NEW SEATON PARAMEDIC STATION AND TRAINING FACILITY IN PICKERING FLOOR PLAN - DRAINAGE

PROPERTY NO.	FACILITIES CODE	FACILITIES PROJECT NO. P061-18-01
CONTRACT NO. T- 1160- 2021	DRAWING NO.  M- 101	SHEET NO.

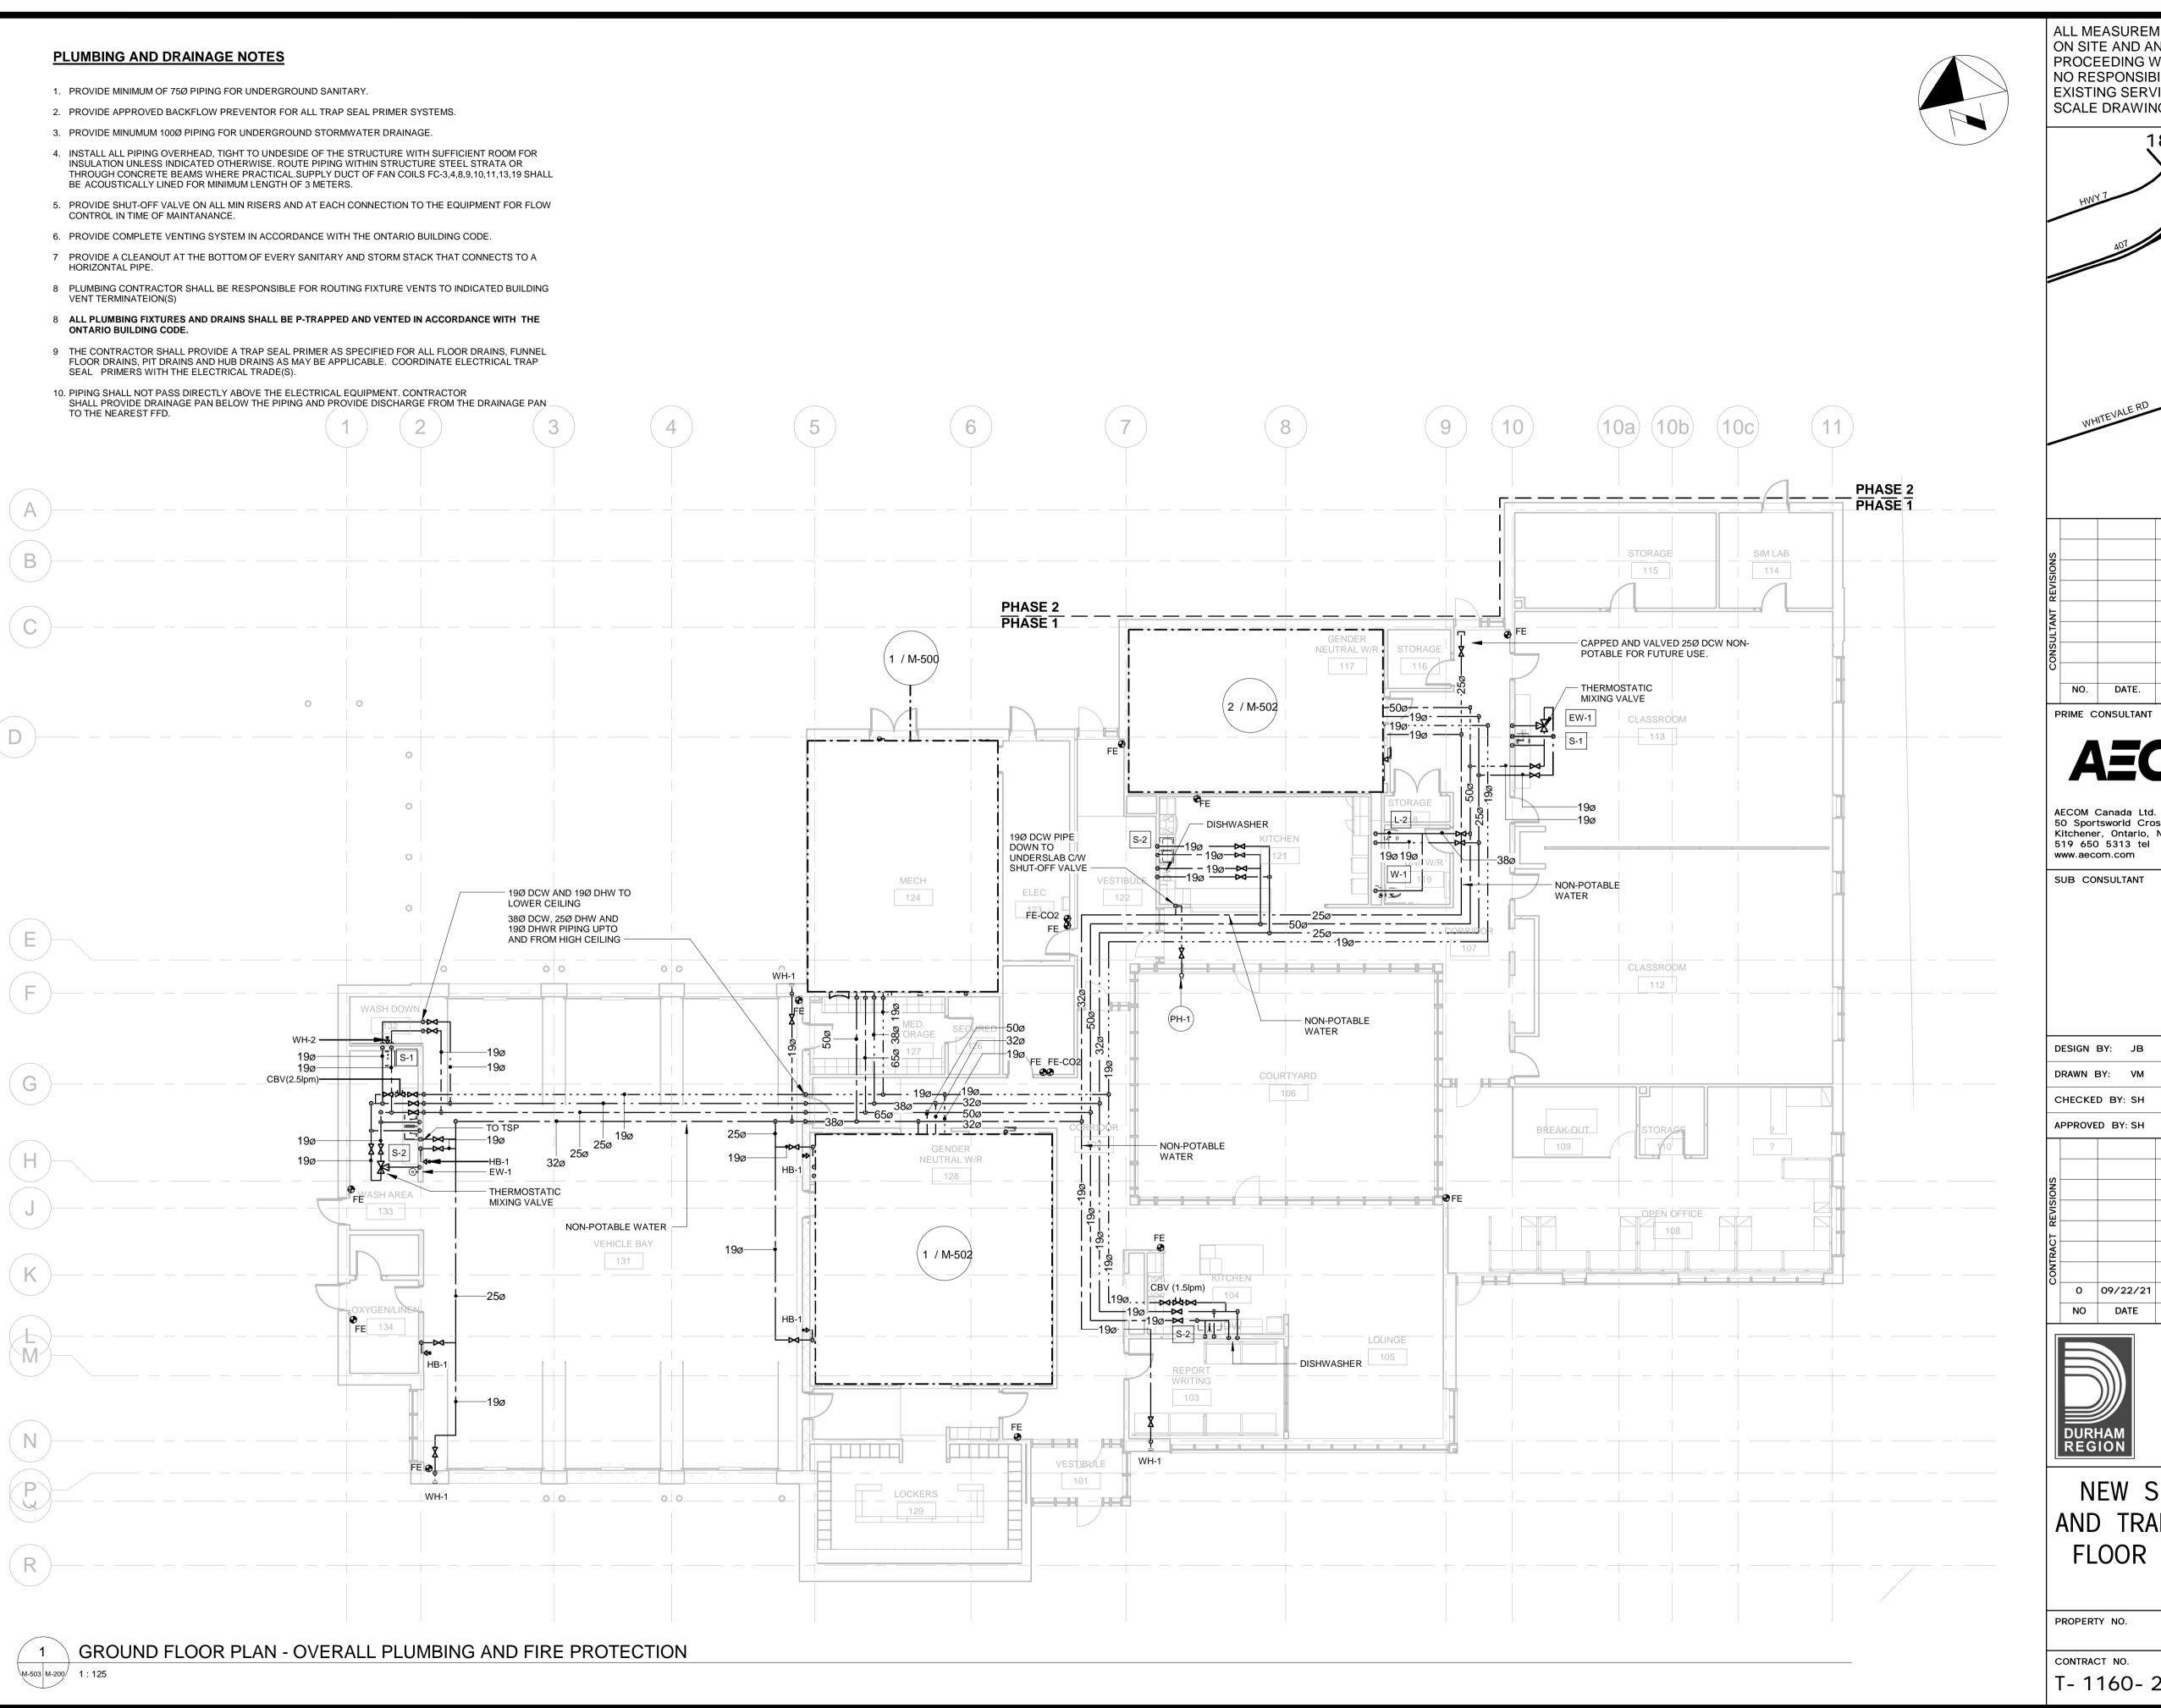

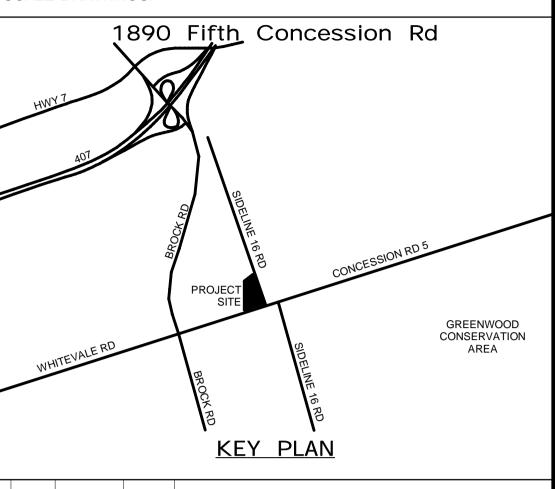

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THE REGIONAL MUNICIPALITY OF DURHAM

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DESIGN, CONSTRUCTION & ASSET MANAGEMENT

NEW SEATON PARAMEDIC STATION AND TRAINING FACILITY IN PICKERING FLOOR PLAN - PLUMBING & FIRE **PROTECTION** 

PROPERTY NO.	FACILITIES CODE	FACILITIES PROJECT NO. P061-18-01
CONTRACT NO.	DRAWING NO.	SHEET NO.
T- 1160- 2021	M- 200	


#### **KEY NOTES** 1. PROVIDE SILVER COLOURED GRAVITY BACKDRAFT FLAP FOR RANGE HOOD AND WASHROOM EXHAUST. (TYPICAL OF 3) INSTALL AT 3500 AFF 2. DUCT DOWN TO 300MM A.F.F. COMPLETE WITH BALANCING DAMPER. TERMINATE AT E3 GRILLE.. 3. 350Ø TRANSFER DUCT TO BE 300X300 UNLESS INDICATED OTHERWISE. PROVIDE ACOUSTICALLY LINED DUCT FOR ALL TRANSFER AIR DUCTS. 4. RETURN AIR PLENUMS OF FAN COIL TO BE ACOUSTICALLY LINED COMPLETE WITH MITERED SINGLE THICKNESS VANE ELBOW. FOR SIZE, REFER TO MANUFACTURER SPECIFICATION. (TYPICAL FOR ALL FAN WITHOUT T-BAR CEILING.

- 5. PROVIDE ACCESS DOORS FOR ALL FAN COILS, VAV TERMINAL BOXES AND BALANCING DAMPERS IN AREAS
- 6. INSTALL GAS DETECTORS OF VEHICLE BAY AT 1500mm A.F.F.
- 7. ROOM THERMOSTATS OF FOLLOWING FAN COIL UNITS SHALL HAVE INTEGRATED RELATIVE HUMIDITY SENSOR AND CO2 SENSOR: FC-3,4,8,9,13&19
- 8. ROOM THERMOSTATS OF FOLLOWING FAN COIL UNITS SHALL HAVE INTEGRATED RELATIVE HUMIDITY SENSOR, CO2 SENSOR AND OCCUPANCY SENSOR: FC-10&11


GROUND FLOOR PLAN - OVERALL HVAC PLAN

M-503 M-300 1: 125

9. AIR BALANCING AND SEQUENCING OF MOTORIZED DAMPERS: a. WHEN EMS IS THE ONLY OCCUPIED SPACE OF THE BUILDING (AS DETERMINED BY THE TIME-OF-DAY SCHEDULING) GENERAL RETURN AIR DAMPER [MD-4] SHALL BE CLOSED AND WASHROOM EXHAUST AIR

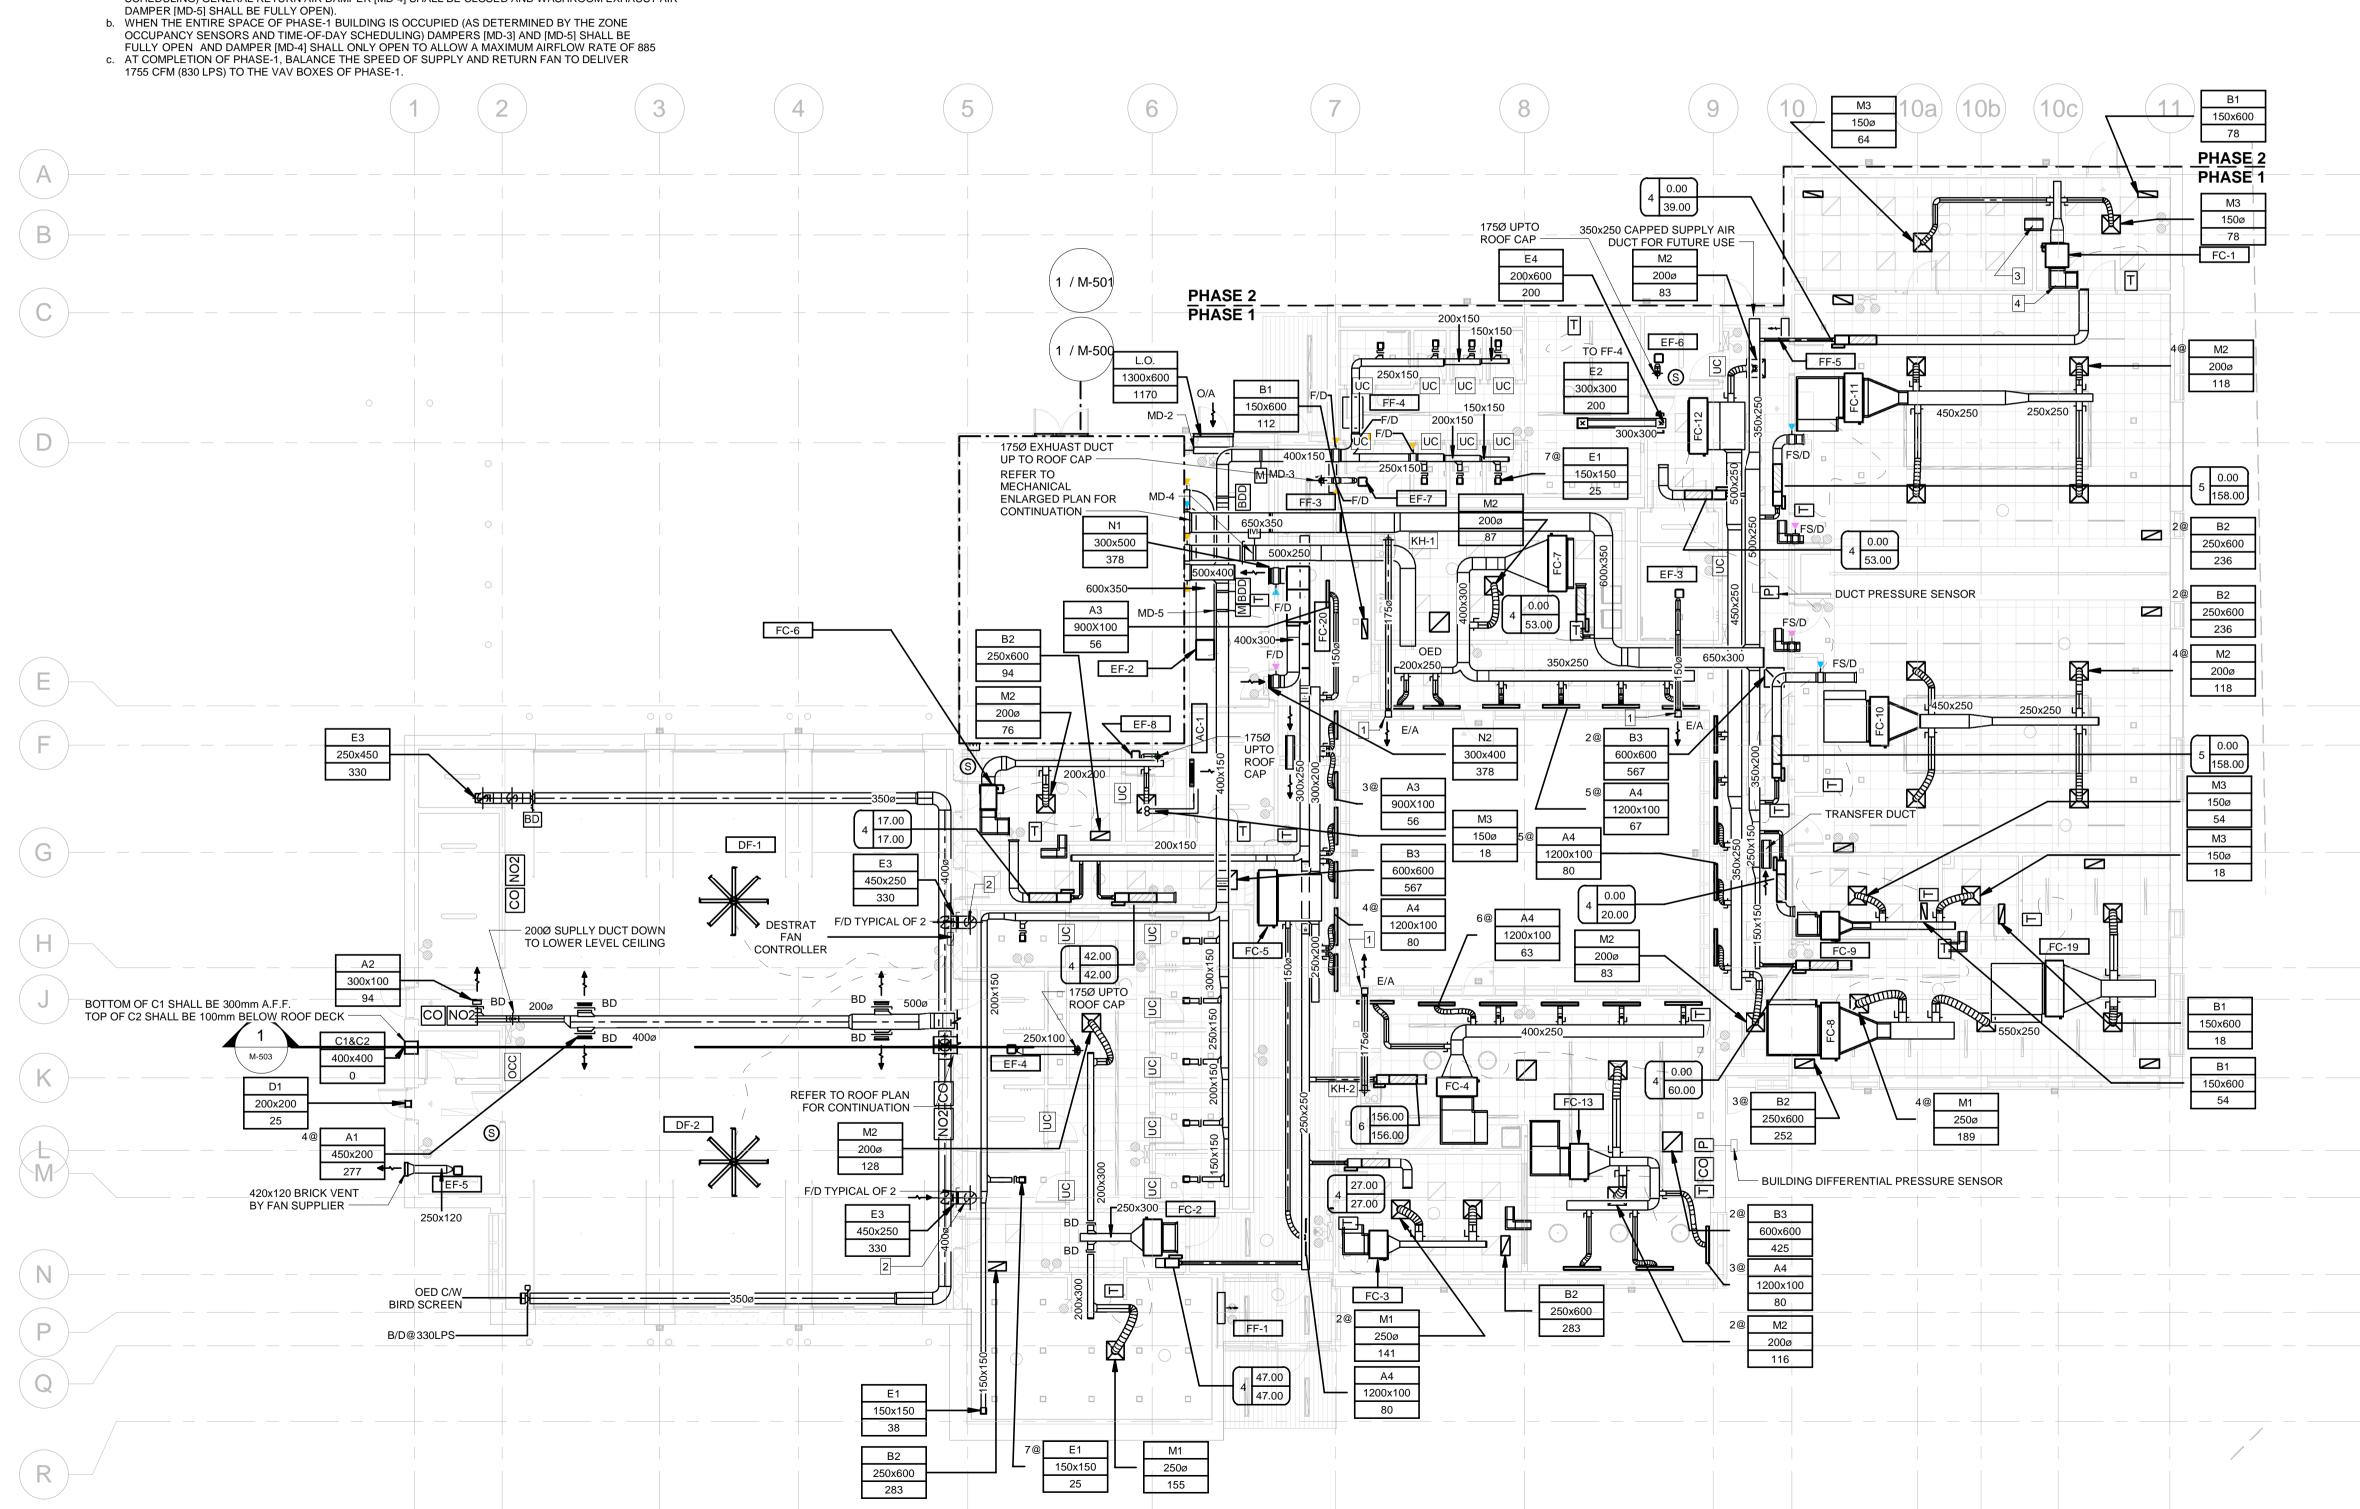

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PROVED BY: Approver		CLIENT FIL	E No.: 811/20
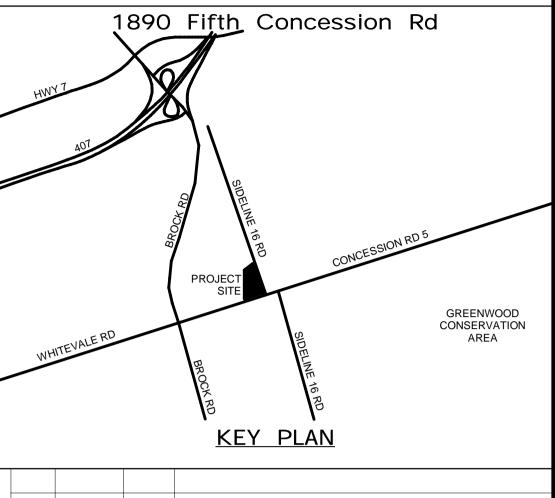
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REVISIONS

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NEW SEATON PARAMEDIC STATION AND TRAINING FACILITY IN PICKERING FIRST FLOOR PLAN - HVAC


PROPERTY NO.	FACILITIES CODE	FACILITIES PROJECT NO. P061-18-01
CONTRACT NO.	DRAWING NO.	SHEET NO.
T- 1160- 202	1 M- 300	

#### **GENERAL NOTES** 1- SHUT OFF VALVE SHALL BE CLOSED AT COMPLETION OF PHASE 2 (TYP. OF 2). 2- PIPING SHALL NOT PASS DIRECTLY ABOVE THE ELECTRICAL EQUIPMENT. CONTRACTOR SHALL PROVIDE DRAINAGE PAN BELOW ALL THE PIPING AND PROVIDE DISCHARGE FROM THE DRAINAGE PAN TO THE 3- GENERAL CONTRACTOR SHALL PROVIDE ACCESS DOORS FOR OPERATING/MAINTENANCE OF VALVES IN NON-REMOVABLE CEILING TYPES (GYPSUM BOARD AND WOOD FEATURE CEILING). 4- INSTALL ALL PIPING OVERHEAD, TIGHT TO UNDERSIDE OF THE STRUCTURE WITH SUFFICIENT ROOM FOR INSULATION. ROUTE PIPING WITHIN STRUCTURE STEEL STRATA OR THROUGH CONCRETE BEAMS WHERE CAPPED AND VALVED CONNECTION FOR FUTURE \_USE. (TYPICAL OF 6)\_-REFER TO NOTE 1 CH-1 TO BE 2000A.F.F. FC-1 1 / M-500 FF-4 CLASSROOM 113 50ø HWR 75ø CHWR 75ø CHWS 32ø 50ø HWS-REFER TO PROVIDE MINIMUM FLOW BYPASS VALVES BETWEEN CHWS NOTE 2 -AND CHWR PIPES AROUND THIS AREA. CONTRACTOR TO ADJUST LOCATION ON SITE. PROVIDE 50MM PIPE AND VALVES. ALSO PROVIDE DIFFERENTIAL PRESSURE SENSOR FOR P-6A&6B 124 AT THIS LOCATION. HWS — CHWS — CHWRR -FC-6 19ø 19ø COURTYARD G -1—12ø HWS—— PROVIDE MINIMUM FLOW BYPASS VALVES BETWEEN HWS AND HWR PIPES AROUND THIS 32ø + 32ø AREA. CONTRACTOR TO ADJUST LOCATION ON SITE. PROVIDE 38MM PIPE AND VALVES. IN-FLOOR HEATING -– 32Ø GLYS & GLYR UPTO ERV-1 ON ROOF. GENDER L + + 3 NEUTRAL W/R MFC-13 129

GROUND FLOOR PLAN - HEAT TRANSFER

M-503 M-301 1 : 125

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PRIME CONSULTANT
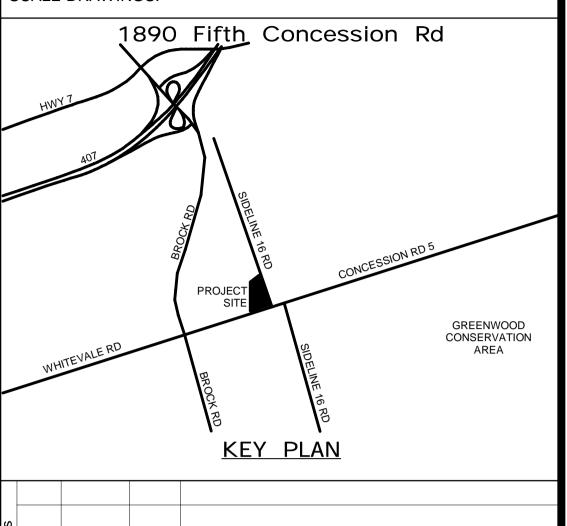
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PHASE 2

PHASE 1

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DESIGN BY: Designer	SCALE: As indicated
DRAWN BY: Author	DATE: 10/28/20
CHECKED BY: Checker	CONSULTANT PROJECT NO. 60611569
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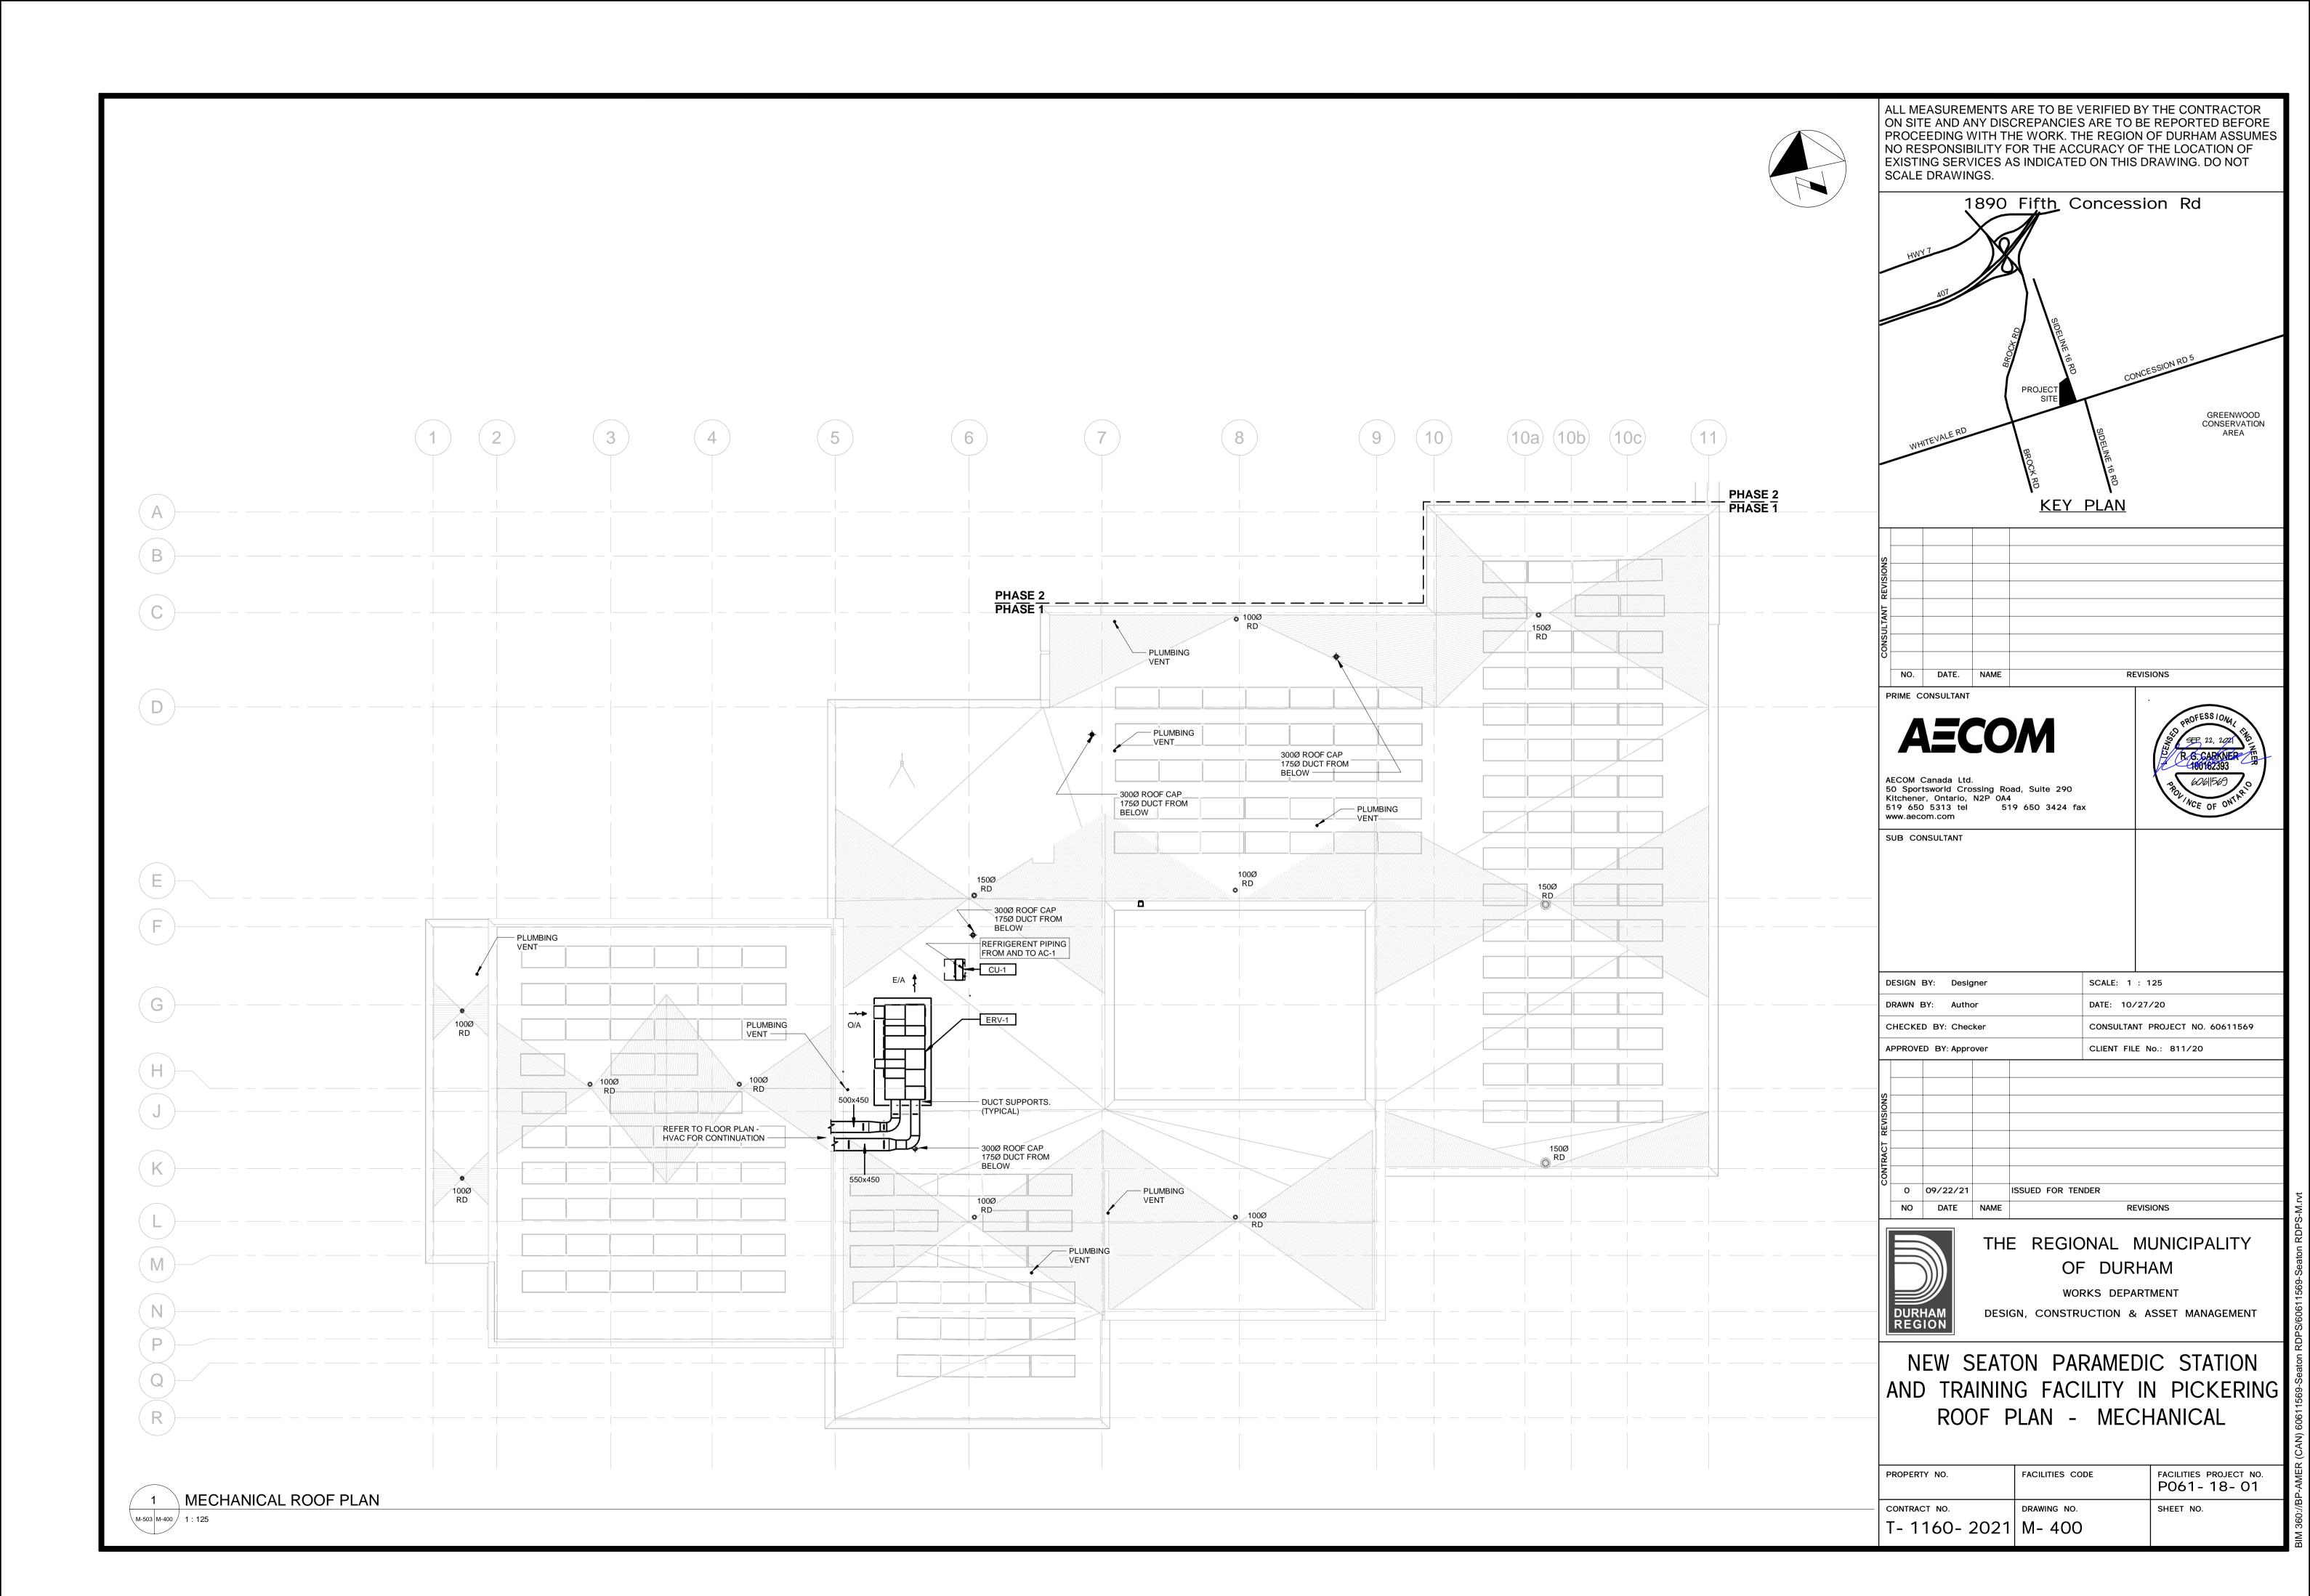
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OF DURHAM


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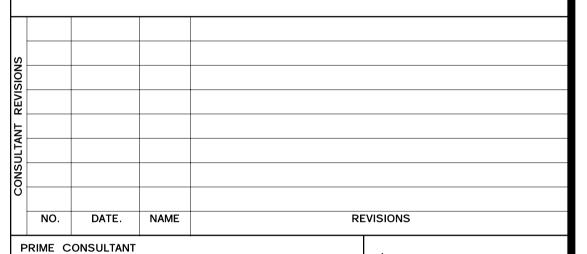
NEW SEATON PARAMEDIC STATION
AND TRAINING FACILITY IN PICKERING
FLOOR PLAN - HYDRONIC HEATING
& COOLING

PROPERTY NO.	FACILITIES CODE	FACILITIES PROJECT NO. P061-18-01	
CONTRACT NO. T- 1160- 2021	DRAWING NO. M- 301	SHEET NO.	a//·U36 MIa





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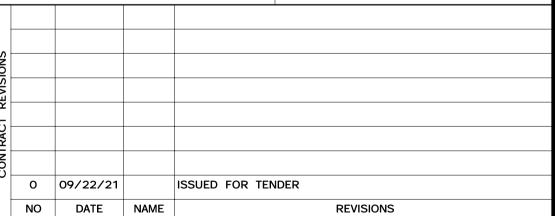
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APPROVED BY: Approver	CLIENT FILE No.: 811/20

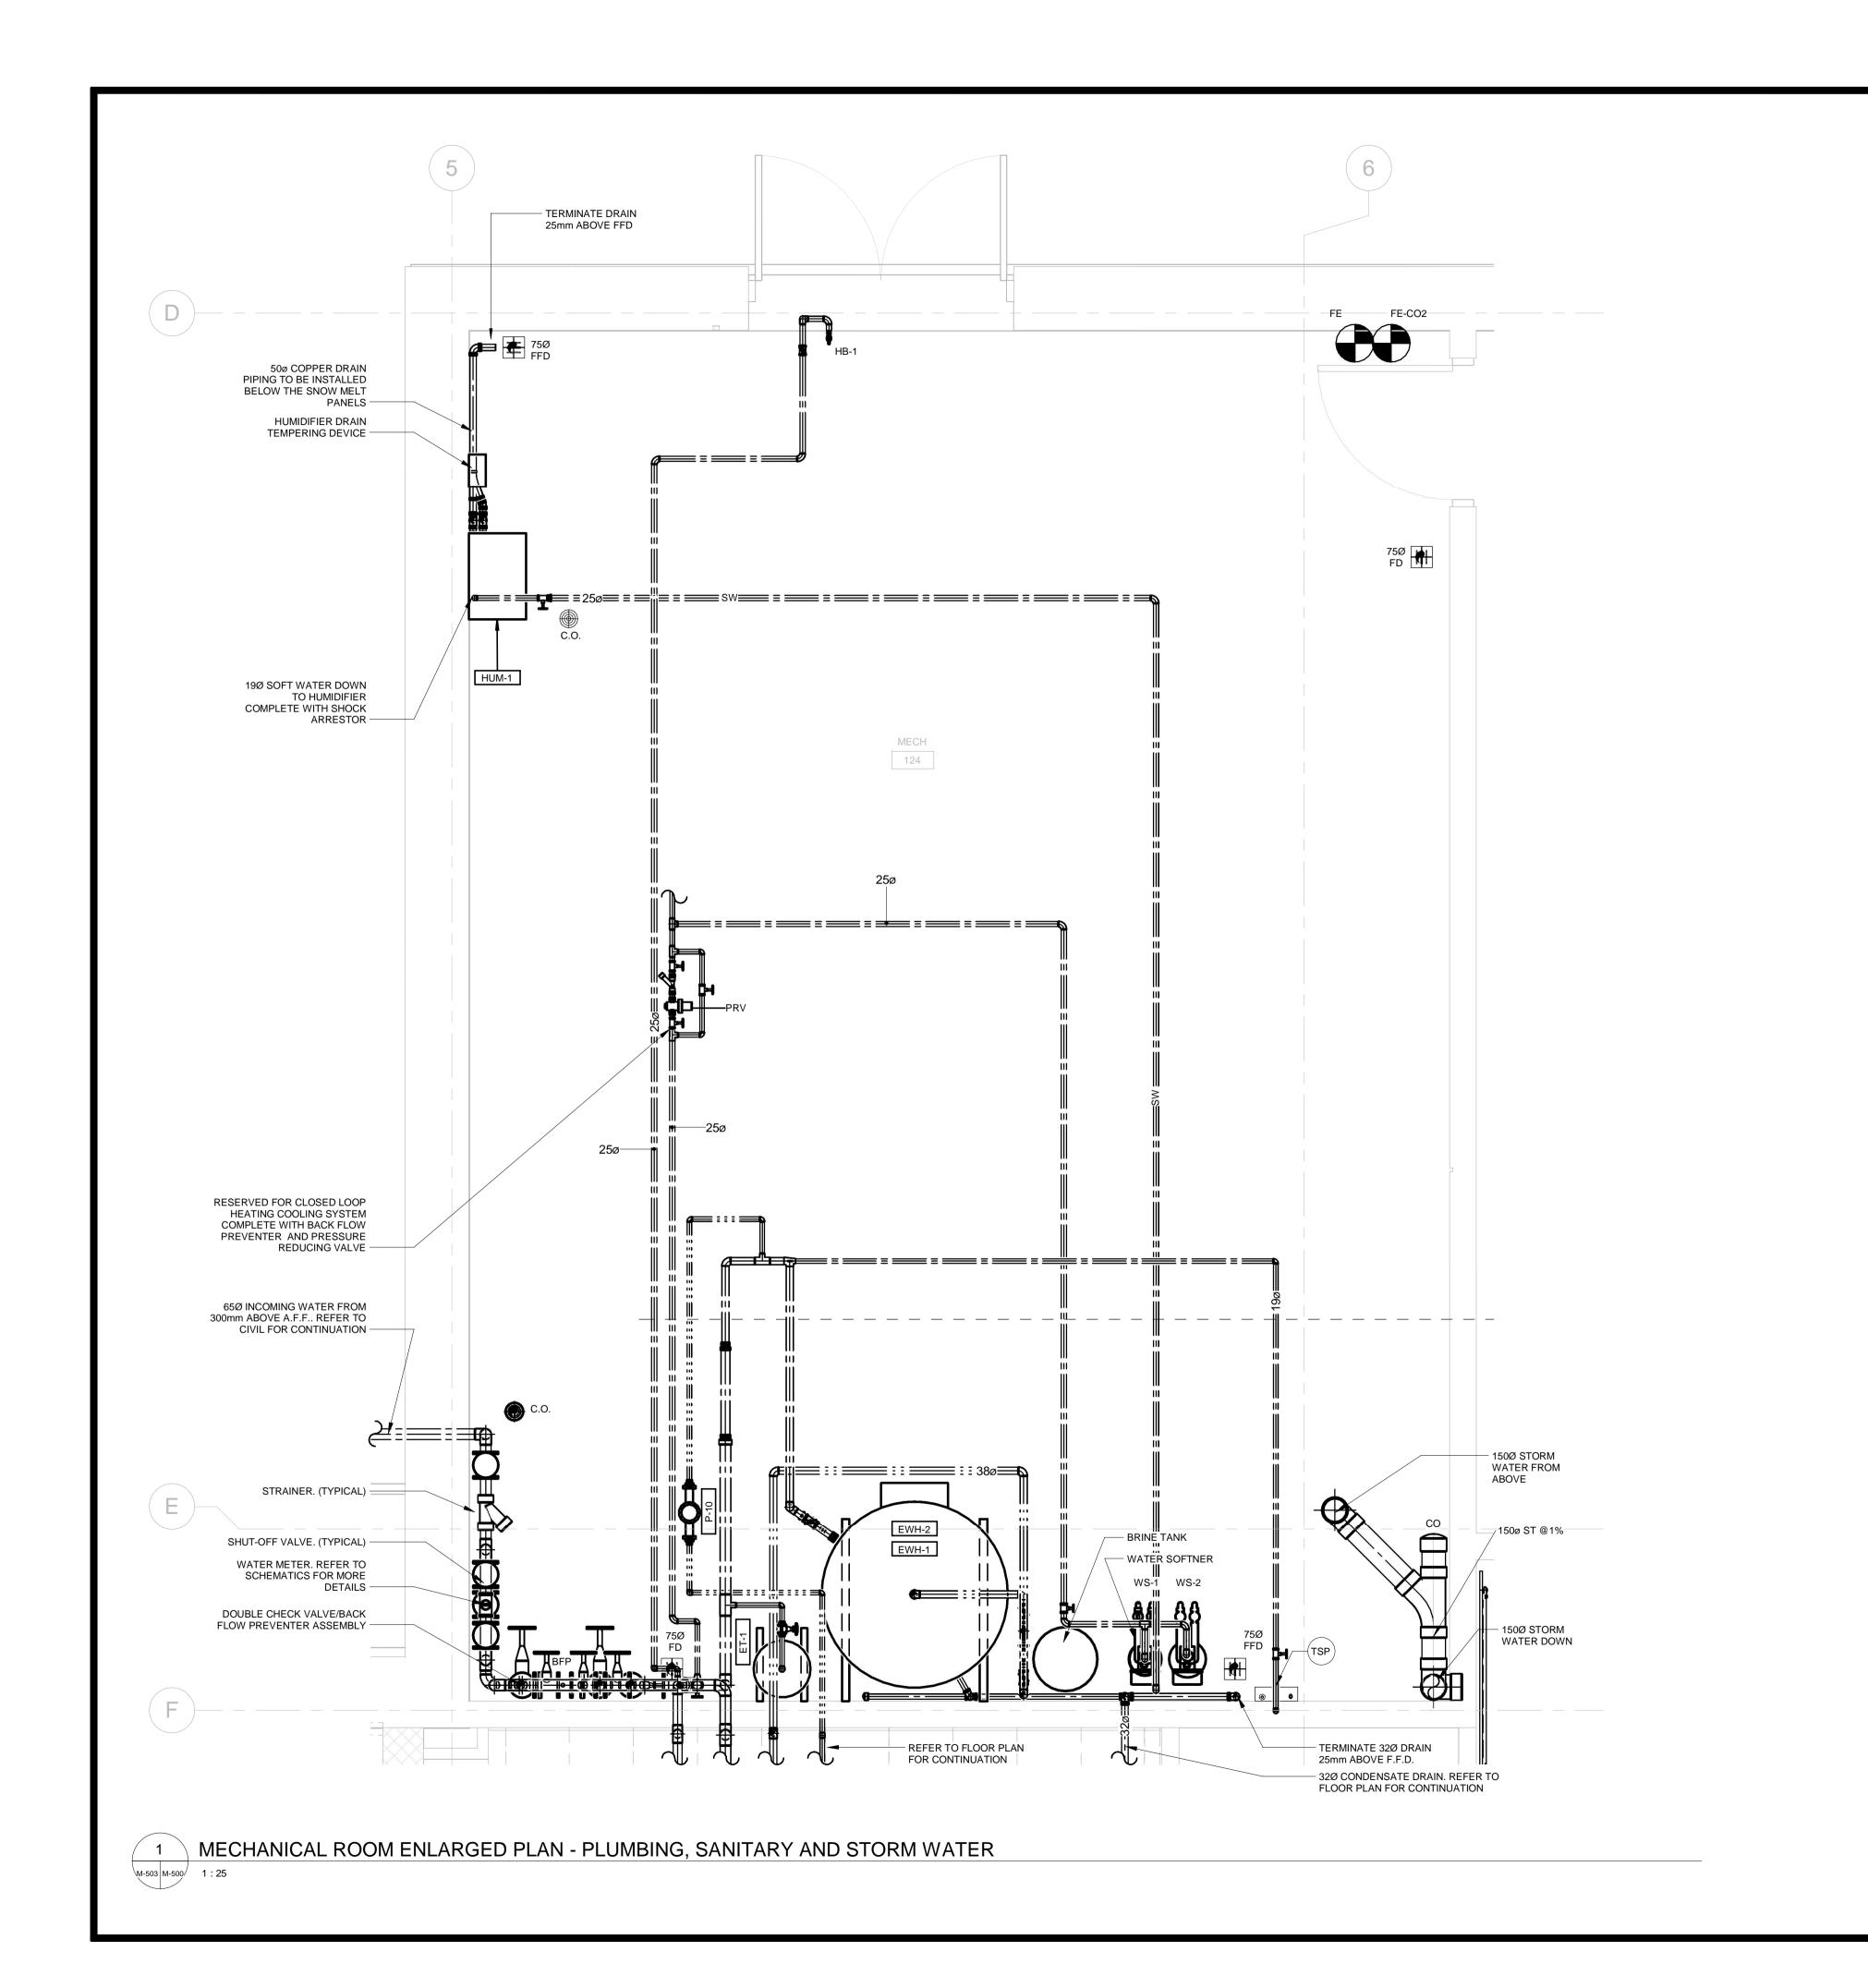




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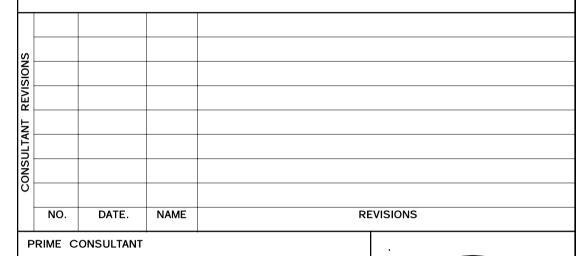
DESIGN, CONSTRUCTION & ASSET MANAGEMENT

# NEW SEATON PARAMEDIC STATION AND TRAINING FACILITY IN PICKERING MECHANICAL ROOM ENLARGED PLAN- 1

L					
	PROPERTY NO.	FACILITIES CODE	FACILITIES PROJECT NO. P061-18-01		
	CONTRACT NO.	DRAWING NO.	SHEET NO.		
	T- 1160- 2021	M- 500			



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DRAWN BY: Author	DATE: 12/10/20
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APPROVED BY: Approver	CLIENT FILE No.: 811/20
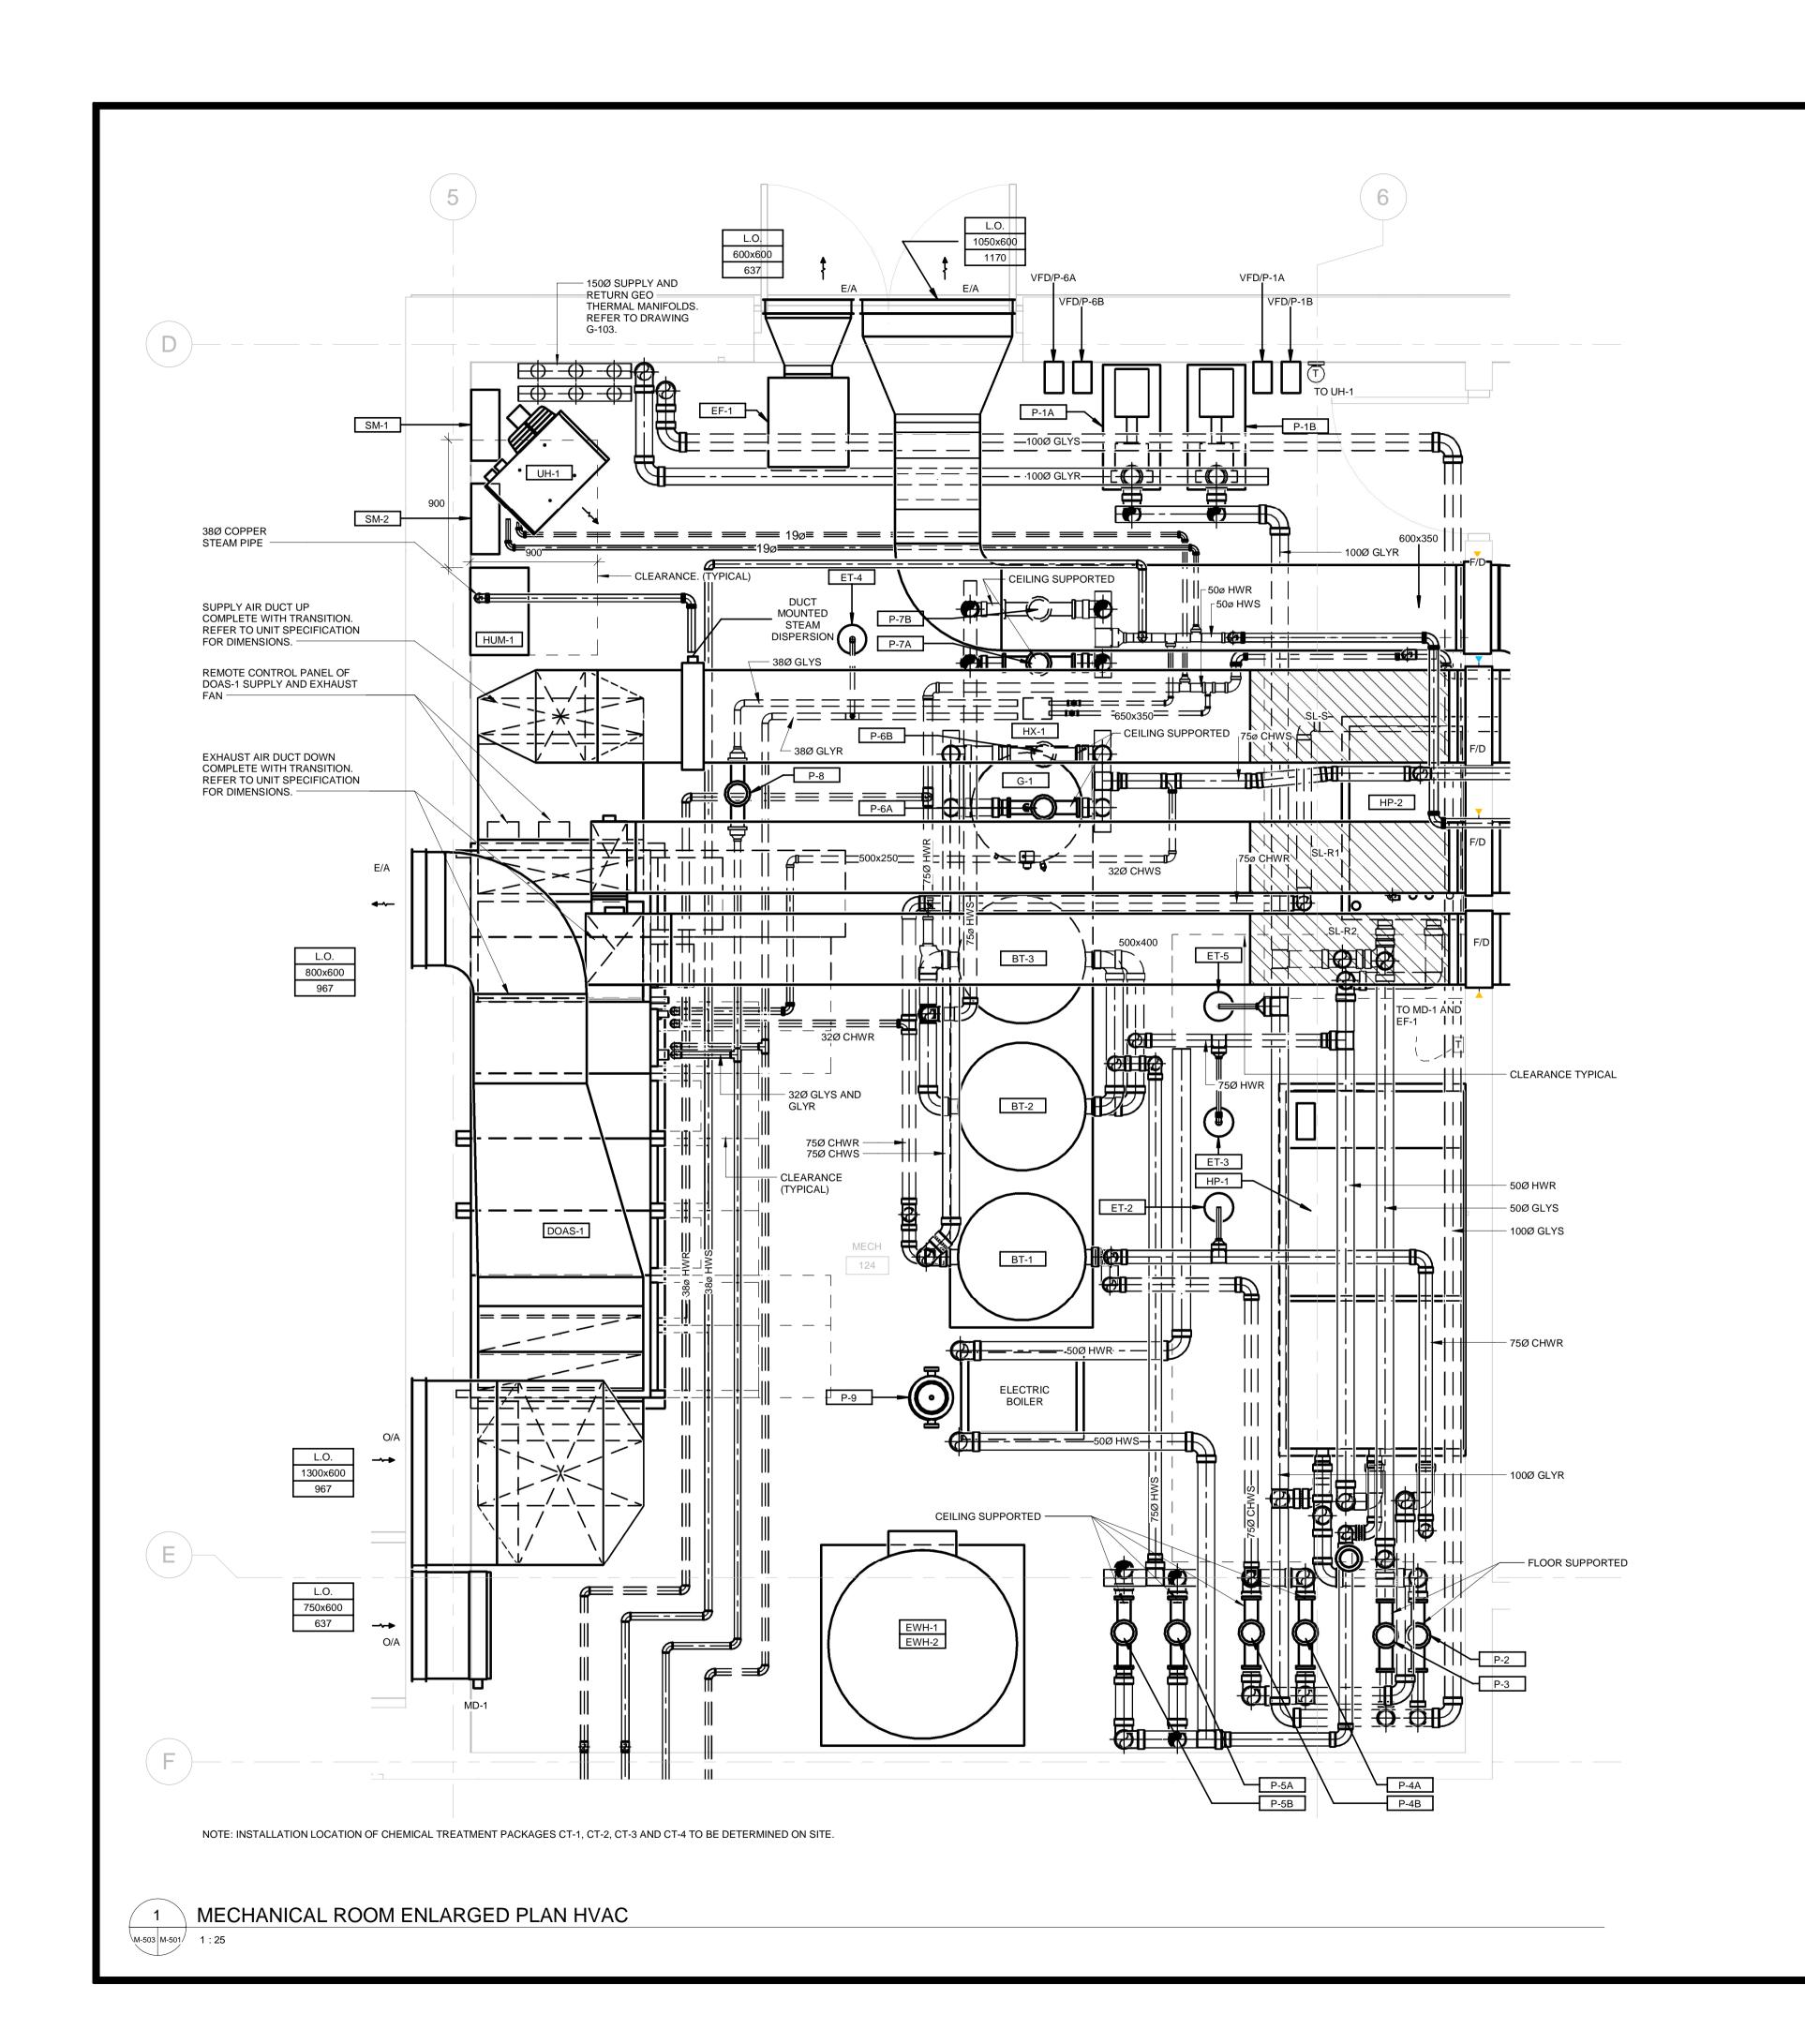
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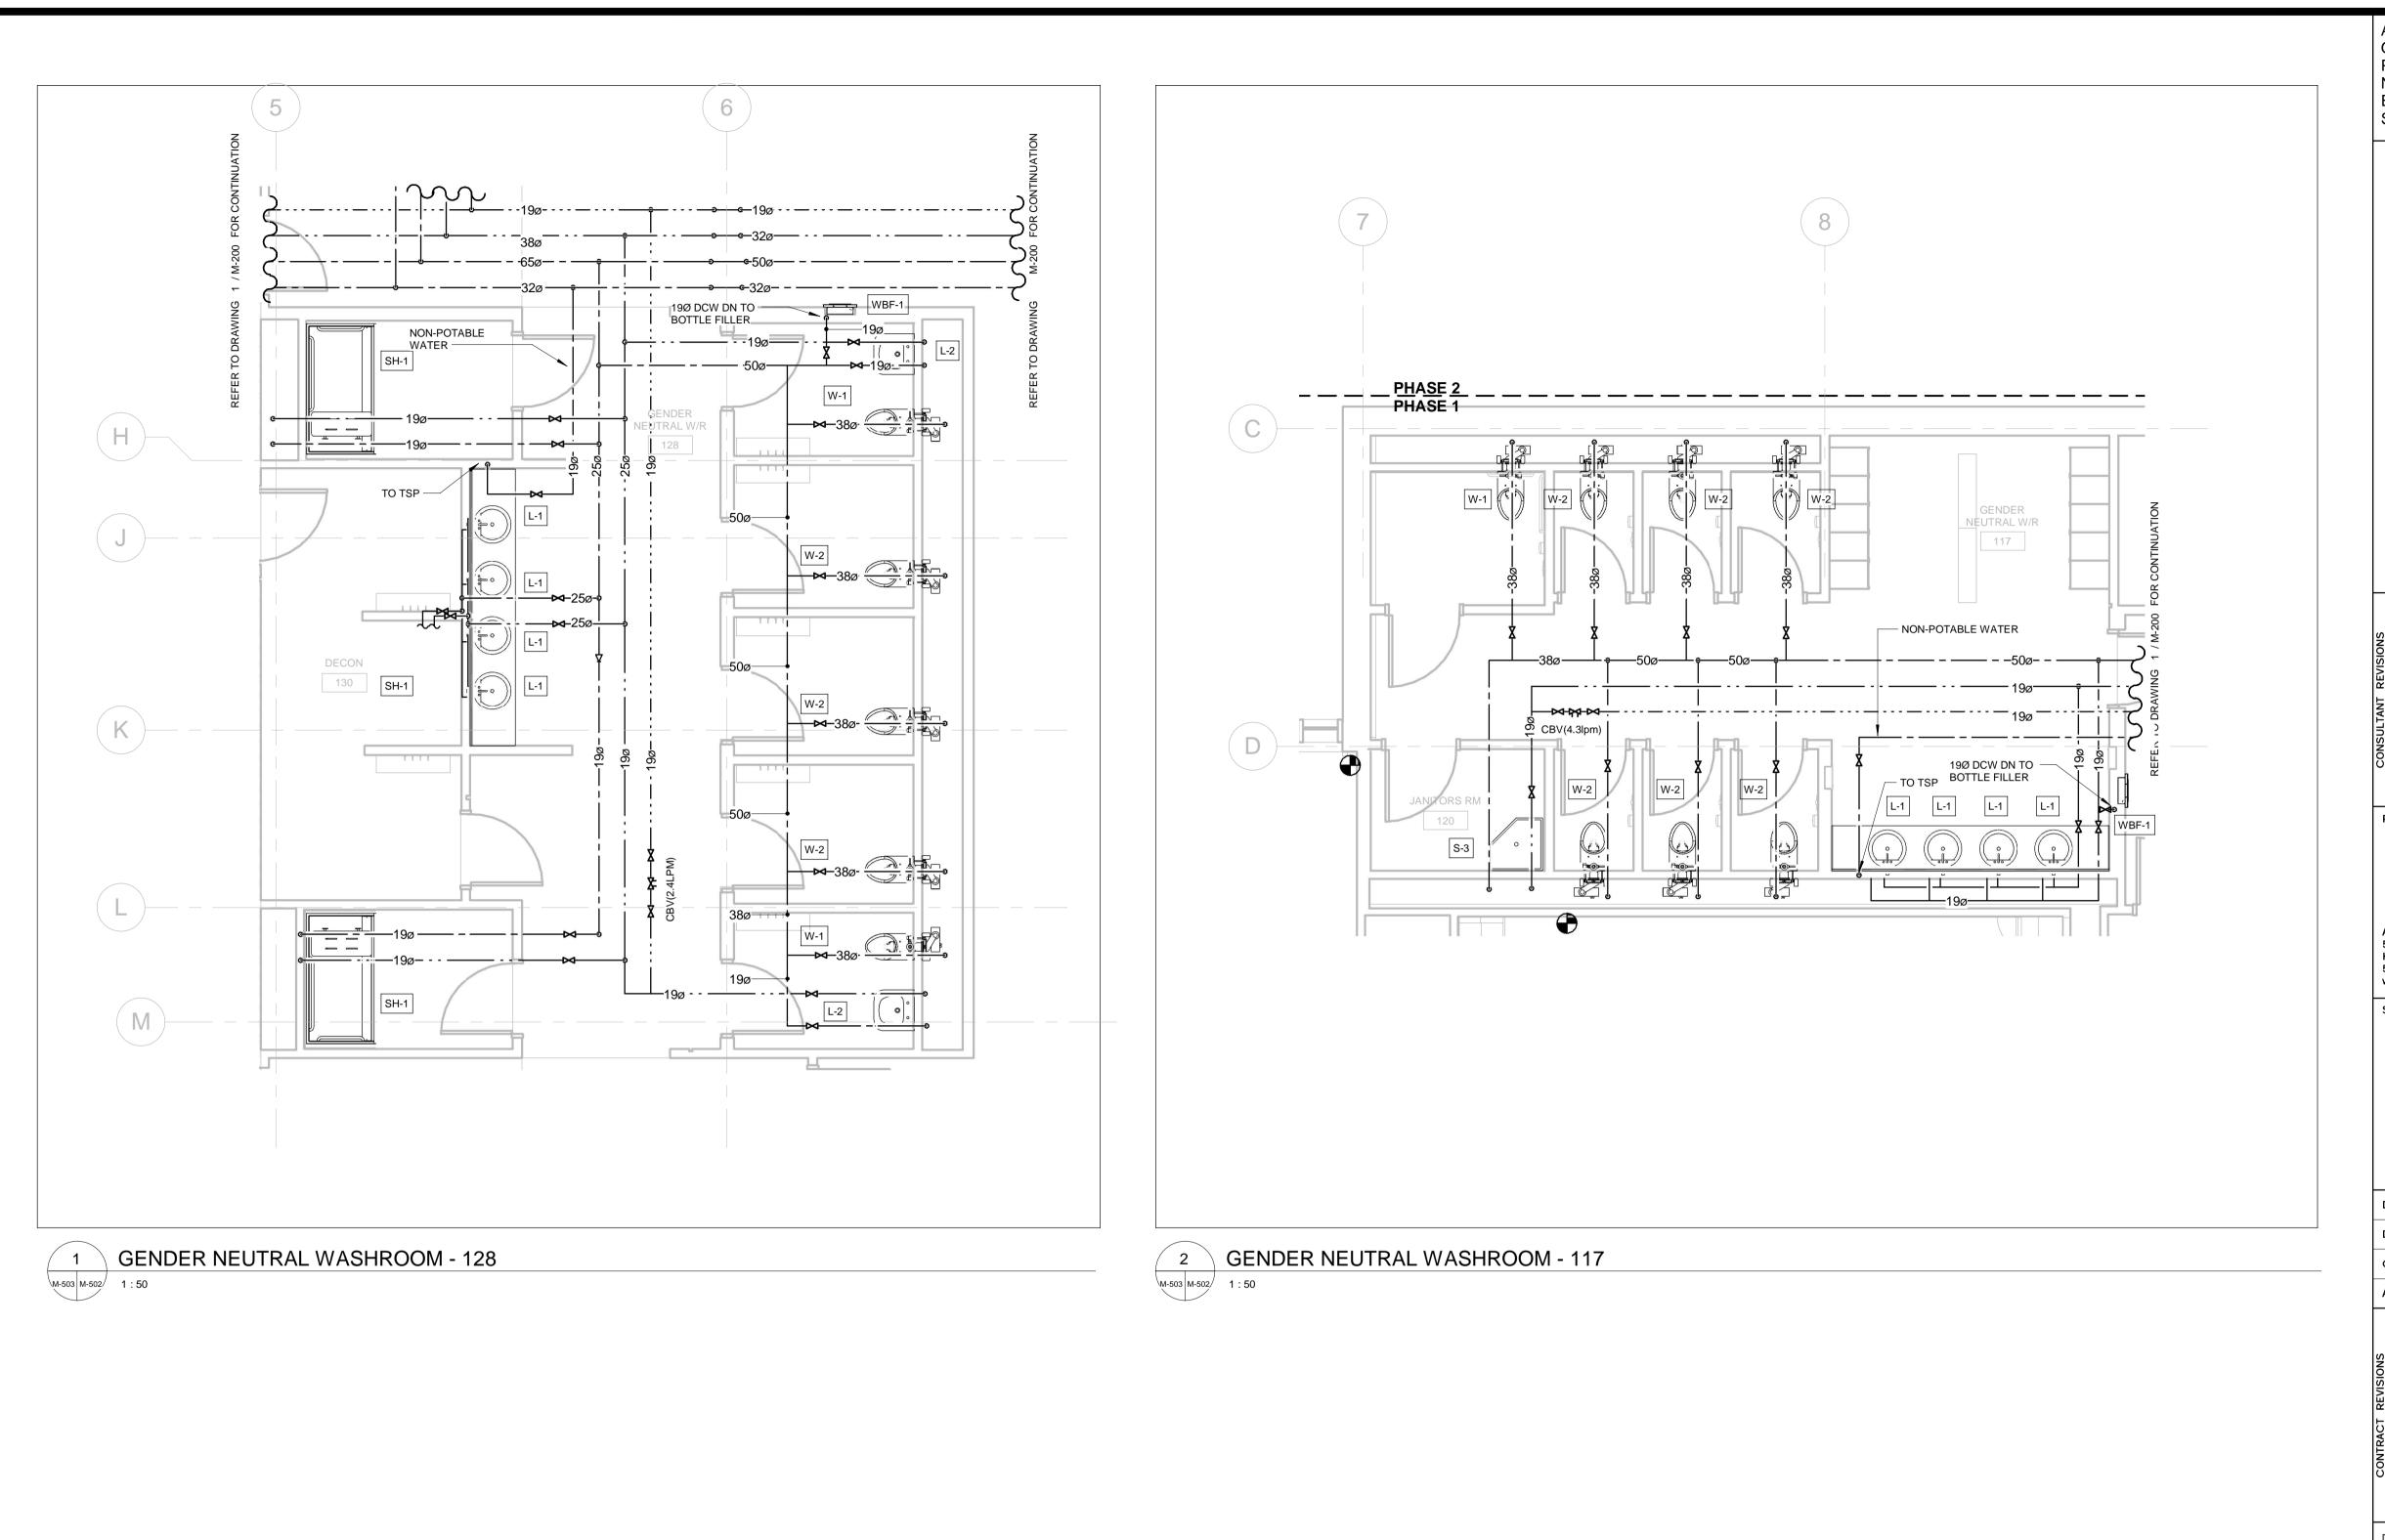
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WORKS DEPARTMENT

DESIGN, CONSTRUCTION & ASSET MANAGEMENT

# NEW SEATON PARAMEDIC STATION AND TRAINING FACILITY IN PICKERING MECHANICAL ROOM ENLARGED PLAN- 2

PROPERTY NO.	FACILITIES CODE	FACILITIES PROJECT NO. P061-18-01		
CONTRACT NO.	DRAWING NO.	SHEET NO.		
T- 1160- 2021	M- 501			



1890 Fifth Concession Rd





0 09/22/21

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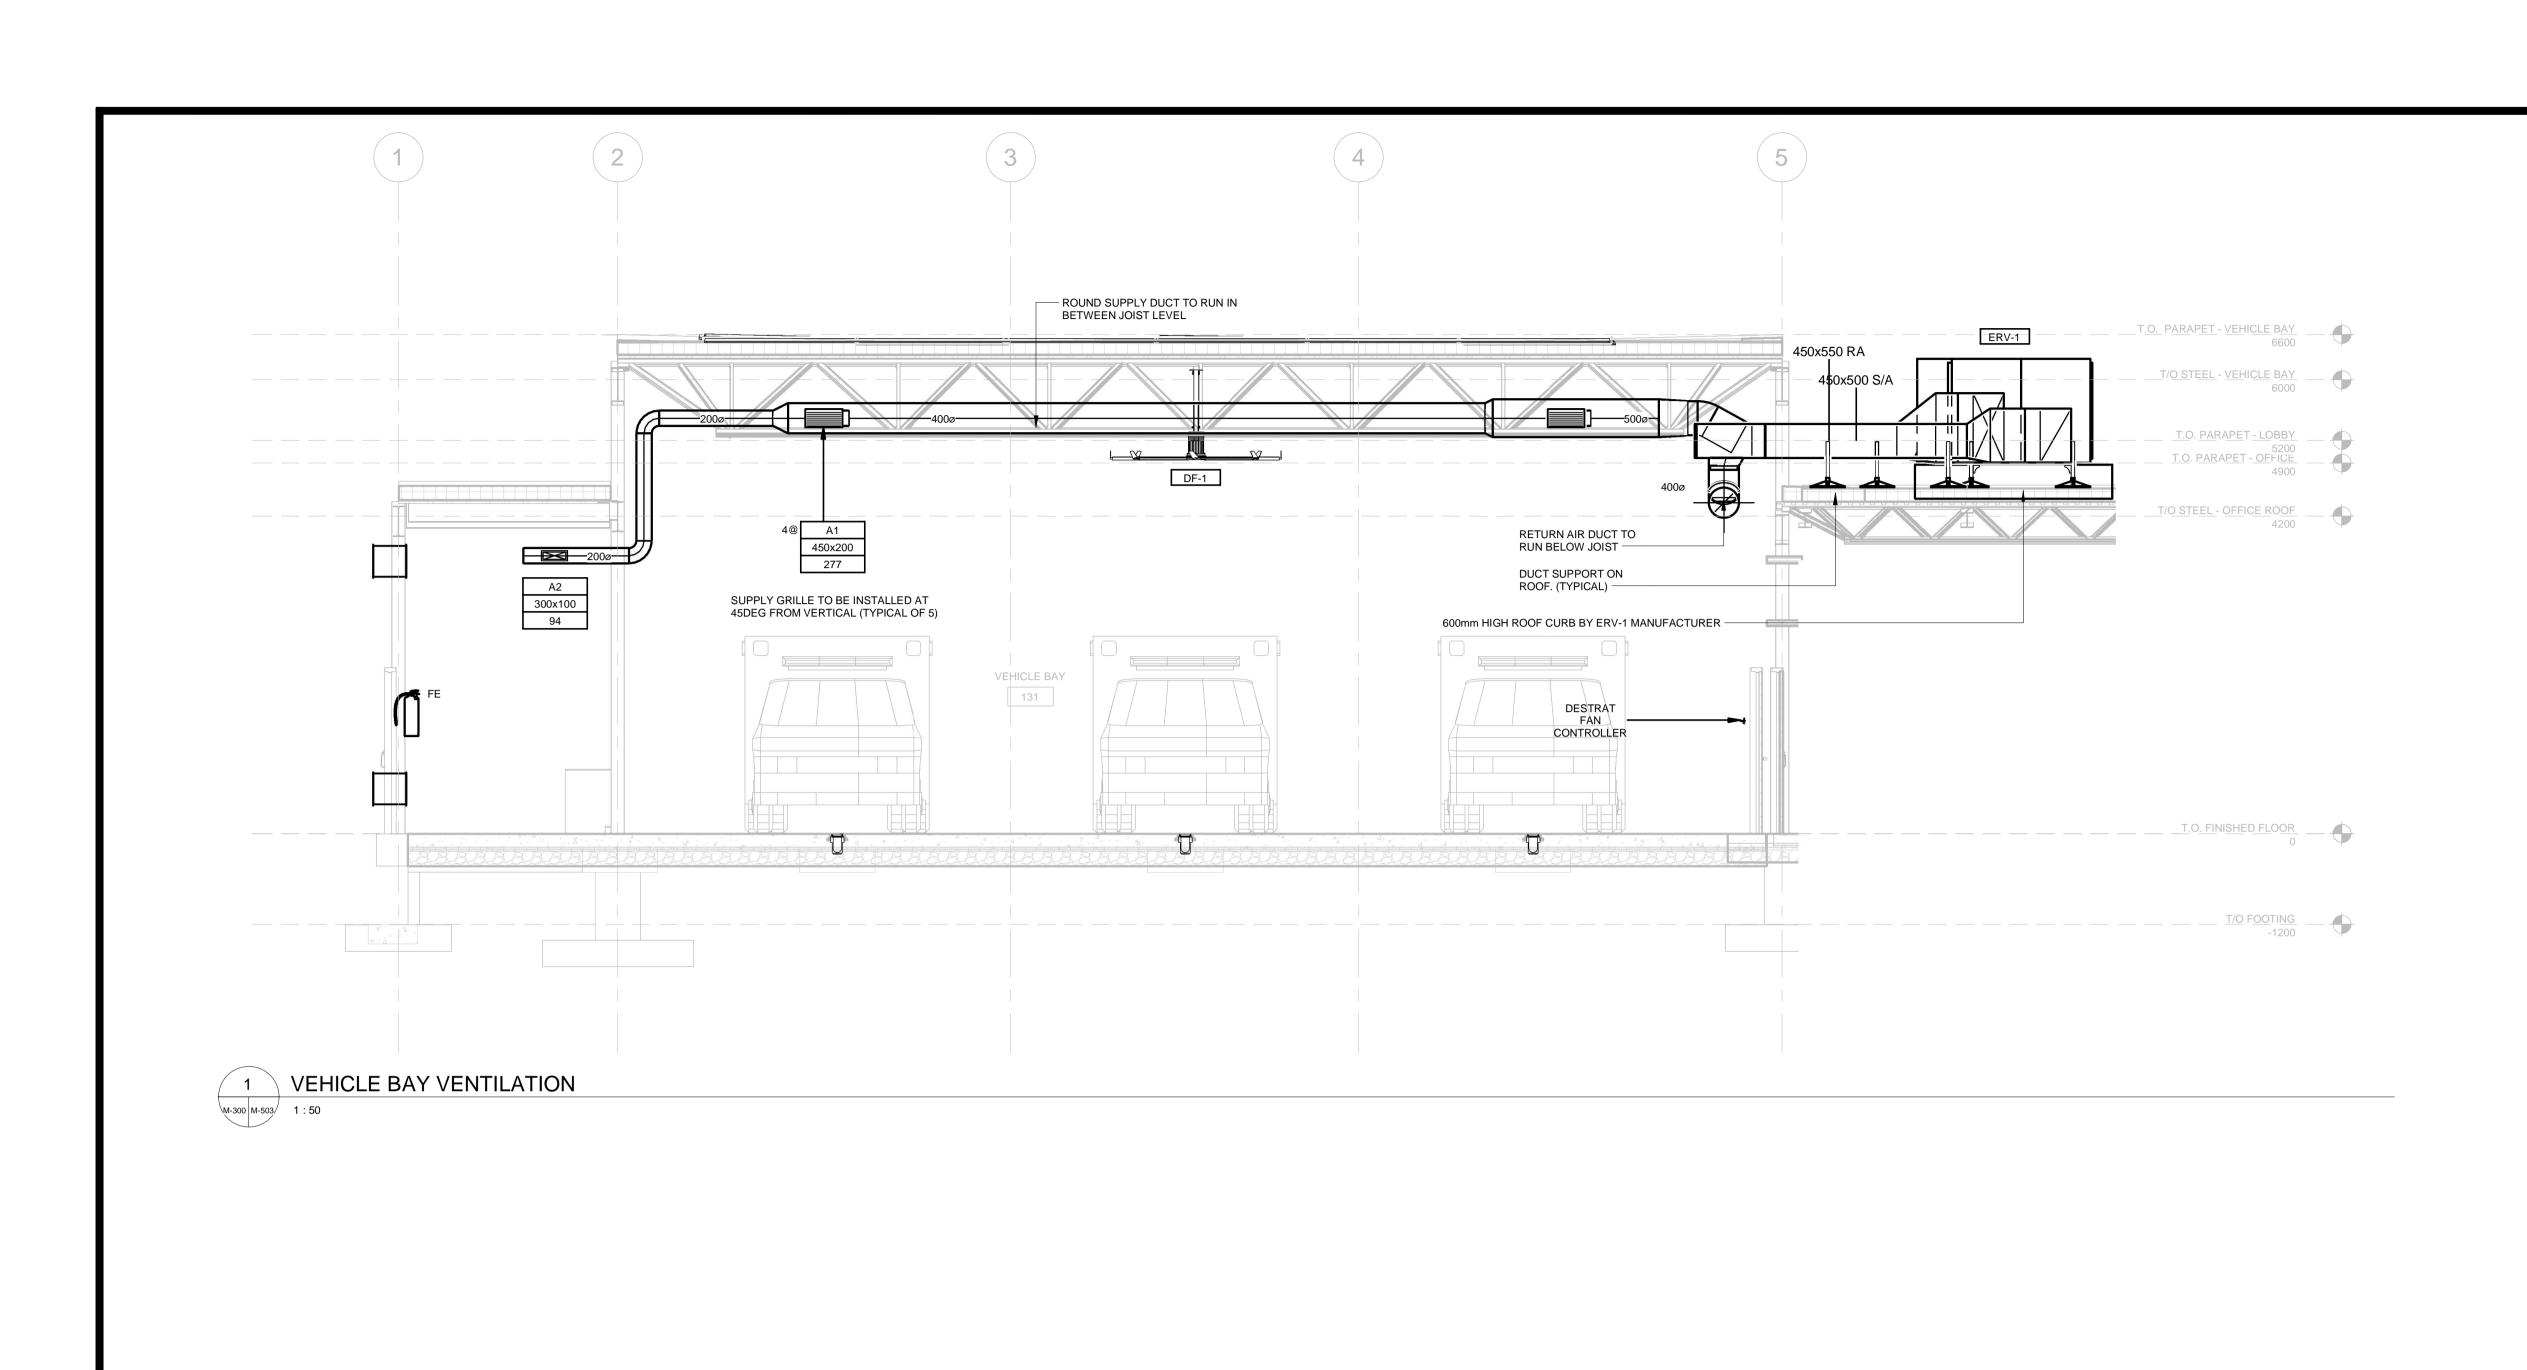
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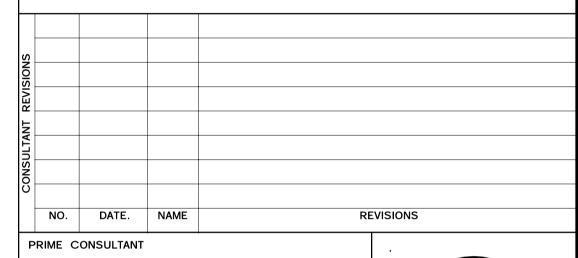
## NEW SEATON PARAMEDIC STATION AND TRAINING FACILITY IN PICKERING WASHROOM ENLARGED PLAN

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PROPERTY NO.	FACILITIES CODE	FACILITIES PROJECT NO. PO61-18-01
CONTRACT NO.	DRAWING NO.	SHEET NO.
T- 1160- 2021	M- 502	



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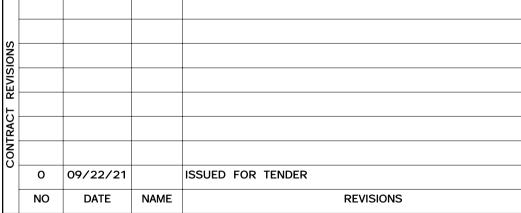


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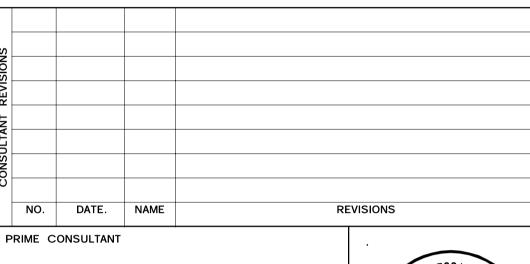
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OF DURHAM

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CONTRACT NO. T- 1160- 2021	DRAWING NO. M- 503	SHEET NO.

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DRAWN BY: Author DATE: 11/27/20

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APPROVED BY: Approver

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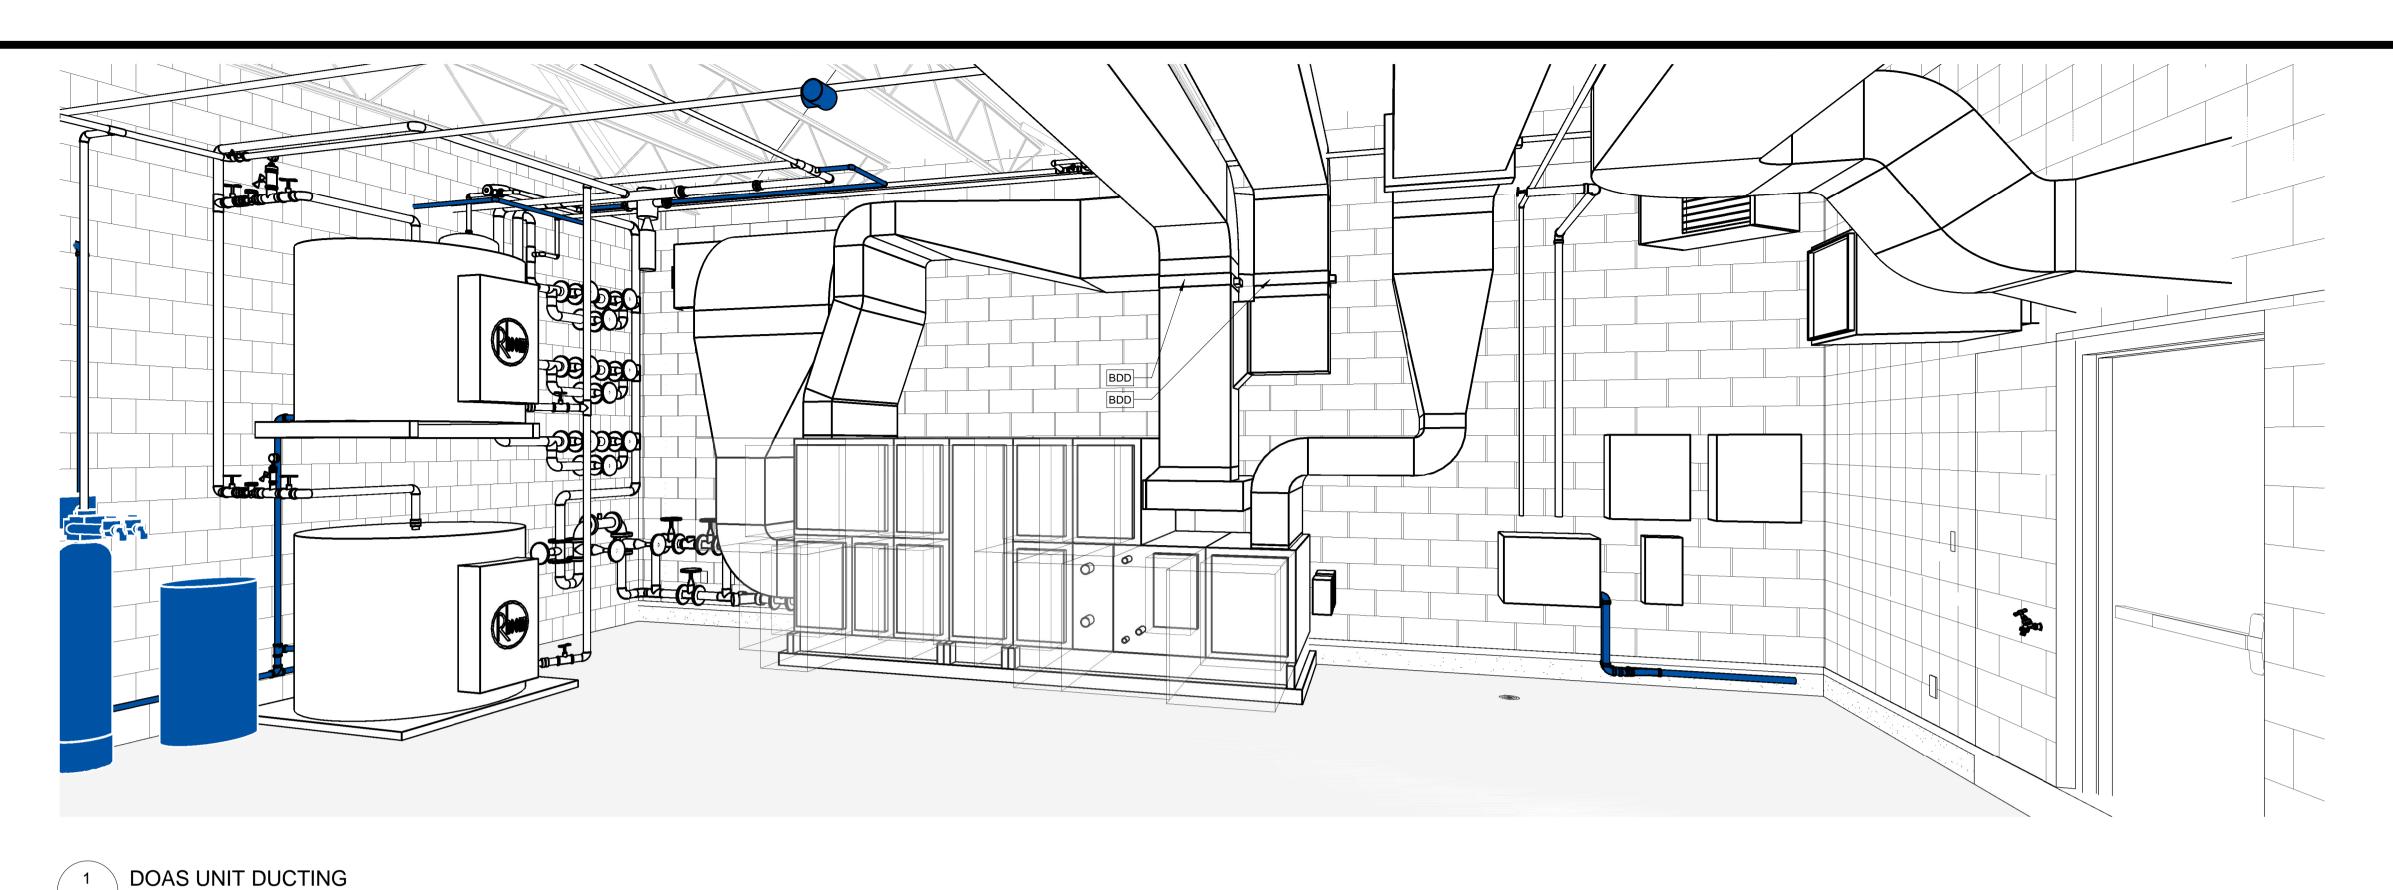


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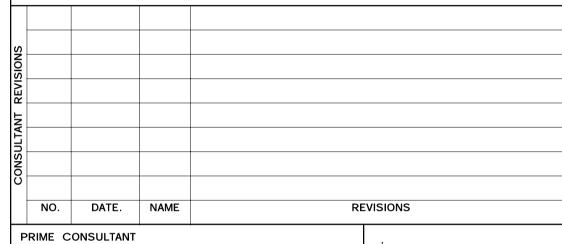
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DESIGN, CONSTRUCTION & ASSET MANAGEMENT

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CONTRACT NO. T- 1160- 2021	DRAWING NO. M-504	SHEET NO.	AIM 360-//B



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DRAWN BY: Author DATE: 12/19/20

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REVISIONS





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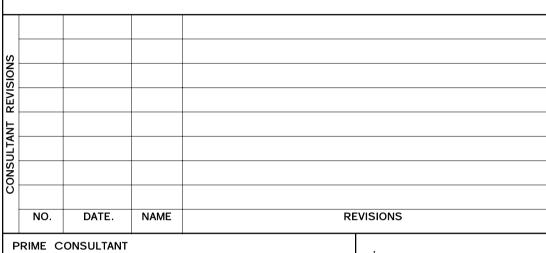
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PROPERTY NO.	FACILITIES CODE	FACILITIES PROJECT NO. P061-18-01
CONTRACT NO.	DRAWING NO.	SHEET NO.
T- 1160- 2021	M- 505	





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HYDRONIC SCHEMATIC

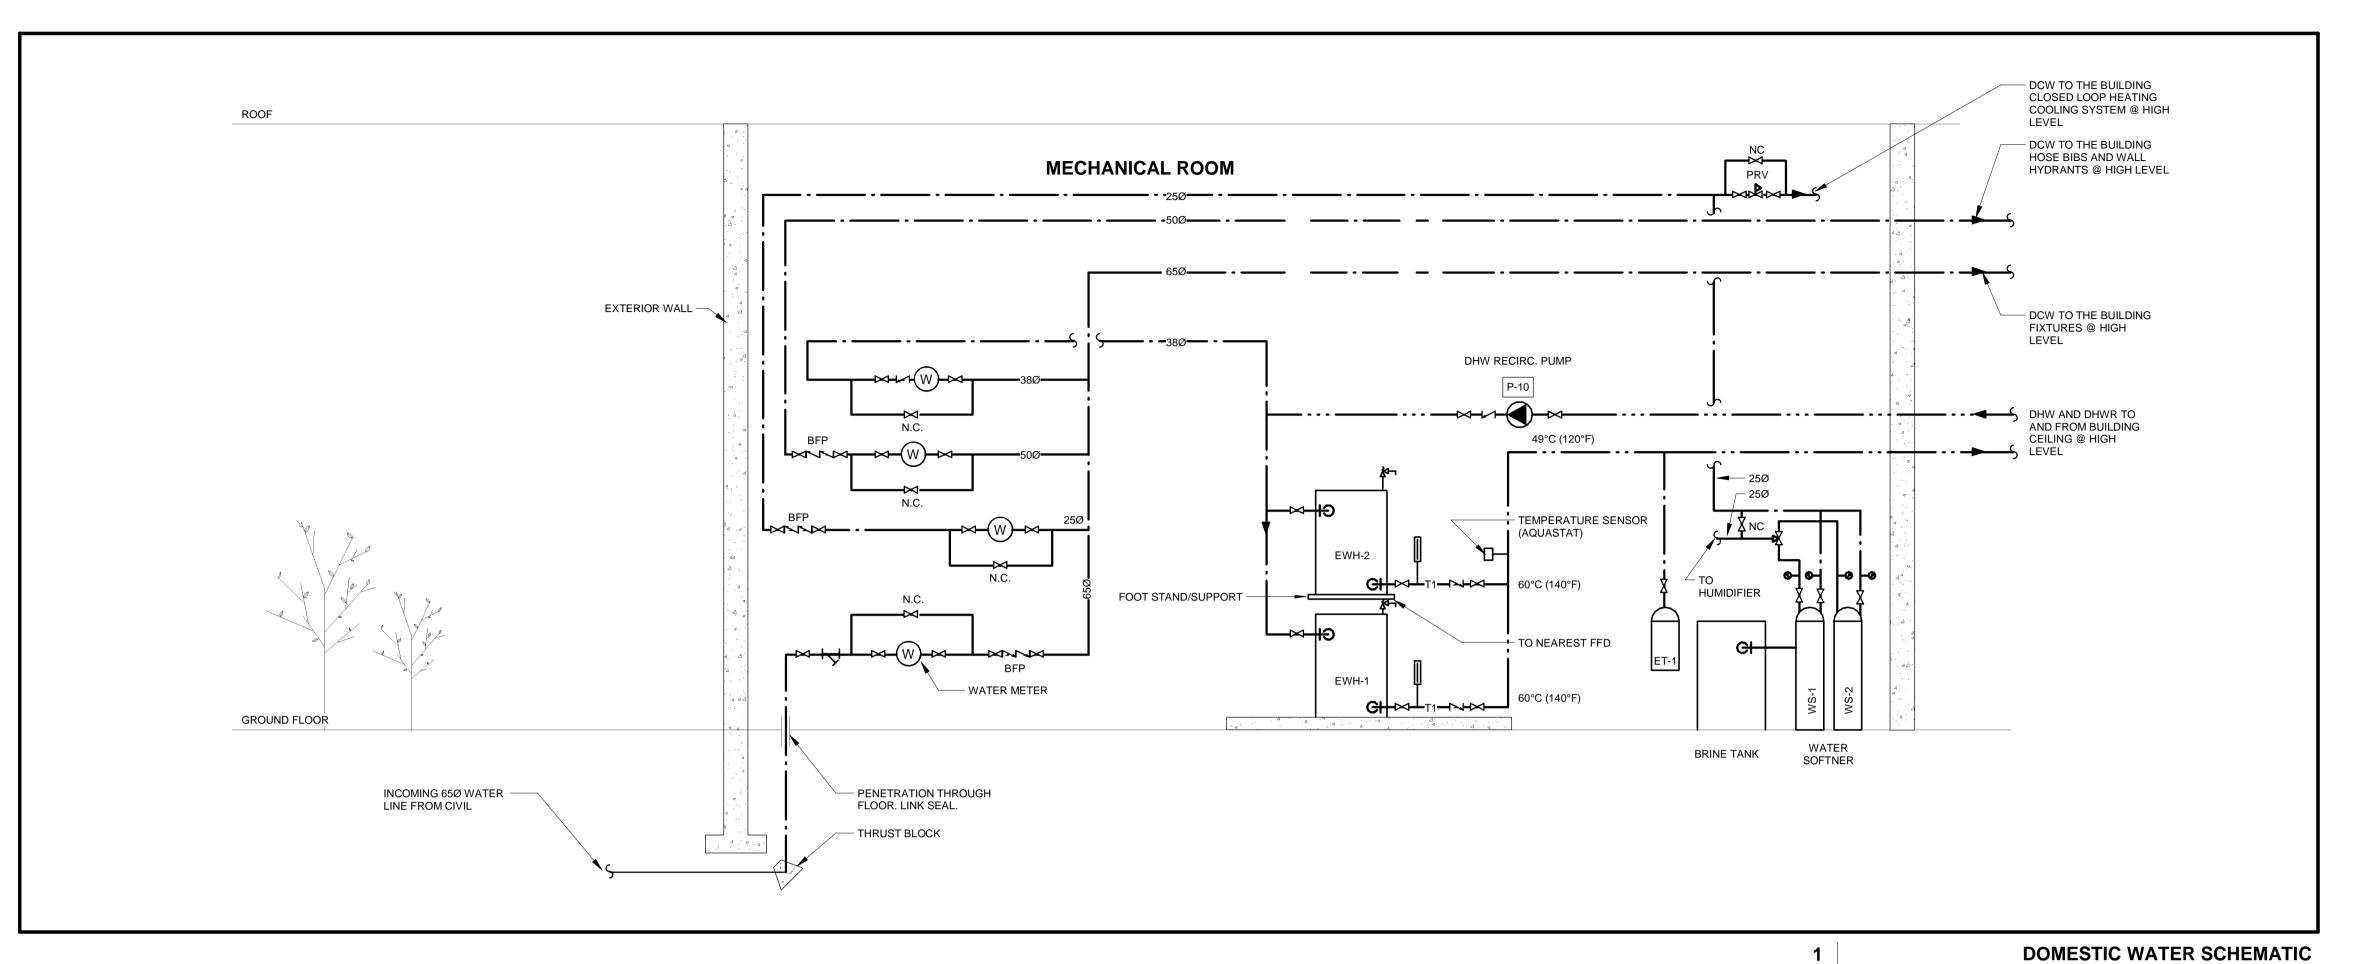Scale: N.T.S.
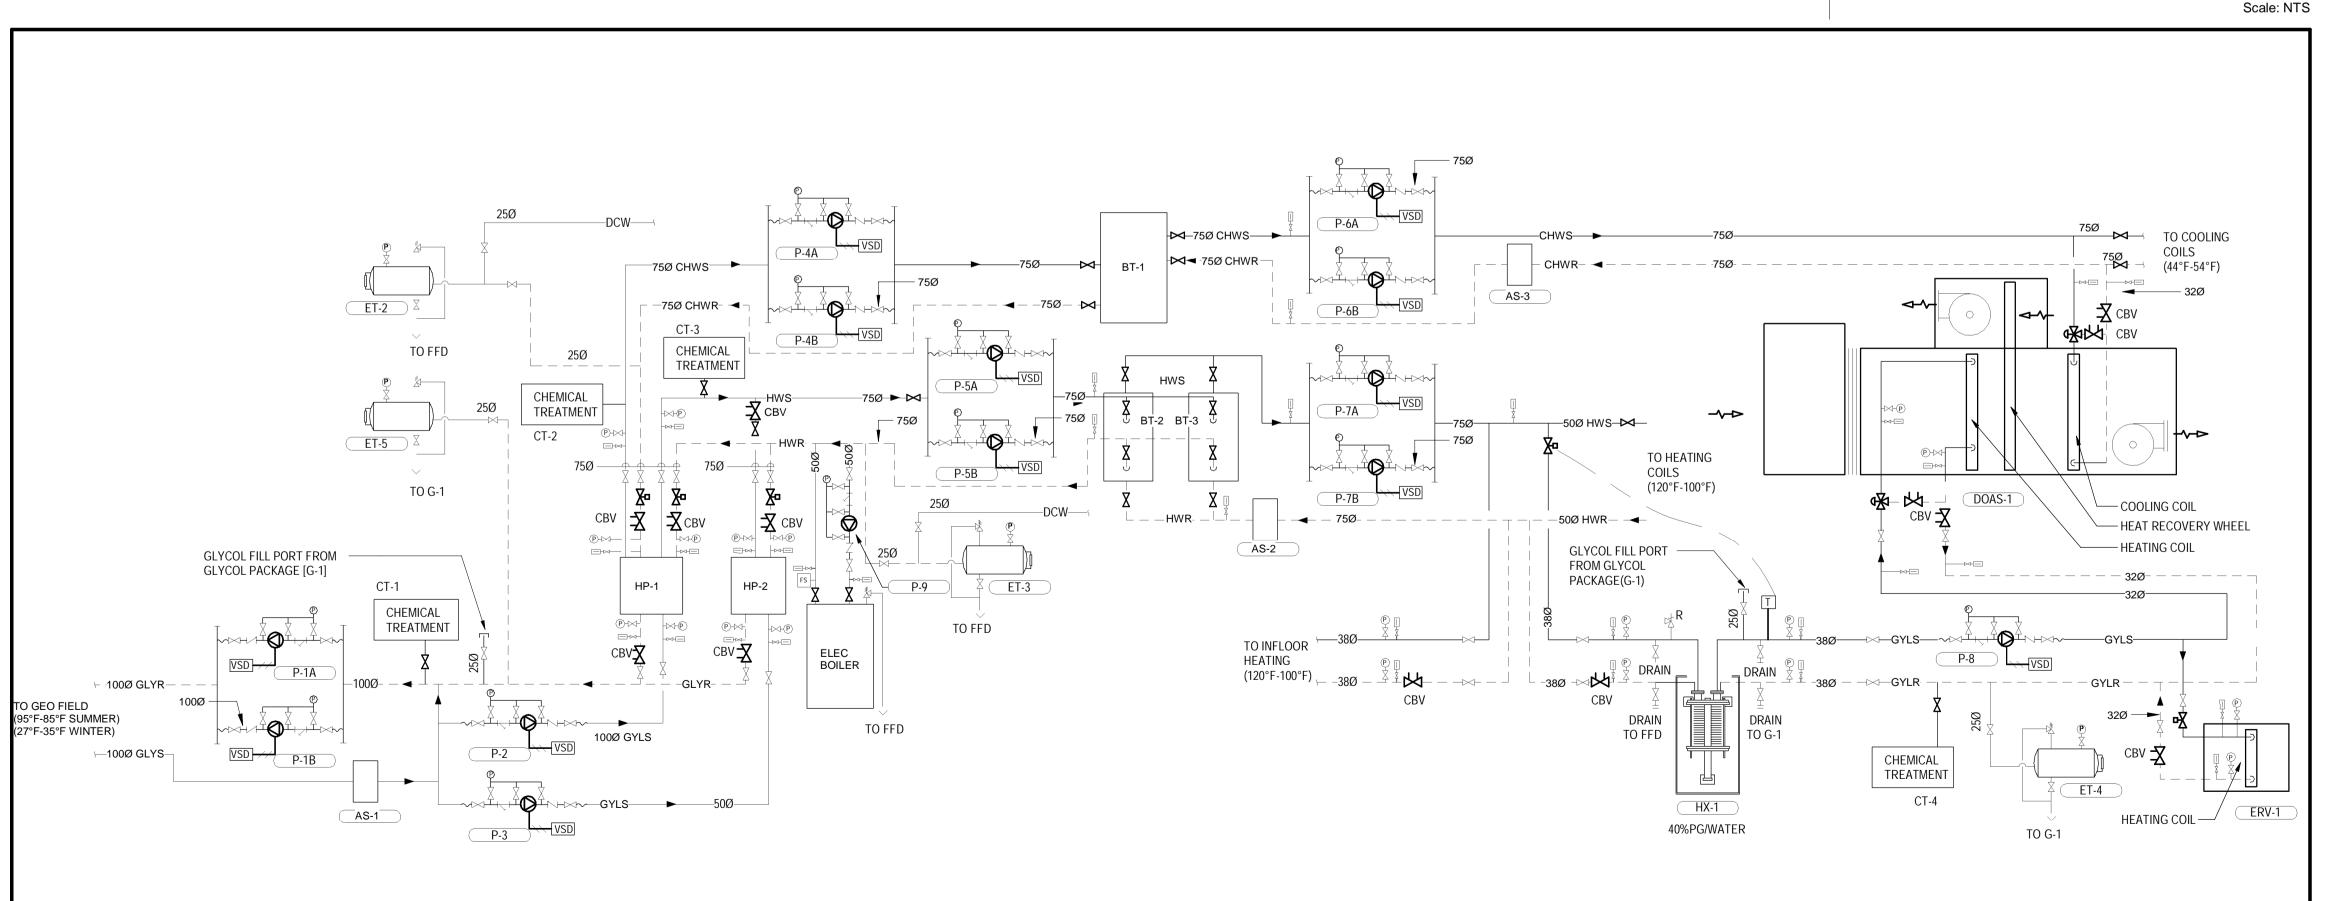
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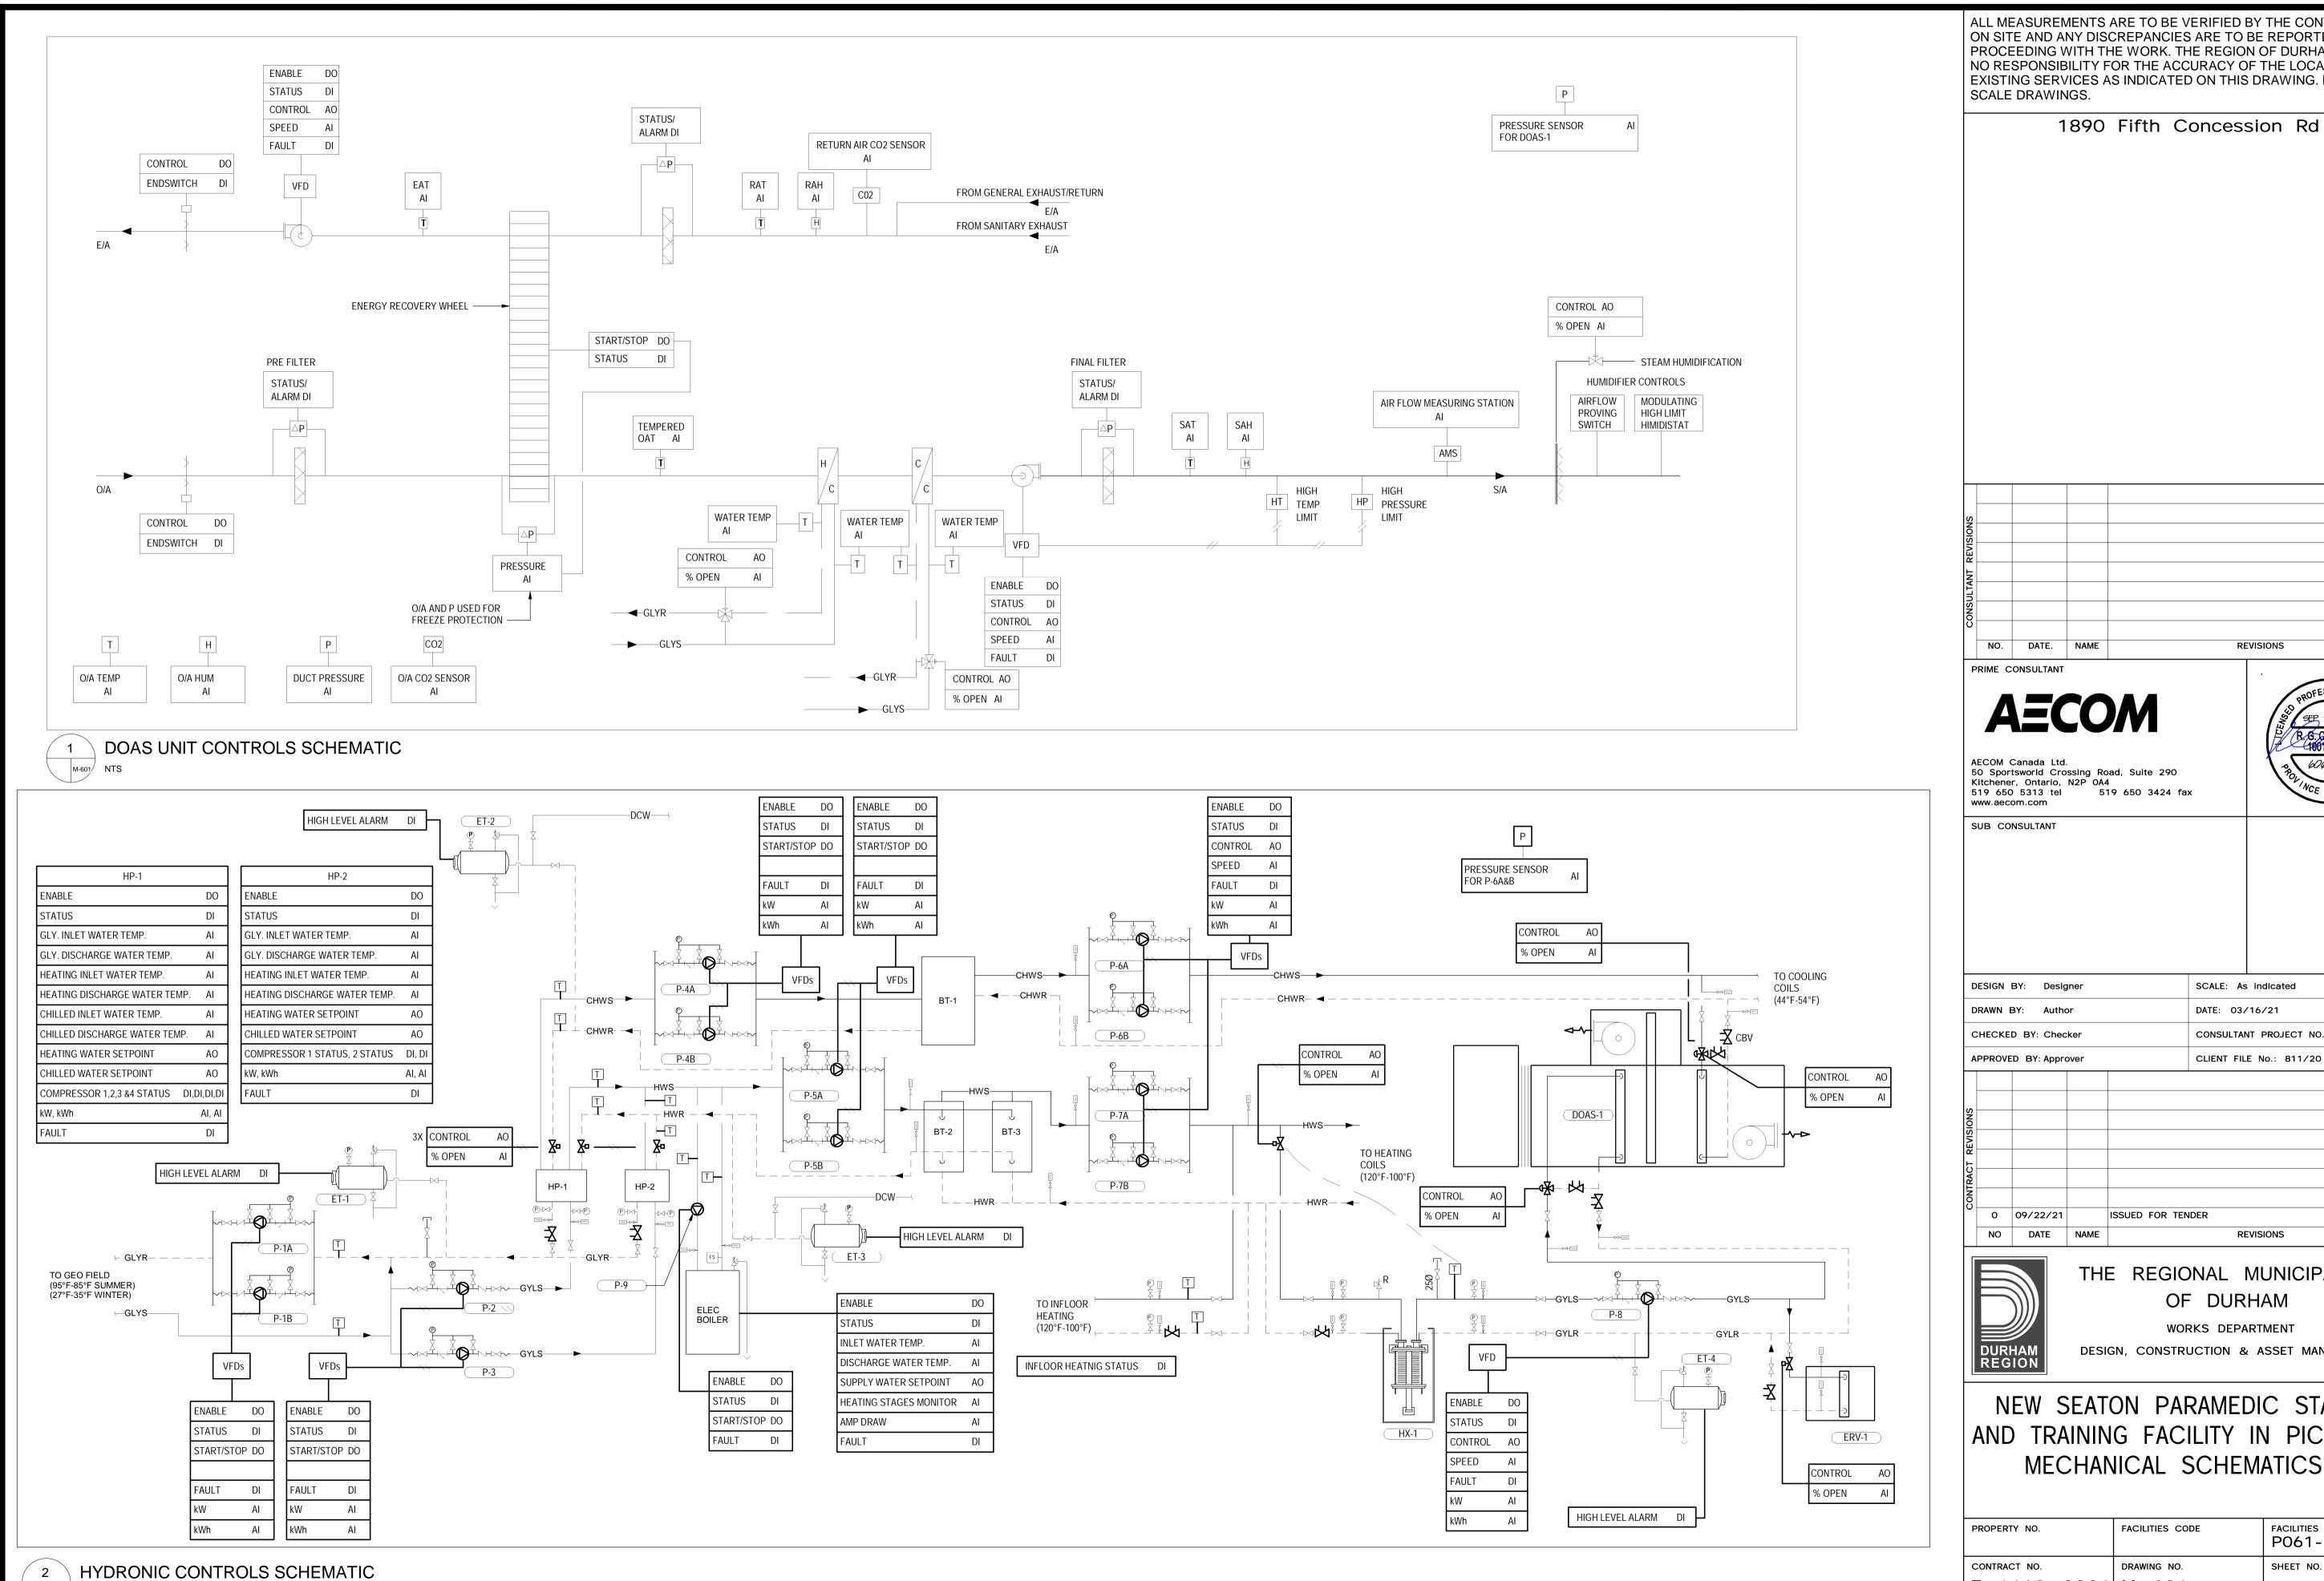
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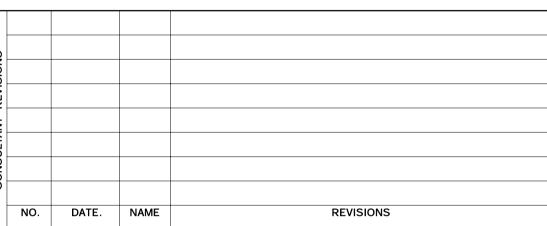
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NEW SEATON PARAMEDIC STATION

### AND TRAINING FACILITY IN PICKERING MECHANICAL SCHEMATICS

PROPERTY NO.	FACILITIES CODE	FACILITIES PROJECT NO. PO61-18-01
CONTRACT NO.	DRAWING NO.	SHEET NO.
T- 1160- 2021	M- 600	







DATE: 03/16/21 CONSULTANT PROJECT NO. 60611569


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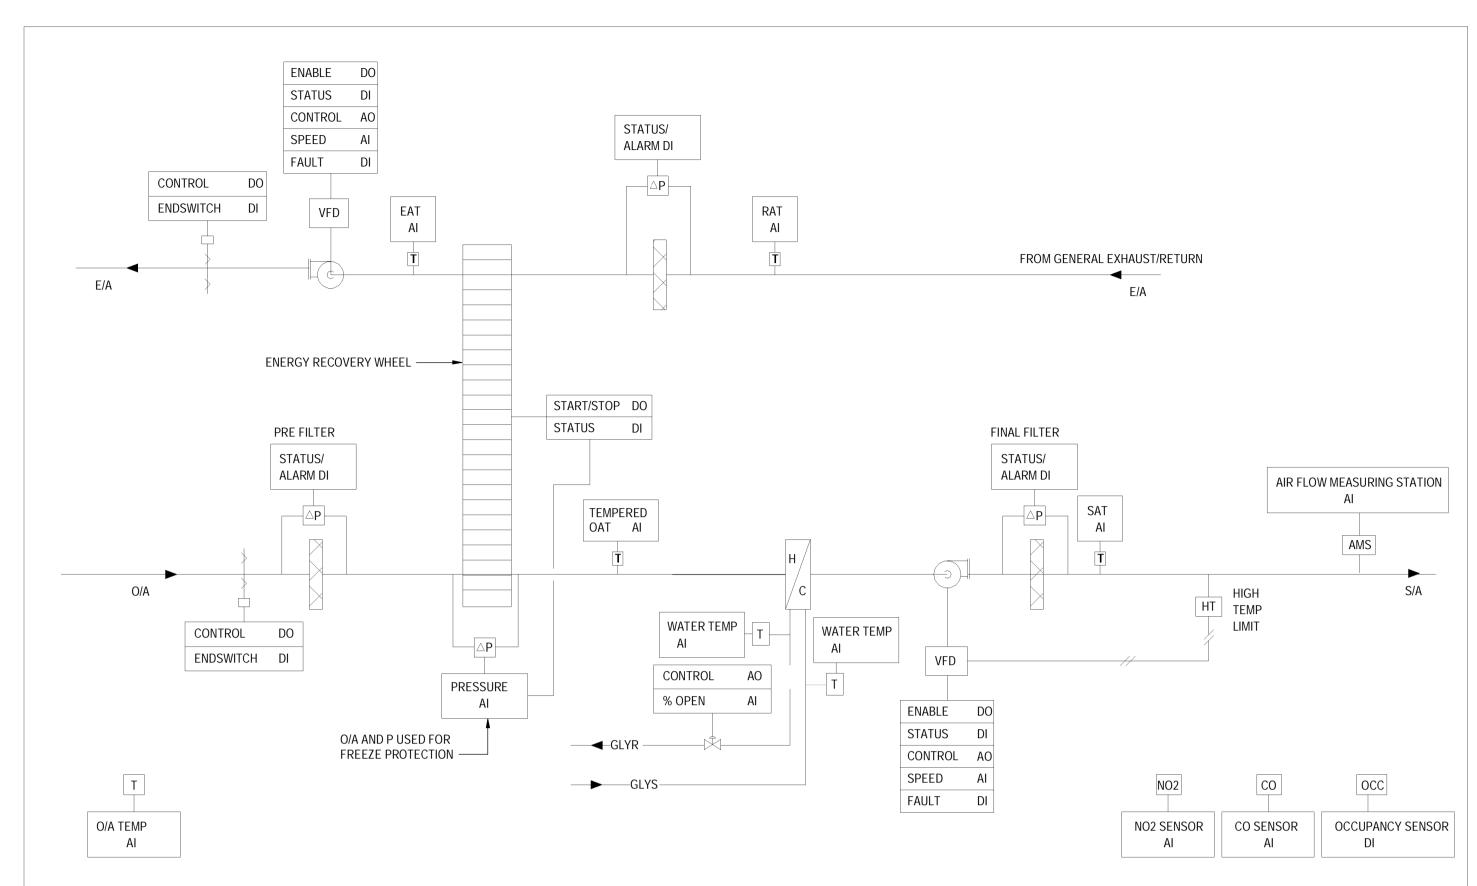
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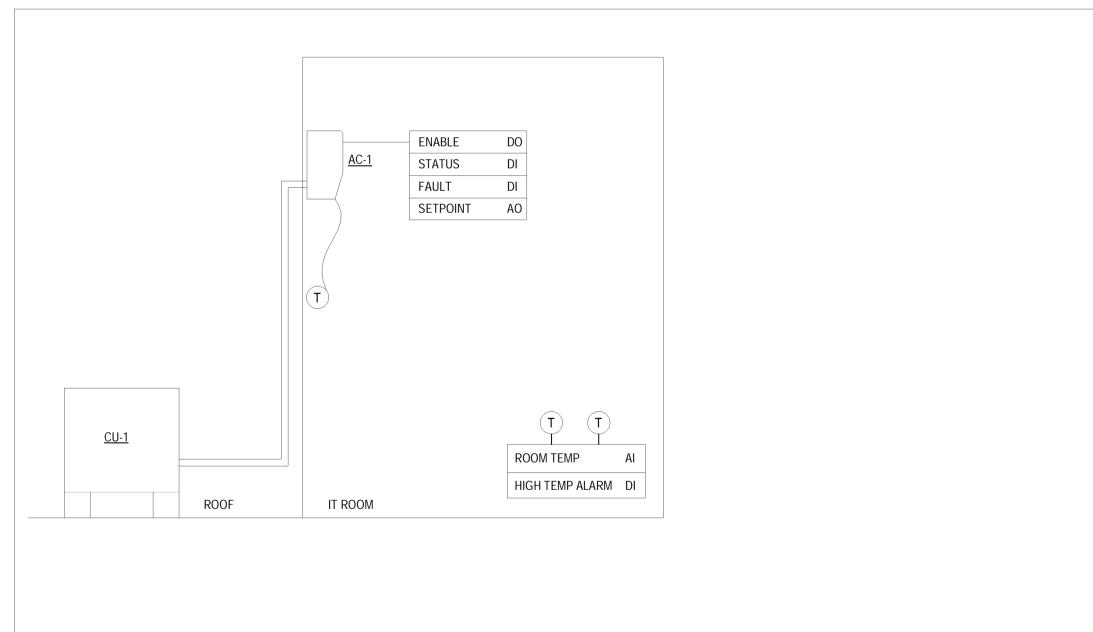
NEW SEATON PARAMEDIC STATION AND TRAINING FACILITY IN PICKERING MECHANICAL SCHEMATICS II

FACILITIES PROJECT NO. P061- 18- 01 DRAWING NO. SHEET NO. T- 1160- 2021 M- 601









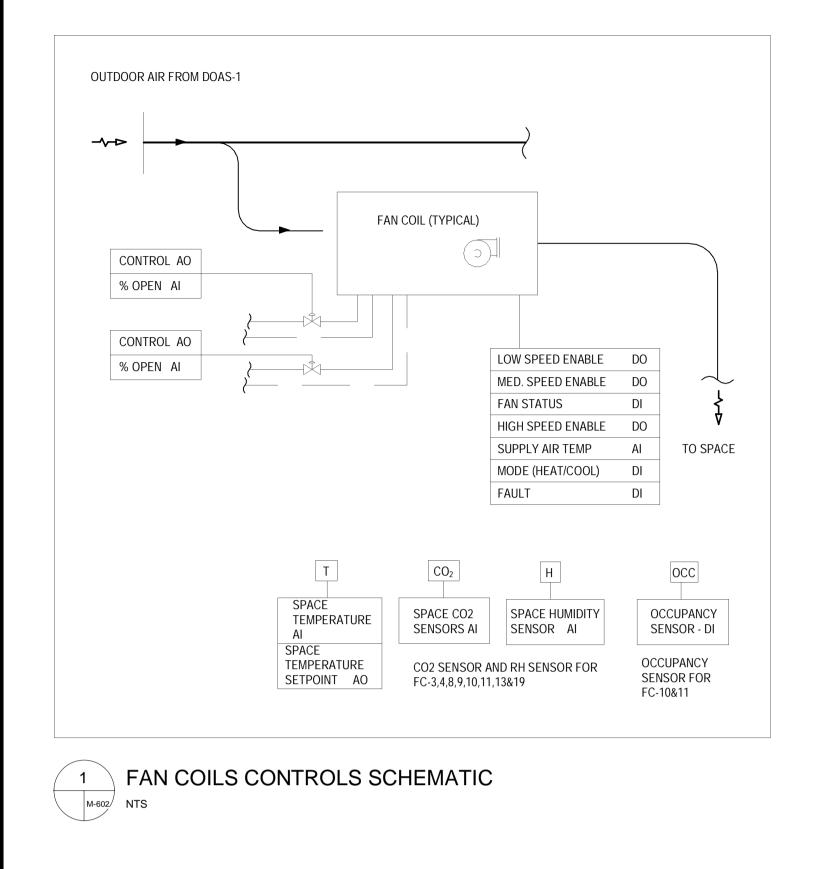



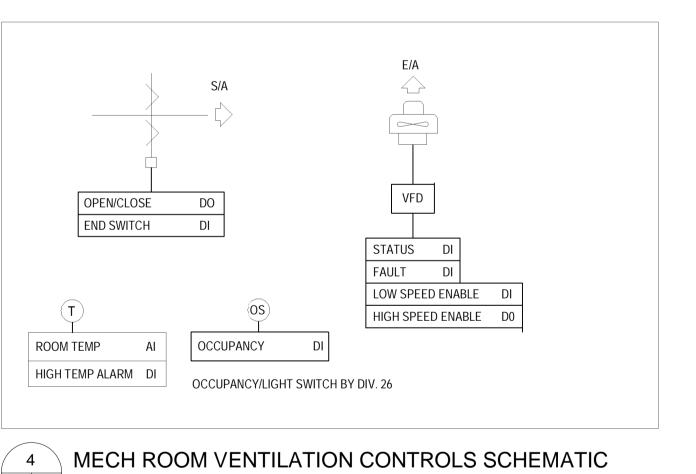

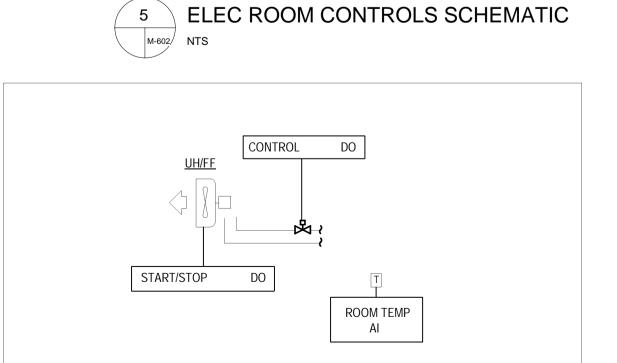

**ENABLE** STATUS

FAULT

ELEC ROOM CONTROLS SCHEMATIC

OPEN/CLOSE DO ENDSWITCH DI

BACK DRAFT DAMPER


O/A

HIGH TEMP ALARM DI

6 HYDRONIC UNIT HEATER CONTROLS SCHEMATIC
NTS

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THE REGIONAL MUNICIPALITY OF DURHAM

WORKS DEPARTMENT DESIGN, CONSTRUCTION & ASSET MANAGEMENT

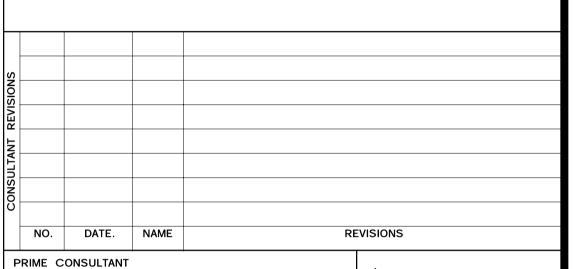NEW SEATON PARAMEDIC STATION AND TRAINING FACILITY IN PICKERING

MECHANICAL SCHEMATICS III

PROPERTY NO.	FACILITIES CODE	FACILITIES PROJECT NO. P061-18-01
CONTRACT NO.	DRAWING NO.	SHEET NO.
T- 1160- 2021	M- 602	

Seaton Paramedics

							V	ATE	R SOI	FTENER	SCHE	DUL	E					
						Flow	Rate			Brir Tank		101	-:-b4		Electrical			
TAG	LOCATION	LOCATION MANUFACTUR	MANUFACTURER	MODEL	Mini	mum	Max Co	ntinuous	Back	wash	Dx	Н	VVE	eight	Input	Output	Output	REMARKS
				LPM	GPM	LPM	GPM	LPM	GPM	(mm x mm)	(in x in)	Kg	LBS	V/Ph/Hz	V/Ph/Hz	Current		
VS-1 & 2	MECHANICAL ROOM [124]	EXCALIBUR	EWS SD 130	3.4	0.9	18.9	5	10.2	2.7	450 x 840	18 x 33	82	180	120/1/60	12 VAC	500 mA	-Refer to specifications section -C/W Controls.	

				DUEC	ED TANKS				
		BUFFER TANKS  # OF SHIP WT.							
TAG	LOCATION	MANUFACTURER	SYSTEM	MODEL	VOLUME	# OF PORTS	Kg	LBS	REMARKS
BT-1	MECH ROOM	AMTROL	CHILLED	HWBT300-4/4-125	300 GAL	4	342	753	
BT-2	MECH ROOM	AMTROL	HEATING	HWBT300-4/4-125	300 GAL	4	342	753	
ВТ-3	MECH ROOM	AMTROL	HEATING	HWBT300-4/4-125	300 GAL	4	342	753	

							DO	OMESTIC	WATER HEATE	R SCHEDULE					
					CA	PACITY	REC	OVERY			EFFICIENCY	OPER	R. WT.	ELEC.	
TAG	LOCATION	MANUFACTURER	MODEL	TYPE	L	USG	LPH	GPH	NO. OF ELEMENTS	WATTAGE PER ELEMENT	PERCENT	Kg	LBS	V/Ph/Hz	REMARKS
EWH-1 EWH-2	MECHANICAL ROOM [124]		E50 (A) -18-G	TANK-HIGH EFFICIENCY	189	50	83	313	6	3000	98.0	145	320	208/3/60	-Refer to specifications -C/W Controls.

					AIR SEPERATO	OR .			
TAG	LOCATION	MANUFACTURER	SYSTEM	MODEL	RATED	MAX	SHIF	WT.	REMARKS
IAG	LOCATION	WANDFACTURER	STOTEM	MODEL	FLOW	PRESS. DROP	Kg	LBS	TEND THE
AS-1	MECH ROOM	AMTROL	GEO	4-AS	130 GPM	3 FTHD	32	70	
									INSTALL WITH REQUIRED
AS-2	MECH ROOM	AMTROL	HEATING	3-AS	100 GPM	0.7 FTHD	27	60	MAINTENANCE CLEARANCE
AS-2	MECH ROOM	AMTROL	CHILLED	3-AS	100 GPM	0.7 FTHD	27	60	

					S	SPLIT AIR CON	DITIONING	SYSTEM S	CHEDULI	E	
							INDOOR U	NIT			
UNIT No.	LOCATION / AREA SERVED	ARRANGEMENT	MANUFACTURER	MODEL	SEER	RATED COOLING CAPACITY kW (MBH)	REFRIGERANT	OPERATING WEIGHT Kg (Lbs)	POWER SUPPLY V / PH / Hz	MCA	REMARKS
AC-1	IT ROOM [125]	WALL MOUNTED	MITSUBISHI	PKA-A24KA7	21.4	7 (24)	R410a	21 (46)	FROM CU-1	1	PROVIDE POWER AND CONTROL INTERLOCKS WITH REMOTE CONDENSER, COMPLETE WITH PROGRAMMABLE WIRED REMOTE CONTROLLER.
							OUTDOOR	UNIT			
UNIT No.	LOCATION	ARRANGEMENT	MANUFACTURER	MODEL	SEER	RATED COOLING CAPACITY kW (MBH)	REFRIGERANT	OPERATING WEIGHT Kg (Lbs)	POWER SUPPLY V / PH / Hz	MCA / MOCP	REMARKS
CU-1	EXTERIOR	OUTDOOR ROOF MOUNTED	мітѕивіѕні	PUY-A24NHA7	21.4	7 (24)	R410a	69 (153)	208 / 1 / 60	19 / 26	INTERLOCK WITH ASSOCIATED INDOOR UNIT. COMPLETE WITH VARIABLE SPEED INVERTER COMPRESSOR, WEATHERPROOF FACTORY DISCONNECT SWITCH, 600MM (24") HIGH STAND AND FRONT, REAR AND SIDE WIND BAFFLES FOR COOLING OPERATION TO -40°C (-40°F).

																					AIR HA	NDLIN	IG UNIT	SCHED	DULE																								
									4	-		SUPPL	LY FAN										- 44			EXHAL	IST FAN				-				No.				_	COOLIN	G PERFORM	MANCE			4 6				
TAG	LOCATION	MANUFACTURER / MODEL		NG WEIGHT	MAX. AIR	VOLUME	MIN. AIR	VOLUME	ES	SP	TSP				мот		FAN	ELECT	RICAL	MAX. AIR	OLUME N	IIN. AIR V	OLUME	ESP		TSP			landari de la	MOTOR	FAN	ELECTRICAL	SE	NSIBLE	TO	DTAL -	E	AIR S	IDE LA	AT	EWI	г	LWT	WATER S	SIDE FLOW	Pr	RESS. DRC	OP	Selector
17.0	200/111011	IMATOL NO TORLETT MODEL	KG	LBS	LPS	CFM	LPS	CFM	Pa	INS.W.C.	Pa IN	IS.W.C.	FAN TYPE		PEED RPM	CONTROL	SPEED -	MCA	POWER FEED	LPS	CFM	LPS	CFM	Pa INS.W	V.C. Pa	a INS.\		AN TYPE	BHP	SPEED S	RPM I	MCA POWER	kW	МВН	kW	мвн	CDB / CWB	FDB / FWB	CDB / CWB	FDB / FWB	С	F	С	F	LPS (	SPM N	A F	T FLU	JID
DOAS-1	MECHANICAL ROOM [124]	DAIKIN / CAH006GDCM	1107	2440	967	2050	283	600	253	1.1	873		ENTRIFUGAL PLENUM			NTEGRATED DRIVE	2665	10.6	208/3/60	967	2050	283	600 1	172 0.8	3 482	2 2.		ITRIFUGAL PLENUM	1.00	2600	2190	5.5 208/3/6	14.8	50.5	18.2	62	26.4 18.6	79.5 65.5	13.9 13.1	57 55.6	6.7	44.0	12.3	54.1	0.8	12.2 0.	5 1.	.8 WAT	TER
ERV-1	ROOF	DAIKIN / OAH008GHGM	2042 WITH CURB	4500 WITI CURB	1203	2550	602	1275	115	0.5	666	2.9 CE	ENTRIFUGAL PLENUM	1.90 1	1750	VFD	2075	4.3	575/3/60	1321	2800	661	1400 1	161 0.7	7 574	4 2.	5 CEN	ITRIFUGAL PLENUM	1.60	1750	1990	2.9 575/3/6	-	2	121	18	(2)	-	2	(4)	-	a a	127		(2)			8 9	i .

															AIR HANDL	ING UNIT SC	HEDULE (PA	ART 2)																	
												NERGY RECOVERY			1		1		T		FEEECTIV	ENESS			AID	SIDE		HEATING	PERFORMANO		ID CIDE				=
TAG	RECOVERY WHEEL	TYPE	ELEC	TRICAL	WINTER CA	PACITY	SUMMER	CAPACITY	RETURN AIR T HEAT EXCHANG	EMP. BEFORE GER IN WINTER	EXHAUST AIR HEAT EXCHAN			TEMP. BEFORE		TEMP. BEFORE IGER IN SUMMER		R TEMP. AFTER GER IN SUMMER		TEMP. BEFORE GER IN SUMMER	SENSIBLE		CAPACITY		EAT	LA	T	EWT	r	LWT	IID SIDE FLC	.OW	PRESS. DR	OP FI	LIID
	MANUFACTURER. MODEL	1172	HP	POWER FEED	kW	МВН	kW	МВН	С	F	С	F	С	F	С	F	С	F	С	F	%	%	kW ME	н с	F	С	F	С	F C	F	LPS	GPM	М	FT	
DOAS-1	AIROTOR SXA-1200-MW	ALUMINUM	0.13 VFD	208/3/60	50.1	171.0	21.7	74.0	21.1	70	-13.2	8.2	-21.7	-7.0	23.9	75	32.2	90	32.2	90.0	77.2	77.8	27.2 93	0	32.0	22.9	73.2	47.8	118.0 36.	.7 98.0	0.6	10	0.58 1	.90 40 PR	)% .OP.
ERV-1	AIROTOR SXA-1200-MW	ALUMINUM	0.13 VFD	208/3/60	61.5	210.0	26.1	89.0	20.0	68	-11.1	12	-21.7	-7.0	26.7	80	32.8	91	32.2	90.0	76.4	75.8	32.5 111	0 -1.1	30.0	21.0	69.7	47.8	118.0 36.	.7 98.0	0.8	12.0	1.49 4	4.90 A0	)% OP.

									ECTRIC F	OII ED (	COUEDI					
								EL	ECTRIC E	SOILER	SCHEDU	ILE .				·
TAG	MANUFACTURER / MODEL	LOCATION	SERVICE		IMUM ACITY	(0.000	IMUM ACITY	ELEMENTS	FLUID TYPE	WATER F	LOW RATE	POWER	FLA	OPERATI	NG WEIGHT	REMARKS
				KW	МВН	KW	MBH	QTY.		LPS	GPM	17 / 17 / 18/10 S - 3 / 18/10 S		KG	LBS	
B-1	PRECISION BOILERS / PCW1-094B-600-160	MECHANICAL ROOM [124]	BUILDING HEATING BACKUP	94	321	24	80	4	WATER	2.0	32	600/3/60	90	355	783	COMPLETE WITH DISCONNECT SWITCH, TEMPERATURE LIMIT SWITCH WITH RESET, LOW WATER CUTOFF, HIGH/LOW PRESSURE SWITCH, FLOW SWITCH, TEMPERATURE SETPOINT, SAFETY RELIEF VALVE, TEMPERATURE AND PRESSURE GAUGE, DRAIN VALVE AND 4-STAGE CONTROL. COMMUNICATING WITH BAS.

				EXPAN	SION	TAN	K SCI	HEDU	LE		
TAG	MANUFACTURER	MODEL	SERVICE	FLUID TYPE	TANK V	OLUME	ACCEP <sup>-</sup> VOLU	CONTRACTOR CONTRACTOR OF	SHIP WEI	PING GHT	REMARKS
					L	GAL	L	GAL	KG	LBS	
ET-1	BELL AND GOSSETT	PTA-20V	POTABLE HOT WATER	WATER	30.3	8.0	20.1	5.3	15.5	34.0	-
ET-2	BELL AND GOSSETT	HFT-15	CHILLED WATER LOOP	WATER	7.6	2.0	3.8	1.0	2.3	5.0	-
ET-3	BELL AND GOSSETT	D-60	HEATING WATER LOOP	WATER	127.2	33.6	42.8	11.3	46.8	103.0	-
ET-4	BELL AND GOSSETT	D-15	HEATING GLYCOL LOOP	40% P.G.	30.3	8.0	9.1	2.4	16.8	37.0	-
ET-5	BELL AND GOSSETT	D-40	GEOFIELD GLYCOL LOOP	25% P.G.	82.1	21.7	42.8	11.3	37.3	82.0	-

													HEAT	EXCH	ANGE	R SCH	EDULE										
TAG	MANUFACTURER	MODEL	TYPE	HEAT EX	CHANGED	EV	WT	L\	VT (	OLD SID	E OW	PRESS	. DROP	FLUID	EV	WT	LV		HOT SIDE	OW	PRESS.	. DROP	FLUID	EFFECTIVE AREA	OPERATING	G WEIGHT	REMARKS
				KW	BTU/H	С	F	С	F	LPS	GPM	KPA	PSI	TYPE	С	F	С	F	LPS	GPM	KPA	PSI	TYPE	SQFT	KG	LBS	
HX-1	XYLEM	BP422-40	BRAZED PLATE	58.2	198516	36.7	98	47.6	117.6	1.39	22.0	9.2	1.33	40%PG	37.8	100	48.9	120	1.26	20.0	7.3	1.06	WATER	40.39	35.4	77.9	

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<u>Р</u>	RIME C	ONSULTANT	,	

**AECOM** 


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OF DURHAM

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DESIGN, CONSTRUCTION & ASSET MANAGEMENT


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CONTRACT NO.	DRAWING NO.	SHEET NO.
T- 1160- 2021	M- 700	

					N	OTORI	ZED DA	MPER S	CHEDU	LE		
TAG	MANUFACTURER /	LOCATION	FUNCTION	DIMENSIC	NS (WxH)	MINIMUM	AIR FLOW	MAXIMUM	AIR FLOW	MAXIMUM	VELOCITY	ACCESSORIES
800 E00	MODEL		W Seeding of the Seed	MM	INS	LPS	CFM	LPS	CFM	MPS	FPM	
MD-1	NAILOR 2010	MECHANICAL ROOM	INTAKE AIR OF EF-1	750 x 600	30 x 24	0	0	637	1,350	1.4	270	LOW LEAKAGE ALUMINUM CONTROL DAMPER WITH PARALLEL BLADES, INSULATED FRAME AND BLADES AND STAINLESS STEEL 304 LINKAGE. COMPLETE WITH 24VAC ON/OFF ACTUATOR, END SWITCH AND SPRING RETUR
MD-2	NAILOR 2010	ELECTRICAL ROOM	INTAKE AIR OF EF-2	1000 x 600	40 x 24	0	0	944	2,000	1.5	300	LOW LEAKAGE ALUMINUM CONTROL DAMPER WITH PARALLEL BLADES, INSULATED FRAME AND BLADES AND STAINLESS STEEL 304 LINKAGE. COMPLETE WITH 24VAC ON/OFF ACTUATOR, END SWITCH AND SPRING RETURN
MD-3	NAILOR 1020	ELECTRICAL ROOM	EXHAUST AIR OF WASHROOMS	400 x 150	16 x 6	0	0	175	370	2.8	555	LOW LEAKAGE GALVANIZED STEEL CONTROL DAMPER WITH OPPOSED BLADES COMPLETE WITH 24VAC MODULATING ACTUATOR AND SPRING RETURN.
MD-4	NAILOR 1020	ELECTRICAL ROOM	GENERAL RETURN OF [DOAS-1]	500 x 250	20 x 10	0	0	580	1,230	4.5	885	LOW LEAKAGE GALVANIZED STEEL CONTROL DAMPER WITH OPPOSED BLADES COMPLETE WITH 24VAC MODULATING ACTUATOR AND SPRING RETURN.
MD-5	NAILOR 1020	ELECTRICAL ROOM	EXHAUST AIR OF WASHROOMS	400 x 150	16 x 6	212	450	212	450	3.4	675	LOW LEAKAGE GALVANIZED STEEL CONTROL DAMPER WITH OPPOSED BLADES COMPLETE WITH 24VAC MODULATING ACTUATOR AND SPRING RETURN.
FS/D	NAILOR 1222-2-12x08-V-BEL-120 I-24-250-ERL-DSDNF- EXT-CL-FL12-DTS	CLASSROOMS	[DOAS-1] SUPPLY AIR TO CLASSROOMS	300 x 200	12 x 8	0	0	156	330	2.5	490	ULC LISTED ULTRA LOW LEAKAGE GALVANIZED STEEL COMBINATION FIRE/SMOKE DAMPER WITH AIRFOIL BLADES AND FACTORY SLEEVE. LABELLED FOR 1.5 HR.  COMPLETE WITH BELIMO 120VAC ACTUATOR, ERL (ELECTRIC RESETTABLE LINI HEAT RESPONSIVE DEVICE AND SPRING RETURN FAIL CLOSE.  COMPLETE WITH 120VAC FACTORY MOUNTED DUCT SMOKE DETECTOR WITH PHOTOELECTRIC SENSOR, FOR NO FLOW CONDITION.  WIRING TO FACP BY DIV. 26.
FS/D	NAILOR 1221-1-12x12-V-BEL-120 I-24-250-ERL-DSDNF- EXT-CL-FL12-DTS	CLASSROOMS	RETURN AIR FROM CLASSROOMS TO CORRIDOR	300 x 300	12 x 12	0	0	156	330	1.7	330	ULC LISTED ULTRA LOW LEAKAGE GALVANIZED STEEL COMBINATION FIRE/SMOKE DAMPER WITH AIRFOIL BLADES AND FACTORY SLEEVE. LABELLED FOR 1.5 HR.  COMPLETE WITH BELIMO 120VAC ACTUATOR, ERL (ELECTRIC RESETTABLE LINI HEAT RESPONSIVE DEVICE AND SPRING RETURN FAIL CLOSE.  COMPLETE WITH 120VAC FACTORY MOUNTED DUCT SMOKE DETECTOR WITH PHOTOELECTRIC SENSOR, FOR NO FLOW CONDITION.  WIRING TO FACP BY DIV. 26.

						IFFUSE	R, REGI	STER & C	GRILLE S	CHEDULE
TAG	KRUEGER MODEL NO.	APPLICATION		IZE I x WIDTH	NEC	K SIZE		FLOW 1 / MAXIMUM	MAXIMUM	REMARKS
,,,,,,,,,,,,,,,,,,,,,,,,,,,,,,,,,,,,,,,	SOMEONIC DE COME ANTE DE L'ANTIGORIE		MM	INS	MM	INS	LPS	CFM	NC RANGE	
A1	DMD-18-08-XX-01-44	DRUMLOUVRE	450	18	450	18	203	430	244	DUCT MOUNTED DRUM LOUVRE WITH ADJUSTABLE HEAVY GAUGE ALUMINUM VANES, HEAVY GAUGE ALUMINUM
AI	[XX = VARIES]	DROWLOOVRE	200	8	200	8	342	725	30	DRUM AND WHITE FINISH. COMPLETE WITH DAMPER EXTRACTOR.
A2	DMD-12-04-XX-01-44	DRUMLOUVRE	300	12	300	12	78	165	170	DUCT MOUNTED DRUM LOUVRE WITH ADJUSTABLE HEAVY GAUGE ALUMINUM VANES, HEAVY GAUGE ALUMINUM
AZ	[XX = VARIES]	DROWLOOVRE	100	4	100	4	130	275	30	DRUM AND WHITE FINISH. COMPLETE WITH DAMPER EXTRACTOR.
40	1900-36-2-50-C-E-00-44 &	LINEAR SLOT	900	36	200	8	28	60	141	ALUMINUM LINEAR SLOT SUPPLY DIFFUSER WITH 2 SLOTS AND 25MM SLOT WIDTH. CONCEALED SURFACE MOUN
A3	1900BOOT-36-2-50-8-C-E-00-G-01	DIFFUSER	100	4	OVAL	OVAL	66	140	26	BOTH END CAPS AND A WHITE FINISH.  COMPLETE WITH GALVANIZED STEEL PLENUM BOOT AND PERFORMANCE BAFFLE.
	1900-48-2-50-C-E-00-44 &	LINEAR SLOT	1200	48	250	10	38	80	17	ALUMINUM LINEAR SLOT SUPPLY DIFFUSER WITH 2 SLOTS AND 25MM SLOT WIDTH. CONCEALED SURFACE MOUN
A4	1900BOOT-48-2-50-10-C-E-00-G-01	DIFFUSER	100	4	OVAL	OVAL	99	210	29	BOTH END CAPS AND A WHITE FINISH.  COMPLETE WITH GALVANIZED STEEL PLENUM BOOT AND PERFORMANCE BAFFLE.
217			600	24	0.000	n to a manage	24	50	120	ALUMINUM CORE EGG-CRATE RETURN GRILLE WITH 12MMx12MMx12MM (1/2"x1/2"x1/2") CORE STYLE, LAY-IN T-BAR
B1	EG5-24x06-F23-NONE-00-00-00-44	RETURN AIR GRILLE	150	6	GRILL	LE SIZE	293	620	23	ALUMINUM FRAME, NO SCREW HOLES AND WHITE FINISH.
LOWER T			600	24			189	400	100	ALUMINUM CORE EGG-CRATE RETURN GRILLE WITH 12MMx12MMx12MM (1/2"x1/2"x1/2") CORE STYLE, LAY-IN T-BAR
B2	EG5-24x10-F23-NONE-00-00-00-44	RETURN AIR GRILLE	250	10	GRILL	LE SIZE	547	1,160	25	ALUMINUM FRAME, NO SCREW HOLES AND WHITE FINISH.
(SCORE)	Was notice to the second region to the Grand control of the contro	Supplied a dependent of the control	600	24	Se Manhata	V. 150 J.	425	900	525	ALUMINUM CORE EGG-CRATE RETURN GRILLE WITH 12MMx12MMx12MM (1/2"x1/2"x1/2"x1/2") CORE STYLE, LAY-IN T-BAR
B3	EG5-24x24-F23-NONE-00-00-00-44	RETURN AIR GRILLE	600	24	GRILL	LE SIZE	1,227	2,600	24	ALUMINUM FRAME, NO SCREW HOLES AND WHITE FINISH.
			200	8		0.0000000000000000000000000000000000000	-	-	-	ALUMINUM DOOR GRILLE WITH 12MM (1/2") BLADE SPACING, C/W ALUMINUM AUXILIARY FRAME, NO SCREW HOLE:
D1	5600A-08x08-00-10	DOOR GRILLE	200	8	GRILL	LE SIZE	53	113	27	AND ALUMICAN FINISH
	AUDIO ANNO ANTO CONTRACTOR AND AUDIO MATERIA CONTRACTOR AND ANALYSIS (AUDIO MATERIA)		150	6	ID WARMAN	0 (100 P. 900AC to	14	30	12	ALUMINUM CORE EGG-CRATE EXHAUST GRILLE WITH 32MM (1 1/4" FLANGE), 12MMx12MMx12MM (1/2"x1/2"x1/2") COR
E1	EGC5-06x06-F22-NONE-00-00-00-44	EXHAUST AIR GRILLE	150	6	GRILL	LE SIZE	80	170	21	<ul> <li>STYLE, SURFACE MOUNT, NO SCREW HOLES AND WHITE FINISH. SITE VERIFY THE FLANGE REQUIREMENT BEFOR ORDERING.</li> </ul>
			300	12			142	300	-	ALUMINUM CORE EGG-CRATE EXHAUST GRILLE WITH 32MM (1 1/4" FLANGE), 12MMx12MMx12MM (1/2"x1/2"x1/2") COR
E2	EGC5-12x12-F22-NONE-00-00-00-44	RETURN AIR GRILLE	300	12	GRILL	LE SIZE	354	750	23	<ul> <li>STYLE, SURFACE MOUNT, NO SCREW HOLES AND WHITE FINISH. SITE VERIFY THE FLANGE REQUIREMENT BEFOR ORDERING.</li> </ul>
	MATTER COMMANDE AND SERVICE AND THE CHANGE WHEN A VALUE	EURINA MARKAMA IZHINAN	250 W	10 W	(SA SINAMANA	n 1900 A. Walker Co.	156	330	127	SINGLE DEFLECTION STAINLESS STEEL 304 EXHAUST GRILLE WITH 19MM (3/4") BLADE SPACING, 45 DEG HORIZON
E3	9S80-H-304-F22-NONE-01-00-00-44	EXHAUST AIR GRILLE	450 H	18 H	GRILL	LE SIZE	472	1,000	27	BLADES, SURFACE MOUNT, COUNTERSUNK STAINLESS STEEL SCREWS AND WHITE FINISH.
			600	24			142	300	-	ALUMINUM CORE EGG-CRATE EXHAUST GRILLE WITH 32MM (1 1/4" FLANGE), 12MMx12MMx12MM (1/2"x1/2"x1/2") COR
E4	EGC5-24x8-F23-24x24-00-00-00-44	RETURN AIR GRILLE	200	8	GRILL	LE SIZE	448	950	24	STYLE, LAY-IN T-BAR FRAME, 600MM x 600 MM PANEL, NO SCREW HOLES AND WHITE FINISH. SITE VERIFY THE FLANGE REQUIREMENT BEFORE ORDERING.
and the second	Name of the Control o	4 WAY SUPPLY AIR	600	24	250	10	52	110	127	ALUMINUM SQUARE FACE DROP CONE DIFFUSER WITH 3 CONES AND INTEGRAL EARTHQUAKE TABS. LAY-IN T-BA
M1	51450-04-10-F23-24x24-00-44	DIFFUSER	600	24	ROUND	ROUND	203	430	26	FRAME, 600MM x 600 MM PANEL, NECK-MOUNTED ROUND DAMPER ADJUSTABLE FROM FACE OF THE DIFFUSER, 250MM (10") ROUND INLET AND WHITE FINISH.
E IIIRO		4 WAY SUPPLY AIR	600	24	200	8	33	70	-	ALUMINUM SQUARE FACE DROP CONE DIFFUSER WITH 3 CONES AND INTEGRAL EARTHQUAKE TABS. LAY-IN T-BA
M2	51450-04-08-F23-24x24-00-44	DIFFUSER	600	24	ROUND	ROUND	146	310	27	FRAME, 600MM x 600 MM PANEL, NECK-MOUNTED ROUND DAMPER ADJUSTABLE FROM FACE OF THE DIFFUSER, 200MM (8") ROUND INLET AND WHITE FINISH.
		A WAY CURRLY AIR	600	24	150	6	14	30	1 12	ALUMINUM SQUARE FACE DROP CONE DIFFUSER WITH 3 CONES AND INTEGRAL EARTHQUAKE TABS. LAY-IN T-BA
МЗ	51450-04-06-F23-24x24-00-44	4 WAY SUPPLY AIR DIFFUSER	600	24	ROUND	ROUND	92	195	26	FRAME, 600MM x 600 MM PANEL, NECK-MOUNTED ROUND DAMPER ADJUSTABLE FROM FACE OF THE DIFFUSER, 150MM (6") ROUND INLET AND WHITE FINISH.
			400 W	16 W	3,,0	1	283	600	13	
N1	S80-HZ-16x12-F22-NONE-01-00-00-44	RETURN AIR GRILLE	300 H	12 H	GRILL	LE SIZE	434	920	23	STEEL SINGLE DEFLECTION RETURN GRILLE WITH 19MM (3/4") BLADE SPACING, 0 DEG HORIZONTAL BLADES, SURFACE MOUNT, COUNTERSUNK SCREWS AND WHITE FINISH.
			500 W	20 W			236	500	122	OTEST DOUBLE DESTROY CURRING A DIVISION OF A DESCRIPTION
N2	880-V-20x12-F22-NONE-01-00-00-44	SUPPLY AIR GRILLE	300 H	12 H	GRILL	LE SIZE	510	1,080	27	STEEL DOUBLE DEFLECTION SUPPLY GRILLE WITH 19MM (3/4") BLADE SPACING, SURFACE MOUNT, COUNTERSUN SCREWS AND WHITE FINISH.

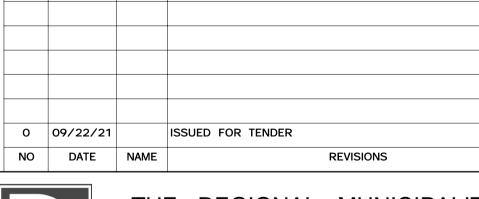		ļ	PLUMBI	NG FIX	TURE C	ONNEC	TION SC	HEDUL	E			
TAG	FIXTURE NAME	SANITAR	Y WASTE	SANITA	RY VENT	DC	cws	DH	WS	TEMF	PERED	- REMARKS
TAG	FIXTORE NAIVIE	ММ	INS	ММ	INS	ММ	INS	ММ	INS	ММ	INS	REWARKS
W-1	BARRIER FREE WALL HUNG FLUSH VALVE WATER CLOSET	75	3	38	1.5	25	1	-	-	-	-	
W-2	GENERAL USE WALL HUNG FLUSH VALVE WATER CLOSET	75	3	38	1.5	25	1	-	-	-	-	
U-1	BARRIER FREE WALL HUNG FLUSH VALVE URINAL	50	2	38	1.5	19	0.75	-	-	-	-	
L-1	BARRIER FREE COUNTERTOP LAVATORY	32	1.25	32	1.25	13	0.5	13	0.5	13	0.5	TEMPERED WATER FROM THERMOSTATIC MIXING VALVE
L-2	BARRIER FREE WALL HUNG LAVATORY	32	1.25	32	1.25	13	0.5	13	0.5	13	0.5	TEMPERED WATER FROM THERMOSTATIC MIXING VALVE
S-1	SINGLE COMPARTMENT STAINLESS STEEL SINK	38	1.5	38	1.5	13	0.5	13	0.5	-	-	
S-2	DOUBLE COMPARTMENT STAINLESS STEEL SINK	2@ 38	2@ 1.5	38	1.5	13	0.5	13	0.5	-	-	
S-3	JANITOR'S SERVICE SINK	75	3	38	1.5	13	0.5	13	0.5	-	-	
WBF-1	BARRIER FREE DRINKING FOUNTAIN	32	1.25	32	1.25	13	0.5					
E-1	EMERGENCY EYE/FACE WASH	38	1.5	38	1.5	19	0.75	19	0.75	19	0.75	TEMPERED WATER FROM THERMOSTATIC MIXING VALVE
FD	FLOOR DRAIN	75	3	38	1.5	9	0.38	-	-	-	-	NON-POTABLE SUPPLY FROM TSP
FFD	FUNNEL FLOOR DRAIN	75	3	38	1.5	9	0.38	-	-	-	-	NON-POTABLE SUPPLY FROM TSP
TD	TRENCH DRAIN	75	3	38	1.5	9	0.38	-	-	-	-	NON-POTABLE SUPPLY FROM TSP
TSP	TRAP SEAL PRIMER		-	-	-	19 9*	0.75 0.38*	-	-	-	-	* PER FD+FFD
WH-1	EXTERIOR NON-FREEZE WALL HYDRANT	-	-	-	-	19	0.75	-	-	-	-	
WH-2	INTERIOR DOUBLE TEMPERATURE WALL HYDRANT	-	-	-	-	19	0.75	19	0.75	-	-	
HB-1	HOSE-BIBB	-	-	-	-	19	0.75	-	-	-	-	
PH-1	POST HYDRANT	-	-	-	-	19	0.75	-	-	-	-	
PH-1	POST HYDRANT	-	-	-	-	19	0.75	-	-	-	-	

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SUB CONSULTANT

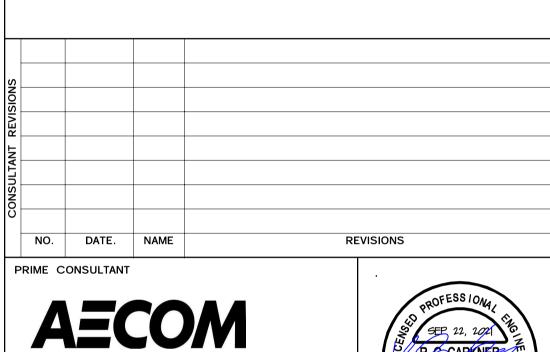

DESIGN BY: Designer SCALE:

DRAWN BY: Author DATE: 04/01/21

CHECKED BY: Checker CONSULTANT PROJECT NO. 60611569

APPROVED BY: Approver

CLIENT FILE No.: 811/20

SOURCE

O 09/22/21 ISSUED FOR TENDER

NO DATE NAME REVISIONS



## THE REGIONAL MUNICIPALITY OF DURHAM

WORKS DEPARTMENT
DESIGN, CONSTRUCTION & ASSET MANAGEMENT

PROPERTY NO.	FACILITIES CODE	FACILITIES PROJECT NO. PO61-18-01
CONTRACT NO.	DRAWING NO.	SHEET NO.
T- 1160- 2021	M- 701	


				ELEC.	TRIC SNOW	MELT:	SYSTEM	SCHED	ULE		
CONTROL PANEL	LOCATION	AREA SERVED	RAYCHEM	EMBEDDED MATERIAL	CIRCUIT	HEAT	r LOAD	ELE	CTRICAL	POWER	REMARKS
TAG	LOCATION	AREA SERVED	PRODUCT NO.	EIMBEDDED MATERIAL	QUANTITY	KW	МВН	FEED	DISTRIBUTION	KW	REWARKS
SM-1	MECHANICAL ROOM [124]	[131] VEHICLE BAY APRONS	SMPG3-208-3-2/3P(40)-1-100	ASPHALT	6 (3 + 3)	33.0	112629	208/3/60	208/3/60	33.0	THREE PHASE POWER DISTRIBUTION PANEL FOR THREE PHASE HEATING CABLES, COMPLETE WITH MAIN CIRCUIT BREAKER, INTERNAL TRANSFORMER, HDPE JACKETED COPPER SHEATHED HEATING CABLES, AERIAL SNOW SENSOR AND FOUR (4) PAVEMENT MOUNTED TEMPERATURE SENSORS.
SM-2	MECHANICAL ROOM [124]	PEDESTRIAN ENTRANCES [101], [122], [123], [124], [134] & [107]	SMPG1-208-3-4/2P(50)-1-200	CONCRETE	5 (2 + 1 +1 + 1)	27.4	93516	208/3/60	208/1/60	27.4	THREE PHASE POWER DISTRIBUTION PANEL FOR SINGLE PHASE HEATING CABLES, COMPLETE WITH MAIN CIRCUIT BREAKER, INTERNAL TRANSFORMER, HDPE JACKETED COPPER SHEATHED HEATING CABLES, AERIAL SNOW SENSOR AND FOUR (4) PAVEMENT MOUNTED TEMPERATURE SENSORS.

													FA	N SCH	IEDULE					
TAG	LOCATION	FUNCTION	FAN TYPE	MANUFACTURER	MODEL		(IMUM ACITY	VATI (571 ft 574)	MUM ACITY	STATIC PF	RESSURE	OPER/ WEI		FAN	NOMINAL	MOTOR POWER	POWER	SOUND DATA	CONTROLLED BY	REMARKS
100			() () () () () () () ()			LPS	CFM	LPS	CFM	Pa	IN WC	KGS	LBS	RPM	W	MCA OR BHP		SONES		
EF-1	MECHANICAL ROOM [124]	GENERAL EXHAUST	CENTRIFUGAL CABINET FAN BELT DRIVE	PENNBARRY	ZEPHYR ZC12	639	1,350	213	450	75	0.3			500	250	0.2 BHP	120/1/60		& OCCUPANCY SENSOR H	COMPLETE WITH 2-SPEED 2-WINDING TOTALLY ENCLOSED MOTOR, GRAVITY BACKDRAFT DAMPER, VIBRATION ISOLATION GRAVITY BACKDRAFT DAMPER, VIBRATION
EF-2	ELECTRICAL ROOM [123]	GENERAL EXHAUST	CENTRIFUGAL CABINET FAN BELT DRIVE	PENNBARRY	ZEPHYR ZC15	1,183	2,500	1,183	2,500	87	0.35			1050	370	0.38 BHP	120/1/60		PY DIV 25	COMPLETE WITH TOTALLY ENCLOSED MOTOR, GRAVITY BACKDRAFT DAMPER, VIBRATION ISOLATION HANGER, FLEXIE DUCT CONNECTION, INLET GUARD, EPOXY COATING, INSULATION, DISCONNECT SWITCH AND THERMAL OVERLOAD PROTECTION.
EF-3	UNIVERSAL WASHROOM [119]	SANITARY EXHAUST	CENTRIFUGAL CEILING FAN DIRECT DRIVE	PENNBARRY	ZEPHYR Z1	24	50	24	50	31	0.125	3.6	8.0	1700	55	-	120/1/60	3.4	and the second control of the second control	COMPLETE WITH UNIT MOUNTED SPEED CONTROLLER, VIBRATION ISOLATION HANGER AND FLEXIBLE DUCT CONNECTION.
EF-4	DECONTAMINATION SHOWER [130]	SANITARY EXHAUST	CENTRIFUGAL CEILING FAN DIRECT DRIVE	PENNBARRY	ZEPHYR Z5H	70	150	70	150	31	0.125	6.4	14.0	1550	80	-	120/1/60	3.3		COMPLETE WITH GRAVITY BACKDRAFT DAMPER, UNIT MOUNTED SPEED CONTROLLER, VIBRATION ISOLATION HANGEF CLEXIBLE DUCT CONNECTION AND WCC06 CURB-MOUNTED ROOF CAP.
EF-5	LINEN ROOM [134]	GENERAL EXHAUST	CENTRIFUGAL CEILING FAN DIRECT DRIVE	PENNBARRY	ZEPHYR Z1	24	50	24	50	31	0.125	3.6	8.0	1700	55		120/1/60	3.4		COMPLETE WITH GRAVITY BACKDRAFT DAMPER, UNIT MOUNTED SPEED CONTROLLER, VIBRATION ISOLATION HANGEF ELEXIBLE DUCT CONNECTION, B68 BRICK VENT AND METAL FACE GRILLE.
EF-6	STORAGE ROOM [116]	GENERAL EXHAUST	CENTRIFUGAL CEILING FAN DIRECT DRIVE	PENNBARRY	ZEPHYR Z1	24	50	24	50	31	0.125	3.6	8.0	1700	55	-	120/1/60	3.4		COMPLETE WITH GRAVITY BACKDRAFT DAMPER, UNIT MOUNTED SPEED CONTROLLER, VIBRATION ISOLATION HANGEF CLEXIBLE DUCT CONNECTION AND WCC06 CURB-MOUNTED ROOF CAP.
EF-7	JANITOR ROOM [120]	SANITARY EXHAUST	CENTRIFUGAL CEILING FAN DIRECT DRIVE	PENNBARRY	ZEPHYR Z1	24	50	24	50	31	0.125	3.6	8.0	1700	55	-	120/1/60	3.4	The state of the s	COMPLETE WITH GRAVITY BACKDRAFT DAMPER, UNIT MOUNTED SPEED CONTROLLER, VIBRATION ISOLATION HANGEI CLEXIBLE DUCT CONNECTION AND WCC06 CURB-MOUNTED ROOF CAP.
DF-1 & DF-2	VEHICLE BAY [131]	DE-STRATIFICATION	AXIAL DIRECT DRIVE	BIGASS FANS	POWERFOIL D PFD1-0822	-			-	-	-	96.2	212.0	200 MAX.	-	10 MCA	208/3/60	<55dB	VARIABLE SPEED T	2.4 M (8 FT) DIAMETER, COMPLETE WITH AIRFOIL RESTRAINT AND SAFETY CABLE, MOUNTING KIT AND FIRE ALARM REL TIE-IN TO BAS FOR CONTROL AND MONITORING. TINISH COLOUR SELECTED AT SHOP DRAWING REVIEW

																	FAN	COIL S	CHEDU	LE															
			ELECT	RICAL				SUPPL	Y FAN										201					CHILLED WATER	COOLING CO	L	1000	194 DC	1000	1000	MIR.	W.H.			
TAG	SPACE SERVED	DAIKIN		2000/2020/01/04	8			entation en					EAT			L	AT		E40E	FACE					CENCIDI E	CENCIDI E	FNITTOING	FUTERING	I FAVING	LEAVING				WATER	WATER
IAG	SPACE SERVED	MODEL	VOLTAGE	MCA	AIRFLOW LPS	AIRFLO	W ES	1000 00001000000	MOTOR POWER HP	MOTOR TYPE	EDB °C	EDB °F	EWB °C	EWB °F	LDB °C	LDB °F	LWB °C	LWB °F	FACE AREA M²	FACE AREA ft²	FPI	ROWS	TOTAL CAPACITY KW	TOTAL CAPACITY BTU/H	SENSIBLE CAPACITY KW	SENSIBLE CAPACITY BTU/H		ENTERING WATER TEMP °F	LEAVING WATER TEMP °C	LEAVING WATER TEMP °F	FLOW RATE	FLOW RATE GPM	FLUID TYPE	WATER PRESS. DROP kPa	WATER PRESS. DROP ft H <sub>2</sub> O
FC-1	114 SIM LAB & 115 STORAGE	FCHH203	115/1/60	2.2	142	300	37.	.4 0.15	1/8	3-SPEED ECM	24.4	76.0	18.7	65.7	12.2	54.0	12.2	53.9	0.10	1.1	12	4	2.81	9595	1.89	6445	6.7	44.0	12.2	54.0	0.12	1.9	Water	4.39	1.47
FC-2	128 WASHROOMS & 129 LOCKER ROOM	FCHH206	115/1/60	4.7	283	600	37.	.4 0.15	1/4	3-SPEED ECM	24.5	76.1	18.2	64.8	11.9	53.5	11.8	53.2	0.20	2.1	12	4	5.53	18872	3.94	13452	6.7	44.0	12.2	54.0	0.24	3.8	Water	20.71	6.93
FC-3	103 REPORT WRITING	FCHH206	115/1/60	2.9	283	600	37.	0.15	1/4	3-SPEED ECM	24.4	75.9	17.6	63.6	11.7	53.0	11.2	52.2	0.20	2.1	12	4	4.54	15502	3.50	11953	6.7	44.0	12.2	53.9	0.20	3.1	Water	14.65	4.90
FC-4	104 KITCHEN	FCHH210	115/1/60	5.8	472	1000	37.	.4 0.15	(2) 1/4	3-SPEED ECM	24.4	76.0	17.8	64.1	14.8	58.6	13.7	56.6	0.29	3.1	12	2	5.84	19948	4.79	16352	6.7	44.0	12.2	53.9	0.25	4.0	Water	14.86	4.97
FC-5	102 CORRIDOR & 122 VESTIBULE	FCHH212	115/1/60	8.5	567	1200	37.	.4 0.15	(2) 1/4	3-SPEED ECM	24.5	76.1	17.8	64.1	11.9	53.4	11.3	52.4	0.35	3.8	12	4	11.16	38103	8.06	27524	6.7	44.0	12.2	53.9	0.49	7.7	Water	27.23	9.11
FC-6	126 SECURE STORAGE & 127 MEDICAL STORAGE	FCHH202	115/1/60	2.2	94	200	37.	.4 0.15	1/8	3-SPEED ECM	24.4	76.0	18.3	65.0	13.0	55.4	12.7	54.8	0.07	0.7	12	3	1.54	5252	1.12	3818	6.7	44.0	12.2	54.0	0.07	1.1	Water	1.14	0.38
FC-7	121 KITCHEN	FCHH212	115/1/60	8.5	567	1200	49.	.8 0.20	(2) 1/4	3-SPEED ECM	24.6	76.2	17.9	64.2	12.5	54.5	11.6	52.8	0.35	3.8	12	3	10.53	35923	7.43	25346	6.7	44.0	12.2	54.0	0.45	7.2	Water	35.66	11.93
FC-8 & FC-19	108 OPEN OFFICE	FCHH208	115/1/60	5.3	378	800	37.	.4 0.15	1/4	3-SPEED ECM	24.6	76.3	17.8	64.0	11.9	53.4	11.6	52.8	0.23	2.5	12	4	6.72	22924	5.12	17465	6.7	44.0	12.2	54.0	0.29	4.6	Water	32.10	10.74
FC-9	109 BREAK-OUT & 110 STORAGE	FCHH203	115/1/60	2.2	142	300	37.	.4 0.15	1/8	3-SPEED ECM	24.3	75.8	18.4	65.2	13.3	56.0	13.2	55.8	0.10	1.1	12	4	2.12	7236	1.65	5643	6.7	44.0	12.2	54.0	0.09	1.5	Water	3.44	1.15
FC-10	112 CLASSROOM	FCHH210	115/1/60	5.8	472	1000	37.	.4 0.15	(2) 1/4	3-SPEED ECM	24.4	75.9	19.2	66.5	12.9	55.2	12.7	54.9	0.29	3.1	12	3	8.94	30514	5.66	19308	6.7	44.0	12.2	54.0	0.38	6.1	Water	23.02	7.70
FC-11	113 CLASSROOM	FCHH210	115/1/60	5.8	472	1000	37.	.4 0.15	(2) 1/4	3-SPEED ECM	24.4	75.9	19.2	66.5	12.9	55.2	12.7	54.9	0.29	3.1	12	3	8.94	30514	5.66	19308	6.7	44.0	12.2	54.0	0.38	6.1	Water	23.02	7.70
FC-12	107 CORRIDOR	FCHH212	115/1/60	8.5	567	1200	49.	.8 0.20	(2) 1/4	3-SPEED ECM	24.6	76.2	17.9	64.2	12.5	54.5	11.6	52.8	0.35	3.8	12	3	10.53	35923	7.43	25346	6.7	44.0	12.2	54.0	0.45	7.2	Water	35.66	11.93
FC-13	105 LOUNGE	FCHH210	115/1/60	5.8	472	1000	37.	.4 0.15	(2) 1/4	3-SPEED ECM	24.4	75.9	17.8	64.1	14.7	58.5	13.6	56.5	0.29	3.1	12	2	5.72	19534	4.71	16061	6.7	44.0	12.2	54.0	0.25	3.9	Water	14.29	4.78
FC-20	123 ELECTRICAL ROOM	BCHD0081	115/1/60	8.0	378	800	37.	.4 0.15	1/2	3-SPEED DIRECT CONTACT BRUSHLESS	30.6	87.0	17.8	64.1	12.7	54.8	11.2	52.2	0.15	1.6	12	6	8.24	28131	8.24	28131	6.7	44.0	12.2	54.0	0.35	5.6	Water	23.61	7.90

								OIL SCHE	JULE (1 7									
										HOT WATER H	EATING COIL							
TAG	SPACE SERVED	EDB °C	EDB °F	LDB °C	LDB °F	FPI	ROWS	TOTAL CAPACITY KW	TOTAL CAPACITY BTU/H	ENTERING WATER TEMP. °C	ENTERING WATER TEMP. °F	LEAVING WATER TEMP. °C	LEAVING WATER TEMP. °F	FLOW RATE LPS	FLOW RATE GPM	FLUID TYPE	WATER PRESS. DROP kPa	WATER PRESS DROP ft H <sub>2</sub> O
=C-1	114 SIM LAB & 115 STORAGE	21.4	70.5	34.4	93.9	12	2	2.01	6862	48.9	120.0	37.7	99.9	0.04	0.7	Water	1.85	0.62
-C-2	128 WASHROOMS & 129 LOCKER ROOM	21.7	71.0	35.6	96.0	12	2	4.35	14857	48.9	120.0	37.8	100.1	0.09	1.5	Water	10.49	3.51
-C-3	103 REPORT WRITING	21.9	71.5	28.6	83.5	12	1	1.84	6272	48.9	120.0	37.8	100.1	0.04	0.6	Water	4.24	1.42
-C-4	104 KITCHEN	21.6	70.8	35.5	95.9	12	2	6.94	23696	48.9	120.0	37.8	100.1	0.15	2.4	Water	5.17	1.73
-C-5	102 CORRIDOR & 122 VESTIBULE	21.8	71.2	36.2	97.2	12	2	9.22	31471	48.9	120.0	37.8	100.1	0.20	3.2	Water	9.86	3.30
-C-6	126 SECURE STORAGE & 127 MEDICAL STORAGE	21.7	71.0	35.6	96.1	12	1	0.78	2655	48.9	120.0	37.8	100.0	0.02	0.3	Water	5.08	1.70
-C-7	121 KITCHEN	21.8	71.2	35.4	95.7	12	2	8.38	28590	48.9	120.0	37.8	100.1	0.18	2.9	Water	8.13	2.72
-C-8 & FC-19	108 OPEN OFFICE	21.8	71.2	34.2	93.5	12	2	4.97	16977	48.9	120.0	37.8	100.1	0.11	1.7	Water	14.44	4.83
-C-9	109 BREAK-OUT & 110 STORAGE	21.9	71.4	36.1	97.0	12	1	0.26	900	48.9	120.0	37.8	100.1	0.01	0.1	Water	0.15	0.05
-C-10	112 CLASSROOM	21.7	71.0	36.2	97.1	12	2	7.12	24292	48.9	120.0	37.8	100.1	0.16	2.5	Water	5.47	1.83
-C-11	113 CLASSROOM	21.7	71.0	36.2	97.1	12	2	7.12	24292	48.9	120.0	37.8	100.1	0.16	2.5	Water	5.47	1.83
FC-12	107 CORRIDOR	21.8	71.2	35.4	95.7	12	2	8.38	28590	48.9	120.0	37.8	100.1	0.18	2.9	Water	8.13	2.72
FC-13	105 LOUNGE	21.7	71.1	28.9	84.1	12	1	3.52	12024	48.9	120.0	37.8	100.1	0.08	1.2	Water	17.49	5.85
-C-20	123 ELECTRICAL ROOM	18.3	65.0	26.9	80.5	12	1	1.44	4900	48.9	120.0	37.8	100.1	0.03	0.5	Water	12.25	4.10

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DESIGN BY: Designer	SCALE:
DRAWN BY: Author	DATE: 04/01/21
CHECKED BY: Checker	CONSULTANT PROJECT NO. 60611569
APPROVED BY: Approver	CLIENT FILE No.: 811/20

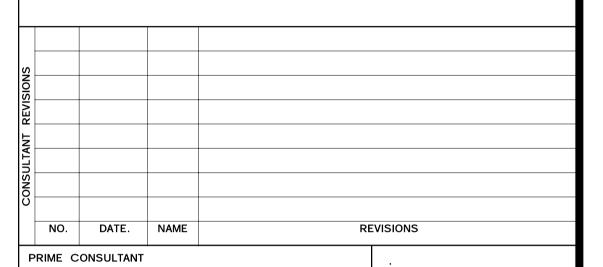O 09/22/21 ISSUED FOR TENDER
NO DATE NAME REVISIONS



THE REGIONAL MUNICIPALITY
OF DURHAM

WORKS DEPARTMENT
DESIGN, CONSTRUCTION & ASSET MANAGEMENT

PROPERTY NO.	FACILITIES CODE	FACILITIES PROJECT NO. P061-18-01
CONTRACT NO.	DRAWING NO.	SHEET NO.
T- 1160- 2021	M- 702	

						Н	JMIDIF	IER SC	CHEDULE
TAG	MANUFACTURER	MA STEAM FL	AX. .OW RATE	POWE	ER SUPPLY		OPER WEI	ATING GHT	REMARKS
TAG	/ MODEL	KG/HR	LB/HR	V / PH / Hz	KW	FLA	KG	LBS	REWARKS
HUM-1	DRISTEEM / VAPORMIST VM-14	19.1	42.0	600 / 3 / 60	14	13.5	63	130	MODULATING SOLID STATE RELAY CONTROLLED, WITH BACNET COMMUNICATION AND DISCONNECT SWITCH. COMPLETE WITH DRISTEEM "DRANE-KOOLER", REMOTE HIGH HUMIDITY SWITCH AND AIR PROVING SWITCH IN SUPPLY AIR DUCT. CONNECTED TO "DRISTEEM RAPIDSORB" STEAM DISPERSION TUBES WITH STAINLESS STEEL HEADER AND TUBE INSIDE ASSOCIATED SUPPLY AIR DUCT.

																	НҮІ	DRONI	C HEA	T TRANSFE	ER UNITS	SCHEDU	LE								
				MANUFACTURER /	MAX. A	IR FLOW	E	AT	L	_AT			EWT	г	LV	VT	FLOV	V RATE	WATER	PRESSURE DROP	MAX. HEAT	NG CAPACITY	MOTOR SIZE	MAX. FAN SPEED	POWER	AMP.	OPERATI	NG WEIGHT	DIME	ENSIONS	
TAG	TYPE	LOCATION	CONFIGURATION	MODEL	LPS	CFM	°C	°F	°C	°F	FLUID		°C	°F	°C	°F	LPS	GPM	kPa	FT.W.G.	kW	МВН	HP	RPM	SUPPLY	Α	KG	LBS	ММ	IN	REMARKS
UH-1	UNIT HEATER	MECH. ROOM [124]	HORIZONTAL	SIGMA 058H	429	910	18.0	64.4	28.0	82.4	WATE	R 4	8.9 1	120.0	37.8	100.0	0.11	1.8	0.36	0.12	5.3	18	0.125	1150	115/1/60	2	21.8	48.0	W 685 D 457 H 420		COMPLETE WITH WALL BRACKET, HORIZONTAL LOUVRES, OSHA FAN GUARD, OVERLOAD PROTECTION, DISCONNECT SWITCH AND REMOTE THERMOSTAT WITH INSULATED SUB-BASE
FF-1	FORCE FLOW HEATER	VESTIBULE [101]	RECESSED FRONT IN / FRONT OUT	SIGMA SFF-03	142	300	18.0	64.4	40.2	104.4	WATE	R 4	8.9 1	120.0	37.8	100.0	0.08	1.3	1.13	0.38	3.8	13	0.100	1075	115 / 1 / 60	1.9	56.8	125.0	W 1028 D 240 H 660	W 40.5 D 9.5 H 26	COMPLETE WITH LOUVRES, ACCESS DOOR, OVERLOAD PROTECTION, DISCONNECT SWITCH, UNIT MOUNTED THERMOSTAT AND SPEED CONTROLLER. COLOUR TO BE SELECTED AT SHOP DRAWING REVIEW.
FF-3	FORCE FLOW HEATER	VESTIBULE [122]	SEMI-RECESSED FRONT IN / FRONT OUT	SIGMA SFF-02	94	200	21.1	70.0	39.1	102.4	WATE	R 4	8.9 1	120.0	37.8	100.0	0.04	0.7	0.81	0.27	2.1	7	0.100	1075	115/1/60	1.9	34.1	75.0	W 660 D 240 H 660		COMPLETE WITH LOUVRES, ACCESS DOOR, OVERLOAD PROTECTION, DISCONNECT SWITCH, UNIT MOUNTED THERMOSTAT AND SPEED CONTROLLER. COLOUR TO BE SELECTED AT SHOP DRAWING REVIEW.
FF-4	FORCE FLOW HEATER	GENDER NEUTRAL W/R [117]	RECESSED CEILING MOUNTED	SIGMA SFF-02	94	200	21.1	70.0	41.7	107.0	WATE	R 4	8.9 1	120.0	37.8	100.0	0.05	0.8	0.90	0.30	2.3	8	0.100	1075	115/1/60	1.9	34.1	75.0	W 660 D 240 H 660	D 9.5	COMPLETE WITH LOUVRES, ACCESS DOOR, OVERLOAD PROTECTION, DISCONNECT SWITCH, REMOTE THERMOSTAT AND SPEED CONTROLLER. COLOUR TO BE SELECTED AT SHOP DRAWING REVIEW.
FF-5	FORCE FLOW HEATER	CORRIDOR [107]	SEMI-RECESSED FRONT IN / FRONT OUT	SIGMA SFF-02	94	200	21.1	70.0	33.9	93.1	WATE	R 4	8.9	120.0	37.8	100.0	0.03	0.5	0.60	0.20	1.5	5	0.100	1075	115/1/60	1.9	34.1	75.0	W 660 D 240 H 660		COMPLETE WITH LOUVRES, ACCESS DOOR, OVERLOAD PROTECTION, DISCONNECT SWITCH, UNIT MOUNTED THERMOSTAT AND SPEED CONTROLLER. COLOUR TO BE SELECTED AT SHOP DRAWING REVIEW.
CH-1	CONVECTOR HEATER	STORAGE [116]	WALL TYPE	SIGMA CWF			-	-	-	-	WATE	R 4	8.9 1	120.0	37.8	100.0	0.01	0.2			0.5	1.7	-	-	-	-			W 500 D 115 H 350	W 20 D 4.5 H 14	FLAT TOP, COMPLETE WITH 16 GA. FRONT COVER AND REMOTE THERMOSTAT. COLOUR TO BE SELECTED AT SHOP DRAWING REVIEW.


							II	I-FLOOR	RADIANT	CIRCU	ITS SCH	EDULE		
		REHAU	CIRCUIT	HEAT	LOAD	PIPE	SIZE	PIPE SI	PACING	WATE	R FLOW	HEAD	LOSS	
MANIFOLD	AREA SERVED	ARTICLE NO.	QUANTITY	KW	МВН	ММ	INS.	ММ	INS.	LPS	GPM	KPA	FT	
M-1	133 WASH AREA AND 134 OXYGEN & LINEN	PRO-BALANCE 381102-001 & 345400-512	3	6.44	22.0	16	0.625	150	6	0.14	2.20	15.82	5.30	25MM (1") STAINLESS STEEL MANIFOLD AND WHITE FLUSH MOUNT MANIFOLD CABINET. PROVIDE PROGRAMMABLE RADIANT THERMOSTAT WITH SEPARATE CONTROL VALVES AND FLOOR SENSORS FOR WASH BAY AND OXYGEN/LINEN ROOM (ART. NO. 398023) AND 4 MANIFOLD ACTUATOR CONTROLLER (ART. NO. 298276-001)
M-2	131 VEHICLE BAY	PRO-BALANCE 381110-001 & 316856-512	10	30.16	103.0	16	0.625	150 AND 250	6 AND 12	0.65	10.30	41.49	13.90	25MM (1") STAINLESS STEEL MANIFOLD AND STAINLESS STEEL SURFACE MOUNT MANIFOLD CABINET. PROVIDE TWO PROGRAMMABLE RADIANT THERMOSTATS WITH SEPARATE CONTROL VALVES AND FLOOR SENSORS (ART. NO. 398023) AND 4 MANIFOLD ACTUATOR CONTROLLER (ART. NO. 298276-001)

							LOU	VRE SC	HEDUL	E	
TAG	LOCATION	MANUFACTURER /	APPLICATION	FREE AREA	SIZ	ZE	VELC	OCITY	AIR F	LOW	ACCESSORIES / COLOUR
		MODEL		SQIVI	MM	INS	MPS	FPM	LPS	CFM	
C1 & C2	OXYGEN	VENTEX / 2625	NATURAL	0.05	400 W	16 W					150MM (6") DEEP STORMPROOF LOUVRE, COMPLETE WITH INSECT SCREEN AND EXTENDED SLEEVE. LOUVRE COLOUR SHALL BE SELECTED AT SHOP DRAWING REVIEW.
01402	ROOM	VEIVIEX / 2020	VENTILATION	0.00	400 H	16 H	10000100	107-9415-05	***************************************	*******	CONTRACTOR TO PROVIDE LINTEL FOR INSTALLATION.

						PUI	MP S	CHEDU	JLE									
TAG	LOCATION	SERVICE	FLUID TYPE	MANUFACTURER	MODEL	FLOW (	MAX)	FLOW (OF	PERATING)	HE	AD		мото	R DATA		CONTROLS	POWER	REMARKS
17.0	200/111011	SERVICE	12015 1112	NIVATOT ACTORER	WODEL	LPM	GPM	LPM	GPM	М	FT	RPM	ВНР	HP	WATTS	CONTINUES	V/Ph/Hz	KEIWAKKO
P-1A&B	MECH ROOM	GEO FIELD PRIMARY PUMPS	25% P.G.	XYLEM	E-1531 2BD	492.1	130	469.4	124	15.2	50	1531	2.47	5		VFD (LOOSE)	5/5/3/60	DUTY/STANDBY, VARIABLE SPEED OPERATION, INTEGRATED TECHNOLOGIC SENSORLESS CONTROL (ITSC)
P-2	MECH ROOM	HP-1 SECONDARY PUMP	25% P.G.	XYLEM	E-80 3x3x7C	492.1	130	469.4	124	6.1	20	1548	0.9	1.5		VFD (PUMP MOUNTED)	575/3/60	VARIABLE SPEED OPERATION
P-3	MECH ROOM	HP-2 SECONDARY PUMP	25% P.G.	XYLEM	E-80 2x2x9.5C	170.3	45	147.6	39	4.3	14	976	0.35	0.75		VFD (PUMP MOUNTED)	575/3/60	VARIABLE SPEED OPERATION
P-4A&B	MECH ROOM	CHILLED WATER PRIMARY PUMPS	WATER	XYLEM	E-80SC 3x3x7C	397.5	105	371.0	98	3.7	12	991	0.4	0.75		VFD (PUMP MOUNTED)	575/3/60	DUTY/STANDBY, CONSTANT SPEED OPERATION
P-5A&B	MECH ROOM	HEATING WATER PRIMARY PUMPS	WATER	XYLEM	E-80 3x3x7C	605.7	160	473.2	125	4.6	15	1140	0.82	1		VFD (PUMP MOUNTED)		DUTY/STANDBY, VARIABLE SPEED OPERATION, INTEGRATED TECHNOLOGIC SENSORLESS CONTROL (ITSC)
P-6A&B	MECH ROOM	CHILLED WATER SECONDARY PUMPS	WATER	XYLEM	E-90 2AB	397.5	105	371.0	98	9.1	30	1696	1.13	1.5		VFD (LOOSE)	575/3/60	DUTY/STANDBY, VARIABLE SPEED OPERATION
P-7A&B	MECH ROOM	HEATING WATER SECONDARY PUMPS	WATER	XYLEM	E-80 2x2x9.5C	302.8	80	276.3	73	9.1	30	1098	1.02	1.5		VFD (PUMP MOUNTED)		DUTY/STANDBY, VARIABLE SPEED OPERATION, INTEGRATED TECHNOLOGIC SENSORLESS CONTROL (ITSC)
P-8	MECH ROOM	HEATING GLYCOL SECONDARY PUMP	40% P.G.	XYLEM	E-80 1.5x1.5x9.5B	94.6	25	83.3	22	6.1	20	1070	0.263	0.5		VFD (PUMP MOUNTED)	575/3/60	VARIABLE SPEED OPERATION, INTEGRATED TECHNOLOGIC SENSORLESS CONTROL (ITSC)
P-9	MECH ROOM	ELECTRIC BOILER INJECTION PUMP	WATER	XYLEM	ECOCIRC XL 15-75	132.5	35	121.1	32	3.0	10	2315		0.16		STARTER	120/1/60	ECM MOTOR
P-10	MECH ROOM	DOMESTIC HOT WATER RECIRCULATION PUMP	DOMESTIC WATER	XYLEM	ECOCIRC 19-16	15.1	4	15.1	4	2.4	8	1929			60	STARTER	120/1/60	ECM MOTOR C/W AQUASTAT, TIMER AND BAS INTERLOCK

						RAN	GE HO	OD SC	HEDUL	.E					
TAG	LOCATION	FUNCTION	MANUFACTURER	MODEL	BLOWER TYPE	CAPA	CITY	STATIC P	RESSURE	МС	TOR POW	ER	SOUND DATA	CONTROLLED BY	REMARKS
	LOCATION	101011014	MANOTAGTORER	WODEL	BEOWERTTE	LPS	CFM	Pa	IN WC	RPM	AMP.	V/PH/HZ	SONES	OOMINGLED BY	TALMATURE
KH-1	KITCHEN [121]	RESIDENTIAL RANGE HOOD	REVERSOMATIC	DELUXE 2000-200 600MM (24")	CENTRIFUGAL DIRECT DRIVE	80	170	37	0.15	1,500	1.4	115/1/60	6.0		COMPLETE WITH INTEGRAL SPEED CONTROLLER, 60W LIGHT AND WHITE FINISH.
KH-2	KITCHEN [104]	RESIDENTIAL RANGE HOOD	REVERSOMATIC	DELUXE 2000-200 600MM (24")	CENTRIFUGAL DIRECT DRIVE	80	170	37	0.15	1,500	1.4	115/1/60	6.0		COMPLETE WITH INTEGRAL SPEED CONTROLLER, 60W LIGHT AND WHITE FINISH.


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DESIGN BY: Designer

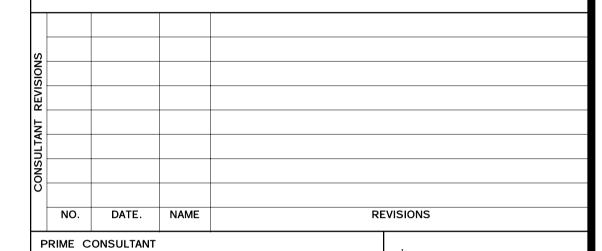DRAWN BY: Author

DATE: 06/10/21

CHECKED BY: Checker

CONSULTANT PROJECT NO. 60611569

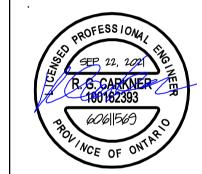APPROVED BY: Approver

CLIENT FILE No.: 811/20

0 09/22/21 ISSUED FOR TENDER
NO DATE NAME REVISIONS



### THE REGIONAL MUNICIPALITY OF DURHAM

WORKS DEPARTMENT
DESIGN, CONSTRUCTION & ASSET MANAGEMENT

PROPERTY NO.	FACILITIES CODE	FACILITIES PROJECT NO. P061-18-01
CONTRACT NO.	DRAWING NO.	SHEET NO.
T- 1160- 2021	M- 703	

						SILE	NCER S	CHEDUL	.E										
				D	IMENSION	IS		VELOCITY	IDEAL	MAX.DP		MINI	мим р	YNAMI	C INSE	RTION	LOSS		2
TAG	VIBRO-ACOUSTICS	SYSTEM	TYPE	DUCT	DUCT	LENGTH	AIRFLOW	VLLOCITI	DP	W/SYS EFF				dB (N	OTE 5)				Notes
170	MODEL NUMBER	OTOTEN		WIDTH	HEIGHT	LLINOIII		(NOTE 2)	(NOTE 3)	(NOTE 4)		OCTAV	E BAN	D CEN	TER FR	EQUEN	ICY, HZ	2	140103
			(NOTE 1)	MM.	MM.	MM.	L/S	M/S	Pa	Pa	63	125	250	500	1000	2000	4000	8000	
SL-S	RD-LV-AY26997	SUPPLY	RD	650	350	900	967	+4	42	59	5	8	15	20	23	19	14	12	6, 7, 8
SL-R1	RD-ULV-AY26997	RETURN	RD	500	250	900	392	-3	27	33	9	18	21	17	22	16	13	12	6, 7, 8
SL-R2	RD-ULV-AY26997	RETURN	RD	500	400	900	599	-3	25	30	9	18	21	17	22	16	13	12	6, 7, 8

1. TYPE: R - RECTANGULAR D - DISSIPATIVE

2. VELOCITY SHOWN IS + (FORWARD FLOW) OR - (REVERSE FLOW) AS DEFINED BY ASTM E477-13.

3. IDEAL PRESSURE DROP AS DETERMINED PER ASTM E477-13 IN A NVLAP-ACCREDITED ACOUSTICAL LABORATORY.

. PRESSURE DROP PER ASTM E477-13 PLUS SYSTEM EFFECTS FOR NEARBY DUCT ELEMENTS. MINIMUM DYNAMIC INSERTION LOSS DETERMINED PER ASTM E477-13 IN A NVLAP-ACCREDITED ACOUSTICAL LABORATORY.

3. NON-BASIS OF DESIGN SILENCER MANUFACTURER SHALL PROVIDE, FOR APPROVAL, PROFESSIONAL ENGINEER STAMPED ACOUSTICAL CALCULATIONS FOR ALL SYSTEMS WITH SILENCERS TO DEMONSTRATE THAT THE RESULTANT DUCTBORNE FAN SOUND LEVELS, INCLUDING AIRBORNE AND BREAKOUT NOISE, MEET THE REQUIRED CRITERIA.

NON-BASIS OF DESIGN SILENCER MANUFACTURER SHALL PROVIDE, FOR APPROVAL, PROFESSIONAL ENGINEER STAMPED PRESSURE DROP CALCULATIONS FOR ALL SYSTEMS WITH SILENCERS TO

DEMONSTRATE THAT THE RESULTANT INSTALLED PRESSURE DROP WITH SYSTEM EFFECTS DOES NOT EXCEED SCHEDULED VALUES. 8. FOR NON-BASIS OF DESIGN PRODUCT SUPPLIED, CONTRACTOR IS FINANCIALLY RESPONSIBLE TO ENSURE NOISE CONTROL SOLUTION IS DELIVERED TO ACHIEVE SPECIFIED NC LEVEL IN SPACES.

							VARIAE	BLE AIR	VOLUM	E (VAV)	TERMIN	AL BOX	SCHED	ULE					
			NOMIN	IAL INLET		NOMINAL (	OUTLET SIZE		7	TERMINAL AIF	RFLOW RANG	θE	MIN	IIMUM	ATTEN	JATOR	NC SOU	ND DATA	
TAG	MANUFACTURER & MODEL	TERMINAL TYPE		METER	WI	DTH	HE	IGHT	MIN	IIMUM	MAX	IMUM	1000000	P's	LEN		AUDICAL STRUCTURES	IMUM	REMARKS
			ММ	INS	ММ	INS	ММ	INS	LPS	CFM	LPS	CFM	PA	INS.W.C.	ММ	INS	DISC.	RAD.	
04	KRUEGER LMHS-1-1-1-XX-04-D		100	4	300	12	200	8	19	40	109	230			900	36	32	24	
05	KRUEGER LMHS-1-1-1-XX-05-D	SINGLE INLET, PRESSURE INDEPENDENT (SUPPLY)	125	5	300	12	200	8	29	62	170	360	25	0.10	900	36	31	21	COMPLETE WITH 25 MM (1 IN) INSULATION AND LINEAR AVERAGIN SENSOR. DIGITAL CONTROLS SUPPLIED BY THIS DISCIPLINE AND INSTALLED BY THE TERMINAL MANUFACTURER.
06	KRUEGER LMHS-1-1-1-XX-06-D		150	6	300	12	200	8	42	89	243	515	]		900	36	27	25	


										1	HEAT	PUMP	SCHE	DULE																
ì				OPERATIN	IG WEIGHT		CIRCUIT D	ATA	(3	CAPA	CITY				10	GEOTHER	RMAL SOL	RCE SIDE	COOLIN	G PERFOR	RMANCE				S	YSTEM SID	DE	2	11 72 100 60 100	
TAG	LOCATION	MANUFACTURER / MODEL	TYPE	THE RESIDENCE OF THE PROPERTY	hore i who hereach has rece	COMPRESSOR	COMPRESSOR	CIRCUIT	REFRIGERAN		CITY	EER	EV	ΛT	LV		FL		PRESS	. DROP	14500000000	EV	VT	L۱	NΤ	FLO	WC	PRESS	DROP	Total Manager
				KG	LBS	TYPE	QTY.	QTY.	T	kW	TON	LLIX	С	F	С	F	LPS	GPM	М	FT	FLUID	С	F	С	F	LPS	GPM	М	FT	FLUID
HP-1	MECHANICAL ROOM	AERMEC / NXP0650Y	6 PIPE	1450	3196	SCROLL	4	2	R410A	144.1	41	15.6	29.5	85	35.0	95	7.8	124.0	4.75	15.60	25% PROP.	12.2	54.0	6.7	44.0	6.2	98.3	2.0	6.6	WATER
HP-2	[124]	AERMEC / WRL400Y	4 PIPE	411	907	SCROLL	2	1	R410A							14.0				-										

										111	AIF	JMP SC	HEDU	יבב (די	AIX 1 2)									
							GEOTHE	RMAL SOU	DCE SIDE	GUIDAN USA ARADEL	G PERFO	RMANCE				10/	ATER SID	E				SOUND	ELECTR	RICAL
TAG	CAPA	CITY	000	EV	VT	LV		FLO			. DROP		EV	VT	LV		FLO		PRESS	. DROP		POWER	POWER SUPPLY	
	kW	мвн	COP	С	F	С	F	LPS	GPM	М	FT	FLUID	С	F	С	F	LPS	GPM	М	FT	FLUID	dBA	V / PH / HZ	MCA / MOC
HP-1	119.8	409.0	3	1.7	35	-2.8	27	4.6	73.2	1.86	6.10	25% PROP.	43.4	110.0	48.9	120.0	5.2	82.6	1.4	4.7	WATER	79	575/3/60	58 / 70
HP-2	62.1	212.0	3.23	1.7	35	-2.8	27	2.4	38.4	2.93	9.60	25% PROP.	43.4	110.0	48.9	120.0	2.7	42.8	2.8	9.1	WATER	82	575/3/60	35 / 40

						GLYCC	DL MAKE	UP UNI	T SCHE	DULE				
TAG	LOCATION	MANUFACTURER	MODEL	PUMP FLO	OW RATE GPM	PRESSUF kPa	RE RANGE PSI	RESERV	OIR SIZE GAL.	MOTOR HP	POWER V/PH/HZ	SHIPPING KG	WEIGHT LBS	REMARKS
G-1	MECHANICAL ROOM	BELL & GOSSETT	GMU-30	0.63	10	21 - 207	3 - 30	208	55	1/2	115/1/60	73	160	

ALL MEASUREMENTS ARE TO BE VERIFIED BY THE CONTRACTOR ON SITE AND ANY DISCREPANCIES ARE TO BE REPORTED BEFORE PROCEEDING WITH THE WORK. THE REGION OF DURHAM ASSUMES NO RESPONSIBILITY FOR THE ACCURACY OF THE LOCATION OF EXISTING SERVICES AS INDICATED ON THIS DRAWING. DO NOT SCALE DRAWINGS.

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SUB CONSULTANT

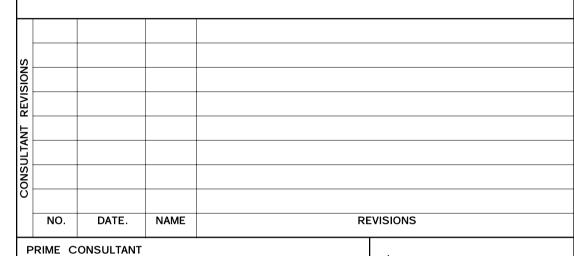DESIGN BY: Designer DATE: 06/15/21 CHECKED BY: Checker CONSULTANT PROJECT NO. 60611569 APPROVED BY: Approver CLIENT FILE No.: 811/20

ISSUED FOR TENDER 0 09/22/21 NO DATE NAME





#### THE REGIONAL MUNICIPALITY OF DURHAM


WORKS DEPARTMENT


DESIGN, CONSTRUCTION & ASSET MANAGEMENT

PROPERTY NO.	FACILITIES CODE	FACILITIES PROJECT NO. P061-18-01
CONTRACT NO.	DRAWING NO.	SHEET NO.
T- 1160- 2021	M- 704	

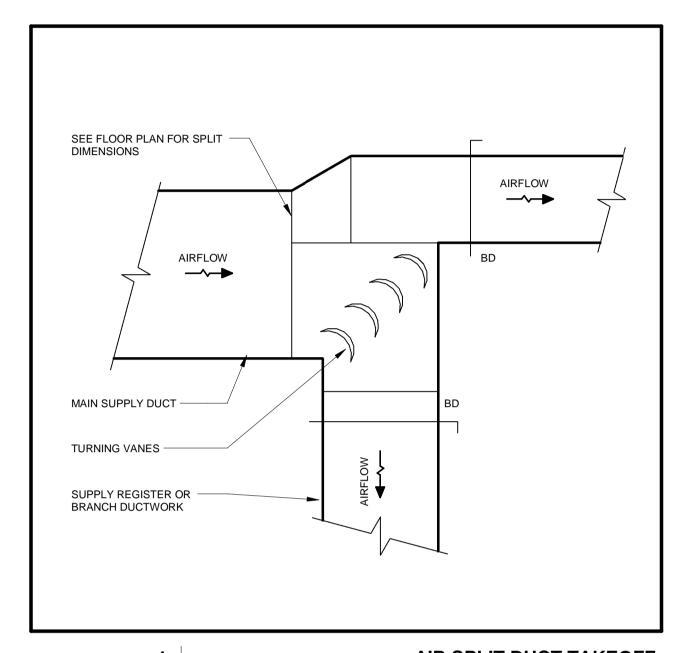

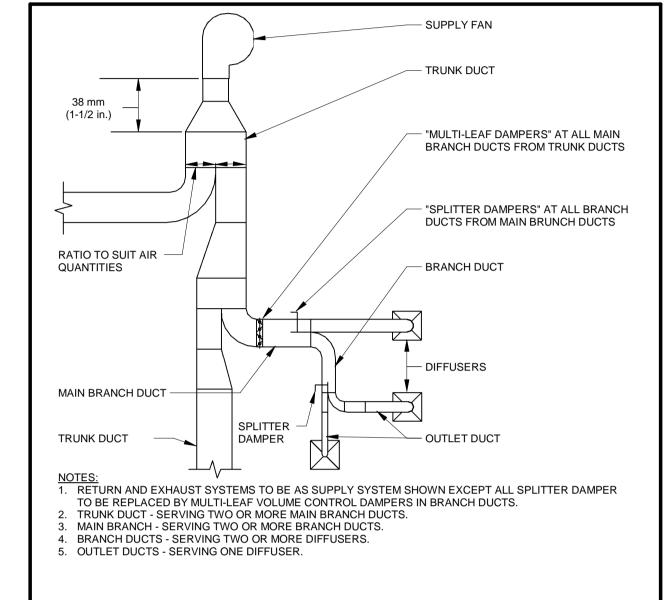


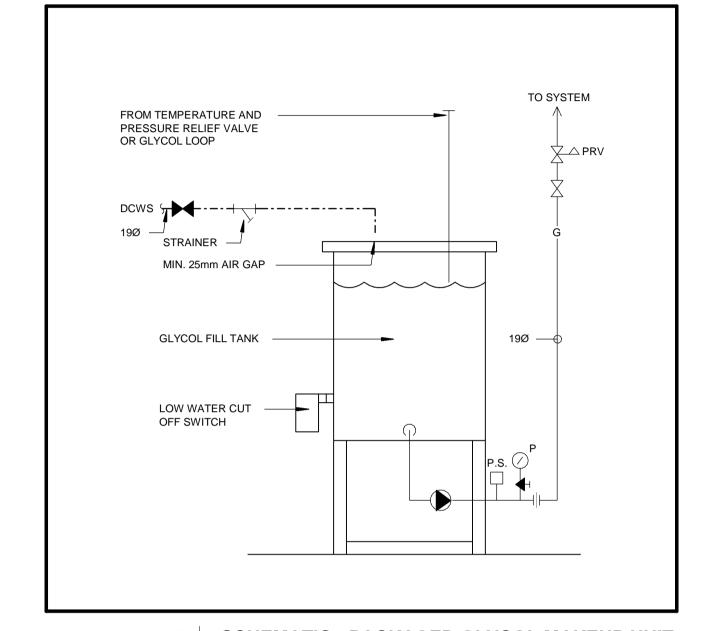

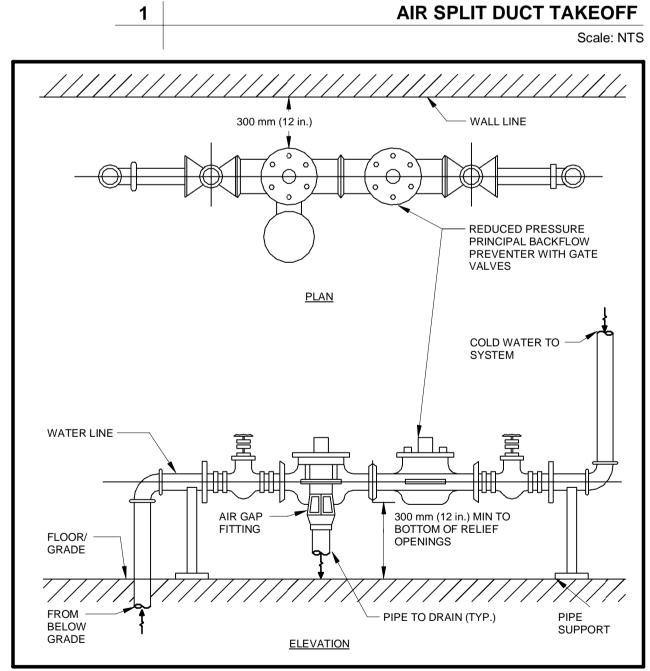


**BACKFLOW PREVENTER PIPING DETAIL** 

Scale: NTS

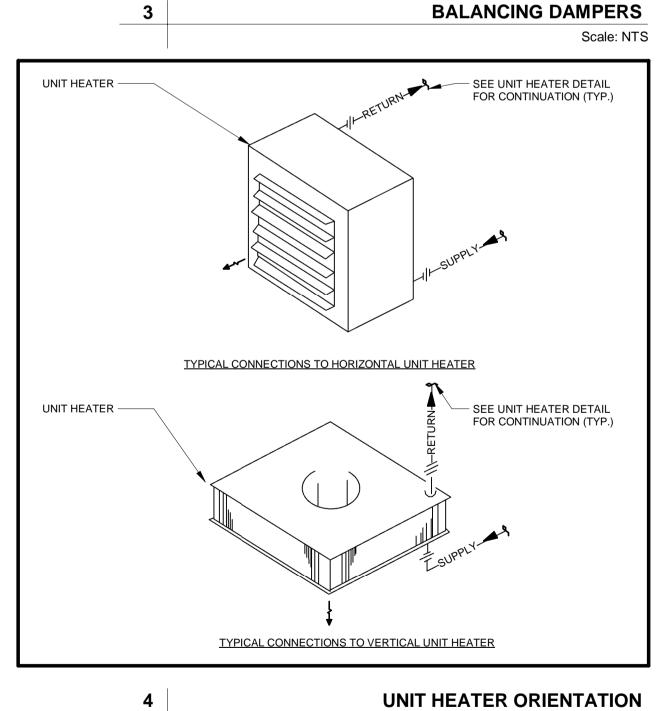

Scale: NTS

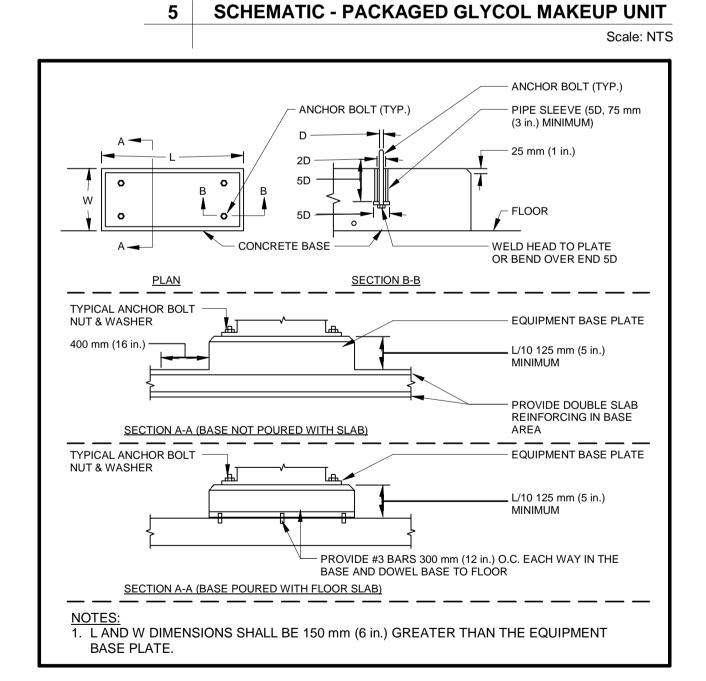


6 CONCRETE EQUIPMENT BASES

Scale: NTS

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0 09/22/21

NO DATE NAME

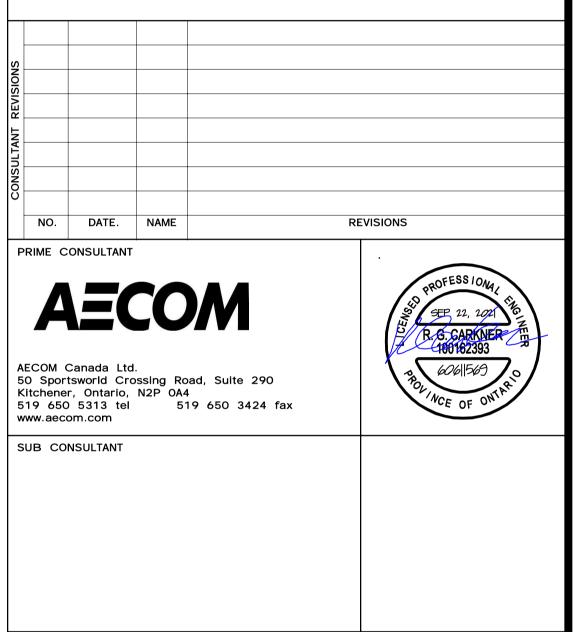DESIGN BY: Designer

DRAWN BY: Author

CHECKED BY: Checker

APPROVED BY: Approver

## THE REGIONAL MUNICIPALITY OF DURHAM

SCALE: As indicated

CLIENT FILE No.: 811/20

REVISIONS

CONSULTANT PROJECT NO. 60611569

DATE: 10/27/20


WORKS DEPARTMENT


DESIGN, CONSTRUCTION & ASSET MANAGEMENT

## NEW SEATON PARAMEDIC STATION AND TRAINING FACILITY IN PICKERING MECHANICAL STANDARD DETAILS


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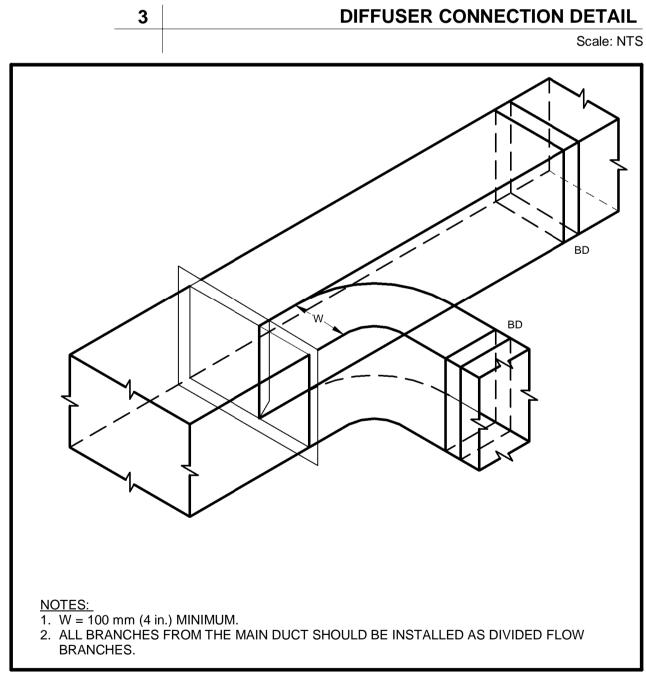
PROPERTY NO.	FACILITIES CODE	FACILITIES PROJECT NO. P061-18-01
CONTRACT NO.	DRAWING NO.	SHEET NO.
T- 1160- 2021	M- 800	



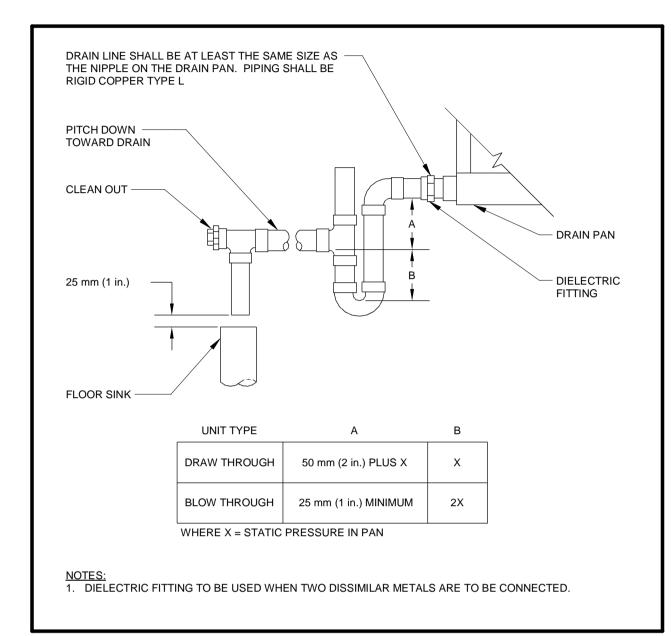


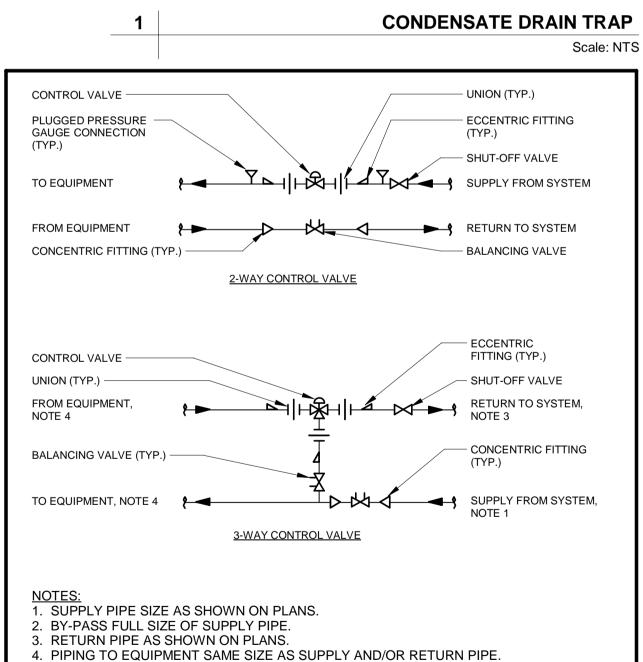




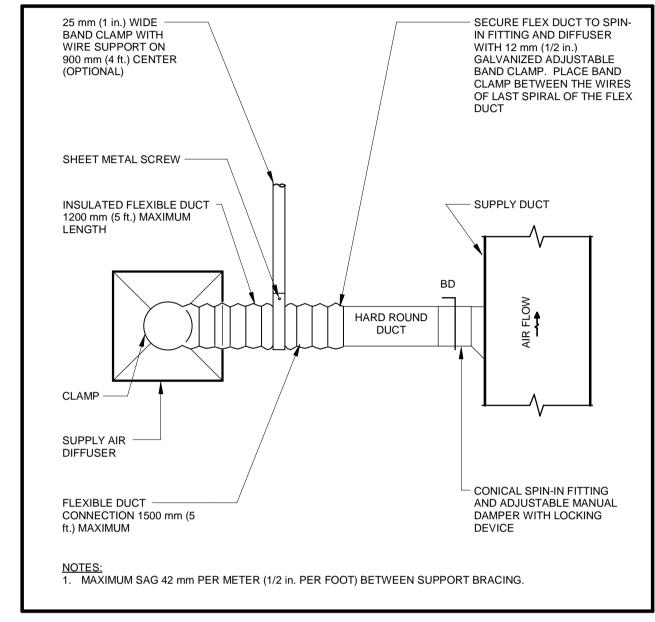

4 DIVIDED FLOW BRANCH TYPE 1
Scale: NTS

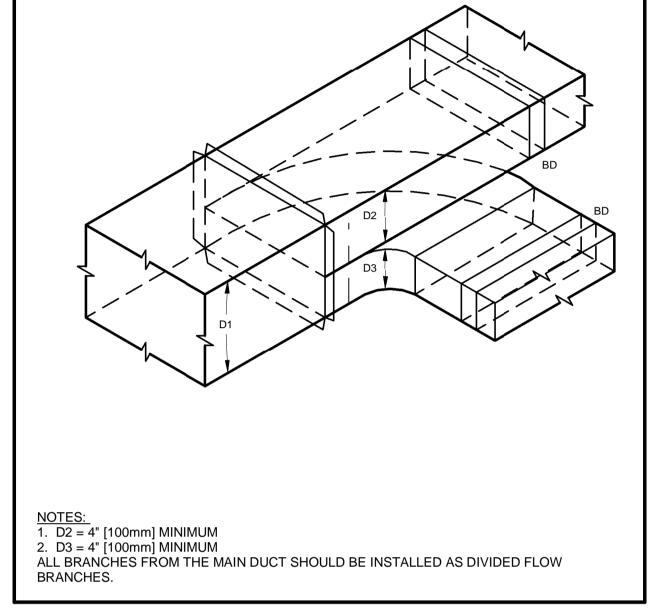



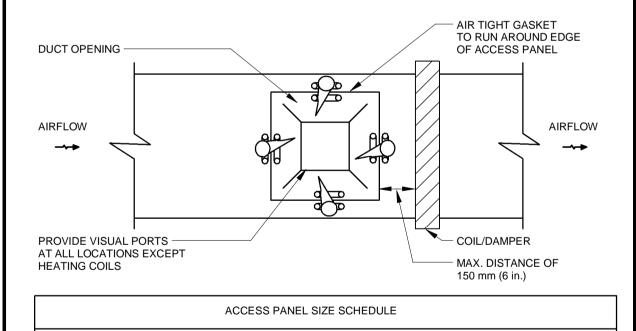

ACCESS P	PANEL SIZE SCHEDULE
DUCT DEPTH	ACCESS PANEL SIZE
150 mm (6 in.) TO 375 mm (15 in.)	250 mm (10 in.) W x (DUCT DEPTH - 50 mm (2 in.))D
375 mm (15 in.) TO 525 mm (21 in.)	300 mm (12 in.) W x (DUCT DEPTH - 50 mm (2 in.))D
525 mm (21 in.) AND ABOVE	450 mm (18 in.) W x (DUCT DEPTH - 50 mm(2 in.))D


### NOTES: 1. MAXIMUM ACCESS PANEL DIMENSION OF 600 mm (24 in.).

USE CAM LATCHES ON ACCESS PANELS
 FOLLOW SMACNA FOR ACCEPTABLE TYPE AND CONTRUCTION STANDARDS

6 DUCT ACCESS PANEL SIZING
Scale: NTS

ALL MEASUREMENTS ARE TO BE VERIFIED BY THE CONTRACTOR ON SITE AND ANY DISCREPANCIES ARE TO BE REPORTED BEFORE PROCEEDING WITH THE WORK. THE REGION OF DURHAM ASSUMES NO RESPONSIBILITY FOR THE ACCURACY OF THE LOCATION OF EXISTING SERVICES AS INDICATED ON THIS DRAWING. DO NOT SCALE DRAWINGS.

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SUB CONSULTANT

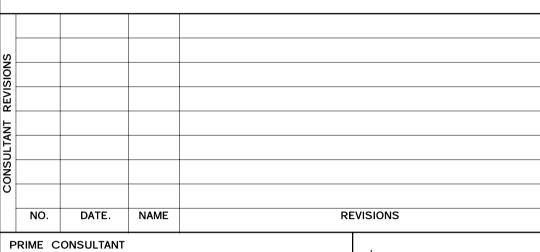

DESIGN BY: Designer

SCALE: As indicated

DRAWN BY: Author

DATE: 10/28/20

CHECKED BY: Checker

CONSULTANT PROJECT NO. 60611569

APPROVED BY: Approver

CLIENT FILE No.: 811/20





## THE REGIONAL MUNICIPALITY OF DURHAM

WORKS DEPARTMENT

DESIGN, CONSTRUCTION & ASSET MANAGEMENT

PROPERTY NO.	FACILITIES CODE	FACILITIES PROJECT NO. P061-18-01				
CONTRACT NO.	DRAWING NO.	SHEET NO.				
T- 1160- 2021	M- 801					

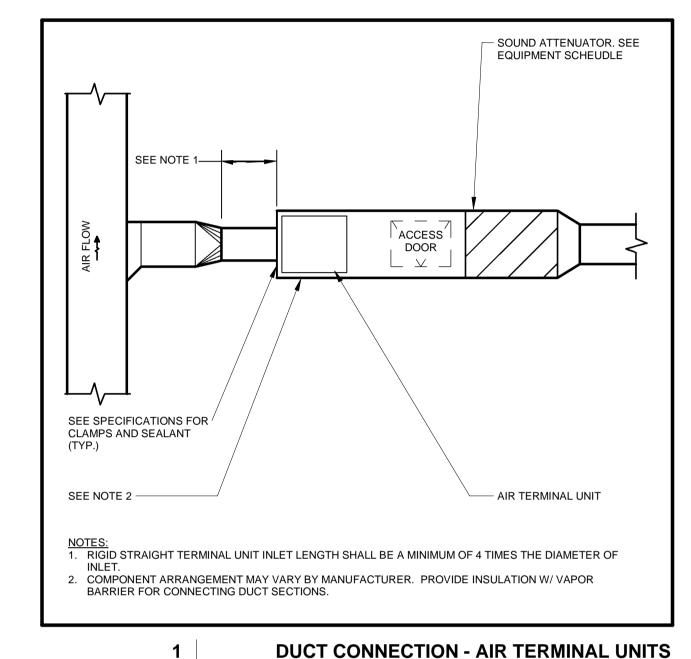

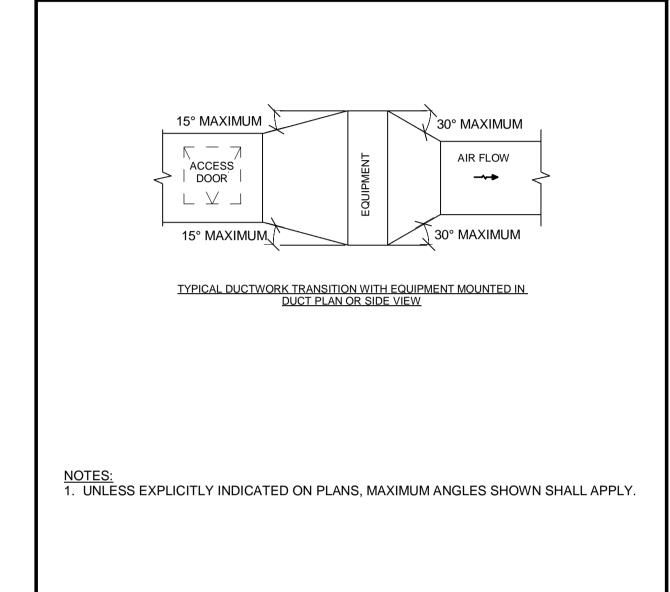

STRAPS OR -ISOLATOR HANGERS

PER SPECIFICATIONS

WALL SLEEVE ---

PACK ANNULAR SPACE COMPLETELY WITH MINERAL FIBER. RECESS

FIBEROUS MATERIAL INTO SLEEVE 12


mm (1/2 in.) OR AS REQUIRED BY THE


U.L. SYSTEM FOR THE REQUIRED


SEALANT THICKNESS

**DUCT TAKE-OFF** 

Scale: NTS

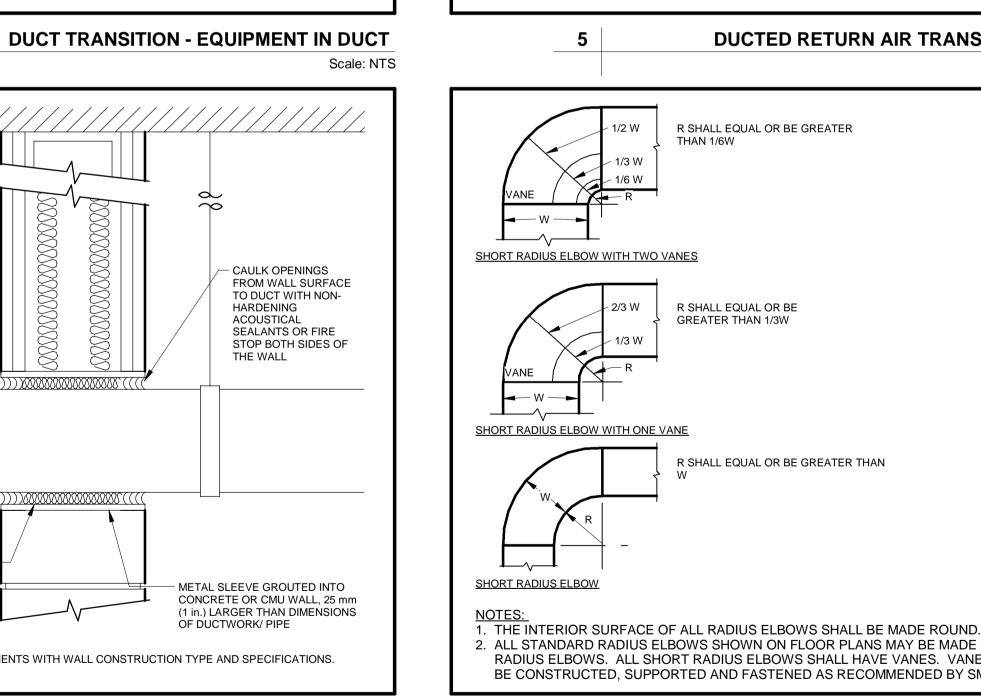

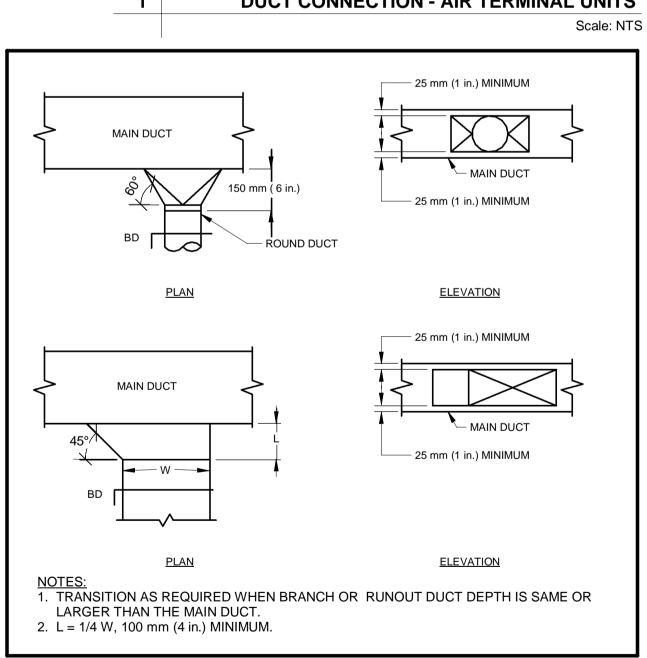

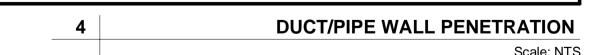

NOTES:

1. CONFIRM FIRE STOPPING REQUIREMENTS WITH WALL CONSTRUCTION TYPE AND SPECIFICATIONS.

- CAULK OPENINGS


ACOUSTICAL


THE WALL

OF DUCTWORK/ PIPE

TO DUCT WITH NON-

SEALANTS OR FIRE

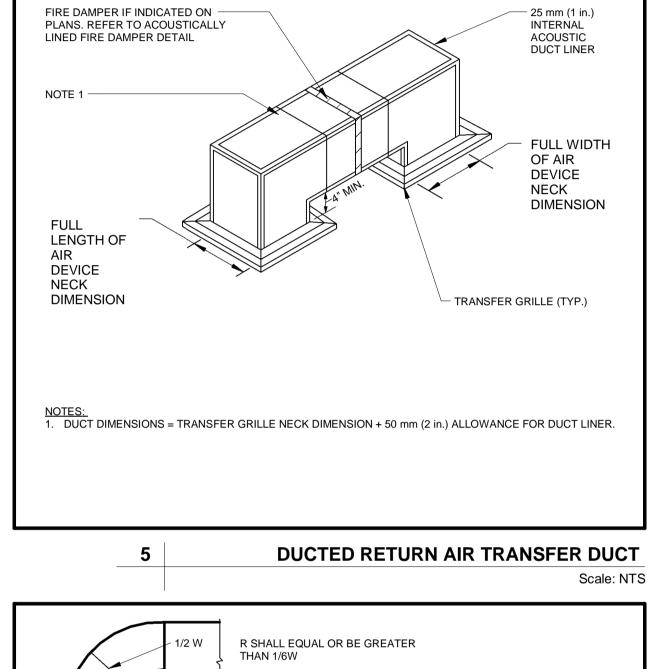


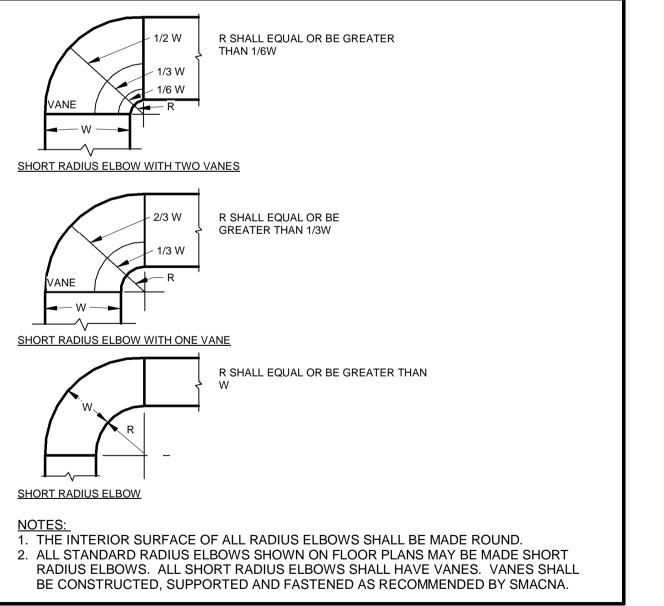

**DUCTWORK RADIUS ELBOW** Scale: NTS

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NEW SEATON PARAMEDIC STATION AND TRAINING FACILITY IN PICKERING MECHANICAL STANDARD DETAILS


THE REGIONAL MUNICIPALITY

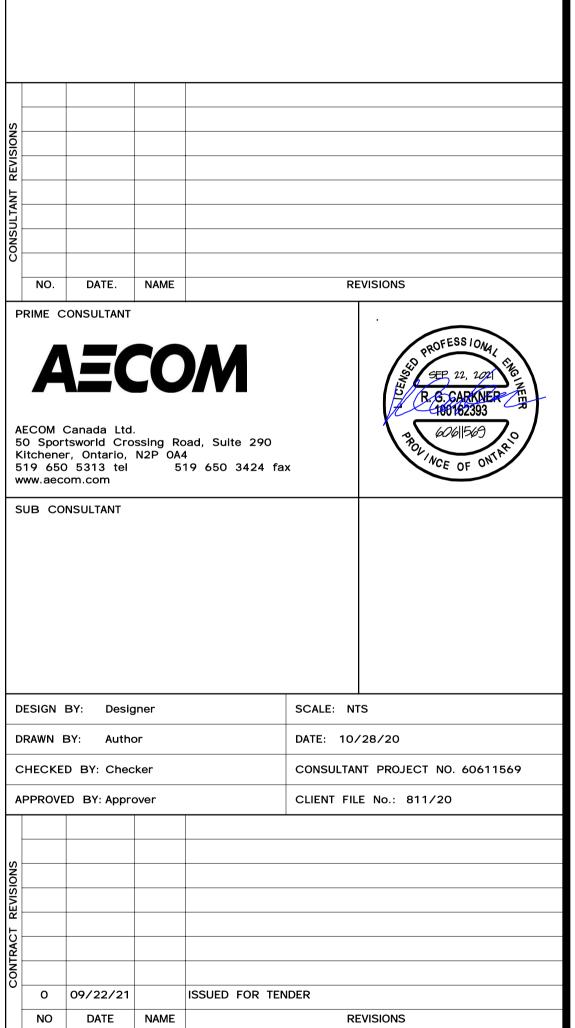
OF DURHAM


WORKS DEPARTMENT

DESIGN, CONSTRUCTION & ASSET MANAGEMENT

PROPERTY NO.	FACILITIES CODE	FACILITIES PROJECT NO. P061-18-01
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- LIFTING RING

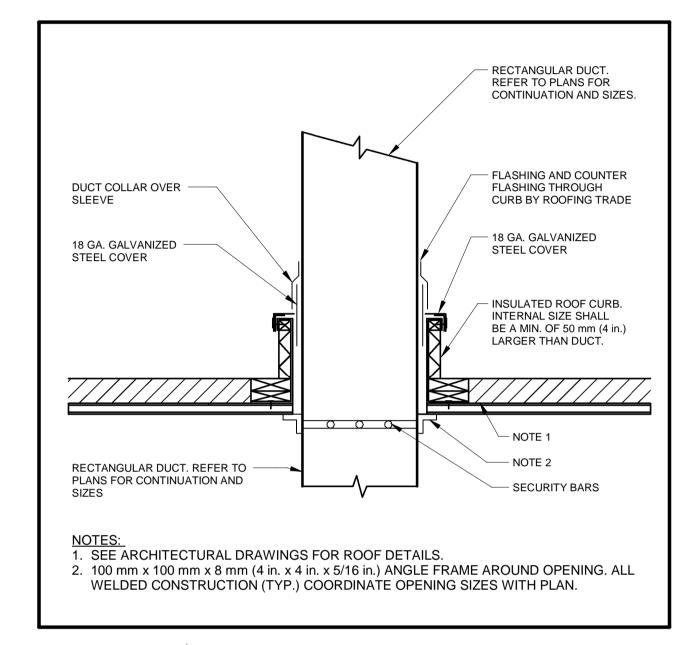NPT CHARGING VALVE

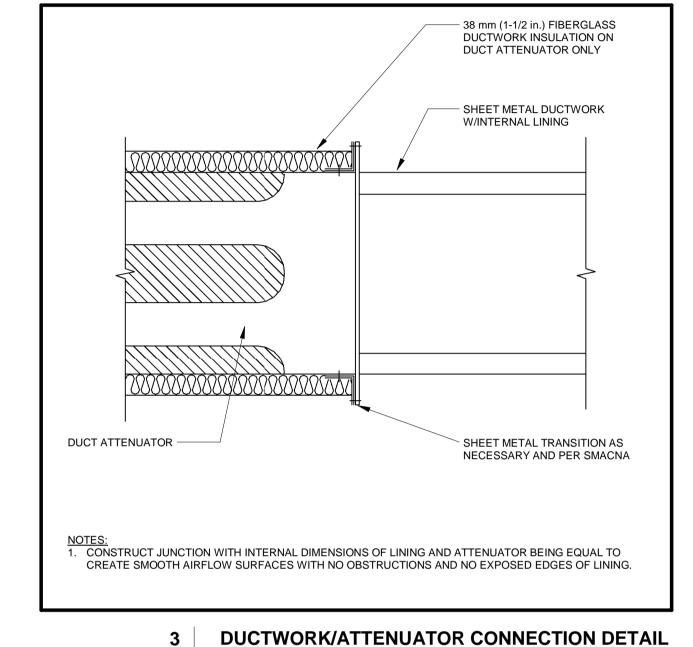FLOOR MOUNTED

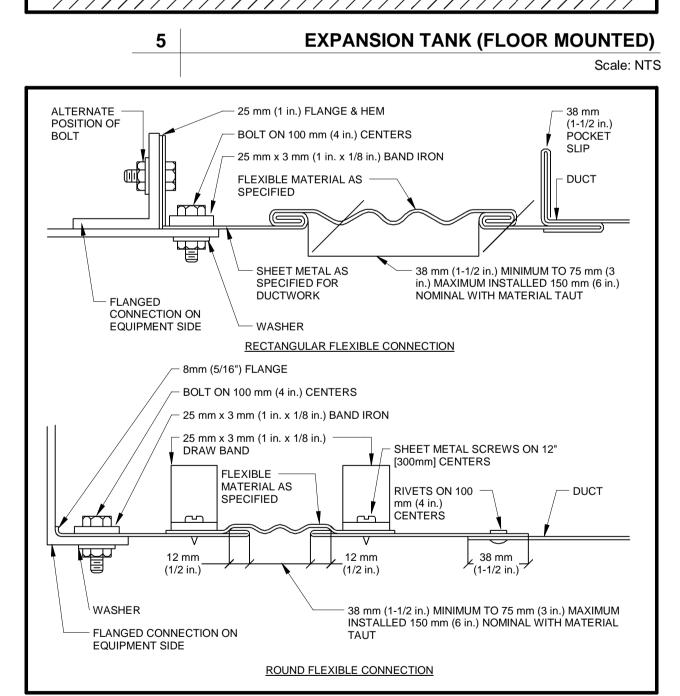LIFTING RING

**FLEXIBLE DUCT CONNECTIONS** 


Scale: NTS

HOUSEKEEPING PAD

**EXPANSION TANK** 



**DUCTWORK SQUARE VANE ELBOWS** 

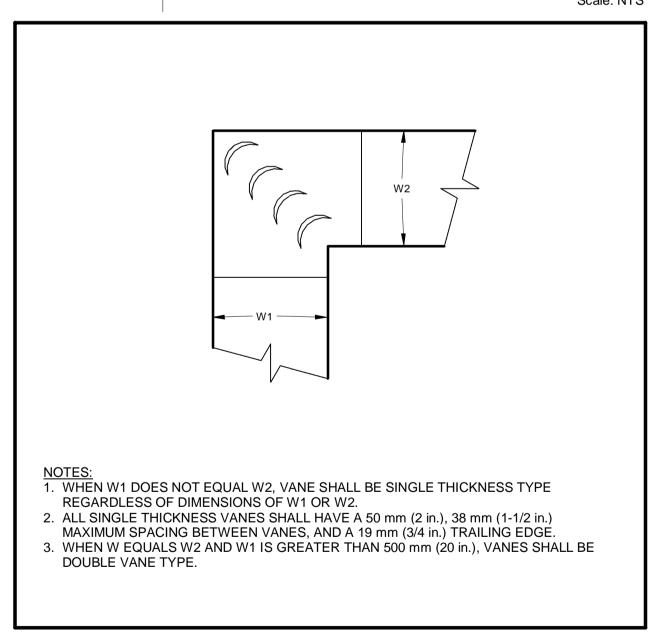


Scale: 1:5

UNION

FLOOR -

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SUB CONSULTANT

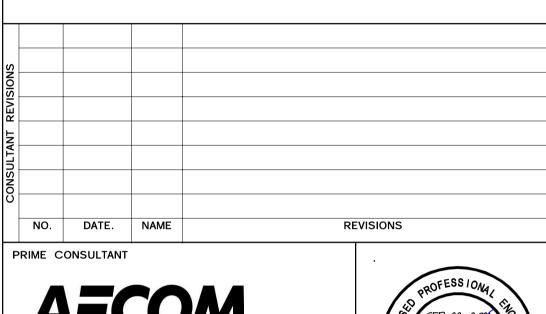DESIGN BY: Designer	SCALE: As Indicated
DRAWN BY: Author	DATE: 10/28/20
CHECKED BY: Checker	CONSULTANT PROJECT NO. 60611569
APPROVED BY: Approver	CLIENT FILE No.: 811/20

ISSUED FOR TENDER 0 09/22/21 NO DATE NAME REVISIONS



THE REGIONAL MUNICIPALITY OF DURHAM

WORKS DEPARTMENT


DESIGN, CONSTRUCTION & ASSET MANAGEMENT


### NEW SEATON PARAMEDIC STATION AND TRAINING FACILITY IN PICKERING MECHANICAL STANDARD DETAILS


PROPERTY NO.	FACILITIES CODE	FACILITIES PROJECT NO. P061-18-01	
CONTRACT NO.	DRAWING NO.	SHEET NO.	
T- 1160- 2021	M- 803		


**DETAIL - IN-FLOOR HEATING MANIFOLD** Scale: NTS


TO THERMOSTAT SHUT OFF VALVES -MOTORIZED ACTUATOR, TYP. END CAP WITH VENT ~ PRESSURE BYPASS MANIFOLD KIT SUPPLY AND RETURN MANIFOLDS CABINET BY RADIANT HEATING MANUFACTURER 13mm ID PEX OXYGEN BARRIER PIPES

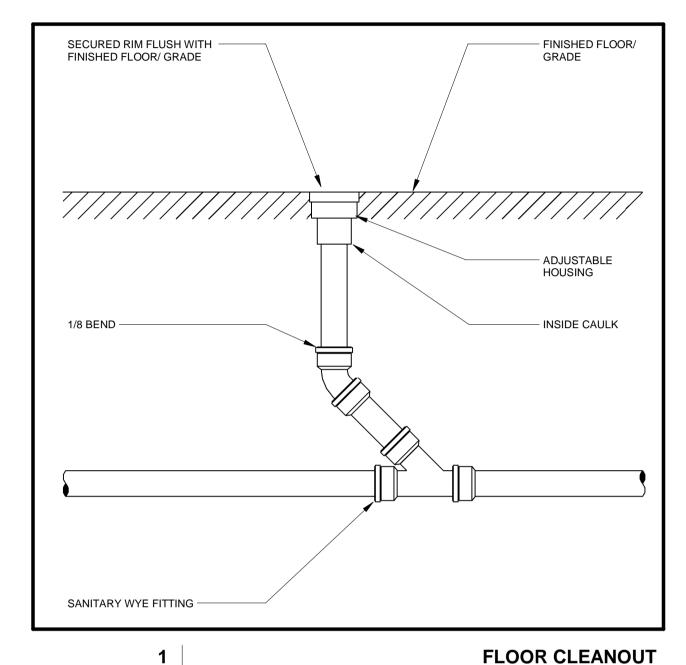


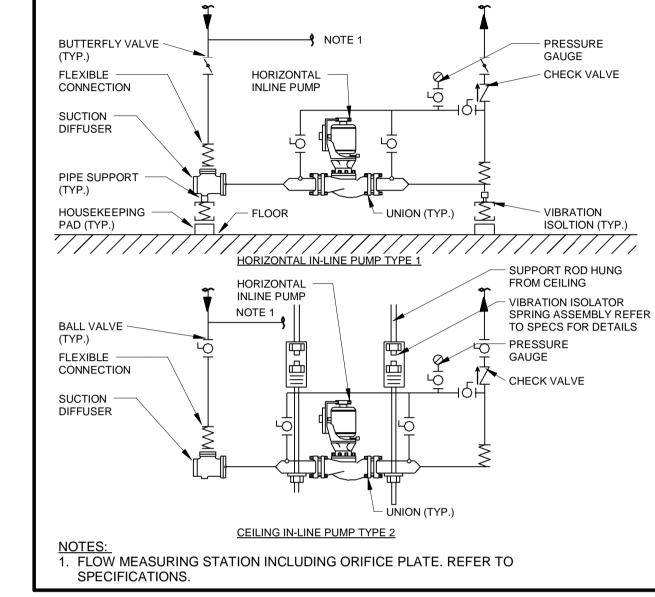

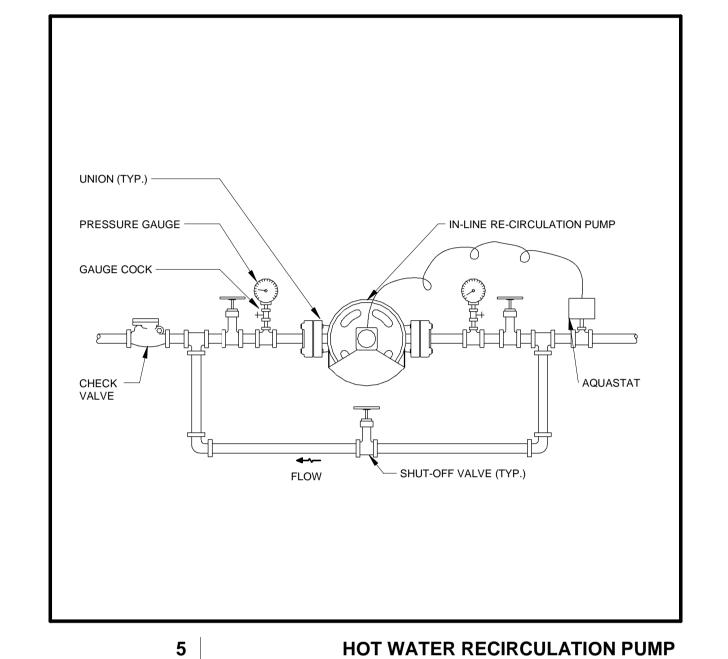

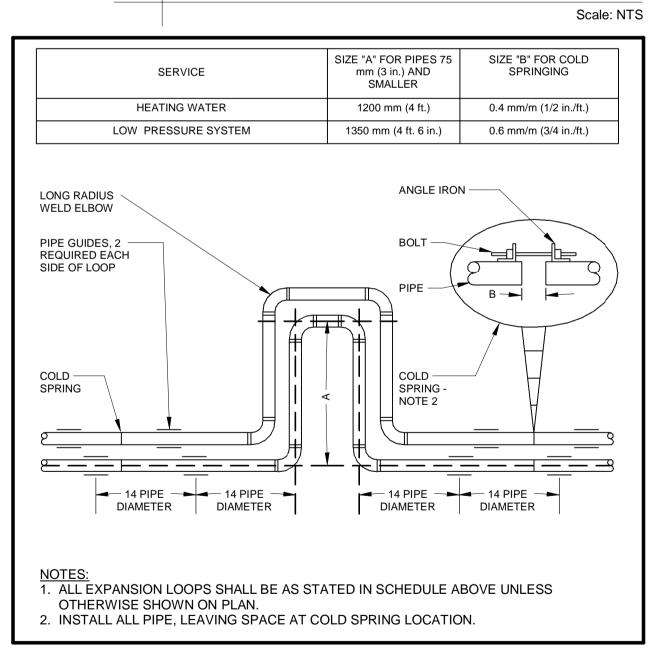

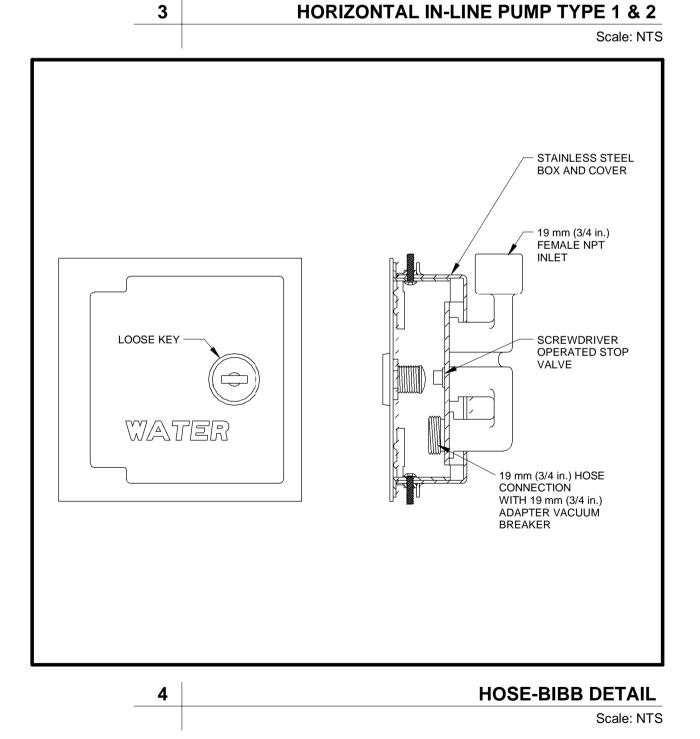

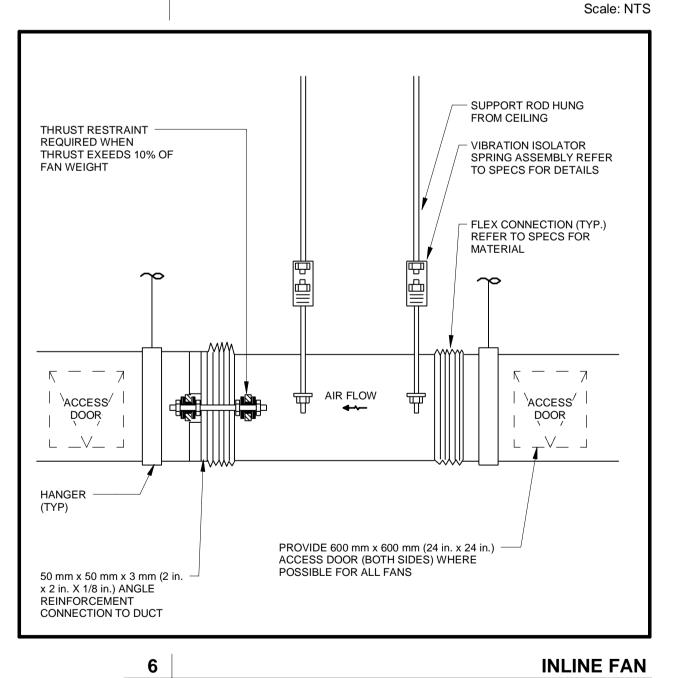



Scale: NTS

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ALL MEASUREMENTS ARE TO BE VERIFIED BY THE CONTRACTOR



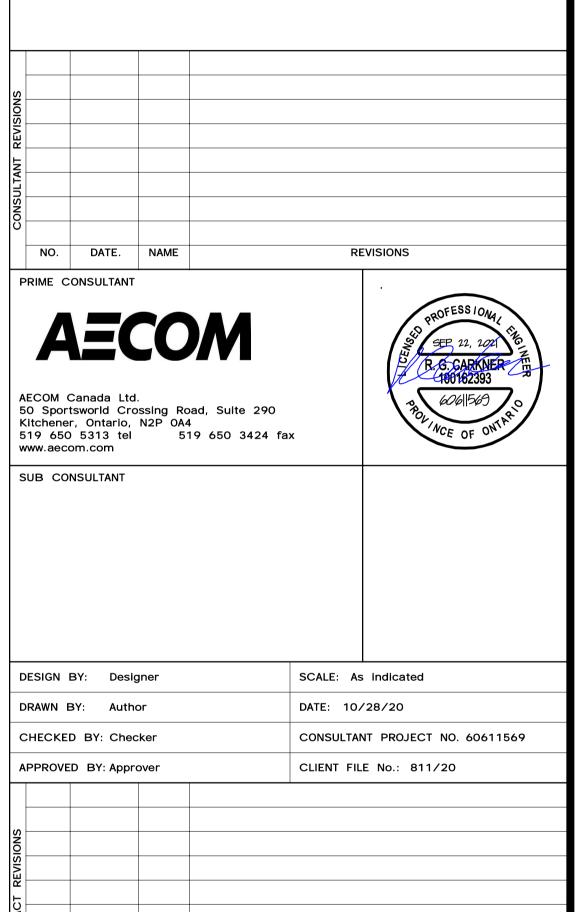

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## THE REGIONAL MUNICIPALITY OF DURHAM

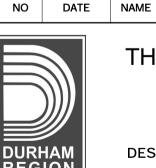REVISIONS

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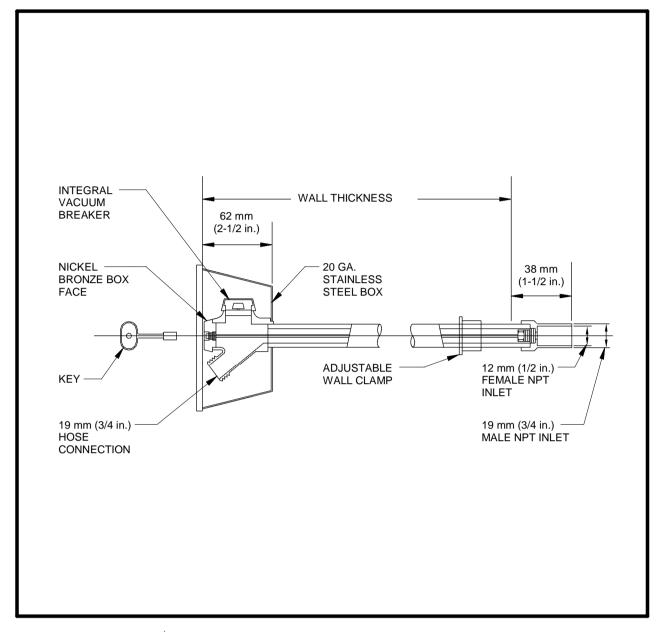
DESIGN, CONSTRUCTION & ASSET MANAGEMENT


## NEW SEATON PARAMEDIC STATION AND TRAINING FACILITY IN PICKERING MECHANICAL STANDARD DETAILS

ISSUED FOR TENDER


PROPERTY NO.	FACILITIES CODE	FACILITIES PROJECT NO. P061-18-01
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T- 1160- 2021	M- 804	

2 HEATING PIPING EXPANSION LOOP DETAIL
Scale: NTS



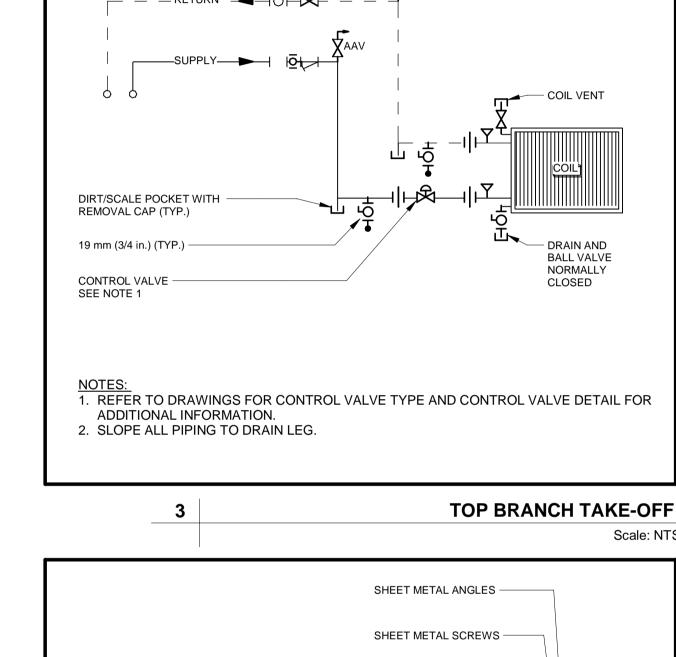

NORMALLY OPEN (TYP.) -

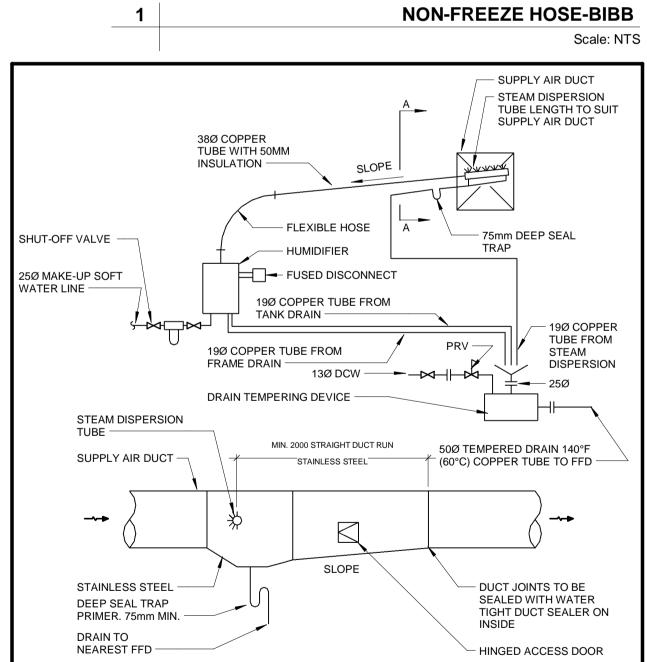

**DUCT MOUNTED HUMIDIFIER DETAIL** 

Scale: NTS


460 mm (18 in.) NOTE 1 **←** W — **►** - INTAKE OR EXHAUST DUCT NOTES: 1. ALL JOINTS SHALL BE WATERTIGHT.


3. FOLLOW SMACNA FOR ACCEPTABLE TYPE AND CONTRUCTION STANDARDS.

2. SEE DUCT ROOF PENETRATION DETAIL.

TYPICAL GOOSENECK Scale: NTS

Scale: NTS

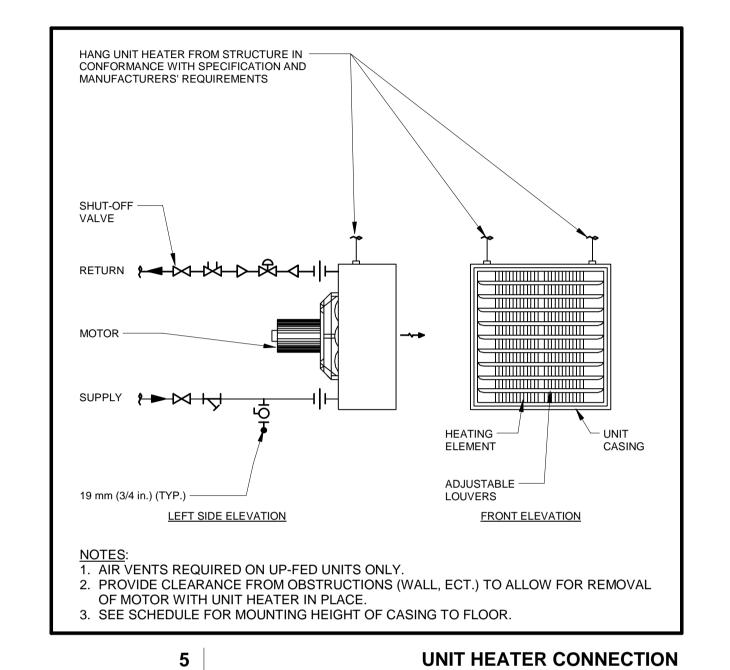


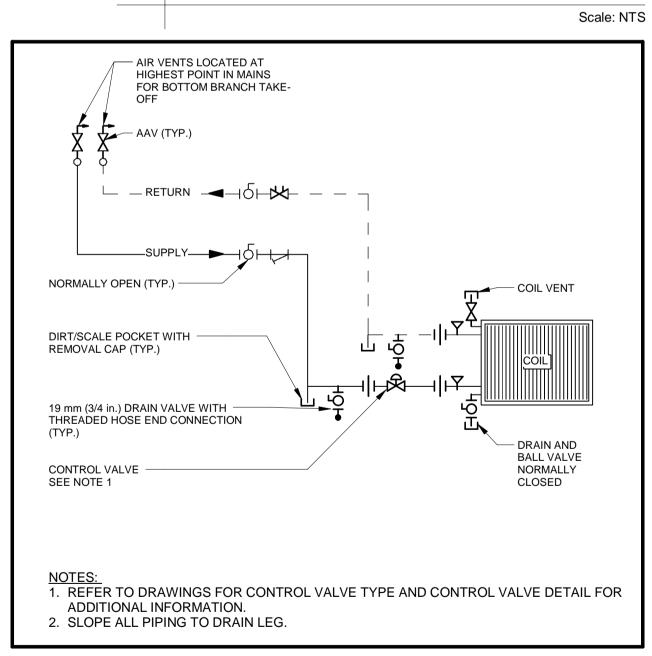

**BOTTOM BRANCH TAKE-OFF** Scale: NTS

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CHECKED BY: Checker			CONSUL	LTANT PROJECT NO. 60611569				
APPROVED BY: Approver			CLIENT	FILE No.: 811/20				
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EVIS								
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CONTRACT								
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	NO	DATE	NAME					REVISIONS

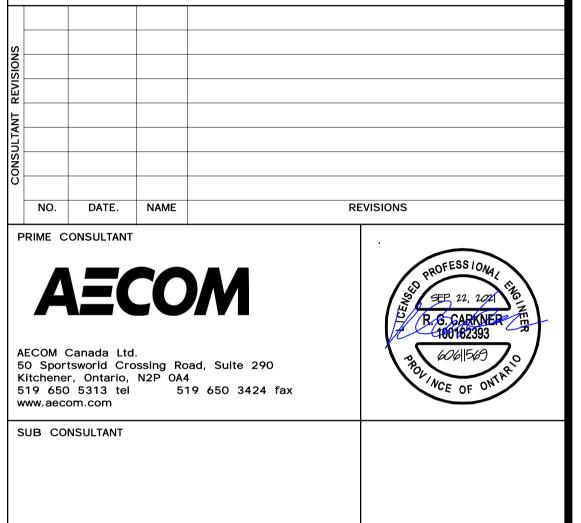

DESIGN BY: Designer

DRAWN BY: Author

#### THE REGIONAL MUNICIPALITY OF DURHAM

SCALE: As indicated

DATE: 10/28/20

WORKS DEPARTMENT DESIGN, CONSTRUCTION & ASSET MANAGEMENT

NEW SEATON PARAMEDIC STATION AND TRAINING FACILITY IN PICKERING

MECHANICAL STANDARD DETAILS

PROPERTY NO.	FACILITIES CODE	FACILITIES PROJECT NO. P061-18-01
CONTRACT NO.	DRAWING NO.	SHEET NO.
T- 1160- 2021	M- 805	