

EROSION & SEDIMENT CONTROL GENERAL NOTES

- 1. PRIOR TO COMMENCEMENT OF ANY ON-SITE WORK/TOPSOIL STRIPPING, EROSION AND SEDIMENT CONTROL (ESC) MEASURES, AS PER APPROVED EROSION & SEDIMENT CONTROL PLAN, MUST BE INSTALLED TO PREVENT SURFACE RUNOFF FROM LEAVING THE SITE "UNTREATED". ALL ESC MEASURES ARE TO BE MAINTAINED UNTIL THE
- SITE HAS BEEN STABILIZED. 2. THE CONTRACTOR SHALL BE RESPONSIBLE FOR THE PROPER INSTALLATION, MAINTENANCE AND REMOVAL OF ALL TEMPORARY EROSION AND SEDIMENT CONTROL MEASURES DURING CONSTRUCTION, AS DIRECTED BY THE ENGINEER OR THE CITY OF PICKERING.

SEDIMENT CONTROL FENCE TO USE GEOTEXTILE WITH WEAVE DENSITY OF 270R TERRAFIX OR EQUIVALENT.

ALL EXPOSED SOILS SHALL BE IMMEDIATELY STABILIZED AS DIRECTED BY THE ENGINEER OR CITY OF PICKERING.

CHECK DAMS ARE TO BE USED IN ANY TEMPORARY DRAINAGE SWALES REQUIRED DURING THE CONSTRUCTION PERIOD.

ADDITIONAL EROSION AND SEDIMENT CONTROL MEASURES MAY BE REQUIRED AND SHALL BE DETERMINED BY THE ENGINEER OR THE CITY OF PICKERING. ALL SWALES ARE TO BE STABILIZED PRIOR TO USE. 8. INSPECTION OF THE PROPOSED EROSION AND SEDIMENT CONTROL MEASURES WILL OCCUR ON A WEEKLY BASIS, AFTER RAINFALL EVENTS EXCEEDING 10mm OR AFTER

RAPID SNOW MELT EVENTS AND DAILY DURING EXTENDED RAIN OR SNOW MELT PERIODS. THE SILT CONTROL FENCE MUST BE INSPECTED FOR RIPS OR TEARS, BROKEN STAKES. BLOW OUTS AND ACCUMULATION OF SEDIMENT. THE SILT CONTROL FENCE MUST BE FIXED AND/OR REPLACED IMMEDIATELY WHEN DAMAGED. ACCUMULATED SEDIMENT MUST BE REMOVED FROM THE SILT CONTROL FENCE WHEN ACCUMULATION REACHES 50% OF THE HEIGHT OF THE FENCE.

9. ROCK CHECK DAMS ARE TO BE CLEANED OF ALL ACCUMULATED SEDIMENT AS SOON AS SEDIMENT HAS ACCUMULATED TO A DEPTH GREATER THAN 50% OF ALL THE UPSTREAM CHECK DAMS. 10. CLEANING AND REPAIR OF MUD MATS AND ANY OTHER TEMPORARY SEDIMENT CONTROL MEASURES SHALL BE DONE AS NECESSARY THROUGH REGULAR INSPECTION OR AS DIRECTED BY THE ENGINEER OR CITY OF PICKERING. ALL DAMAGED ESC MEASURES SHALL BE REPAIRED AND/OR REPLACED WITHIN 48 HOURS OF THE

11. MATERIALS TO REPAIR DAMAGED ESC MEASURES MUST BE KEPT ON-SITE AT ALL TIMES. 12. THE ESC STRATEGIES ON THESE PLANS ARE NOT STATIC AND MAY NEED TO BE UPGRADED/AMENDED AS SITE CONDITIONS CHANGE TO PREVENT SEDIMENT

RELEASES. FAILED ESC MEASURE MUST BE REPAIRED IMMEDIATELY. 13. NO CONSTRUCTION ACTIVITY OR MACHINERY SHALL INTRUDE BEYOND THE SILT CONTROL FENCE OR LIMIT OR DEVELOPMENT. ALL CONSTRUCTION VEHICLES SHALL LEAVE THE SITE AT DESIGNATED LOCATIONS AS SHOWN ON THE PLANS. ALL MATERIALS AND EQUIPMENT SHALL BE STORED ON SITE IN A DESIGNATED AREA. NO MATERIALS OR EQUIPMENT SHALL BE STORE ON THE MUNICIPAL RIGHT OF WAY. NO CONSTRUCTION VEHICLES WILL PARK ON MUNICIPAL ROADS.

14. SERVICING OF CONSTRUCTION EQUIPMENT ON SITE IS PROHIBITED. 15. THE CONTRACTOR MUST CLEAN ADJACENT ROADS ON A REGULAR BASIS. THE ROAD SHALL BE, AT A MINIMUM SCRAPED DAILY AND FLUSHED (IF NECESSARY) ON

FRIDAY EVENINGS OR SATURDAY MORNINGS. 16. DUST CONTROL TO BE REVIEWED DAILY. WATER TRUCK OR CALCIUM CHLORIDE IS TO BE PROVIDED ON-SITE AND HAUL ROADS/WORKING AREAS ARE TO BE TREATED AS REQUIRED TO ENSURE THAT DUST IS CONTROLLED ON-SITE.


17. AT THE END OF CONSTRUCTION PERIOD, ACCUMULATED SEDIMENT IS TO BE REMOVED OFF SITE PRIOR TO THE REMOVAL OF THE SILT FENCE.

18. ALL LITTER AND DEBRIS SHALL BE MONITORED AND DISPOSED OF DAILY OR AS NECESSARY THROUGH REGULAR INSPECTION.

19. ALL TOPSOIL STOCKPILES SHALL BE SURROUNDED WITH SEDIMENT CONTROL FENCE AND STABILIZED WITH SEED MIX AS PER THIS DRAWING.

20. DISTURBED AREAS ARE TO BE MINIMIZED TO THE EXTENT POSSIBLE AND STABILIZED AS THE WORK PROGRESSES. ANY AREA EXPOSED FOR MORE THAN 30 DAYS

ALL MEASUREMENTS ARE TO BE VERIFIED BY THE CONTRACTOR ON SITE AND ANY DISCREPANCIES ARE TO BE REPORTED BEFORE PROCEEDING WITH THE WORK. THE REGION OF DURHAM ASSUMES NO RESPONSIBILITY FOR THE ACCURACY OF THE LOCATION OF EXISTING SERVICES AS INDICATED ON THIS DRAWING. DO NOT SCALE DRAWINGS.

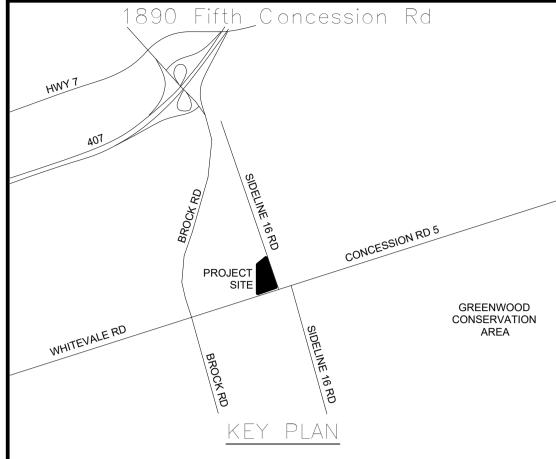

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SURVEY & BENCHMARK

SURVEY COMPLETED BY IBW SURVEYORS JULY 2018.

AVING A GEODETIC ELEVATION OF 151.957m.

RID BY MULTIPLYING BY THE COMBINED SCALE FACTOR OF 0.99986.

EVATIONS ARE GEODETIC AND REFERRED TO CITY OF PICKING BENCHMARK 4-031 AND

ESIGN BY: SM CALE: 1:500 RAWN BY: MB ATE: 22 September, 202 HECKED BY: SM ONSULTANT PROJECT NO. 60698928

LIENT FILE No.: 811/20



THE REGIONAL MUNICIPALITY OF DURHAM

WORKS DEPARTMENT


DESIGN, CONSTRUCTION & ASSET MANAGEMENT


NEW SEATON PARAMEDIC STATION AND TRAINING FACILITY IN PICKERING EROSION & SEDIMENT CONTROL CONSTRUCTION MANAGEMENT PLAN

PROPERTY NO.	FACILITIES CODE	FACILITIES PROJECT NO. PO61-18-01
CONTRACT NO. T-1160-2021	C - 101	SHEET NO.

LEGEND


o o o	PROPOSED SILT FENCE	
	PROPOSED STAGING LIMIT	
95889689	PROPOSED MUDMAT	
	EXISTING WETLAND BOUNDAR	
	EXISTING WETLAND SETBACK	
	EXISTING PROPERTY LINE	
BH12 152.73	EXISTING BOREHOLE	
G	EXISTING UNDERGROUND GAS	
—— ОН ———	EXISTING OVERHEAD HYDRO	
x x x	EXISTING FENCE	
152	EXISTING MAJOR CONTOUR	
151.5	EXISTING MINOR CONTOUR	
♦ H.P.	EXISTING HYDRO POLE	
	EXISTING DITCH LINE	
	EXISTING EDGE OF PAVEMEN	
4	OVERLAND FLOW	

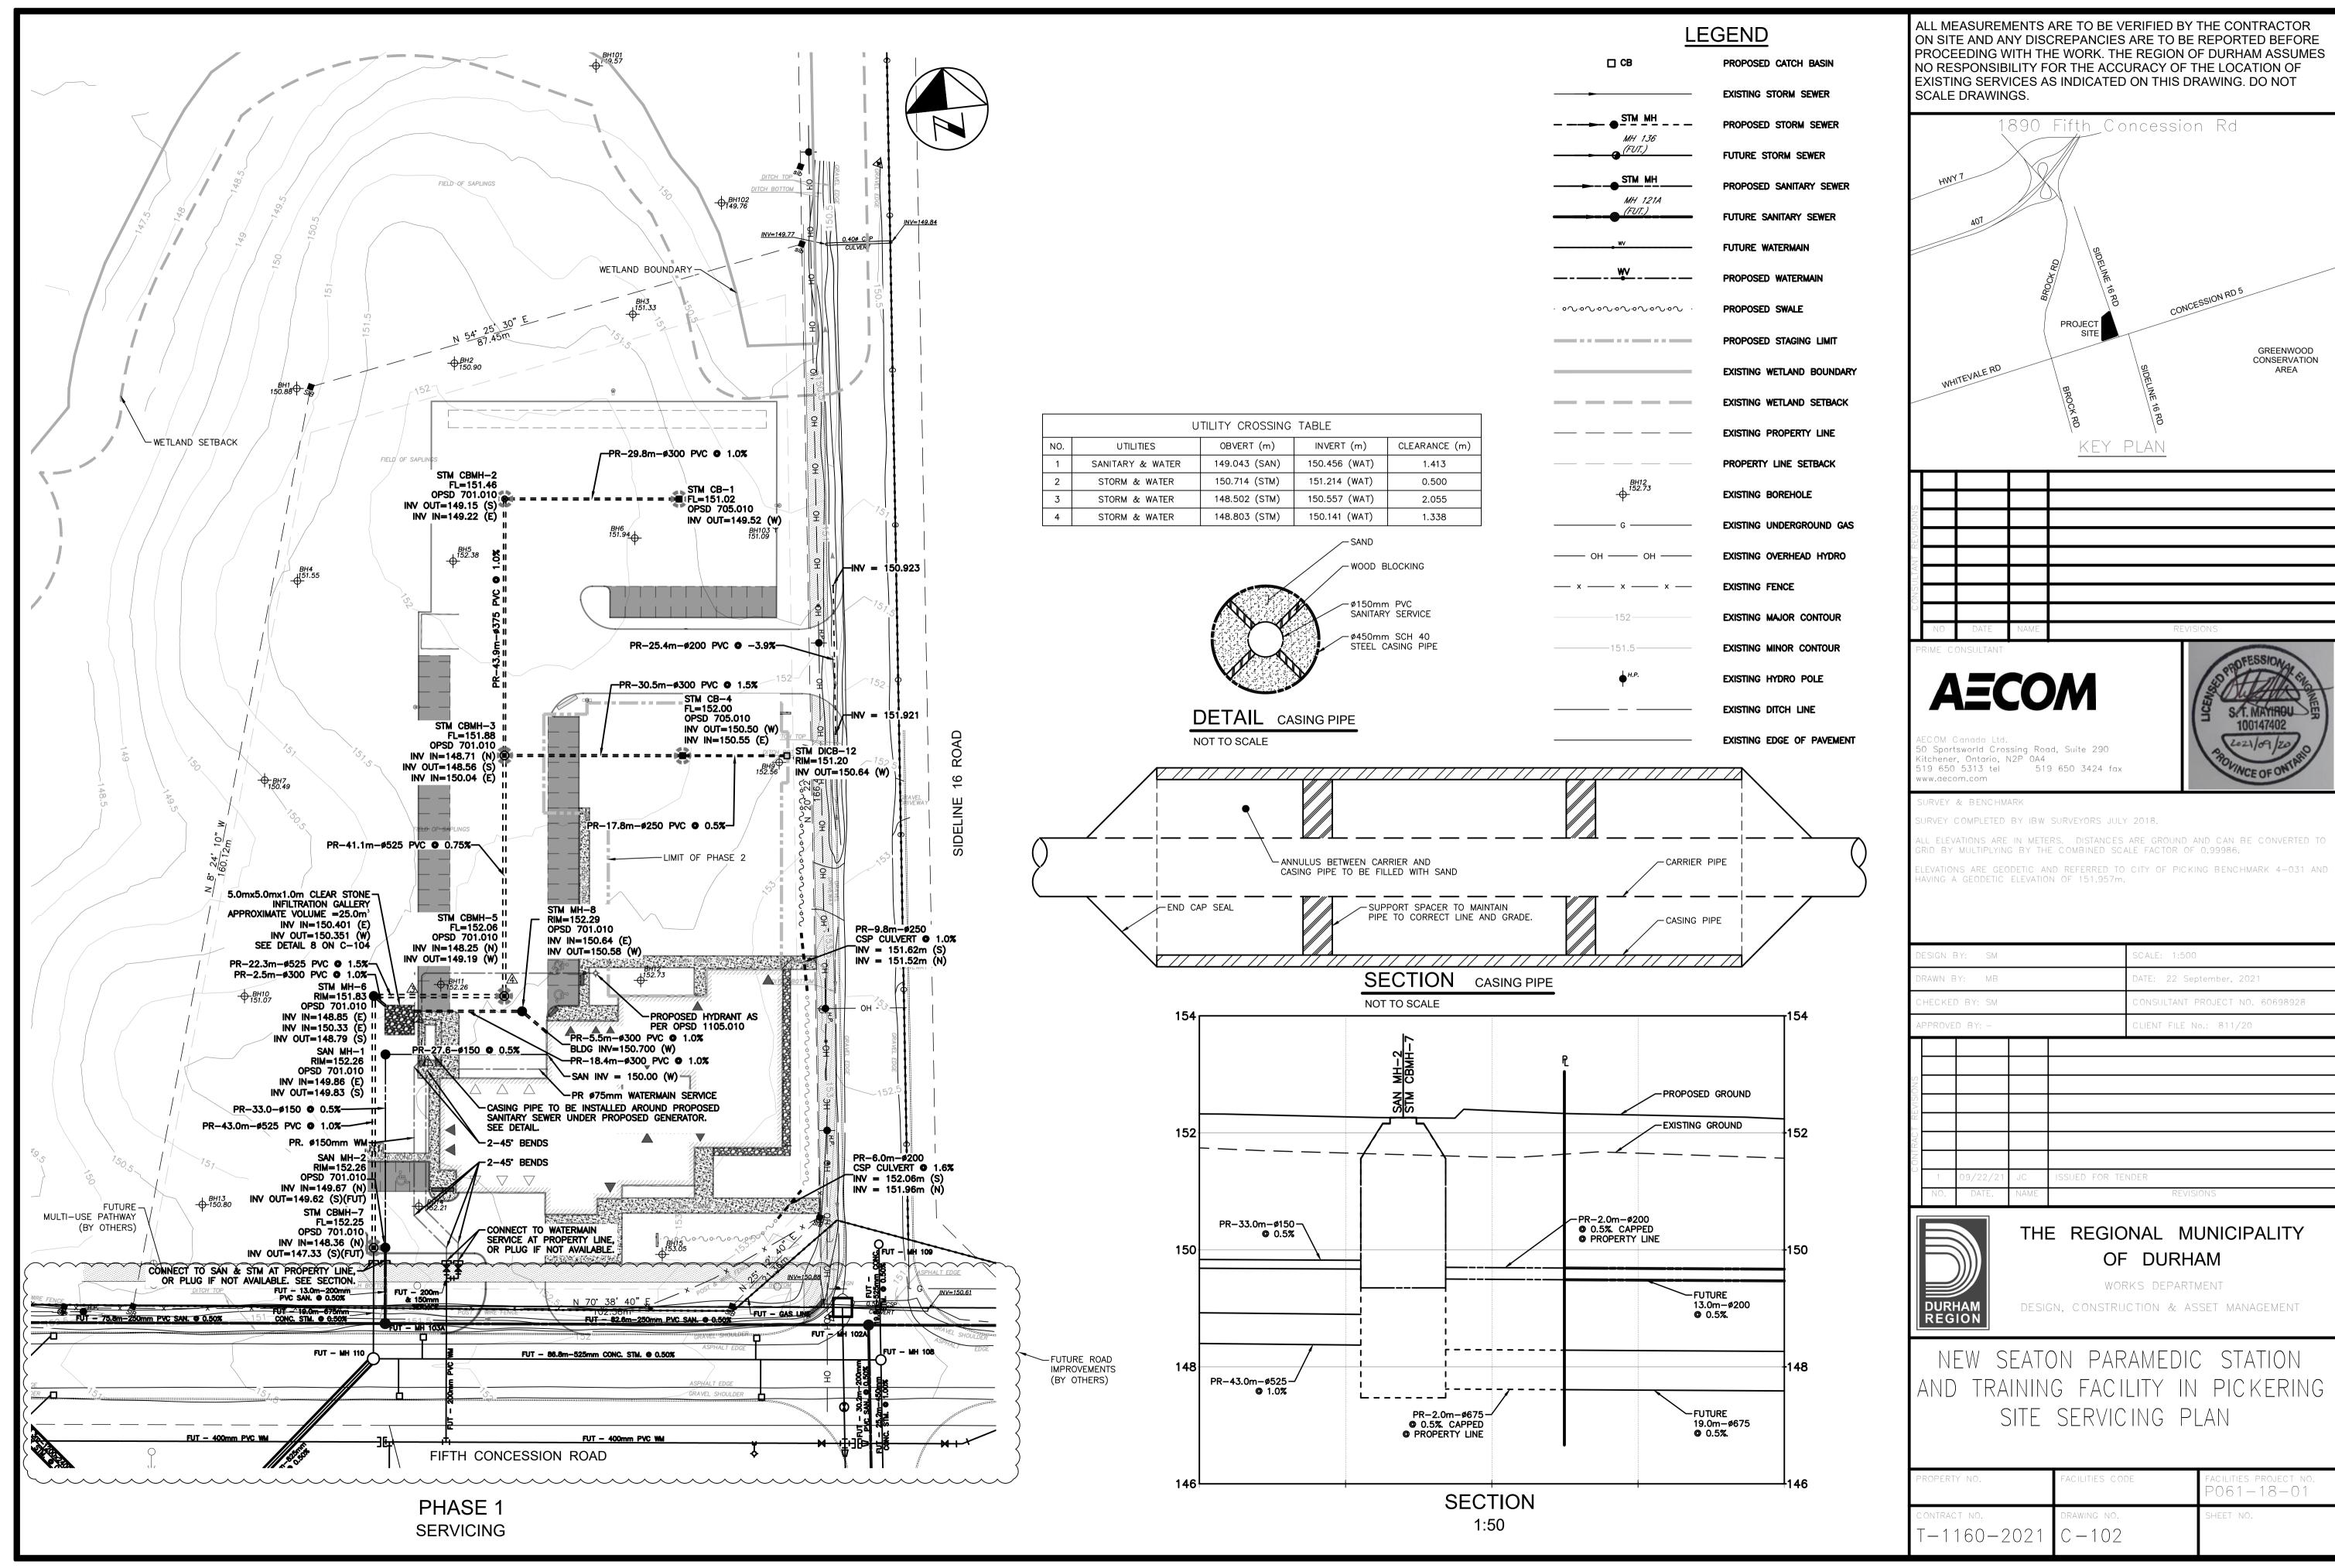

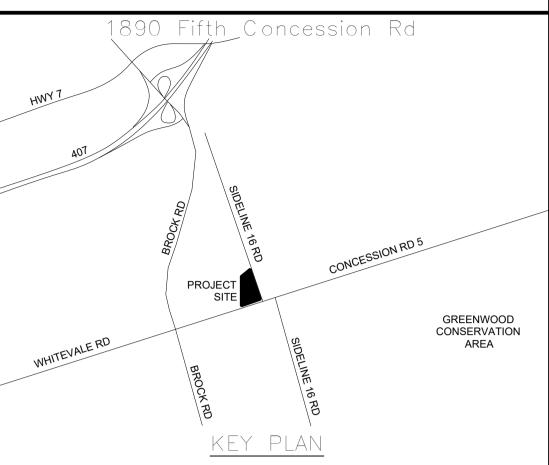

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D	DRAWN BY: MB				DATE: 22 September, 2021	
CHECKED BY: SM				CONSULTANT PROJECT NO. 60698928		
А	APPROVED BY: -				CLIENT FILE No.: 811/20	
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PROPERTY NO.	FACILITIES CODE	FACILITIES PROJECT NO. P061-18-01	
CONTRACT NO.	DRAWING NO.	SHEET NO.	
T-1160-2021	C-102		

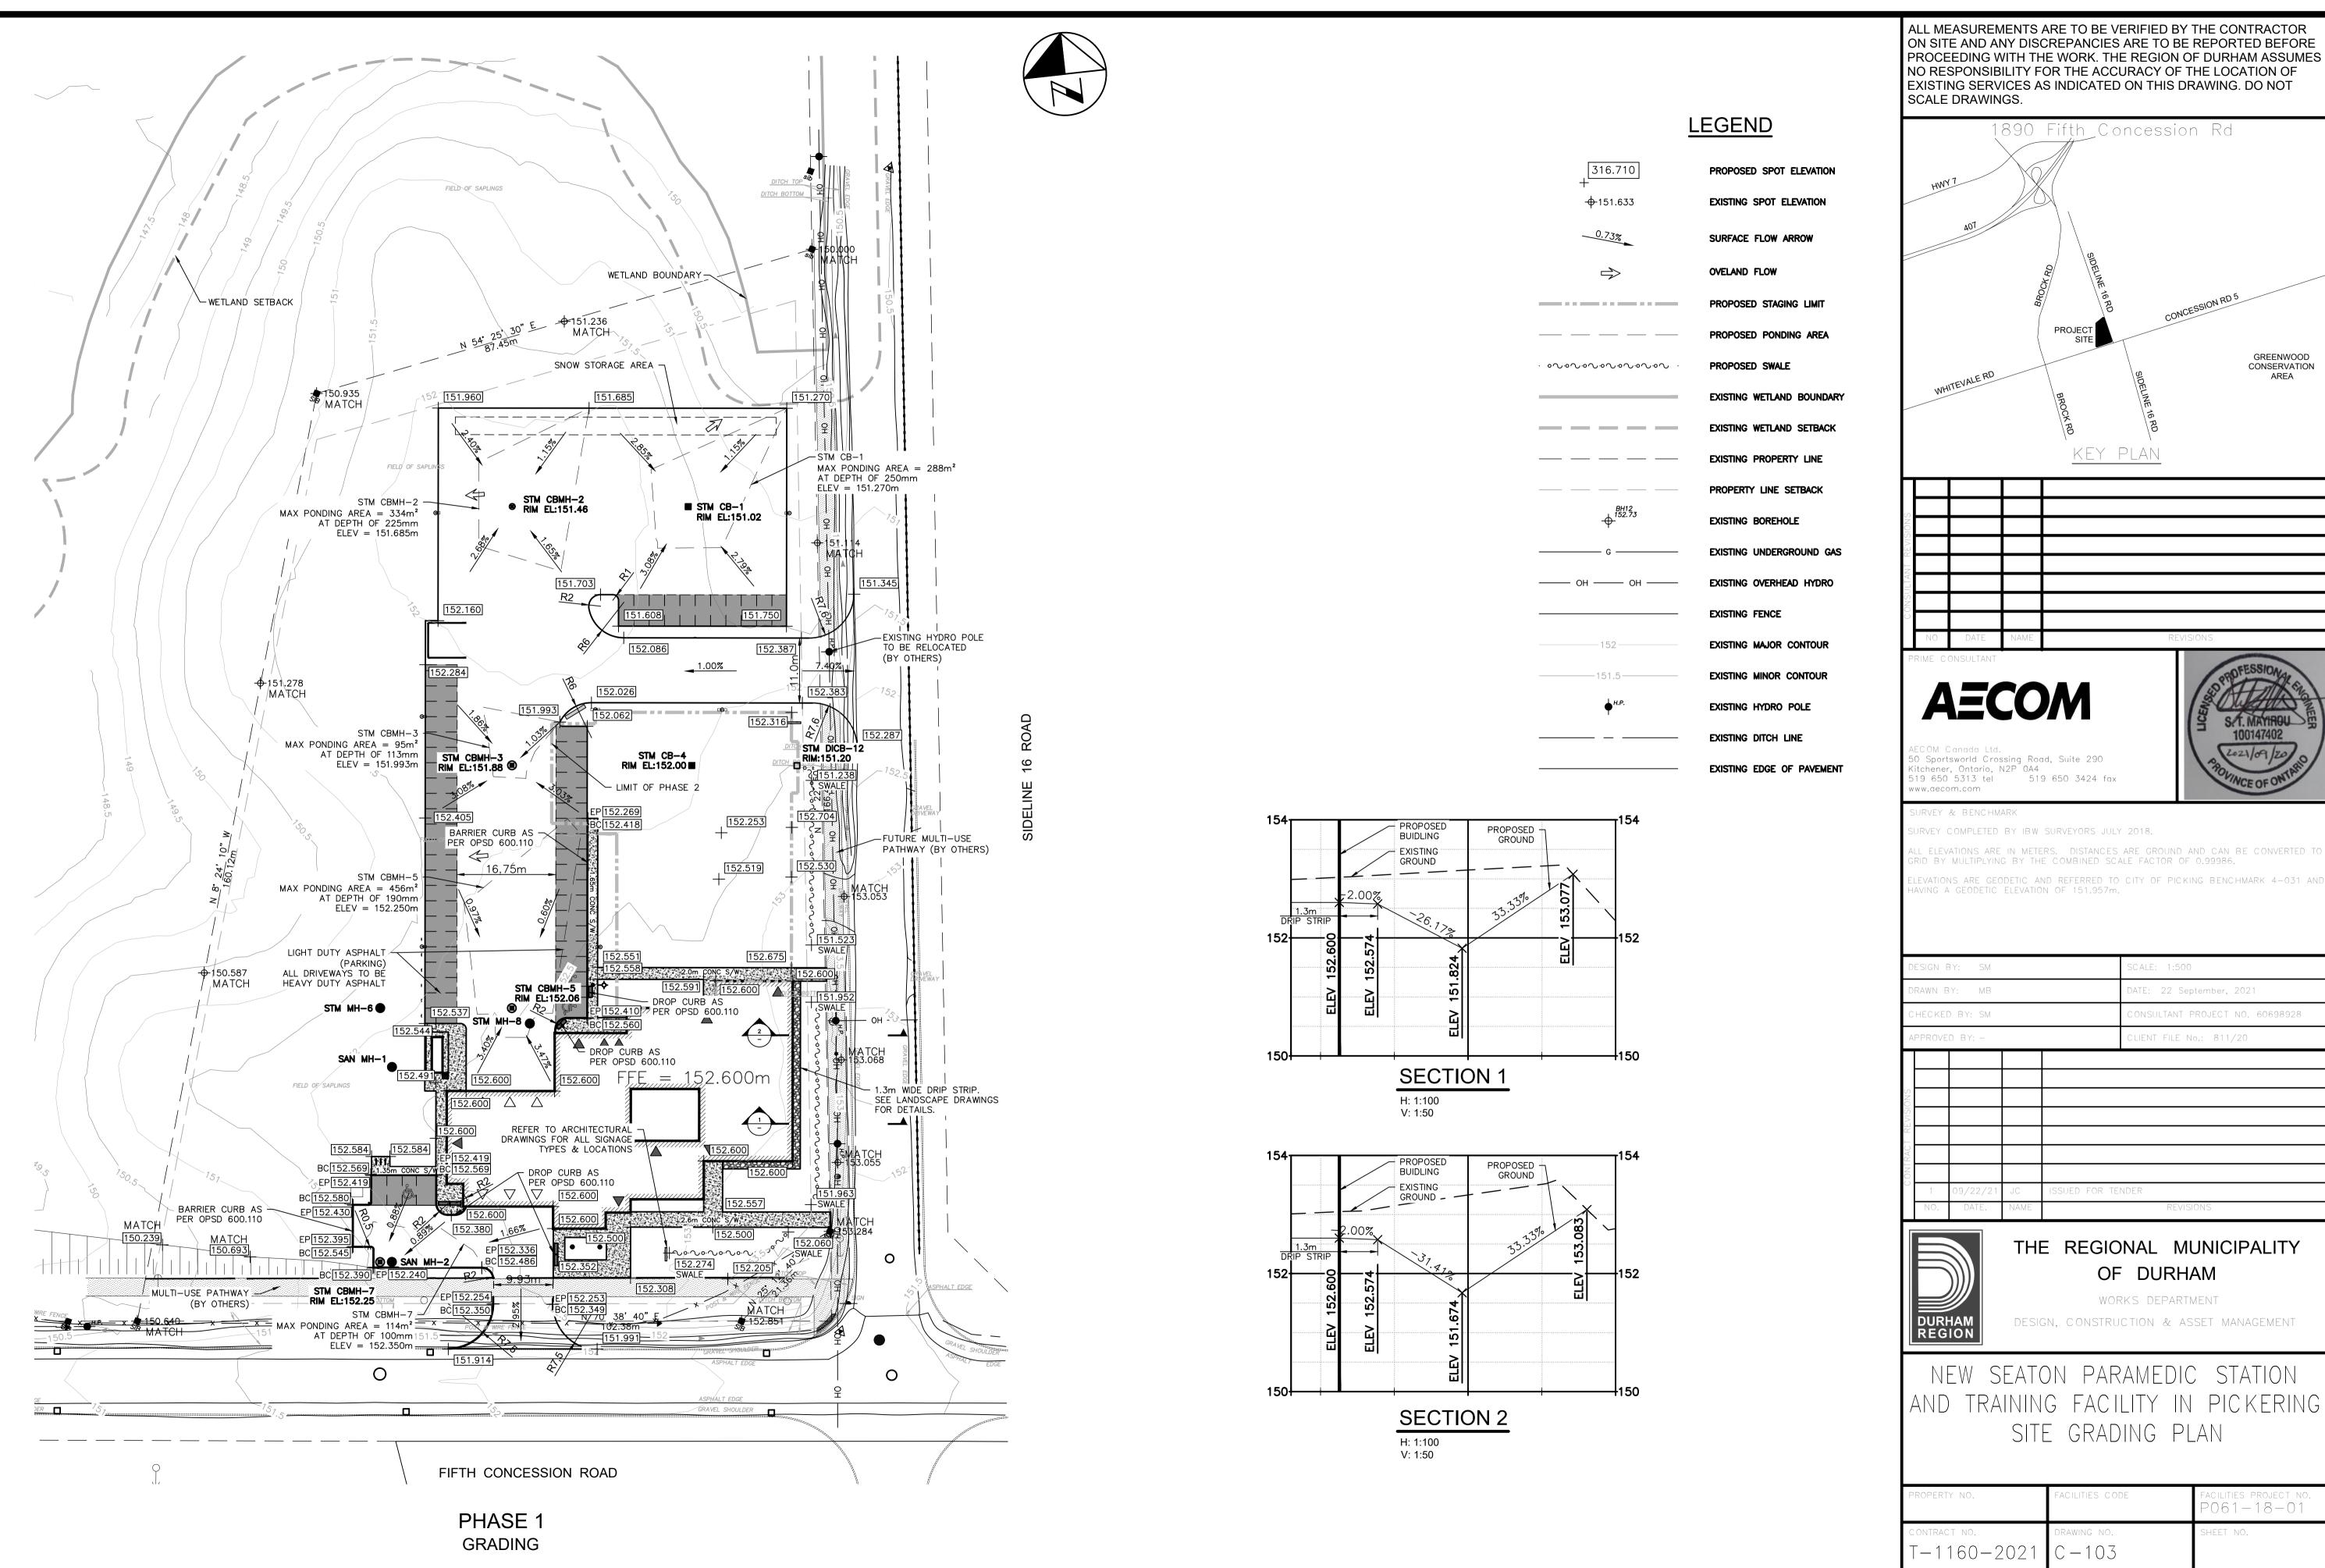

KEY PLAN

GREENWOOD

CONSERVATION

1890 Fifth Concession Rd

PROJECT

tchener, Ontario, N2P 0A4 19 650 5313 tel 519 650 3424 fax ww.aecom.com

SURVEY & BENCHMARK

SURVEY COMPLETED BY IBW SURVEYORS JULY 2018.

RID BY MULTIPLYING BY THE COMBINED SCALE FACTOR OF 0.99986.

ELEVATIONS ARE GEODETIC AND REFERRED TO CITY OF PICKING BENCHMARK 4-031 AND HAVING A GEODETIC ELEVATION OF 151.957m.

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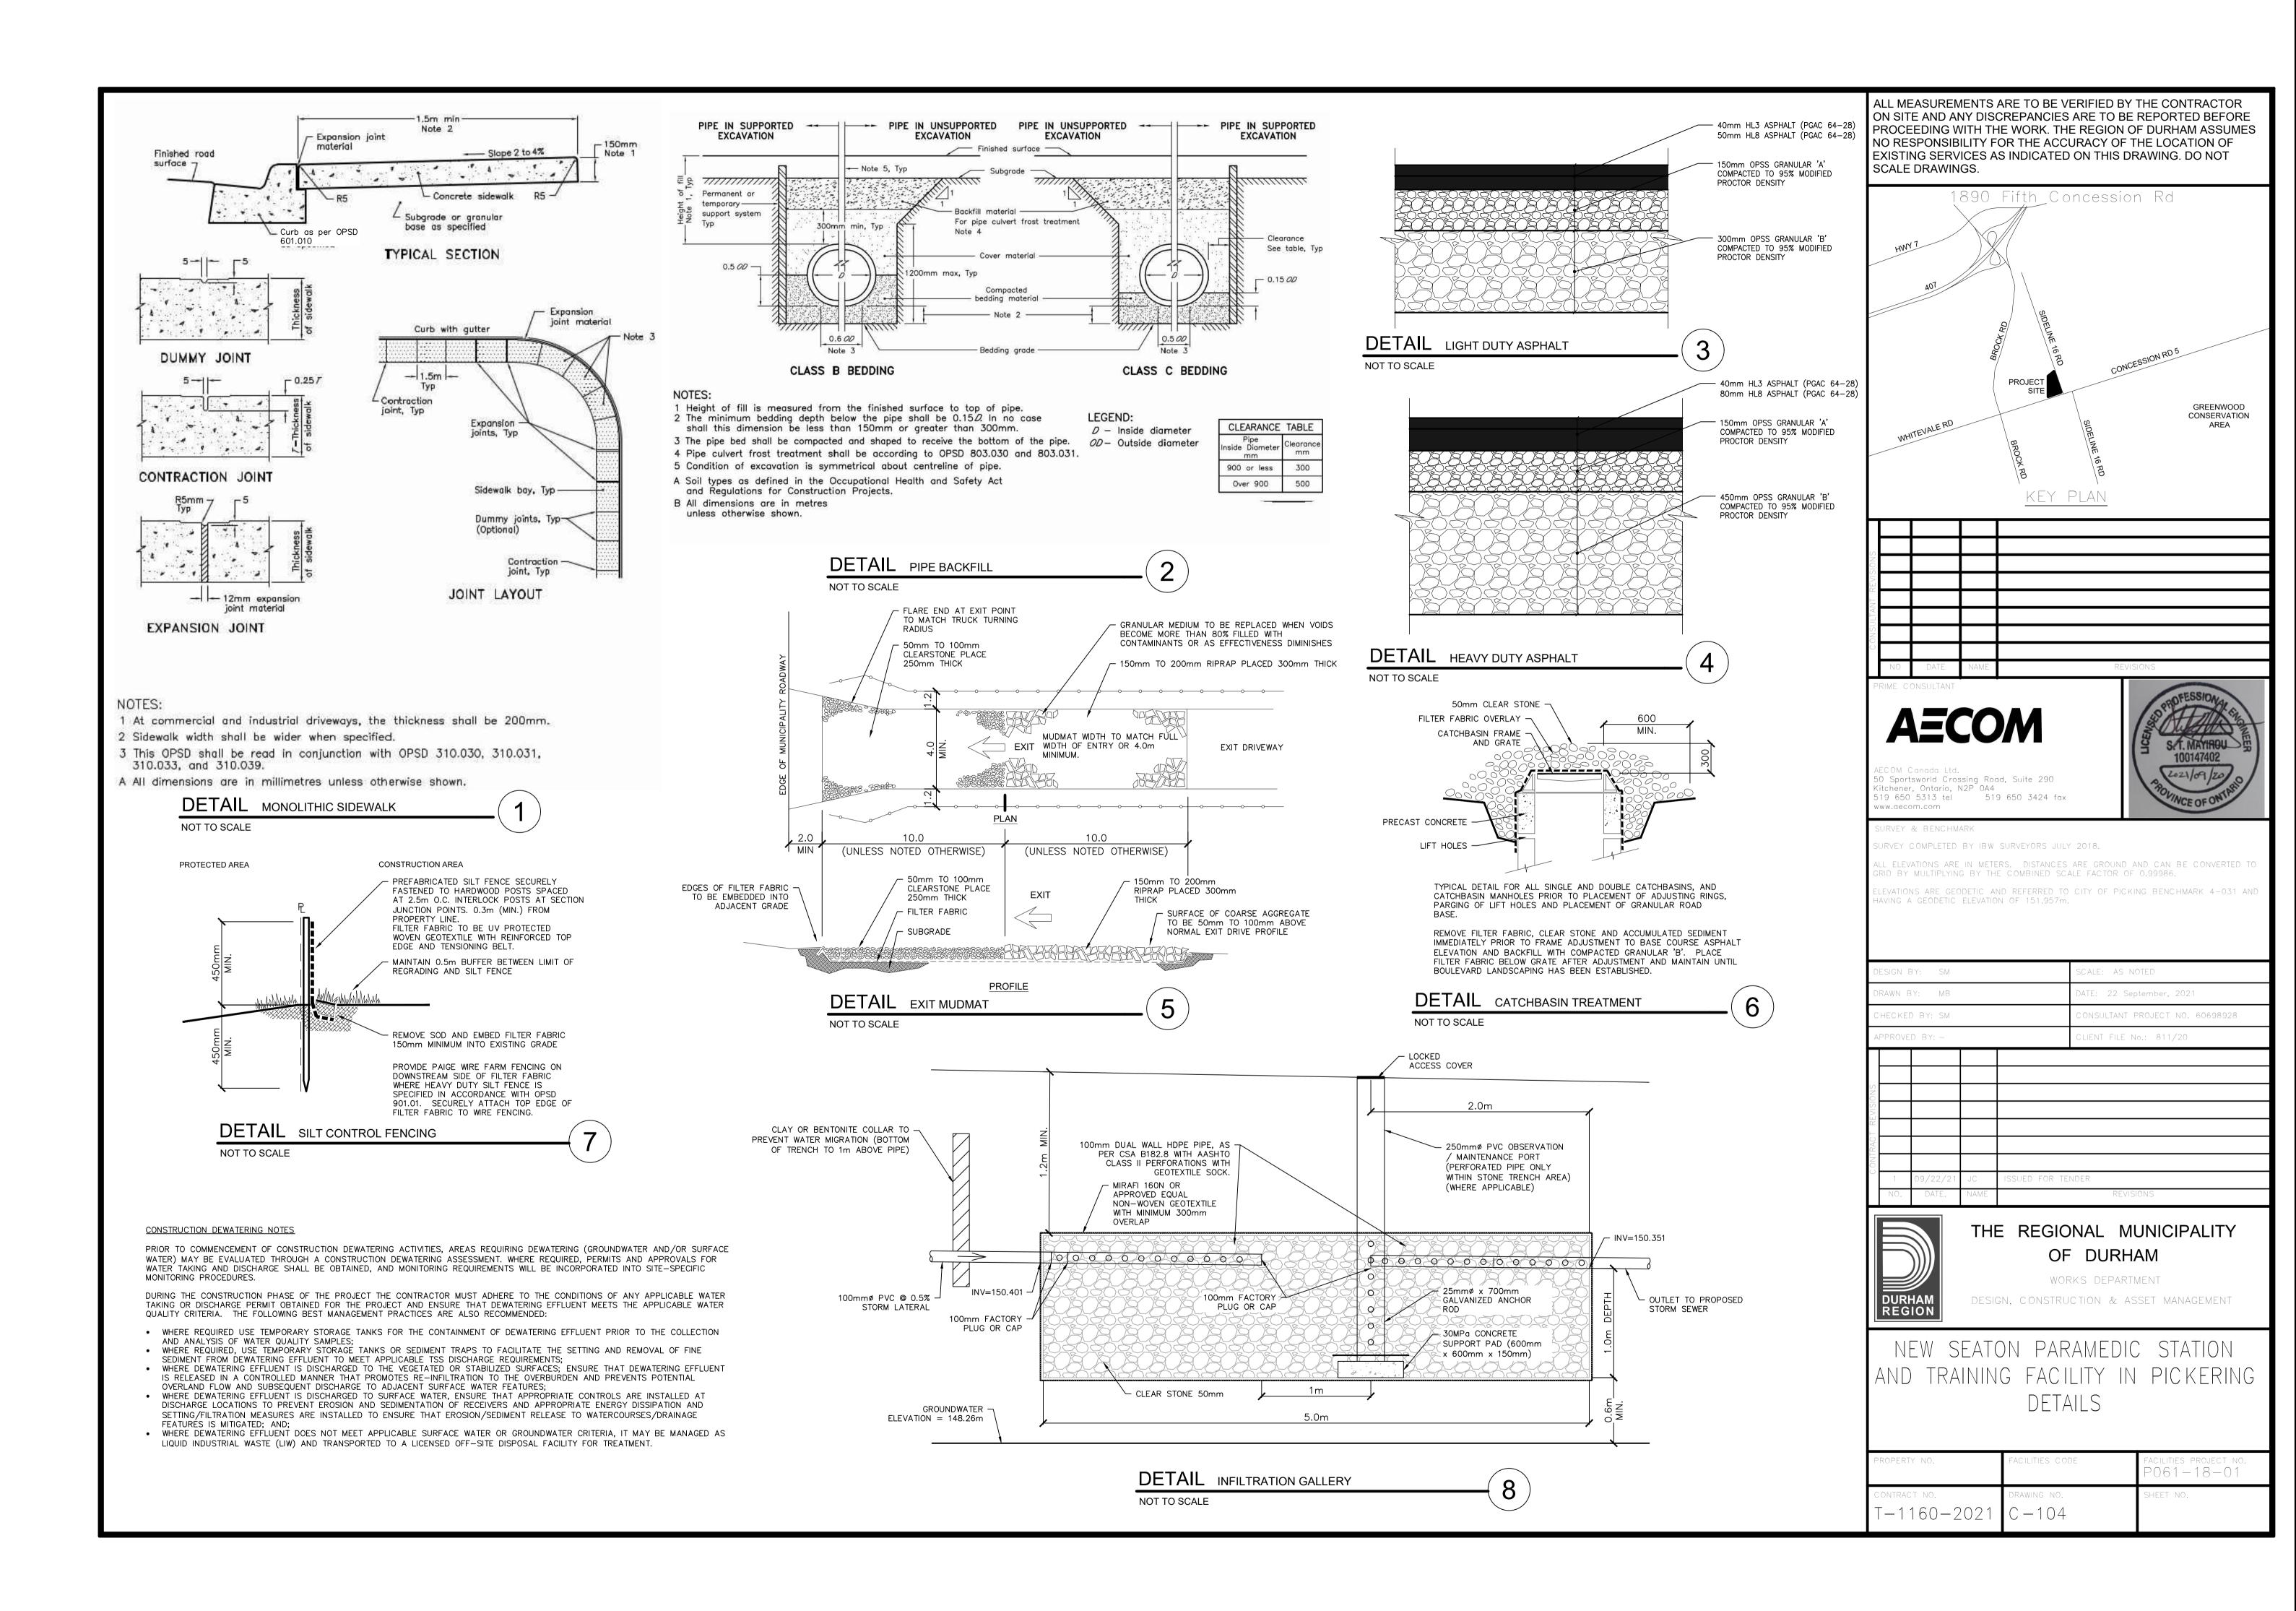
THE REGIONAL MUNICIPALITY OF DURHAM


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DESIGN, CONSTRUCTION & ASSET MANAGEMENT


NEW SEATON PARAMEDIC STATION AND TRAINING FACILITY IN PICKERING SITE GRADING PLAN

PROPERTY NO.	FACILITIES CODE	FACILITIES PROJECT NO. P061-18-01	
CONTRACT NO.	DRAWING NO.	SHEET NO.	
T-1160-2021	C-103		



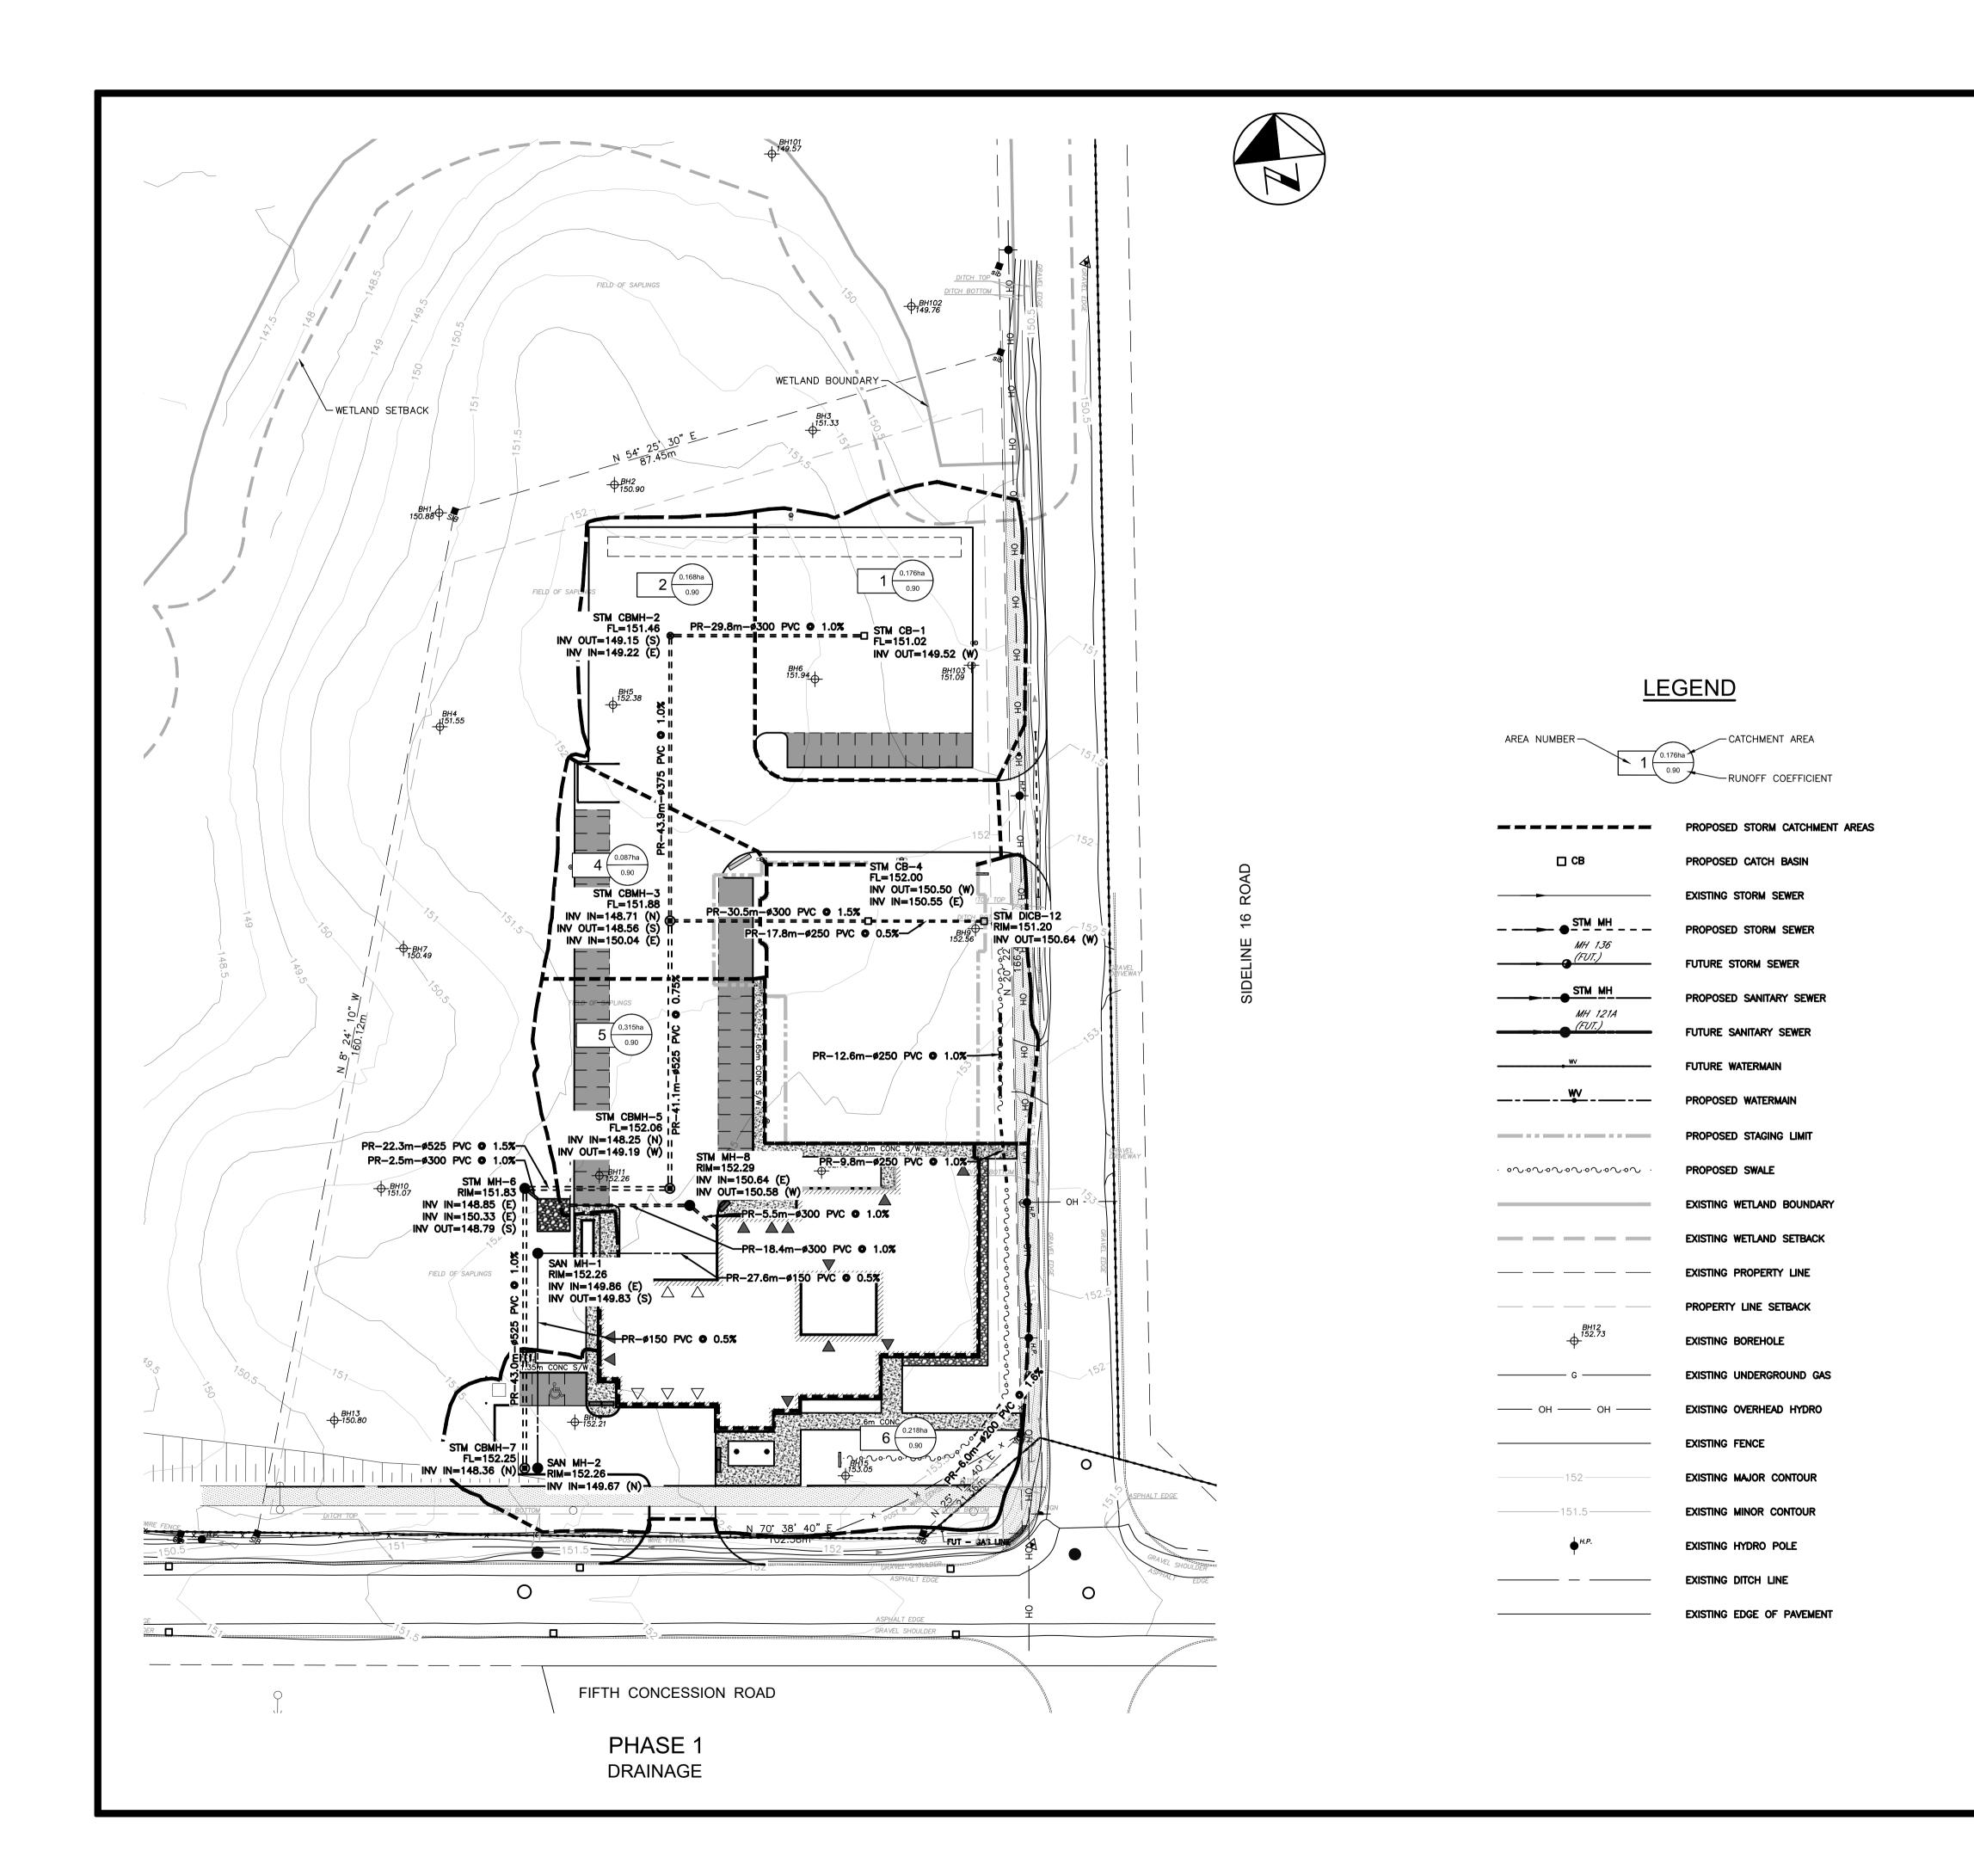

ALL MEASUREMENTS ARE TO BE VERIFIED BY THE CONTRACTOR ON SITE AND ANY DISCREPANCIES ARE TO BE REPORTED BEFORE PROCEEDING WITH THE WORK. THE REGION OF DURHAM ASSUMES NO RESPONSIBILITY FOR THE ACCURACY OF THE LOCATION OF EXISTING SERVICES AS INDICATED ON THIS DRAWING. DO NOT SCALE DRAWINGS.

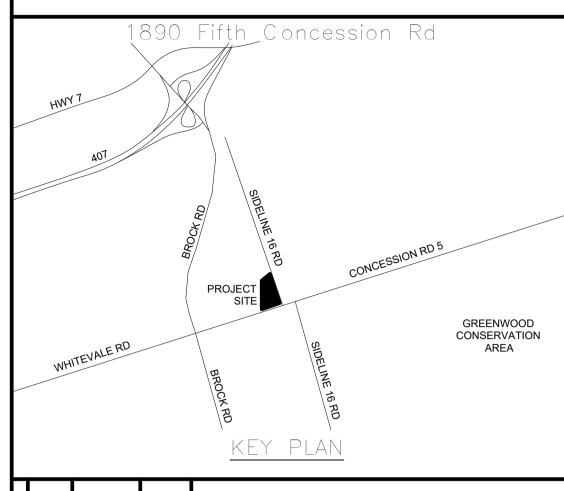

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SURVEY COMPLETED BY IBW SURVEYORS JULY 2018.

ALL ELEVATIONS ARE IN METERS. DISTANCES ARE GROUND AND CAN BE CONVERTED TO GRID BY MULTIPLYING BY THE COMBINED SCALE FACTOR OF 0.99986.

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SCALE: 1:500

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THE REGIONAL MUNICIPALITY OF DURHAM

WORKS DEPARTMENT

DESIGN, CONSTRUCTION & ASSET MANAGEMENT

NEW SEATON PARAMEDIC STATION
AND TRAINING FACILITY IN PICKERING
DRAINAGE AREAS

PROPERTY NO.	FACILITIES CODE	FACILITIES PROJECT NO. P061-18-01
CONTRACT NO.	DRAWING NO.	SHEET NO.
T-1160-2021	C-105	