EQUIPMENT ABBREVIATIONS		
SYMBOL	DESCRIPTION	
AC	AIR COMPRESSOR	
ARC	AIR CURTAIN	
AHU	AIR HANDLING UNIT	
ВВ	BASEBOARD HEATER	
В	BOILER	
CUH	CABINET UNIT HEATER	
СН	CHILLER	
С	CONDENSER	
CAV	CONSTANT AIR VOLUME BOX	
CC	COOLING COIL	
DWH	DOMESTIC WATER HEATER	
EF	EXHAUST FAN	
FCU	FAN COIL UNIT	
FFH	FORCED FLOW HEATER	
GSHP	GROUND SOURCE HEAT PUMP	
HEX	HEAT EXCHANGER	
HP	HEAT PUMP	
HC	HEATING COIL	
Р	PUMP	
PHC	PRE-HEAT COIL	
RP	RADIANT PANEL	
RHC	RE-HEAT COIL	
RF	RETURN FAN	
RTU	ROOFTOP UNIT	
SF	SUPPLY FAN	
UH	UNIT HEATER	
VAV	VARIABLE AIR VOLUME BOX	

HEATING & COOLING PIPING		
SYMBOL	DESCRIPTION	
CNDR	CONDENSATE DRAIN	
PC	PUMPED CONDENSATE	
REFR	REFRIGERANT GAS	
REFS	REFRIGERANT LIQUID	
V	VENT	
 	UNION	
¥	MANUAL AIR VENT	
Ŷ	AUTOMATIC AIR VENT	
===	EXPANSION COMPENSATOR	
<u></u> -	EXPANSION LOOP	
	PIPE ANCHOR	
=	PIPE GUIDE	
	PIPE SLEEVE	
BBH-#	BASEBOARD HEATER	
<u>CU</u> H	CABINET UNIT HEATER	
UH	UNIT HEATER	

SYMBOL SAN SANITARY DRAINAGE - ABOVE GROUND SAN SANITARY DRAINAGE - ABOVE GROUND SANITARY DRAINAGE - ABOVE GROUND SANITARY DRAINAGE - ABOVE GROUND SANITARY DRAINAGE - ADOVE GROUND SANITARY DRAINAGE (ACID RESISTANT) - ABOVE GROUND SANITARY DRAINAGE (ACID RESISTANT) - UNDERGROUND STIM STORM DRAINAGE - ADOVE GROUND STIM STORM DRAINAGE - ADOVE GROUND PD PUMPED DISCHARGE DOMESTIC COLD WATER SUPPLY DOMESTIC HOT WATER SUPPLY DOMESTIC HOT WATER SUPPLY DOMESTIC HOT WATER RECIRC. TW TEMPERED WATER ACID RESISTANT VENT VENT C G GAS RO REVERSE OSMOSIS PIPING HSO RADIO ISOTOPE DRAIN HSO RADIO ISOTOPE DRAIN CAA COMPRESSED AIR RUNNING TRAP P - TRAP O ES-1 EMERGENCY SHOWER O EW-1 EYE WASH O CO CLEANOUT IN FLOOR/BELOW GRADE H C SINGLE GAS OUTLET O'G GROUND HYDRANT O'G DOWLE GAS OUTLET O'G GROUND HYDRANT O'G POPARANT O'CAP COMPRESSED AIR O'LLET O'G CORPORE SHOULD HE ADOVE GROUND O'VIR VENT THROUGH ROOF O'RWL RAIN WATER LEADER TSP TRAP GOOD AIR O'LLET O'G CROUND HYDRANT O'CAP CROWNER STAN WATER LEADER TSP TRAP SAL PRIMER SCUPPER DRAIN O'NTR VENT THROUGH ROOF O'RWL RAIN WATER LEADER TSP TRAP GOOD ARAIN O'VIR VENT THROUGH ROOF O'RWL RAIN WATER LEADER TSP TRAP SAL PRIMER SCUPPER DRAIN O'NTROLE HAND O'NTROLE HA		PLUMBING
SANIARY DRAINAGE - UNDERGROUND SANIARY) SANIARY DRAINAGE (ACID RESISTANT) - ABOVE GROUND STM STORM DRAINAGE - ABOVE GROUND STM STORM DRAINAGE - LUNDERGROUND STM STORM DRAINAGE - ABOVE GROUND	SYMBOL	DESCRIPTION
SANIAR)————————————————————————————————————	SAN	SANITARY DRAINAGE - ABOVE GROUND
SANIAR) SANITARY DRAINAGE (ACID RESISTANT) - UNDERGROUND STM STORM DRAINAGE - ABOVE GROUND - STM STORM DRAINAGE - UNDERGROUND - PD PUMPED DISCHARGE - DOMESTIC COLD WATER SUPPLY DOMESTIC HOT WATER SUPPLY - DOMESTIC HOT WATER RECIRC. - TW TEMPERED WATER - ACID RESISTANT VENT - VENT - G GAS - RO REVERSE OSMOSIS PIPING - ISO RADIO ISOTOPE DRAIN - CA COMPRESSED AIR - Q P.TRAP - DES-1 EMERGENCY SHOWER - WE WASH - O CO CLEANOUT IN FLOORIBELOW GRADE - WINTH HOSE BIBB - H G SINGLE GAS OUTLET - H CA COMPRESSED AIR DITLET - H CA COMPRESSED AIR DITLET - H CA COMPRESSED AIR DITLET - H CO CLEANOUT NOELING - H HB HOSE BIBB - H G SINGLE GAS OUTLET - H CA COMPRESSED AIR DITLET	— — —SAN— — —	SANITARY DRAINAGE - UNDERGROUND
STM————————————————————————————————————	SAN(AR)	SANITARY DRAINAGE (ACID RESISTANT) - ABOVE GROUND
STORM DRAINAGE - UNDERGROUND PD PUMPED DISCHARGE DOMESTIC COLD WATER SUPPLY DOMESTIC HOT WATER SUPPLY DOMESTIC HOT WATER FECIRC. TW TEMPERED WATER ACID RESISTANT VENT VENT GAS RO REVERSE OSMOSIS PIPING ISO RADIO ISOTOPE DRAIN CA COMPRESSED AIR P P-TRAP O ES-1 EMERGENCY SHOWER EYE WASH O CO CLEANOUT IN FLOORIBELOW GRADE H DOSE BIB NON FREEZE HOSE BIBB NON FREEZE HOSE BIBB NON FREEZE HOSE BIBB HG SINGLE GAS OUTLET HCA COMPRESSED AIR OCOMENT CA COMPRESSED AIR TO COULD COMENT OF THE COUR OF DRAIN O CO CLEANOUT IN FLOORIBELOW GRADE H CO CLEANOUT IN FLOORIBELOW GRADE H CO CLEANOUT IN FLOORIBELOW GRADE H CO CLEANOUT IN FLOORIBELOW GRADE O CO CLEANOUT IN FLOORIBELOW GRADE FINGLE GAS OUTLET CO COMPRESSED AIR OUTLET CO COMPRESSED AIR OUTLET FINGLE GAS OUTLET CO COMPRESSED AIR OUTLET FINGLE GAS OUTLET FINGLE GAS OUTLET O CA COMPRESSED AIR OUTLET THE ROOF HYDRANT O HGH GROUND HYDRANT O TREE CENTROLE FLOW ROOF DRAIN O TREE CENTROLE FLOOR DRAIN O TRENCH GRATE & FRAME AREA DRAIN O FED FLOOR DRAIN FINGLE FLOOR DRAIN O HD HUB DRAIN FINGLE FLOOR DRAIN - FLUSHING RIM O HD HUB DRAIN FINGLE FLOOR DRAIN - FLUSHING RIM O WATER METER ASSEMBLY G GAS METER BACK WATER VALVE BEFP BACK FLOW PREVENTER	— — SAN(AR)— —	SANITARY DRAINAGE (ACID RESISTANT) - UNDERGROUND
PD PUMPED DISCHARGE	STM	STORM DRAINAGE - ABOVE GROUND
DOMESTIC COLD WATER SUPPLY DOMESTIC HOT WATER RECIRC. TW———————————————————————————————————	— — —STM— — —	STORM DRAINAGE - UNDERGROUND
DOMESTIC HOT WATER SUPPLY DOMESTIC HOT WATER RECIRC. TW TEMPERED WATER AWV VENT G G GAS RO REVERSE OSMOSIS PIPING ISO RADIO ISOTOPE DRAIN CA COMPRESSED AIR PTRAP O ES-1 EMERGENCY SHOWER O EW-1 EYE WASH O CO CLEANOUT IN PLOOR/BELOW GRADE ICO CLEANOUT IN CEILING HIB HOSE BIBB NPHB NON PREEZE HOSE BIBB NPHB NON PREEZE HOSE BIBB NPHB ROOF PAYANT CA COMPRESSED AIR TRAP O ES-1 EMERGENCY SHOWER O EW-1 EYE WASH O CO CLEANOUT IN PLOOR/BELOW GRADE ICO COMPRESSED AIR	PD	PUMPED DISCHARGE
DOMESTIC HOT WATER RECIRC. TW TEMPERED WATER ACID RESISTANT VENT VENT G- GAS RO REVERSE OSMOSIS PIPING ISO RADIO ISOTOPE DRAIN CA COMPRESSED AIR P.TRAP O ES-1 EMERGENCY SHOWER O EW-1 EYE WASH O CO CLEANOUT IN FLOOR/BELOW GRADE H CO CLEANOUT IN CEILING H HB HOSE BIBB H OF SINGLE GAS OUTLET CA COMPRESSED AIR ROUTLET CA COMPRESSED AIR O HH R ROOF HYDRANT O HH R ROOF HYDRANT O GB CORAIN O CO CLEANOUT IN COLLING H NFHB NON FREEZE HOSE BIBB O NFHE BACK BASING BAS OUTLET CA COMPRESSED AIR OUTLET THE ROOF HYDRANT O FRD ROOF DRAIN O VIR VENT THROUGH ROOF O RWL RAIN WATER LEADER TESP TRAP SEAL PRIMER CATCH BASIN TRENCH GRATE THE ROOF DRAIN O FRD CATCH BASIN THE ROOF DRAIN O FRD FLOOR DRAIN O FRD FLOOR DRAIN FRD FLOOR DRAIN O WATER METER ASSEMBLY O GAS METER D BACK WATER VALVE BEFP BACK FLOOR DRAVER		DOMESTIC COLD WATER SUPPLY
TW TEMPERED WATER ACID RESISTANT VENT C G GAS RO REVERSE OSMOSIS PIPING ISO RADIO ISOTOPE DRAIN CA COMPRESSED AIR P.TRAP Q F P.TRAP Q ES-1 EMERGENCY SHOWER Q EW-1 EYE WASH O CC CLEANOUT IN FLOORBELOW GRADE IF CO CLEANOUT IN FLOORBELOW GRADE O HB HB HOSE BIBB ON NFREEZE HOSE BIBB ON NFREEZE HOSE BIBB OH NFHB NON FREEZE HOSE BIBB OHG SINGLE GAS OUTLET OF CA COMPRESSED AIR OUTLET OF CA COMPRESSED AIR OUTLET O CA COMPRESSED AIR OUTLET OF CARD O CARD O CARD O CARD O RWL RAIN WATER LEADER TSP TRAP SEAL PRIMER CO SCUPPER DRAIN O MH MANHOLE CO CARD CARD CARD O FED FLOOR DRAIN O FRD FLOOR DRAIN O HD HUB DRAIN O FRD FLOOR DRAIN FLUSHING RIM O WATER METER ASSEMBLY O GAS METER D BACK WATER VALVE BEPD BACKFLOW PREVENTER		DOMESTIC HOT WATER SUPPLY
ACID RESISTANT VENT		DOMESTIC HOT WATER RECIRC.
GGGAS RO—RO—REVERSE OSMOSIS PIPING RADIO ISOTOPE DRAIN CA—COMPRESSED AIR RUNNING TRAP Q—P-TRAP Q—SE-1 EMERGENCY SHOWER Q—W-1 EYE WASH Q—CO CLEANOUT IN FLOORIBELOW GRADE —H CO CLEANOUT IN GEILING Q—HB HB HOSE BIBB Q—NFHB NON FREEZE HOSE BIBB Q—NFHB NON FREEZE HOSE BIBB Q—NG SINGLE GAS OUTLET Q—GG DOUBLE GAS OUTLET Q—GG RO ROOF DRAIN Q—CFRD CONTROL FLOW ROOF DRAIN Q—CFRD CONTROL FLOW ROOF DRAIN Q—CFRD CONTROL FLOW ROOF Q—RUL RAIN WATER LEADER TSP—TRAP SEAL PRIMER D—TO TRENCH GRATE & FRAME Q—AD AREA DRAIN Q—FD FLOOR DRAIN Q—FFD FLOOR DRAIN Q—FD FLOOR DRAIN Q—F	TW	TEMPERED WATER
GS GAS REVERSE OSMOSIS PIPING RODERSESED AIR CA COMPRESSED AIR RUNNING TRAP Q F P-TRAP O ES-1 EMERGENCY SHOWER ○ EW-1 EYE WASH ○ CO CLEANOUT IN FLOOR/BELOW GRADE → I CO CLEANOUT IN CEILING → HB HOSE BIBB → NFHB NON FREEZE HOSE BIBB → NFHB NON FREEZE HOSE BIBB → HG SINGLE GAS OUTLET → CA COMPRESSED AIR OUTLET → CA COMPRESS	AWV	ACID RESISTANT VENT
GS GAS REVERSE OSMOSIS PIPING RODERSESED AIR CA COMPRESSED AIR RUNNING TRAP Q PTRAP Q ES-1 EMERGENCY SHOWER Q EW-1 EYE WASH Q CO CLEANOUT IN FLOOR/BELOW GRADE →I CO CLEANOUT IN CEILING →HB HOSE BIBB →NFHB NON FREEZE HOSE BIBB →I G SINGLE GAS OUTLET →CA COMPRESSED AIR ROUTLET →I CA COMPRESSED AIR OUTLET →I CO CLEANOUT IN CEILING	V	VENT
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CA————————————————————————————————————		REVERSE OSMOSIS PIPING
CA————————————————————————————————————	ISO	RADIO ISOTOPE DRAIN
RUNNING TRAP P-TRAP P-TRAP O ES-1 EMERGENCY SHOWER O EW-1 EYE WASH O CO CLEANOUT IN FLOOR/BELOW GRADE I CO CLEANOUT IN CEILING HB HOSE BIBB HOSE BIBB NON FREEZE HOSE BIBB GINGLE GAS OUTLET GO GO COMPRESSED AIR OUTLET HCA COMPRESSED AIR OUTLET FOR COMPRESSED AIR OUTLET OF RD ROOF HYDRANT O VTR VENT THROUGH ROOF O RWL RAIN WATER LEADER TSP TRAP SEAL PRIMER SCUPPER DRAIN MH MANHOLE CB CATCH BASIN FED FUNNEL FLOOR DRAIN FED FUNNEL FLOOR DRAIN FED FLOOR DRAIN GO HD HUB DRAIN FS FLOOR DRAIN GAS METER BACK WATER VALVE BEFP BACK WATER VALVE BEFP BACK WATER VALVE BEFP BACK WATER VALVE BEFP BACK FLOW PREVENTER	CA	
P-TRAP O ES-1 EMERGENCY SHOWER O EW-1 EYE WASH O CO CLEANOUT IN FLOOR/BELOW GRADE I CO CLEANOUT IN CEILING O+HB HOSE BIBB O+NFHB NON FREEZE HOSE BIBB O+IG SINGLE GAS OUTLET O+ICA COMPRESSED AIR OUTLET O+ICA COMPRESSED AIR OUTLET O+ICH ROOF HYDRANT O+IGH GROUND HYDRANT O CFRD CONTROL FLOW ROOF DRAIN O VTR VENT THROUGH ROOF O RWL RAIN WATER LEADER TSP TRAP SEAL PRIMER CD OMH MANHOLE CATCH BASIN FFD FINNEL FLOOR DRAIN O FFD FUNNEL FLOOR DRAIN FFD FLOOR DRAIN O FRD FRD FLOOR DRAIN OFFD GAS METER D BACK WATER VALVE BFP BACK FLOW PREVENTER	⇒ ⊢	RUNNING TRAP
© ES-1 EMERGENCY SHOWER ○ EW-1 EYE WASH ○ CO CLEANOUT IN FLOOR/BELOW GRADE ───────────────────────────────────	<u> </u>	
○ EW-1 EYE WASH ○ CO CLEANOUT IN FLOOR/BELOW GRADE —I CO CLEANOUT IN CEILING ●+HB HOSE BIBB ●+NFHB NON FREEZE HOSE BIBB ●+NFHB NON FREEZE HOSE BIBB ●+OF SINGLE GAS OUTLET ●+G SINGLE GAS OUTLET ●+CA COMPRESSED AIR OUTLET ●+CA COMPRESSED AIR OUTLET ●+RH ROOF HYDRANT ●+GH GROUND HYDRANT ●+GH GROUND HYDRANT ● FGH CONTROL FLOW ROOF DRAIN ● CFRD CONTROL FLOW ROOF DRAIN ● VTR VENT THROUGH ROOF ● RWL RAIN WATER LEADER TSP TRAP SEAL PRIMER INDEX SCUPPER DRAIN ● MAIN MANHOLE Image: SCUPPER DRAIN MANHOLE Image: SCUPPER DRA	_	EMERGENCY SHOWER
O CO CLEANOUT IN FLOOR/BELOW GRADE →I CO CLEANOUT IN CEILING →I HB HOSE BIBB →I NFHB NON FREEZE HOSE BIBB →I G SINGLE GAS OUTLET ♣ G DOUBLE GAS OUTLET →I CA COMPRESSED AIR OUTLET →I CA COMPRESSED AIR OUTLET →I CH R ROOF HYDRANT →I CH GROUND HYDRANT →I CH R ROOF DRAIN ✓ CFRD CONTROL FLOW ROOF DRAIN ✓ VENT THROUGH ROOF O RWL RAIN WATER LEADER TSP TRAP SEAL PRIMER ✓ SCUPPER DRAIN ✓ MH MANHOLE ☐ CB CATCH BASIN —I TD TRENCH GRATE & FRAME ✓ AD AREA DRAIN ○ FFD FUNNEL FLOOR DRAIN ○ HD HUB DRAIN ☐ HO HUB DRAIN ☐ FS FLOOR SINK ✓ GAS METER ☐ BACK WATER VALVE ☐ BFP ☐ BACKFLOW PREVENTER		
H CO CLEANOUT IN CEILING ●HB HOSE BIBB ●HOSE BIBB		
HB HOSE BIBB HOSE BIBB HOSE BIBB HOSE BIBB HOSE BIBB NON FREEZE HOSE BIBB HOSE BIBB HOSE BIBB NON FREEZE HOSE BIBB HOSE BIBB NON FREEZE HOSE BIBB HOSE BIBB NON FREEZE NON FREEZE HOSE BIBB NON FREEZE HOSE NON FREEZE NON FREEZE HOSE NON FREEZE HOSE NON FREEZE HOSE NON FREEZE		
OHNFHB NON FREEZE HOSE BIBB OHG SINGLE GAS OUTLET OÇG DOUBLE GAS OUTLET OHCA COMPRESSED AIR OUTLET OHCH ROOF HYDRANT OHGH GROUND HYDRANT ORD ROOF DRAIN OFFID CONTROL FLOW ROOF DRAIN OFFID TRAP SEAL PRIMER SCUPPER DRAIN OMH MANHOLE CB CATCH BASIN TO TRENCH GRATE & FRAME AREA DRAIN OFFID FUNNEL FLOOR DRAIN OHD HUB DRAIN OHD HUB DRAIN OHD HUB DRAIN OFFID FLOOR DRAIN OHD HUB DRAIN OFFID FLOOR DRAIN OFFID FLOOR DRAIN OHD HUB DRAIN OFFID FLOOR DRAIN OFFID FLOOR DRAIN OHD HUB DRAIN	·	
SINGLE GAS OUTLET GG DOUBLE GAS OUTLET HCA COMPRESSED AIR OUTLET HRH ROOF HYDRANT GROUND HYDRANT GRO ROOF DRAIN CFRD CONTROL FLOW ROOF DRAIN O VTR VENT THROUGH ROOF O RWL RAIN WATER LEADER TSP TRAP SEAL PRIMER SCUPPER DRAIN MH MANHOLE GB CATCH BASIN TD TRENCH GRATE & FRAME AD AREA DRAIN FFD FUNNEL FLOOR DRAIN FFD FLOOR DRAIN HUB DRAIN FFS FLOOR SINK FRD FLOOR DRAIN - FLUSHING RIM WATER METER ASSEMBLY GAS METER BACK WATER VALVE BEPP BACKFLOW PREVENTER		
♣G DOUBLE GAS OUTLET ♣HCA COMPRESSED AIR OUTLET ♣HRH ROOF HYDRANT ♣HGH GROUND HYDRANT ♣HGH ROOF DRAIN ♣CFRD CONTROL FLOW ROOF DRAIN ♠O VTR VENT THROUGH ROOF ♠ RWL RAIN WATER LEADER ★TSP TRAP SEAL PRIMER ★ZI SCUPPER DRAIN ♠MH MANHOLE ★GB CATCH BASIN ★MH MANHOLE ★GB CATCH BASIN ★FD FUNNEL FLOOR DRAIN ♠ FFD FUNNEL FLOOR DRAIN ♠ FD FLOOR DRAIN ♠ HD HUB DRAIN ♣ FS FLOOR SINK ♠ FRD FLOOR DRAIN - FLUSHING RIM ♠ WATER METER ASSEMBLY ♠ GAS METER ★BACK WATER VALVE ♠ BACK WATER VALVE		
OHCA COMPRESSED AIR OUTLET OHRH ROOF HYDRANT OHGH GROUND HYDRANT ORD ROOF DRAIN CFRD CONTROL FLOW ROOF DRAIN O VTR VENT THROUGH ROOF O RWL RAIN WATER LEADER TSP TRAP SEAL PRIMER SCUPPER DRAIN MH MANHOLE CB CATCH BASIN TRENCH GRATE & FRAME AREA DRAIN OFD FLOOR DRAIN HUB DRAIN FS FLOOR SINK FRD FLOOR DRAIN - FLUSHING RIM WATER METER ASSEMBLY GAS METER BACK WATER VALVE BEP BACKFLOW PREVENTER		
OHRH ROOF HYDRANT OHGH GROUND HYDRANT ORD ROOF DRAIN OFFRD CONTROL FLOW ROOF DRAIN OFFRD VENT THROUGH ROOF ORWL RAIN WATER LEADER TSP TRAP SEAL PRIMER SCUPPER DRAIN OMH MANHOLE CB CATCH BASIN TD TRENCH GRATE & FRAME OAD AREA DRAIN OFFD FUNNEL FLOOR DRAIN OFFD FLOOR DRAIN OHD HUB DRAIN OHD HUB DRAIN OFFD FLOOR SINK OFFRD FLOOR DRAIN OFFRD FLOOR SINK OFFRD FLOOR DRAIN FLUSHING RIM OFFRD GAS METER DACK WATER VALVE OFFRD BACK WATER VALVE OFFRD BACK FLOOR PREVENTER	·	
OHGH GROUND HYDRANT ORD ROOF DRAIN CFRD CONTROL FLOW ROOF DRAIN O VTR VENT THROUGH ROOF O RWL RAIN WATER LEADER TSP TRAP SEAL PRIMER SCUPPER DRAIN MH MANHOLE CB CATCH BASIN TD TRENCH GRATE & FRAME AD AREA DRAIN FFD FUNNEL FLOOR DRAIN FFD FLOOR DRAIN HUB DRAIN FS FLOOR SINK FRD FLOOR DRAIN - FLUSHING RIM WATER METER ASSEMBLY G GAS METER BACK WATER VALVE BEPP BACKFLOW PREVENTER		
② RD ROOF DRAIN ② CFRD CONTROL FLOW ROOF DRAIN ○ VTR VENT THROUGH ROOF ○ RWL RAIN WATER LEADER TSP TRAP SEAL PRIMER ☑ SCUPPER DRAIN ○ MH MANHOLE ☐ CB CATCH BASIN ☐ TD TRENCH GRATE & FRAME ② AD AREA DRAIN ⑥ FFD FUNNEL FLOOR DRAIN ⑥ FD FLOOR DRAIN ⑥ HD HUB DRAIN ☐ FS FLOOR SINK ② FRD FLOOR DRAIN - FLUSHING RIM ※ WATER METER ASSEMBLY ⑥ GAS METER ☑ BACK WATER VALVE ⑤FP BACKFLOW PREVENTER		
② CFRD CONTROL FLOW ROOF DRAIN ○ VTR VENT THROUGH ROOF ○ RWL RAIN WATER LEADER TSP TRAP SEAL PRIMER □ SCUPPER DRAIN		
O VTR O RWL RAIN WATER LEADER TRAP SEAL PRIMER SCUPPER DRAIN MH MANHOLE CB CATCH BASIN TRENCH GRATE & FRAME AREA DRAIN FFD FUNNEL FLOOR DRAIN FFD FLOOR DRAIN FS FLOOR SINK FRD FLOOR DRAIN WATER METER ASSEMBLY G AS METER BACK WATER VALVE BEFP BACK WATER VALVE BEFP		
O RWL TSP TRAP SEAL PRIMER SCUPPER DRAIN MH MANHOLE CB CATCH BASIN TD TRENCH GRATE & FRAME AD AREA DRAIN FFD FUNNEL FLOOR DRAIN HD HD HUB DRAIN FS FLOOR SINK FRD FLOOR DRAIN - FLUSHING RIM WATER METER ASSEMBLY GAS METER BACK WATER VALVE BEP BACKFLOW PREVENTER		
TSP TRAP SEAL PRIMER SCUPPER DRAIN MH MANHOLE CB CATCH BASIN TD TRENCH GRATE & FRAME AD AREA DRAIN FFD FUNNEL FLOOR DRAIN FD FLOOR DRAIN HUB DRAIN HUB DRAIN FS FLOOR SINK FLOOR DRAIN - FLUSHING RIM WATER METER ASSEMBLY G GAS METER BACK WATER VALVE BFP BACKFLOW PREVENTER		
SCUPPER DRAIN MH MANHOLE CB CATCH BASIN TD TRENCH GRATE & FRAME AD AREA DRAIN FFD FUNNEL FLOOR DRAIN FD FLOOR DRAIN HUB DRAIN FS FLOOR SINK FRD FLOOR DRAIN - FLUSHING RIM WATER METER ASSEMBLY G AS METER BACK WATER VALVE BFP BACKFLOW PREVENTER		
MH MANHOLE ☐ CB CATCH BASIN ☐ TD TRENCH GRATE & FRAME ② AD AREA DRAIN ③ FFD FUNNEL FLOOR DRAIN ③ FD FLOOR DRAIN ④ HD HUB DRAIN ☐ FS FLOOR SINK ② FRD FLOOR DRAIN - FLUSHING RIM ⑥ WATER METER ASSEMBLY ⑤ GAS METER ☐ BACK WATER VALVE ☐ BFP BACKFLOW PREVENTER		
CATCH BASIN TRENCH GRATE & FRAME AD AREA DRAIN FFD FUNNEL FLOOR DRAIN FD FLOOR DRAIN HUB DRAIN HUB DRAIN FS FLOOR SINK FRD FLOOR DRAIN - FLUSHING RIM WATER METER ASSEMBLY GAS METER BACK WATER VALVE BFP BACKFLOW PREVENTER		
TD TRENCH GRATE & FRAME AREA DRAIN FFD FUNNEL FLOOR DRAIN FD FLOOR DRAIN HUB DRAIN FS FLOOR SINK FRD FLOOR DRAIN - FLUSHING RIM WATER METER ASSEMBLY G GAS METER BACK WATER VALVE BFP BACKFLOW PREVENTER		
 ● FFD ● FUNNEL FLOOR DRAIN ● FD ● FLOOR DRAIN ● HD HUB DRAIN ● FS ■ FLOOR SINK ● FRD ● FLOOR DRAIN - FLUSHING RIM ● WATER METER ASSEMBLY ● GAS METER ■ BACK WATER VALVE ■ BACKFLOW PREVENTER 		
FD FLOOR DRAIN HUB DRAIN FS FLOOR SINK FRD FLOOR DRAIN - FLUSHING RIM WATER METER ASSEMBLY G GAS METER BACK WATER VALVE BFP BACKFLOW PREVENTER	-	
 ⊕ HD ☐ FS ☐ FLOOR SINK ② FRD ☐ FLOOR DRAIN - FLUSHING RIM ☐ WATER METER ASSEMBLY ☐ GAS METER ☐ BACK WATER VALVE ☐ BACKFLOW PREVENTER 		
FS FLOOR SINK FRD FLOOR DRAIN - FLUSHING RIM WATER METER ASSEMBLY G GAS METER BACK WATER VALVE BFP BACKFLOW PREVENTER		
FRD FLOOR DRAIN - FLUSHING RIM WATER METER ASSEMBLY G GAS METER BACK WATER VALVE BFP BACKFLOW PREVENTER	-	
 M WATER METER ASSEMBLY G GAS METER BACK WATER VALVE BFP BACKFLOW PREVENTER 		
G GAS METER BACK WATER VALVE BFP BACKFLOW PREVENTER		
BACK WATER VALVE BFP BACKFLOW PREVENTER		
BFP BACKFLOW PREVENTER	=	
"WC-1" DENOTES FIXTURE TYPE PER SPECIFICATION		
	"WC-1"	DENOTES FIXTURE TYPE PER SPECIFICATION

BFP	BACKFLOW PREVENTER	
"WC-1"	DENOTES FIXTURE TYPE PER SPECIFICATION	
	FIRE PROTECTION	
SYMBOL	DESCRIPTION	
SP	SPRINKLER LINE	
FM	FIRE MAIN	
———F———	STANDPIPE	
X √ S√	SUPERVISED VALVE	
sWFA ₽	WATER FLOW ALARM	
PS 📮	PRESSURE SWITCH	
1 <u>4</u> 1	TEST CONNECTION	
ď,	SPRINKLER FIRE DEPARTMENT CONNECTION	
	PRESSURE SWITCH	
,	WATER FLOW ALARM	
	EXCESS PRESSURE PUMP	
¥ J	WET ALARM CHECK VALVE	
A	TEST & DRAIN VALVE	
Υ	WATER FLOW ALARM	
L	PRESSURE SWITCH	
Z Z	DRY ALARM CHECK VALVE	
J 1	TEST & DRAIN VALVE	
	AIR COMPRESSOR	
SVC	SPRINKLER VALVE CABINET	
FEC	FIRE EXTINGUISHER CABINET	
FHC	FIRE HOSE CABINET	
(F)	FIRE EXTINGUISHER C/W WALL BRACKET	
X PIV	POST-INDICATOR VALVE	
-	FIRE HYDRANT C/W SHUT-OFF VALVE	
•	PENDENT SPRINKLER HEAD	
©	UPRIGHT SPRINKLER HEAD	
0	CONCEALED SPRINKLER HEAD	
8	FIRE SUPPRESSION (CLEAN AGENT) SPRINKLER HEAD	-
\dashv	SIDEWALL SPRINKLER HEAD	
•	FIRE DEPARTMENT CONNECTION	

VENTILATION					
SYMBOL FD	DESCRIPTION				
<u>† </u>	FUSIBLE LINK FIRE DAMPER (DOUBLE LINE)				
\$\$	FUSIBLE LINK FIRE DAMPER (SINGLE LINE)				
BDD	BACK DRAFT DAMPER (DOUBLE LINE)				
S	BACK DRAFT DAMPER (SINGLE LINE)				
₹ BD	BALANCING DAMPER (DOUBLE LINE)				
S → BD	BALANCING DAMPER (SINGLE LINE)				
M	MOTORIZED DAMPER (DOUBLE LINE)				
\$ M	MOTORIZED DAMPER (SINGLE LINE)				
600x300	RECTANGULAR DUCTWORK - DIMENSIONS AS SHOWN				
€ 600Ø	ROUND DUCTWORK - DIMENSION AS SHOWN				
s 600x300 s	DUCTWORK (SINGLE LINE) - DIMENSION AS SHOWN				
H	RECTANGULAR SUPPLY/OUTDOOR AIR DUCT UP				
	RECTANGULAR EXHAUST/RETURN AIR DUCT UP				
•	CIRCULAR SUPPLY/OUTDOOR AIR DUCT UP				
(2)	CIRCULAR EXHAUST/RETURN AIR DUCT UP				
	RECTANGULAR SUPPLY/OUTDOOR AIR DUCT DOWN				
	RECTANGULAR EXHAUST/RETURN AIR DUCT DOWN				
(2)	CIRCULAR SUPPLY/OUTDOOR AIR DUCT DOWN				
0	CIRCULAR EXHAUST/RETURN AIR DUCT DOWN				
Leker	MITRED ELBOW WITH TURNING VANES				
	DUCT RISE (DOUBLE LINE)				
₹	DUCT RISE (SINGLE LINE)				
├	SUPPLY GRILLE - DIMENSIONS AS SHOWN ON SCHEDULE				
├	EXHAUST/RETURN GRILLE - DIMENSIONS AS SHOWN ON SCHEDULE				
	CEILING SUPPLY AIR DIFFUSER - DIMENSIONS AS SHOWN ON SCHEDULE				
	LINEAR SLOT DIFFUSER - DIMENSIONS AS SHOWN ON SCHEDULE				
	CEILING EXHAUST/RETURN GRILLE - DIMENSIONS AS SHOWN ON SCHEDULE				
<u>• • • • • • • • • • • • • • • • • • • </u>	SUPPLY AIR ROUND DIFFUSER				
	BRANCH TAKE-OFF WITH ADJUSTABLE SPLITTER DAMPER IN SUPPLY DUCT (DOUBLE LINE)				
, J ,	BRANCH TAKE-OFF WITH ADJUSTABLE SPLITTER DAMPER IN SUPPLY DUCT (SINGLE LINE)				
O.E.D.	OPEN ENDED DUCT WITH BALANCING DAMPER AND BELLMOUTH. DIRECTION AS SHOWN (DOUBLE				
, O.E.D.	LINE) OPEN ENDED DUCT WITH BALANCING DAMPER AND				
	BELLMOUTH. DIRECTION AS SHOWN (SINGLE LINE) FLEXIBLE DUCT CONNECTION				
	ACOUSTICALLY LINED DUCTWORK (DOUBLE LINE)				
DUCT SILENCER					
FLEXIBLE DUCT (DOUBLE LINE)					
FLEXIBLE DUCT (SINGLE LINE) FLEXIBLE DUCT CONNECTION WITH BALANCING DAMPER ON TAKE-OF					
¥ 400,400 H4002	DUCT TRANSITION FROM RECTANGULAR TO ROUND				
₹ 400×400 400Ø δ					
<u> </u>	RECTANGULAR DUCT BREAK				
<u>\ \ \ \ \ \ \ \ \ \ \ \ \ \ \ \ \ \ \ </u>	ROUND DUCT BREAK				
// /// /	SINGLE LINE DUCT BREAK TRANSFER AIR DUCT				
V - ' - V 					


75mm (3/4") DOOR UNDERCUT

	MECHANICAL DRAWING LIST		
DRAWING #	DRAWING NAME		
M001	MECHANICAL LEGEND & DRAWING LIST		
M101	MECHANICAL SITE PLAN		
M200	FOUNDATION PLAN - PLUMBING & DRAINAGE		
M201	LEVEL 1 PLAN - PLUMBING & DRAINAGE		
M202	ROOF PLAN - PLUMBING & DRAINAGE		
M301	LEVEL 1 PART PLAN WEST - VENTILATION		
M302	LEVEL 1 PART PLAN EAST - VENTILATION		
M303	LEVEL 1 PART PLAN NORTH - VENTILATION		
M304	ROOF PLAN - VENTILATION		
M401	LEVEL 1 PLAN - FIRE PROTECTION		
M601	VRV SCHEMATIC		
M602	FIRE PROTECTION & GAS SCHEMATIC		
M610	MECHANICAL EQUIPMENT SCHEDULE		
M621	MECHANICAL SECTIONS		
M641	MECHANICAL DETAILS I		
M642	MECHANICAL DETAILS II		
M643	MECHANICAL DETAILS III		
M644	MECHANICAL DETAILS IV		
M645	MECHANICAL DETAILS V		
M646	MECHANICAL DETAILS VI		
M647	MECHANICAL DETAILS VII		
M648	MECHANICAL DETAILS VIII		
M650	CONTROL SEQUENCES I		
M651	CONTROL SEQUENCES II		
M652	CONTROL SEQUENCES III		

CONTROLS		
SYMBOL	DESCRIPTION	
SF	SUPPLY FAN	
RF	RETURN FAN	
EF	EXHAUST FAN	
H/ C	HEATING COIL	
<u> </u>	COOLING COIL	
P/ _C	PRE-HEAT COIL	
	FILTERS	
	HUMIDIFIER	
<u>SA</u>	SUPPLY AIR	
	EXHAUST AIR	
OA	OUTDOOR AIR	
RA	RETURN AIR	
MD	MOTORIZED DAMPER	
MSP	MOTOR STARTER PANEL	
MCC	MOTOR CONTROL CENTER	
VFD	VARIABLE FREQUENCY DRIVE	
NO	NORMALLY OPEN	
NC	NORMALLY CLOSED	
<u> </u>	NORMALLY CLOSED CONTACT NORMALLY OPEN CONTACT	
FS FS	FLOW SWITCH	
LS	LEVEL SWITCH	
PS	PRESSURE SWITCH	
NC NO	ACTUATOR NORMALLY CLOSED DE-ENERGIZED POSITION	
NO O	ACTUATOR NORMALLY OPEN DE-ENERGIZED POSITION ACTUATOR FAIL OPEN POSITION	
<u>∪</u> Ø	ACTUATOR FAIL OPEN POSITION ACTUATOR FAIL CLOSED POSITION	
FL	ACTUATOR FAIL LAST POSITION	
Ā	TWO-POSITION ACTUATOR	
	MODULATING ACTUATOR	
<u> </u>	PRESSURE SENSOR DIFFERENTIAL PRESSURE SENSOR	
<u> </u>	VELOCITY SENSOR	
Θ	HUMIDITY SENSOR	
0	TEMPERATURE SENSOR	
<u> </u>	OCCUPANCY SENSOR CARRON MONOYIDE SENSOR	
<u> </u>	CARBON MONOXIDE SENSOR NOX SENSOR	
<u> </u>	OXYGEN SENSOR	
GDP	GAS DETECTION SYSTEM CONTROL PANEL	
¤	VISUAL INDICATOR ALARM	
Ø	AUDIBLE INDICATOR ALARM	
BAS	BUILDING AUTOMATION SYSTEM	
AI AO	ANALOG INPUT ANALOG OUTPUT	
DI	DIGITAL INPUT	
DO	DIGITAL OUTPUT	
AP	BAS ADJUSTABLE SET POINT	
BV	BACNET VARIABLE	

FOR QUESTIONS REGARDING THIS PROJECT, PLEASE EMAIL: CM-20-063@QUASARCG.COM

I	ISSUED FOR TENDER	2021-08-12
Н	ISSUED FOR BUILDING PERMIT	2021-07-27
G	90% CD	2021-05-03
F	SITE PLAN RESUBMISSION	2021-04-23
Е	SPA	2021-02-12
D	50% CD	2021-02-05
С	BUILDING PERMIT	2021-02-05
В	PERMIT/SPA COORDINATION	2021-02-02
Α	100% DESIGN DEVELOPMENT	2021-01-19
No.	Revision	Date

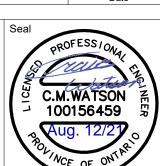

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Project Information

BFES Station 201 (SPA-2021-0032)

27 Rutherford Rd. S., Brampton, ON, L6W 3J3


City of Brampton Fire & Emergency Services

Drawing Title

MECHANICAL LEGEND & DRAWING LIST


2021-08-12 Drawn by CMW

Scale 1:1

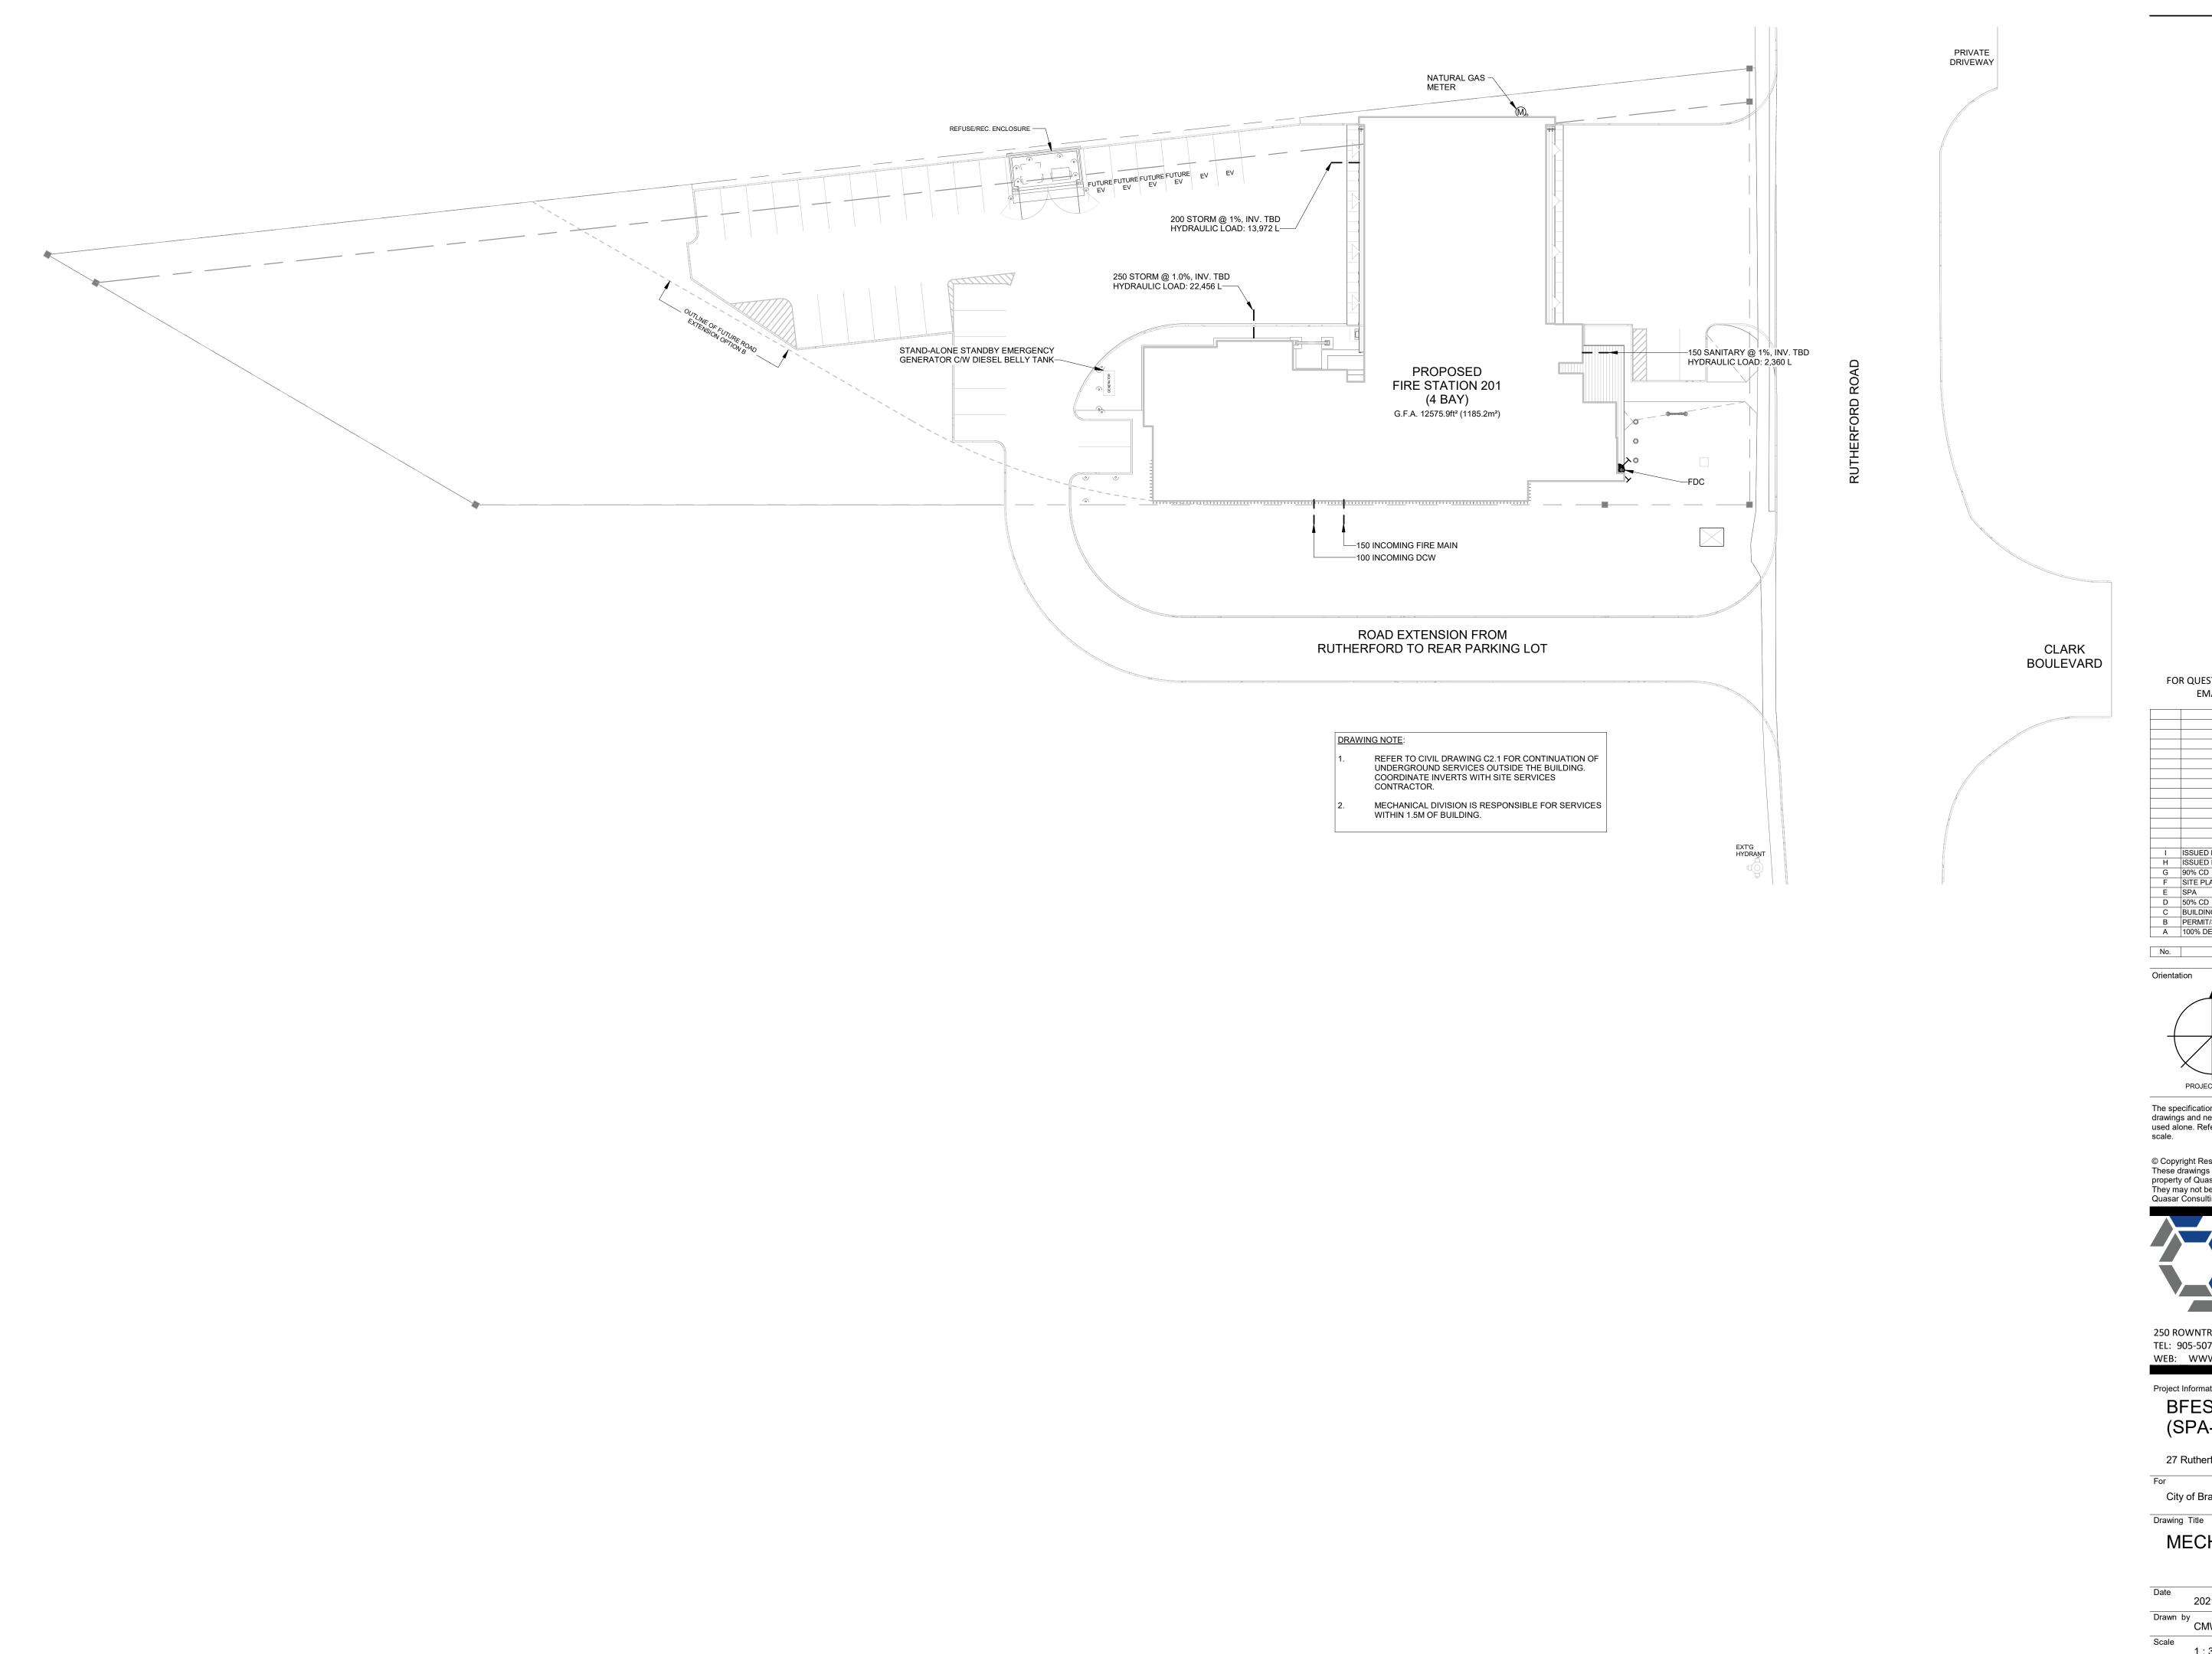

FOR QUESTIONS REGARDING THIS PROJECT, PLEASE

	ISSUED FOR TEMPER	2004.00
<u> </u>	ISSUED FOR TENDER	2021-08
Н_	ISSUED FOR BUILDING PERMIT	2021-07
G	90% CD	2021-05
F	SITE PLAN RESUBMISSION	2021-04
E	SPA	2021-02
D	50% CD	2021-02
С	BUILDING PERMIT	2021-02
В	PERMIT/SPA COORDINATION	2021-02
Α	100% DESIGN DEVELOPMENT	2021-01
No.	Revision	Date

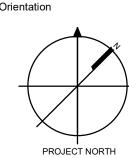

C.M.WATSON 100156459

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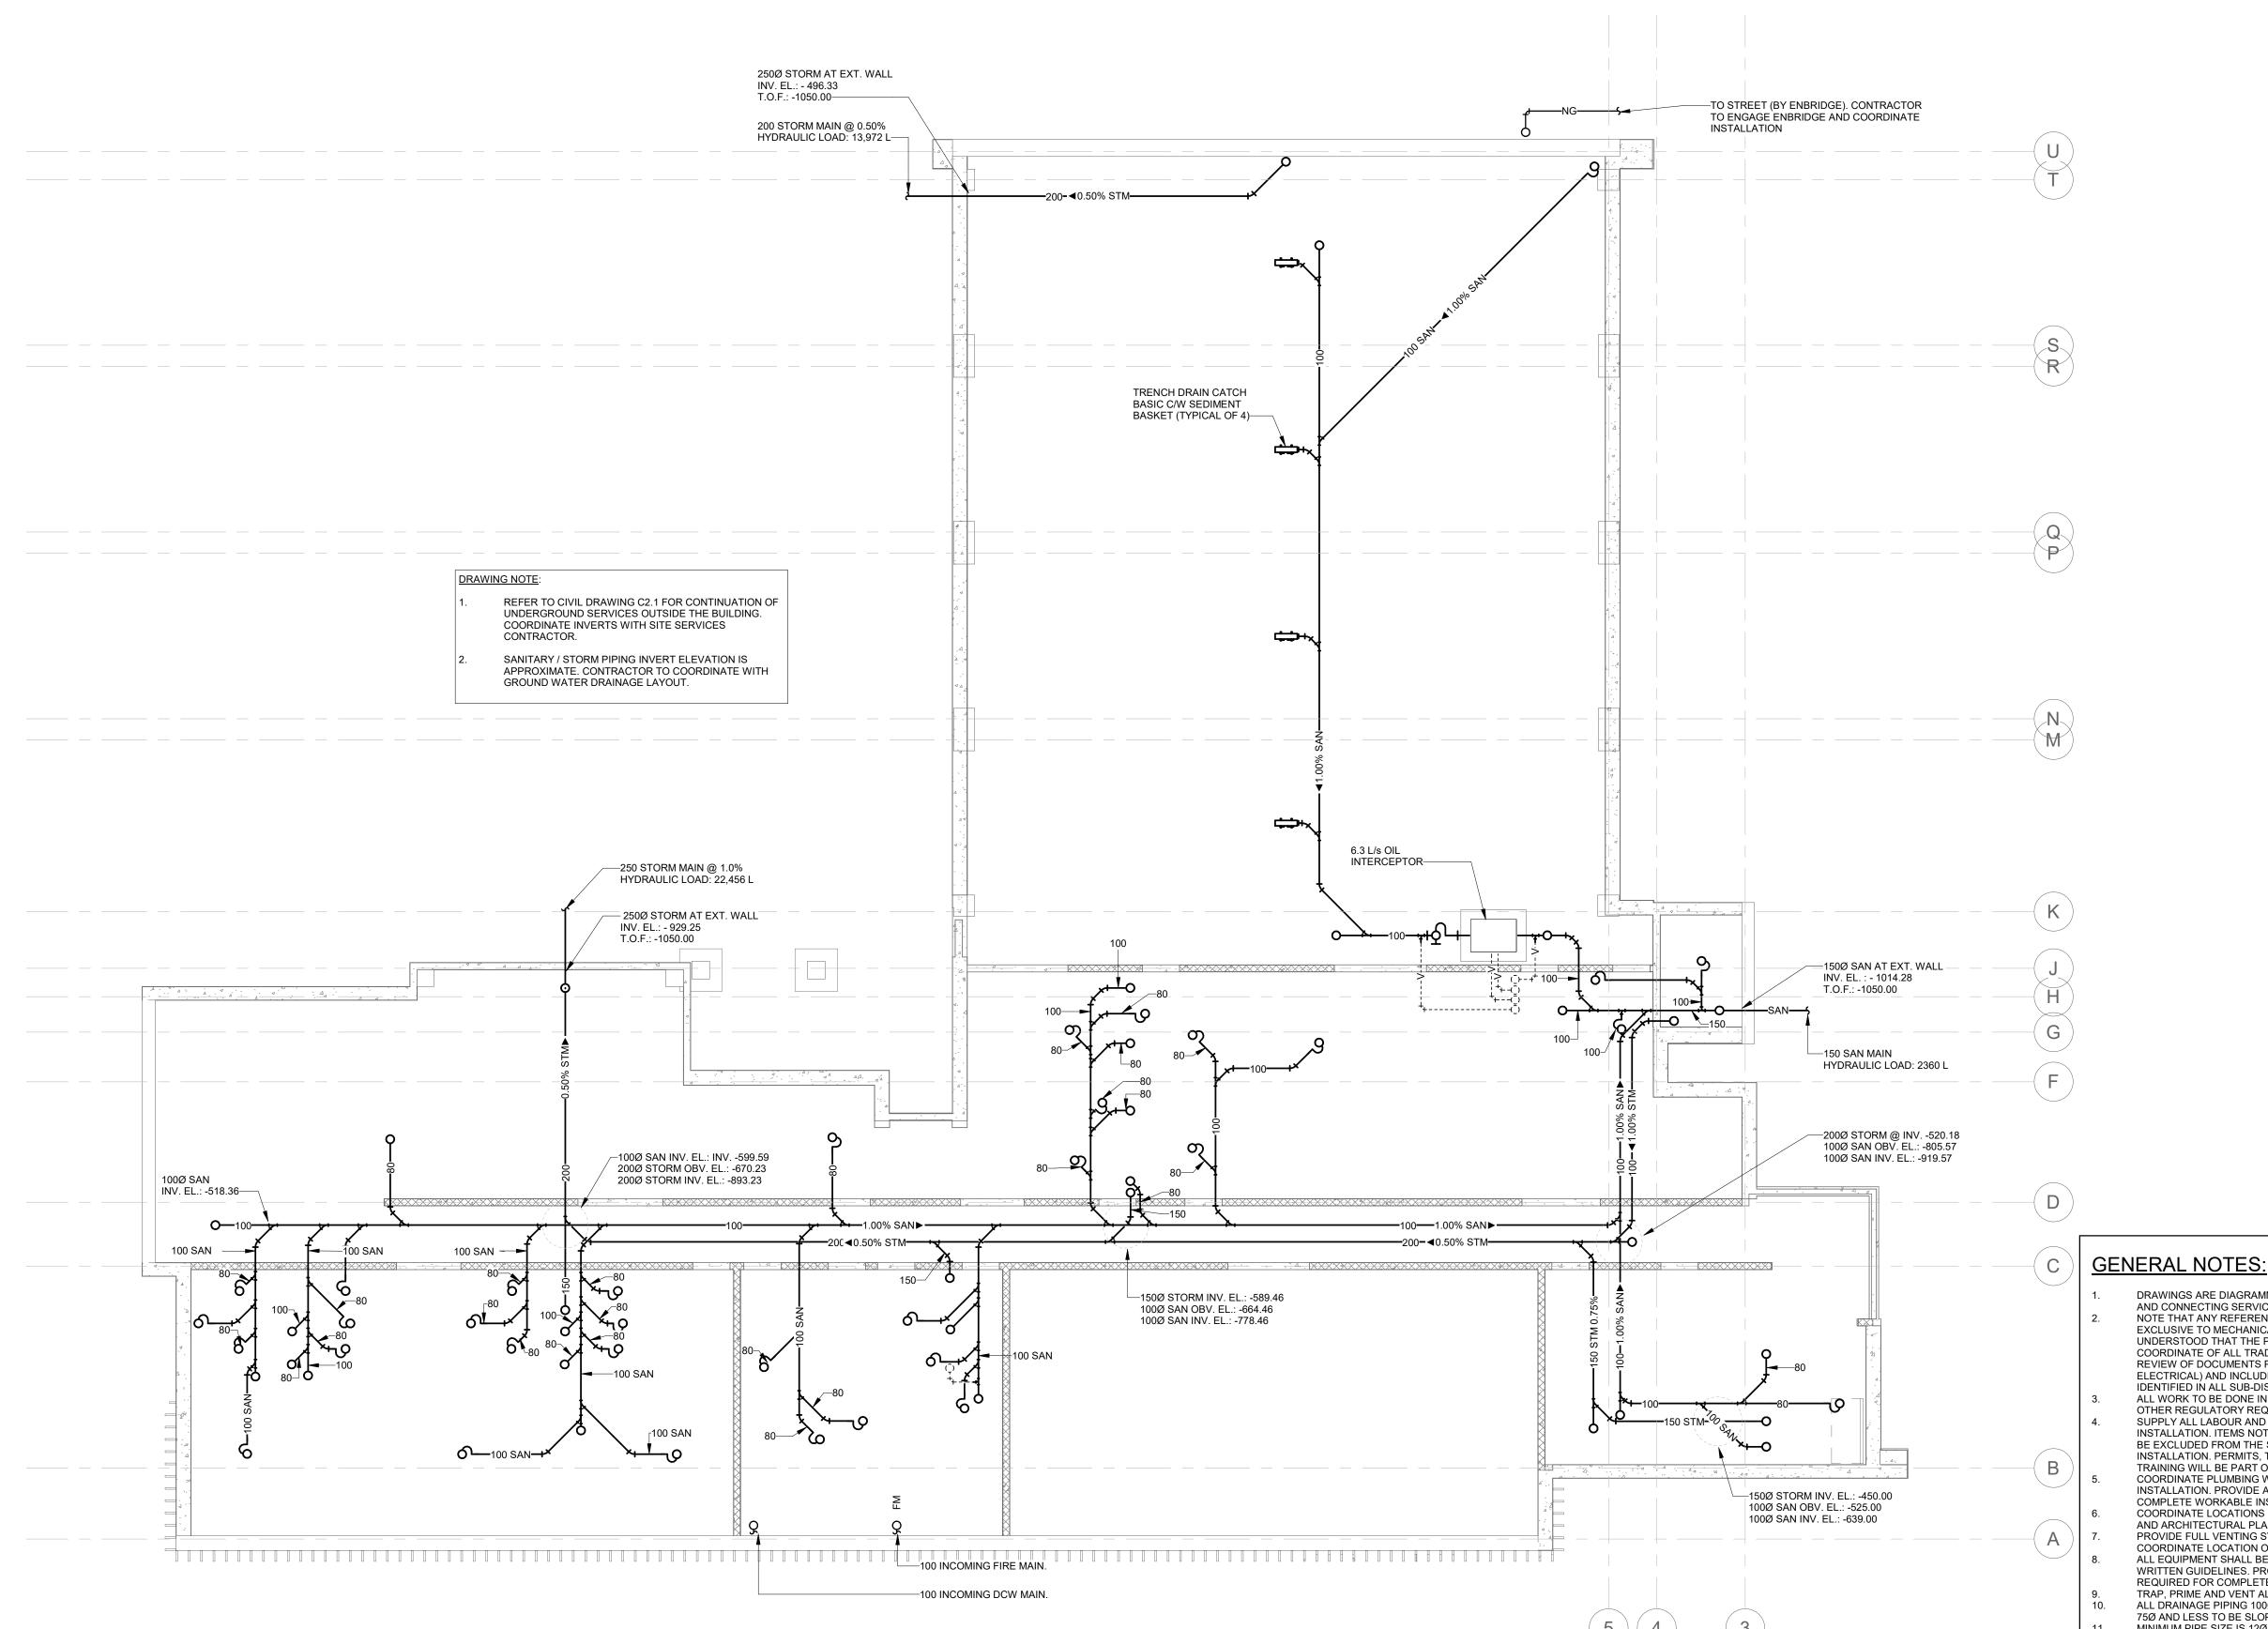
Project Information BFES Station 201 (SPA-2021-0032)

27 Rutherford Rd. S., Brampton, ON, L6W 3J3


City of Brampton Fire & Emergency Services


MECHANICAL SITE PLAN

Project No Drawing No 2021-08-12 Drawn by CMW Scale 1:300



	•	
Н	ISSUED FOR TENDER	2021-08-12
G	ISSUED FOR BUILDING PERMIT	2021-07-27
F	90% CD	2021-05-03
E	SPA	2021-02-12
D	50% CD	2021-02-05
С	BUILDING PERMIT	2021-02-05
В	PERMIT/SPA COORDINATION	2021-02-02
Α	100% DESIGN DEVELOPMENT	2021-01-19
No.	Revision	Date

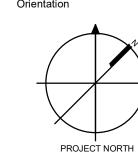

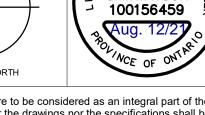

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Project Information BFES Station 201 (SPA-2021-0032)

27 Rutherford Rd. S., Brampton, ON, L6W 3J3

City of Brampton Fire & Emergency Services

As indicated

Drawing Title FOUNDATION PLAN -PLUMBING & DRAINAGE

2021-08-12

ALL WORK TO BE DONE IN ACCORDANCE WITH THE ONTARIO BUILDING CODE AND ALL OTHER REGULATORY REQUIREMENTS. SUPPLY ALL LABOUR AND MATERIALS TO PROVIDE A COMPLETE MECHANICAL INSTALLATION. ITEMS NOT EXPLICITLY ILLUSTRATED ON THE DRAWINGS ARE NOT TO

IDENTIFIED IN ALL SUB-DISCIPLINE'S DOCUMENTS.

INSTALLATION. PERMITS, TESTING, BALANCING, AND OCCUPANT OPERATIONAL TRAINING WILL BE PART OF THE WORK.

COORDINATE PLUMBING WITH WORK OF OTHER TRADES PRIOR TO FABRICATION OR INSTALLATION. PROVIDE ALL FITTINGS, OFFSETS AND TRANSITIONS REQUIRED FOR COMPLETE WORKABLE INSTALLATION.
COORDINATE LOCATIONS OF ALL ROOF OPENINGS WITH STRUCTURAL, MECHANICAL AND ARCHITECTURAL PLANS PRIOR TO ANY INSTALLATION.
PROVIDE FULL VENTING SYSTEM MITTALES.

DRAWINGS ARE DIAGRAMMATIC AND INDICATE GENERAL LOCATIONS OF EQUIPMENT AND CONNECTING SERVICES. DRAWINGS ARE NOT TO BE DIMENSIONED OR SCALED. NOTE THAT ANY REFERENCE TO CONTRACTOR ON MECHANICAL DRAWINGS IS NOT

EXCLUSIVE TO MECHANICAL CONTRACTOR OR ON PARTICULAR SUB-TRADE. IT IS

COORDINATE OF ALL TRADES' WORK AND AS SUCH SHALL BE RESPONSIBLE FOR REVIEW OF DOCUMENTS PREPARED BY ALL DISCIPLINES (I.E. MECHANICAL AND

BE EXCLUDED FROM THE SCOPE OF WORK IF REQUIRED AS PART OF A PROPER

ELECTRICAL) AND INCLUDING ALL ASSOCIATED COSTS FOR THE SCOPE OF WORK AS


UNDERSTOOD THAT THE PRIME CONTRACTOR SHALL BE RESPONSIBLE FOR

COORDINATE LOCATION OF VTRS WITH AIR INTAKES.


ALL EQUIPMENT SHALL BE INSTALLED IN ACCORDANCE WITH MANUFACTURER'S WRITTEN GUIDELINES. PROVIDE ALL FITTINGS, OFFSETS AND TRANSITIONS AS REQUIRED FOR COMPLETE INSTALLATION. TRAP, PRIME AND VENT ALL FLOOR DRAINS

ALL DRAINAGE PIPING 100Ø AND LARGER TO BE SLOPED AT 1%. ALL DRAINAGE PIPING 75Ø AND LESS TO BE SLOPED AT 2%. MINIMUM PIPE SIZE IS 12Ø UNLESS NOTED OTHERWISE.

PROVIDE ISOLATION VALVES AT EACH PLUMBING FIXTURE. ALL JANITOR'S SINKS, WALL HYDRANTS AND HOSE BIBBS TO BE PROVIDED C/W CSA VACUUM BREAKER PER OBC REQUIREMENTS.

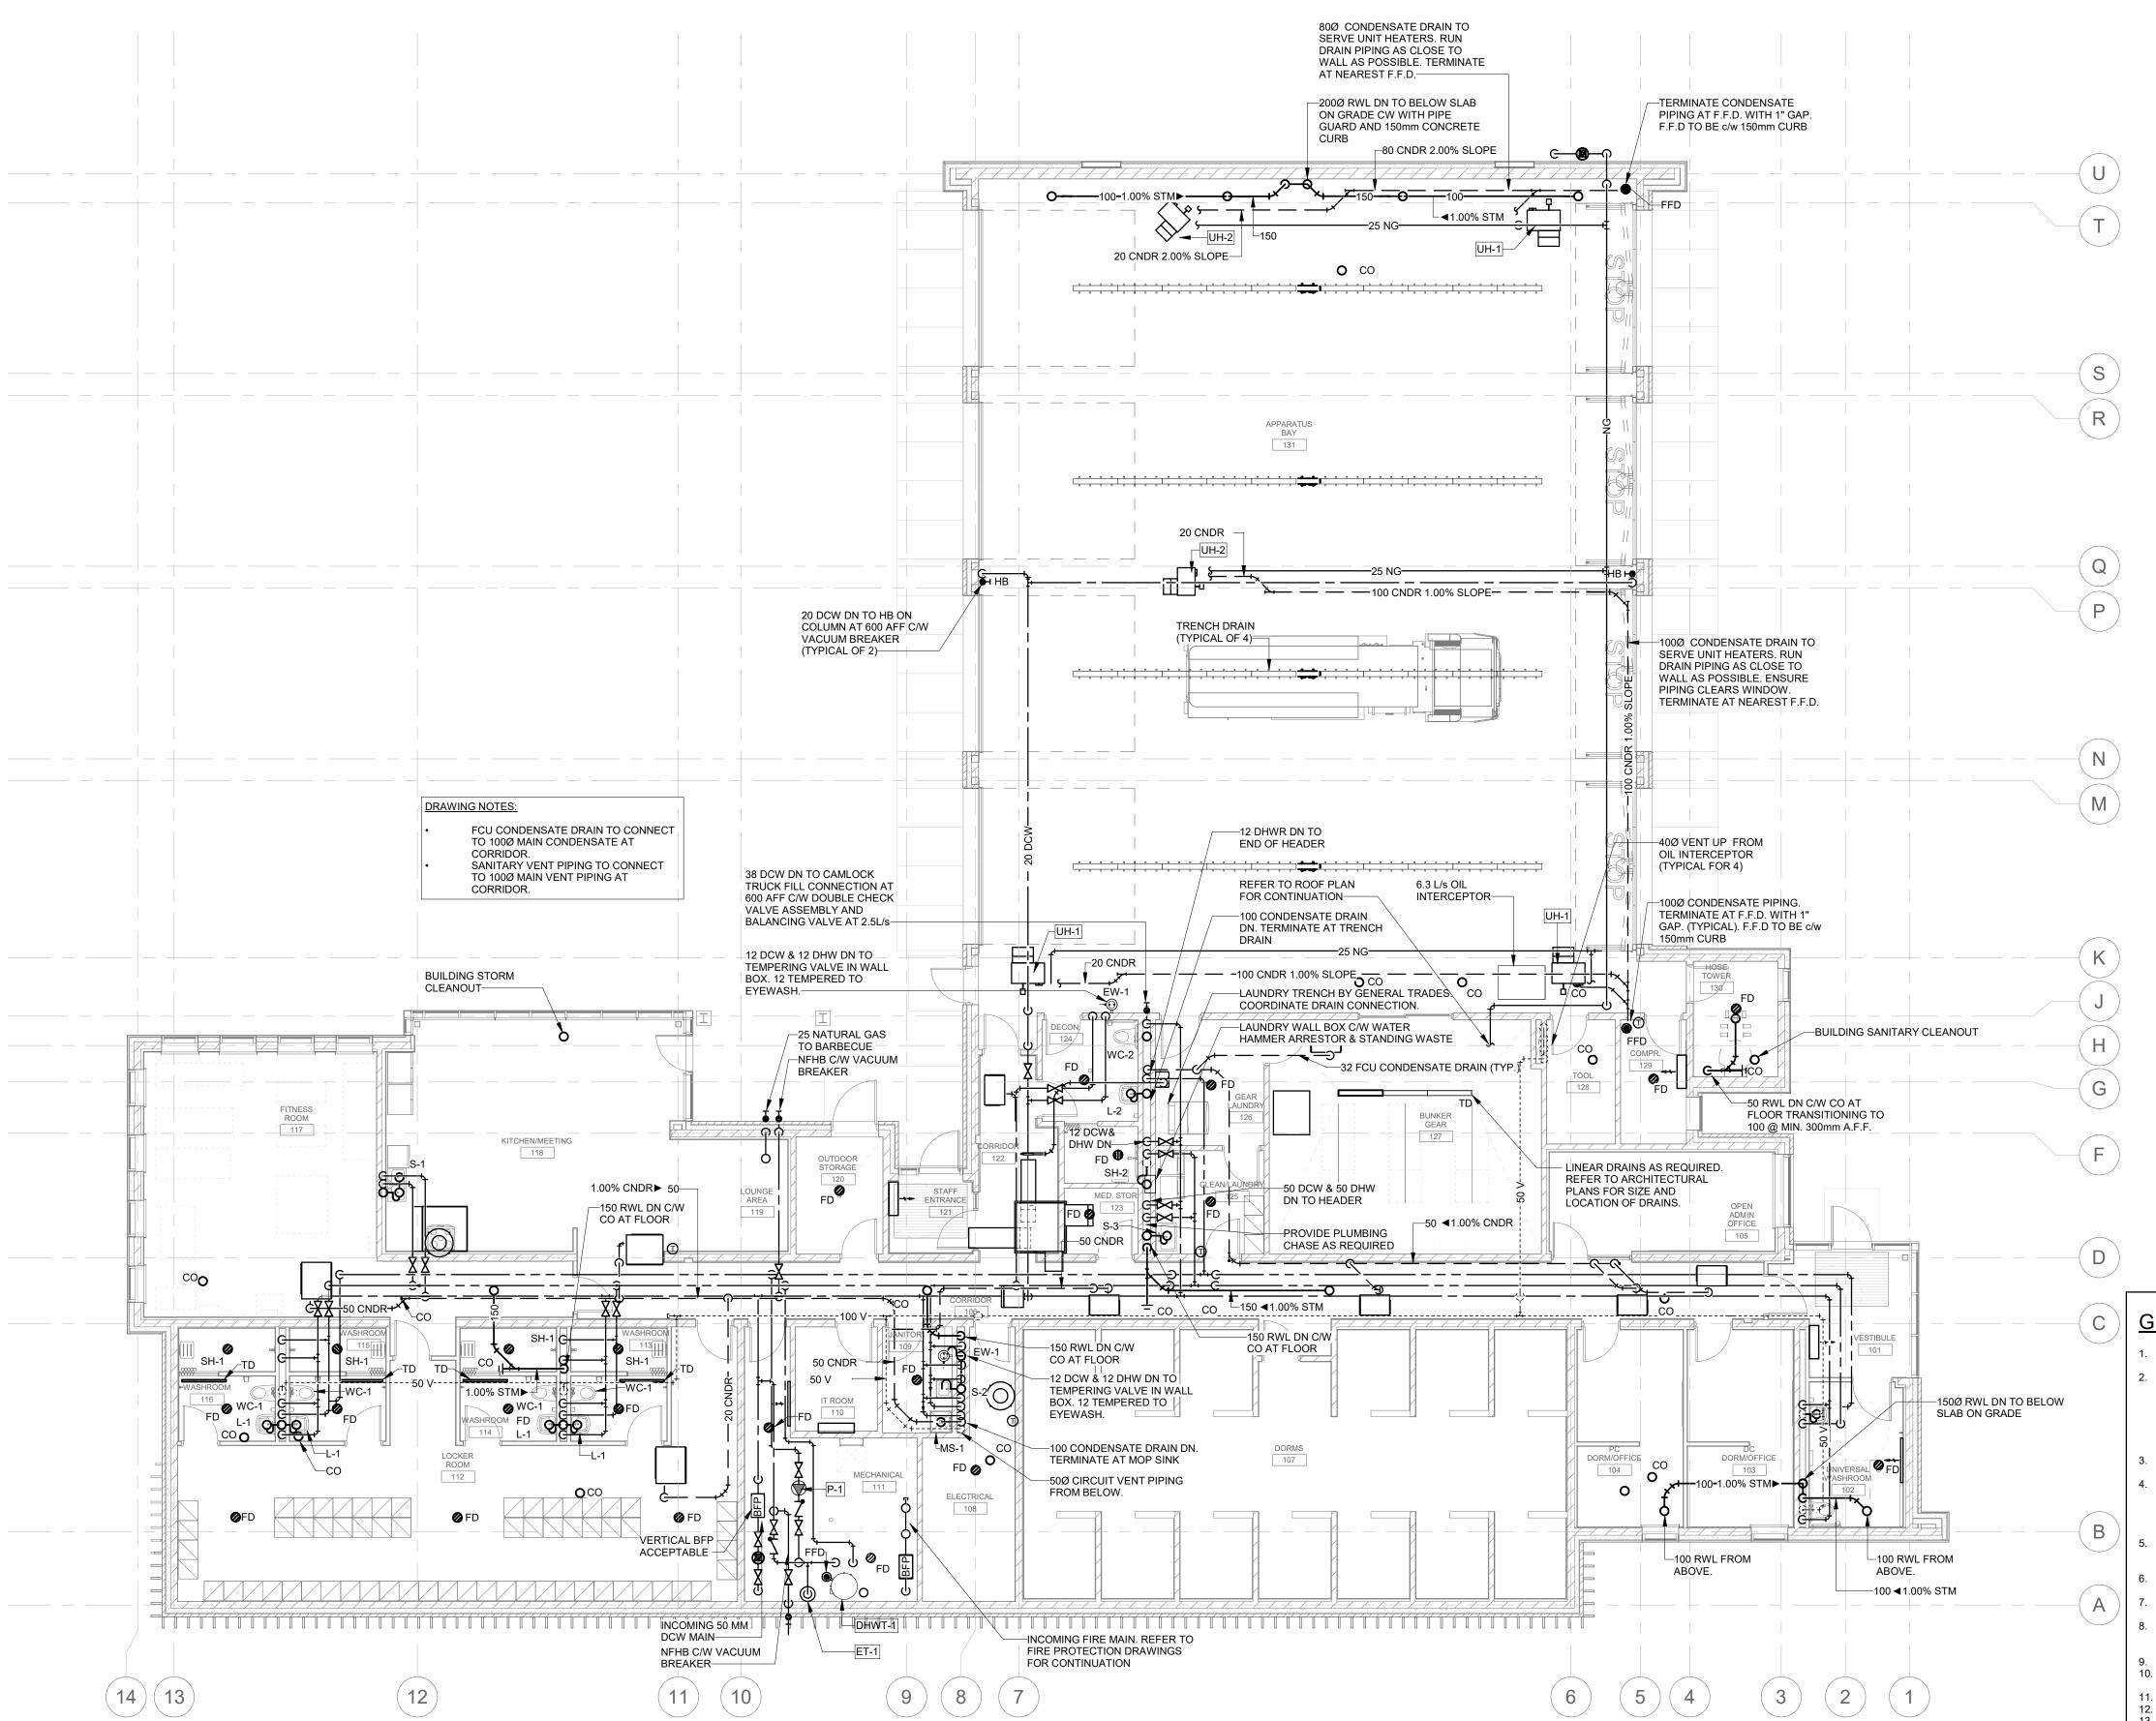

Н	ISSUED FOR TENDER	2021-08-1
G	ISSUED FOR BUILDING PERMIT	2021-07-2
F	90% CD	2021-05-0
Е	SPA	2021-02-1
D	50% CD	2021-02-0
С	BUILDING PERMIT	2021-02-0
В	PERMIT/SPA COORDINATION	2021-02-0
Α	100% DESIGN DEVELOPMENT	2021-01-1
No.	Revision	Date

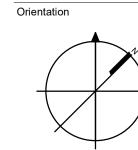

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Project Information BFES Station 201 (SPA-2021-0032)

27 Rutherford Rd. S., Brampton, ON, L6W 3J3

City of Brampton Fire & Emergency Services

Drawing Title

LEVEL 1 PLAN -PLUMBING & DRAINAGE

2021-08-12

As indicated

GENERAL NOTES:

DRAWINGS ARE DIAGRAMMATIC AND INDICATE GENERAL LOCATIONS OF EQUIPMENT AND CONNECTING SERVICES. DRAWINGS ARE NOT TO BE DIMENSIONED OR SCALED. NOTE THAT ANY REFERENCE TO CONTRACTOR ON MECHANICAL DRAWINGS IS NOT EXCLUSIVE TO MECHANICAL CONTRACTOR OR ON PARTICULAR SUB-TRADE. IT IS UNDERSTOOD THAT THE PRIME CONTRACTOR SHALL BE RESPONSIBLE FOR COORDINATE OF ALL TRADES' WORK AND AS SUCH SHALL BE RESPONSIBLE FOR REVIEW OF DOCUMENTS PREPARED BY ALL DISCIPLINES (I.E. MECHANICAL AND ELECTRICAL) AND INCLUDING ALL ASSOCIATED COSTS FOR THE SCOPE OF WORK AS IDENTIFIED IN ALL SUB-DISCIPLINE'S DOCUMENTS. ALL WORK TO BE DONE IN ACCORDANCE WITH THE ONTARIO BUILDING CODE AND ALL


OTHER REGULATORY REQUIREMENTS. SUPPLY ALL LABOUR AND MATERIALS TO PROVIDE A COMPLETE MECHANICAL INSTALLATION. ITEMS NOT EXPLICITLY ILLUSTRATED ON THE DRAWINGS ARE NOT TO BE EXCLUDED FROM THE SCOPE OF WORK IF REQUIRED AS PART OF A PROPER INSTALLATION. PERMITS, TESTING, BALANCING, AND OCCUPANT OPERATIONAL TRAINING WILL BE PART OF THE WORK.

COORDINATE PLUMBING WITH WORK OF OTHER TRADES PRIOR TO FABRICATION OR INSTALLATION. PROVIDE ALL FITTINGS, OFFSETS AND TRANSITIONS REQUIRED FOR COMPLETE WORKABLE INSTALLATION. COORDINATE LOCATIONS OF ALL ROOF OPENINGS WITH STRUCTURAL, MECHANICAL AND ARCHITECTURAL PLANS PRIOR TO ANY INSTALLATION.
PROVIDE FULL VENTING SYSTEM IN ACCORDANCE TO PART 7 OF THE OBC. COORDINATE LOCATION OF VTRS WITH AIR INTAKES.


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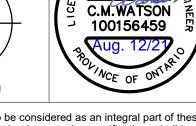
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ALL JANITOR'S SINKS, WALL HYDRANTS AND HOSE BIBBS TO BE PROVIDED C/W CSA VACUUM BREAKER PER OBC REQUIREMENTS.



Н	ISSUED FOR TENDER	2021-08-1
G	ISSUED FOR BUILDING PERMIT	2021-07-2
F	90% CD	2021-05-0
E	SPA	2021-02-1
D	50% CD	2021-02-0
С	BUILDING PERMIT	2021-02-0
В	PERMIT/SPA COORDINATION	2021-02-0
Α	100% DESIGN DEVELOPMENT	2021-01-1
No.	Revision	Date

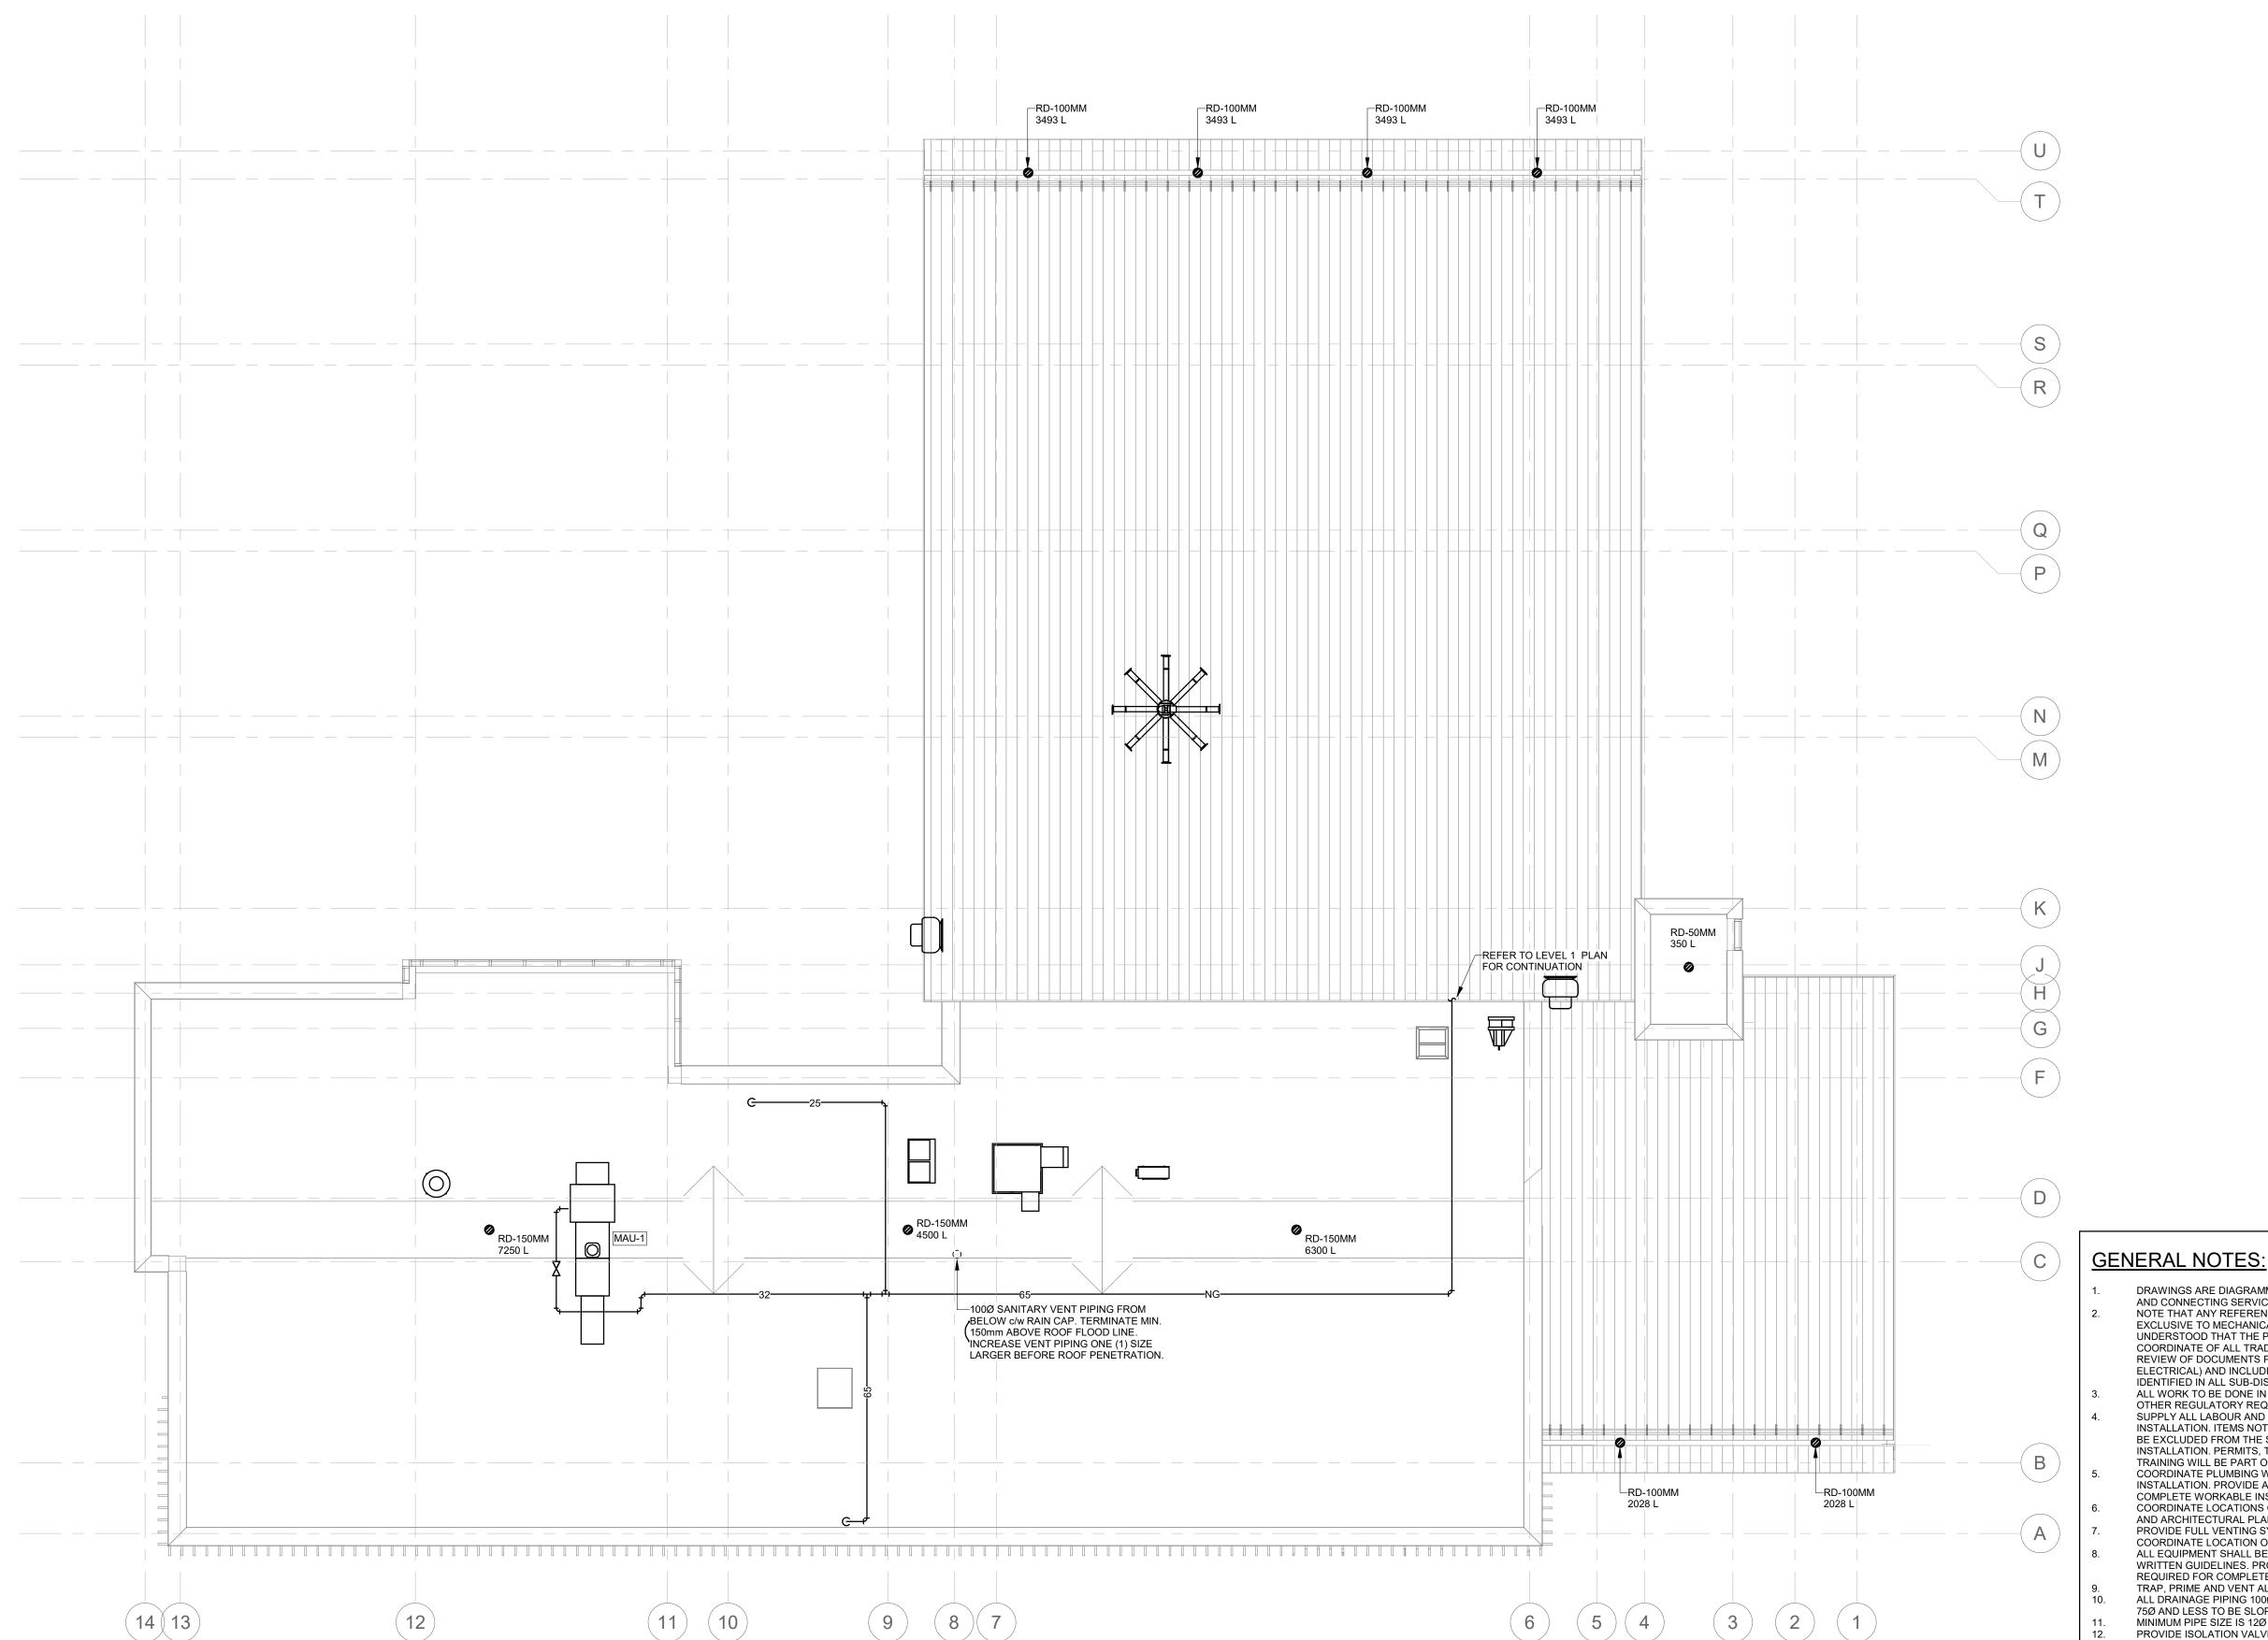

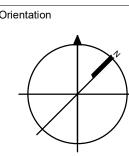

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Project Information BFES Station 201 (SPA-2021-0032)

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27 Rutherford Rd. S., Brampton, ON, L6W 3J3

City of Brampton Fire & Emergency Services

Drawing Title ROOF PLAN - PLUMBING &

DRAINAGE

Project No Drawing No 2021-08-12

As indicated


75Ø AND LESS TO BE SLOPED AT 2%. MINIMUM PIPE SIZE IS 12Ø UNLESS NOTED OTHERWISE.

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- ELECTRICAL) AND INCLUDING ALL ASSOCIATED COSTS FOR THE SCOPE OF WORK AS IDENTIFIED IN ALL SUB-DISCIPLINE'S DOCUMENTS. ALL WORK TO BE DONE IN ACCORDANCE WITH THE ONTARIO BUILDING CODE AND ALL OTHER REGULATORY REQUIREMENTS.

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- COMPLETE WORKABLE INSTALLATION. COORDINATE LOCATIONS OF ALL ROOF OPENINGS WITH STRUCTURAL, MECHANICAL AND ARCHITECTURAL PLANS PRIOR TO ANY INSTALLATION.
 PROVIDE FULL VENTING SYSTEM IN ACCORDANCE TO PART 7 OF THE OBC.
- COORDINATE LOCATION OF VTRS WITH AIR INTAKES. ALL EQUIPMENT SHALL BE INSTALLED IN ACCORDANCE WITH MANUFACTURER'S WRITTEN GUIDELINES. PROVIDE ALL FITTINGS, OFFSETS AND TRANSITIONS AS REQUIRED FOR COMPLETE INSTALLATION.
- TRAP, PRIME AND VENT ALL FLOOR DRAINS ALL DRAINAGE PIPING 100Ø AND LARGER TO BE SLOPED AT 1%. ALL DRAINAGE PIPING
- PROVIDE ISOLATION VALVES AT EACH PLUMBING FIXTURE. ALL JANITOR'S SINKS, WALL HYDRANTS AND HOSE BIBBS TO BE PROVIDED C/W CSA VACUUM BREAKER PER OBC REQUIREMENTS.




GENERAL NOTES:

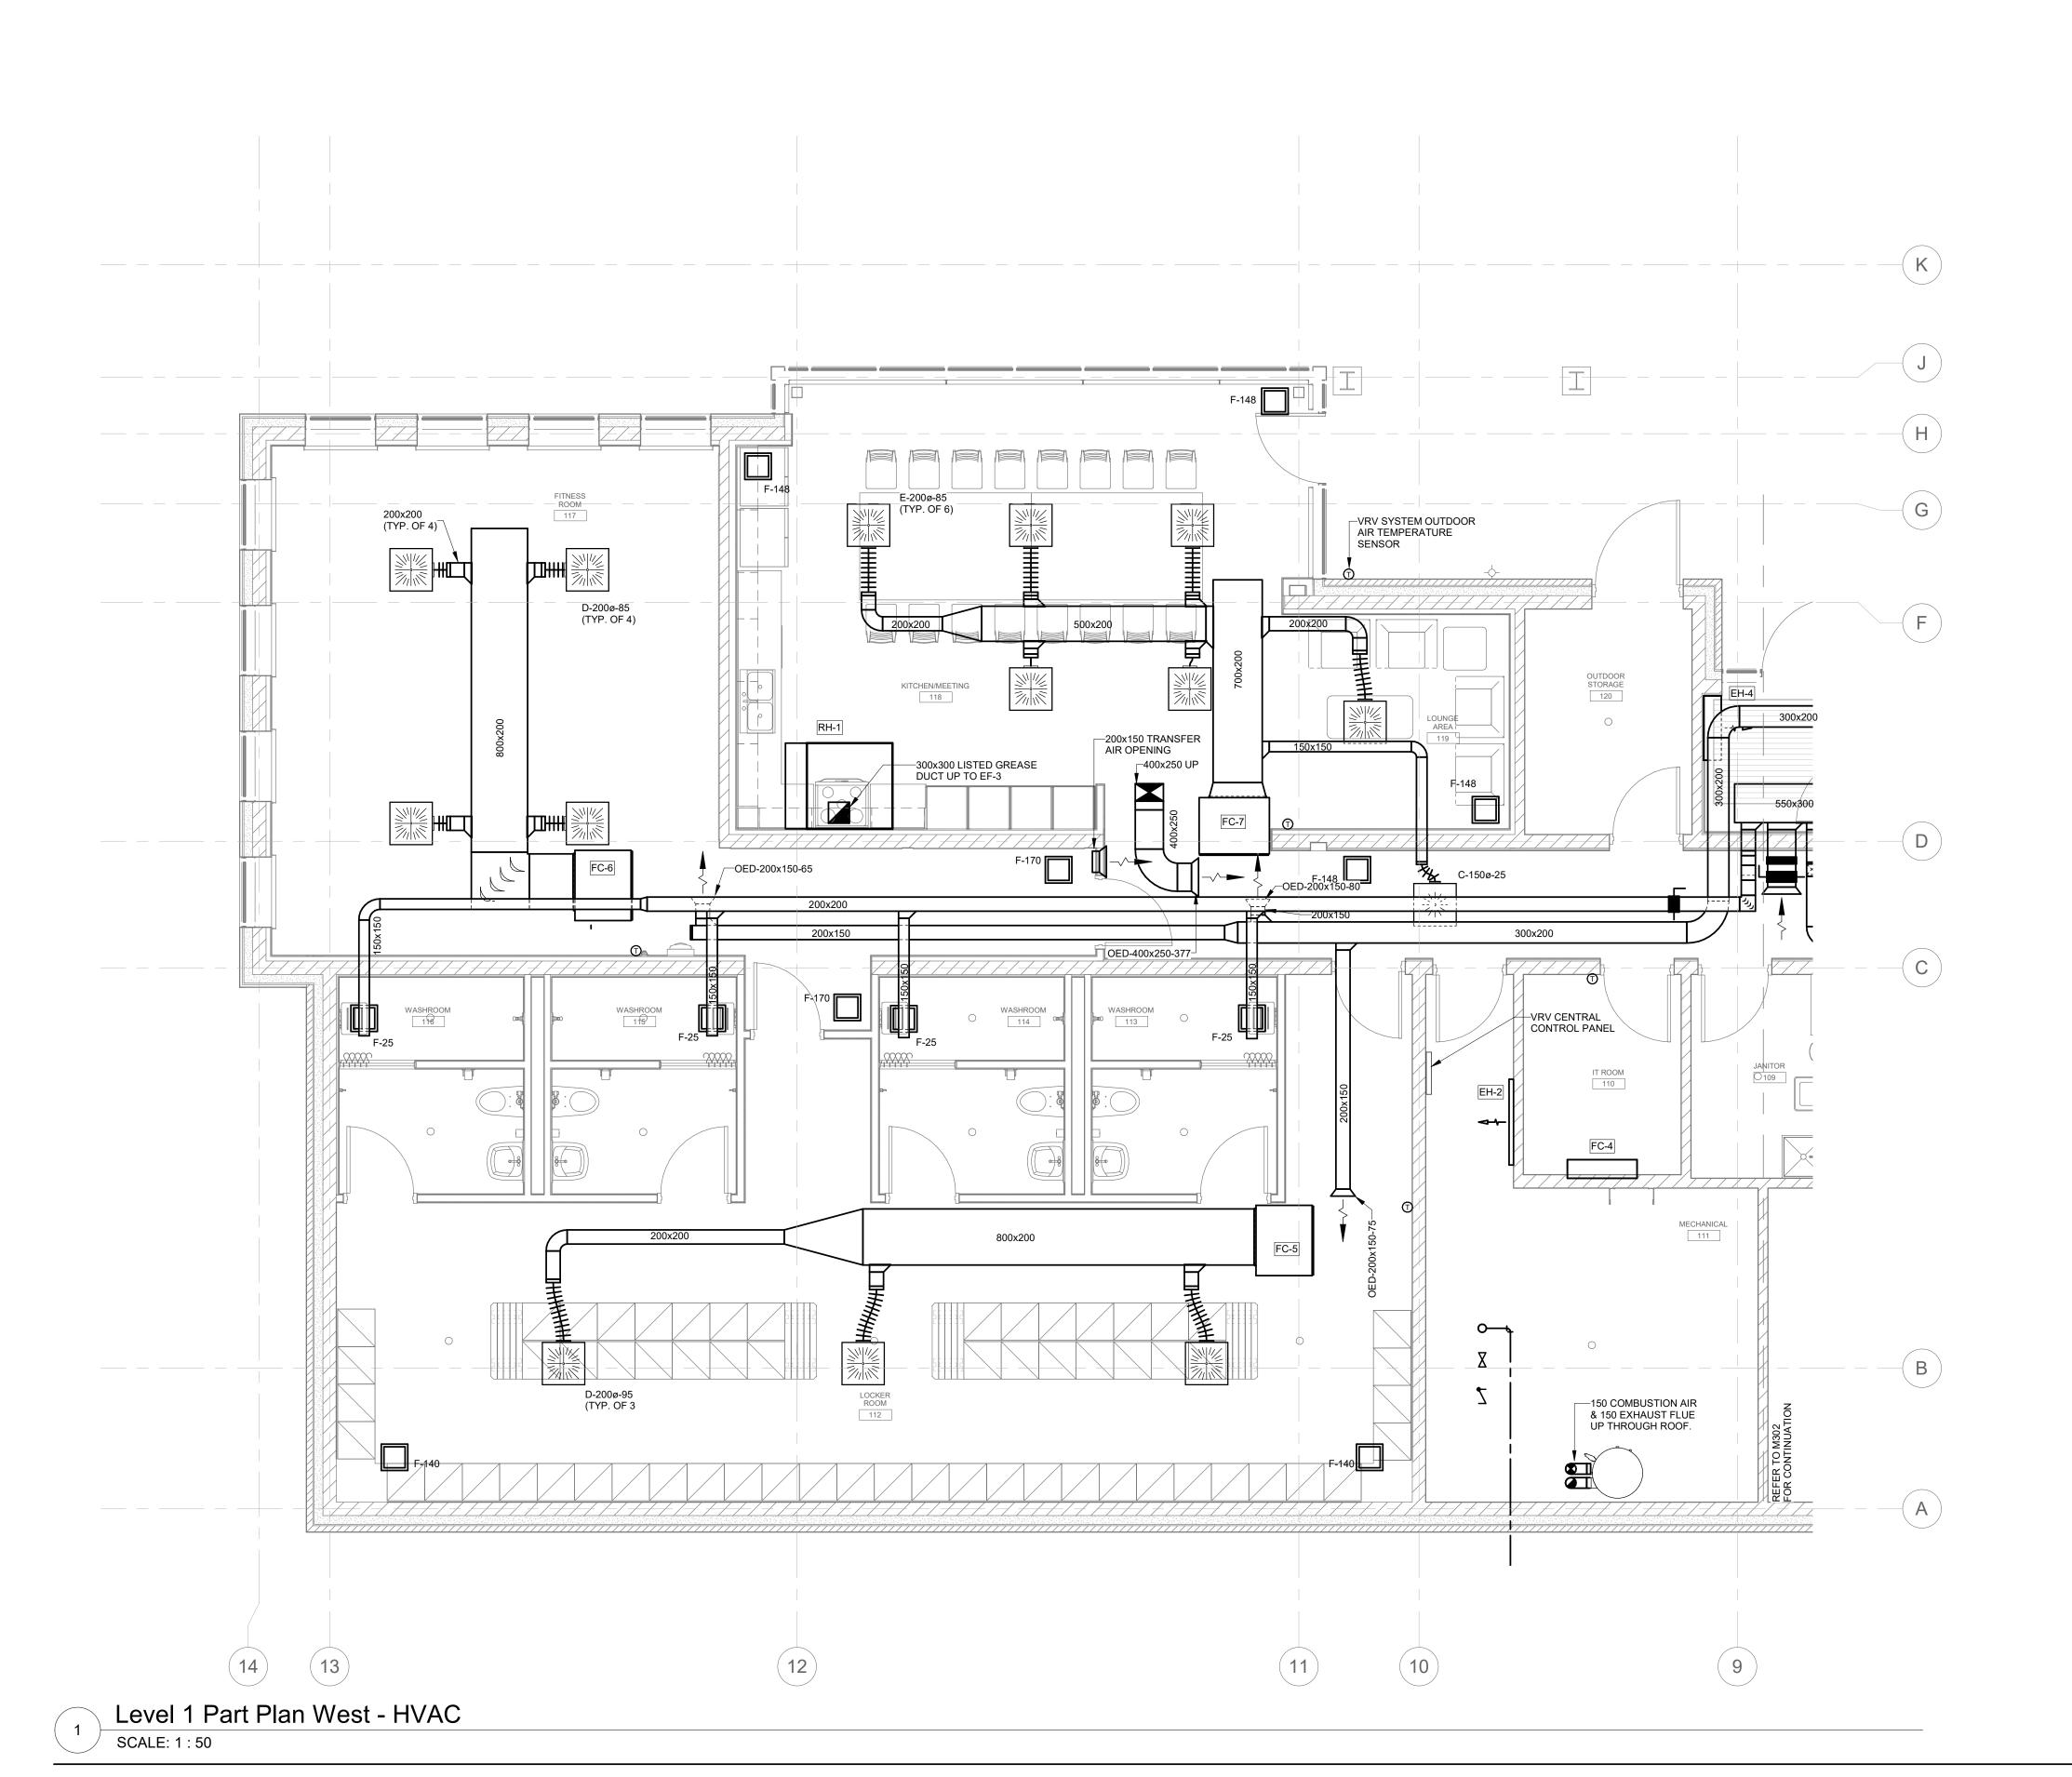
INDICATED.

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- ALL WORK TO BE DONE IN ACCORDANCE WITH THE ONTARIO BUILDING CODE AND ALL OTHER REGULATORY REQUIREMENTS.
- SUPPLY ALL LABOUR AND MATERIALS TO PROVIDE A COMPLETE MECHANICAL INSTALLATION. ITEMS NOT EXPLICITLY ILLUSTRATED ON THE DRAWINGS ARE NOT TO BE EXCLUDED FROM THE SCOPE OF WORK IF REQUIRED AS PART OF A PROPER INSTALLATION. PERMITS, TESTING, BALANCING, AND OCCUPANT OPERATIONAL TRAINING WILL BE PART OF THE WORK.
- EXACT LOCATION OF ALL CEILING DIFFUSERS, REGISTERS AND GRILLES ARE DETAILED ON ARCHITECTURAL REFLECTED CEILING PLANS. THE LOCATION OF ALL ROOF OPENINGS SHALL BE AS INDICATED ON THE MECHANICAL, STRUCTURAL AND ARCHITECTURAL DRAWINGS. COORDINATE EXACT SIZES OF OPENINGS
- AS REQUIRED. ALL EQUIPMENT SHALL BE INSTALLED IN STRICT ACCORDANCE WITH MANUFACTURER'S RECOMMENDATIONS. PROVIDE ALL FITTINGS, TRANSITIONS, DAMPERS ETC AS REQUIRED FOR COMPLETE WORKABLE INSTALLATION.
- DUCTWORK SHALL BE INSULATED OR LINED PER SPECIFICATIONS AND/OR AS NOTED ON DRAWINGS. ALL DUCT JOINTS AND SEAMS SHALL BE SEAL PER SPECIFICATIONS. DUCT AND PLENUM SIZES ARE CLEAR INSIDE DIMENSIONS. WHERE DUCTWORK AND PLENUMS ARE INTERNALLY LINED, THEIR SIZES SHALL BE ADJUSTED TO PROVIDE THE INSIDE CLEAR DIMENSIONS INDICATED ON THE DRAWINGS.
- MANUAL BALANCING DAMPERS SHALL BE PROVIDED IN ALL DUCT BRANCHES AND IN ALL BRANCHES TO INDIVIDUAL DIFFUSERS, GRILLES AND REGISTERS, WHETHER SHOWN OR
- ALL DUCTWORK LOCATED OUTSIDE THE BUILDING SHALL BE WEATHERPROOFED.
 CONTRACTOR SHALL INSTALL ANY DUCT MOUNTED SMOKE DETECTORS FURNISHED BY
 THE ELECTRICAL CONTRACTOR.
- LIMIT LENGTHS OF FLEXIBLE DUCT TO 1200mm

 COORDINATE LOCATIONS OF WALL MOUNTED SENSORS WITH ARCHITECTURAL DRAWINGS. MINIMUM DUCT SIZE TO DIFFUSERS TO MATCH DIFFUSER NEXT SIZE UNLESS OTHERWISE

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Project Information

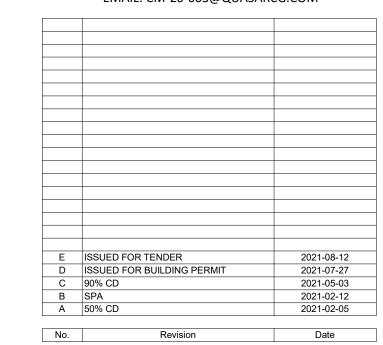BFES Station 201 (SPA-2021-0032)

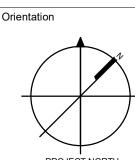27 Rutherford Rd. S., Brampton, ON, L6W 3J3

City of Brampton Fire & Emergency Services

Drawing Title


LEVEL 1 PART PLAN WEST - VENTILATION


2021-08-12

Drawn by CM-20-063 M301


As indicated

Scale

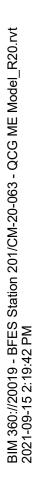

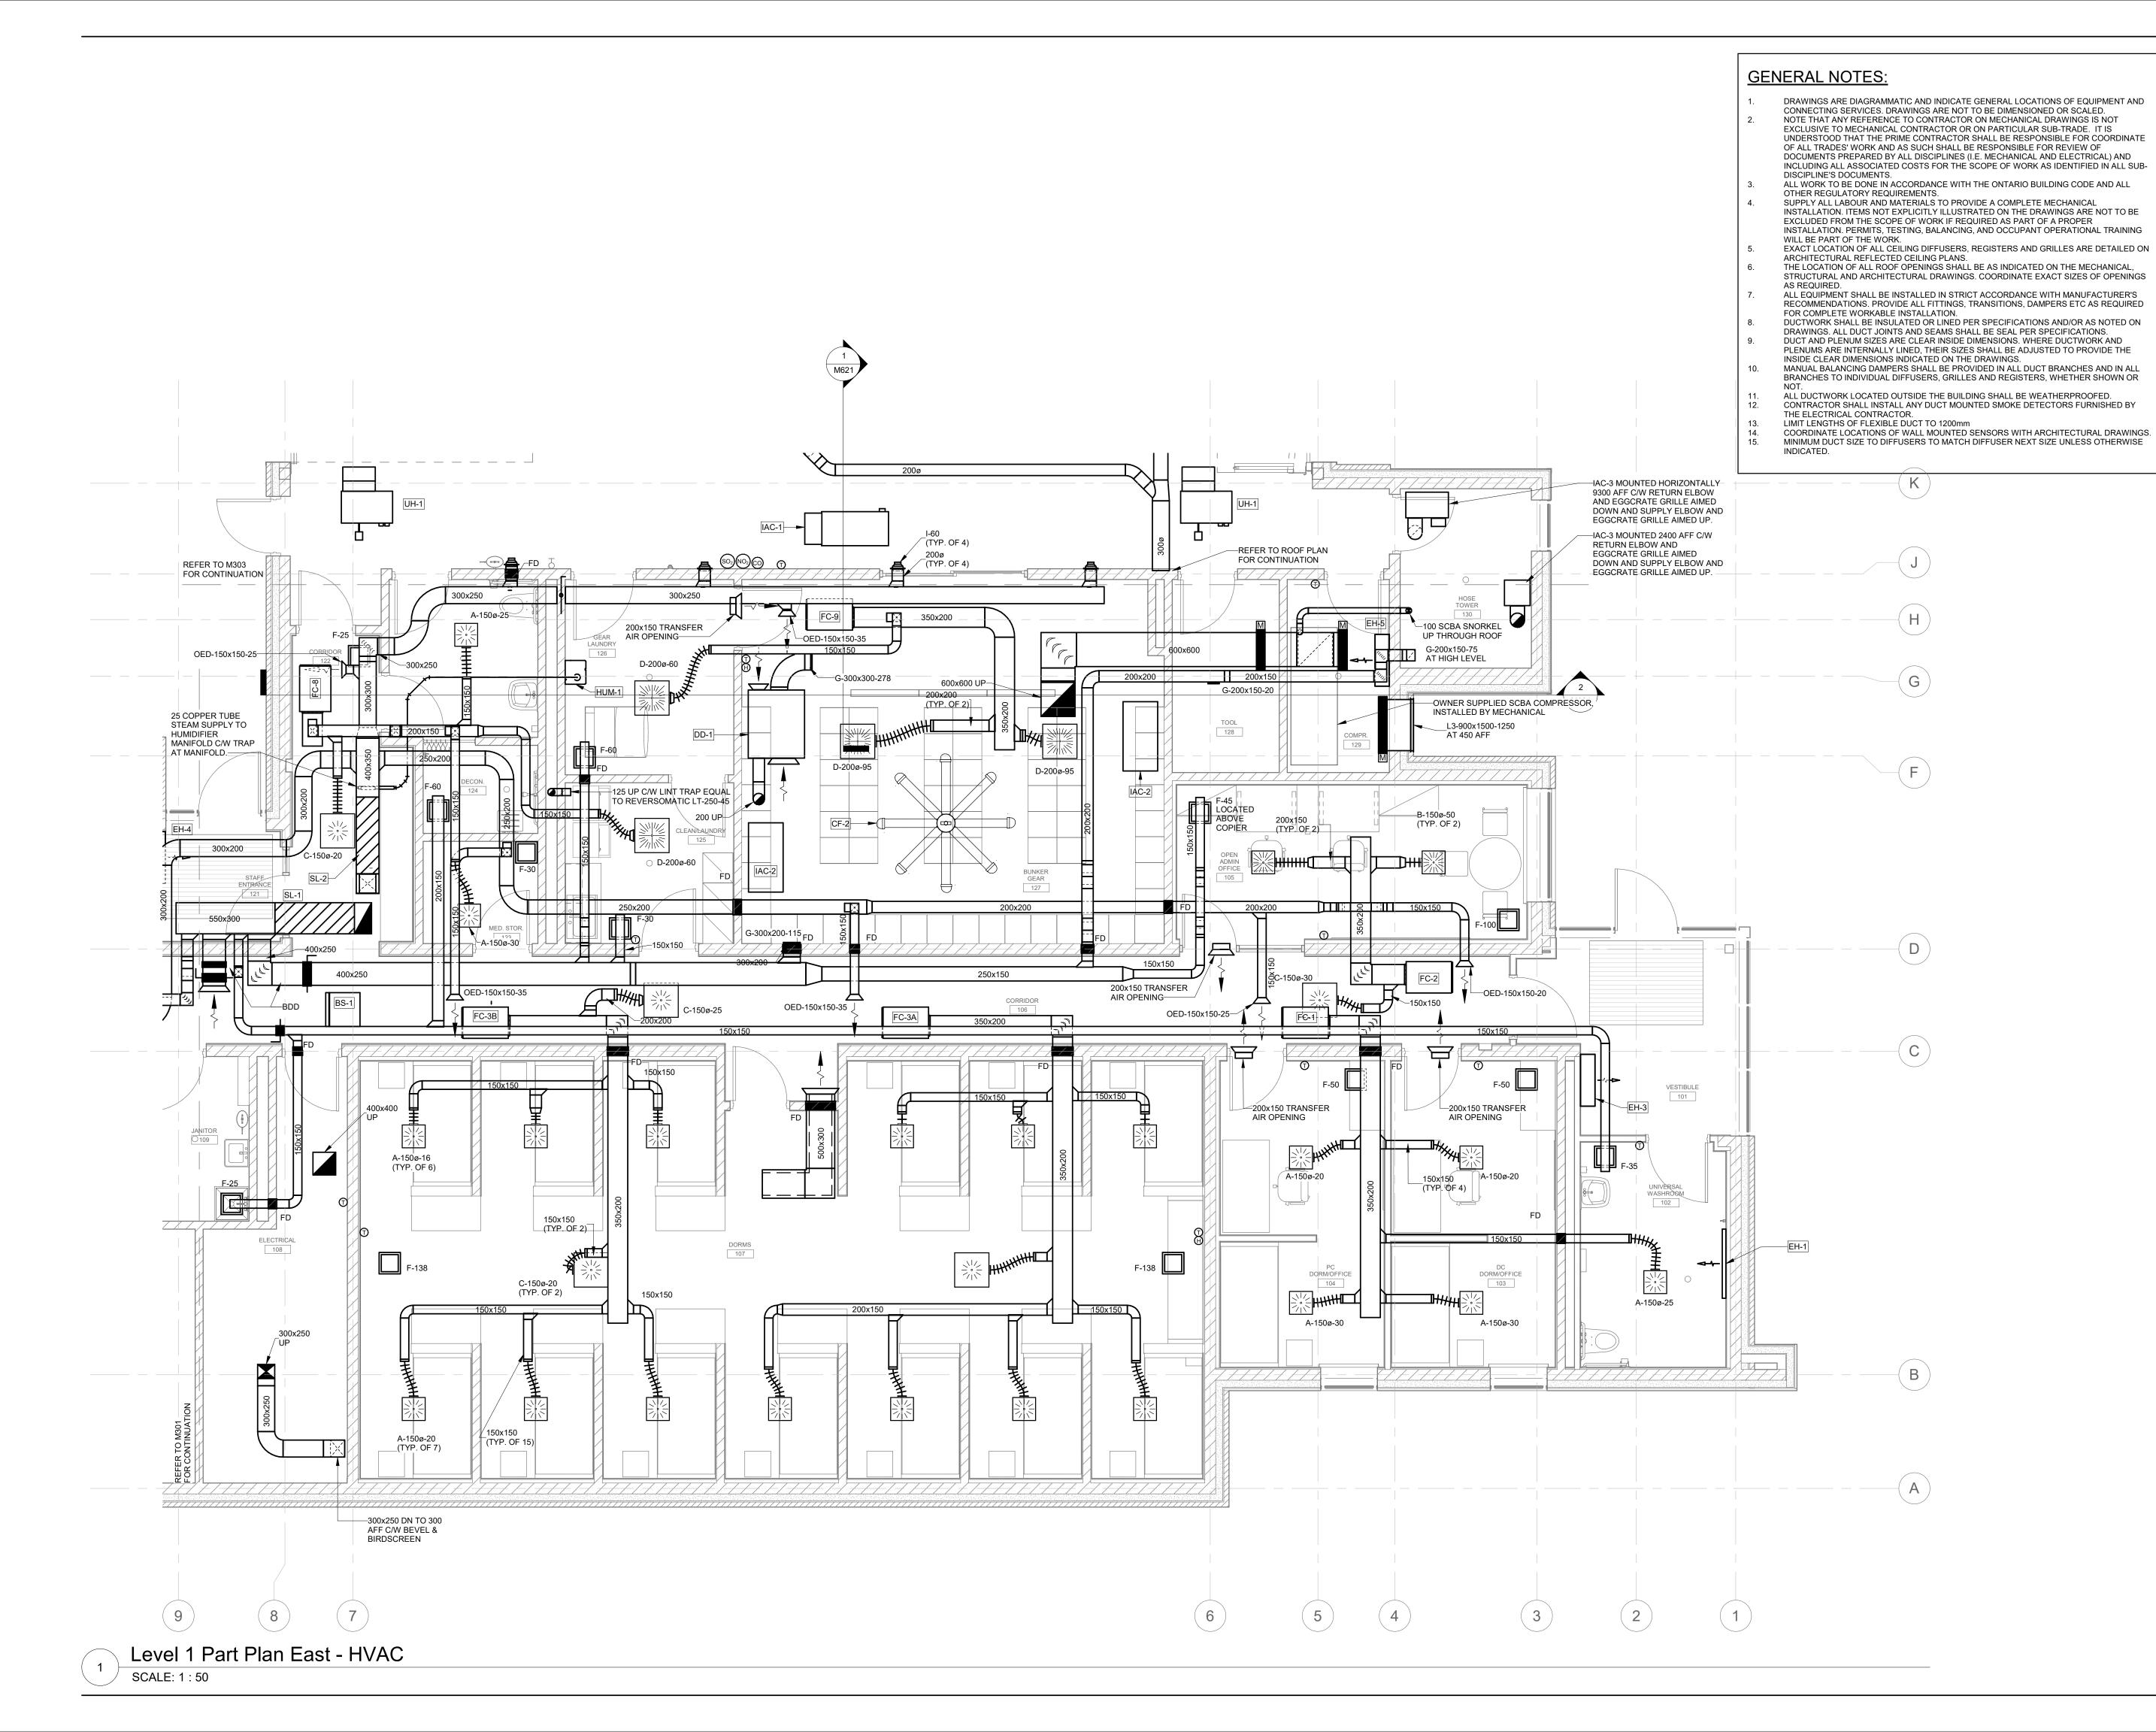

E	ISSUED FOR TENDER	2021-08-12
D	ISSUED FOR BUILDING PERMIT	2021-07-27
С	90% CD	2021-05-03
В	SPA	2021-02-12
Α	50% CD	2021-02-05
No.	Revision	Date

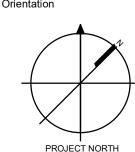

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BFES Station 201 (SPA-2021-0032)

27 Rutherford Rd. S., Brampton, ON, L6W 3J3

City of Brampton Fire & Emergency Services


Drawing Title

LEVEL 1 PART PLAN EAST - VENTILATION

Project No Drawing No 2021-08-12 Drawn by CM-20-063 M302

Scale

As indicated

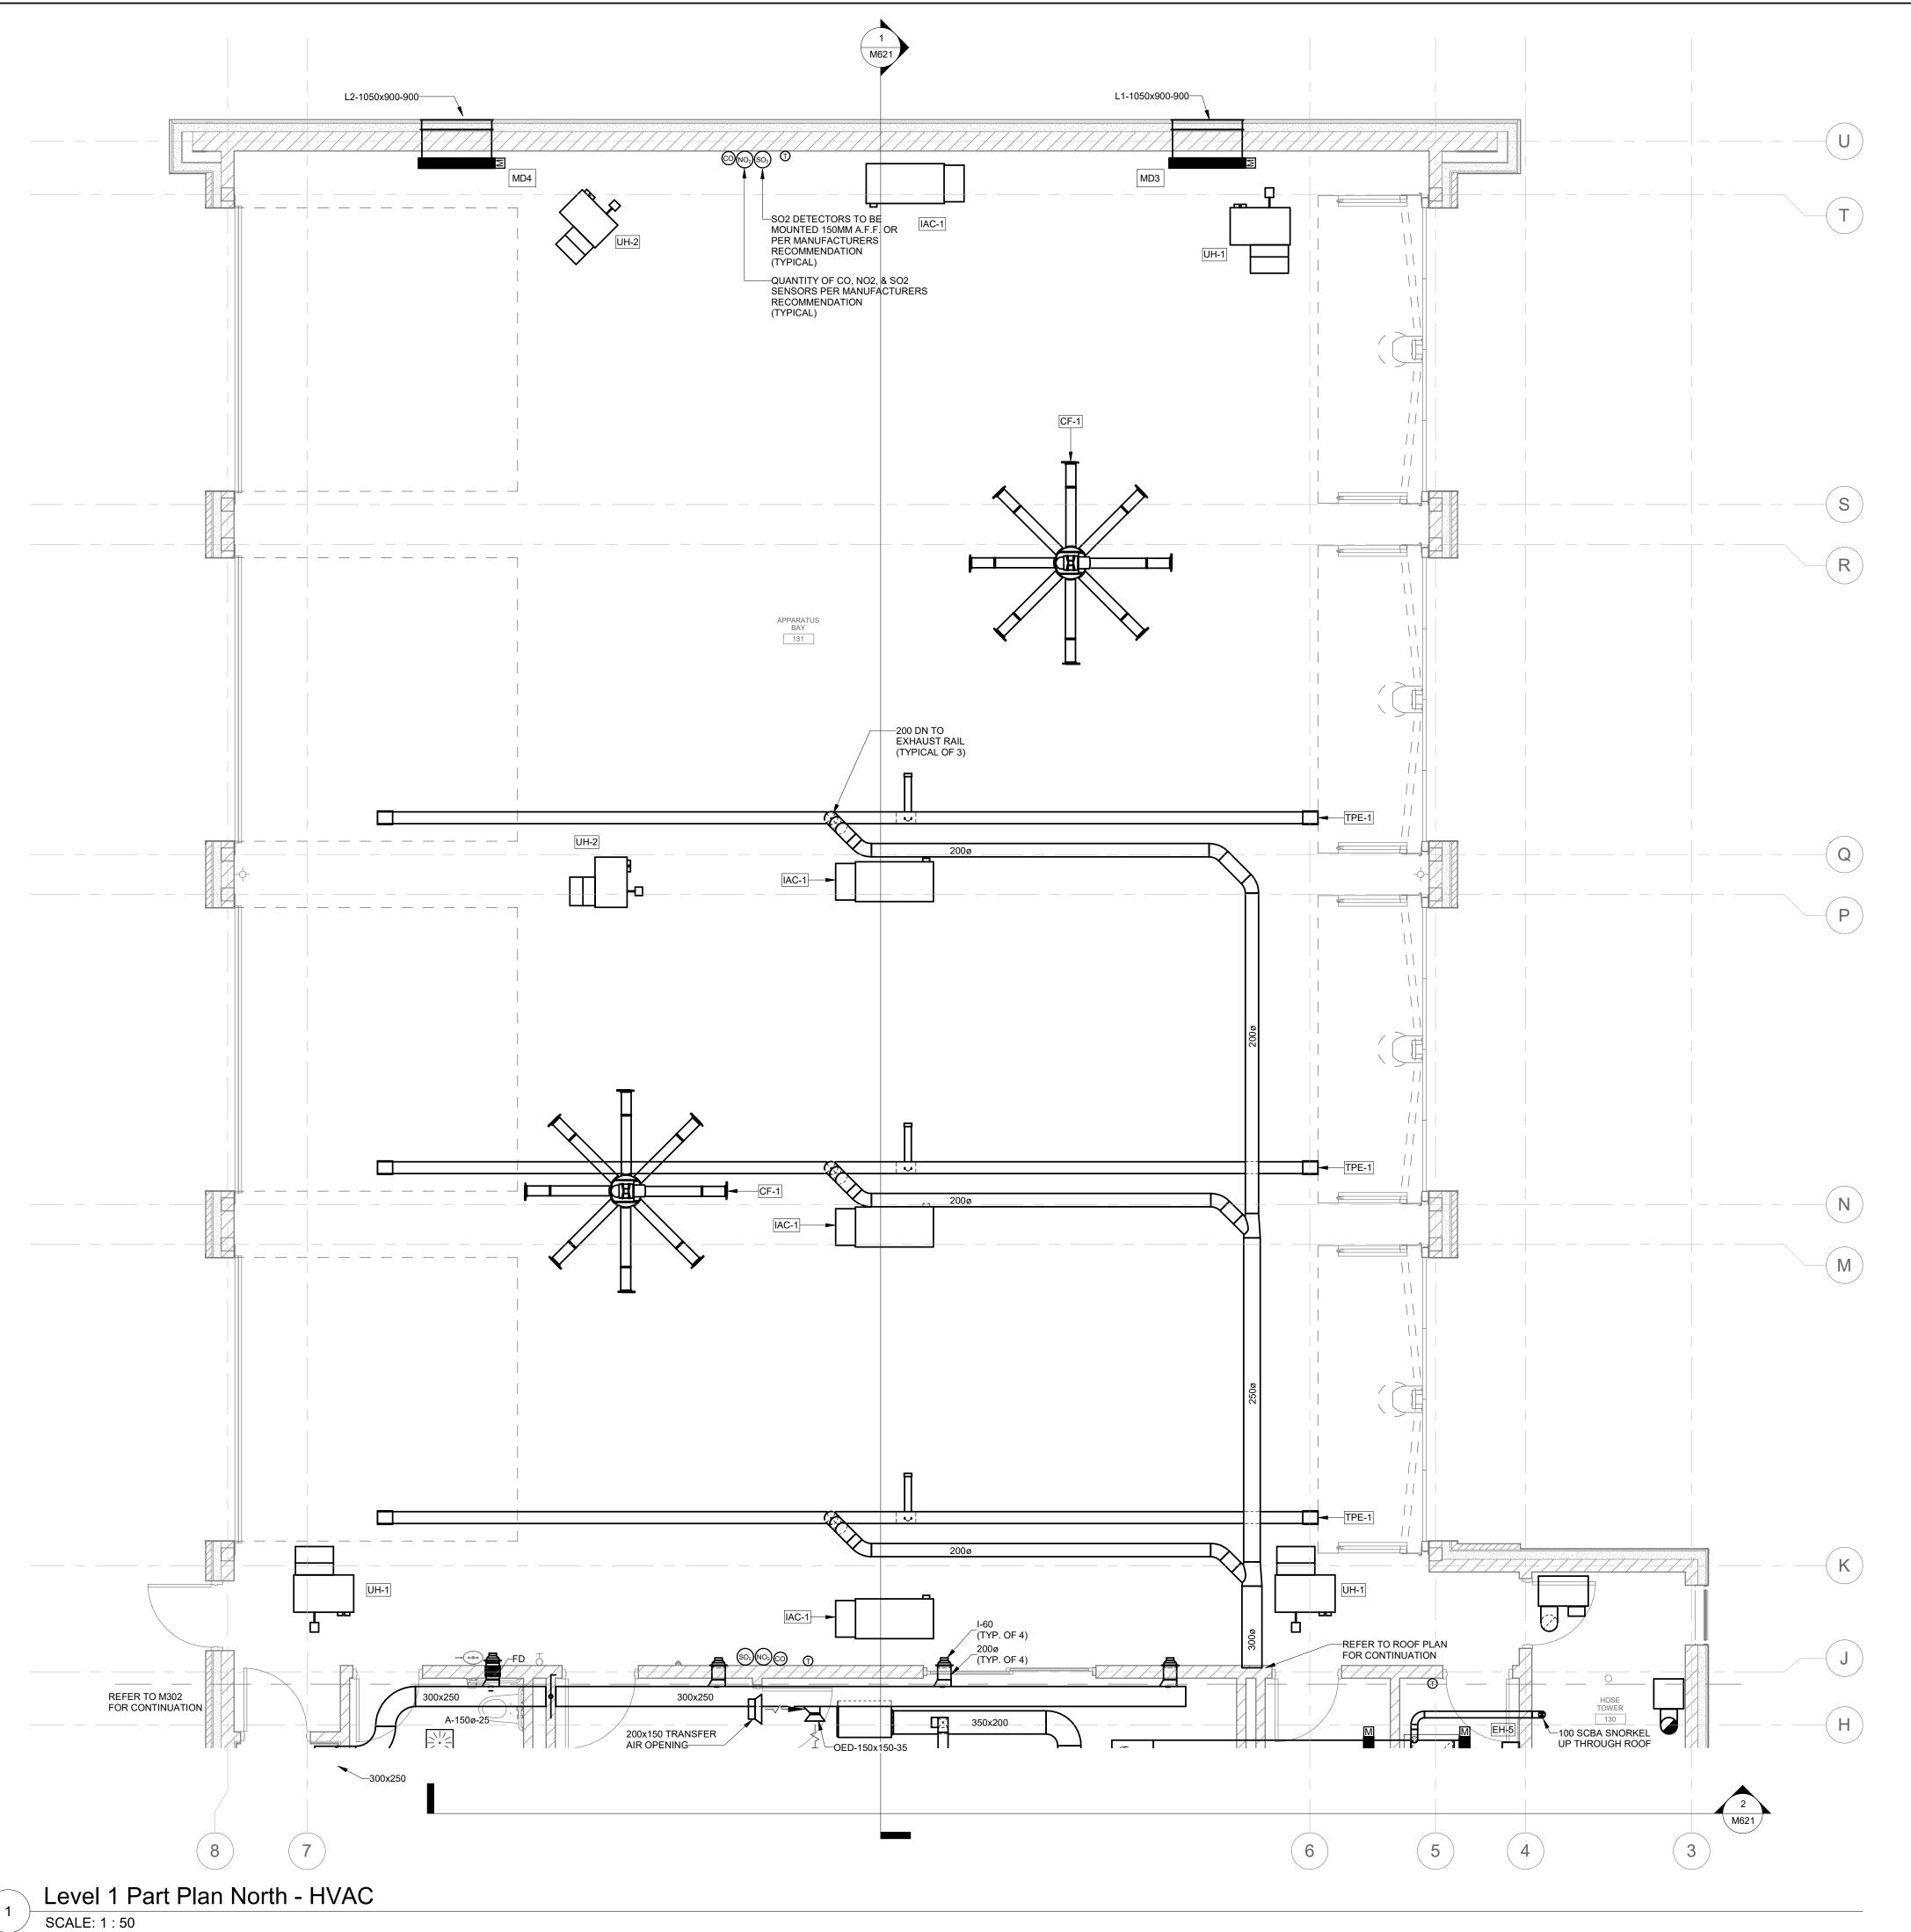

GENERAL NOTES:


- DRAWINGS ARE DIAGRAMMATIC AND INDICATE GENERAL LOCATIONS OF EQUIPMENT AND CONNECTING SERVICES. DRAWINGS ARE NOT TO BE DIMENSIONED OR SCALED. NOTE THAT ANY REFERENCE TO CONTRACTOR ON MECHANICAL DRAWINGS IS NOT EXCLUSIVE TO MECHANICAL CONTRACTOR OR ON PARTICULAR SUB-TRADE. IT IS UNDERSTOOD THAT THE PRIME CONTRACTOR SHALL BE RESPONSIBLE FOR COORDINATE OF ALL TRADES' WORK AND AS SUCH SHALL BE RESPONSIBLE FOR REVIEW OF DOCUMENTS PREPARED BY ALL DISCIPLINES (I.E. MECHANICAL AND ELECTRICAL) AND INCLUDING ALL ASSOCIATED COSTS FOR THE SCOPE OF WORK AS IDENTIFIED IN ALL SUB-DISCIPLINE'S DOCUMENTS.
- ALL WORK TO BE DONE IN ACCORDANCE WITH THE ONTARIO BUILDING CODE AND ALL OTHER REGULATORY REQUIREMENTS.
- SUPPLY ALL LABOUR AND MATERIALS TO PROVIDE A COMPLETE MECHANICAL INSTALLATION. ITEMS NOT EXPLICITLY ILLUSTRATED ON THE DRAWINGS ARE NOT TO BE EXCLUDED FROM THE SCOPE OF WORK IF REQUIRED AS PART OF A PROPER INSTALLATION. PERMITS, TESTING, BALANCING, AND OCCUPANT OPERATIONAL TRAINING
- WILL BE PART OF THE WORK.

 EXACT LOCATION OF ALL CEILING DIFFUSERS, REGISTERS AND GRILLES ARE DETAILED ON ARCHITECTURAL REFLECTED CEILING PLANS.

 THE LOCATION OF ALL ROOF OPENINGS SHALL BE AS INDICATED ON THE MECHANICAL, STRUCTURAL AND ARCHITECTURAL DRAWINGS. COORDINATE EXACT SIZES OF OPENINGS
- ALL EQUIPMENT SHALL BE INSTALLED IN STRICT ACCORDANCE WITH MANUFACTURER'S RECOMMENDATIONS. PROVIDE ALL FITTINGS, TRANSITIONS, DAMPERS ETC AS REQUIRED FOR COMPLETE WORKABLE INSTALLATION.
- DUCTWORK SHALL BE INSULATED OR LINED PER SPECIFICATIONS AND/OR AS NOTED ON DRAWINGS. ALL DUCT JOINTS AND SEAMS SHALL BE SEAL PER SPECIFICATIONS. DUCT AND PLENUM SIZES ARE CLEAR INSIDE DIMENSIONS. WHERE DUCTWORK AND PLENUMS ARE INTERNALLY LINED, THEIR SIZES SHALL BE ADJUSTED TO PROVIDE THE
- INSIDE CLEAR DIMENSIONS INDICATED ON THE DRAWINGS. MANUAL BALANCING DAMPERS SHALL BE PROVIDED IN ALL DUCT BRANCHES AND IN ALL BRANCHES TO INDIVIDUAL DIFFUSERS, GRILLES AND REGISTERS, WHETHER SHOWN OR
- NOT.
 ALL DUCTWORK LOCATED OUTSIDE THE BUILDING SHALL BE WEATHERPROOFED.
 CONTRACTOR SHALL INSTALL ANY DUCT MOUNTED SMOKE DETECTORS FURNISHED BY
 THE ELECTRICAL CONTRACTOR.
 LIMIT LENGTHS OF FLEXIBLE DUCT TO 1200mm
 COORDINATE LOCATIONS OF WALL MOUNTED SENSORS WITH ARCHITECTURAL DRAWINGS.
- MINIMUM DUCT SIZE TO DIFFUSERS TO MATCH DIFFUSER NEXT SIZE UNLESS OTHERWISE

FOR QUESTIONS REGARDING THIS PROJECT, PLEASE EMAIL: CM-20-063@QUASARCG.COM

E ISSUED FOR TENDER
D ISSUED FOR BUILDING PERMIT 2021-07-27 2021-05-03 2021-02-12 2021-02-05

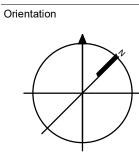

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100156459

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Project Information

BFES Station 201 (SPA-2021-0032)

27 Rutherford Rd. S., Brampton, ON, L6W 3J3


City of Brampton Fire & Emergency Services

Drawing Title


LEVEL 1 PART PLAN **NORTH - VENTILATION**

Project No Drawing No 2021-08-12 Drawn by CM-20-063 M303

Scale As indicated

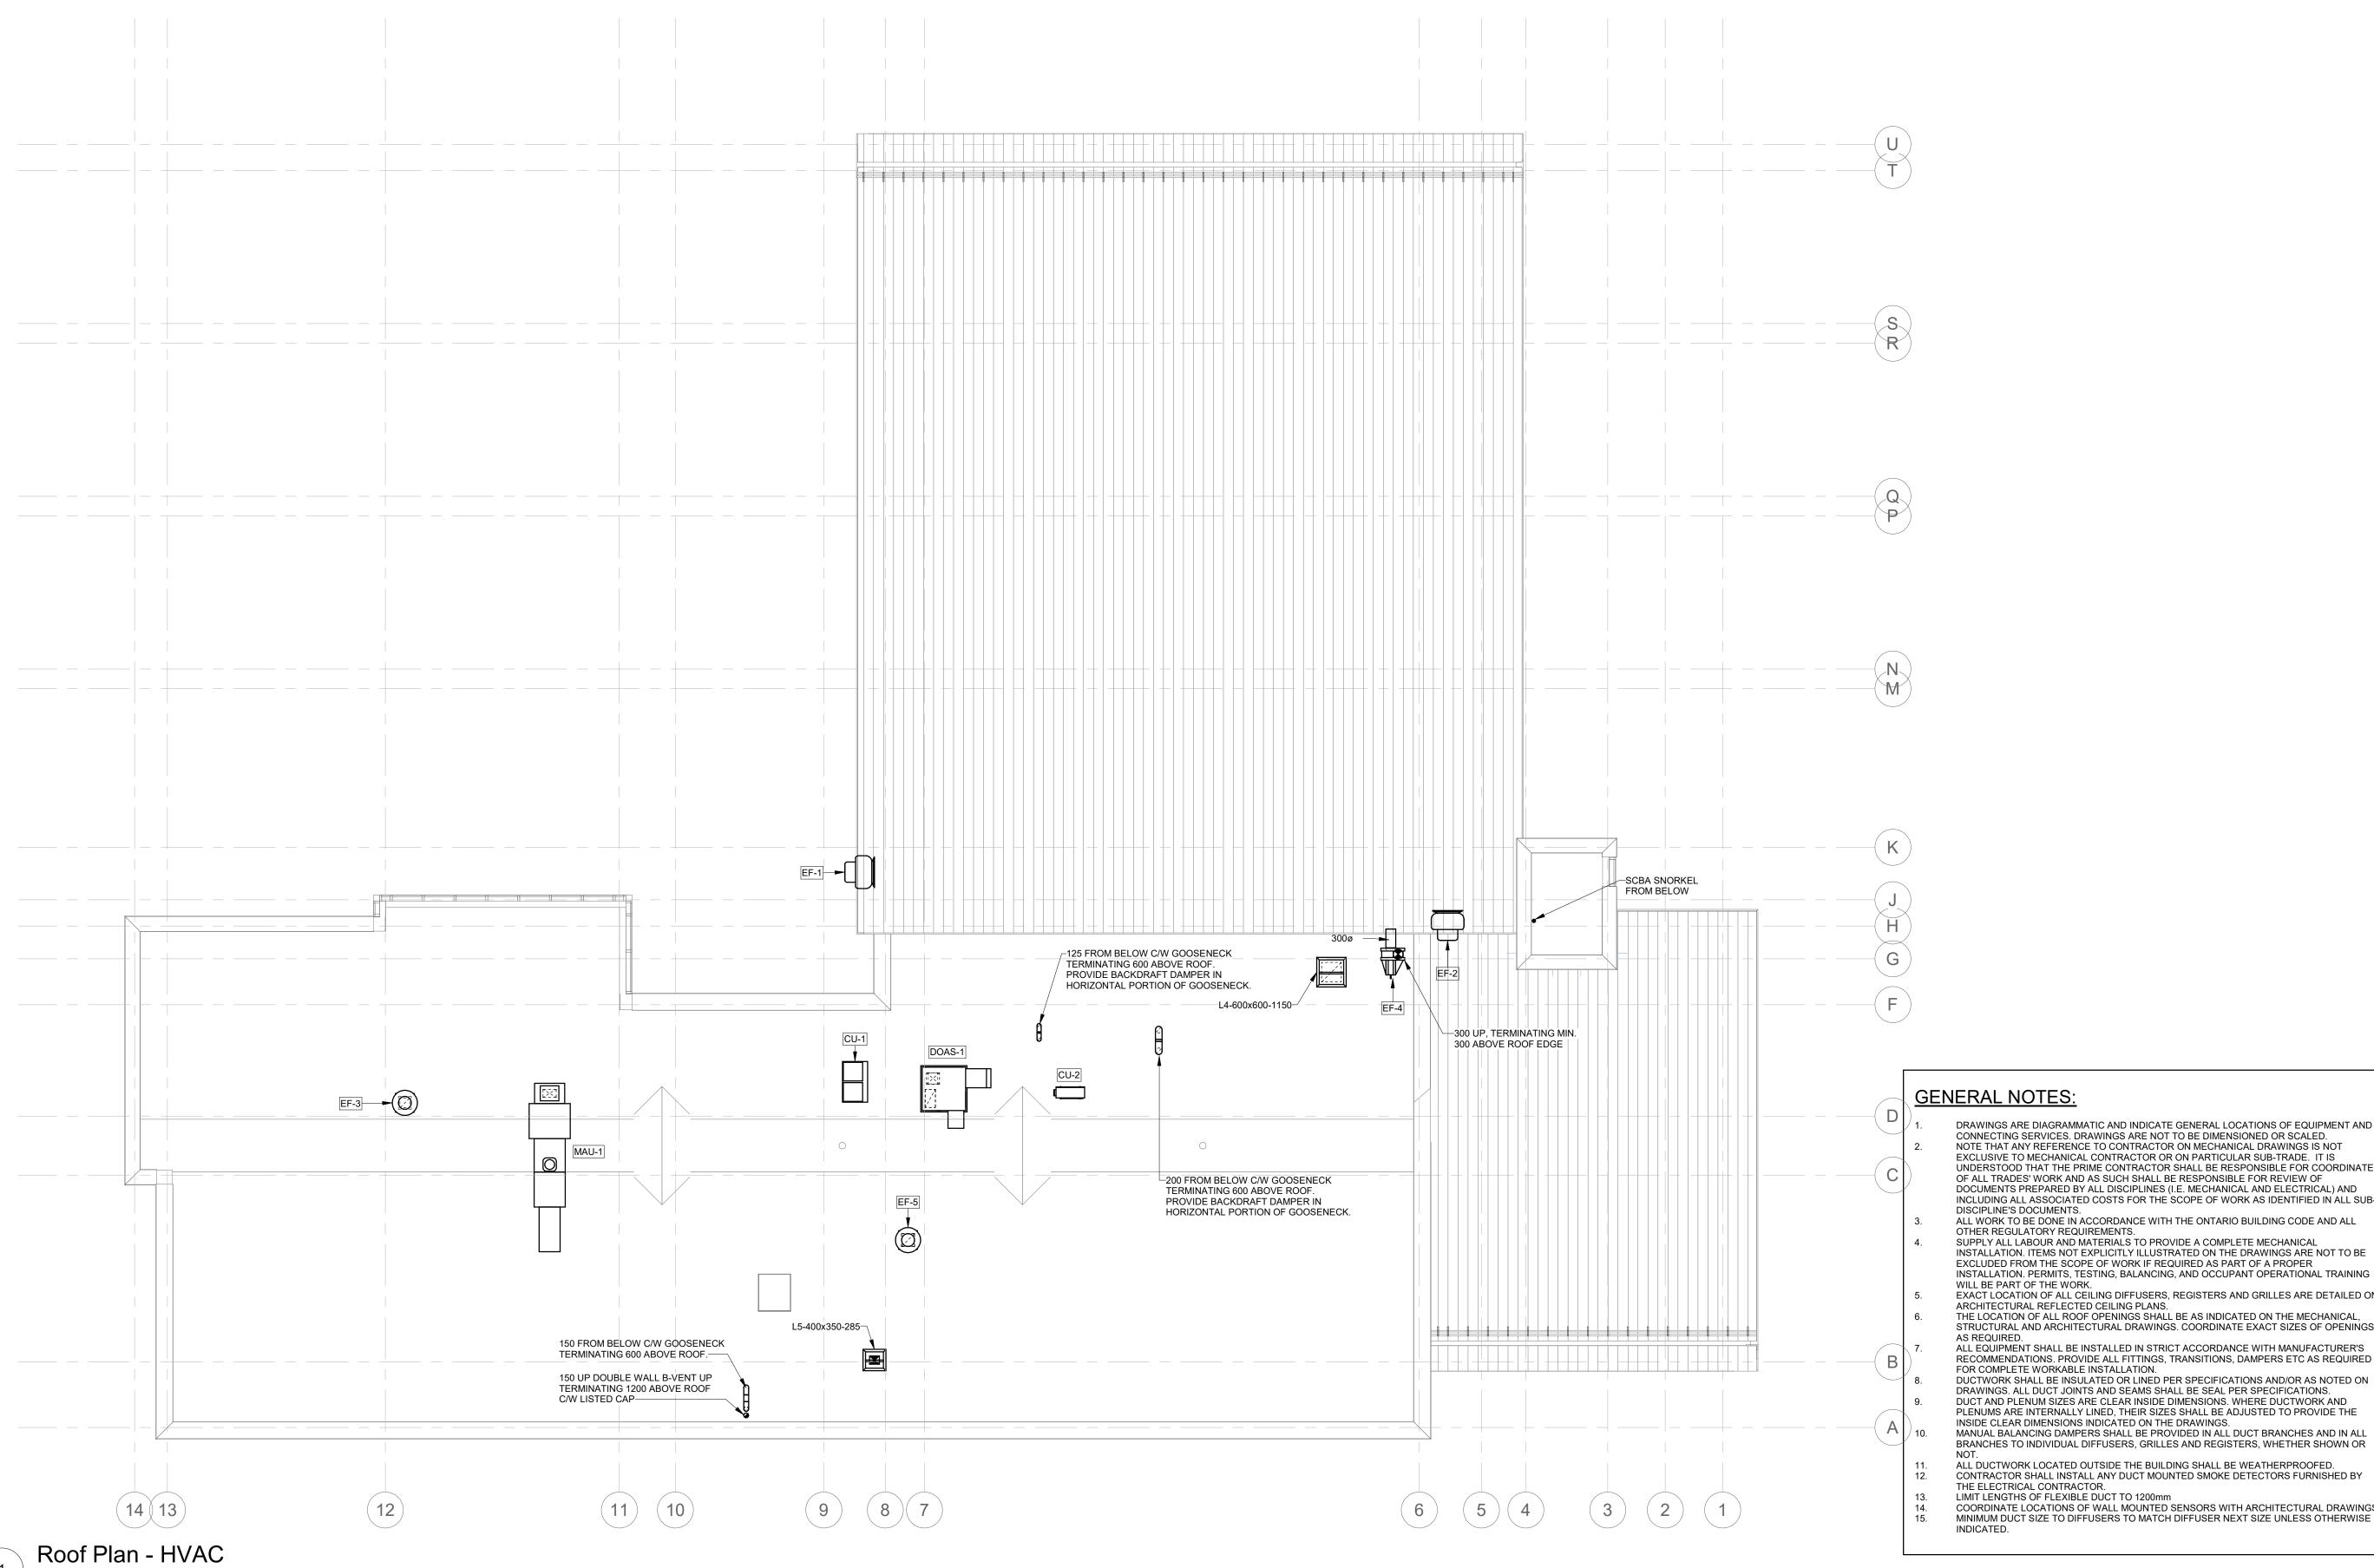

	LOOLIED FOR TELIDED	2004.00
H	ISSUED FOR TENDER	2021-08-
G	ISSUED FOR BUILDING PERMIT	2021-07-
F	90% CD	2021-05-
E	SPA	2021-02-
D	50% CD	2021-02-
С	BUILDING PERMIT	2021-02-
В	PERMIT/SPA COORDINATION	2021-02-
Α	100% DESIGN DEVELOPMENT	2021-01-
No.	Revision	Date

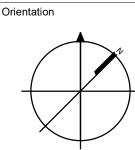

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City of Brampton Fire & Emergency Services

Drawing Title ROOF PLAN -**VENTILATION**

As indicated

Project No Drawing No 2021-08-12

DRAWINGS ARE DIAGRAMMATIC AND INDICATE GENERAL LOCATIONS OF EQUIPMENT AND CONNECTING SERVICES. DRAWINGS ARE NOT TO BE DIMENSIONED OR SCALED.

NOTE THAT ANY REFERENCE TO CONTRACTOR ON MECHANICAL DRAWINGS IS NOT EXCLUSIVE TO MECHANICAL CONTRACTOR OR ON PARTICULAR SUB-TRADE. IT IS UNDERSTOOD THAT PRIME CONTRACTOR PROPERTY OF THE OF ALL TRADES' WORK AND AS SUCH SHALL BE RESPONSIBLE FOR REVIEW OF DOCUMENTS PREPARED BY ALL DISCIPLINES (I.E. MECHANICAL AND ELECTRICAL) AND INCLUDING ALL ASSOCIATED COSTS FOR THE SCOPE OF WORK AS IDENTIFIED IN ALL SUB-DISCIPLINE'S DOCUMENTS.

ALL WORK TO BE DONE IN ACCORDANCE WITH THE ONTARIO BUILDING CODE AND ALL OTHER REGULATORY REQUIREMENTS. SUPPLY ALL LABOUR AND MATERIALS TO PROVIDE A COMPLETE MECHANICAL INSTALLATION. ITEMS NOT EXPLICITLY ILLUSTRATED ON THE DRAWINGS ARE NOT TO BE EXCLUDED FROM THE SCOPE OF WORK IF REQUIRED AS PART OF A PROPER

EXACT LOCATION OF ALL CEILING DIFFUSERS, REGISTERS AND GRILLES ARE DETAILED ON ARCHITECTURAL REFLECTED CEILING PLANS.


THE LOCATION OF ALL ROOF OPENINGS SHALL BE AS INDICATED ON THE MECHANICAL, STRUCTURAL AND ARCHITECTURAL DRAWINGS. COORDINATE EXACT SIZES OF OPENINGS

ALL EQUIPMENT SHALL BE INSTALLED IN STRICT ACCORDANCE WITH MANUFACTURER'S RECOMMENDATIONS. PROVIDE ALL FITTINGS, TRANSITIONS, DAMPERS ETC AS REQUIRED FOR COMPLETE WORKABLE INSTALLATION. DUCTWORK SHALL BE INSULATED OR LINED PER SPECIFICATIONS AND/OR AS NOTED ON DRAWINGS. ALL DUCT JOINTS AND SEAMS SHALL BE SEAL PER SPECIFICATIONS. DUCT AND PLENUM SIZES ARE CLEAR INSIDE DIMENSIONS. WHERE DUCTWORK AND PLENUMS ARE INTERNALLY LINED, THEIR SIZES SHALL BE ADJUSTED TO PROVIDE THE


INSIDE CLEAR DIMENSIONS INDICATED ON THE DRAWINGS. MANUAL BALANCING DAMPERS SHALL BE PROVIDED IN ALL DUCT BRANCHES AND IN ALL BRANCHES TO INDIVIDUAL DIFFUSERS, GRILLES AND REGISTERS, WHETHER SHOWN OR


ALL DUCTWORK LOCATED OUTSIDE THE BUILDING SHALL BE WEATHERPROOFED.
CONTRACTOR SHALL INSTALL ANY DUCT MOUNTED SMOKE DETECTORS FURNISHED BY
THE ELECTRICAL CONTRACTOR.
LIMIT LENGTHS OF FLEXIBLE DUCT TO 1200mm
COORDINATE LOCATIONS OF WALL MOUNTED SENSORS WITH ARCHITECTURAL DRAWINGS.

MINIMUM DUCT SIZE TO DIFFUSERS TO MATCH DIFFUSER NEXT SIZE UNLESS OTHERWISE

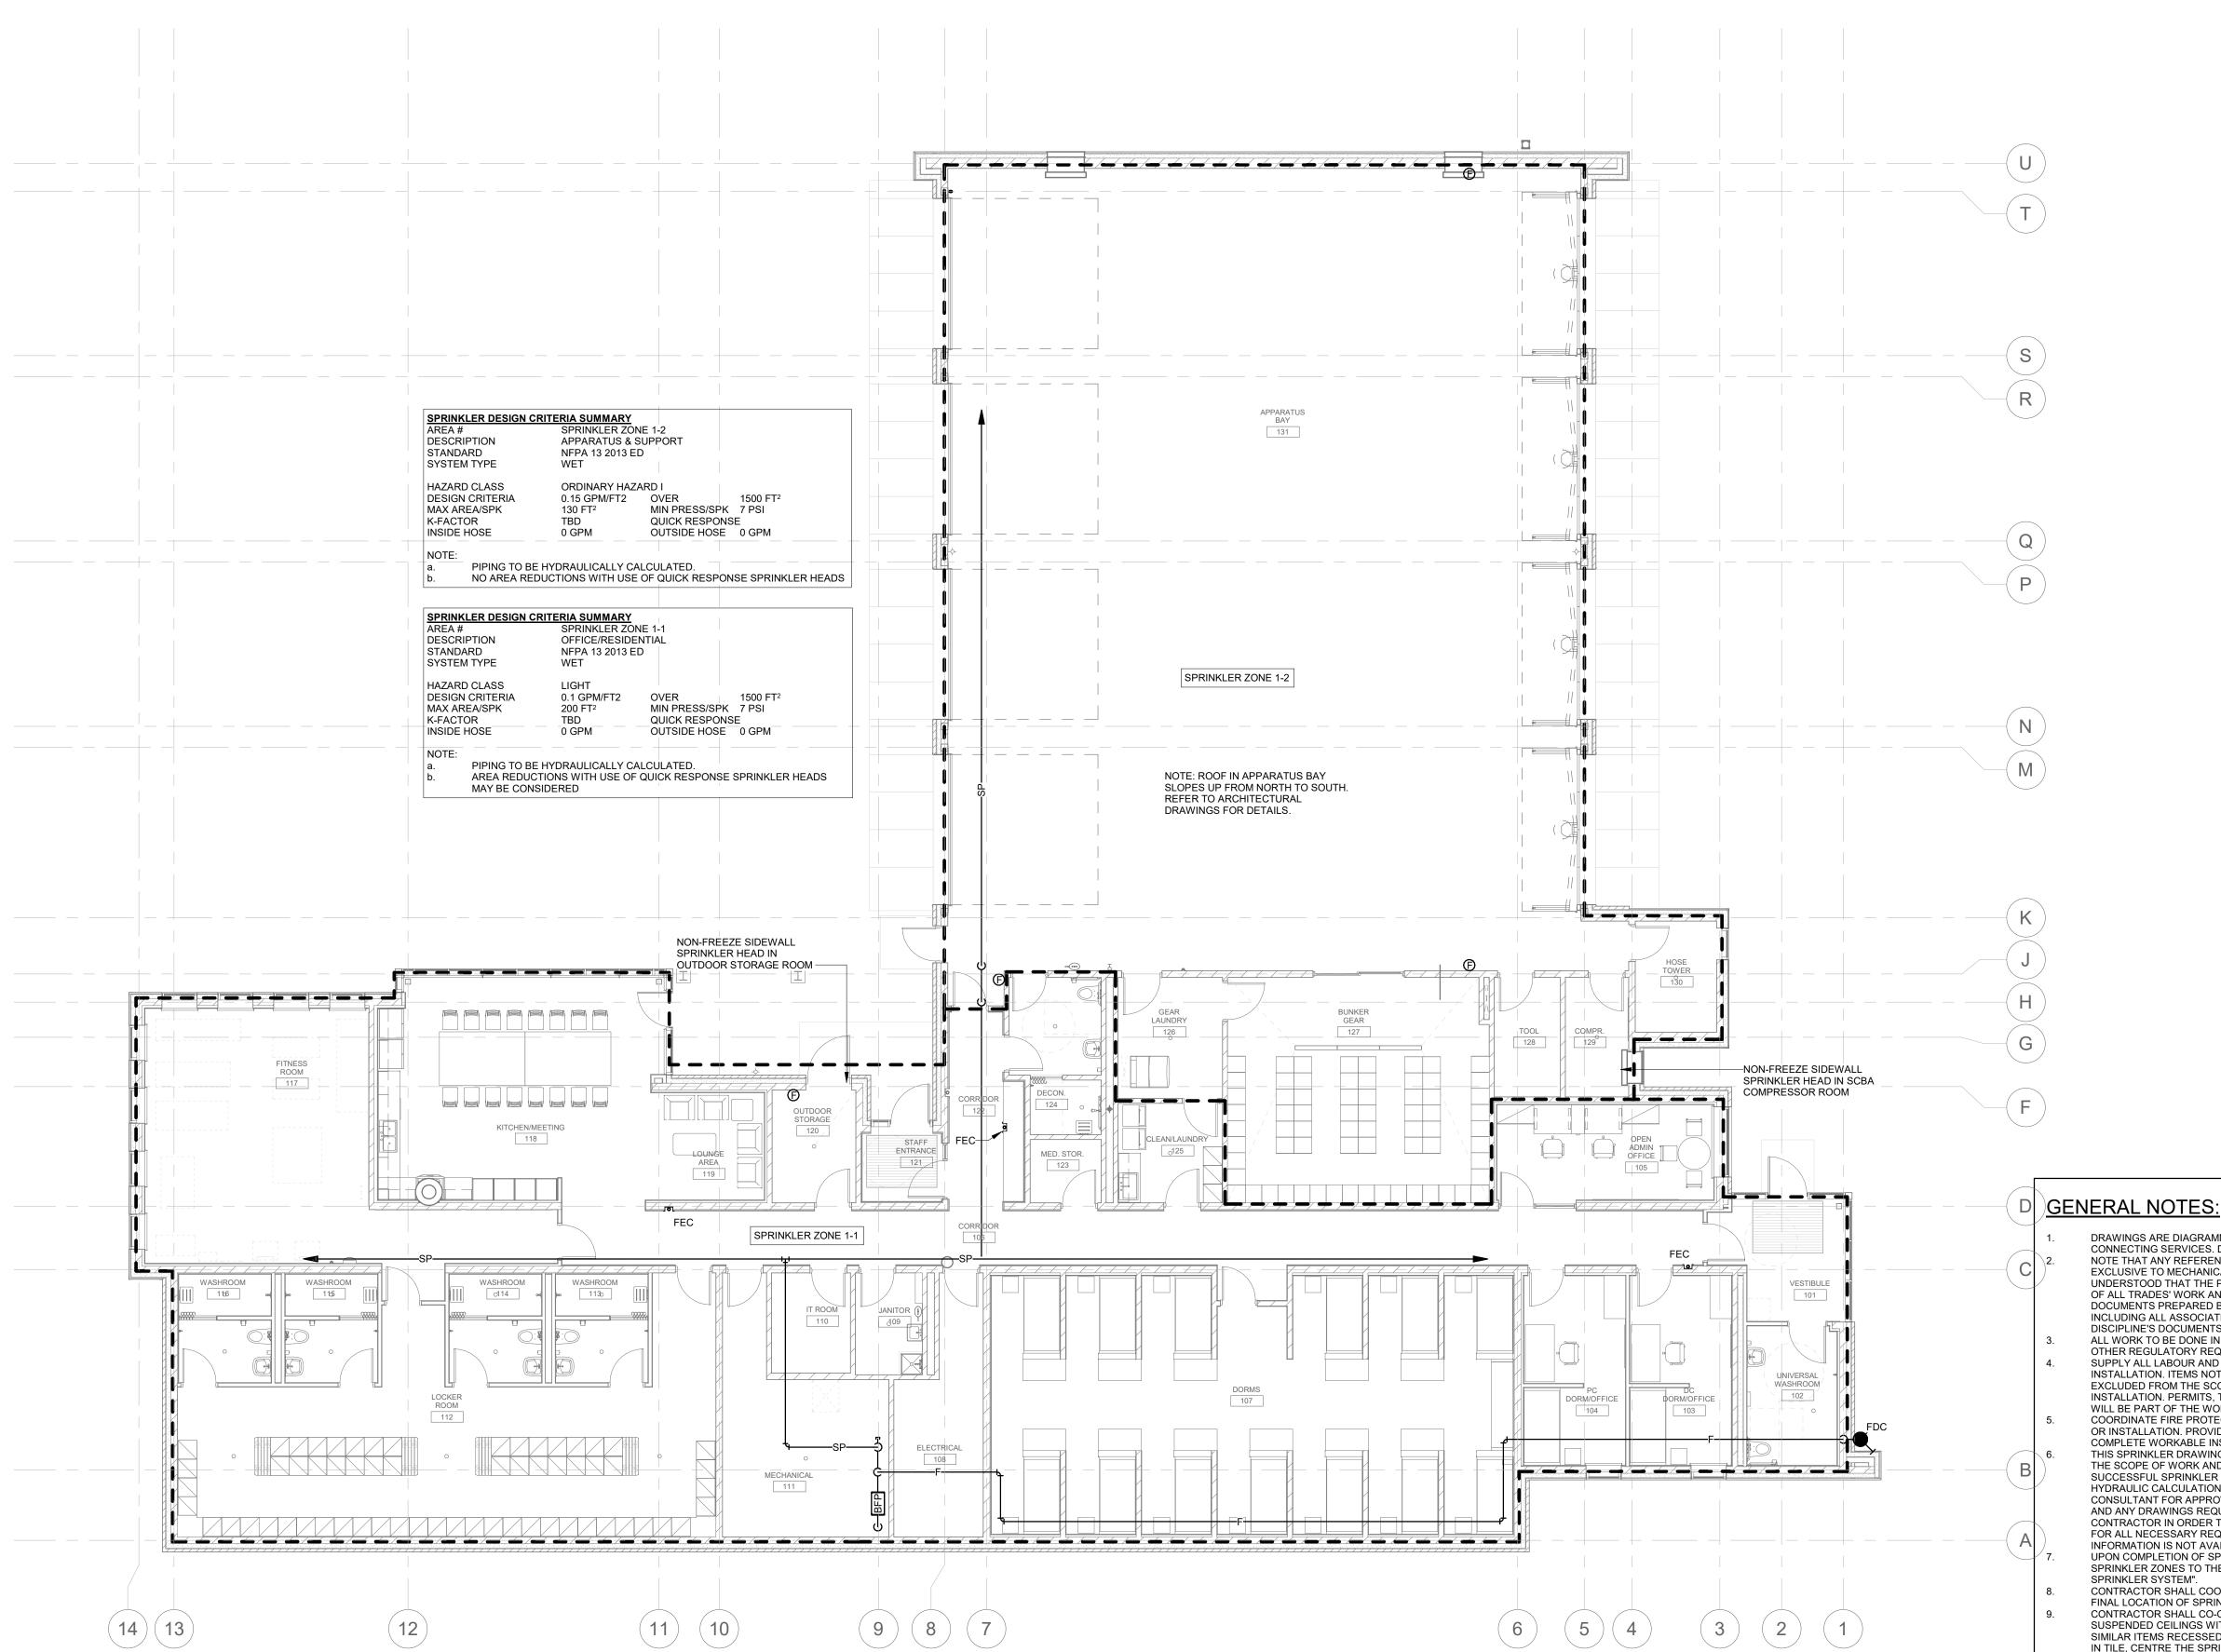

Н	ISSUED FOR TENDER	2021-08-
G	ISSUED FOR BUILDING PERMIT	2021-07-
F	90% CD	2021-05-
Е	SPA	2021-02-
D	50% CD	2021-02-
С	BUILDING PERMIT	2021-02-
В	PERMIT/SPA COORDINATION	2021-02-
Α	100% DESIGN DEVELOPMENT	2021-01-
		•
No.	Revision	Date

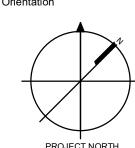

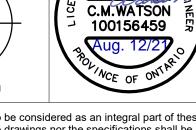

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Scale

As indicated

Project Information BFES Station 201 (SPA-2021-0032)

27 Rutherford Rd. S., Brampton, ON, L6W 3J3

City of Brampton Fire & Emergency Services

Drawing Title LEVEL 1 PLAN - FIRE

PROTECTION 2021-08-12

Project No Drawing No

DRAWINGS ARE DIAGRAMMATIC AND INDICATE GENERAL LOCATIONS OF EQUIPMENT AND CONNECTING SERVICES. DRAWINGS ARE NOT TO BE DIMENSIONED OR SCALED. NOTE THAT ANY REFERENCE TO CONTRACTOR ON MECHANICAL DRAWINGS IS NOT EXCLUSIVE TO MECHANICAL CONTRACTOR OR ON PARTICULAR SUB-TRADE. IT IS UNDERSTOOD THAT THE PRIME CONTRACTOR SHALL BE RESPONSIBLE FOR COORDINATE OF ALL TRADES' WORK AND AS SUCH SHALL BE RESPONSIBLE FOR REVIEW OF DOCUMENTS PREPARED BY ALL DISCIPLINES (I.E. MECHANICAL AND ELECTRICAL) AND INCLUDING ALL ASSOCIATED COSTS FOR THE SCOPE OF WORK AS IDENTIFIED IN ALL SUBDISCIPLINE'S DOCUMENTS.

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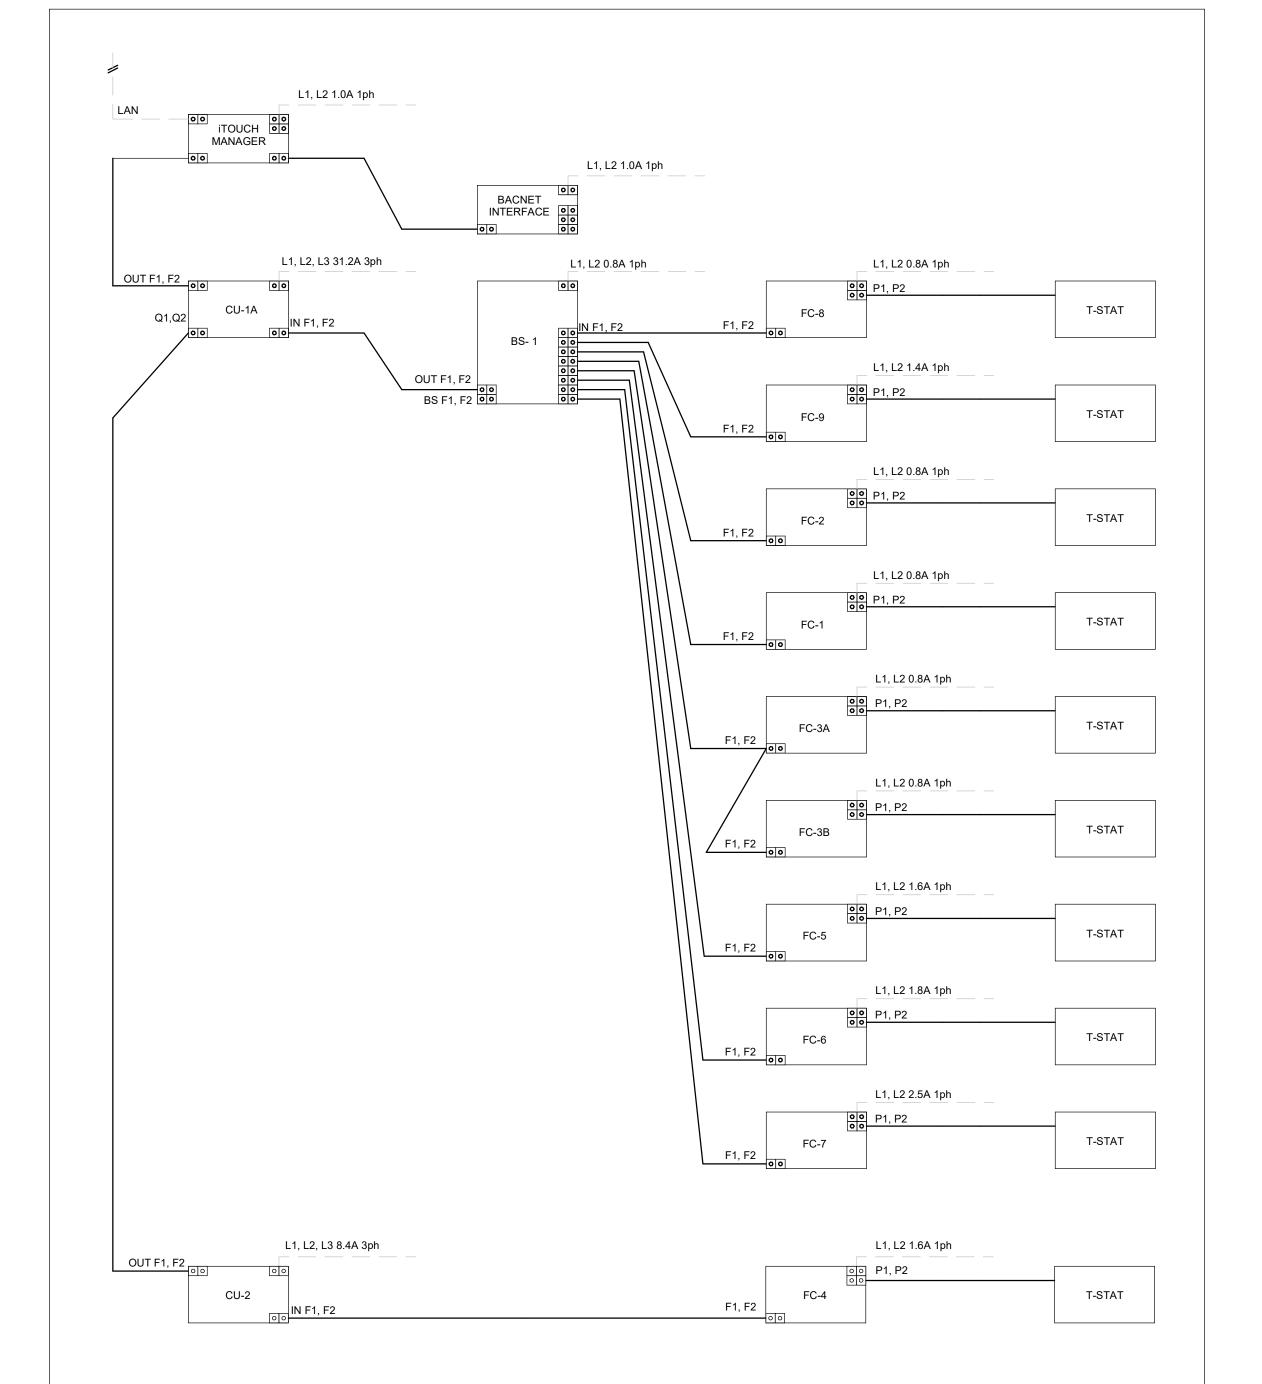
INSTALLATION. PERMITS, TESTING, BALANCING, AND OCCUPANT OPERATIONAL TRAINING WILL BE PART OF THE WORK. COORDINATE FIRE PROTECTION WITH WORK OF OTHER TRADES PRIOR TO FABRICATION OR INSTALLATION. PROVIDE ALL FITTINGS, OFFSETS AND TRANSITIONS REQUIRED FOR

COMPLETE WORKABLE INSTALLATION. THIS SPRINKLER DRAWING IS PREPARED TO GIVE THE CONTRACTOR THE DESIGN INTENT, THE SCOPE OF WORK AND TO ASSIST IN PRICING THE SPRINKLER WORK. THE SUCCESSFUL SPRINKLER CONTRACTOR SHALL PREPARE SHOP DRAWINGS AND HYDRAULIC CALCULATIONS AND SUBMIT TO THE CITY FIRE DEPARTMENT AND TO THE CONSULTANT FOR APPROVAL. CONTRACTOR SHALL OBTAIN COPIES OF CALCULATIONS AND ANY DRAWINGS REQUIRED FROM THE OWNER AND/OR THE ORIGINAL INSTALLING CONTRACTOR IN ORDER TO COMPLETE THIS DESIGN. THE CONTRACTOR SHALL INCLUDE FOR ALL NECESSARY REQUIREMENTS TO COMPLETE THE DESIGN IF THE ABOVE INFORMATION IS NOT AVAILABLE OR ACCEPTABLE.

UPON COMPLETION OF SPRINKLER WORKS, CONTRACTOR SHALL TEST REVISED SPRINKLER ZONES TO THE LATEST REQUIREMENTS OF NFPA 13 "INSTALLATION OF


CONTRACTOR SHALL COORDINATE WITH MECHANICAL AND ELECTRICAL TRADES FOR FINAL LOCATION OF SPRINKLER HEADS IN ORDER TO PREVENT CONFLICTS.


CONTRACTOR SHALL CO-ORDINATE SPRINKLER HEAD LOCATIONS IN AREAS WITH SUSPENDED CEILINGS WITH THE LOCATION OF LIGHTING, GRILLES, DIFFUSERS, AND SIMILAR ITEMS RECESSED IN OR SURFACE MOUNTED ON THE CEILING. IN AREAS WITH LAY-IN TILE, CENTRE THE SPRINKLER HEAD BOTH WAYS IN THE LAY-IN TILE.



VRV WIRING SCHEMATIC

SCALE:N.T.S.

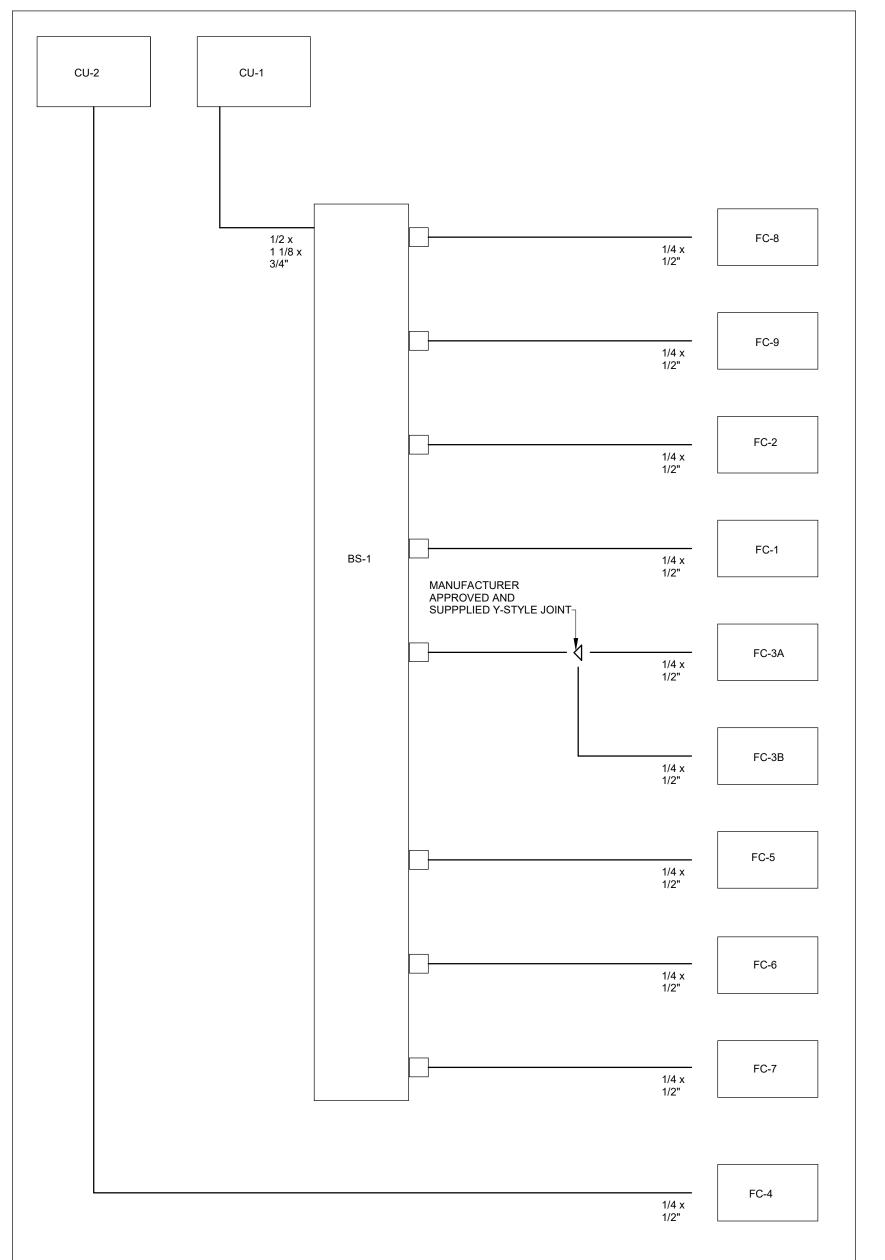

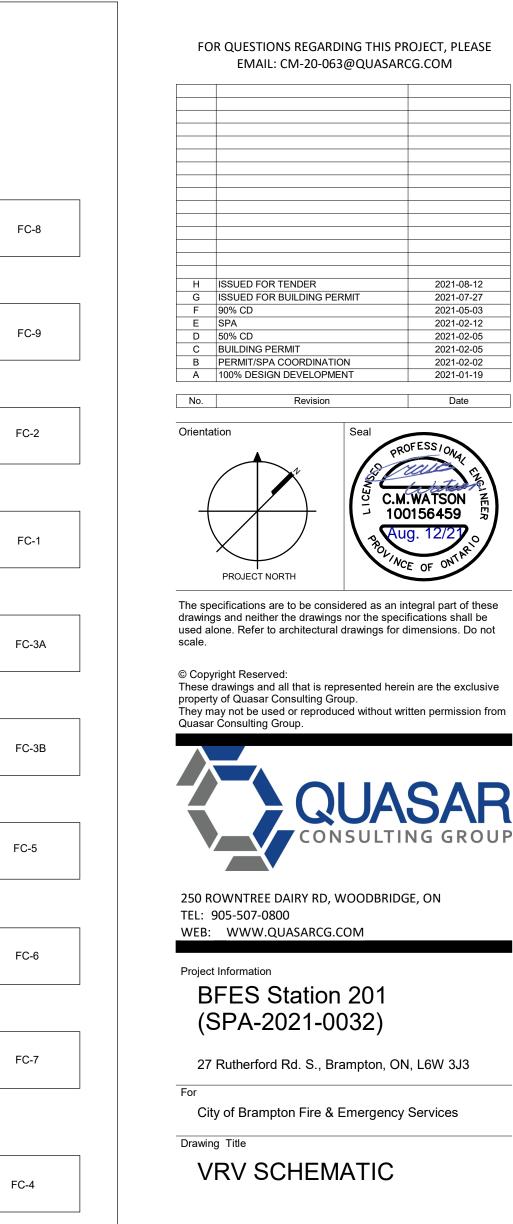




Project No Drawing No 2021-08-12 Drawn by CMW CM-20-063 M601 Scale N.T.S.

EMAIL: CM-20-063@QUASARCG.COM


2021-08-12 2021-07-27

2021-07-27 2021-05-03 2021-02-12 2021-02-05 2021-02-05 2021-02-02 2021-01-19

C.M.WATSON 100156459

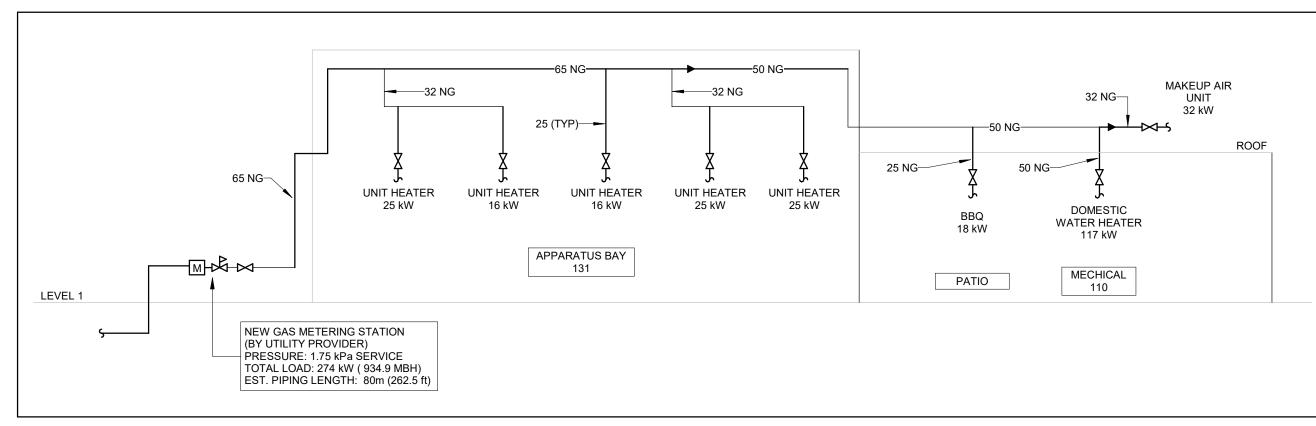

NATURAL GAS SCHEMATIC SCALE:N.T.S.

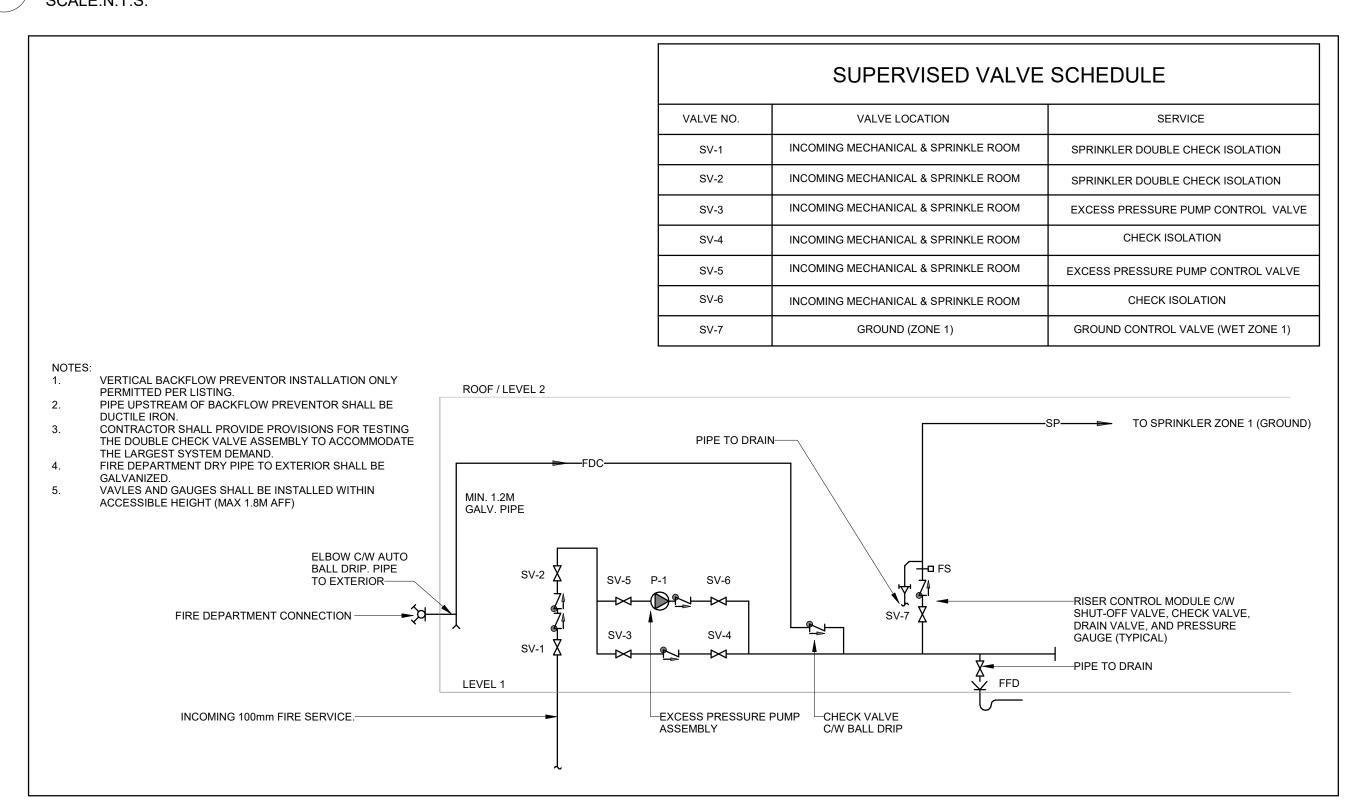


FIRE PROTECTION SCHEMATIC

FOR QUESTIONS REGARDING THIS PROJECT, PLEASE

SSUED FOR TENDER	2021-08-12
SSUED FOR BUILDING PERMIT	2021-07-2
0% CD	2021-05-0
PA	2021-02-1
*** *=	2021-02-0
	2021-02-0
	2021-02-02
00% DESIGN DEVELOPMENT	2021-01-1
	00% CD SUILDING PERMIT SERMIT/SPA COORDINATION 00% DESIGN DEVELOPMENT

Orientation

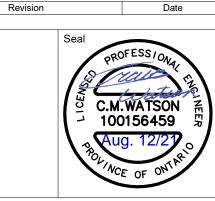

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Project Information BFES Station 201 (SPA-2021-0032)

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27 Rutherford Rd. S., Brampton, ON, L6W 3J3

City of Brampton Fire & Emergency Services Drawing Title

FIRE PROTECTION & GAS SCHEMATIC

Project No Drawing No 2021-08-12 Drawn by CMW Scale N.T.S.

	SILENCERS																			
TAG	SERVICE	MANUFACTURER	TYPE	MODEL	WIDTH	HEIGHT	LENGTH	AIRFLOW	VELOCITY	IDEAL DP	MAX DP W/	MININ	UM [OYNA	VIIC II	NSERT	ION I	LOSS	(dB)	REMARKS
	-				(mm)	(mm)	(mm)	(L/s)	(m/s)	(Pa)	SYS. EFF. (Pa)	1	2	3	4	5	6	7	8	
SL-1	DOAS RETURN	VIBRO-ACOUSTICS	RED	RED-L27621	550	300	1800	612	-4	30	72	9	17	25	34	46	47	34	24	REFER TO NOTE 6,7.8
SL-2	DOAS SUPPLY	VIBRO-ACOUSTICS	RED	RED-L27621	400	350	1800	612	4	33	52	6	11	21	27	39	38	31	25	REFER TO NOTE 6,7.8
NOTES:											•		•							

1. TYPE R - RECTANGULAR E- ELBOW D -DISSIPATIVE

2. VELOCITY SHOWN IS + (FORWARD FLOW) OR - (REVERSE FLOW) AS DEFINED BY ASTM E477-13. 3. IDEAL PRESSURE DROP AS DETERMINED PER ÀSTM E477-13 IN Á NVLAP-ACCREDITED ACOUSTICAL LABORATORY.

4. PRESSURE DROP PER ASTM E477-13 PLUS SYSTEM EFFECTS FOR NEARBY DUCT ELEMENTS.

5. MINIMUM DYNAMIC INSERTION LOSS DETERMINED PER ASTM E477-13 IN A NVLAP-ACCREDITED ACOUSTICAL LABORATORY. 6. NON-BASIS OF DESIGN SILENCER MANUFACTURER SHALL PROVIDE, FOR APPROVAL, PROFESSIONAL ENGINEER STAMPED ACOUSTICAL CALCULATIONS FOR ALL SYSTEMS WITH SILENCERS TO DEMONSTRATE THAT THE RESULTANT DUCTBORNE FAN SOUND LEVELS, INCLUDING AIRBORNE AND BREAKOUT NOISE, MEET NC-30 IN THE OCCUPIED SPACES.

7. NON-BASIS OF DESIGN SILENCER MANUFACTURER SHALL PROVIDE, FOR APPROVAL, PROFESSIONAL ENGINEER STAMPED PRESSURE DROP CALCULATIONS FOR ALL SYSTEMS WITH SILENCERS TO DEMONSTRATE THAT THE RESULTANT INSTALLED PRESSURE DROP WITH SYSTEM EFFECTS DOES NOT EXCEED SCHEDULED VALUES.

8. FOR NON-BASIS OF DESIGN PRODUCT SUPPLIED, CONTRACTOR IS FINANCIALLY RESPONSIBLE TO ENSURE NOISE CONTROL SOLUTION IS DELIVERED TO MEET NC-30 IN THE OCCUPIED SPACES.

	GAS-FIRED UNIT HEATERS													
TAG	TYPE	MANUFACTURER	MODEL	LOCATION	QTY	GAS INPUT (kW)	GAS OUTPUT (kW)	COMBUSTION EFFICIENCY	AIRFLOW (L/S)	ELECTRICAL V/Ph/Hz	WEIGHT (kg)	REMARKS		
UH-1	CONDENSING	MODINE	PTC 85SS0111S	APPARATUS BAY	4	25 kW	23.2	98%	779	115/1/60	64	C/W 60 DEGREE HOOD		
UH-2	CONDENSING	MODINE	PTC 55SS0111S	APPARATUS BAY	1	16 kW	15.0	98%	518	115/1/60	45	C/W 60 DEGREE HOOD		

				PUN	MPS						
TAG	TYPE	MANUFACTURER	MODEL	LOCATION	FLOW (L/s)	HEAD (kPa)	MAX POWER (W)	FLA (A)	V/Ph/Hz	WEIGHT (kg) (KG)	REMARKS
P-1	DHW RE-CIRC.	ARMSTRONG	ASTRO 225BS	CORRIDOR	0.07	32.8	75	0.64	115/1/60	3	

	DESICCANT DEHUMIDIFIER																	
TAG	MANUFACTURER	MODEL	PROCESS AIRFLOW (L/s)		REGEN. AIRFLOW (L/s)		SPACE CO	% RH	CAPACITY (kg/hr)	SOUND (dB)	POWER	ECTRIC FLA	AL V/Ph/Hz	HEIGHT (MM)	WIDTH (MM)	DEPTH (MM)	WEIGHT (kg)	REMARKS
DD-1	CONDAIR	DA 600	278	303.4	97	200.0	20.0	60	7.1	62	11.90 kW	33.1 A	208/3/60	910	1199	991	195	

	ELECTRIC HEATERS													
TAG	TYPE	MANUFACTURER	MODEL	LOCATION	CAPACITY	AIRFLOW	ELECTRICAL	REMARKS						
IAG	ITPE	WANDFACTURER WODEL LOCATION CAPACITY		CAPACITI	(L/S)	V/Ph/Hz	KEWAKKS							
EH-1	BASEBOARD HEATER	OUELLET	OCB1008-RT	WASHROOM 102	1 kW	0	208/1/60	WALL MOUNTED						
EH-2	BASEBOARD HEATER	OUELLET	OCB1008-RT	MECHANICAL 111	1 kW	0	208/1/60	WALL MOUNTED						
EH-3	CABINET ELECTRIC HEATER	OUELLET	OLA02038-RT	VESTIBULE 101	2 kW	118	208/1/60	WALL MOUNTED - SEMI RECESSED						
EH-4	CABINET ELECTRIC HEATER	OUELLET	OLA02038-RT	VESTIBULE 121	2 kW	118	208/1/60	WALL MOUNTED - SEMI RECESSED						
EH-5	CABINET ELECTRIC HEATER	OUELLET	OLA02038-RT	COMPRESSOR RM	2 kW	118	208/1/60	WALL MOUNTED						

	LOUVRES													
TAG	TYPE	MANUFACTURER	MODEL	LENGTH	HEIGHT	AIRFLOW (L/s)	REMARKS							
L1	STORM	E.H. PRICE	DE635	1050	900	900	5.1 SQ.m. FREE AREA MINIMUM							
L2	STORM	E.H. PRICE	DE635	1050	900	900	5.1 SQ.m. FREE AREA MINIMUM							
L3	STORM	E.H. PRICE	2630/2635	600	1500	1250	1.8 SQ.m. FREE AREA MINIMUM							
L4	GRAVITY RELIEF PENTHOUSE	COOK	24X24X4 TRE	610	450	1150	0.67 SQ.m. FREE AREA MINIMUM. WIDTH = LENGTH. PD=25Pa							
L5	LOUVER PENTHOUSE	COOK	14X16X2 TRE	650	225	285	2.62 SQ.m. FREE AREA MINIMUM. WIDTH = LENGTH. PD=12.5Pa							

	EXPANSION TANKS												
			BASIS OF	DESIGN	VOLUME	TANK	MAX OPERATING						
TAG	LOCATION	SERVICE	MANUFACTURER	MODEL	(L)	ACCEPTANCE (L)	PRESSURE (kPa)	REMARKS					
ET-1	MECHANICAL ROOM	DOMESTIC WATER	WATTS	DETA 20	32	20	1034						

	INDUSTRIAL AIR CLEANERS												
TAG	SERVICE	MANUFACTURER	MODEL	AIRFLOW	FAN MOTOR	ELECTR	ICAL	WEIGHT	REMARKS				
IAG	SERVICE	WANUFACTURER	WIODEL	(L/S)	(kW)	V/Ph/Hz	FLA	(kg)	REWARKS				
IAC-1	APPARATUS BAY	AIRMATION	AMB302-NDR	1416	0.75	208/3/60	7.5	108.9	REFER TO NOTES 1&4				
IAC-2	BUNKER GEAR	AIRMATION	MICROCON CD	378	0.24	120/1/60	2.4	56.7	REFER TO NOTES 2 & 4				
IAC-3	HOSE TOWER	AIRMATION	MICROCON AS	283	0.23	120/1/60	2.4	15.0	REFER TO NOTES 3 & 4				
NOTES:			,										

1. C/W PRE-FILTER, FINAL FILTER, GAS PHASE FILTER AND TCMMB CONTROLLER.
2. CEILING HUNG UNIT C/W VIBRATION ISOLATORS.

3. PORTABLE UNIT TO HAVE WHEELS REMOVED AND SHALL BE WALL MOUNTED OUT OF THE WAY AND C/W DUCTWORK TO AVOID RECIRCULATION AS INDICATED ON PLANS. 4. INSTALL AS PER MANUFACTURER INSTRUCTION.

EIVTUDE TAC	DESCRIPTION		CONNE	CTION SIZES		DEMARKS
FIXTURE TAG	DESCRIPTION		DHW	SAN	VENTOCW	REMARKS
WC-1/WC-2	WC - Flush Valve	25	n/a	100	38	
L-1/L-2	Lavatory	12	12	32	32	
S-1	Private Single Comp. Sink	12	12	38	32	
S-1	Private Two Comp. Sink	12	12	38	32	
S-1	Kitchen Single Comp. Sink	12	12	38	32	
S-2	Kitchen Two Comp. Sink	12	12	38	32	
S-3	Kitchen Three Comp. Sink	12	12	50	38	
JS-1	Mop / Janitor's Sink	20	20	75	38	
SH-1	Shower	12	12	50	38	
DW-1	Dishwasher (Domestic)	n/a	12	38	32	INDIRECT CONNECTION TO SINK TAILPIECE
HB-1	Hose Bibb	20	n/a	n/a	n/a	C/W ATMOSPHERIC VACUUM BREAKER
FD-1	4" F.D	n/a	n/a	100	38	
FD-1	3" F.D	n/a	n/a	75	38	
FD-1	2" F.D	n/a	n/a	50	38	
EW-1	Eyewash Station	12	12	38	32	TEMPERED WATER FROM T.M.V

		•	GRILLES AND DIFFUS	ERS		
TAG	TYPE	MANUFACTURER	MODEL	LENGTH	WIDTH	REMARKS
Α	SWIRL DIFFUSER	KAMPMANN	KASWIRL-ED-300	300	300	C/W HIGH INDUCTION ECCENTRIC DRUM
В	SWIRL DIFFUSER	KAMPMANN	KASWIRL-ED-400	400	400	C/W HIGH INDUCTION ECCENTRIC DRUM
С	SWIRL DIFFUSER	KAMPMANN	KASWIRL-ED-300/600	600	600	C/W HIGH INDUCTION ECCENTRIC DRUM
D	SWIRL DIFFUSER	KAMPMANN	KASWIRL-ED-500/600	600	600	C/W HIGH INDUCTION ECCENTRIC DRUM
E	SWIRL DIFFUSER	KAMPMANN	KASWIRL-ED-500/600	600	600	C/W HIGH INDUCTION ECCENTRIC DRUM
F	EGG CRATE GRILLE	EH PRICE	85 DAL	300	300	C/W RETURN AIR CANOPY
G	SIDEWALL	E.H. PRICE	85 DAL			
I	NOZZLE DIFFUSER	E.H. PRICE	ND	0	0	200Ø DIAMETER

					DESTRATIF	ICATIO	N FANS				
TAG	LOCATION	QTY	MANUFACTURER	MODEL	DIAMETER (M)	POWER (kW)	MAX RPM	V/Ph/Hz	SPEED CONTROL	WEIGHT (kg)	REMARKS
CF-1	APPARATUS BAY	2	BIG ASS FANS	PFX3-10	3.0	0.75	160	208/3/60	VFD	105	
CF-2	BUNKER GEAR 127	1	BIG ASS FANS	E7	2.1	0.18	198	115/1/60	DIAL	31	C/W WALL SPEED CONTROL & EXTENSION TUBE TO REACH 10' INSTALL HEIGHT

		V	ARIABLE RI	EFRIGERANT	FLOW	HEAT	RECO	VER'	Y BR	ANCH	SELECTOR	2
TAG	MANUFACTURER	MODEL	ASSOCIATED	MAX CAPACITY	ELE	ECTRICA	L	DIN	/IENSIO	NS	WEIGHT (kg)	REMARKS
IAG	WANDFACTORER	WIODEL	CONDENSER	(kW)	V/Ph/Hz	MCA	MOCP	W	Н	D	WEIGHT (Kg)	KEWIARRO
BS-1	DAIKIN	BSF8Q54TVJ	CU-1	0.00 kW	208/1/60	0.4	15	579	297	480	33.1 kg	C/W BRANCH SELECTOR CLOSED PIPE KIT

				KITCH	IEN RANGE	HOOD				
TAG	LOCATION	MANUFACTURER	MODEL	WIDTH (mm)	DEPTH (mm)	AIRFLOW (L/s)	S.P (Pa)	V/Ph/Hz	WEIGHT (kg)	REMARKS
RH-1	KITCHEN	CAPTIVEAIRE	4824 ND-2	1219	1219	378	-153	120/1/60	150	430 SS WHERE EXPOSED
	OKING TEMPERATURE: 3	315 DEG. C								

3. C/W ANSUL R102 COMMERCIAL SUPPRESSION SYSTEM CONTAINED IN INTEGRATED UTILITY CABINET. 4. C/W GREASE FILTERS AND MINIMUM TWO UL LISTED LIGHT FIXTURES

				GAS FI	RED HOT WA	ATER TANK H	IEATER					
				# OF	GAS - INPUT	RECOVERY RATE			DIAMETER	HEIGHT	FLUE SIZE	
TAG	MANUFACTURER	MODEL	LOCATION	HEATERS	CAPACITY	(LPH @ 37.7C)	STORAGE CAPACITY	V/Ph/Hz	(mm)	(mm)	(mm)	REMARKS
DHWT-1	BRADFORD WHITE	EF-100T-399E-3N (A)	MECHANICAL ROOM	1	117.0 kW	1707	264.90 L	120/1/60	718	1432	76	

							EXHA	AUST F	ANS												
TAG	SERVICE	LOCATION	MANUFACTURER	MODEL	AIRFLOW	E.S.P.	POWER	ВНР	MOTOR	V/Ph/Hz	SPEED			so	UND	POWER	R (dB)			WEIGHT	REMARKS
1,40	CERTICE	LOCATION	MANOI ACTORER	WODEL	(L/s)	(Pa)	(kW)	(kW)	RPM	V/1 11/112	CONTROL	1	2	3	4	5 6	7	8	dB(A)	(kg)	KEMAKKO
EF-1	APPARATUS BAY EXHAUST	WALL	COOK	180W17D (VF)	900	100	0.19	0.16	703	115/1/60	ECM	59	69	66 6	31 6	0 55	51	48	53	40	REFER TO NOTE 1
EF-2	APPARATUS BAY EXHAUST	WALL	COOK	180W17D (VF)	900	100	0.19	0.16	703	115/1/60	ECM	59	69	66 6	31 6	0 55	51	48	53	40	REFER TO NOTE 1
EF-3	KITCHEN EXHAUST	ROOF	CAPTIVEAIRE	DU50HFA	378	250	0.37	0.24	0	115/1/60	ECM	75	77	83	75 7	0 68	64	55	67	55	REFER TO NOTE 2
EF-4	TAILPIPE EXHAUST	ROOF	NEDERMAN	NCF-30/20	920	1493	4.10	0.00	0	208/3/60	VFD	0	0	0	0	0	0	0	88	85	REFER TO NOTE 3
EF-5	ELECTRICAL ROOM EXHAUST	ROOF	COOK	120C17DEC	285	75	0.56	0.24	1725	115/1/60	ECM	58	61	58 5	53 5	2 47	42	38	45	14	REFER TO NOTE 2

1. C/W 600mm ROOF CURB, UNIT MOUNTED ADJUSTABLE SPEED CONTROL, REMOTE CONTROL INTERFACE TO CONNECT TO BAS AND APPARATUS BAY GAS DETECTION CONTROLLER.

2. UL705, UL762, & ULC-S645 LISTINGS AND C/W 600mm CURB, GREASE BOX, 0-10V REFERENCE SPEED CONTROL. FAN PROVIDED BY COMMERCIAL HOOD SUPPLIER. 3. C/W TAILPIPE CAPTURE RAILS, HOSES, MAGNETIC GRABBERS, AND CONTROLLER. FAN TO BE MOUNTED ON NON-PENETRATING SUPPORT EQUAL TO PORTABLE PIPE HANGERS EQUIPMENT PLATFORM.

								FAN CC	IL CAS	SETTE	ES										
							AIR		COOLII	NG		HEATIN	IG	ELEC	TRICAL		DIME	NSIONS	(m)		
TAG	MANUFACTURER	MODEL	NOMINAL	TYPE	ASSOCIATED	REFRIGERANT	AIRFLOW		TY (kW)	EAT	EAT	CAPACITY	EAT							WEIGHT	REMARKS
IAG	MAROT ACTORER	MODEL	TONNAGE	2	CONDENSER	TYPE	(L/s)	TOTAL	SENSIBL E	(DB)	(WB)	(kW)	(DB)	V/Ph/Hz	MCA	MOCP	W	н	D	(kg)	KEMAKKO
FC-4	DAIKIN	FTX15NMVJU	1.3	WALL MOUNTED UNIT	CU-2	R401A	593	4.4	3.65	26 °C	19 °C	5.36	21 °C	208/1/60	17.0	20	990	295	263	12.0 kg SEE NOTES	
NOTES: 1 C/W SMAR	RT THERMOSTAT TO M	MONITOR TEMPER	RATURE HUM	DITY, AND OCCUPANCY, A	ND TO CONTROL	ASSOCIATED FE	RV/DOAS UN	IT								'			'		

									AIR-CO	OLED (CONE	DENSI	NG U	INITS							
TAC	MANUFACTURER	MODEL	NOMINAL	COOLING	CAPACITY	HE	ATING CAPA	CITY	REFRIGERANT		ELECTR	RICAL		DIME	NSION	S (M)	WEIGHT	E	FFICIENC	Y	REMARKS
TAG	WANUFACTURER	MODEL	TONNAGE	(kW)	OAT (DB)	(kW)	OAT (DB)	OAT (WB)	TYPE	V/Ph/Hz	MCA	MOCP	RLA	W	D	Н	WEIGHT	EER	IEER	COP	KEWAKAS
CU-2	DAIKIN	RXL15QMVJU	1.25	4.40	35 °C	5.36	-25 °C	-25 °C	R401A	208/1/60	13 A	15	12 A	870	320	735	49.00 kg	13	20	4	

									GAS FIF	RED MA	KEUP A	R UNITS													
TAG	MANUFACTURER	MODEL	SERVICE	NOMINAL COOLING CAPACITY (TONS)	OUTDOOR AIRFLOW (L/s)	AIRFLOW (L/s)	JPPLY FA E.S.P (Pa)	SPEED CONTROL	C REFRIGERANT		CITY (kW)	GAS TYPE	HEATING GAS INPUT (kW)	OUTPUT (kW)	FILTER	COP			MOCP	CAL V/Ph/Hz			V/Ph/Hz	WEIGHT (kg)	REMARKS
MAU-1	CAPTIVEAIRE	AI-IBT-150-15D-MPU	KITCHEN HOOD	2	378	378	125	ECM	R410-A	7.0	4.3	NG	31.7	25.4	MERV 8	3.7	14	19	30	115/1/60	14 A	20 A	208/1/60	680	

TAG MANUFACTURER MODEL AIRFLOW (L/s) (Pa) (W) (W) (L/s) (Pa) (W) (W) (W) (W) (W) (W) (W) (W) (W) (W														DE	DICATE	OUTS	SIDE	AIR S	YSTE	/IS																	
TAG MANUFACTURER MODEL AIRFLOW [L/s) (L/s) (Pa) (W) (L/s) (Pa) (W) (L/s) (Pa) (W) (L/s) (Pa) (W) (H/s) (Pa) (W) (H/s) (Pa) (W) (W) (W) (H/s) (W) (W) (W) (W) (W) (W) (W) (W) (W) (W					SUPP	LY FAN				EXHAUS	ST FAN	i .	FILTERS		FFFIOIEN	101/ (0/)		-					ERFOF	RMANCE			10 DEF	FORM	11105				ELI	CTRIC	AL.		
(L/s) (Pa) (kW) (W) (L/s) (Pa) (kW) (W) RETURN) Y SENSIBLE LATENT DB WB	TAG	MANUFACTURER	MODEL	AIRFLOV	V E.S.P	. POWE	ER E	BHP /	AIRFLOW	E.S.P.	POWER	ВНР	(SUPPLY /	PREHEAT COIL		NCY (%)	0.4.7	(00)	DAT	ZEKLO	RMANG	E	T (9C)	-							(90)	- L	MCA	MOCD	\//Db/II-	WEIGHT REMAR	RKS
DB WB		1		(L/s)	(Pa)	(kW	n ((W)	(L/s)	(Pa)	(kW)	(W)	RETURN)	CAPACITI (KVV)	SENSIBLE	LATENT	U.A.1	. (°C)	R.A. I. (*	<i>,</i>) 3.,	4.1. (**) E.A	_ ` 		i. (°C)	K.A.I.	('6)	5.A.I.	` '		`	FLA	IVICA	MOCP	V/PN/HZ		
DOLO 1 DODY FRVOTO 000 USB 000				` ′	` ′	,		` /	` ,	\	` ,	` ′					DB	WB	DB W	B DI	3 WE	3 DB	EB	DB	WB	DB	WB	DB	WB	DB	WB						
DOAS-1 COOK ERV-2500 610 165 Pa 0.37 274 610 180 0.56 386 MERV 13 5.0 kW 81.7 79 30.0 23.0 25.0 18.7 25.5 19.2 29.4 22.5 -19.6 -20.2 22.0 12.2 17.6 9.8 -15.3 -15.4 8 10 15 575/3/60 815 kg NOTES 1&2	DOAS-1	COOK	ERV-2500	610	165 Pa	a 0.37	7 2	274	610	180	0.56	386	MERV 13	5.0 kW	81.7	79	30.0	23.0	25.0 18	.7 25	.5 19.	2 29.4	22.5	-19.6	-20.2	22.0	12.2	17.6	9.8	-15.3	-15.4	8	10	15	575/3/60	815 kg NOTES	1&2

NOTES:
1. UNIT TO BE COMPLETE WITH VARIABLES FREQUENCY DRIVES FOR SUPPLY AND EXHAUST FANS. REFER TO CONTROLS SCHEMATICS FOR OPERATIONAL REQUIREMENTS. PROVIDE REQUIRED INTERFACE CARD FOR VRV BAS REMOTE MONITORING AND SETPOINT CONTROL.
2. CURB TO BE MINIMUM 600MM TALL.
3. COMPLETE WITH HINGED ACCESS DOOR, PURGE SECTION, DOUBLE WALL CONSTRUCTION, GFCI SERVICE OUTLET, ROTATION SENSOR, DIRTY FILTER SENSOR, ENTHALPY ECONOMIZER MODE, INSULATED MOTORIZED CENTRE PIVOT INTAKE DAMPER, MOTORIZED CENTRE PI

//UM 600MM TALL.
HINGED ACCESS DOOR, PURGE SECTION, DOUBLE WALL CONSTRUCTION, GFCI SERVICE OUTLET, ROTATION SENSOR, ENTHALPY ECONOMIZER MODE, INSULATED MOTORIZED CENTRE PIVOT INTAKE DAMPER, MOTORIZED CENTRE PIVOT RETURN DAMPER, MOTORIZED EXHAUST DAMPER.

							VAF	RIABLE F	REFRIG	ERANT	FLOW C	ASSETT	ΓES														
						70115		AIR		COOL	ING		HEATIN	NG	EL	ECTRICAL		DIM	ENSIO	NS							
TAG	MANUFACTURER	MODEL	NOMINAL		ASSOCIATED	ZONE CHANGEOVER	REFRIGERANT	AIRFLOW	CAPAC	ITY (kW)	EAT _	CAR	ACITY								WEIGHT (kg)	REMARKS					
MARGI ACTO	MAROTAGIONER	MODEL	TOP	TON	TON	TONNAGE	TONNAGE	TONNAGE	TYPE	CONDENSER	DEVICE	TYPE AIRFLO (L/s)		TOTAL	SENSIBL E	(DB) E	l (k	(W)	EAT (DB)	V/Ph/Hz	MCA	MOCP	w	Н	D	WEIGHT (Ng)	KEMPARIO
FC-1	DAIKIN	FXSQ07TAVJU	0.6	MSP Concealed Ducted Unit	CU-1	Yes	R410A	133	2.07	1.57	26 °C 65 °F	1114	46.00	19 °C	208/1/60	0.8	15	551	246	800	25.0 kg	c/w NAVIGATION REMOTE CONTROLI					
C-2	DAIKIN	FXSQ05TAVJU	0.5	MSP Concealed Ducted Unit	CU- 1	Yes	R410A	133	1.64	1.31	26 °C 65 °F	1444	44.00	19 °C	208/1/60	0.8	15	551	246	800	25.0 kg	c/w NAVIGATION REMOTE CONTROL					
C-3A	DAIKIN	FXSQ09TAVJU	0.8	MSP Concealed Ducted Unit	CU-1	Yes	R410A	150	2.66	1.91	26 °C 65 °F	1114	46.00	19 °C	208/1/60	0.8	15	551	246	800	25.0 kg	c/w NAVIGATION REMOTE CONTROL					
C-3B	DAIKIN	FXSQ09TAVJU	0.8	MSP Concealed Ducted Unit	CU-1	Yes	R410A	150	2.66	1.91	26 °C 65 °F	1114	46.00	19 °C	208/1/60	0.8	15	551	246	800	25.0 kg	c/w NAVIGATION REMOTE CONTROL					
C-5	DAIKIN	FXSQ18TAVJU	1.5	MSP Concealed Ducted Unit	CU-1	Yes	R410A	284	4.95	3.73	26 °C 65 °F	12	2.50	19 °C	208/1/60	1.6	15	1001	246	800	35.0 kg	c/w NAVIGATION REMOTE CONTROLI					
-C-6	DAIKIN	FXSQ24TAVJU	2.0	MSP Concealed Ducted Unit	CU-1	Yes	R410A	350	0	0	26 °C 65 °F	12	2.50	19 °C	208/1/60	1.8	15	0	0	0	0.0 kg						
FC-7	DAIKIN	FXSQ36TAVJU	3.0	MSP Concealed Ducted Unit	CU-1	Yes	R410A	534	9.96	7.09	26 °C 65 °F	4264	49.00	19 °C	208/1/60	2.5	15	1400	246	800	46.0 kg	c/w NAVIGATION REMOTE CONTROLI					
FC-8	DAIKIN	FXSQ07TAVJU	0.6	MSP Concealed Ducted Unit	CU-1	Yes	R410A	133	2.07	1.57	26 °C 65 °F	1444	44.00	19 °C	208/1/60	0.8	15	551	246	800	25.0 kg	c/w NAVIGATION REMOTE CONTROL					
FC-9	DAIKIN	FXSQ15TAVJUO	1.3	MSP Concealed Ducted Unit	CU-1	Yes	R410A	250	0	0	26 °C 65 °F	3.	.27	19 °C	208/1/60	1.4	15	0	0	0	0.0 kg						

										VAR	IABLE REFR	RIGERANT FLOW	AIR-COOLE	D CONDEN	ISING UNI	TS											
TAG	MANUFACTURER	MODEL	NOMINAL TONNAGE	COOLING	CAPACITY	Н	HEATING CAPA	CITY	PEAK COINCIDENT	INDOOR UNIT LOAD	REFRIGERANT TYPE	REFRIGE		CONNECTION RATIO	ELEC	TRICAL (P	ER MODU	LE)	OVER DIMEN		WEIGHT		E	FFICIENC	Υ	REMARKS	
			IONNAGE	(kW)	OAT (DB)	(kW)	OAT (DB)	OAT (WB)	COOLING (kW)	HEATING (kW)	ITPE	FACTORY CHARGE	ADD'L CHARGE	RATIO	V/Ph/Hz	MCA	MOCP	RLA	W	Н		EER	IEER	COP47	COP17 SC	HE	
CU-1	DAIKIN	RELQ120TAYCA	10	35.30	35 °C	33.90	-30 °C	-30 °C	35.0	23.1	R410A	25.8 kg	25.5 kg	110.7%	575/3/60	31 A	40	14 A	1241 76	6 1693	360.00 kg	13.7	23.4	4	2.3 26	.7	
NOTES:																•							•				

1. Manufacturer must be certified, listed, and labeled per AHRI 1230. 2. Submitted performance data must be fully de-rated for all components and accessories, including but not limited to, line length, vertical separation, connection ratio, design conditions, condenser coil coating. 3. Condensing units must have fully modulating INVERTER compressors.

4. Condensing units must have have auto changeover functions

5. Demand limiting relay contact must be provided. 6. EEV actuators must be removable from valve body without disturbing the refrigerant system.

7. FCU thermostats must provide +/- 1 degree dead-band set-point and control capability. 8. System shall be provided with i-Touch Manager controller with WEB based software for displaying up to 8 DIII-Net systems with 128 indoor units per system.PC by others.


9. Manufacturers submittal must include refrigerant piping diagram with pipe diameters, lengths, and refrigerant volume.

10. Substitute manufacturer shall be responsible for additional piping and refrigerant.

11. Contractor to verify piping dimensions. 12. Installing contractor must have successfully completed manufacturers certified installation class within past 36 months. 13. Contractor to furnish and install insulation on refrigerant piping.

FOR QUESTIONS REGARDING THIS PROJECT, PLEA	۱S
EMAIL: CM-20-063@QUASARCG.COM	

Н	ISSUED FOR TENDER	2021-08
G	ISSUED FOR BUILDING PERMIT	2021-00
F	90% CD	2021-07
Ē	SPA	2021-02
	50% CD	2021-02
С	BUILDING PERMIT	2021-02
В	PERMIT/SPA COORDINATION	2021-02
Α	100% DESIGN DEVELOPMENT	2021-01
		•

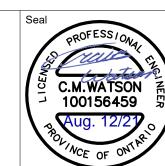

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Project Information BFES Station 201 (SPA-2021-0032)

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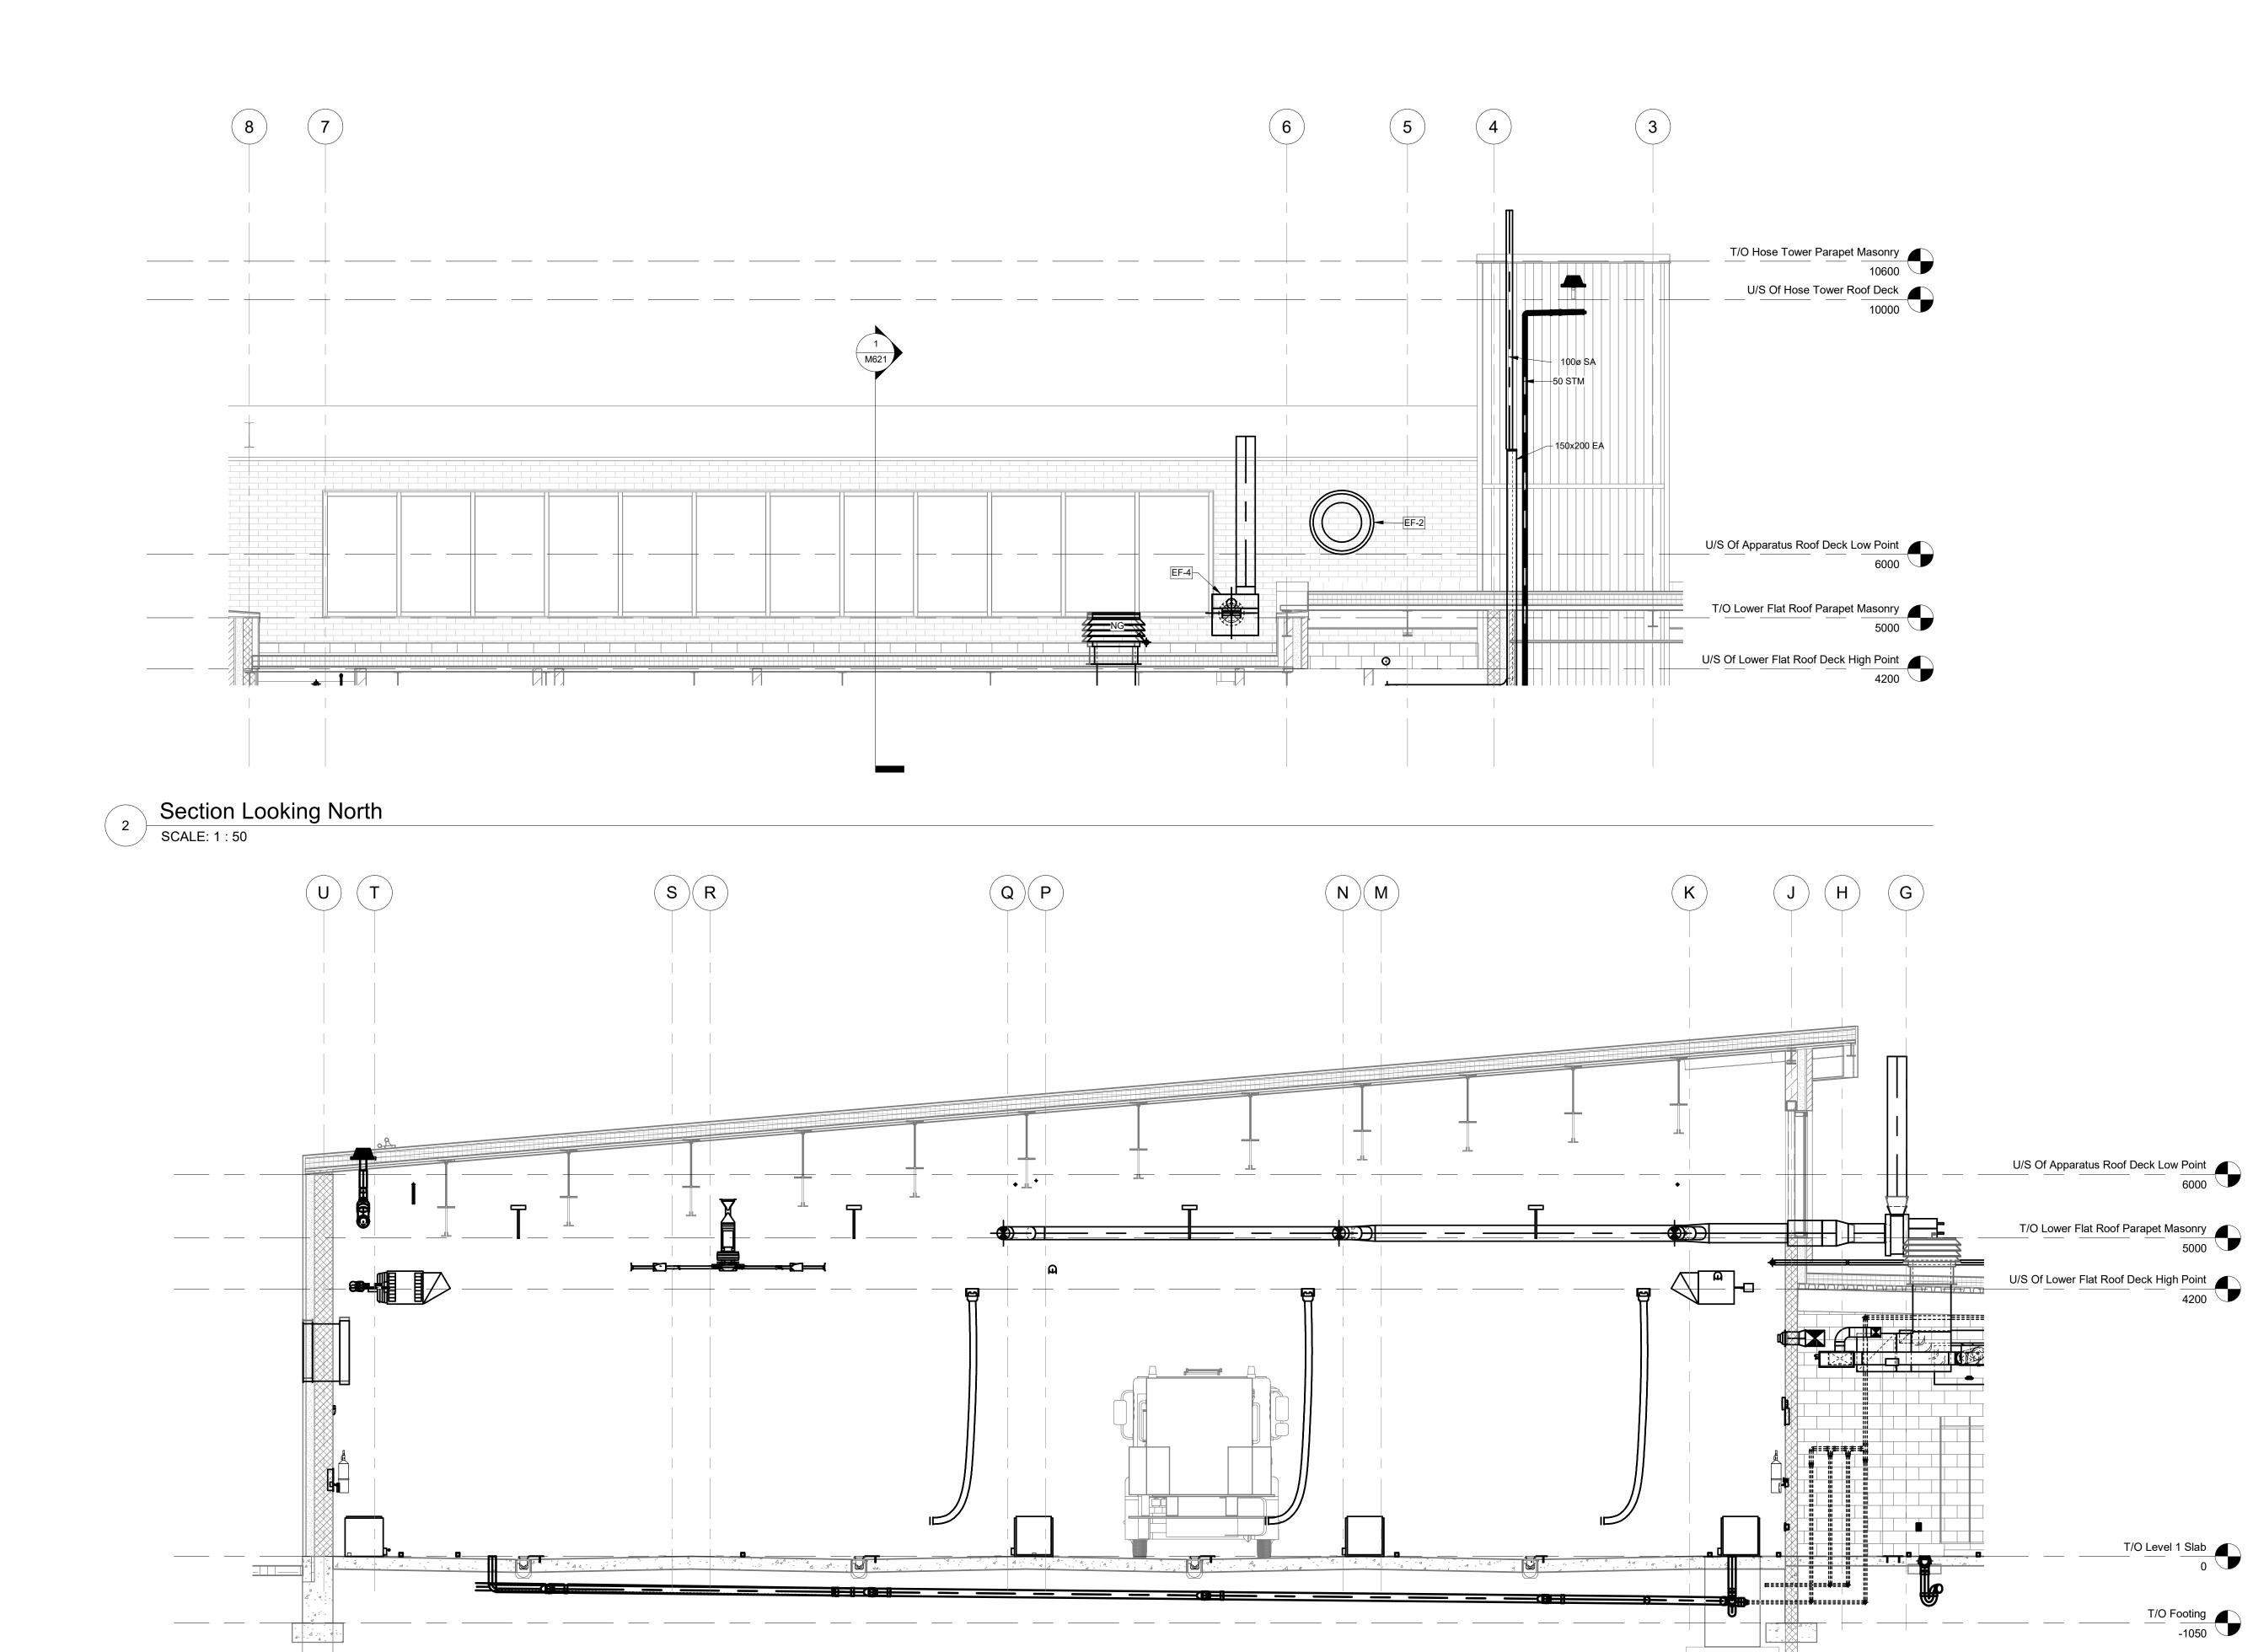
27 Rutherford Rd. S., Brampton, ON, L6W 3J3

City of Brampton Fire & Emergency Services

Drawing Title MECHANICAL EQUIPMENT SCHEDULE


te 2021-08-12	Project No	Drawing No
awn by CMW	CM-20-063	M610
ale 1 : 1		

East-West Section Through Apparatus Bay
SCALE: 1:50



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В	ISSUED FOR TENDER	2021-08-12
Α	ISSUED FOR BUILDING PERMIT	2021-07-27
No.	Revision	Date

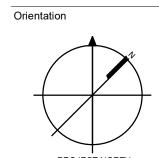

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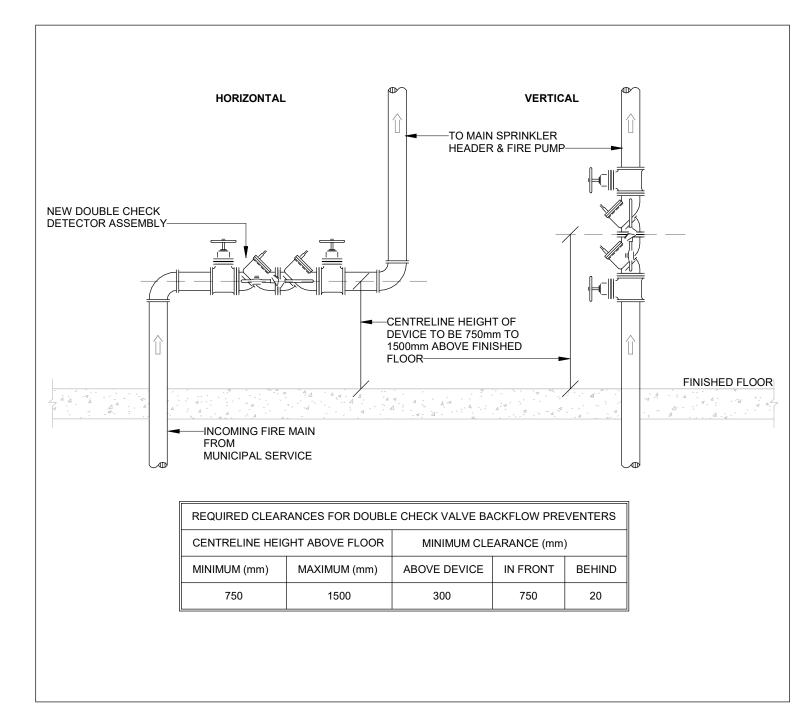
27 Rutherford Rd. S., Brampton, ON, L6W 3J3

City of Brampton Fire & Emergency Services

Drawing Title

MECHANICAL SECTIONS

Project No Drawing No 2021-08-12 Drawn by CM-20-063 M621 Author Scale 1 : 50



21 13 00.01 FIRE DOUBLE CHECK DETECTOR ASSY

12 MIN.

PIPE OR CONDUIT

—ULC LISTED FIRE BARRIER SEALANT

FIRE RATED WALL

GROUT IN CONCRETE WALLS.


PIPE SLEEVE IN CONCRETE-


IN DRYWALL PARTITIONS.


WALLS. 20G GALVANIZED SLEEVE

PATCH WITH DRYWALL COMPOUND IN DRYWALL

CONSTRUCTION.

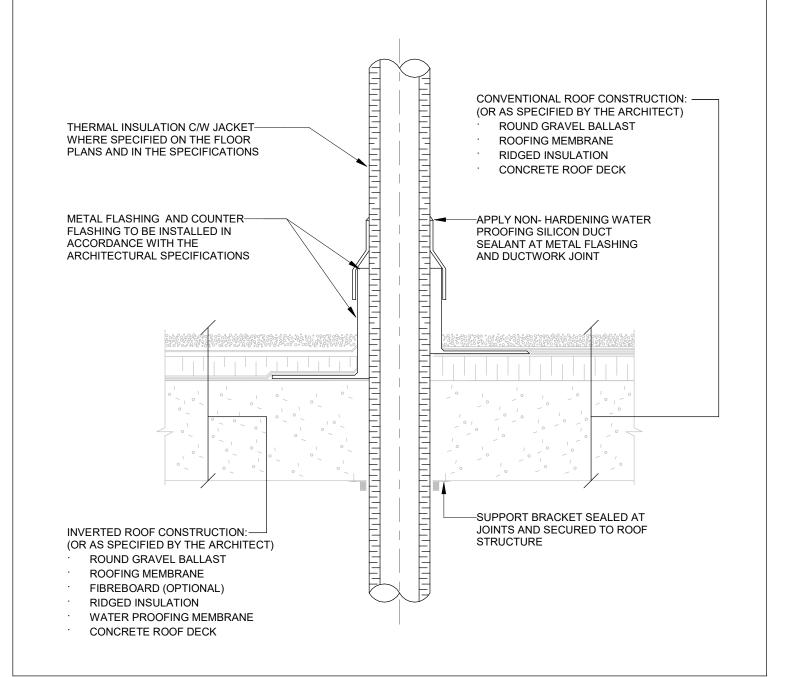

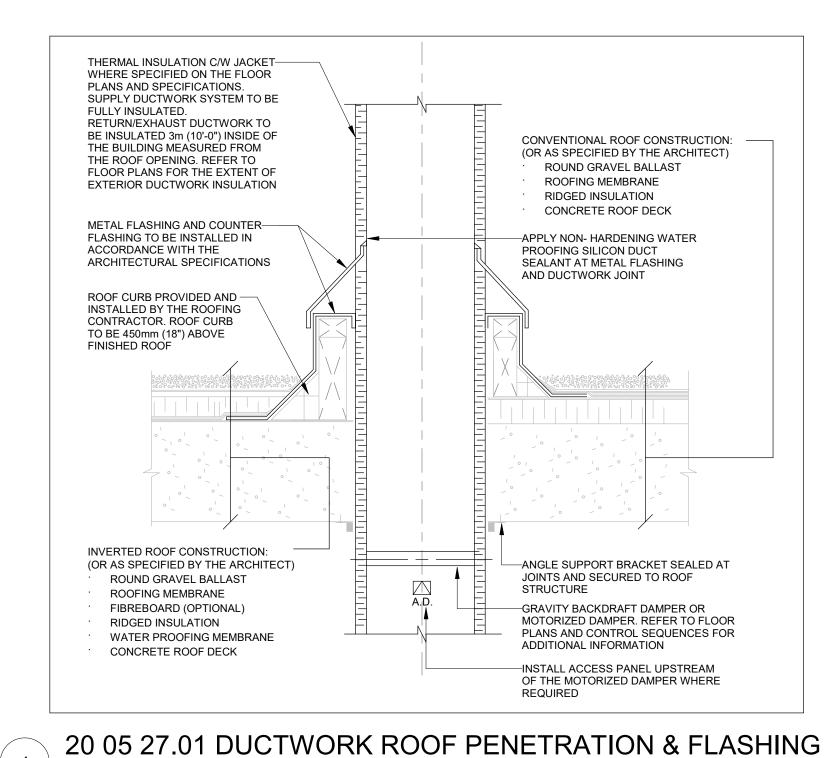

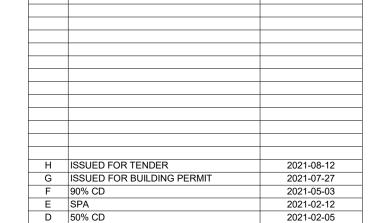

2021-02-05

2021-02-02

2021-01-19

FOR QUESTIONS REGARDING THIS PROJECT, PLEASE

EMAIL: CM-20-063@QUASARCG.COM

BUILDING PERMIT B PERMIT/SPA COORDINATION A 100% DESIGN DEVELOPMENT

100156459

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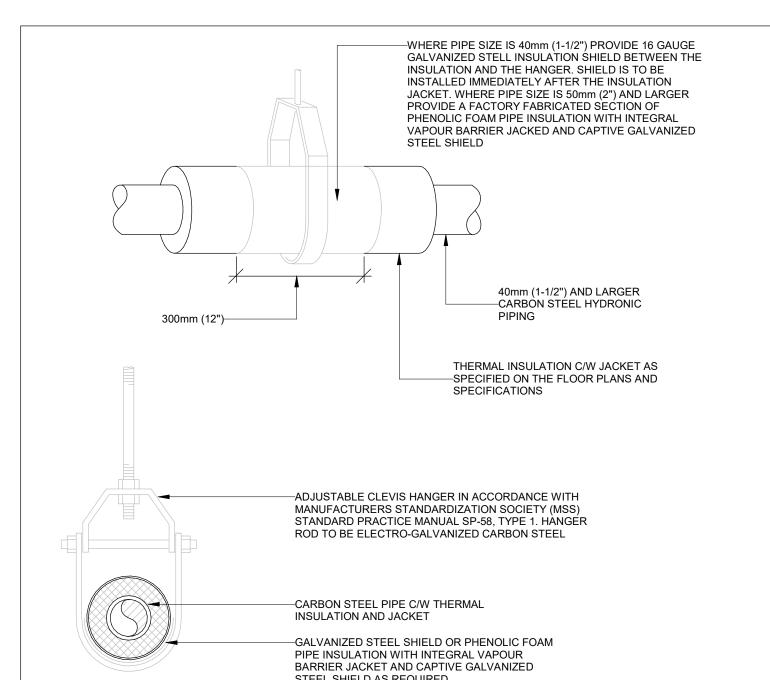
City of Brampton Fire & Emergency Services

Drawing Title

MECHANICAL DETAILS I

Drawn by CMW Scale N.T.S.

20 05 27.02 HVAC PIPE ROOF PENETRATION & FLASHING



STEEL SHIELD AS REQUIRED

SCALE:N.T.S.

20 05 05.08 PIPE PENETRATION THROUGH FIRE RATED WALL 20 05 05.02 PIPING HANGERS AND SUPPORTS

SCALE:N.T.S.

SCALE:N.T.S.

20 05 05.01 PIPING HANGERS AND SUPPORTS

-CARBON STEEL PIPE C/W THERMAL INSULATION AND JACKET -GALVANIZED STEEL SHIELD 2021-08-12

-WHERE PIPE SIZE IS 12mm - 40mm (1/2" -

1-1/2") PROVIDE 16 GAUGE GALVANIZED

STEEL INSULATION SHIELD BETWEEN THE

INSULATION AND THE HANGER. SHIELD IS

TO BE INSTALLED IMMEDIATELY AFTER

THE INSULATION JACKET

-12mm - 25mm (1/2" - 1")

-300mm (12")

ADJUSTABLE SWIVEL RING BAND HANGER IN

STANDARDIZATION SOCIETY (MSS) STANDARD

PRACTICE MANUAL SP-58, TYPE 10. HANGER ROD TO BE


ACCORDANCE WITH MANUFACTURERS


ELECTRO-GALVANIZED CARBON STEEL


CARBON STEEL HYDRONIC


THERMAL INSULATION C/W

JACKET AS SPECIFIED ON THE FLOOR PLANS AND SPECIFICATIONS

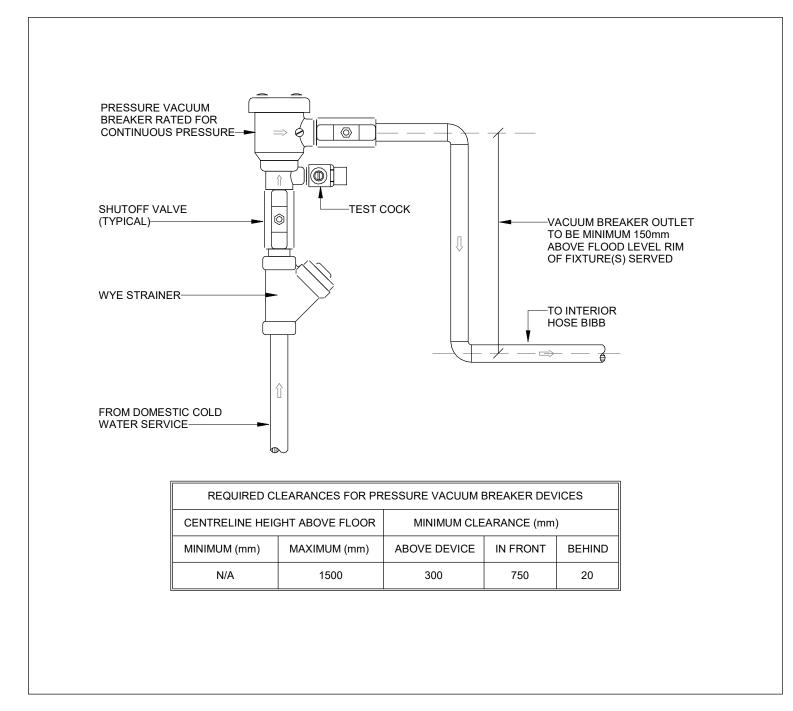

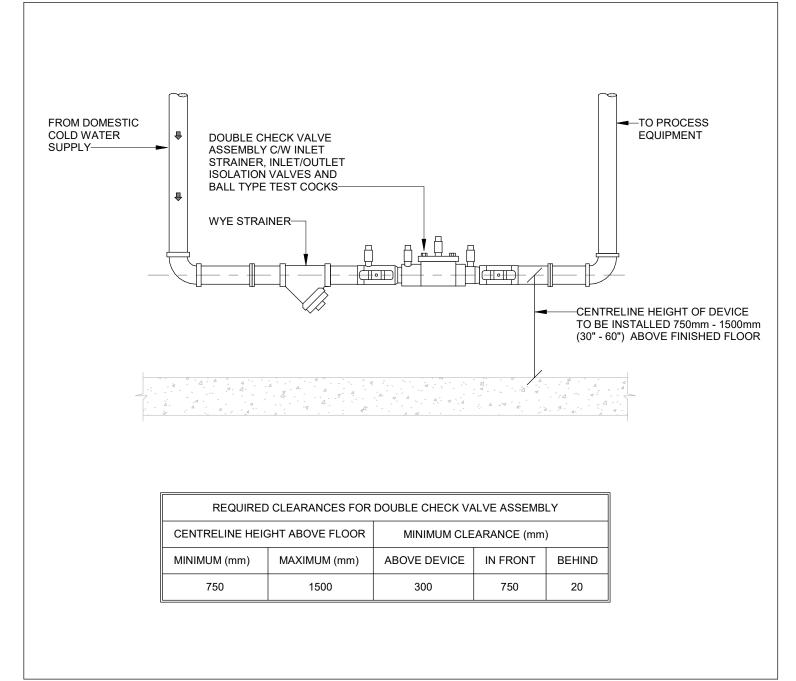

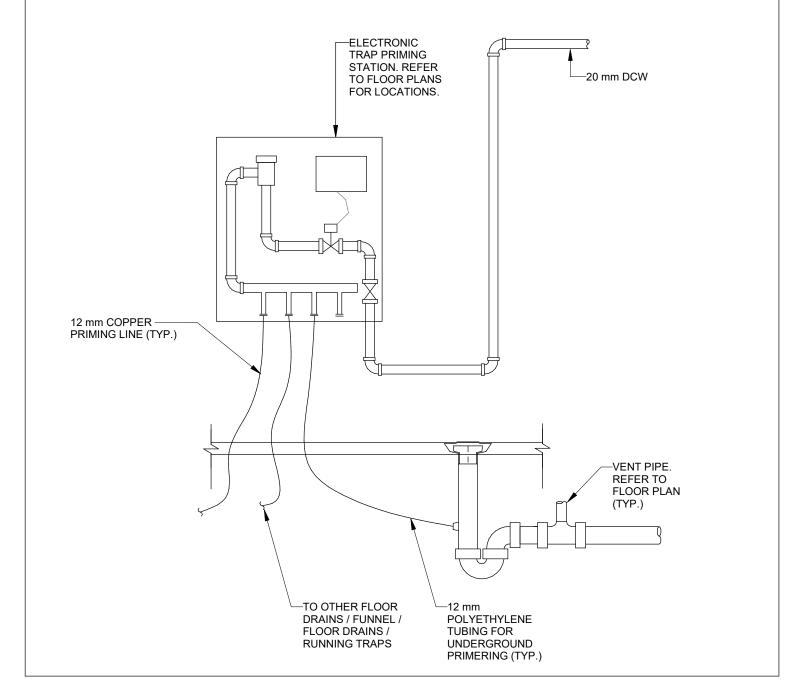

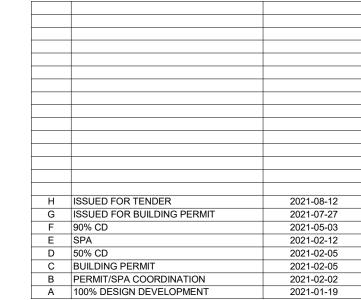

FOR QUESTIONS REGARDING THIS PROJECT, PLEASE


EMAIL: CM-20-063@QUASARCG.COM

Orientation


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22 11 18.03 INTERIOR HOSE BIBB PRESS. VAC. BREAKER

5 22 11 18.02 DOUBLE CHECK VALVE ASSEMBLY SCALE:N.T.S.

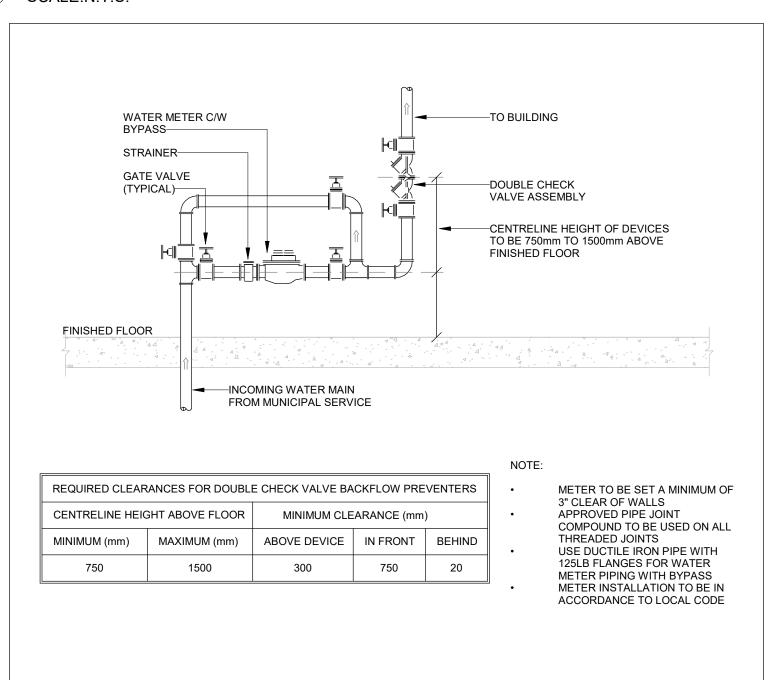

SCALE:N.T.S.

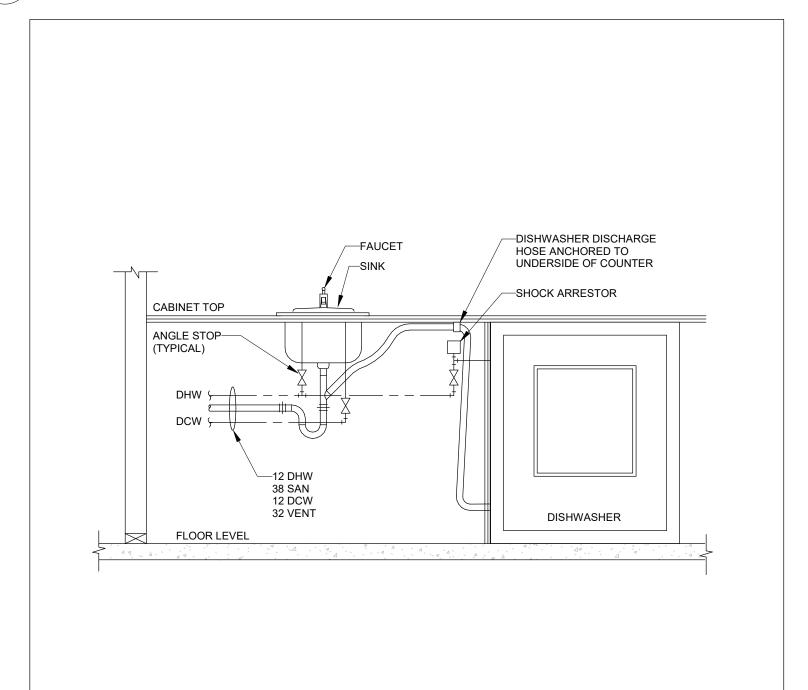

—FIRE DEPARTMENT **FACEPLATE** —FIRE DEPARTMENT CONNECTION C/W TWO 65mm (2-1/2") CONNECTIONS USING NH INTERNAL THREADED SWIVEL FITTINGS WITH CAPS AND CHECK VALVE C/W 20mm-CHAINS 20mm (3/4") AUTOMATIC BALL DRIP FIRE DEPARTMENT CONNECTION TO BE INSTALLED 300mm - 900mm TERMINATE DRAINAGE PIPING-OVER FUNNEL FLOOR DRAIN. (12" - 1m) ABOVE GRADE

22 11 00.02 ELECTRONIC TRAP PRIMING STATION

AUTO-SPKR

STANDPIPE

—FIRE DEPARTMENT
FACEPLATE TO BE POLISHED
BRASS CAST WITH RAISED
LETTERING

SCALE:N.T.S.

PROVIDE AN AIR GAP OF 25mm (1") -

OUTLET PIPING TO THE TOP

OF THE FUNNEL FLOOR DRAIN

300mm (1'-0") MEASURED FROM THE

21 13 00.02 FIRE DEPARTMENT CONNECTION SCALE:N.T.S.

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Project Information

BFES Station 201 (SPA-2021-0032)

27 Rutherford Rd. S., Brampton, ON, L6W 3J3

City of Brampton Fire & Emergency Services

MECHANICAL DETAILS II


Drawing Title


Project No Drawing No


2021-08-12 CM-20-063 M642 CMW Scale N.T.S.

22 11 00.01 DISHWASHER PLUMBING SCALE:N.T.S.

22 11 00.01 WATER METER ASSEMBLY SCALE:N.T.S.

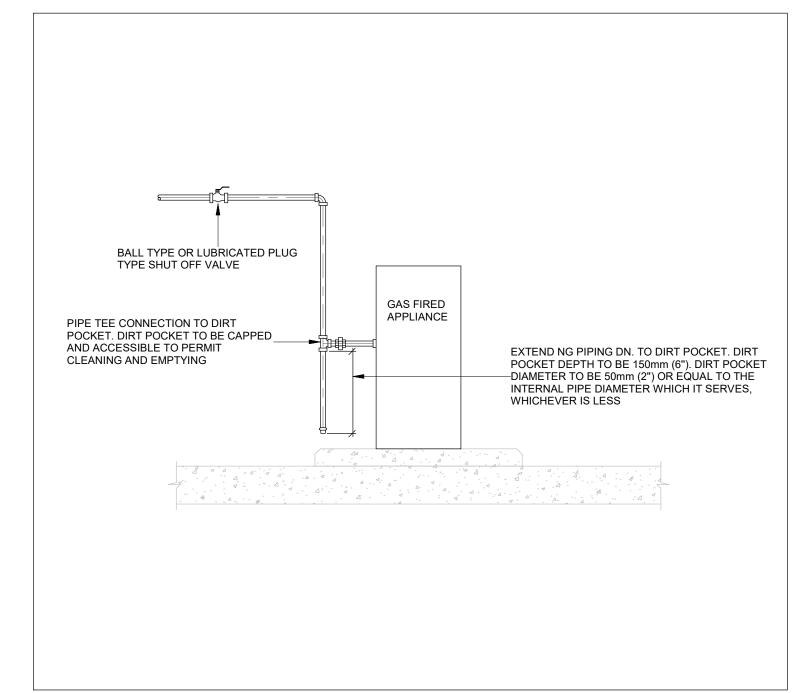

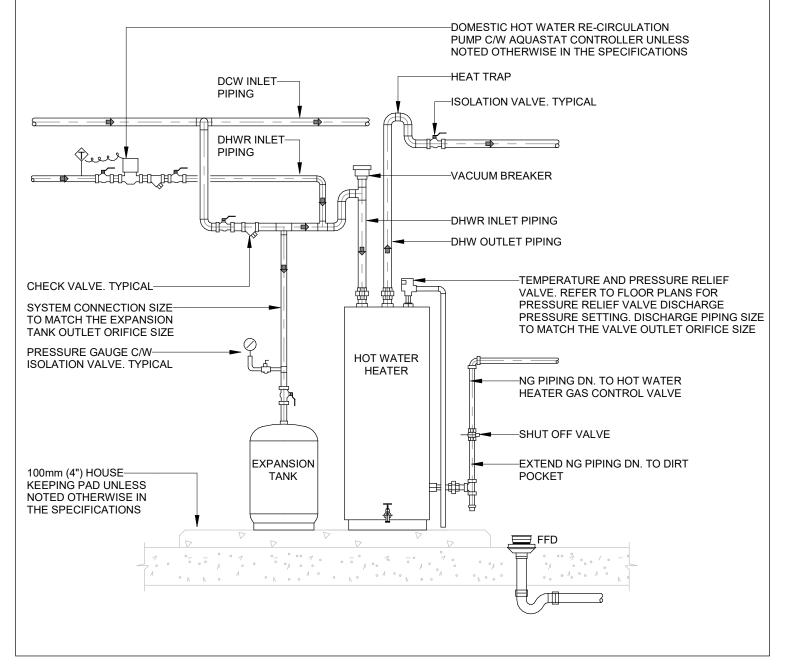

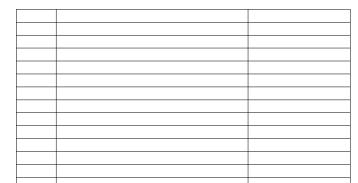

FOR QUESTIONS REGARDING THIS PROJECT, PLEASE

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E SPA
D 50% CD
C BUILDING PERMIT
B PERMIT/SPA COORDINATION
A 100% DESIGN DEVELOPMENT

Quasar Consulting Group.

TEL: 905-507-0800

Orientation

G ISSUED FOR BUILDING PERMIT

H ISSUED FOR TENDER

Seal PROFESS/ONAL COMMANDER OF ONTRE

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2021-08-12


2021-05-03

2021-02-12

2021-02-05 2021-02-05

2021-02-02 2021-01-19


23 11 23.02 GAS PIPE CONNECTION TO EQUIPMENT SCALE:N.T.S.

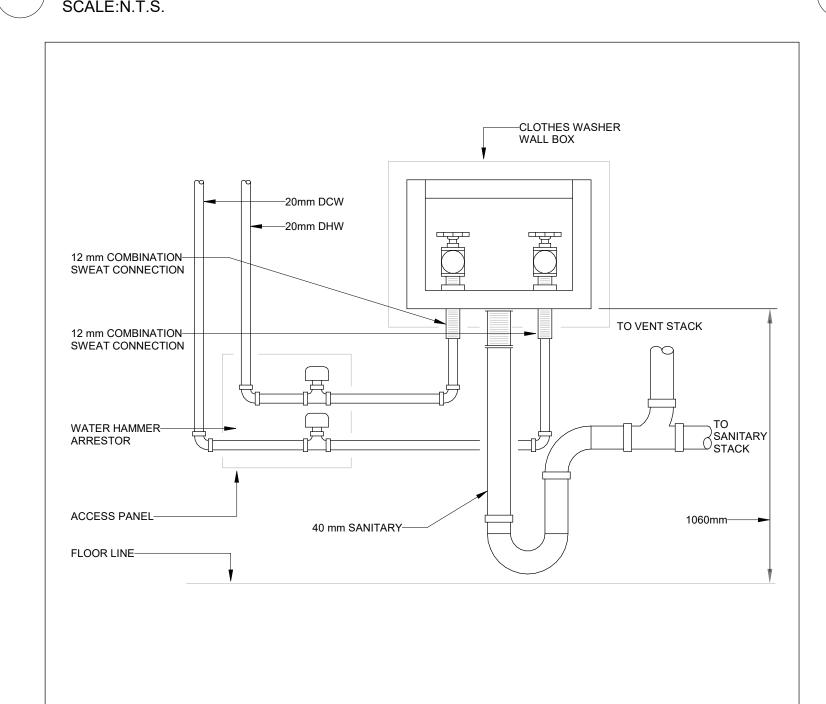

22 30 00.01 LAUNDRY BOX


SCALE:N.T.S.

23 11 23.01 NATURAL GAS EQUIPMENT CONNECTION

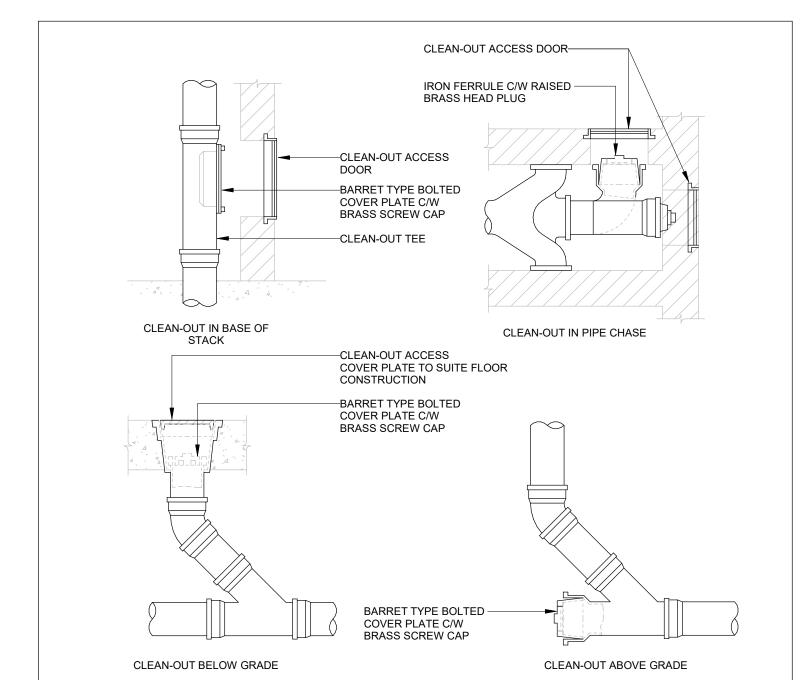

22 13 00.02 SANITARY & STORM WATER CLEANOUTS
SCALE:N.T.S.

22 30 18.01 SEALED COMUSTION HOT WATER HEATER SCALE:N.T.S.

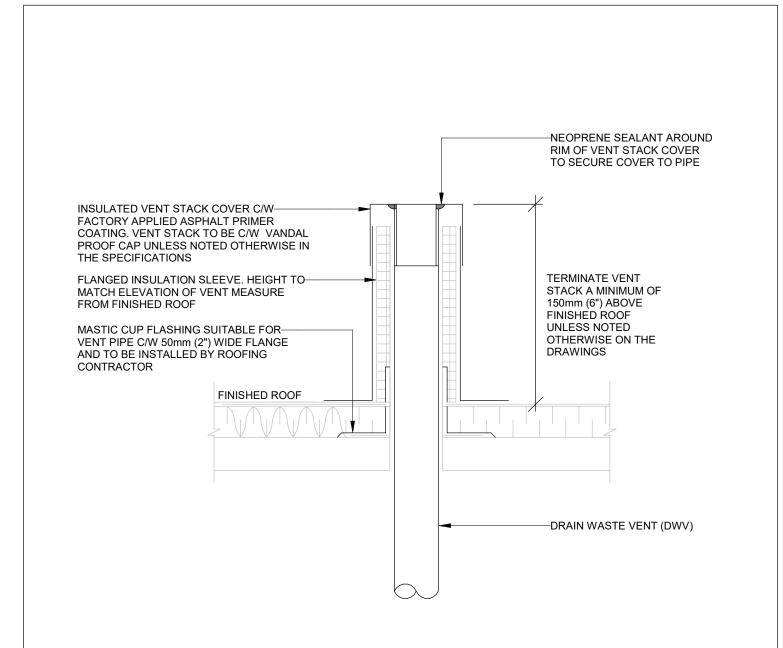

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(SPA-2021-0032)

27 Rutherford Rd. S., Brampton, ON, L6W 3J3

250 ROWNTREE DAIRY RD, WOODBRIDGE, ON

City of Brampton Fire & Emergency Services

Drawing Title

MECHANICAL DETAILS III

Date 2021-08-12 Project No Drawing No CMW CMW CM-20-063 M643

22 13 00.01 DWV ROOF PENETRATION & VENT CAP COVER Scale N.T.S.

PLENUM STORM LOUVER-----1/4 " WIRE MESH SCREEN -PROVIDE MIN. 15° DEEP POCKET NOTES: SLOPED TOWARDS THE STORM 1. ALL JOINTS TO BE MADE WATER TIGHT. 2. REFER TO SPECIFICATIONS FOR ADDITIONAL REQUIREMENTS.

HEEL RADIUS (D + 3/4D)-GOOSENECK DISCHARGE-C/W 5mm WIRE MESH SCREEN AIRFLOW TERMINATE EXHAUST STACK A MINIMUM OF 900mm (3'-0") ABOVE FINISHED ROOF UNLESS OTHERWISE SPECIFIED ON -ROOF CURB AND METAL FLASHING. REFER DRAWINGS TO DUCTWORK ROOF PENETRATION & FLASHING FOR ADDITIONAL INFORMATION. —ANGLE SUPPORT BRACKET SEALED AT JOINTS AND SECURED TO ROOF STRUCTURE -GRAVITY BACKDRAFT DAMPER OR MOTORIZED DAMPER. REFER TO FLOOR PLANS AND CONTROL SEQUENCES FOR ADDITIONAL INFORMATION -INSTALL ACCESS PANEL UPSTREAM OF THE MOTORIZED DAMPER WHERE REQUIRED

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H ISSUED FOR TENDER 2021-08-12 G ISSUED FOR BUILDING PERMIT F 90% CD
E SPA
D 50% CD
C BUILDING PERMIT 2021-05-03 2021-02-12 2021-02-05 2021-02-05 B PERMIT/SPA COORDINATION
A 100% DESIGN DEVELOPMENT 2021-02-02 2021-01-19

100156459

23 30 09.01 FLEXIBLE METALLIC DUCTWORK SCALE:N.T.S.

AIRFLOW

AIRFLOW

45° RADIUS BEND TAKE-OFF

45° SQUARE BRANCH TAKE-OFF

—HEEL RADIUS (D + 3/4D)

SINGLE OR PARALLEL TYPE— BLADE VOLUME CONTROL (BALANCING DAMPER) TO

EXTENSION AND LOCKING

SUITE DUCT SIZE AND DIMENSIONS. BALANCING DAMPER TO BE C/W SHAFT

QUADRANT DAMPER OPERATOR. TYPICAL

SPLITTER DAMPER

SPLITTER ROD C/W——OPERATING HARDWARE.

PROVIDE WITH STAND-OFF

WHERE INSTALLED IN INSULATED DUCTWORK,

MOUNTING BRACKETS

SUPPLY - ROUND RADIUS ELBOW TAKE OFF

TURNING VANES WHERE

SPECIFIED ON THE FLOOR

-RATIO OF CONICAL REDUCTION

TO BE 4:1

HEEL RADIUS (D + 3/4D)

90° BRANCH TEE TAKE-OFF

CONICAL REDUCTION

90° ROUND RADIUS ELBOW

AIRFLOW

23 30 00.02 DUCTWORK CONNECTION TO STORM LOUVRE

-CONICAL SPIN-ON ROUND

-RECTANGULAR 90° RADIUS

WHERE SPECIFIED ON THE


−90° ROUND RADIUS ELBOW

FLOOR PLANS

ELBOW C/W TURNING VANES

TAKE-OFF COLLAR C/W LOCKING DAMPER

23 30 00.02 DUCT THROUGH ROOF PENETRATION & TERM. SCALE:N.T.S.

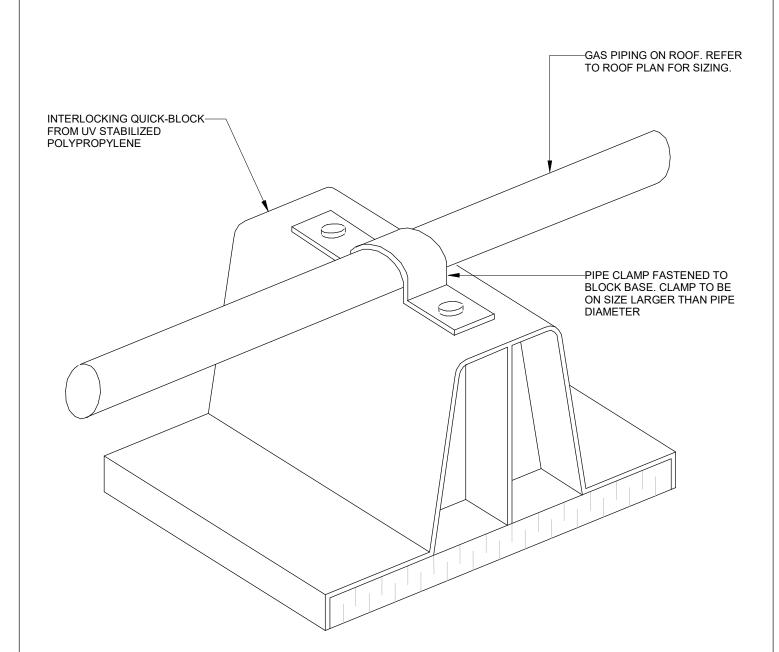

23 11 23.03 GAS PIPING ON ROOF - SUPPORT DETAIL SCALE:N.T.S.

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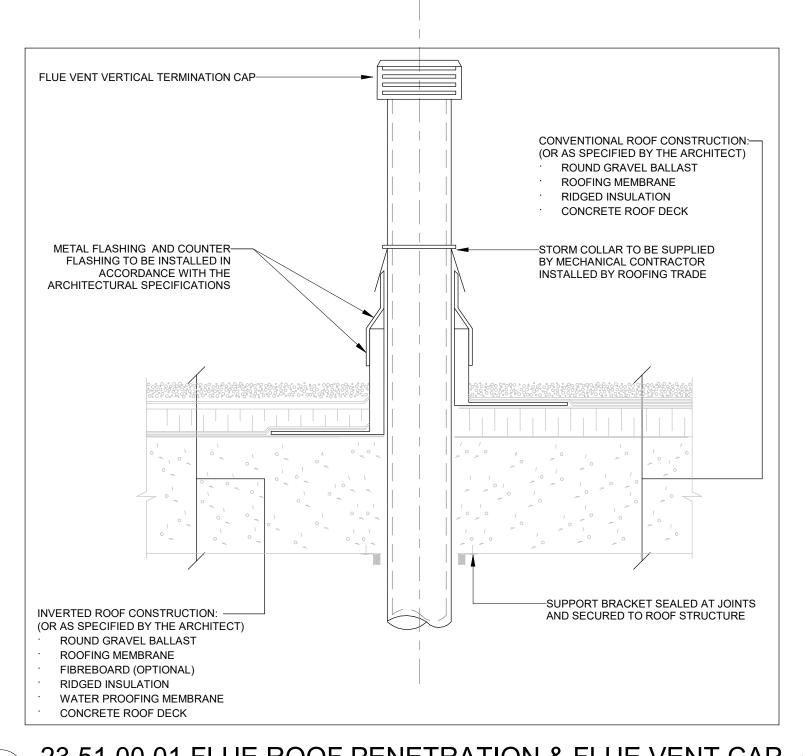
27 Rutherford Rd. S., Brampton, ON, L6W 3J3


City of Brampton Fire & Emergency Services


Drawing Title MECHANICAL DETAILS IV

> Project No Drawing No 2021-08-12 CM-20-063 M644 N.T.S.

23 30 00.01 DUCTWORK FITTINGS & TAKE-OFF'S SCALE:N.T.S.




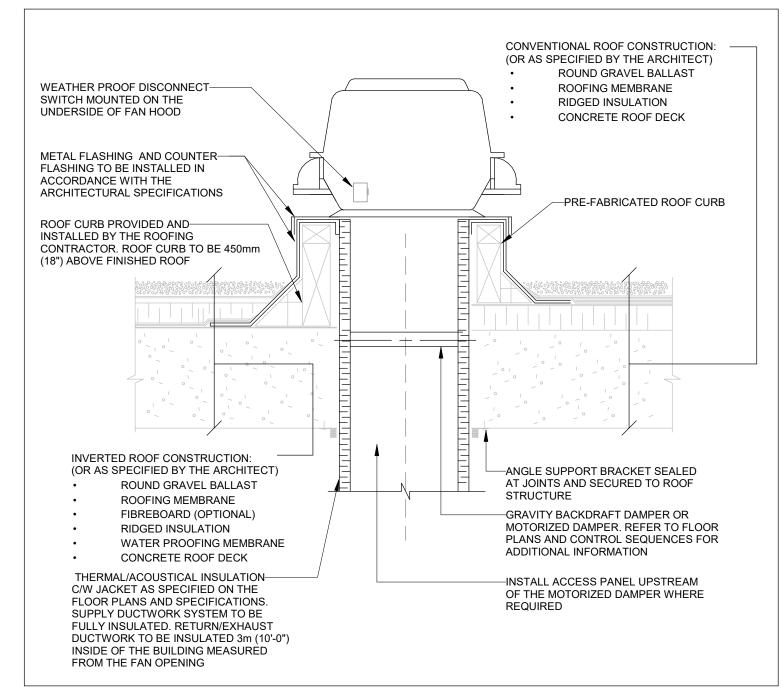

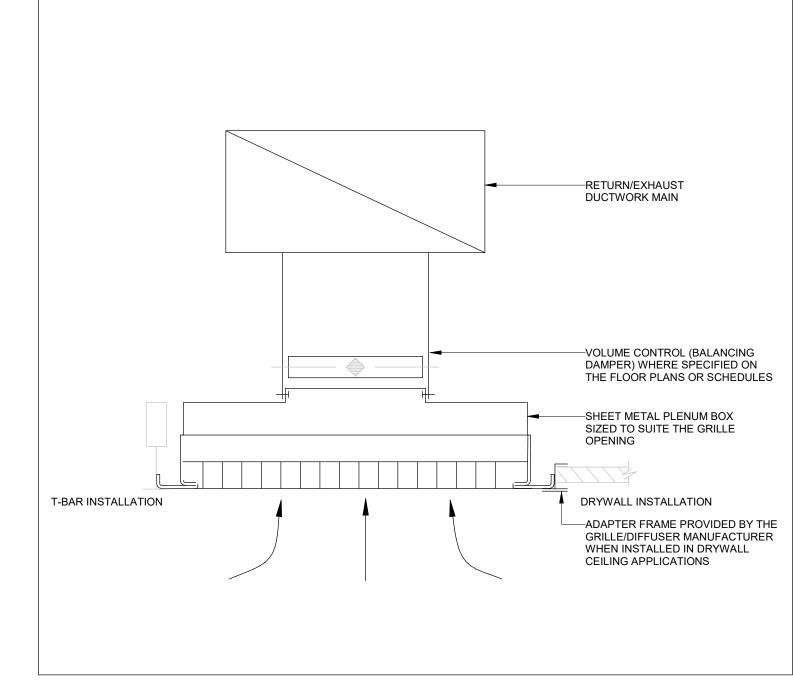


23 51 00.01 FLUE ROOF PENETRATION & FLUE VENT CAP SCALE:N.T.S.

23 34 06.01 ROOF MOUNTED EXHAUST FAN

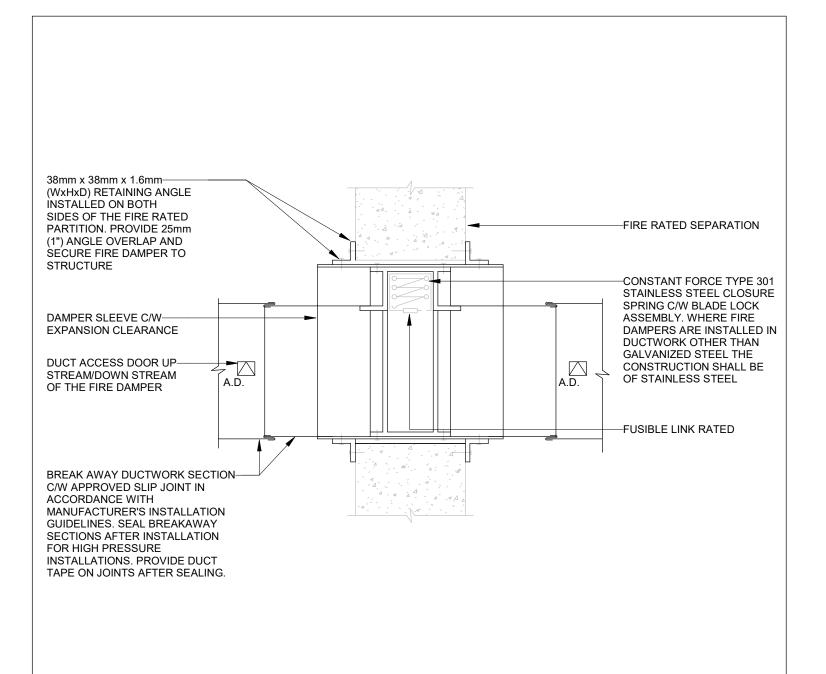

23 30 29.01 FUSIBLE LINK DAMPER SCALE:N.T.S.

23 30 42.02 CEILING MOUNTED GRILLE

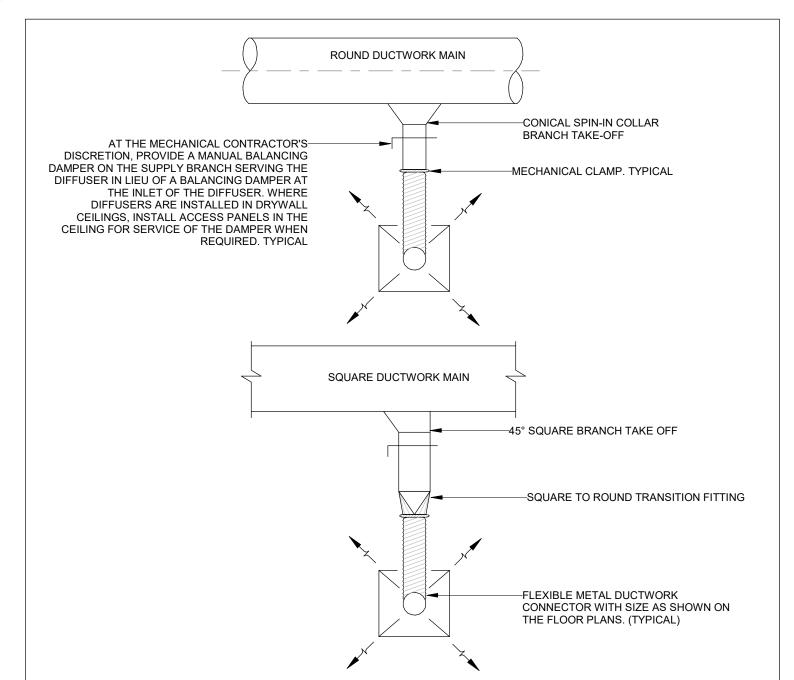

23 30 09.02 FLEXIBLE METALLIC DUCTWORK CONNECTION Scale

H ISSUED FOR TENDER 2021-08-12 G ISSUED FOR BUILDING PERMIT 2021-05-03 2021-02-12 BUILDING PERMIT 2021-02-05 B PERMIT/SPA COORDINATION 2021-02-02 A 100% DESIGN DEVELOPMENT 2021-01-19 100156459 The specifications are to be considered as an integral part of these drawings and neither the drawings nor the specifications shall be used alone. Refer to architectural drawings for dimensions. Do not © Copyright Reserved: These drawings and all that is represented herein are the exclusive property of Quasar Consulting Group. They may not be used or reproduced without written permission from Quasar Consulting Group.

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(SPA-2021-0032)

27 Rutherford Rd. S., Brampton, ON, L6W 3J3

City of Brampton Fire & Emergency Services

Drawing Title MECHANICAL DETAILS V

> Project No Drawing No 2021-08-12 N.T.S.

23 30 42.01 CEILING MOUNTED DIFFUSER

FLEXIBLE METALIC DUCTWORK—

MANUFACTURER SUPPLIED-

AIRFLOW EQUALIZER PLATE


WHERE SPECIFIED ON THE

FLOOR PLANS OR SCHEDULES

T-BAR INSTALLATION

ON THE FLOOR PLANS

CONNECTOR WITH SIZE AS SHOWN

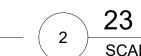

---VOLUME CONTROL (BALANCING DAMPER)

WHERE SPECIFIED ON

THE FLOOR PLANS OF


DRYWALL INSTALLATION


—ADAPTER FRAME PROVIDED

BY THE GRILLE/DIFFUSER

MANUFACTURER WHEN

INSTALLED IN DRYWALL **CEILING APPLICATIONS**

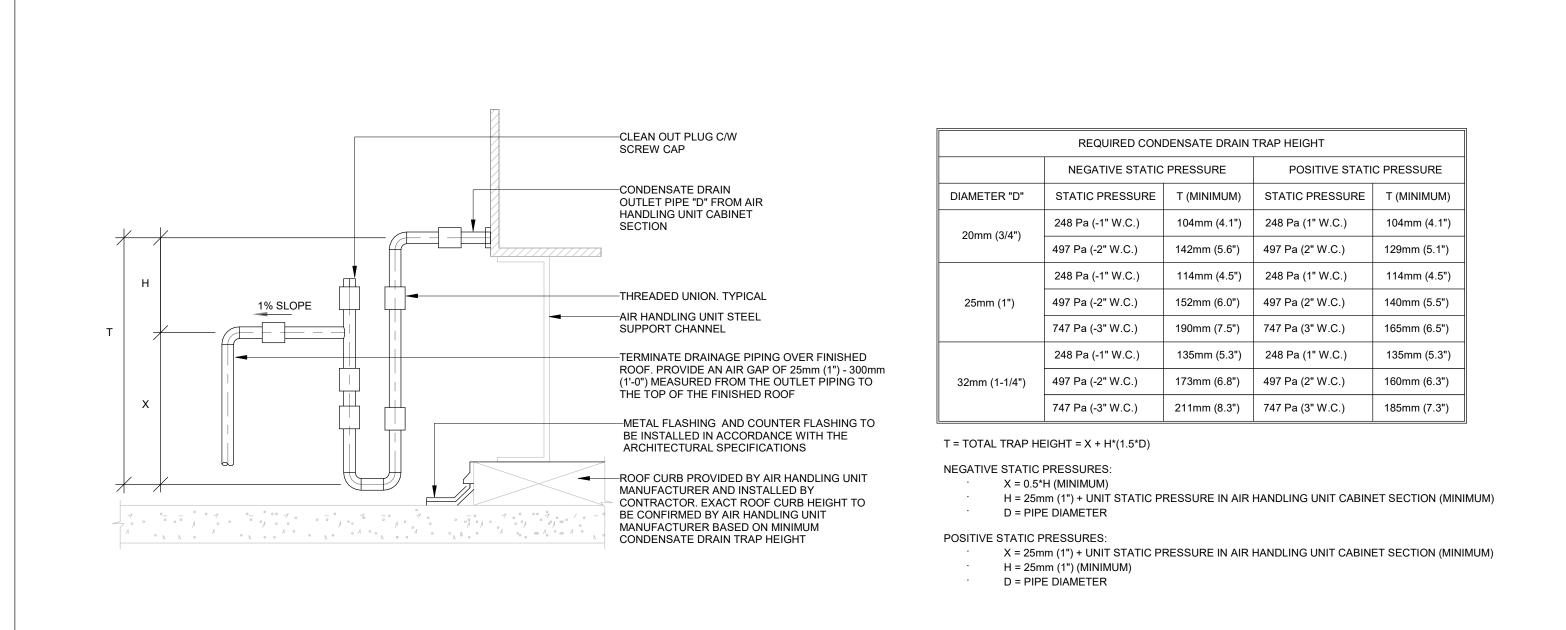

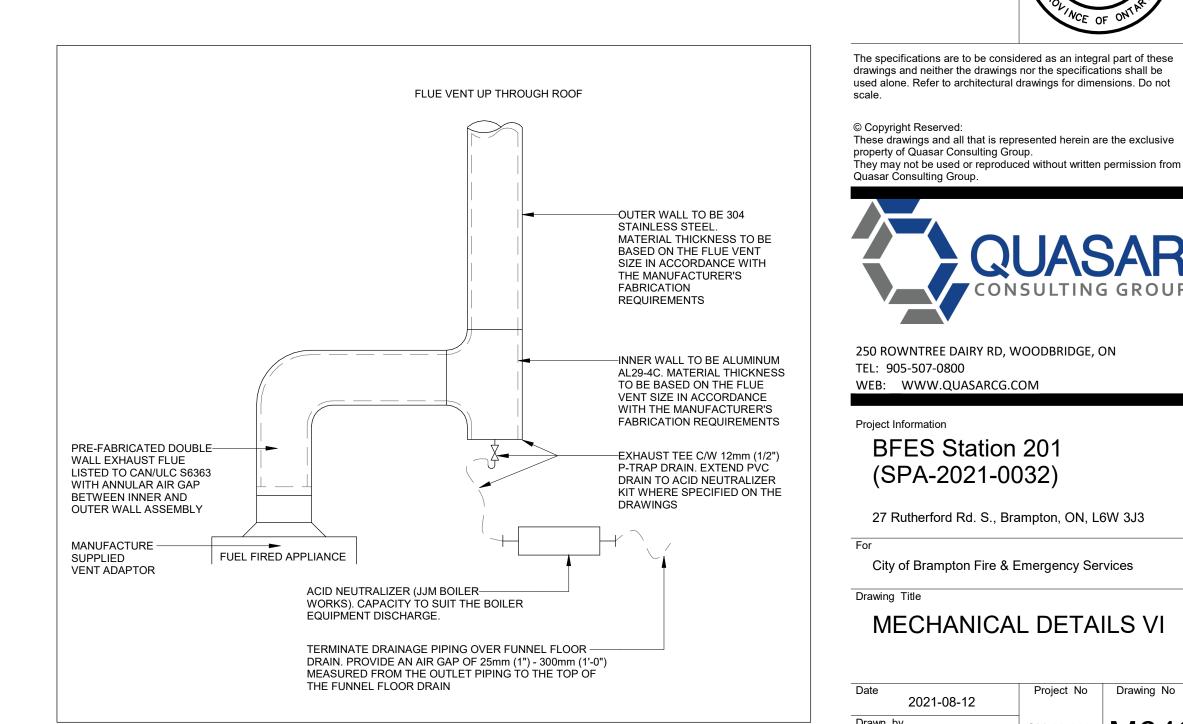

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23 51 04.01 EXHAUST FLUE VENT - CATEGORY III AND IV1 SCALE:N.T.S.

City of Brampton Fire & Emergency Services Drawing Title MECHANICAL DETAILS VI Project No Drawing No 2021-08-12 N.T.S.

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2021-08-12

2021-05-03 2021-02-12

2021-02-05 2021-02-05

2021-02-02 2021-01-19

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A 100% DESIGN DEVELOPMENT

SCALE:N.T.S.

23 72 00.01 CONENSATE DRAIN TRAP HEIGHT - OUTDOOR AIR HANDLING UNIT

DESCRIPTION OF OPERATION:

BREAKER PANEL

BREAKER 1PH

120 V

15 A

BREAKER 1PH

115 V

MCA: 7.9 A

MOCP: 15 A

120V 1 Phase w/ control for 1 Exhaust Fan, Exhaust on in Fire, Lights out in Fire.

CONTROL POWER. DO NOT WIRE

CONTROL POWER. SWITCH #1

1ST HOOD LIGHT BREAKER SHARED W/

TO GFCI OR SHUNT TRIP

BREAKER.

EXH-1

BREAKER PANEL TO PRIMARY CONTROL PANEL

Responsibility: Electrician

BREAKER SIZE SHOWN IS THE MAXIMUM ALLOWED

CONTROL PANEL TO FANS


Responsibility: Electrician


Ground


) GND (


) FN1 (

GND (

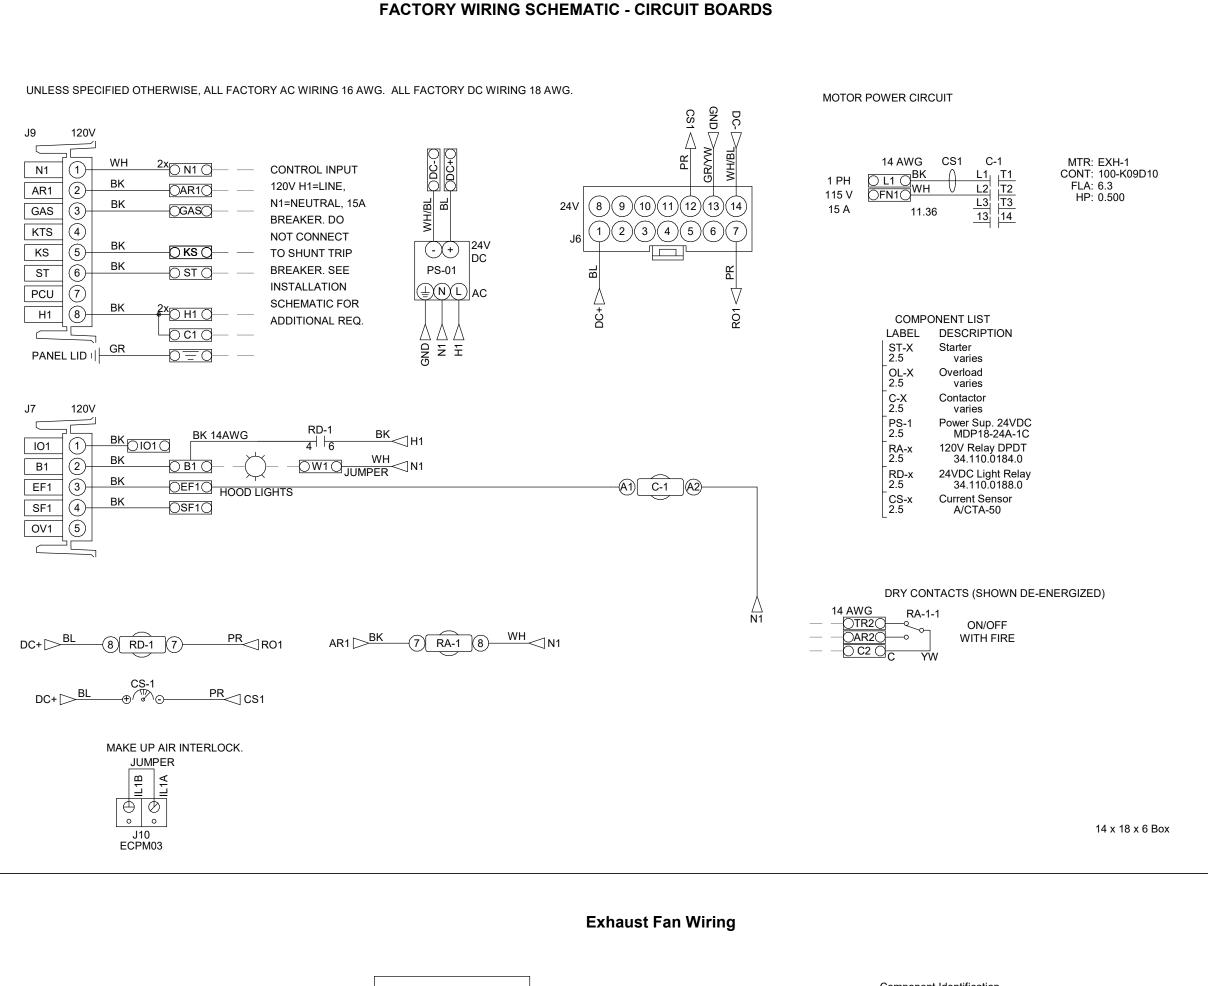

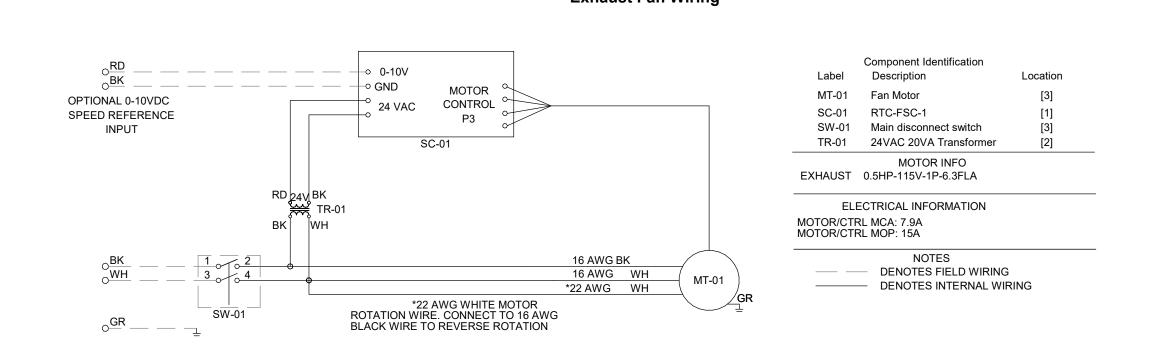

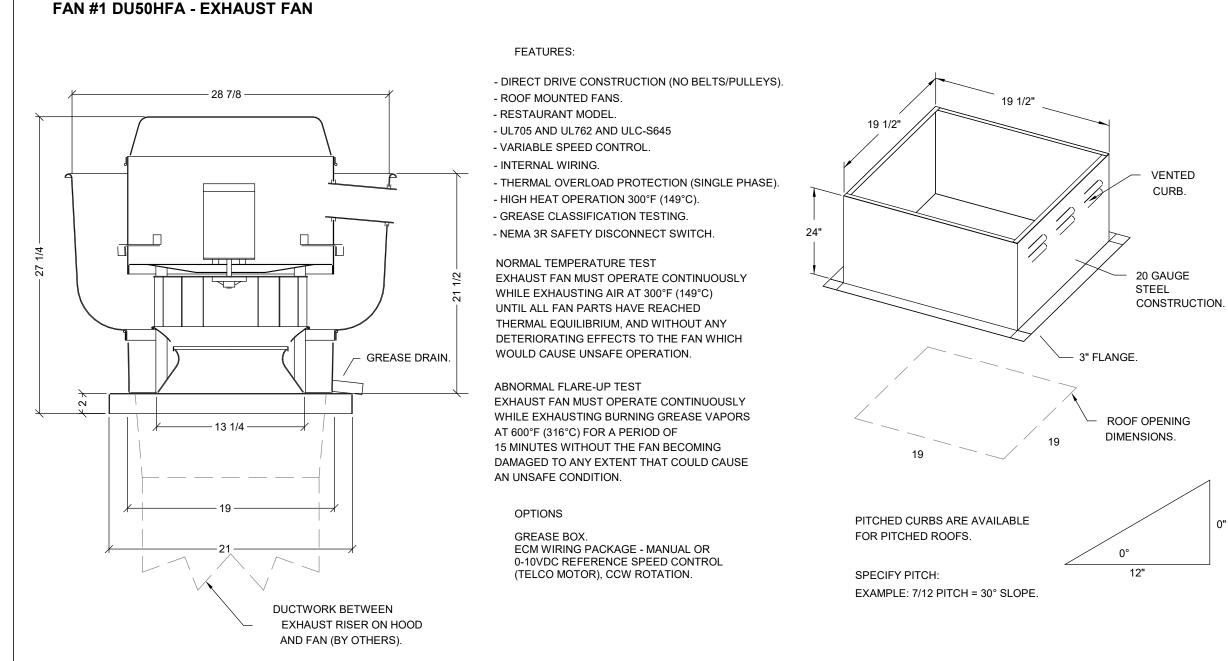

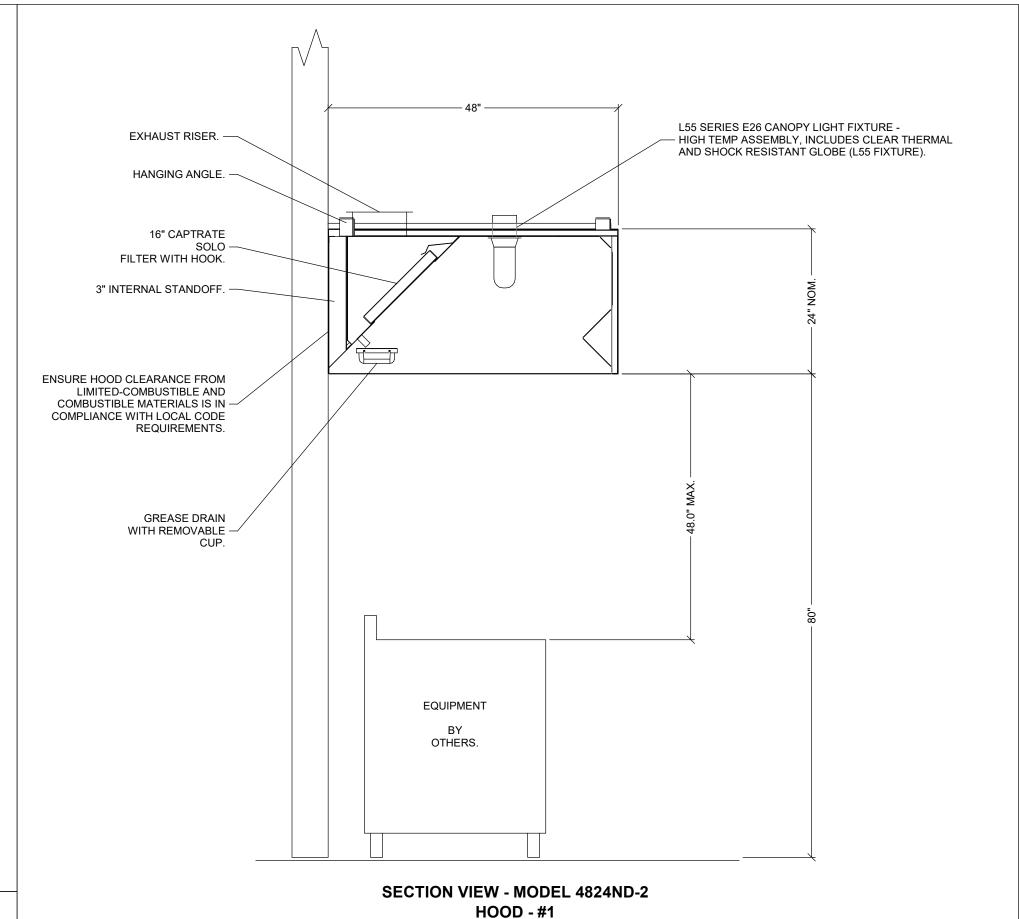

U.L. LISTED L55 SERIES E26 CANOPY

-4' 0"NOM./4' 0.00"OD.


PLAN VIEW - HOOD #1

4' 0.00" LONG 4824ND-2

UTILITY

CABINET

FIXTURE - HIGH TEMP ASSEMBLY

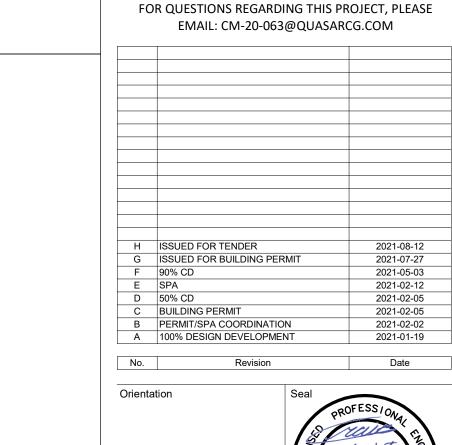

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Project Information BFES Station 201


(SPA-2021-0032)

27 Rutherford Rd. S., Brampton, ON, L6W 3J3

City of Brampton Fire & Emergency Services MECHANICAL DETAILS VII

Project No Drawing No 2021-08-12 CM-20-063 CMW

N.T.S.

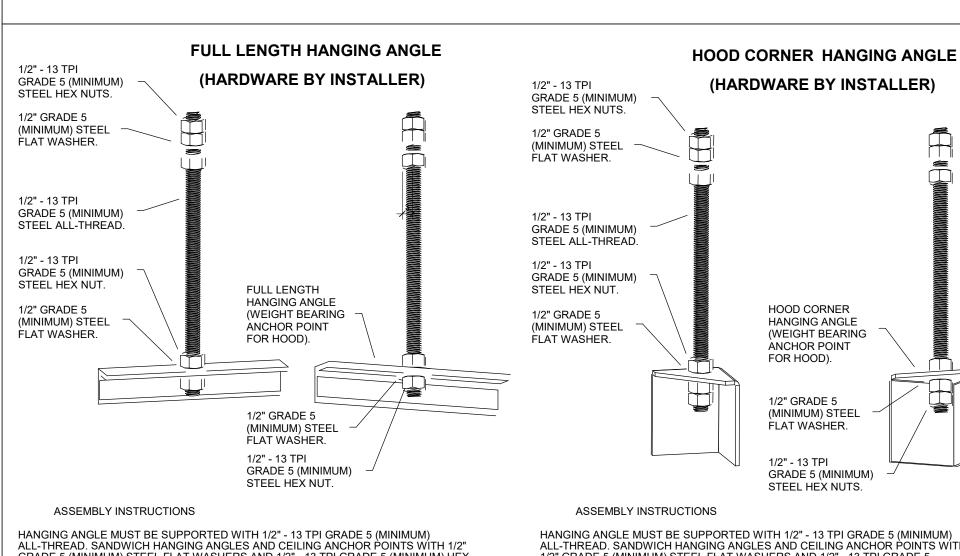

HANGING ANGLE MUST BE SUPPORTED WITH 1/2" - 13 TPI GRADE 5 (MINIMUM) ALL-THREAD. SANDWICH HANGING ANGLES AND CEILING ANCHOR POINTS WITH 1/2" GRADE 5 (MINIMUM) STEEL FLAT WASHERS AND 1/2" - 13 TPI GRADE 5 (MINIMUM) HEX NUTS AS SHOWN. MUST USE DOUBLED HEX NUT CONFIGURATION ABOVE CEILING ANCHORS. SINGLE HEX NUT BENEATH HANGING ANGLE IS ACCEPTABLE FOR FULL LENGTH HANGING ANGLES. MAINTAIN 1/4" OF EXPOSED THREADS BENEATH BOTTOM HEX NUT. TORQUE ALL HEX NUTS TO 57 FT-LBS.

HANGING ANGLE MUST BE SUPPORTED WITH 1/2" - 13 TPI GRADE 5 (MINIMUM) ALL-THREAD. SANDWICH HANGING ANGLES AND CEILING ANCHOR POINTS WITH 1/2" GRADE 5 (MINIMUM) STEEL FLAT WASHERS AND 1/2" - 13 TPI GRADE 5 MINIMUM) HEX NUTS AS SHOWN. MUST USE DOUBLED HEX NUT CONFIGURATION ÈENEATH HOOD HANGING ANGLES AND ABOVE CEILING ANCHORS. MAINTAIN 1/4" OF EXPOSED THREADS BENEATH BOTTOM HEX NUT. TORQUE ALL HEX NUTS TO 57

HOOD CORNER

ANCHOR POINT

1/2" GRADE 5

FLAT WASHER.

1/2" - 13 TPI

(MINIMUM) STEEL

GRADE 5 (MINIMUM)


STEEL HEX NUTS.


FOR HOOD).


HANGING ANGLE


(WEIGHT BEARING


BMS SWITCH

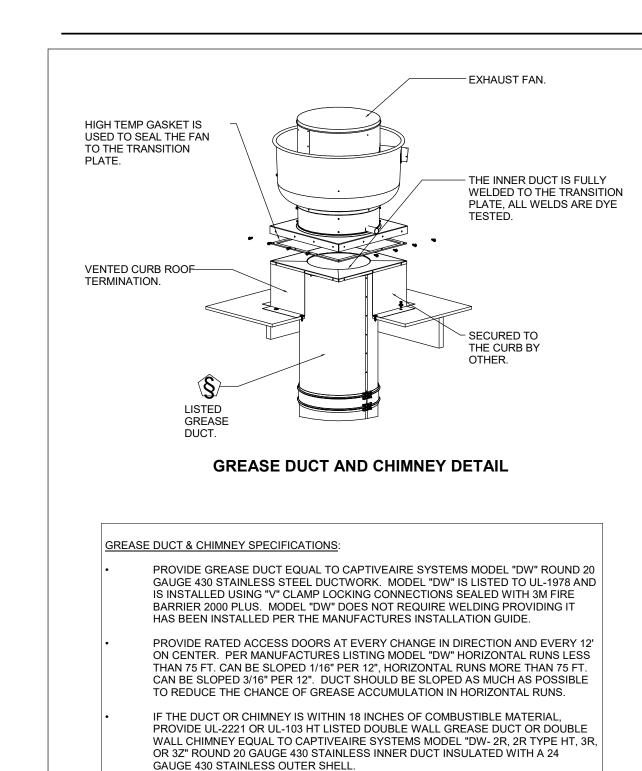


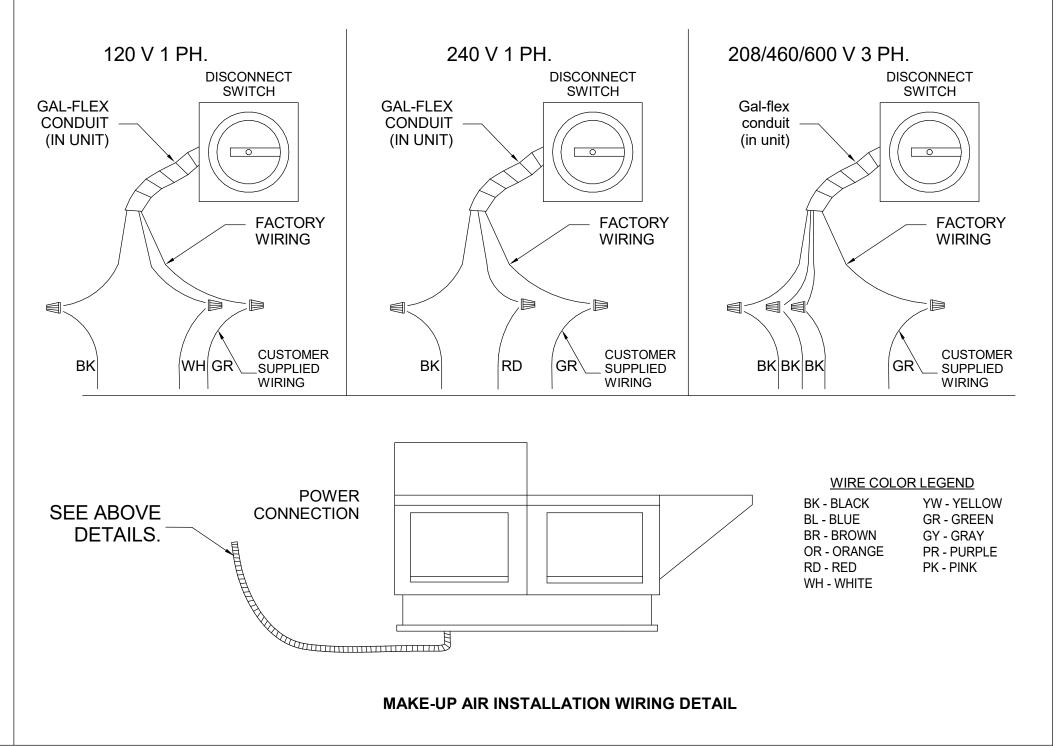

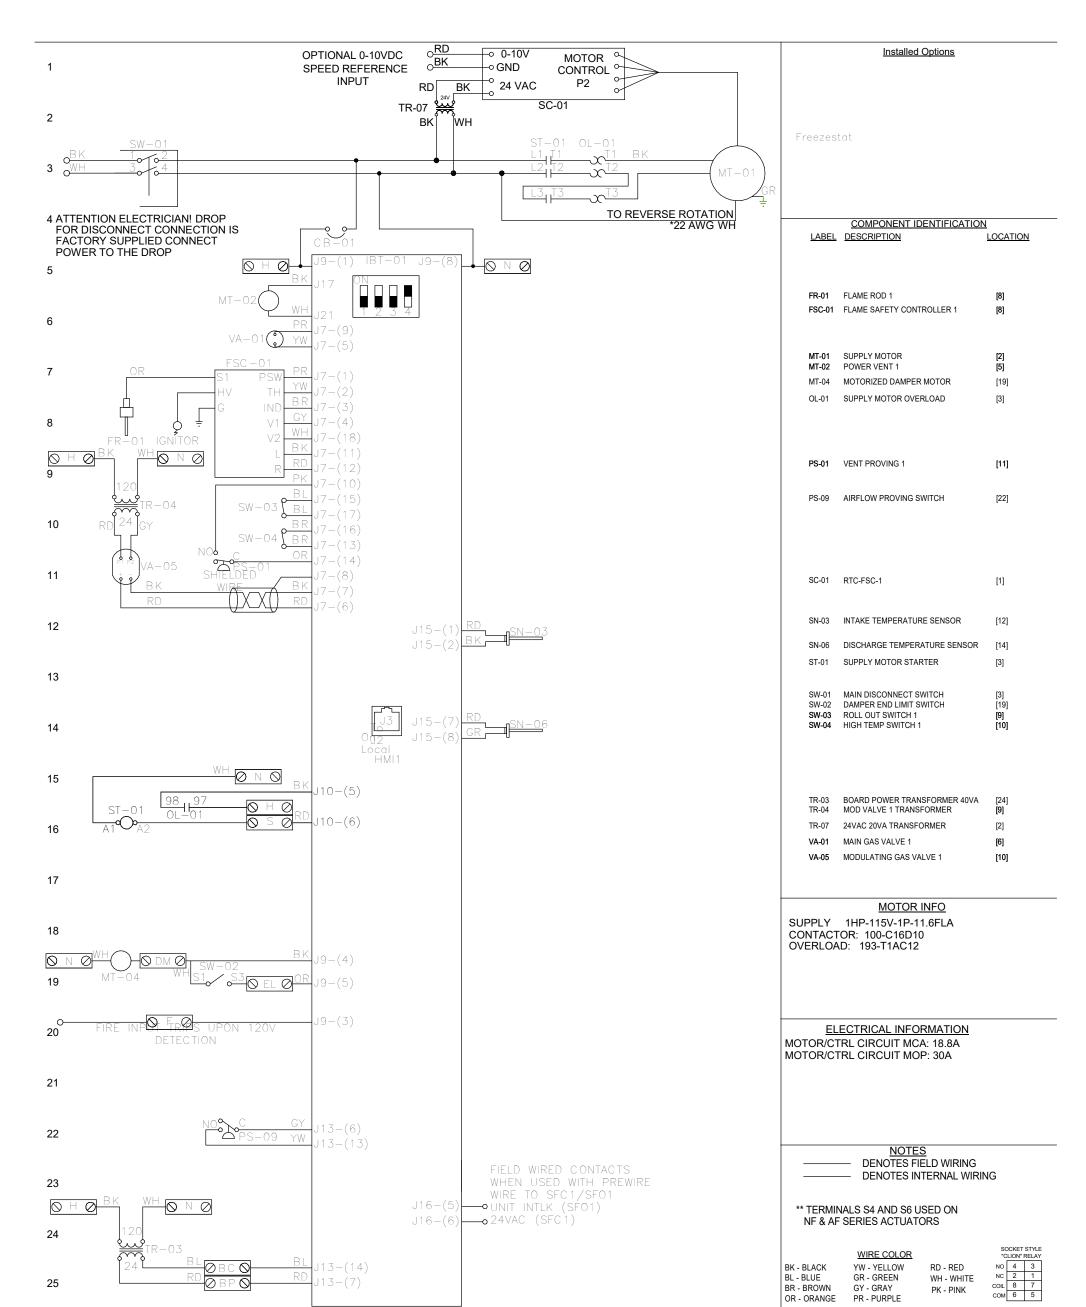

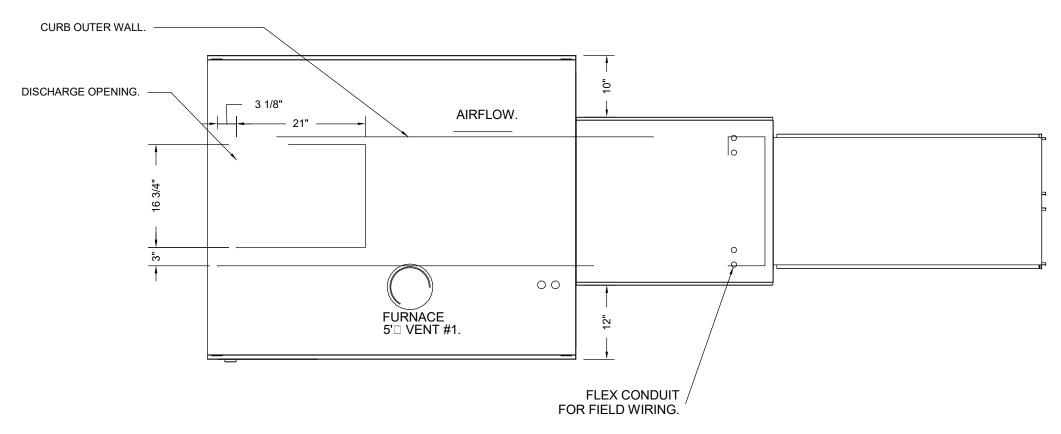

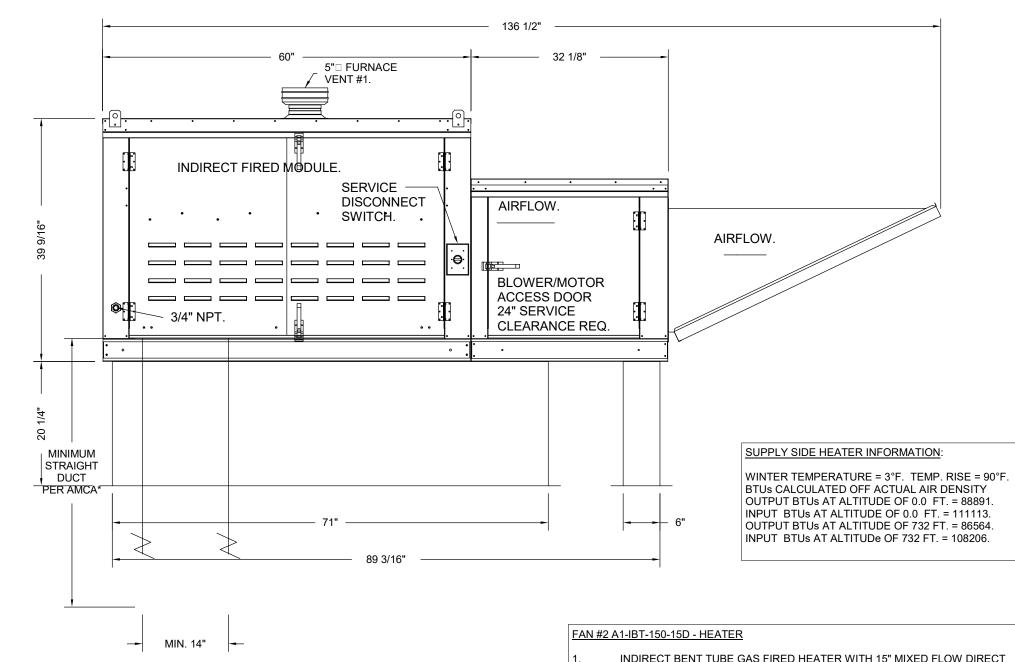

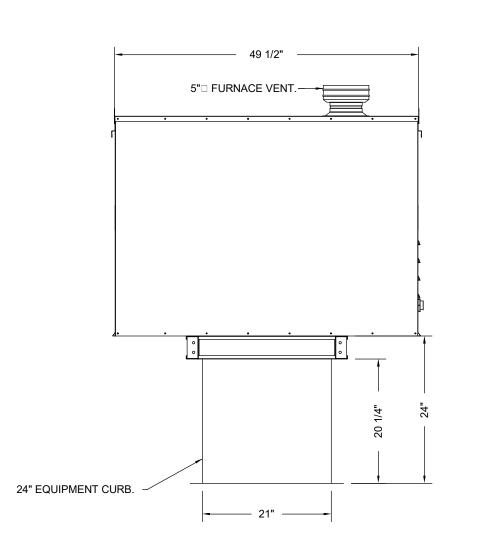

MAKE-UP AIR UNIT DETAIL


- INDIRECT BENT TUBE GAS FIRED HEATER WITH 15" MIXED FLOW DIRECT DRIVE FAN, 1 FURNACE, ELECTRONIC FULL MODULATION, CONSTANT 80% EFFICIENCY, AND 6:1 MAX TURNDOWN FOR NG, (5:1 MAX TURNDOWN FOR
- LP). STAINLESS STEEL BURNER AND HEAT EXCHANGER. INTAKE HOOD WITH EZ FILTERS
- DOWN DISCHARGE AIR FLOW RIGHT -> LEFT.
- GAS PRESSURE GAUGE, 0-35", 2.5" DIAMETER, 1/4" THREAD SIZE.
- GAS PRESSURE GAUGE, 0 TO +10 INCHES WC., 2.5" DIAMETER, 1/8" THREAD
- MOTORIZED BACK DRAFT DAMPER 16" X 18" FOR SIZE 1 STANDARD & MODULAR HEATER UNITS W/EXTENDED SHAFT, STANDARD GALVANIZED CONSTRUCTION, 3/4" REAR FLANGE, LOW LEAKAGE, TFB120S ACTUATOR
- ECM WIRING PACKAGE AND MANUAL OR 0-10VDC CONTROL FOR SUPPLY EC MOTORS. RTC CONTROLLER. **DO NOT ORDER UNDER WARRANTY, SEE PART NUMBER "ECM-VCU-RTC"**.
- FREEZESTAT FACTORY SET AT 35°F AND 10 MINUTES.
- 9. HINGED DOUBLE WALL INSULATED DOOR ASSEMBLY (BURNER/BLOWER
- 2 YEAR ENTIRE UNIT PARTS WARRANTY, 25 YEAR STAINLESS STEEL FURNACE PARTS WARRANTY. IBT - US PATENT 877119 B2.

*NOTE: SUPPLY DUCT MUST BE INSTALLED TO MEET SMACNA STANDARDS. A MINIMUM STRAIGHT DUCT LENGTH MUST BE MAINTAINED DOWNSTREAM OF UNIT DISCHARGE AS OUTLINED IN AMCA PUBLICATION 201. WHEN USING RECTANGULAR DUCTWORK, ELBOWS MUST BE RADIUS THROAT, RADIUS BACK WITH TURNING VANES. FLEXIBLE DUCTWORK AND SQUARE THROAT/SQUARE BACK ELBOWS SHOULD NOT BE USED. ANY TRANSITION AND/OR TURNS IN THE DUCTWORK WILL CAUSE SYSTEM EFFECT. SYSTEM EFFECT WILL DRASTICALLY INCREASE STATIC PRESSURE AND REDUCE AIRFLOW. DO NOT RELY ON UNIT TO SUPPORT DUCT IN ANY WAY. FAILURE TO PROPERLY SIZE DUCTWORK MAY CAUSE SYSTEM EFFECTS AND REDUCE PERFORMANCE OF THE EQUIPMENT.

SUGGESTED STRAIGHT DUCT SIZE IS 14" x 14".

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В	ISSUED FOR TENDER	2021-08-1
Α	ISSUED FOR BUILDING PERMIT	2021-07-2
No.	Revision	Date

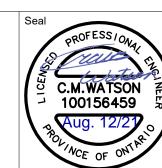

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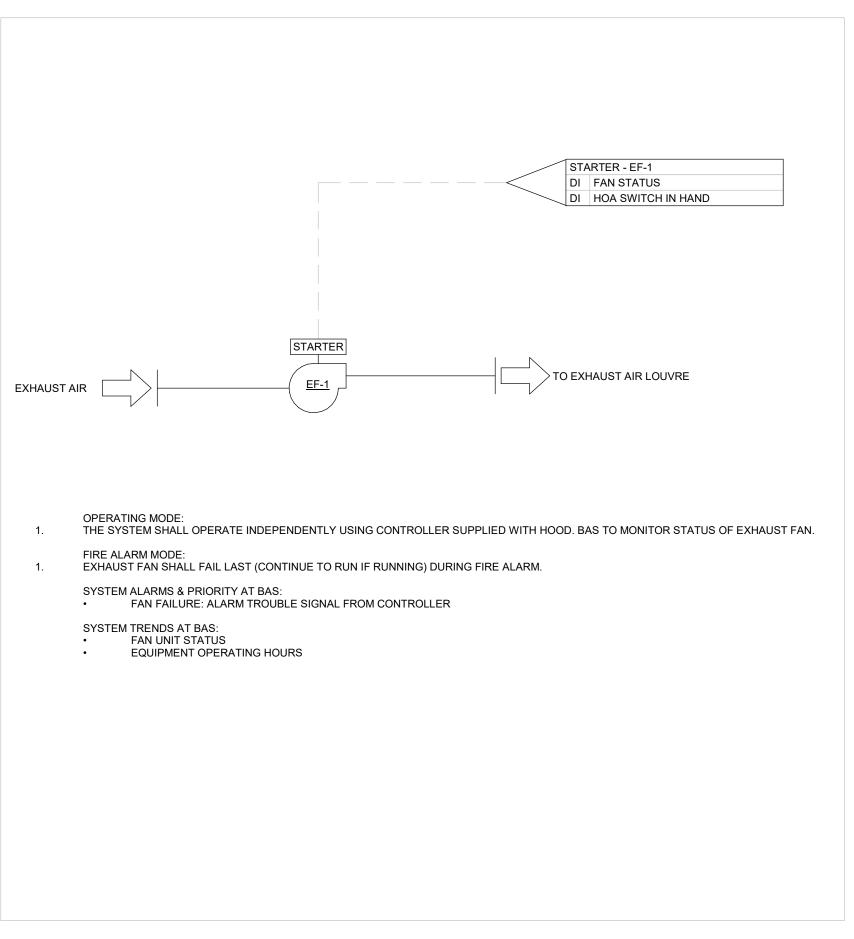
City of Brampton Fire & Emergency Services

MECHANICAL DETAILS VIII


Project No Drawing No 2021-08-12

INDIRECT FIRED BENT TUBE HTR WIRING DETAIL

Scale N.T.S.





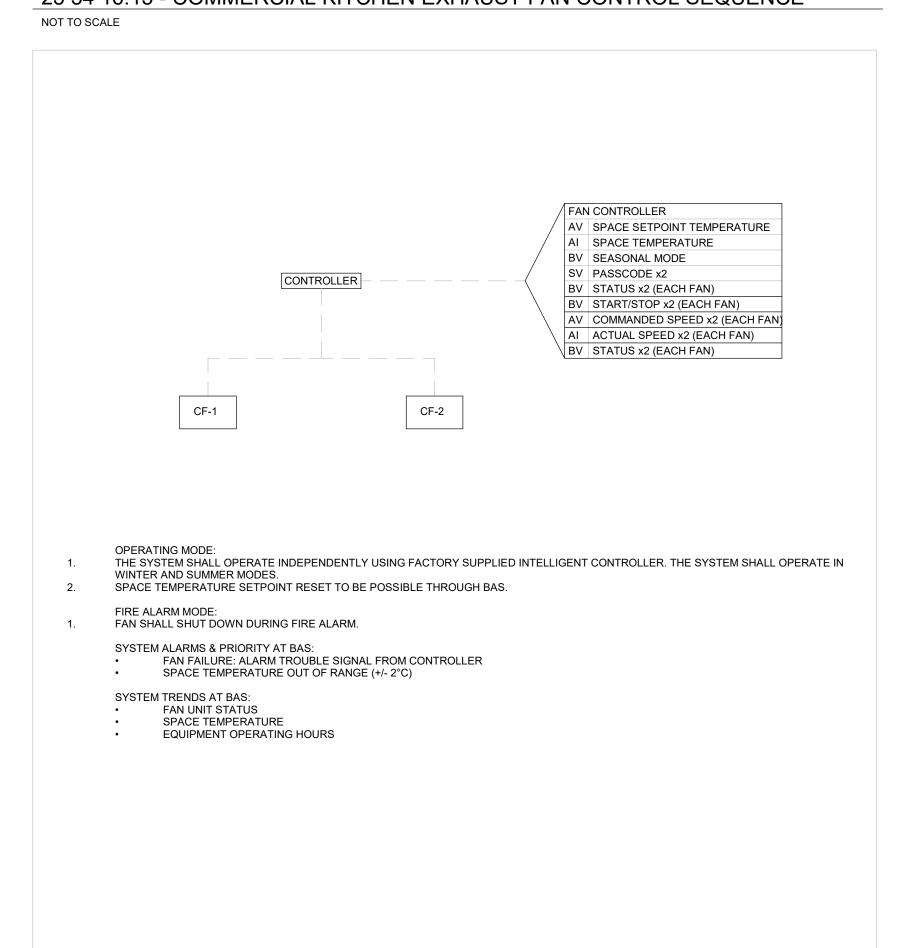


23 34 02.01 - CEILING MOUNTED DESTRATIFICATION FAN CONTROL SEQUENCE

NOT TO SCALE


RTU CONTROLLER BV STATUS BV START/STOP AV R/A TEMPERATURE CONTROLLER AV S/A TEMPERATURE AV R/A HUMIDITY AV ROTATION SENSOR AV DIRTY FILTER SENSOR THE SYSTEM SHALL BE ENABLED ACCORDING TO THE FOLLOWING MODE: SCHEDULED RUN TIME MODE INITIAL SET UP: DOAS SHALL BE NORMALLY DISABLED. MOTORIZED DAMPERS SHALL BE NORMALLY CLOSED. FANS SHALL BE BALANCED TO A FIELD DETERMINED AIRFLOW & STATIC PRESSURE AS PER THE VALUES INDICATED ON THE DRAWINGS DURING SYSTEM P1 SHALL BE LOCATED APPROXIMATELY TWO-THIRDS DOWNSTREAM OF SUPPLY FAN. P2 SHALL BE LOCATED APPROXIMATELY TWO-THIRDS UPSTREAM OF EXHAUST FAN. FINAL LOCATION SHALL BE COORDINATED WITH THE BALANCING CONTRACTOR AND THE CONTROLS CONTRACTOR. VFD SPEED SHALL BE FIELD OPTIMIZED TO AVOID FAN (TORQUE AND CURRENT) STALL CONDITIONS AND SHALL NOT OPERATE BELOW 30% SPEED SYSTEM SHALL BE ENABLED BASED ON SCHEDULED RUN TIME AT VRV BAS. FAN SHALL BE ENABLED/DISABLED LOCALLY AT THE UNIT CONTROLLER/VFD OR REMOTELY THROUGH THE BAS. DOAS MODULE: THE DOAS OA AND EA FANS WILL RUN CONTINUOUSLY WHEN UNIT IS ENABLED. UNIT TO CONTROL PREHEAT TO PREVENT FROST. ENTHALPY WHEEL SHALL RUN WHEN SYSTEM IS ENABLED. FAN CONTROL:
ON COMMAND TO START MOTORIZED DAMPERS SHALL OPEN. UPON PROOF OF MOTORIZED DAMPER POSITION FAN SHALL BE ENABLED. MD1 SHALL BE
ON COMMAND TO START MOTORIZED DAMPERS SHALL OPEN. UPON PROOF OF MOTORIZED DAMPER POSITION FAN SHALL BE ENABLED. MD1 SHALL BE HARD WIRED INTERLOCKED WITH F1 TO ENSURE CONTROLS OPERATION WHEN FAN IS OPERATING IN "HAND" OR "AUTO" MODE. CONTROLS SIGNAL SHALL FANS SHALL MODULATE TO MAINTAIN THE STATIC PRESSURE SET POINT DETERMINED BY P1 AND P2. FIRE ALARM MODE: FAN SHALL <u>SHUT DOWN</u> DURING FIRE ALARM. FAN FAILURE: UPON FAN FAILURE, RESPECTIVE DAMPER SHALL REMAIN OPEN. SYSTEM ALARMS & PRIORITY AT BAS:

UNIT FAILURE: AS DETERMINED BY CONTROLLER UNIT FAULT STATIC PRESSURE **EQUIPMENT OPERATING HOURS**

23 72 00.01 - DEDICATED OUTDOOR AIR SUPPLY UNIT DOAS-1 CONTROL SEQUENCE NOT TO SCALE

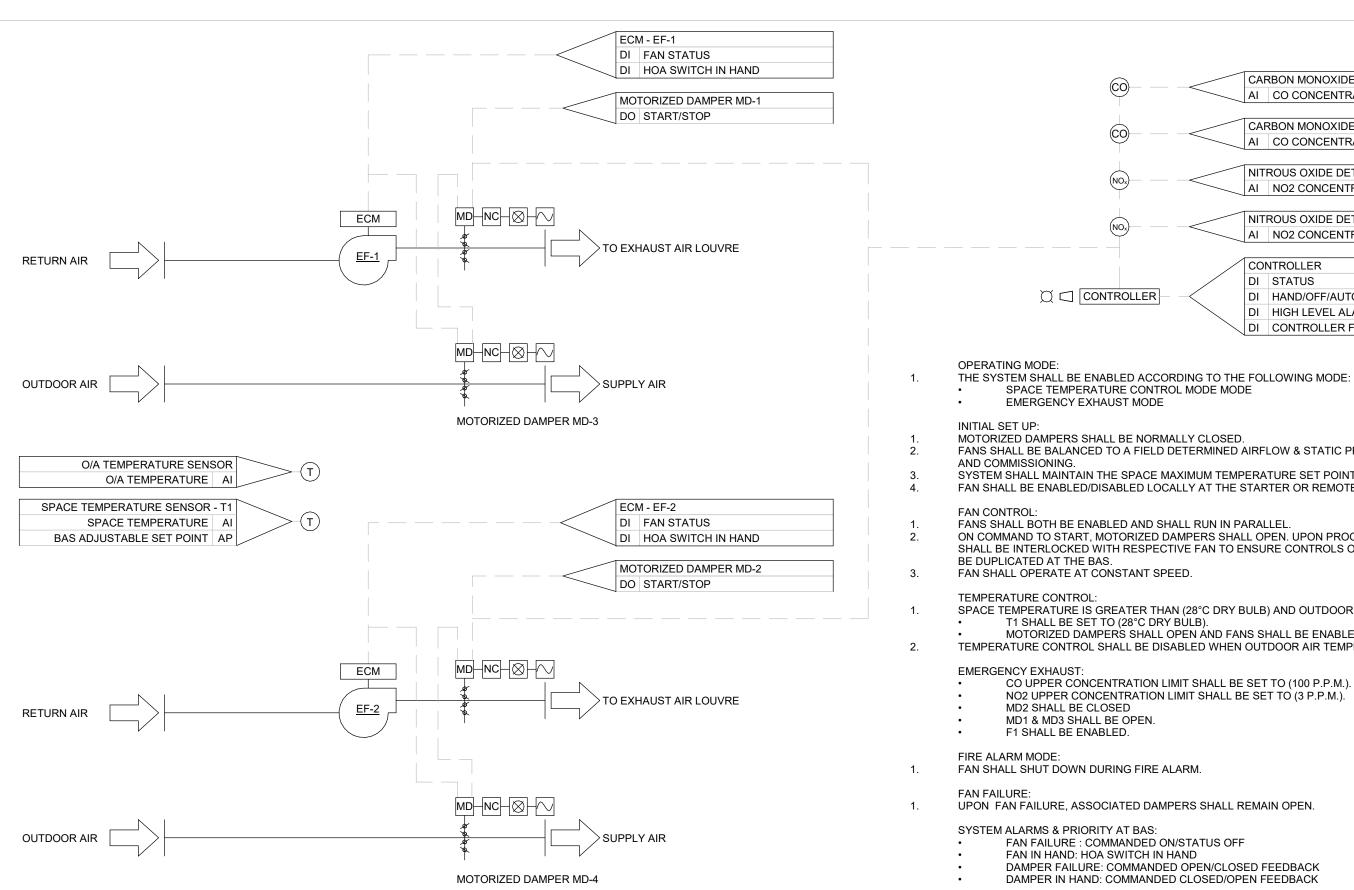

23 34 00.03 - APPARATUS BAY FAN CONTROL SEQUENCE NOT TO SCALE

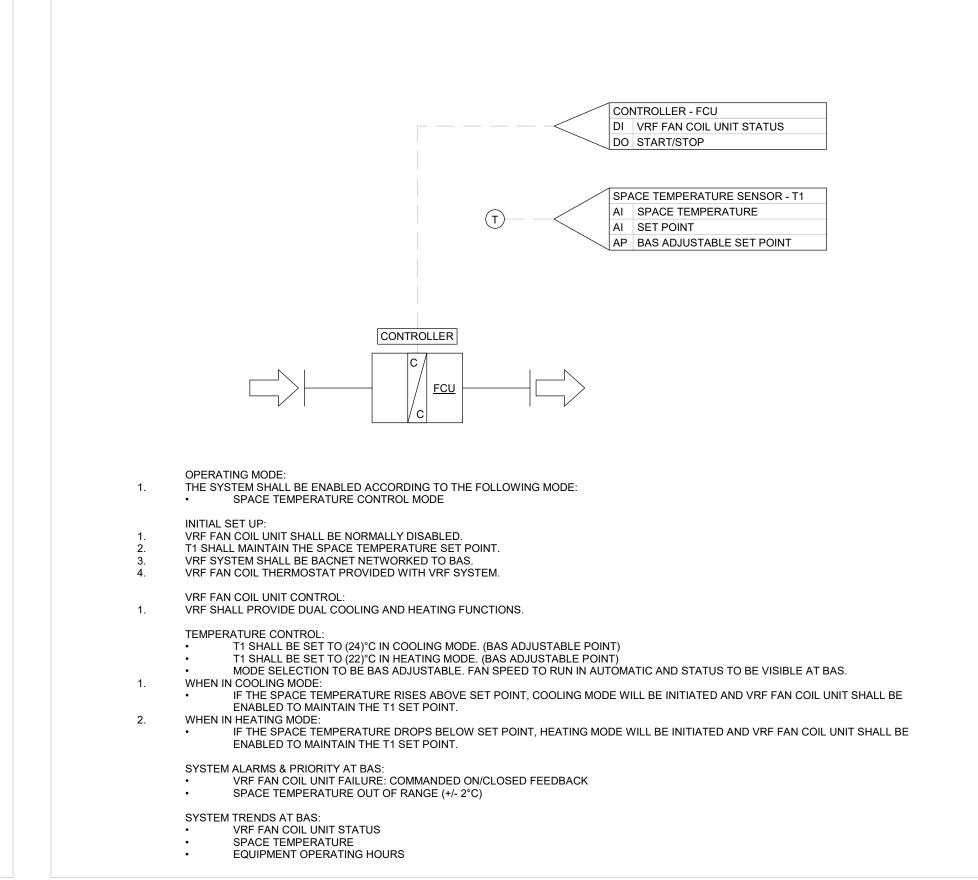

23 81 29.00 - VRF FAN COIL UNIT CONTROL SEQUENCE

CARBON MONOXIDE DETECTOR AI CO CONCENTRATION LEVEL CARBON MONOXIDE DETECTOR AI CO CONCENTRATION LEVEL NITROUS OXIDE DETECTOR AI NO2 CONCENTRATION LEVEL NITROUS OXIDE DETECTOR AI NO2 CONCENTRATION LEVEL

DI STATUS

CONTROLLER DI HAND/OFF/AUTO SWITCH DI HIGH LEVEL ALARM DI CONTROLLER FAULT ALARM

EMERGENCY EXHAUST MODE MOTORIZED DAMPERS SHALL BE NORMALLY CLOSED. FANS SHALL BE BALANCED TO A FIELD DETERMINED AIRFLOW & STATIC PRESSURE AS PER THE VALUES INDICATED ON THE DRAWINGS DURING SYSTEM BALANCING AND COMMISSIONING. SYSTEM SHALL MAINTAIN THE SPACE MAXIMUM TEMPERATURE SET POINT AND SHALL BE ENABLED DURING EMERGENCY EXHAUST OF CO AND NO2.

FAN SHALL BE ENABLED/DISABLED LOCALLY AT THE STARTER OR REMOTELY THROUGH THE BAS. FANS SHALL BOTH BE ENABLED AND SHALL RUN IN PARALLEL. ON COMMAND TO START, MOTORIZED DAMPERS SHALL OPEN. UPON PROOF OF MOTORIZED DAMPER POSITION, RESPECTIVE FAN SHALL BE ENABLED. MD2 AND MD4 SHALL BE INTERLOCKED WITH RESPECTIVE FAN TO ENSURE CONTROLS OPERATION WHEN FAN IS OPERATING IN "HAND" OR "AUTO" MODE. CONTROLS SIGNAL SHALL

SPACE TEMPERATURE IS GREATER THAN (28°C DRY BULB) AND OUTDOOR AIR TEMPERATURE IS LESS THAN (SPACE TEMPERATURE MINUS 2°C). T1 SHALL BE SET TO (28°C DRY BULB). MOTORIZED DAMPERS SHALL OPEN AND FANS SHALL BE ENABLED.

TEMPERATURE CONTROL SHALL BE DISABLED WHEN OUTDOOR AIR TEMPERATURE IS LESS THAN 24°C.

EMERGENCY EXHAUST: CO UPPER CONCENTRATION LIMIT SHALL BE SET TO (100 P.P.M.). NO2 UPPER CONCENTRATION LIMIT SHALL BE SET TO (3 P.P.M.). MD2 SHALL BE CLOSED

F1 SHALL BE ENABLED. FAN SHALL SHUT DOWN DURING FIRE ALARM.

NOT TO SCALE

UPON FAN FAILURE, ASSOCIATED DAMPERS SHALL REMAIN OPEN.

SYSTEM ALARMS & PRIORITY AT BAS: FAN FAILURE : COMMANDED ON/STATUS OFF

FAN IN HAND: HOA SWITCH IN HAND


DAMPER FAILURE: COMMANDED OPEN/CLOSED FEEDBACK DAMPER IN HAND: COMMANDED CLOSED/OPEN FEEDBACK

FOR QUESTIONS REGARDING THIS PROJECT, PLEASE

EMAIL: CM-20-063@QUASARCG.COM

Н	ISSUED FOR TENDER	2021-08-12
G	ISSUED FOR BUILDING PERMIT	2021-07-27
F	90% CD	2021-05-03
Е	SPA	2021-02-12
D	50% CD	2021-02-05
С	BUILDING PERMIT	2021-02-05
В	PERMIT/SPA COORDINATION	2021-02-02
Α	100% DESIGN DEVELOPMENT	2021-01-19
No.	Revision	Date
	•	

Orientation

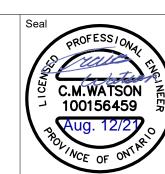

The specifications are to be considered as an integral part of these drawings and neither the drawings nor the specifications shall be used alone. Refer to architectural drawings for dimensions. Do not

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WEB: WWW.QUASARCG.COM

Project Information

BFES Station 201

(SPA-2021-0032)

27 Rutherford Rd. S., Brampton, ON, L6W 3J3


City of Brampton Fire & Emergency Services


Drawing Title


N.T.S.

CONTROL SEQUENCES I


Project No Drawing No 2021-08-12 Drawn by CMW Scale

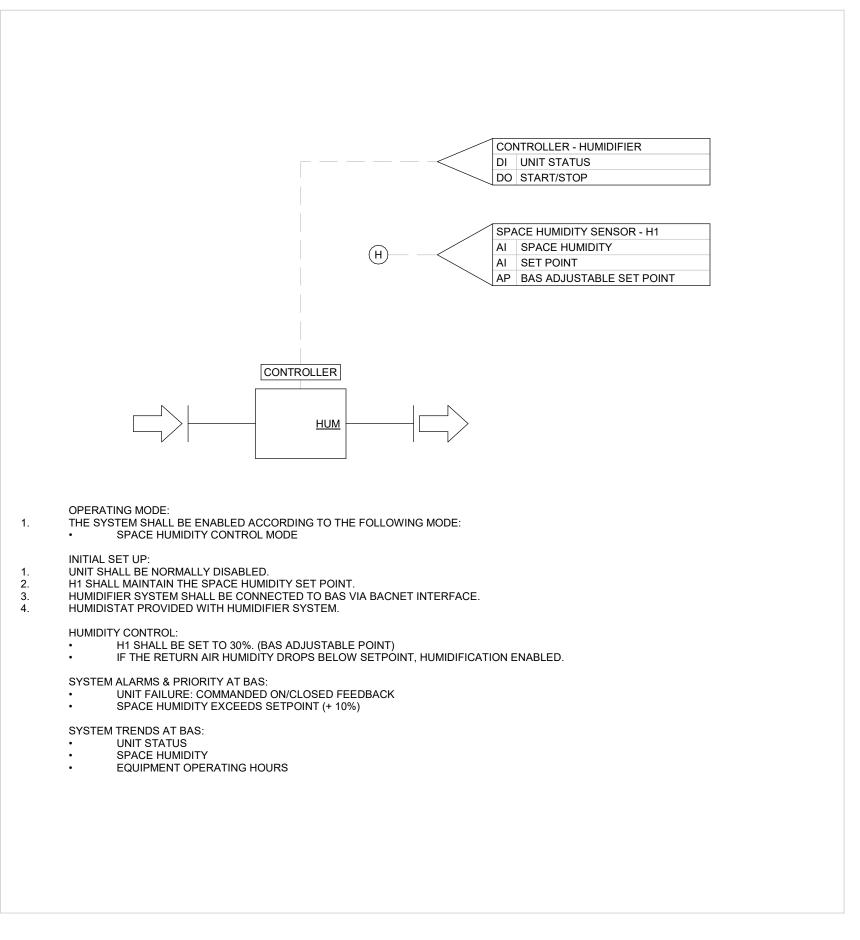

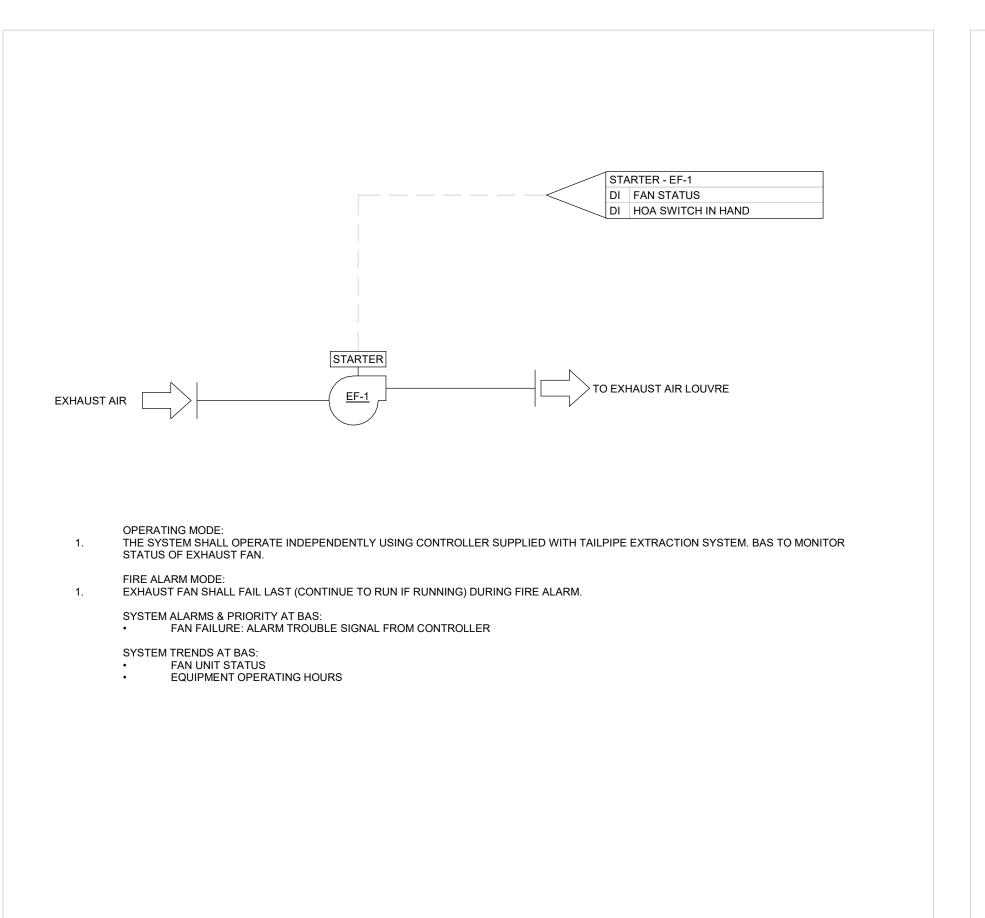

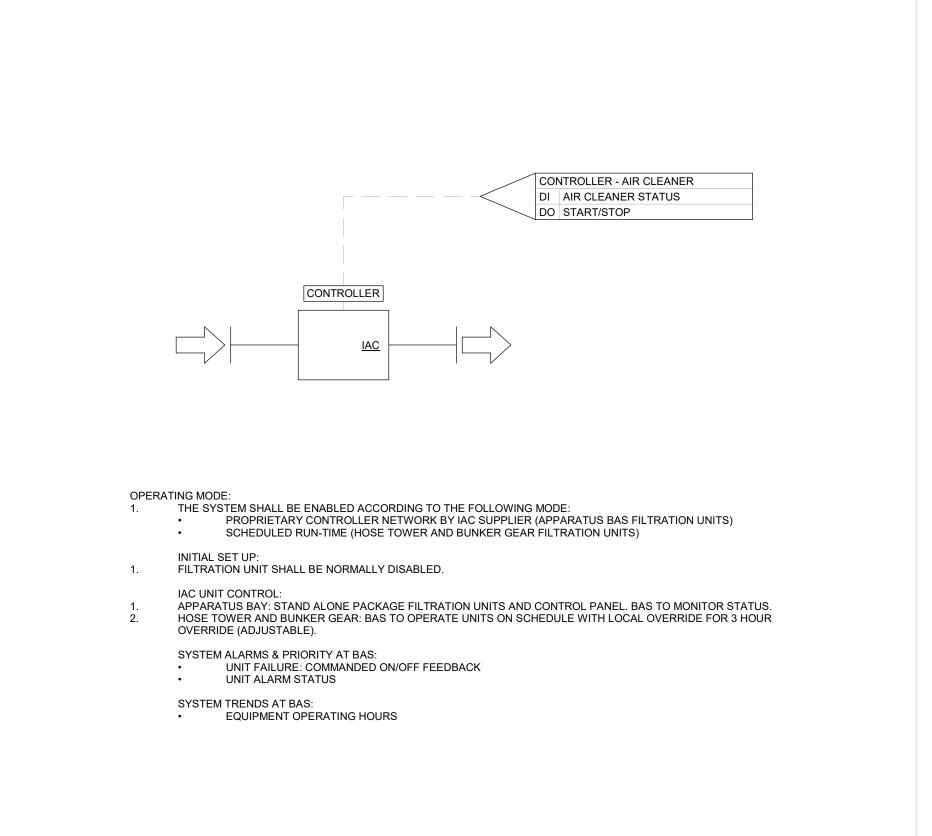



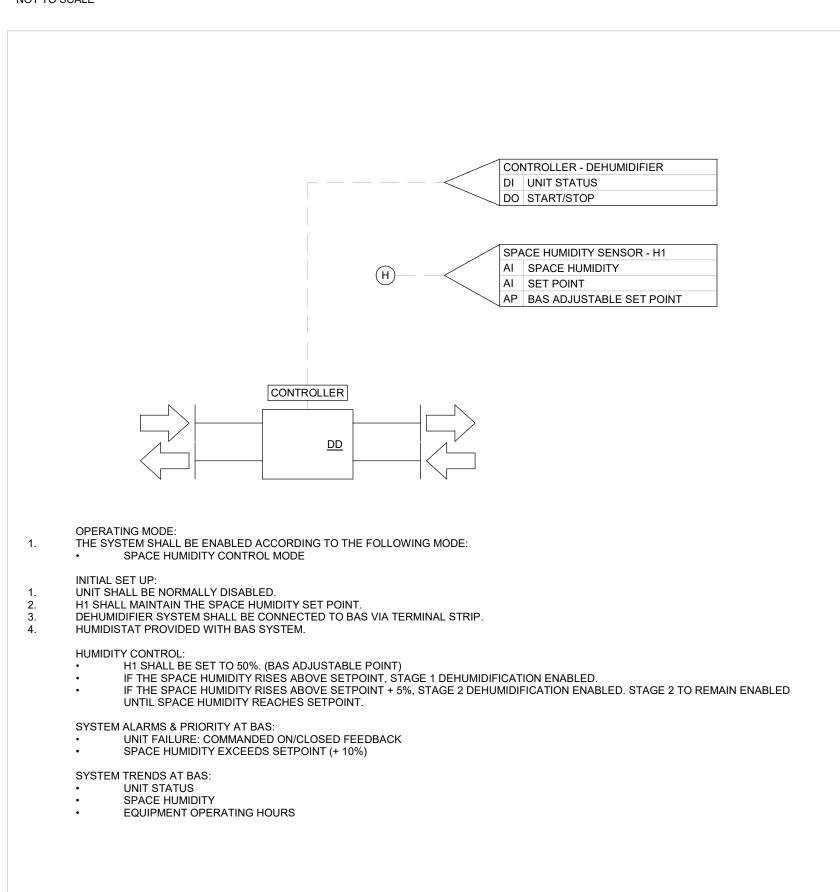

23 35 22.00 - STRAIGHT RAIL VEHICLE EXHAUST CONTROL SEQUENCE

PRESSURE SENSOR - P1 AV STATIC PRESSURE AP BAS ADJUSTABLE SET POINT GAS FIRED DX COOLING COIL CONDENSING UNIT HEATING COIL RTU CONTROLLER BV STATUS BV START/STOP CONTROLLER BV FILTER STATUS AV S/A TEMPERATURE AV R/A HUMIDITY

23 35 16.00 - INDOOR AIR CLEANER UNIT CONTROL SEQUENCE

OPERATING MODE: THE SYSTEM SHALL BE ENABLED ACCORDING TO THE FOLLOWING MODE:

HARDWIRED START SIGNAL FROM KITCHEN HOOD CONTROLLER. FOR QUESTIONS REGARDING THIS PROJECT, PLEASE EMAIL: CM-20-063@QUASARCG.COM

Α	ISSUED FOR TENDER	2021-08-12
No.	Revision	Date



100156459

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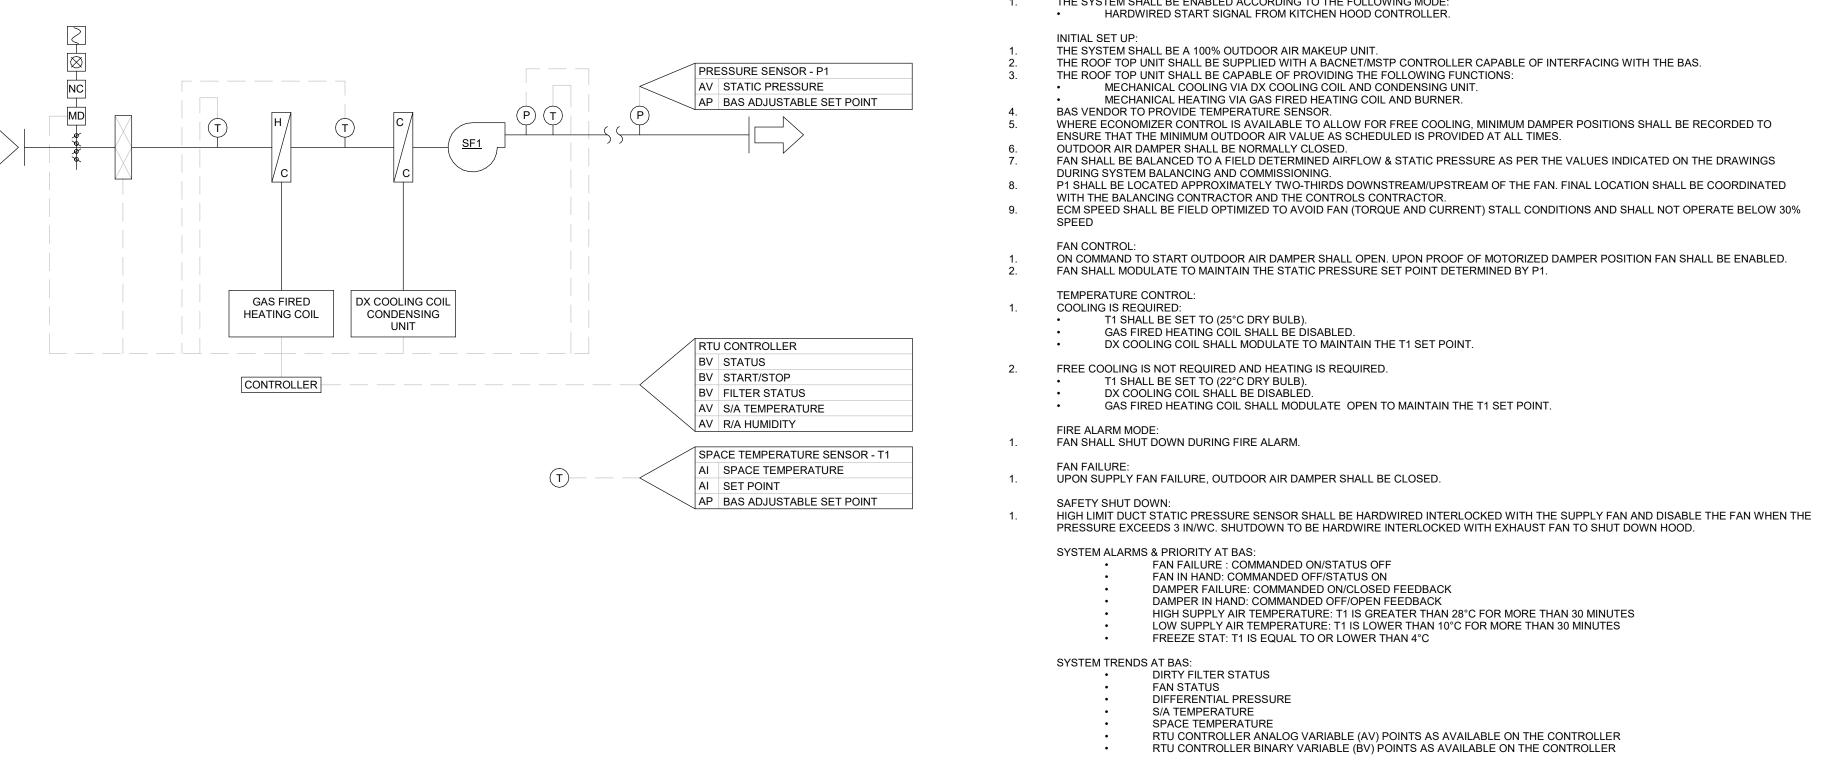
27 Rutherford Rd. S., Brampton, ON, L6W 3J3


City of Brampton Fire & Emergency Services


N.T.S.


CONTROL SEQUENCES II

2021-08-12 Author Scale



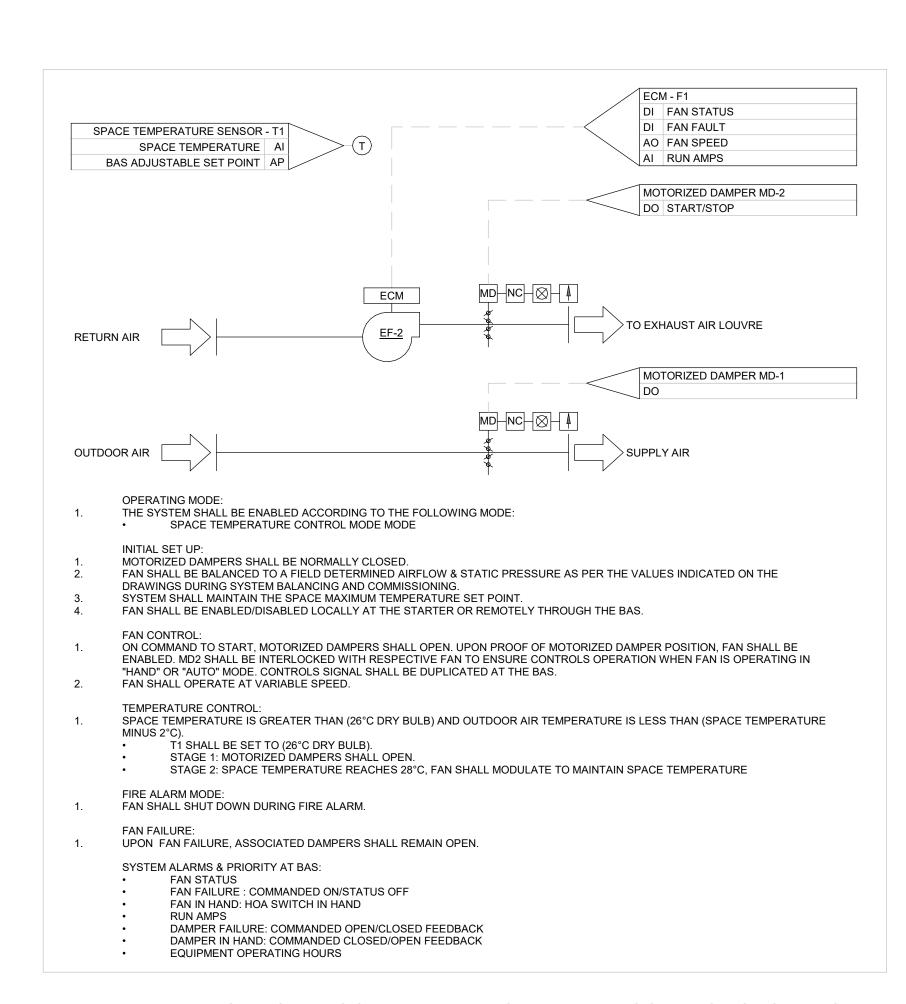

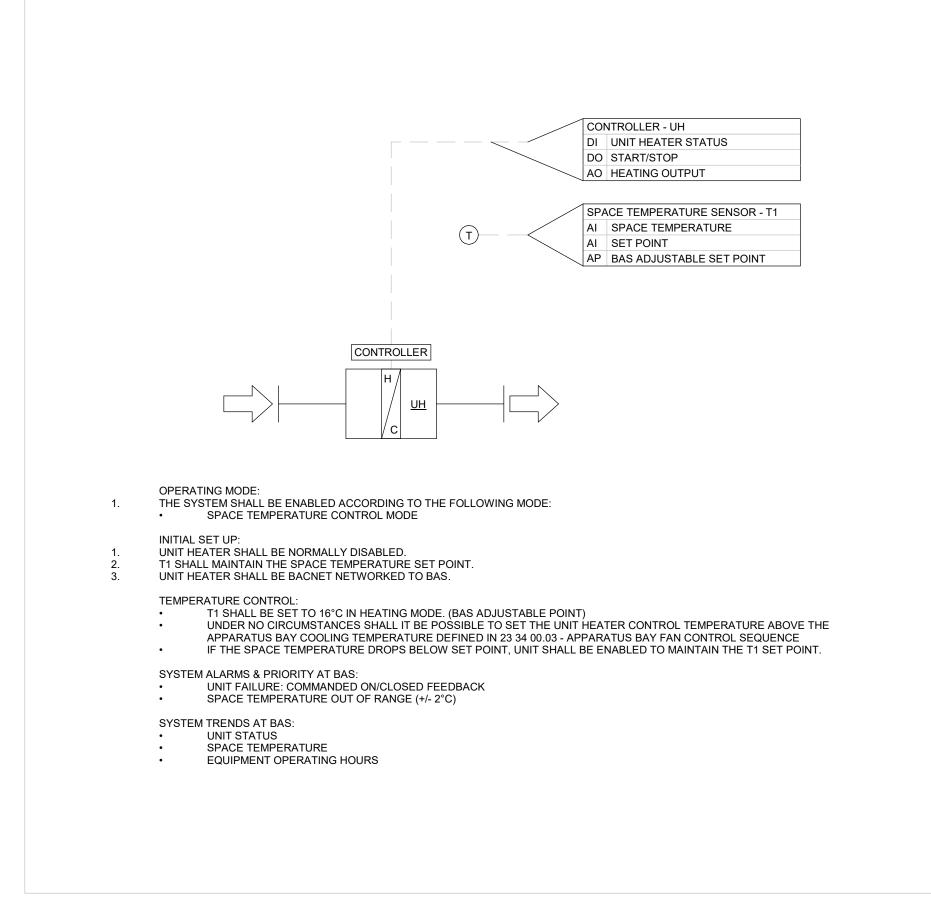

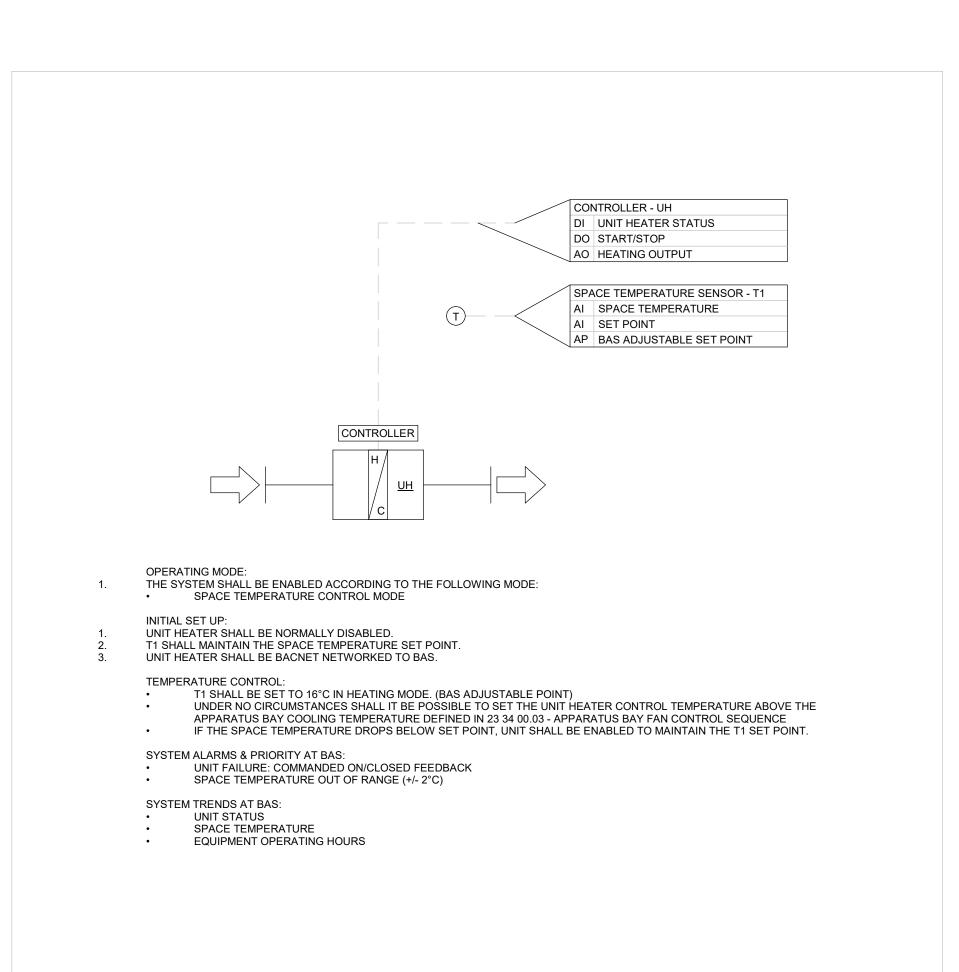

23 55 00.01 - GAS-FIRED UNIT HEATER CONTROL SEQUENCE

NOT TO SCALE

2021-08-12 Drawn by Author Scale N.T.S.

CONTROL SEQUENCES III

27 Rutherford Rd. S., Brampton, ON, L6W 3J3

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2021-08-12

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(SPA-2021-0032)

23 34 00.01 - ELECTRICAL ROOM VARIABLE SPEED FAN CONTROL SEQUENCE NOT TO SCALE