SYMBOL	DESCRIPTION	
AC	AIR COMPRESSOR	
ARC	AIR CURTAIN	
AHU	AIR HANDLING UNIT	
ВВ	BASEBOARD HEATER	
В	BOILER	
CUH	CABINET UNIT HEATER	
СН	CHILLER	
С	CONDENSER	
CAV	CONSTANT AIR VOLUME BOX	
CC	COOLING COIL	
DWH	DOMESTIC WATER HEATER	
EF	EXHAUST FAN	
FCU	FAN COIL UNIT	
FFH	FORCED FLOW HEATER	
GSHP	GROUND SOURCE HEAT PUMP	
HEX	HEAT EXCHANGER	
HP	HEAT PUMP	
HC	HEATING COIL	
Р	PUMP	
PHC	PRE-HEAT COIL	
RP	RADIANT PANEL	
RHC	RE-HEAT COIL	
RF	RETURN FAN	
RTU	ROOFTOP UNIT	
SF	SUPPLY FAN	
UH	UNIT HEATER	
VAV	VARIABLE AIR VOLUME BOX	

HI	EATING & COOLING PIPING
SYMBOL	DESCRIPTION
CNDR	CONDENSATE DRAIN
PC	PUMPED CONDENSATE
REFR	REFRIGERANT GAS
REFS	REFRIGERANT LIQUID
V	VENT
─ ─ ├ ──	UNION
¥	MANUAL AIR VENT
Ŷ	AUTOMATIC AIR VENT
== -==	EXPANSION COMPENSATOR
<u></u> -	EXPANSION LOOP
	PIPE ANCHOR
	PIPE GUIDE
8	PIPE SLEEVE
BBH-#	BASEBOARD HEATER
<u>CU</u> H	CABINET UNIT HEATER
UH	UNIT HEATER

	PLUMBING
SYMBOL	DESCRIPTION
SAN	SANITARY DRAINAGE - ABOVE GROUND
SAN	SANITARY DRAINAGE - UNDERGROUND
——————————————————————————————————————	SANITARY DRAINAGE (ACID RESISTANT) - ABOVE GROUND
— SAN(AR)— —	SANITARY DRAINAGE (ACID RESISTANT) - UNDERGROUND
STM	STORM DRAINAGE - ABOVE GROUND
STM	STORM DRAINAGE - UNDERGROUND
PD	PUMPED DISCHARGE
	DOMESTIC COLD WATER SUPPLY
	DOMESTIC HOT WATER SUPPLY
	DOMESTIC HOT WATER RECIRC.
TW	TEMPERED WATER
AWV	ACID RESISTANT VENT
V	VENT
G	GAS
RO	REVERSE OSMOSIS PIPING
ISO	RADIO ISOTOPE DRAIN
CA	COMPRESSED AIR
	RUNNING TRAP
<u> </u>	P-TRAP
O ES-1	EMERGENCY SHOWER
O EW-1	EYE WASH
O CO	CLEANOUT IN FLOOR/BELOW GRADE
⊣ ı co	CLEANOUT IN CEILING
 ⊙ HB	HOSE BIBB
● H NFHB	NON FREEZE HOSE BIBB
⊕ + G	SINGLE GAS OUTLET
« ÇG	DOUBLE GAS OUTLET
ө н СА	COMPRESSED AIR OUTLET
⊙ +RH	ROOF HYDRANT
9 +GH	GROUND HYDRANT
Ø RD	ROOF DRAIN
Ø CFRD	CONTROL FLOW ROOF DRAIN
O VTR	VENT THROUGH ROOF
O RWL	RAIN WATER LEADER
TSP	TRAP SEAL PRIMER
	SCUPPER DRAIN
	MANHOLE
	CATCH BASIN
TD	TRENCH GRATE & FRAME
⊘ AD	AREA DRAIN
© FFD	FUNNEL FLOOR DRAIN
Ø FD	FLOOR DRAIN
⊚ HD	HUB DRAIN
⊟ FS	FLOOR SINK
Ø FRD	FLOOR DRAIN - FLUSHING RIM
<u> </u>	WATER METER ASSEMBLY
<u>©</u>	GAS METER
	BACK WATER VALVE
BFP	BACKFLOW PREVENTER
"WC-1"	DENOTES FIXTURE TYPE PER SPECIFICATION

BFP	BACKFLOW PREVENTER	
"WC-1"	DENOTES FIXTURE TYPE PER SPECIFICATION	
	FIRE PROTECTION	
SYMBOL	DESCRIPTION	
SP	SPRINKLER LINE	
———FM———	FIRE MAIN	
———F——	STANDPIPE	
SV	SUPERVISED VALVE	
ςWFA <mark>□</mark>	WATER FLOW ALARM	
PS 7	PRESSURE SWITCH	
1 \frac{1}{1} 1	TEST CONNECTION	
ď,	SPRINKLER FIRE DEPARTMENT CONNECTION	
	PRESSURE SWITCH	
,	WATER FLOW ALARM	
	EXCESS PRESSURE PUMP	
X J	WET ALARM CHECK VALVE	
Ţ f	TEST & DRAIN VALVE	
Υ	WATER FLOW ALARM	
	PRESSURE SWITCH	
本	DRY ALARM CHECK VALVE	
J 1	TEST & DRAIN VALVE	
	AIR COMPRESSOR	
SVC	SPRINKLER VALVE CABINET	
FEC	FIRE EXTINGUISHER CABINET	
FHC	FIRE HOSE CABINET	
Ē	FIRE EXTINGUISHER C/W WALL BRACKET	
X PIV	POST-INDICATOR VALVE	
-	FIRE HYDRANT C/W SHUT-OFF VALVE	
•	PENDENT SPRINKLER HEAD	
0	UPRIGHT SPRINKLER HEAD	
0	CONCEALED SPRINKLER HEAD	
8	FIRE SUPPRESSION (CLEAN AGENT) SPRINKLER HEAD	
-<	SIDEWALL SPRINKLER HEAD	
•	FIRE DEPARTMENT CONNECTION	

VENTILATION SYMBOL DESCRIPTION			
FD	FUSIBLE LINK FIRE DAMPER (DOUBLE LINE)		
5—————————————————————————————————————	FUSIBLE LINK FIRE DAMPER (SINGLE LINE)		
BDD	BACK DRAFT DAMPER (DOUBLE LINE)		
BDD	BACK DRAFT DAMPER (SINGLE LINE)		
BD J	BALANCING DAMPER (DOUBLE LINE)		
-BD	BALANCING DAMPER (SINGLE LINE)		
	MOTORIZED DAMPER (DOUBLE LINE)		
——————————————————————————————————————	MOTORIZED DAMPER (SINGLE LINE)		
<u>+ 600×300</u> +	RECTANGULAR DUCTWORK - DIMENSIONS AS SHOWN		
<u>€ 600</u> Ø	ROUND DUCTWORK - DIMENSION AS SHOWN		
\$ 600×300 \$	DUCTWORK (SINGLE LINE) - DIMENSION AS SHOWN		
	RECTANGULAR SUPPLY/OUTDOOR AIR DUCT UP		
	RECTANGULAR EXHAUST/RETURN AIR DUCT UP		
•	CIRCULAR SUPPLY/OUTDOOR AIR DUCT UP		
0	CIRCULAR EXHAUST/RETURN AIR DUCT UP		
	RECTANGULAR SUPPLY/OUTDOOR AIR DUCT DOWN		
	RECTANGULAR EXHAUST/RETURN AIR DUCT DOWN		
(2)	CIRCULAR SUPPLY/OUTDOOR AIR DUCT DOWN		
(2)	CIRCULAR EXHAUST/RETURN AIR DUCT DOWN		
**************************************	MITRED ELBOW WITH TURNING VANES		
	DUCT RISE (DOUBLE LINE)		
 X	DUCT RISE (SINGLE LINE)		
├	SUPPLY GRILLE - DIMENSIONS AS SHOWN ON SCHEDULE		
	EXHAUST/RETURN GRILLE - DIMENSIONS AS SHOWN ON SCHEDULE		
\bowtie	CEILING SUPPLY AIR DIFFUSER - DIMENSIONS AS SHOWN ON SCHEDULE		
	LINEAR SLOT DIFFUSER - DIMENSIONS AS SHOWN ON SCHEDULE		
	CEILING EXHAUST/RETURN GRILLE - DIMENSIONS AS SHOWN ON SCHEDULE		
<u> </u>	SUPPLY AIR ROUND DIFFUSER		
	BRANCH TAKE-OFF WITH ADJUSTABLE SPLITTER DAMPER IN SUPPLY DUCT (DOUBLE LINE)		
, <u>J</u>	BRANCH TAKE-OFF WITH ADJUSTABLE SPLITTER DAMPER IN SUPPLY DUCT (SINGLE LINE)		
O.E.D.	OPEN ENDED DUCT WITH BALANCING DAMPER AND BELLMOUTH. DIRECTION AS SHOWN (DOUBLE		
ÇO.E.D.	LINE) OPEN ENDED DUCT WITH BALANCING DAMPER AND BELLMOUTH. DIRECTION AS SHOWN (SINGLE		
	LINE) FLEXIBLE DUCT CONNECTION		
	ACOUSTICALLY LINED DUCTWORK (DOUBLE LINE)		
' 	DUCT SILENCER		
 	FLEXIBLE DUCT (DOUBLE LINE)		
	FLEXIBLE DUCT (SINGLE LINE) FLEXIBLE DUCT CONNECTION WITH BALANCING DAMPER ON TAKE-OFF		
₹ 400x400 400ø }	DUCT TRANSITION FROM RECTANGULAR TO ROUND		
	RECTANGULAR DUCT BREAK		
8 8	ROUND DUCT BREAK		
\$	SINGLE LINE DUCT BREAK		
	TRANSFER AIR DUCT		
II/C	75mm (2/4") DOOD HAIDEDOUT		

U/C -∕√►

75mm (3/4") DOOR UNDERCUT

MECHANICAL DRAWING LIST		
DRAWING #	DRAWING NAME	
M001	MECHANICAL LEGEND & DRAWING LIST	
M101	MECHANICAL SITE PLAN	
M200	FOUNDATION PLAN - PLUMBING & DRAINAGE	
M201	LEVEL 1 PLAN - PLUMBING & DRAINAGE	
M202	ROOF PLAN - PLUMBING & DRAINAGE	
M301	LEVEL 1 PART PLAN WEST - VENTILATION	
M302	LEVEL 1 PART PLAN EAST - VENTILATION	
M303	LEVEL 1 PART PLAN NORTH - VENTILATION	
M304	ROOF PLAN - VENTILATION	
M401	LEVEL 1 PLAN - FIRE PROTECTION	
M601	VRV SCHEMATIC	
M602	FIRE PROTECTION & GAS SCHEMATIC	
M610	MECHANICAL EQUIPMENT SCHEDULE	
M621	MECHANICAL SECTIONS	
M641	MECHANICAL DETAILS I	
M642	MECHANICAL DETAILS II	
M643	MECHANICAL DETAILS III	
M644	MECHANICAL DETAILS IV	
M645	MECHANICAL DETAILS V	
M646	MECHANICAL DETAILS VI	
M647	MECHANICAL DETAILS VII	
M648	MECHANICAL DETAILS VIII	
M650	CONTROL SEQUENCES I	
M651	CONTROL SEQUENCES II	
M652	CONTROL SEQUENCES III	

	CONTROLS
SYMBOL	DESCRIPTION
SF	SUPPLY FAN
RF	RETURN FAN
EF	EXHAUST FAN
	HEATING COIL
	COOLING COIL
<u> </u>	PRE-HEAT COIL
	FILTERS
	HUMIDIFIER
SA	SUPPLY AIR
<u>EA</u>	EXHAUST AIR
OA	OUTDOOR AIR
	RETURN AIR
MD	MOTORIZED DAMPER
MSP	MOTOR STARTER PANEL
MCC	MOTOR CONTROL CENTER
VFD	VARIABLE FREQUENCY DRIVE
NO	NORMALLY OPEN
NC	NORMALLY CLOSED
<u> </u>	NORMALLY CLOSED CONTACT
	NORMALLY OPEN CONTACT FLOW SWITCH
LS	LEVEL SWITCH
PS	PRESSURE SWITCH
NC	ACTUATOR NORMALLY CLOSED DE-ENERGIZED POSITION
NO	ACTUATOR NORMALLY OPEN DE-ENERGIZED POSITION
<u></u>	ACTUATOR FAIL OPEN POSITION ACTUATOR FAIL CLOSED POSITION
FL	ACTUATOR FAIL LAST POSITION
Ā	TWO-POSITION ACTUATOR
$\overline{\mathbb{Q}}$	MODULATING ACTUATOR
<u> </u>	PRESSURE SENSOR
<u> </u>	DIFFERENTIAL PRESSURE SENSOR VELOCITY SENSOR
 ⊕	VELOCITY SENSOR HUMIDITY SENSOR
У	TEMPERATURE SENSOR
<u> </u>	OCCUPANCY SENSOR
<u>©</u>	CARBON MONOXIDE SENSOR
(<u>()</u>	NOX SENSOR
<u>O</u> 2	OXYGEN SENSOR
GDP	GAS DETECTION SYSTEM CONTROL PANEL
<u> </u>	VISUAL INDICATOR ALARM
BAS	AUDIBLE INDICATOR ALARM BUILDING AUTOMATION SYSTEM
BAS AI	ANALOG INPUT
AO	ANALOG OUTPUT
DI	DIGITAL INPUT
DO	DIGITAL OUTPUT
AP	BAS ADJUSTABLE SET POINT
BV	BACNET VARIABLE

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J	ISSUED FOR CONSTRUCTION	2021-12-20
ı	ISSUED FOR TENDER	2021-08-12
Н	ISSUED FOR BUILDING PERMIT	2021-07-27
G	90% CD	2021-05-03
F	SITE PLAN RESUBMISSION	2021-04-23
E	SPA	2021-02-12
D	50% CD	2021-02-05
С	BUILDING PERMIT	2021-02-05
В	PERMIT/SPA COORDINATION	2021-02-02
Α	100% DESIGN DEVELOPMENT	2021-01-19
No.	Revision	Date

Orientation

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Project Information

BFES Station 201 (SPA-2021-0032)

27 Rutherford Rd. S., Brampton, ON, L6W 3J3


City of Brampton Fire & Emergency Services

Drawing Title

MECHANICAL LEGEND & DRAWING LIST


Project No Drawing No 2021-12-20 Drawn by CMW CM-20-063 M001

Scale 1:1

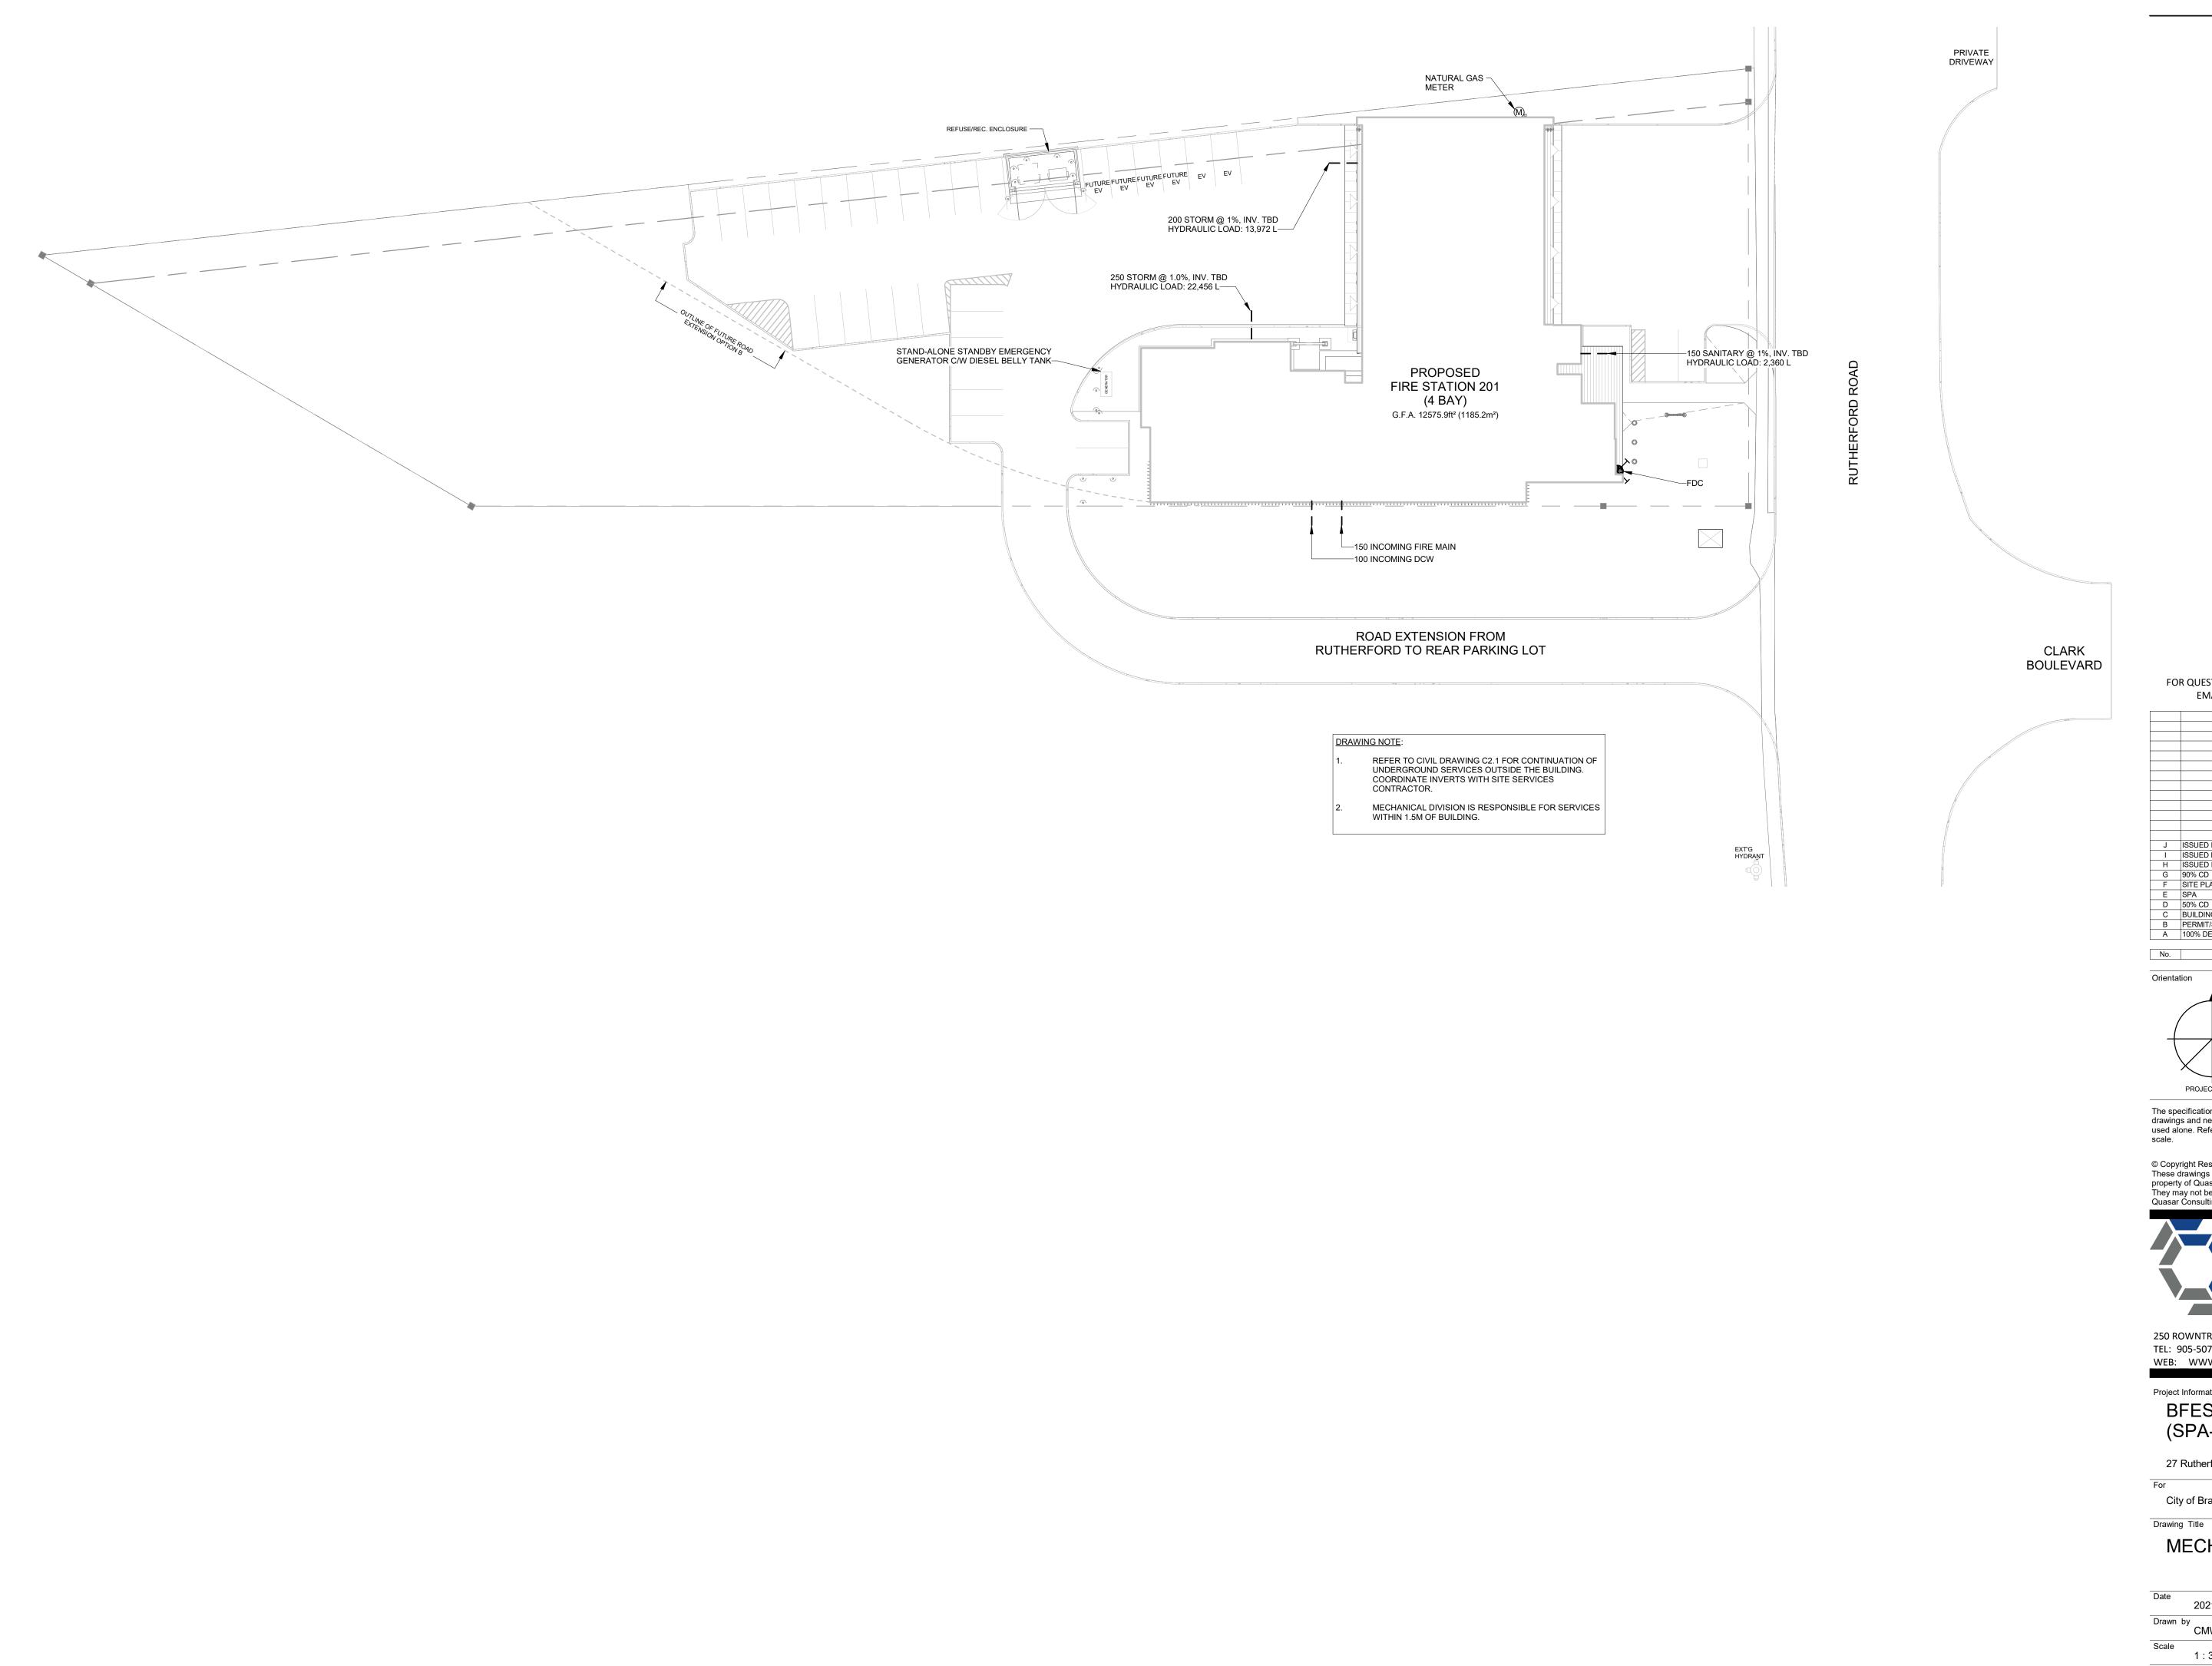

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- 1	ISSUED FOR TENDER	2021-08-12
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Α	100% DESIGN DEVELOPMENT	2021-01-19
		•
No.	Revision	Date

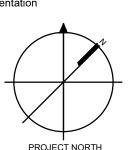

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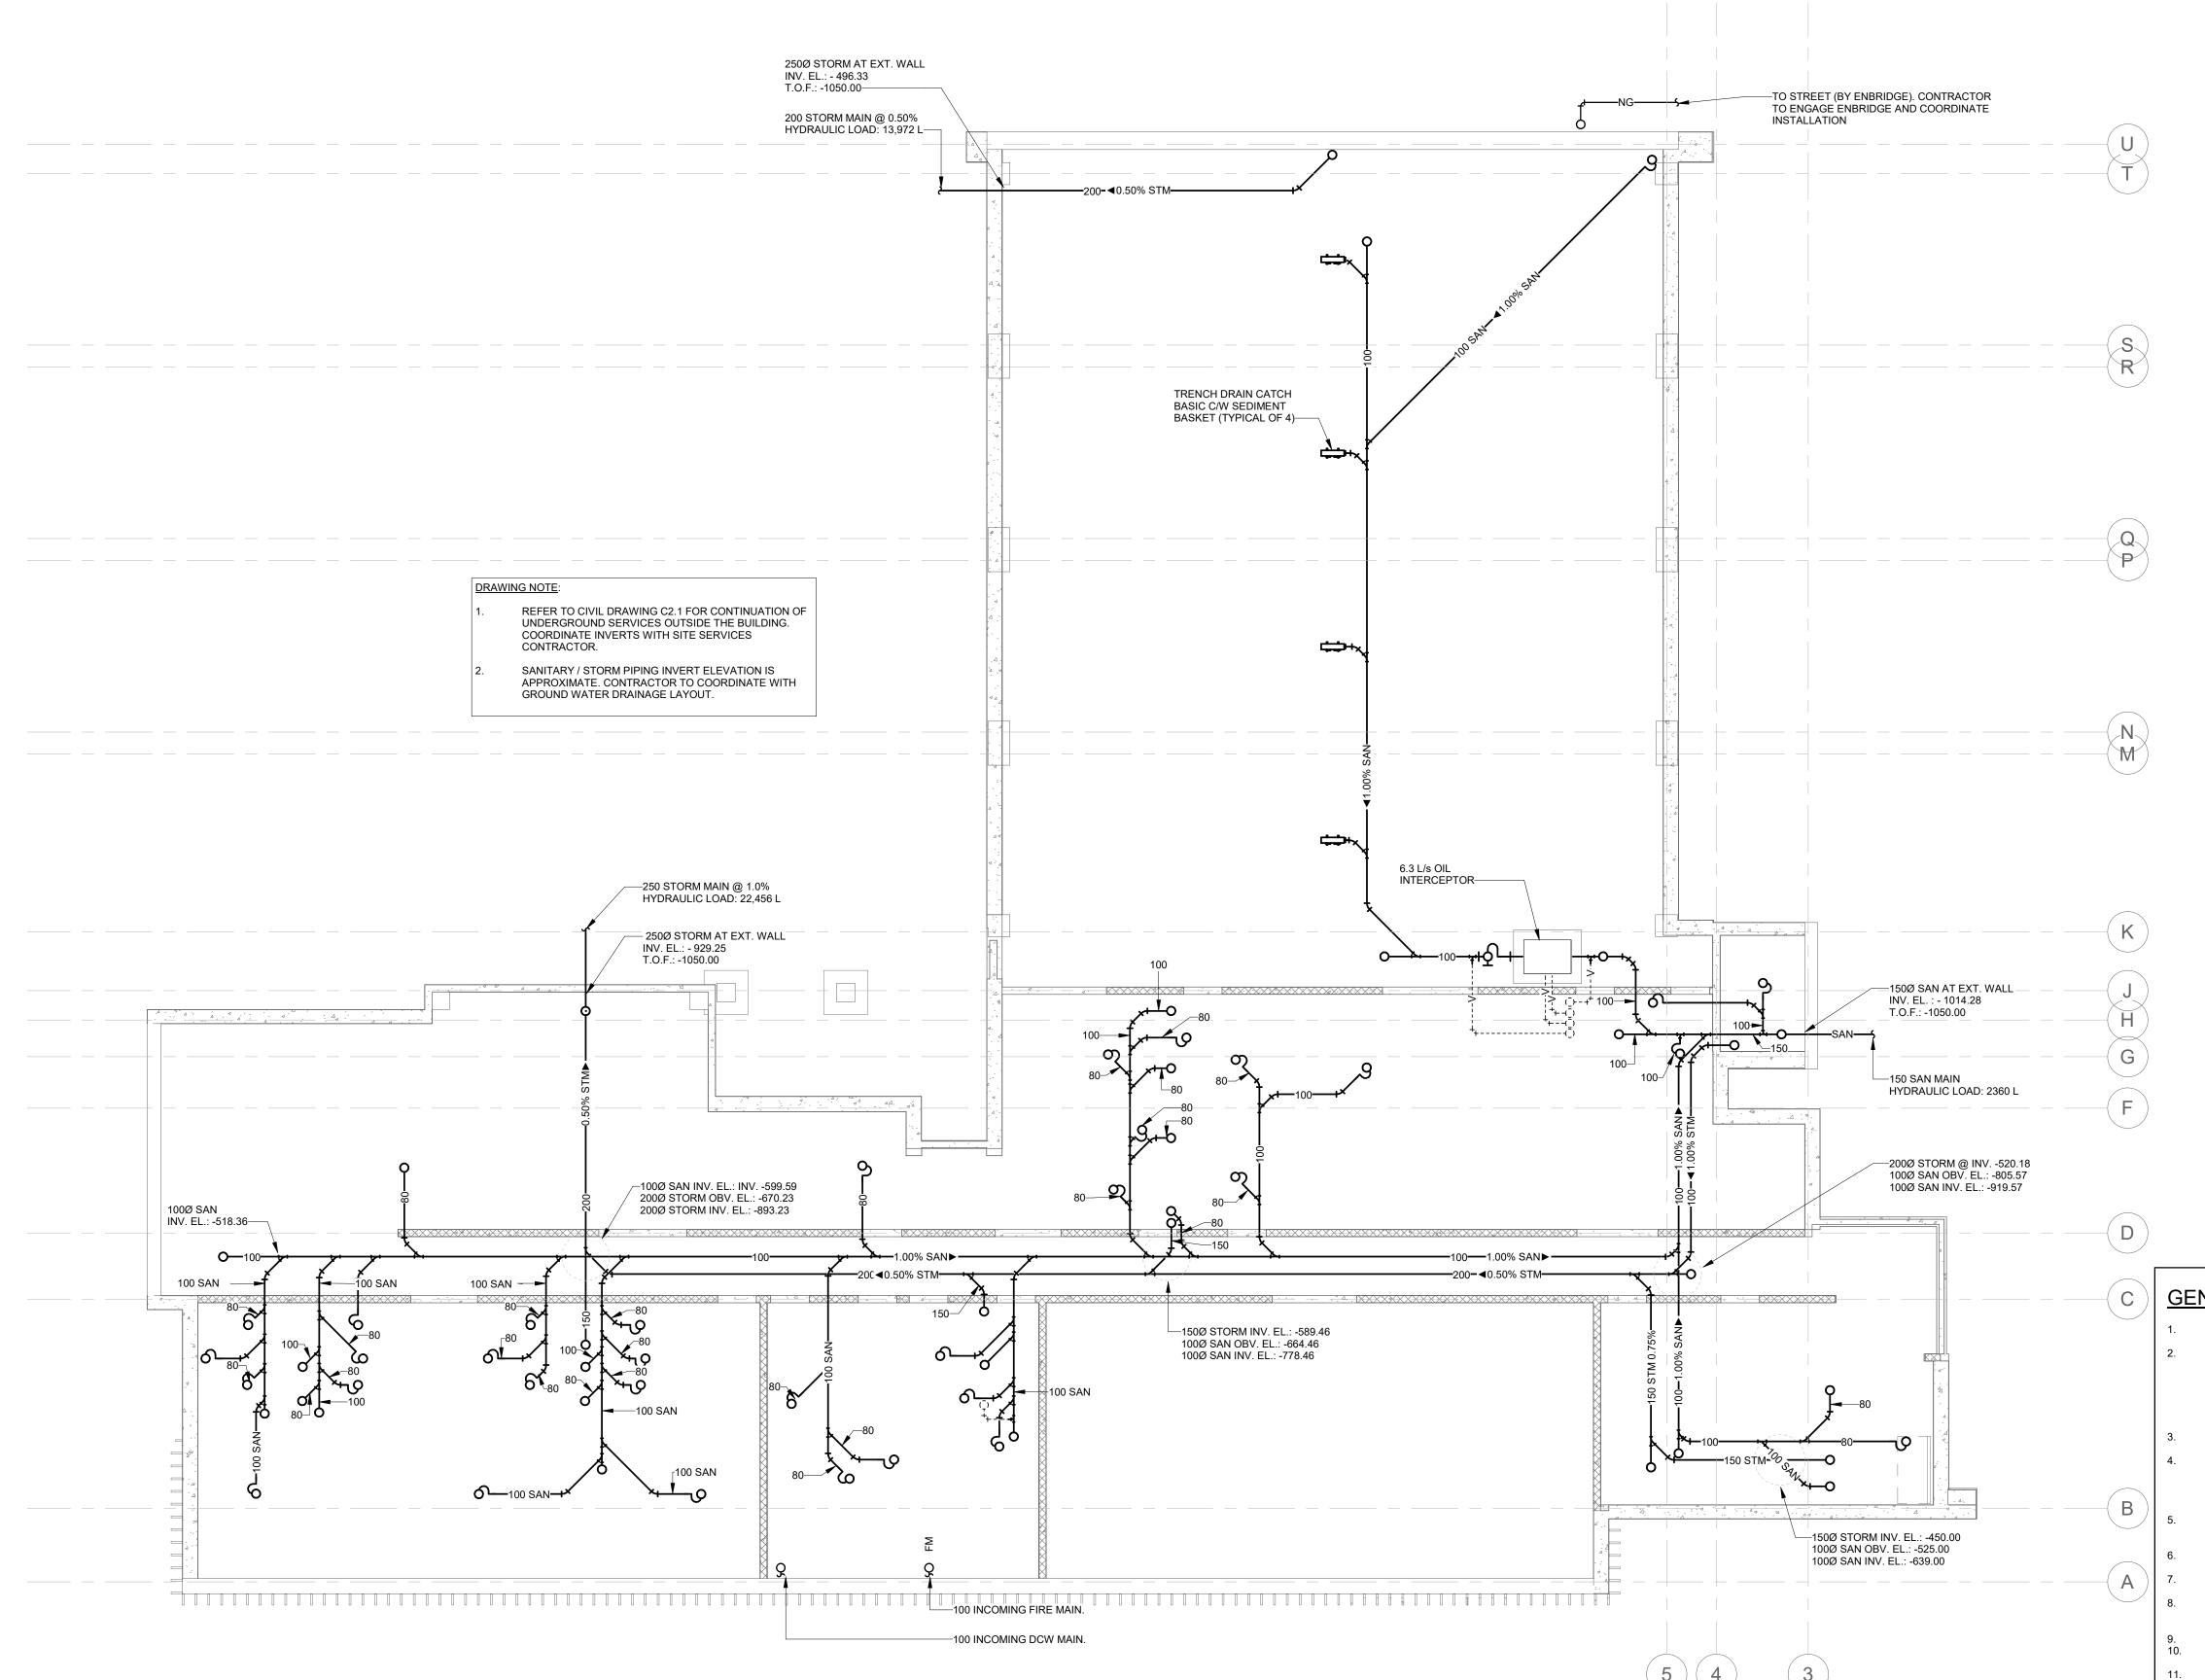
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City of Brampton Fire & Emergency Services

MECHANICAL SITE PLAN


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ı	ISSUED FOR CONSTRUCTION	2021-12-20
Н	ISSUED FOR TENDER	2021-08-12
G	ISSUED FOR BUILDING PERMIT	2021-07-27
F	90% CD	2021-05-03
Е	SPA	2021-02-12
D	50% CD	2021-02-05
С	BUILDING PERMIT	2021-02-05
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Α	100% DESIGN DEVELOPMENT	2021-01-19
No.	Revision	Date

o. Revision



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or
City of Brampton Fire & Emergency Services

City of Brampton

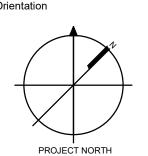FOUNDATION PLAN PLUMBING & DRAINAGE

Date 2021-12-20

Drawn by CMW

CMW

As indicated

GENERAL NOTES:

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ALL WORK TO BE DONE IN ACCORDANCE WITH THE ONTARIO BUILDING CODE AND ALL OTHER REGULATORY REQUIREMENTS.

OTHER REGULATORY REQUIREMENTS.
SUPPLY ALL LABOUR AND MATERIALS TO PROVIDE A COMPLETE MECHANICAL
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TRAINING WILL BE PART OF THE WORK.

TRAINING WILL BE PART OF THE WORK.

COORDINATE PLUMBING WITH WORK OF OTHER TRADES PRIOR TO FABRICATION OR INSTALLATION. PROVIDE ALL FITTINGS, OFFSETS AND TRANSITIONS REQUIRED FOR COMPLETE WORKABLE INSTALLATION.

COORDINATE LOCATIONS OF ALL ROOF OPENINGS WITH STRUCTURAL, MECHANICAL AND ARCHITECTURAL PLANS PRIOR TO ANY INSTALLATION.


PROVIDE FULL VENTING SYSTEM IN ACCORDANCE TO PART 7 OF THE OBC.

COORDINATE LOCATION OF VTRS WITH AIR INTAKES.

COORDINATE LOCATION OF VTRS WITH AIR INTAKES.
ALL EQUIPMENT SHALL BE INSTALLED IN ACCORDANCE WITH MANUFACTURER'S WRITTEN GUIDELINES. PROVIDE ALL FITTINGS, OFFSETS AND TRANSITIONS AS REQUIRED FOR COMPLETE INSTALLATION.


TRAP, PRIME AND VENT ALL FLOOR DRAINS.
ALL DRAINAGE PIPING 100Ø AND LARGER TO BE SLOPED AT 1%. ALL DRAINAGE PIPING
75Ø AND LESS TO BE SLOPED AT 2%.
MINIMUM PIPE SIZE IS 12Ø UNLESS NOTED OTHERWISE.

PROVIDE ISOLATION VALVES AT EACH PLUMBING FIXTURE.
ALL JANITOR'S SINKS, WALL HYDRANTS AND HOSE BIBBS TO BE PROVIDED C/W CSA
VACUUM BREAKER PER OBC REQUIREMENTS.

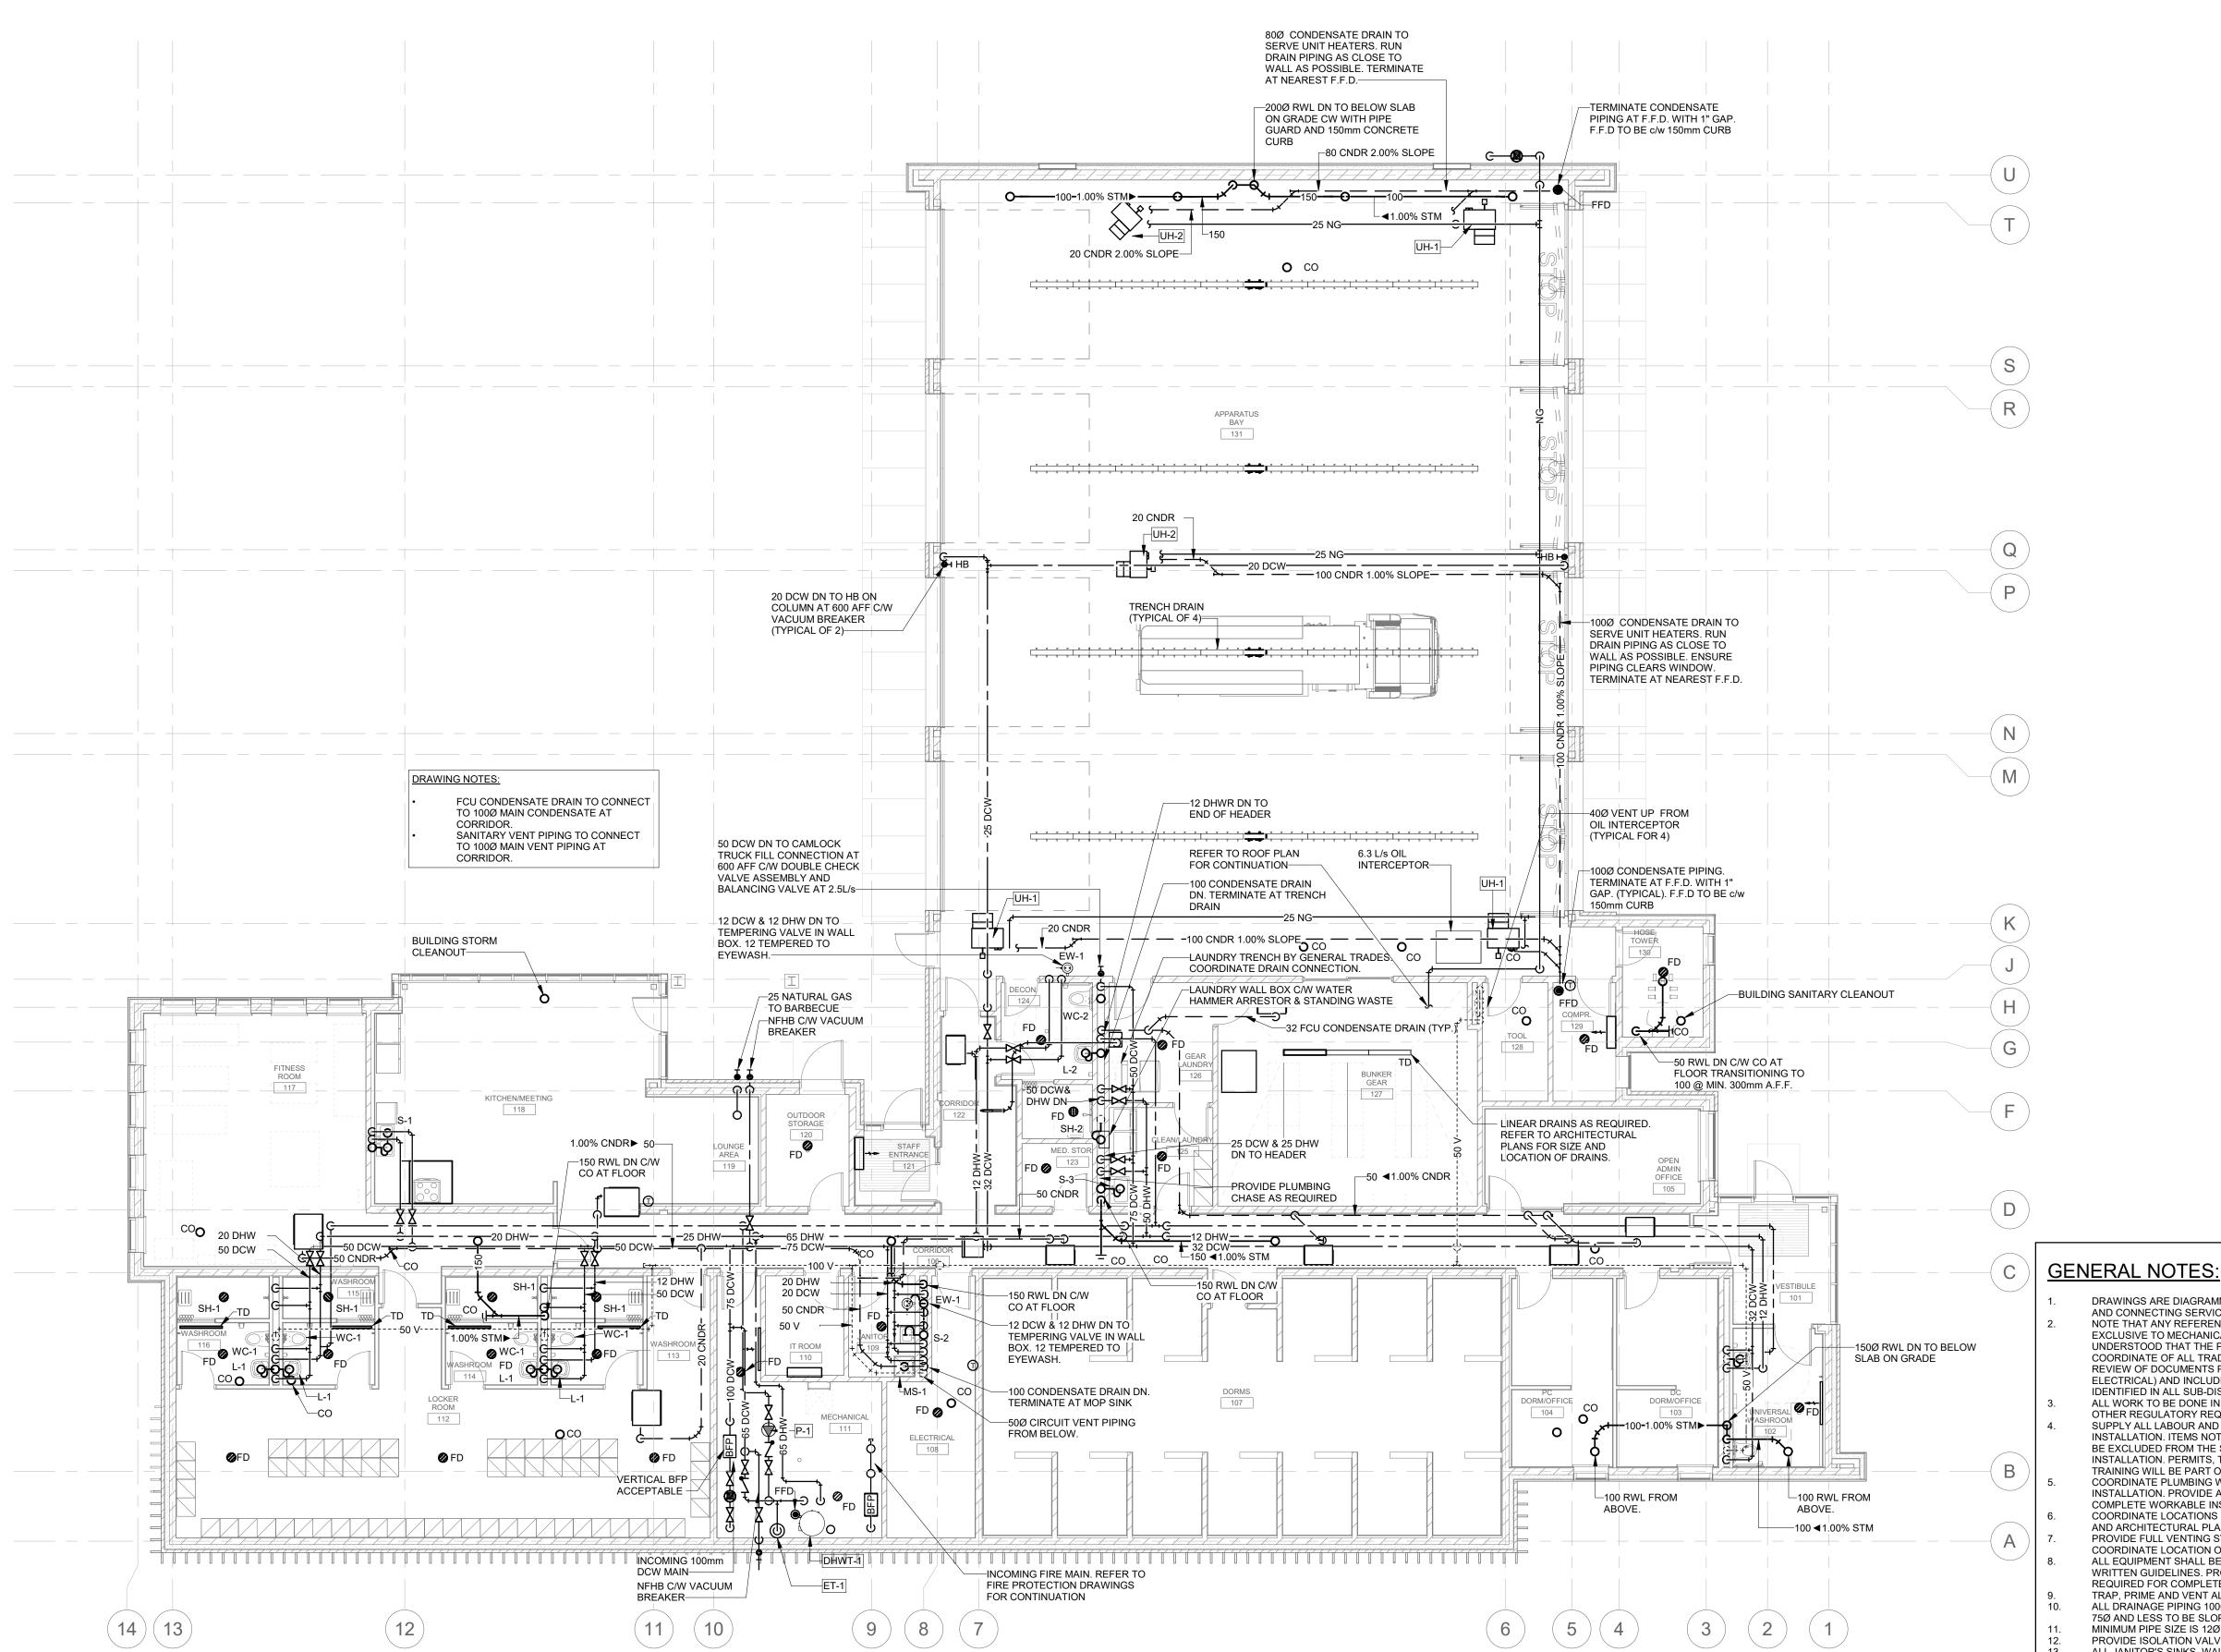

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J	ISSUED FOR CONSTRUCTION	2021-12-20
ı	ADDENDUM M02	2021-10-25
Н	ISSUED FOR TENDER	2021-08-12
G	ISSUED FOR BUILDING PERMIT	2021-07-27
F	90% CD	2021-05-03
E	SPA	2021-02-12
D	50% CD	2021-02-05
C	BUILDING PERMIT	2021-02-05
В	PERMIT/SPA COORDINATION	2021-02-02
Α	100% DESIGN DEVELOPMENT	2021-01-19
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City of Brampton Fire & Emergency Services

Drawing Title LEVEL 1 PLAN -

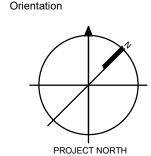PLUMBING & DRAINAGE

2021-12-20 Scale As indicated

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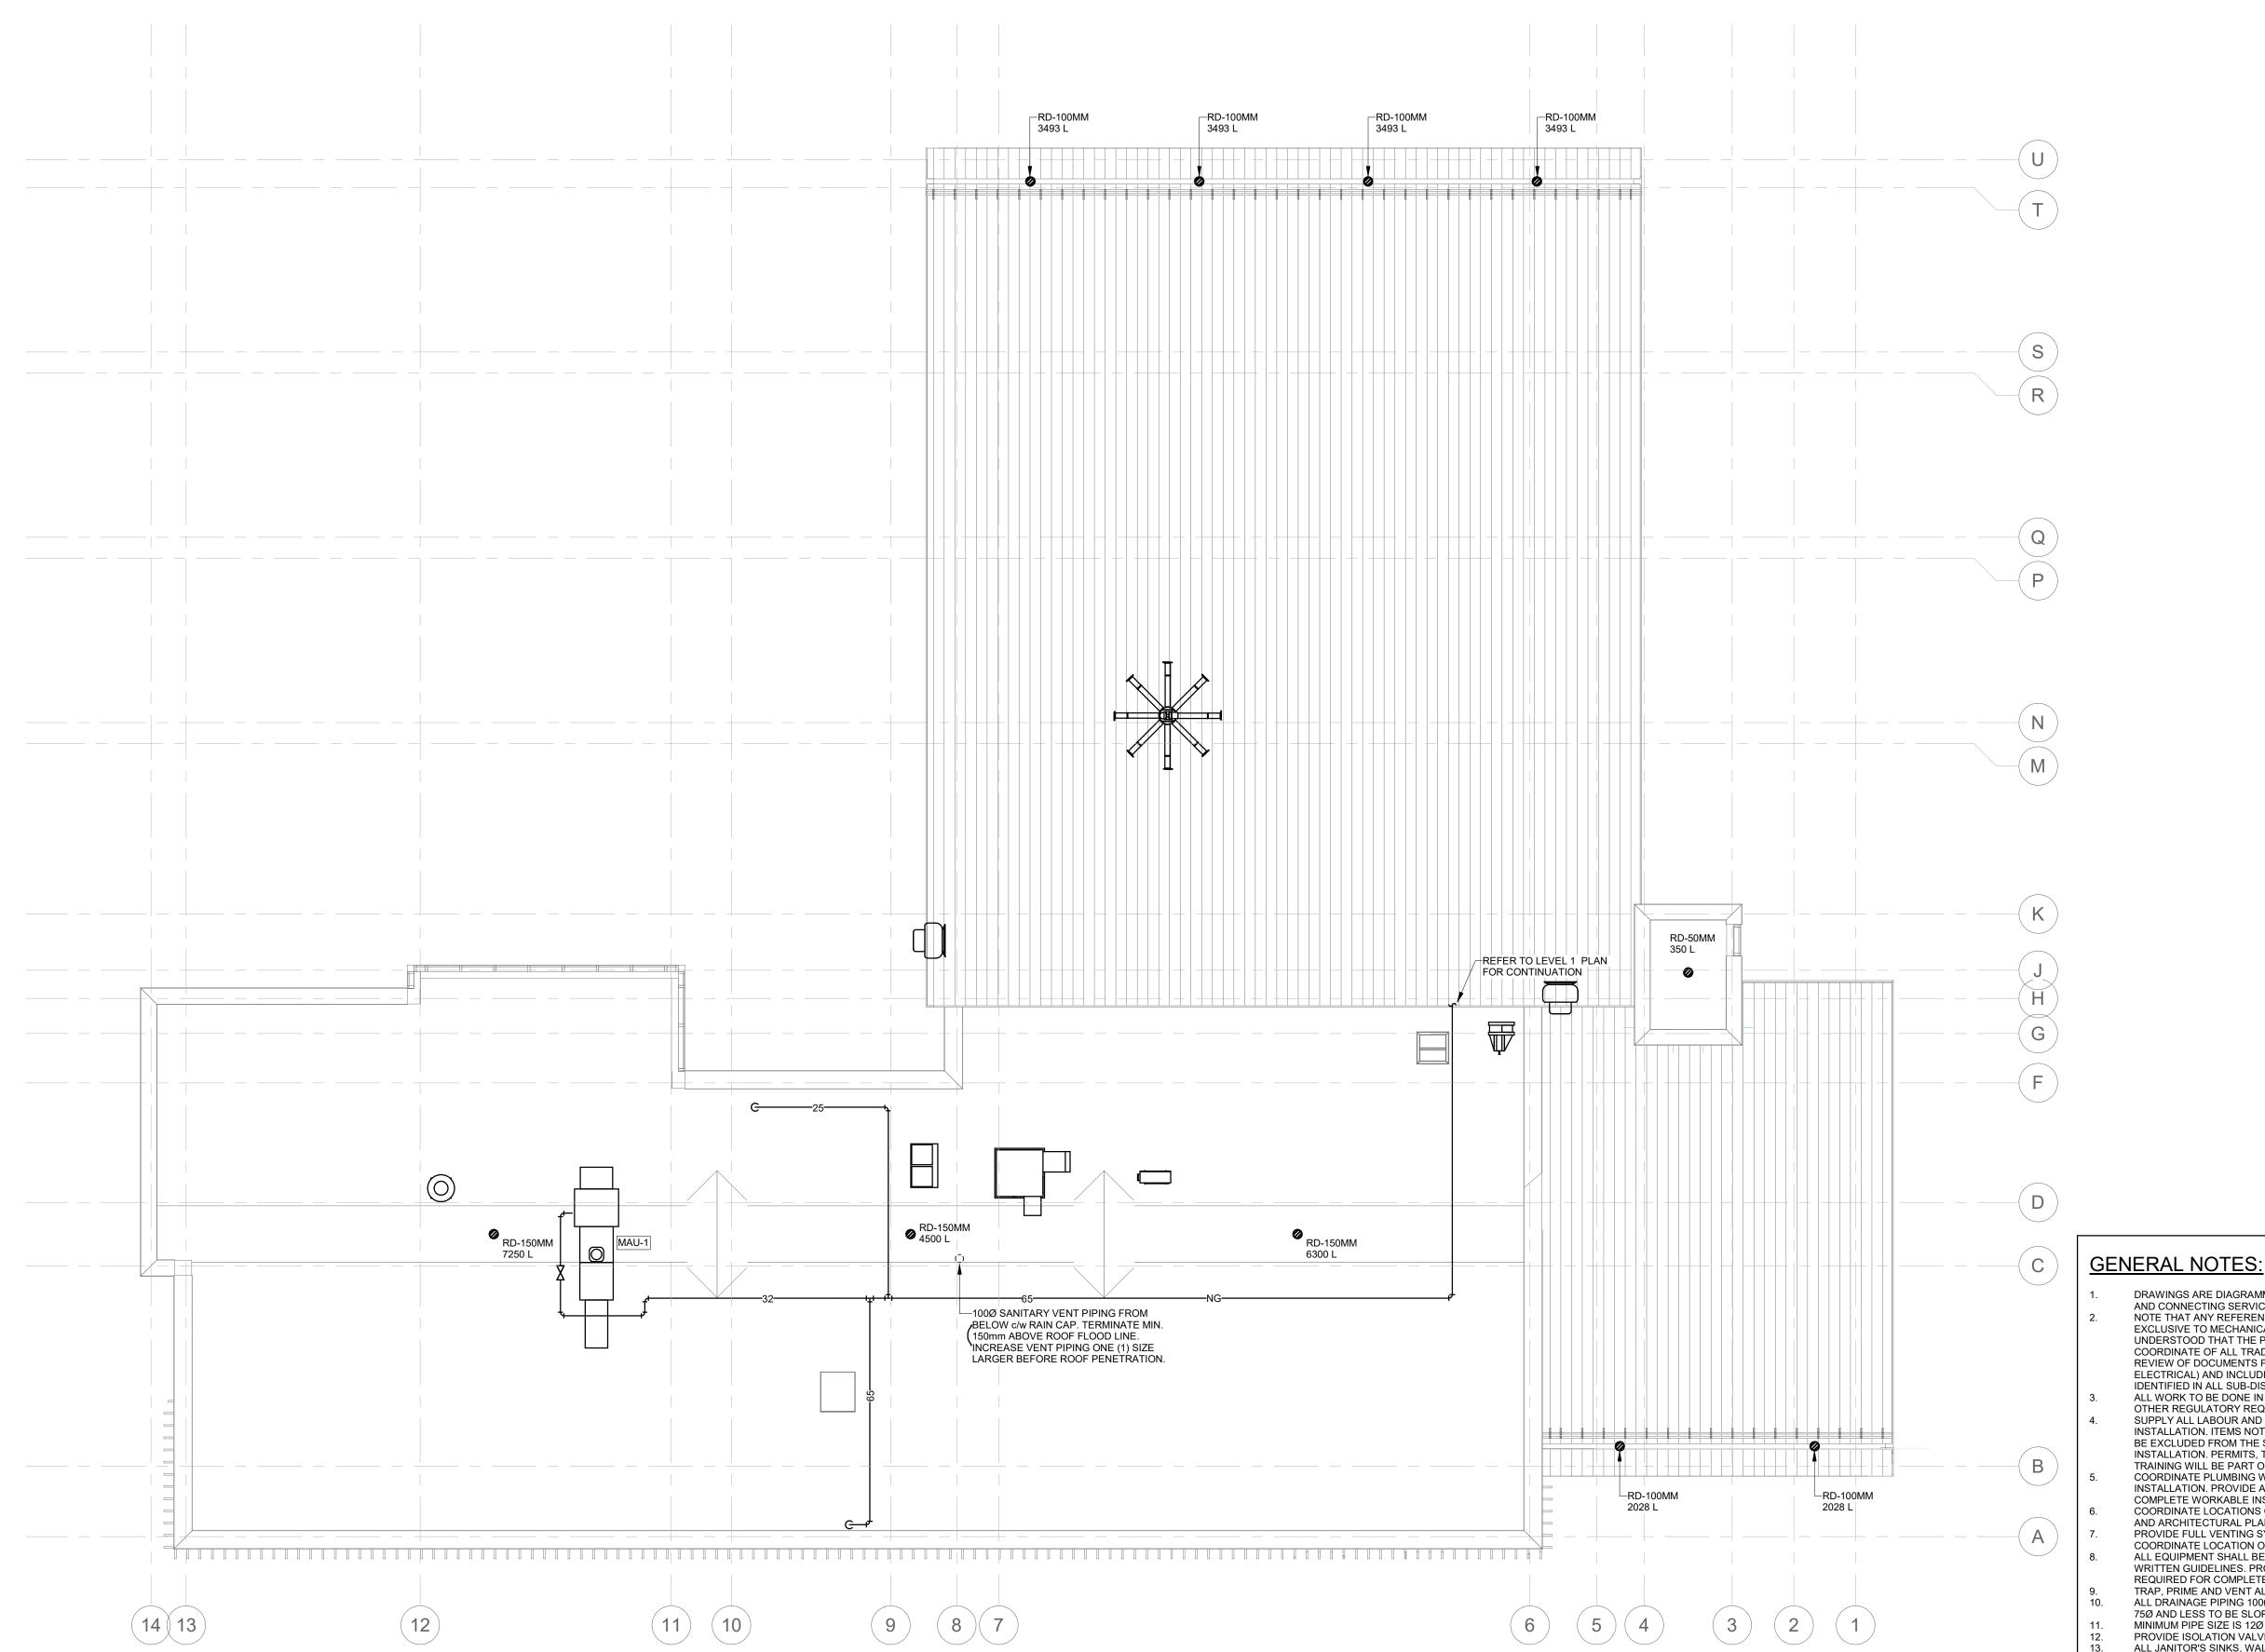
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TRAP, PRIME AND VENT ALL FLOOR DRAINS ALL DRAINAGE PIPING 100Ø AND LARGER TO BE SLOPED AT 1%. ALL DRAINAGE PIPING 75Ø AND LESS TO BE SLOPED AT 2%. MINIMUM PIPE SIZE IS 12Ø UNLESS NOTED OTHERWISE.


PROVIDE ISOLATION VALVES AT EACH PLUMBING FIXTURE. ALL JANITOR'S SINKS, WALL HYDRANTS AND HOSE BIBBS TO BE PROVIDED C/W CSA VACUUM BREAKER PER OBC REQUIREMENTS.

Roof Plan - Plumbing and Drainage



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ı	ISSUED FOR CONSTRUCTION	2021-12-20
Н	ISSUED FOR TENDER	2021-08-12
G	ISSUED FOR BUILDING PERMIT	2021-07-27
F	90% CD	2021-05-03
Е	SPA	2021-02-12
D	50% CD	2021-02-05
С	BUILDING PERMIT	2021-02-05
В	PERMIT/SPA COORDINATION	2021-02-02
Α	100% DESIGN DEVELOPMENT	2021-01-19
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Drawing Title

ROOF PLAN - PLUMBING & DRAINAGE

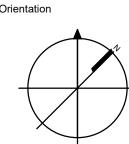Project No Drawing No 2021-12-20

As indicated

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- BE EXCLUDED FROM THE SCOPE OF WORK IF REQUIRED AS PART OF A PROPER INSTALLATION. PERMITS, TESTING, BALANCING, AND OCCUPANT OPERATIONAL TRAINING WILL BE PART OF THE WORK.


 COORDINATE PLUMBING WITH WORK OF OTHER TRADES PRIOR TO FABRICATION OR INSTALLATION. PROVIDE ALL FITTINGS, OFFSETS AND TRANSITIONS REQUIRED FOR
- COMPLETE WORKABLE INSTALLATION. COORDINATE LOCATIONS OF ALL ROOF OPENINGS WITH STRUCTURAL, MECHANICAL

SUPPLY ALL LABOUR AND MATERIALS TO PROVIDE A COMPLETE MECHANICAL INSTALLATION. ITEMS NOT EXPLICITLY ILLUSTRATED ON THE DRAWINGS ARE NOT TO

- AND ARCHITECTURAL PLANS PRIOR TO ANY INSTALLATION.
 PROVIDE FULL VENTING SYSTEM IN ACCORDANCE TO PART 7 OF THE OBC. COORDINATE LOCATION OF VTRS WITH AIR INTAKES. ALL EQUIPMENT SHALL BE INSTALLED IN ACCORDANCE WITH MANUFACTURER'S WRITTEN GUIDELINES. PROVIDE ALL FITTINGS, OFFSETS AND TRANSITIONS AS
- REQUIRED FOR COMPLETE INSTALLATION. TRAP, PRIME AND VENT ALL FLOOR DRAINS ALL DRAINAGE PIPING 100Ø AND LARGER TO BE SLOPED AT 1%. ALL DRAINAGE PIPING 75Ø AND LESS TO BE SLOPED AT 2%.
- PROVIDE ISOLATION VALVES AT EACH PLUMBING FIXTURE.

MINIMUM PIPE SIZE IS 12Ø UNLESS NOTED OTHERWISE.

ALL JANITOR'S SINKS, WALL HYDRANTS AND HOSE BIBBS TO BE PROVIDED C/W CSA VACUUM BREAKER PER OBC REQUIREMENTS.

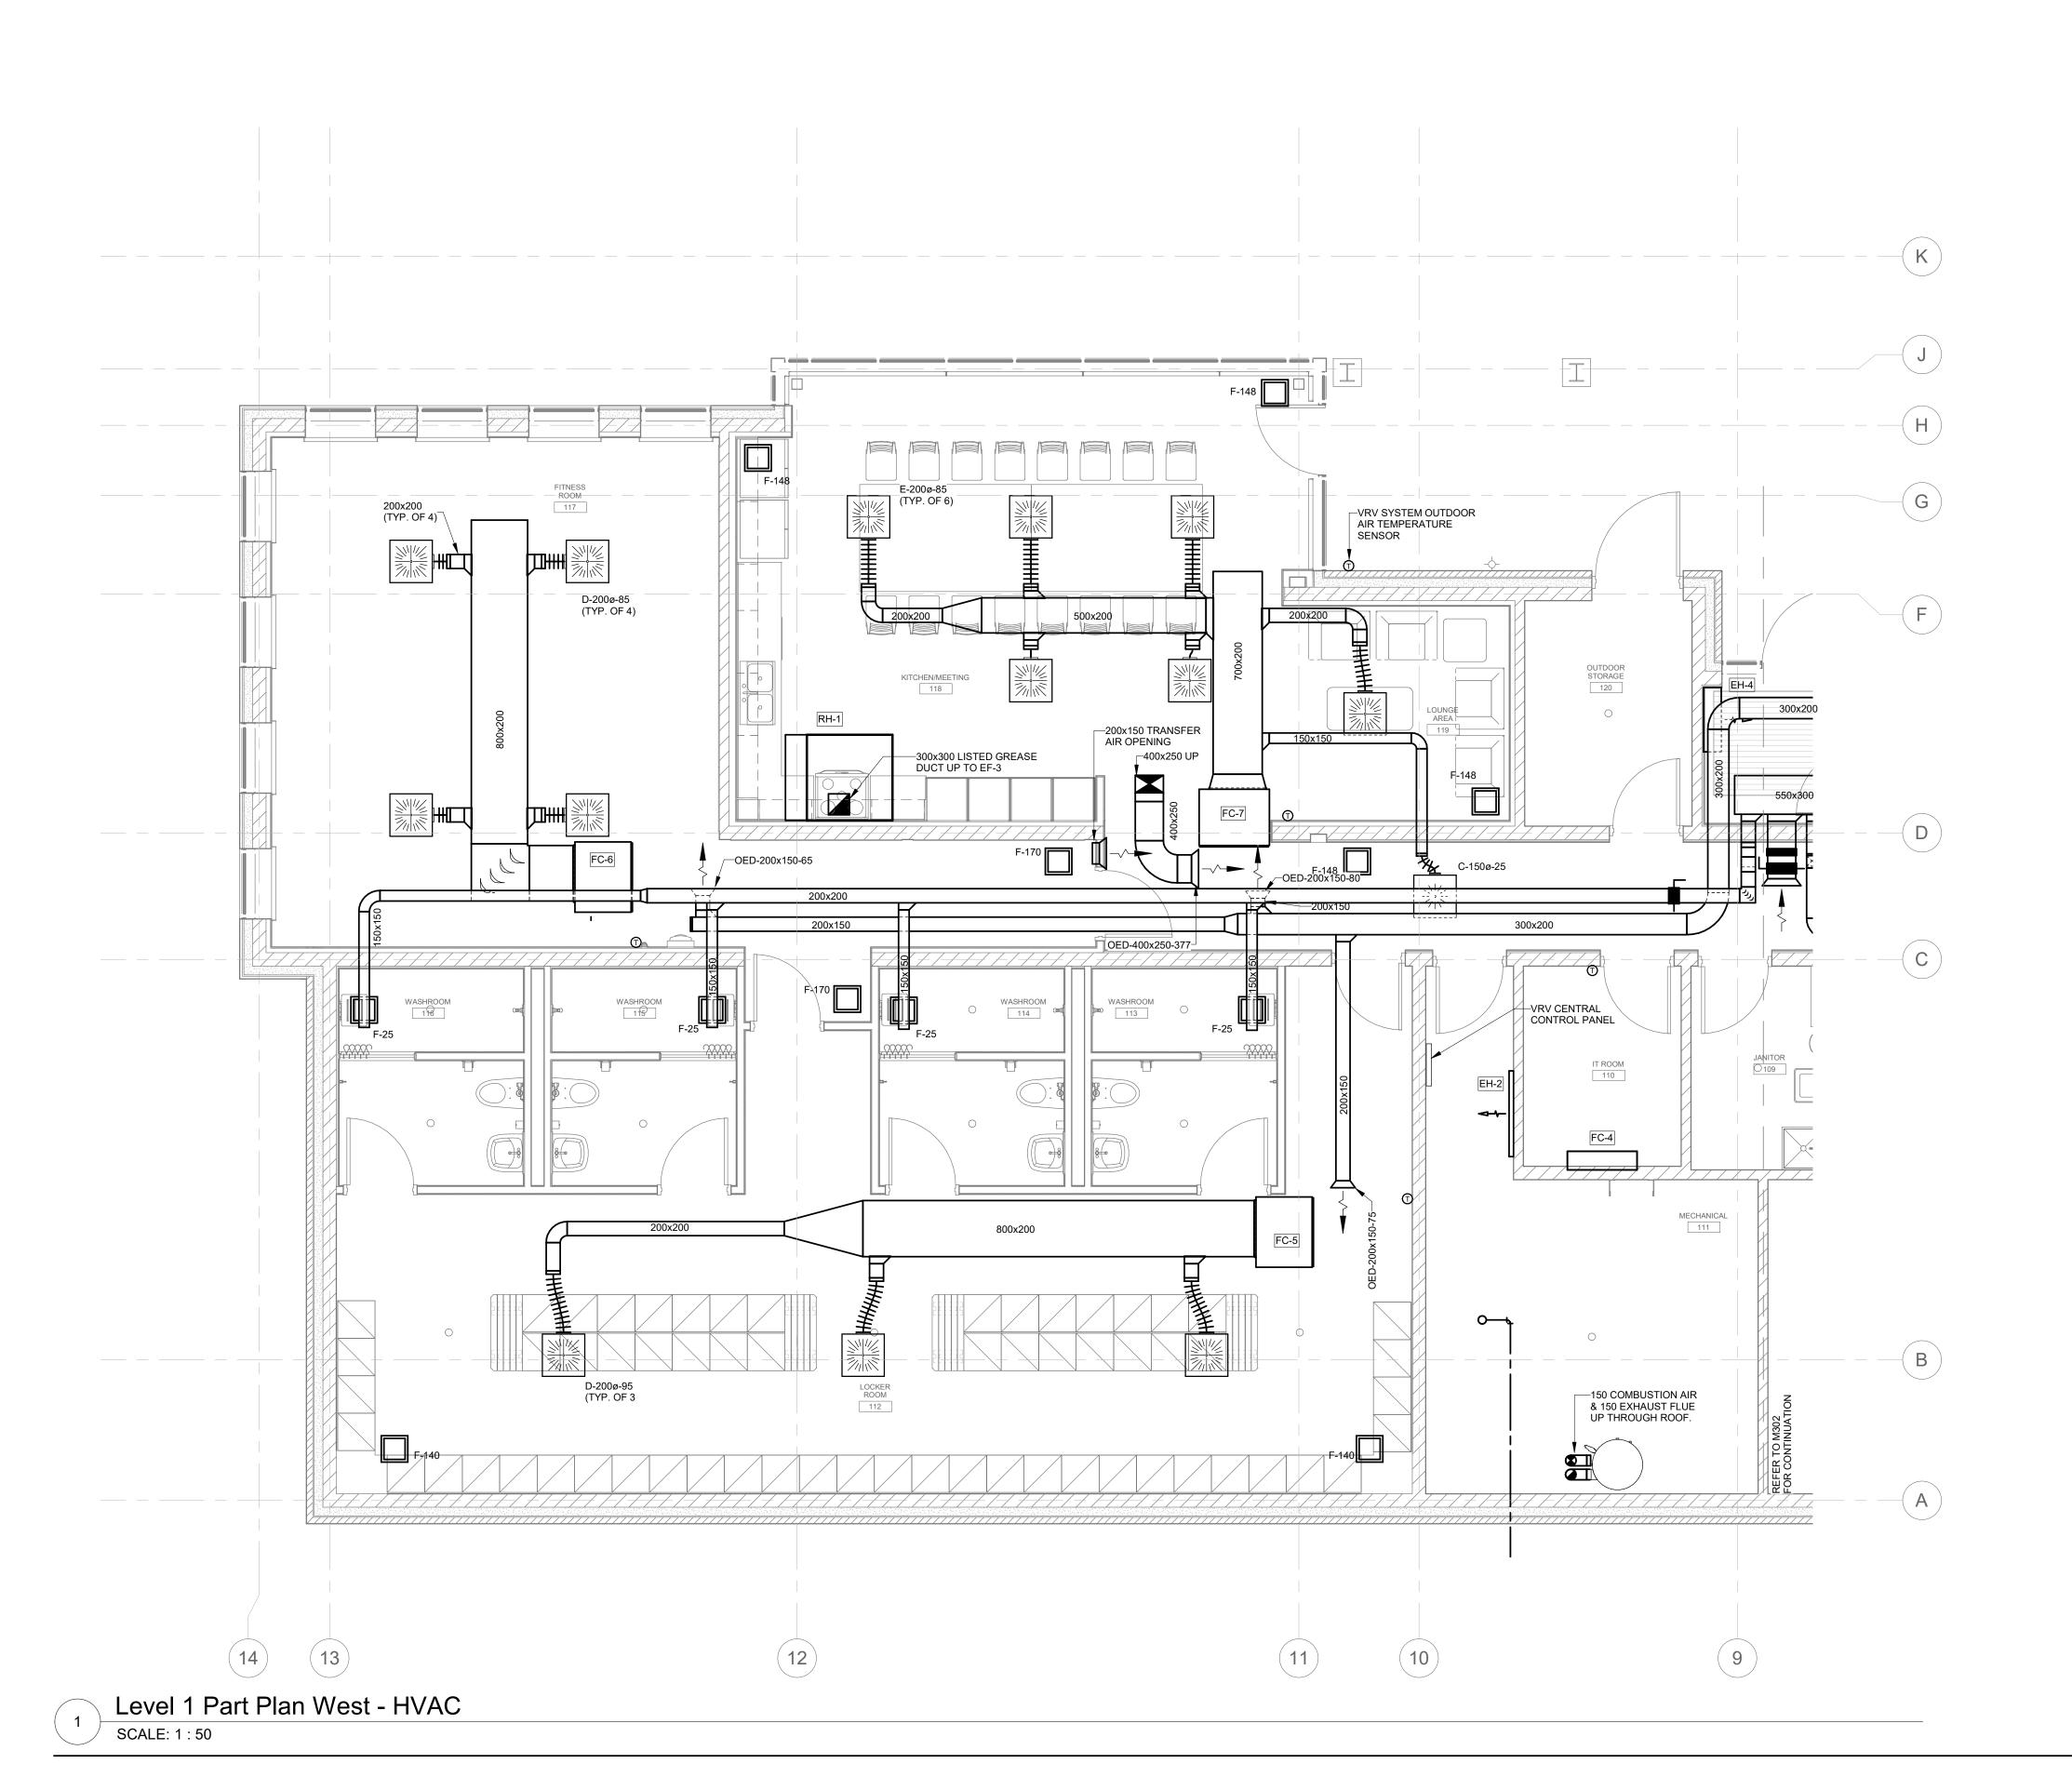

GENERAL NOTES:

- DRAWINGS ARE DIAGRAMMATIC AND INDICATE GENERAL LOCATIONS OF EQUIPMENT AND CONNECTING SERVICES. DRAWINGS ARE NOT TO BE DIMENSIONED OR SCALED. NOTE THAT ANY REFERENCE TO CONTRACTOR ON MECHANICAL DRAWINGS IS NOT EXCLUSIVE TO MECHANICAL CONTRACTOR OR ON PARTICULAR SUB-TRADE. IT IS UNDERSTOOD THAT THE PRIME CONTRACTOR SHALL BE RESPONSIBLE FOR COORDINATE OF ALL TRADES' WORK AND AS SUCH SHALL BE RESPONSIBLE FOR REVIEW OF DOCUMENTS PREPARED BY ALL DISCIPLINES (I.E. MECHANICAL AND ELECTRICAL) AND INCLUDING ALL ASSOCIATED COSTS FOR THE SCOPE OF WORK AS IDENTIFIED IN ALL SUB-DISCIPLINE'S DOCUMENTS.
- ALL WORK TO BE DONE IN ACCORDANCE WITH THE ONTARIO BUILDING CODE AND ALL OTHER REGULATORY REQUIREMENTS.
- SUPPLY ALL LABOUR AND MATERIALS TO PROVIDE A COMPLETE MECHANICAL INSTALLATION. ITEMS NOT EXPLICITLY ILLUSTRATED ON THE DRAWINGS ARE NOT TO BE EXCLUDED FROM THE SCOPE OF WORK IF REQUIRED AS PART OF A PROPER INSTALLATION. PERMITS, TESTING, BALANCING, AND OCCUPANT OPERATIONAL TRAINING WILL BE PART OF THE WORK.
- EXACT LOCATION OF ALL CEILING DIFFUSERS, REGISTERS AND GRILLES ARE DETAILED ON ARCHITECTURAL REFLECTED CEILING PLANS. THE LOCATION OF ALL ROOF OPENINGS SHALL BE AS INDICATED ON THE MECHANICAL, STRUCTURAL AND ARCHITECTURAL DRAWINGS. COORDINATE EXACT SIZES OF OPENINGS
- AS REQUIRED. ALL EQUIPMENT SHALL BE INSTALLED IN STRICT ACCORDANCE WITH MANUFACTURER'S RECOMMENDATIONS. PROVIDE ALL FITTINGS, TRANSITIONS, DAMPERS ETC AS REQUIRED FOR COMPLETE WORKABLE INSTALLATION.
- DUCTWORK SHALL BE INSULATED OR LINED PER SPECIFICATIONS AND/OR AS NOTED ON DRAWINGS. ALL DUCT JOINTS AND SEAMS SHALL BE SEAL PER SPECIFICATIONS. DUCT AND PLENUM SIZES ARE CLEAR INSIDE DIMENSIONS. WHERE DUCTWORK AND PLENUMS ARE INTERNALLY LINED, THEIR SIZES SHALL BE ADJUSTED TO PROVIDE THE
- MANUAL BALANCING DAMPERS SHALL BE PROVIDED IN ALL DUCT BRANCHES AND IN ALL BRANCHES TO INDIVIDUAL DIFFUSERS, GRILLES AND REGISTERS, WHETHER SHOWN OR


INSIDE CLEAR DIMENSIONS INDICATED ON THE DRAWINGS.

- ALL DUCTWORK LOCATED OUTSIDE THE BUILDING SHALL BE WEATHERPROOFED.
 CONTRACTOR SHALL INSTALL ANY DUCT MOUNTED SMOKE DETECTORS FURNISHED BY
 THE ELECTRICAL CONTRACTOR.
- LIMIT LENGTHS OF FLEXIBLE DUCT TO 1200mm

 COORDINATE LOCATIONS OF WALL MOUNTED SENSORS WITH ARCHITECTURAL DRAWINGS. MINIMUM DUCT SIZE TO DIFFUSERS TO MATCH DIFFUSER NEXT SIZE UNLESS OTHERWISE INDICATED.

FOR QUESTIONS REGARDING THIS PROJECT, PLEASE EMAIL: CM-20-063@QUASARCG.COM



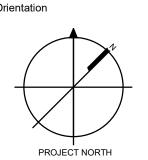

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Project Information

BFES Station 201 (SPA-2021-0032)

27 Rutherford Rd. S., Brampton, ON, L6W 3J3

City of Brampton Fire & Emergency Services

Drawing Title


LEVEL 1 PART PLAN WEST - VENTILATION

2021-12-20 Drawn by CM-20-063 M301

Scale


As indicated



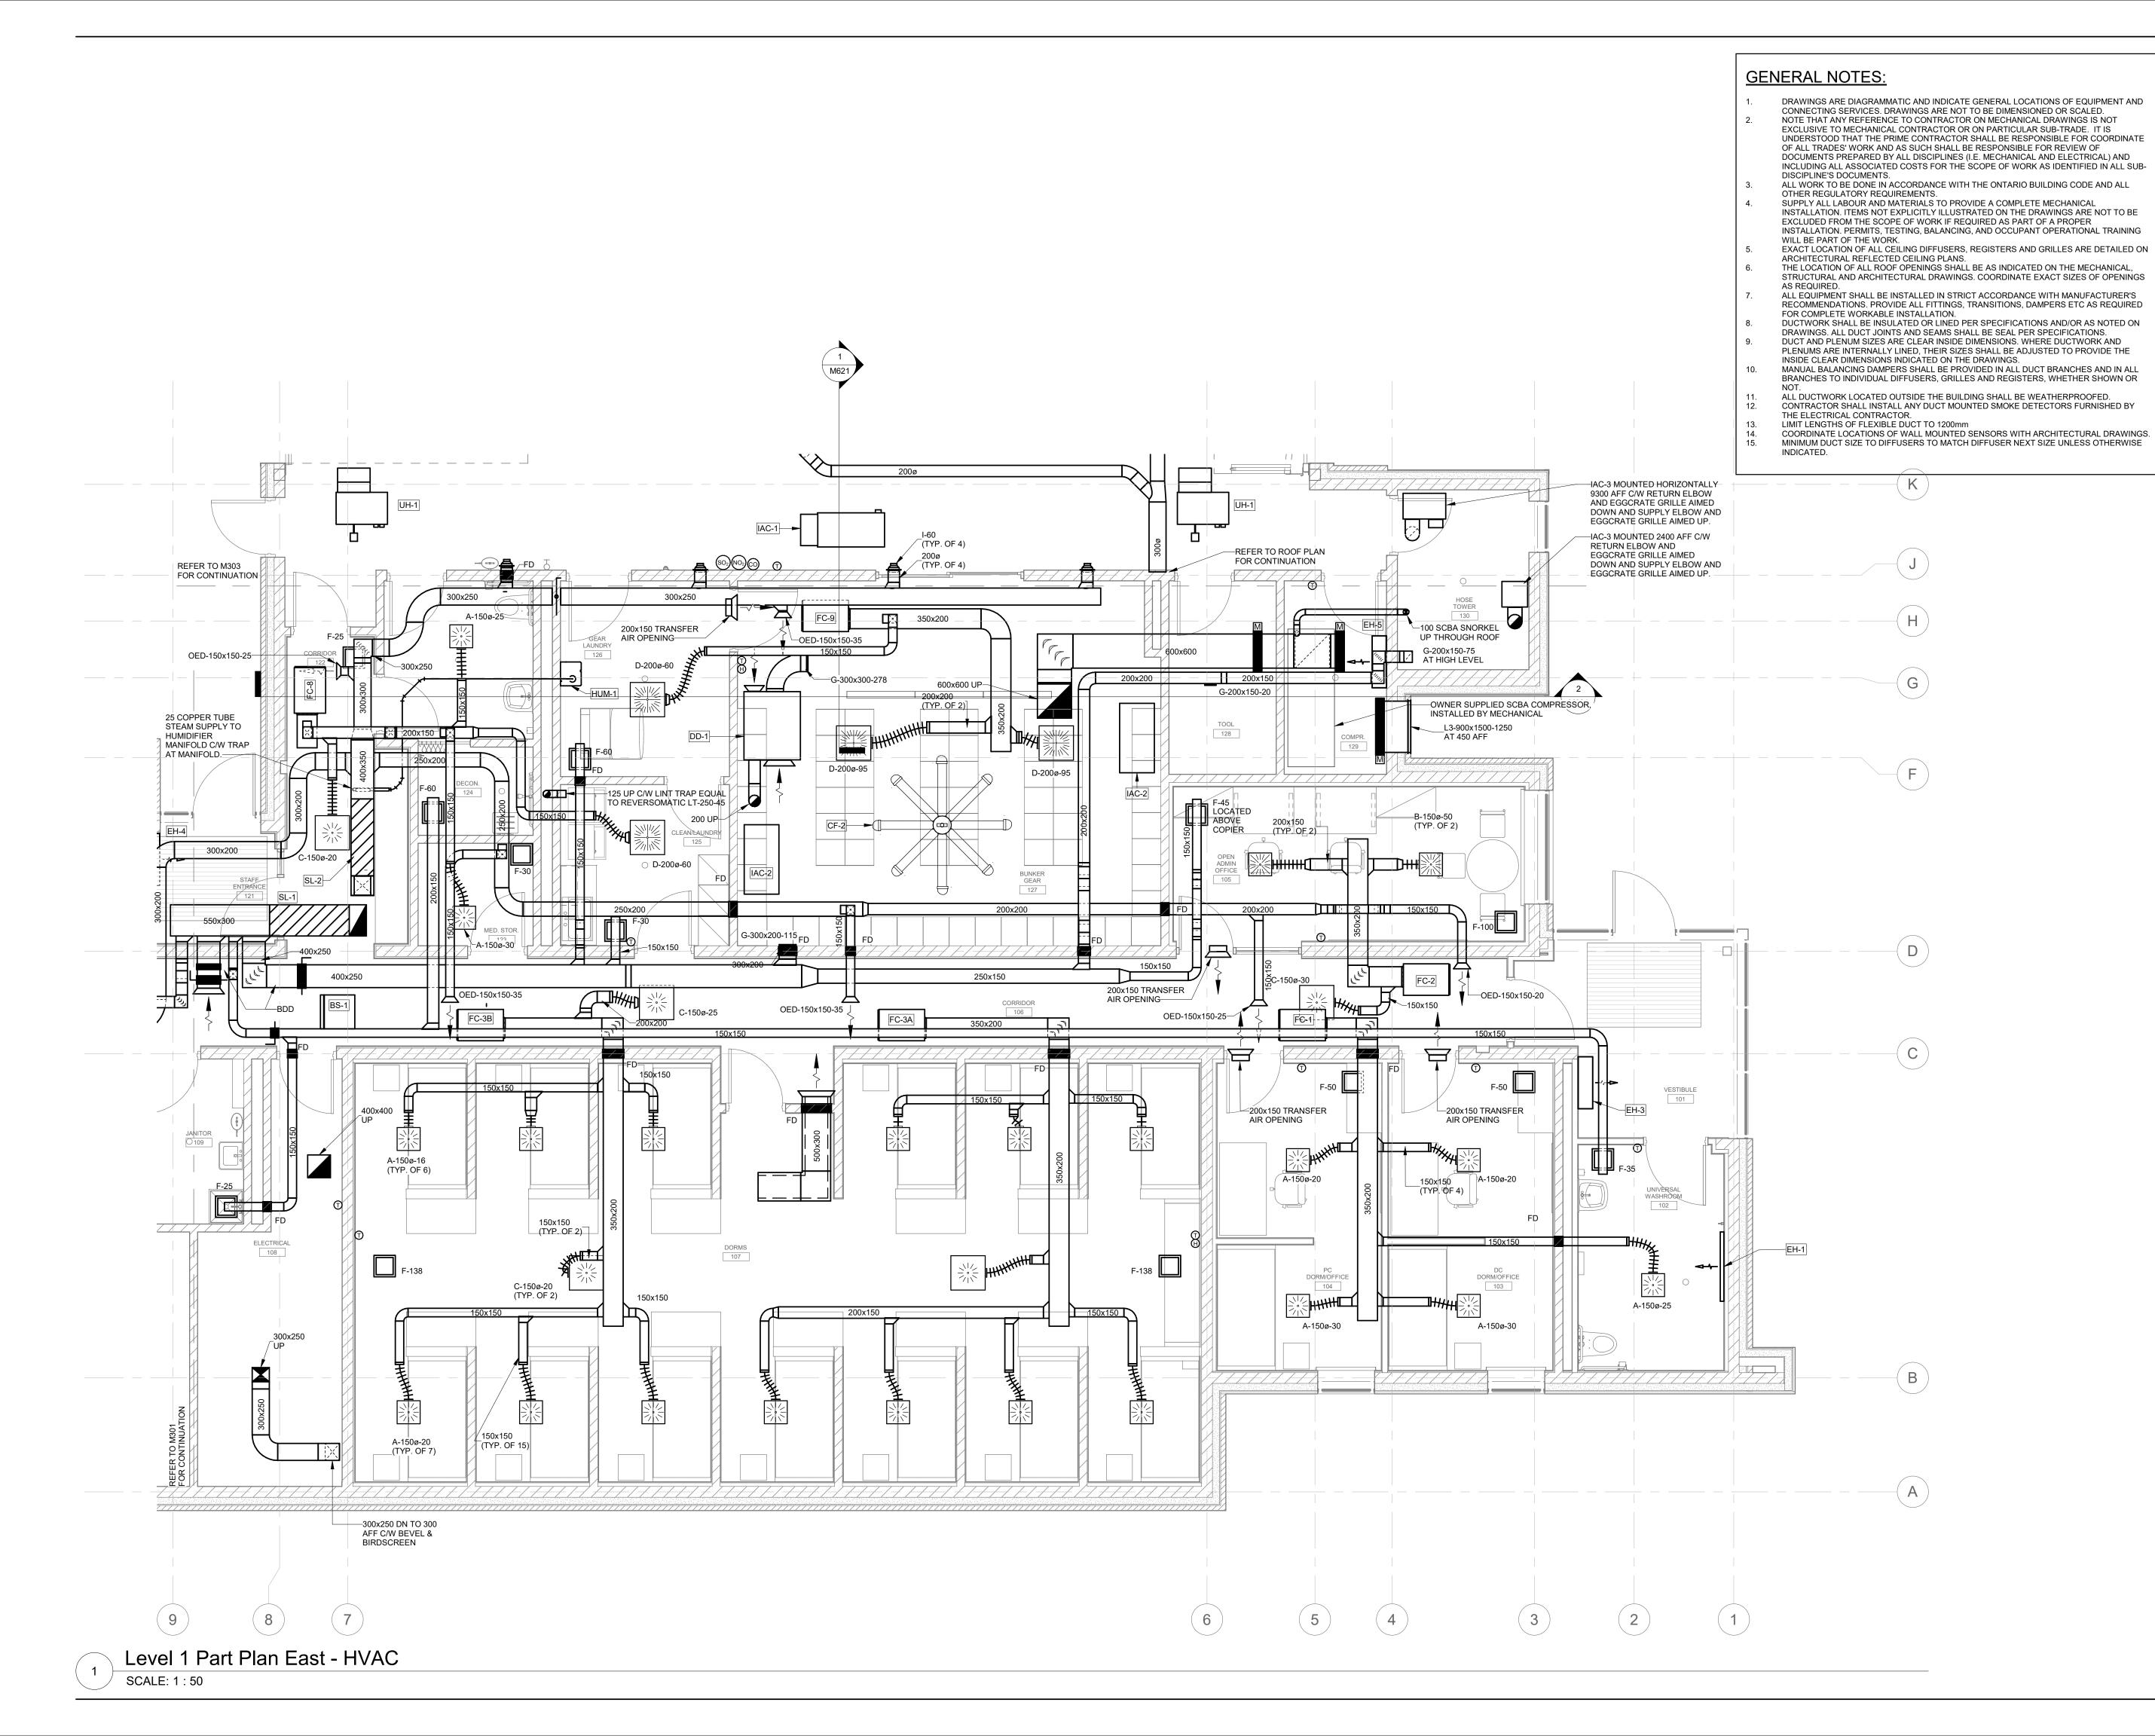

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G	ISSUED FOR CONSTRUCTION	2021-12-
F	REISSUED FOR BUILDING PERMIT	2021-09-
Е	ISSUED FOR TENDER	2021-08-
D	ISSUED FOR BUILDING PERMIT	2021-07-
С	90% CD	2021-05-
В	SPA	2021-02-
Α	50% CD	2021-02-
NI-	Davisian	Dete
No.	Revision	Date

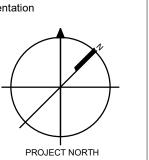

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Project Information

BFES Station 201 (SPA-2021-0032)


27 Rutherford Rd. S., Brampton, ON, L6W 3J3

City of Brampton Fire & Emergency Services Drawing Title

LEVEL 1 PART PLAN EAST - VENTILATION

Date 2021-12-20	Project No	Drawing
Orawn by CMW	CM-20-063	M3

As indicated

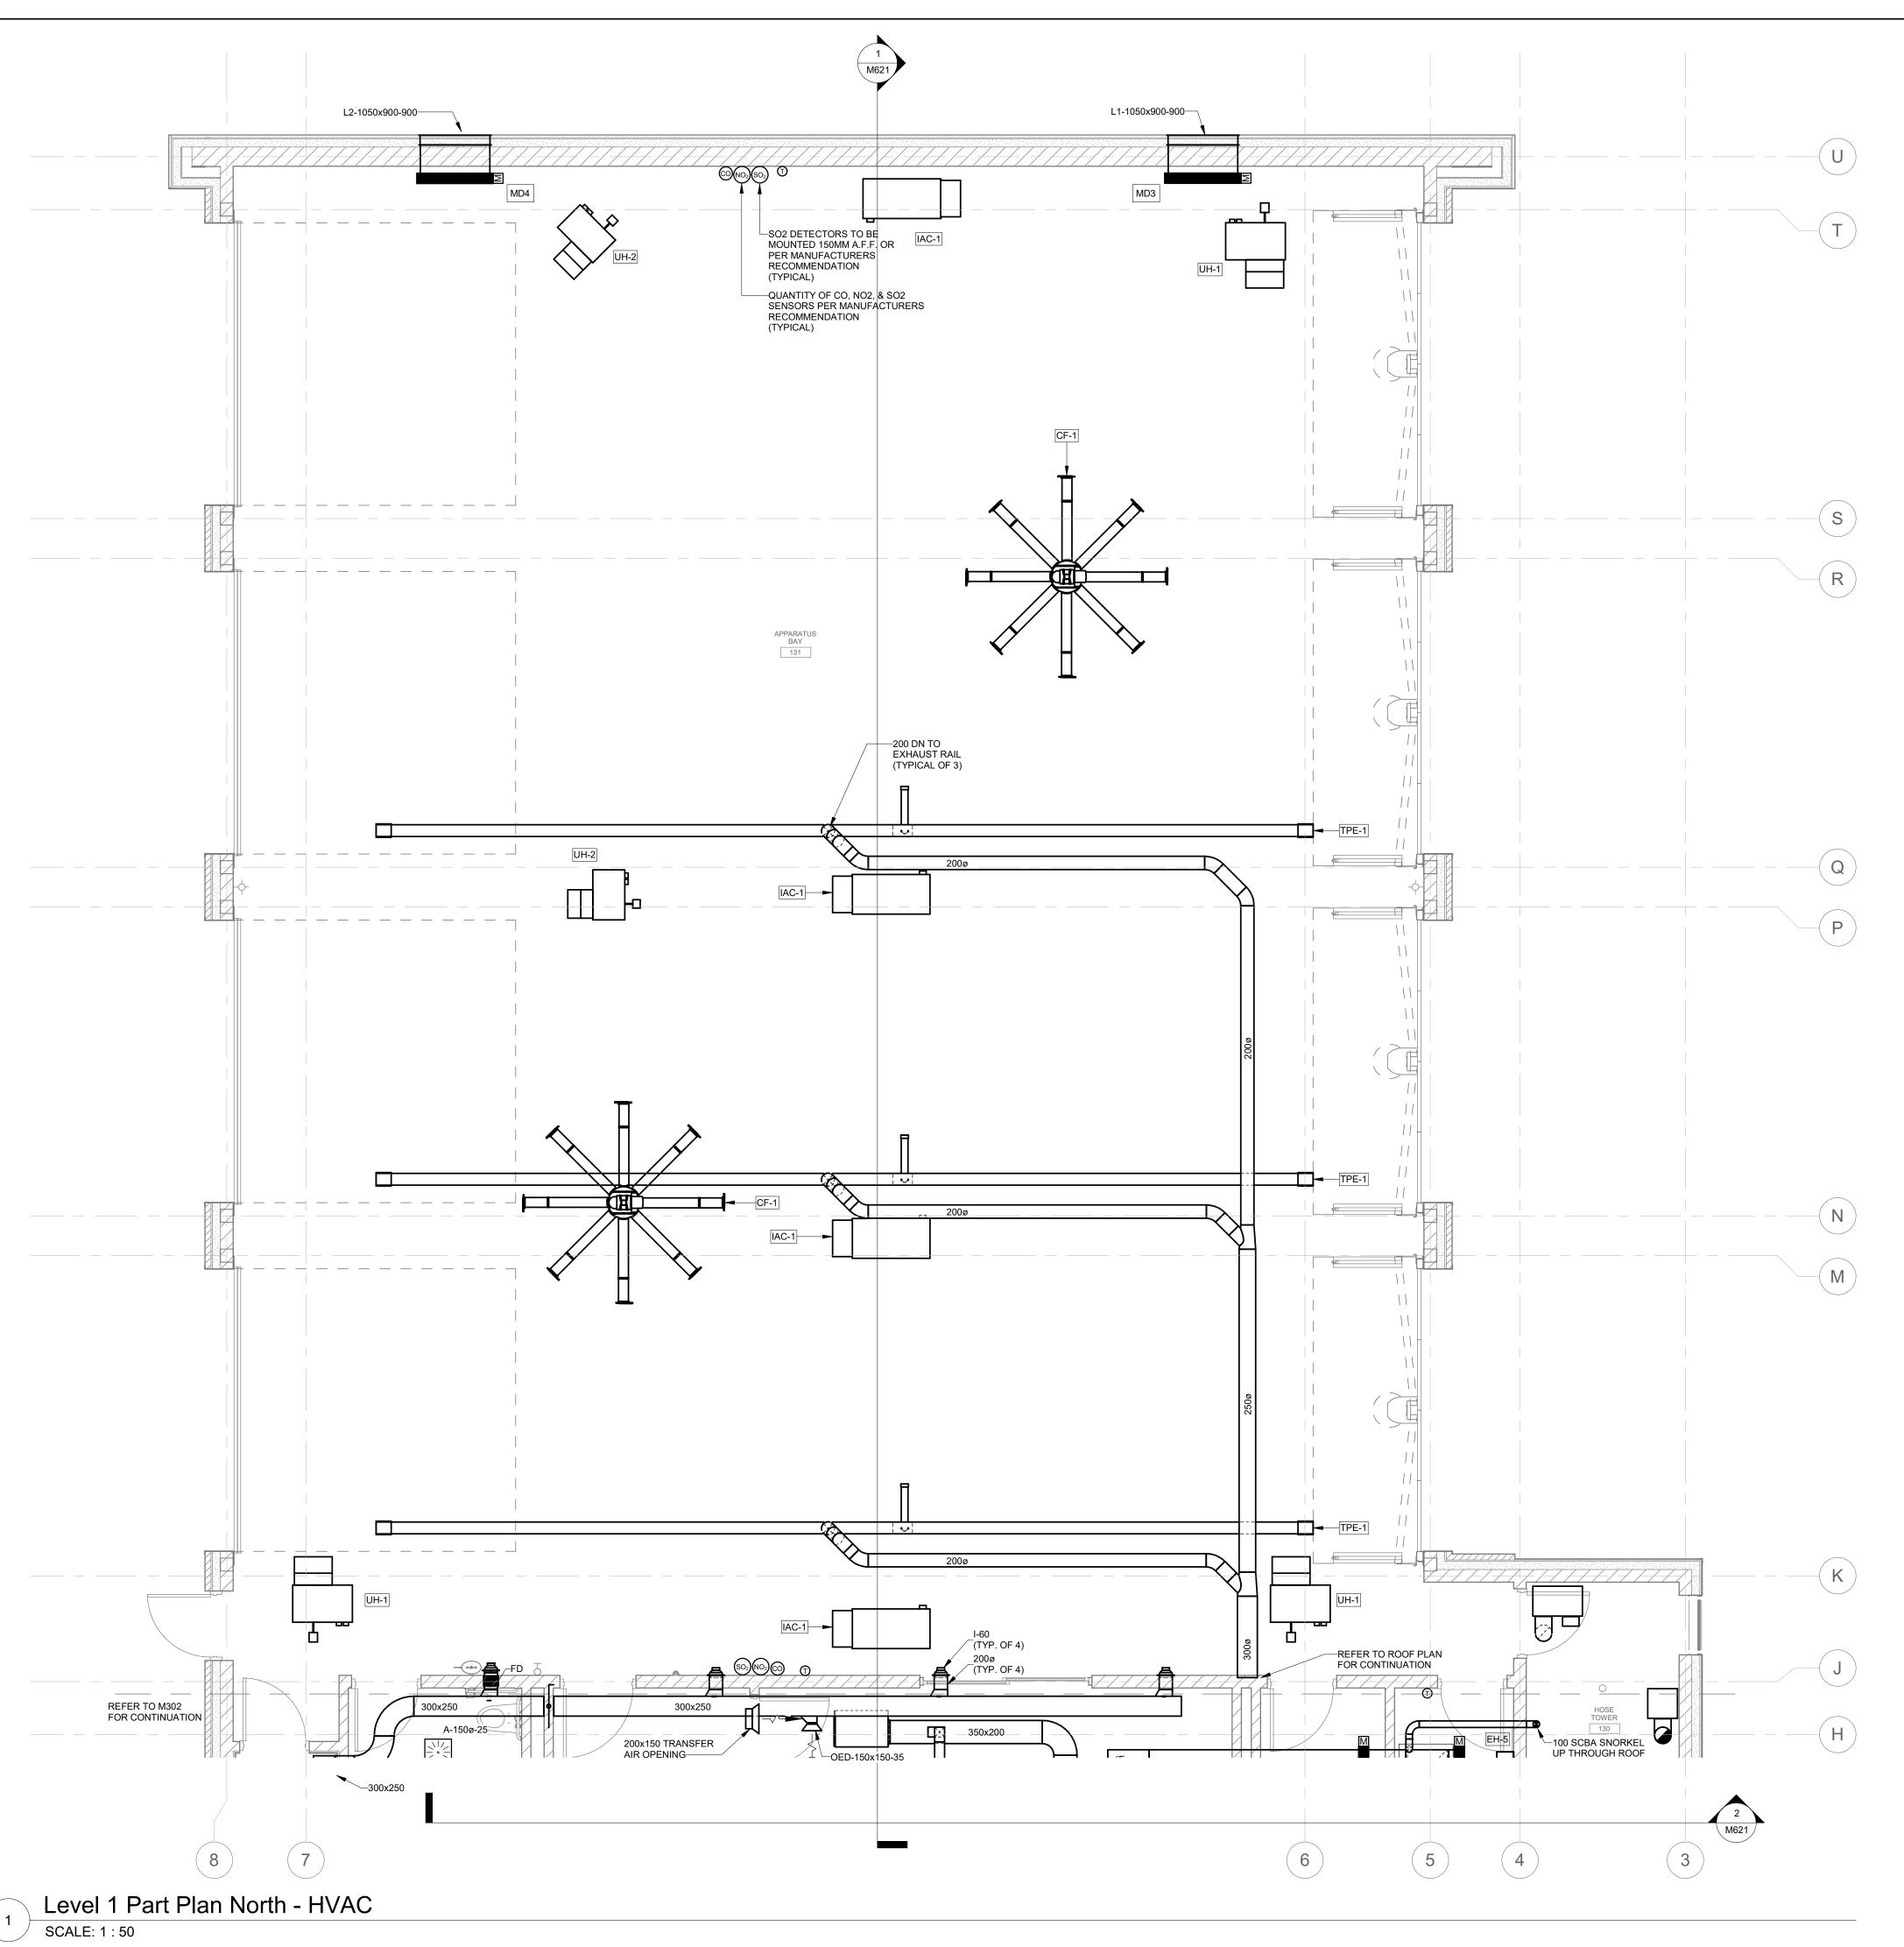

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- WILL BE PART OF THE WORK.


 EXACT LOCATION OF ALL CEILING DIFFUSERS, REGISTERS AND GRILLES ARE DETAILED ON ARCHITECTURAL REFLECTED CEILING PLANS.

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 THE ELECTRICAL CONTRACTOR.
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 COORDINATE LOCATIONS OF WALL MOUNTED SENSORS WITH ARCHITECTURAL DRAWINGS.
- MINIMUM DUCT SIZE TO DIFFUSERS TO MATCH DIFFUSER NEXT SIZE UNLESS OTHERWISE

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F ISSUED FOR CONSTRUCTION
E ISSUED FOR TENDER
D ISSUED FOR BUILDING PERMIT 2021-12-20 2021-08-12 90% CD 2021-05-03 2021-02-12 2021-02-05



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27 Rutherford Rd. S., Brampton, ON, L6W 3J3

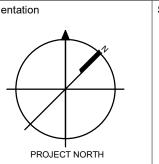
City of Brampton Fire & Emergency Services

Drawing Title

LEVEL 1 PART PLAN NORTH - VENTILATION


Project No Drawing No 2021-12-20 Drawn by CM-20-063 M303 Scale

As indicated

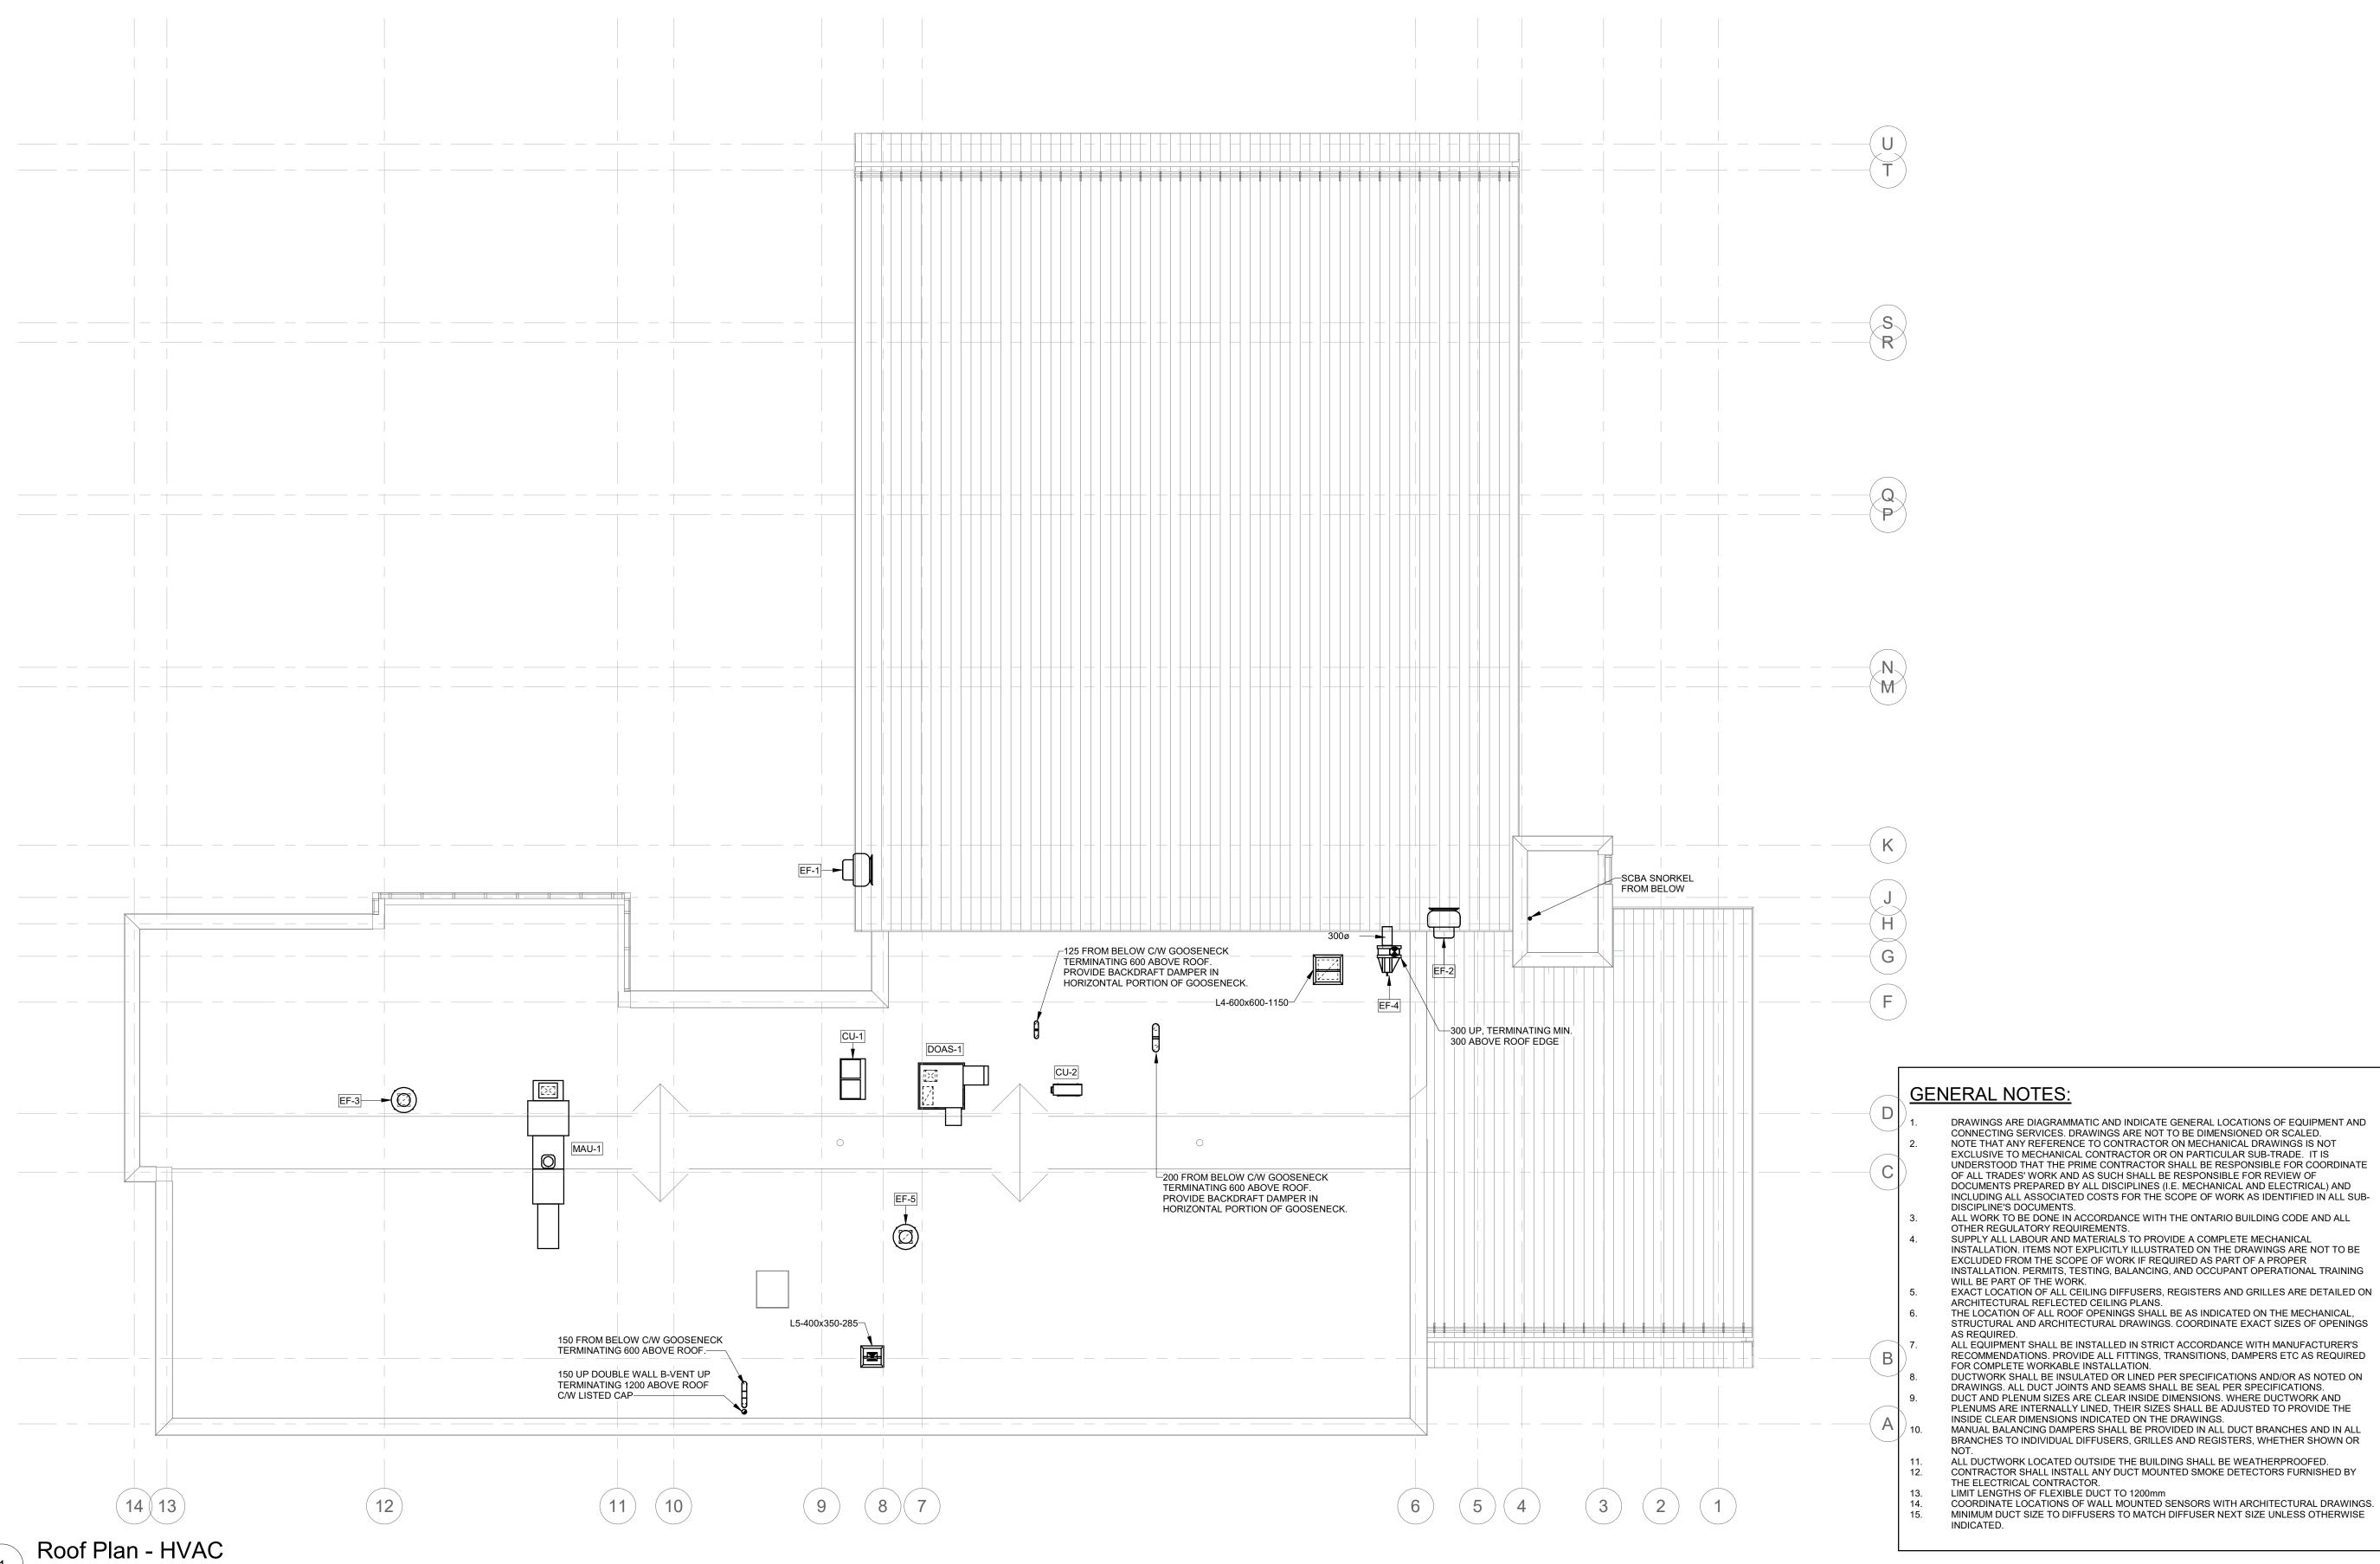

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	EMAIL: CM-20-063@QUASAI	(CG.COIVI
J	ISSUED FOR CONSTRUCTION	2021-12-
- 1	REISSUED FOR BUILDING PERMIT	2021-09-
Н	ISSUED FOR TENDER	2021-08-
G	ISSUED FOR BUILDING PERMIT	2021-07-
F	90% CD	2021-05-
Е	SPA	2021-02-
D	50% CD	2021-02-
С	BUILDING PERMIT	2021-02-
В	PERMIT/SPA COORDINATION	2021-02-
Α	100% DESIGN DEVELOPMENT	2021-01-
		-
No.	Revision	Date

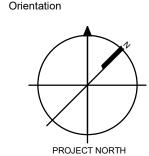

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City of Brampton Fire & Emergency Services Drawing Title

ROOF PLAN -**VENTILATION**

As indicated

Scale


Project No Drawing No 2021-12-20

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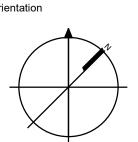
ALL DUCTWORK LOCATED OUTSIDE THE BUILDING SHALL BE WEATHERPROOFED.
CONTRACTOR SHALL INSTALL ANY DUCT MOUNTED SMOKE DETECTORS FURNISHED BY
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LIMIT LENGTHS OF FLEXIBLE DUCT TO 1200mm
COORDINATE LOCATIONS OF WALL MOUNTED SENSORS WITH ARCHITECTURAL DRAWINGS.

MINIMUM DUCT SIZE TO DIFFUSERS TO MATCH DIFFUSER NEXT SIZE UNLESS OTHERWISE



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I	ISSUED FOR CONSTRUCTION	2021-12-20
Н	ISSUED FOR TENDER	2021-08-12
G	ISSUED FOR BUILDING PERMIT	2021-07-27
F	90% CD	2021-05-03
E	SPA	2021-02-12
D	50% CD	2021-02-05
С	BUILDING PERMIT	2021-02-05
В	PERMIT/SPA COORDINATION	2021-02-02
Α	100% DESIGN DEVELOPMENT	2021-01-19
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City of Brampton Fire & Emergency Services

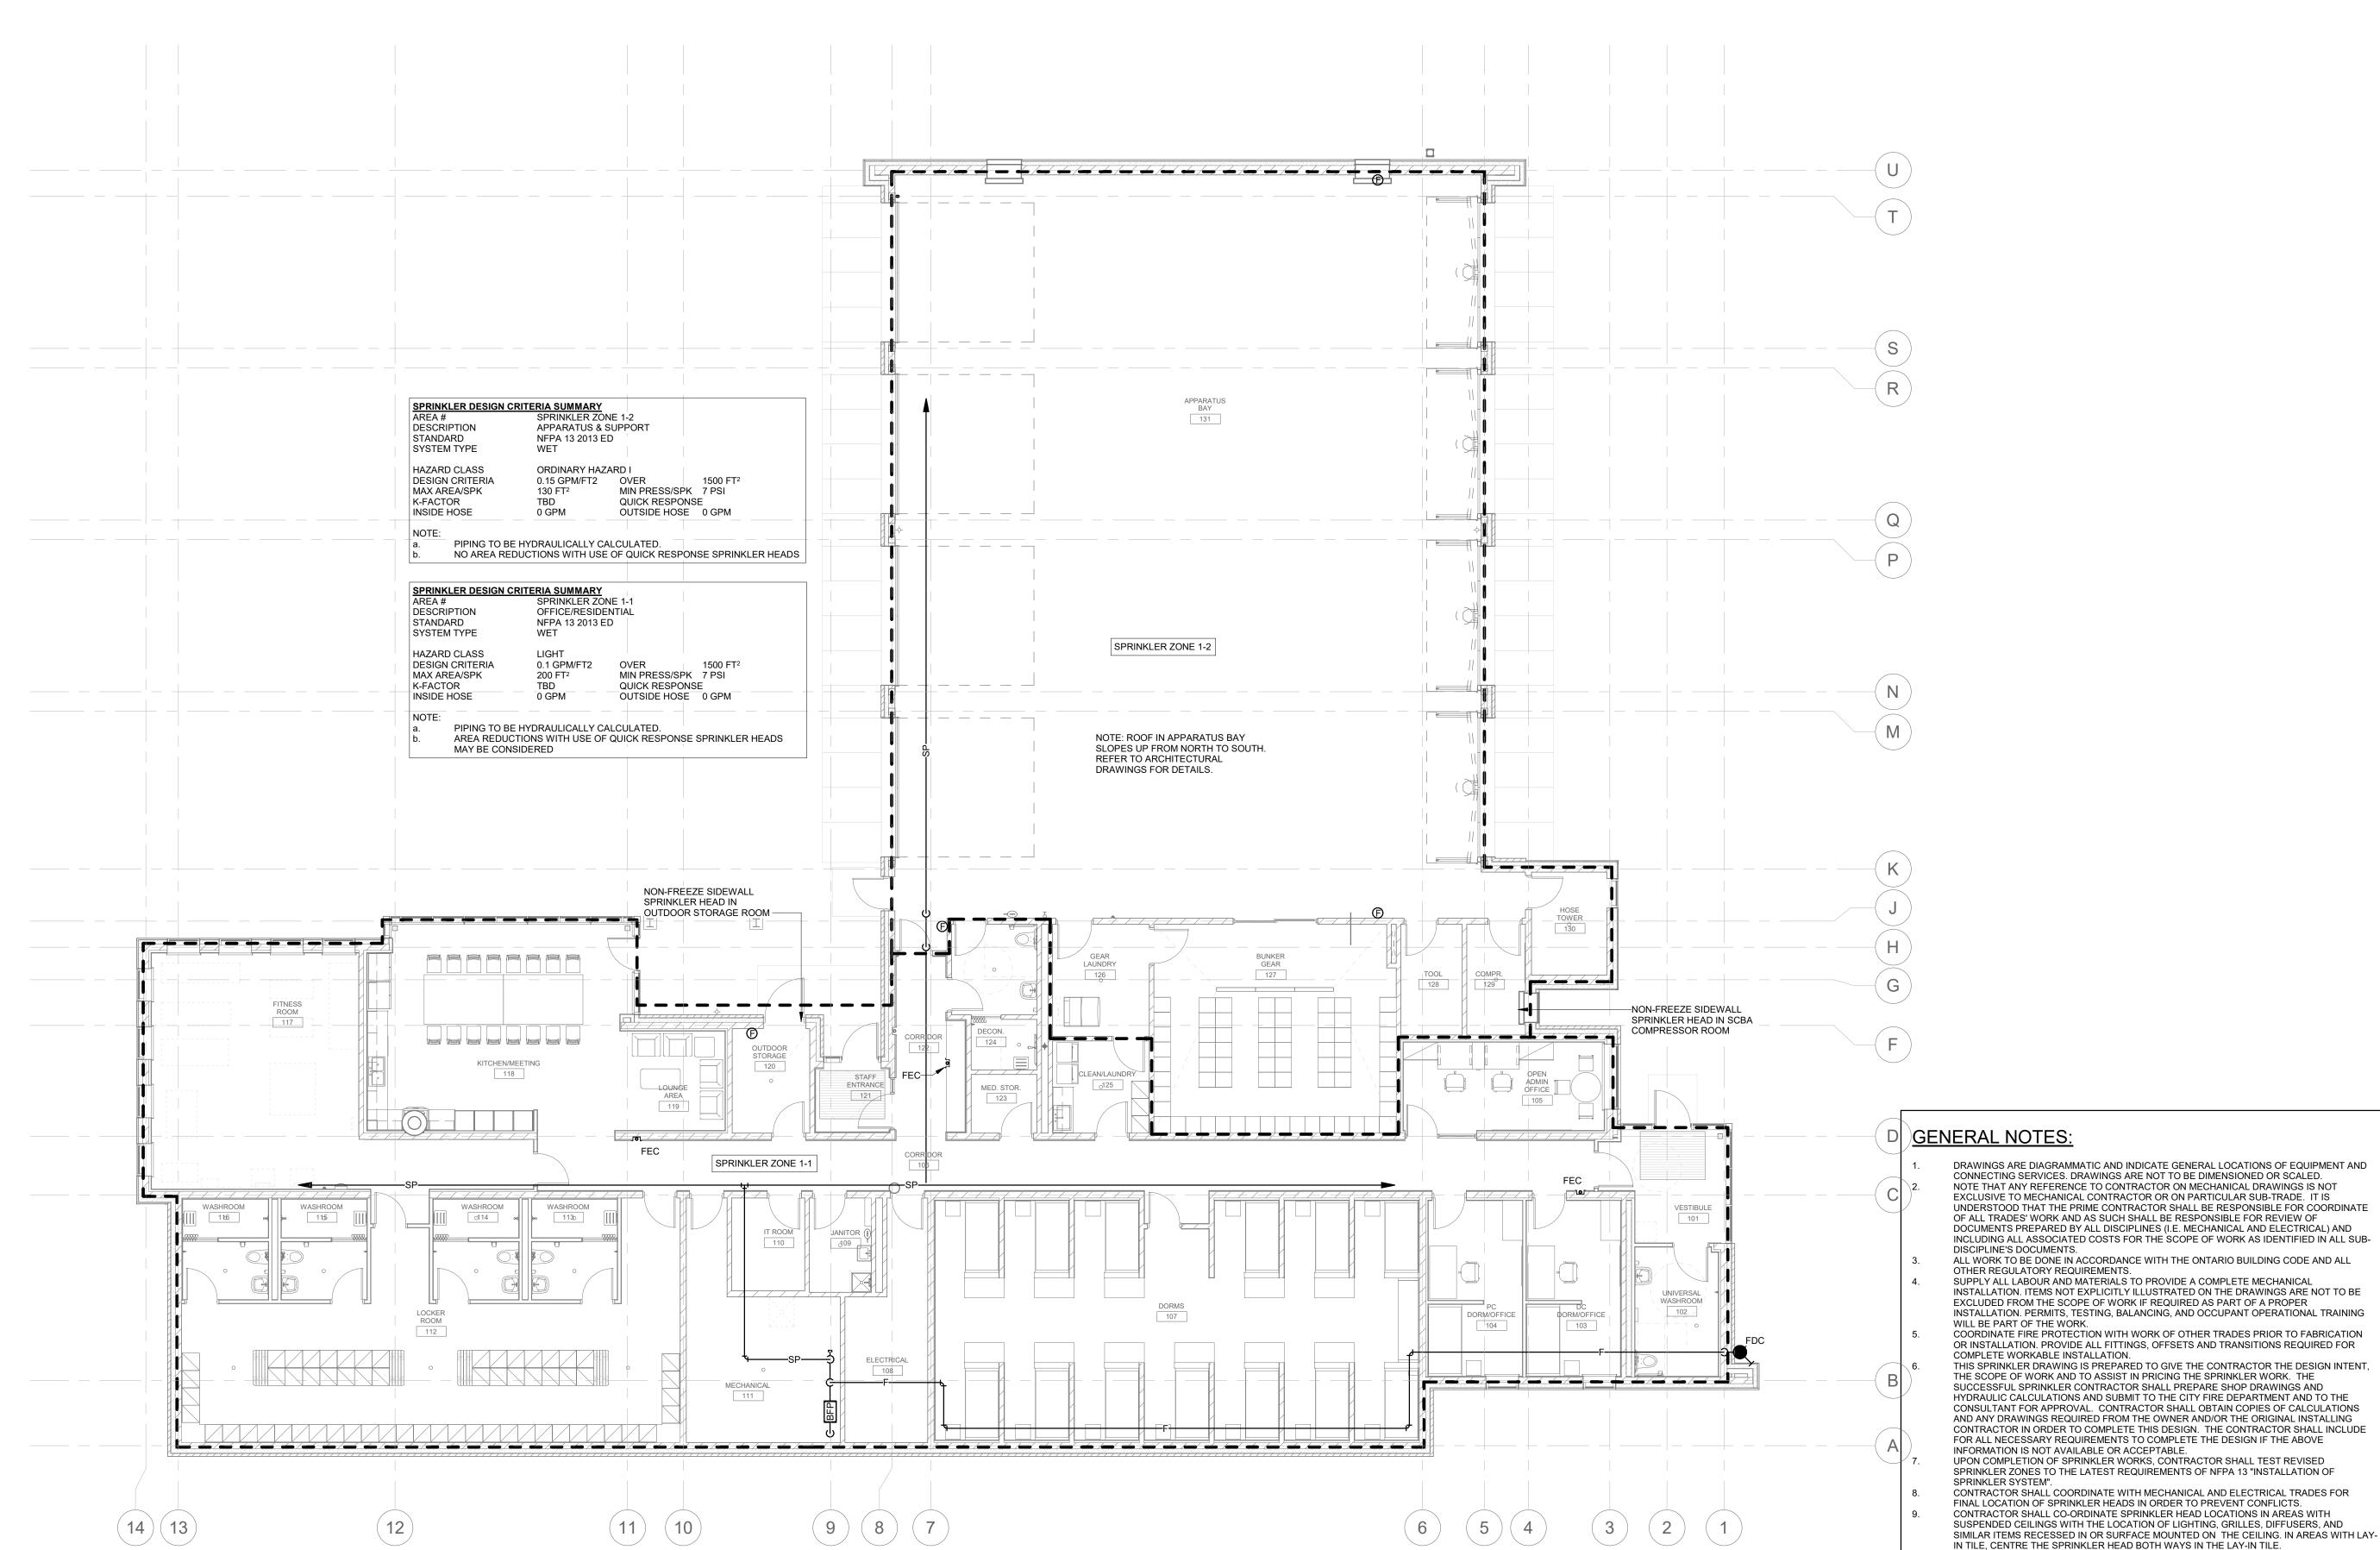
Drawing Title LEVEL 1 PLAN - FIRE **PROTECTION**


Project No Drawing No 2021-12-20


FINAL LOCATION OF SPRINKLER HEADS IN ORDER TO PREVENT CONFLICTS. CONTRACTOR SHALL CO-ORDINATE SPRINKLER HEAD LOCATIONS IN AREAS WITH SUSPENDED CEILINGS WITH THE LOCATION OF LIGHTING, GRILLES, DIFFUSERS, AND SIMILAR ITEMS RECESSED IN OR SURFACE MOUNTED ON THE CEILING. IN AREAS WITH LAY-IN TILE, CENTRE THE SPRINKLER HEAD BOTH WAYS IN THE LAY-IN TILE.

Level 1 Plan - Fire Protection

Scale As indicated

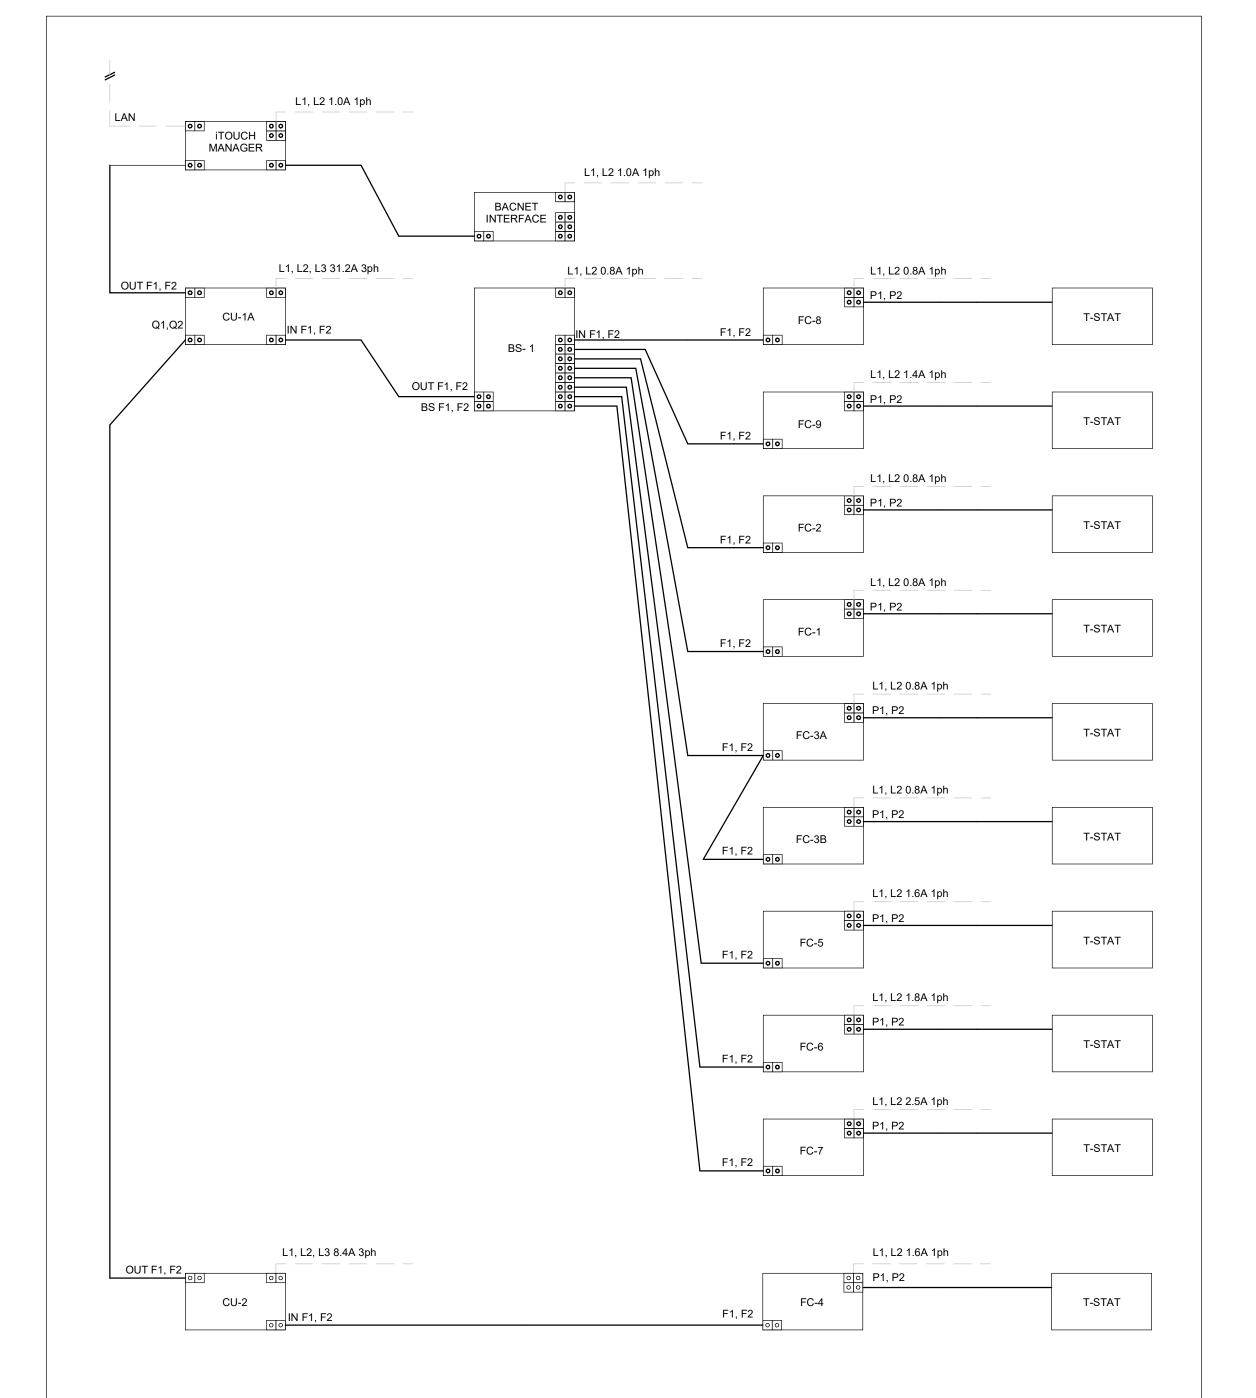

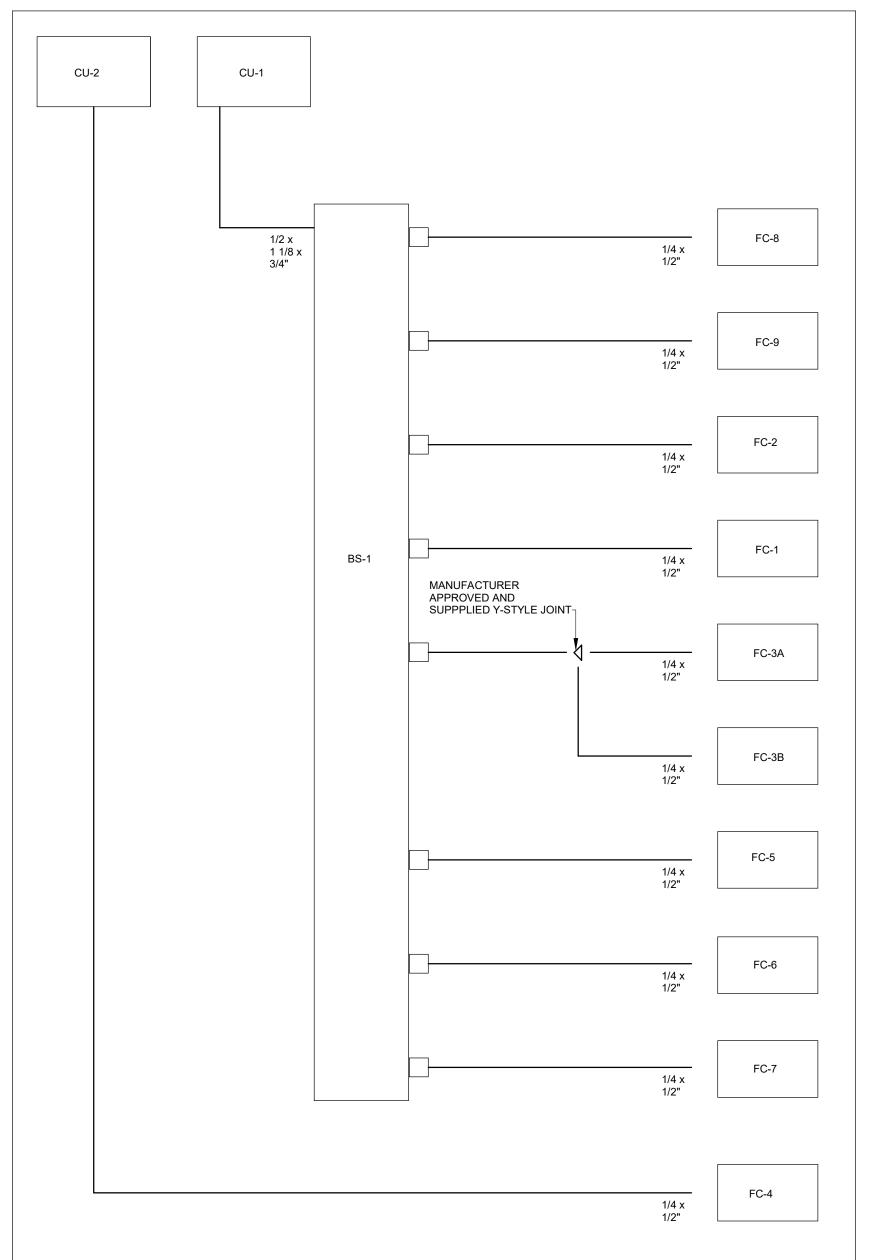

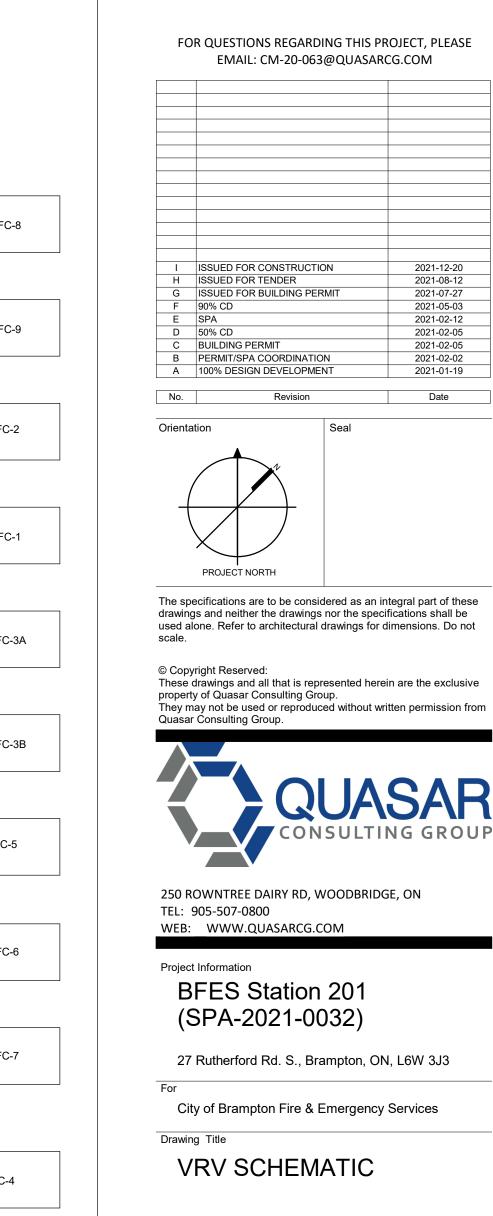

VRV PIPING SCHEMATIC SCALE:N.T.S.


VRV SCHEMATIC

Project No Drawing No 2021-12-20 Drawn by CMW CM-20-063 M601 Scale N.T.S.


EMAIL: CM-20-063@QUASARCG.COM

2021-12-20 2021-08-12 2021-07-27

2021-07-27 2021-05-03 2021-02-12 2021-02-05 2021-02-05 2021-02-02 2021-01-19

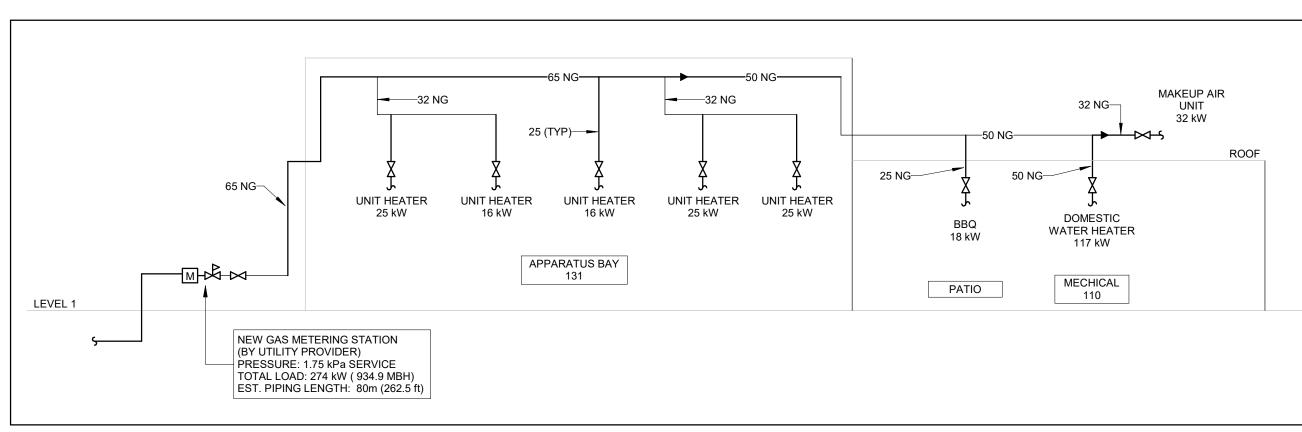

NATURAL GAS SCHEMATIC SCALE:N.T.S.

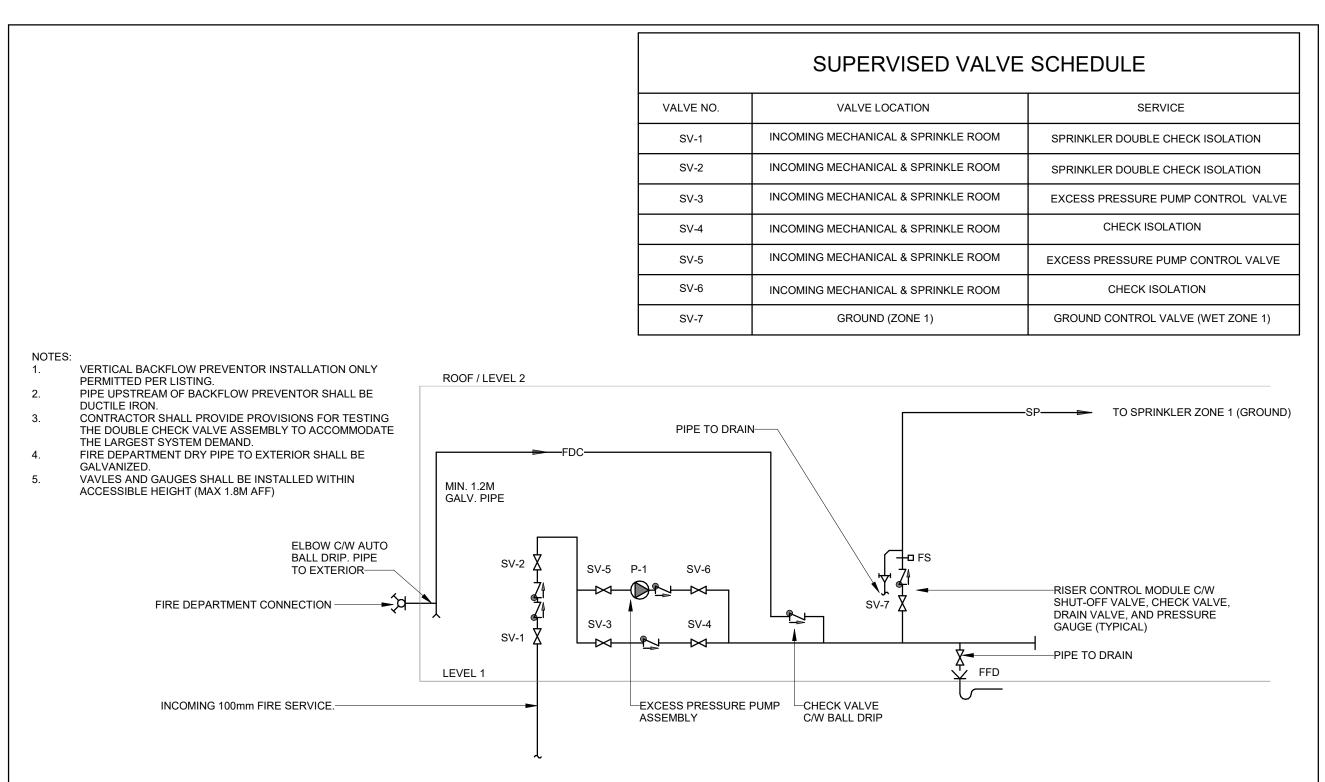

FIRE PROTECTION SCHEMATIC

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Н	ISSUED FOR TENDER	2021-08-12
G	ISSUED FOR BUILDING PERMIT	2021-07-27
F	90% CD	2021-05-03
E	SPA	2021-02-12
D	50% CD	2021-02-05
С	BUILDING PERMIT	2021-02-05
В	PERMIT/SPA COORDINATION	2021-02-02
Α	100% DESIGN DEVELOPMENT	2021-01-19
No.	Revision	Date

Orientation

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Project Information

BFES Station 201 (SPA-2021-0032)

27 Rutherford Rd. S., Brampton, ON, L6W 3J3

City of Brampton Fire & Emergency Services

Drawing Title

FIRE PROTECTION & GAS SCHEMATIC

Project No Drawing No 2021-12-20 Drawn by CMW Scale N.T.S.

	SILENCERS																			
TAG	SERVICE	MANUFACTURER	TYPE	MODEL	WIDTH	HEIGHT	LENGTH	AIRFLOW	VELOCITY	IDEAL DP	MAX DP W/	MININ	UM [OYNA	VIIC II	NSERT	ION I	LOSS	(dB)	REMARKS
					(mm)	(mm)	(mm)	(L/s)	(m/s)	(Pa)	SYS. EFF. (Pa)	1	2	3	4	5	6	7	8	
SL-1	DOAS RETURN	VIBRO-ACOUSTICS	RED	RED-L27621	550	300	1800	612	-4	30	72	9	17	25	34	46	47	34	24	REFER TO NOTE 6,7.8
SL-2	DOAS SUPPLY	VIBRO-ACOUSTICS	RED	RED-L27621	400	350	1800	612	4	33	52	6	11	21	27	39	38	31	25	REFER TO NOTE 6,7.8
NOTES:												•								

1. TYPE R - RECTANGULAR E- ELBOW D -DISSIPATIVE

2. VELOCITY SHOWN IS + (FORWARD FLOW) OR - (REVERSE FLOW) AS DEFINED BY ASTM E477-13. 3. IDEAL PRESSURE DROP AS DETERMINED PER ÀSTM E477-13 IN Á NVLAP-ACCREDITED ACOUSTICAL LABORATORY.

4. PRESSURE DROP PER ASTM E477-13 PLUS SYSTEM EFFECTS FOR NEARBY DUCT ELEMENTS.

5. MINIMUM DYNAMIC INSERTION LOSS DETERMINED PER ASTM E477-13 IN A NVLAP-ACCREDITED ACOUSTICAL LABORATORY. 6. NON-BASIS OF DESIGN SILENCER MANUFACTURER SHALL PROVIDE, FOR APPROVAL, PROFESSIONAL ENGINEER STAMPED ACOUSTICAL CALCULATIONS FOR ALL SYSTEMS WITH SILENCERS TO DEMONSTRATE THAT THE RESULTANT DUCTBORNE FAN SOUND

LEVELS, INCLUDING AIRBORNE AND BREAKOUT NOISE, MEET NC-30 IN THE OCCUPIED SPACES. 7. NON-BASIS OF DESIGN SILENCER MANUFACTURER SHALL PROVIDE, FOR APPROVAL, PROFESSIONAL ENGINEER STAMPED PRESSURE DROP CALCULATIONS FOR ALL SYSTEMS WITH SILENCERS TO DEMONSTRATE THAT THE RESULTANT INSTALLED PRESSURE DROP WITH SYSTEM EFFECTS DOES NOT EXCEED SCHEDULED VALUES.

8. FOR NON-BASIS OF DESIGN PRODUCT SUPPLIED, CONTRACTOR IS FINANCIALLY RESPONSIBLE TO ENSURE NOISE CONTROL SOLUTION IS DELIVERED TO MEET NC-30 IN THE OCCUPIED SPACES.

	GAS-FIRED UNIT HEATERS													
TAG	TYPE	MANUFACTURER	MODEL	LOCATION	QTY	GAS INPUT (kW)	GAS OUTPUT (kW)	COMBUSTION EFFICIENCY	AIRFLOW (L/S)	ELECTRICAL V/Ph/Hz	WEIGHT (kg)	REMARKS		
UH-1	CONDENSING	MODINE	PTC 85SS0111S	APPARATUS BAY	4	25 kW	23.2	98%	779	115/1/60	64	C/W 60 DEGREE HOOD		
UH-2	CONDENSING	MODINE	PTC 55SS0111S	APPARATUS BAY	1	16 kW	15.0	98%	518	115/1/60	45	C/W 60 DEGREE HOOD		

	PUMPS											
TAG	TYPE	MANUFACTURER	MODEL	LOCATION	FLOW (L/s)	HEAD (kPa)	MAX POWER (W)	FLA (A)	V/Ph/Hz	WEIGHT (kg) (KG)	REMARKS	
P-1	DHW RE-CIRC.	ARMSTRONG	ASTRO 225BS	CORRIDOR	0.07	32.8	75	0.64	115/1/60	3		

	DESICCANT DEHUMIDIFIER																	
TAG	MANUFACTURER	MODEL	PROCESS AIRFLOW (L/s)		REGEN. AIRFLOW (L/s)		SPACE CC	% RH	CAPACITY (kg/hr)	SOUND (dB)	POWER	ECTRIC FLA	AL V/Ph/Hz	HEIGHT (MM)	WIDTH (MM)	DEPTH (MM)	WEIGHT (kg)	REMARKS
DD-1	CONDAIR	DA 600	278	303.4	97	200.0	20.0	60	7.1	62	11.90 kW	33.1 A	208/3/60	910	1199	991	195	

	ELECTRIC HEATERS													
TAG	TYPE	MANUFACTURER	MODEL	LOCATION	CAPACITY	AIRFLOW	ELECTRICAL	REMARKS						
IAG	ITPE	WANUFACTURER	WIODEL	LOCATION	CAPACITI	(L/S)	V/Ph/Hz	REMARKS						
EH-1	BASEBOARD HEATER	OUELLET	OCB1008-RT	WASHROOM 102	1 kW	0	208/1/60	WALL MOUNTED						
EH-2	BASEBOARD HEATER	OUELLET	OCB1008-RT	MECHANICAL 111	1 kW	0	208/1/60	WALL MOUNTED						
EH-3	CABINET ELECTRIC HEATER	OUELLET	OLA02038-RT	VESTIBULE 101	2 kW	118	208/1/60	WALL MOUNTED - SEMI RECESSED						
EH-4	CABINET ELECTRIC HEATER	OUELLET	OLA02038-RT	VESTIBULE 121	2 kW	118	208/1/60	WALL MOUNTED - SEMI RECESSED						
EH-5	CABINET ELECTRIC HEATER	OUELLET	OLA02038-RT	COMPRESSOR RM	2 kW	118	208/1/60	WALL MOUNTED						

	LOUVRES													
TAG	TYPE	MANUFACTURER	MODEL	LENGTH	HEIGHT	AIRFLOW (L/s)	REMARKS							
L1	STORM	E.H. PRICE	DE635	1050	900	900	5.1 SQ.m. FREE AREA MINIMUM							
L2	STORM	E.H. PRICE	DE635	1050	900	900	5.1 SQ.m. FREE AREA MINIMUM							
L3	STORM	E.H. PRICE	2630/2635	600	1500	1250	1.8 SQ.m. FREE AREA MINIMUM							
L4	GRAVITY RELIEF PENTHOUSE	COOK	24X24X4 TRE	610	450	1150	0.67 SQ.m. FREE AREA MINIMUM. WIDTH = LENGTH. PD=25Pa							
L5	LOUVER PENTHOUSE	COOK	14X16X2 TRE	650	225	285	2.62 SQ.m. FREE AREA MINIMUM. WIDTH = LENGTH. PD=12.5Pa							

	EXPANSION TANKS												
			BASIS OF	DESIGN	VOLUME	TANK	MAX OPERATING						
TAG	LOCATION	SERVICE	MANUFACTURER	MODEL	(L)	ACCEPTANCE (L)	PRESSURE (kPa)	REMARKS					
ET-1	MECHANICAL ROOM	DOMESTIC WATER	WATTS	DETA 20	32	20	1034						

			INDUSTRIAL	AIR CLE	EANERS				
TAG	SERVICE	MANUFACTURER	MODEL	AIRFLOW	FAN MOTOR	ELECTR	ICAL	WEIGHT	REMARKS
IAG	SERVICE	WANUFACTURER	IVIODEL	(L/S)	(kW)	V/Ph/Hz	FLA	(kg)	REWARKS
IAC-1	APPARATUS BAY	AIRMATION	AMB302-NDR	1416	0.75	208/3/60	7.5	108.9	REFER TO NOTES 1&4
IAC-2	BUNKER GEAR	AIRMATION	MICROCON CD	378	0.24	120/1/60	2.4	56.7	REFER TO NOTES 2 & 4
IAC-3	HOSE TOWER	AIRMATION	MICROCON AS	283	0.23	120/1/60	2.4	15.0	REFER TO NOTES 3 & 4
NOTES:									

1. C/W PRE-FILTER, FINAL FILTER, GAS PHASE FILTER AND TCMMB CONTROLLER.
2. CEILING HUNG UNIT C/W VIBRATION ISOLATORS.

3. PORTABLE UNIT TO HAVE WHEELS REMOVED AND SHALL BE WALL MOUNTED OUT OF THE WAY AND C/W DUCTWORK TO AVOID RECIRCULATION AS INDICATED ON PLANS. 4. INSTALL AS PER MANUFACTURER INSTRUCTION.

		PLUI	MBING FIXT	JRE SCHEDI	JLE	
FIXTURE TAG	DESCRIPTION		CONNEC	CTION SIZES		REMARKS
TIXTORE TAG	DESCRIPTION		DHW	SAN	VENTOCW	I NEWAKKS
WC-1/WC-2	WC - Flush Valve	25	n/a	100	38	
L-1/L-2	Lavatory	12	12	32	32	
S-1	Private Single Comp. Sink	12	12	38	32	
S-1	Private Two Comp. Sink	12	12	38	32	
S-1	Kitchen Single Comp. Sink	12	12	38	32	
S-2	Kitchen Two Comp. Sink	12	12	38	32	
S-3	Kitchen Three Comp. Sink	12	12	50	38	
JS-1	Mop / Janitor's Sink	20	20	75	38	
SH-1	Shower	12	12	50	38	
DW-1	Dishwasher (Domestic)	n/a	12	38	32	INDIRECT CONNECTION TO SINK TAILPIECE
HB-1	Hose Bibb	20	n/a	n/a	n/a	C/W ATMOSPHERIC VACUUM BREAKER
FD-1	4" F.D	n/a	n/a	100	38	
FD-1	3" F.D	n/a	n/a	75	38	
FD-1	2" F.D	n/a	n/a	50	38	
EW-1	Eyewash Station	12	12	38	32	TEMPERED WATER FROM T.M.V

TAG	TYPE	MANUFACTURER	MODEL	LENGTH	WIDTH	REMARKS
Α	SWIRL DIFFUSER	KAMPMANN	KASWIRL-ED-300	300	300	C/W HIGH INDUCTION ECCENTRIC DRUM
В	SWIRL DIFFUSER	KAMPMANN	KASWIRL-ED-400	400	400	C/W HIGH INDUCTION ECCENTRIC DRUM
С	SWIRL DIFFUSER	KAMPMANN	KASWIRL-ED-300/600	600	600	C/W HIGH INDUCTION ECCENTRIC DRUI
D	SWIRL DIFFUSER	KAMPMANN	KASWIRL-ED-500/600	600	600	C/W HIGH INDUCTION ECCENTRIC DRUI
E	SWIRL DIFFUSER	KAMPMANN	KASWIRL-ED-500/600	600	600	C/W HIGH INDUCTION ECCENTRIC DRUM
F	EGG CRATE GRILLE	EH PRICE	85 DAL	300	300	C/W RETURN AIR CANOPY
G	SIDEWALL	E.H. PRICE	85 DAL			
ı	NOZZLE DIFFUSER	E.H. PRICE	ND	0	0	200Ø DIAMETER

					DESTRATIF	ICATIO	N FANS				
TAG	LOCATION	QTY	MANUFACTURER	MODEL	DIAMETER (M)	POWER (kW)	MAX RPM	V/Ph/Hz	SPEED CONTROL	WEIGHT (kg)	REMARKS
CF-1	APPARATUS BAY	2	BIG ASS FANS	PFX3-10	3.0	0.75	160	208/3/60	VFD	105	
CF-2	BUNKER GEAR 127	1	BIG ASS FANS	E7	2.1	0.18	198	115/1/60	DIAL	31	C/W WALL SPEED CONTROL & EXTENSION TUBE TO REACH 10' INSTALL HEIGHT

		V	ARIABLE RI	EFRIGERANT	FLOW	HEAT	RECO	VER'	Y BR	ANCH	SELECTOR	2
TAG	MANUFACTURER	MODEL	ASSOCIATED	MAX CAPACITY	ELI	ECTRICA	L	DIN	MENSIO	NS	WEIGHT (kg)	REMARKS
IAG	WANDFACTORER	WODEL	CONDENSER	(kW)	V/Ph/Hz	MCA	MOCP	W	Н	D	WEIGHT (Kg)	KEWIARRO
BS-1	DAIKIN	BSF8Q54TVJ	CU-1	0.00 kW	208/1/60	0.4	15	579	297	480	33.1 kg	C/W BRANCH SELECTOR CLOSED PIPE KIT

TAG	LOCATION	MANUFACTURER	MODEL	WIDTH (mm)	DEPTH (mm)	AIRFLOW (L/s)	S.P (Pa)	V/Ph/Hz	WEIGHT (kg)	REMARKS
RH-1	KITCHEN	CAPTIVEAIRE	4824 ND-2	1219	1219	378	-153	120/1/60		430 SS WHERE EXPOSED

3. C/W ANSUL R102 COMMERCIAL SUPPRESSION SYSTEM CONTAINED IN INTEGRATED UTILITY CABINET. 4. C/W GREASE FILTERS AND MINIMUM TWO UL LISTED LIGHT FIXTURES

				GAS F	RED HOT W	ATER TANK H	IEATER					
				# OF	GAS - INPUT	RECOVERY RATE			DIAMETER	HEIGHT	FLUE SIZE	
TAG	MANUFACTURER	MODEL	LOCATION	HEATERS	CAPACITY	(LPH @ 37.7C)	STORAGE CAPACITY	V/Ph/Hz	(mm)	(mm)	(mm)	REMARKS
DHWT-1	BRADFORD WHITE	EF-100T-399E-3N (A)	MECHANICAL ROOM	1	117.0 kW	1707	264.90 L	120/1/60	718	1432	76	
				•		•					,	

							EXHA	UST F	ANS												
TAG	SERVICE	LOCATION	MANUFACTURER	MODEL	AIRFLOW (L/s)	E.S.P. (Pa)	POWER (kW)	BHP (kW)	MOTOR RPM	V/Ph/Hz	SPEED CONTROL	1	2	3	OUND 4	POWE 5	R (d	B) 7 8	dB(A)	WEIGHT (kg)	REMARKS
EF-1	APPARATUS BAY EXHAUST	WALL	COOK	180W17D (VF)	900	100	0.19	0.16	703	115/1/60	ECM	59	69	66	61	60 5	5 5	1 48	53	40	REFER TO NOTE 1
EF-2	APPARATUS BAY EXHAUST	WALL	COOK	180W17D (VF)	900	100	0.19	0.16	703	115/1/60	ECM	59	69	66	61	60 5	5 5	1 48	53	40	REFER TO NOTE 1
EF-3	KITCHEN EXHAUST	ROOF	CAPTIVEAIRE	DU50HFA	378	250	0.37	0.24	0	115/1/60	ECM	75	77	83	75	70 6	8 6	4 55	67	55	REFER TO NOTE 2
EF-4	TAILPIPE EXHAUST	ROOF	NEDERMAN	NCF-30/20	920	1493	4.10	0.00	0	208/3/60	VFD	0	0	0	0	0 () (0 0	88	85	REFER TO NOTE 3
EF-5	ELECTRICAL ROOM EXHAUST	ROOF	COOK	120C17DEC	285	75	0.56	0.24	1725	115/1/60	ECM	58	61	58	53	52 4	7 4	2 38	45	14	REFER TO NOTE 2

NOTES: 1. C/W 600mm ROOF CURB, UNIT MOUNTED ADJUSTABLE SPEED CONTROL, REMOTE CONTROL INTERFACE TO CONNECT TO BAS AND APPARATUS BAY GAS DETECTION CONTROLLER.

2. UL705, UL762, & ULC-S645 LISTINGS AND C/W 600mm CURB, GREASE BOX, 0-10V REFERENCE SPEED CONTROL. FAN PROVIDED BY COMMERCIAL HOOD SUPPLIER. 3. C/W TAILPIPE CAPTURE RAILS, HOSES, MAGNETIC GRABBERS, AND CONTROLLER. FAN TO BE MOUNTED ON NON-PENETRATING SUPPORT EQUAL TO PORTABLE PIPE HANGERS EQUIPMENT PLATFORM.

								FAN CC	OIL CAS	SETTI	ES										
							AIR		COOLI	NG		HEATI	NG	ELEC	TRICAL	-	DIME	NSIONS	6 (m)		
TAG	MANUFACTURER	MODEL	NOMINAL	TYPE	ASSOCIATED		RIGERANT AIRFLOW		ITY (kW)	EAT	EAT	CAPACITY	EAT							WEIGHT	REMARKS
.,,,,	III atory to rotter	0222	TONNAGE	=	CONDENSER	TYPE	(L/s)	TOTAL	SENSIBL E	(DB)	(WB)	(kW)	(DB)	V/Ph/Hz	MCA	МОСР	W	Н	D	(kg)	1121111111111
FC-4	DAIKIN	FTX15NMVJU	1.3	WALL MOUNTED UNIT	CU-2	R401A	593	4.4	3.65	26 °C	19 °C	5.36	21 °C	208/1/60	17.0	20	990	295	263	12.0 kg	SEE NOTES

	TONNAGE (kW) OAT (DB) (kW) OAT (DB) OAT (WB) TYPE V/Ph/Hz MCA MOCP RLA W D H EER IEER COP																				
TAG	MANUEACTURER	MODEL		COOLING	CAPACITY	Н	EATING CAPA	CITY		l	ELECTR	RICAL		DIME	ENSION	S (M)	WEIGHT	EF	FICIENC	Y	DEMARKS
IAG	WANUFACTURER	WODEL	TONNAGE	(kW)	OAT (DB)	(kW)	OAT (DB)	OAT (WB)	TYPE	V/Ph/Hz	MCA	MOCP	RLA	W	D	Н	WEIGHT	EER	IEER	COP	KEWAKAS
CU-2	DAIKIN	RXL15QMVJU	REL NOMINAL COOLING CAPACITY HEATING CAPACITY REFRIGERANT ELECTRICAL DIMENSIONS (M) TONNAGE (kW) OAT (DB) (kW) OAT (DB) OAT (WB) TYPE V/Ph/Hz MCA MOCP RLA W D H REMARKS																		

									GAS FIF	RED MA	KEUP AI	R UNITS												
	MANUFACTURER MORE SERVICE NOMINAL COOLING OUTDOOR SUPPLY FAN COOLING												HEATING			EFFICI	IENCY	ELEC.	TRICAL	CONE	DENSING L	INIT ELEC.	WEIGHT	
TAG	MANUFACTURER	MODEL	SERVICE	CAPACITY (TONS)	AIRFLOW (L/s)	AIRFLOW (L/s)	E.S.P (Pa)	SPEED CONTROL	REFRIGERANT		SENSIBLE	GASTYPE	GAS INPUT (kW)	OUTPUT (kW)	FILTER	СОР	SEER	MCA MOC	P V/Ph/Hz	MCA	МОСР	V/Ph/Hz		REMARKS
MAU-1	CAPTIVEAIRE	AI-IBT-150-15D-MPU	KITCHEN HOOD	2	378	378	125	ECM	R410-A	7.0	4.3	NG	31.7	25.4	MERV 8	3.7	14	19 30	115/1/60	14 A	20 A	208/1/60	680	

													DE	DICATE	D OUTS	SIDE	AIR S	YSTE	MS																	
				SUPPL	LY FAN				EXHAU	ST FAN		FII TEDE							ENTHA	LPY W	HEEL P	ERFO	RMANC	E								ELEC.	TRICA	L		
TAG	MANUFACTURER	MODEL	AIDEL OV	V E C B	DOWE		, au	AIDEI OW	ECD	POWER	рир	FILTERS (SUPPLY /	PREHEAT COIL		NCY (%)			COOLING	PERFO	RMAN	E				HEATI	NG PE	RFORM	ANCE				1			WEIGHT REMAR	KG
170	MANOI ACTORER	WIODEL	(I/e)	(Pa)	. FOWE		W)	(L/s)	(Pa)	(kW)	(W)	RETURN)	CAPACITY (kW)	SENSIDI E	LATENT	O.A.	T. (°C)	R.A.T. (°	C) S.	A.T. (°C) E.A	.T. (°C)	O.A.	T. (°C)	R.A.T	. (°C)	S.A.T.	(°C)	E.A.T. (°C) F	LA	MCA M	OCP	V/Ph/Hz	WEIGHT KEWAK	NO
			(113)	(i a)	(KVV)	<u>'</u> '	(**)	(113)	(i a)	(KVV)	(**)	1.2.01,		SENSIBLE	LAIENI	DB	WB	DB W	/B DI	B WE	3 DB	EB	DB	WB	DB	WB	DB	WB	DB	WB						
DOAS-1	COOK	ERV-2500	610	165 Pa	a 0.37	' 2	274	610	180	0.56	386	MERV 13	5.0 kW	81.7	79	30.0	23.0	25.0 18	3.7 25	.5 19.	2 29.4	22.5	-19.6	-20.2	22.0	12.2	17.6	9.8 -	15.3 -	15.4	8	10	15	575/3/60	815 kg NOTES	1&2
NOTES:																																				•

1. UNIT TO BE COMPLETE WITH VARIABLES FREQUENCY DRIVES FOR SUPPLY AND EXHAUST FANS. REFER TO CONTROLS SCHEMATICS FOR OPERATIONAL REQUIREMENTS. PROVIDE REQUIRED INTERFACE CARD FOR VRV BAS REMOTE MONITORING AND SETPOINT CONTROL.

2. CURB TO BE MINIMUM 600MM TALL.

3. COMPLETE WITH HINGED ACCESS DOOR, PURGE SECTION, DOUBLE WALL CONSTRUCTION, GFCI SERVICE OUTLET, ROTATION SENSOR, ENTHALPY ECONOMIZER MODE, INSULATED MOTORIZED CENTRE PIVOT INTAKE DAMPER, MOTORIZED CENTRE PIVOT RETURN DAMPER, MOTORIZED EXHAUST DAMPER.

	VARIABLE REFRIGERANT FLOW CASSETTES																										
						ZONE		AIR	AIR COOLING		HEATI	HEATING EL		LECTRICAL		DIMENSIONS											
TAG	MANUFACTURER	MODEL	NOMINAL		ASSOCIATED	CHANGEOVER	REFRIGERANT	AIRFLOW	CAPAC	ITY (kW)	EAT		CAPACITY							_	WEIGHT (kg)	REMARKS					
	-	10						IONNAGE	TONNAGE	TYPE	CONDENSER	DEVICE TYPE	(L/s)	TOTAL	SENSIBL E	(DB)	EAT (WB)	(kW)	EAT (DB)	V/Ph/Hz	MCA	MOCP	W	н	D	(0)	
FC-1	DAIKIN	FXSQ07TAVJU	0.6	MSP Concealed Ducted Unit	CU-1	Yes	R410A	133	2.07	1.57	26 °C	65 °F	11146.00	19 °C	208/1/60	0.8	15	551	246	800	25.0 kg	c/w NAVIGATION REMOTE CONTROLLER					
FC-2	DAIKIN	FXSQ05TAVJU	0.5	MSP Concealed Ducted Unit	CU- 1	Yes	R410A	133	1.64	1.31	26 °C	65 °F	14444.00	19 °C	208/1/60	0.8	15	551	246	800	25.0 kg	c/w NAVIGATION REMOTE CONTROLLER					
FC-3A	DAIKIN	FXSQ09TAVJU	0.8	MSP Concealed Ducted Unit	CU-1	Yes	R410A	150	2.66	1.91	26 °C	65 °F	11146.00	19 °C	208/1/60	0.8	15	551	246	800	25.0 kg	c/w NAVIGATION REMOTE CONTROLLER					
FC-3B	DAIKIN	FXSQ09TAVJU	0.8	MSP Concealed Ducted Unit	CU-1	Yes	R410A	150	2.66	1.91	26 °C	65 °F	11146.00	19 °C	208/1/60	0.8	15	551	246	800	25.0 kg	c/w NAVIGATION REMOTE CONTROLLER					
FC-5	DAIKIN	FXSQ18TAVJU	1.5	MSP Concealed Ducted Unit	CU-1	Yes	R410A	284	4.95	3.73	26 °C	65 °F	12.50	19 °C	208/1/60	1.6	15	1001	246	800	35.0 kg	c/w NAVIGATION REMOTE CONTROLLER					
FC-6	DAIKIN	FXSQ24TAVJU	2.0	MSP Concealed Ducted Unit	CU-1	Yes	R410A	350	0	0	26 °C	65 °F	12.50	19 °C	208/1/60	1.8	15	0	0	0	0.0 kg						
FC-7	DAIKIN	FXSQ36TAVJU	3.0	MSP Concealed Ducted Unit	CU-1	Yes	R410A	534	9.96	7.09	26 °C	65 °F	42649.00	19 °C	208/1/60	2.5	15	1400	246	800	46.0 kg	c/w NAVIGATION REMOTE CONTROLLER					
FC-8	DAIKIN	FXSQ07TAVJU	0.6	MSP Concealed Ducted Unit	CU-1	Yes	R410A	133	2.07	1.57	26 °C	65 °F	14444.00	19 °C	208/1/60	8.0	15	551	246	800	25.0 kg	c/w NAVIGATION REMOTE CONTROLLER					
FC-9	DAIKIN	FXSQ15TAVJUO	1.3	MSP Concealed Ducted Unit	CU-1	Yes	R410A	250	0	0	26 °C	65 °F	3.27	19 °C	208/1/60	1.4	15	0	0	0	0.0 kg						

VARIABLE REFRIGERANT FLOW AIR-COOLED CONDENSING UNITS																									
TAG	MANUFACTURER	MODEL	NOMINAL	COOLING	CAPACITY	H	HEATING CAP	ACITY	PEAK COINCIDENT	INDOOR UNIT LOAD	REFRIGERANT TYPE	REFRIGE	RANT	CONNECTION RATIO	ELEC	TRICAL (PER N	ODULE)		OVERALL IMENSION		IT	E	FFICIENCY	REMARKS	
			TONNAGE	(kW)	OAT (DB)	(kW)	OAT (DB)	OAT (WB)	COOLING (kW)	HEATING (kW)	ITPE	FACTORY CHARGE	ADD'L CHARGE	RATIO	V/Ph/Hz	MCA MC	CP RL	A W	D	Н	EEF	RIEER	COP47 COP17 SCH	ιΕ	
CU-1	DAIKIN	RELQ120TAYCA	10	35.30	35 °C	33.90	-30 °C	-30 °C	35.0	23.1	R410A	25.8 kg	25.5 kg	110.7%	575/3/60	31 A 4	0 14	A 1241	766	1693 360.00	ka 13.7	23.4	4 2.3 26.	7	

1. Manufacturer must be certified, listed, and labeled per AHRI 1230. 2. Submitted performance data must be fully de-rated for all components and accessories, including but not limited to, line length, vertical separation, connection ratio, design conditions, condenser coil coating.

3. Condensing units must have fully modulating INVERTER compressors.

4. Condensing units must have have auto changeover functions

5. Demand limiting relay contact must be provided. 6. EEV actuators must be removable from valve body without disturbing the refrigerant system.

7. FCU thermostats must provide +/- 1 degree dead-band set-point and control capability.
8. System shall be provided with i-Touch Manager controller with WEB based software for displaying up to 8 DIII-Net systems with 128 indoor units per system.PC by others.

Manufacturers submittal must include refrigerant piping diagram with pipe diameters, lengths, and refrigerant volume.
 Substitute manufacturer shall be responsible for additional piping and refrigerant.

12. Installing contractor must have successfully completed manufacturers certified installation class within past 36 months.

	EMAIL: CM-20-063@QUASAF	RCG.COM
	ISSUED FOR CONSTRUCTION	2021-12-20
J		
H	REISSUED FOR BUILDING PERMIT ISSUED FOR TENDER	2021-09-15 2021-08-12
G	ISSUED FOR TENDER ISSUED FOR BUILDING PERMIT	2021-08-12
F	90% CD	2021-07-27
F	SPA	2021-05-03
 D	50% CD	2021-02-12
C	BUILDING PERMIT	2021-02-05
B	PERMIT/SPA COORDINATION	2021-02-03
A	100% DESIGN DEVELOPMENT	2021-02-02
- ^	100 % DESIGN DEVELOPMENT	2021-01-19
No.	Revision	Date

FOR QUESTIONS REGARDING THIS PROJECT, PLEASE

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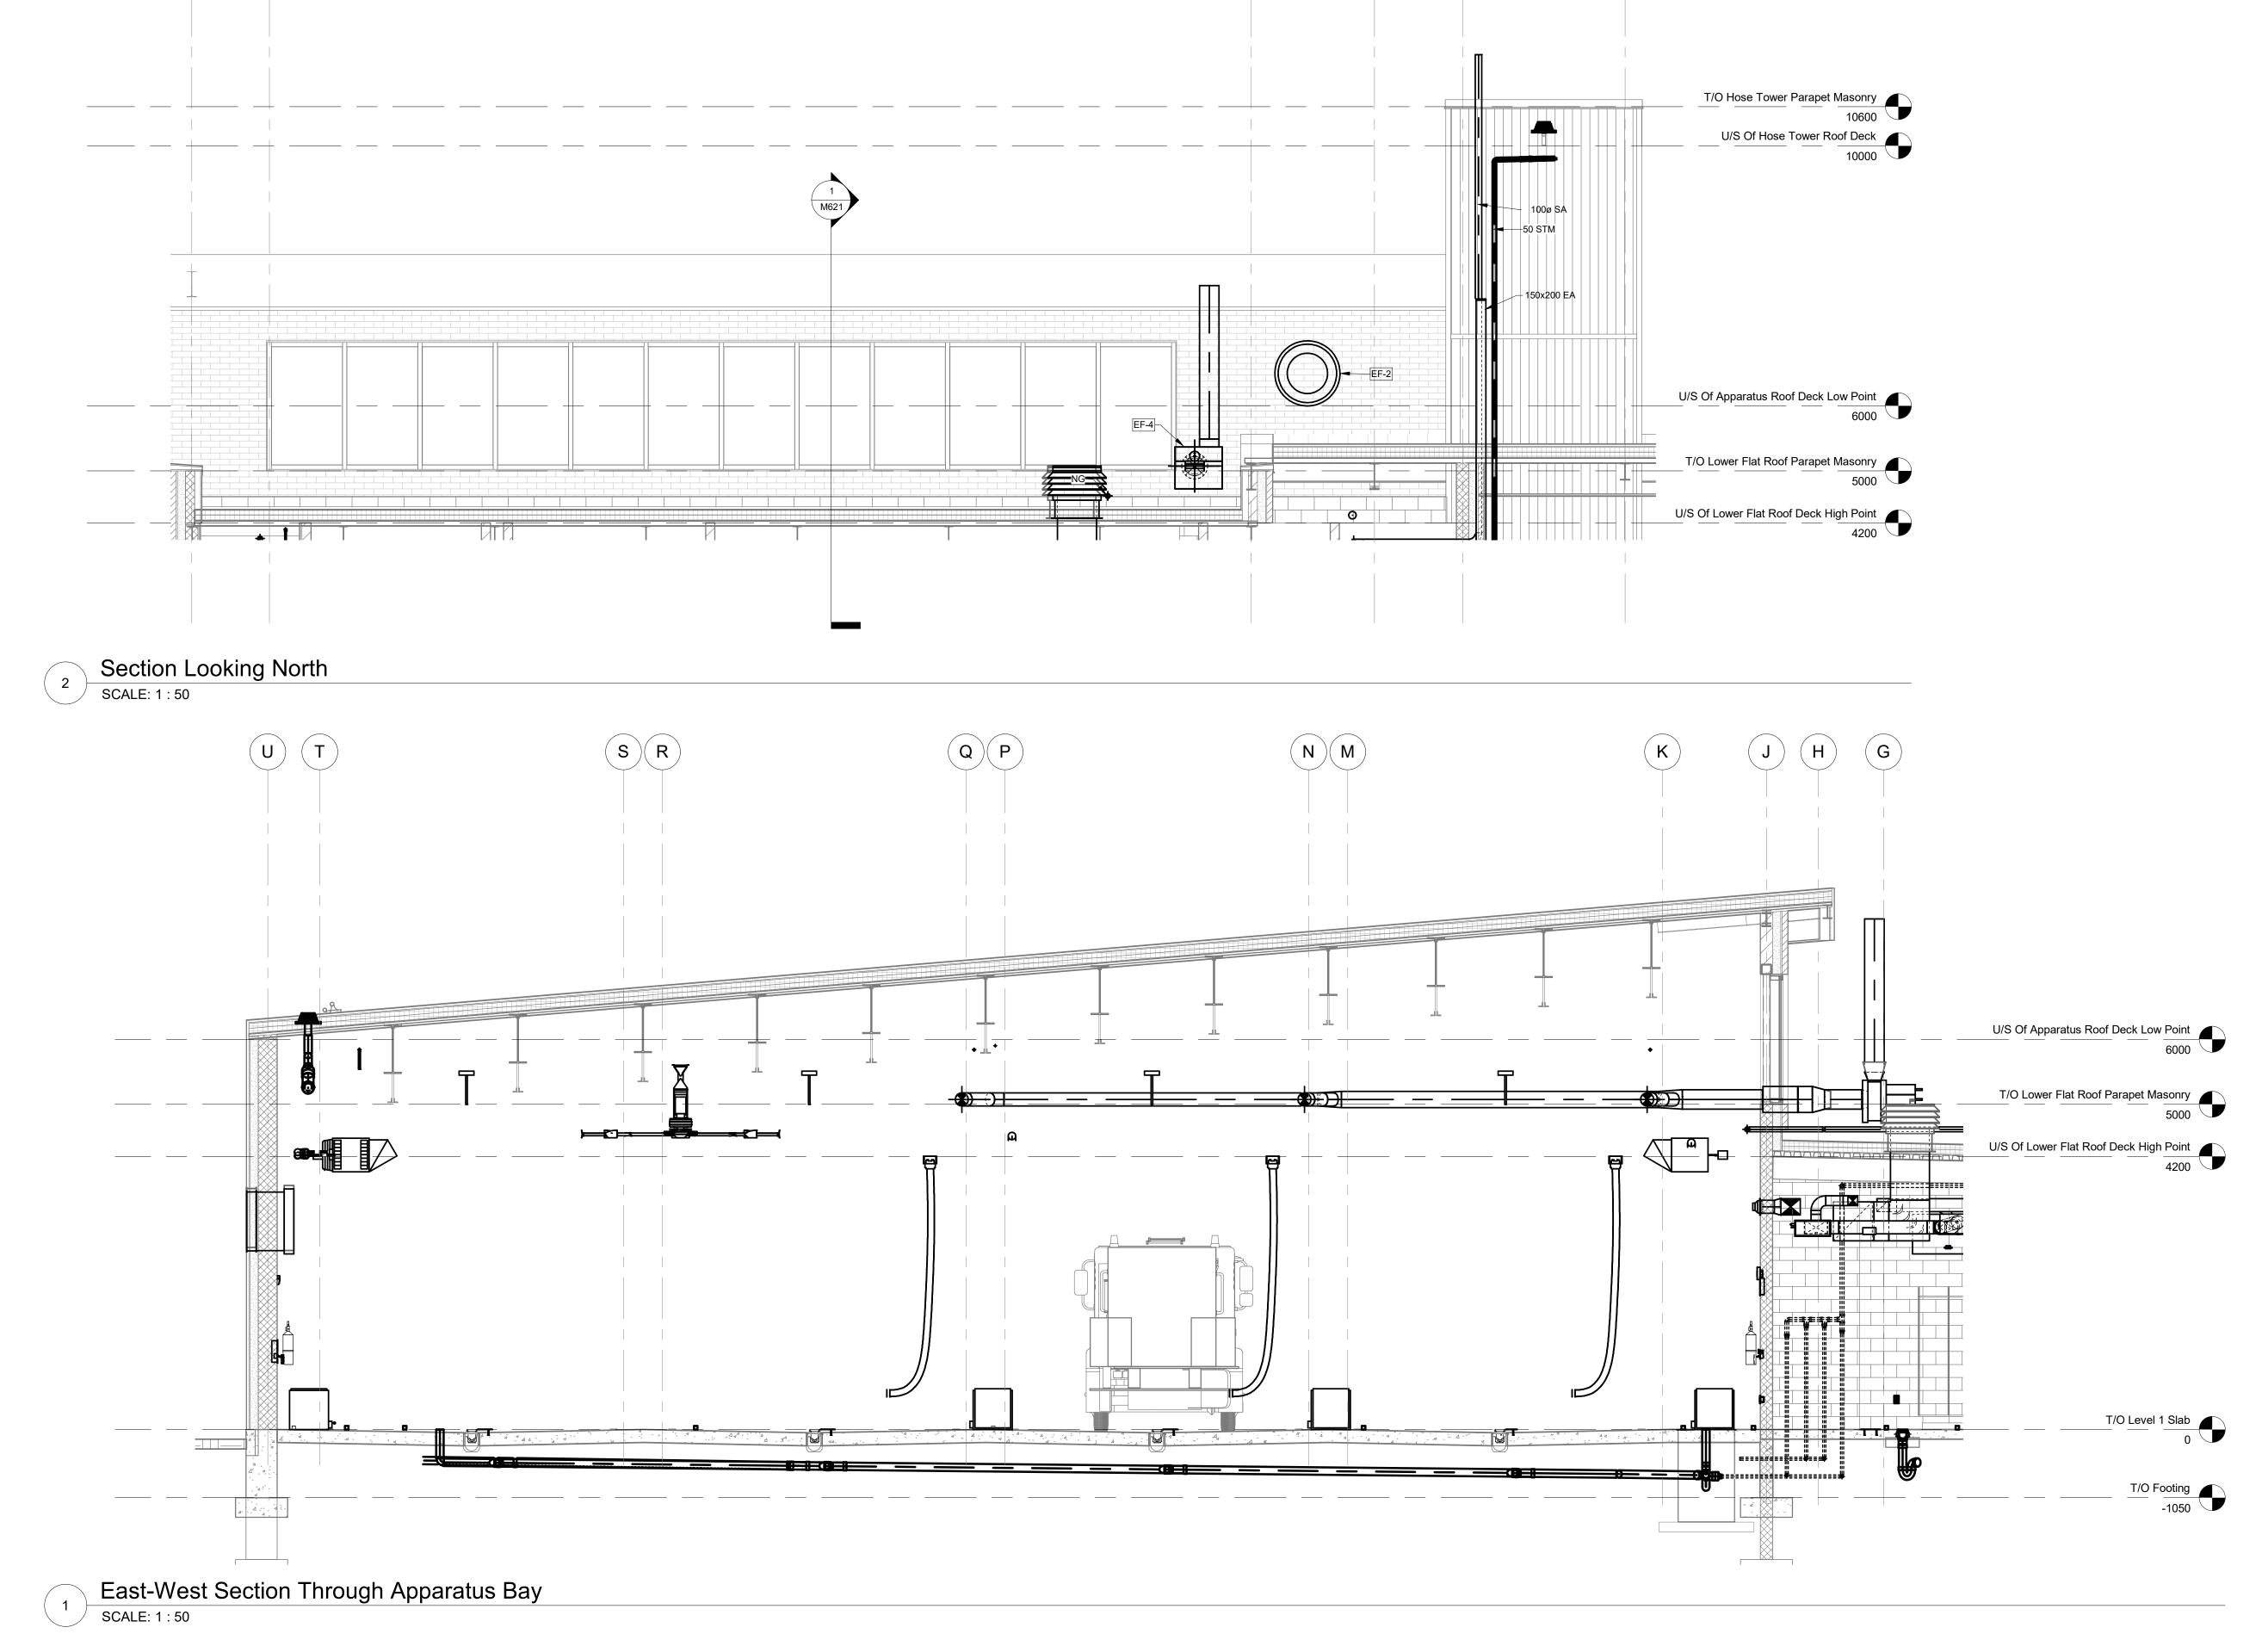
27 Rutherford Rd. S., Brampton, ON, L6W 3J3

City of Brampton Fire & Emergency Services

Drawing Title MECHANICAL EQUIPMENT SCHEDULE

Project No Drawing No 2021-12-20 Scale 1:1


11. Contractor to verify piping dimensions. 13. Contractor to furnish and install insulation on refrigerant piping.





С	ISSUED FOR CONSTRUCTION	2021-12-2
В	ISSUED FOR TENDER	2021-08-
Α	ISSUED FOR BUILDING PERMIT	2021-07-2
		•
No.	Revision	Date

entation Seal

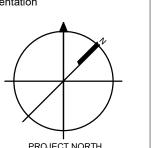

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or
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Drawing Title

MECHANICAL SECTIONS


Date 2021-12-20


Drawn by Author


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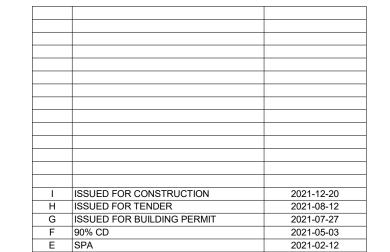
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CM-20-063





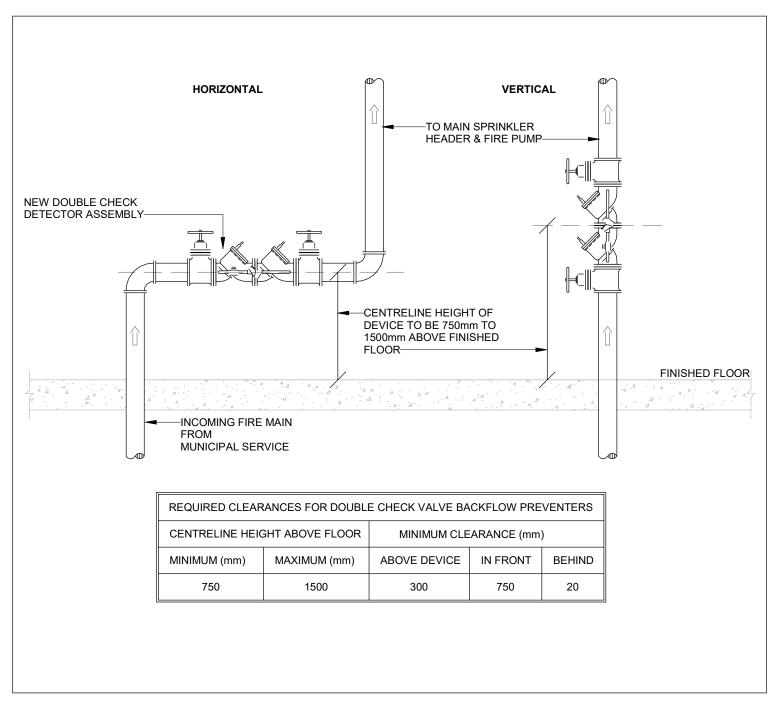

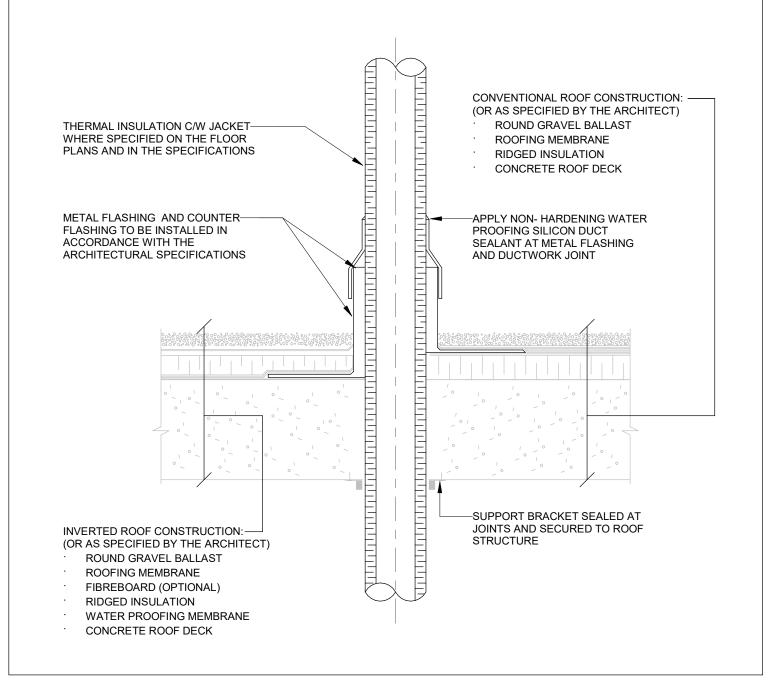
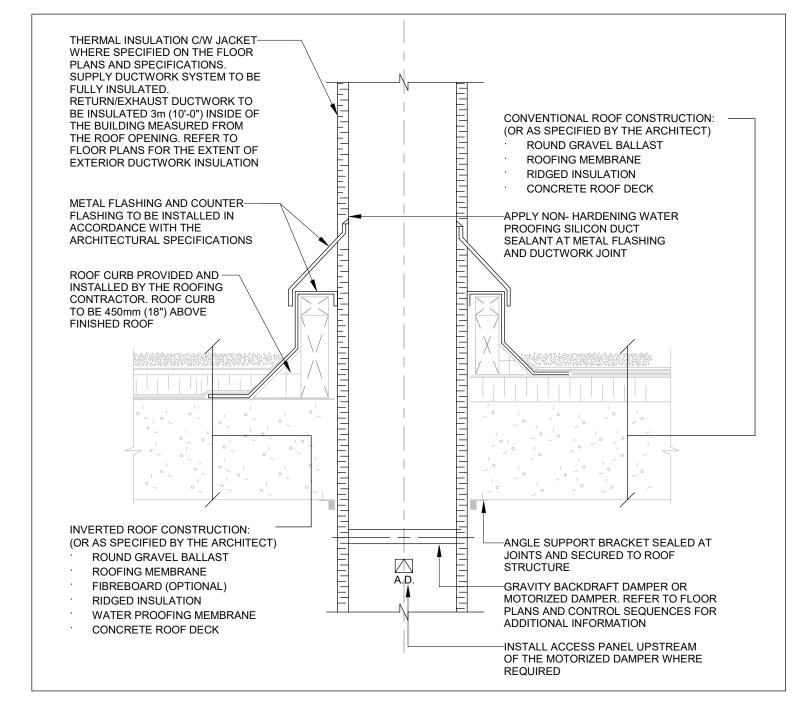
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2021-02-05

2021-02-05

2021-02-02

2021-01-19

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B PERMIT/SPA COORDINATION A 100% DESIGN DEVELOPMENT

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BUILDING PERMIT

21 13 00.01 FIRE DOUBLE CHECK DETECTOR ASSY

20 05 27.02 HVAC PIPE ROOF PENETRATION & FLASHING

-WHERE PIPE SIZE IS 40mm (1-1/2") PROVIDE 16 GAUGE GALVANIZED STELL INSULATION SHIELD BETWEEN THE INSULATION AND THE HANGER. SHIELD IS TO BE INSTALLED IMMEDIATELY AFTER THE INSULATION JACKET. WHERE PIPE SIZE IS 50mm (2") AND LARGER PROVIDE A FACTORY FABRICATED SECTION OF PHENOLIC FOAM PIPE INSULATION WITH INTEGRAL VAPOUR BARRIER JACKED AND CAPTIVE GALVANIZED STEEL SHIELD 40mm (1-1/2") AND LARGER —CARBÒN STÉEL HYDRONIC THERMAL INSULATION C/W JACKET AS — SPECIFIED ON THE FLOOR PLANS AND SPECIFICATIONS -ADJUSTABLE CLEVIS HANGER IN ACCORDANCE WITH MANUFACTURERS STANDARDIZATION SOCIETY (MSS) STANDARD PRACTICE MANUAL SP-58, TYPE 1. HANGÉR ROD TO BE ELECTRO-GALVANIZED CARBON STEEL -CARBON STEEL PIPE C/W THERMAL INSULATION AND JACKET

20 05 27.01 DUCTWORK ROOF PENETRATION & FLASHING SCALE:N.T.S.

-WHERE PIPE SIZE IS 12mm - 40mm (1/2" -1-1/2") PROVIDE 16 GAUGE GALVANIZED STEEL INSULATION SHIELD BETWEEN THE INSULATION AND THE HANGER. SHIELD IS TO BE INSTALLED IMMEDIATELY AFTER THE INSULATION JACKET -12mm - 25mm (1/2" - 1") CARBON STEEL HYDRONIC THERMAL INSULATION C/W JACKET AS SPECIFIED ON THE FLOOR PLANS AND SPECIFICATIONS -300mm (12") ADJUSTABLE SWIVEL RING BAND HANGER IN ACCORDANCE WITH MANUFACTURERS STANDARDIZATION SOCIETY (MSS) STANDARD PRACTICE MANUAL SP-58, TYPE 10. HANGER ROD TO BE ELECTRO-GALVANIZED CARBON STEEL -CARBON STEEL PIPE C/W THERMAL INSULATION AND JACKET -GALVANIZED STEEL SHIELD

20 05 05.01 PIPING HANGERS AND SUPPORTS SCALE:N.T.S.


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City of Brampton Fire & Emergency Services

Drawing Title MECHANICAL DETAILS I

Project No Drawing No 2021-12-20 Drawn by CMW Scale N.T.S.



20 05 05.08 PIPE PENETRATION THROUGH FIRE RATED WALL 20 05 05.02 PIPING HANGERS AND SUPPORTS

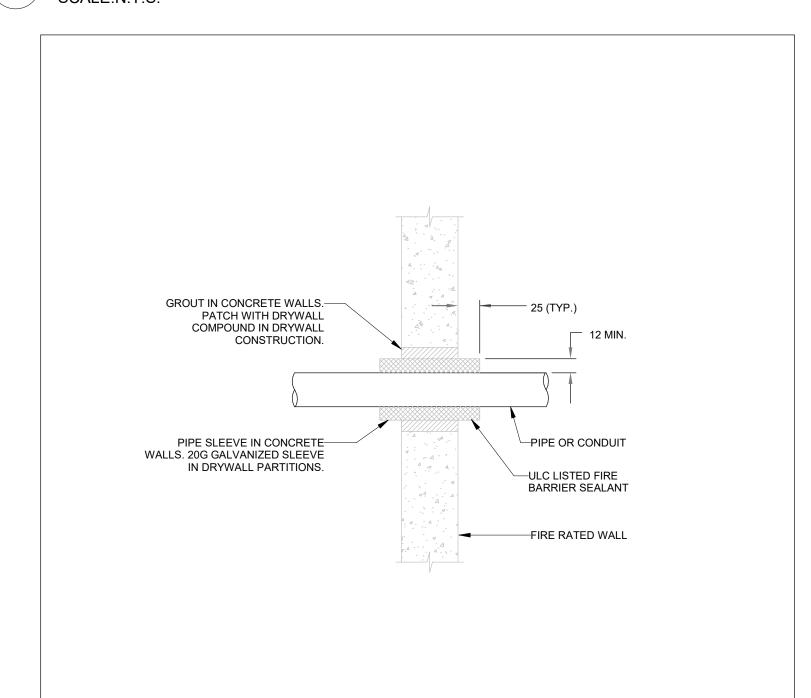
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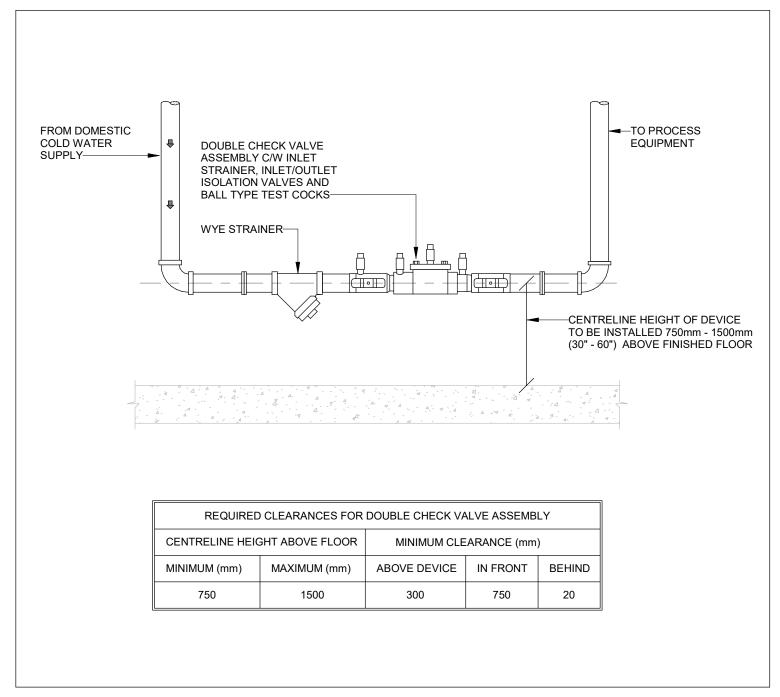
—GALVANIZED STEEL SHIELD OR PHENOLIC FOAM


PIPE INSULATION WITH INTEGRAL VAPOUR BARRIER JACKET AND CAPTIVE GALVANIZED


STEEL SHIELD AS REQUIRED

300mm (12")---



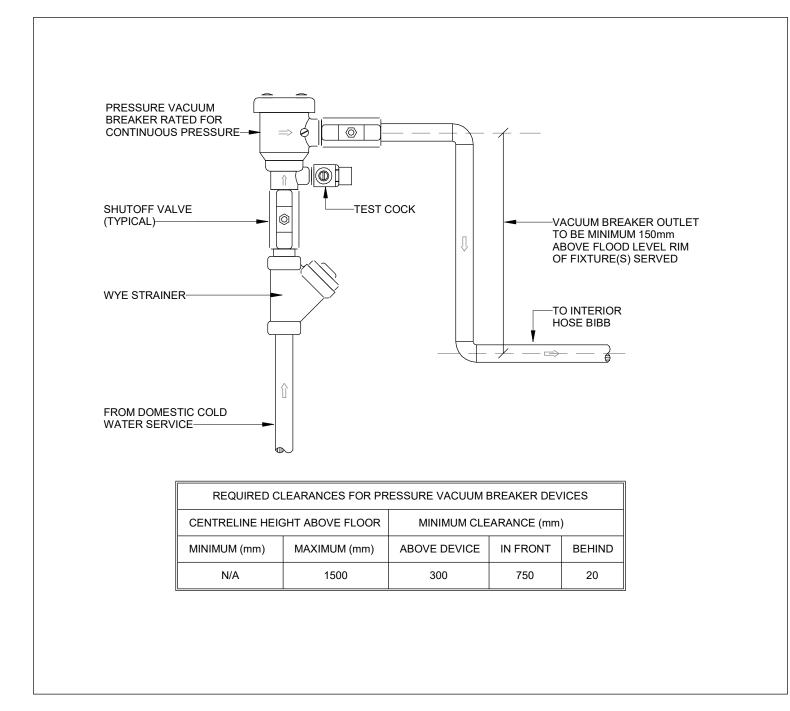


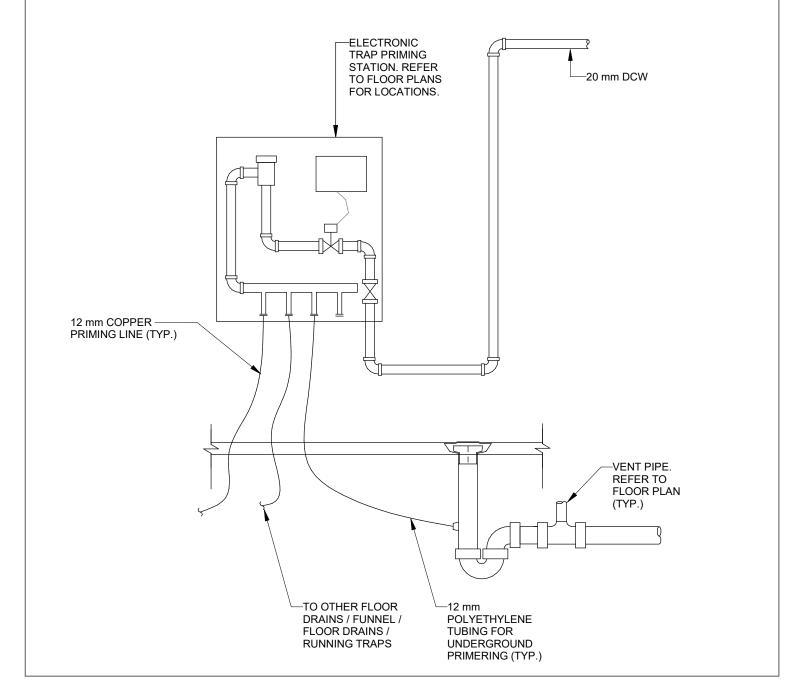

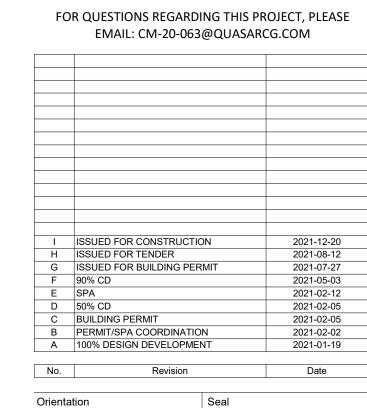

22 11 18.03 INTERIOR HOSE BIBB PRESS. VAC. BREAKER


5 22 11 18.02 DOUBLE CHECK VALVE ASSEMBLY SCALE:N.T.S.

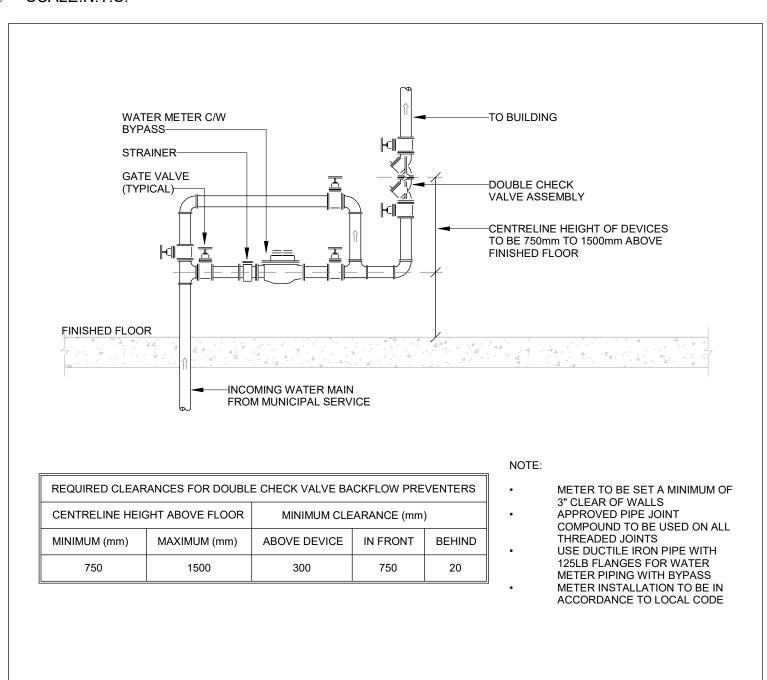

22 11 00.01 WATER METER ASSEMBLY


SCALE:N.T.S.

SCALE:N.T.S.

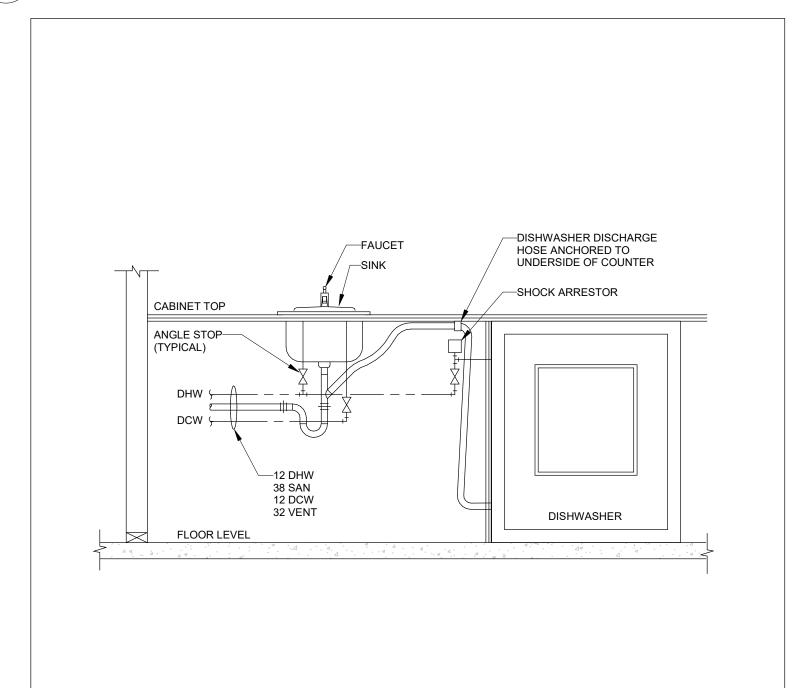

22 11 00.01 DISHWASHER PLUMBING SCALE:N.T.S. SCALE:N.T.S.

22 11 00.02 ELECTRONIC TRAP PRIMING STATION SCALE:N.T.S.

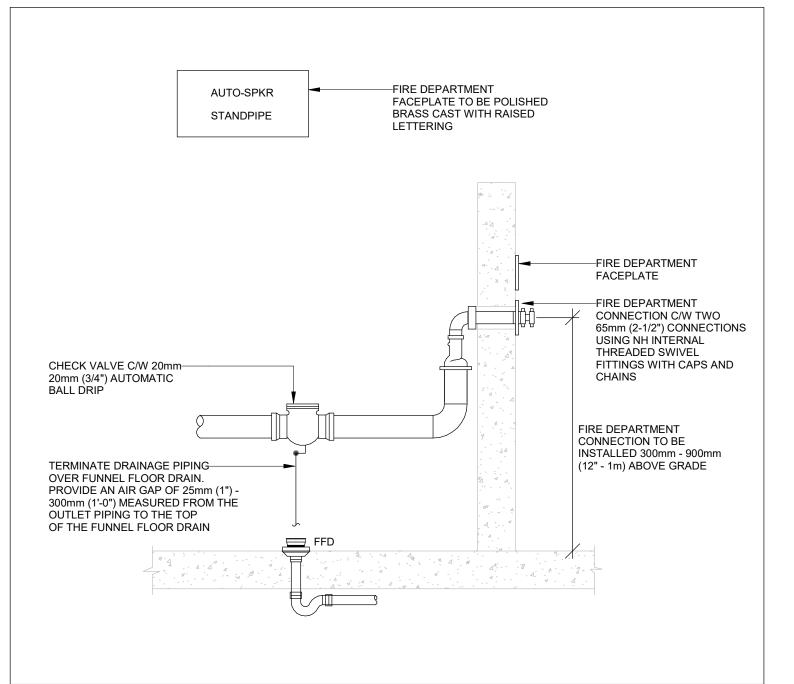

21 13 00.02 FIRE DEPARTMENT CONNECTION

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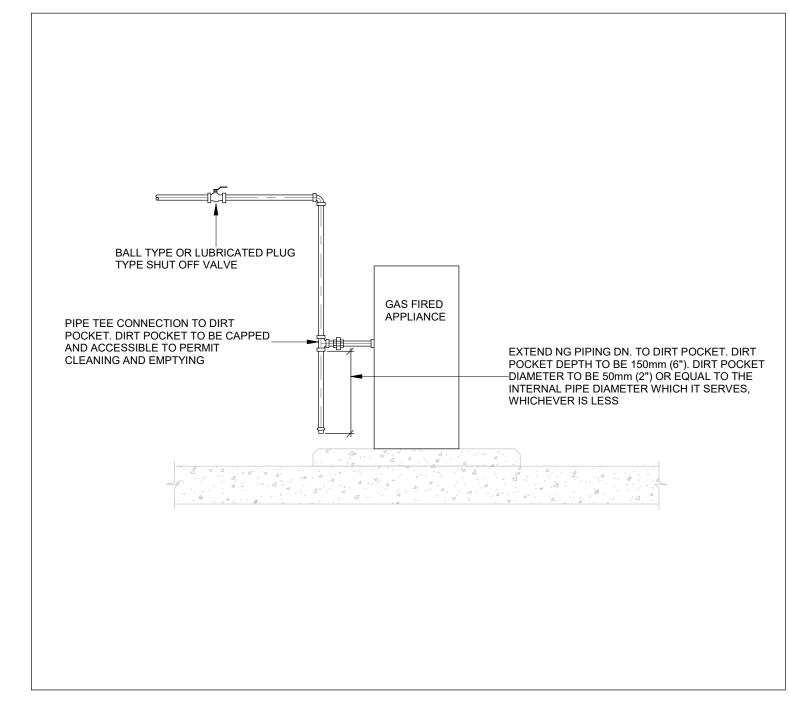
City of Brampton Fire & Emergency Services


Drawing Title MECHANICAL DETAILS II

Scale

N.T.S.

Project No Drawing No 2021-12-20 CM-20-063 M642 CMW



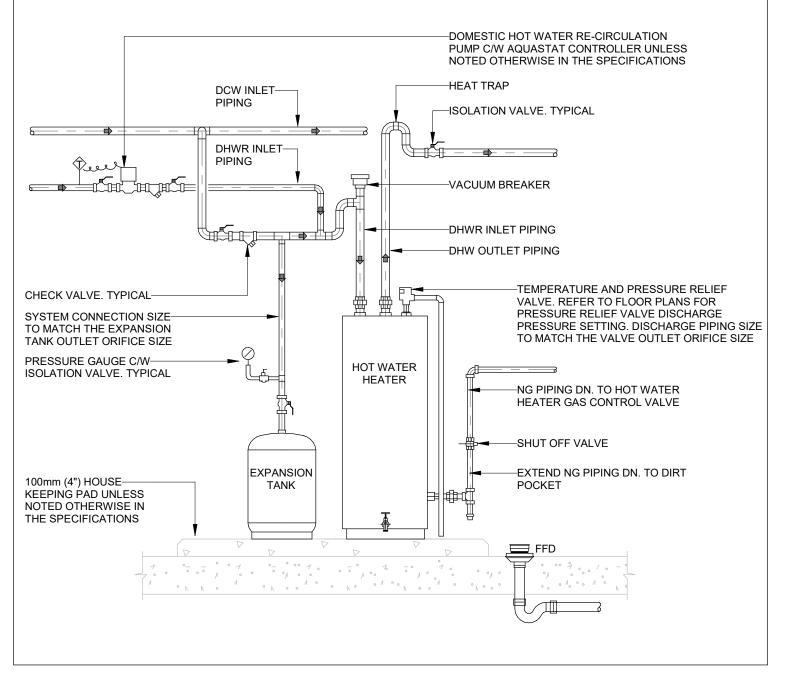




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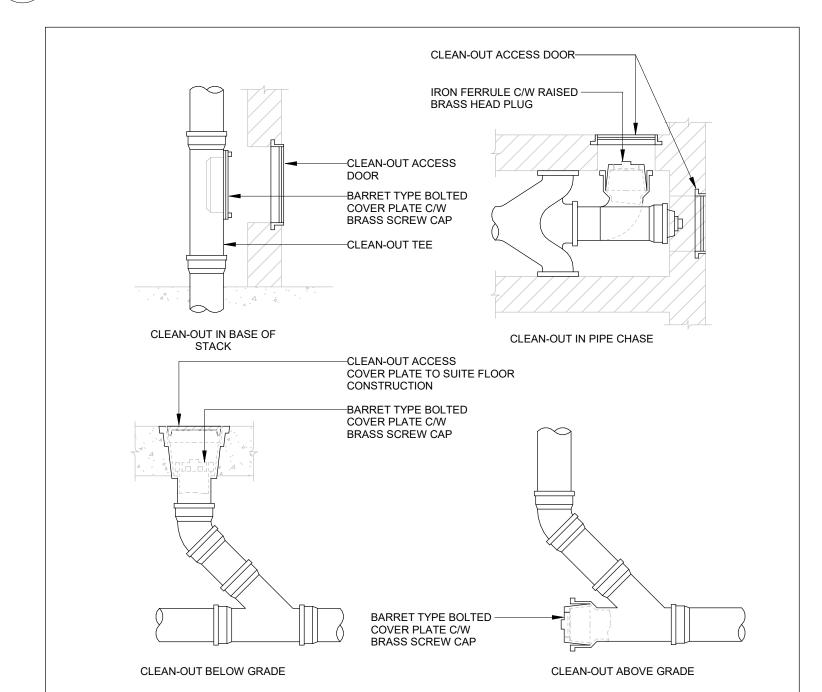
I ISSUED FOR CONSTRUCTION H ISSUED FOR TENDER 2021-08-12 G ISSUED FOR BUILDING PERMIT 2021-07-27 2021-05-03 2021-02-12 E SPA
D 50% CD
C BUILDING PERMIT 2021-02-05 2021-02-05 B PERMIT/SPA COORDINATION
A 100% DESIGN DEVELOPMENT 2021-02-02 2021-01-19

Orientation

23 11 23.02 GAS PIPE CONNECTION TO EQUIPMENT SCALE:N.T.S.




23 11 23.01 NATURAL GAS EQUIPMENT CONNECTION SCALE:N.T.S.

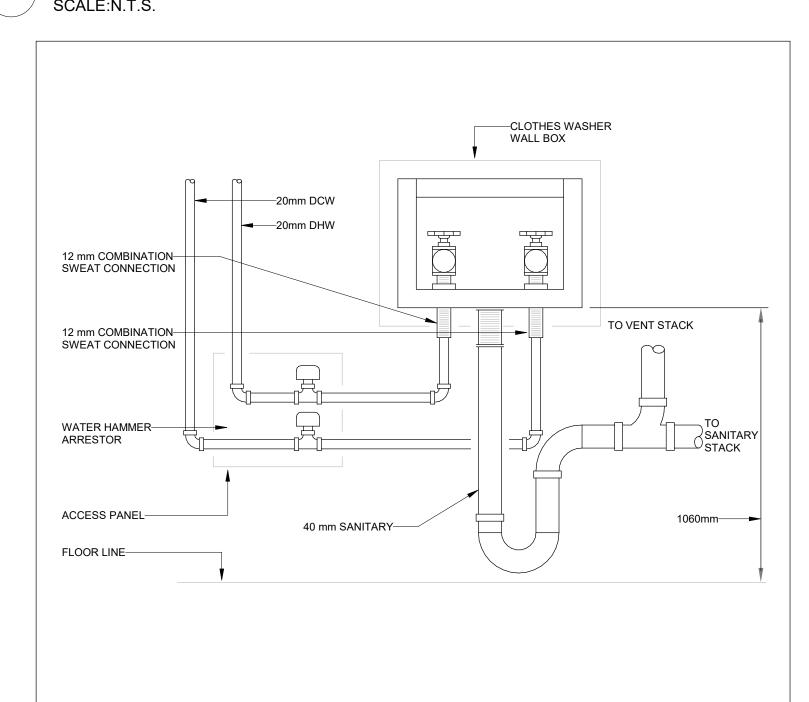

22 13 00.02 SANITARY & STORM WATER CLEANOUTS

22 30 18.01 SEALED COMUSTION HOT WATER HEATER SCALE:N.T.S.

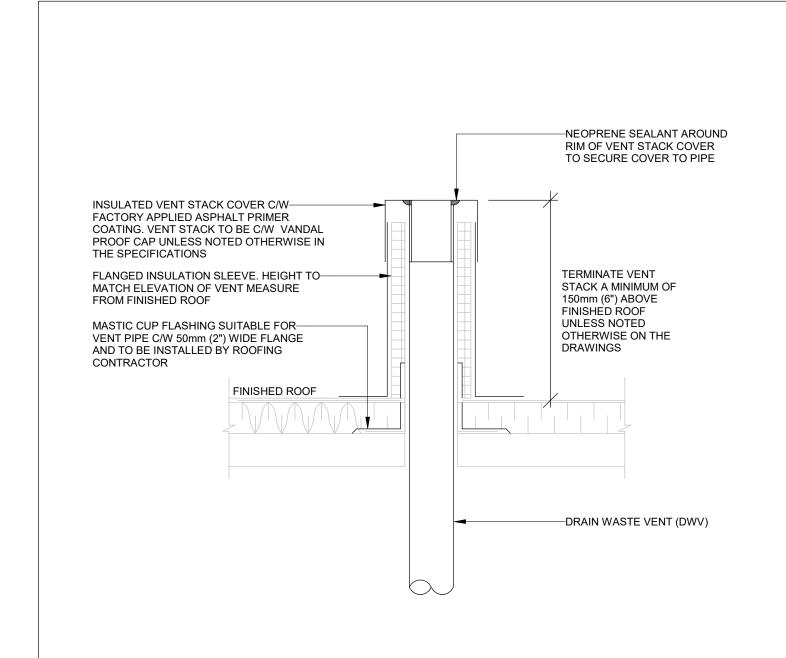

SCALE:N.T.S.

22 13 00.01 DWV ROOF PENETRATION & VENT CAP COVER Scale N.T.S.

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City of Brampton Fire & Emergency Services Drawing Title

MECHANICAL DETAILS III

2021-12-20 CM-20-063 M643

22 30 00.01 LAUNDRY BOX SCALE:N.T.S.

SCALE:N.T.S.

PLENUM STORM LOUVER-----1/4 " WIRE MESH SCREEN -PROVIDE MIN. 15° DEEP POCKET NOTES: SLOPED TOWARDS THE STORM 1. ALL JOINTS TO BE MADE WATER TIGHT. 2. REFER TO SPECIFICATIONS FOR ADDITIONAL REQUIREMENTS.

HEEL RADIUS (D + 3/4D)-GOOSENECK DISCHARGE-C/W 5mm WIRE MESH SCREEN AIRFLOW TERMINATE EXHAUST STACK A MINIMUM OF 900mm (3'-0") ABOVE FINISHED ROOF UNLESS OTHERWISE SPECIFIED ON —ROOF CURB AND METAL FLASHING. REFER DRAWINGS TO DUCTWORK ROOF PENETRATION & FLASHING FOR ADDITIONAL INFORMATION. —ANGLE SUPPORT BRACKET SEALED AT JOINTS AND SECURED TO ROOF STRUCTURE —GRAVITY BACKDRAFT DAMPER OR MOTORIZED DAMPER. REFER TO FLOOR PLANS AND CONTROL SEQUENCES FOR ADDITIONAL INFORMATION -INSTALL ACCESS PANEL UPSTREAM OF THE MOTORIZED DAMPER WHERE REQUIRED

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I ISSUED FOR CONSTRUCTION
H ISSUED FOR TENDER 2021-08-12 G ISSUED FOR BUILDING PERMIT 2021-07-27 F 90% CD
E SPA
D 50% CD
C BUILDING PERMIT 2021-05-03 2021-02-12 2021-02-05 2021-02-05 B PERMIT/SPA COORDINATION
A 100% DESIGN DEVELOPMENT 2021-02-02 2021-01-19

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MECHANICAL DETAILS IV

Project No Drawing No

CM-20-063 M644

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BFES Station 201

(SPA-2021-0032)

2021-12-20

N.T.S.

AIRFLOW

AIRFLOW

45° RADIUS BEND TAKE-OFF

45° SQUARE BRANCH TAKE-OFF

—HEEL RADIUS (D + 3/4D)

SINGLE OR PARALLEL TYPE— BLADE VOLUME CONTROL (BALANCING DAMAR) TO

EXTENSION AND LOCKING

SUITE DUCT SIZE AND DIMENSIONS. BALANCING DAMPER TO BE C/W SHAFT

QUADRANT DAMPER OPERATOR. TYPICAL

SPLITTER DAMPER

SPLITTER ROD C/W——OPERATING HARDWARE.

PROVIDE WITH STAND-OFF

WHERE INSTALLED IN INSULATED DUCTWORK,

MOUNTING BRACKETS

23 30 00.02 DUCTWORK CONNECTION TO STORM LOUVRE

SUPPLY - ROUND RADIUS ELBOW TAKE OFF

TURNING VANES WHERE

SPECIFIED ON THE FLOOR

-RATIO OF CONICAL REDUCTION

TO BE 4:1

HEEL RADIUS (D + 3/4D)


90° BRANCH TEE TAKE-OFF

CONICAL REDUCTION

90° ROUND RADIUS ELBOW

AIRFLOW

23 30 00.02 DUCT THROUGH ROOF PENETRATION & TERM. SCALE:N.T.S.

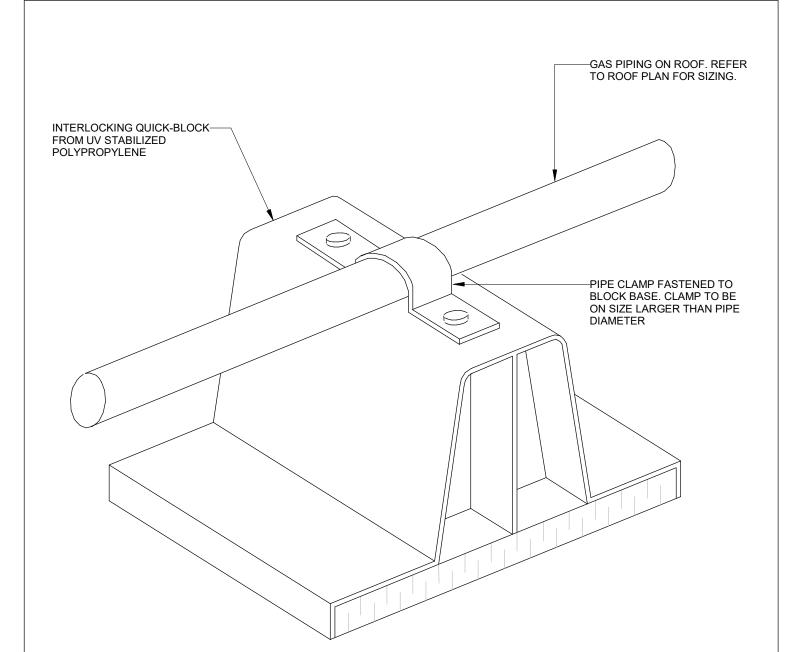



23 11 23.03 GAS PIPING ON ROOF - SUPPORT DETAIL SCALE:N.T.S.


-CONICAL SPIN-ON ROUND TAKE-OFF COLLAR C/W LOCKING DAMPER -RECTANGULAR 90° RADIUS ELBOW C/W TURNING VANES WHERE SPECIFIED ON THE −90° ROUND RADIUS ELBOW

FLOOR PLANS

23 30 00.01 DUCTWORK FITTINGS & TAKE-OFF'S SCALE:N.T.S.

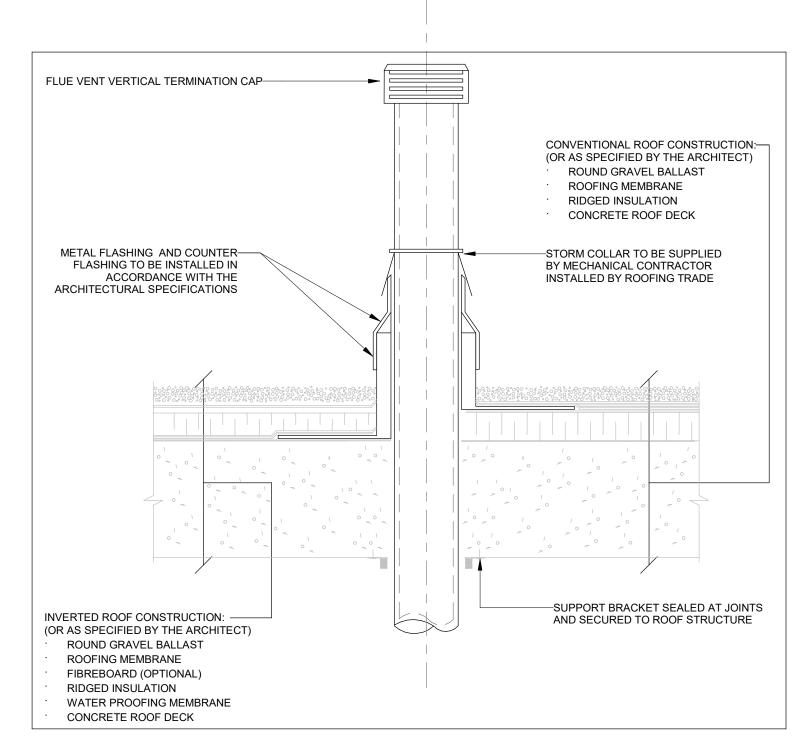

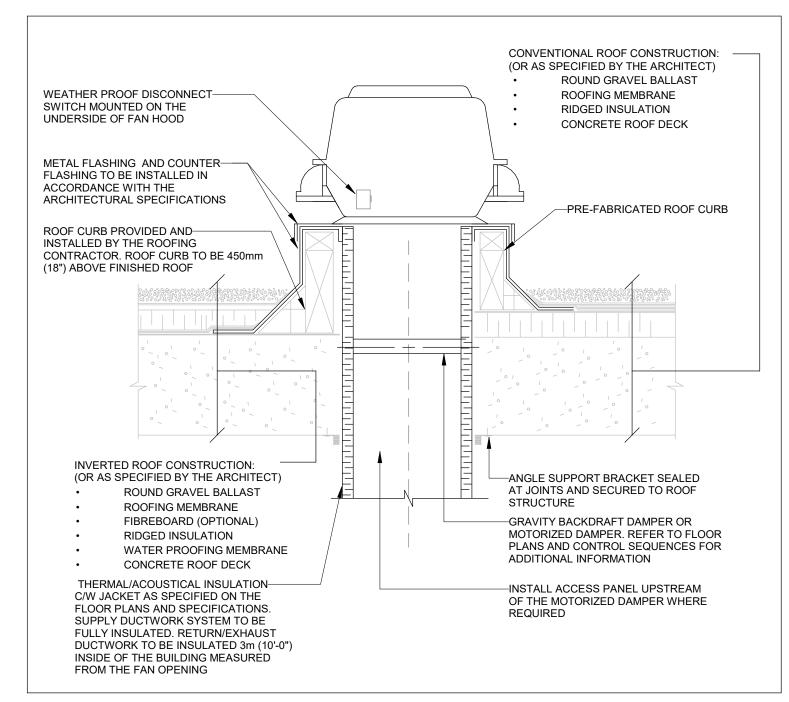

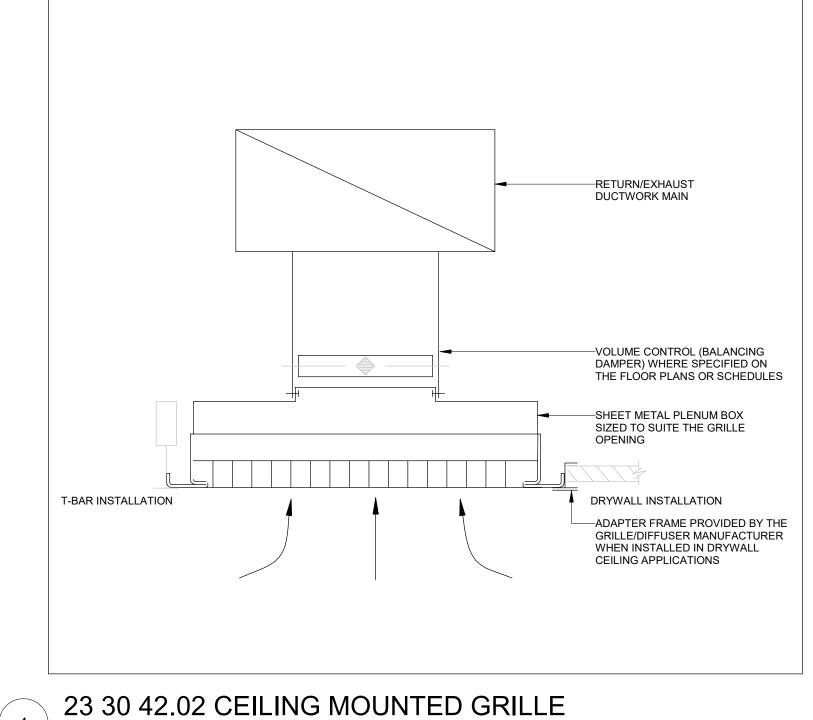



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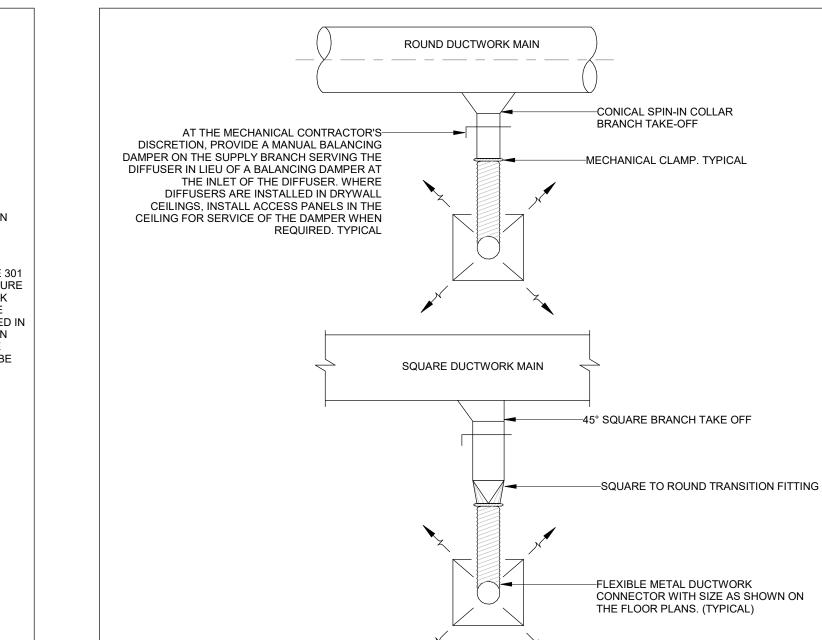
23 51 00.01 FLUE ROOF PENETRATION & FLUE VENT CAP SCALE:N.T.S.

(WxHxD) RETAINING ANGLE

SIDES OF THE FIRE RATED

ÌNSTALLED ON BOTH

23 34 06.01 ROOF MOUNTED EXHAUST FAN



SCALE:N.T.S.

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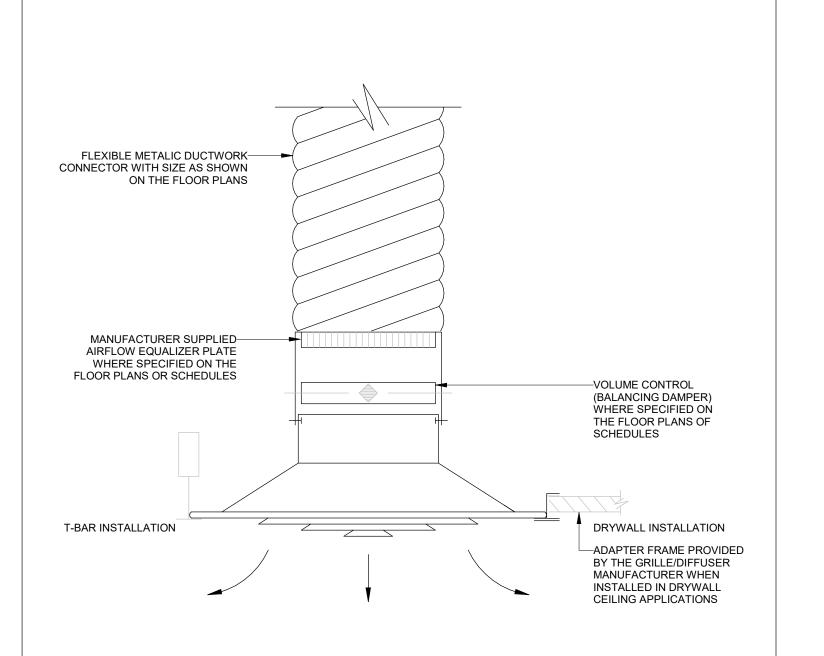
(SPA-2021-0032)


27 Rutherford Rd. S., Brampton, ON, L6W 3J3

City of Brampton Fire & Emergency Services Drawing Title MECHANICAL DETAILS V

Project No Drawing No 2021-12-20


N.T.S.




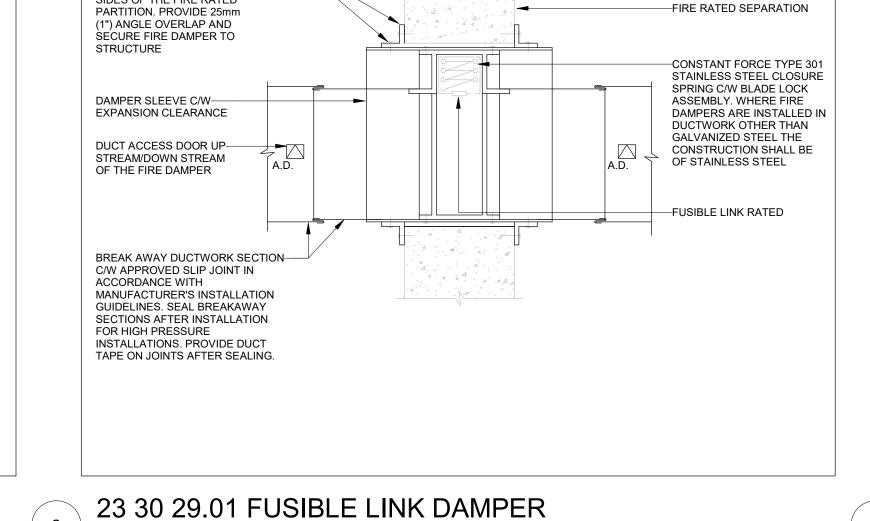

23 30 42.01 CEILING MOUNTED DIFFUSER

23 30 09.02 FLEXIBLE METALLIC DUCTWORK CONNECTION Scale

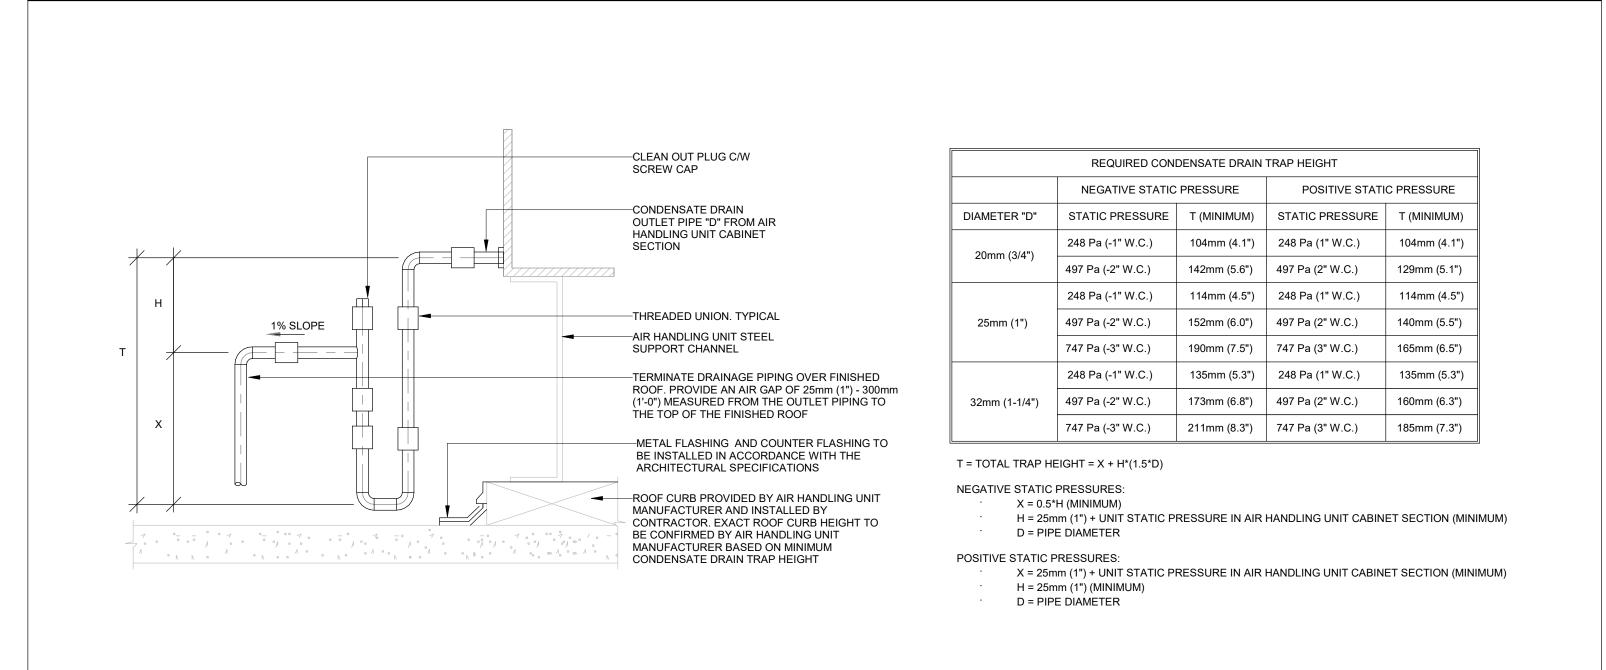

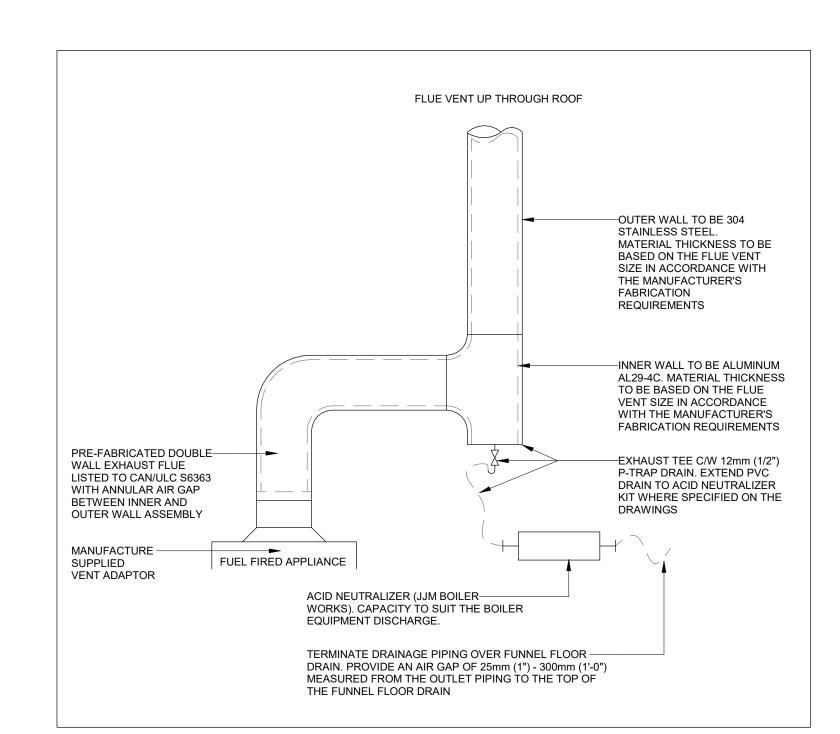

23 51 04.01 EXHAUST FLUE VENT - CATEGORY III AND IV1
SCALE:N.T.S.

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2021-08-12

2021-05-03 2021-02-12

2021-02-05 2021-02-05

2021-02-02 2021-01-19

I ISSUED FOR CONSTRUCTION

G ISSUED FOR BUILDING PERMIT

B PERMIT/SPA COORDINATION
A 100% DESIGN DEVELOPMENT

H ISSUED FOR TENDER

D 50% CD
C BUILDING PERMIT

Orientation

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For City of Prompton Fire & Emergency Convisee

City of Brampton Fire & Emergency Services

Drawing Title

MECHANICAL DETAILS VI

N.T.S.

Date 2021-12-20 Project No Drawing No CM-20-063 NA646

23 72 00.01 CONENSATE DRAIN TRAP HEIGHT - OUTDOOR AIR HANDLING UNIT SCALE:N.T.S.

MOTOR POWER CIRCUIT

14 AWG CS1 C-1

MTR: EXH-1

EXHAUST RISER. —

HANGING ANGLE. -

L55 SERIES E26 CANOPY LIGHT FIXTURE -

- HIGH TEMP ASSEMBLY, INCLUDES CLEAR THERMAL

2021-08-12

2021-05-03

2021-02-12

2021-02-05

2021-02-05

2021-02-02

2021-01-19

AND SHOCK RESISTANT GLOBE (L55 FIXTURE).

FACTORY WIRING SCHEMATIC - CIRCUIT BOARDS

UNLESS SPECIFIED OTHERWISE, ALL FACTORY AC WIRING 16 AWG. ALL FACTORY DC WIRING 18 AWG.

DESCRIPTION OF OPERATION:


BREAKER PANEL


120V 1 Phase w/ control for 1 Exhaust Fan, Exhaust on in Fire, Lights out in Fire.


BREAKER PANEL TO PRIMARY CONTROL PANEL


Responsibility: Electrician


BREAKER SIZE SHOWN IS THE MAXIMUM ALLOWED

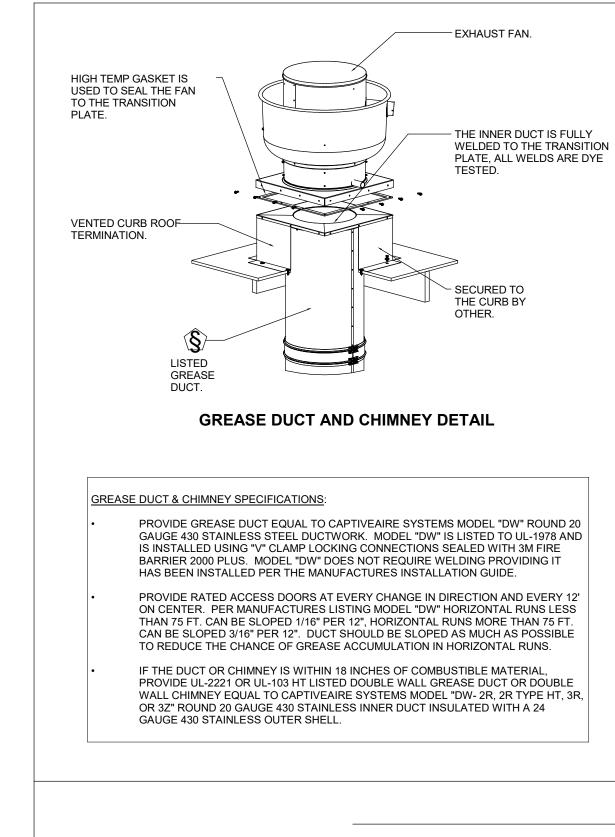


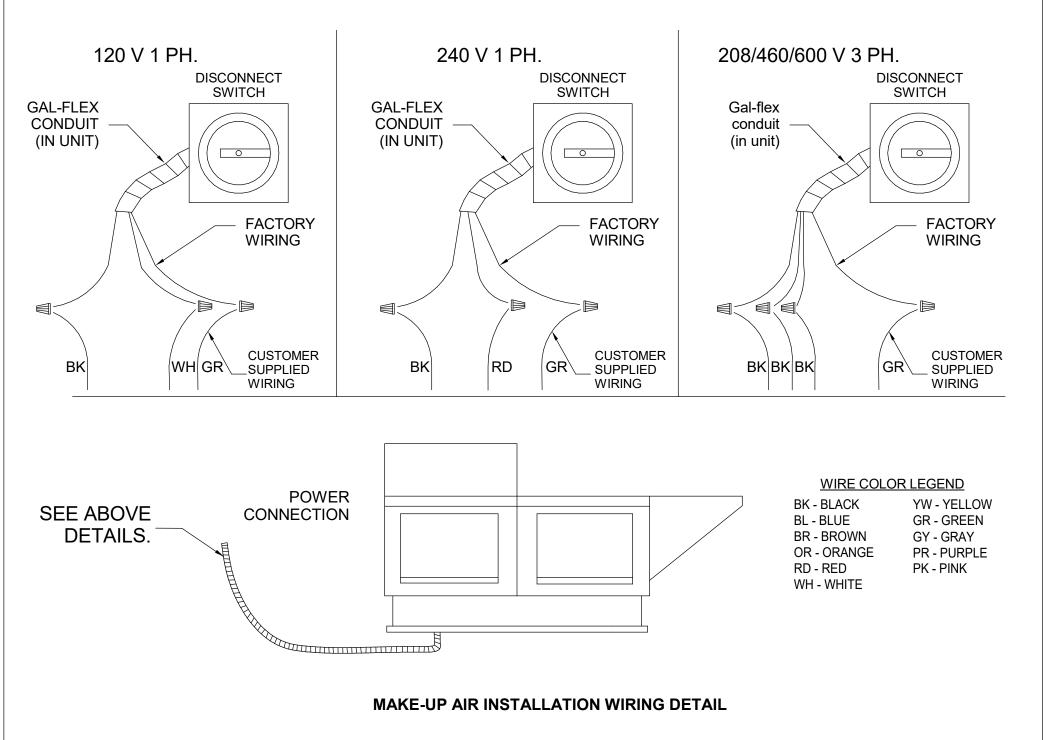

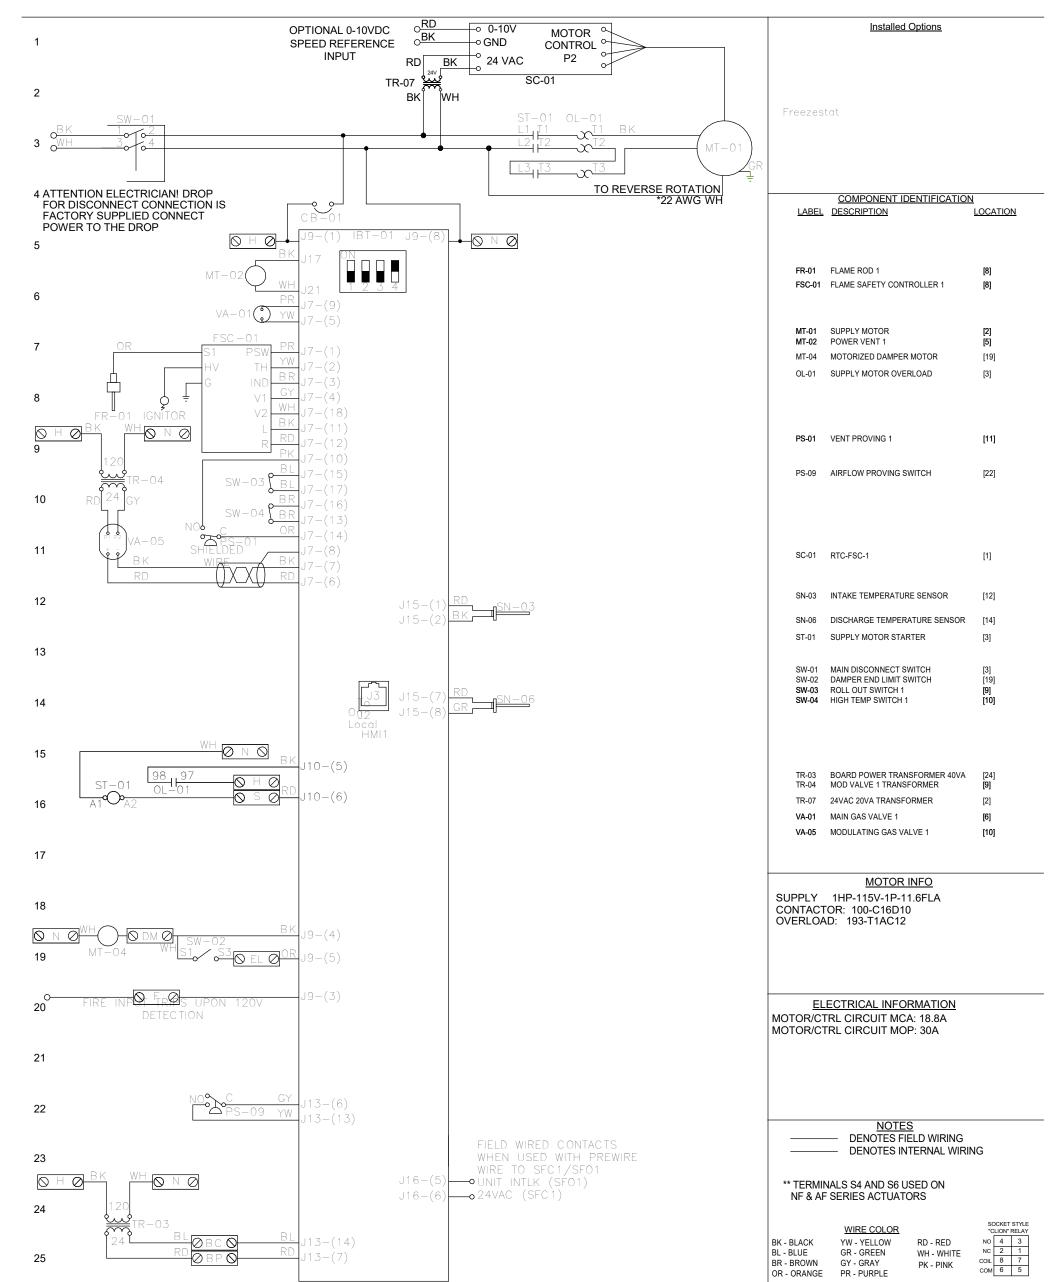

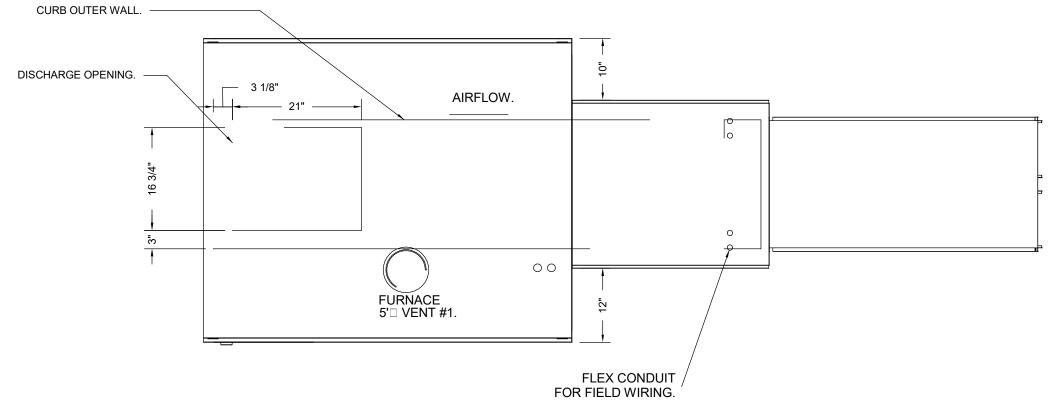

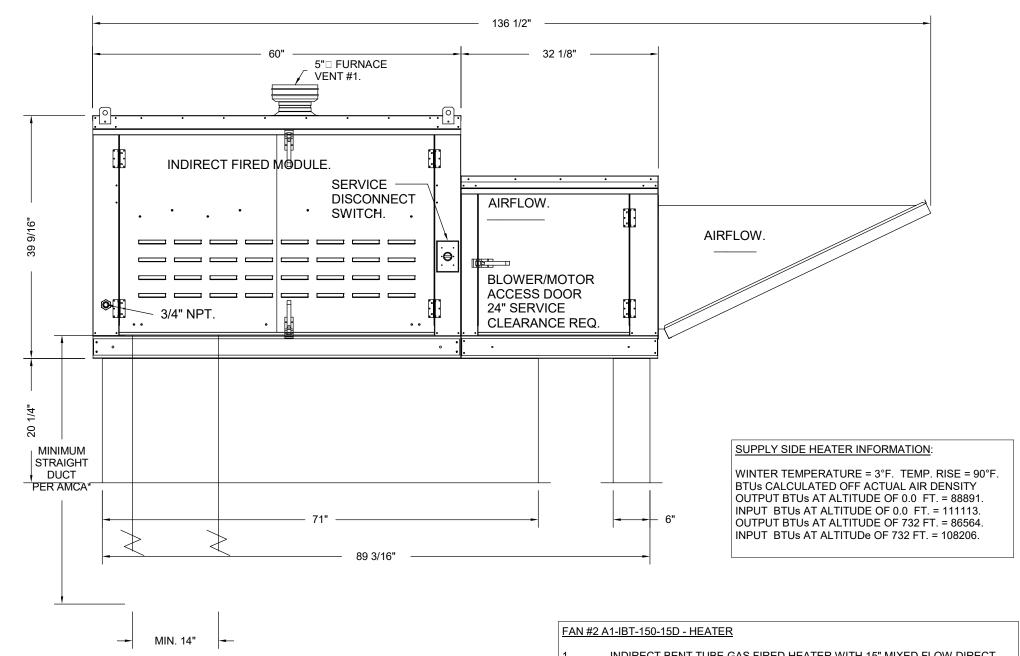

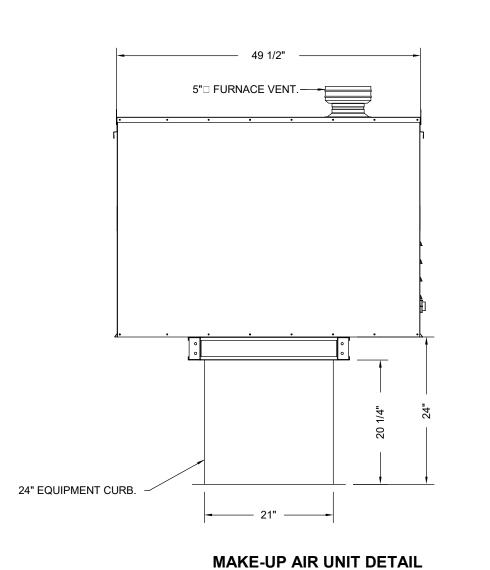

- INDIRECT BENT TUBE GAS FIRED HEATER WITH 15" MIXED FLOW DIRECT DRIVE FAN, 1 FURNACE, ELECTRONIC FULL MODULATION, CONSTANT 80% EFFICIENCY, AND 6:1 MAX TURNDOWN FOR NG, (5:1 MAX TURNDOWN FOR
- LP). STAINLESS STEEL BURNER AND HEAT EXCHANGER.

 2. INTAKE HOOD WITH EZ FILTERS
- 3. DOWN DISCHARGE AIR FLOW RIGHT -> LEFT.
- 4. GAS PRESSURE GAUGE, 0-35", 2.5" DIAMETER, 1/4" THREAD SIZE.
- . GAS PRESSURE GAUGE, 0 TO +10 INCHES WC., 2.5" DIAMETER, 1/8" THREAD SIZE, REAR THREAD.
- 6. MOTORIZED BACK DRAFT DAMPER 16" X 18" FOR SIZE 1 STANDARD & MODULAR HEATER UNITS W/EXTENDED SHAFT, STANDARD GALVANIZED CONSTRUCTION, 3/4" REAR FLANGE, LOW LEAKAGE, TFB120S ACTUATOR INCLUDED.
- ECM WIRING PACKAGE AND MANUAL OR 0-10VDC CONTROL FOR SUPPLY EC MOTORS. RTC CONTROLLER. **DO NOT ORDER UNDER WARRANTY, SEE PART NUMBER "ECM-VCU-RTC"**.
- FREEZESTAT FACTORY SET AT 35°F AND 10 MINUTES.
- 9. 9. HINGED DOUBLE WALL INSULATED DOOR ASSEMBLY (BURNER/BLOWER
- 10. 2 YEAR ENTIRE UNIT PARTS WARRANTY, 25 YEAR STAINLESS STEEL FURNACE PARTS WARRANTY. IBT US PATENT 877119 B2.

*NOTE: SUPPLY DUCT MUST BE INSTALLED TO MEET SMACNA STANDARDS. A MINIMUM STRAIGHT DUCT LENGTH MUST BE MAINTAINED DOWNSTREAM OF UNIT DISCHARGE AS OUTLINED IN AMCA PUBLICATION 201. WHEN USING RECTANGULAR DUCTWORK, ELBOWS MUST BE RADIUS THROAT, RADIUS BACK WITH TURNING VANES. FLEXIBLE DUCTWORK AND SQUARE THROAT/SQUARE BACK ELBOWS SHOULD NOT BE USED. ANY TRANSITION AND/OR TURNS IN THE DUCTWORK WILL CAUSE SYSTEM EFFECT. SYSTEM EFFECT WILL DRASTICALLY INCREASE STATIC PRESSURE AND REDUCE AIRFLOW. DO NOT RELY ON UNIT TO SUPPORT DUCT IN ANY WAY. FAILURE TO PROPERLY SIZE DUCTWORK MAY CAUSE SYSTEM EFFECTS AND REDUCE PERFORMANCE OF THE EQUIPMENT.

SUGGESTED STRAIGHT DUCT SIZE IS 14" x 14".

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С	ISSUED FOR CONSTRU	CTION	2021-12-2
В	ISSUED FOR TENDER		2021-08-1
Α	ISSUED FOR BUILDING	PERMIT	2021-07-2
No.	Revisio	n	Date
Orienta	ation	Seal	

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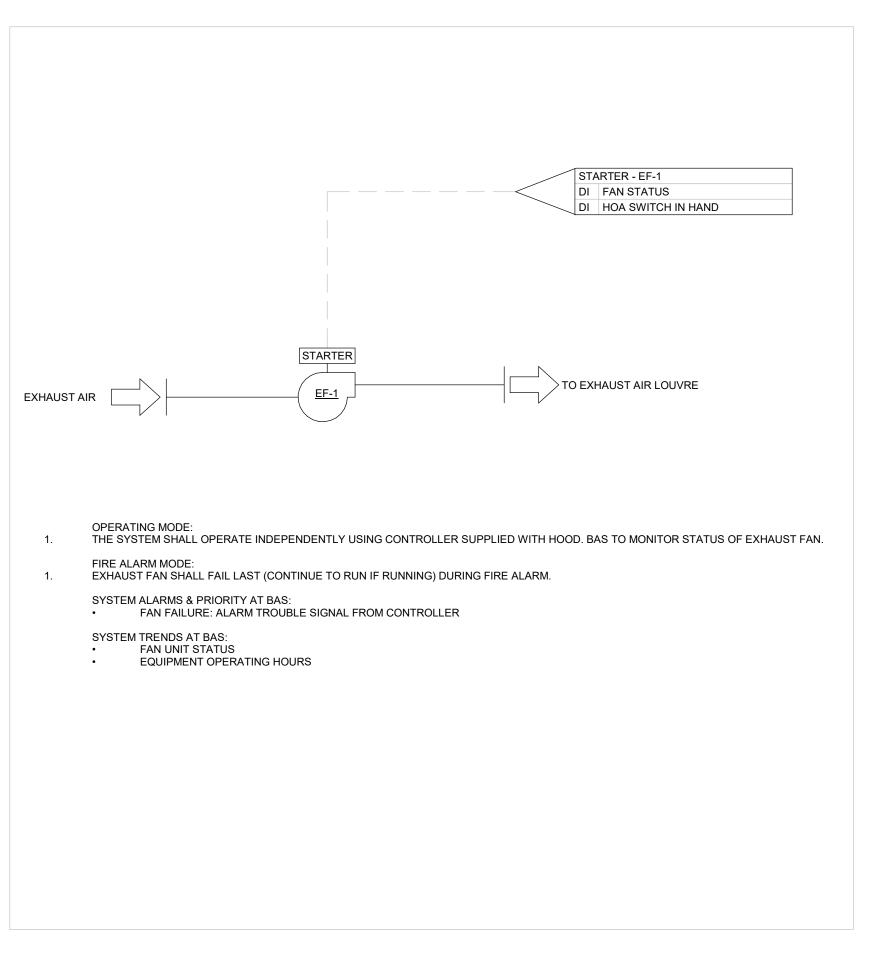
or Otto (Dometro Etc. 0 Ecc.)

City of Brampton Fire & Emergency Services


MECHANICAL DETAILS VIII

Date	2021-12-20	Project No	Drawing No
Drawn	by CMW	CM-20-063	M648

INDIRECT FIRED BENT TUBE HTR WIRING DETAIL






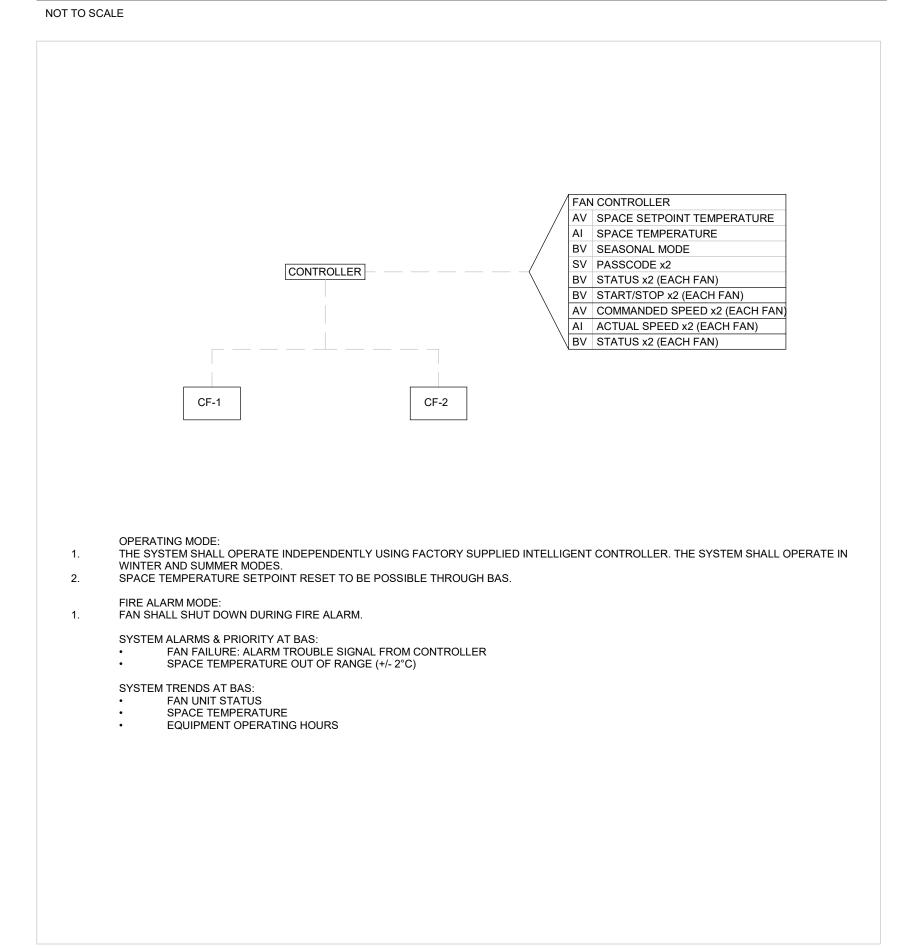



23 34 02.01 - CEILING MOUNTED DESTRATIFICATION FAN CONTROL SEQUENCE

NOT TO SCALE

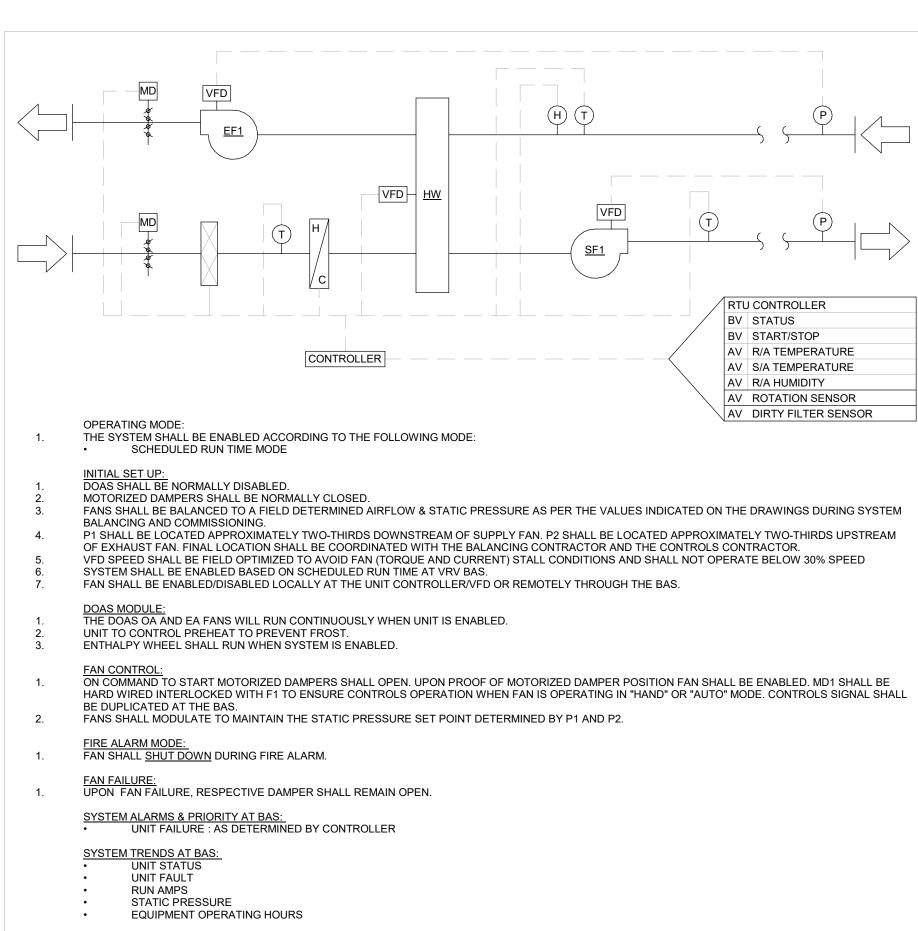

23 72 00.01 - DEDICATED OUTDOOR AIR SUPPLY UNIT DOAS-1 CONTROL SEQUENCE NOT TO SCALE

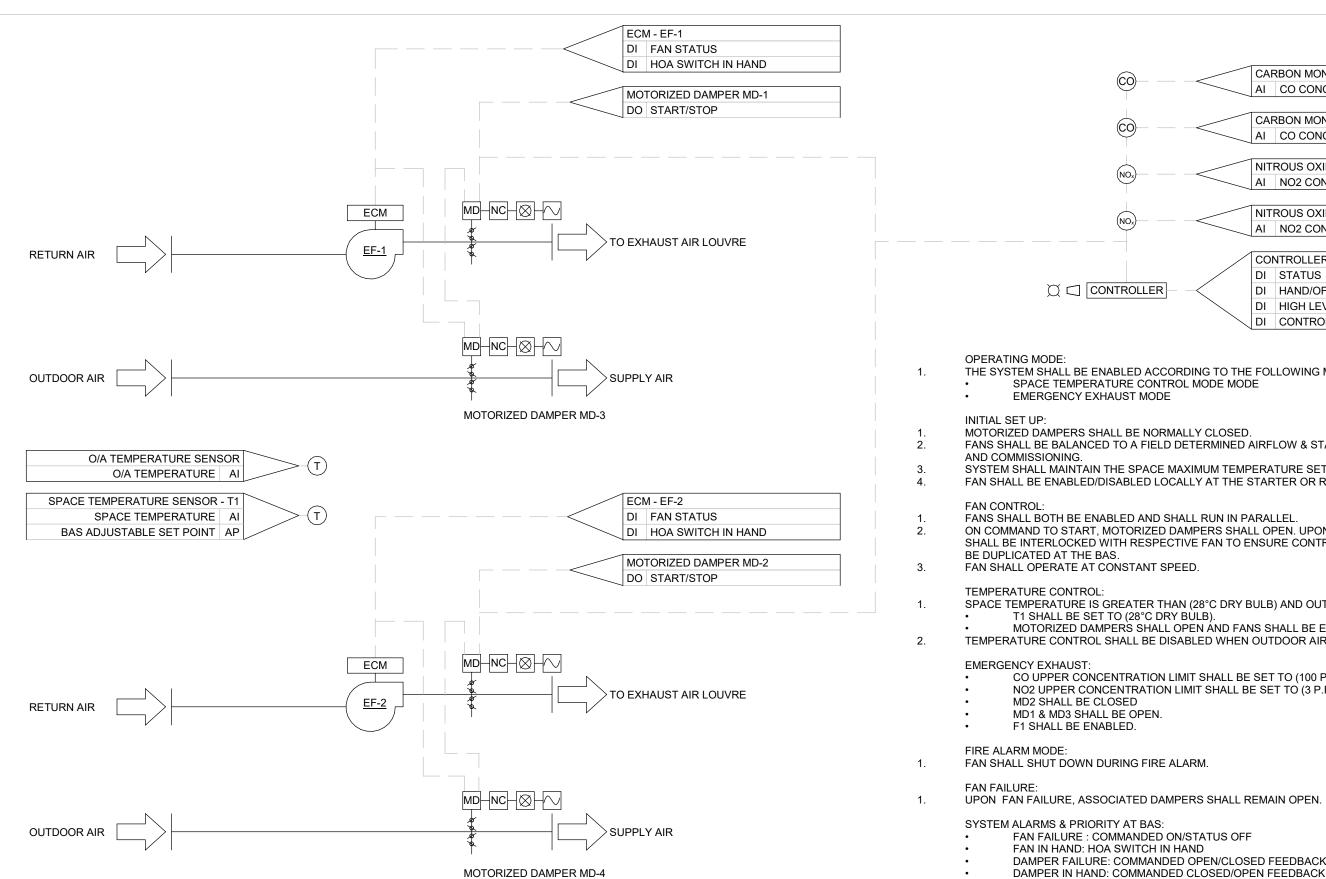

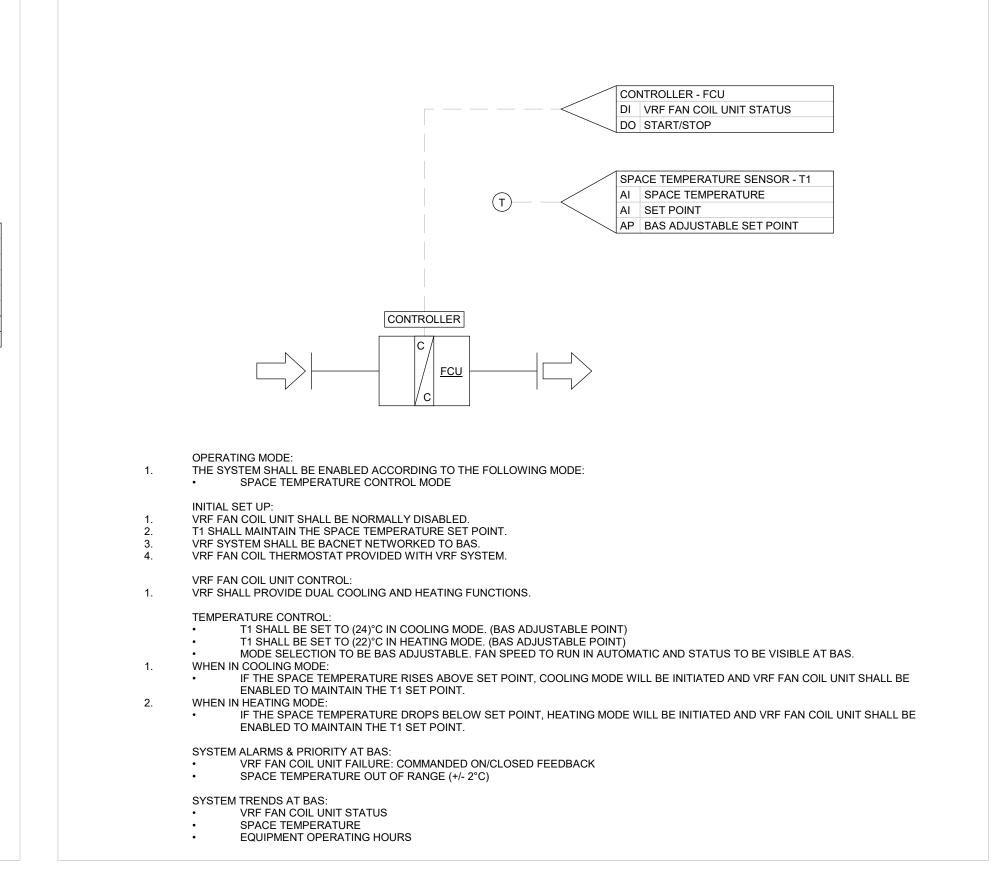

23 81 29.00 - VRF FAN COIL UNIT CONTROL SEQUENCE

NOT TO SCALE


MD1 & MD3 SHALL BE OPEN. F1 SHALL BE ENABLED.

FAN FAILURE : COMMANDED ON/STATUS OFF

DAMPER FAILURE: COMMANDED OPEN/CLOSED FEEDBACK

DAMPER IN HAND: COMMANDED CLOSED/OPEN FEEDBACK

FAN IN HAND: HOA SWITCH IN HAND

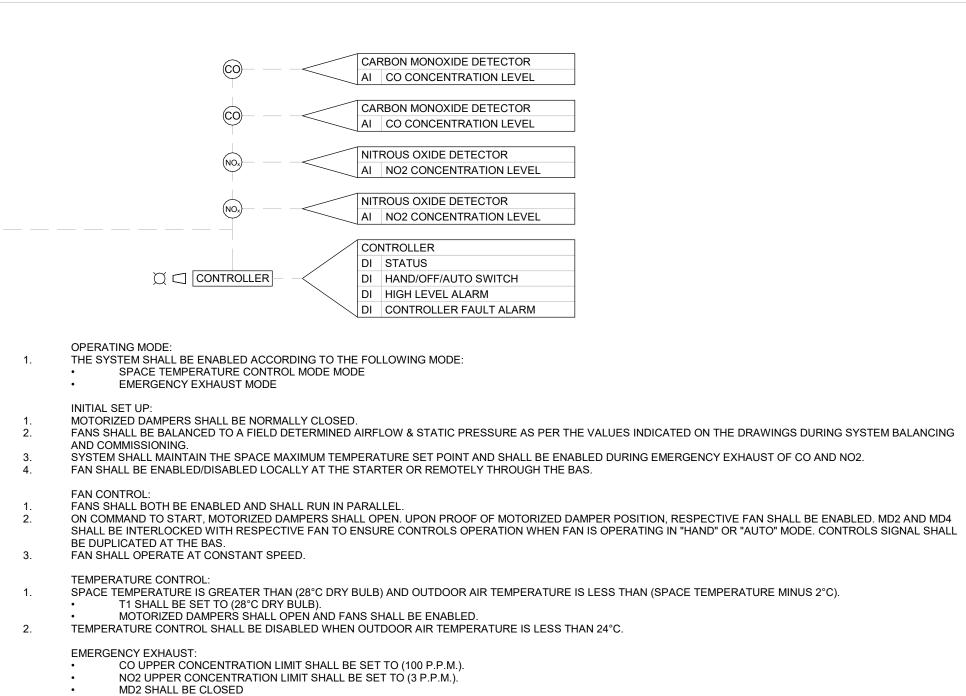

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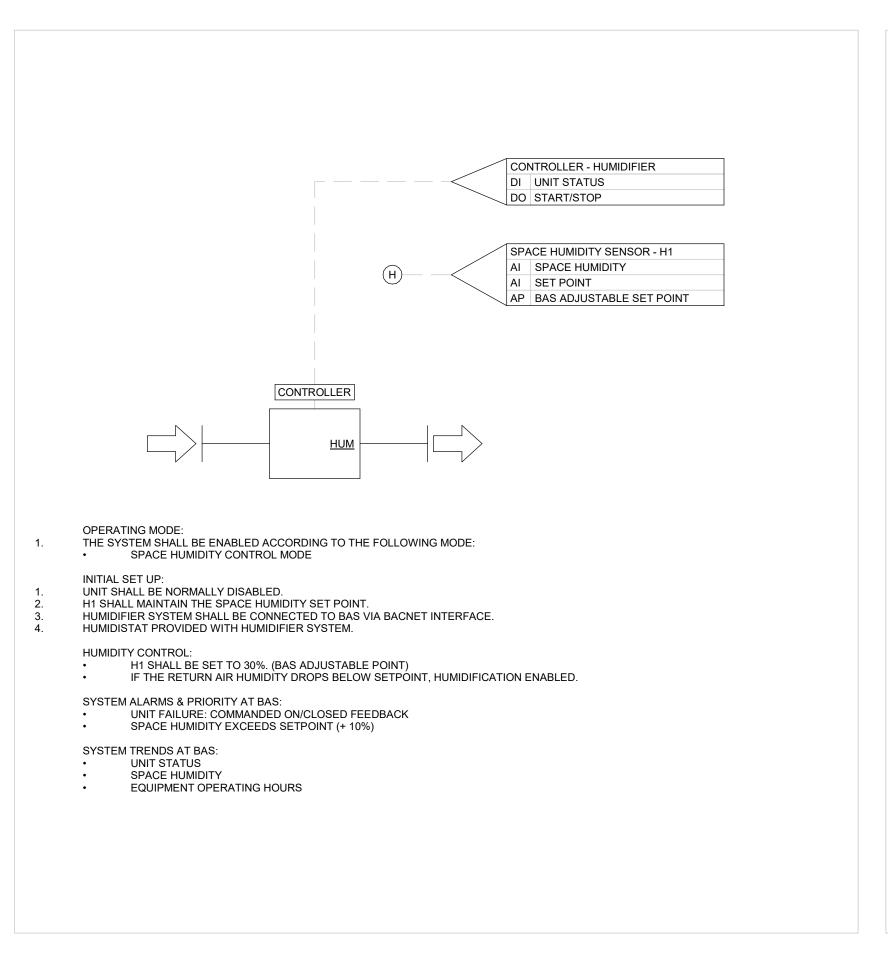
City of Brampton Fire & Emergency Services


Drawing Title


CONTROL SEQUENCES |

Date	e 2021-12-20	Project No	Drawing N
Drav	on by CMW	CM-20-063	M65
Scal	le N.T.S.		


23 34 00.03 - APPARATUS BAY FAN CONTROL SEQUENCE NOT TO SCALE



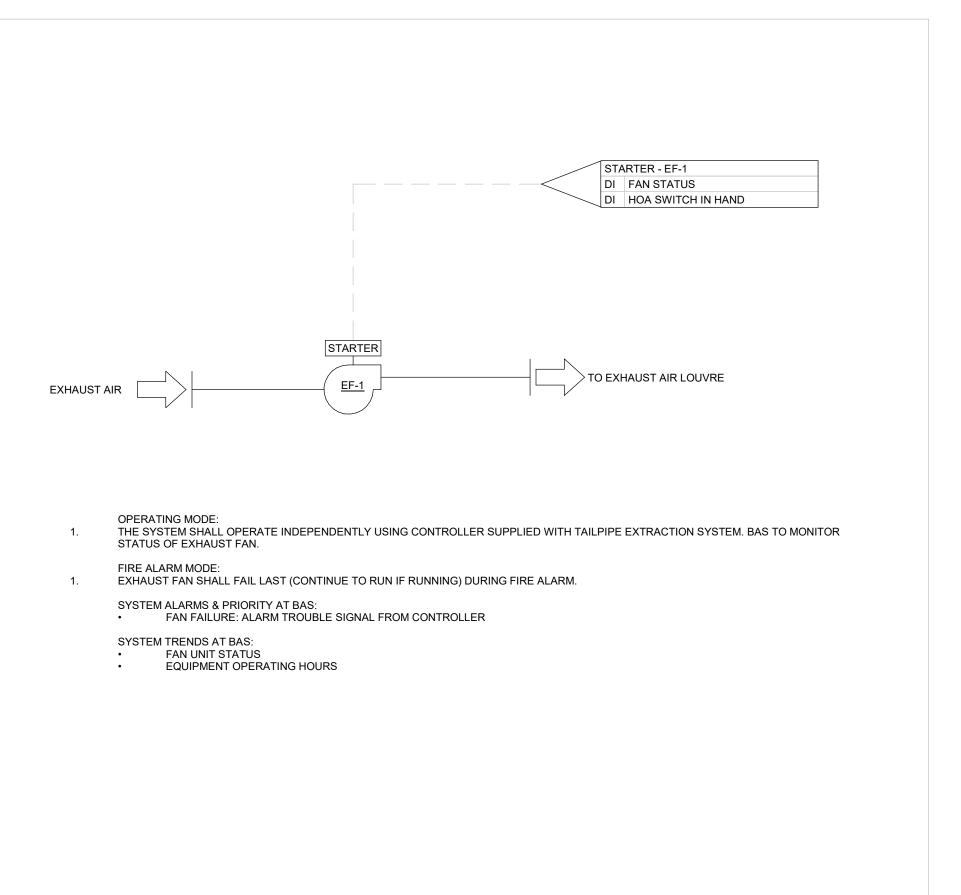

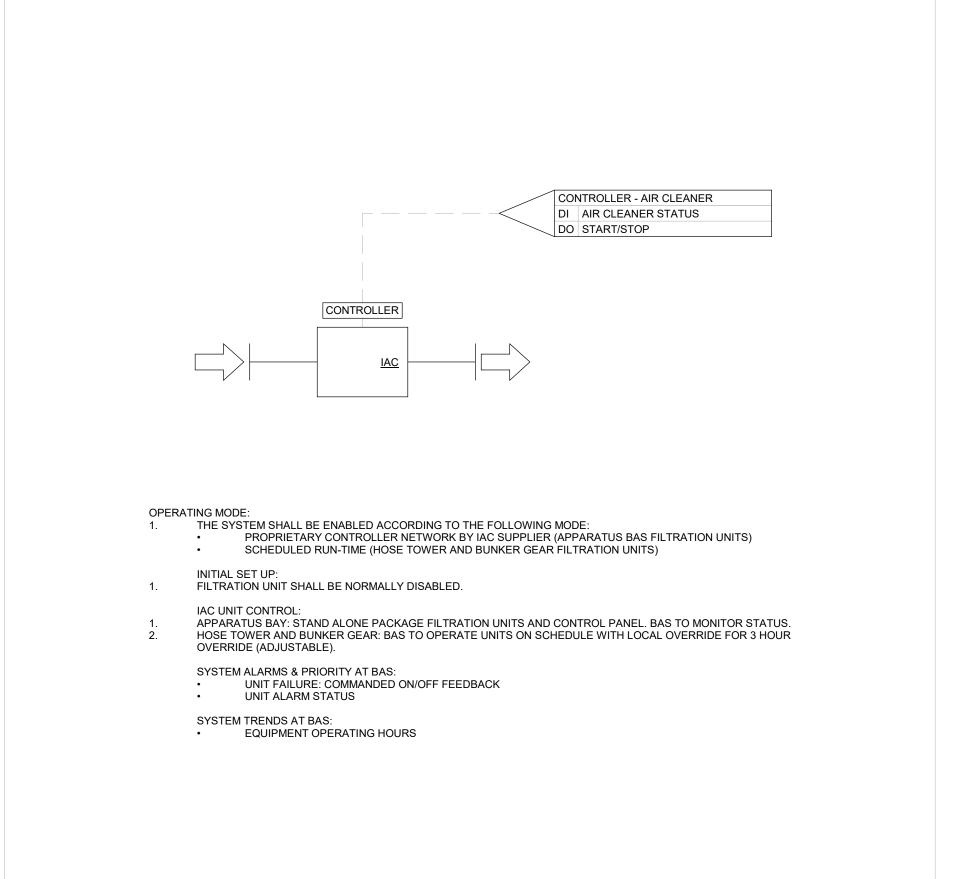

23 84 00.02 - HUMIDIFIER CONTROL SEQUENCE

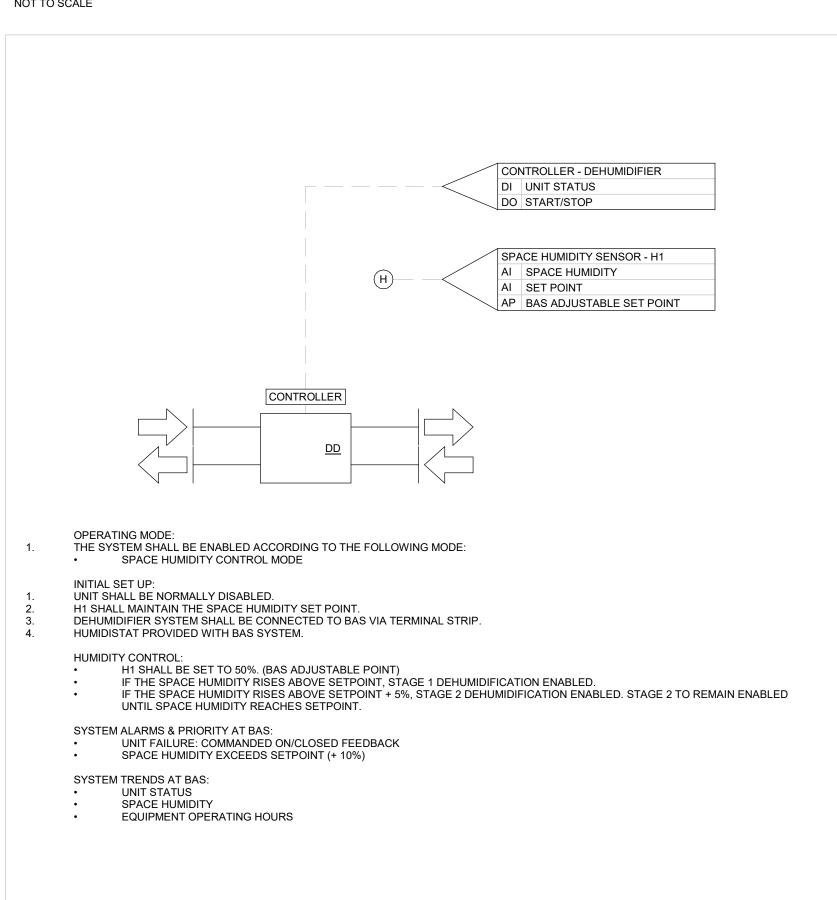

23 35 22.00 - STRAIGHT RAIL VEHICLE EXHAUST CONTROL SEQUENCE

PRESSURE SENSOR - P1 AV STATIC PRESSURE AP BAS ADJUSTABLE SET POINT GAS FIRED DX COOLING COIL CONDENSING HEATING COIL UNIT RTU CONTROLLER BV STATUS BV START/STOP CONTROLLER BV FILTER STATUS AV S/A TEMPERATURE AV R/A HUMIDITY

SPACE TEMPERATURE SENSOR - T1

AP BAS ADJUSTABLE SET POINT

AI SPACE TEMPERATURE

AI SET POINT

23 35 16.00 - INDOOR AIR CLEANER UNIT CONTROL SEQUENCE

OPERATING MODE: THE SYSTEM SHALL BE ENABLED ACCORDING TO THE FOLLOWING MODE:

HARDWIRED START SIGNAL FROM KITCHEN HOOD CONTROLLER.

INITIAL SET UP: THE SYSTEM SHALL BE A 100% OUTDOOR AIR MAKEUP UNIT.
THE ROOF TOP UNIT SHALL BE SUPPLIED WITH A BACNET/MSTP CONTROLLER CAPABLE OF INTERFACING WITH THE BAS. THE ROOF TOP UNIT SHALL BE CAPABLE OF PROVIDING THE FOLLOWING FUNCTIONS:

• MECHANICAL COOLING VIA DX COOLING COIL AND CONDENSING UNIT. MECHANICAL HEATING VIA GAS FIRED HEATING COIL AND BURNER.

BAS VENDOR TO PROVIDE TEMPERATURE SENSOR. WHERE ECONOMIZER CONTROL IS AVAILABLE TO ALLOW FOR FREE COOLING, MINIMUM DAMPER POSITIONS SHALL BE RECORDED TO ENSURE THAT THE MINIMUM OUTDOOR AIR VALUE AS SCHEDULED IS PROVIDED AT ALL TIMES.

OUTDOOR AIR DAMPER SHALL BE NORMALLY CLOSED. FAN SHALL BE BALANCED TO A FIELD DETERMINED AIRFLOW & STATIC PRESSURE AS PER THE VALUES INDICATED ON THE DRAWINGS DURING SYSTEM BALANCING AND COMMISSIONING.

> 2021-12-20 Author

P1 SHALL BE LOCATED APPROXIMATELY TWO-THIRDS DOWNSTREAM/UPSTREAM OF THE FAN. FINAL LOCATION SHALL BE COORDINATED WITH THE BALANCING CONTRACTOR AND THE CONTROLS CONTRACTOR. ECM SPEED SHALL BE FIELD OPTIMIZED TO AVOID FAN (TORQUE AND CURRENT) STALL CONDITIONS AND SHALL NOT OPERATE BELOW 30% ON COMMAND TO START OUTDOOR AIR DAMPER SHALL OPEN. UPON PROOF OF MOTORIZED DAMPER POSITION FAN SHALL BE ENABLED. FAN SHALL MODULATE TO MAINTAIN THE STATIC PRESSURE SET POINT DETERMINED BY P1. TEMPERATURE CONTROL T1 SHALL BE SET TO (25°C DRY BULB). GAS FIRED HEATING COIL SHALL BE DISABLED. DX COOLING COIL SHALL MODULATE TO MAINTAIN THE T1 SET POINT. FREE COOLING IS NOT REQUIRED AND HEATING IS REQUIRED. T1 SHALL BE SET TO (22°C DRY BULB). DX COOLING COIL SHALL BE DISABLED. GAS FIRED HEATING COIL SHALL MODULATE OPEN TO MAINTAIN THE T1 SET POINT. FIRE ALARM MODE: FAN SHALL SHUT DOWN DURING FIRE ALARM. UPON SUPPLY FAN FAILURE, OUTDOOR AIR DAMPER SHALL BE CLOSED. HIGH LIMIT DUCT STATIC PRESSURE SENSOR SHALL BE HARDWIRED INTERLOCKED WITH THE SUPPLY FAN AND DISABLE THE FAN WHEN THE PRESSURE EXCEEDS 3 IN/WC. SHUTDOWN TO BE HARDWIRE INTERLOCKED WITH EXHAUST FAN TO SHUT DOWN HOOD. SYSTEM ALARMS & PRIORITY AT BAS: FAN FAILURE: COMMANDED ON/STATUS OFF FAN IN HAND: COMMANDED OFF/STATUS ON DAMPER FAILURE: COMMANDED ON/CLOSED FEEDBACK DAMPER IN HAND: COMMANDED OFF/OPEN FEEDBACK HIGH SUPPLY AIR TEMPERATURE: T1 IS GREATER THAN 28°C FOR MORE THAN 30 MINUTES LOW SUPPLY AIR TEMPERATURE: T1 IS LOWER THAN 10°C FOR MORE THAN 30 MINUTES FREEZE STAT: T1 IS EQUAL TO OR LOWER THAN 4°C SYSTEM TRENDS AT BAS: DIRTY FILTER STATUS FAN STATUS DIFFERENTIAL PRESSURE S/A TEMPERATURE RTU CONTROLLER ANALOG VARIABLE (AV) POINTS AS AVAILABLE ON THE CONTROLLER RTU CONTROLLER BINARY VARIABLE (BV) POINTS AS AVAILABLE ON THE CONTROLLER

23 74 23.01 - PACKAGED ROOF TOP MAKEUP AIR UNIT CONTROL SEQUENCE NOT TO SCALE

23 84 00.01 - DESICCANT DEHUMIDIFIER CONTROL SEQUENCE

Scale N.T.S.

FOR QUESTIONS REGARDING THIS PROJECT, PLEASE

EMAIL: CM-20-063@QUASARCG.COM

2021-08-12

ISSUED FOR CONSTRUCTION B ISSUED FOR BUILDING PERMIT

The specifications are to be considered as an integral part of these

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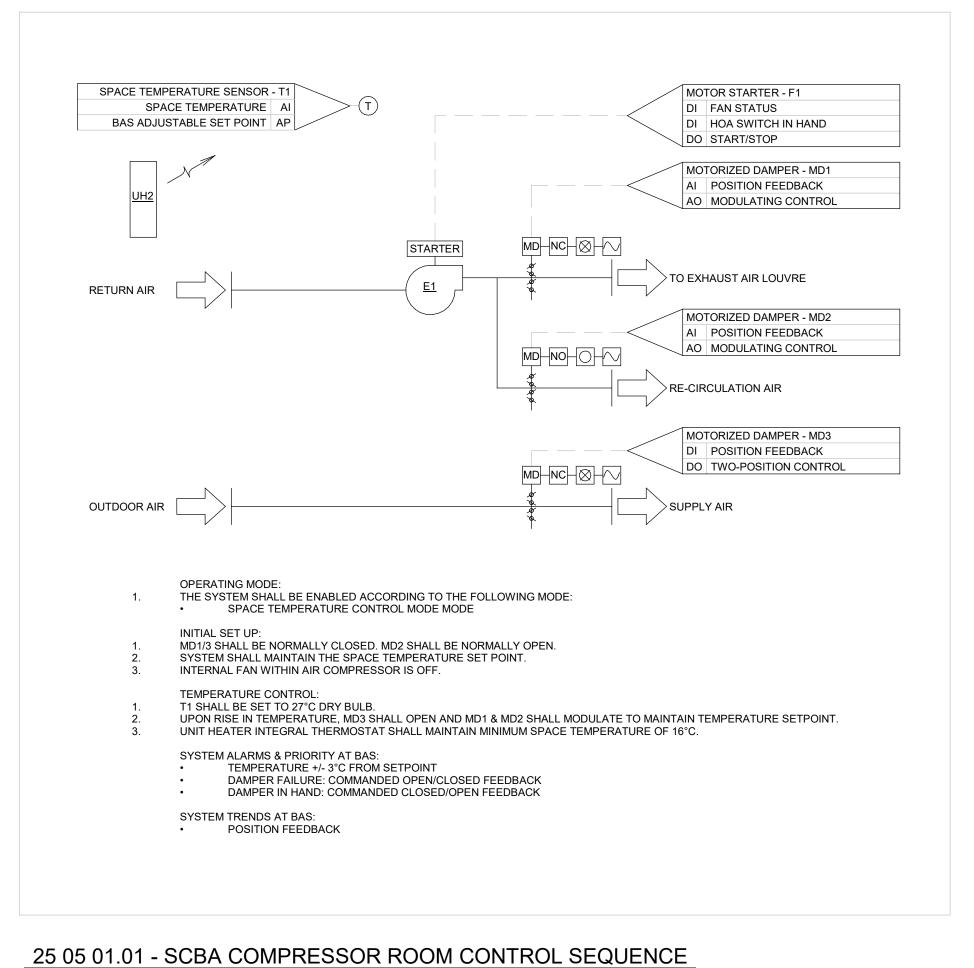
BFES Station 201


(SPA-2021-0032)


27 Rutherford Rd. S., Brampton, ON, L6W 3J3

City of Brampton Fire & Emergency Services

CONTROL SEQUENCES II



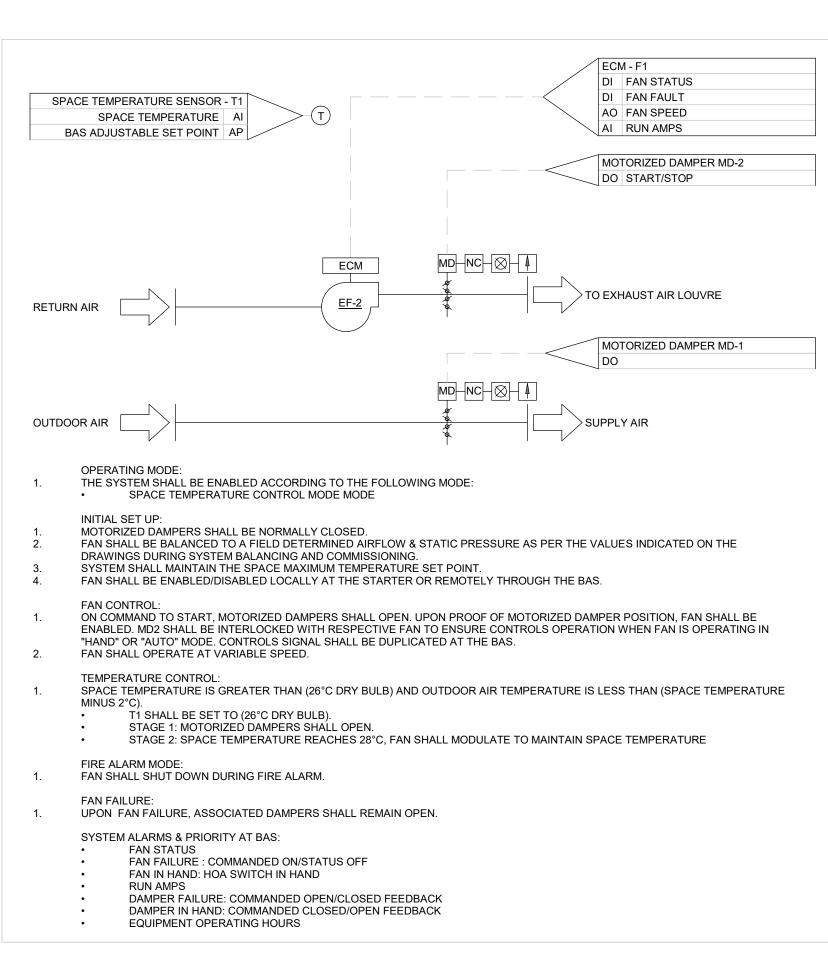

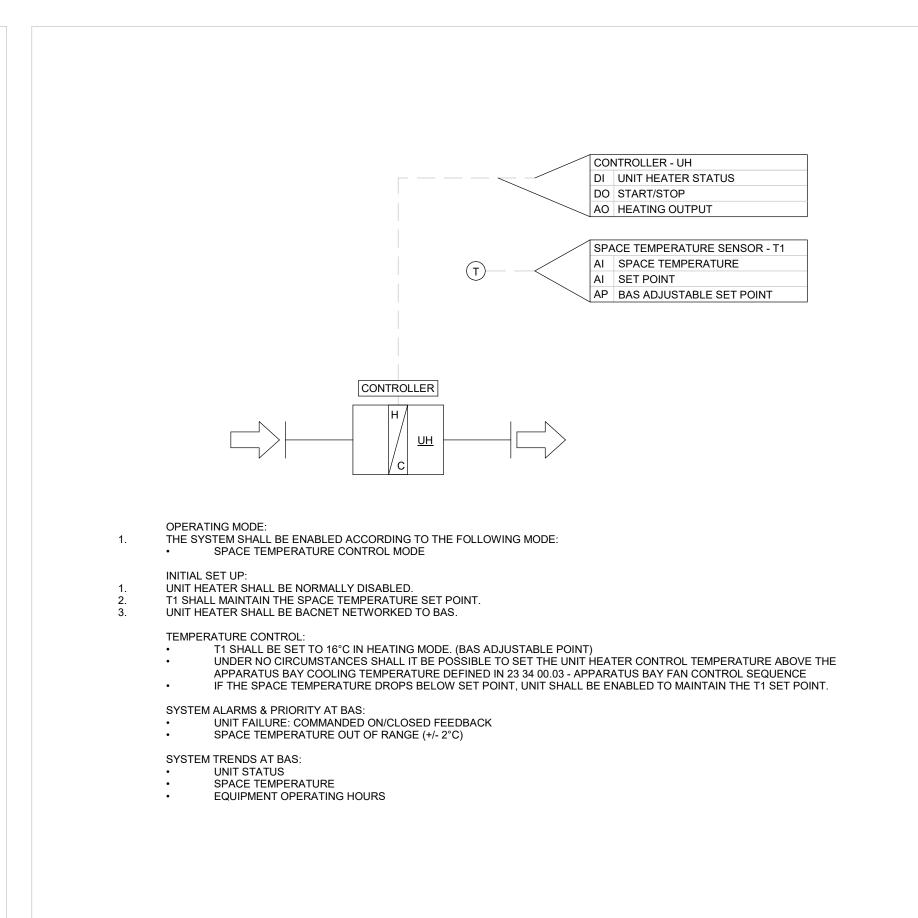

D ISSUED FOR CONSTRUCTION ADDENDUM M03 2021-10-29 B REISSUED FOR BUILDING PERMIT
A ISSUED FOR TENDER 2021-09-15 2021-08-12 Orientation The specifications are to be considered as an integral part of these drawings and neither the drawings nor the specifications shall be used alone. Refer to architectural drawings for dimensions. Do not © Copyright Reserved: These drawings and all that is represented herein are the exclusive property of Quasar Consulting Group.

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FOR QUESTIONS REGARDING THIS PROJECT, PLEASE EMAIL: CM-20-063@QUASARCG.COM

23 34 00.01 - ELECTRICAL ROOM VARIABLE SPEED FAN CONTROL SEQUENCE NOT TO SCALE

23 55 00.01 - GAS-FIRED UNIT HEATER CONTROL SEQUENCE

NOT TO SCALE

2021-12-20 Drawn by Author 1:1

Scale