

ELECTRICAL DRAWING LIST	
Sheet Number	Sheet Name
E0000	DRAWING LIST
E1101	ELECTRICAL DEMOLITION PLAN 1ST FLOOR
E1102	ELECTRICAL DEMOLITION ENLARGED PLAN 1ST FLOOR PART 1
E1103	ELECTRICAL DEMOLITION ENLARGED PLAN 1ST FLOOR PART 2
E1104	ELECTRICAL DEMOLITION ENLARGED PLAN 1ST FLOOR PART 3
E1105	ELECTRICAL DEMOLITION PLAN 2ND FLOOR
E1106	ELECTRICAL DEMOLITION ENLARGED PLAN 2ND FLOOR PART 1
E1107	ELECTRICAL DEMOLITION ENLARGED PLAN 2ND FLOOR PART 2
E1108	ELECTRICAL DEMOLITION ENLARGED PLAN 2ND FLOOR PART 3
E1109	ELECTRICAL DEMOLITION 3RD FLOOR
E1110	ELECTRICAL DEMOLITION ENLARGED PLAN 3RD FLOOR PARTIAL PLANS
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E2101	POWER & SYSTEMS PLAN 1ST FLOOR KEY PLAN
E2103	POWER & SYSTEMS ENLARGED PLAN 1ST FLOOR PART 1
E2104	POWER & SYSTEMS ENLARGED PLAN 1ST FLOOR PART 2
E2105	POWER & SYSTEMS ENLARGED PLAN 1ST FLOOR PART 3
E2106	POWER & SYSTEMS PLAN 2ND FLOOR KEY PLAN
E2107	POWER & SYSTEMS ENLARGED PLAN 2ND FLOOR PART 1
E2108	POWER & SYSTEMS ENLARGED PLAN 2ND FLOOR PART 2
E2109	POWER & SYSTEMS ENLARGED PLAN 2ND FLOOR PART 3
E2110	POWER & SYSTEMS PLAN 3RD FLOOR KEY PLAN
E2111	POWER & SYSTEMS 3RD FLOOR PARTIAL PLANS

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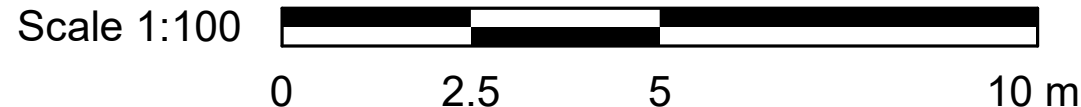
PROJECT ADDRESS
Fire/EMS HQ & EMS Station
53
4330 Dufferin St

PROJECT NO: 9119- 19- 0162 / IBI 122260	
DRAWN BY: M.BOJIC	CHECKED BY: P. WILLIAMS
PROJECT MGR: F.BOLOURIAN	APPROVED BY: P. WILLIAMS

SHEET TITLE
DRAWING LIST


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1
E1101

FIRST FLOOR DEMOLITION KEY PLAN
Scale: 1 : 250



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PROJECT ADDRESS

**Fire/EMS HQ & EMS Station
53
4330 Dufferin St**

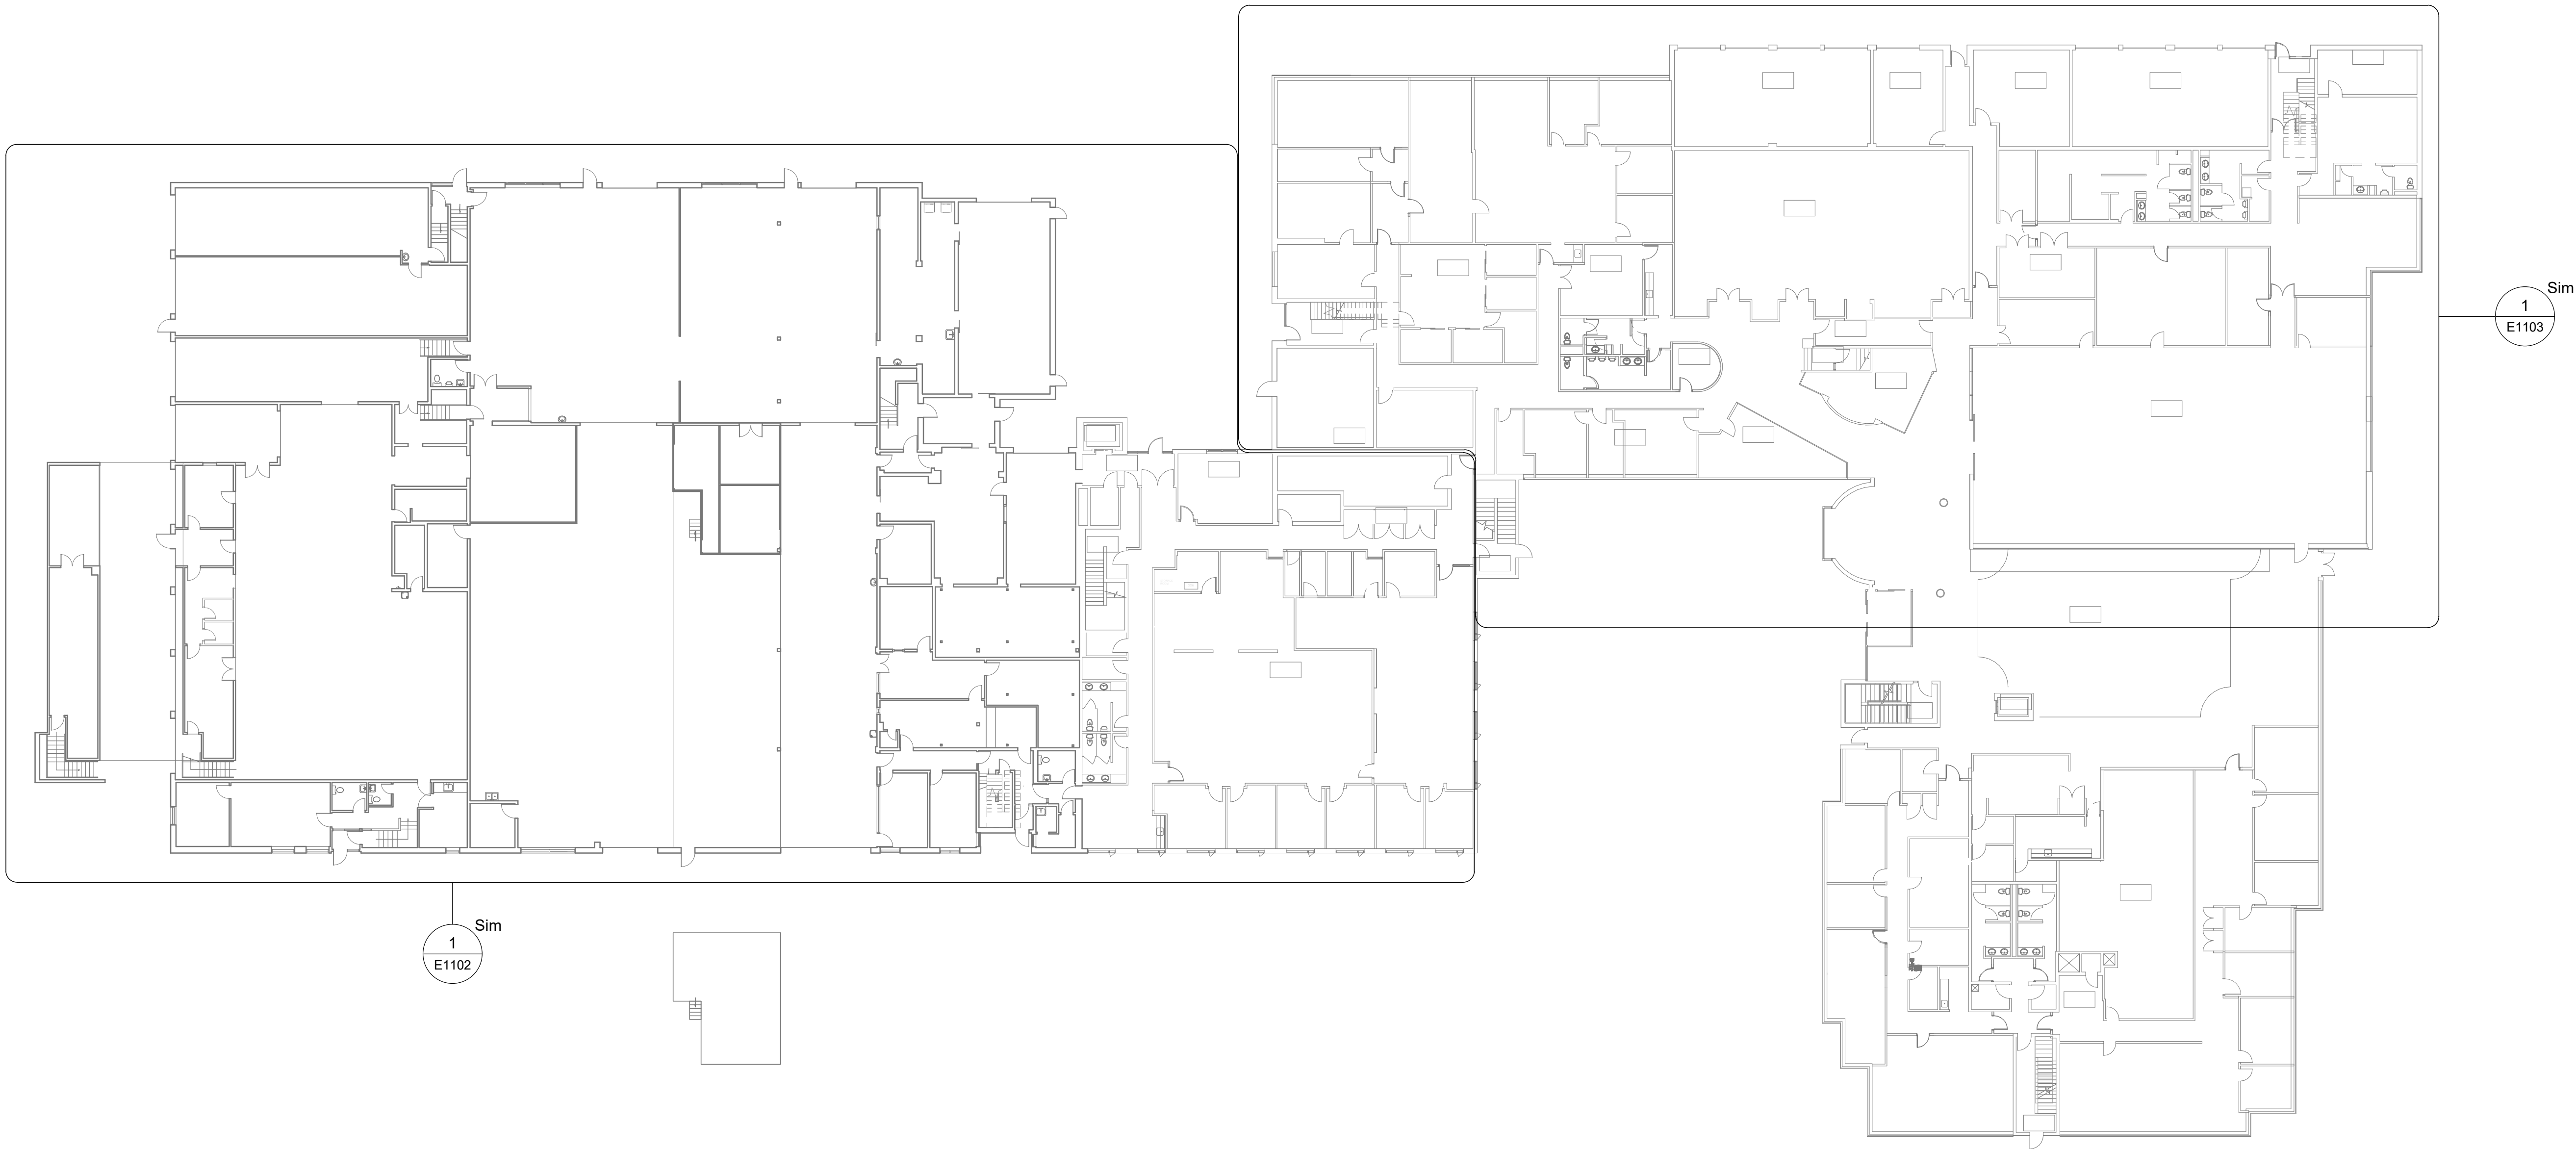PROJECT NO:
9119- 19- 0162 / IBI 122260

DRAWN BY:
M.BOJIC

CHECKED BY:
P. WILLIAMS

PROJECT MGR:
F.BOLOURIAN

APPROVED BY:
P. WILLIAMS

SHEET TITLE

**ELECTRICAL
DEMOLITION PLAN 1ST
FLOOR**

SHEET NUMBER

G08-229-E1101

ISSUE

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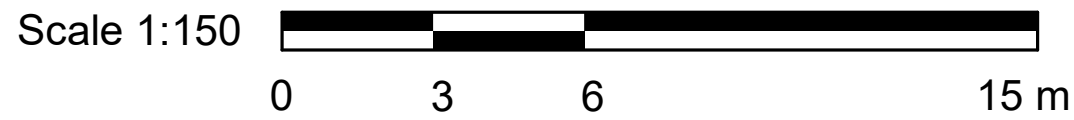
1
E1102

ELECTRICAL DEMOLITION PLAN 1ST FLOOR PART 1

Scale: 1 : 150

NOTES:

1. REMOVE EXISTING LIGHT SWITCHES SHOWN ON PLAN. PREPARE CIRCUITS FOR RE-USE FOR NEW LIGHT SWITCHES TO REPLACE DEMOLISHED.
2. RELOCATE FIRE PULL STATIONS SHOWN TO COMPLIANT TAG HEIGHT AS INDICATED ON MOUNTING HEIGHTS SCHEDULE.
3. REMOVE EXISTING SECURITY DEVICES SHOWN ON PLAN.



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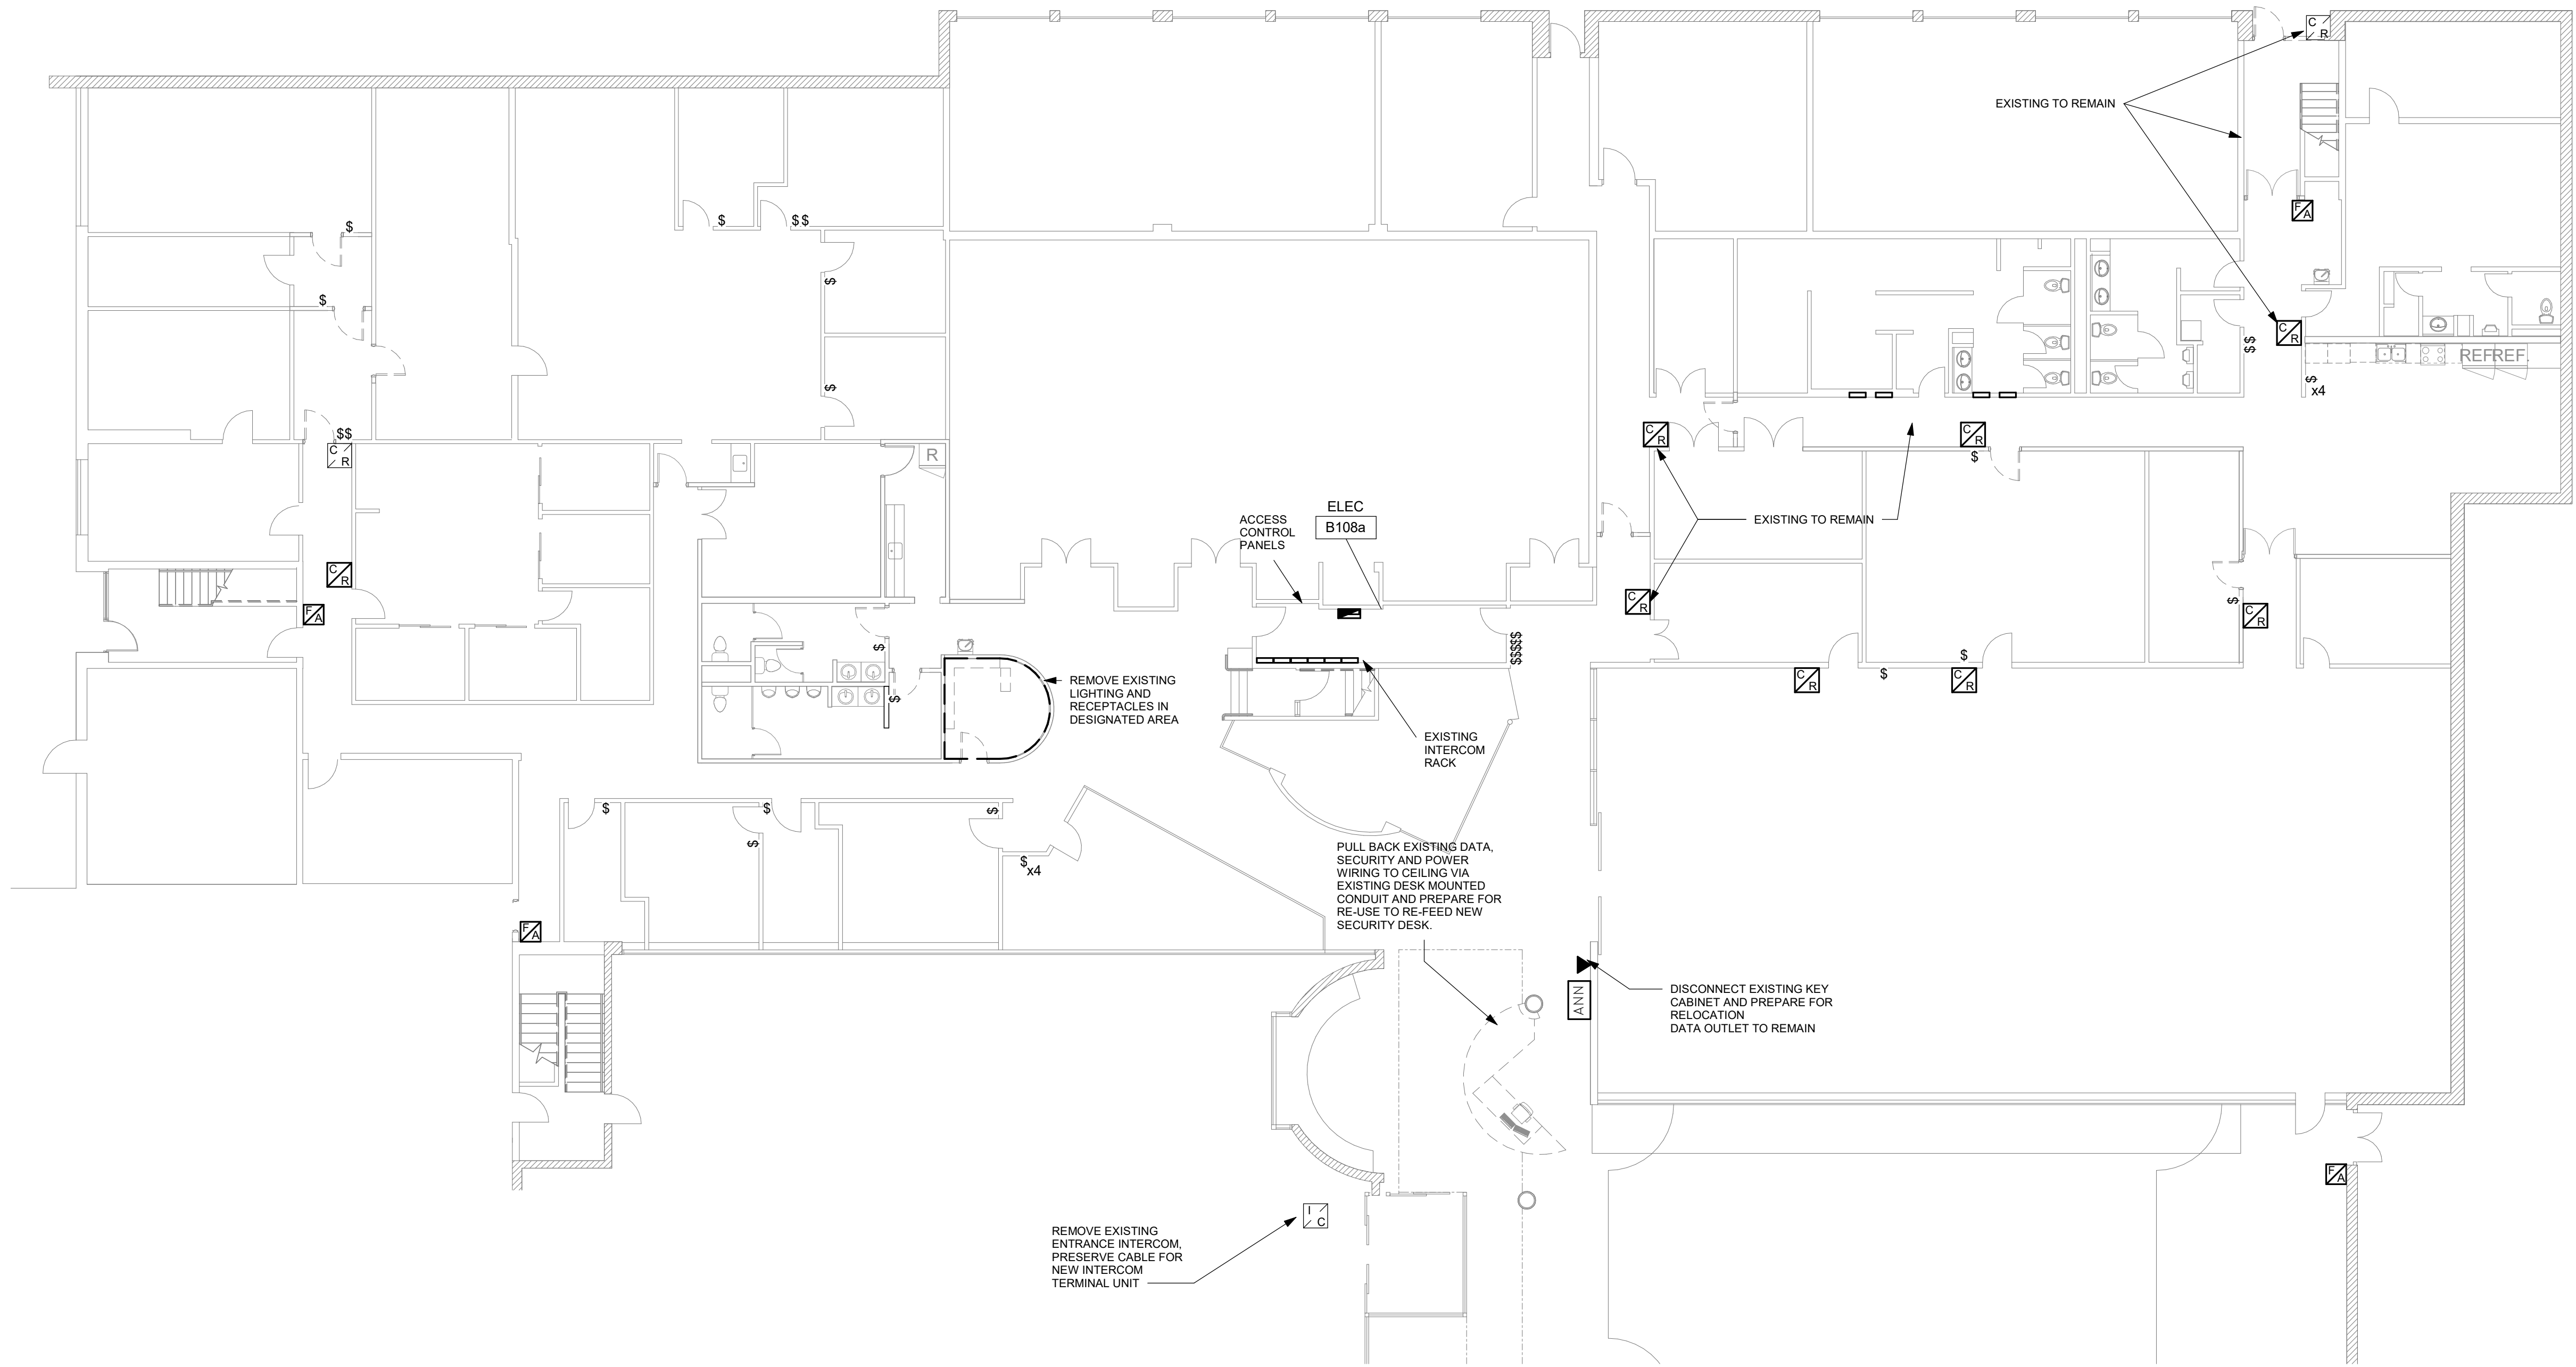
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PROJECT MGR: **F.BOLOURIAN** APPROVED BY: **Approver**

SHEET TITLE
**ELECTRICAL
DEMOLITION ENLARGED
PLAN 1ST FLOOR PART 1**

SHEET NUMBER
G08-229-E1102

ISSUE
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1 ELECTRICAL DEMOLITION PLAN 1ST FLOOR PART 2
E1103 Scale: 1 : 125

NOTES:

1. REMOVE EXISTING LIGHT SWITCHES SHOWN ON PLAN. PREPARE CIRCUITS FOR RE-USE FOR NEW LIGHT SWITCHES TO REPLACE DEMOLISHED.
2. RELOCATE FIRE PULL STATIONS SHOWN TO COMPLIANT TAGG HEIGHT AS INDICATED ON MOUNTING HEIGHTS SCHEDULE.
3. ADJUST INDICATED CARD READERS TO NEW TAGG COMPLIANT HEIGHTS (AS INDICATED IN MOUNTING HEIGHTS SCHEDULE). PROVIDE CABLING/CONDUIT AS NECESSARY TO FACILITATE RECONNECTION TO DOOR SECURITY BOX.

Scale 1:100
0 2.5 5 10 m

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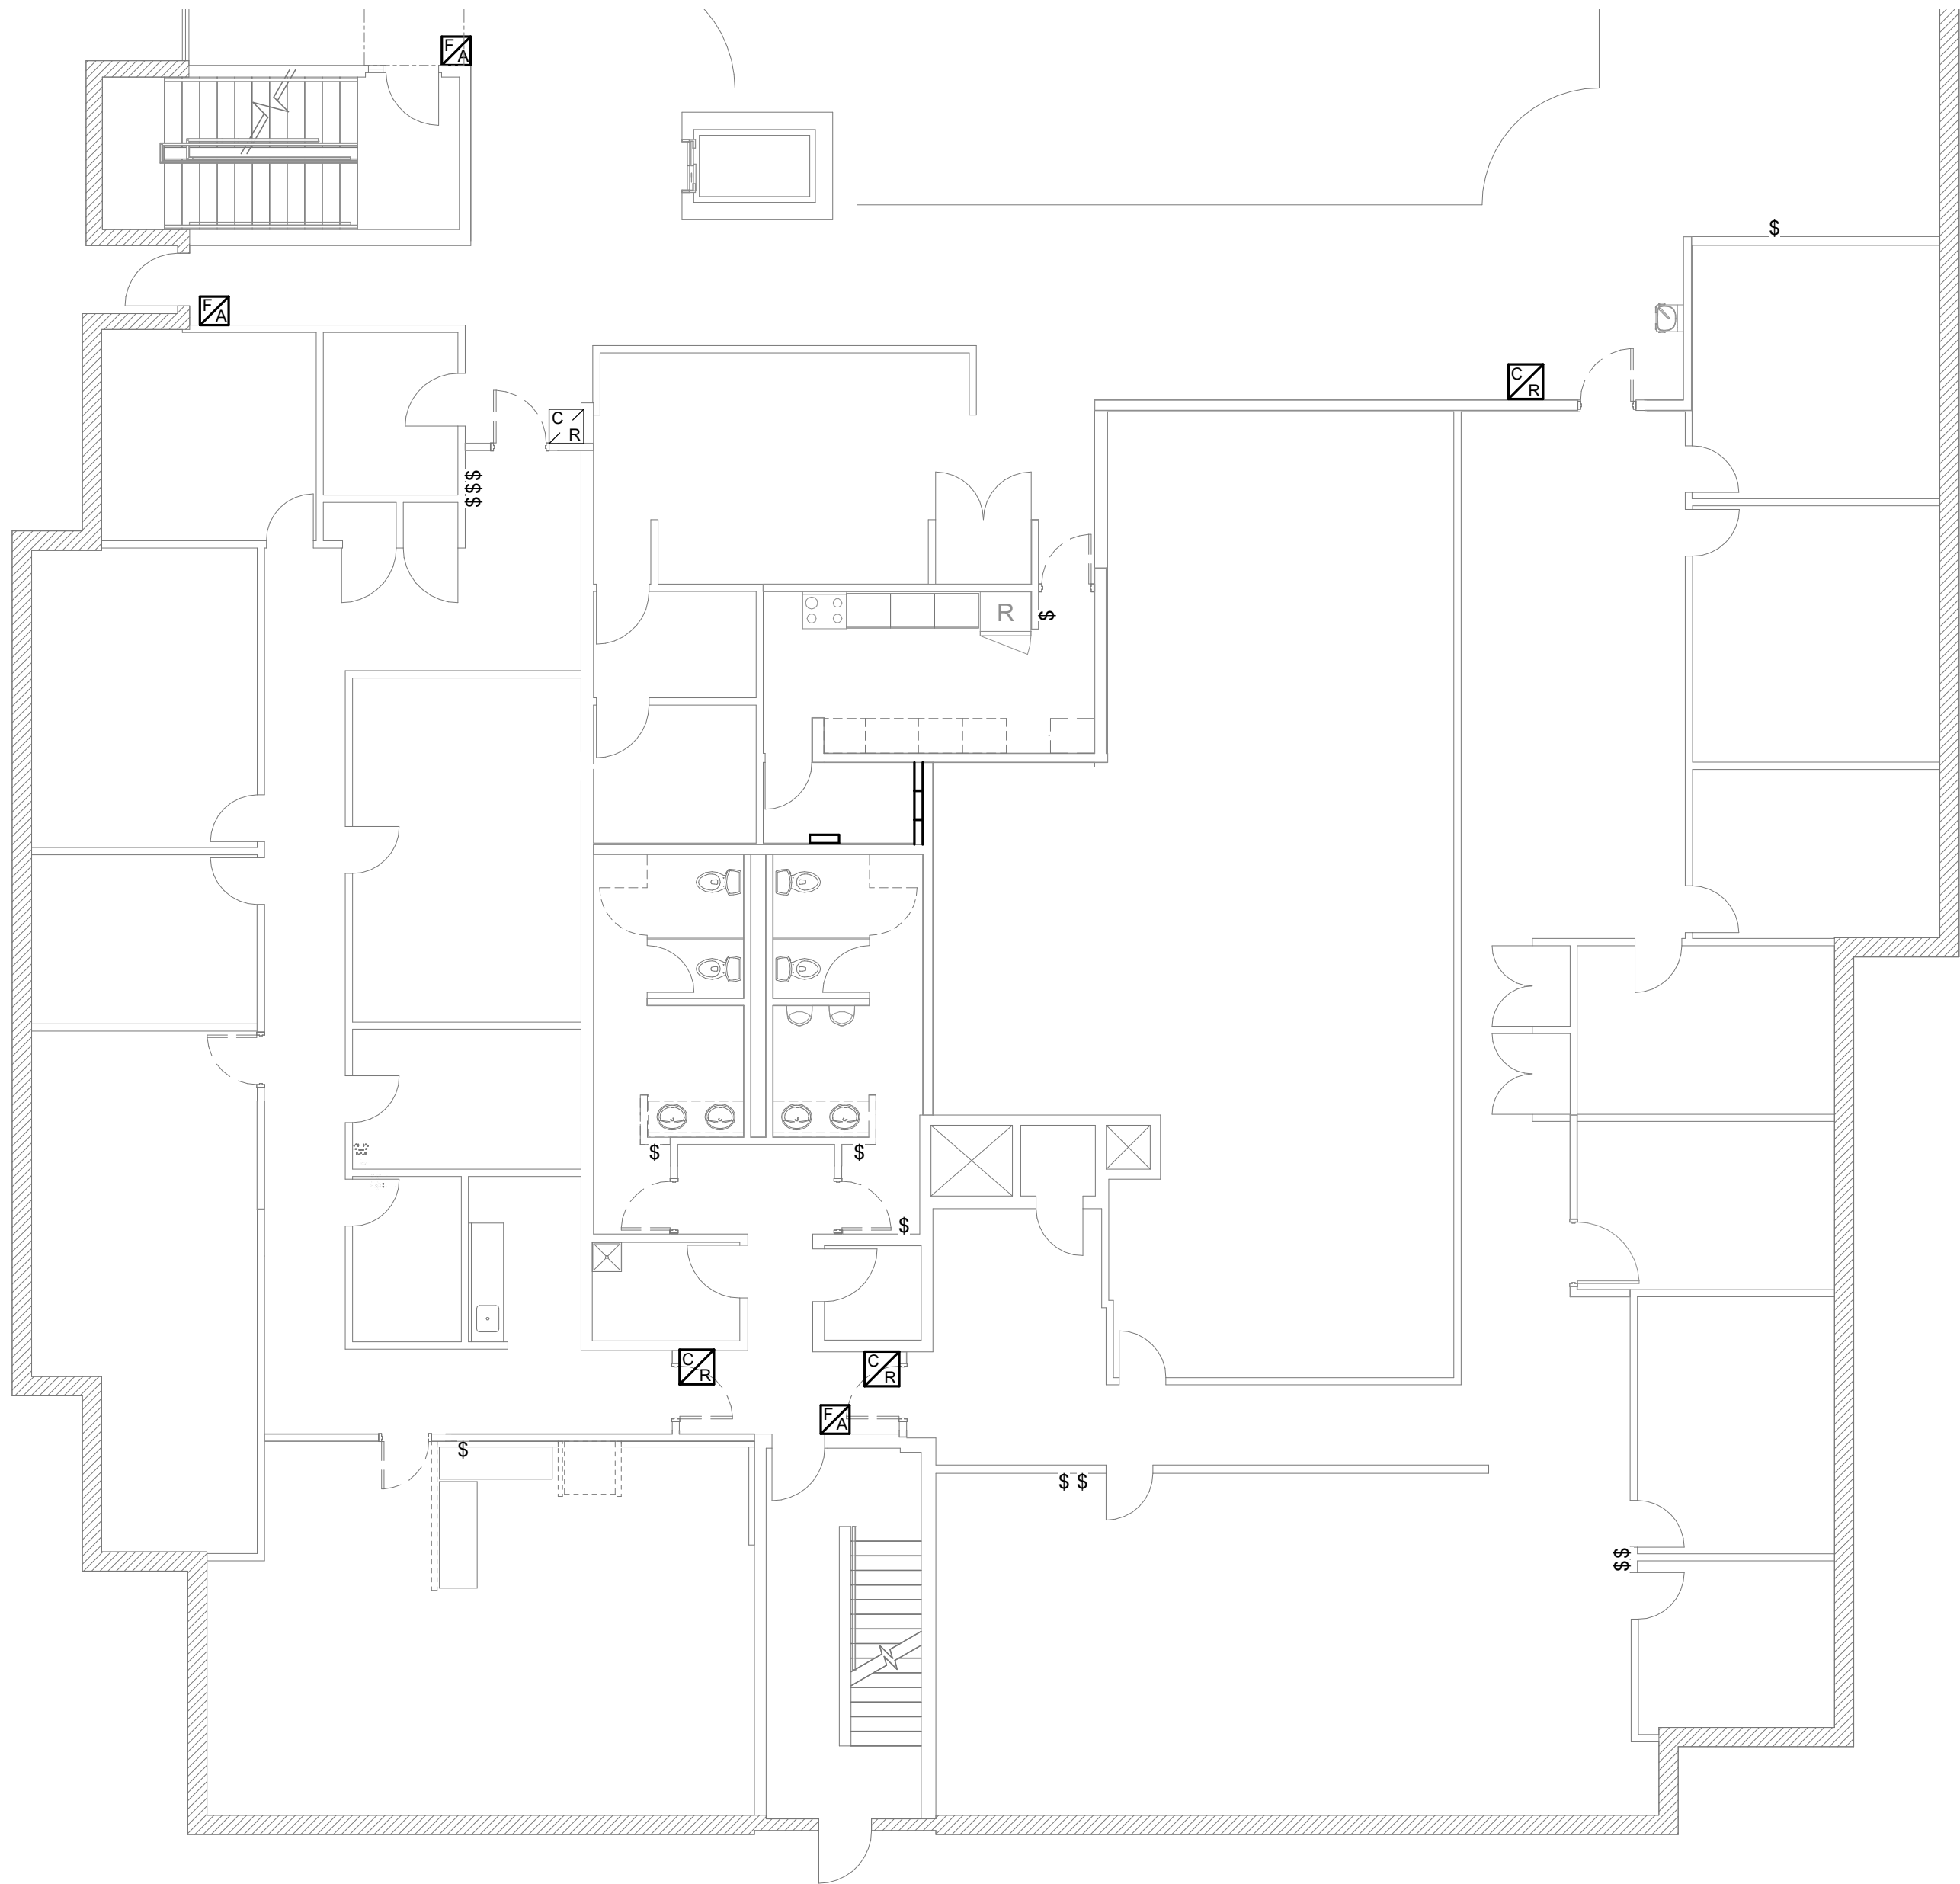
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PROJECT MGR:
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ELECTRICAL
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PLAN 1ST FLOOR PART 2

SHEET NUMBER
G08-229-E1103
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1 ELECTRICAL DEMOLITION PLAN 1ST FLOOR PART 3
E1104 Scale: 1 : 100

NOTES:

1. REMOVE EXISTING LIGHT SWITCHES SHOWN ON PLAN. PREPARE CIRCUITS FOR RE-USE FOR NEW LIGHT SWITCHES TO REPLACE DEMOLISHED.
2. RELOCATE FIRE PULL STATIONS SHOWN TO COMPLIANT TAGG HEIGHT AS INDICATED ON MOUNTING HEIGHTS SCHEDULE.
3. ADJUST INDICATED CARD READERS TO NEW TAGG COMPLIANT HEIGHTS (AS INDICATED IN MOUNTING HEIGHTS SCHEDULE). PROVIDE CABLING/CONDUIT AS NECESSARY TO FACILITATE RECONNECTION TO DOOR SECURITY BOX.



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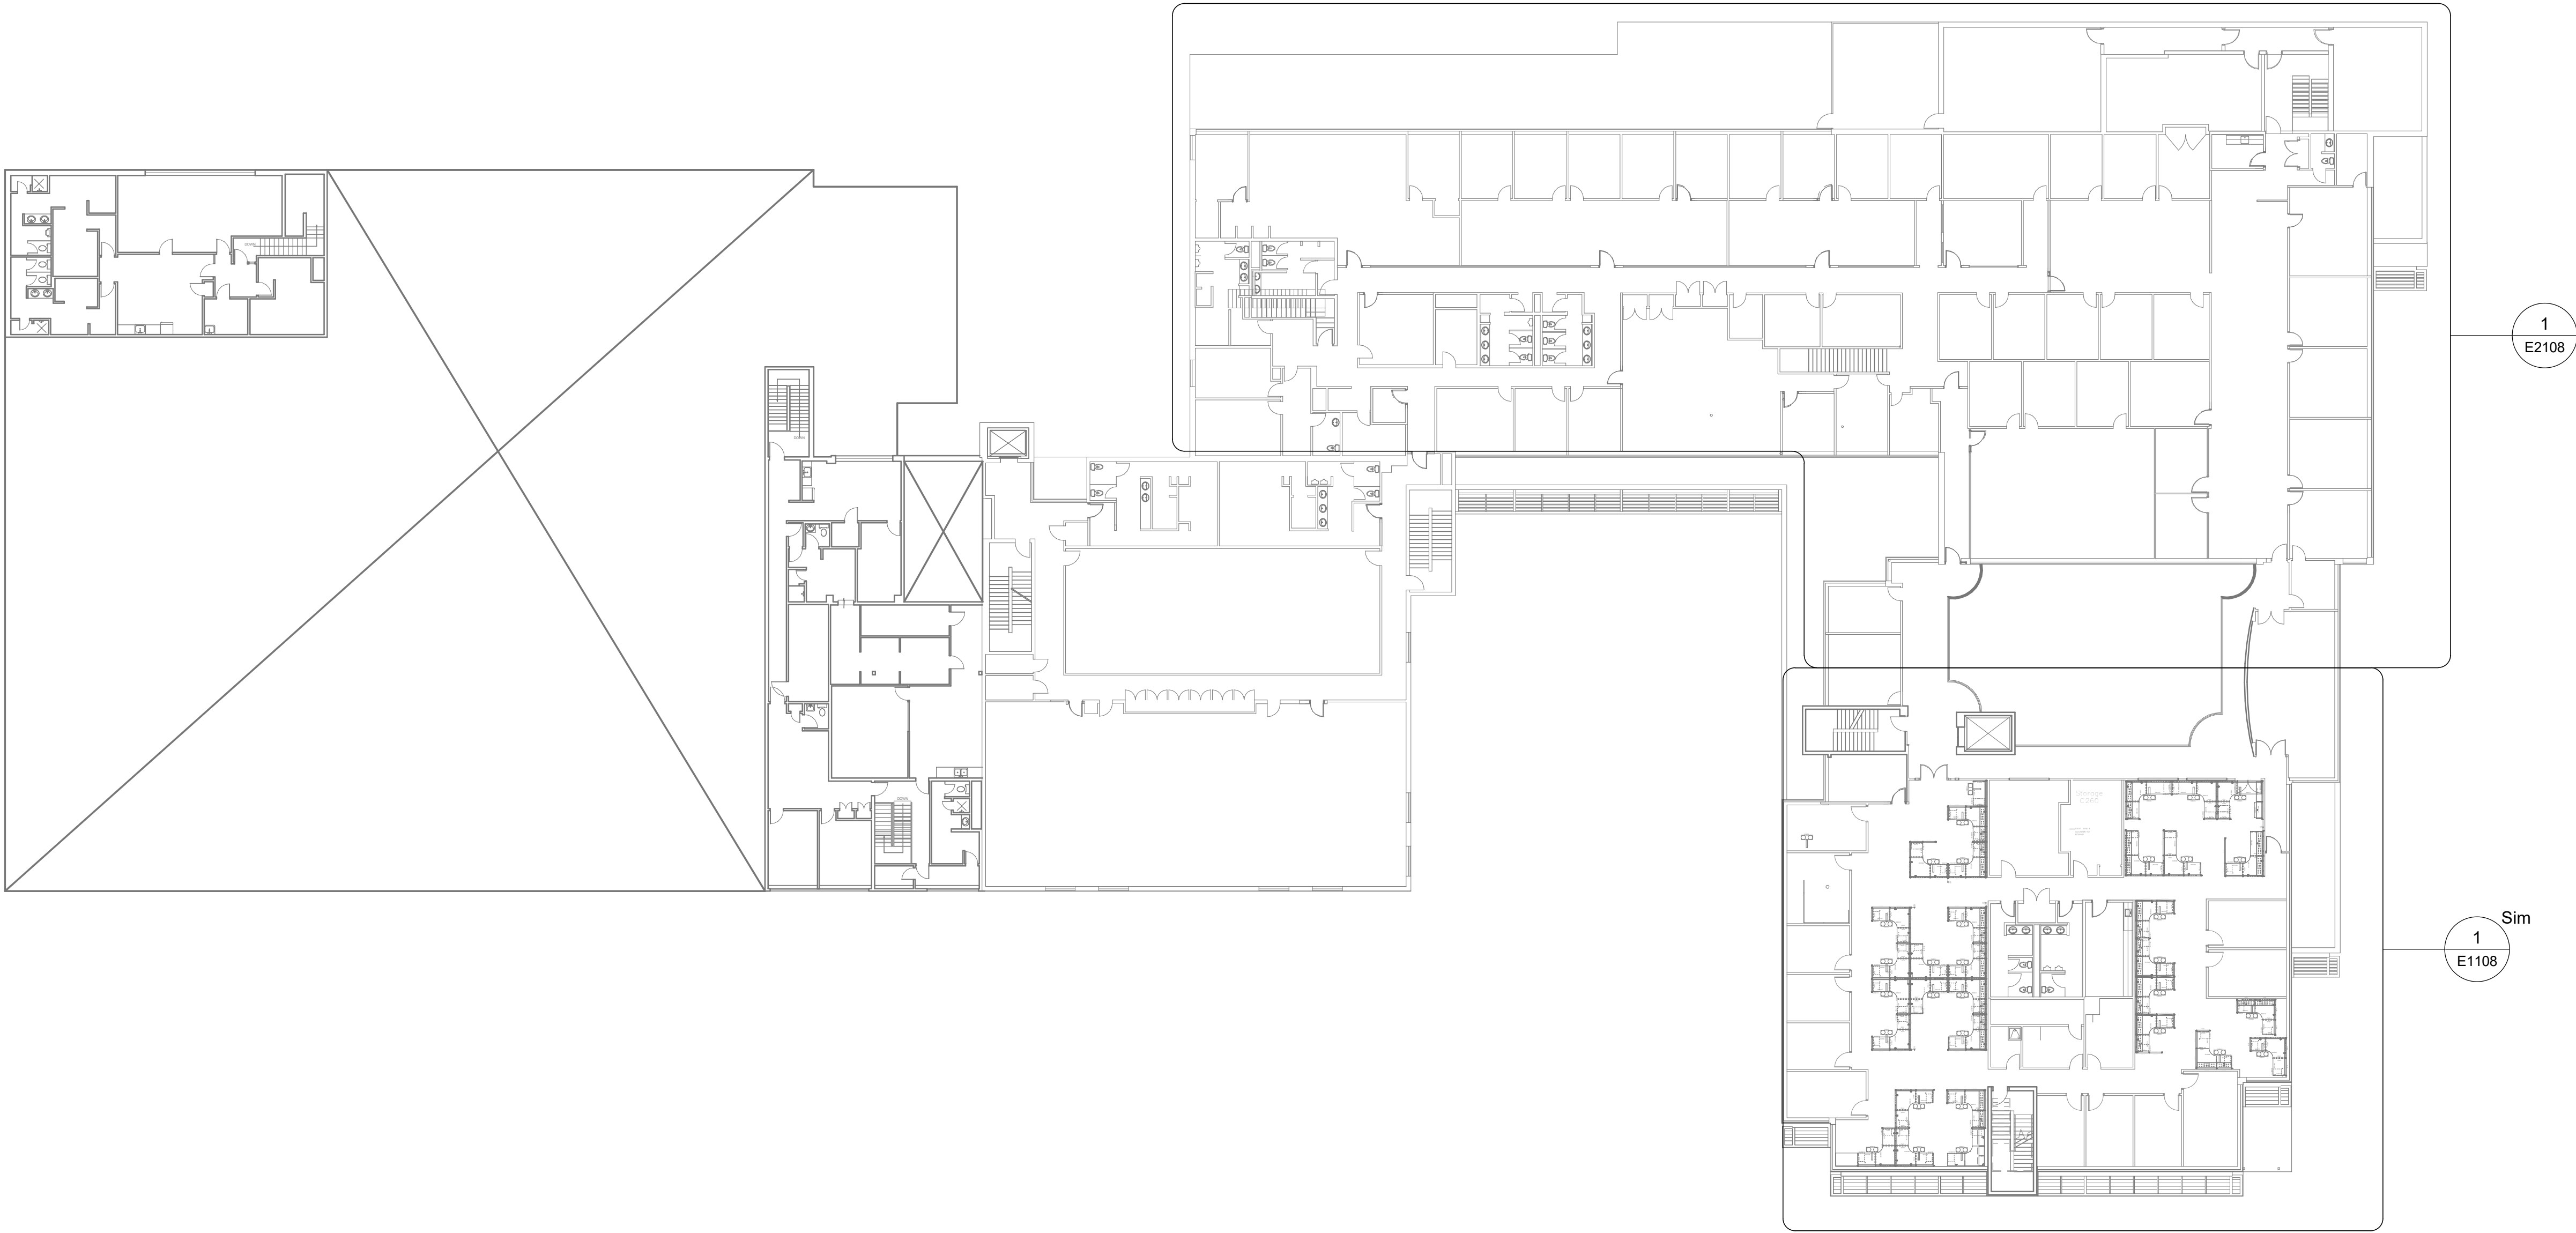
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**ELECTRICAL
DEMOLITION ENLARGED
PLAN 1ST FLOOR PART 3**

SHEET NUMBER
G08-229-E1104

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1 SECOND FLOOR DEMOLITION KEY PLAN
E1105 Scale: 1 : 250



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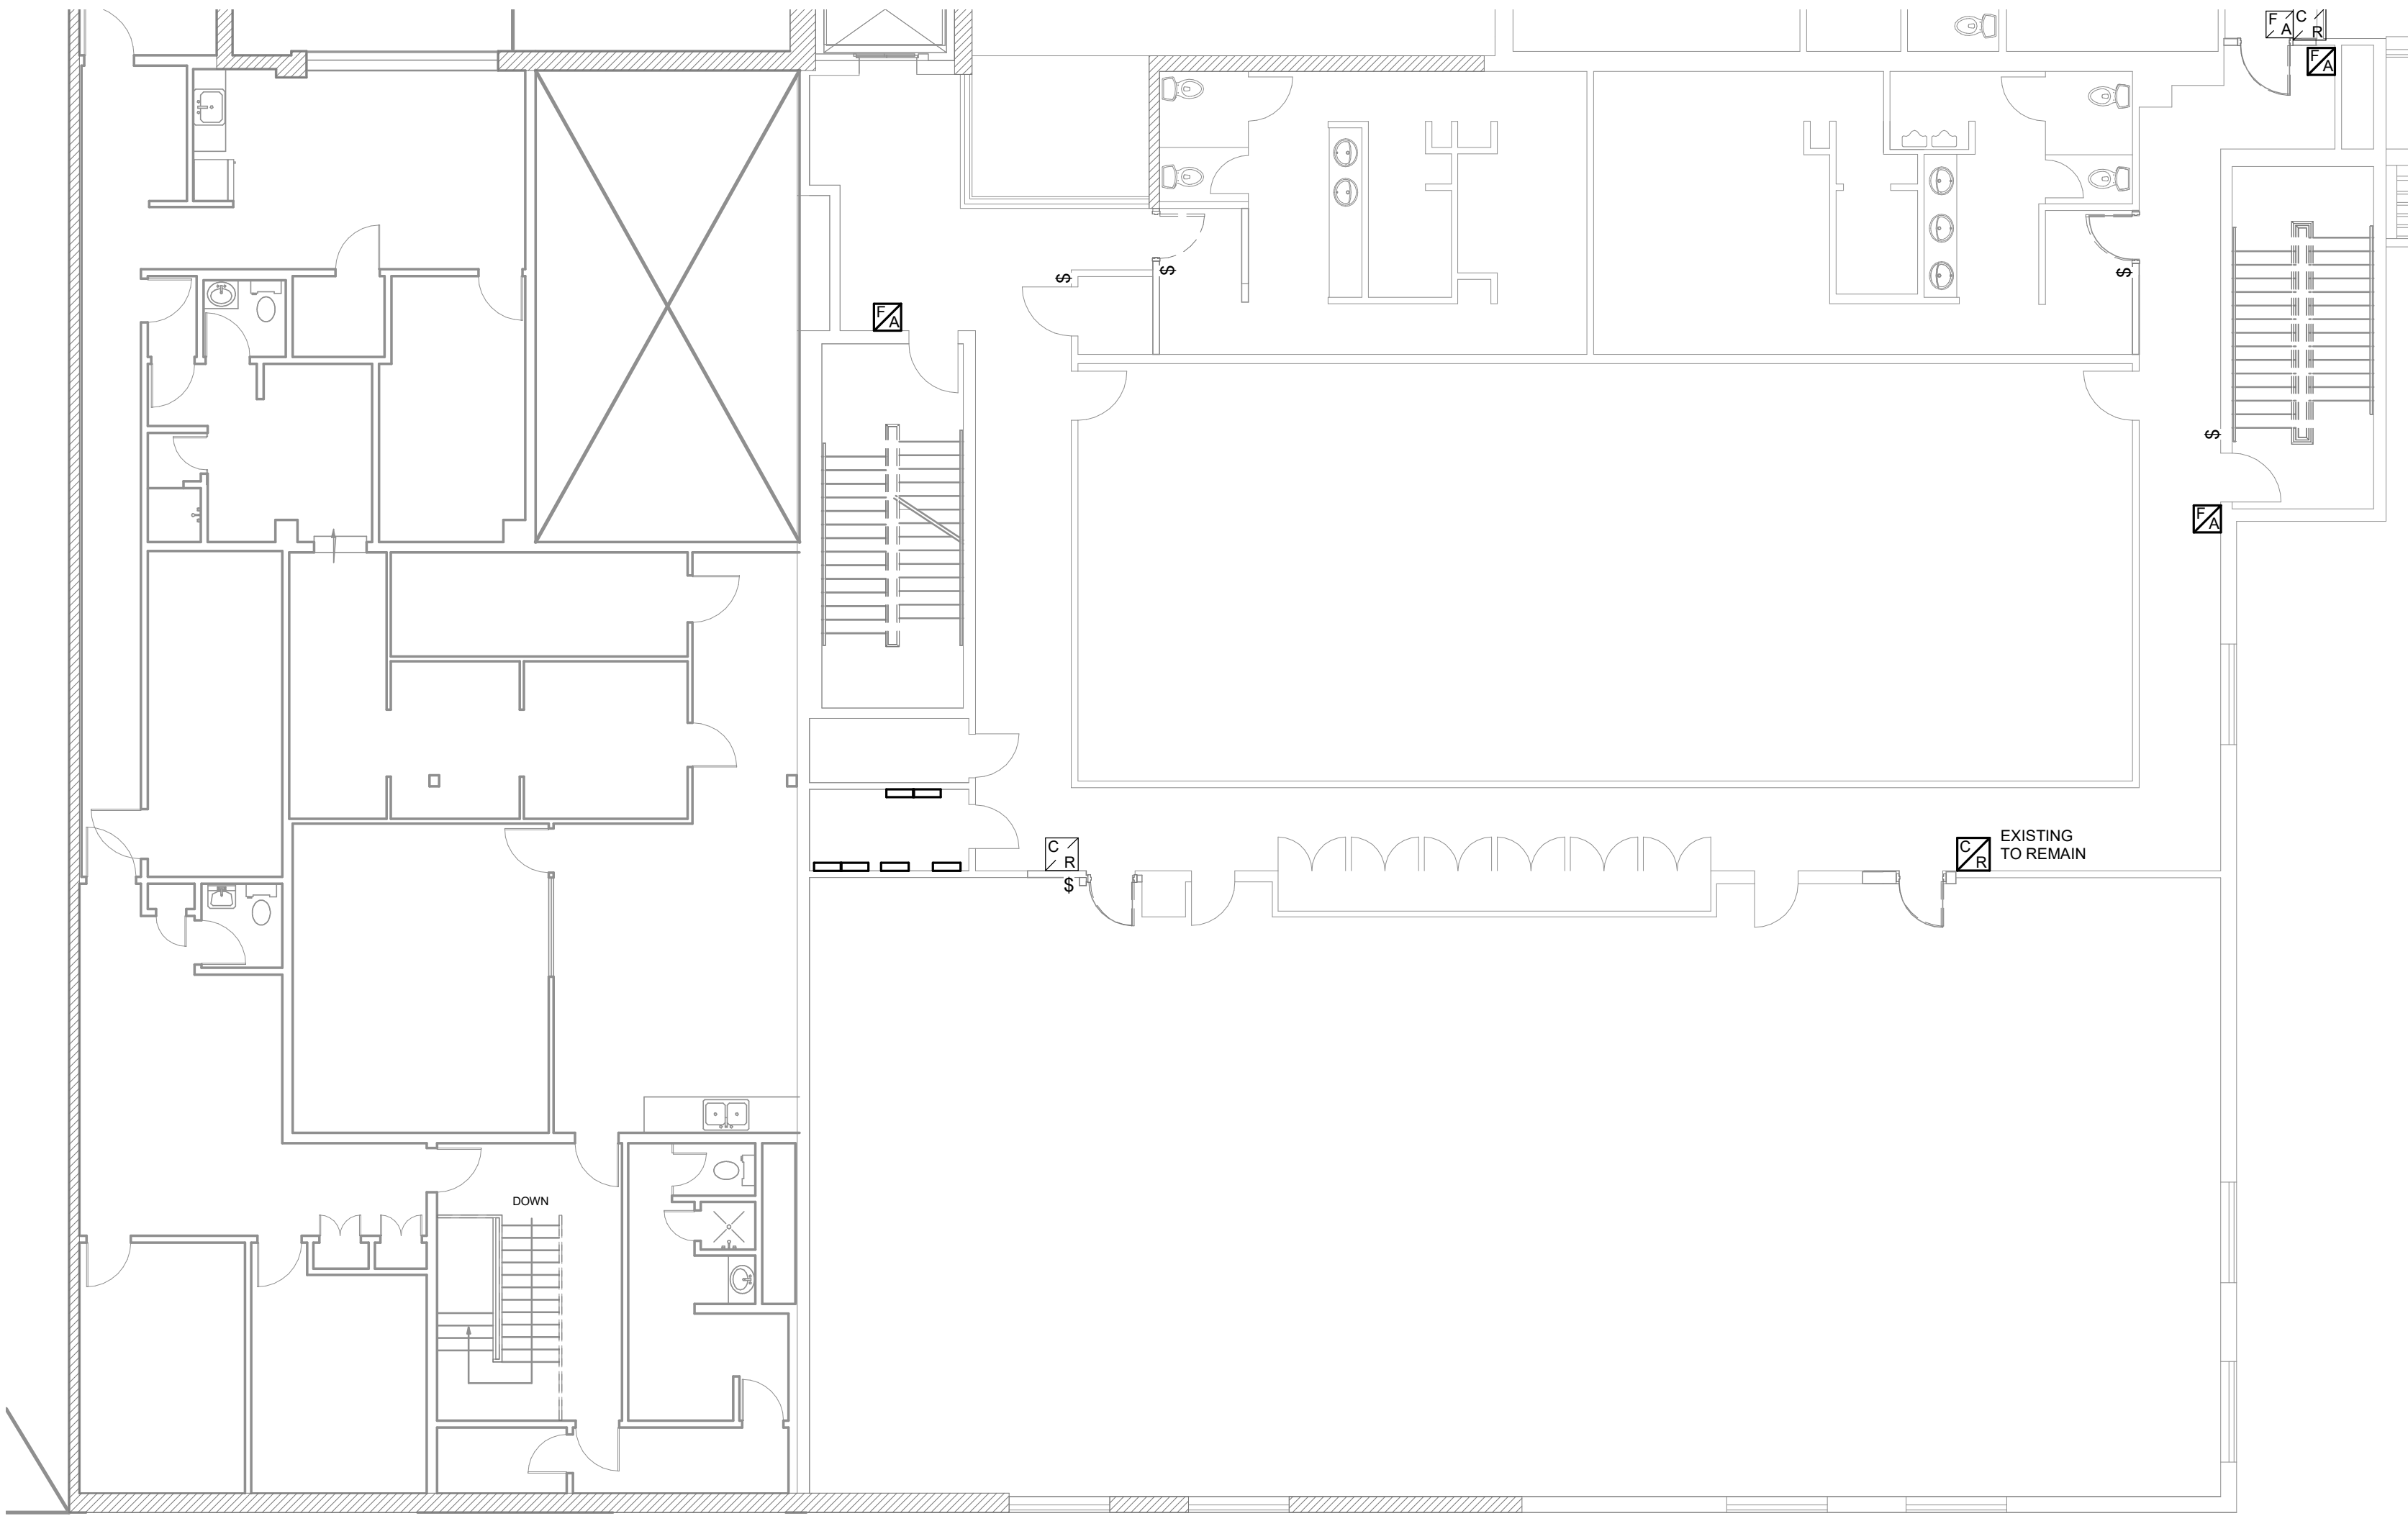
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PROJECT MGR: F.BOLOURIAN	APPROVED BY: P. WILLIAMS

SHEET TITLE
ELECTRICAL
DEMOLITION PLAN 2ND
FLOOR

SHEET NUMBER G08-229-E1105	ISSUE 0
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1 ELECTRICAL DEMOLITION PLAN 2ND FLOOR PART 1
E1106 Scale: 1 : 100

- NOTES:
1. REMOVE EXISTING LIGHT SWITCHES SHOWN ON PLAN. PREPARE CIRCUITS FOR RE-USE FOR NEW LIGHT SWITCHES TO REPLACE DEMOLISHED.
 2. RELOCATE FIRE PULL STATIONS SHOWN TO COMPLIANT TADG HEIGHT AS INDICATED ON MOUNTING HEIGHTS SCHEDULE.
 3. ADJUST INDICATED CARD READERS TO NEW TADG COMPLIANT HEIGHTS (AS INDICATED IN MOUNTING HEIGHTS SCHEDULE). PROVIDE CABLING/CONDUIT AS NECESSARY TO FACILITATE RECONNECTION TO DOOR SECURITY BOX.

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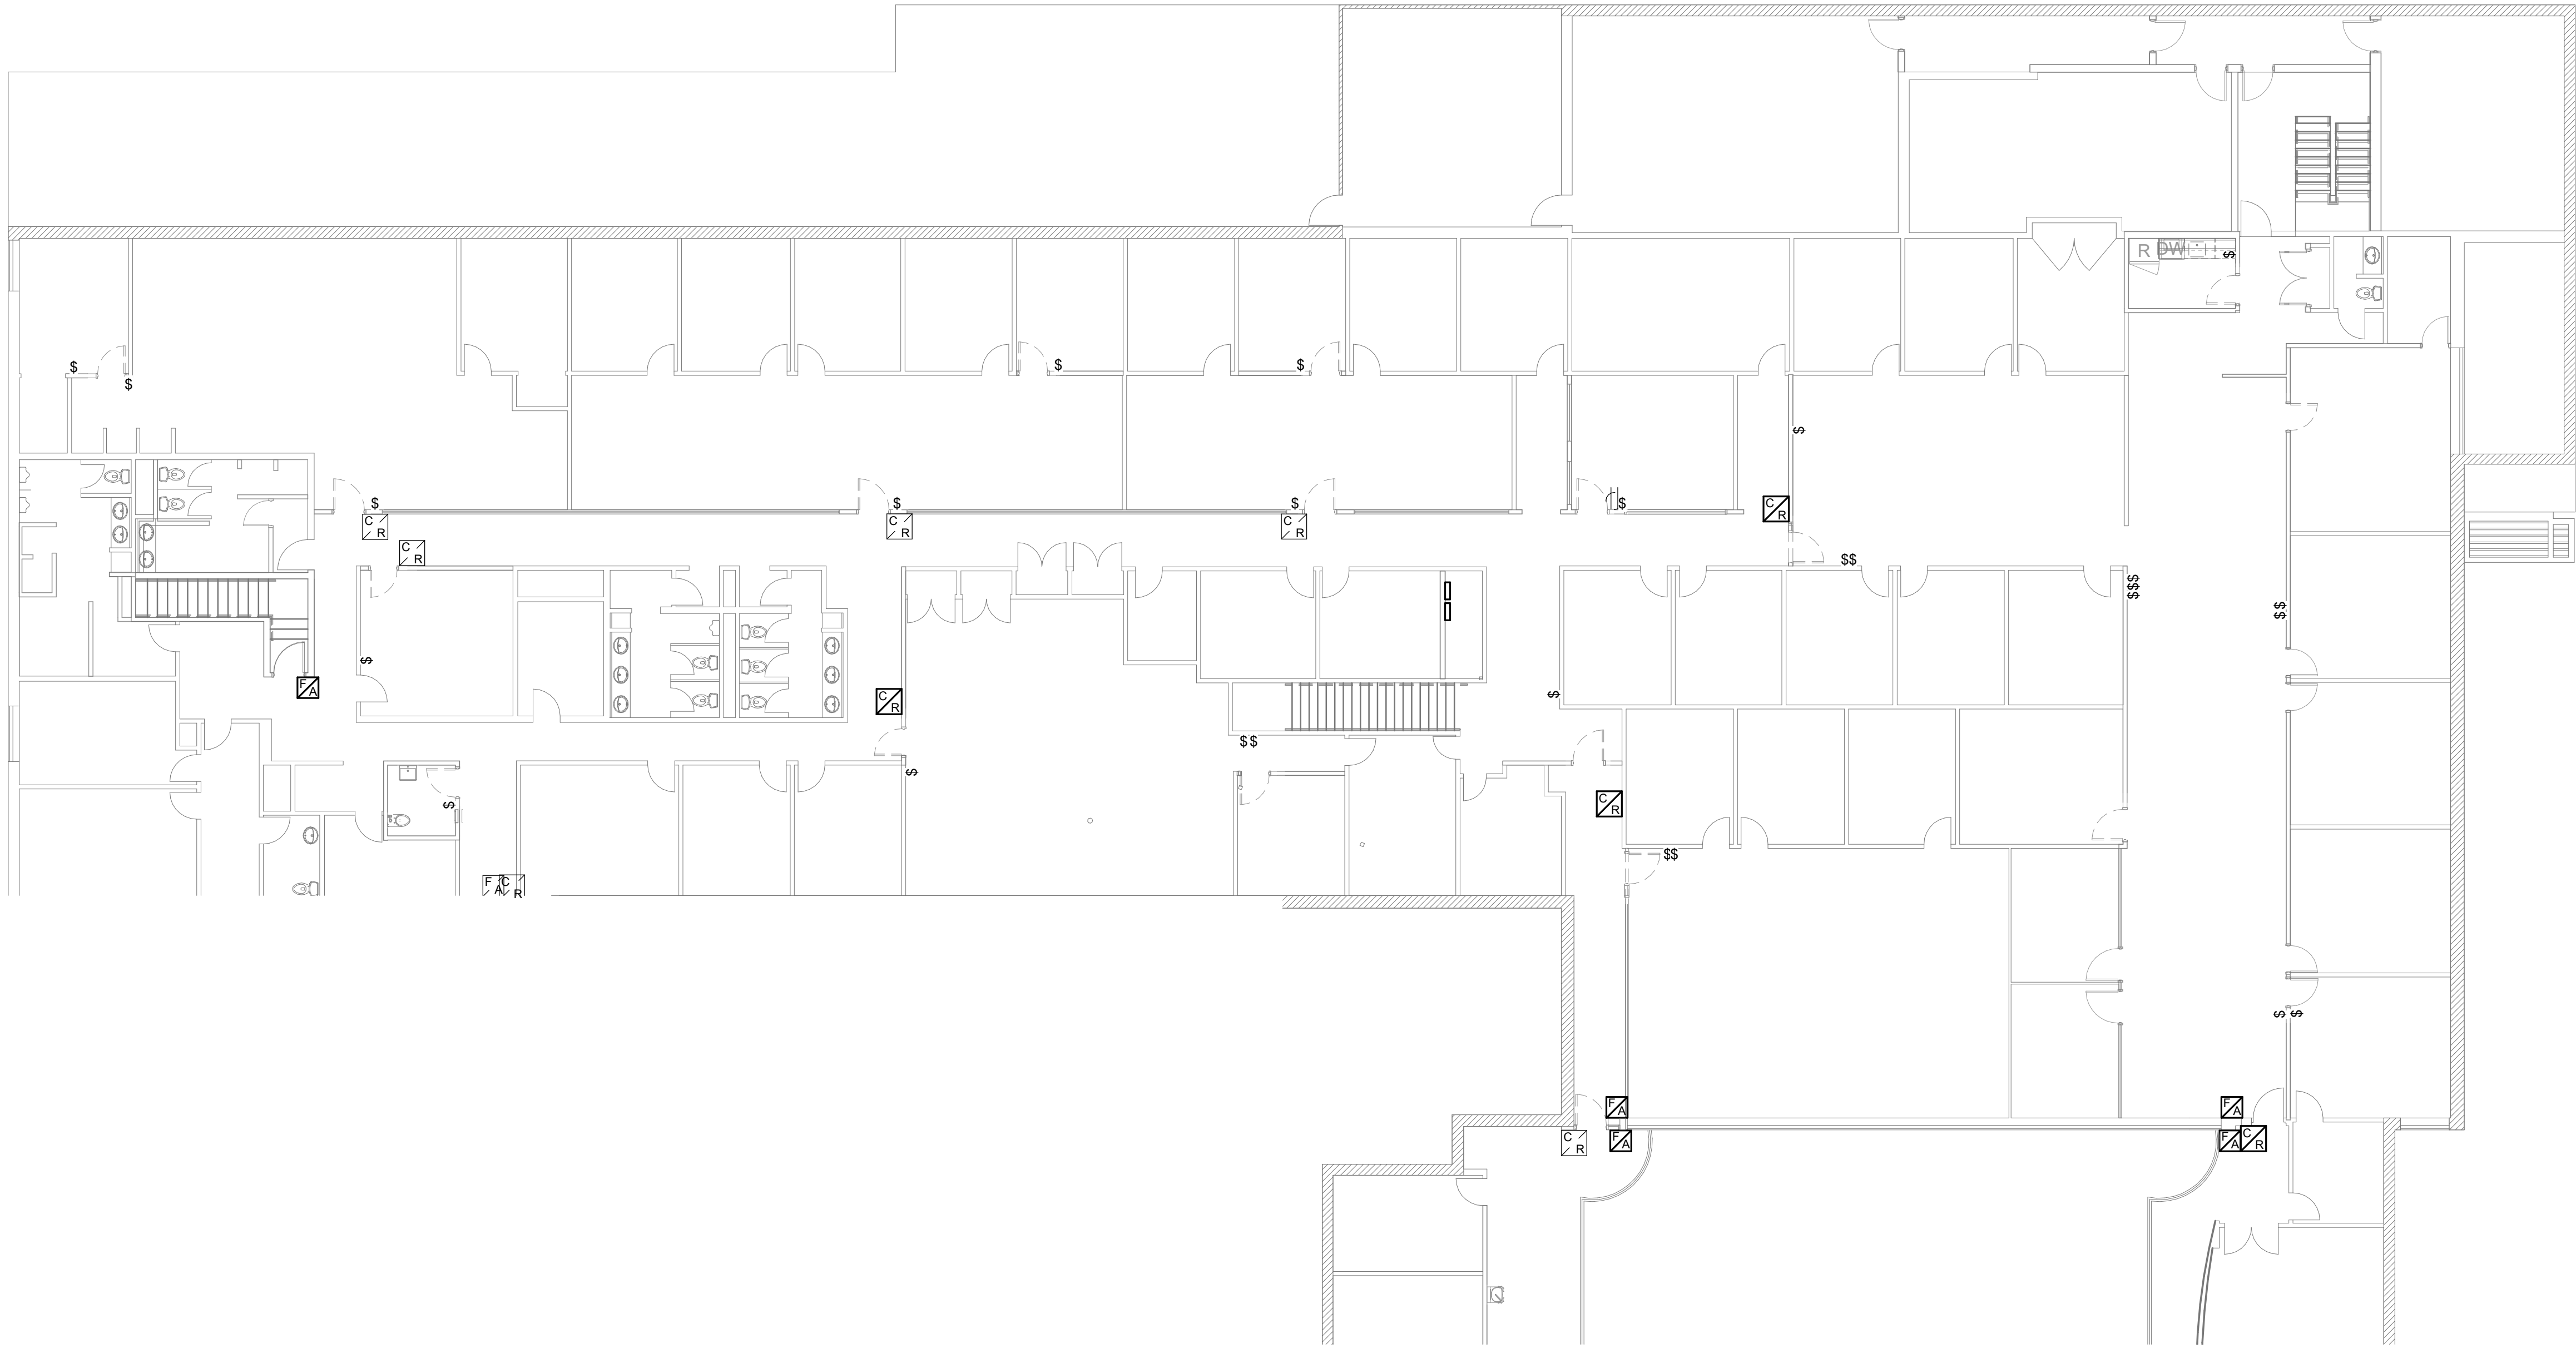
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PROJECT MGR: F.BOLOURIAN	APPROVED BY: Approver
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SHEET TITLE
**ELECTRICAL
DEMOLITION ENLARGED
PLAN 2ND FLOOR PART 1**


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ISSUE
0



1
E1107 ELECTRICAL DEMOLITION PLAN 2ND FLOOR PART 2
Scale: 1 : 125

- NOTES:
1. REMOVE EXISTING LIGHT SWITCHES SHOWN ON PLAN. PREPARE CIRCUITS FOR RE-USE FOR NEW LIGHT SWITCHES TO REPLACE DEMOLISHED.
 2. RELOCATE FIRE PULL STATIONS SHOWN TO COMPLIANT TADG HEIGHT AS INDICATED ON MOUNTING HEIGHTS SCHEDULE.
 3. ADJUST INDICATED CARD READERS TO NEW TADG COMPLIANT HEIGHTS (AS INDICATED IN MOUNTING HEIGHTS SCHEDULE). PROVIDE CABLING/CONDUIT AS NECESSARY TO FACILITATE RECONNECTION TO DOOR SECURITY BOX.

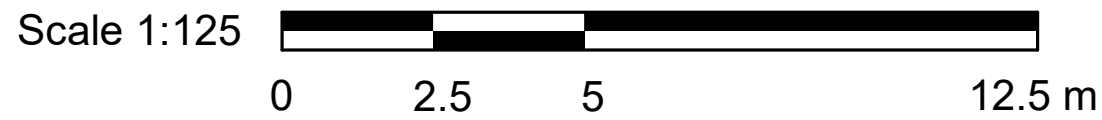

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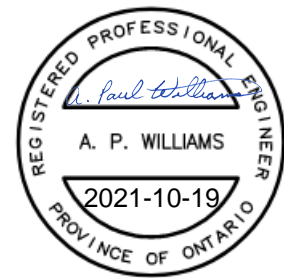
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ELECTRICAL
DEMOLITION ENLARGED
PLAN 2ND FLOOR PART 2

SHEET NUMBER G08-229-E1107	ISSUE 0
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1
E1108

ELECTRICAL DEMOLITION PLAN 2ND FLOOR PART 3

Scale: 1 : 100

NOTES:

1. REMOVE EXISTING LIGHT SWITCHES SHOWN ON PLAN. PREPARE CIRCUITS FOR RE-USE FOR NEW LIGHT SWITCHES TO REPLACE DEMOLISHED.
2. RELOCATE FIRE PULL STATIONS SHOWN TO COMPLIANT TAGS HEIGHT AS INDICATED ON MOUNTING HEIGHTS SCHEDULE.
3. ADJUST INDICATED CARD READERS TO NEW TAGS COMPLIANT HEIGHTS (AS INDICATED IN MOUNTING HEIGHTS SCHEDULE); PROVIDE CABLING/CONDUIT AS NECESSARY TO FACILITATE RECONNECTION TO DOOR SECURITY BOX.

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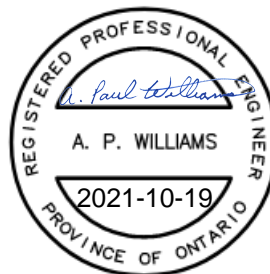
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PROJECT NO:

9119- 19- 0162 / IBI 122260

DRAWN BY:

Author

CHECKED BY:

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PROJECT MGR:

F. BOLOURIAN

APPROVED BY:

Approver

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ELECTRICAL
DEMOLITION ENLARGED
PLAN 2ND FLOOR PART 3

SHEET NUMBER

G08-229-E1108

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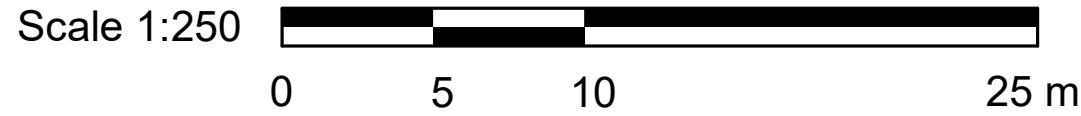
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10mm

SCALE CHECK
1 m

1 THIRD FLOOR DEMOLITION PLAN
E1109 Scale: 1 : 250



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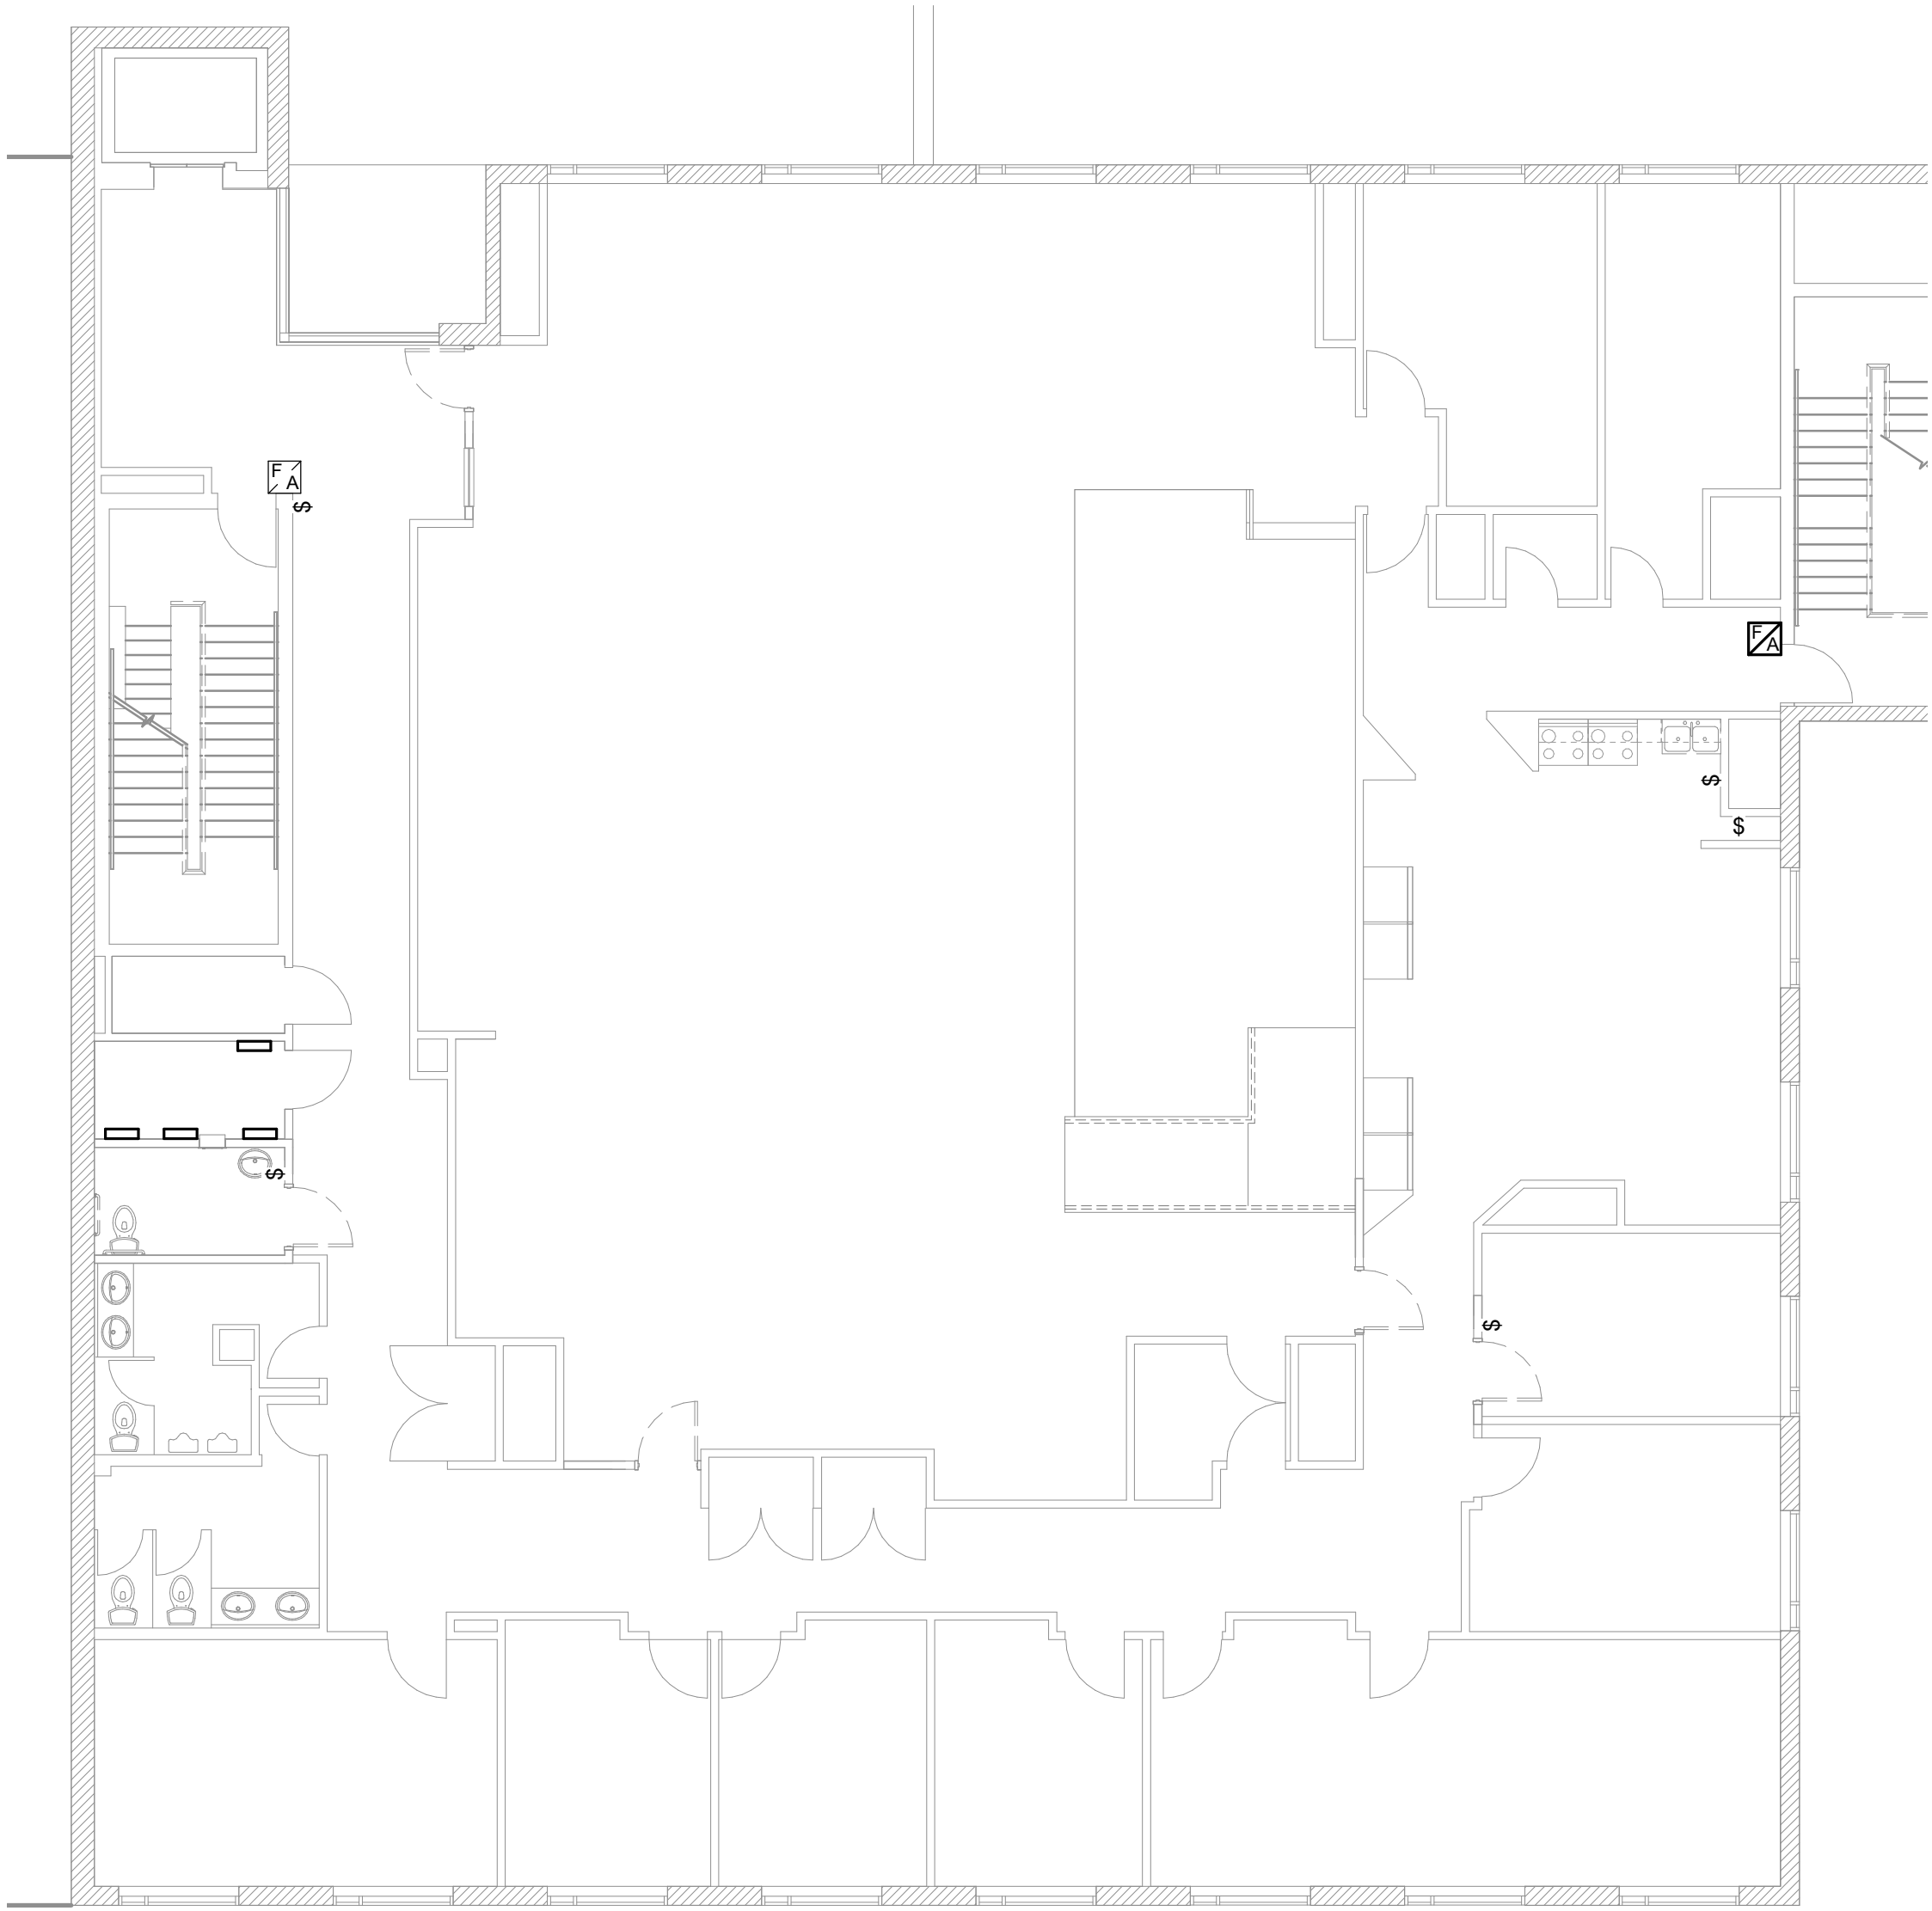
**ELECTRICAL
DEMOLITION 3RD FLOOR**

SHEET NUMBER

G08-229-E1109

ISSUE

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1
E1110
THIRD FLOOR DEMOLITION PLAN WEST OFFICES
Scale: 1 : 100

NOTES:

1. REMOVE EXISTING LIGHT SWITCHES SHOWN ON PLAN. PREPARE CIRCUITS FOR RE-USE FOR NEW LIGHT SWITCHES TO REPLACE DEMOLISHED.
2. RELOCATE FIRE PULL STATIONS SHOWN TO COMPLIANT TADG HEIGHT AS INDICATED ON MOUNTING HEIGHTS SCHEDULE.
3. ADJUST INDICATED CARD READERS TO NEW TADG COMPLIANT HEIGHTS (AS INDICATED IN MOUNTING HEIGHTS SCHEDULE). PROVIDE CABLING/CONDUIT AS NECESSARY TO FACILITATE RECONNECTION TO DOOR SECURITY BOX.



2
E1110
THIRD FLOOR DEMOLITION PLAN EAST OFFICES
Scale: 1 : 100

NOTES:

1. REMOVE EXISTING LIGHT SWITCHES SHOWN ON PLAN. PREPARE CIRCUITS FOR RE-USE FOR NEW LIGHT SWITCHES TO REPLACE DEMOLISHED.
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Scale 1:100
0 2.5 5 10 m

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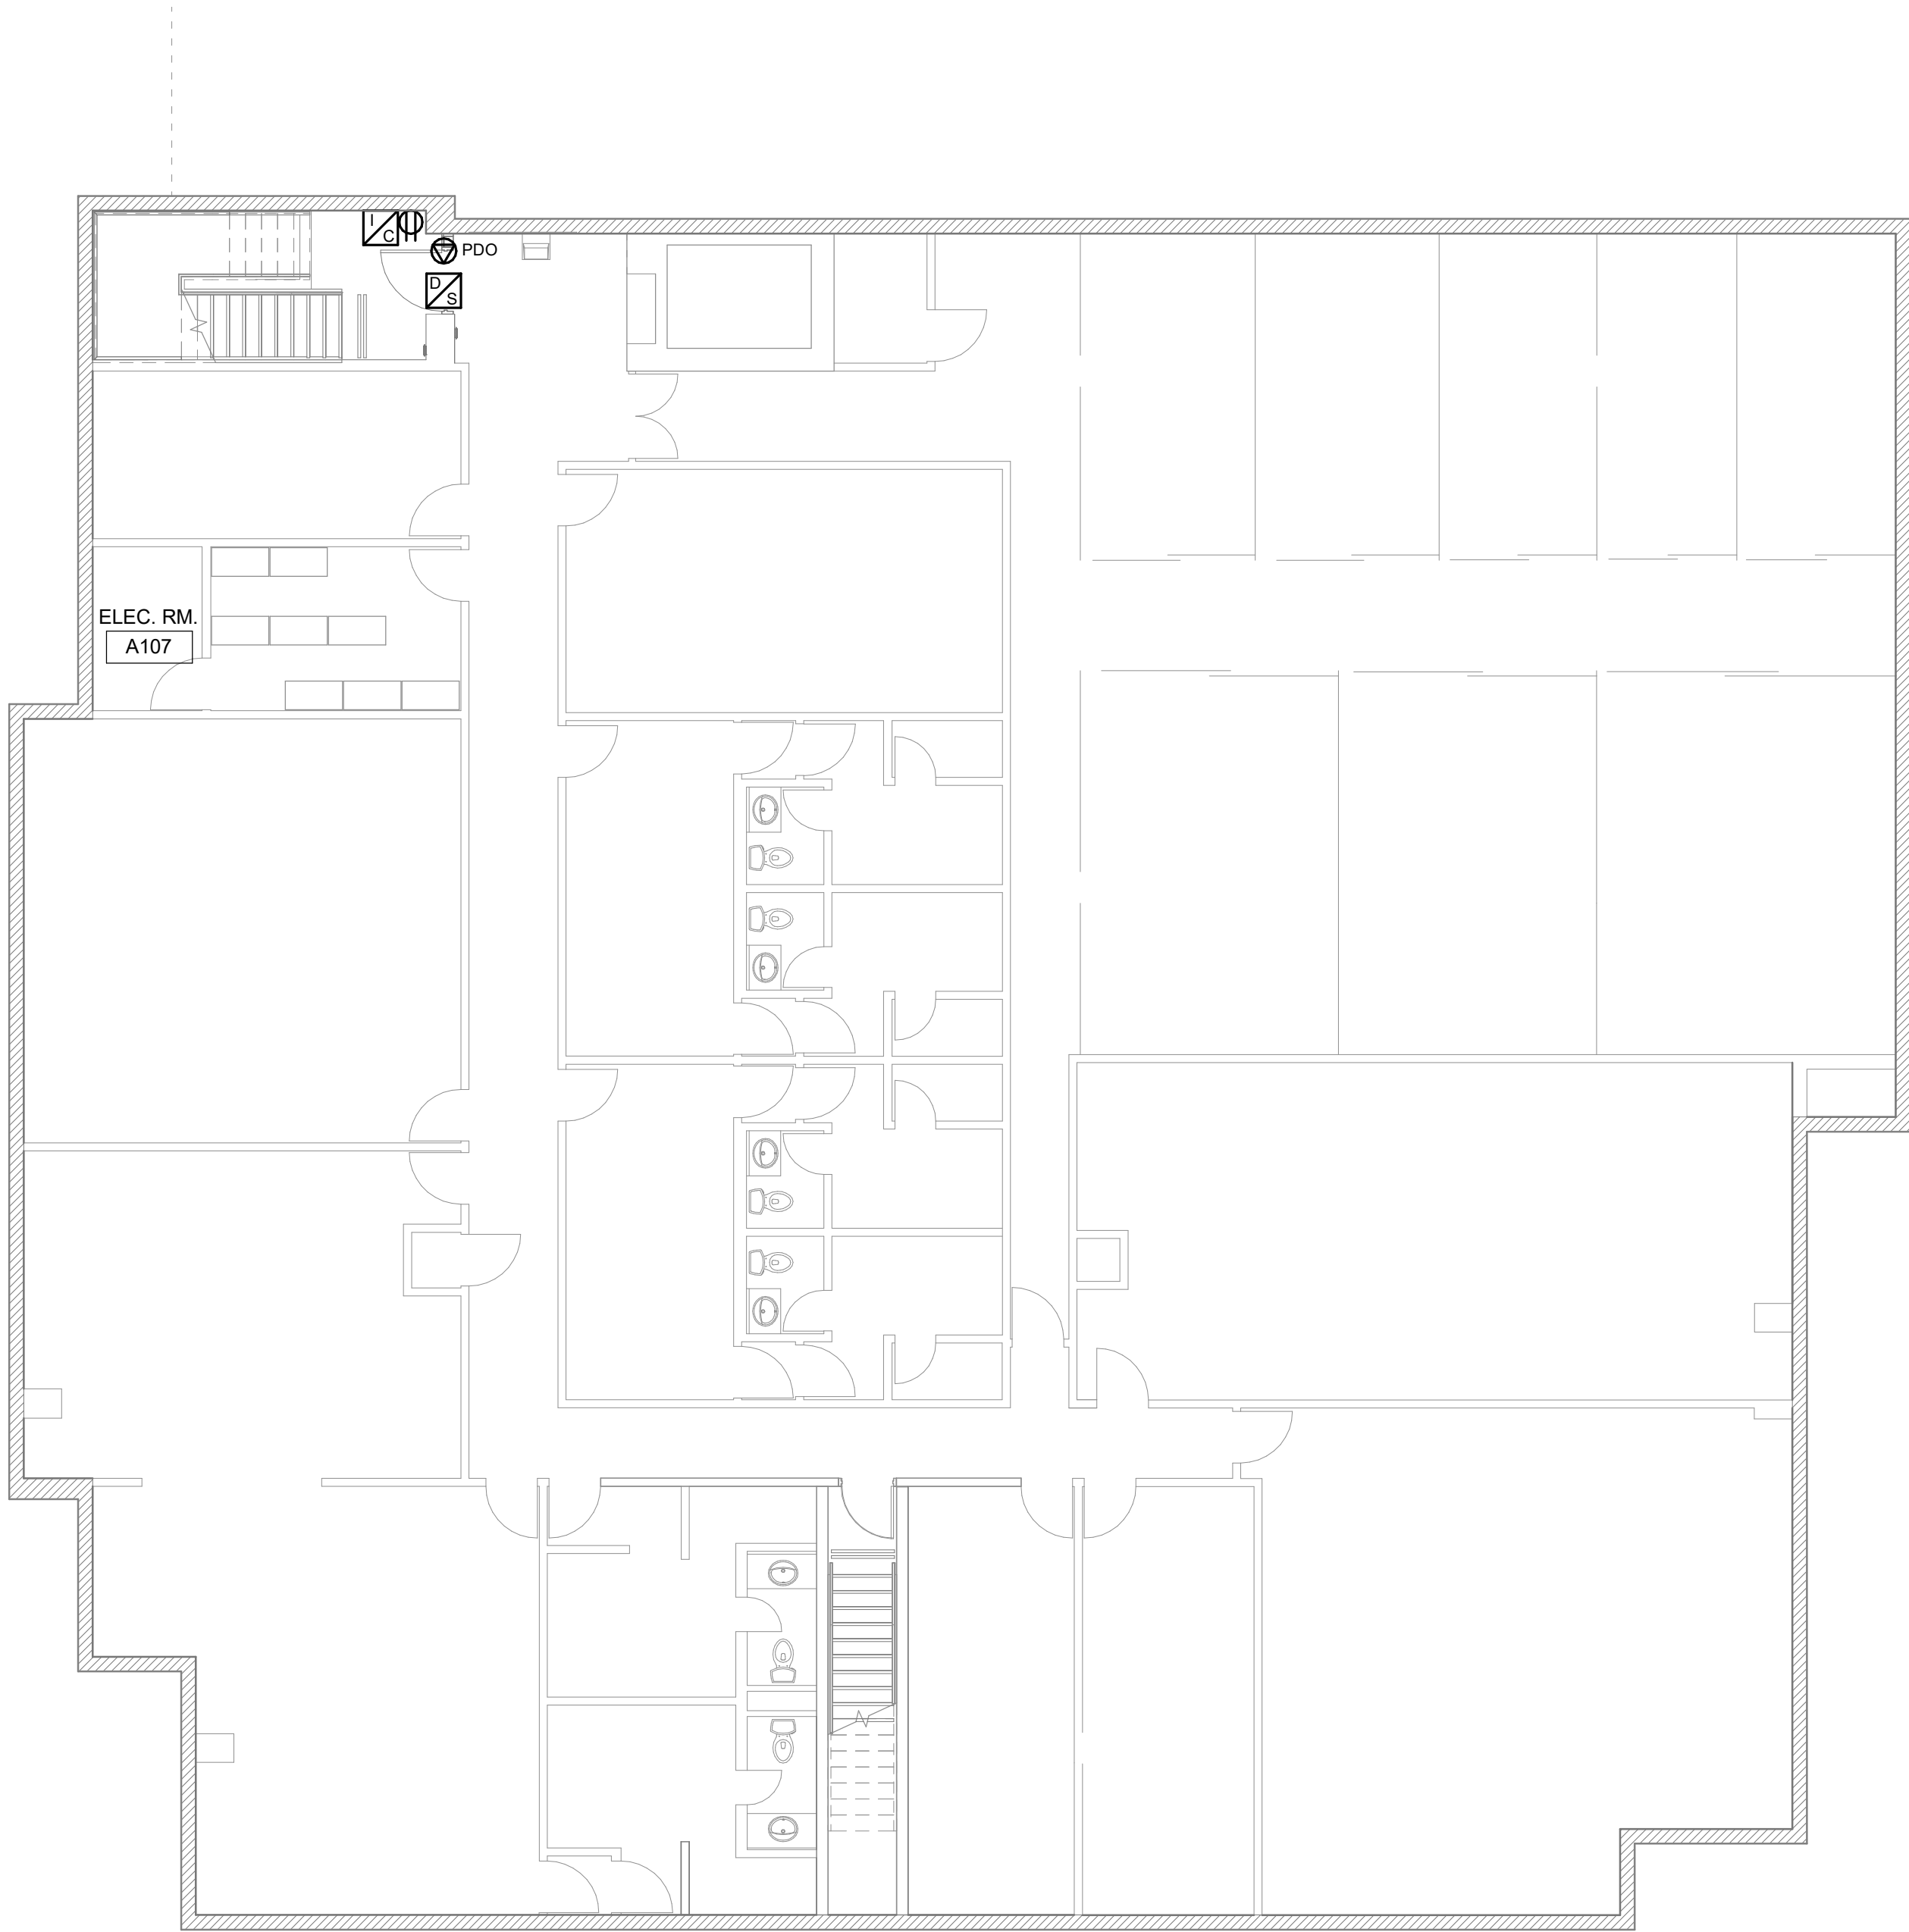
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**ELECTRICAL
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PLAN 3RD FLOOR
PARTIAL PLANS**

SHEET NUMBER
G08-229-E1110 ISSUE
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1 POWER & SYSTEMS BASEMENT PLAN
E2100 Scale: 1 : 100

NOTES:

1. PROVIDE INTERCOM TERMINAL UNIT FOR PROTECT IN PLACE AREA. RUN CATEGORY 6 CABLE TO FIRST FLOOR MAIN ELECTRICAL/SECURITY ROOM



2021-10-19 12:28:50 PM

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ibigroup.com

PROJECT TITLE
**CITY OF TORONTO
ACCESSIBILITY UPGRADES**

PROJECT ADDRESS
**Fire/EMS HQ & EMS Station
53
4330 Dufferin St**

PROJECT NO:
9119- 19- 0162 / IBI 122260

DRAWN BY:
Author

CHECKED BY:
Checker

PROJECT MGR:
F.BOLOURIAN

APPROVED BY:
Approver

SHEET TITLE
**POWER & SYSTEMS
BASEMENT PLAN**

SHEET NUMBER
G08-229-E2100

ISSUE
0


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10mm

SCALE CHECK
1 m



1 POWER & SYSTEMS 1ST FLOOR KEY PLAN
E2101 Scale: 1 : 250

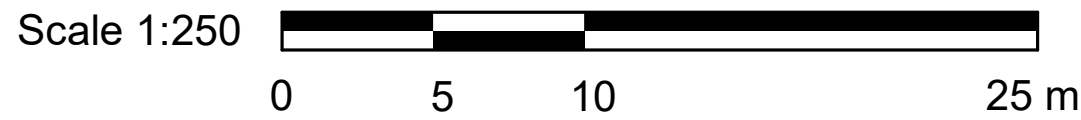

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PROJECT TITLE
**CITY OF TORONTO
ACCESSIBILITY UPGRADES**

PROJECT ADDRESS
**Fire/EMS HQ & EMS Station
53
4330 Dufferin St**

PROJECT NO:
9119- 19- 0162 / IBI 122260

DRAWN BY:
M.BOJIC

CHECKED BY:
P. WILLIAMS

PROJECT MGR:
F.BOLOURIAN

APPROVED BY:
P. WILLIAMS

SHEET TITLE
**POWER & SYSTEMS
PLAN 1ST FLOOR KEY
PLAN**

SHEET NUMBER
G08-229-E2101

ISSUE
0



1 POWER & SYSTEMS PLAN 1ST FLOOR PART 1
E2103 Scale: 1 : 150

NOTES:

1. PROVIDE POWER DOOR OPERATOR CIRCUIT CONNECTION AS INDICATED. PROVIDE CONDUIT/WIRE TO PUSH BUTTON DEVICES FROM DOOR OPERATOR. SEE ARCHITECTURAL PROPOSED PLAN FOR LOCATION OF PUSH BUTTON/WAVE TO OPEN DEVICES.
2. PROVIDE DOOR SECURITY DEVICES AS INDICATED. PROVIDE CONDUIT/WIRING TO ACCESS CONTROL/SECURITY DEVICES AS SHOWN. FOR DRYWALL AREAS CONCEAL CONDUIT AND BOXES. FOR BLOCK WALL AREAS SURFACE MOUNT CONDUIT AND PAINT CONDUIT/BOX SAME COLOUR TONE AS WALL BEHIND IT.
3. ADJUST FIRE ALARM PULL STATION HEIGHT TO COMPLIANT HEIGHT (AS LISTED IN THE MOUNTING HEIGHTS SCHEDULE) FOR ALL PULL STATIONS SHOWN.
4. PROVIDE NEW LIGHTING SWITCHES AT LOCATIONS INDICATED TO REPLACE DEMOLISHED IN SAME AREA. RE-CONNECT EXISTING LIGHTING CIRCUITS TO NEW SWITCHES.



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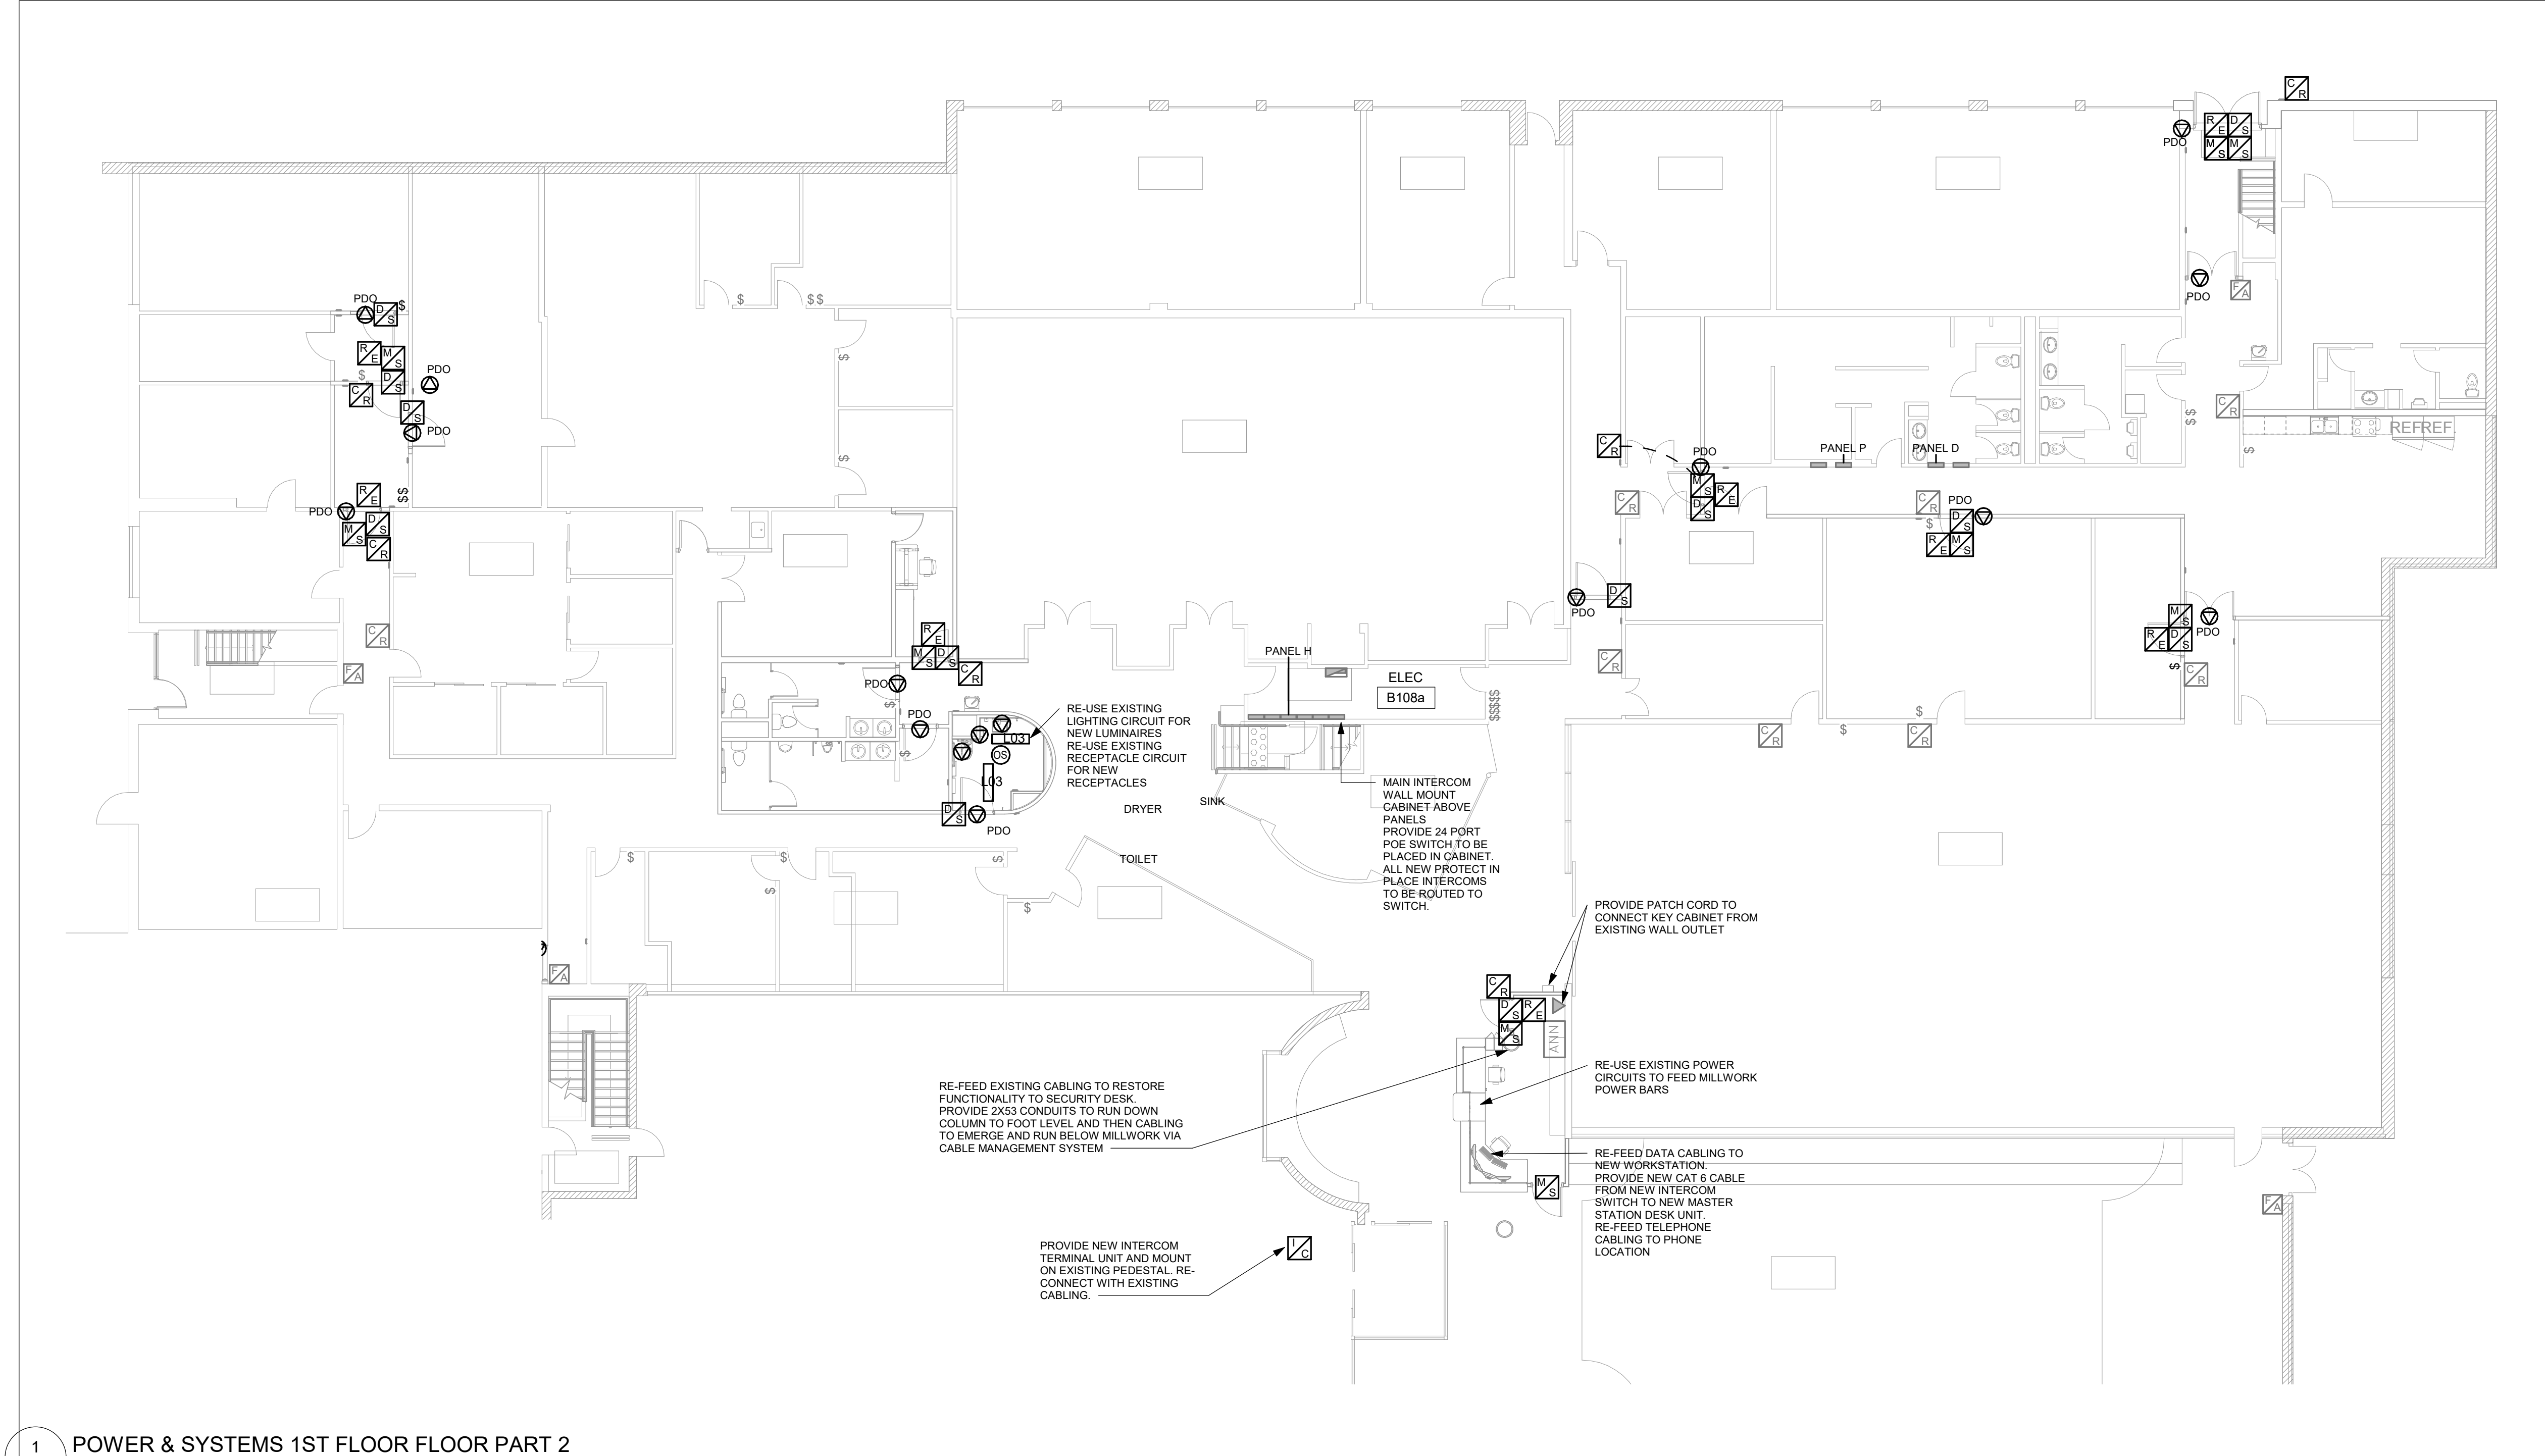
PROJECT ADDRESS
**Fire/EMS HQ & EMS Station
53
4330 Dufferin St**

PROJECT NO:
9119- 19- 0162 / IBI 122260

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PROJECT MGR: F.BOLOURIAN	APPROVED BY: Approver

SHEET TITLE
**POWER & SYSTEMS
ENLARGED PLAN 1ST
FLOOR PART 1**

SHEET NUMBER G08-229-E2103	ISSUE 0
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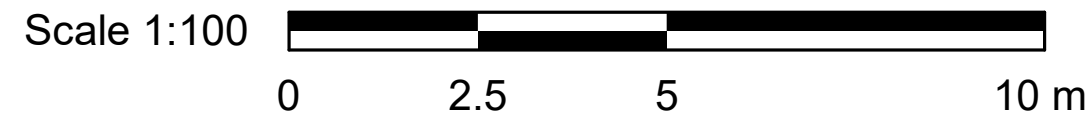


1 POWER & SYSTEMS 1ST FLOOR FLOOR PART 2
E2104 Scale: 1 : 125

NOTES:


1. PROVIDE POWER DOOR OPERATOR CIRCUIT CONNECTION AS INDICATED. PROVIDE CONDUIT/WIRE TO PUSH BUTTON DEVICES FROM DOOR OPERATOR. SEE ARCHITECTURAL PROPOSED PLAN FOR LOCATION OF PUSH BUTTON/WAVE TO OPEN DEVICES.
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3. ADJUST FIRE ALARM PULL STATION HEIGHT TO COMPLIANT HEIGHT (AS LISTED IN THE MOUNTING HEIGHTS SCHEDULE) FOR ALL PULL STATIONS SHOWN.
4. PROVIDE NEW LIGHTING SWITCHES AT LOCATIONS INDICATED TO REPLACE DEMOLISHED IN SAME AREA. RE-CONNECT EXISTING LIGHTING CIRCUITS TO NEW SWITCHES.
5. PROVIDE NEW CIRCUIT CONNECTIONS AS SHOWN. 15A UNLESS OTHERWISE NOTED. NO MORE THAN 4 PDOS TO A CIRCUIT
6. PROVIDE SECURITY DEVICES AS INDICATED.

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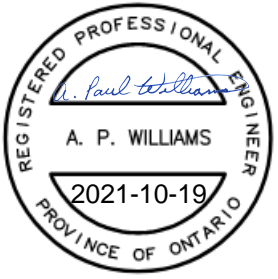
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
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PROJECT TITLE

CITY OF TORONTO

ACCESSIBILITY UPGRADES

PROJECT ADDRESS

Fire/EMS HQ & EMS Station

53

4330 Dufferin St

PROJECT NO:

9119- 19- 0162 / IBI 122260

DRAWN BY:

Author

CHECKED BY:

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PROJECT MGR:

F.BOLOURIAN

APPROVED BY:

Approver

SHEET TITLE

POWER & SYSTEMS

ENLARGED PLAN 1ST

FLOOR PART 2

SHEET NUMBER

G08-229-E2104

ISSUE

0

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10mm

SCALE CHECK
1 m

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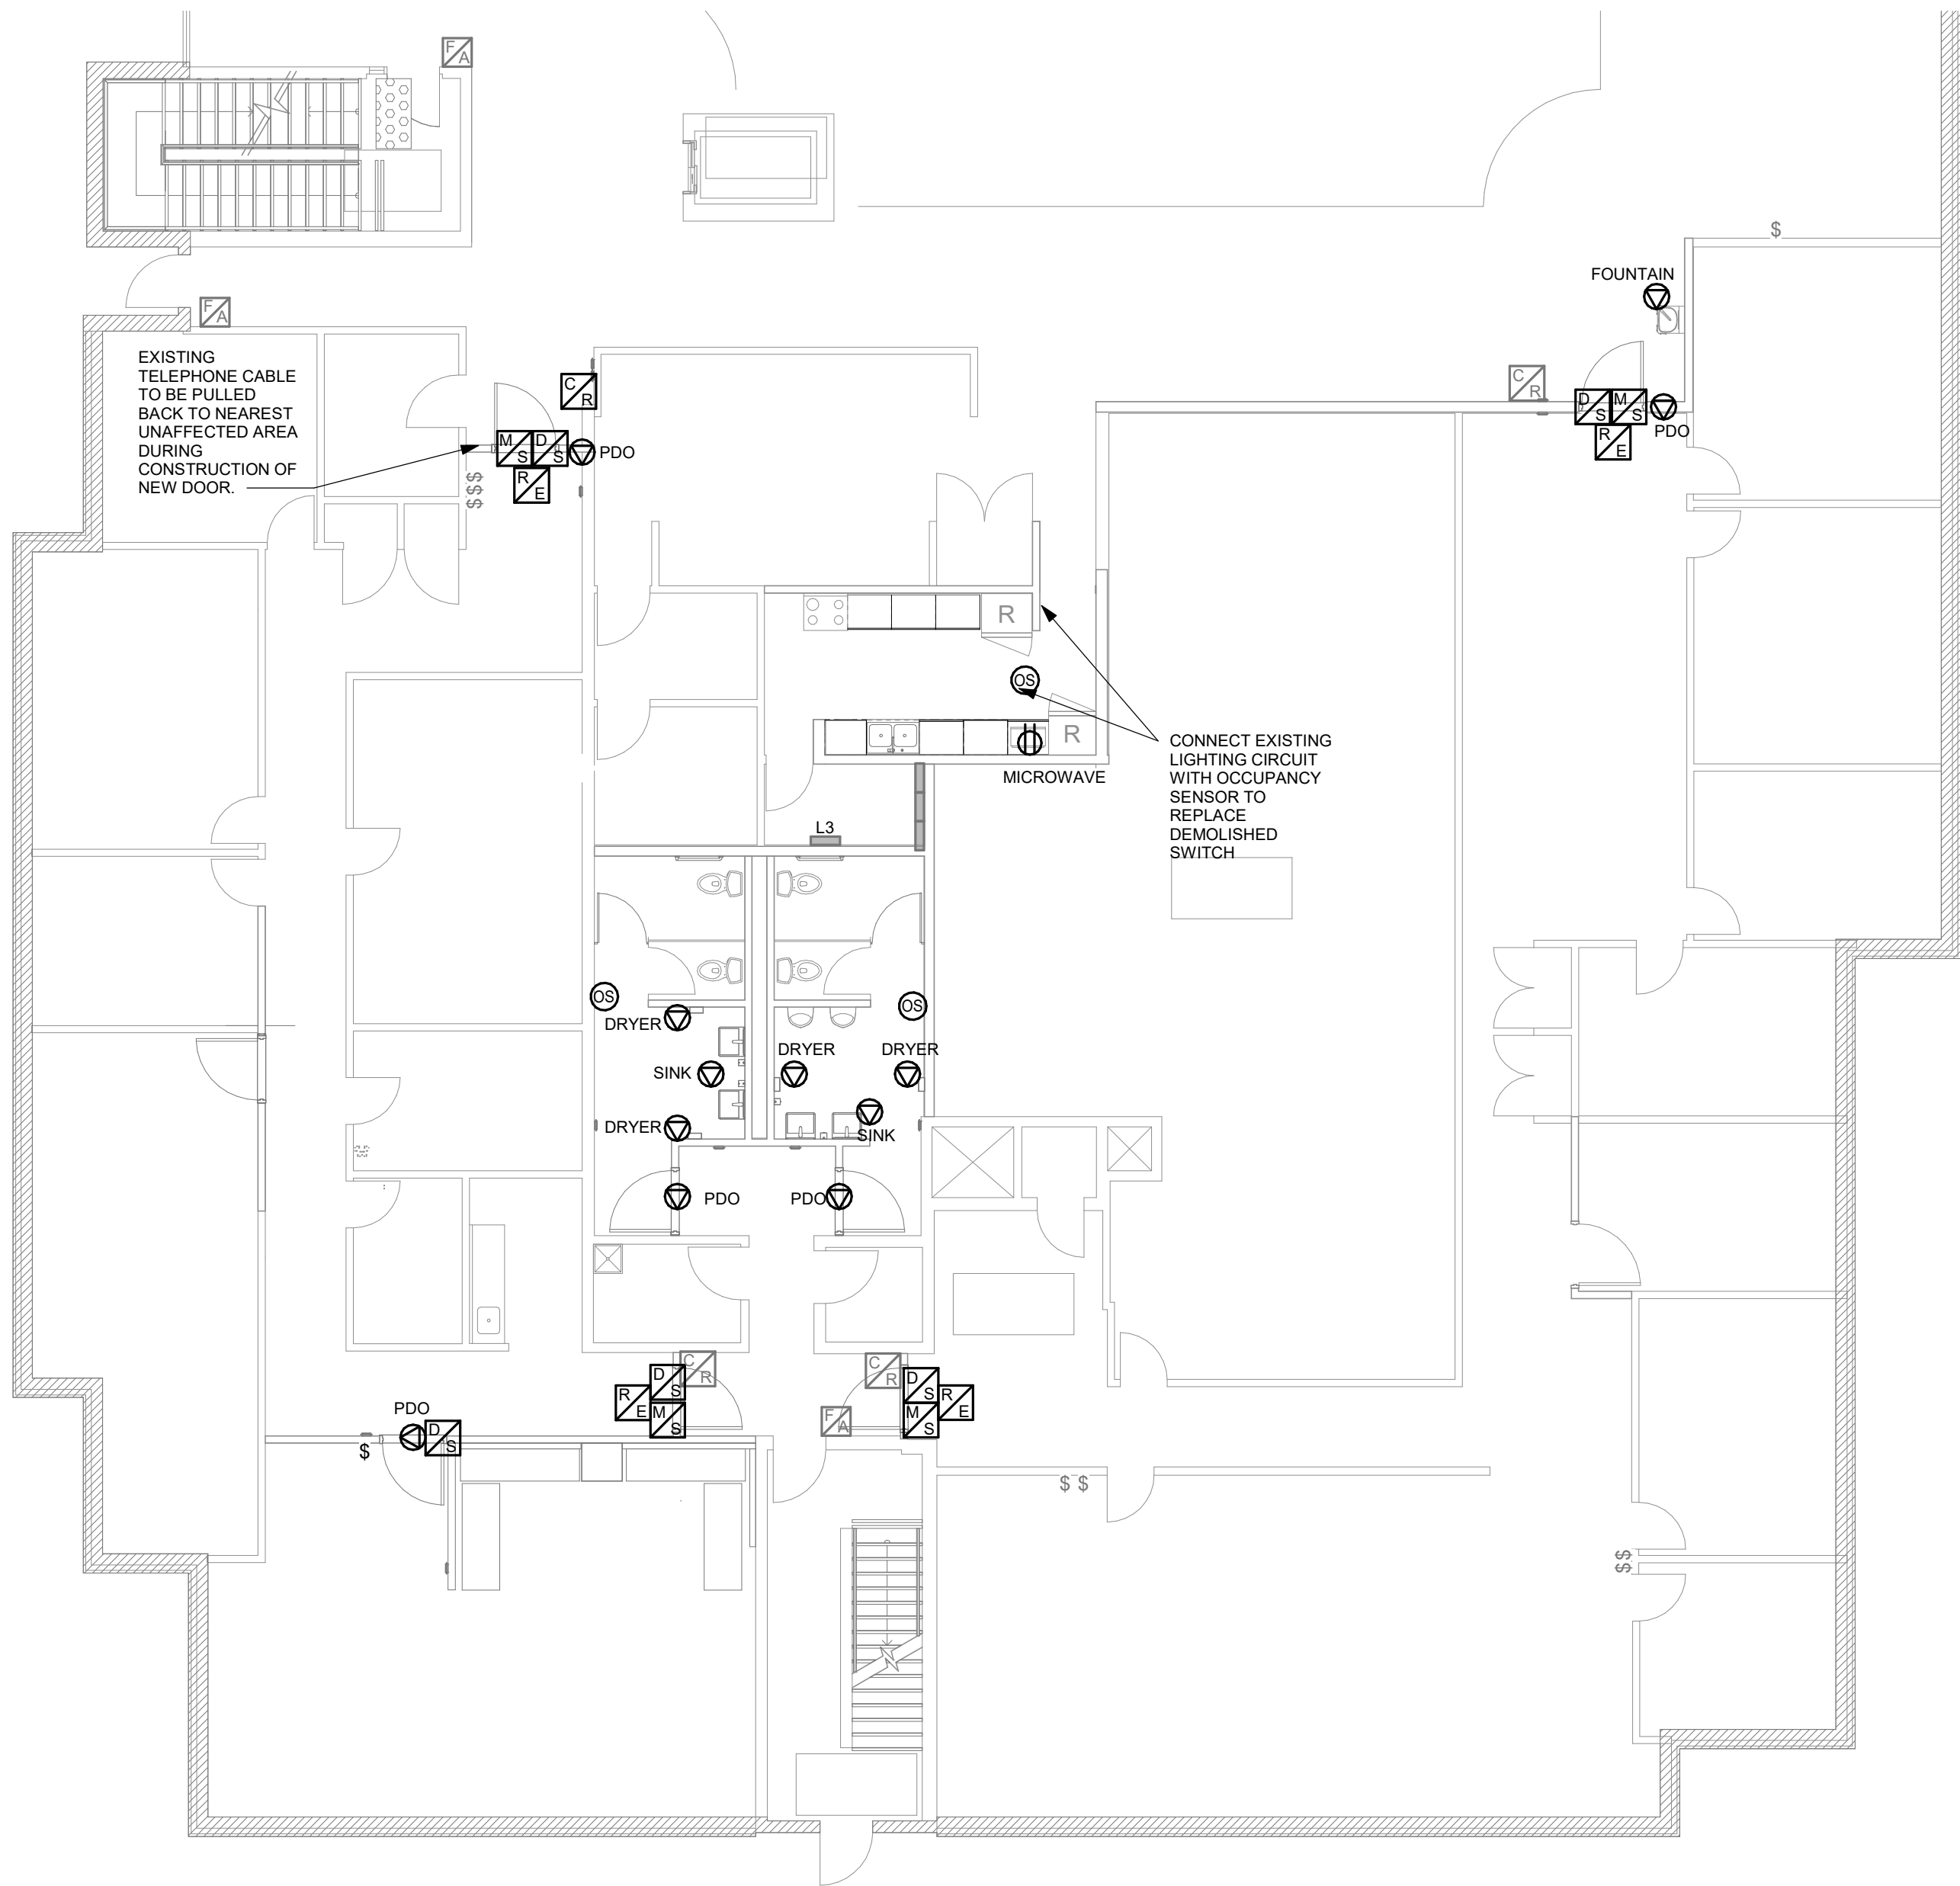
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E2105

POWER & SYSTEMS PLAN 1ST FLOOR PART 3

Scale: 1 : 100

NOTES:

1. PROVIDE POWER DOOR OPERATOR CIRCUIT CONNECTION AS INDICATED. PROVIDE CONDUIT/WIRE TO PUSH BUTTON DEVICES FROM DOOR OPERATOR. SEE ARCHITECTURAL PROPOSED PLAN FOR LOCATION OF PUSH BUTTON/WAVE TO OPEN DEVICES.
2. PROVIDE DOOR SECURITY DEVICES AS INDICATED. PROVIDE CONDUIT/WIRING TO ACCESS CONTROL/SECURITY DEVICES AS SHOWN. FOR DRYWALL AREAS CONCEAL CONDUIT AND BOXES. FOR BLOCK WALL AREAS SURFACE MOUNT CONDUIT AND PAINT CONDUIT/BOX SAME COLOUR TONE AS WALL BEHIND IT.
3. ADJUST FIRE ALARM PULL STATION HEIGHT TO COMPLIANT HEIGHT (AS LISTED IN THE MOUNTING HEIGHTS SCHEDULE) FOR ALL PULL STATIONS SHOWN.
4. PROVIDE NEW LIGHTING SWITCHES AT LOCATIONS INDICATED TO REPLACE DEMOLISHED IN SAME AREA. RE-CONNECT EXISTING LIGHTING CIRCUITS TO NEW SWITCHES.



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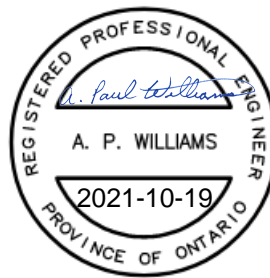
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ibigroup.com

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PROJECT ADDRESS

Fire/EMS HQ & EMS Station
53
4330 Dufferin St

PROJECT NO:

9119- 19- 0162 / IBI 122260

DRAWN BY:

Author

CHECKED BY:

Checker

PROJECT MGR:

F. BOLOURIAN

APPROVED BY:

Approver

SHEET TITLE

POWER & SYSTEMS
ENLARGED PLAN 1ST
FLOOR PART 3

SHEET NUMBER

G08-229-E2105


ISSUE

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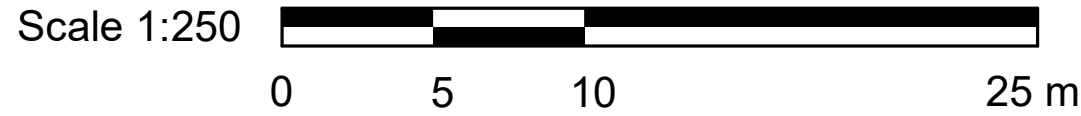
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10mm

SCALE CHECK
1 m



1 POWER & SYSTEMS 2ND FLOOR KEY PLAN
E2106 Scale: 1 : 250

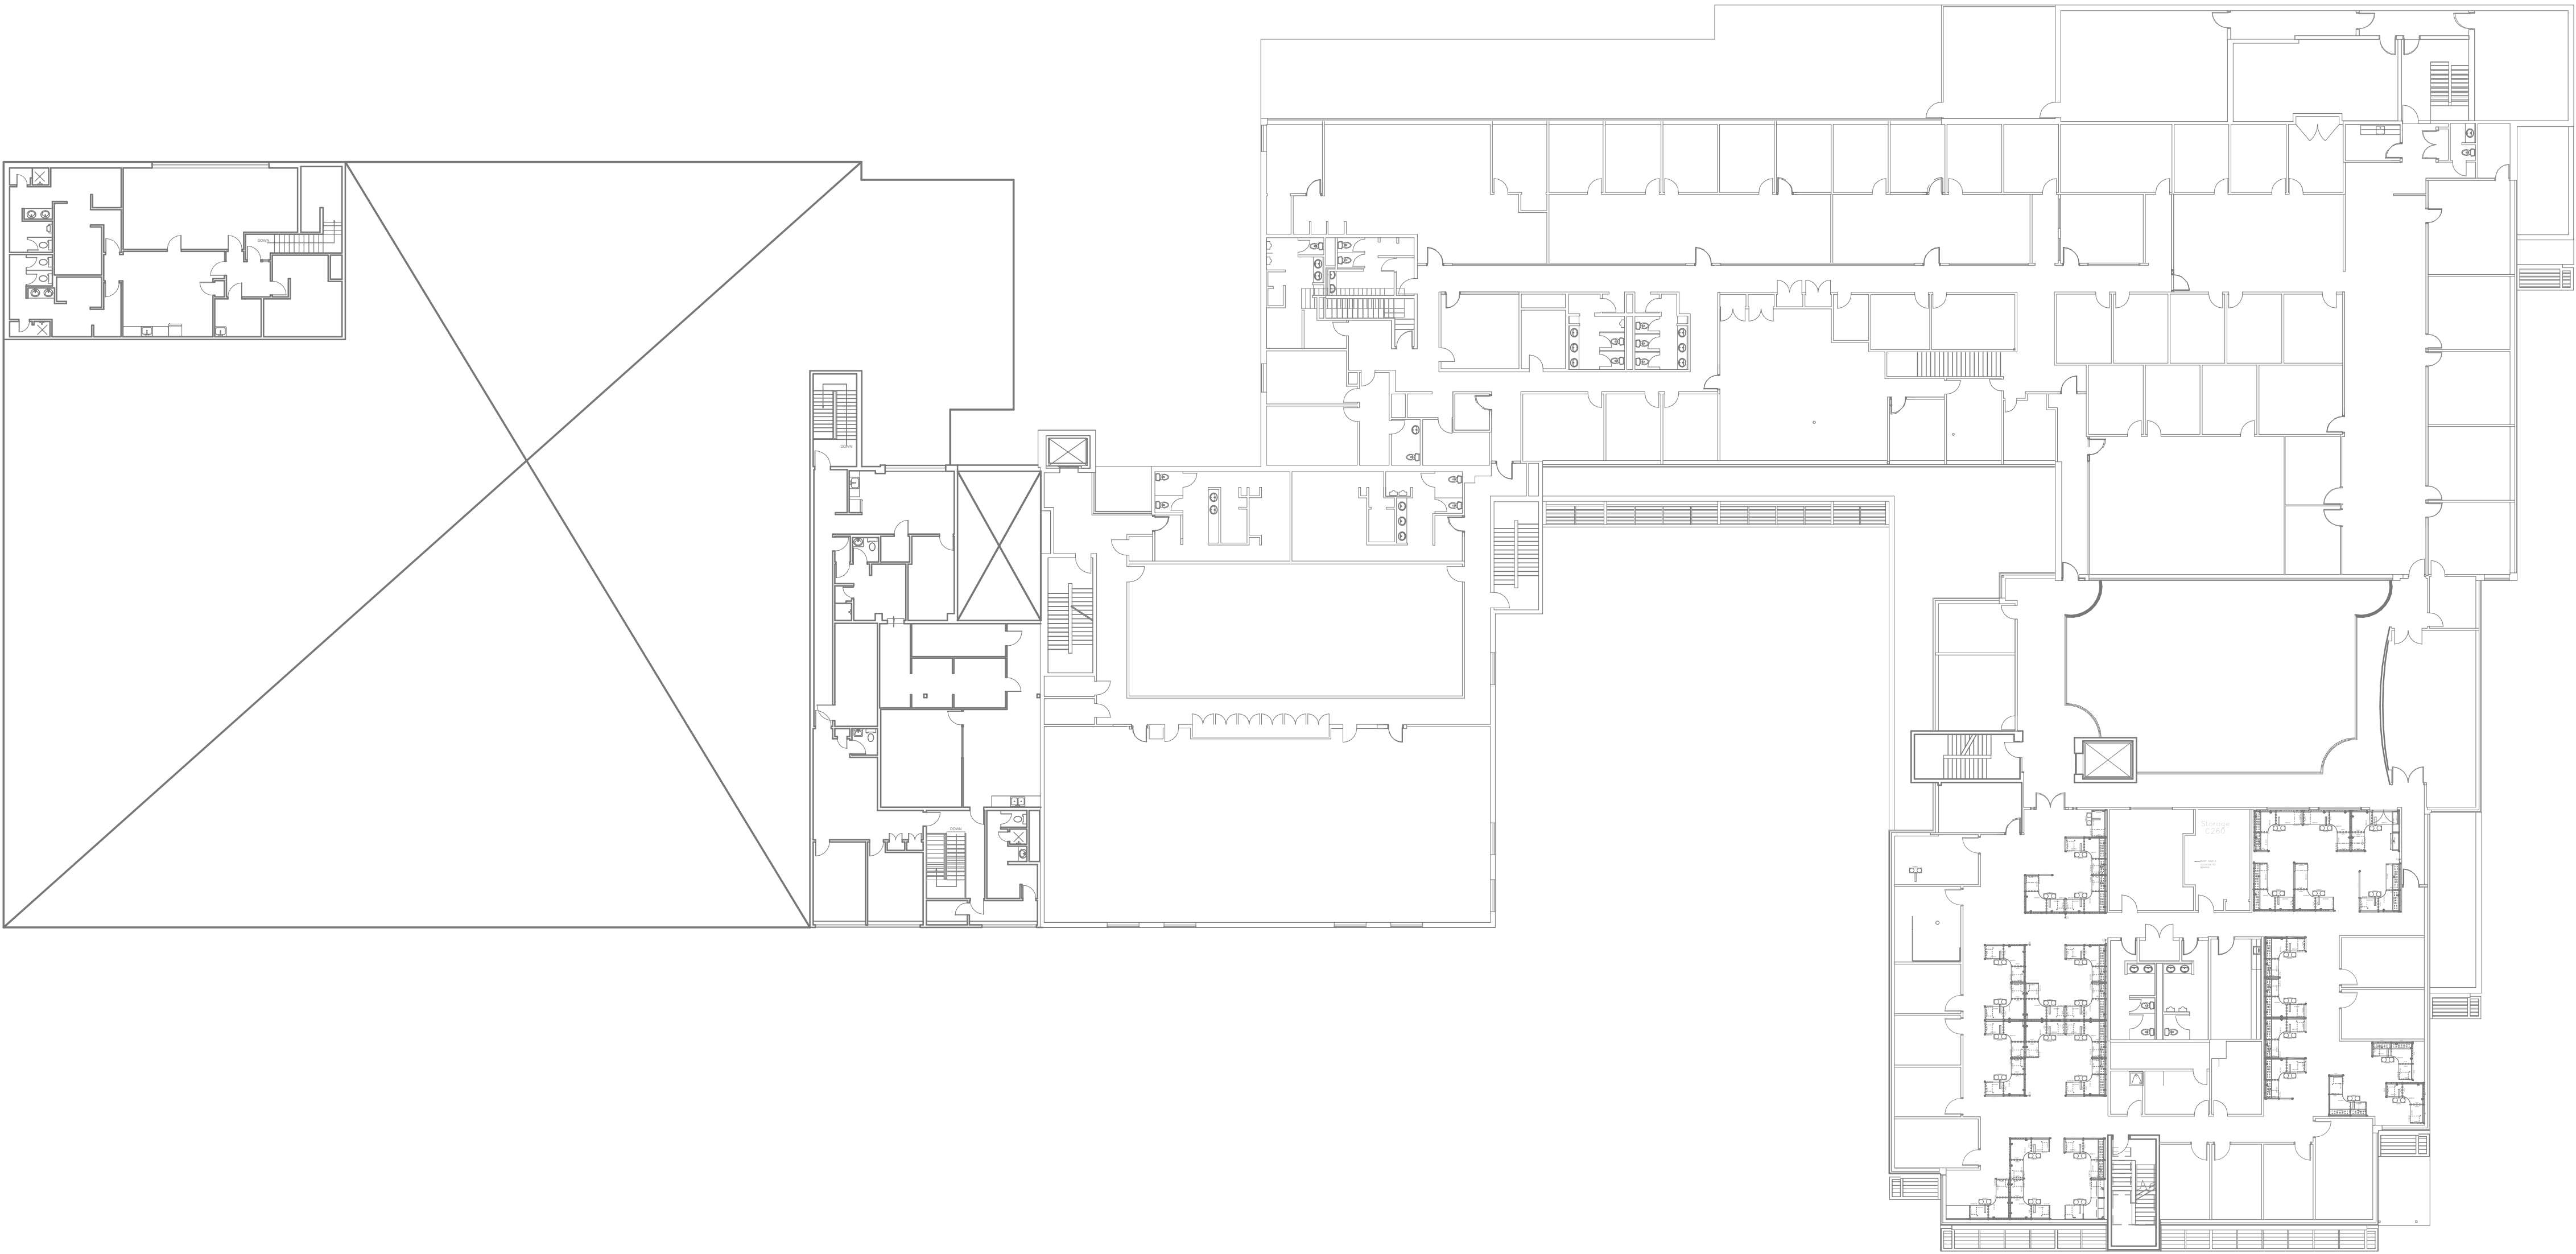

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PROJECT TITLE
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PROJECT ADDRESS
**Fire/EMS HQ & EMS Station
53
4330 Dufferin St**

PROJECT NO:
9119- 19- 0162 / IBI 122260

DRAWN BY:
M.BOJIC

CHECKED BY:
P. WILLIAMS

PROJECT MGR:

F.BOLOURIAN


APPROVED BY:

P. WILLIAMS

SHEET TITLE
**POWER & SYSTEMS
PLAN 2ND FLOOR KEY
PLAN**

SHEET NUMBER
G08-229-E2106

ISSUE
0

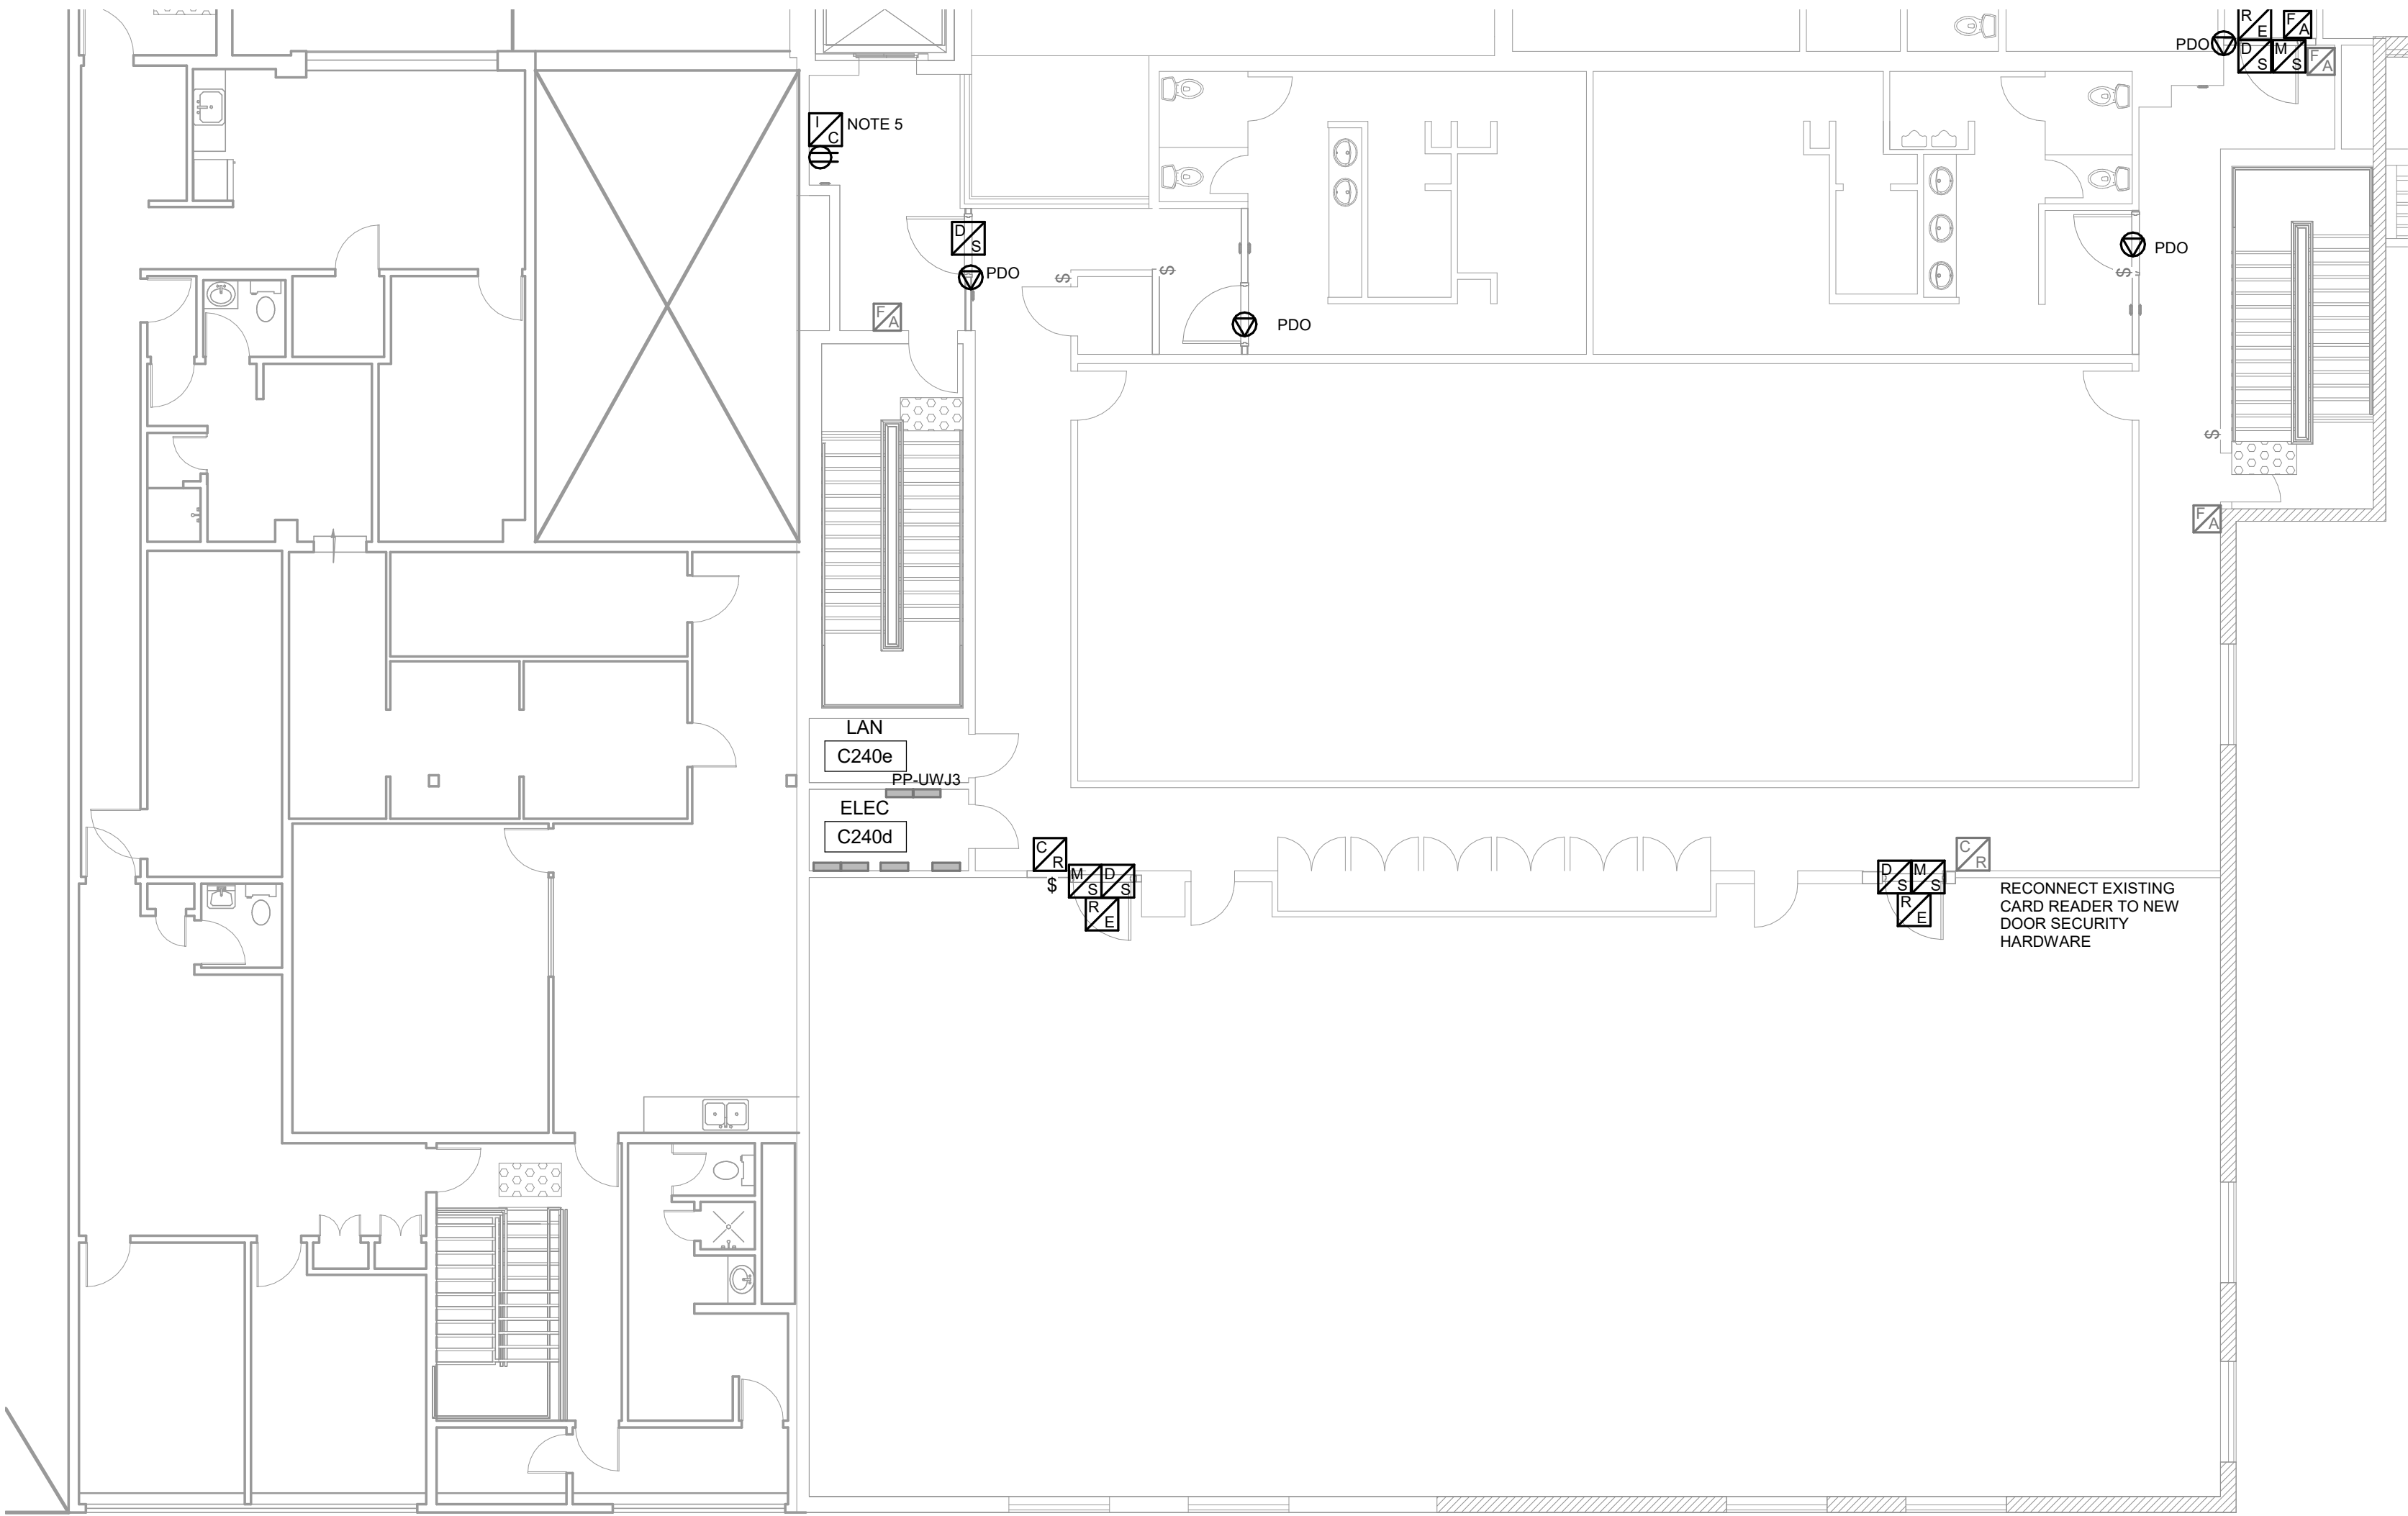

1 POWER & SYSTEMS PLAN 2ND FLOOR PART 1
E2107 Scale: 1 : 100

NOTES:

1. PROVIDE POWER DOOR OPERATOR CIRCUIT CONNECTION AS INDICATED. PROVIDE CONDUIT/WIRE TO PUSH BUTTON DEVICES FROM DOOR OPERATOR. SEE ARCHITECTURAL PROPOSED PLAN FOR LOCATION OF PUSH BUTTON/WAVE TO OPEN DEVICES.
2. PROVIDE DOOR SECURITY DEVICES AS INDICATED. PROVIDE CONDUIT/WIRING TO ACCESS CONTROL/SECURITY DEVICES AS SHOWN. FOR DRYWALL AREAS CONCEAL CONDUIT AND BOXES. FOR BLOCK WALL AREAS SURFACE MOUNT CONDUIT AND PAINT CONDUIT/BOX SAME COLOUR/TONE AS WALL BEHIND IT.
3. ADJUST FIRE ALARM PULL STATION HEIGHT TO COMPLIANT HEIGHT (AS LISTED IN THE MOUNTING HEIGHTS SCHEDULE) FOR ALL PULL STATIONS SHOWN.
4. PROVIDE NEW LIGHTING SWITCHES AT LOCATIONS INDICATED TO REPLACE DEMOLISHED IN SAME AREA. RE-CONNECT EXISTING LIGHTING CIRCUITS TO NEW SWITCHES.
5. PROVIDE INTERCOM TERMINAL UNIT FOR PROTECT IN PLACE AREA. RUN CATEGORY 6 CABLE TO FIRST FLOOR ELECTRICAL ROOM.

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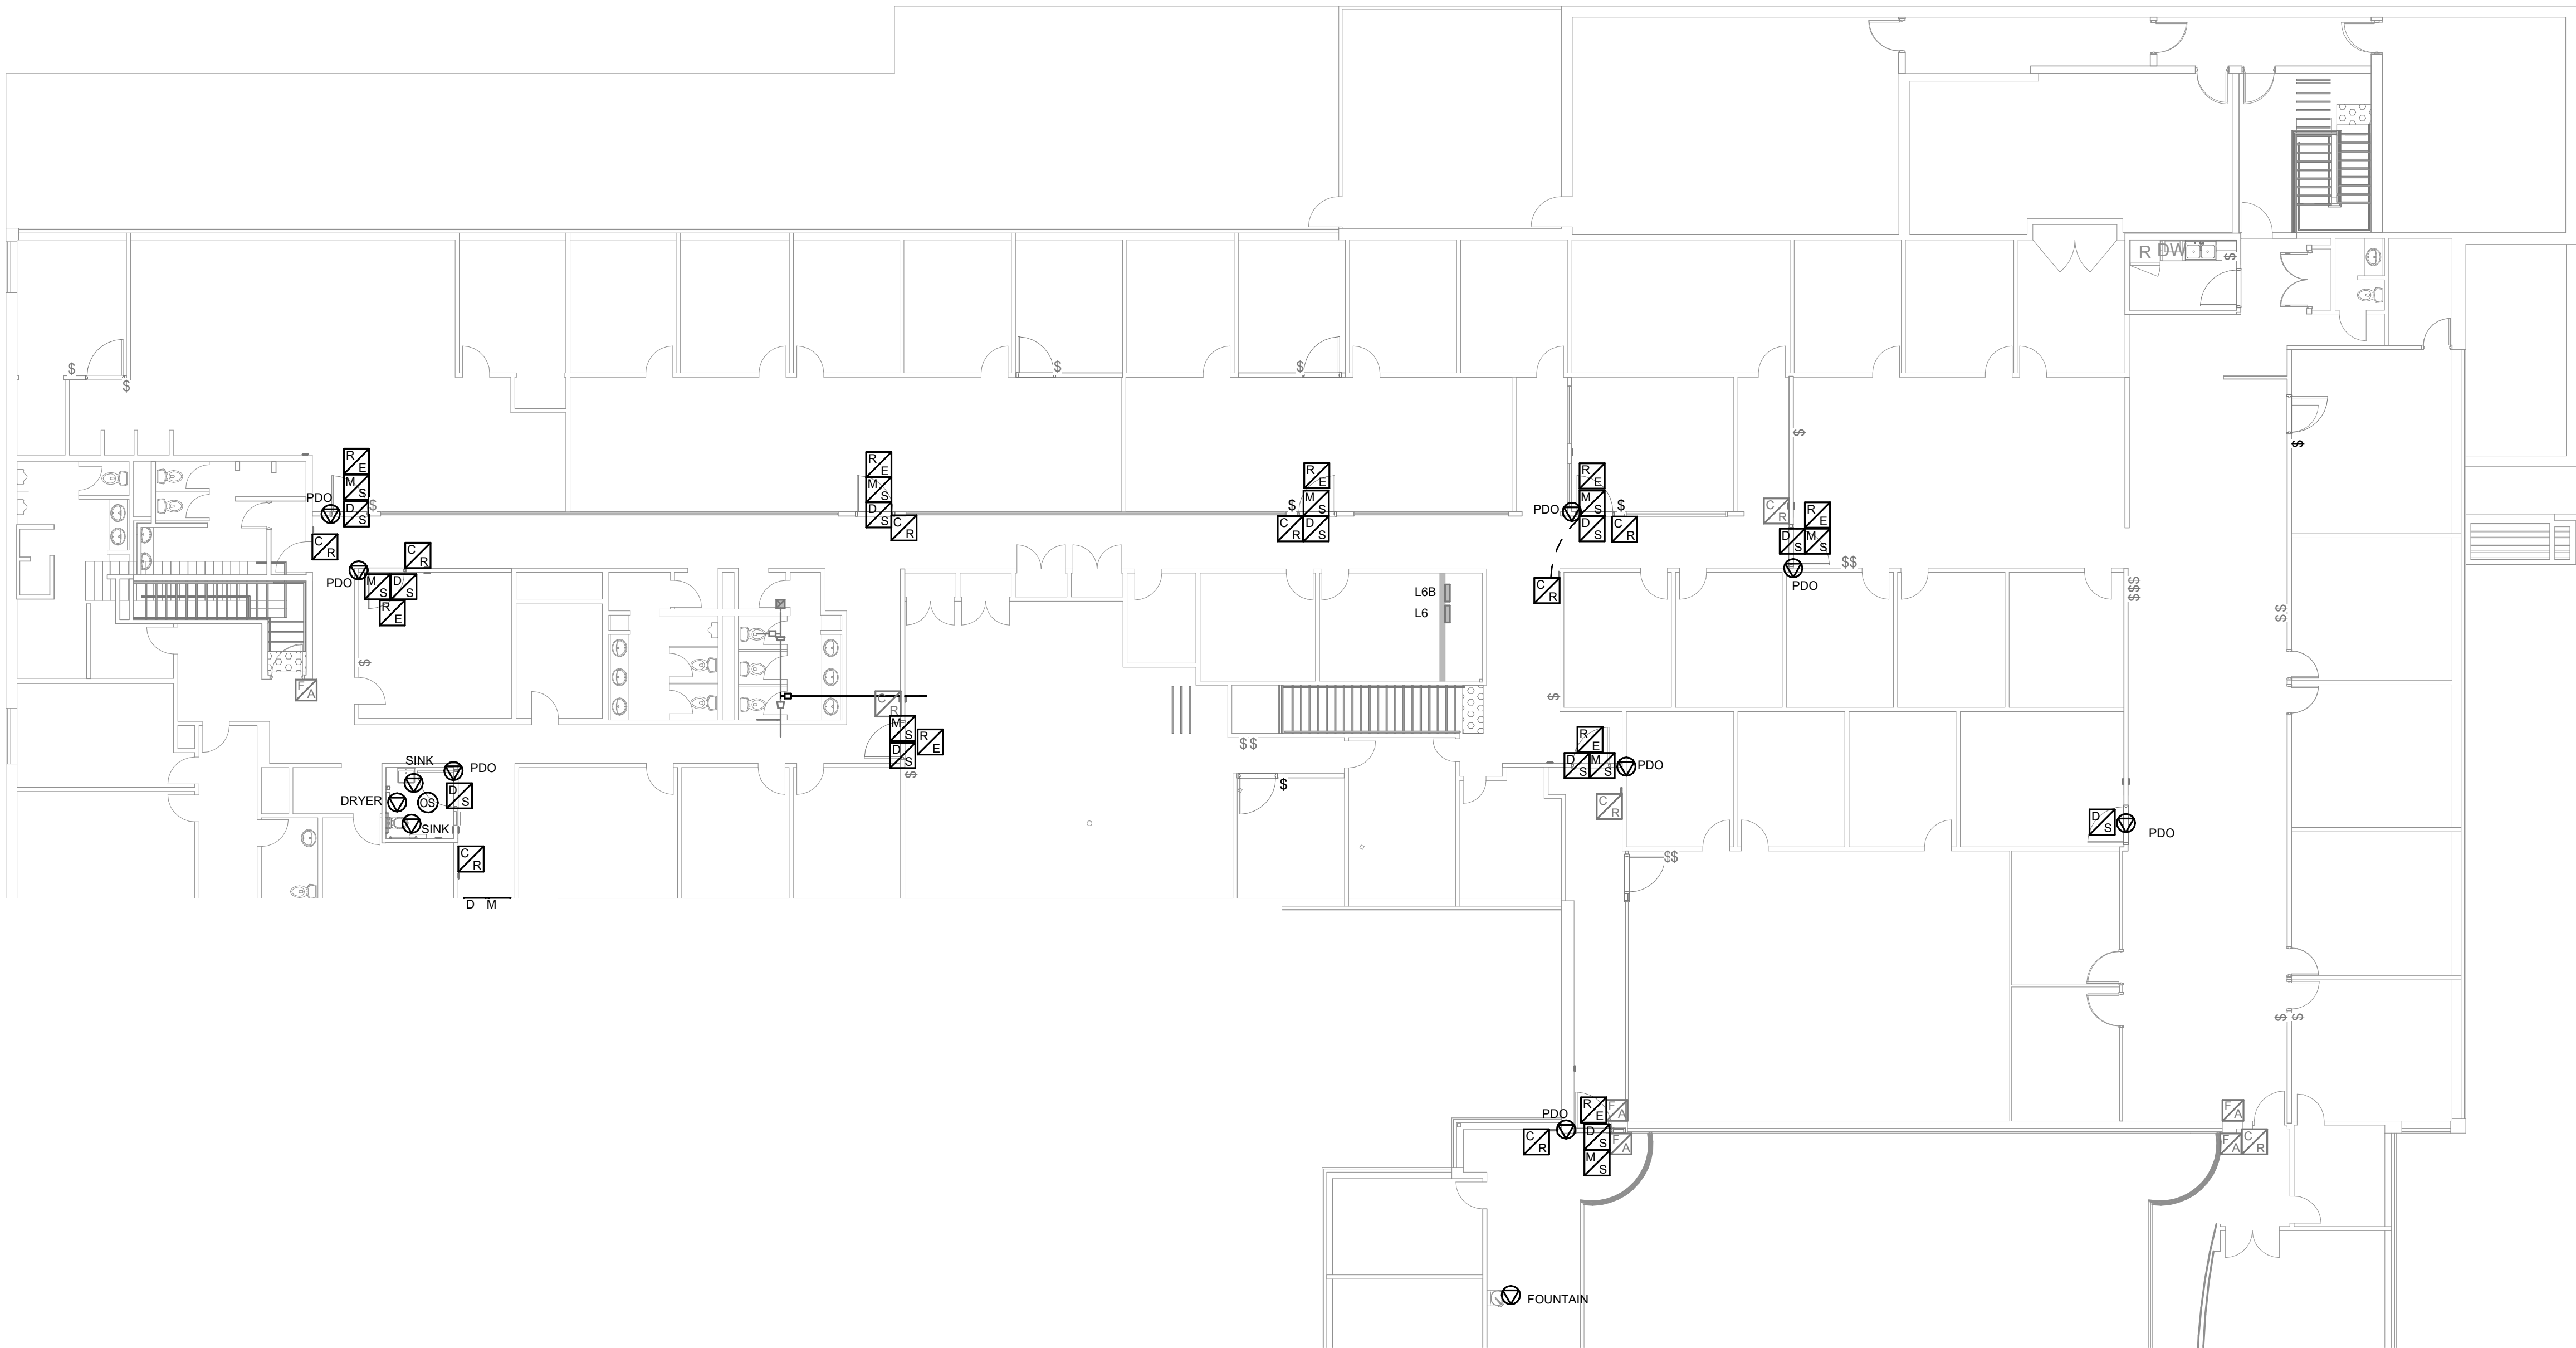
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53
4330 Dufferin St**

PROJECT NO: 9119- 19- 0162 / IBI 122260	
DRAWN BY: Author	CHECKED BY: Checker
PROJECT MGR: F. BOLOURIAN	APPROVED BY: Approver

SHEET TITLE
**POWER & SYSTEMS
ENLARGED PLAN 2ND
FLOOR PART 1**

SHEET NUMBER G08-229-E2107	ISSUE 0
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1
E2108 POWER & SYSTEMS 2ND FLOOR PLAN PART 2
Scale: 1 : 125

NOTES:

1. PROVIDE POWER DOOR OPERATOR CIRCUIT CONNECTION AS INDICATED. PROVIDE CONDUIT/WIRE TO PUSH BUTTON DEVICES FROM DOOR OPERATOR. SEE ARCHITECTURAL PROPOSED PLAN FOR LOCATION OF PUSH BUTTON/WAVE TO OPEN DEVICES.
2. PROVIDE DOOR SECURITY DEVICES AS INDICATED. PROVIDE CONDUIT/WIRING TO ACCESS CONTROL/SECURITY DEVICES AS SHOWN. FOR DRYWALL AREAS CONCEAL CONDUIT AND BOXES. FOR BLOCK WALL AREAS SURFACE MOUNT CONDUIT AND PAINT CONDUIT/BOX SAME COLOUR/TONE AS WALL BEHIND IT.
3. ADJUST FIRE ALARM PULL STATION HEIGHT TO COMPLIANT HEIGHT (AS LISTED IN THE MOUNTING HEIGHTS SCHEDULE) FOR ALL PULL STATIONS SHOWN.
4. PROVIDE NEW LIGHTING SWITCHES AT LOCATIONS INDICATED TO REPLACE DEMOLISHED IN SAME AREA. RE-CONNECT EXISTING LIGHTING CIRCUITS TO NEW SWITCHES.

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Scale 1:100



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4330 Dufferin St**

PROJECT NO:
9119- 19- 0162 / IBI 122260

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Author

CHECKED BY:
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PROJECT MGR:
F.BOLOURIAN

APPROVED BY:
Approver

SHEET TITLE
**POWER & SYSTEMS
ENLARGED PLAN 2ND
FLOOR PART 2**


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G08-229-E2108

ISSUE
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10mm

SCALE CHECK
1 m



1 POWER & SYSTEMS PLAN 2ND FLOOR PART 3
E2109 Scale: 1 : 100

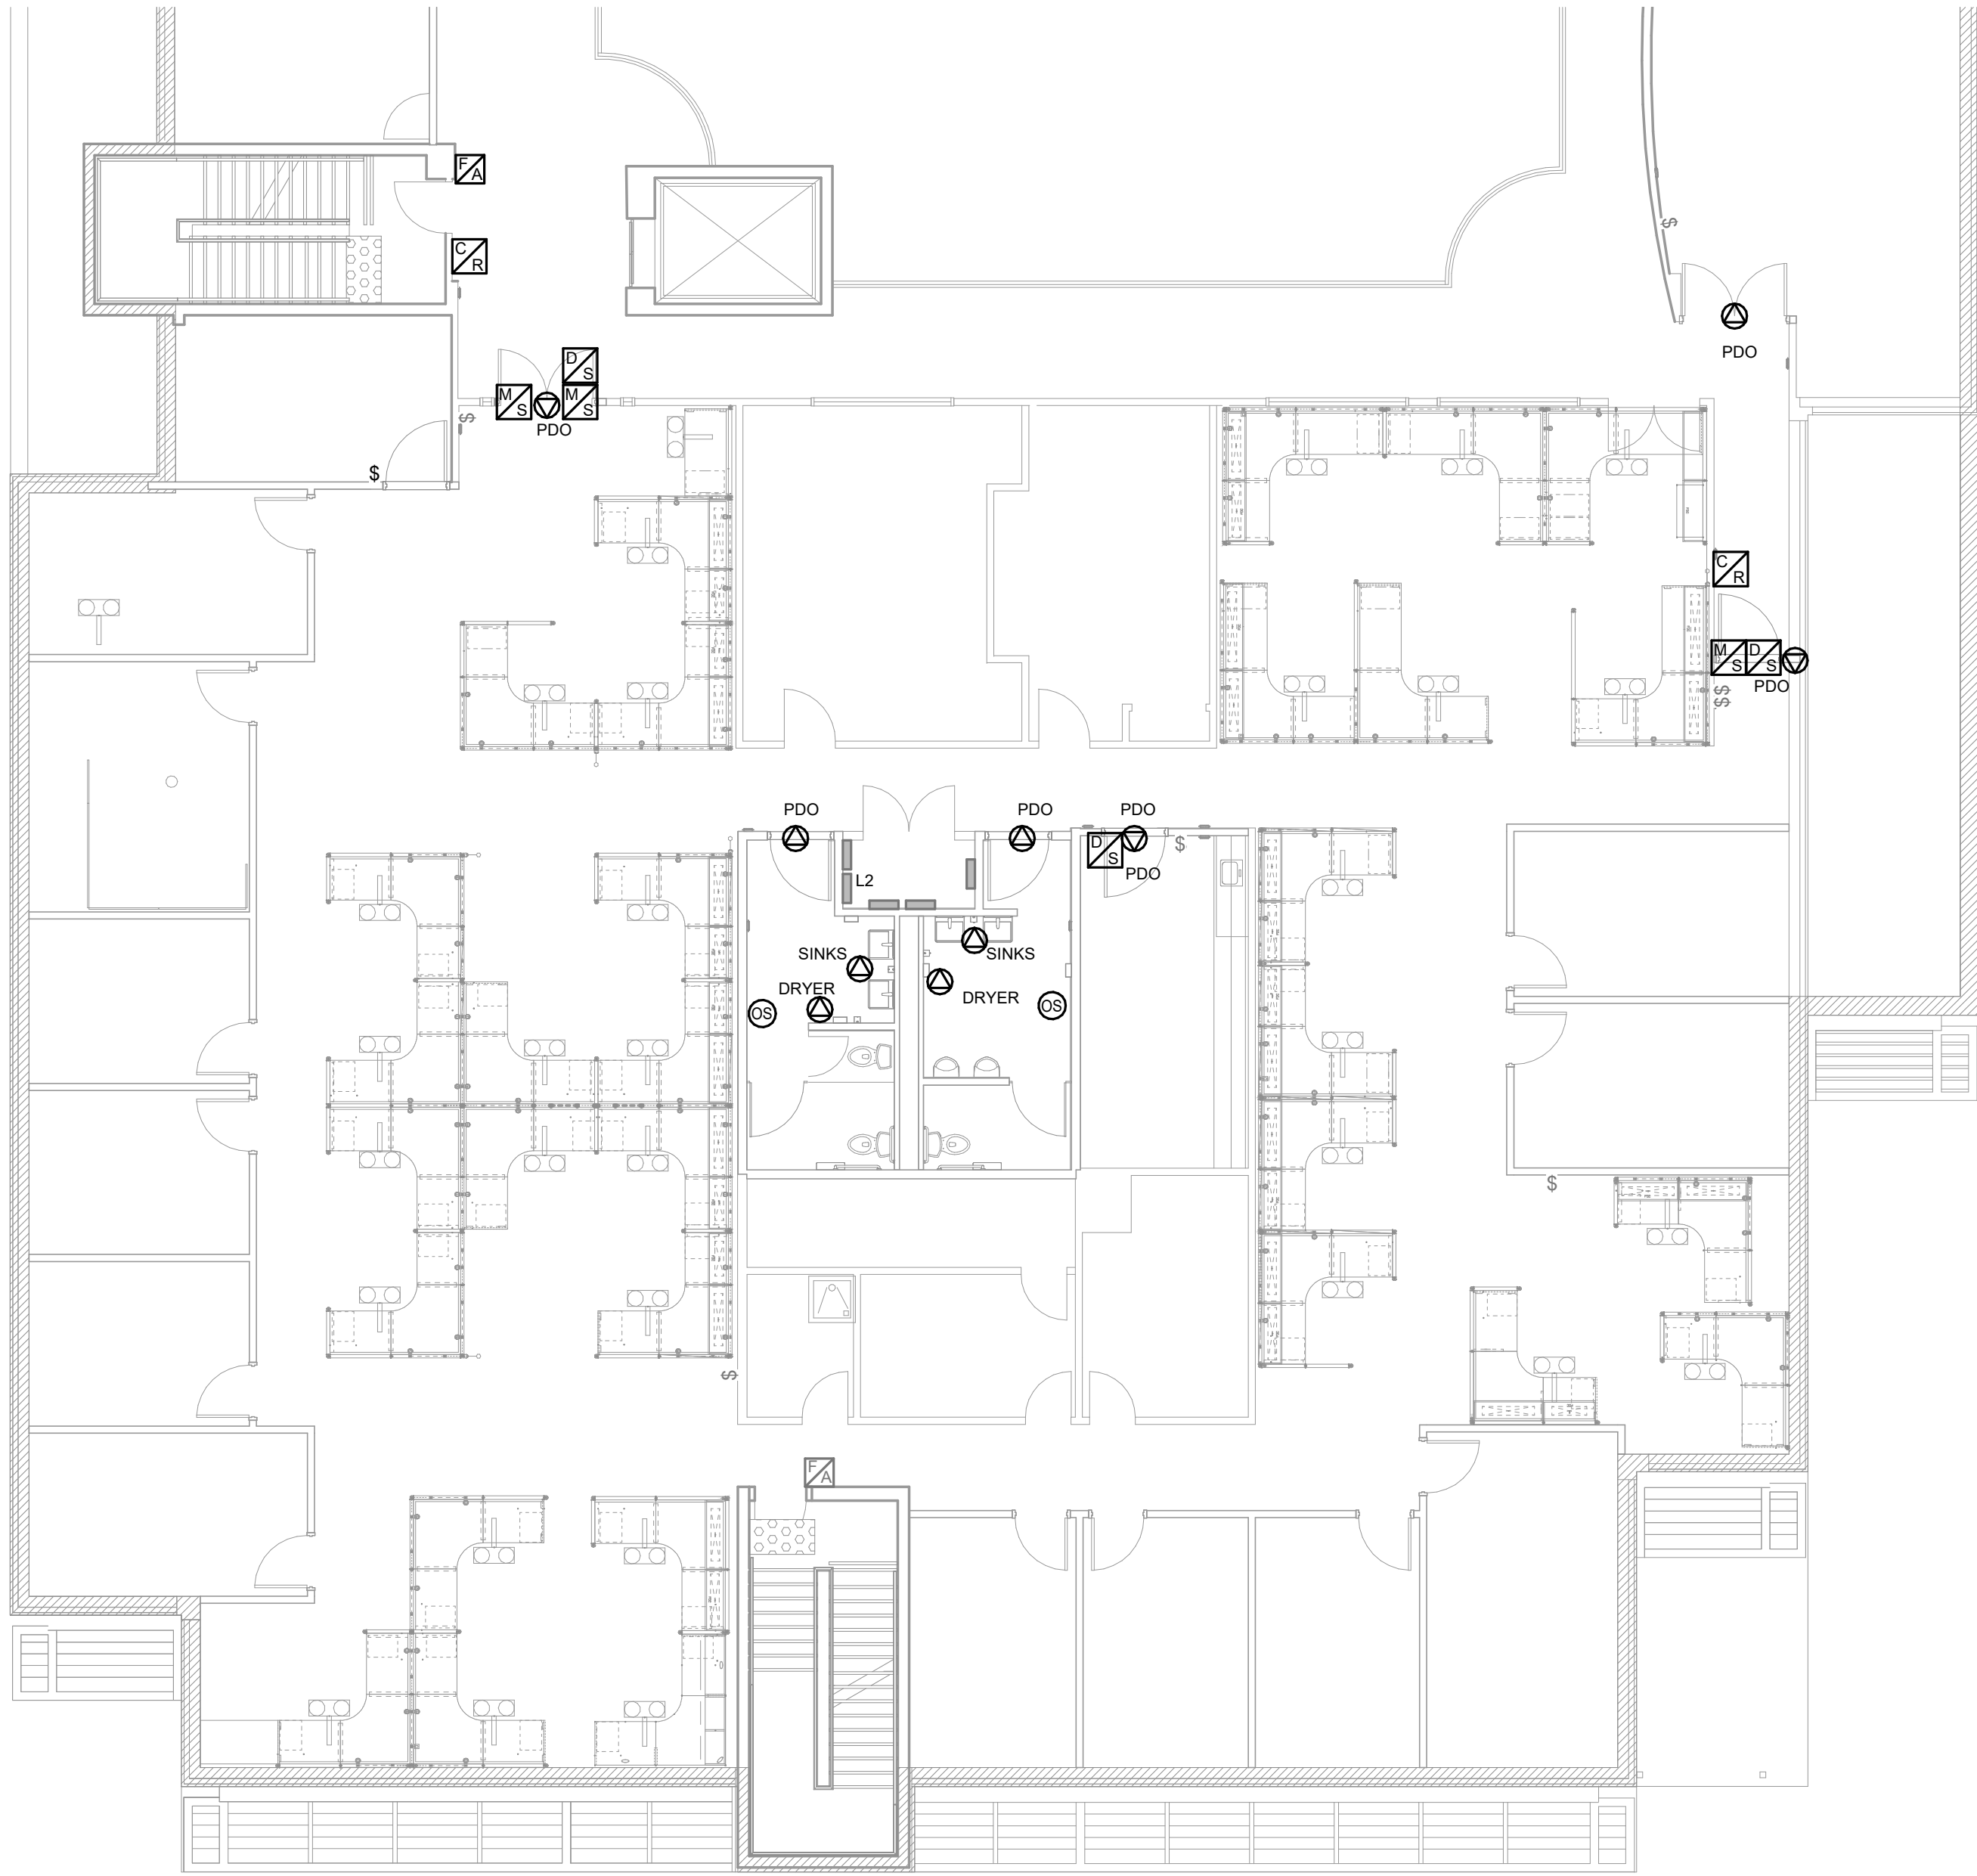- NOTES:
1. PROVIDE POWER DOOR OPERATOR CIRCUIT CONNECTION AS INDICATED. PROVIDE CONDUIT/WIRE TO PUSH BUTTON DEVICES FROM DOOR OPERATOR. SEE ARCHITECTURAL PROPOSED PLAN FOR LOCATION OF PUSH BUTTON/WAVE TO OPEN DEVICES.
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 5. PROVIDE INTERCOM TERMINAL UNIT FOR PROTECT IN PLACE AREA. RUN CATEGORY 6 CABLE TO FIRST FLOOR ELECTRICAL ROOM

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PROJECT TITLE
**CITY OF TORONTO
ACCESSIBILITY UPGRADES**

PROJECT ADDRESS
**Fire/EMS HQ & EMS Station
53
4330 Dufferin St**

PROJECT NO:
91119- 19- 0162 / IBI 122260

DRAWN BY: Author	CHECKED BY: Checker
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PROJECT MGR: F. BOLOURIAN	APPROVED BY: Approver
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SHEET TITLE
**POWER & SYSTEMS
ENLARGED PLAN 2ND
FLOOR PART 3**


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ISSUE
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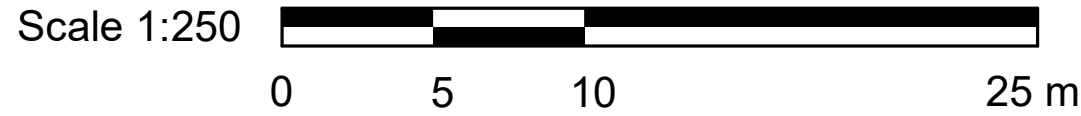
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10mm

SCALE CHECK
1 m



1 THIRD FLOOR KEY PLAN
E2110 Scale: 1 : 250

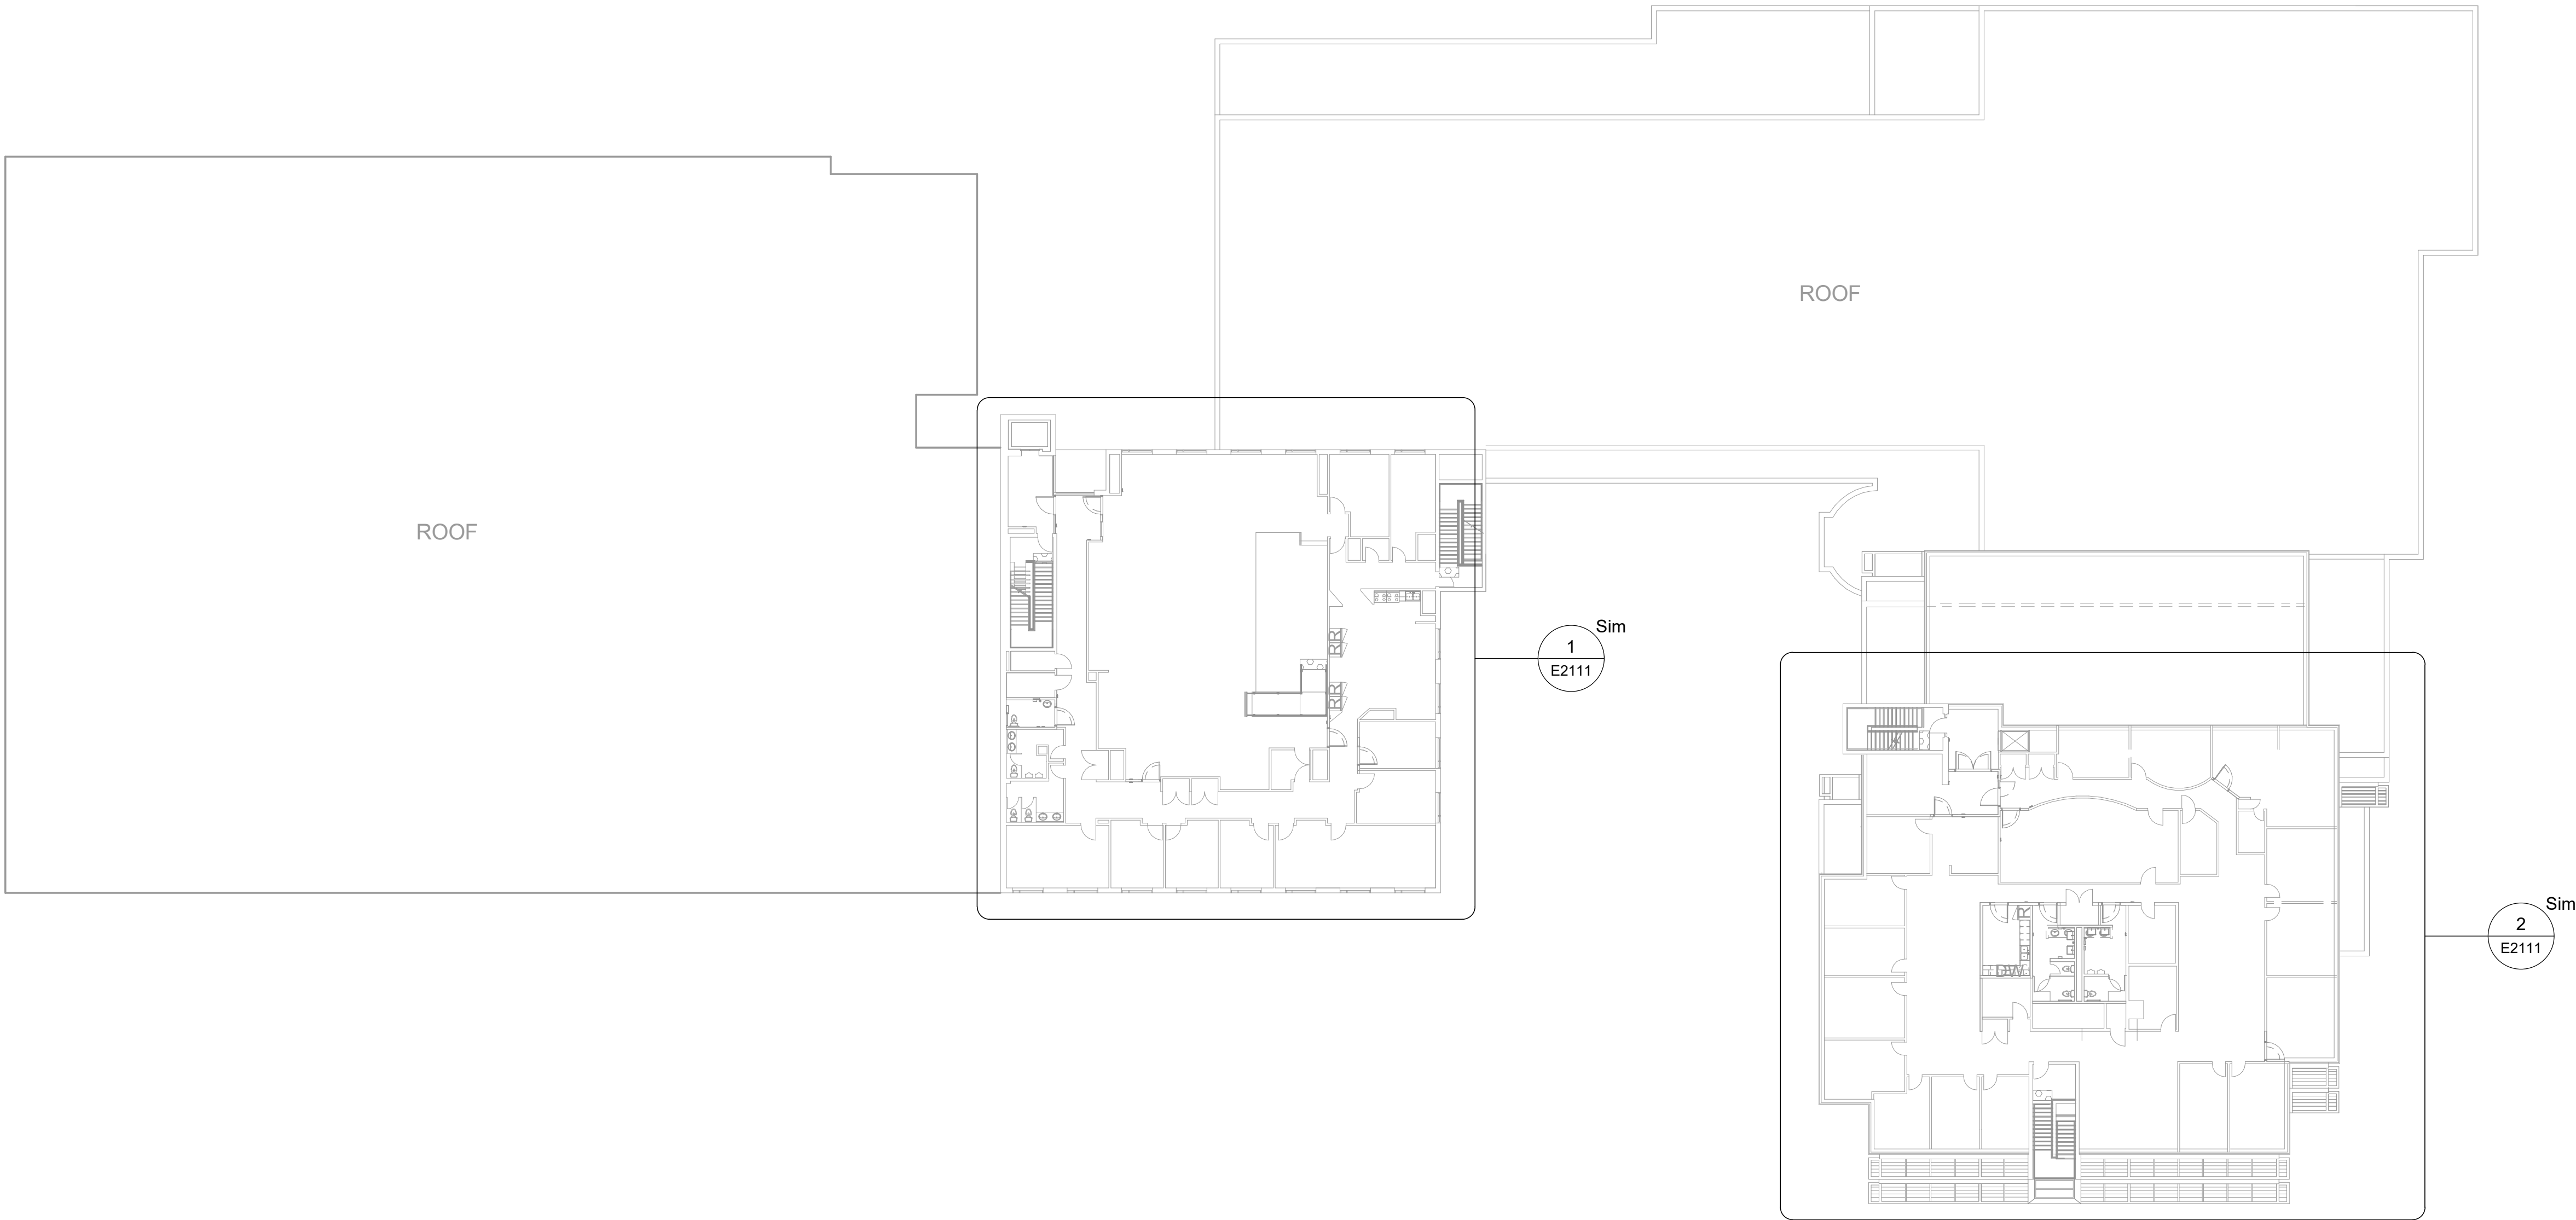

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**Toronto**

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53
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PROJECT NO:
9119- 19- 0162 / IBI 122260

DRAWN BY:
Author

CHECKED BY:
Checker

PROJECT MGR:
F.BOLOURIAN

APPROVED BY:
Approver


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**POWER & SYSTEMS
PLAN 3RD FLOOR KEY
PLAN**

SHEET NUMBER

G08-229-E2110

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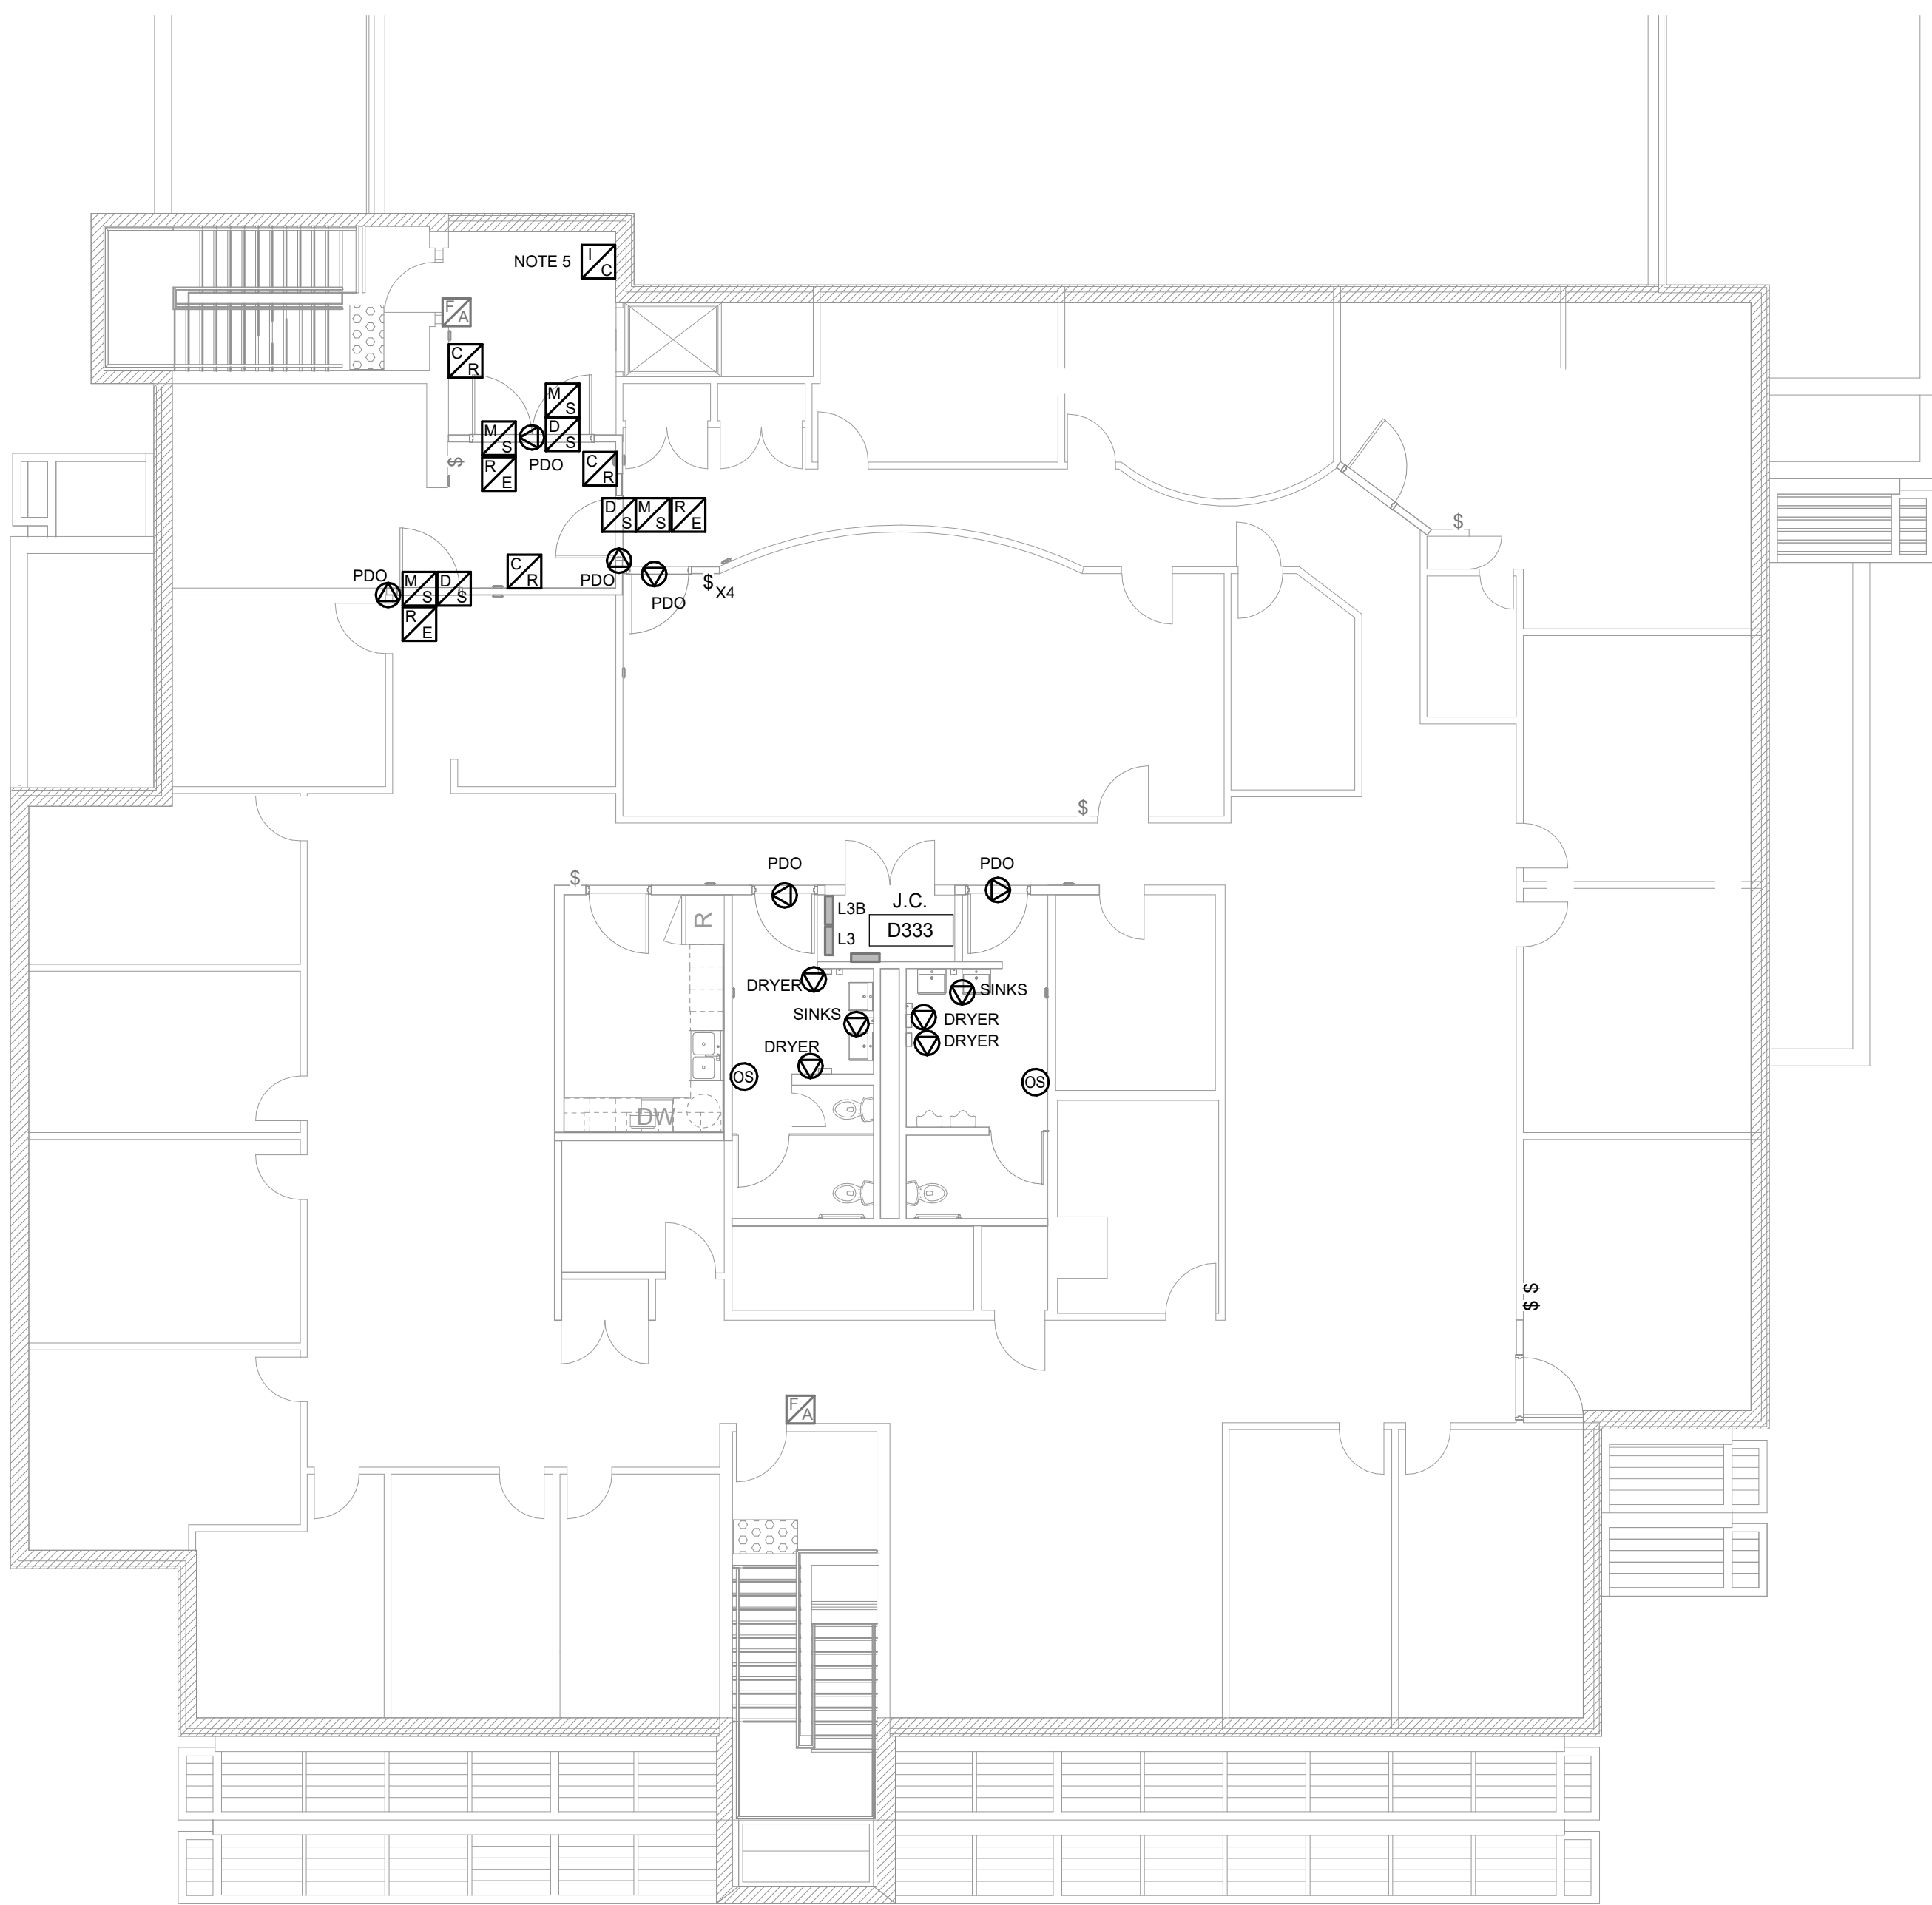
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1 POWER & SYSTEMS PLAN 3RD WEST OFFICES
E2111 / Scale: 1 : 100

NOTES:

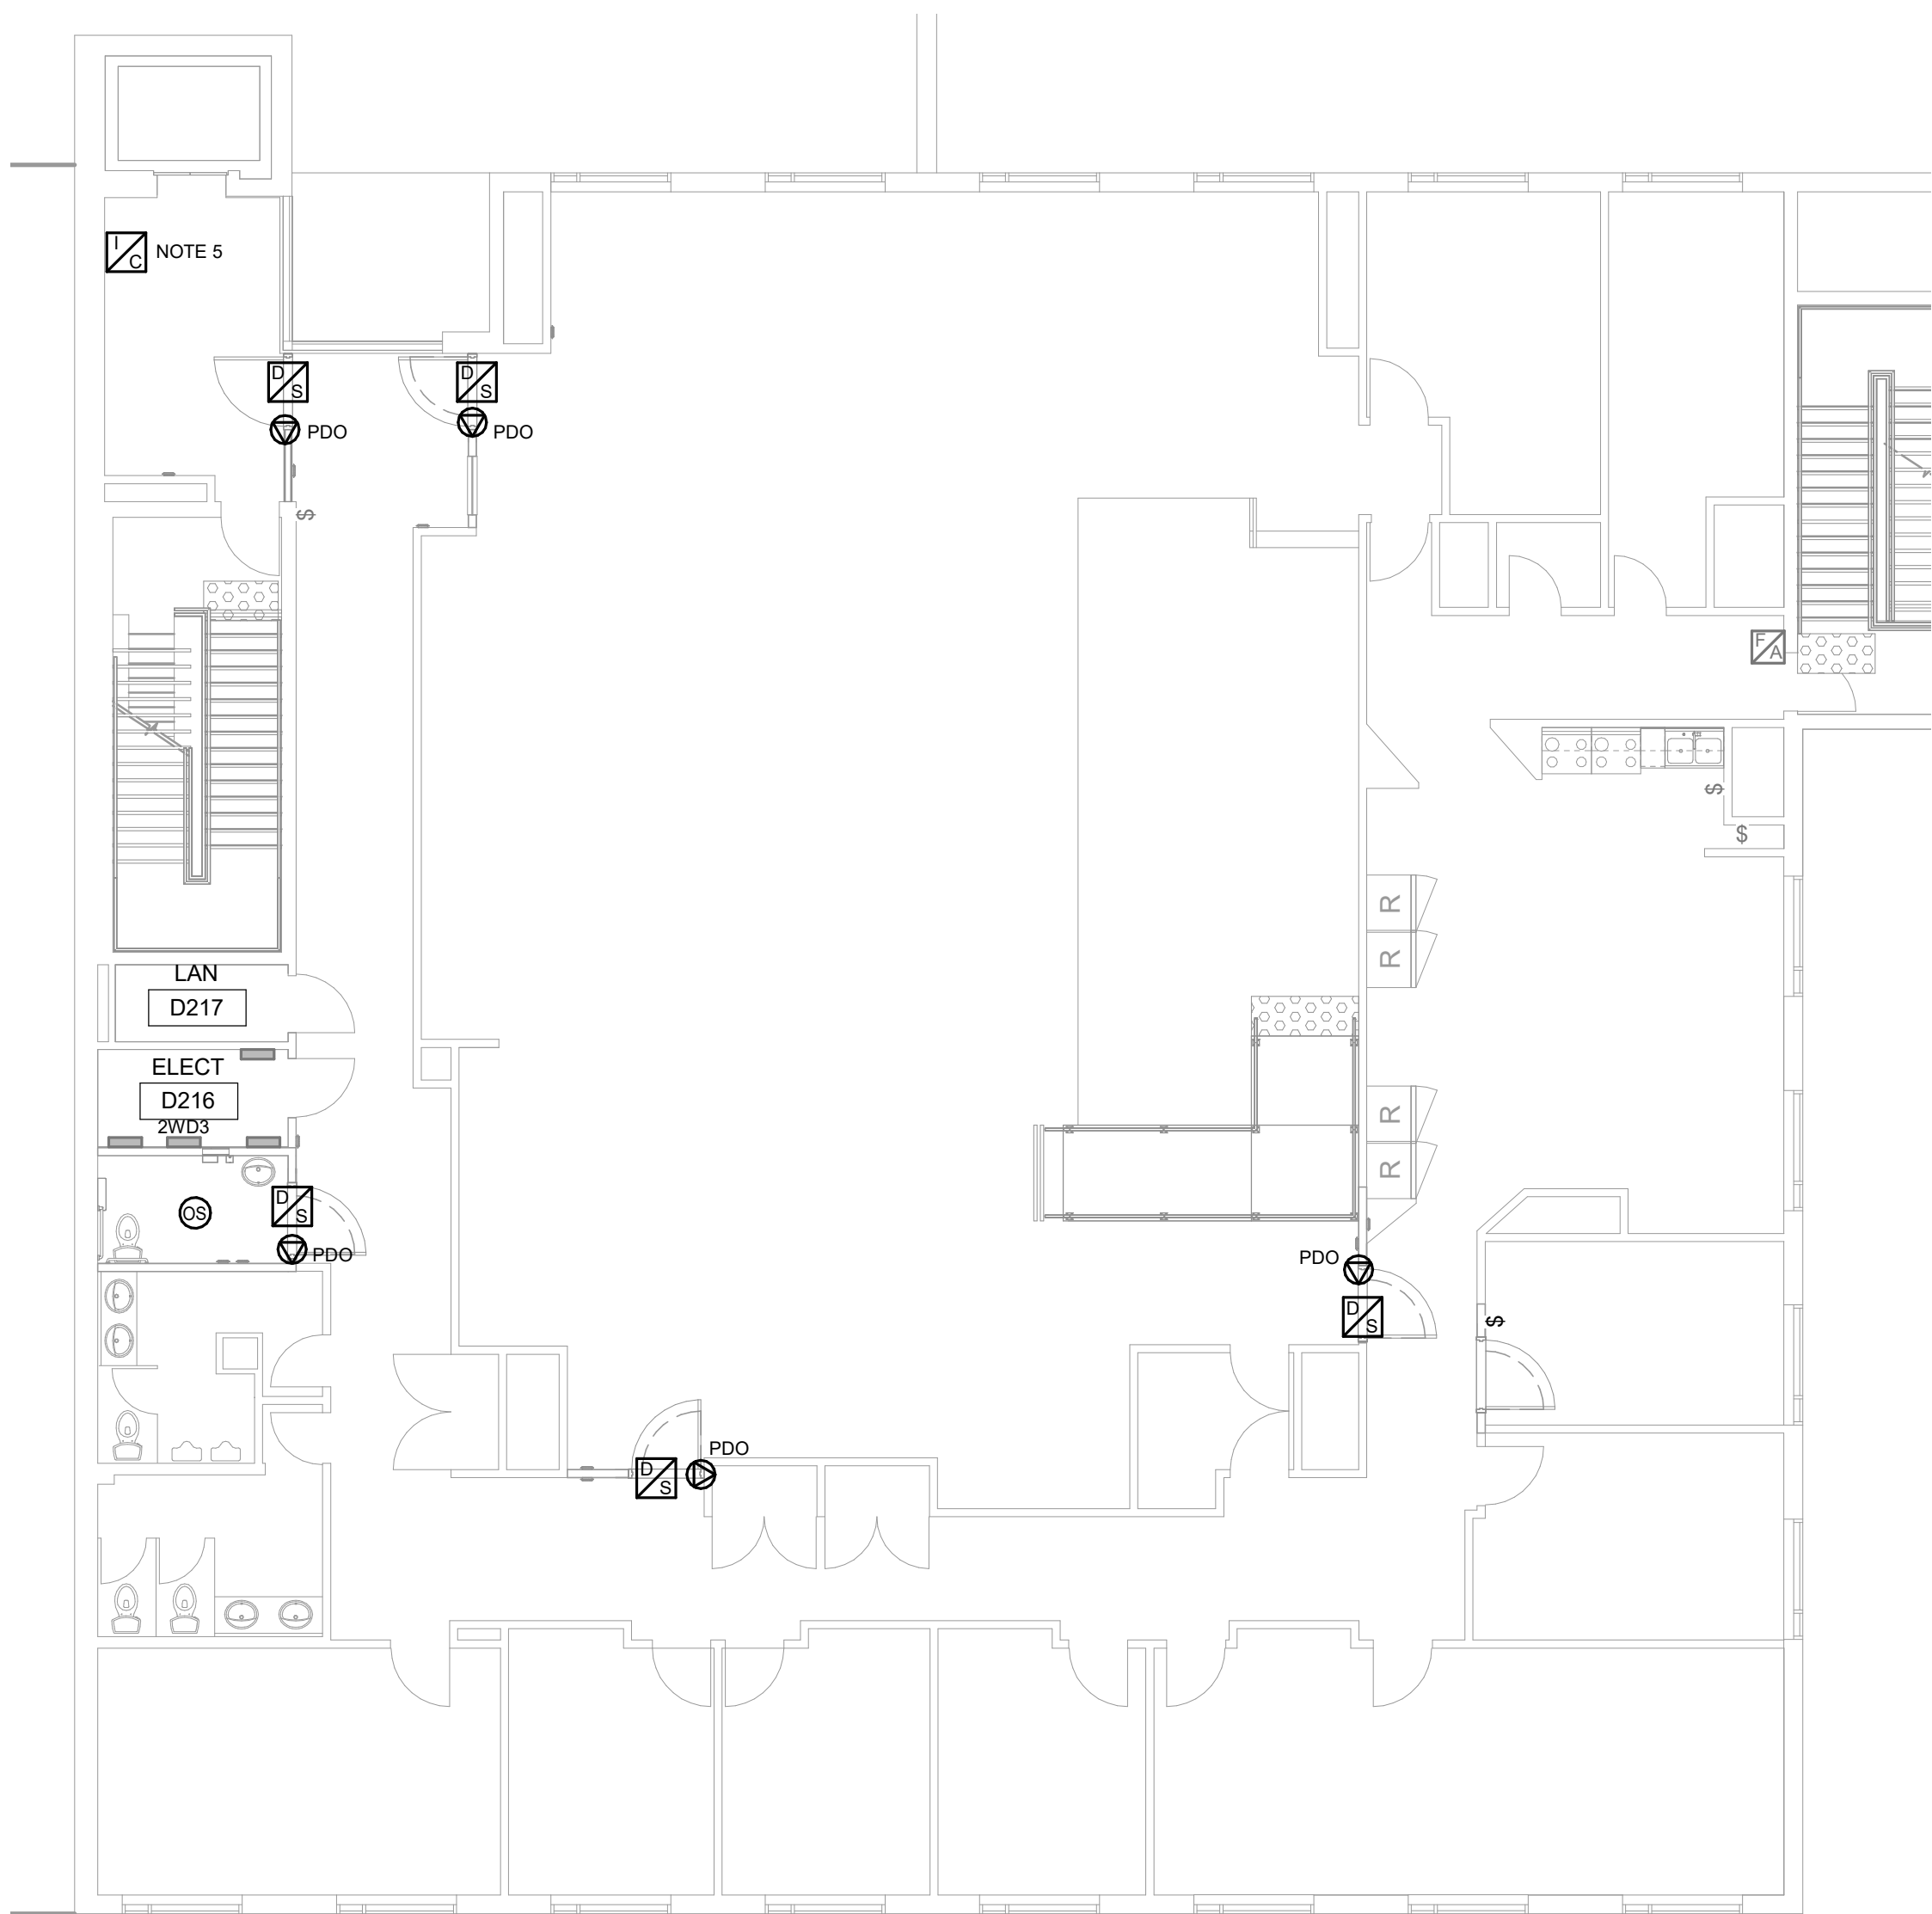1. PROVIDE POWER DOOR OPERATOR CIRCUIT CONNECTION AS INDICATED. PROVIDE CONDUIT/WIRE TO PUSH BUTTON DEVICES FROM DOOR OPERATOR. SEE ARCHITECTURAL PROPOSED PLAN FOR LOCATION OF PUSH BUTTON/WAVE TO OPEN DEVICES.
2. PROVIDE DOOR SECURITY DEVICES AS INDICATED. PROVIDE CONDUIT/WIRING TO ACCESS CONTROL/SECURITY DEVICES AS SHOWN. FOR DRYWALL AREAS CONCEAL CONDUIT AND BOXES. FOR BLOCK WALL AREAS SURFACE MOUNT CONDUIT AND PAINT CONDUIT/BOX SAME COLOUR TONE AS WALL BEHIND IT.
3. ADJUST FIRE ALARM PULL STATION HEIGHT TO COMPLIANT HEIGHT (AS LISTED IN THE MOUNTING HEIGHTS SCHEDULE) FOR ALL PULL STATIONS SHOWN.
4. PROVIDE NEW LIGHTING SWITCHES AT LOCATIONS INDICATED TO REPLACE DEMOLISHED IN SAME AREA. RE-CONNECT EXISTING LIGHTING CIRCUITS TO NEW SWITCHES.
5. PROVIDE INTERCOM TERMINAL UNIT FOR PROTECT IN PLACE AREA. RUN CATEGORY 6 CABLE TO FIRST FLOOR ELECTRICAL ROOM VIA 2ND FLOOR LAN ROOM D217 AND DROP TO FIRST FLOOR.



2 POWER & SYSTEMS ENLARGED PLAN EAST OFFICES
E2111 / Scale: 1 : 100

NOTES:

1. PROVIDE POWER DOOR OPERATOR CIRCUIT CONNECTION AS INDICATED. PROVIDE CONDUIT/WIRE TO PUSH BUTTON DEVICES FROM DOOR OPERATOR. SEE ARCHITECTURAL PROPOSED PLAN FOR LOCATION OF PUSH BUTTON/WAVE TO OPEN DEVICES.
2. PROVIDE DOOR SECURITY DEVICES AS INDICATED. PROVIDE CONDUIT/WIRING TO ACCESS CONTROL/SECURITY DEVICES AS SHOWN. FOR DRYWALL AREAS CONCEAL CONDUIT AND BOXES. FOR BLOCK WALL AREAS SURFACE MOUNT CONDUIT AND PAINT CONDUIT/BOX SAME COLOUR TONE AS WALL BEHIND IT.
3. ADJUST FIRE ALARM PULL STATION HEIGHT TO COMPLIANT HEIGHT (AS LISTED IN THE MOUNTING HEIGHTS SCHEDULE) FOR ALL PULL STATIONS SHOWN.
4. PROVIDE NEW LIGHTING SWITCHES AT LOCATIONS INDICATED TO REPLACE DEMOLISHED IN SAME AREA. RE-CONNECT EXISTING LIGHTING CIRCUITS TO NEW SWITCHES.
5. PROVIDE INTERCOM TERMINAL UNIT FOR PROTECT IN PLACE AREA. RUN CATEGORY 6 CABLE DOWN TO FIRST FLOOR ELECTRICAL ROOM PATCH PANEL.

Scale 1:100
0 2.5 5 10 m

CLIENT
CITY OF TORONTO
Corporate Real Estate Management
Project Management Office
Metro Hall Toronto, ON
MSV 3C6


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ISSUES		
No.	DESCRIPTION	DATE
0	ISSUED FOR CONSTRUCTION	2021-10-19

CONSULTANTS

SEAL



PRIME CONSULTANT
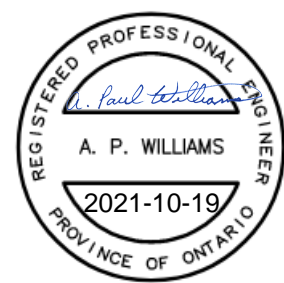
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PROJECT TITLE
**CITY OF TORONTO
ACCESSIBILITY UPGRADES**

PROJECT ADDRESS
**Fire/EMS HQ & EMS Station
53
4330 Dufferin St**

PROJECT NO:
9119- 19- 0162 / IBI 122260

DRAWN BY: Author	CHECKED BY: Checker
PROJECT MGR: F.BOLOURIAN	APPROVED BY: Approver

SHEET TITLE
**POWER & SYSTEMS 3RD
FLOOR PARTIAL PLANS**

SHEET NUMBER G08-229-E2111	ISSUE 0
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