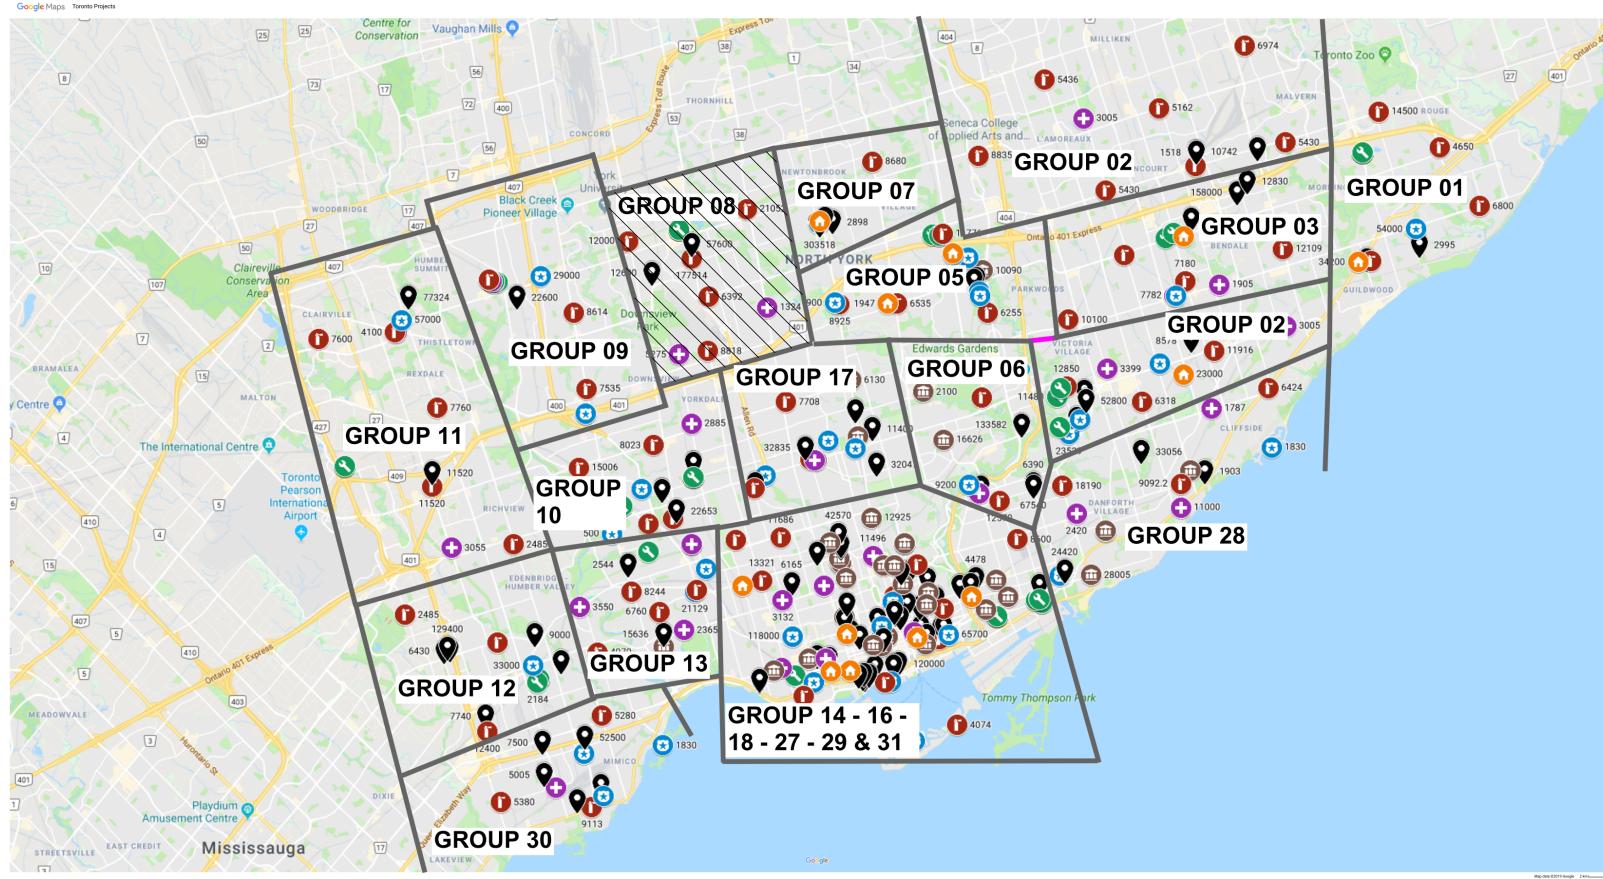
CITY OF TORONTO ACCESSIBILITY UPGRADES TYPICAL DETAILS BOOKLET 9119-19-0162 / IBI 122260



| COVER PAGE GROUP 08 | |
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| SHEET | SHEET # |
| COVER PAGE, GENERAL DRAWING LIST, I | G08-GAL-G0001 |

| GENERAL LAYOUTS GROU | | | | | | |
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| SHE | SHEET # | | | | | |
| ARCHITECTURAL GENERAL NOTES, ABE | G08-GAL-G1001 | | | | | |
| WALL TYPES | G08-GAL-G1002 | | | | | |
| DOOR TYPES | G08-GAL-G1003 | | | | | |
| STRUCTURAL GENERAL NOTES | G08-GAL-G2001 | | | | | |
| ABBREVIATIONS & SYMBOLES | G08-GAL-G2002 | | | | | |
| MECHANICAL LEGEND SHEET 1 OF 2 | G08-GAL-G3001 | | | | | |
| MECHANICAL LEGEND SHEET 2 OF 2 | G08-GAL-G3002 | | | | | |
| ELECTRICAL LEGEND SHEET 1 OF 2 | G08-GAL-G4001 | | | | | |
| ELECTRICAL LEGEND SHEET 2 OF 2 | G08-GAL-G4002 | | | | | |
| ELECTRICAL GENERAL NOTES | G08-GAL-G4003 | | | | | |
| | | | | | | |

GROUP 08 BUILDING INDEX

| Serial # | Building Address | Building Description |
|----------|-------------------------|-----------------------------------|
| 10 | 1009 SHEPPARD AVE. WEST | FIRE HALL NO. 143 |
| 11 | 1026 FINCH AVE. WEST | FINCH YARD - BUILDING B |
| 13 | 1026 FINCH AVE. WEST | FINCH YARD - BUILDING D |
| 36 | 1300 SHEPPARD AVE. WEST | TORONTO ANIMAL SERVICES |
| 110 | 20 BEFFORT ROAD | FIRE HALL NO. 145 |
| 217 | 4100 KEELE STREET | FIRE HALL NO. 141 |
| 229 | 4330 DUFFERIN STREET | FIRE/EMS HQ & EMS STATION 53 |
| 265 | 5700 BATHURST STREET | FIRE STATION 112 & EMS STATION 16 |

TOUCH AND FEEL BOOKLET

TYPICAL DETAILS BOOKLET

IMAGE SOURCES: GOOGLE MAPS

ISSUED FOR CONSTRUCTION

| SKOUP 08 |
|--------------------------|
| SHEET TITLE |
| /ING LIST, BUILDING LIST |
| |
| |
| |
| TS GROUP 08 |
| SHEET TITLE |

BREVIATIONS & REFERENCE SYMBOLS

Building Description

CITY OF TORONTO



55 John ST. TORONTO, ON M5V 3C6

ISSUES No. DESCRIPTION 00 ISSUED FOR CONSTRUCTION

DATE 2021-10-19

ibigroup.com PROJECT NO: 9119- 19- 0162 / IBI 122260 DATE: 2021-10-19 ISSUE SHEET NUMBER

G08-GAL-G1001

175 Galaxy Blvd, Unit 100 tel 416 596 1930 fax 416 596 0644

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IBI GROUP

ABBREVIATIONS

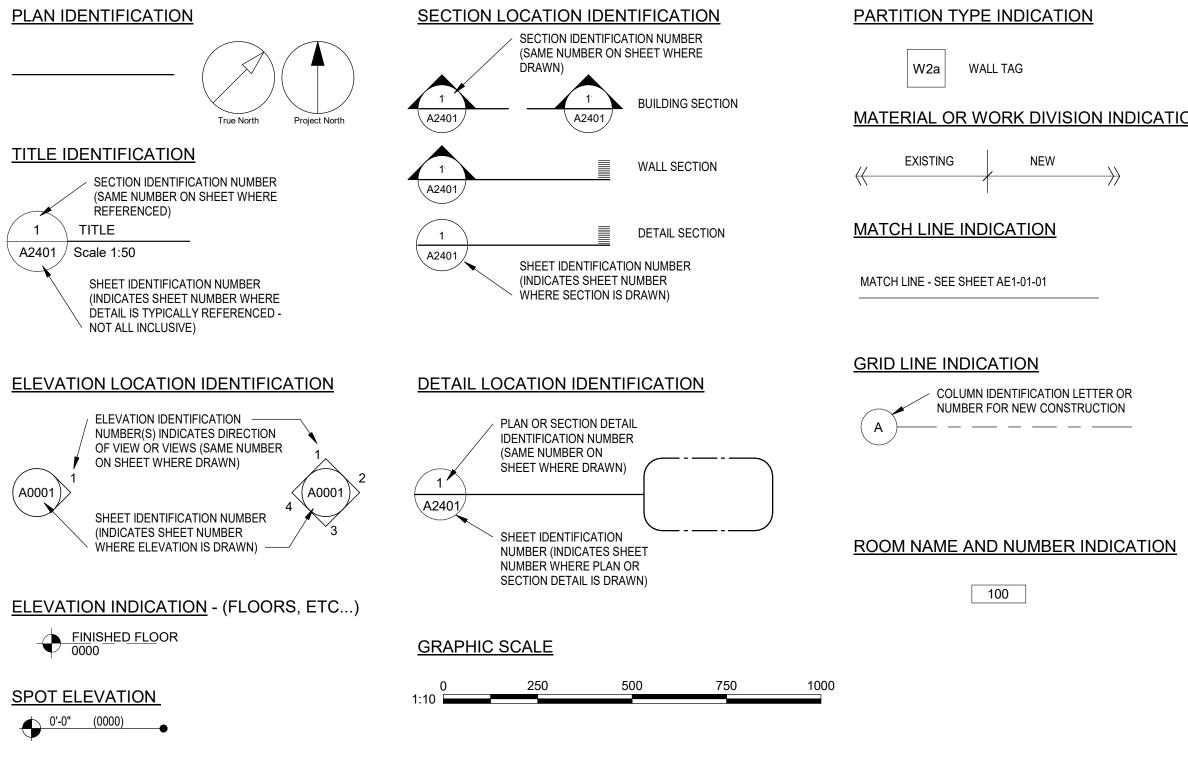
| @ | AT |
|---|--|
| А | ANGLE |
| A/C | AIR CONDITIONER / CONDITIONING |
| ABV | ABOVE |
| | ACCESSORIES |
| | ACCESS DOOR |
| | ACCESS FLOOR |
| ACST / ACOUS | ACOUSTICAL |
| ACCOUR | ACOUSTICAL CEILING TILE |
| AD | AREA DRAIN |
| = | ADDITIONAL |
| | ADDENDUM |
| ADJ | ADJUSTABLE / ADJACENT |
| = . | ADMINISTRATION |
| AFC | ABOVE FINISHED COUNTER |
| AFF | ABOVE FINISHED FLOOR |
| AFG | ABOVE FINISHED GRADE |
| AFS | ABOVE FINISHED SLAB |
| AGGR | AGGREGATE |
| AHR | ANCHOR |
| AHU | AIR HANDLING UNIT |
| AL / | ALUMINUM |
| ALUM | |
| | ALIGNMENT |
| | ALTERNATE |
| ANOD | ANODIZED |
| ANUN | ASSISTANCE REQUIRED |
| AP | ACCESS PANEL |
| APC | ACOUSTICAL PANEL CEILING |
| APPROX | APPROXIMATELY |
| | APPROVED |
| AR-LED | DOOR LOCK INDICATOR |
| ARCH | ARCHITECT(URAL) |
| ASPH | ASPHALT |
| ASTM | AMERICAN SOCIETY FOR TESTING |
| | MATERIALS |
| AUTO | AUTOMATIC |
| AVG | AVERAGE |
| | |
| BD | BOARD |
| BET | BETWEEN |
| BFACT | BARRIER FREE ADULT CHANGE TABLE |
| | |
| BFAO BFPB | BARRIE FREE AUTOMATIC OPENER BARRIER FREE PUSH BUTTON |
| | BARRIER FREE WAVE TO OPEN |
| BG | BUMPER GUARD |
| BITUM | BITUMINOUS |
| BL | BLACK |
| BLDG | BUILDING |
| BLK | BLOCK |
| BLKG | BLOCKING |
| BM | BEAM |
| BOS | BOTTOM OF STEEL |
| DOT | BOTTOM |
| ROT | |
| BOT BR | |
| BOT BR BS | BACKREST BOTH SIDES |
| BR | BACKREST |
| BR | BACKREST |
| BR BS | BACKREST BOTH SIDES |
| BR BS CAB | BACKREST BOTH SIDES CABINET |
| BR BS CAB CAS | BACKREST BOTH SIDES CABINET CASEWORK |
| BR BS CAB CAS CB | BACKREST BOTH SIDES CABINET CASEWORK CATCH BASIN |
| BR BS CAB CAS CB CEM CER CF | BACKREST BOTH SIDES CABINET CASEWORK CATCH BASIN CEMENT CERAMIC CUBIC FOOT |
| BR BS CAB CAS CB CEM CER CF CG | BACKREST BOTH SIDES CABINET CASEWORK CATCH BASIN CEMENT CERAMIC CUBIC FOOT CORNER GUARD |
| BR BS CAB CAS CB CEM CER CF CG CH | BACKREST BOTH SIDES CABINET CASEWORK CATCH BASIN CEMENT CERAMIC CUBIC FOOT CORNER GUARD CEILING HEIGHT |
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| BR BS CAB CAS CB CEM CER CF CG CH CHAM CHBD CI CI CI CI CI CI CI CI CI CI CI CI CI | BACKREST BOTH SIDES CABINET CASEWORK CATCH BASIN CEMENT CERAMIC CUBIC FOOT CORNER GUARD CEILING HEIGHT CHAMFER CHALKBOARD CAST IRON CONTRACTOR INSTALLED CAST IN PLACE CONTROL JOINT CENTRE LINE CEILING CLOSET CLEAR CONCRETE MASONRY UNIT CLEAN/CLEAR OUT COLUMN CONCRETE CONSTRUCTION CONCRETE CONSTRUCTION CONCRETE PAVER CONCRETE PAVER COPPER CARPET(ED)(ING) CERAMIC TILE COAT HOOK COUNTER DOUBLE DEGREE DEMOLISH DEPRESSION DETAIL DRINKING FOUNTAIN DIAMETER DIAGONAL DIMENSION DOWN DOOR DOWNSPOUT |
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| BR BS CAB CAS CB CEM CER CF CG CH CHAM CHBD CI CI CI CI CI CI CI CI CLG CLG CLG CLG CLG CLG CLG CLG CLG CLG | BACKREST BOTH SIDES CABINET CASEWORK CATCH BASIN CEMENT CERAMIC CUBIC FOOT CORNER GUARD CEILING HEIGHT CHAMFER CHALKBOARD CAST IRON CONTRACTOR INSTALLED CAST IN PLACE CONTROL JOINT CENTRE LINE CEILING CLOSET CLEAR CONCRETE MASONRY UNIT CLEAN/CLEAR OUT COLUMN CONCRETE CONSTRUCTION CONTINUOUS CORRIDOR CONCRETE PAVER COPPER CARPET(ED)(ING) CERAMIC TILE COAT HOOK COUNTER DOUBLE DEGREE DEMOLISH DEPRESSION DETAIL DINKING FOUNTAIN DIAMETER DIAGONAL DIMENSION DISPENSER DIVISION DOWN DOOR DOWNSPOUT DISHWASHER DRAWING |
| BR BS CAB CAS CB CEM CER CF CG CH CHAM CHBD CI CI CI CI CI CI CI CI CI CI CI CI CI | BACKREST BOTH SIDES CABINET CASEWORK CATCH BASIN CEMENT CERAMIC CUBIC FOOT CORNER GUARD CEILING HEIGHT CHAMFER CHALKBOARD CAST IRON CONTRACTOR INSTALLED CAST IN PLACE CONTROL JOINT CENTRE LINE CEILING CLOSET CLEAR CONCRETE MASONRY UNIT CLEAN/CLEAR OUT COLUMN CONCRETE MASONRY UNIT CLEAN/CLEAR OUT COLUMN CONCRETE CONSTRUCTION CONTINUOUS CORRIDOR CONCRETE PAVER COPPER CARPET(ED)(ING) CERAMIC TILE COAT HOOK COUNTER DOUBLE DEGREE DEMOLISH DEPRESSION DETAIL DRINKING FOUNTAIN DIAMETER DIAGONAL DIMENSION DISPENSER DIVISION DOWN DOOR DOWNSPOUT DISHWASHER DRAWING |
| BR BS CAB CAS CB CEM CER CF CG CH CHAM CHBD CI CI CI CI CI CI CI CI CI CI CI CI CI | BACKREST BOTH SIDES CABINET CASEWORK CATCH BASIN CEMENT CERAMIC CUBIC FOOT CORNER GUARD CEILING HEIGHT CHAMFER CHALKBOARD CAST IRON CONTRACTOR INSTALLED CAST IN PLACE CONTROL JOINT CENTRE LINE CEILING CLOSET CLEAR CONCRETE MASONRY UNIT CLEAN/CLEAR OUT COLUMN CONCRETE MASONRY UNIT CLEAN/CLEAR OUT COLUMN CONCRETE CONSTRUCTION CONTINUOUS CORRIDOR CONCRETE PAVER COPPER CARPET(ED)(ING) CERAMIC TILE COAT HOOK COUNTER DOUBLE DEGREE DEMOLISH DEPRESSION DETAIL DRINKING FOUNTAIN DIAMETER DIAGONAL DIMENSION DISPENSER DIVISION DOWN DOOR DOWNSPOUT DISHWASHER DRAWING |
| BR BS CAB CAS CB CEM CER CF CG CH CHAM CHBD CI CI CI CI CI CI CI CI CI CI CI CI CI | BACKREST BOTH SIDES CABINET CASEWORK CATCH BASIN CEMENT CERAMIC CUBIC FOOT CORNER GUARD CEILING HEIGHT CHAMFER CHALKBOARD CAST IRON CONTRACTOR INSTALLED CAST IN PLACE CONTROL JOINT CENTRE LINE CEILING CLOSET CLEAR CONCRETE MASONRY UNIT CLEAN/CLEAR OUT COLUMN CONCRETE CONSTRUCTION CONTINUOUS CORRIDOR CONCRETE PAVER COPPER CARPET(ED)(ING) CERAMIC TILE COAT HOOK COUNTER DOUBLE DEGREE DEMOLISH DEPRESSION DETAIL DRINKING FOUNTAIN DIAMETER DIAGONAL DIMENSION DISPENSER DIVISION DOWN DOOR DOWNSPOUT DISHWASHER DRAWING |
| BR BS CAB CAS CB CEM CER CF CG CH CHAM CHBD CI CI CI CI CI CI CI CI CI CI CI CI CI | BACKREST BOTH SIDES CABINET CASEWORK CATCH BASIN CEMENT CERAMIC CUBIC FOOT CORNER GUARD CEILING HEIGHT CHAMFER CHALKBOARD CAST IRON CONTRACTOR INSTALLED CAST IN PLACE CONTROL JOINT CENTRE LINE CEILING CLOSET CLEAR CONCRETE MASONRY UNIT CLEAN/CLEAR OUT COLUMN CONCRETE MASONRY UNIT CLEAN/CLEAR OUT COLUMN CONCRETE CONSTRUCTION CONTINUOUS CORRIDOR CONCRETE PAVER COPPER CARPET(ED)(ING) CERAMIC TILE COAT HOOK COUNTER DOUBLE DEGREE DEMOLISH DEPRESSION DETAIL DRINKING FOUNTAIN DIAMETER DIAGONAL DIMENSION DISPENSER DIVISION DOWN DOOR DOWNSPOUT DISHWASHER DRAWING |

| EMER EMF ENCL ENG EOD EOS EQ EQPT EST EWC EXIST EXP | ENCLOSED / ENCLOSURE ENGINEER EDGE OF DECK EDGE OF SLAB EQUAL(LY) |
|---|--|
| FE FEC FEC (R) | FIRE EXTINGUISHER FIRE EXTINGUISHER CABINET |
| FURR FUT GA GALV GB GBFD GC GL GND GR GRB GRV GT GWG GYP | FURRING FUTURE GAUGE GALVANIZE(D) GYPSUM BOARD GRAB BAR FOLD DOWN GENERAL CONTRACTOR GLASS / GLAZING GROUND GRADE GRAB BAR GRAVEL GLASS TILE GEORGIAN WIRED GLASS GYPSUM |
| HB HC HD HDR HDWR HI HM HMI HMI HMI HNDR HOR / HORIZ HP HR HT HVAC HW HYD | |
| IALUM ID IHM INCL INSUL INT ITGL JAN | INSIDE DIAMETER INSULATED HOLLOW METAL PANEL INCH / INCHES INCLUDE(D) / INCLUDING INSULATE / INSULATION INTERIOR INSULATED TEMPERED GLASS |
| JT | JOINT |
| KIT LAB LAV LB(S) LF LH LIB LKR LNS LNT LP LT LVR LVR LWT | KITCHEN LABORATORY LAMINATE(D) LAVATORY POUND(S) LINEAR FOOT (FEET) LEFT HAND LIBRARY LOCKER LINOLEUM SHEET LINOLEUM TILE LOW POINT LIGHT LOUVRE LIGHT WEIGHT |

| AAT AATL AAX AC AE AECH AEZZ AFR AIN AIR AIN AIR AIN AIN AIR AID A AID A ATL ATL AUL | MACHINE MAINTENANCE ANTI-FATIGUE MATTING MATERIAL MAXIMUM MEDICINE CABINET MECHANICAL EQUIPMENT MECHANICAL EQUIPMENT MECHANICAL MEZZANINE MANUFACTURE(R) MANHOLE MINIMUM MIRROR MISCELLANEOUS MOULDING MASONRY OPENING MOISTURE RESISTANT MOUNTED METAL MULLION MICROWAVE |
|--|--|
| I IA OR | NORTH NOT AVAILABLE / APPLICABLE |
| | NATIONAL FIRE PROTECTION ASSOCIATION NOT IN CONTRACT NUMBER NOMINAL NOT TO SCALE |
| DA DBS DC DCI DD DFF DPG / DPNG DPP | OVERALL OBSCURE ON CENTRE OCCUPIED INDICATOR OUTSIDE DIAMETER OFFICE OPENING |
|)PP)Z | OPPOSITE OUNCE |
| PED PER PERF PERP PF PF PF PL PLAM PLAS PLAM PLAS PLAM PLAS PLAM PLAS PLAM PLAS PLAM PLAS PLAM PLAS PLAM PLAS PLAS PLAS PLAS PLAS PLAS PLAS PLAS | PARTIAL PATTERN PORCELAIN BASE PARTICLE BOARD PRECAST CONCRETE PEDESTAL/PEDESTRIAN PERIMETER PERFORATED PERFORATED PERFORATED PORCELAINE FLOOR TILE POURED-IN-PLACE PLATE PLASTIC LAMINATE PLASTER PLYWOOD PAIR PRE-CAST PREFABRICATED PROPERTY |
| PTDF PTLB PTN PTOB PTR | PORCELAIN TILE POUNDS PER SQUARE FOOT POUNDS PER SQUARE INCH PAINT PAPER TOWEL DISPENSER PAPER TOWEL DISPENSER & WASTE RECEPTACLE PRESSURE TREATED DOUGLAS FIR PUSH TO LOCK BUTTON PARTITION PUSH TO OPEN BUTTON PAPER TOWEL RECEPTACLE POLYVINYL CHLORIDE |
| | QUARTZ QUANTITY |
| A AD AB ACP AD AEF AEF AEF AEF AESIL AESS AEST AEV AFL AM AO AS AST AST AST AST AST AST AST AST AST | RISER RADIUS RUBBER BASE REFLECTED CEILING PLAN ROOF DRAIN REFERENCE REFRIGERATOR REGISTER REINFORCE(D) REQUIRED RESILIENT SHEET RESILIENT SHEET RESILIENT TILE RETAINING REVISE / REVISION REFLECTED RIGHT HAND ROUGH OPENING RUBBER SHEET FLOORING RUBBER STAIR TREADS RUBBER STAIR TREADS RUBBER STAIR TREADS RUBBER TILE RUBBER WALL BASE REDWOOD RAIN WATER LEADER |
| SCD SCHED SCN | SOUTH SOLID CORE SEAT COVER DISPENSER SCHEDULE SCREEN STAINED CONCRETE |

| SD | SOAP DISPENSER / STORM DRAIN |
|------------------------------------|---|
| SDCONC | SEALED CONCRETE |
| SECT | SECTION |
| SF | SQUARE FEET |
| SHLF | SHELF |
| SHT | SHEET |
| SHTG | SHEATHING |
| SHWC | SHOWER CURTAIN AND ROD |
| SHWR | SHOWER |
| SHWS | SHOWER SEAT |
| SIM | SIMILAR |
| SND | SANITARY NAPKIN DISPENSER |
| SNR | SANITARY NAPKIN RECEPTACLE |
| SOG | SLAB ON GRADE |
| SPD | SOAP DISPENSER WITH |
| SPEC SPK SQ | COLLECTOR SPECIFY / SPECIFICATION SPEAKER SQUARE |
| SQFT | SQUARE FEET |
| SQIN | SQUARE INCH(ES) |
| SS | STAINLESS STEEL |
| ST | STONE |
| STA | STATION |
| STC | SOUND TRANSMISSION CLASS |
| STD | STANDARD |
| STDS | STUDS |
| STIFF | STIFFENER |
| STL | STEEL |
| STN | STAINED |
| STOR | STORAGE |
| SV SW | STRUCTURE / STRUCTURAL STOVE SWITCH SYMMETRICAL |
| SYN | SYNTHETIC |
| SYS | SYSTEM |
| T&B | TOP AND BOTTOM |
| T&G | TONGUE AND GROOVE |
| TB | TOWEL BAR |
| TBD | TO BE DETERMINED |
| TC | TOP OF CURB |
| TEMP TER TGL | TELEPHONE TEMPORARY / TEMPERATURE TERRAZZO TEMPERED GLASS |
| THK | THICK |
| THRU | THROUGH |
| TOC | TOP OF CONCRETE |
| TOS | TOP OF STEEL |
| TOW | TOP OF WALL |
| TPD | TOILET PAPER DISPENSER |
| TPTN | TOILET PARTITION |
| TV | TELEVISION |
| TYP | TYPICAL |
| UC | UNDERCUT |
| UG | UNDERGROUND |
| UL | UNDERWRITER'S LABORATORY |
| UNF / UNFIN UNO UPS UR | UNFINISHED UNLESS NOTED OTHERWISE UNINTERRUPTIBLE POWER SUPPLY URINAL |
| V | VOLT |
| VAC | VACUUM |
| VB | VAPOR BARRIER |
| VCT VENT VERT | VINYL COMPOSITION TILE VENTILATE VERTICAL VESTIBULE VERIFY IN FIELD |
| | VENIFT IN FIELD VENEER VINYL STAIR TREADS VINTYL STAIR TREADS & RISERS VENT THRU ROOF VINYL WALLCOVERING |
| W | WEST |
| W/ | WITH |
| W/O | WITHOUT |
| WC | WATER CLOSET |
| WCV | WALLCOVERING |
| WD | WOOD |
| WF | WIDE FLANGE |
| WH | WALL HOSE / HYDRANT |
| WI | WROUGHT IRON |
| WIN WK WNSCT | WROUGHT IRON WINDOW WORK WAINSCOT WATERPROOF(ING) |
| WP WPT WR WRR | WORK POINT WASHROOM WOOD RISER |

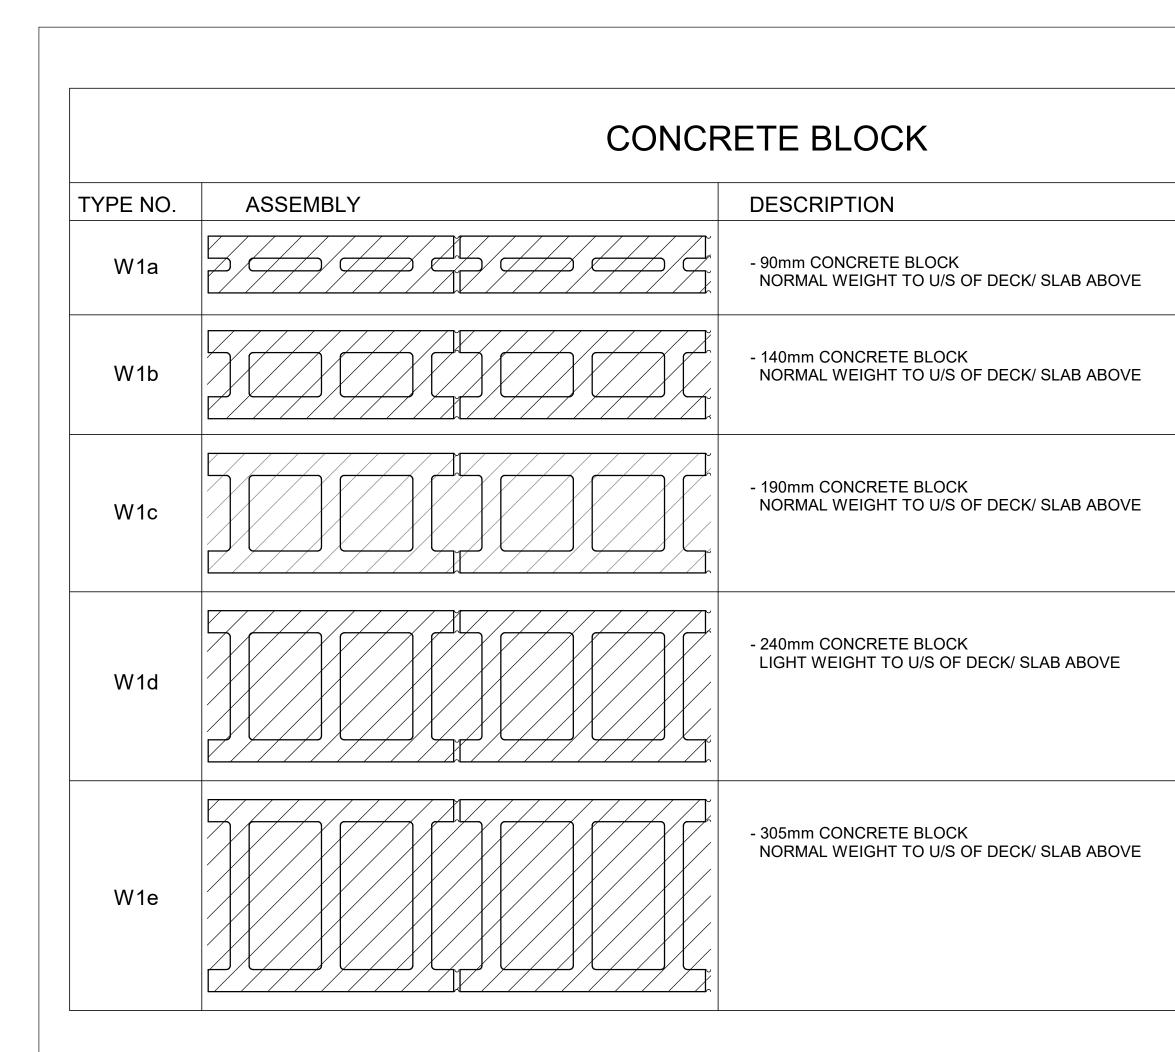
REFERENCE SYMBOLS



GENERAL NOTES

- 1. PERFORM THE WORK IN ACCORDANCE WITH THE LATEST EDITION OF THE ONTARIO BUILDING CODE, CITY OF TORONTO ACCESSIBILITY DESIGN GUIDELINES AND ANY OTHER
- 2. DRAWINGS ARE TO BE READ IN CONJUNCTION WITH THE SPECIFICATIONS AND THE ASSOCIATED STRUCTURAL, MECHANICAL, ELECTRICAL DRAWINGS AND ALL OTHER RELEV
- 3. CONTRACTOR SHALL VERIFY THE SITE INFORMATION PRIOR TO PROCEEDING WITH THE WORK. FAILURE TO REPORT ANY DISCREPANCIES SHALL CONSTITUTE ACCEPTANCE
- 4. THE CONTRACTOR SHALL REVIEW THE DRAWINGS FOR SCOPE OF DEMOLITION AND NEW WORK, INCLUDING ALL DISCIPLINES, AND SHALL COORDINATE WITH NEW WORK DRA
- 5. SCOPE OF WORK SHALL NOT BE LIMITED TO THAT SHOWN ON THE DRAWINGS AND SHALL INCLUDE WORK REQUIRED TO ELIMINATE ALL EXISTING, ABANDONED OR REDUNDA
- 6. PROVIDE 16 GA SHEET METAL REINFORCEMENT INSTALLED ON THE STUDS PRIOR TO INSTALLING THE GYPSUM BOARD IN THE LOCATIONS REQUIRED TO SUPPORT WALL MOU 7. ISOLATE ALL MECHANICAL PIPES DUCTS AND EQUIPMENT FROM INTERIOR PARTITIONS TO AVOID ACOUSTIC NOISE TRANSFER.
- 8. MAINTAIN CONTINUITY OF BUILDING ENVELOPE AIR / VAPOUR BARRIER TRANSITIONS AND PENETRATIONS WITH MEMBRANES LAPPED AND APPROVED SEALANTS COMPATIBLE 9. REINSTATE INTEGRITY OF FIRE SEPARATION WHEN PATCHING. PROVIDE AND INSTALL FIRE STOPPING AND SMOKE SEALS AT ALL NEW SERVICE PENETRATIONS THROUGH FLO REFER TO MECHANICAL DRAWINGS FOR ANY FIRE DAMPER REQUIREMENTS.
- 10. ENSURE THAT FOR ALL FIRE SEPARATIONS INDICATED ON THE DRAWINGS, ALL COMPONENTS OF THE ASSEMBLY SHALL BE OF APPROVED MATERIALS, AND INSTALLATION/FA LABORATORIES OF CANADA LTD." LATEST EDITION MANUAL AND OTHERWISE MEETING THE REQUIREMENTS OF THE ONTARIO BUILDING CODE. ALL FIRE SEPARATIONS MUST E SEPARATIONS AND PENETRATIONS WITH APPROVED U.L.C. LISTED FIRE STOPPING SYSTEMS AND FIRE SEALANTS BOTH SIDES OF PARTITIONS.
- 11. ULC LISTED FIRE-RATED SEALANT IS TO BE APPLIED TO ALL FIRE-RATED PARTITIONS AND LEFT EXPOSED FOR INSPECTION PURPOSES
- 12. WHERE ITEMS NOTED TO BE DEMOLISHED MEET EXISTING WALLS / CEILING AND/OR FLOOR TO REMAIN, PATCH REPAIR AND MAKE GOOD EXISTING SURFACES. PROVIDE NEW 13. PROVIDE CUTTING, PATCHING AND CORING OF ALL WALLS, CEILING, ROOF AND OTHER SURFACES AS REQUIRED TO PERFORM THE WORK. PRIOR TO CUTTING OR CORING, SC
- REINFORCING, CONDUITS, WIRING AND OTHER HIDDEN ITEMS. OBTAIN WRITTEN VERIFICATION OF PROPOSED DRILLING AND CUTTING LOCATIONS FROM THE STRUCTURAL EN 14. BEFORE COMMENCING WORK, ESTABLISH LOCATION AND EXTENT OF EXISTING SERVICE LINES IN AREA OF WORK AND NOTIFY CONSULTANT OF FINDINGS. WHERE UNKNOWN
- 15. PROVIDE FOR DEMOLITION OF INCLUDING BUT NOT LIMITED TO, EXISTING WALLS, FLOORS, CEILINGS, ASSOCIATED FINISHES, MECHANICAL AND ELECTRICAL FIXTURES, DEVIC REMOVAL.
- 16. CONCEAL ALL MECHANICAL AND ELECTRICAL WORK IN WALLS AND CEILINGS, EXCEPT AS INDICATED OTHERWISE OR APPROVED.
- 17. VAPOUR BARRIER TO BE CONTINUOUS UNDER ALL NEW FLOOR SLABS. PATCH ALL CONCRETE CORE TEST AREAS, DEFECTS AND DEMOLITION LOCATIONS.
- 18. ALL SPECIFIED MATERIALS SHALL BE INSTALLED AND FINISHED IN ACCORDANCE WITH MANUFACTURERS WRITTEN INSTRUCTIONS. SHOULD SUCH INSTRUCTIONS DIFFER FRO 19. DETAILS MARKED "TYPICAL" SHALL APPLY IN ALL SIMILAR CONDITIONS UNLESS NOTED OR DETAILED OTHERWISE.
- 20. BRING ALL OMISSIONS AND DISCREPANCIES, INCLUDING DIMENSIONS, TO THE ATTENTION OF THE CONSULTANT PRIOR TO COMMENCEMENT OF ANY WORK.
- 21. FULLY COORDINATE ALL ADDITIONAL SUPPORT REQUIRED FOR ANCHORAGE OF MECHANICAL EQUIPMENT OR DUCTS AND ELECTRICAL FIXTURES/EQUIPMENT. PROVIDE SEISM THE PROVINCE OF ONTARIO.
- 22. WALL ASSEMBLIES SHALL EXTEND TO UNDERSIDE OF ROOF OR STRUCTURE ABOVE UNLESS NOTED OR DETAILED OTHERWISE
- 23. REFER TO ELECTRICAL DRAWINGS FOR LOCATION OF ALL ELECTRICAL EQUIPMENT, CONDUIT, LIGHTING AND RECEPTACLE LOCATIONS.
- 24. REFER TO MECHANICAL DRAWINGS FOR LOCATION OF ALL MECHANICAL EQUIPMENT AND PROVISIONS.
- 25. REFER TO STRUCTURAL DRAWINGS FOR LOCATION AND SIZING OF ALL STRUCTURAL ELEMENTS
- 26. DIMENSIONS ARE SHOWN IN MILLIMETERS UNLESS OTHERWISE NOTED.
- 27. REMOVAL AND DISPOSAL OF HAZARDOUS MATERIALS SHALL BE IN ACCORDANCE WITH LOCAL REGULATIONS AND AUTHORITIES HAVING JURISDICTION.
- 28. UNLESS NOTED OTHERWISE, MAKE GOOD ALL AREAS DISTURBED BY EXCAVATION AND/OR INSTALLATION OF CIVIL, STRUCTURAL, MECHANICAL AND ELECTRICAL SERVICES. 29. PROPER HOARDING TO BE PROVIDED AROUND ALL NEW EXTERIOR WORK LOCATIONS.

| | | | CLIENT CITY OF TORONTO |
|---------------------------|---|----------------------------------|---|
| | | | DA TORONTO |
| | NEW DOOR NUMBER INDICATION | KEYNOTE SYMBOLS | 55 John ST. TORONTO, ON |
| | (100) | 1 DEMOLITION WORK | M5V 3C6 COPYRIGHT |
| <u>NC</u> | WINDOW NUMBER INDICATION | | This drawing has been prepared solely for the intended use, thus any reproduction or distribution for any purpose other than authorized by IBI Group is forbidden. Written dimensions shall have precedence over scaled dimensions. Contractors shall verify and be responsible for all dimensions and conditions on the job, and IBI Group shall be informed of any variations from the dimensions and conditions shown on the drawing. Shop drawings shall be submitted to IBI Group for general |
| | (W101) | | conformance before proceeding with fabrication. IBI Group Professional Services (Canada) Inc. is a member of the IBI Group of companies |
| | LOUVER NUMBER INDICATION | FLOOR FINISH TAG | ISSUESNo.DESCRIPTIONDATE00ISSUED FOR CONSTRUCTION2021-10-19 |
| | CEILING TAG | REVISION INDICATION | |
| | HEIGHT AFF | | |
| | ROOF OR RAMP PITCH INDICATION | | |
| | 6 | | |
| | ROOF OR RAMP SLOPE INDICATION | CAMERA VIEW | |
| | PHOTO NUMBER | | |
| | | | |
| | | | |
| VANT (E OF T AWIN(| ICABLE REQUIREMENT OF AUTHORITIES HAVING JURI CONSULTANT DRAWINGS. HE SITE CONDITIONS. GS FOR EXACT EXTENT OF DEMOLITION. OMPONENTS, AND TO FACILITATE PROPER EXECUTION | | CONSULTANTS |
| E WIT |) ITEMS. H MEMBRANE PRODUCTS USED. | | |
| | , WALLS AND CEILINGS IN ACCORDANCE WITH OBC. L | | |
| BE CC | ONTINUOUS, AND ALL JOINTS TO BE SMOKE TIGHT. MA | INTAIN CONTINUITY OF ALL FIRE | SEAL |
| | L MATERIAL TO MATCH EXISTING AND. MAINTAIN ALL I HE SLAB/WALL/ROOF AND COORDINATE DRILLING/CU EER. | | |
| | VICES ARE ENCOUNTERED, IMMEDIATELY ADVISE AND DUCTS TO ALLOW FOR NEW WORK TO BE INSTALLED. | | |
| ОМ ТН | E SPECIFICATIONS OR DETAILS, ADVISE CONSULTANT | T IMMEDIATELY FOR DIRECTION. | PRIME CONSULTANT IBI GROUP 175 Galaxy Blvd, Unit 100 Toronto, ON M9W 0C9, Canada tel 416 679 1930 fax 416 675 4620 ibigroup.com |
| MIC RI | ESTRAINT DRAWINGS STAMPED BY <u>A THIRD PARTY</u> PF | ROFESSIONAL ENGINEER LICENCED IN | PROJECT TITLE CITY OF TORONTO ACCESSIBILITY UPGRADES |
| | | | PROJECT ADDRESS CITY OF TORONTO ACCESSIBILITY UPGRADES |
| REFE | R TO CIVIL, STRUCTURAL, MECHANICAL, AND ELECTRI | ICAL DRAWINGS. | PROJECT NO: 9119- 19- 0162 / IBI 122260 DRAWN BY: CHECKED BY: A. BOYNARIAN A. VAN VEEN PROJECT MGR: APPROVED BY: F.BOLOURIAN E. FENUTA |
| | | | SHEET TITLE GENERAL NOTES, ABBREVIATIONS & |
| | | | REFERENCE SYMBOLS |
| | | | SHEET NUMBER ISSUE 00 |



WALL TYPE NOTES:

- 1. ACOUSTIC BATT INSULATION TO EXTEND FULL HEIGHT OF WALL ASSEMBLIES UNLESS NOTED OTHERWISE.
- 2. PROVIDE MOISTURE RESISTANT GYPSUM BOARD ON ALL WALLS OF WASHROOMS, KITCHEN AREAS AND BEHIND FOUNTAINS.
- 3. PROVIDE TILE BACKER BOARD BEHIND ALL CERAMIC TILE APPLICATIONS.
- 4. ANY PENETRATIONS THROUGH FIRE RATED WALLS SHOULD BE PROTECTED WITH ULC LISTED FIRE STOPPING.
- 5. AT FIRE RATED WALLS AND SMOKE BARRIERS ABOVE ACCESSIBLE CEILING, PROVIDE IDENTIFICATION SIGNAGE NOT MORE THAN 9 METRE MEASURED HORIZONTALLY, INDICATING "FIRE AND/OR SMOKE BARRIER - PROTECT O PER OBC 3.1.9".
- 6. PROVIDE FIRE BLOCKING IN CONCEALED SPACES OF STUD WALLS AND PARTITIONS VERTICALLY AT THE CEILING LEVELS AND HORIZONTALLY.
- 7. FURRING WALLS AROUND COLUMNS, SHAFTS AND PIPING THAT ARE ALSO DEMISING WALLS BETWEEN ROOMS U/S OF DECK/ SLAB ABOVE AND CARRY ACOUSTIC INSULATION CONTINUITY FROM ADJACENT WALLS.

| | | | | | | | CLIENT |
|-----------------------------|----------|-------------|------------------|--|-----------------------|--------------------|--|
| | | META | LS | TUD - DRYWALL | | | CITY OF TORONTO |
| | TYPE NO. | ASSEMBLY | | DESCRIPTION | FRR | STC | 55 John ST. |
| FRR STC 44 | W2 | | 124 | - 16mm FIRE RATED GYPSUM BOARD - 92mm METAL STUDS @ 400 O.C. - 16mm FIRE RATED GYPSUM BOARD - EXTEND WALL TO U/S OF DECK | 1.0 HR ULC W407 | 38 (OBC S4C) | COPYRIGHT This drawing has been prepared solely for the intended use, thus any reproduction or distribution for any purpose other than authorized by IBI Group is forbidden. Written dimensions shall have precedence over scaled dimensions. Contractors shall verify and be responsible for all dimensions and conditions on the job, and IBI Group shall be informed of any variations from the dimensions and conditions shown on the drawing. Shop drawings shall be submitted to IBI Group for general conformance before proceeding with fabrication. |
| 1.0 HR OBC 46 SB-2 | W2a | | 124 | - 16mm GYPSUM BOARD - 92mm METAL STUDS @ 400 O.C. - 16mm GYPSUM BOARD | | | IBI Group Professional Services (Canada) Inc. is a member of the IBI Group of companies ISSUES DESCRIPTION DATE 00 ISSUED FOR CONSTRUCTION 2021-10-19 |
| 2.0 HR OBC 48 SB-2 | W2b | | 124 | - 16mm FIRE RATED GYPSUM BOARD - 92mm METAL STUDS @ 400 O.C. MAXIMUM - 92mm ACOUSTIC / THERMAL NON COMBUSTIBLE BATT INSULATION - 16mm FIRE RATED GYPSUM BOARD - EXTEND WALL TO U/S OF DECK | 1.0 HR ULC W407 | 45 | |
| | W2c | | 124 | - 16mm GYPSUM BOARD - 92mm METAL STUDS @ 400 O.C. - 92mm ACOUSTIC / THERMAL NON COMBUSTIBLE BATT INSULATION - 16mm GYPSUM BOARD - EXTEND WALL TO U/S OF DECK | | 45 | |
| 49 | W2d | | 156 | - 2 LAYERS OF 16mm FIRE RATED GYPSUM BOARD - 92mm METAL STUDS @ 400 O.C. MAXIMUM - 92mm ACOUSTIC / THERMAL NON COMBUSTIBLE BATT INSULATION - 2 LAYERS OF 16mm FIRE RATED GYPSUM BOARD - EXTEND WALL TO U/S OF DECK | 2.0 HR ULC W414 | 55 | |
| 51 | W2e | | 184 | - 16mm GYPSUM BOARD - 152mm METAL STUDS @ 400 O.C. - 152mm ACOUSTIC / THERMAL NON COMBUSTIBLE BATT INSULATION - 16mm GYPSUM BOARD - EXTEND WALL TO U/S OF DECK | | 51 (OBC S7A) | |
| | W2f | | 184 | - 16mm GYPSUM BOARD - 152mm METAL STUDS @ 400 O.C. - 16mm GYPSUM BOARD | | | CONSULTANTS |
| D DRINKING | W2g | | 140 | - 2 LAYERS OF 16MM GYPSUM BOARD - 92mm METAL STUDS @ 400 O.C. - 92mm ACOUSTIC / THERMAL NON COMBUSTIBLE BATT INSULATION - 16mm GYPSUM BOARD - EXTEND WALL TO U/S OF DECK | | 50 (OBC S5B) | |
| | | FURRING WAL | L T | YPES - INTERNAL | | | SEAL |
| E, SPACED AT OPENINGS AS | TYPE NO. | ASSEMBLY | | DESCRIPTION | FRR | | |
| G AND FLOOR | W3a | | 8 | 38mm FURRING - TO 150mm ABOV FIN. CEILING - 16mm GYPSUM BOARD - 22mm MIN HAT CHANNEL @ 400 O.C. | | | |
| SHALL GO TO | W3b | | * | 80mm FURRING - TO 150mm ABOV FIN. CEILING - 16mm GYPSUM BOARD - 64mm MIN STEEL STUDS @ 400 O.C. | | | |
| | W3c | | | 108mm FURRING - TO 150mm ABOV FIN. CEILING UNLESS OTHERWISE NOTED - 16mm GYPSUM BOARD - 92mm MIN STEEL STUDS @ 400 O.C. | | | IBI 175 Galaxy Blvd, Unit 100 Toronto, ON M9W 0C9, Canada tel 416 679 1930 fax 416 675 4620 ibigroup.com PROJECT TITLE CITY OF TORONTO |
| | W3d | | | 108mm FURRING - TO 150mm ABOV FIN. CEILING UNLESS OTHERWISE NOTED - 16mm GYPSUM BOARD - 92mm MIN STEEL STUDS @ 400 O.C. - 92mm ACOUSTIC NON COMBUSTIBLE BATT INSULATION | | | ACCESSIBILITY UPGRADES PROJECT ADDRESS |
| | | SHAFT WALL | TYF | PES - INTERNAL | | | CITY OF TORONTO ACCESSIBILITY UPGRADES |
| | TYPE NO. | ASSEMBLY | | DESCRIPTION | FRR | STC | PROJECT NO: 9119- 19- 0162 / IBI 122260 DRAWN BY: CHECKED BY: |
| | W4a | 2. | * 2 • | -25.4mm FIRE RATED GYPSUM BOARD -102mm "C-H" SHAPED STUD @600 O.C. - 16mm FIRE RATED GYPSUM BOARD TO U/S OF DECK/ SLAB ABOVE | 1.0 HR ULC W452 | | A. BOYNARIAN A. VAN VEEN PROJECT MGR: APPROVED BY: F.BOLOURIAN E. FENUTA SHEET TITLE WALL TYPES |
| | W4b | | * - - - | -25.4mm FIRE RATED GYPSUM BOARD -102mm "C-H" SHAPED STUD @600 O.C. - 102mm ACOUSTIC / THERMAL NON COMBUSTIBLE BATT INSULATION - 19.1mm FIRE RATED GYPSUM BOARD TO U/S OF DECK/ SLAB ABOVE | 2.0 HR ULC W508 | 52 | SHEET NUMBER ISSUE 00 |

| | METAI | STUD - DR | YWALL | | | |
|----------|--------------|--|--|-----------------------|--------------------|--|
| TYPE NO. | ASSEMBLY | DESCRIPT | ION | FRR | STC | 55 John ST. |
| W2 | | - 92mm METAL S - 16mm FIRE RA | TED GYPSUM BOARD STUDS @ 400 O.C. TED GYPSUM BOARD TO U/S OF DECK | 1.0 HR ULC W407 | 38 (OBC S4C) | COPYRIGHT Tris drawing has been prepared solely for the intended use, thus any reproduction or distribution for any purpose other than authorized by IBI Group is forbidden. Written dimensions shall have precedence over scaled dimensions. Contractors shall verify and be responsible for all dimensions and conditions on the job, and IBI Group shall be informed of any variations from the dimensions and conditions shown on the drawing. Shop drawings shall be submitted to IBI Group for general conformance before proceeding with fabrication. |
| W2a | | - 16mm GYPSUM - 92mm METAL S - 16mm GYPSUM | STUDS @ 400 O.C. | | | IBI Group Professional Services (Canada) Inc. is a member of the IBI Group of companies ISSUES No. DESCRIPTION DATE 00 ISSUED FOR CONSTRUCTION 2021-10-19 |
| W2b | | - 92mm METAL S - 92mm ACOUST - 16mm FIRE RA | TED GYPSUM BOARD STUDS @ 400 O.C. MAXIMUM IC / THERMAL NON COMBUSTIBLE BATT INSULATION TED GYPSUM BOARD TO U/S OF DECK | 1.0 HR ULC W407 | 45 | |
| W2c | | - 92mm ACOUST INSULATION - 16mm GYPSUM | TUDS @ 400 O.C. IC / THERMAL NON COMBUSTIBLE BATT | | 45 | |
| W2d | | - 92mm METAL S - 92mm ACOUST INSULATION - 2 LAYERS OF 1 | 6mm FIRE RATED GYPSUM BOARD TUDS @ 400 O.C. MAXIMUM IC / THERMAL NON COMBUSTIBLE BATT 6mm FIRE RATED GYPSUM BOARD TO U/S OF DECK | 2.0 HR ULC W414 | 55 | |
| W2e | | - 152mm ACOUS INSULATION - 16mm GYPSUM | STUDS @ 400 O.C. TIC / THERMAL NON COMBUSTIBLE BATT | | 51 (OBC S7A) | |
| W2f | | + - 16mm GYPSUM - 152mm METAL - 16mm GYPSUM | STUDS @ 400 O.C. | | | CONSULTANTS |
| W2g | | - 92mm METAL S - 92mm ACOUST - 16mm GYPSUM | 6MM GYPSUM BOARD STUDS @ 400 O.C. IC / THERMAL NON COMBUSTIBLE BATT INSULATION I BOARD TO U/S OF DECK | | 50 (OBC S5B) | |
| | FURRING WAL | . TYPES - II | NTERNAL | | | SEAL |
| TYPE NO. | ASSEMBLY | DESCRIPT | ION | FRR | | |
| W3a | | - 16mm GYPSUM | - TO 150mm ABOV FIN. CEILING I BOARD CHANNEL @ 400 O.C. | | | |
| W3b | | 80mm FURRING - 16mm GYPSUM | - TO 150mm ABOV FIN. CEILING | | | |
| W3c | | OTHERWISE NO - 16mm GYPSUM | | | | IBI 175 Galaxy Blvd, Unit 100 Toronto, ON M9W 0C9, Canada tel 416 679 1930 fax 416 675 4620 ibigroup.com PROJECT TITLE CITY OF TORONTO |
| W3d | ې چ | OTHERWISE NO - 16mm GYPSUM - 92mm MIN STE | | | | ACCESSIBILITY UPGRADES PROJECT ADDRESS |
| | SHAFT WALL 7 | YPES - INT | ERNAL | | | CITY OF TORONTO ACCESSIBILITY UPGRADES |
| TYPE NO. | ASSEMBLY | DESCRIPT | ION | FRR | STC | PROJECT NO: 9119- 19- 0162 / IBI 122260 DRAWN BY: CHECKED BY: |
| W4a | 2000 | -102mm "C-H" SH | ATED GYPSUM BOARD IAPED STUD @600 O.C. TED GYPSUM BOARD X/ SLAB ABOVE | 1.0 HR ULC W452 | | A. BOYNARIAN A. VAN VEEN PROJECT MGR: APPROVED BY: F.BOLOURIAN E. FENUTA SHEET TITLE WALL TYPES |
| W4b | ۲ ۲ ۲ | -102mm "C-H" SH - 102mm ACOUS | ATED GYPSUM BOARD IAPED STUD @600 O.C. TIC / THERMAL NON COMBUSTIBLE BATT INSULATION ATED GYPSUM BOARD {/ SLAB ABOVE | 2.0 HR ULC W508 | 52 | SHEET NUMBER ISSUE 00 |

| TYPE NO. | ASSEMBLY | DESCRIPTION | FRR | STC | 55 John ST. TORONTO, ON |
|-----------------|---|---|-----------------------|---|--|
| W2 | <u>5</u> | - 16mm FIRE RATED GYPSUM BOARD - 92mm METAL STUDS @ 400 O.C. - 16mm FIRE RATED GYPSUM BOARD - EXTEND WALL TO U/S OF DECK | 1.0 HR ULC W407 | 38 (OBC S4C) | M5V 3C6 COPYRIGHT This drawing has been prepared solely for the intended use, thus any reproduction or distribution for any purpose other than authorized by IBI Group is forbidden. Written dimensions shall have precedence over scaled dimensions. Contractors shall verify and be responsible for all dimensions and conditions on the job, and IBI Group shall be informed of any variations from the dimensions and conditions shown on the drawing. Shop drawings shall be submitten to IBI Group for general conformance before proceeding with fabrication. |
| W2a | 12 | | | | IBI Group Professional Services (Canada) Inc. is a member of the IBI Group of companies ISSUES DESCRIPTION DATE 00 ISSUED FOR CONSTRUCTION 2021-10-19 |
| W2b | | - 16mm FIRE RATED GYPSUM BOARD - 92mm METAL STUDS @ 400 O.C. MAXIMUM - 92mm ACOUSTIC / THERMAL NON COMBUSTIBLE BATT INSULATION - 16mm FIRE RATED GYPSUM BOARD - EXTEND WALL TO U/S OF DECK | 1.0 HR ULC W407 | 45 | |
| W2c | t | - 16mm GYPSUM BOARD - 92mm METAL STUDS @ 400 O.C. - 92mm ACOUSTIC / THERMAL NON COMBUSTIBLE BATT INSULATION - 16mm GYPSUM BOARD - EXTEND WALL TO U/S OF DECK | | 45 | |
| W2d | <u>1</u> | - 2 LAYERS OF 16mm FIRE RATED GYPSUM BOARD - 92mm METAL STUDS @ 400 O.C. MAXIMUM - 92mm ACOUSTIC / THERMAL NON COMBUSTIBLE BATT INSULATION - 2 LAYERS OF 16mm FIRE RATED GYPSUM BOARD - EXTEND WALL TO U/S OF DECK | 2.0 HR ULC W414 | 55 | |
| W2e | 10 10 10 10 10 10 10 10 10 10 | - 16mm GYPSUM BOARD - 152mm METAL STUDS @ 400 O.C. - 152mm ACOUSTIC / THERMAL NON COMBUSTIBLE BATT INSULATION - 16mm GYPSUM BOARD - EXTEND WALL TO U/S OF DECK | | 51 (OBC S7A) | |
| W2f | 8.2.2.2.2.2.2.2.2.2.2.2.2.2.2.2.2.2.2.2 | - 16mm GYPSUM BOARD - 152mm METAL STUDS @ 400 O.C. - 16mm GYPSUM BOARD | | | CONSULTANTS |
| W2g | | - 2 LAYERS OF 16MM GYPSUM BOARD - 92mm METAL STUDS @ 400 O.C. - 92mm ACOUSTIC / THERMAL NON COMBUSTIBLE BATT INSULATION - 16mm GYPSUM BOARD - EXTEND WALL TO U/S OF DECK | | 50 (OBC S5B) | |
| | FURRING WALL | TYPES - INTERNAL | | | SEAL |
| TYPE NO. W3a | | DESCRIPTION 38mm FURRING - TO 150mm ABOV FIN. CEILING - 16mm GYPSUM BOARD - 22mm MIN HAT CHANNEL @ 400 O.C. | FRR | | |
| W3b | | 80mm FURRING - TO 150mm ABOV FIN. CEILING - 16mm GYPSUM BOARD - 64mm MIN STEEL STUDS @ 400 O.C. | | | PRIME CONSULTANT |
| W3c | | 108mm FURRING - TO 150mm ABOV FIN. CEILING UNLESS OTHERWISE NOTED - 16mm GYPSUM BOARD - 92mm MIN STEEL STUDS @ 400 O.C. | | | IBI 175 Galaxy Blvd, Unit 100 Toronto, ON M9W 0C9, Canada tel 416 679 1930 fax 416 675 4620 ibigroup.com PROJECT TITLE CITY OF TORONTO |
| W3d | ۴ | 108mm FURRING - TO 150mm ABOV FIN. CEILING UNLESS OTHERWISE NOTED - 16mm GYPSUM BOARD - 92mm MIN STEEL STUDS @ 400 O.C. - 92mm ACOUSTIC NON COMBUSTIBLE BATT INSULATION | | | ACCESSIBILITY UPGRADES |
| | SHAFT WALL TY | | | CITY OF TORONTO ACCESSIBILITY UPGRADES | |
| TYPE NO. | ASSEMBLY | DESCRIPTION | FRR | STC | PROJECT NO: 9119- 19- 0162 / IBI 122260 DRAWN BY: CHECKED BY: |
| W4a | 1 1 1 1 1 1 1 1 1 1 1 1 1 1 1 1 1 1 1 | -25.4mm FIRE RATED GYPSUM BOARD -102mm "C-H" SHAPED STUD @600 O.C. - 16mm FIRE RATED GYPSUM BOARD TO U/S OF DECK/ SLAB ABOVE | 1.0 HR ULC W452 | | A. BOYNARIAN A. VAN VEEN PROJECT MGR: APPROVED BY: F.BOLOURIAN E. FENUTA SHEET TITLE WALL TYPES |
| W4b | | -25.4mm FIRE RATED GYPSUM BOARD -102mm "C-H" SHAPED STUD @600 O.C. - 102mm ACOUSTIC / THERMAL NON COMBUSTIBLE BATT INSULATION - 19.1mm FIRE RATED GYPSUM BOARD TO U/S OF DECK/ SLAB ABOVE | 2.0 HR ULC W508 | 52 | SHEET NUMBER ISSUE 00 |



CITY OF TORONTO ACCESSIBILITY UPGRADES

| | TOUCH AND FEEL INDEX | | |
|---------|---|--|--|
| SHEET # | SHEET TITLE | | |
| Т00 | COVER PAGE | | |
| T01 | WASHROOM | | |
| T02 | WASHROOM ACCESSORIES | | |
| Т03 | WASHROOM FIXTURES & DRINKING FOUNTAIN | | |
| T04 | KITCHEN MATERIALS AND FIXTURES | | |
| T05 | RESERVED | | |
| T06 | TACTILE ATTENTION INDICATORS | | |
| T07 | TEXTURAL & COLOUR CONTRAST WARNING STRIP AND NOSING | | |
| T08 | DOOR THRESHOLDS | | |

TOUCH-AND-FEEL DOCUMENT SHOULD BE READ IN CONJUNCTION WITH DRAWINGS AND SPECIFICATIONS

TORONTO

CITY OF TORONTO ACCESSIBILITY UPGRADES



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TOUCH AND FEEL INTERIOR FIXTURES AND MATERIALS

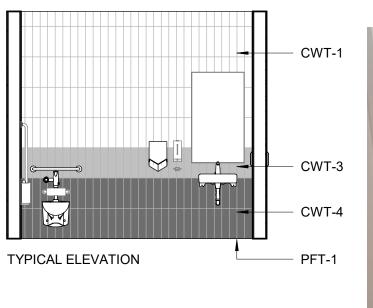
Project Number: 9119- 19- 0162 / IBI 122260 Date: 2021-10-19

| VVA | SHROOM FINISHES |
|-------------------------------|--|
| WASHROOM / SHOWER WALLS | COLLECTION: COLOUR & DIMENSION |
| CWT-1 | COLOUR: ARCTIC WHITE MATTE |
| | SIZE: 100mm X 400mm (4"X16") |
| | SUPPLIER: OLYMPIA |
| WASHROOM / SHOWER WALL ACCENT | |
| CWT-2 | TILE SIZE IS INDICATED ON ROOM FINISH SCHEDULE |
| WASHROOM / SHOWER WALL ACCENT | COLLECTION: COLOUR & DIMENSION |
| CWT-3 | COLOUR: TAUPE, MATTE |
| | SIZE: 100mm X 400mm (4"X16") |
| | SUPPLIER: OLYMPIA |
| WASHROOM / SHOWER WALL ACCENT | COLLECTION: COLOUR & DIMENSION |
| CWT-4 | COLOUR: DARK GREY MATTE |
| | SIZE: 100mm X 400mm (4"X16") |
| | SUPPLIER: OLYMPIA |
| FLOORS | COLLECTION: MICA, MATTE FINISH |
| PFT-1 | SIZE: 300mm X 600mm (12"X24") |
| | MEETS DYNAMIC COEFFICIENT OF FRICTION |
| | PREFERRED SUPPLIER: D9 / EMOTION |
| SHOWER FLOORS | COLLECTION: STI MOSAICO |
| PFT-2 | COLOUR: MID GREY UNGLAZ |
| FT 1 - 2 | SIZE: 50mm X 50mm (2"X2") |
| | MEETS DYNAMIC COEFFICIENT OF FRICTION |
| | SUPPLIER: STONE TILE |
| | |
| FLOORS | MATCH EXISTING |
| PFT-3 | TILE SIZE IS INDICATED ON ROOM FINISH SCHEDULE |
| FLOORS | COLLECTION: CORE COLLECTION TERRA |
| PFT-4 | COLOUR: 200 SMOOTH (V) |
| | SIZE: 304.8mm X 609.6mm (12"X24") |
| | MEETS DYNAMIC COEFFICIENT OF FRICTION |
| | |

FOR WASHROOMS WHERE ALL FIXTURES AND WALLS ARE BEING REMOVED ONLY



PICTURE 1





NOTE: THE FINISHES PRESENTED ON THIS PAGE ARE THE BASIS OF DESIGN - ANY ALTERNATES ARE SUBJECT TO APPROVAL BY CITY OF TORONTO, PROJECT MANAGER, FACILITY MANAGER AND STAKEHOLDERS

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CITY OF TORONTO ACCESSIBILITY UPGRADES CITY OF TORONTO ACCESSIBILITY UPGRADES DRAWING TITLE:

WASHROOM

Date: 2021-10-19

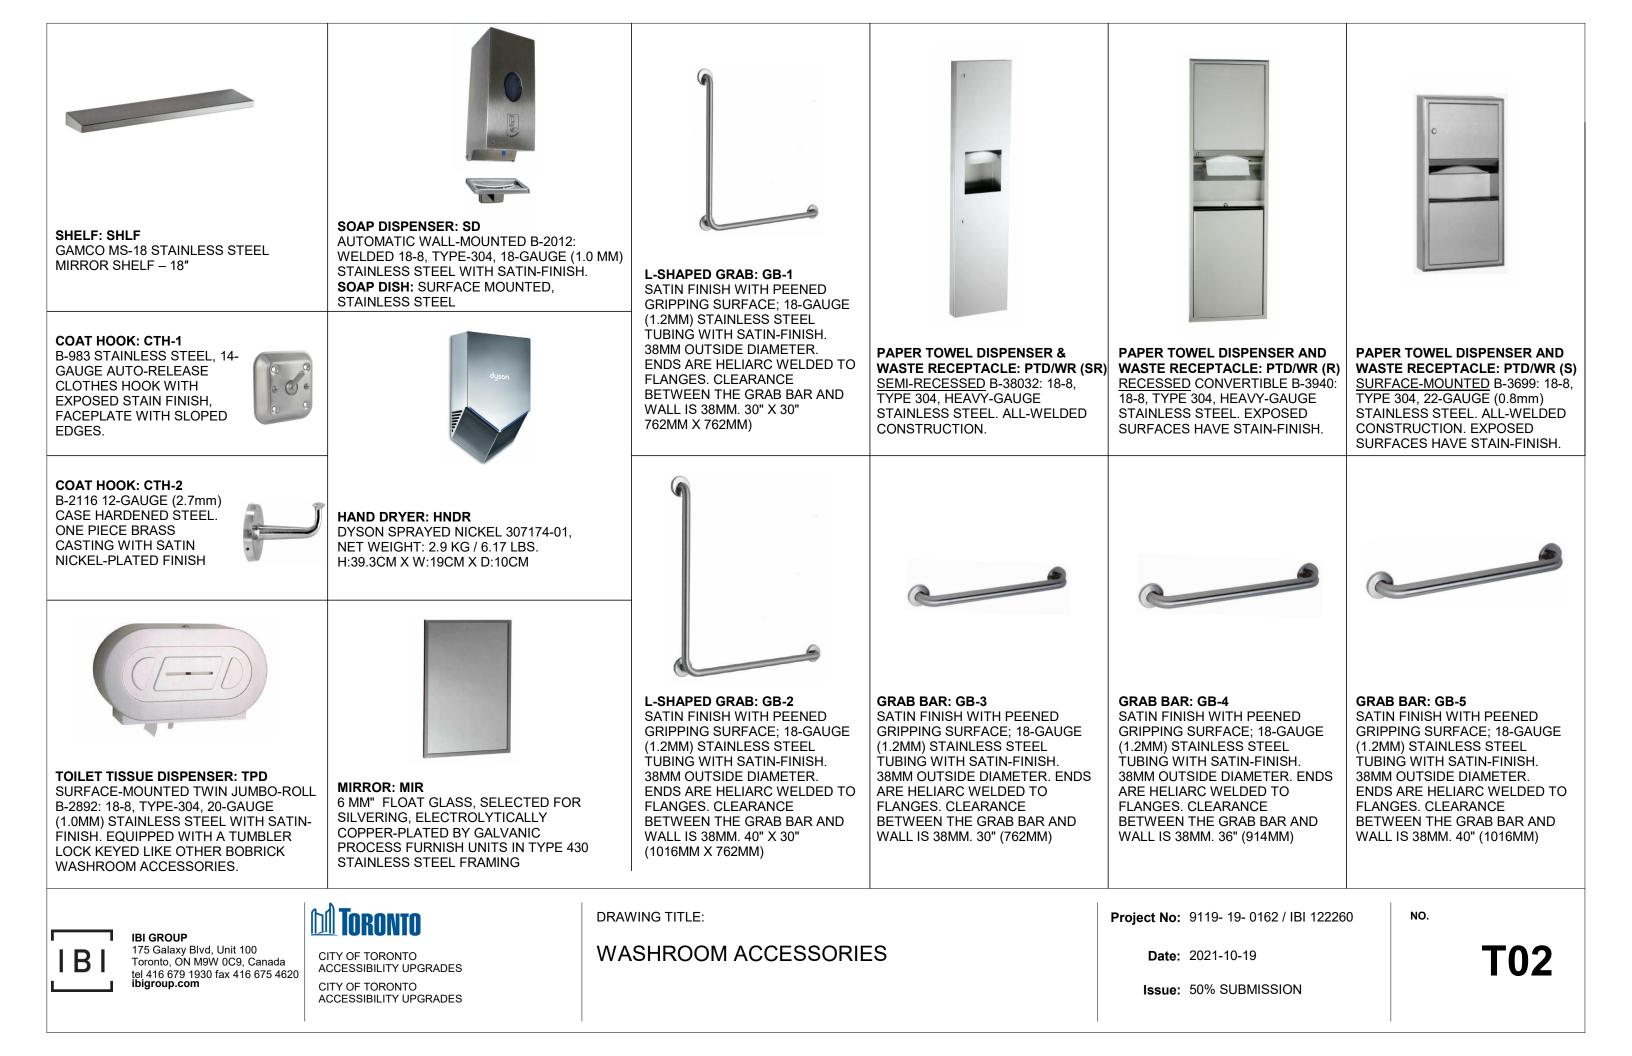
Issue: 50% SUBMISSION



NOTE: PICTURES ARE ONLY FOR ILLUSTRATION PURPOSES

Project No: 9119- 19- 0162 / IBI 122260

NO.









DECORUM WALL HUNG LAVATORY WITH EVERCLEAN 9024-901EC - VITREOUS CHINA - WHITE FINISH - 3 HOLES, 102 MM CENTER - REAR OVERFLOW -RECESSED SELF-DRAINING FAUCET LEDGE

UNDER-MOUNTED LAVATORY SINK: L2H AMERICAN STANDARD "OVALYN UNIVERSAL ACCESS™ SINK"



SOAP DISPENSER: MOEN SINGLE MOUNT MODERN STYLE -8560 ELECTRONIC SOAP DISPENSER "TOUCH FREE"



FAUCET: **MOEN ALIGN SENSOR FAUCET - 8559** ELECTRONIC 'NO-TOUCH' HARDWIRED POWERED FAUCET





TOILET: W1 WALL HUNG - WHITE FINISH - VITREOUS CHINA WITH EVERCLEAN ANTIMICROBIAL SURFACE

TOILET: W2 FLOOR MOUNTED WHITE FINISH - VITREOUS CHINA WITH EVERCLEAN ANTIMICROBIAL SURFACE



TOILET WITH TANK: W3 FLOOR MOUNTED WHITE FINISH - VITREOUS CHINA WITH EVERCLEAN ANTIMICROBIAL SURFACE

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IBI GROUP

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TARANTA

CITY OF TORONTO ACCESSIBILITY UPGRADES CITY OF TORONTO ACCESSIBILITY UPGRADES

DRAWING TITLE:

WASHROOM FIXTURES & **DRINKING FOUNTAIN**

DRINKING FOUNTAIN



DRINKING FOUNTAIN: DF

EZSDWSLK GALVANIZED STEEL WALL MOUNTED, WHEELCHAIR TYPE WATER COOLER WITH STAINLESS STEEL TOP, FRONT AND SIDE MOUNTED PUSH TO OPERATE LEVER(S), SENSOR, TOUCHLESS ACTIVATION WITH AUTO SHUT OFF BOTTLE FILLER, FLEXI-GUARD SAFETY BUBBLER, AND TRAP PACKAGE.



URINAL: U1H WALL HUNG 6590.001.020 - WASHBROOK FLOWISE -EXTENDED SIDES FOR PRIVACY - WASHDOWN ACTION - FLUSHING RIM - 19 MM DIA.

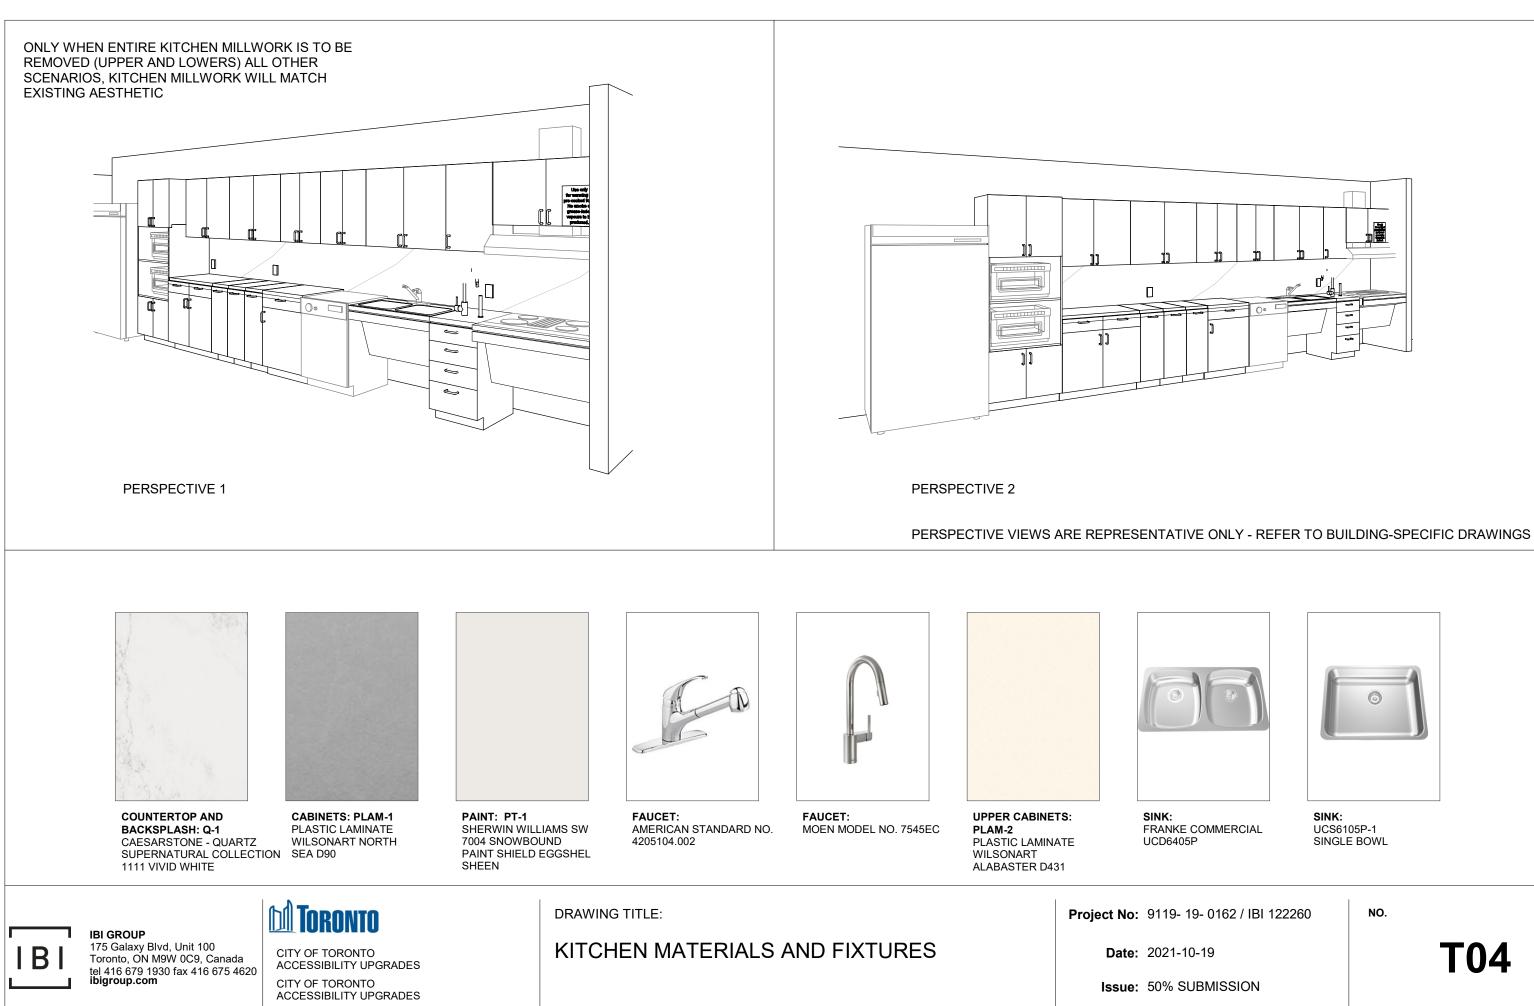
Project No: 9119- 19- 0162 / IBI 122260

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Date: 2021-10-19

Issue: 50% SUBMISSION



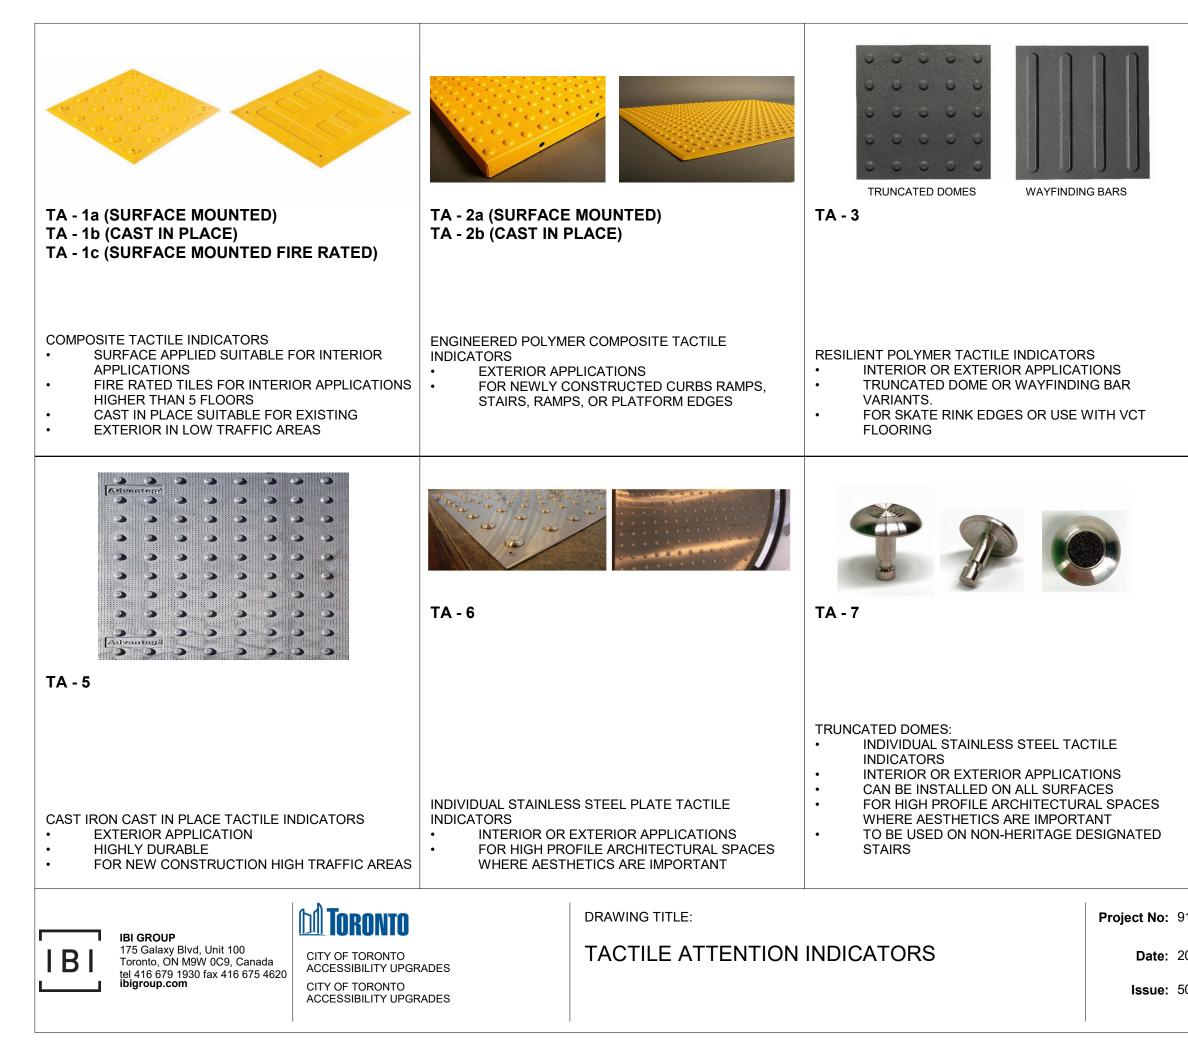
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M Toronto DRAWING TITLE: Project No: 9119- 19- 0162 / IBI 122260 **IBI GROUP** 175 Galaxy Blvd, Unit 100 Toronto, ON M9W 0C9, Canada tel 416 679 1930 fax 416 675 4620 **ibigroup.com** RESERVED CITY OF TORONTO ACCESSIBILITY UPGRADES Date: 2021-10-19 CITY OF TORONTO ACCESSIBILITY UPGRADES Issue: 50% SUBMISSION

IBI

NO.







WAYFINDING BARS

TA - 4

PORCELAIN TACTILE INDICATORS

- INTERIOR OR EXTERIOR APPLICATIONS
 TRUNCATED DOME OR WAYFINDING BAR
- VARIANTS.
- FOR USE WITH PORCELAIN TILE FLOORING



TA - 8

GUIDANCE BARS:

- INDIVIDUAL STAINLESS STEEL, BRASS, BRONZE OR ALUMINUM CARBORUNDUM NON-SLIP OR LINEAR GROOVE PATTERN.
- INTERIOR APPLICATIONS
- CAN BE INSTALLED ON ALL SURFACES
- FOR HIGH PROFILE ARCHITECTURAL SPACES
 WHERE AESTHETICS ARE IMPORTANT
 TO DE USED ON NON HERITAGE DESIGNATED
- TO BE USED ON NON-HERITAGE DESIGNATED
 STAIRS

Project No: 9119- 19- 0162 / IBI 122260

NO.

Date: 2021-10-19

Issue: 50% SUBMISSION

| TA - 11 INTERIOR AND EXTERIOR | TA - 12 EXTERIOR CAST IN PLACE | TA - 16 INTERIOR AND EXTERIOR USE ON SMOOTH SURFACES |
|--|---|---|
| INTERIOR OR EXTERIOR USE ON SMOOTH SURFACES. • AFFIXED WITH ADHESIVE AND SCREWS • SIZES: 50.8MM X 203MM • REFER TO DRAWINGS FOR REQUIRED LENGTH AND WIDTH | EXTERIOR USE IN NEW PROJECTS ON CONCRETE. TEXTURE WARNING STRIP SPECIFICALLY DESIGNED FOR INSTALLATION ON STEP EDGES WHEN CONCRETE IS POURED. INSTALLED IN WET-SET CONCRETE. SIZES: 50.8MM X 76.2MM WIDE REFER TO DRAWINGS FOR REQUIRED LENGTH AND WIDTH | INTERIOR AND EXTERIOR USE ON SMOOTH SURFACES ANODIZED ALUMINUM NOSE, INSTALLED WITH EITHER NON-SLIP STRIP OR WITH PHOTOLUMINESCENT CONTRAST STRIP. AVAILABLE IN 5 DIFFERENT PROFILES TO MATCH THE DESIGN OF THE STEP EDGE AFFLICTED WITH ADHESIVE OR ADHESIVE AND SCREWS SIZES: 70.1MM - 78.7MM WIDE REFER TO DRAWINGS FOR REQUIRED LENGTH AND WIDTH |
| | | |
| | TA - 19 EXTERIOR USE ON POURED | |
| TA - 18 INTERIOR USE ON CARPETED FLOORING | CONCRETE EXTERIOR USE ON POURED CONCRETE: | |
| INTERIOR USE ON CARPETED FLOORING. ANODIZED ALUMINUM NOSE, SPECIFICALLY DESIGNED FOR CARPETED STAIRS, INSTALLED WITH EITHER NON-SLIP STRIP OR WITH PHOTOLUMINESCENCE CONTRAST STRIP INSTALLED WITH SCREWS SIZES: 66MM - 89MM REFER TO DRAWINGS FOR REQUIRED LENGTH AND WIDTH | HEAT TREATED EXTRUDED ALUMINUM ALLOY 6063-T-6, FILLED WITH A MIXTURE OF VIRGIN ALUMINUM OXIDE AND SILICON CARBIDE ABRASIVE GRANULES IN AN EPOXY BINDER. FULL LENGTH, INTEGRALLY EXTRUDED 5/8" ANCHOR. SIZES: 79.4MM X 25.4MM REFER TO DRAWINGS FOR REQUIRED LENGTH AND WIDTH TO BE USED ON NON-HERITAGE DESIGNATED STAIRS | |
| IBI GROUP 175 Galaxy Blvd, Unit 100 Toronto, ON M9W 0C9, Canada tol 416 670 4020 faw 416 675 4620 CITY OF TORONTO ACCESSIBILITY UPG | DRAWING TITLE: TEXTURAL & COLOU WARNING STRIP AND | Data |

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ACCESSIBILITY UPGRADES CITY OF TORONTO ACCESSIBILITY UPGRADES

WARNING STRIP AND NOSING

Issue: 50% SUBMISSION





INTERIOR USE ON TILED STAIRS.

- ALUMINUM NOSE SPECIFICALLY DESIGNED FOR •
- INSTALLATION ON TILED STAIRS.
- 3.2MM TILED STAIRS OR 2.54MM TILED STAIRS. • REFER TO DRAWINGS FOR REQUIRED LENGTH •
- AND WIDTH

9119-19-0162 / IBI 122260

NO.

T07

Date: 2021-10-19

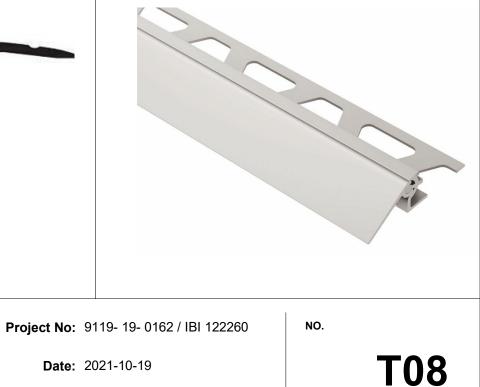


ANODIZED ALUMINUM THRESHOLD FOR TRANSITION BETWWEEN NEW AND EXISTING FLOOR



TH-5a

SATIN ANODIZED ALUMINUM THRESHOLD FOR NEW FLOORING ON BOTH SIDE VARIES HEIGHTS (TILE TO ANY FLOOR SURFACE)



Issue: 50% SUBMISSION

CITY OF TORONTO ACCESSIBILITY UPGRADES TYPICAL DETAILS BOOKLET

9119-19-0162 / IBI 122260

ARCHITECTURAL TYPICAL DETAILS INDEX

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| D1002 | DOOR ENLARGEMENT |
| D1201 | ACCESSIBLE WASHROOM, SHOWER & ACCESSORIES DETAILS |
| D1202 | UNIVERSAL WASHROOM & SHOWER PLANS |
| D1203 | UNIVERSAL WASHROOM ELEVATIONS |
| D1204 | MULTI-STALL WASHROOM PLANS |
| D1205 | UW - EMERGENCY CALL SYSTEM |
| D1301 | KITCHEN MILLWORK PLANS & ELEVATIONS |
| D1302 | KITCHEN MILLWORK DETAIL SECTIONS |
| D1303 | KITCHEN HOOD VENT DETAIL |
| D1305 | RECEPTION DESK MILLWORK PLANS & ELEVATIONS |
| D1401 | STAIR DETAILS - 01 |
| D1402 | STAIR DETAILS - 02 |
| D1403 | RAMP DETAILS - 01 |
| D1404 | RAMP DETAILS - 02 |
| D1405 | TACTILE DETAILS |
| D1501 | MISCELLANEOUS DETAILS - 01 |
| D1502 | MISCELLANEOUS DETAILS - 02 |
| D1601 | ELEVATOR DETAILS |
| D1602 | ELEVATOR CONTROL & INTERIOR CABIN DETAILS |
| D1701 | ACCESSIBLE PARKING AND SITE MARKING DETAILS |
| D1702 | CURB DETAILS |
| D1801 | PHASING / HOARDING DETAILS |

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|----------------------------------|------------------------------|----------------------------------|-----------------------------|---------|----------------|
| SHEET # | SHEET TITLE | SHEET # | SHEET TITLE | SHEET # | |
| D2100 | CONCRETE - TYPICAL DETAIL | D3201 | PLUMBING DETAILS | D4001 | ELECTRICAL DET |
| D2200 | STRUCTURAL STEEL DETAILS - 1 | D3301 | DRAINAGE DETAILS | | |
| D2201 | STRUCTURAL STEEL DETAILS - 2 | D3401 | FIRE PROTECTION DETAILS | | |
| D2300 | MASONRY DETAILS | D3501 | HVAC DETAILS | | |
| | | D3601 | PIPING DETAILS SHEET 1 OF 2 | | |
| | | D3602 | PIPING DETAILS SHEET 2 OF 2 | | |

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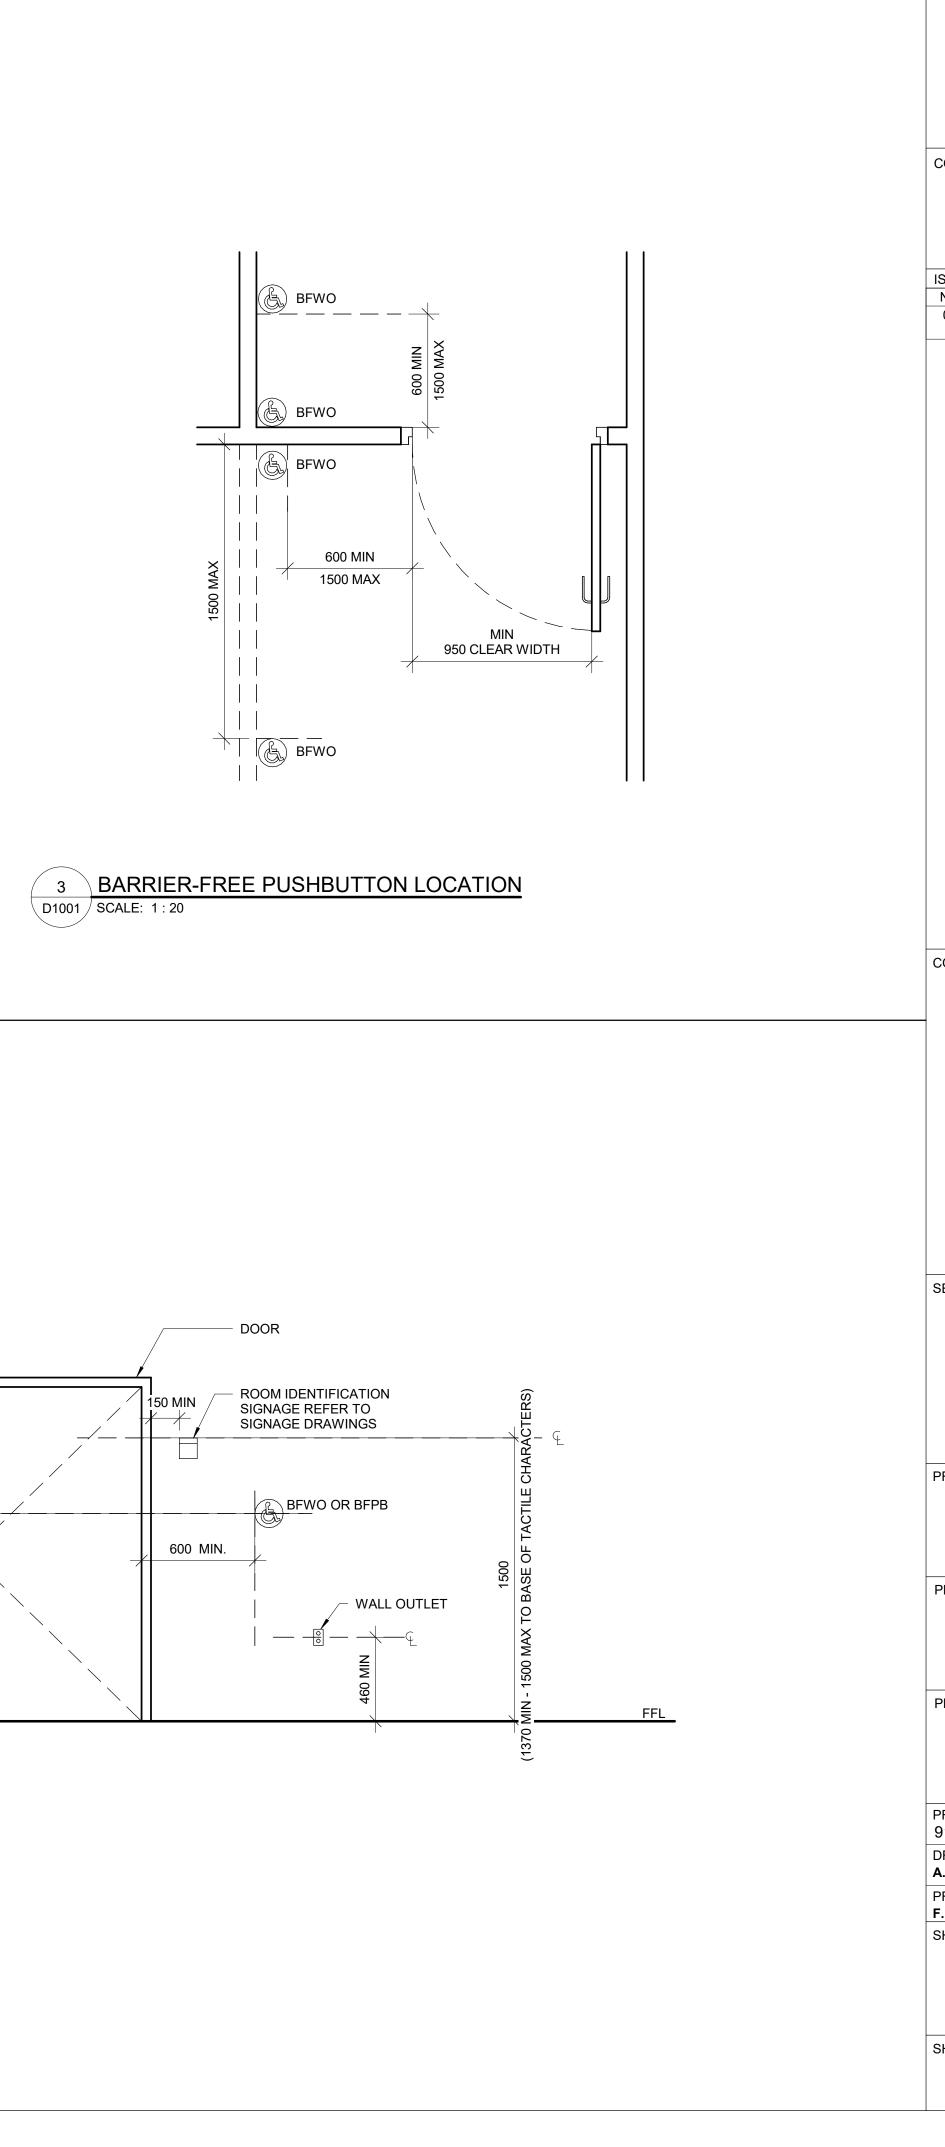
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| 55 John ST. | |
| TORONTO, ON M5V 3C6 ISSUES | |
| No. DESCRIPTION 00 ISSUED FOR CONSTRUCTION | DATE 2021-10-19 |
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| IBI GROUP 175 Galaxy Blvd, Unit 100 | |
| IBI 175 Galaxy Blvd, Unit 100 tel 416 596 1930 fax 416 5 ibigroup.com PROJECT NO: | 596 0644 |
| 9119- 19- 0162 / IBI 122260 Date: | |
| 2021-10-19 SHEET NUMBER | ISSUE |
| D1000 | 00 |

TRICAL TYPICAL DETAILS INDEX

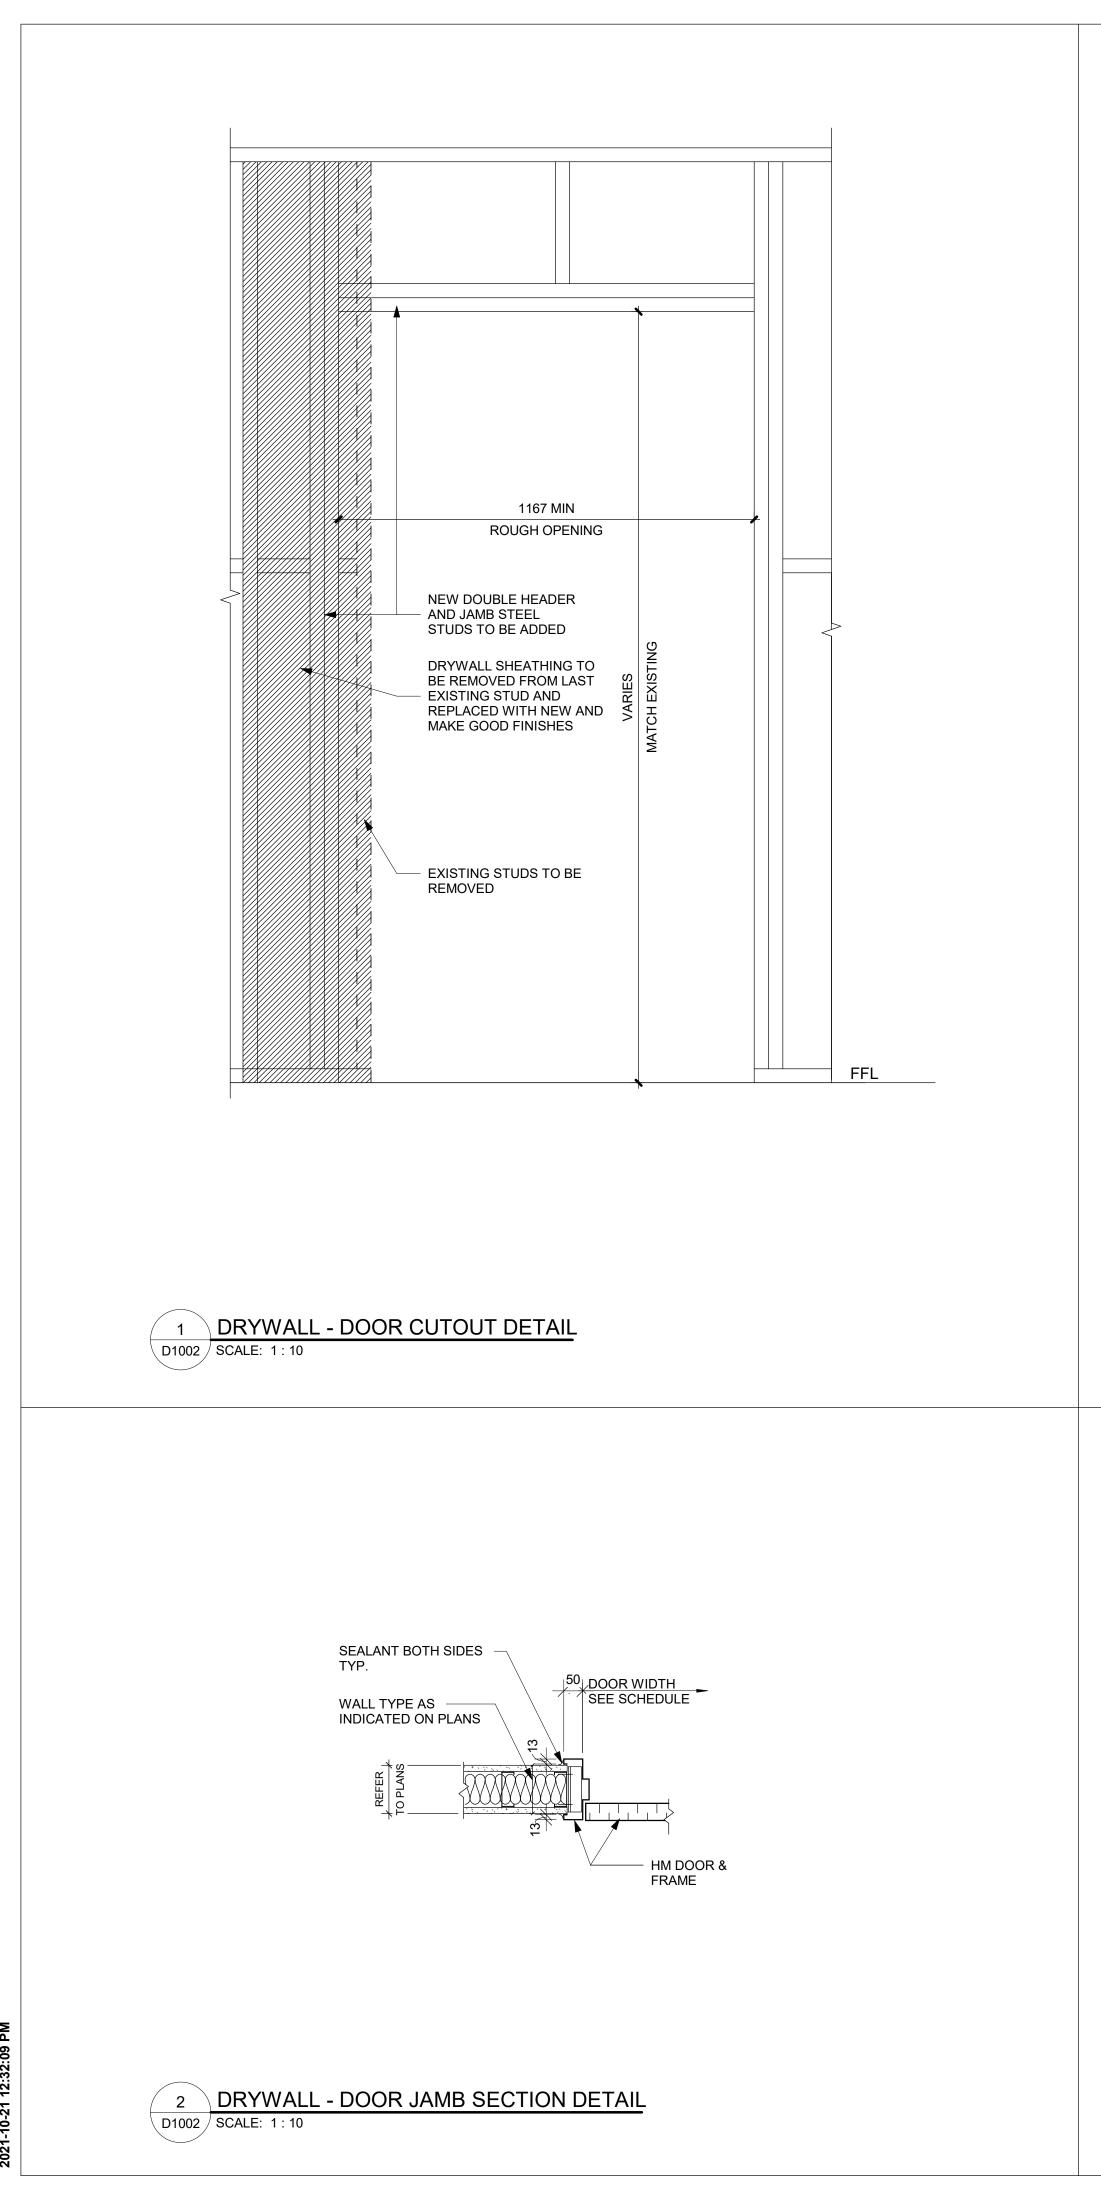
SHEET TITLE

ETAILS 1

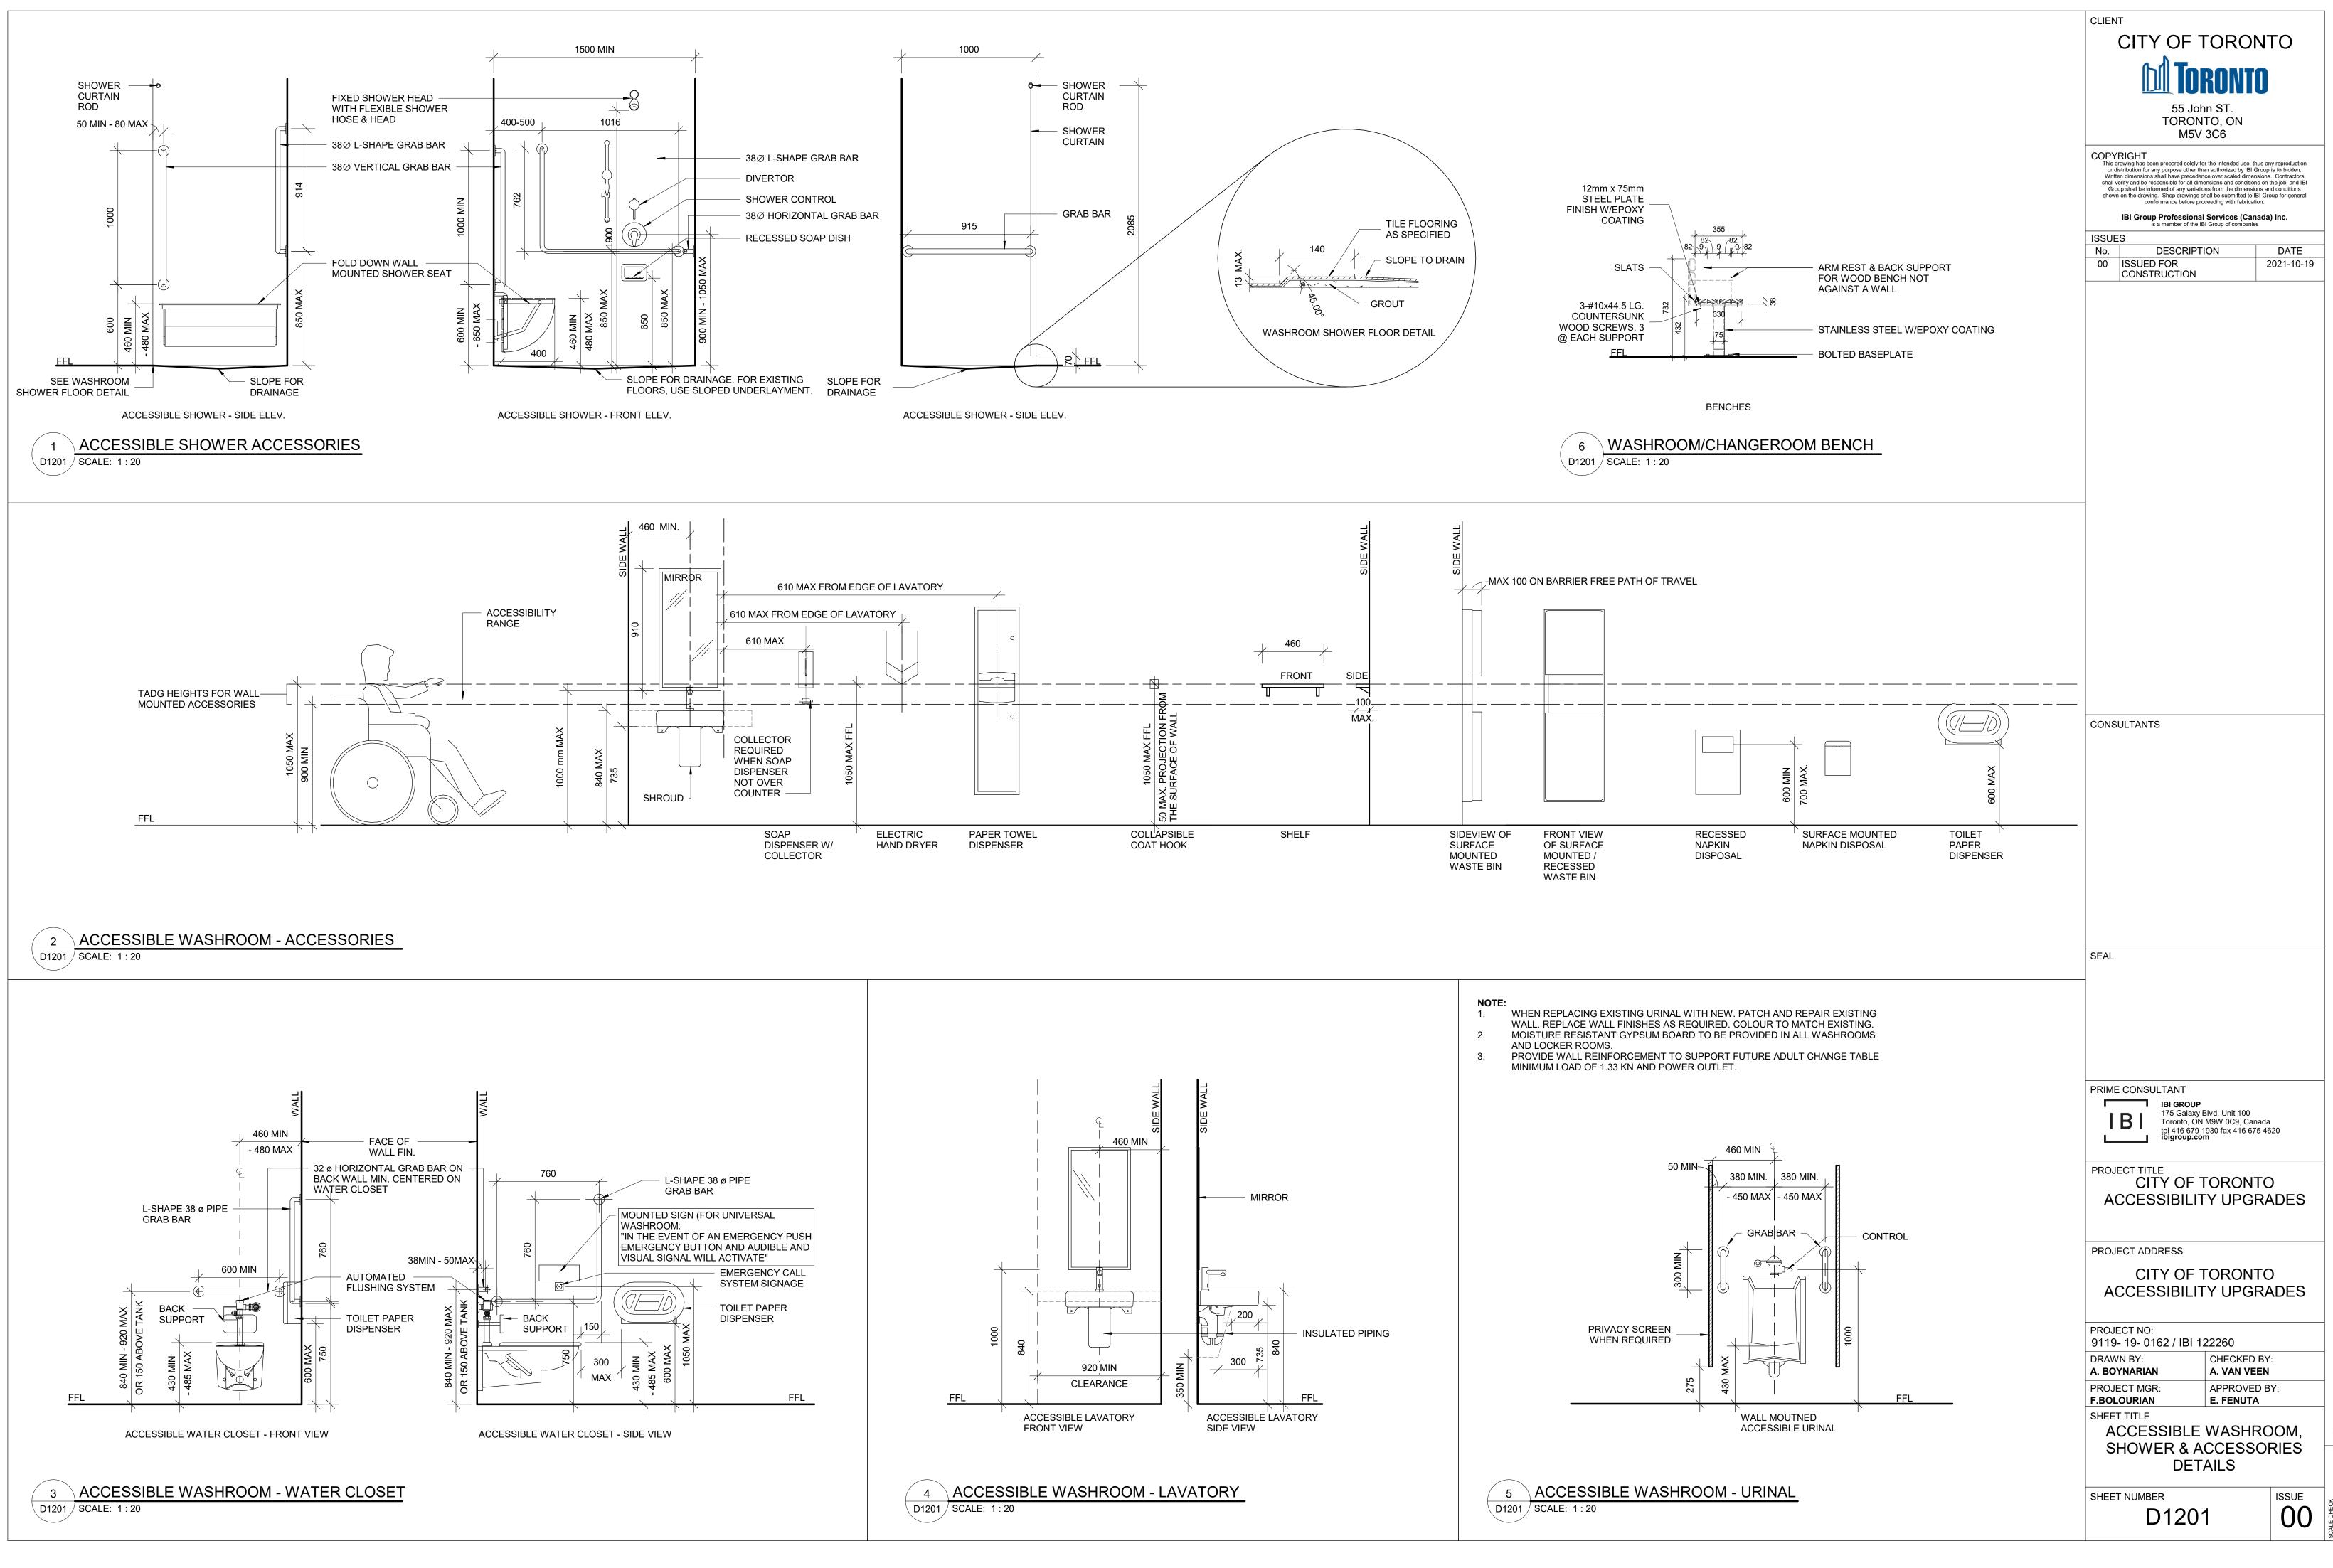




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|--|--------------------------------|
| 55 John ST. TORONTO, ON | |
| M5V 3C6 | |
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| Group shall be informed of any variations from the dimensions an shown on the drawing. Shop drawings shall be submitted to IBI Gro conformance before proceeding with fabrication. | d conditions |
| IBI Group Professional Services (Canada is a member of the IBI Group of companies ISSUES |) Inc. |
| No. DESCRIPTION | DATE 021-10-19 |
| CONSTRUCTION | .021-10-10 |
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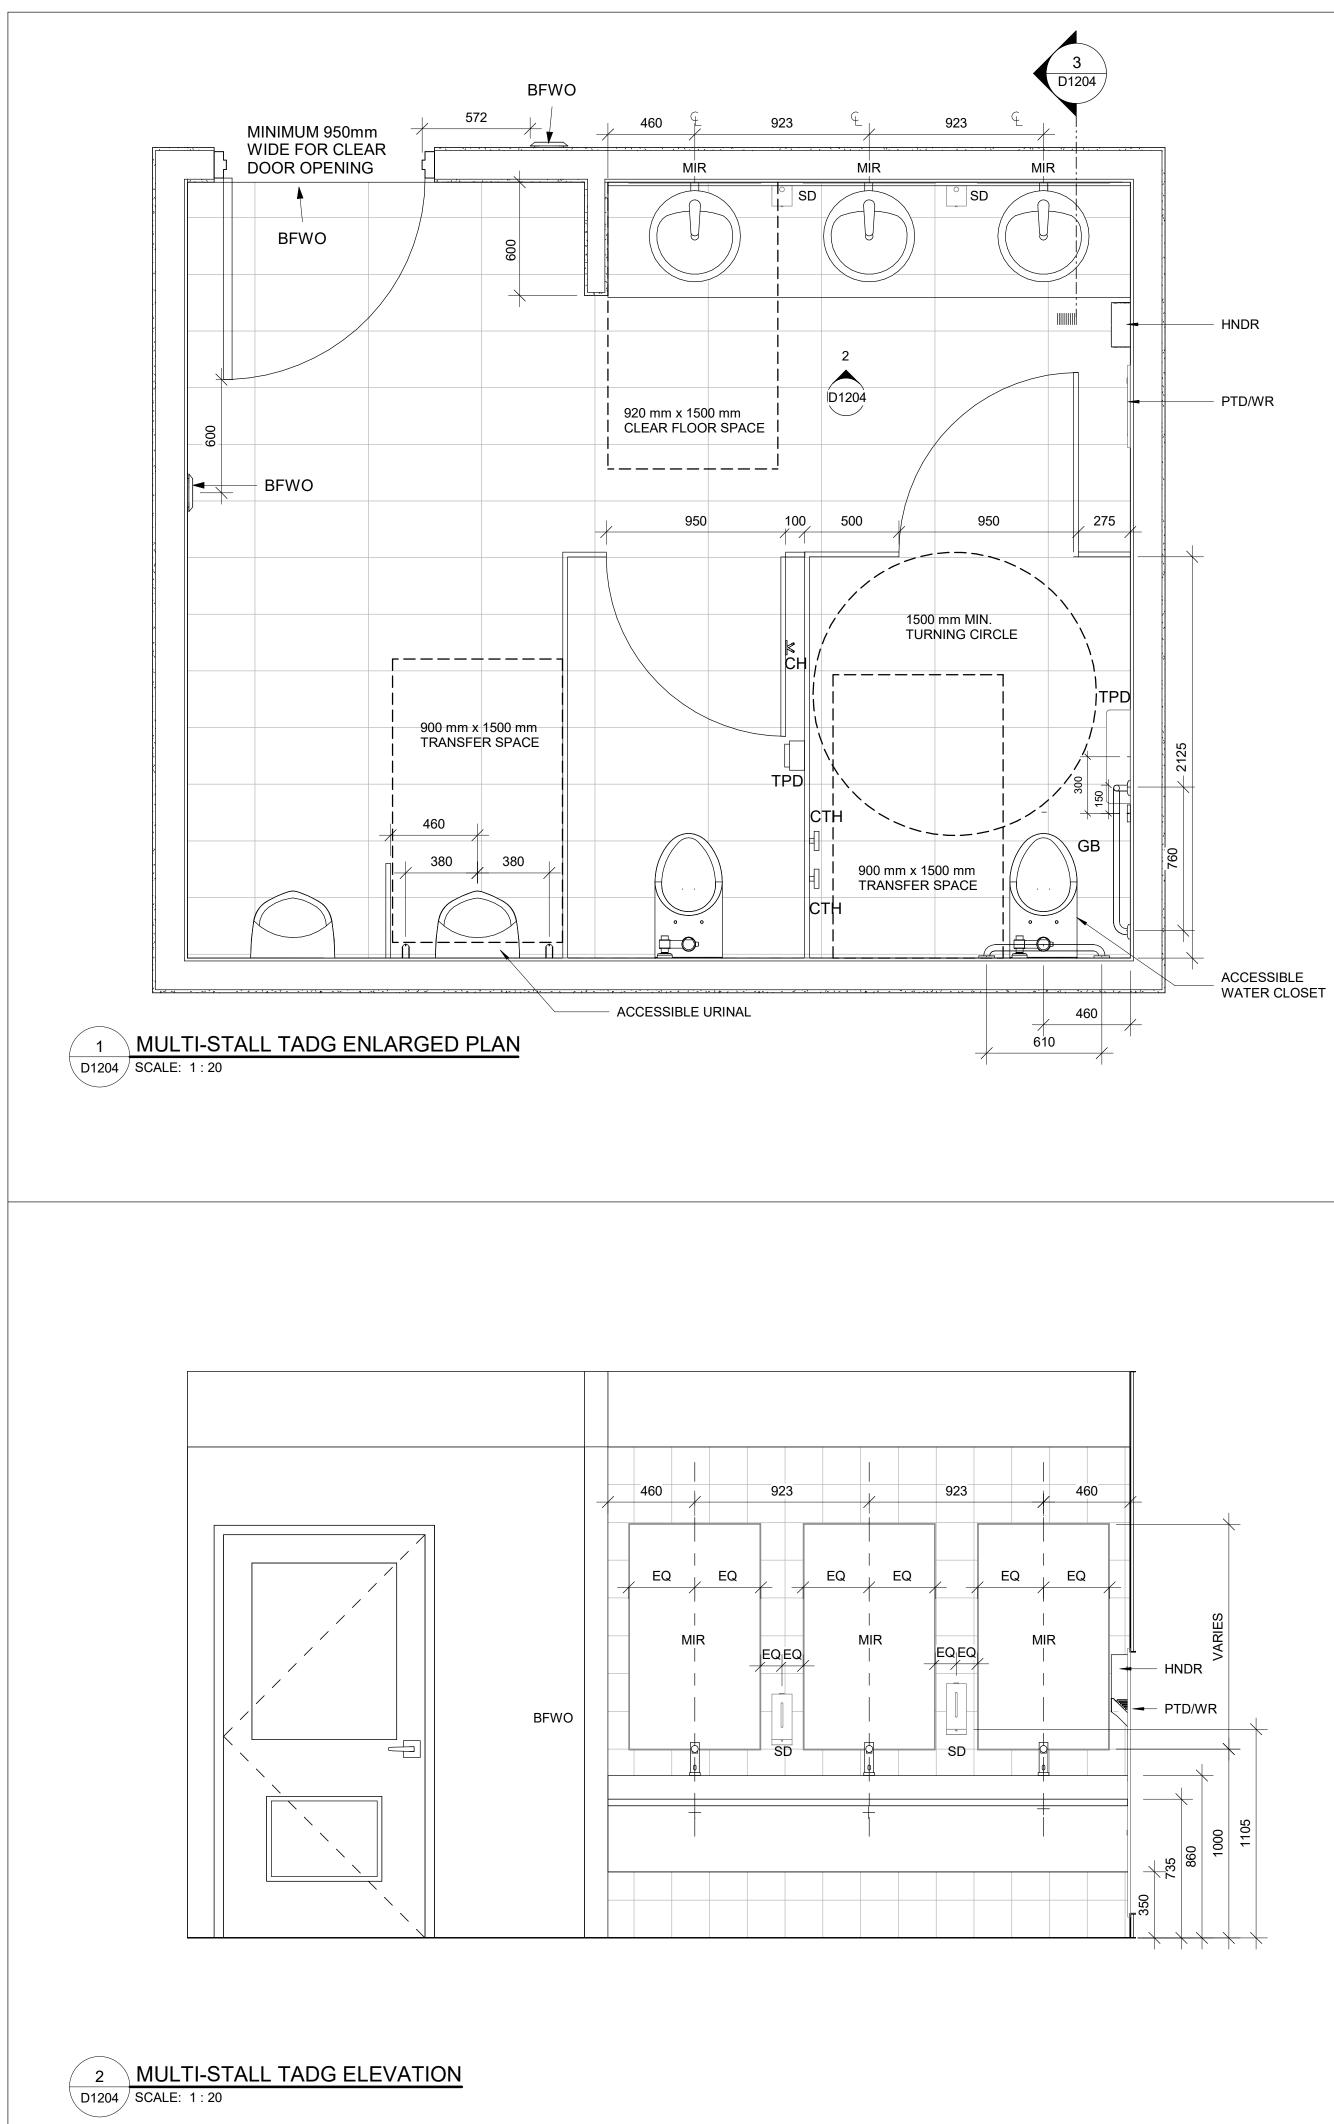
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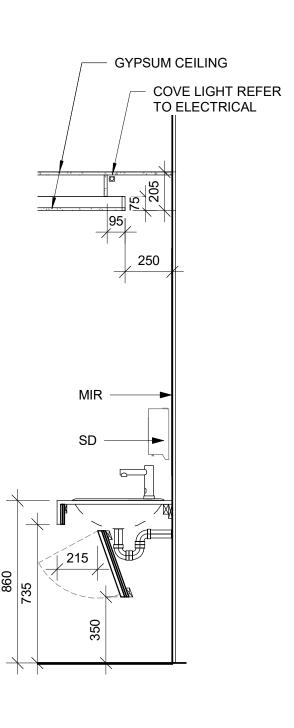
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| WASHROOM ACCESSORIES | | |
|----------------------|--|--|
| ABR | DESCRIPTION | |
| ANUN | ASSISTANCE REQUIRED INDICATOR/ALARM | |
| AR-LED | DOOR LOCK INDICATOR | |
| BFACT | BARRIER FREE ADULT CHANGE TABLE | |
| BFPB | BARRIER FREE PUSH BUTTON | |
| BR | BACKREST | |
| CTH | COAT HOOK | |
| ECB | EMERGENCY CALL BUTTON | |
| ECS | EMERGENCY CALL SIGNAGE | |
| FFL | FINISH FLOOR LEVEL | |
| GRB | GRAB BAR | |
| GBFD | GRAB BAR FOLD DOWN | |
| HNDR | HAND DRYER | |
| MIR | MIRROR | |
| OCI | OCCUPIED INDICATOR | |
| PTD | PAPER TOWEL DISPENSER | |
| PTD/WR | PAPER TOWEL DISPENSER & WASTE RECEPTACLE | |
| PTLB | PUSH TO LOCK BUTTON | |
| PTOB | PUSH TO OPEN BUTTON | |
| SD | SOAP DISPENSER | |
| SHLF | SHELF | |
| SHWC | SHOWER CURTAIN AND ROD | |
| SHWS | SHOWER SEAT | |
| SPD | SOAP DISPENSER WITH COLLECTOR | |
| TPD | TOILET PAPER DISPENSER | |



3 MULTI-STALL TADG SECTION D1204 SCALE: 1:20

| UNIVERSAL WASHROOM GENERAL NOTES: 1. ALL DIMENSIONS ARE TAKEN FROM FINISH FLOOR SURFACE. 2. MOISTURE RESISTANT GYPSUM BOARD TO BE PROVIDED IN ALL WASHROOMS AND LOCKER ROOMS. 3. PROVIDE WALL REINFORCEMENT TO SUPPORT FUTURE ADULT CHANGE TABLE MINIMUM LOAD OF 1.33 KN AND POWER OUTLET | CLIENT CITY OF TORONTO CITY OF TORONTO CONCLASSING CONCLASSING S5 John ST, DORONTO, ON M5V 3C6 COPYRIGHT Marking has been prepared solely for the intended use, thus any reproduction of stribution for any purpose other than authorized by BI Group report Stribution for any purpose other than authorized by BI Group is forbidder. Stribution for any purpose other than authorized by BI Group is forbidder. Shigh cardinal have precedence over scaled dimensions. Contractors solar verify and be responsible for all dimensions and conditions on the job, and BI Group shall be informed of any variations from the dimensions and conditions show no the drawing. Shop drawings shall be submitted to BI Group for general conformance before proceeding with fabrication. |
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| SEE STANDARD MOUNTING HEIGHT DETAILS 2/D1201, 3/D1201, 4/D1201 & 5/D1202 WASHROOM ARRANGMENTS FOR ILLUSTRATION PURPOSES - REFER TO EACH BUILDING ENLARGED | ISSUES No. DESCRIPTION DATE 00 ISSUED FOR 2021-10-19 CONSTRUCTION CONSTRUCTION |
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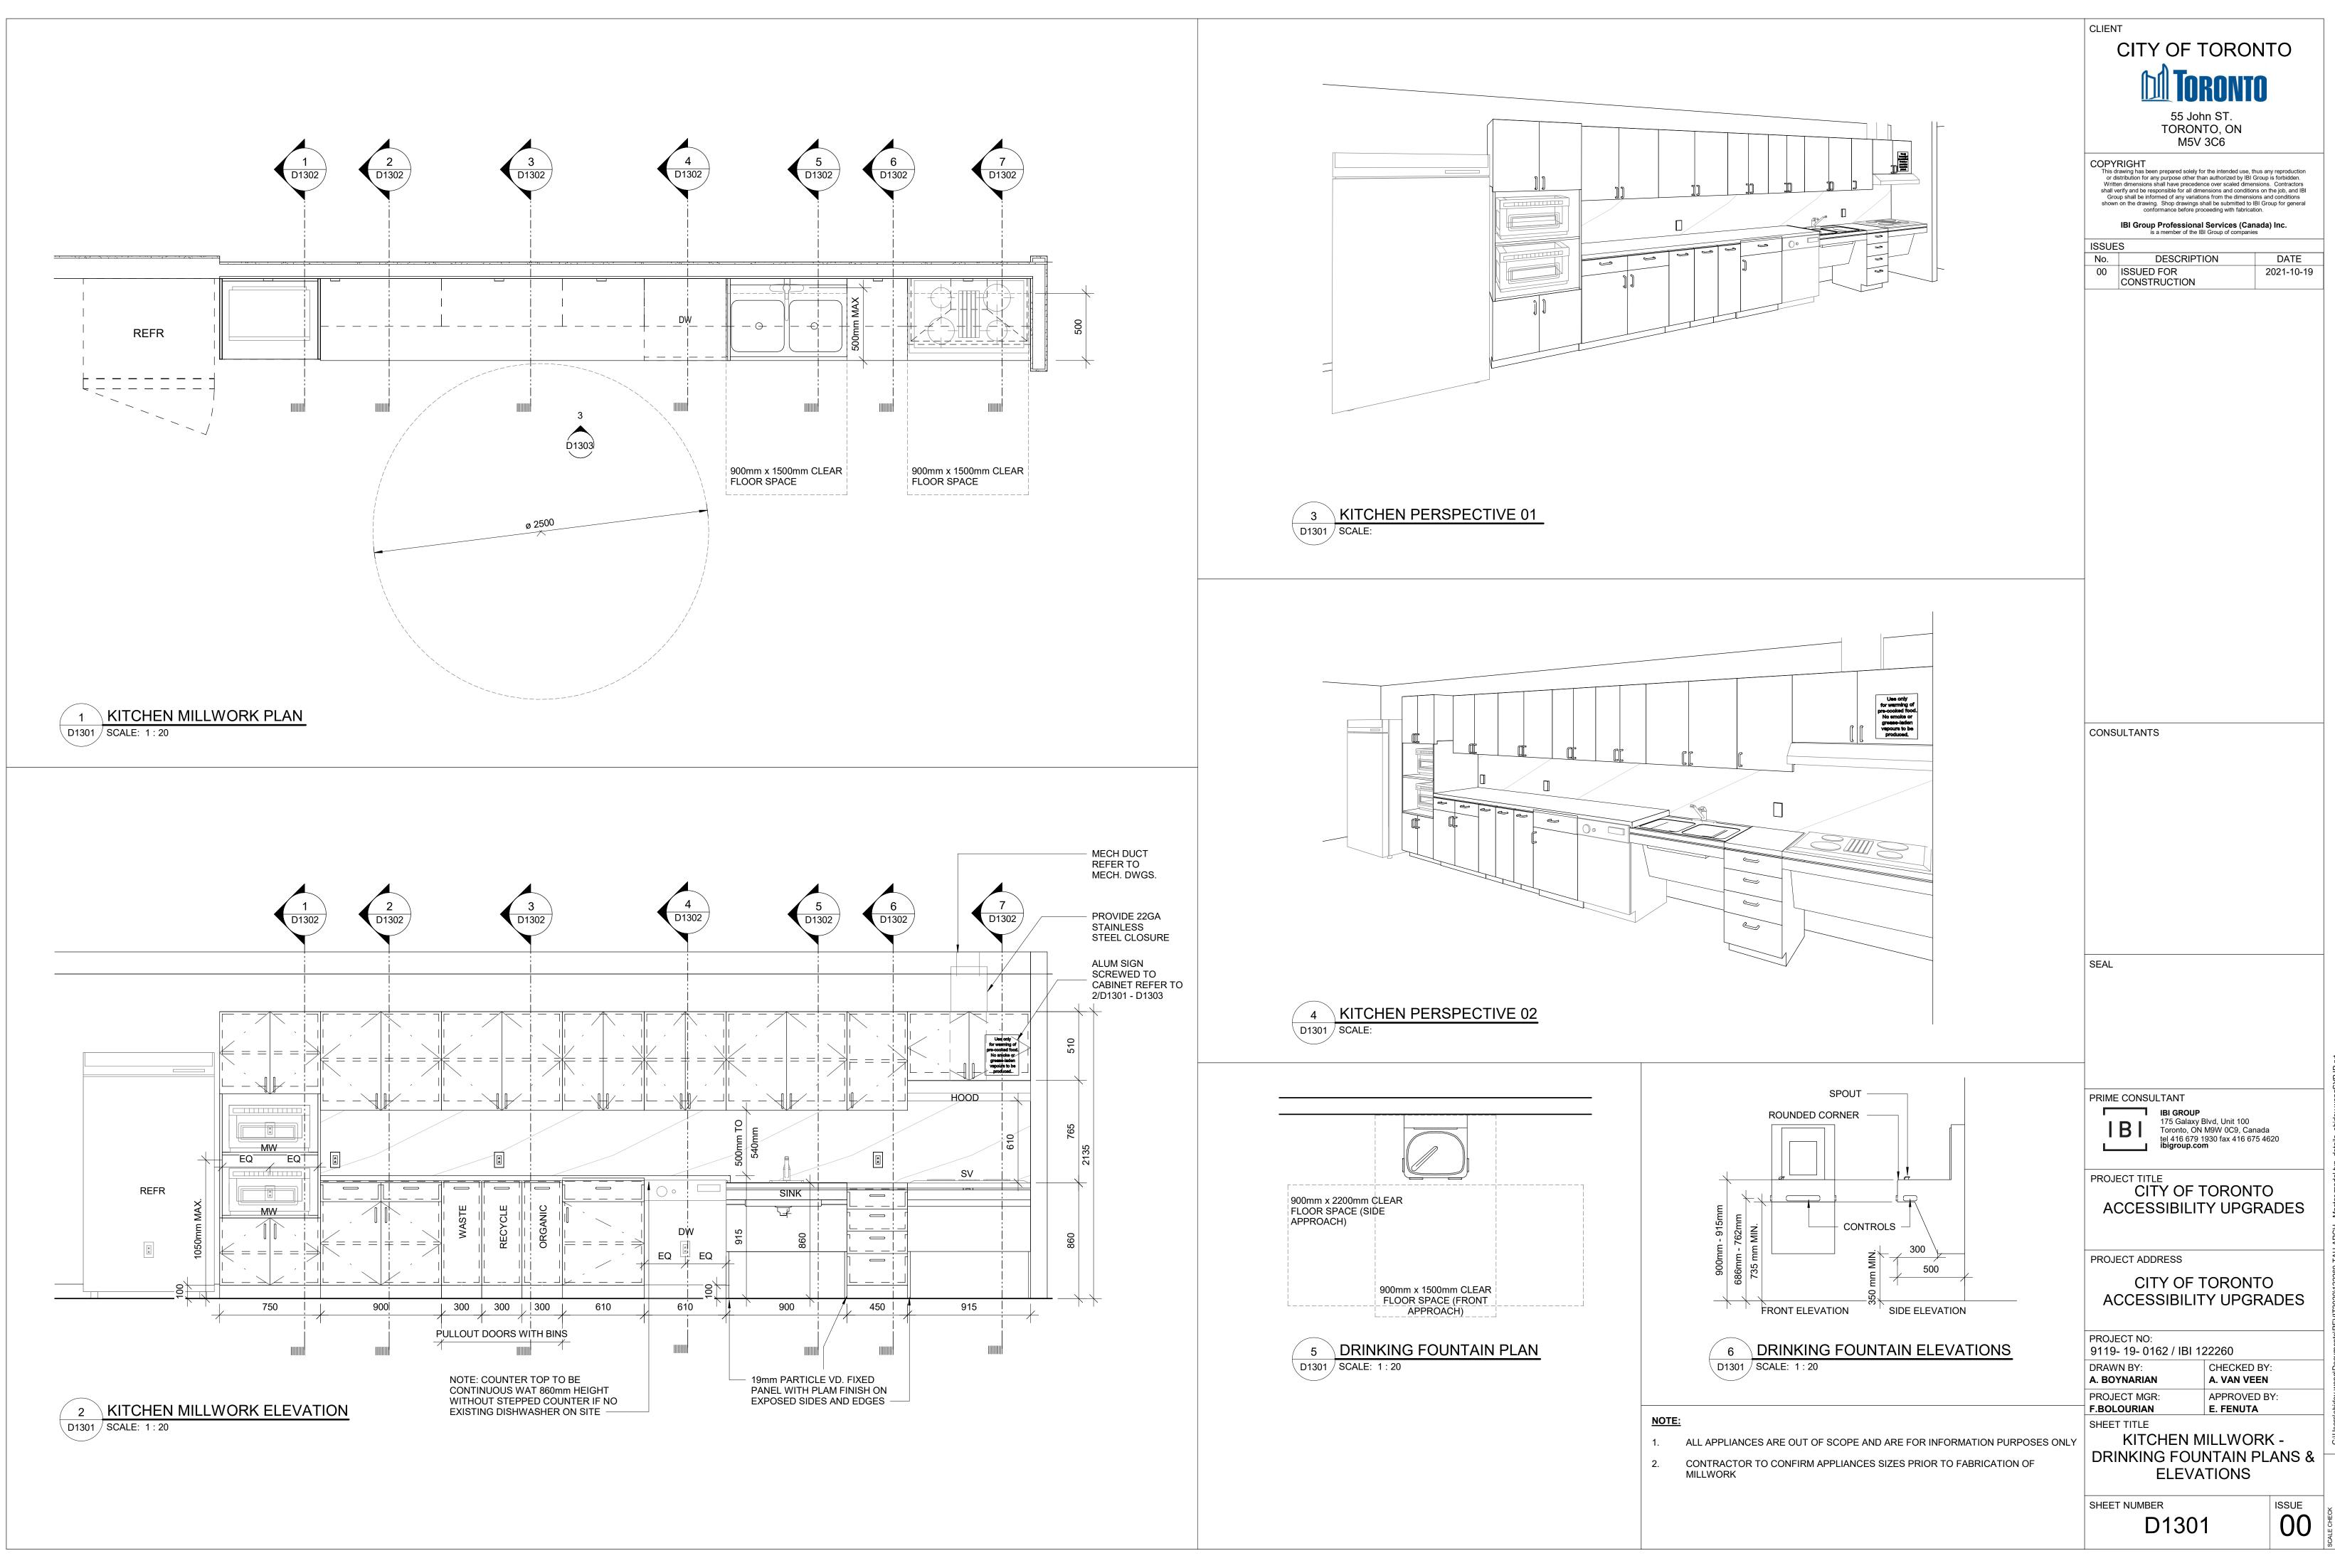
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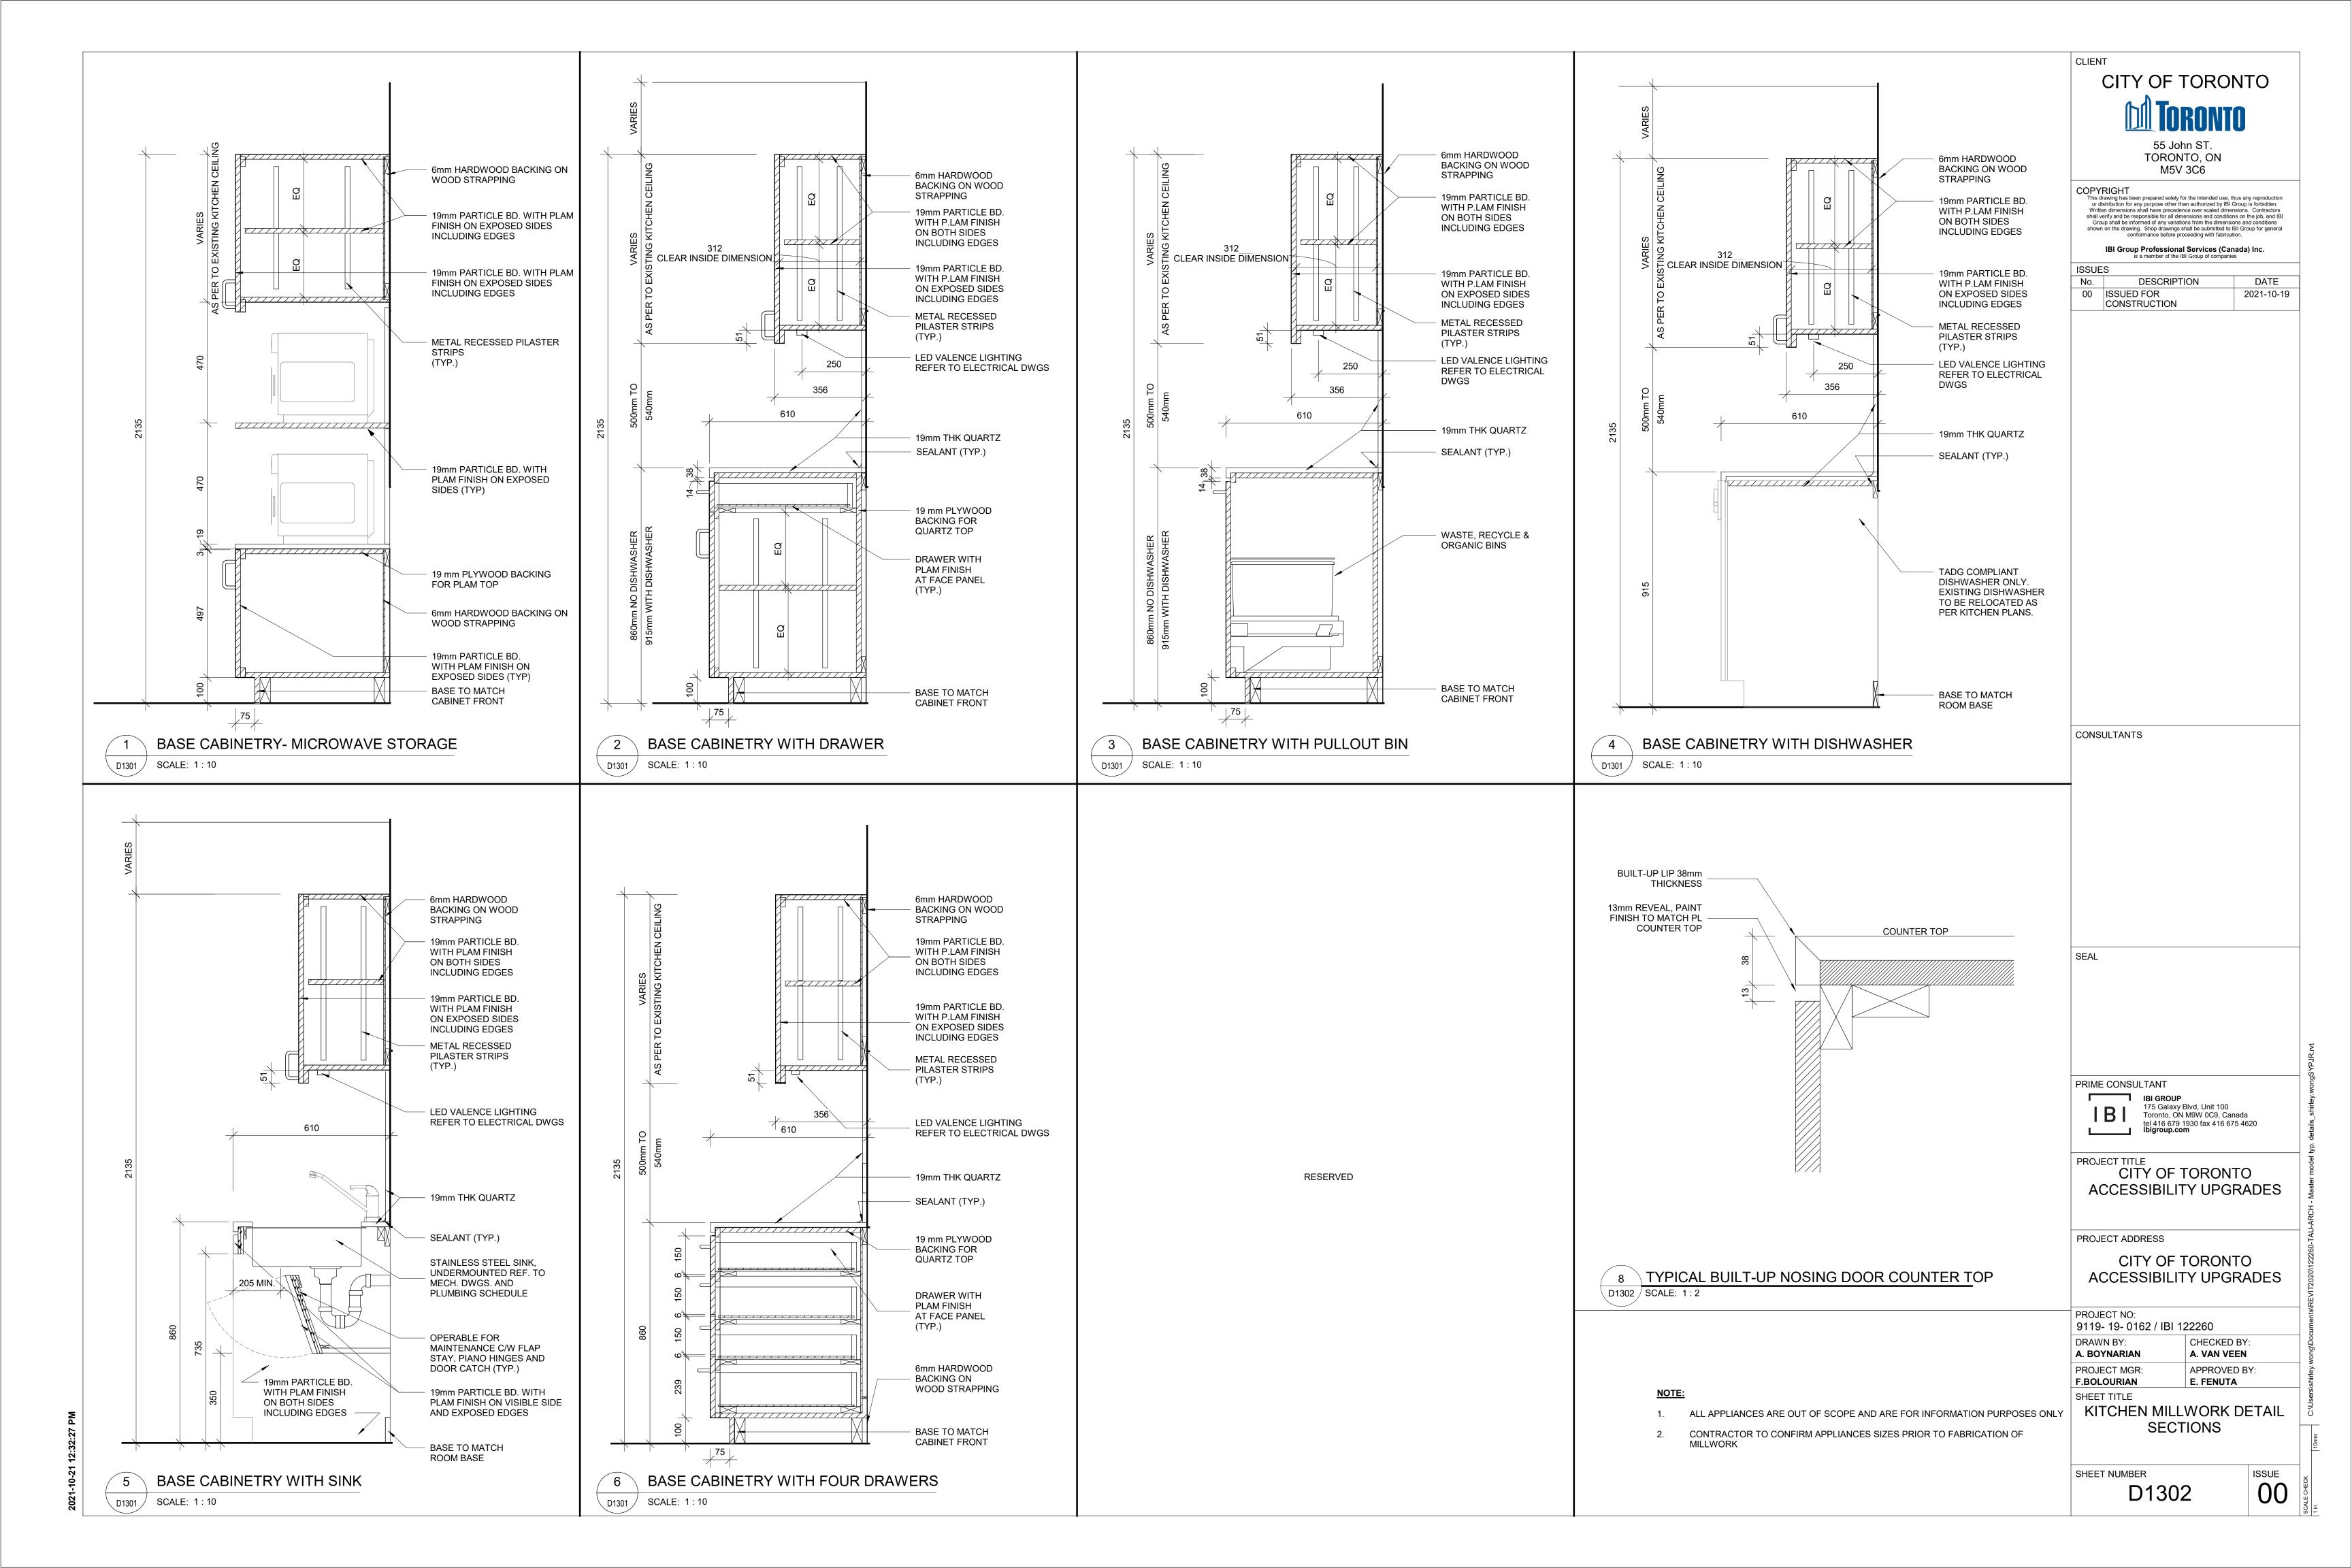
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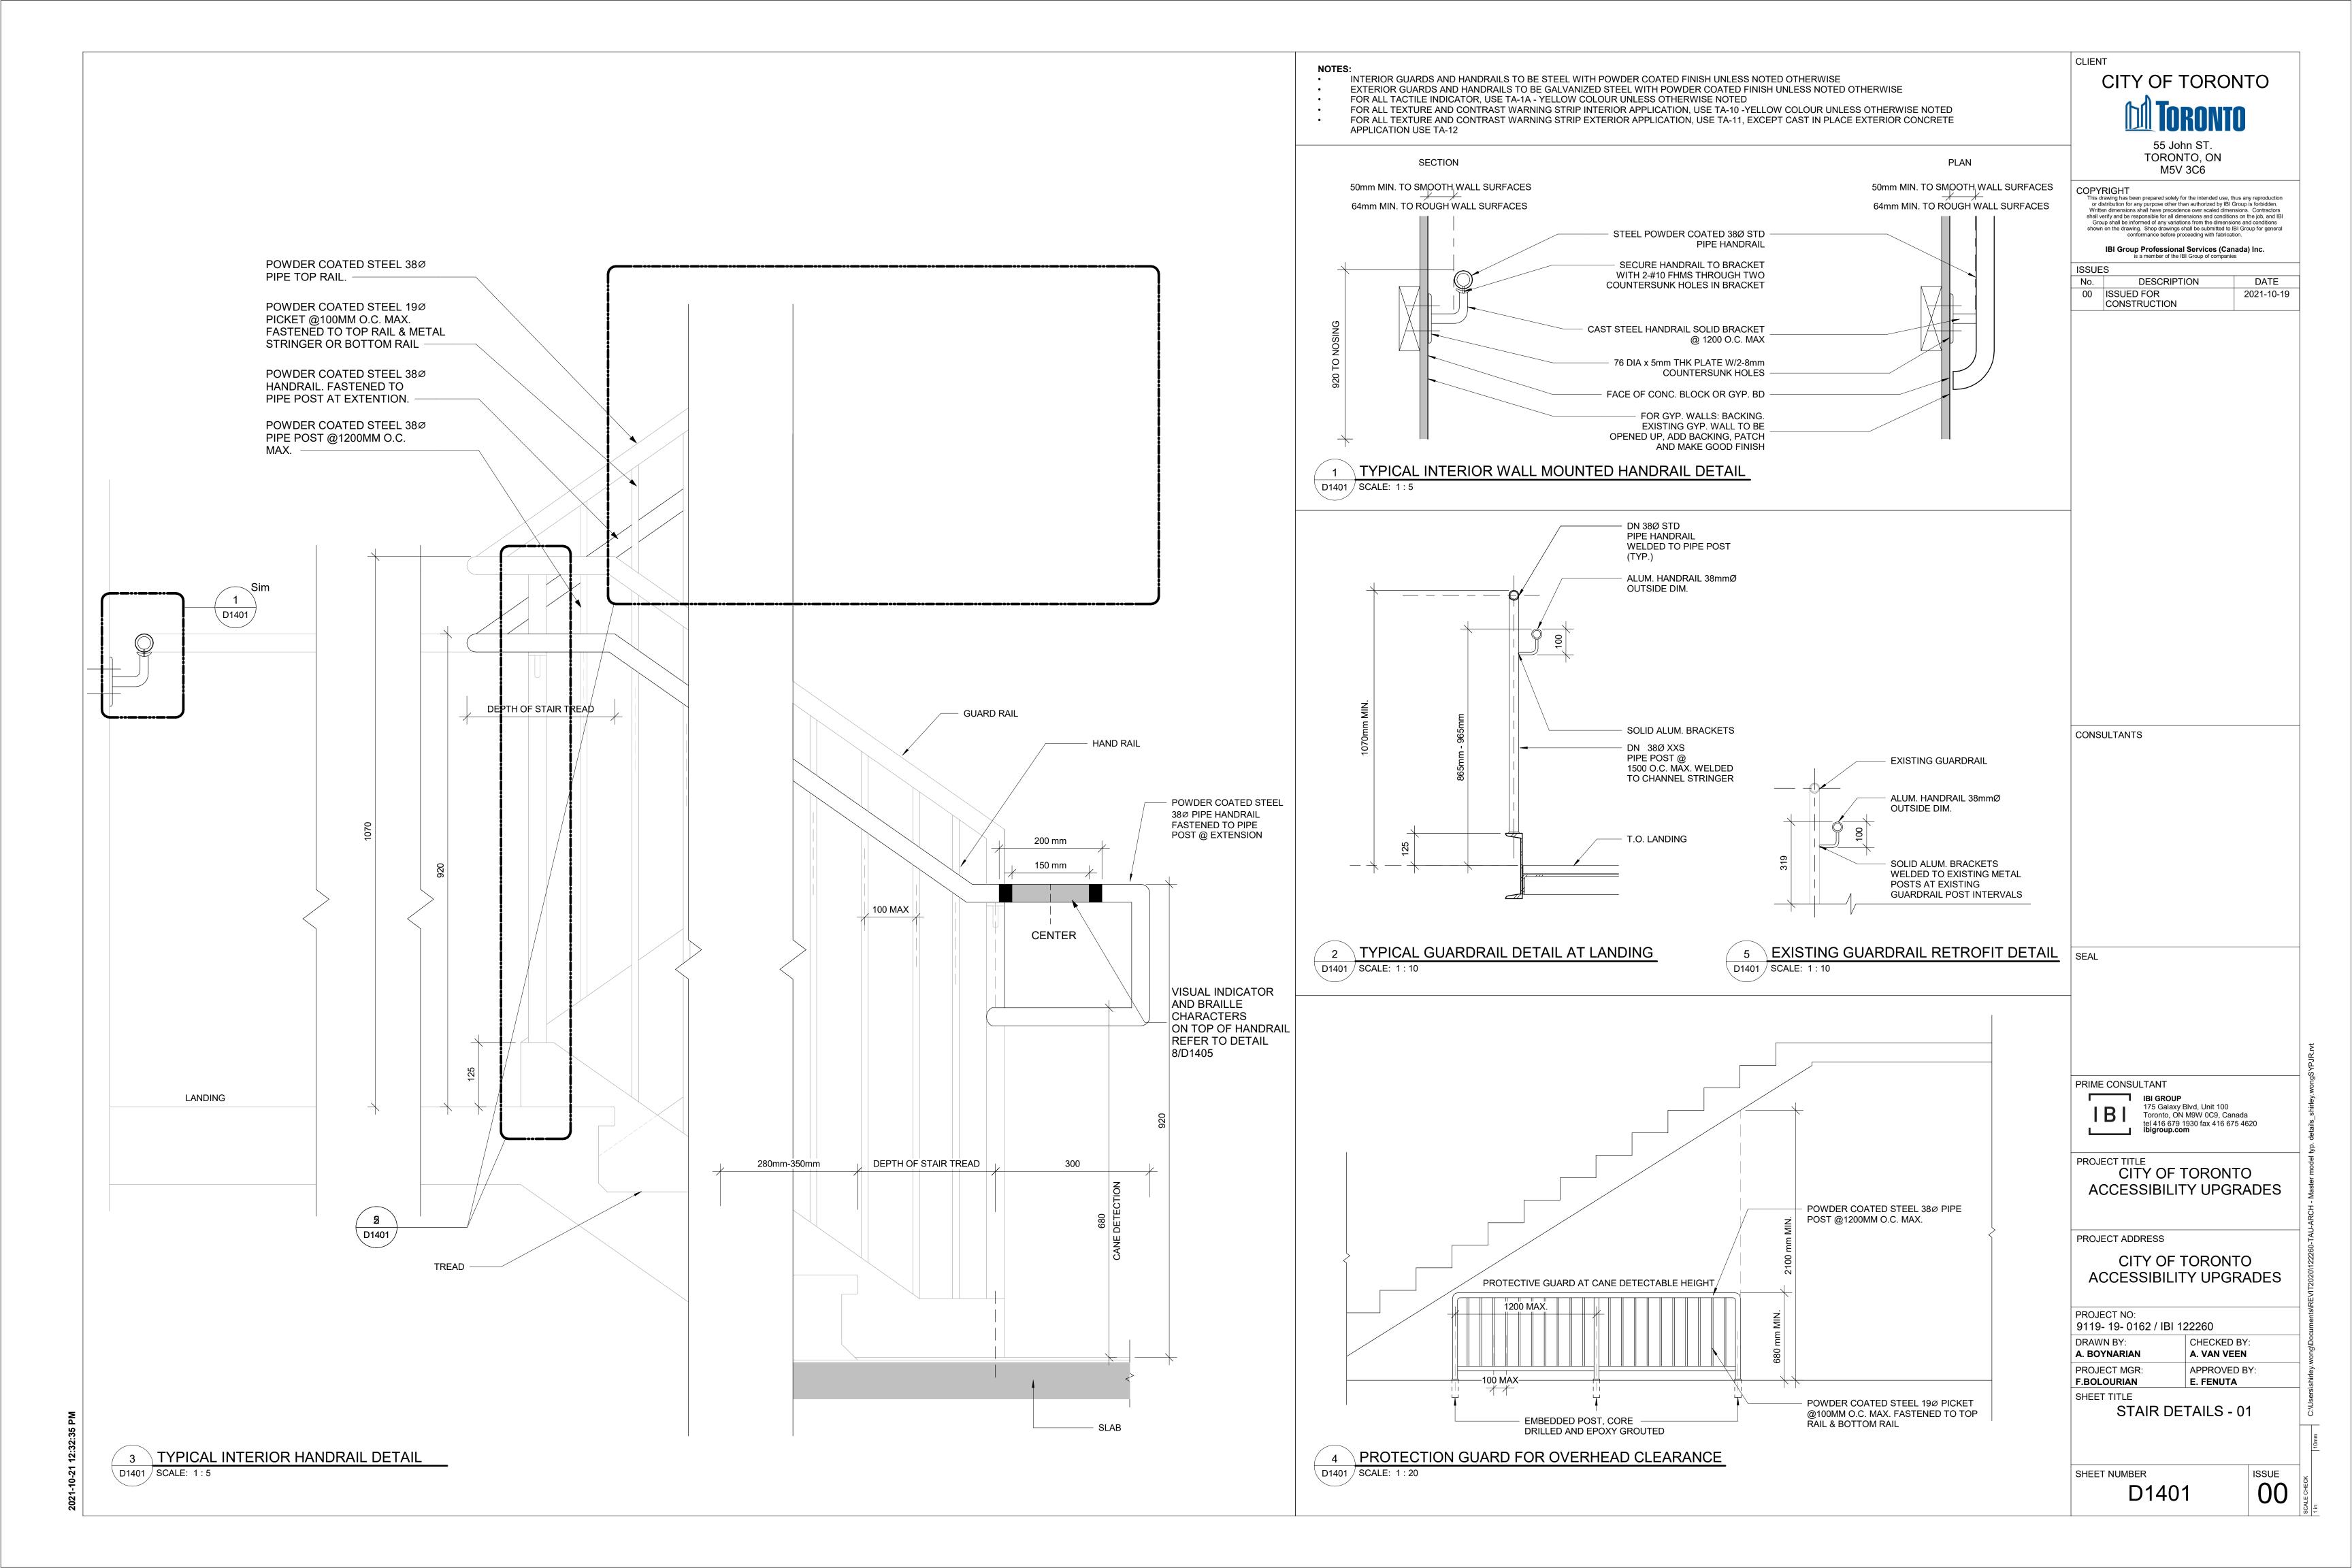
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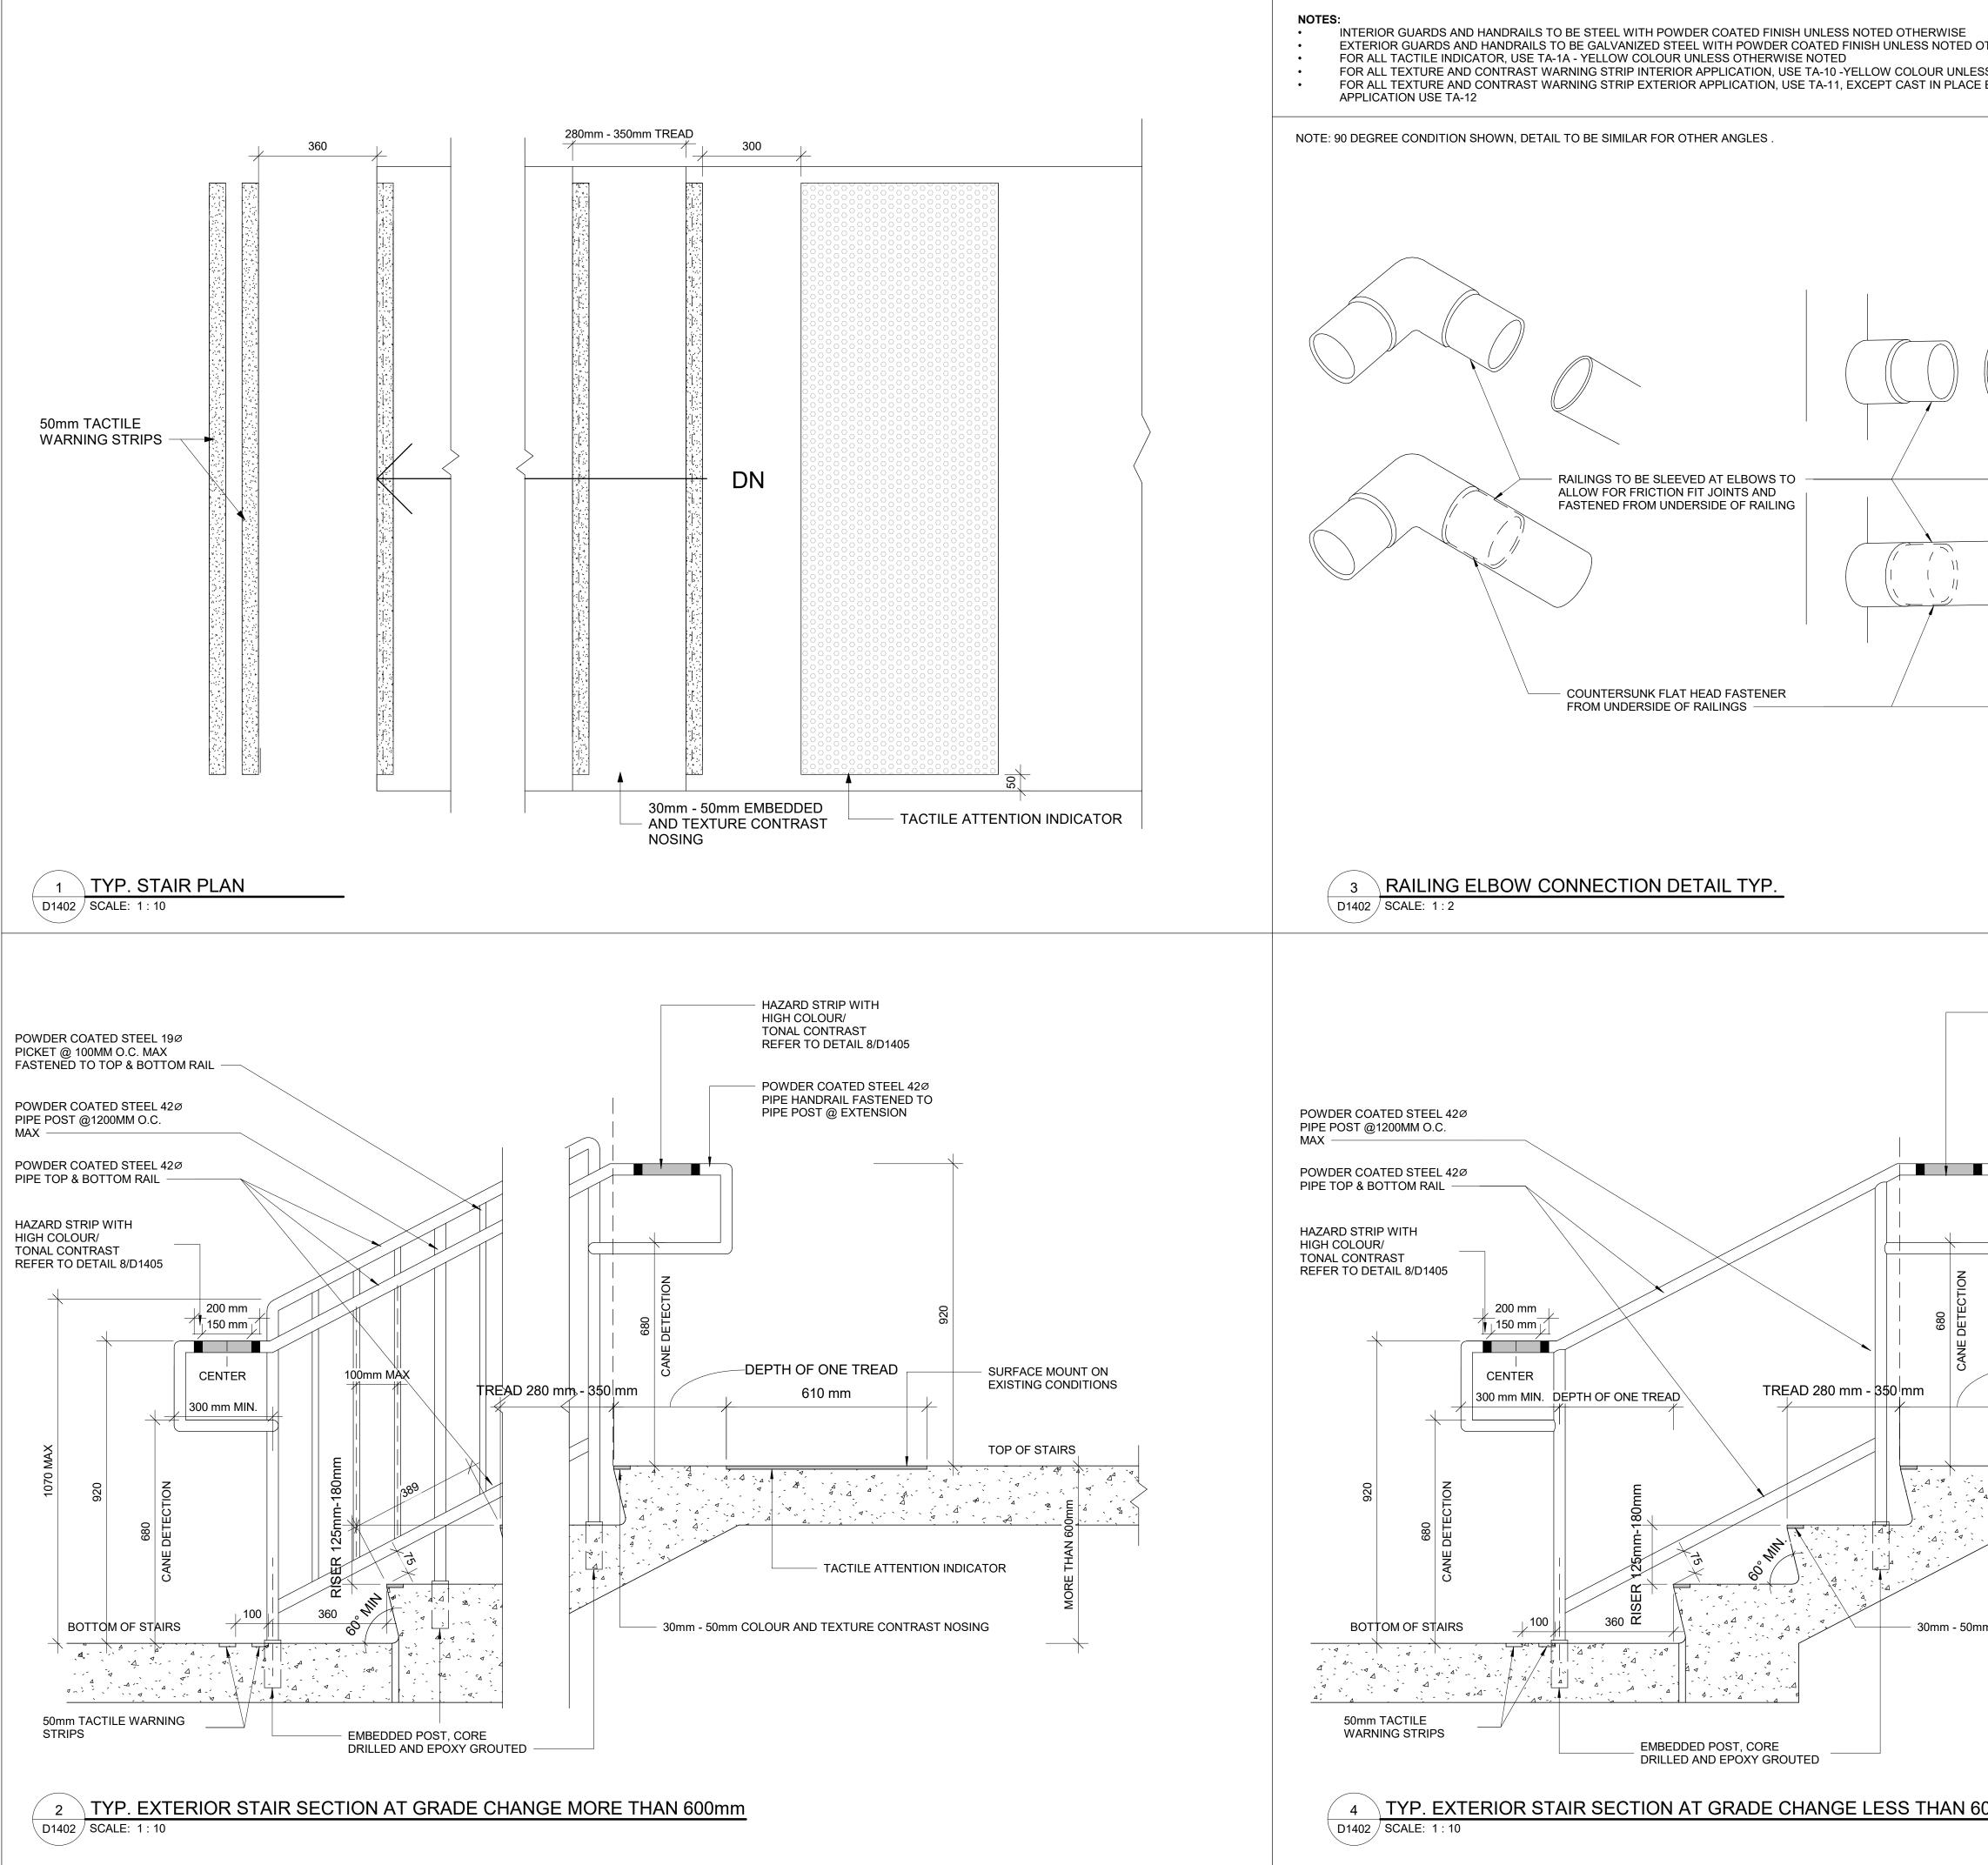
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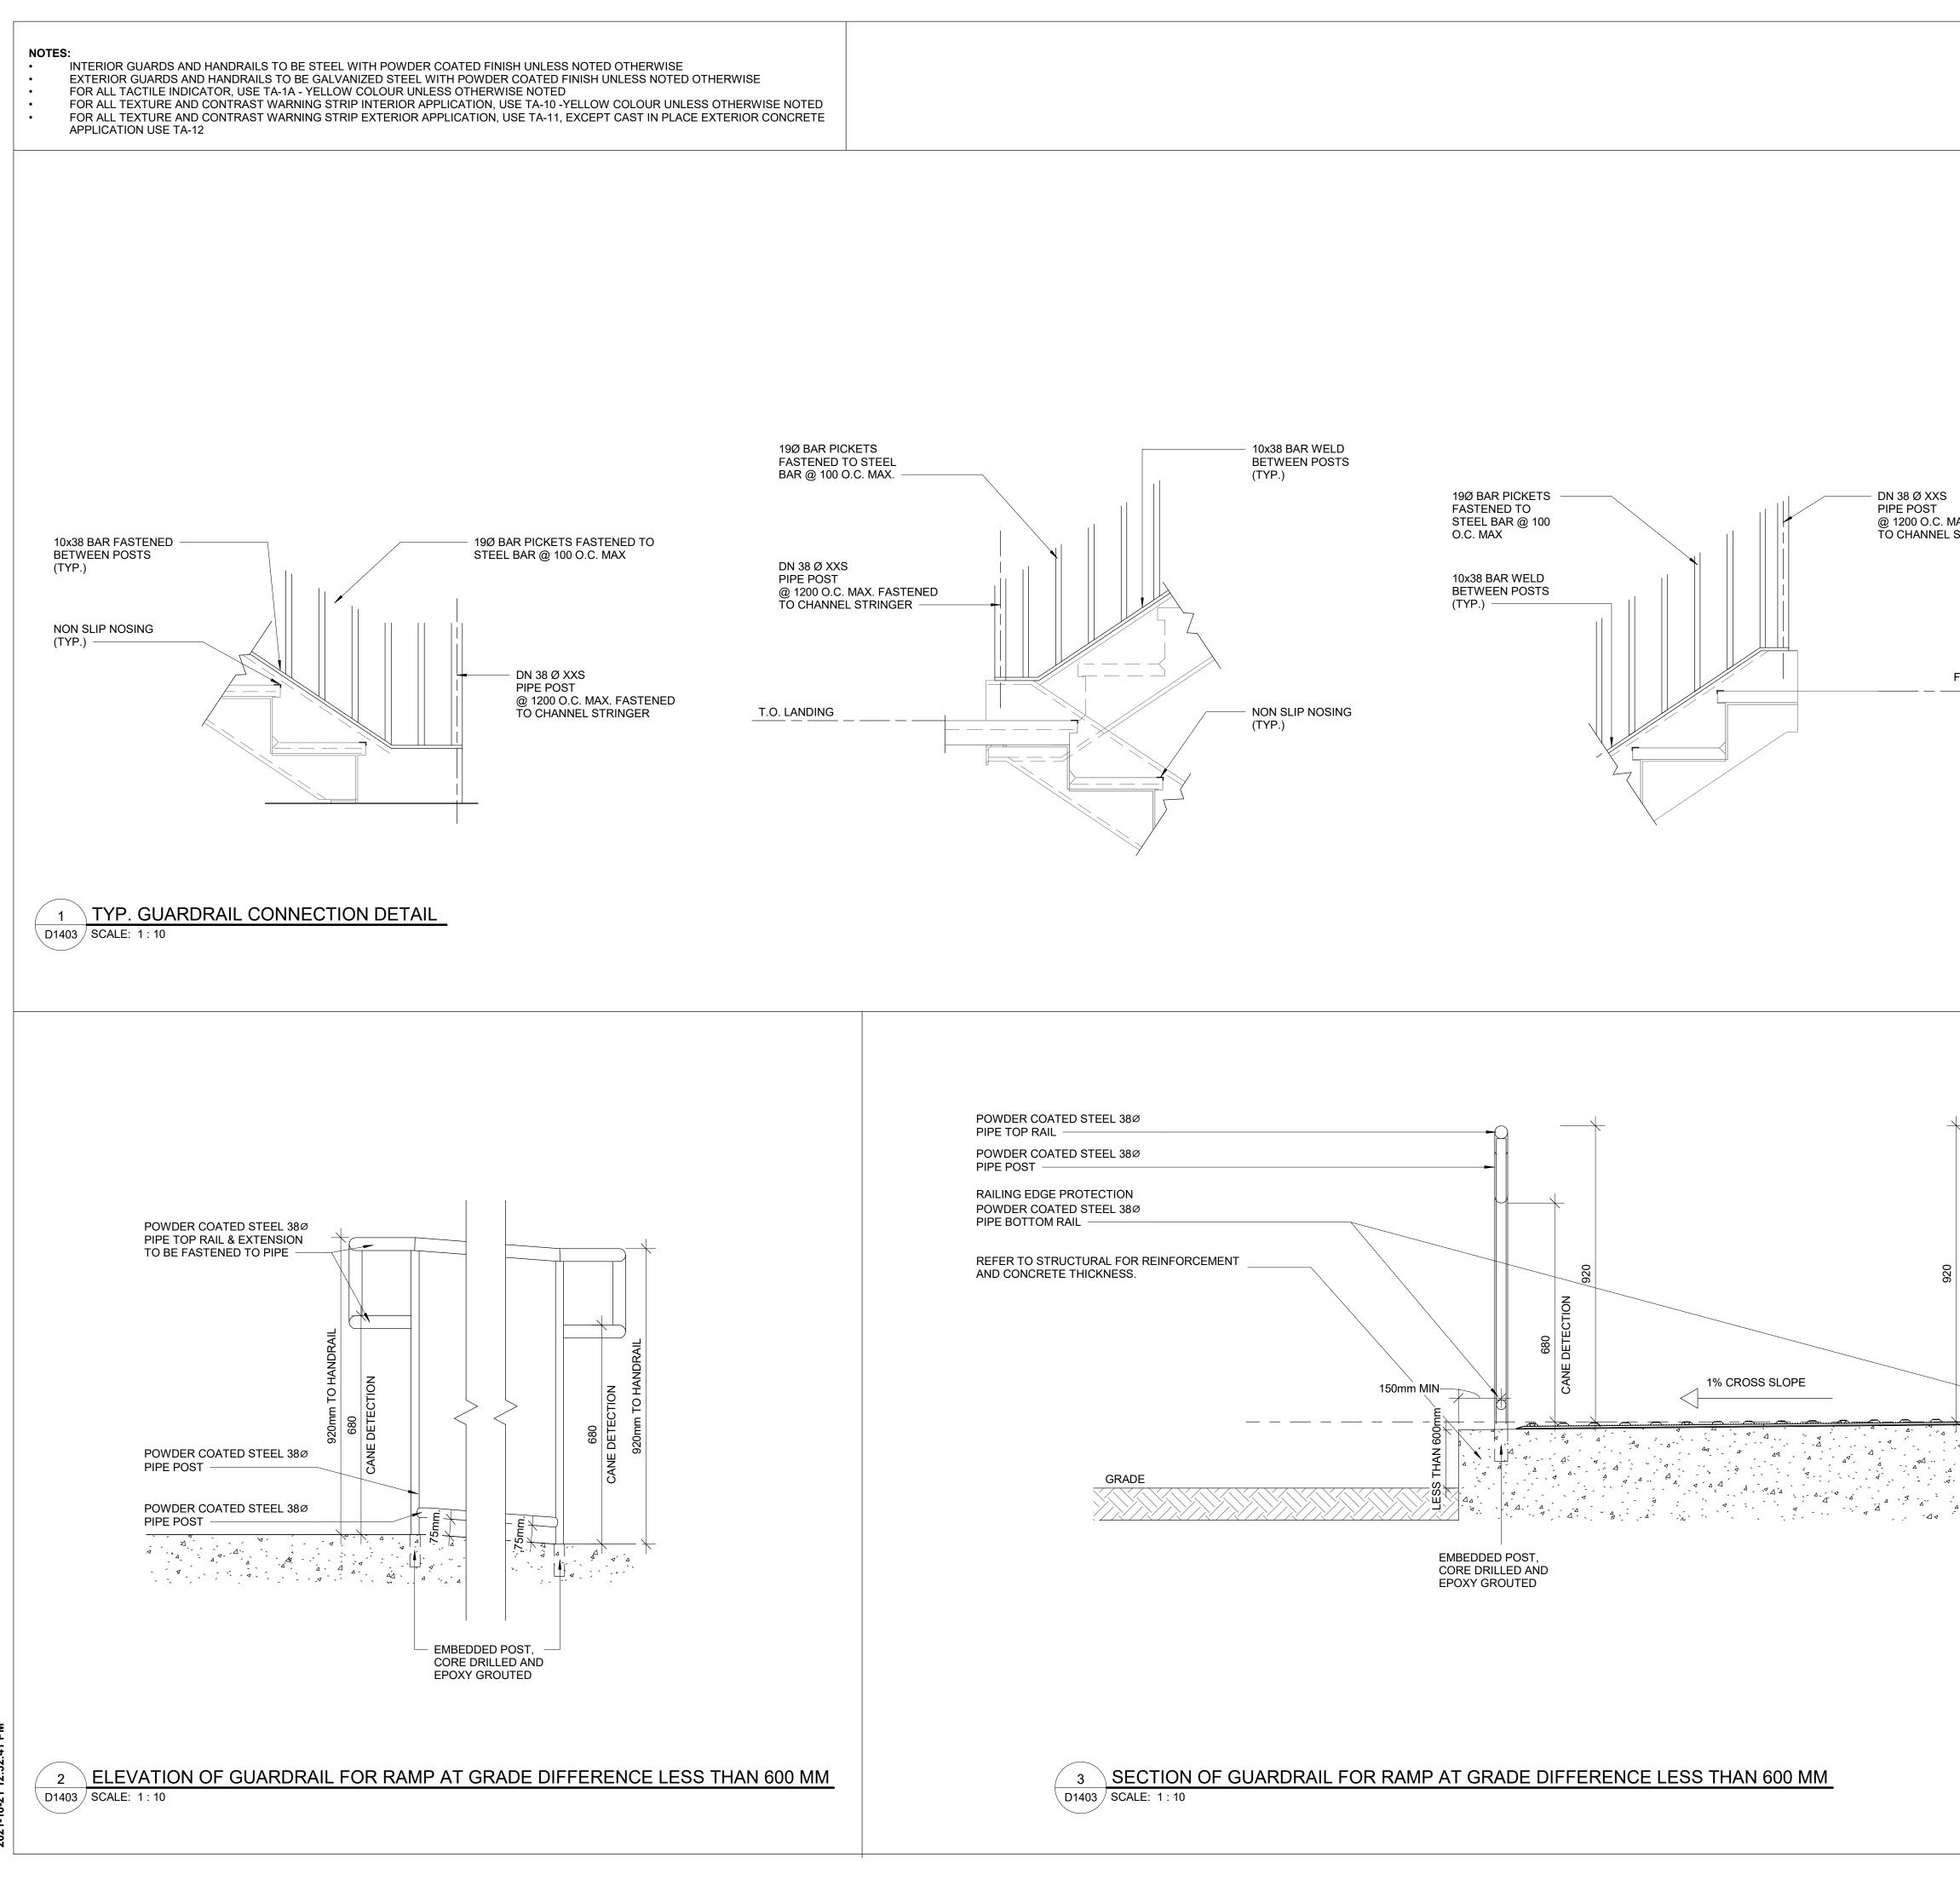
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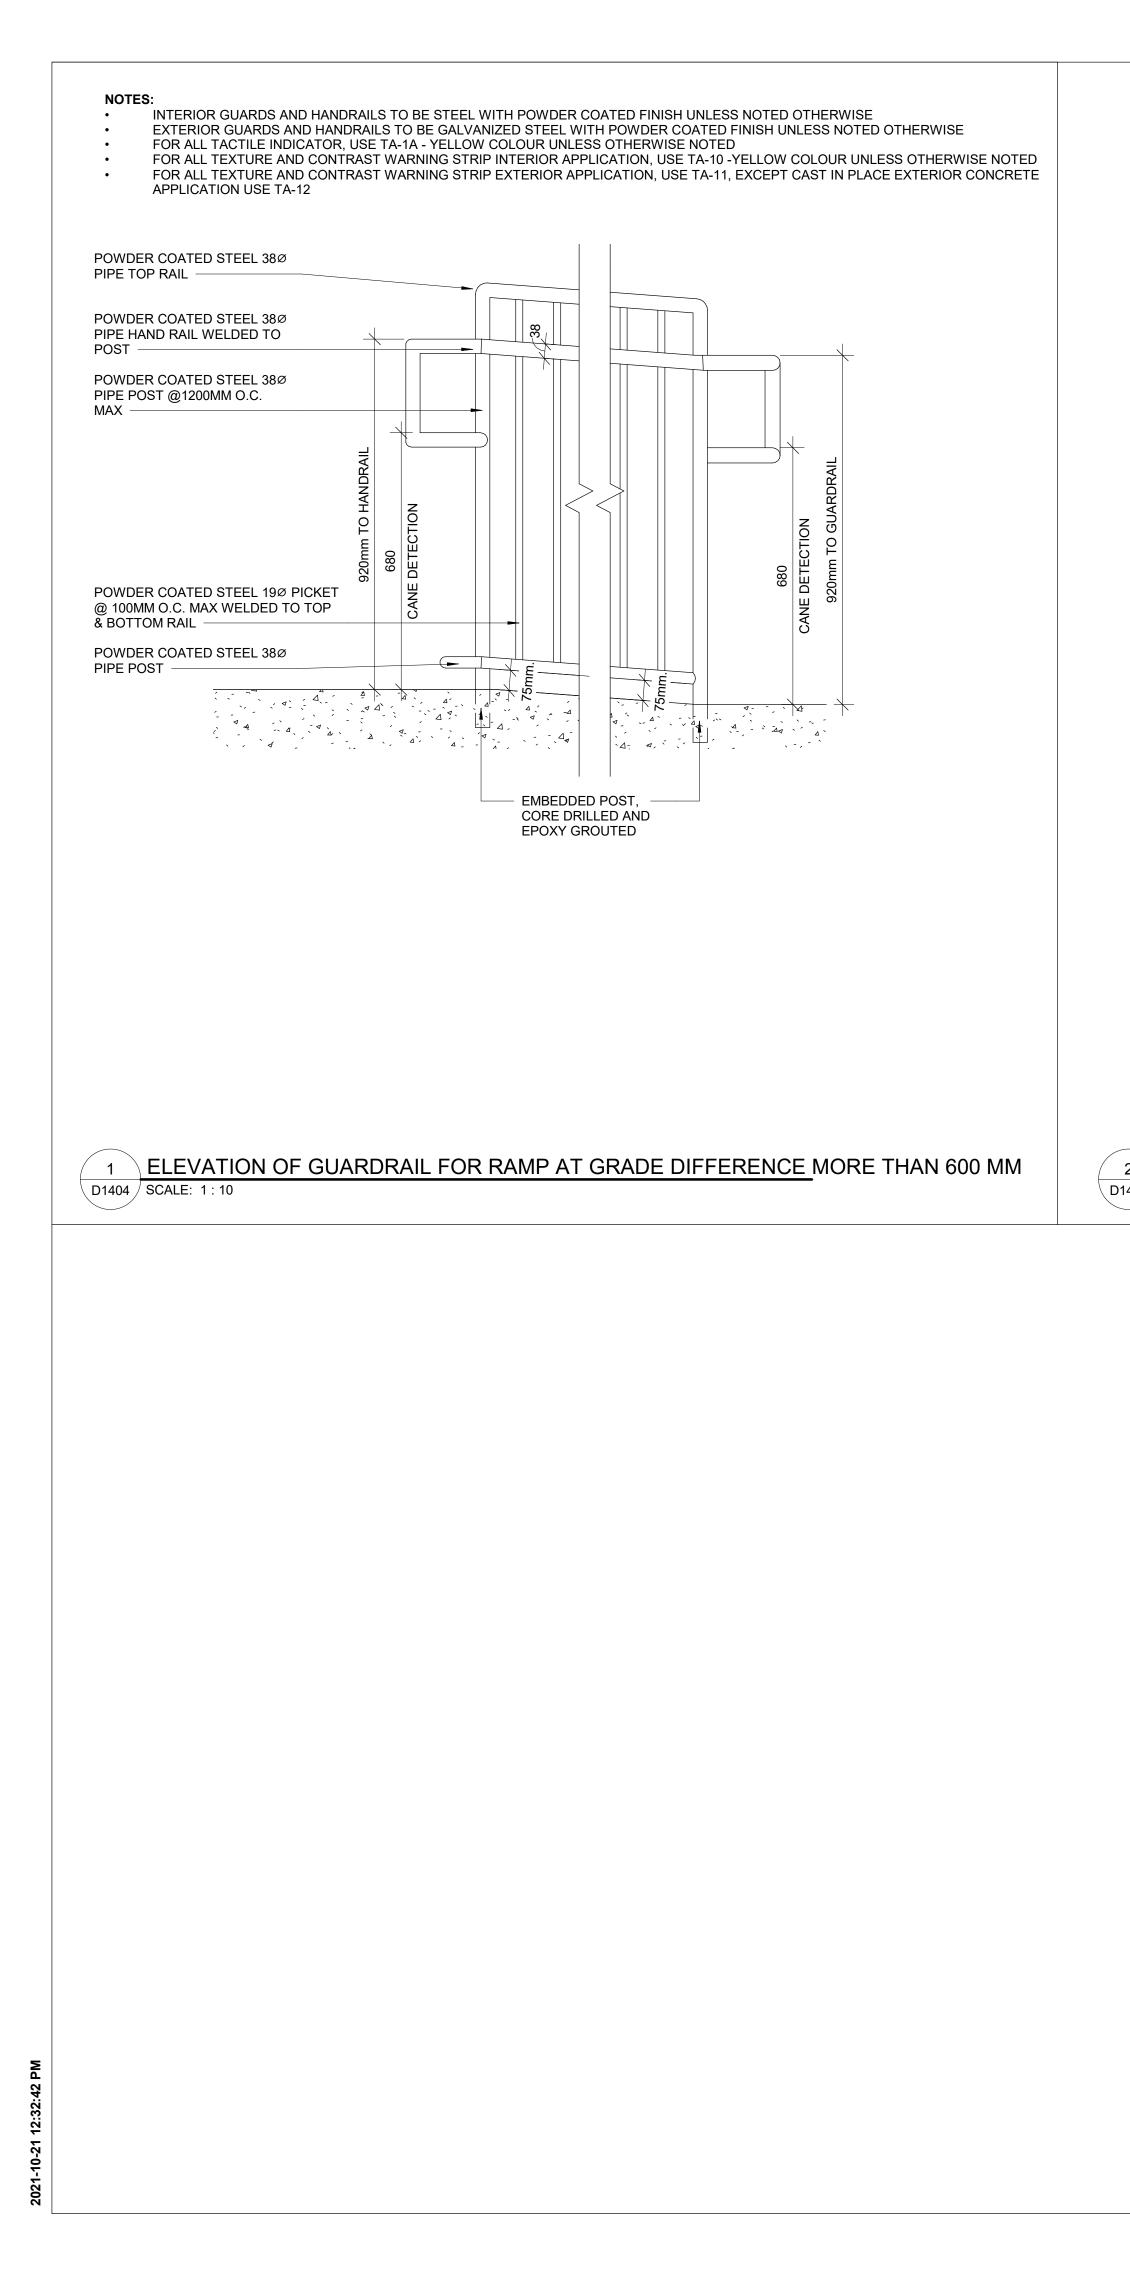


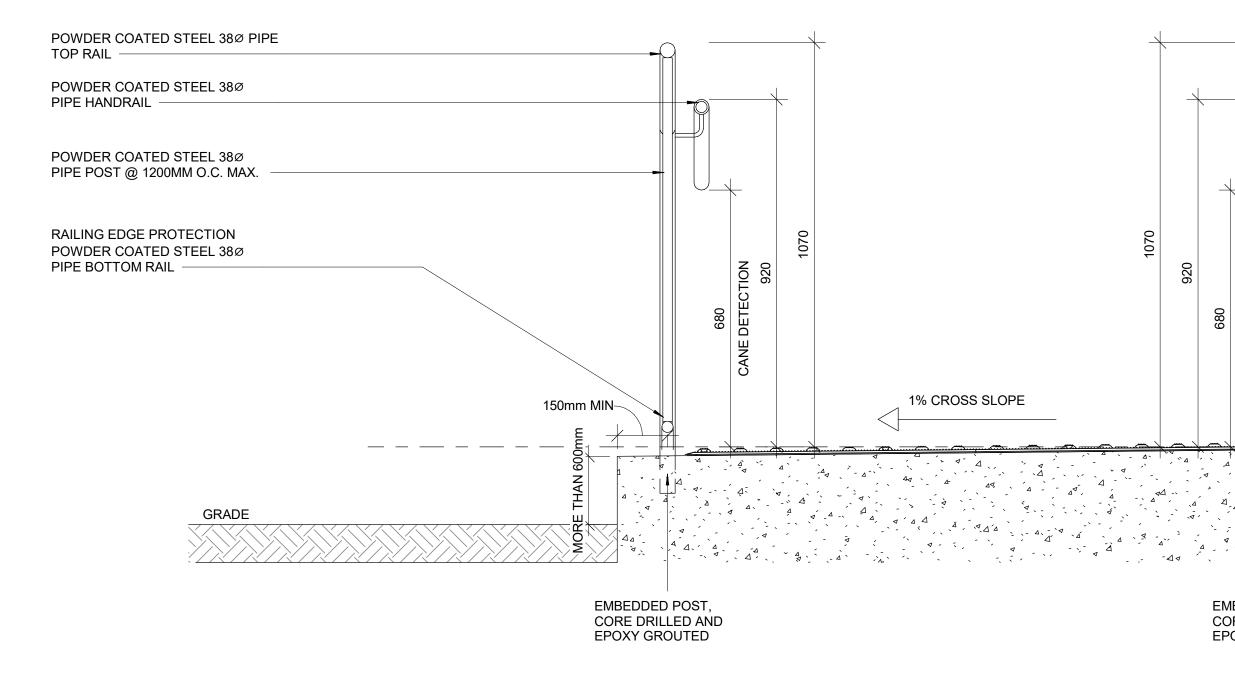
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TA - 1a EXTERIOR AND INTERIOR APPLICATION

| | -/ | VARIES (610mm - 915mm - 1220mm) | | | | | | | | | | | | | | |
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VARIES (610mm - 915mm - 1220mm)

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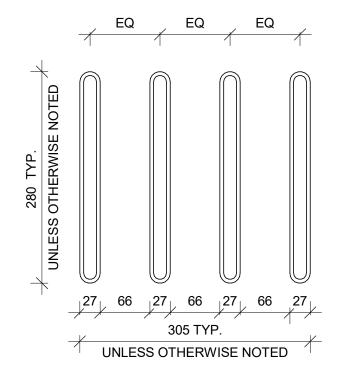
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TA-8 INTERIOR APPLICATION



2 GUIDANCE BARS PLAN D1405 SCALE: 1:5

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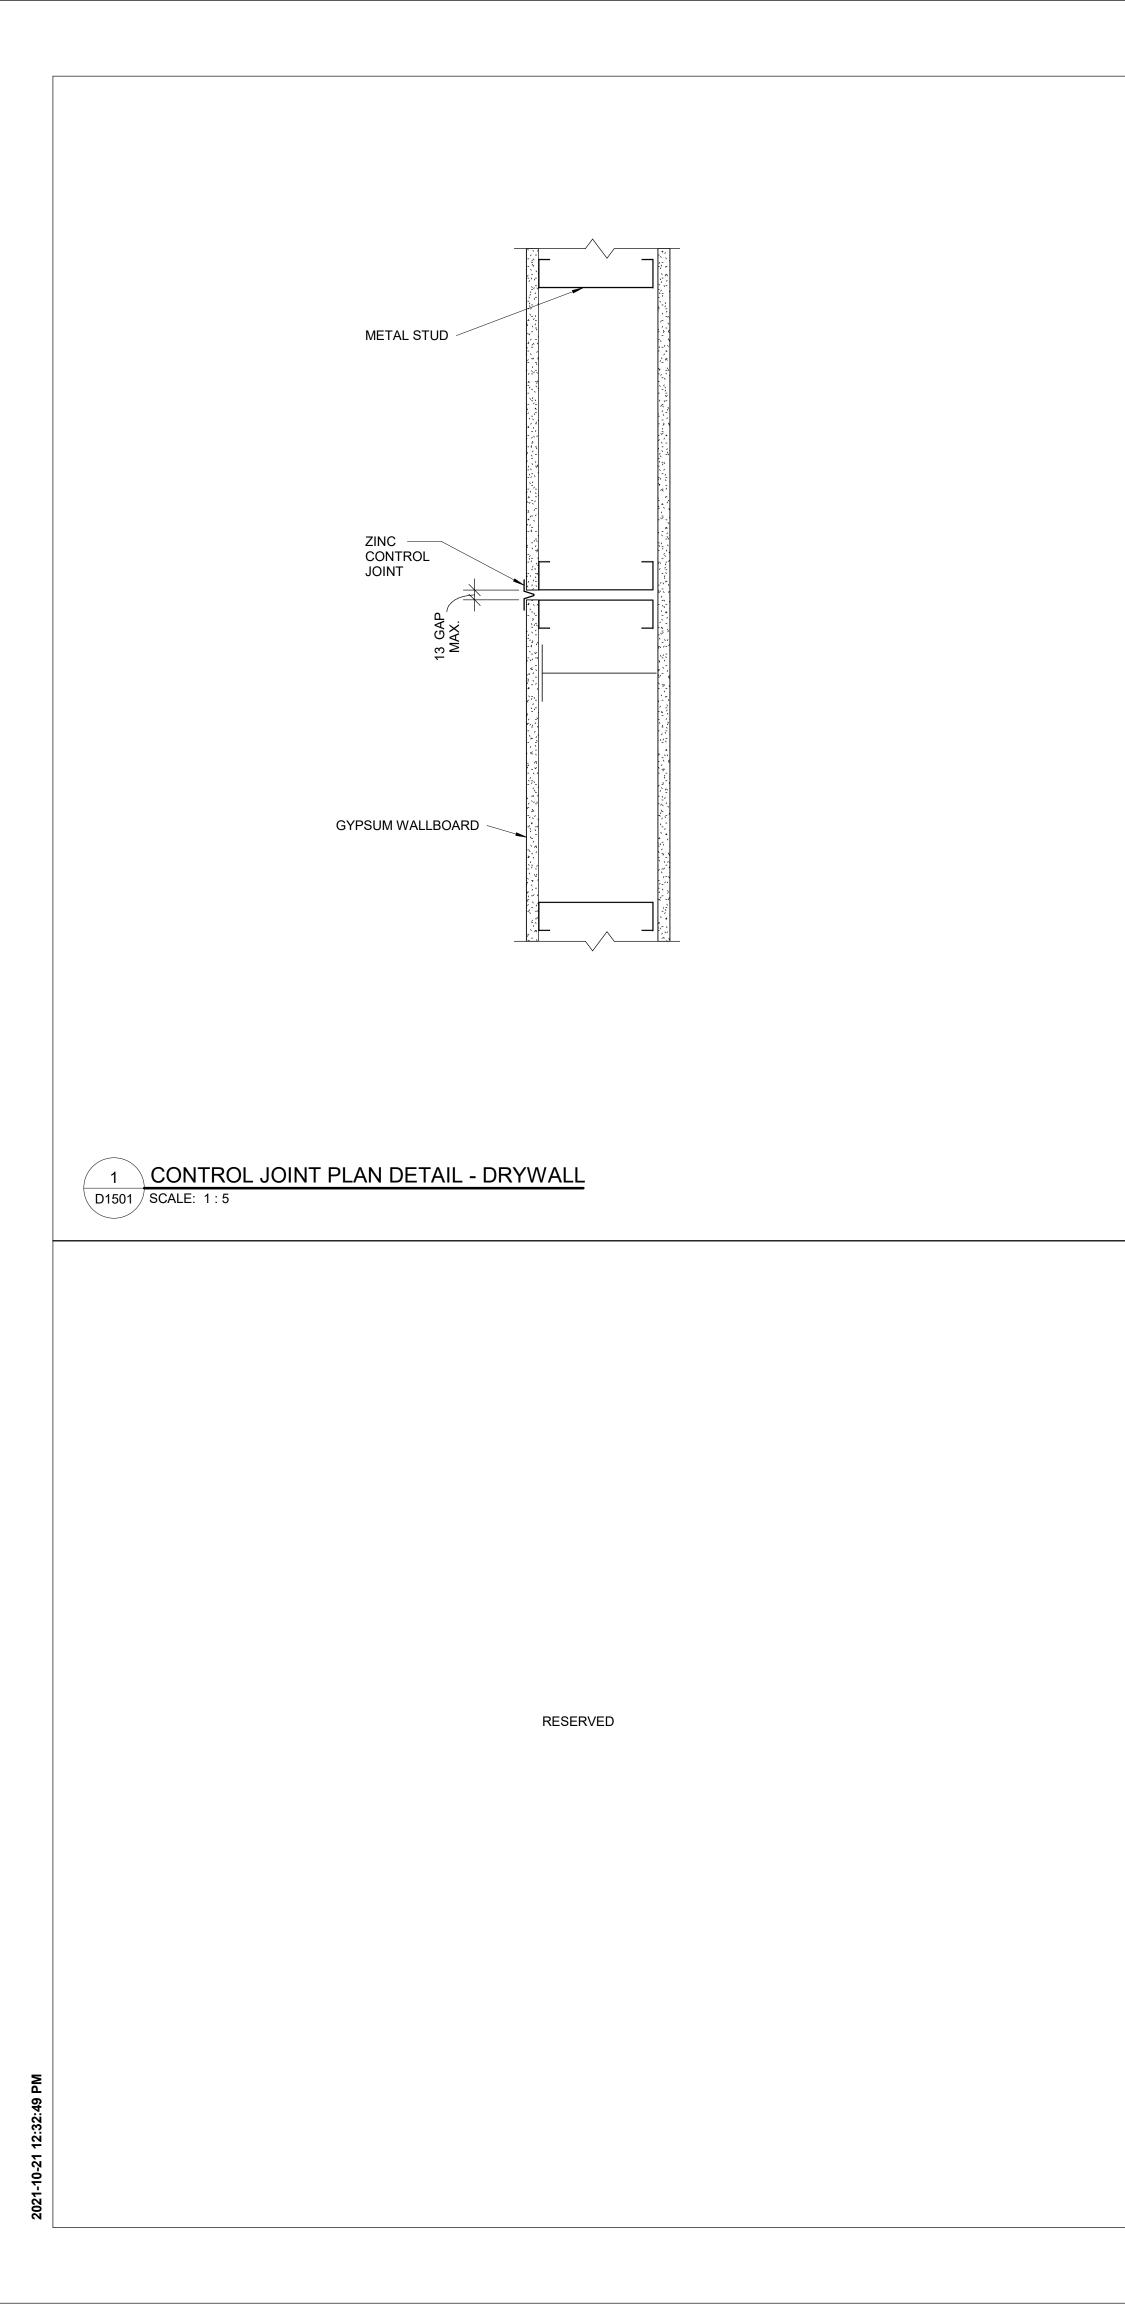
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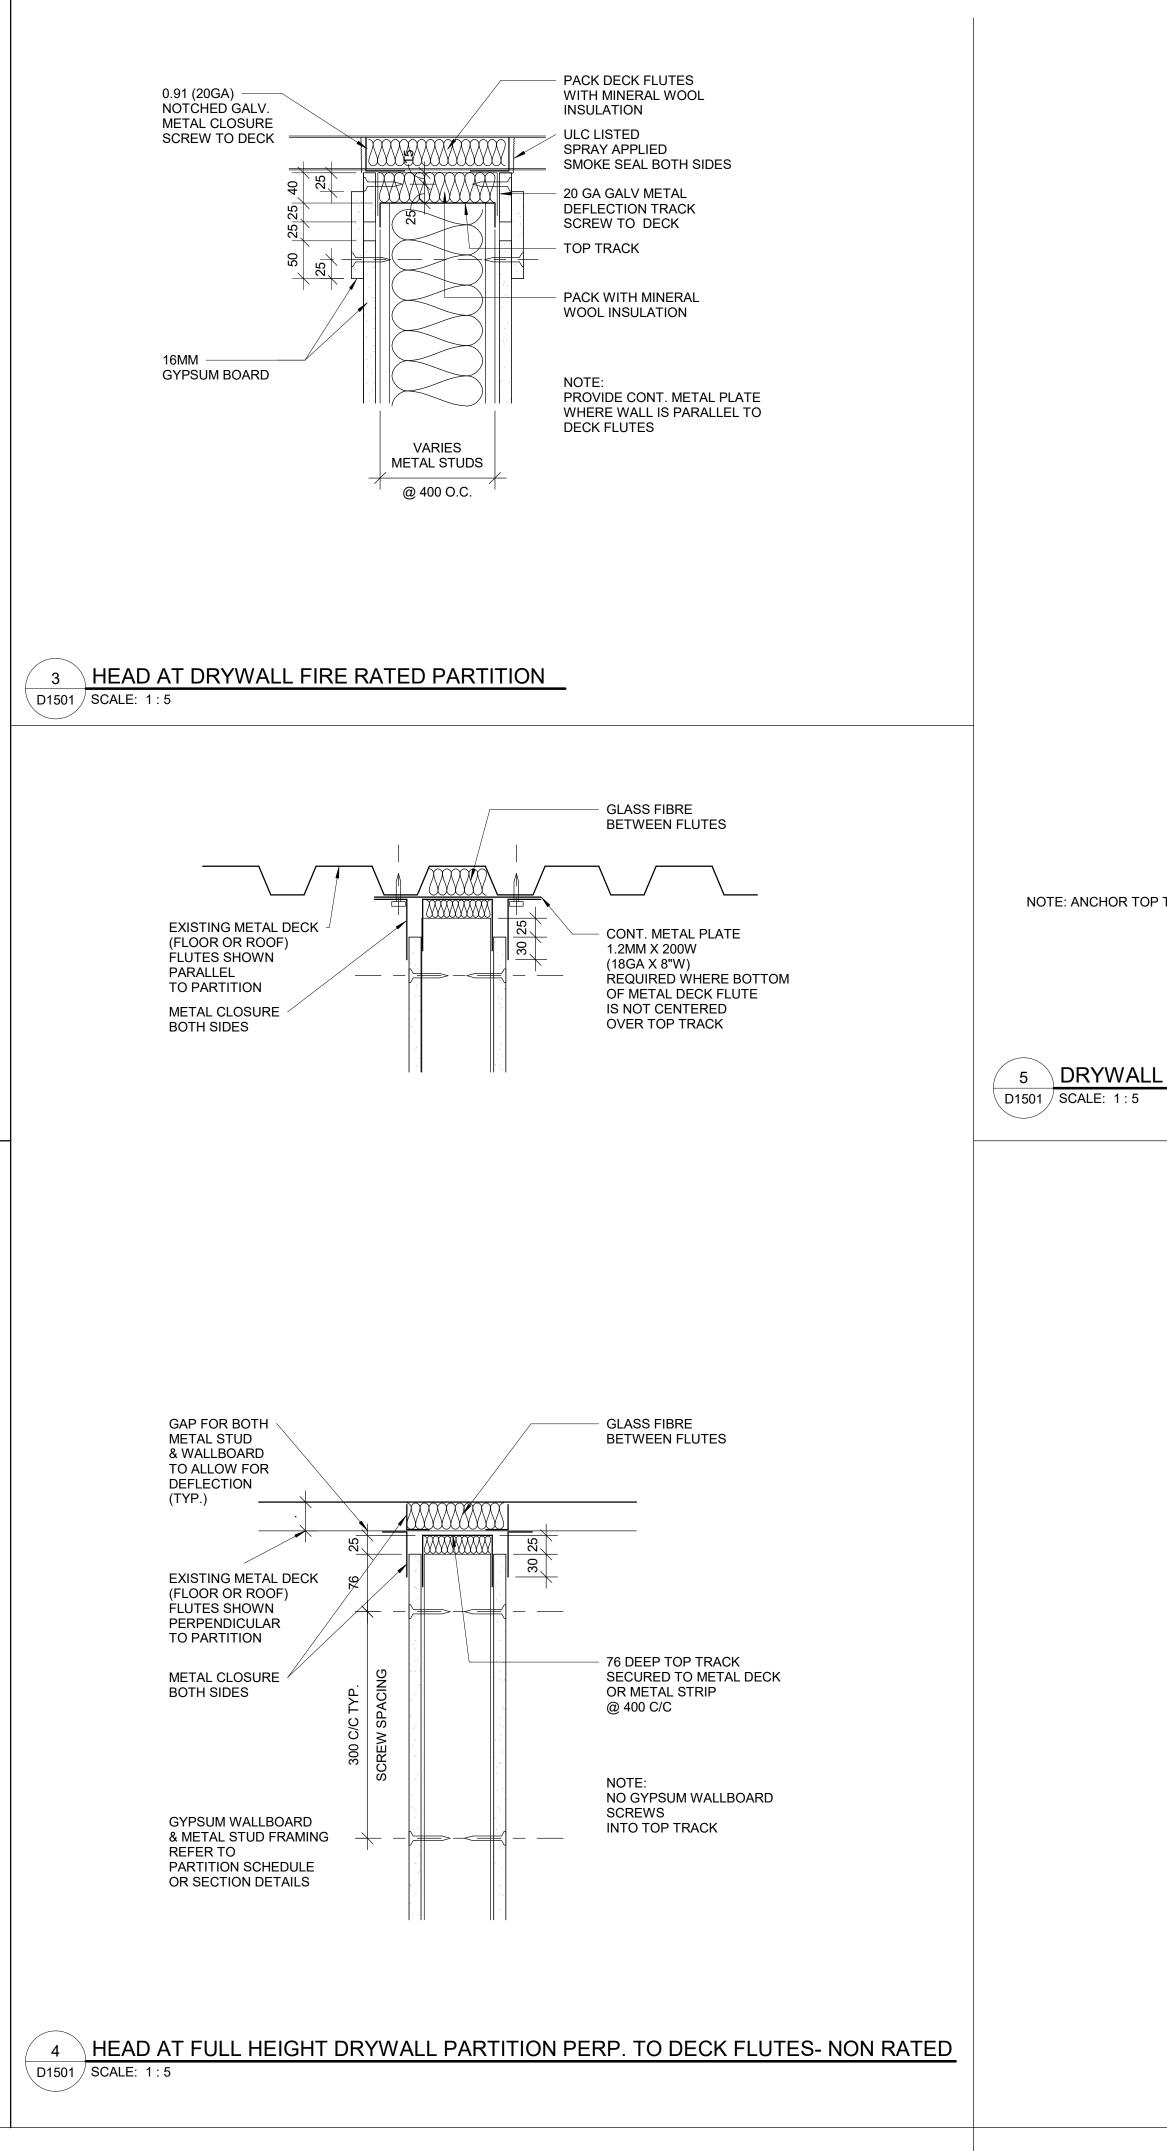
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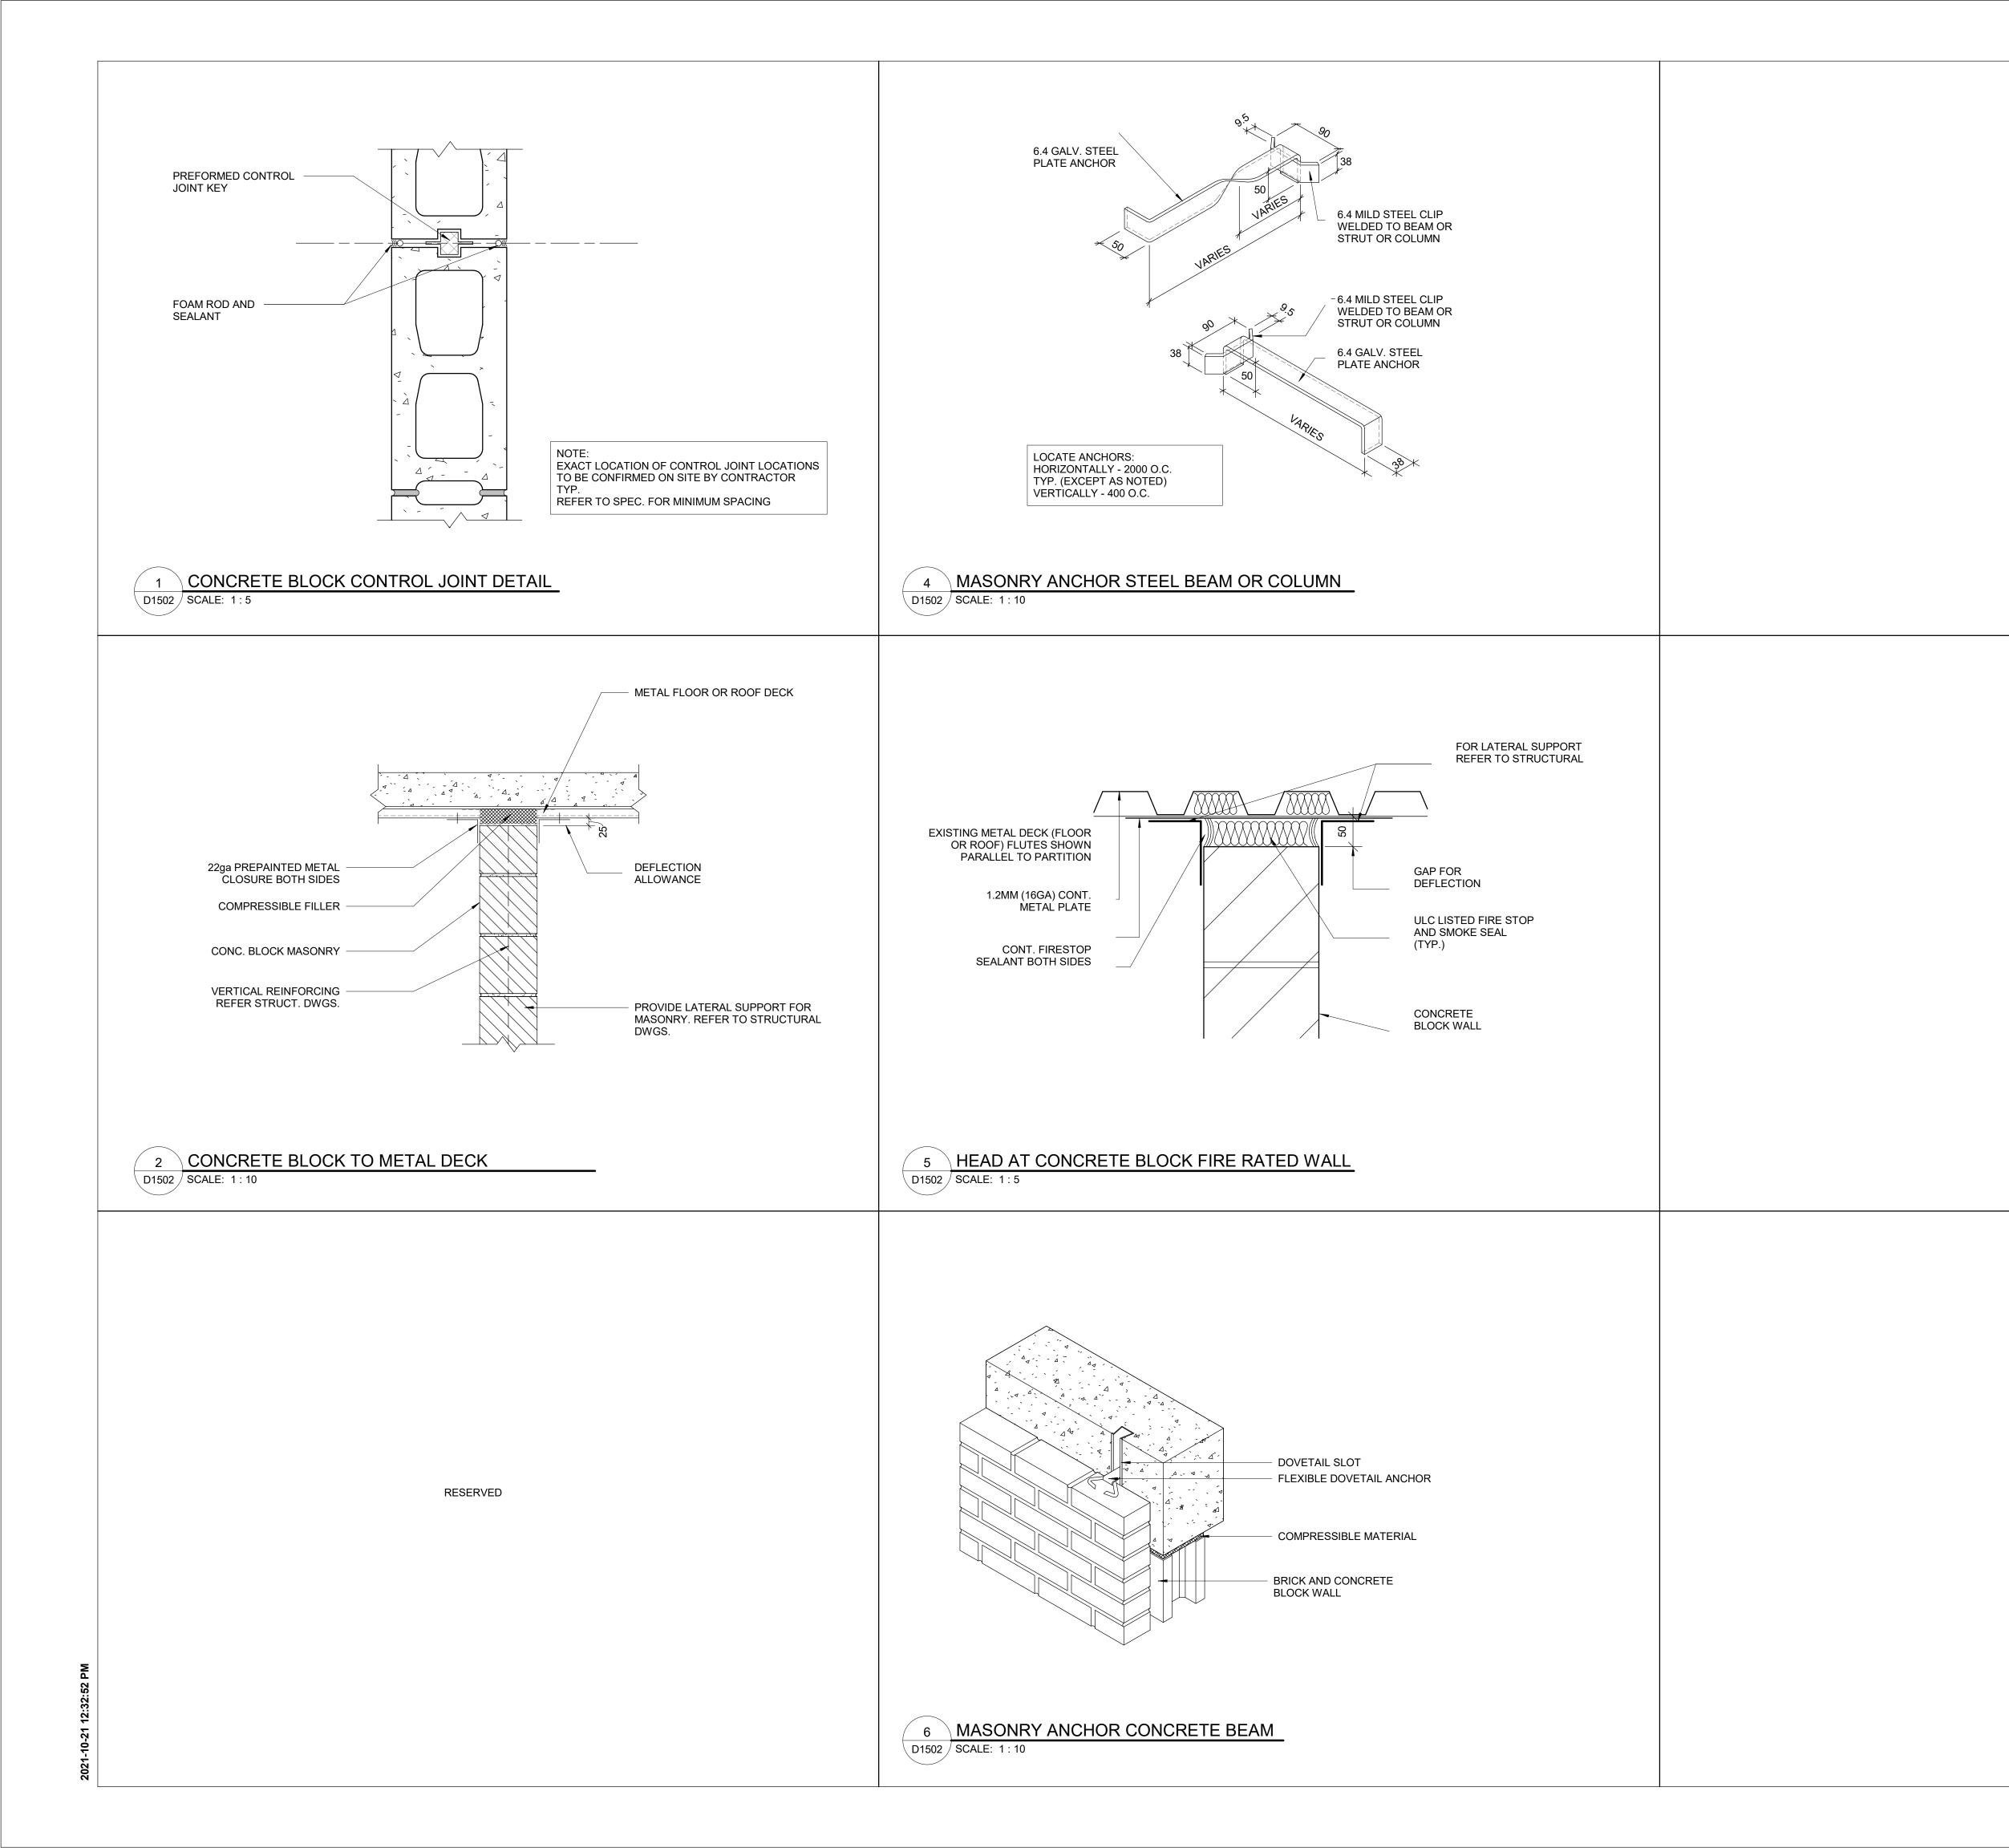
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| HAZARD STRIP PLAN | SHEET NUMBER D1405 | | | | |

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| TRACK TO T-BAR WITH CLIPS OR FASTENERS | U/S OF SLAB OR DECK PROVIDE ACOUSTIC SEALANT WHERE BAFFLE MEETS SURFACE 2 SHEETS 1" RIGID INSULATION W/ FOIL BACKING. FOIL TAPE ALL EXPOSED EDGES OF MINERAL WOOL INSULATION FINISHED CEILING AS SPECIFIED CLOSED CELL FOAM TAPE CENTER PARTITION ON T-BAR UNLESS NOTED SINGLE LAYER 16MM GWB ONE SIDE 2 12.7MM METAL STUDS AT 400MM O/C 51MM BATT INSULATION SOUND ATTENUATION BLANKET APPLIED BASE AS SPECIFIED ACOUSTIC SEALANT FINISHED FLOOR | <text><text><section-header><text><text></text></text></section-header></text></text> | | |
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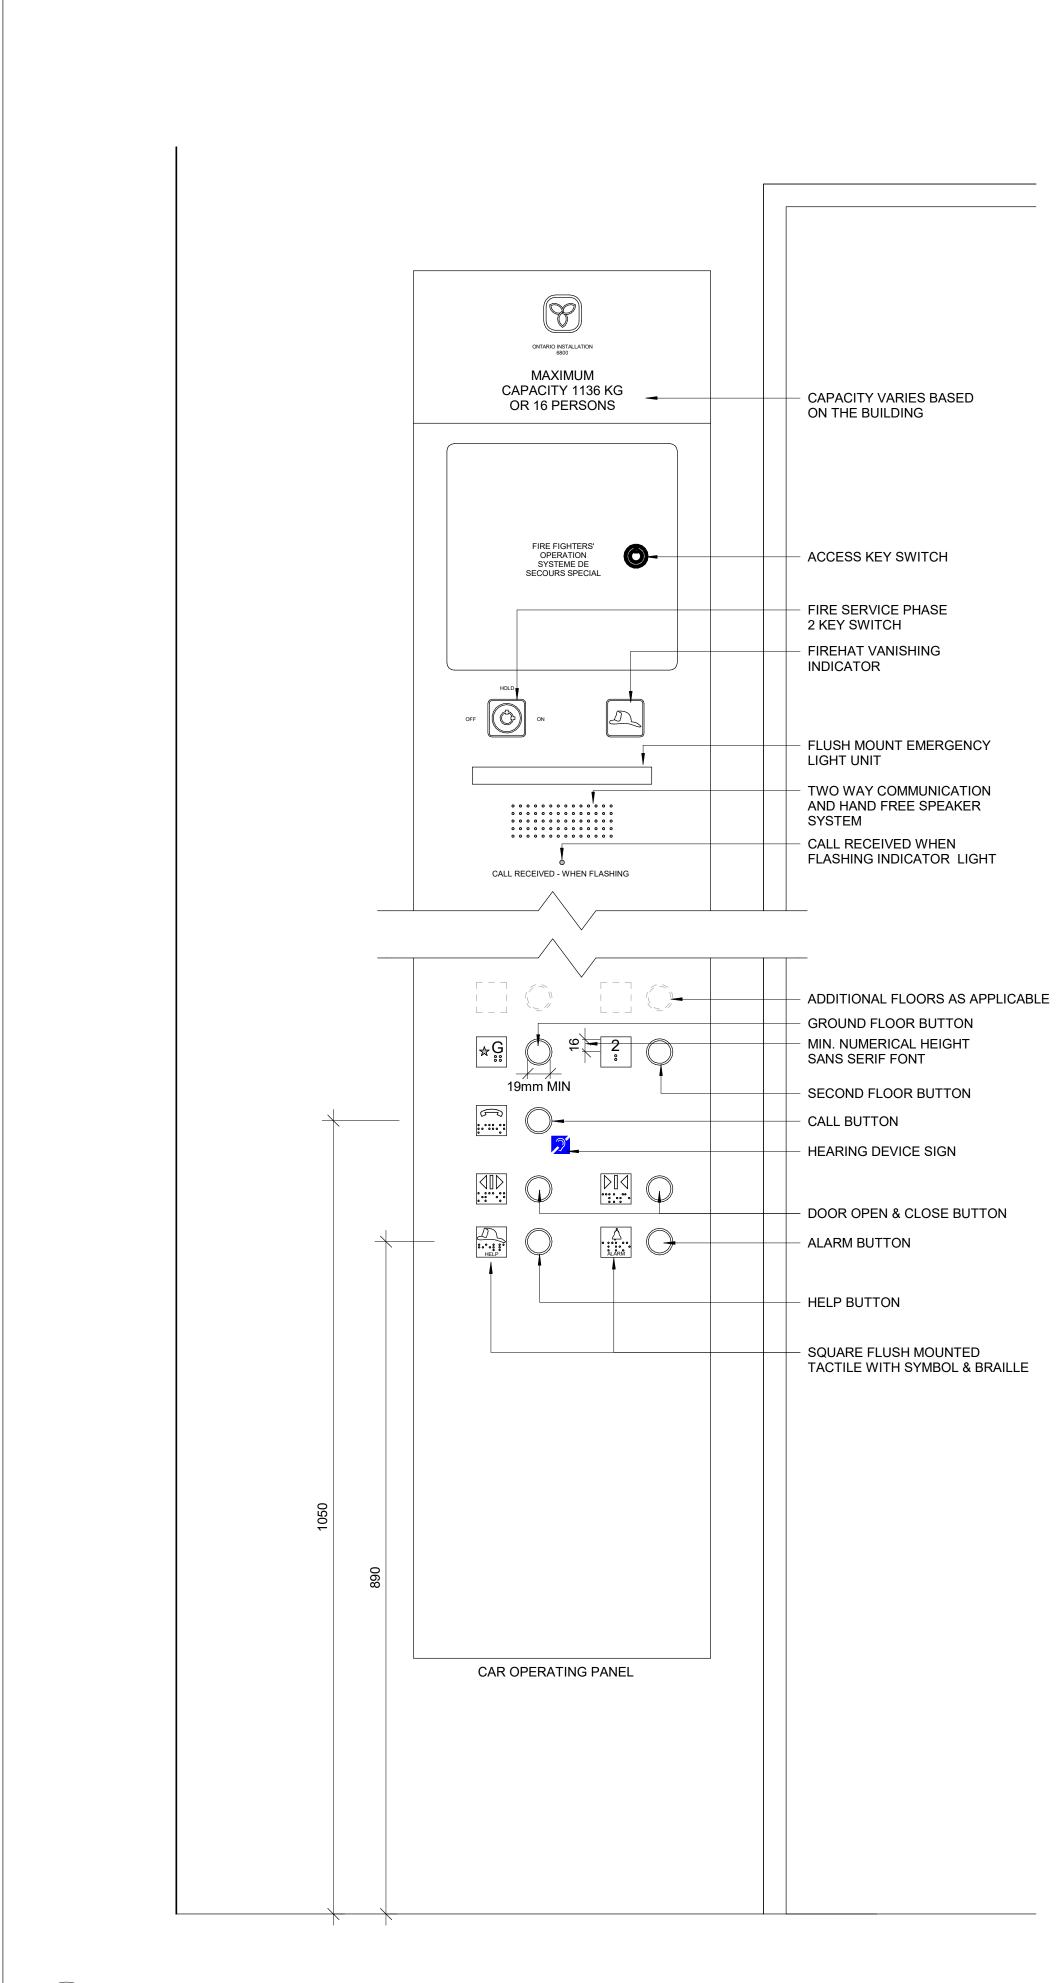


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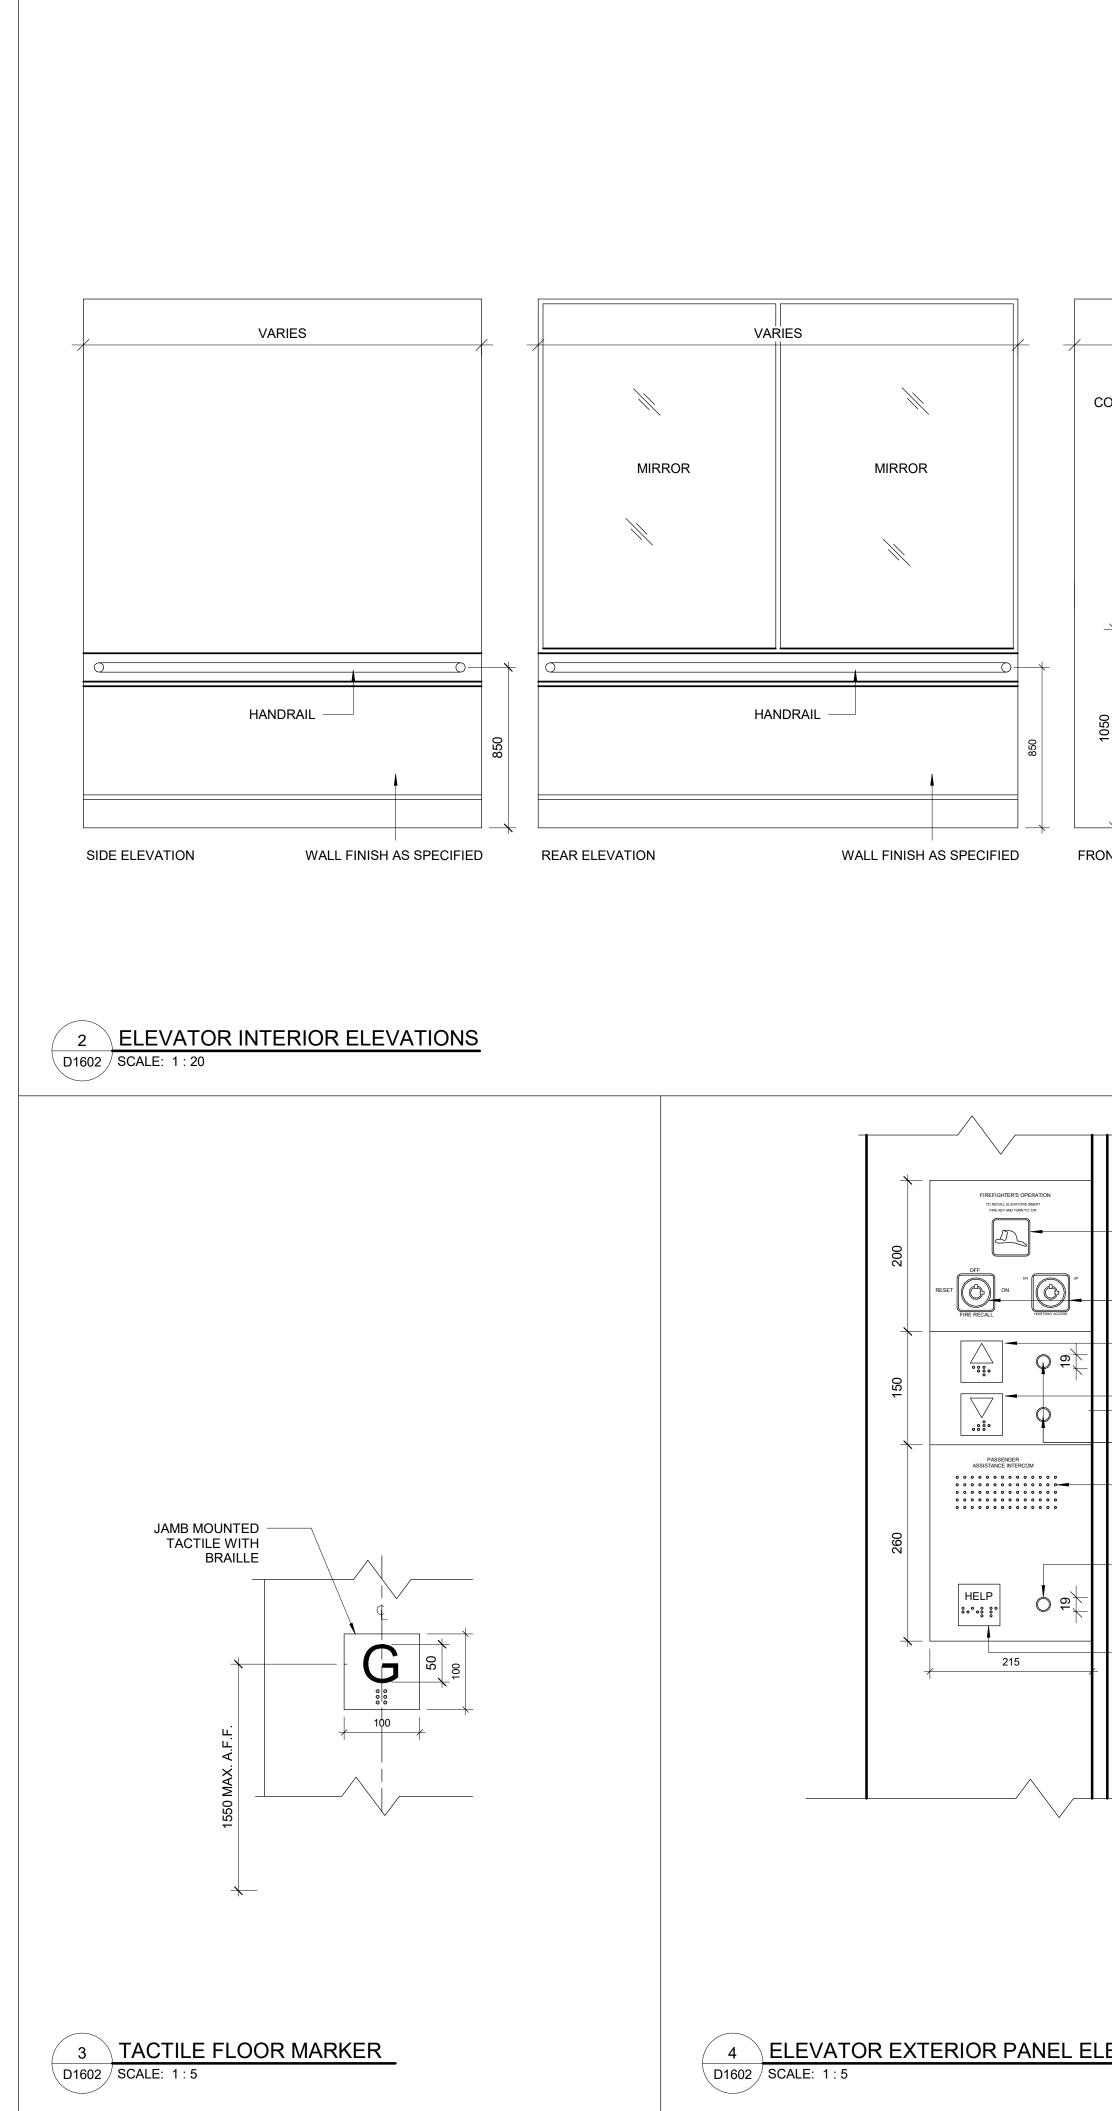
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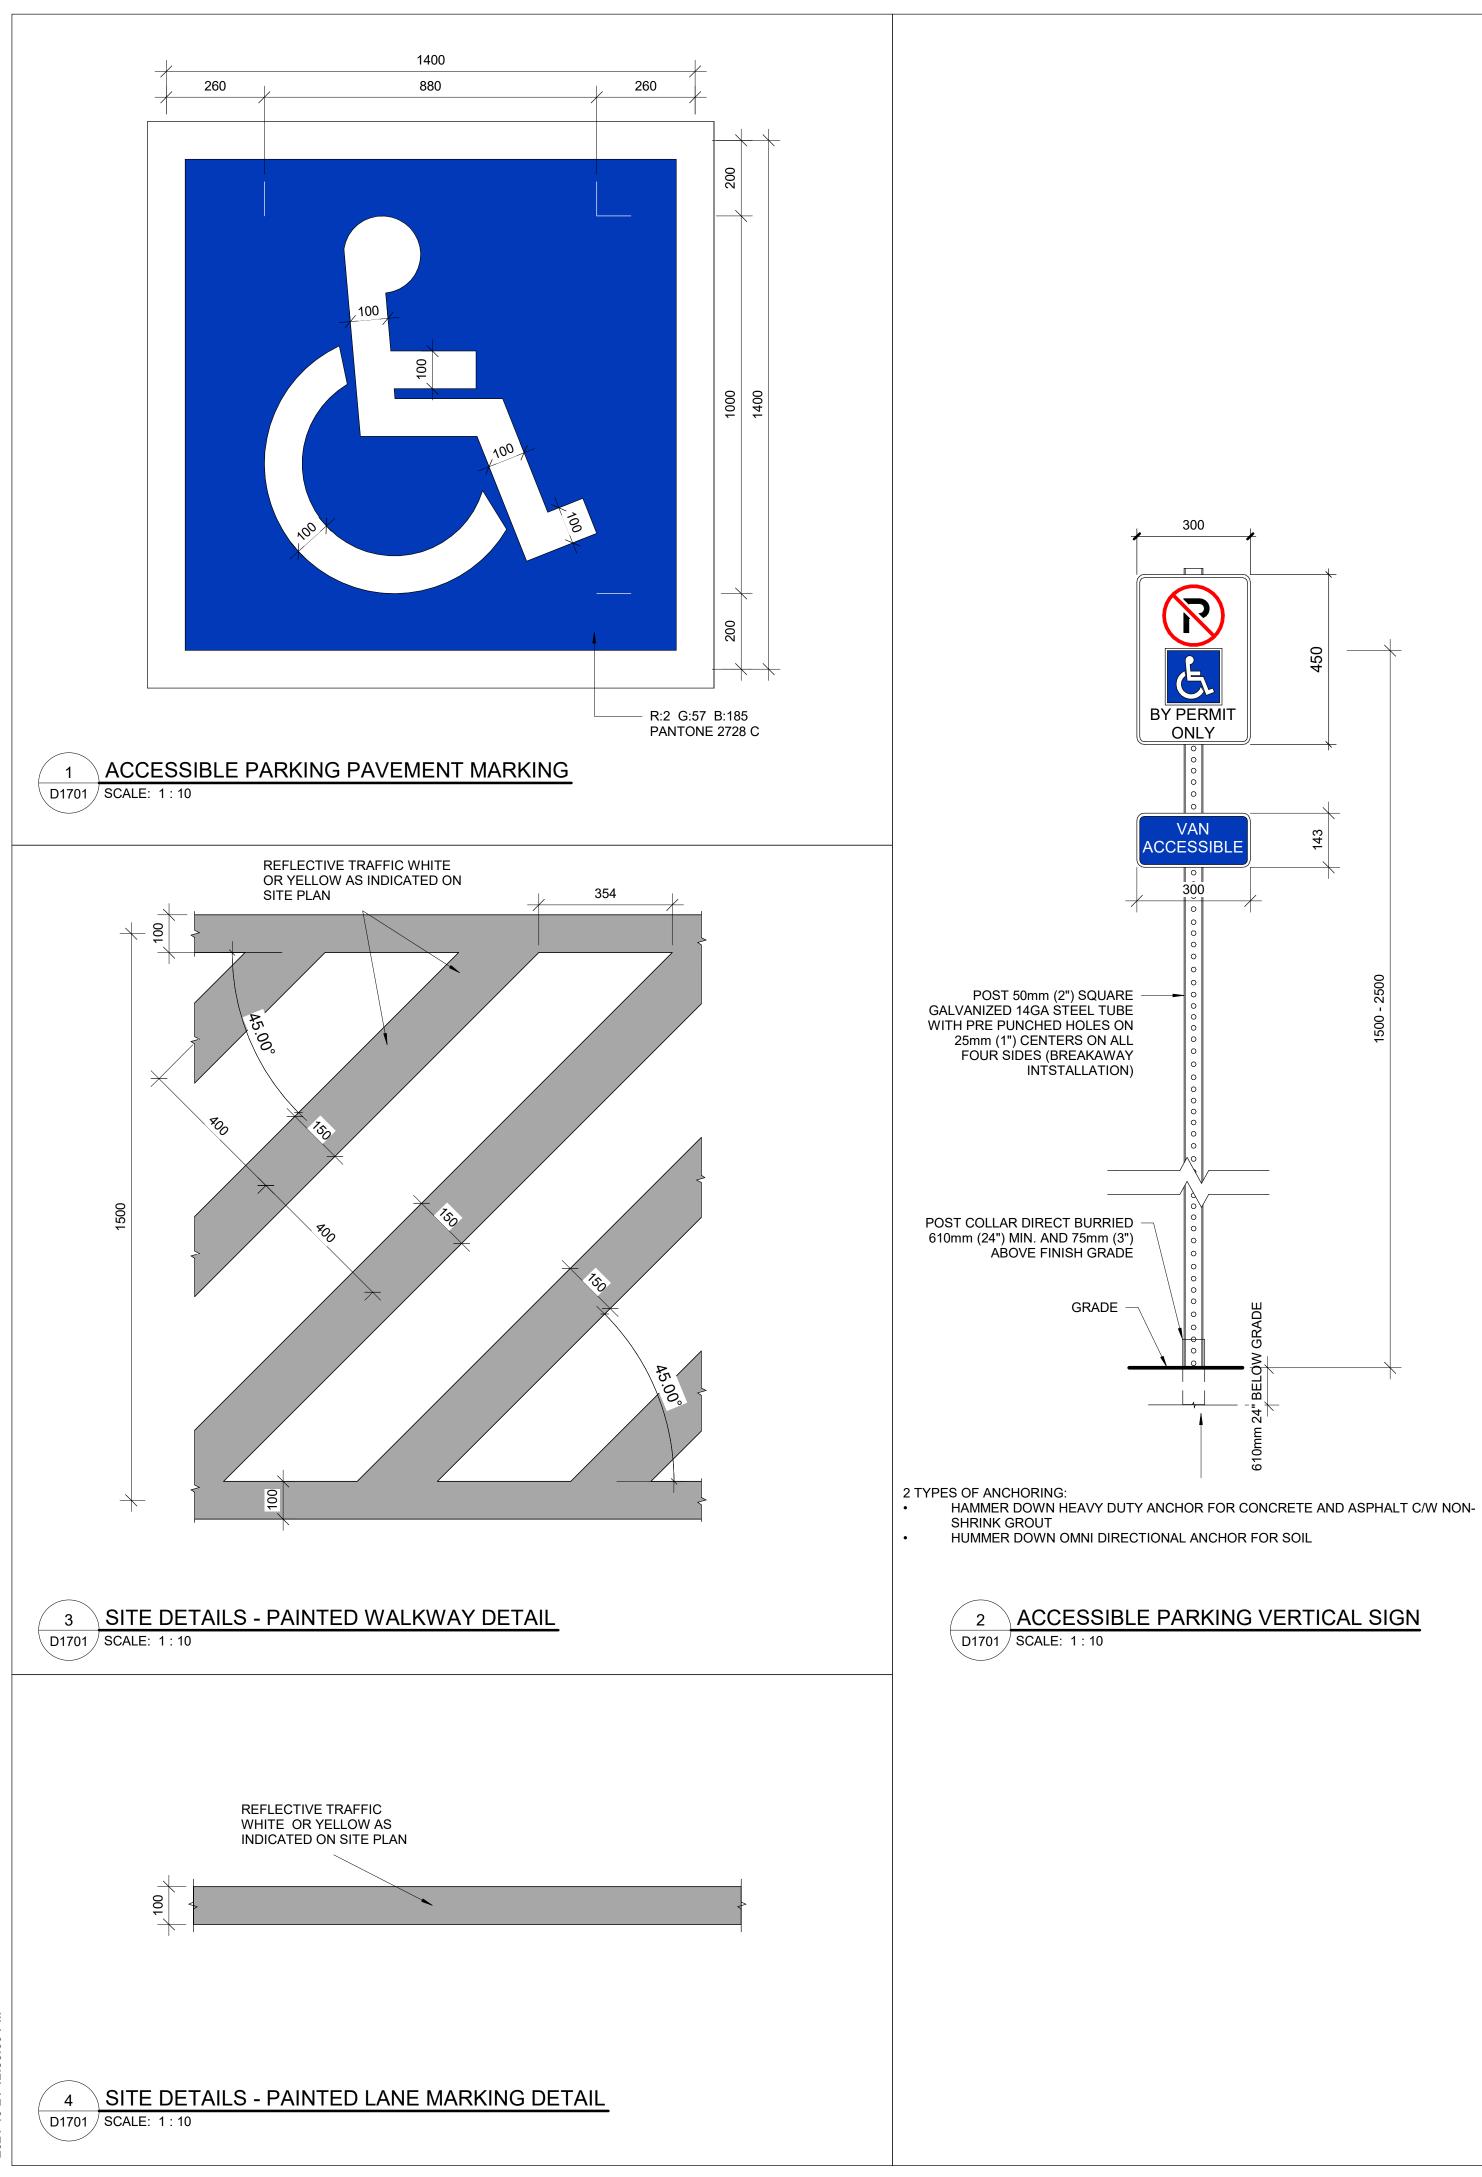
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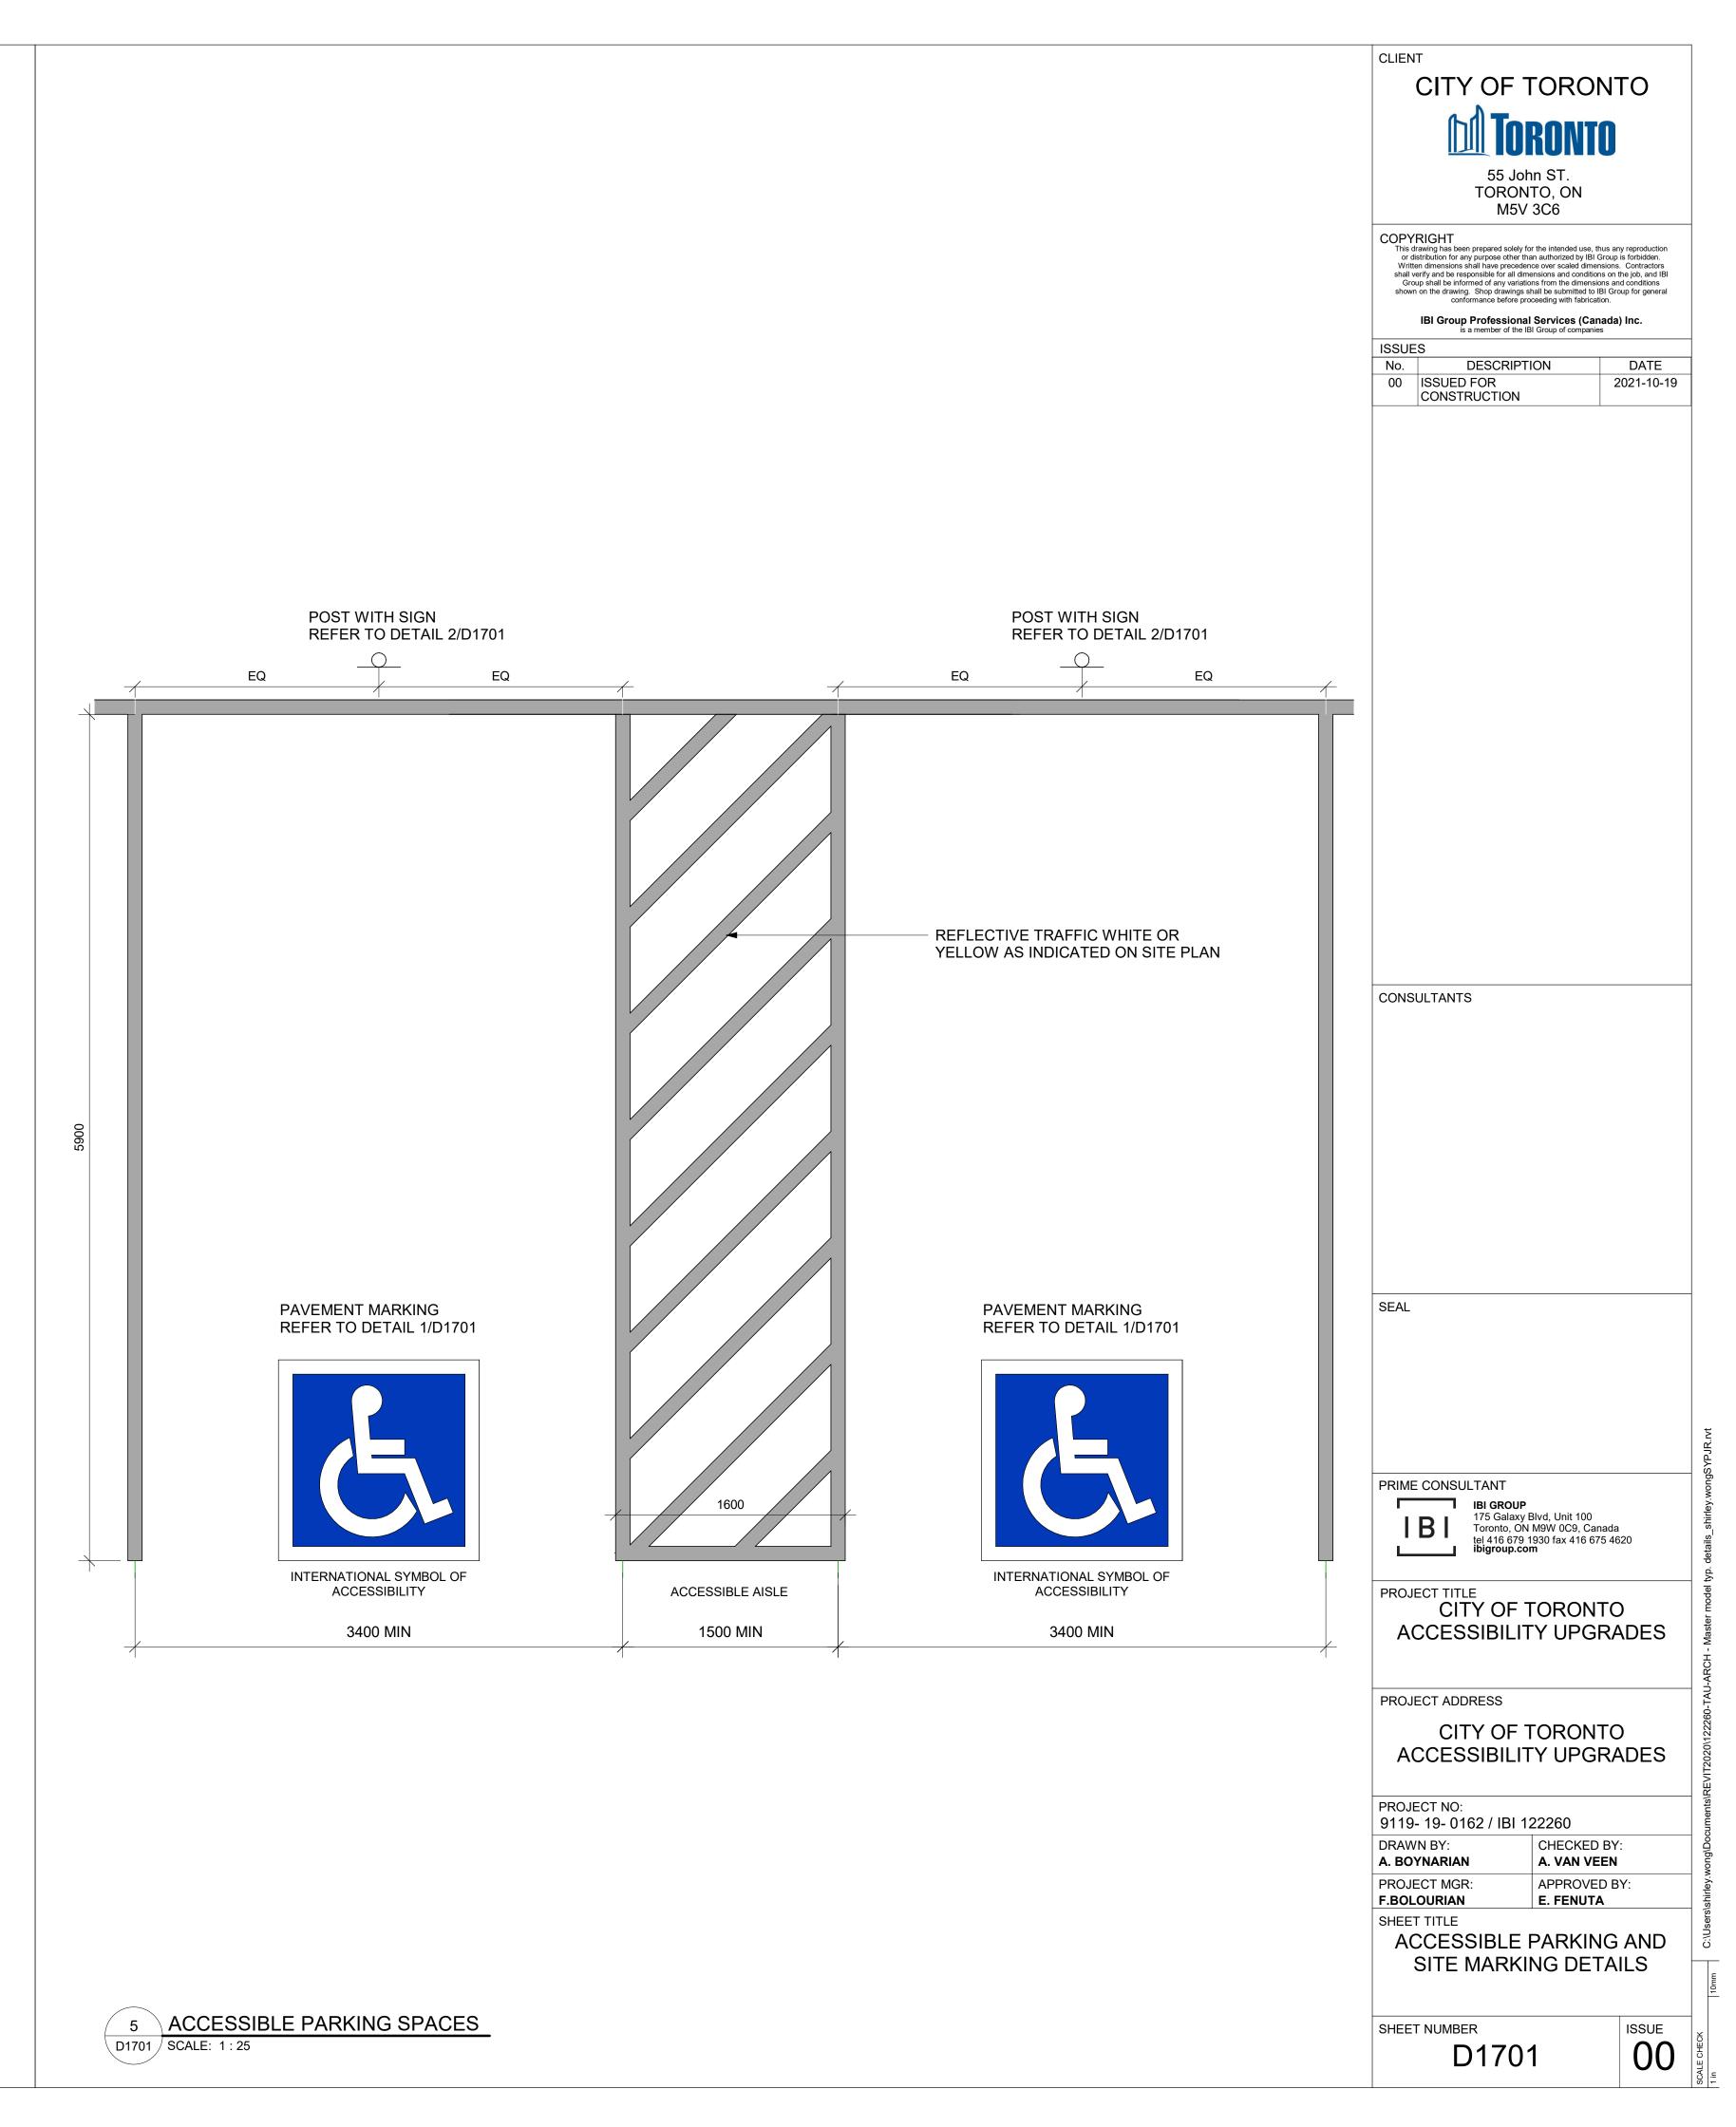
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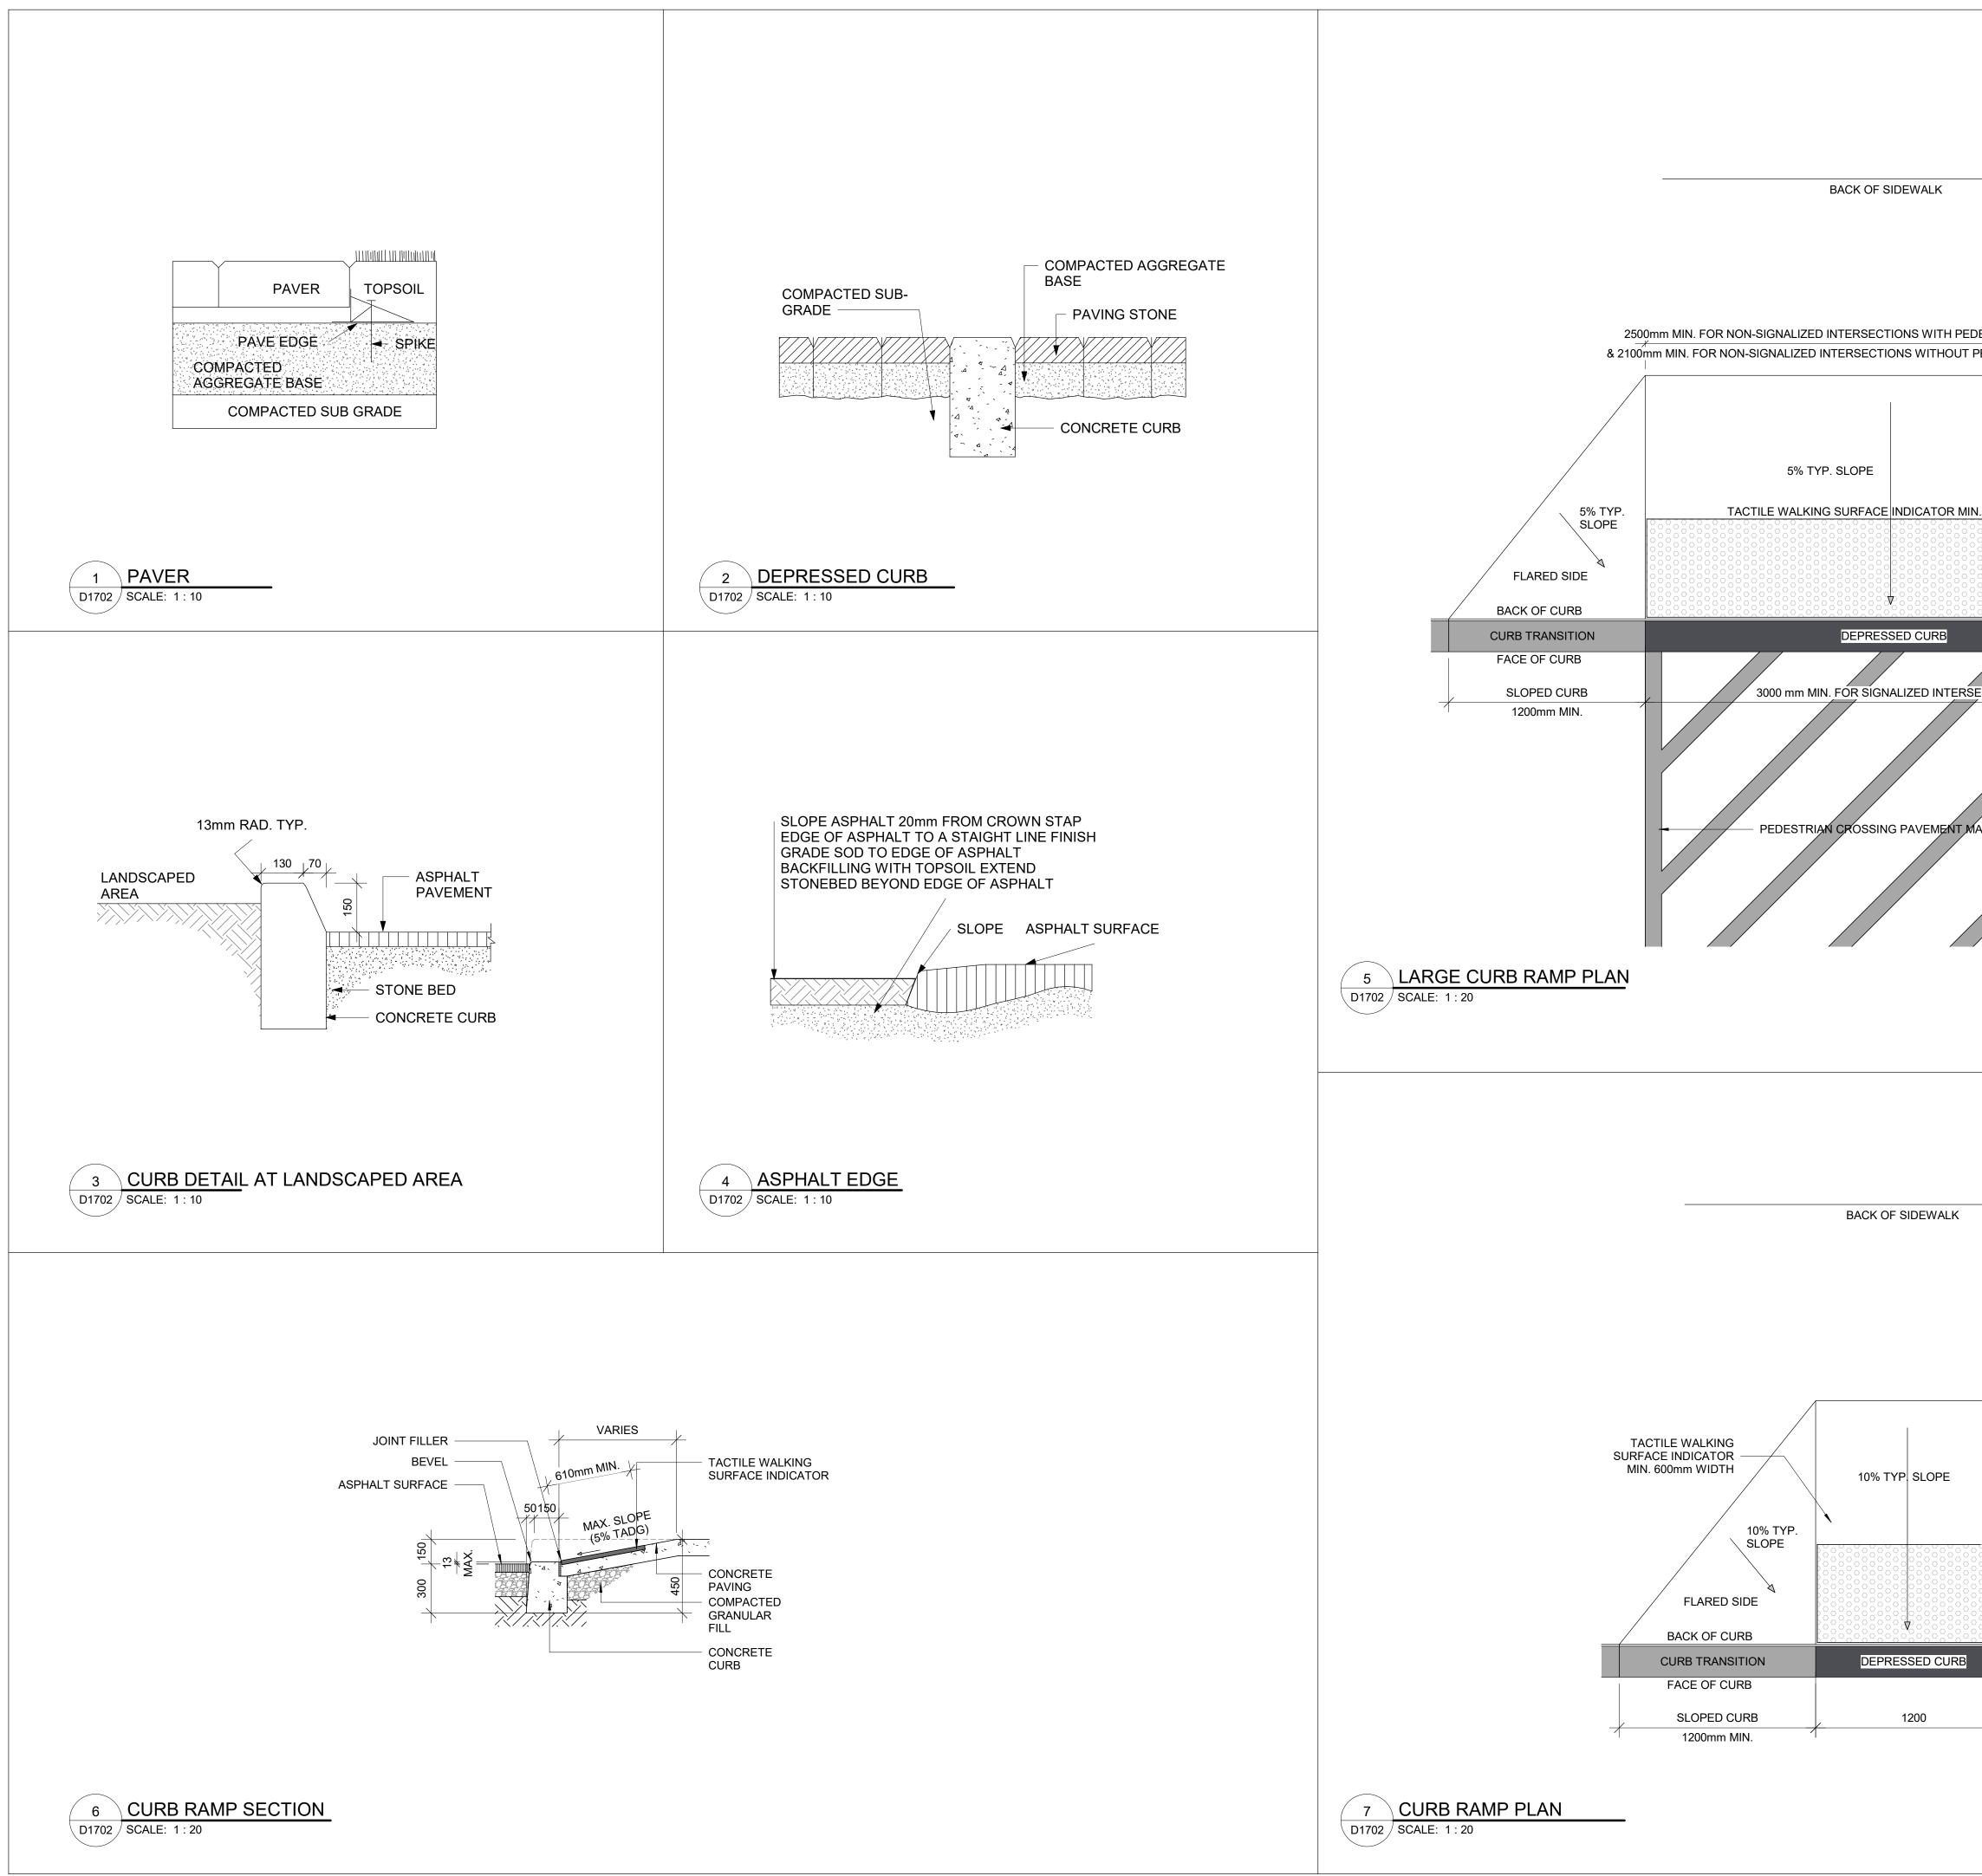


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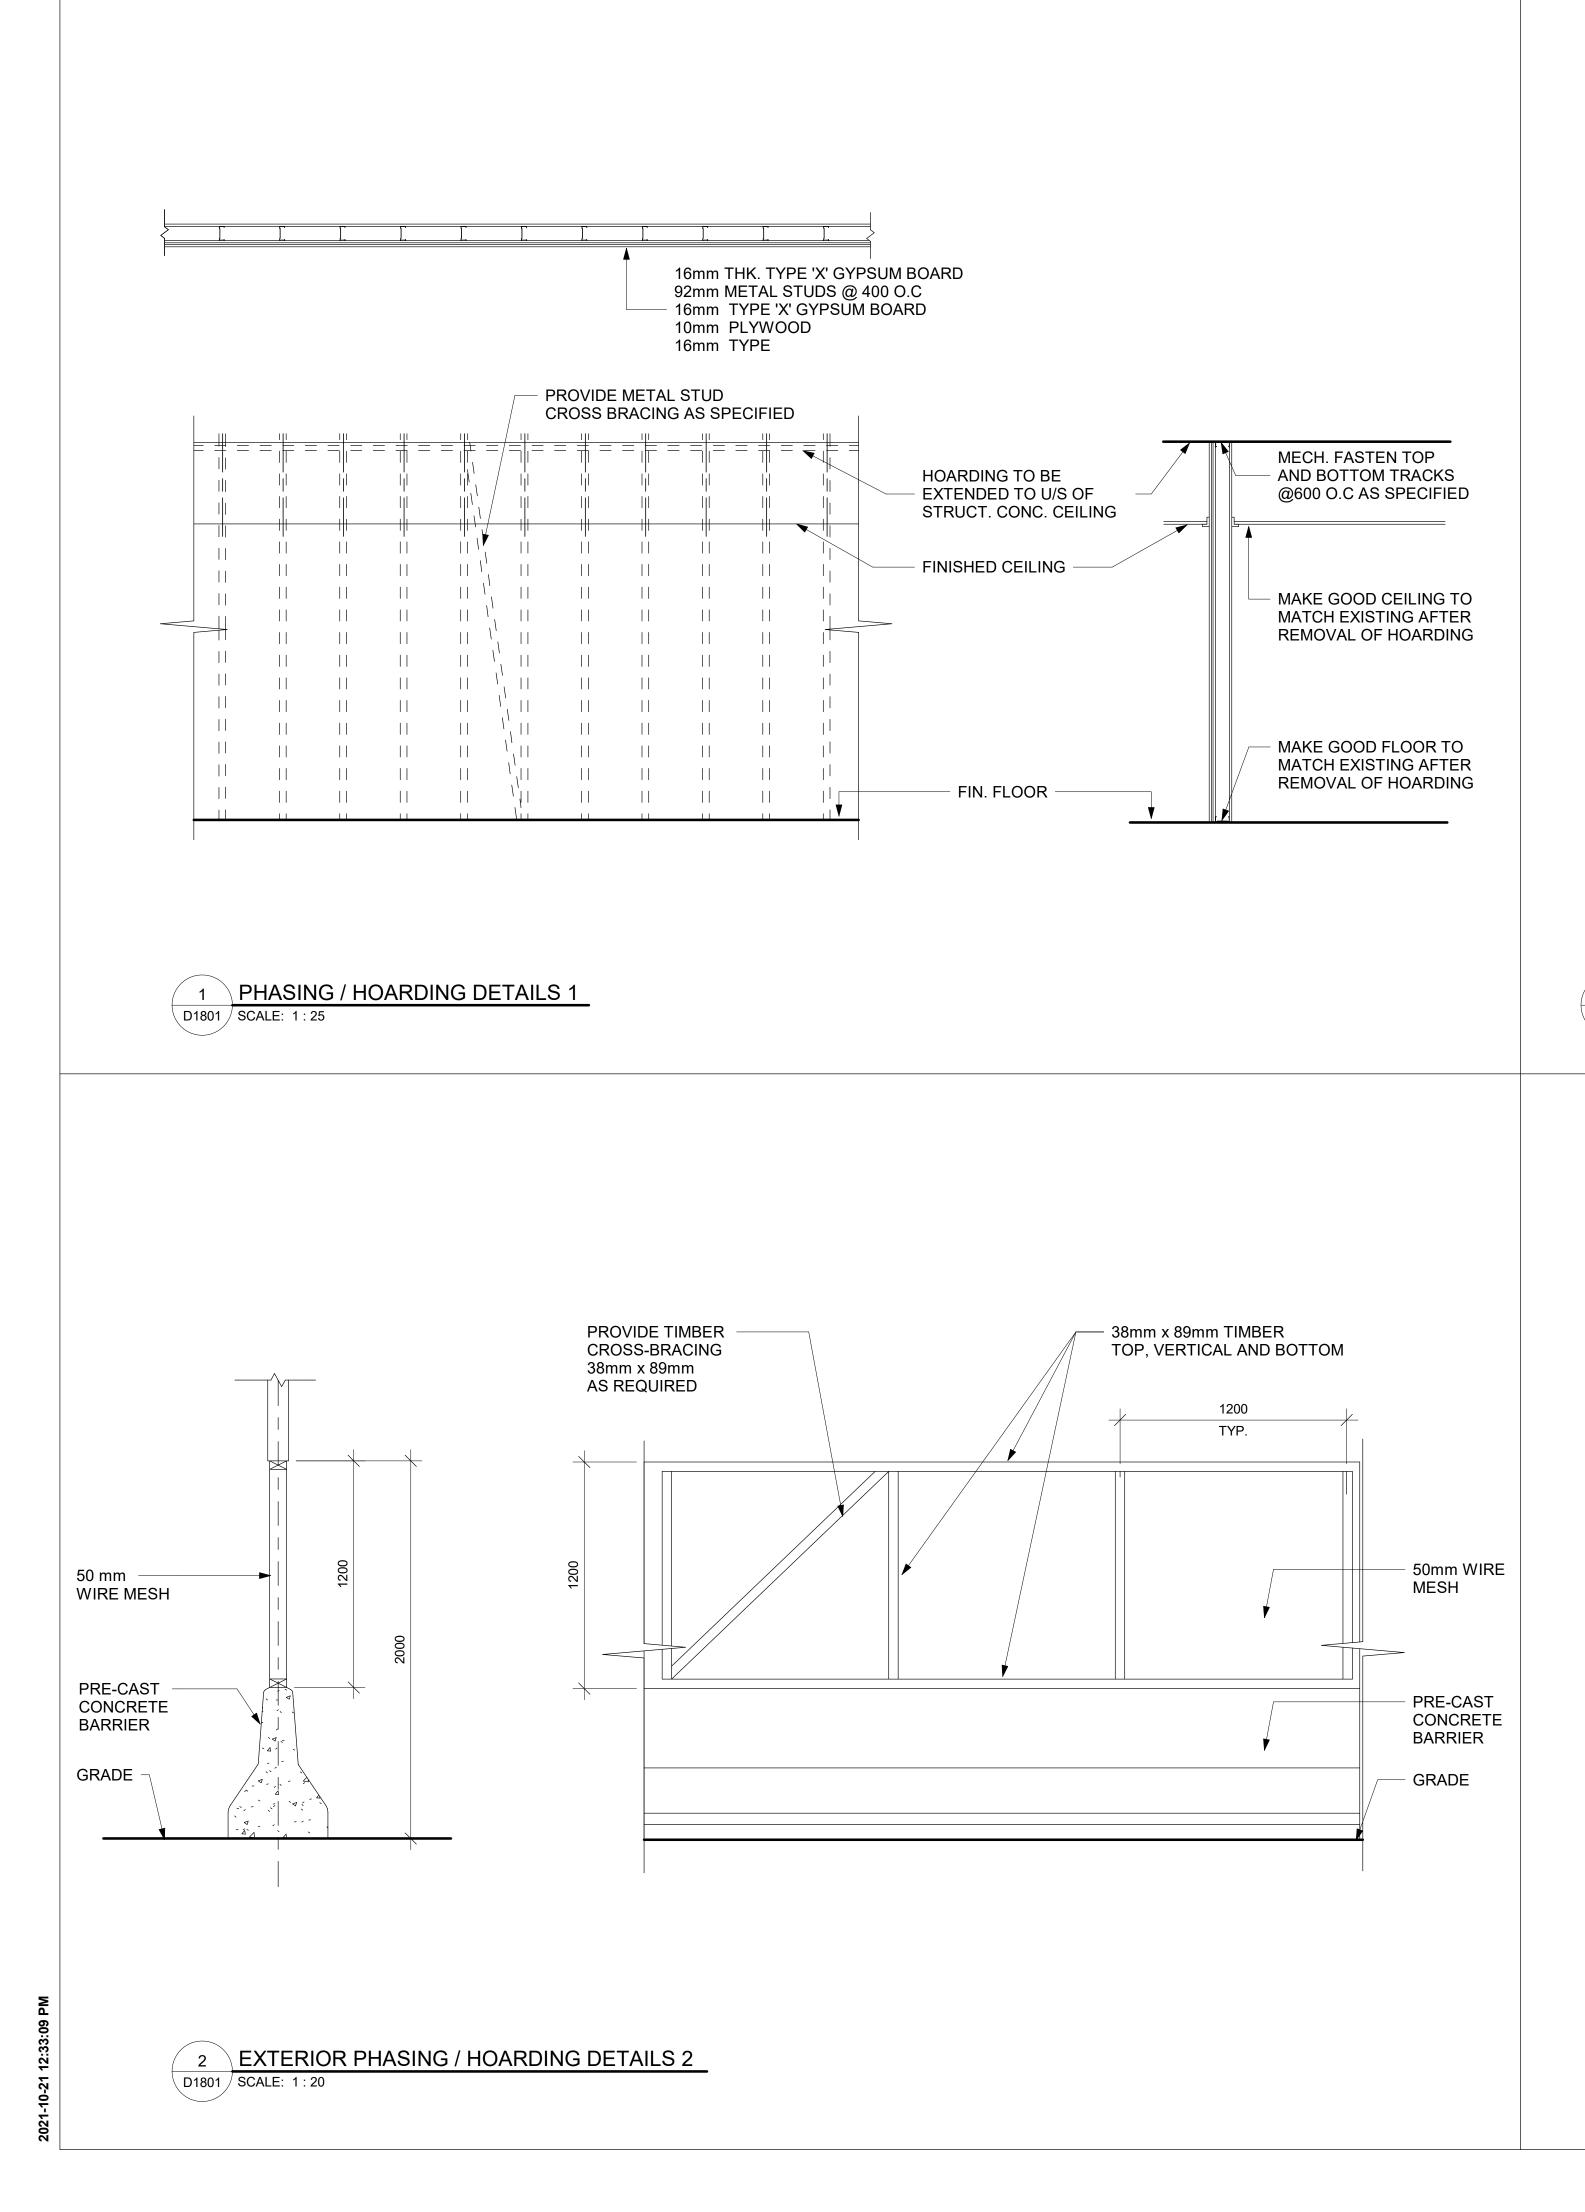


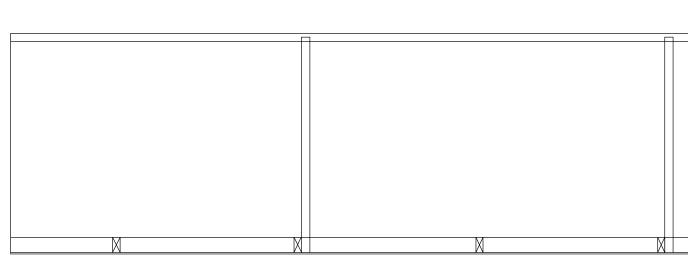


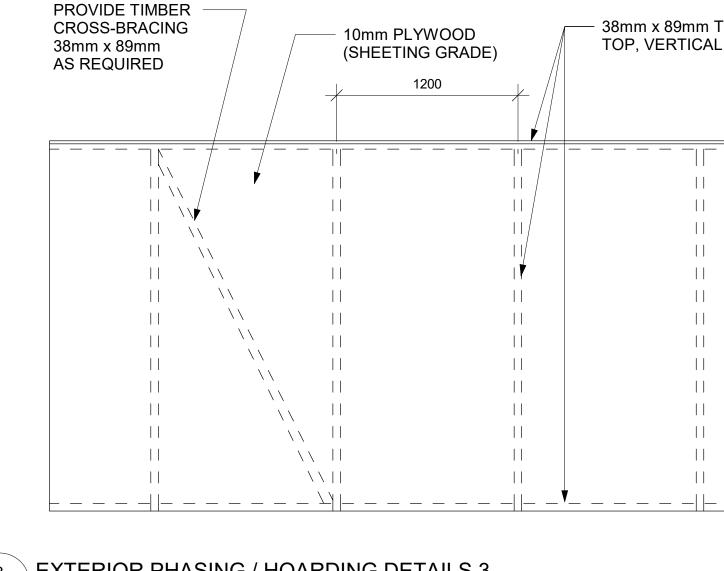


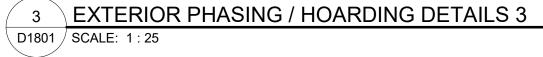
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UNIVERS - BOLD CONDENSED Used for numeric identifiers, eg: Stairwell IDs or Building Street Number

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WHITE

Matthews Acrylic: MP-32071 White Wonder Semi-Gloss Finish

Vinyl 3M7725-20 Opaque Matte White



CITY OF TORONTO BLUE Pantone 647C

Semi-Gloss Finish Vinyl Avery SC95750 Opaque Interstate Blue

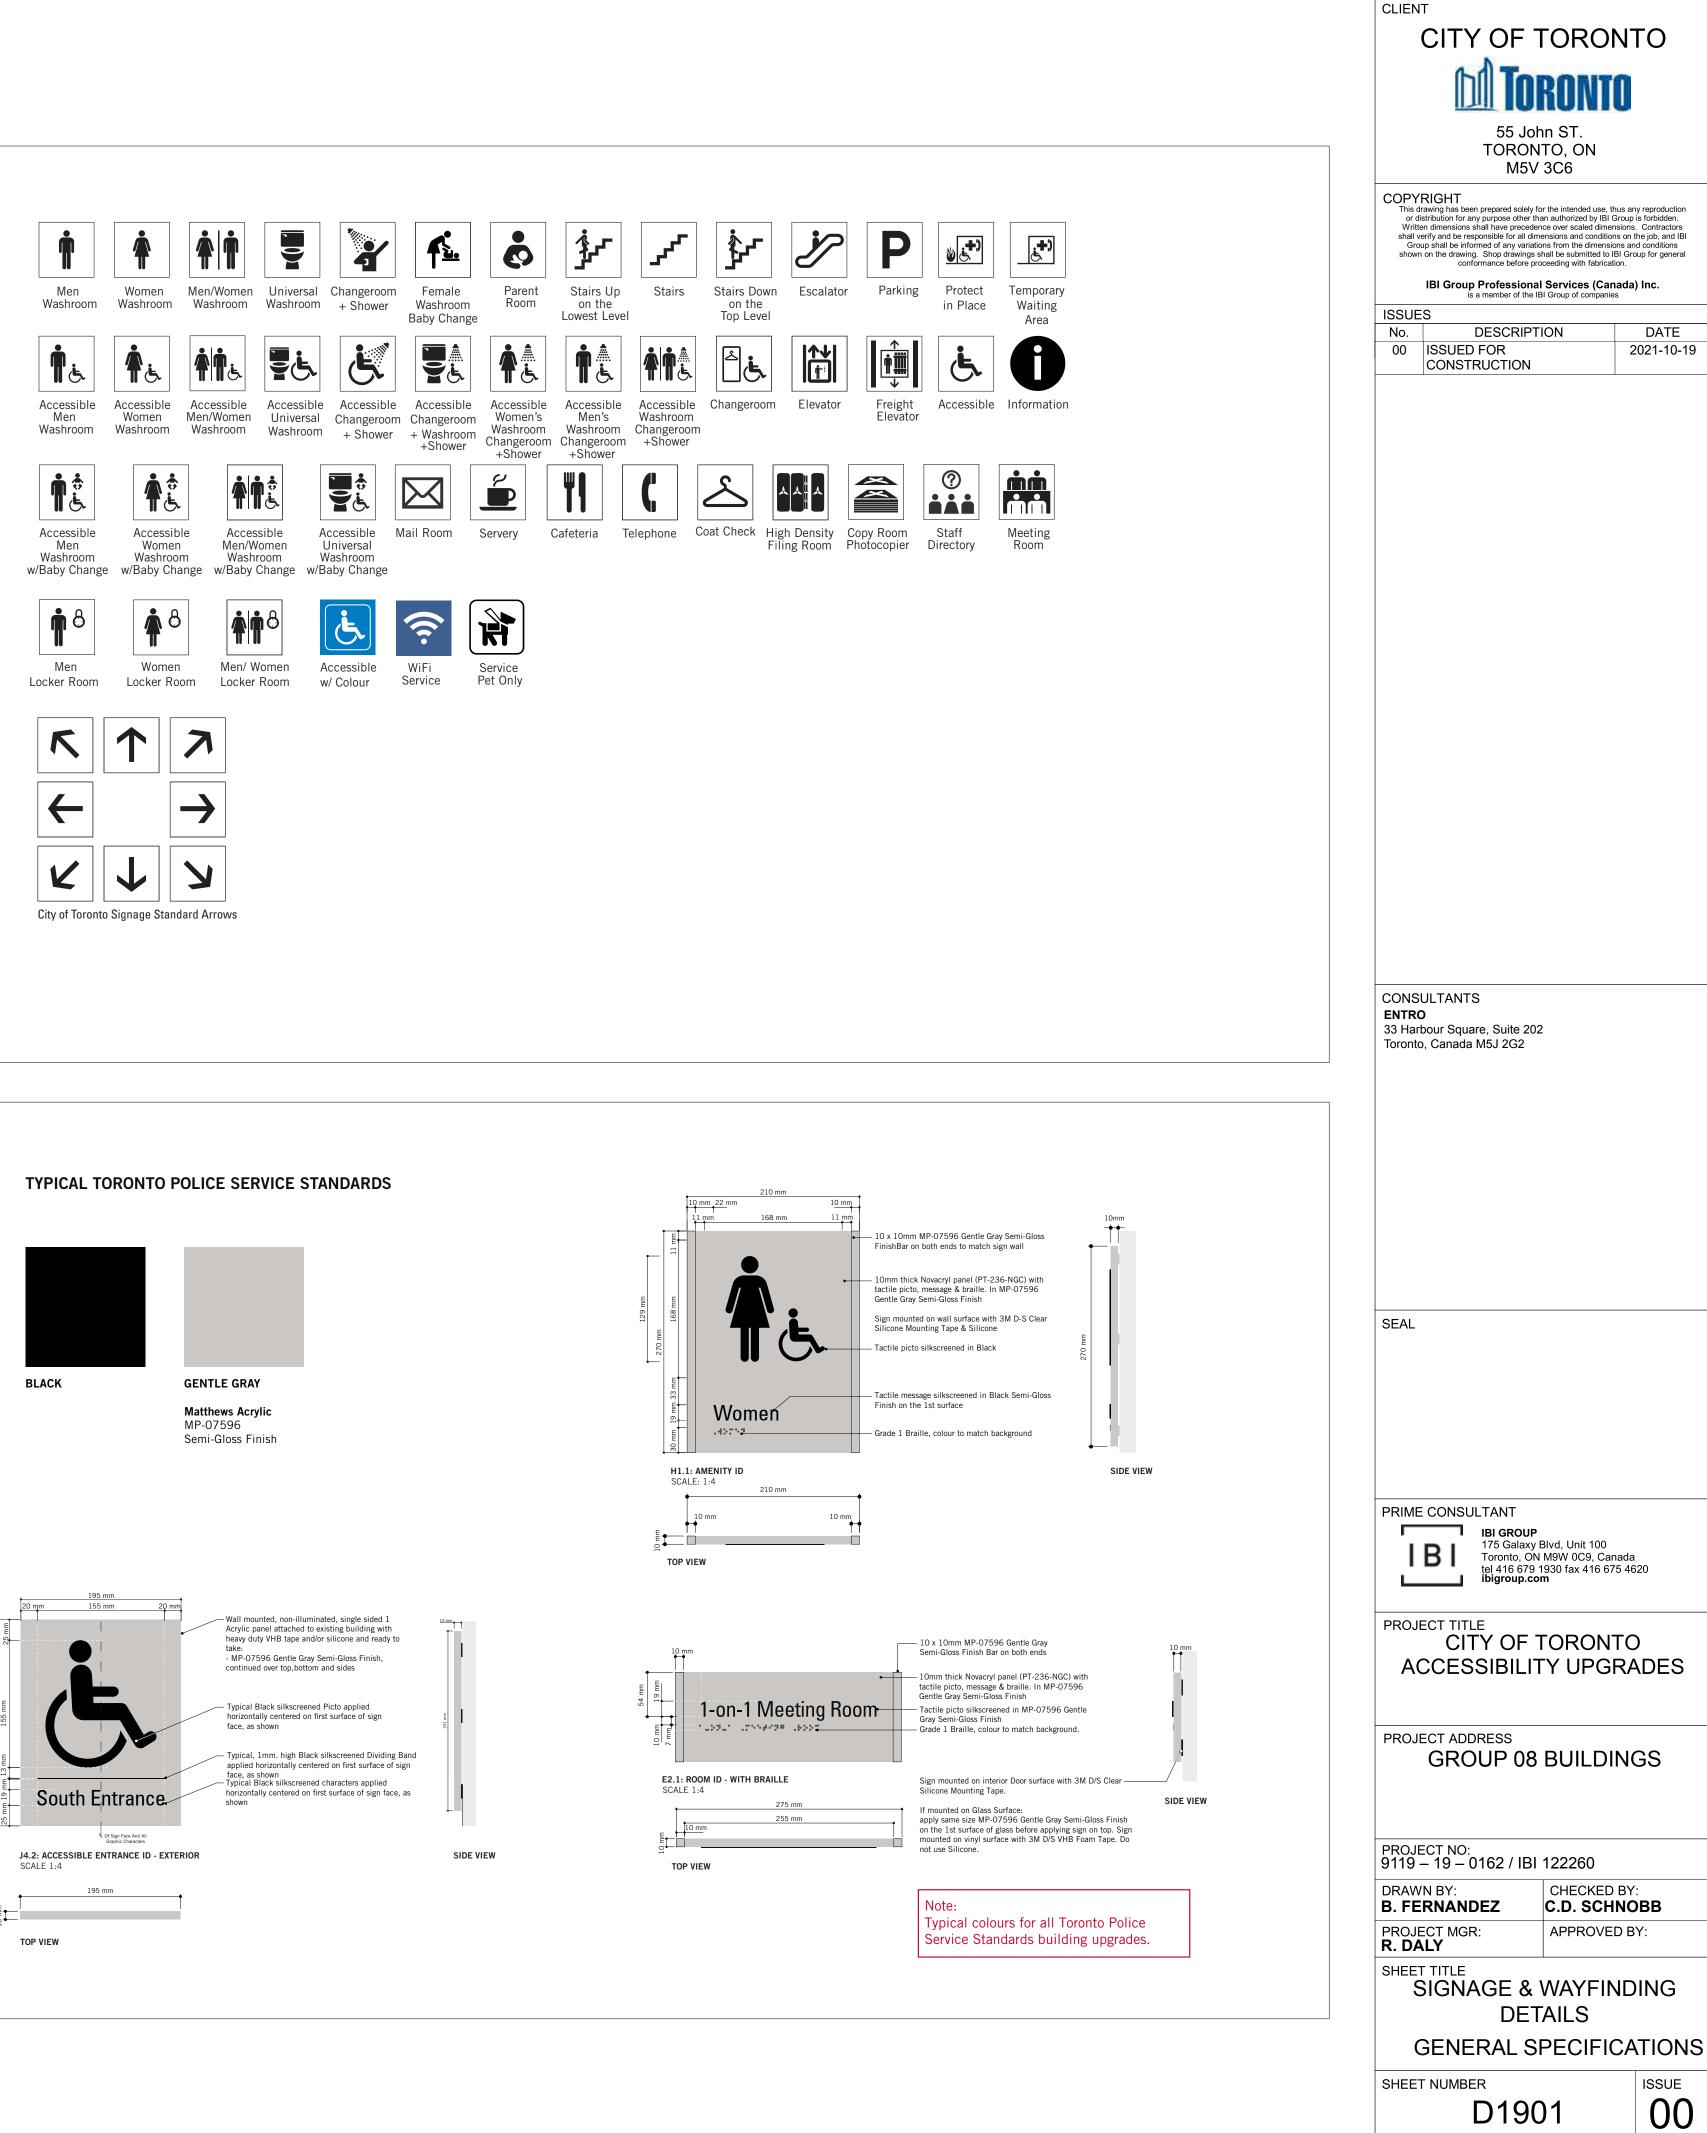
MP-11183 Franco Blue

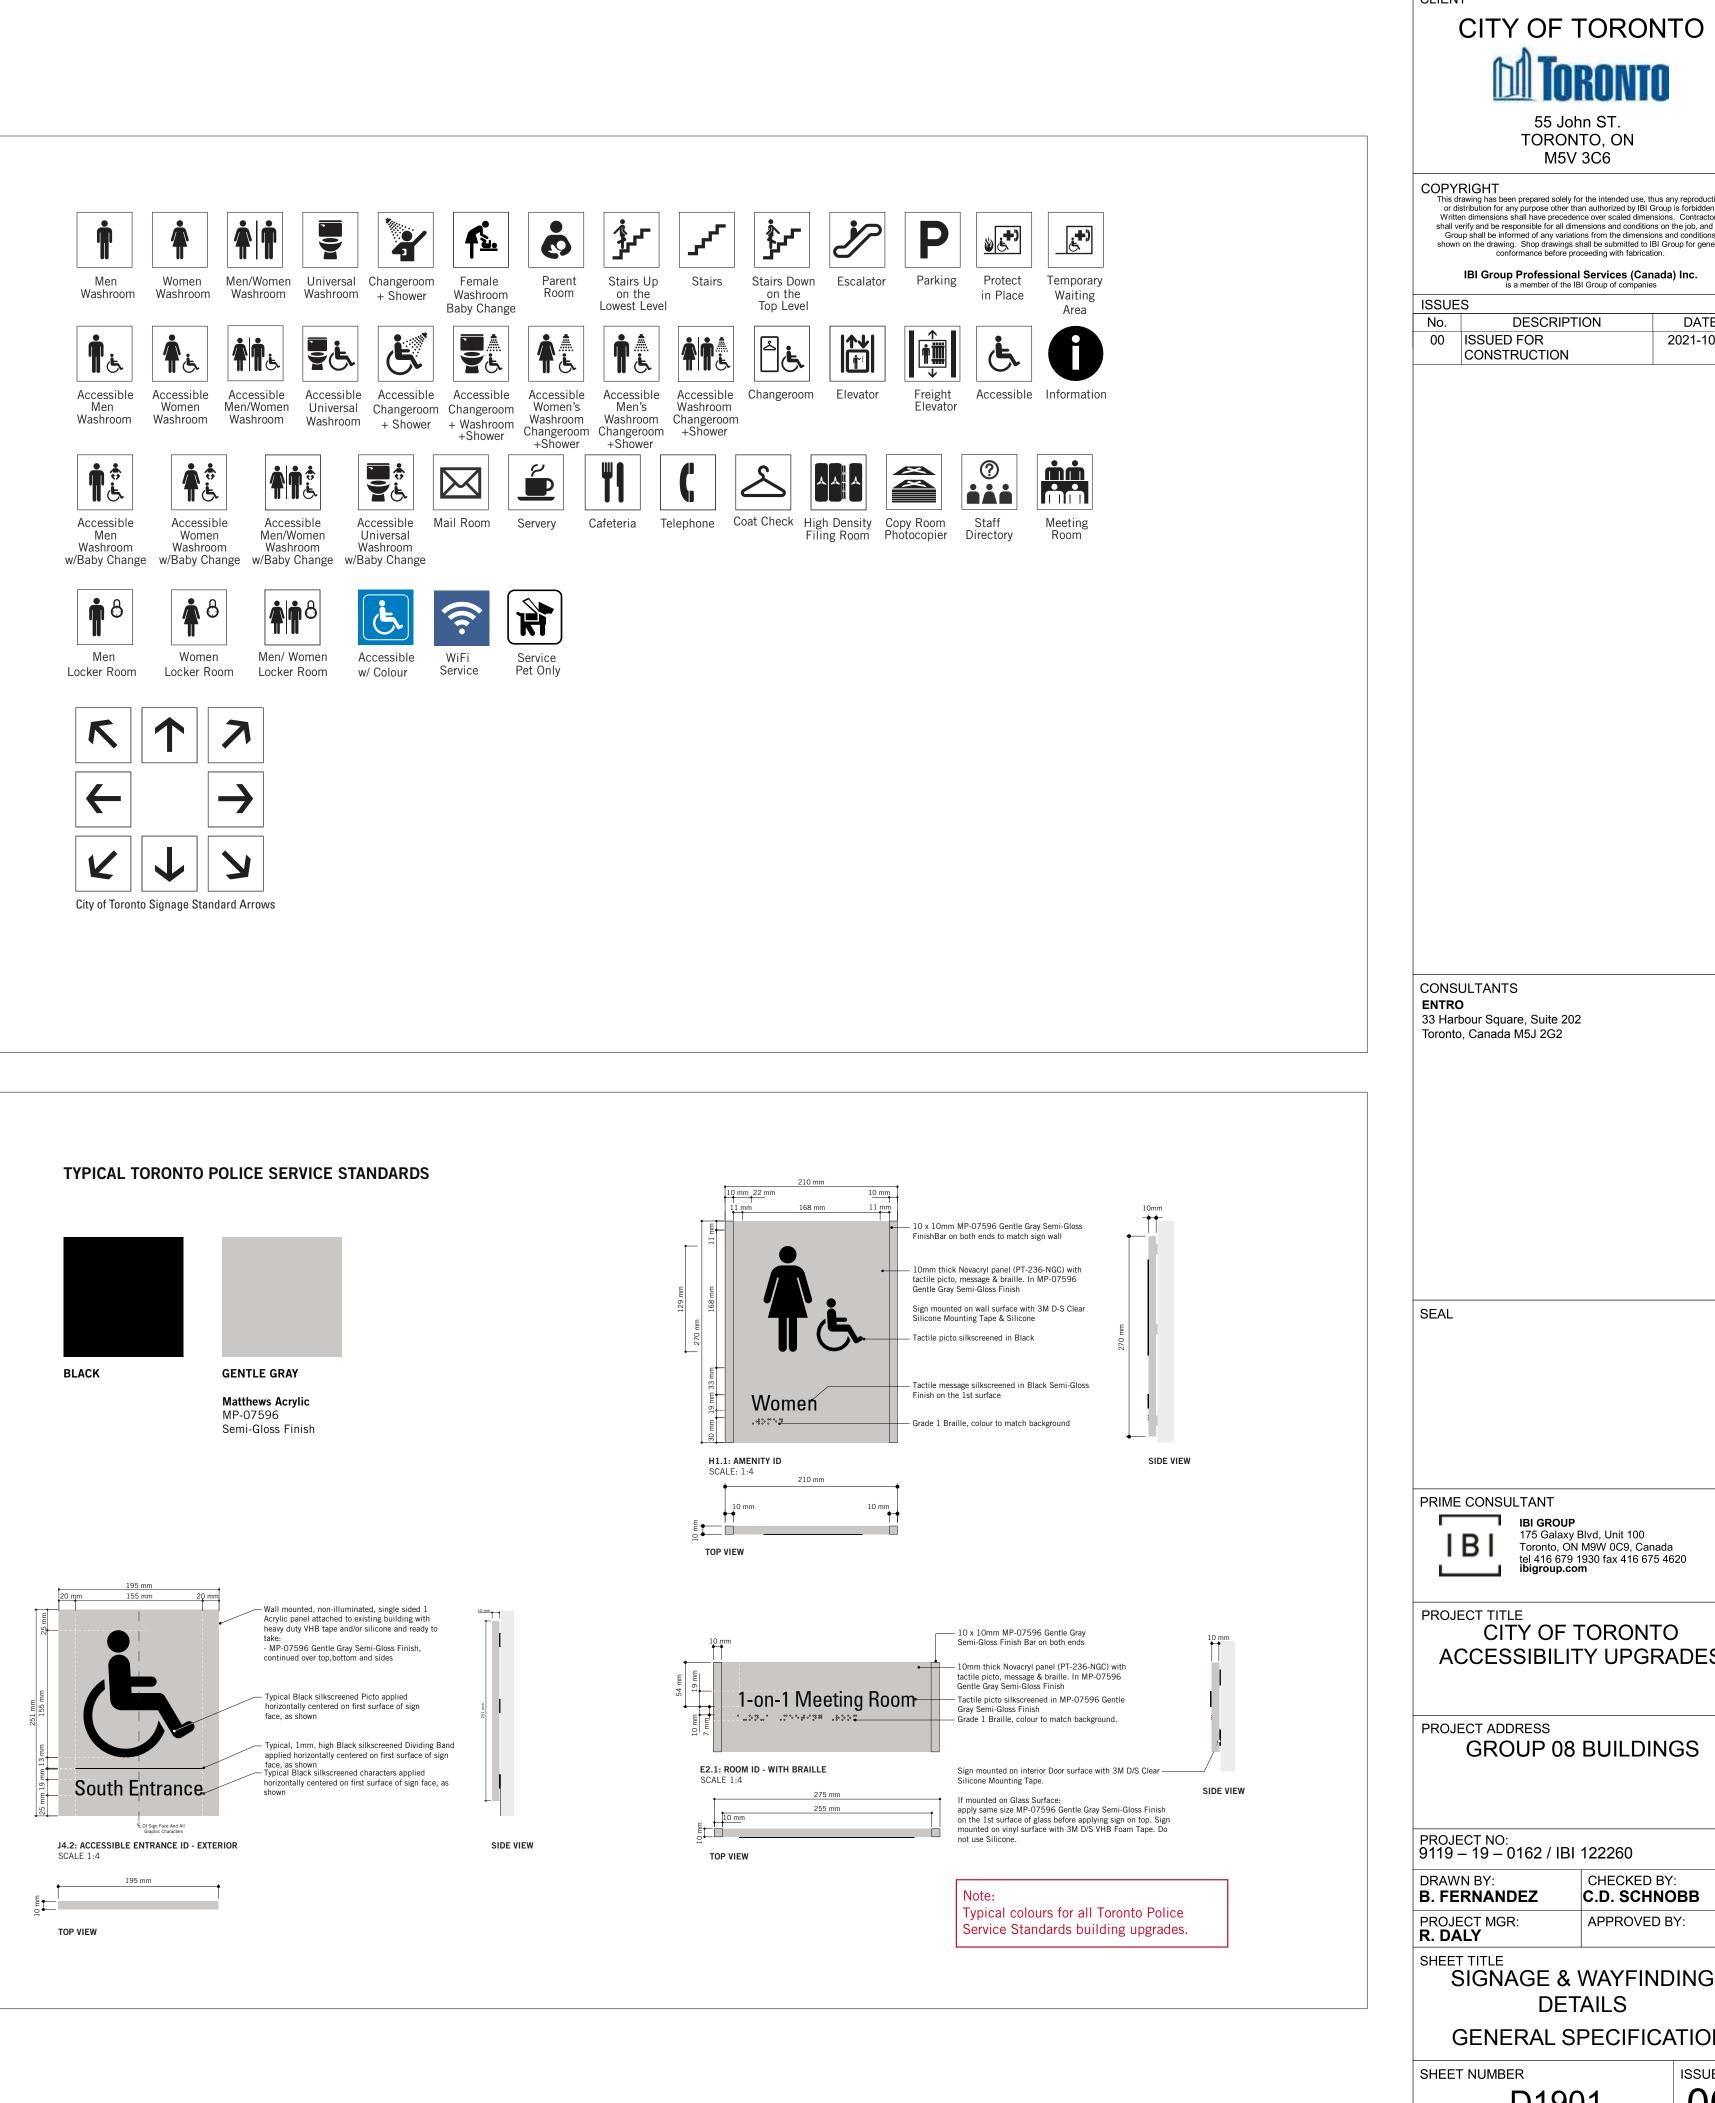
Matthews Acrylic:

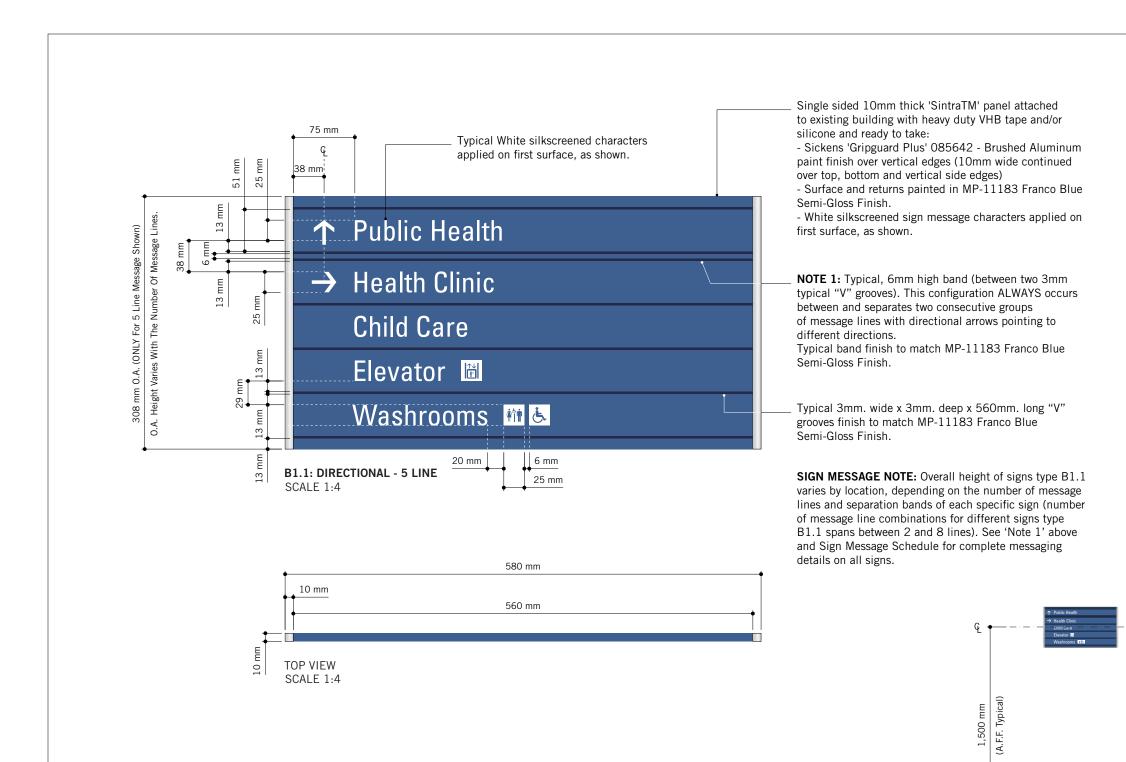
BRUSHED ALUMINUM OR SILVER Pantone 877C Gripguard Plus 085642 Brushed Aluminum Semi-Gloss Finish

Vinyl 3M 180C-220 Opaque Light Silver Metallic Vinyl

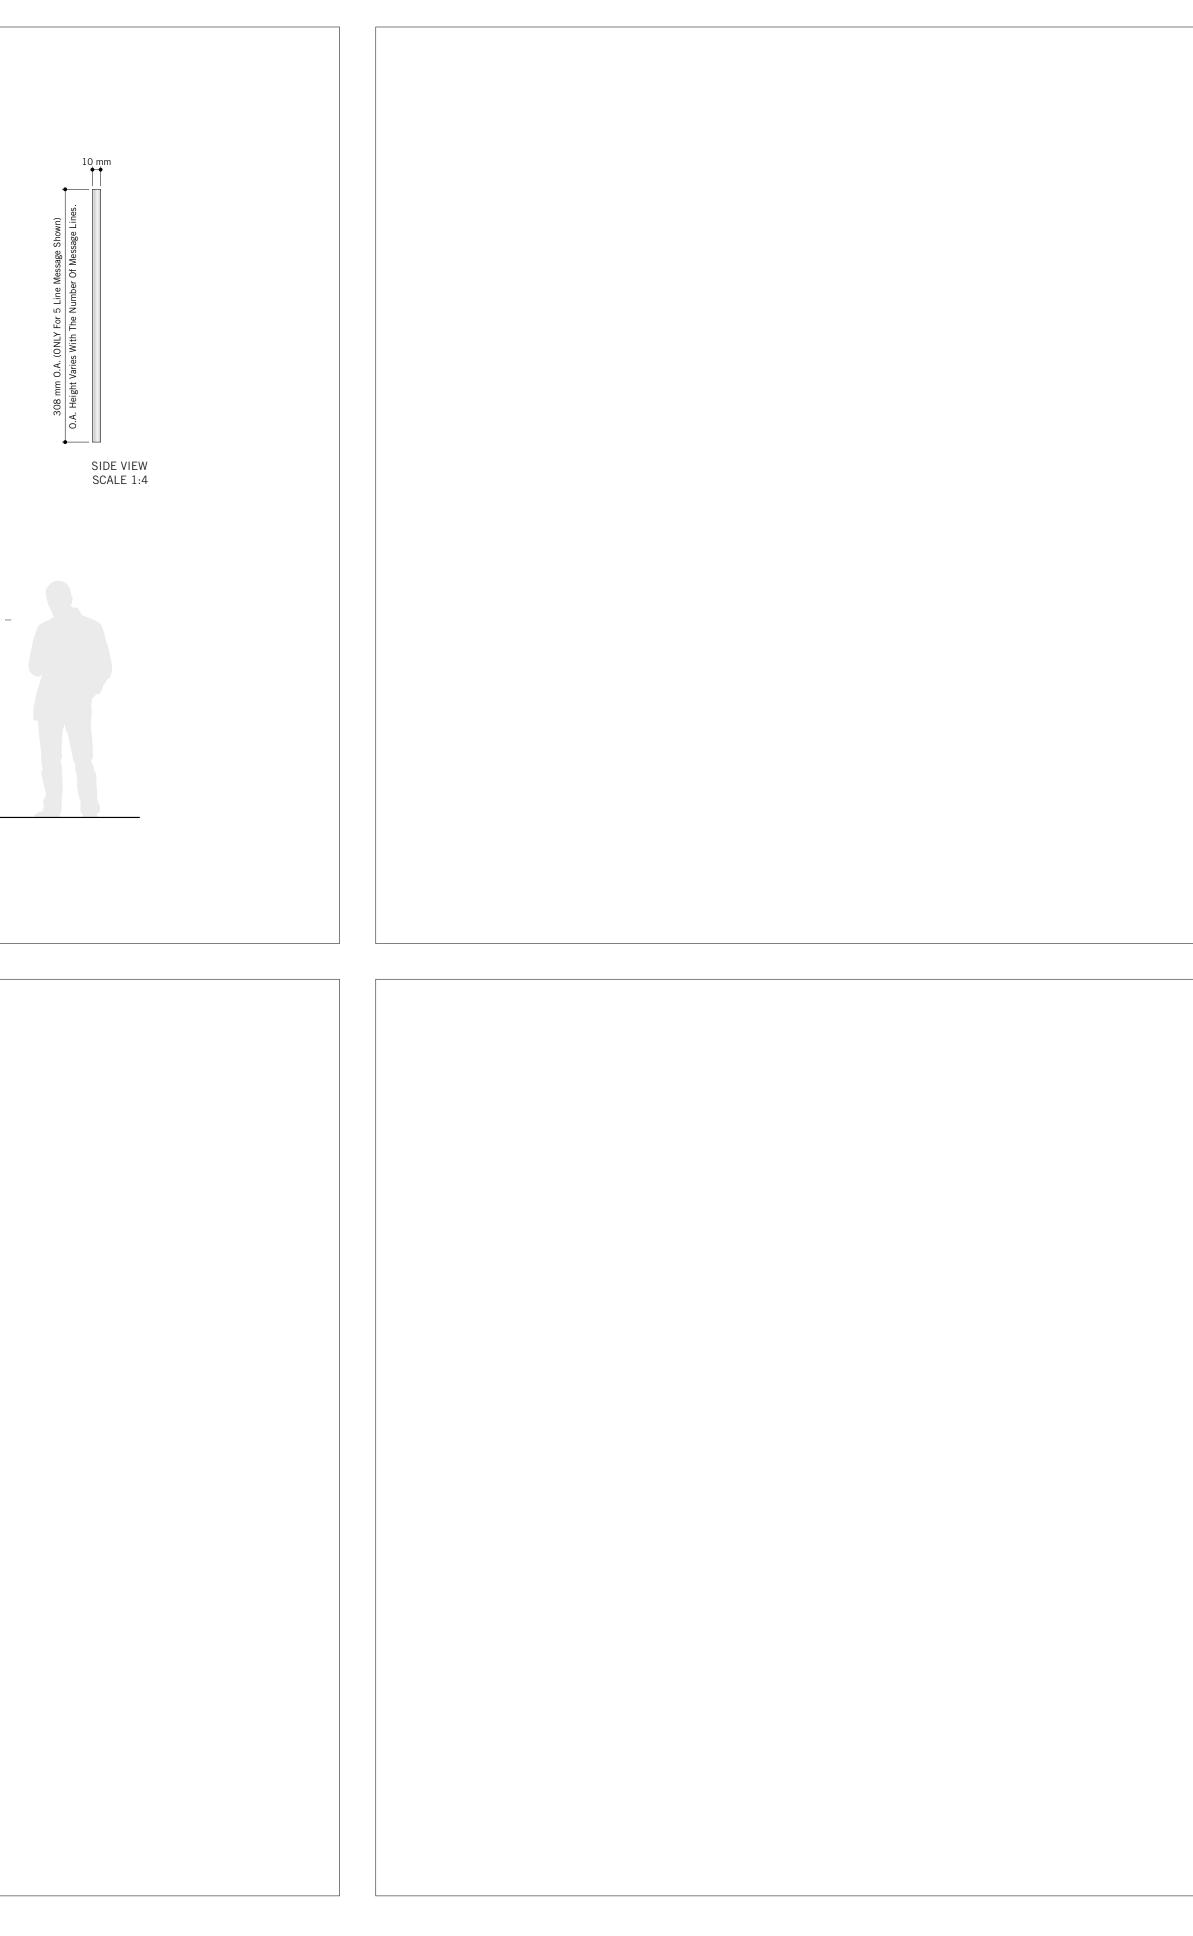




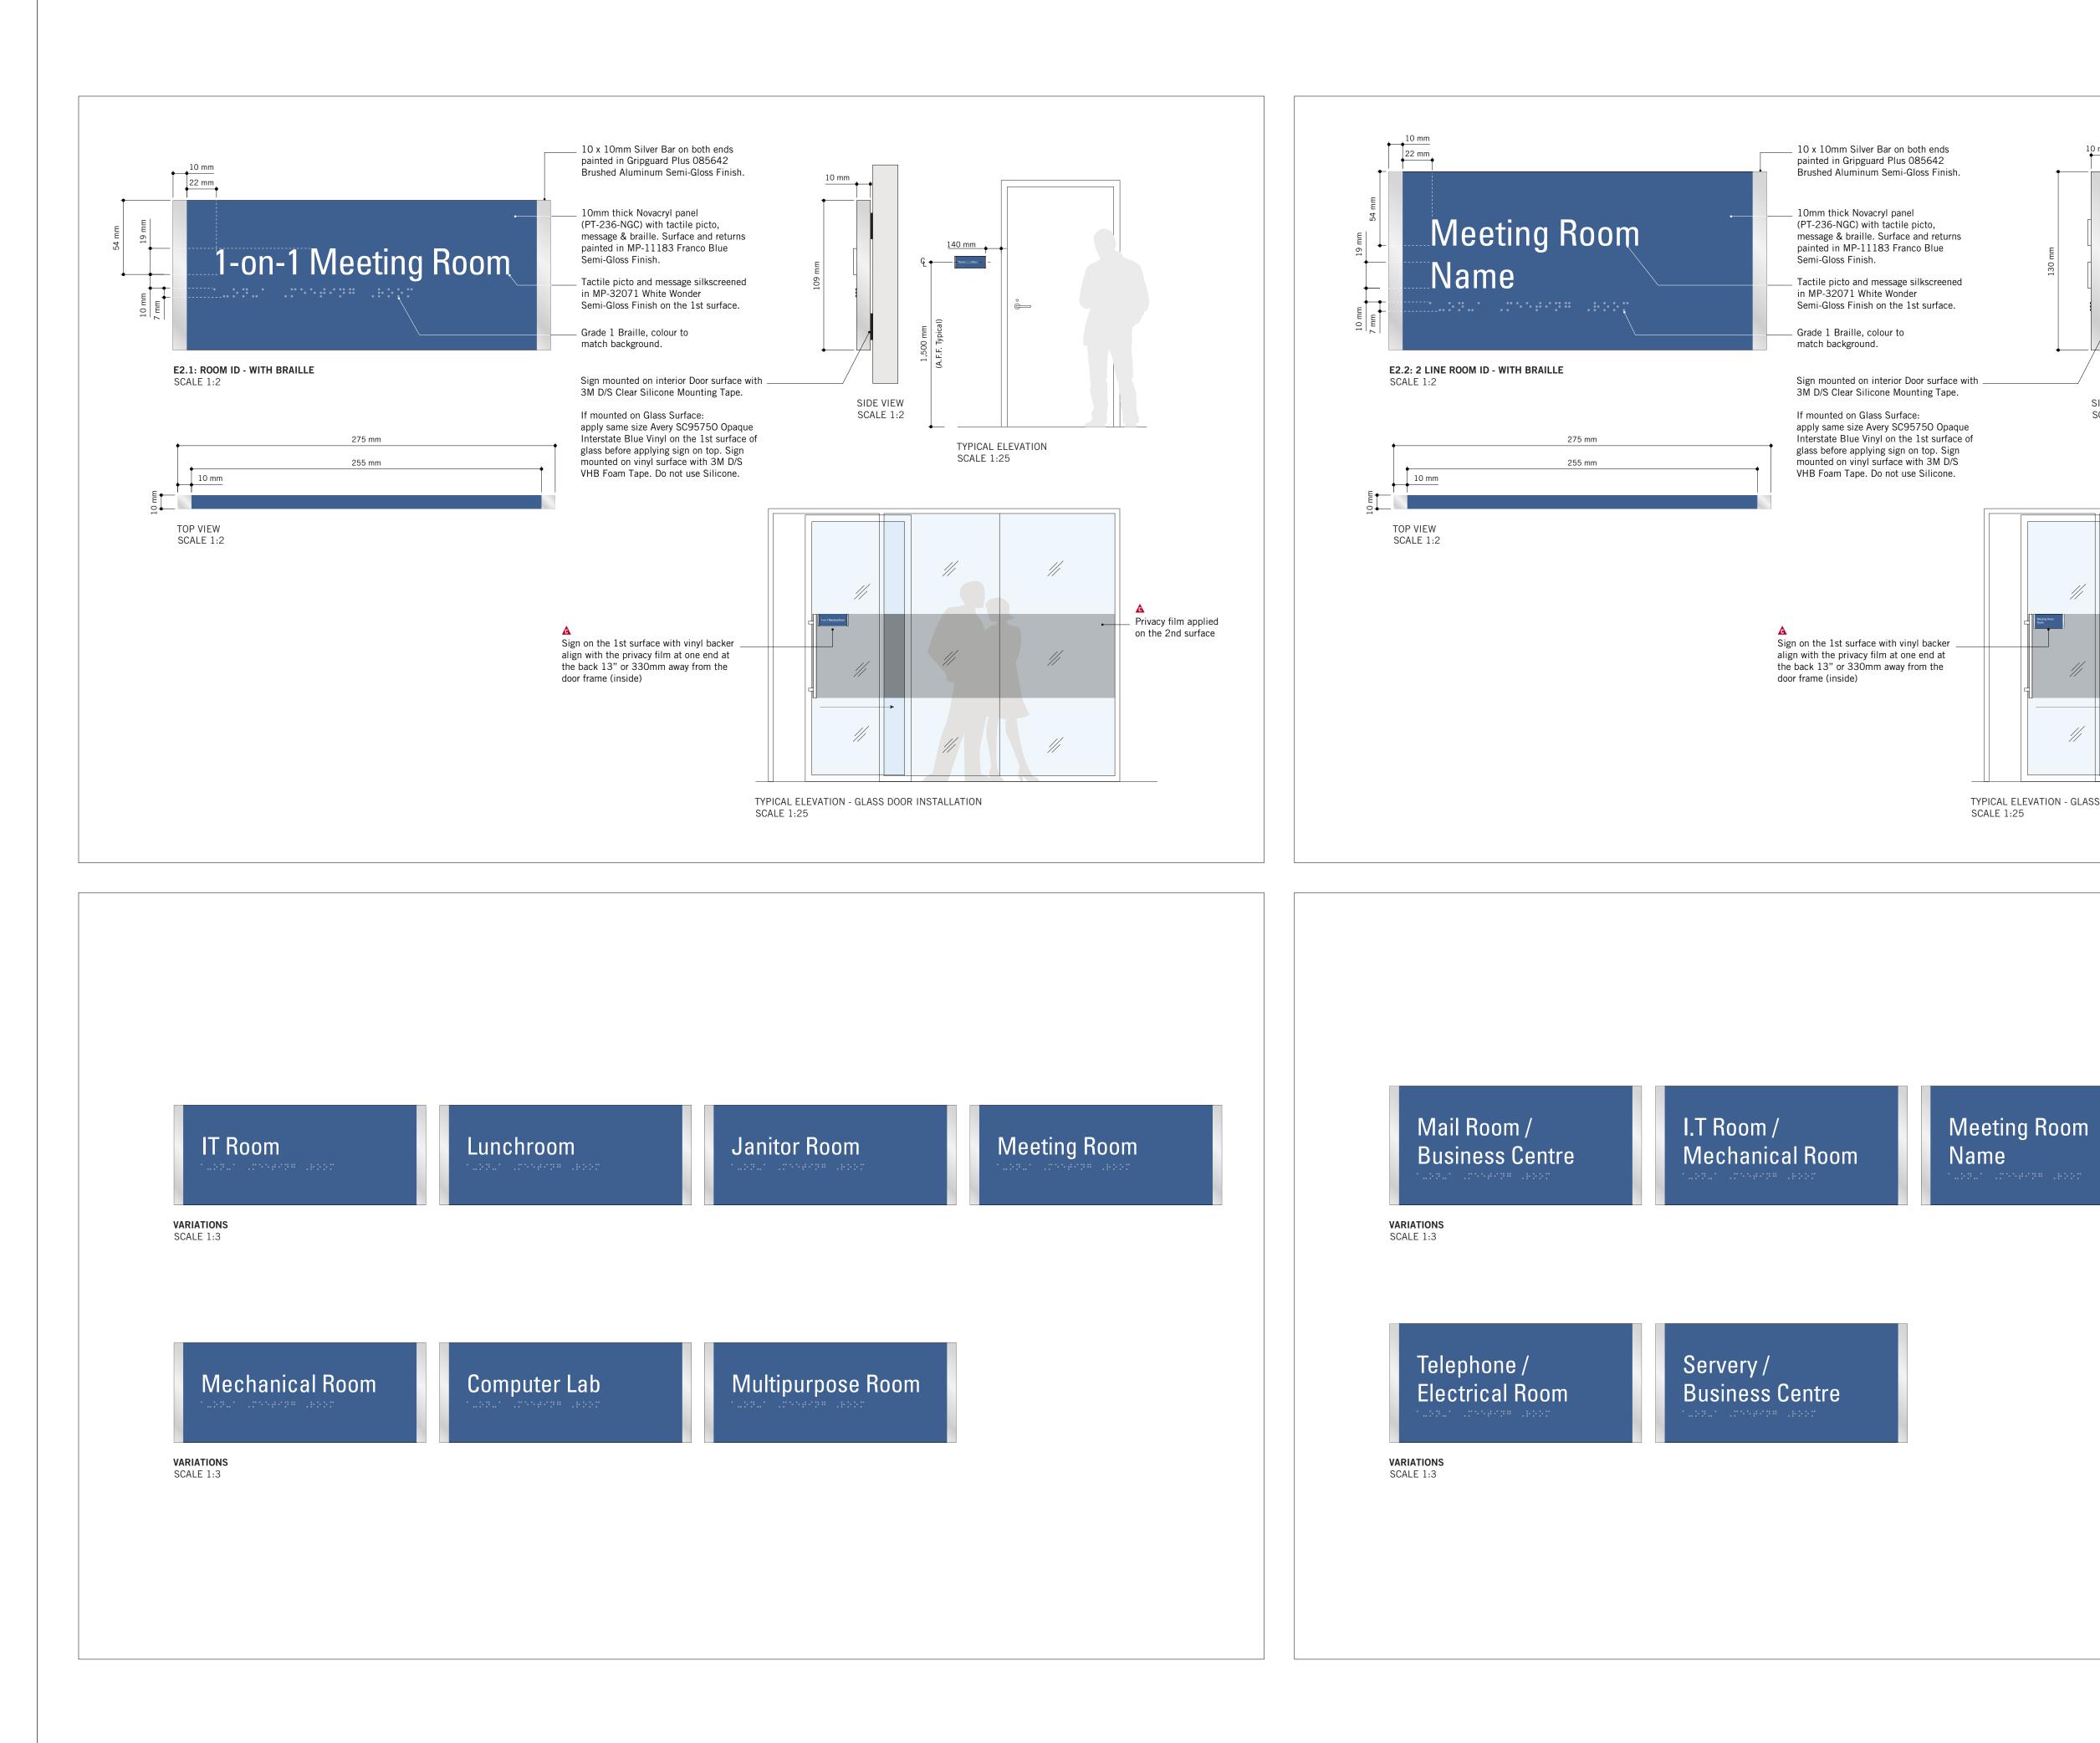


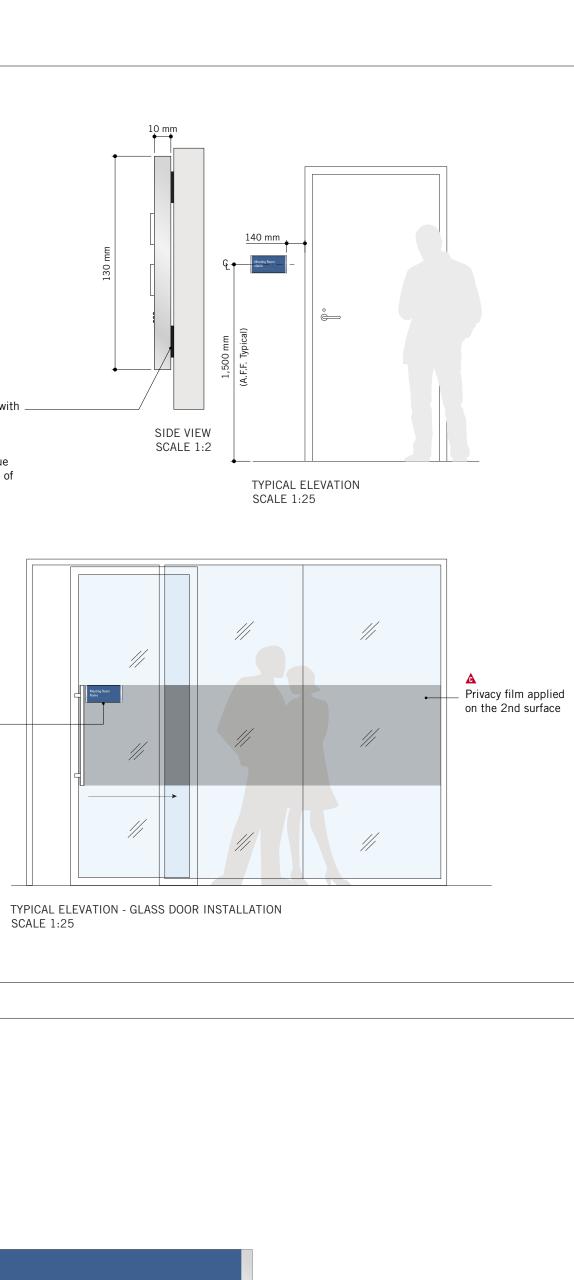




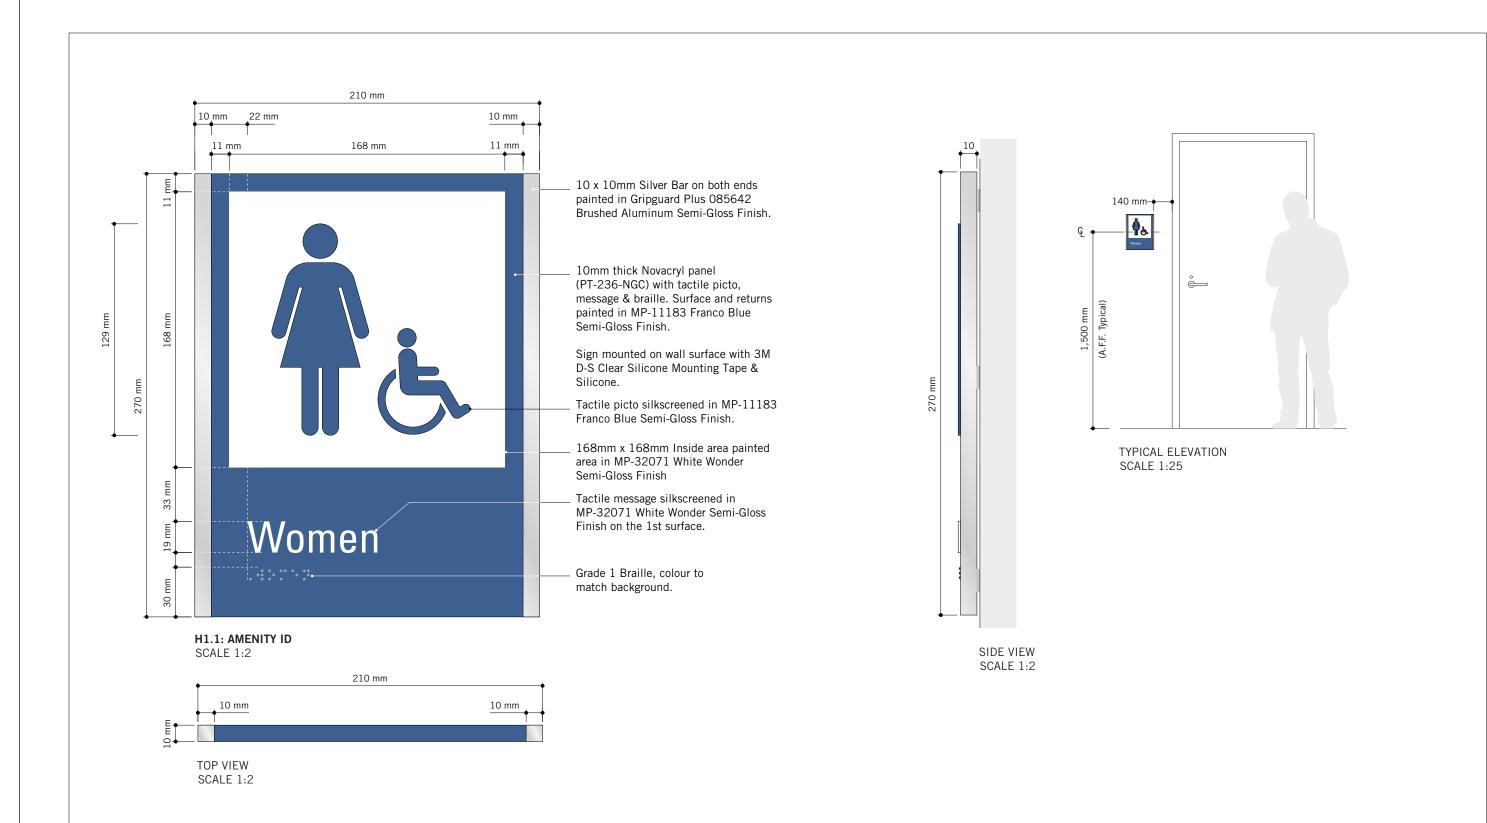


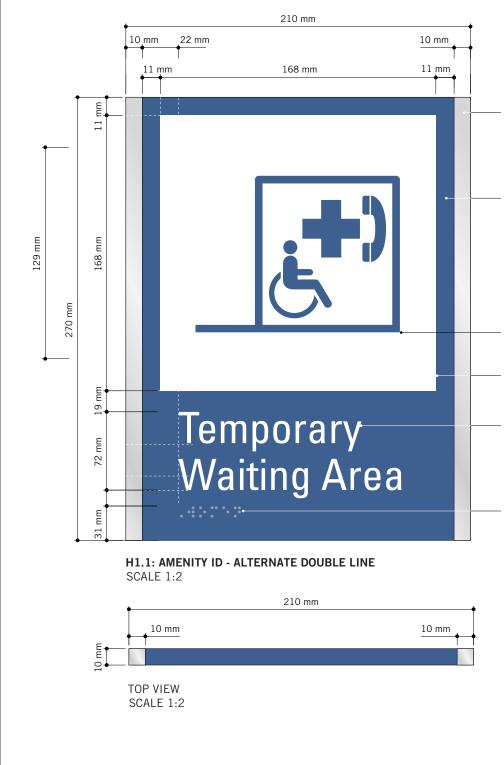
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| PROJECT TITLE CITY OF TORONTO ACCESSIBILITY UPGRA | |
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| PROJECT NO: 9119 – 19 – 0162 / IBI 122260 DRAWN BY: B. FERNANDEZ C.D. SCHNC PROJECT MGR: R. DALY | DBB |
| SHEET TITLE SIGNAGE & WAYFIND DETAILS | _ |
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CLIENT





10 x 10mm Silver Bar on both ends painted in Gripguard Plus 085642 Brushed Aluminum Semi-Gloss Finish.

10mm thick Novacryl panel (PT-236-NGC) with tactile picto, message & braille. Surface and returns painted in MP-11183 Franco Blue Semi-Gloss Finish.

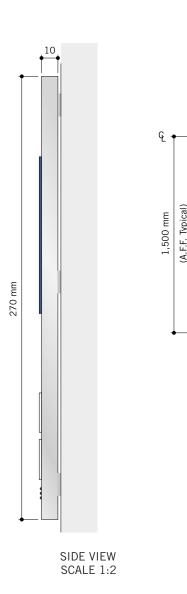
Sign mounted on wall surface with 3M D-S Clear Silicone Mounting Tape & Silicone.

_ Tactile picto silkscreened in MP-11183 Franco Blue Semi-Gloss Finish.

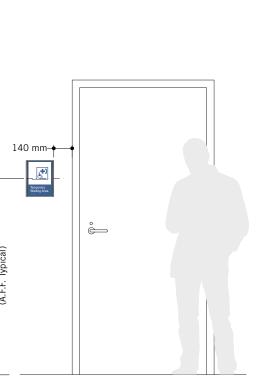
168mm x 168mm Inside area painted area in MP-32071 White Wonder Semi-Gloss Finish

_ Tactile message silkscreened in MP-32071 White Wonder Semi-Gloss Finish on the 1st surface.

Grade 1 Braille, colour to match background.

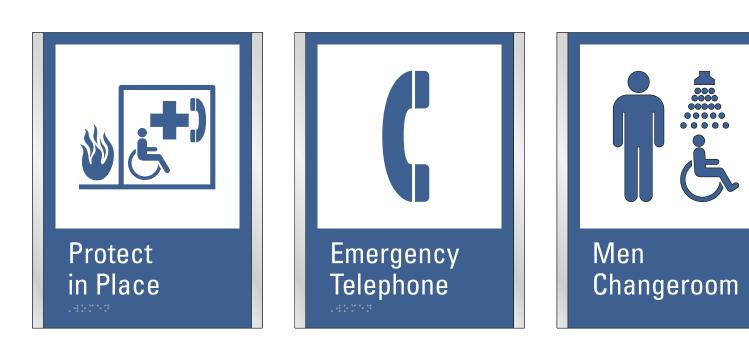


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TYPICAL ELEVATION SCALE 1:25

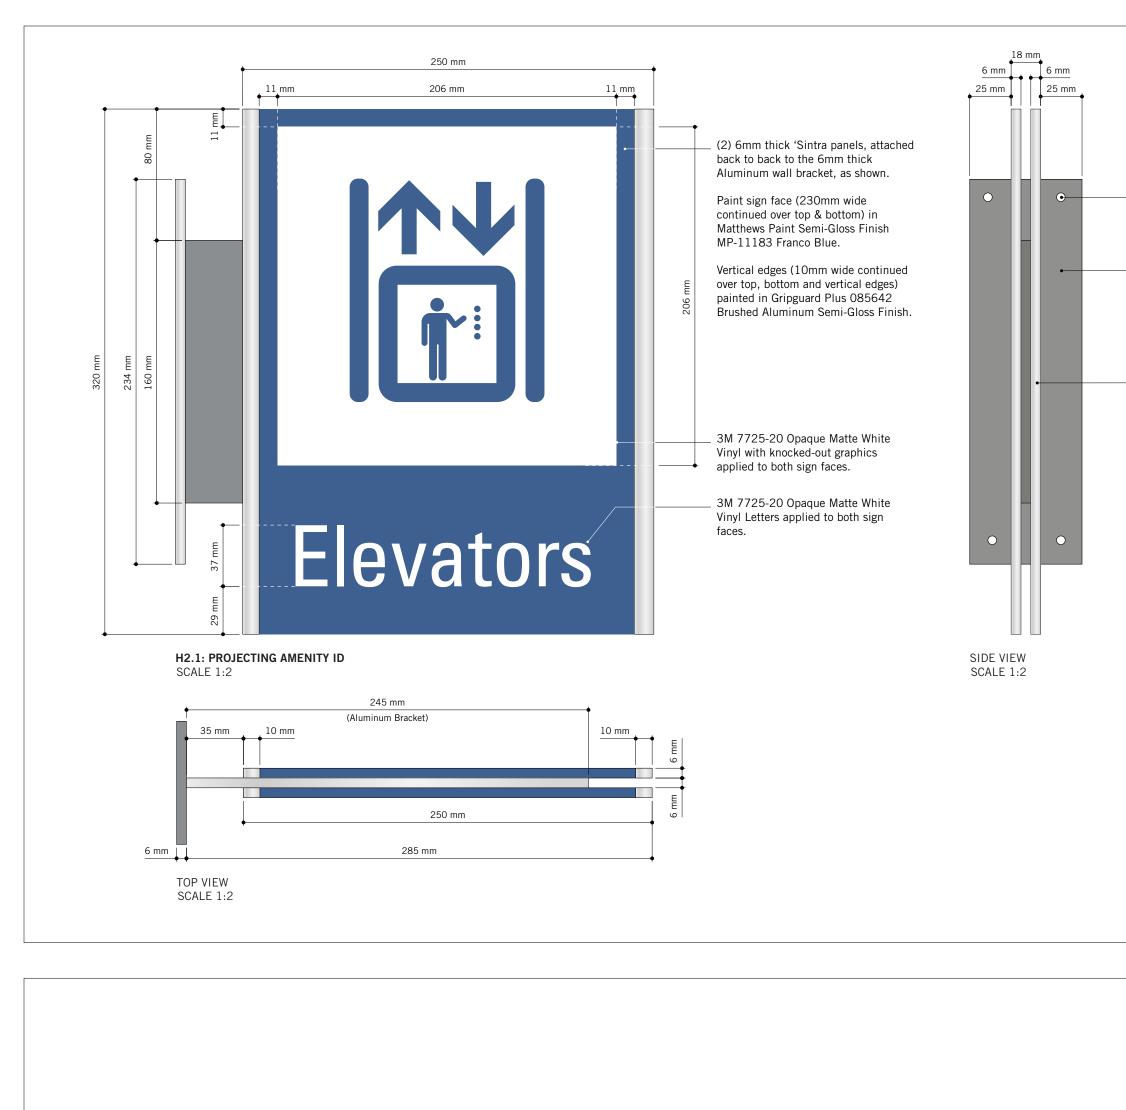




VARIATIONS SCALE 1:3

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(4) 1/4" C/S Toggle bolts into existing drywall (TBC). Heads painted to match.

 6mm (1/4") thick Aluminum Wall Plate Painted in Gripguard Plus 085642 Brushed Aluminum.
 C/W (2) grooves to accept aluminum support bracket - welded through plate.

 (2) 6mm thick Sintra panels, attached back to back to 6mm thick Aluminum bracket.



TYPICAL ELEVATION SCALE 1:25



VARIATIONS SCALE 1:4

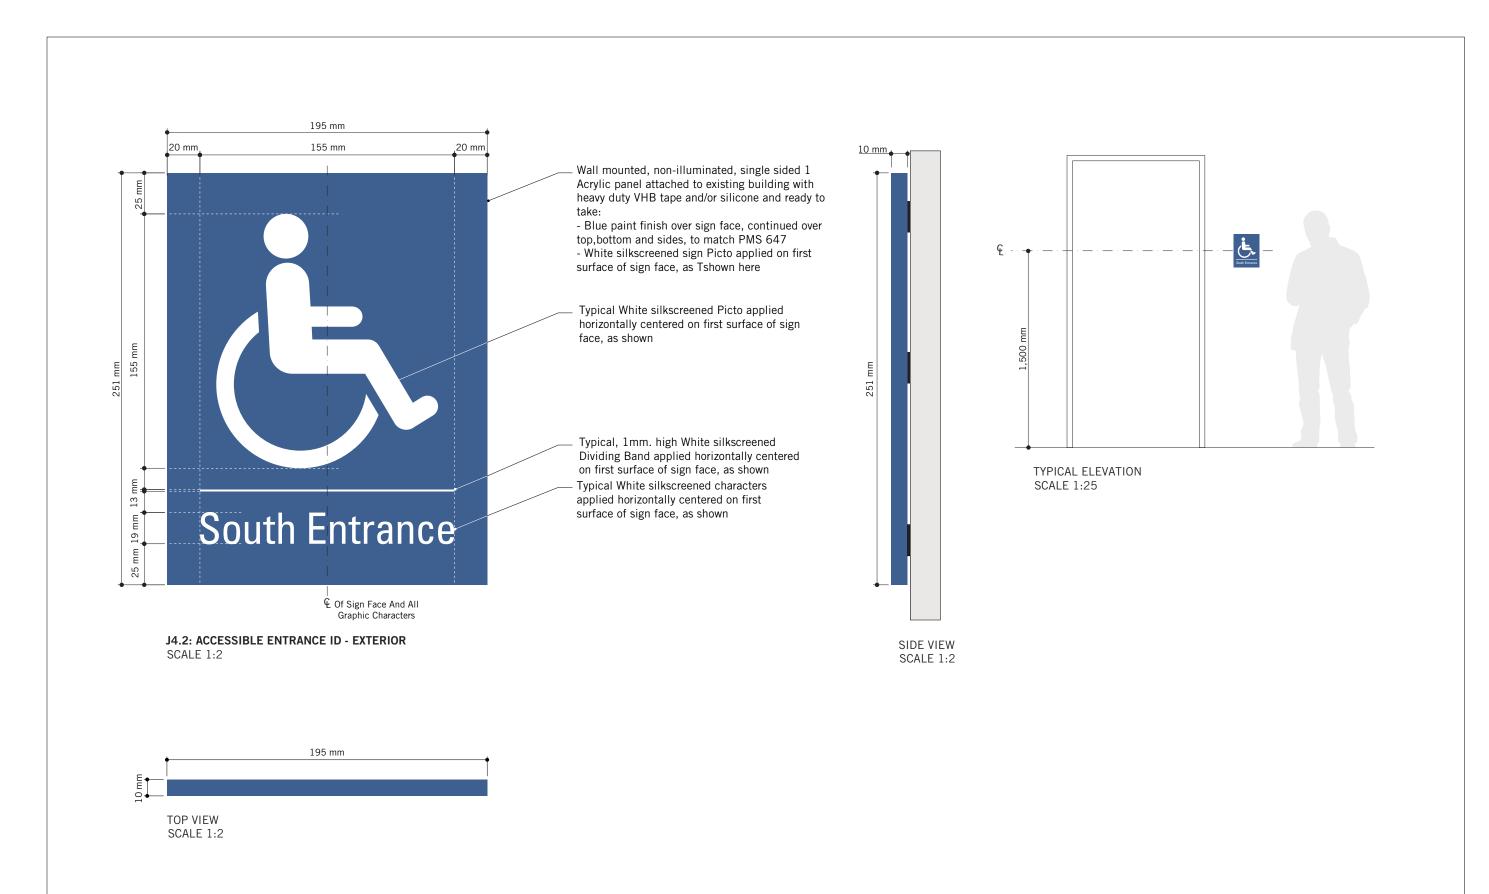


VARIATIONS SCALE 1:4





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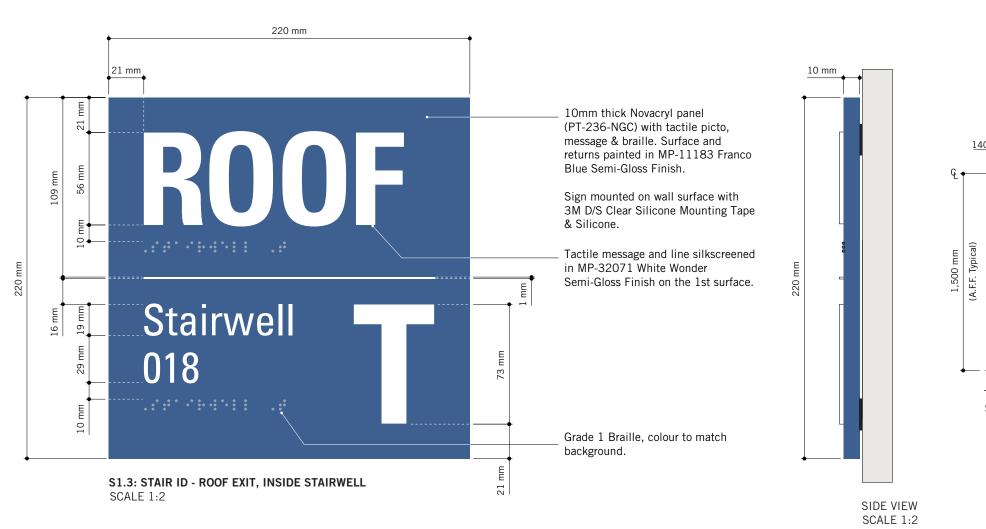
VARIATIONS SCALE 1:3

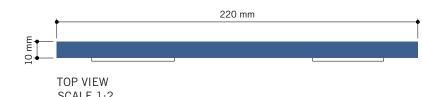




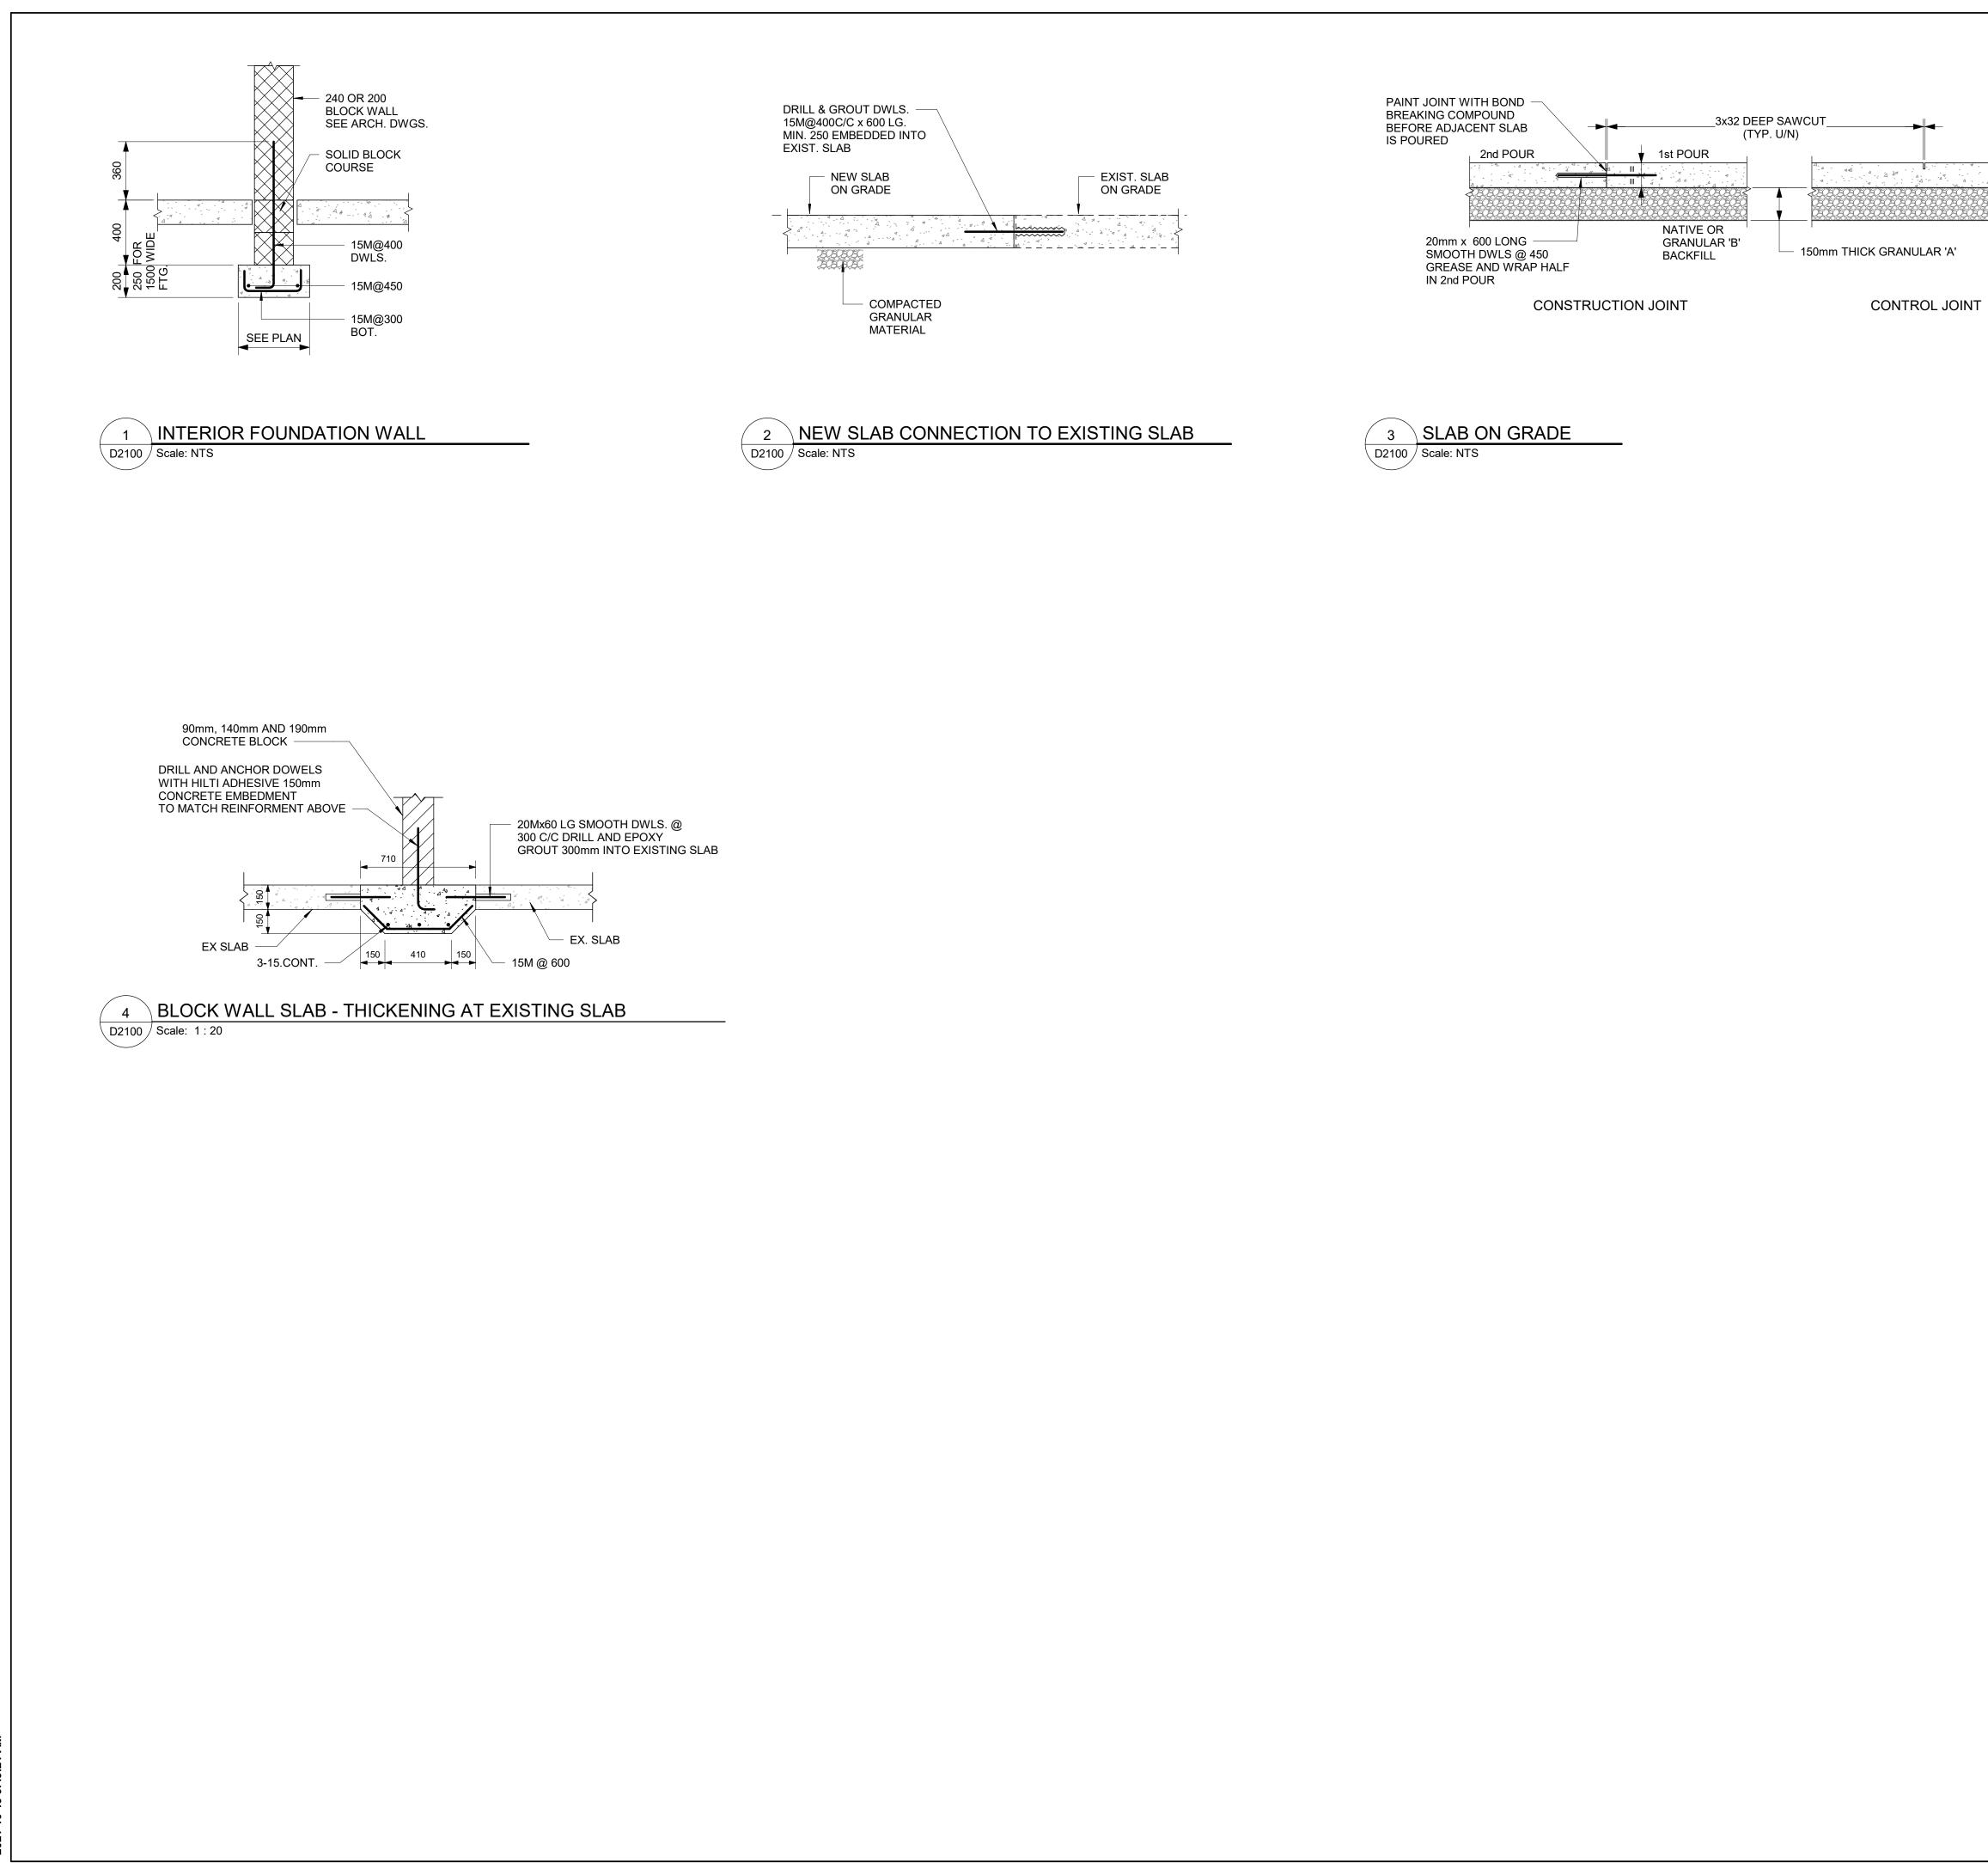
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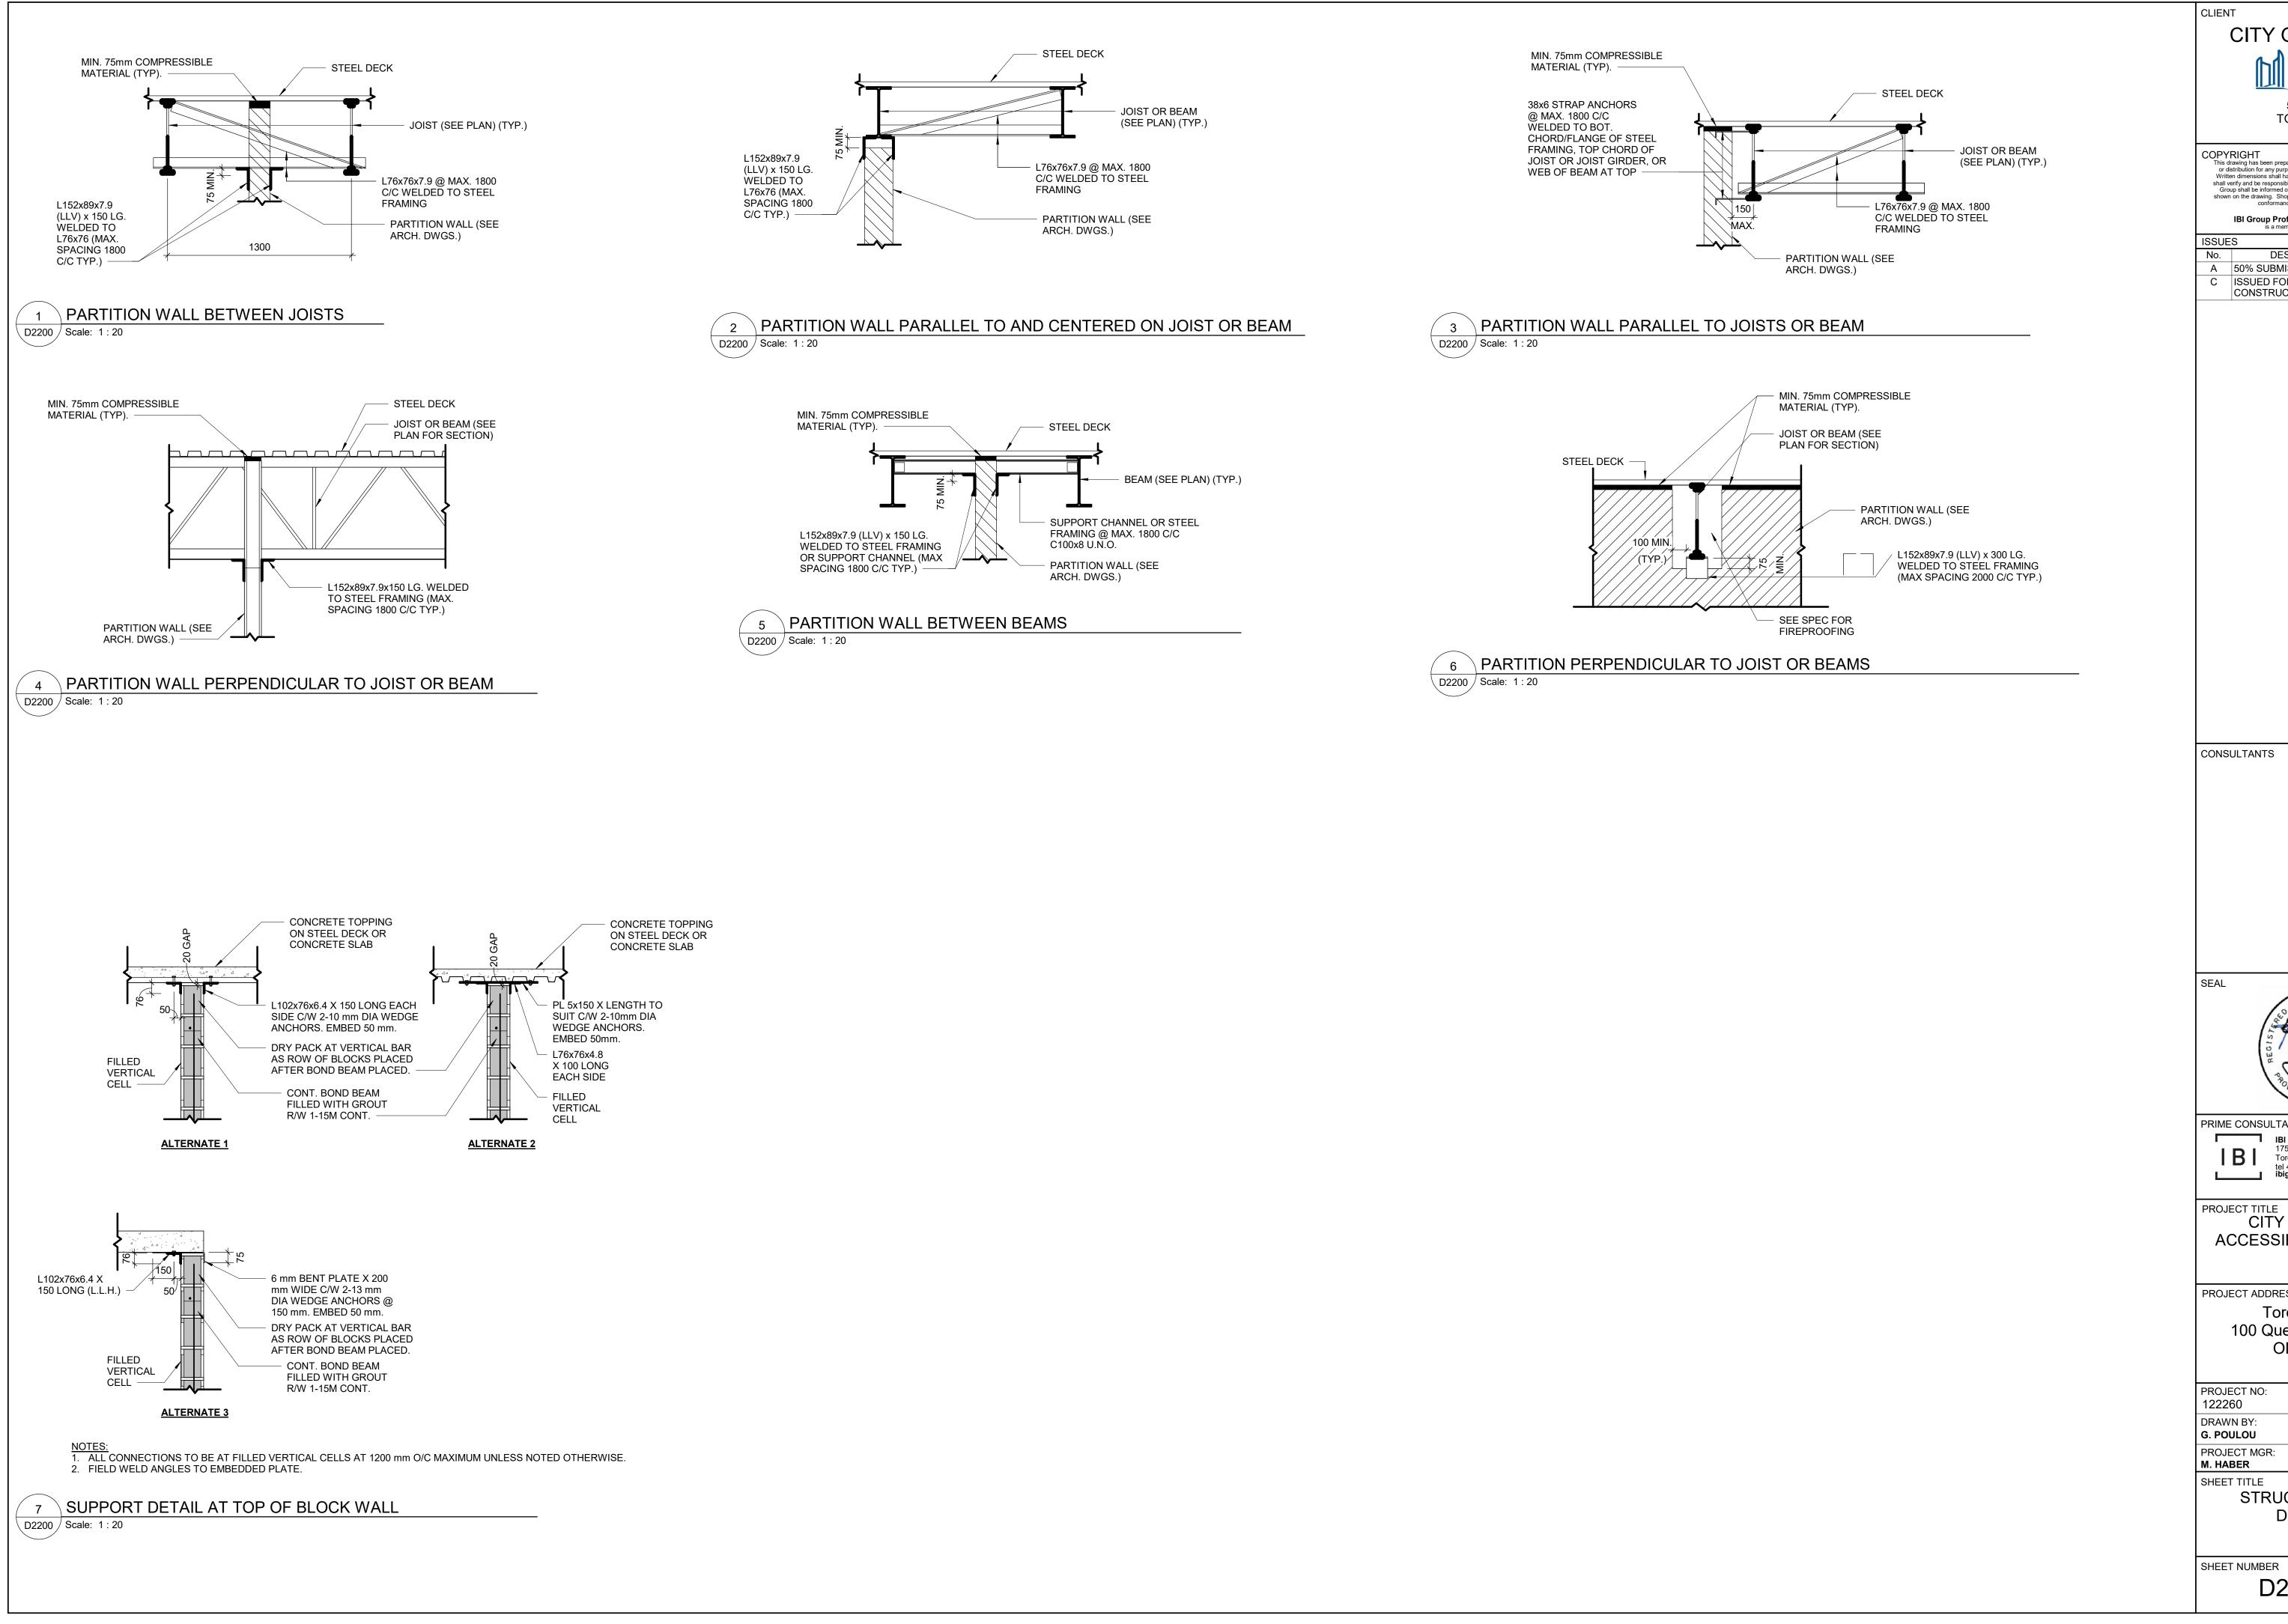




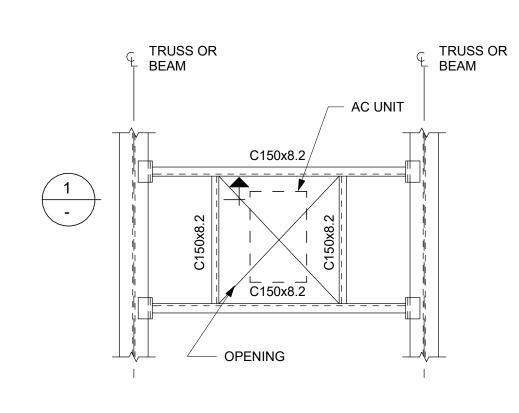
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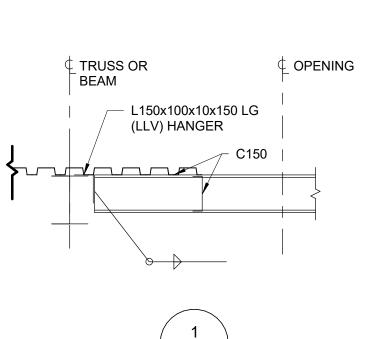
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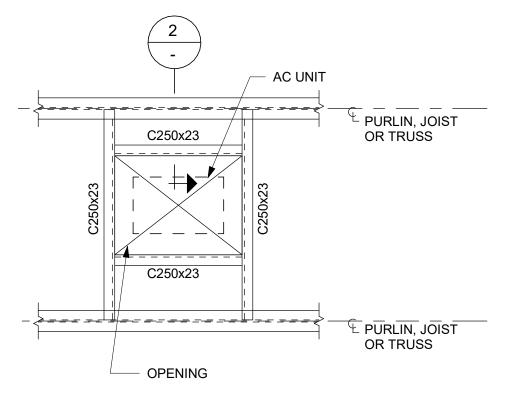
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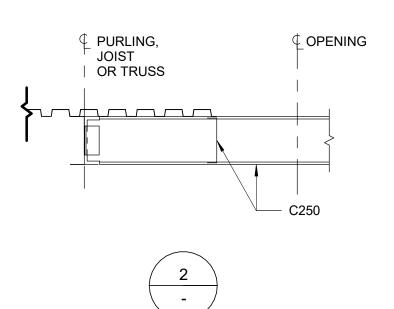




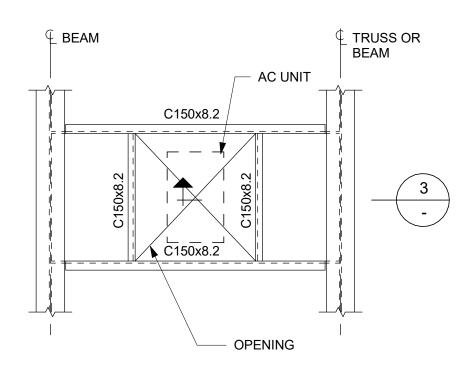
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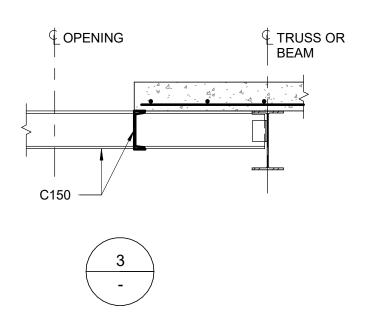
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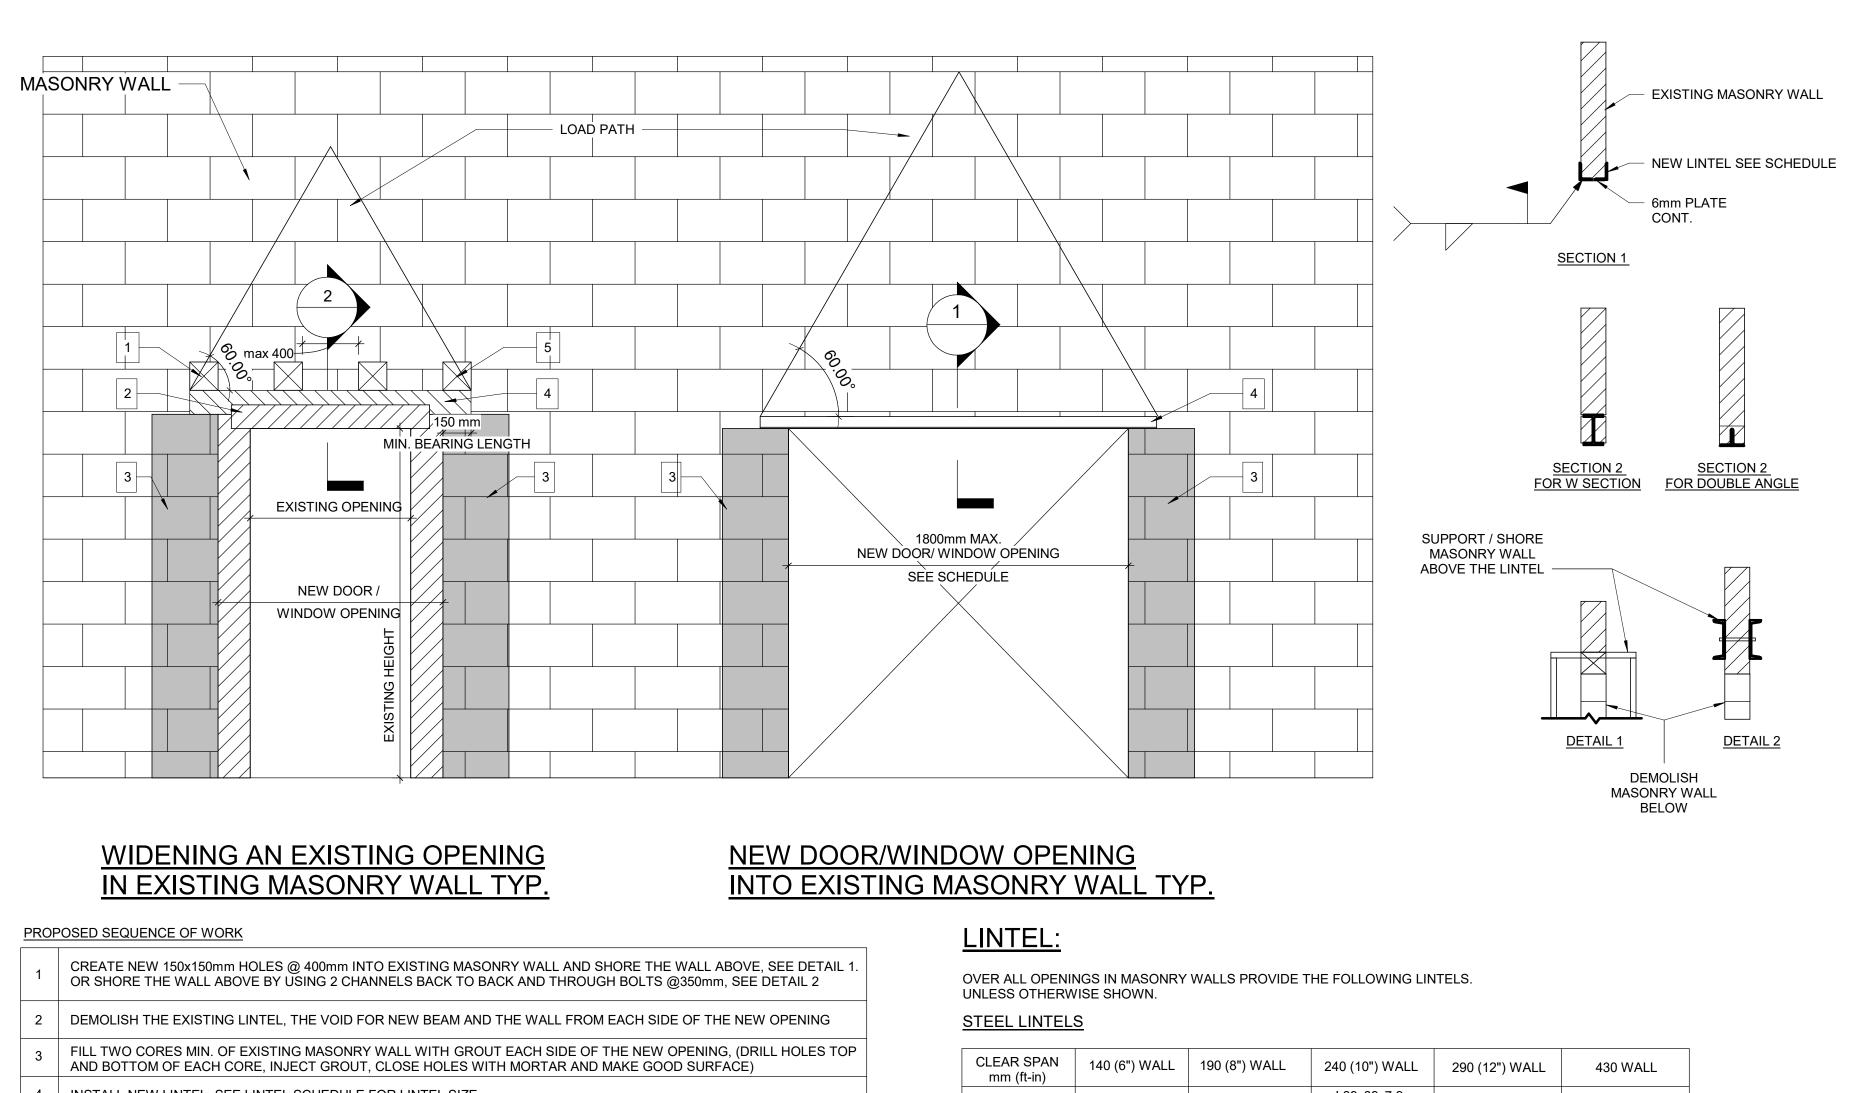
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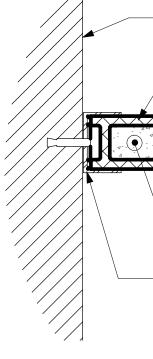
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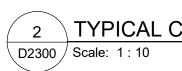




4 INSTALL NEW LINTEL. SEE LINTEL SCHEDULE FOR LINTEL SIZE

5 ADD MASONRY FACES AT LINTEL AND REPAIR MASONRY COURSE





| CLEAR SPAN mm (ft-in) | 140 (6") WALL | 190 (8") WALL | 240 (10") WALL | 290 (12") WALL | 430 WALL |
|-----------------------------|-----------------|-----------------------------|---|-----------------------------|-------------------------------|
| UP TO 1200 (4'-0") | L127x127x7.9 | 2-L89x89x7.9 +170x6mm PL | L89x89x7.9 +L127x89x7.9 LLV +220x6mm PL | 3-L89x89x7.9 +270x6mm PL | 3-L127X127X7.9 +410X6mm PL |
| 1201 TO 1800 (4'0 - 6'-) | 2-L89x64x6.4LLV | 2-L127x89x7.9LLV | L127x89x7.9LLV +L127x127x7.9 | 3-L127x89x7.9LLV | |
| 1801 TO 3100 (6'- 10') | 2-L89x64x9.5LLV | 2-L152x89x9.5LLV | 2-L152x89x9.5LLV | 3-L152x89x9.5LLV | |

| | CLIENT CITY OF TORONTO TORONTO, ON M5V 3C6 |
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| FACE OF EXIST. WALL MASONRY WALL REFER TO PLAN | COPYRIGHT This drawing has been prepared solely for the intended use, thus any reproduction or distribution for any purpose other than authorized by IBI Group is forbidden. Written dimensions shall have precedence over scaled dimensions. Contractors shall verify and be responsible for all dimensions and conditions on the job, and IBI Group shall be informed of any variations from the dimensions and conditions shown on the drawing. Shop drawings shall be submitted to IBI Group for general conformance before proceeding with fabrication. IBI Group Professional Services (Canada) Inc. is a member of the IBI Group of companies |
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| 1-15M FOR 2-FULL GROUTED CORES 6 GALV. BENT PL. CONT. C/W 13ØX89 EMBED HILTI KWIK OR EQUIVALENT BOLT II @ 600 O/C INTO CORE FILLED CONC. BLOCK/CONC. SURFACE. USE 13Ø HILTI HIT HY-20 ADHESIVE ANCHOR C/W 51 EMBED OR EQUIVALENT FOR HOLLOW CONC. BLOCK AND 86 EMBED FOR BRICK VENEER WITH HOLES | |
| MU WALL CONNECTION TO EXISTING WALL | |
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| | PRIME CONSULTANT IBI GROUP 175 Galaxy Blvd, Unit 100 Toronto, ON M9W 0C9, Canada tel 416 679 1930 fax 416 675 4620 ibigroup.com |
| | PROJECT TITLE CITY OF TORONTO ACCESSIBILITY UPGRADES |
| | PROJECT ADDRESS Toronto City Hall 100 Queen St W Toronto, ON MPG 1P5 |
| | PROJECT NO: 122260 DRAWN BY: CHECKED BY: G. POULOU S. NASSER PROJECT MGR: APPROVED BY: M. HABER K. ANGER SHEET TITLE MASONRY DETAILS |
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PLUMBING FIXTURE SCHEDULE

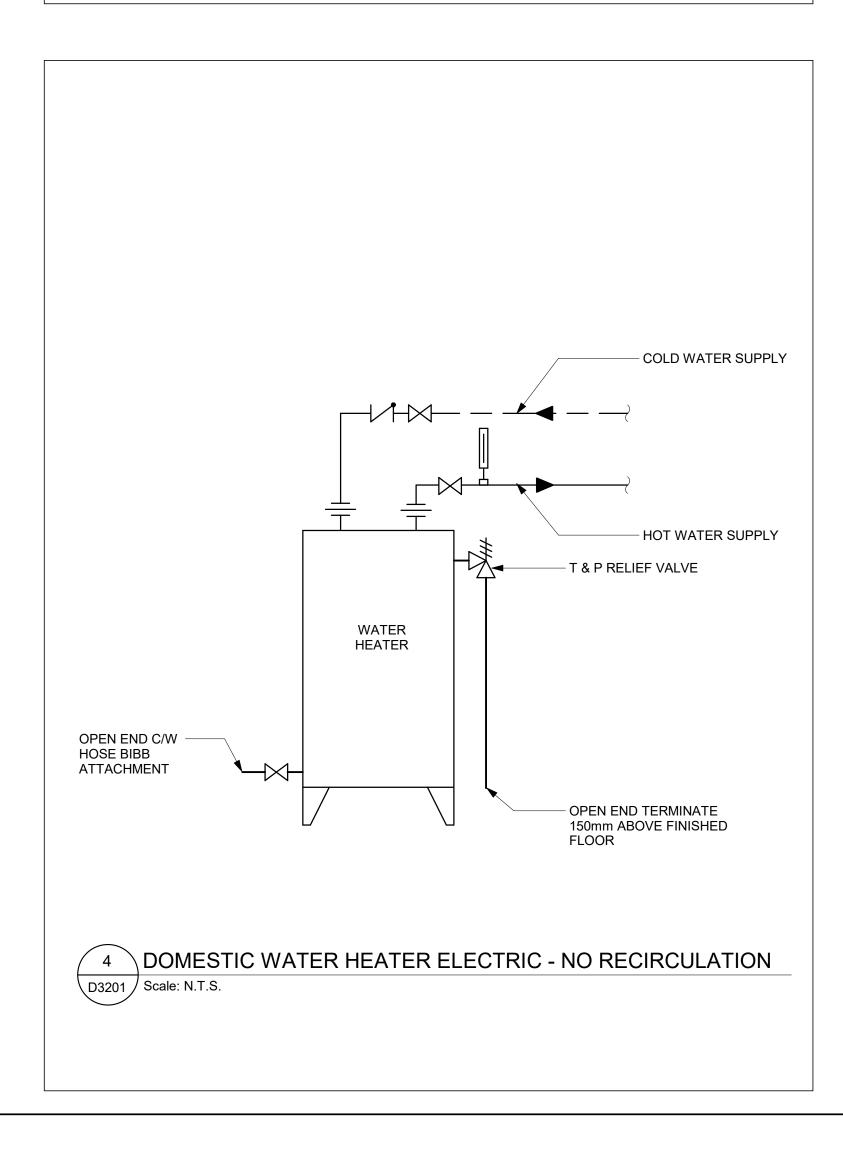
| DECODIDION | | SERV | DEMARKS | | |
|----------------------------|----|------|---------|------|---------|
| DESCRIPTION | CW | HW | WASTE | VENT | REMARKS |
| WATER CLOSET (FLUSH VALVE) | 25 | - | 75 | 40 | |
| WATER CLOSET (FLUSH TANK) | 12 | - | 75 | 40 | |
| URINAL (FLUSH VALVE) | 20 | - | 50 | 40 | |
| URINAL (FLUSH TANK) | 12 | - | 40 | 32 | |
| LAVATORY | 12 | 12 | 32 | 32 | |
| SHOWER | 12 | 12 | 75 | 32 | |
| SERVICE SINK | 12 | 12 | 75 | 40 | |
| DRINKING FOUNTAIN | 12 | - | 32 | 32 | |
| SINKS | 12 | 12 | 40 | 32 | |
| GROUP WASH FOUNTAIN | 25 | 25 | 40 | 40 | |
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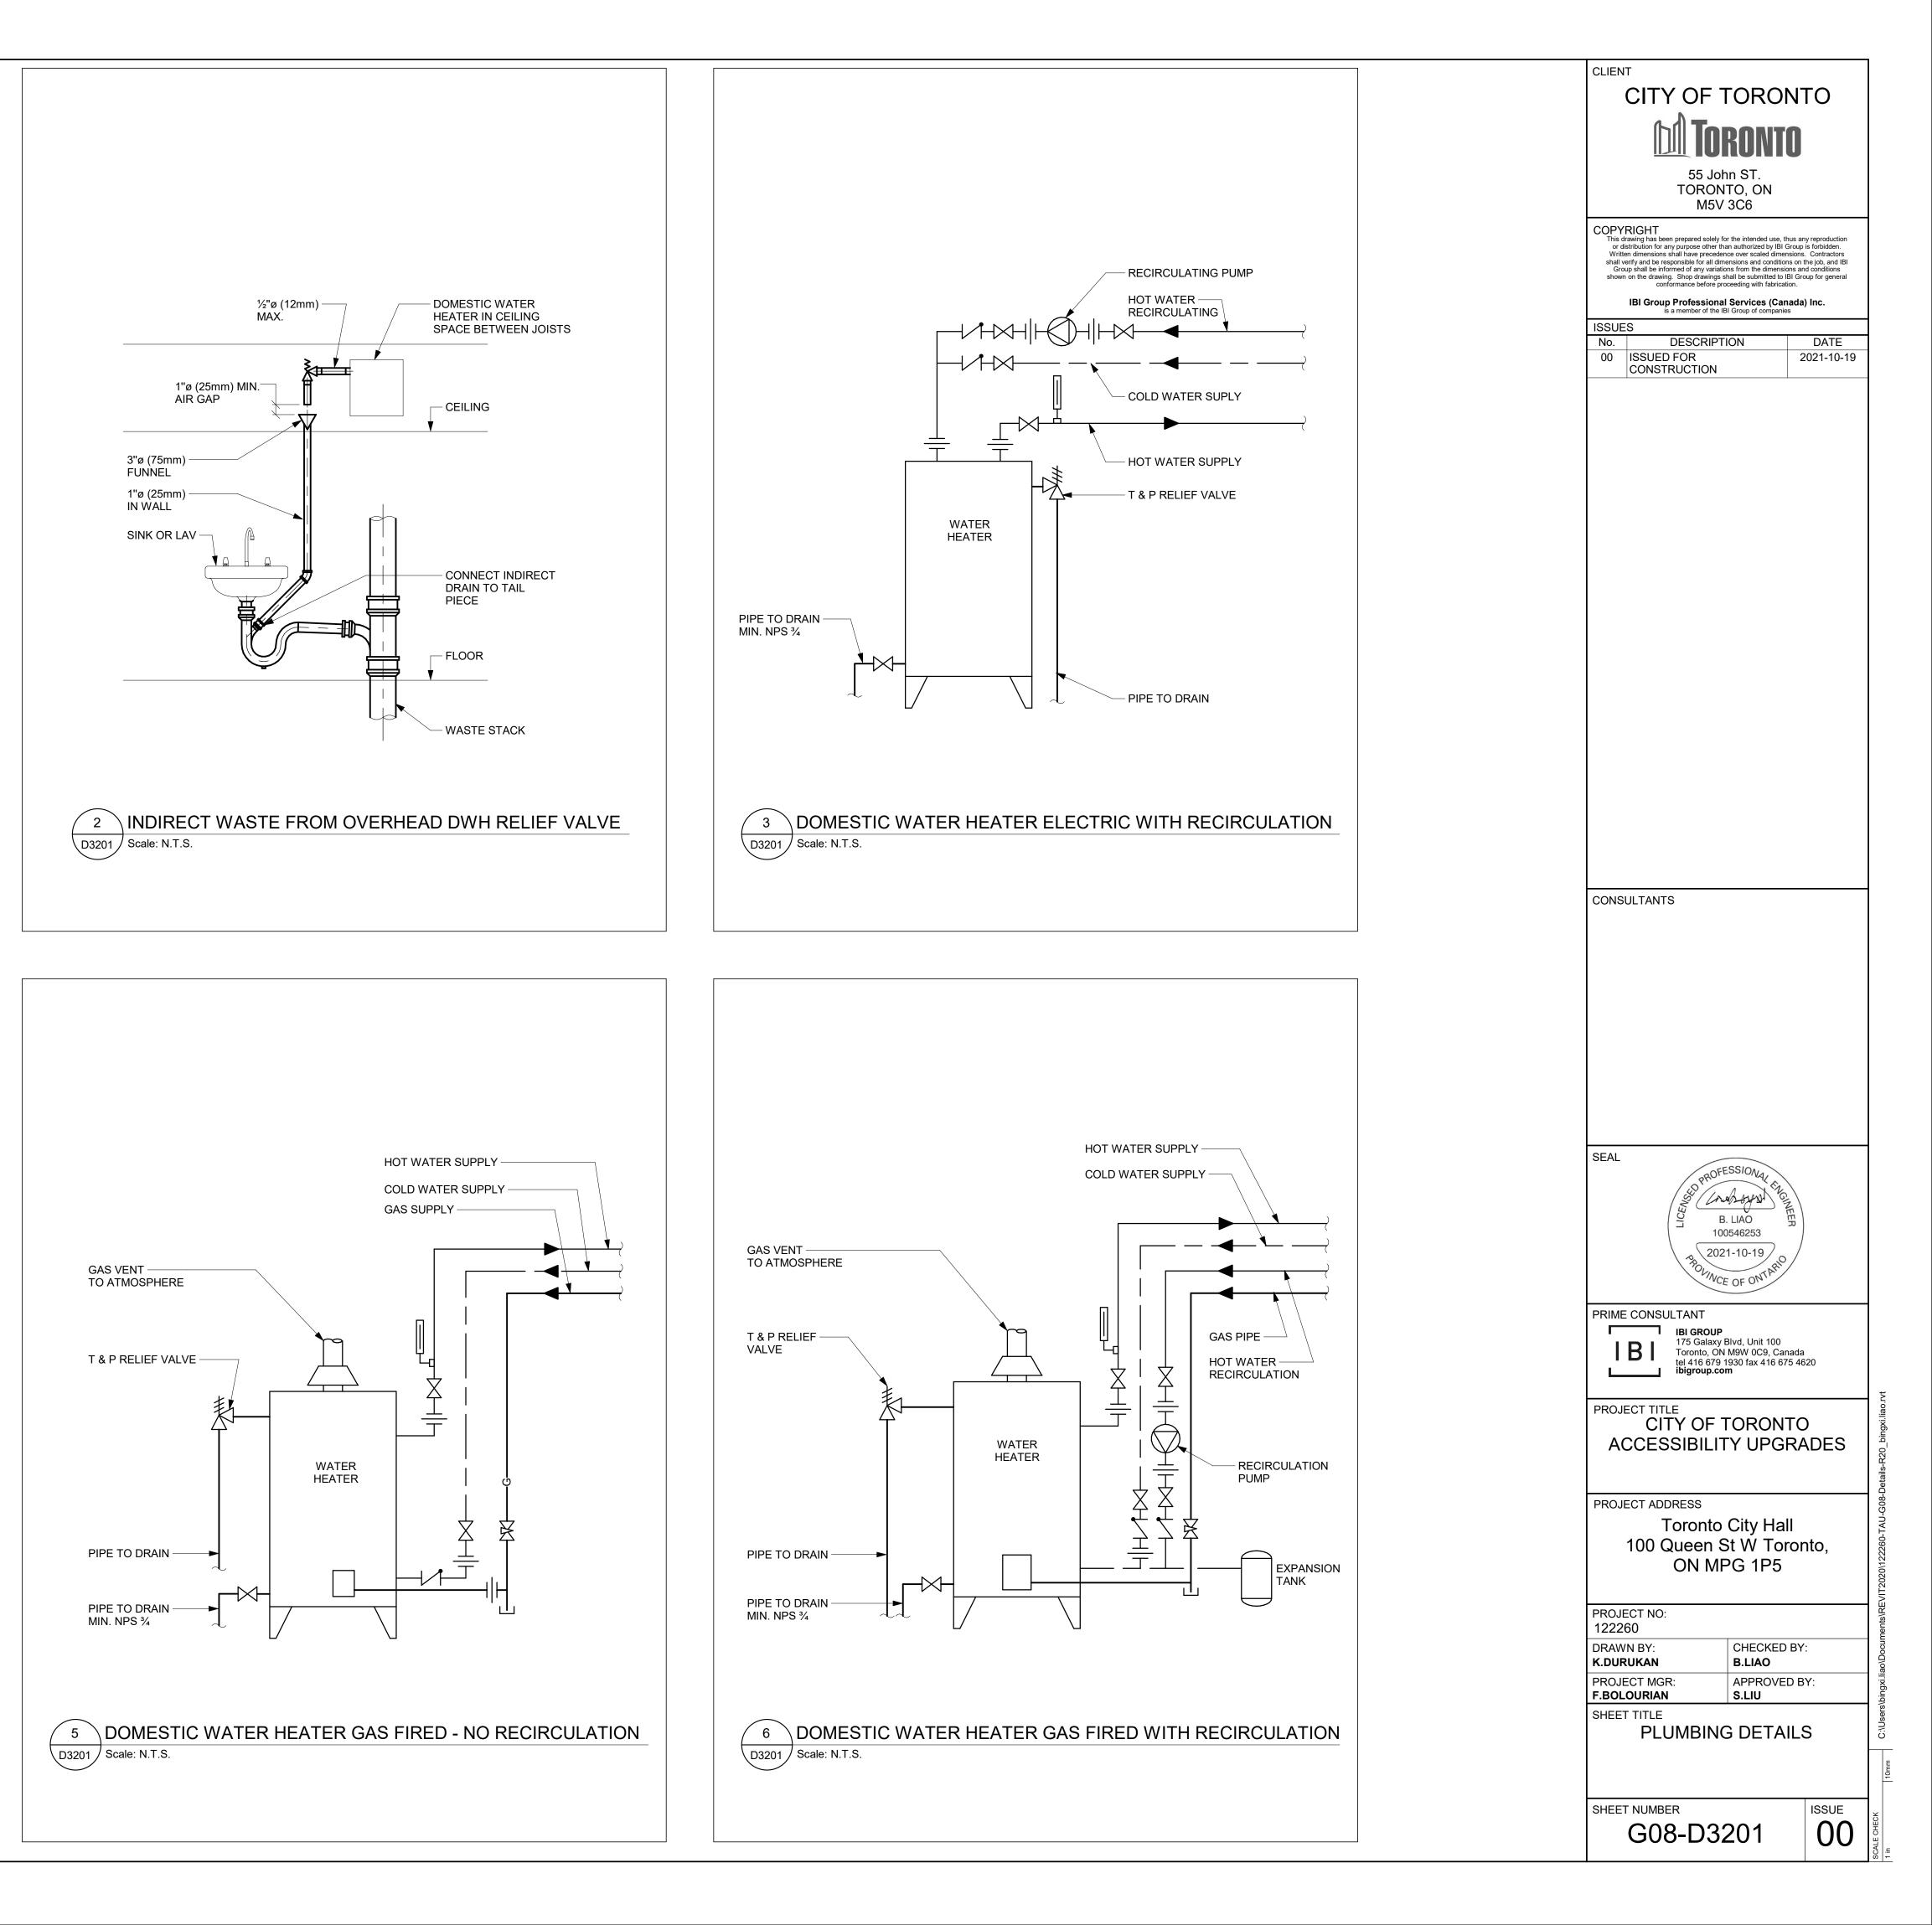
1. SIZING OF SUPPLIES INSIDE WASHROOM TO BE BASED ON 35 KPa PRESSURE DROP PER 30m OF PIPE OR MAXIMUM VELOCITY OF 1.2 mps.

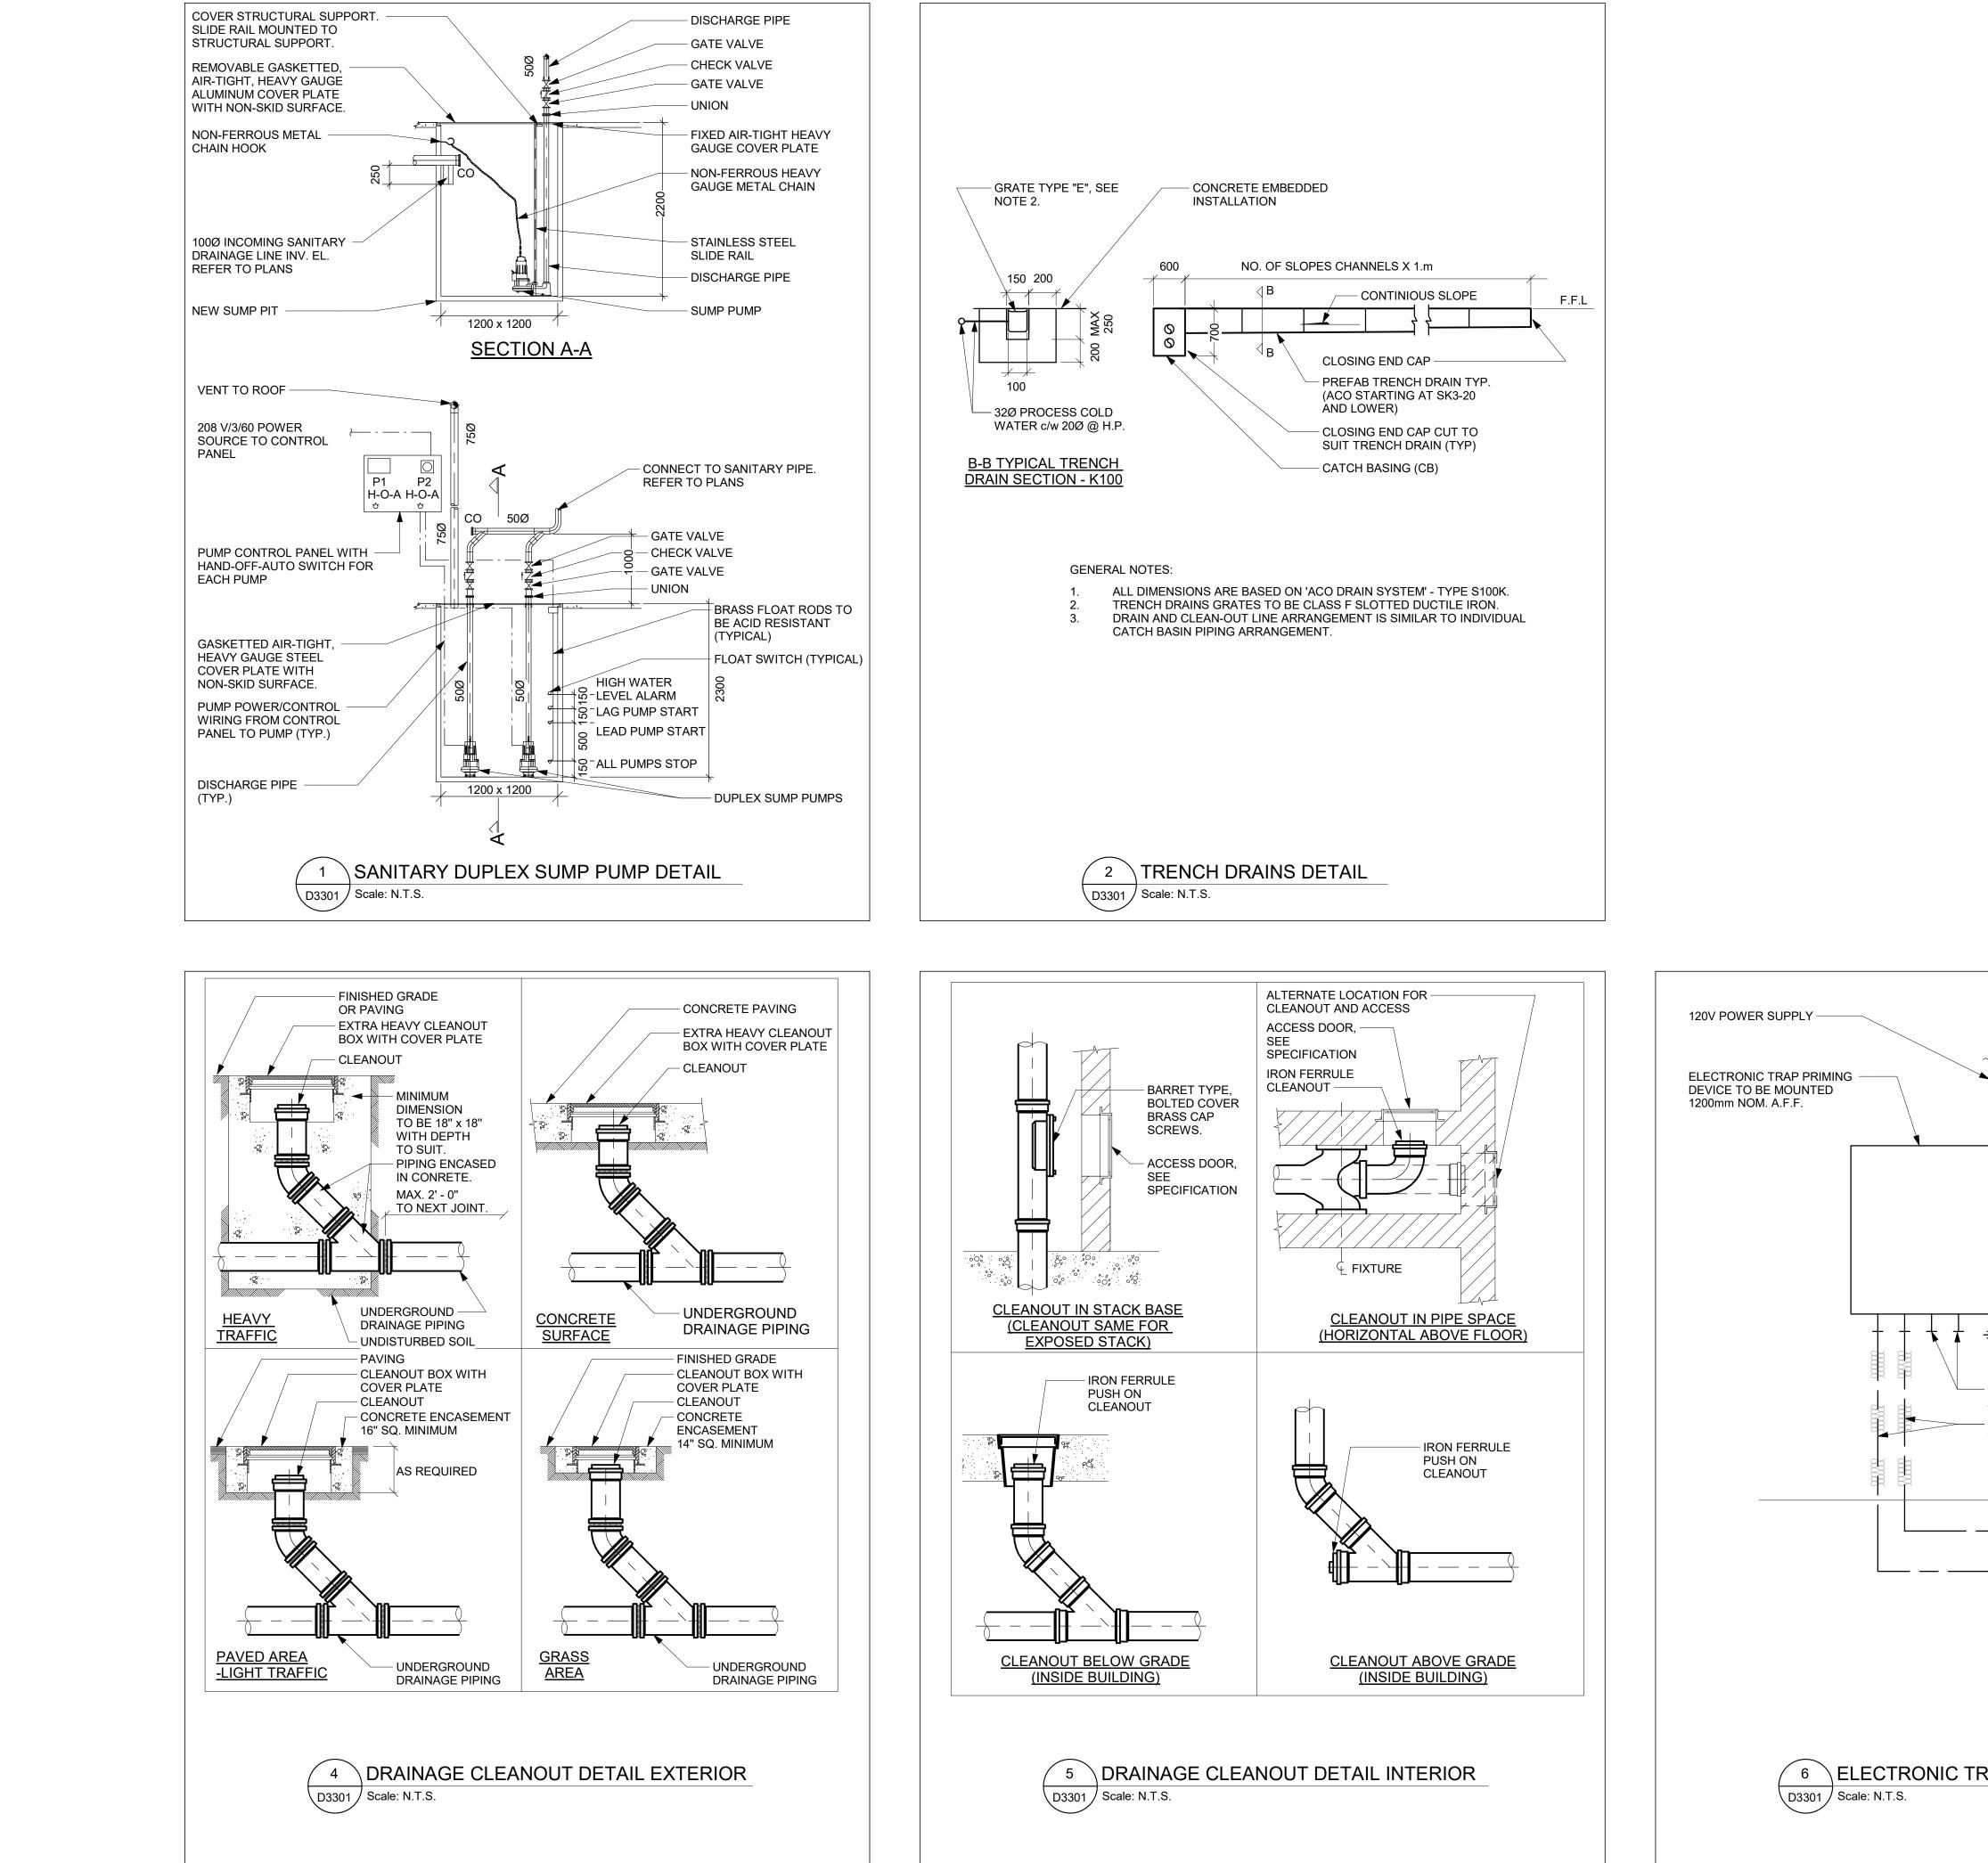
2. CONTRACTOR SHALL PROVIDE SHOP DRAWING OF PLUMBING AND DRAINAGE INSIDE WASHROOM AREA FOR ALL WASHROOMS.

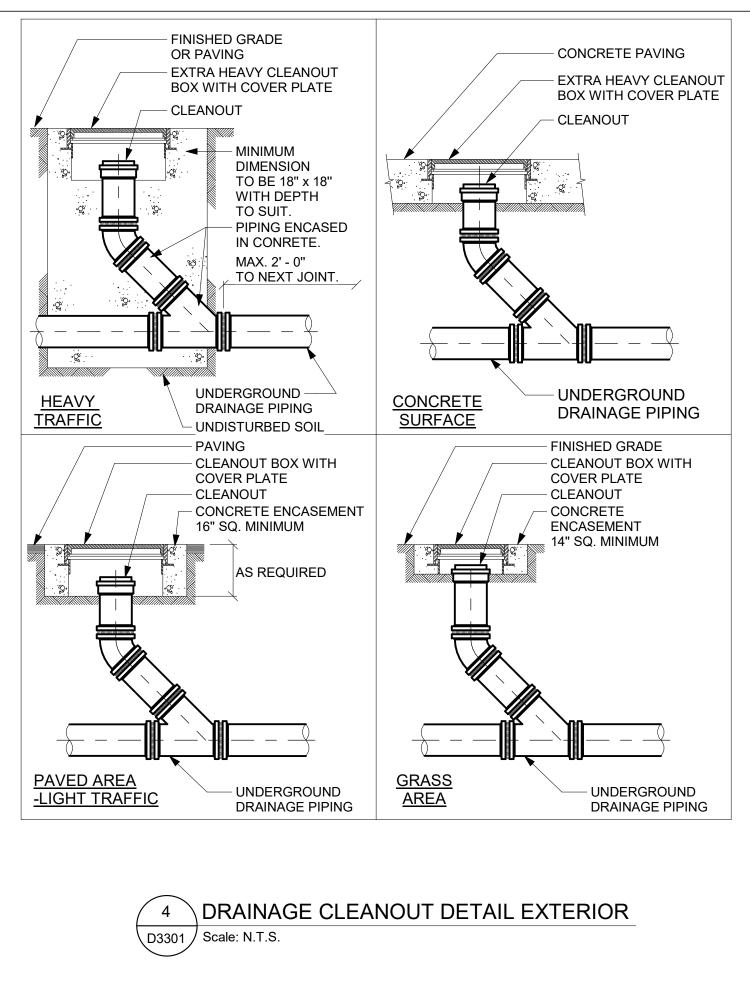
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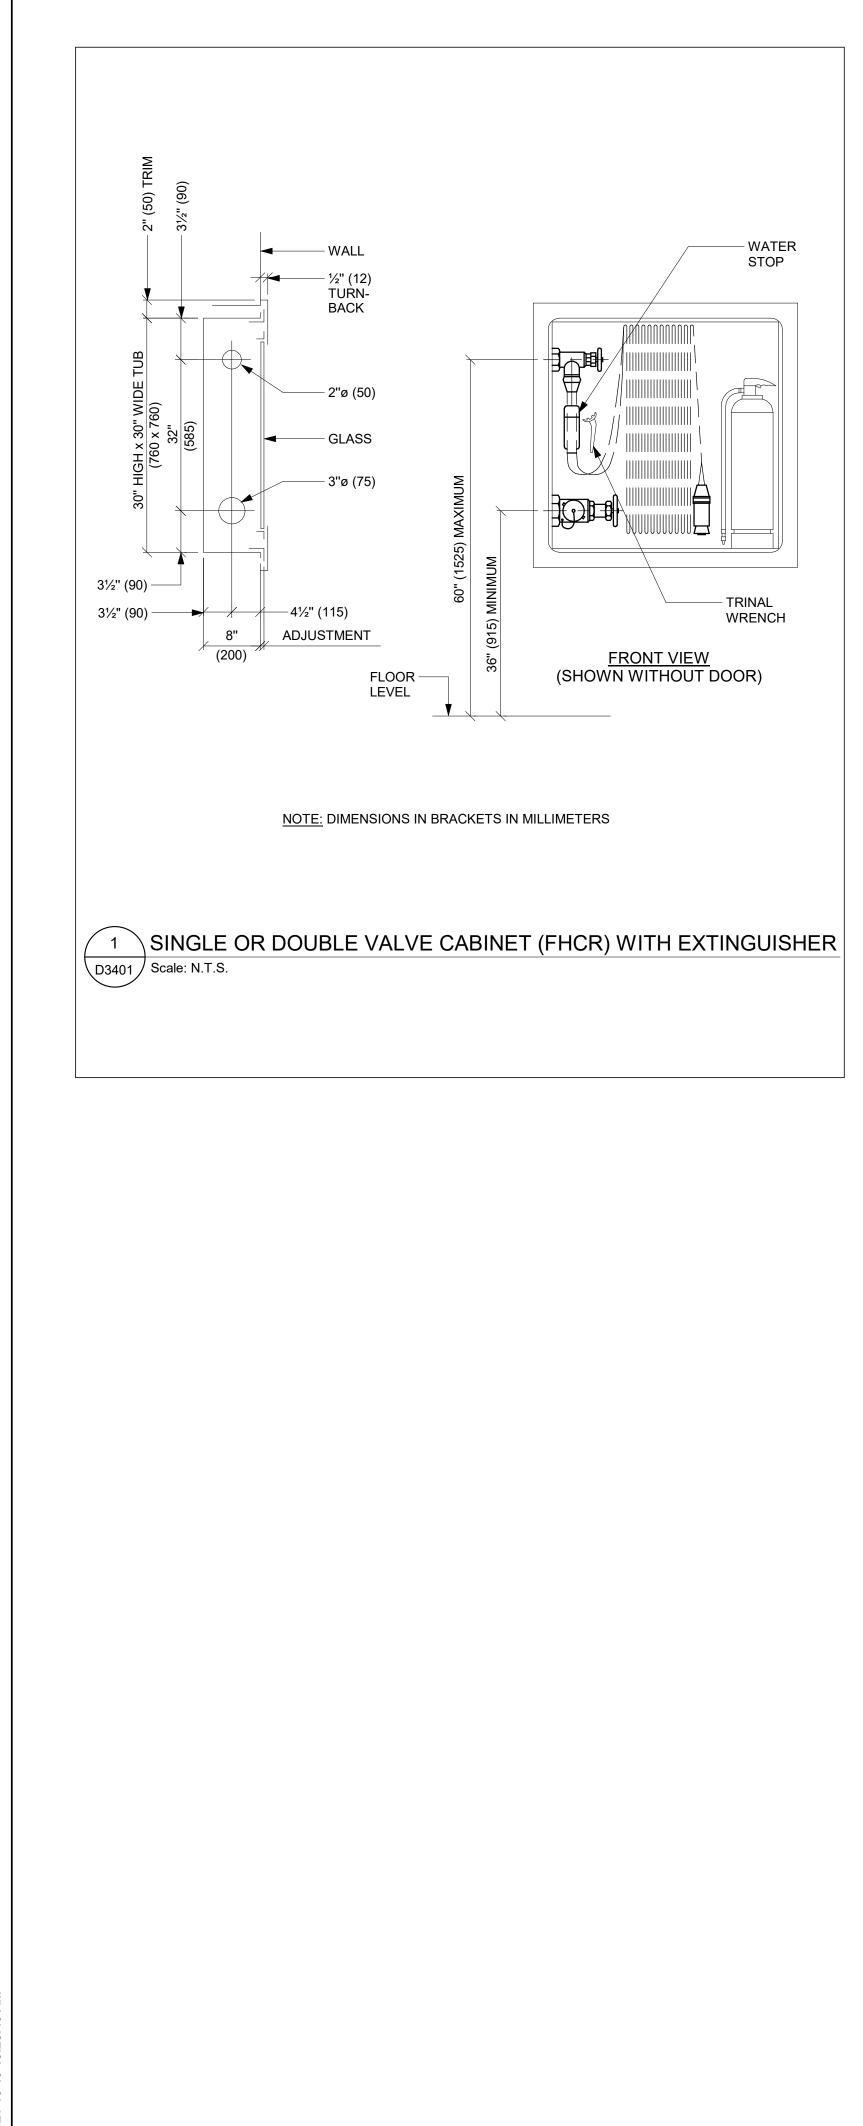
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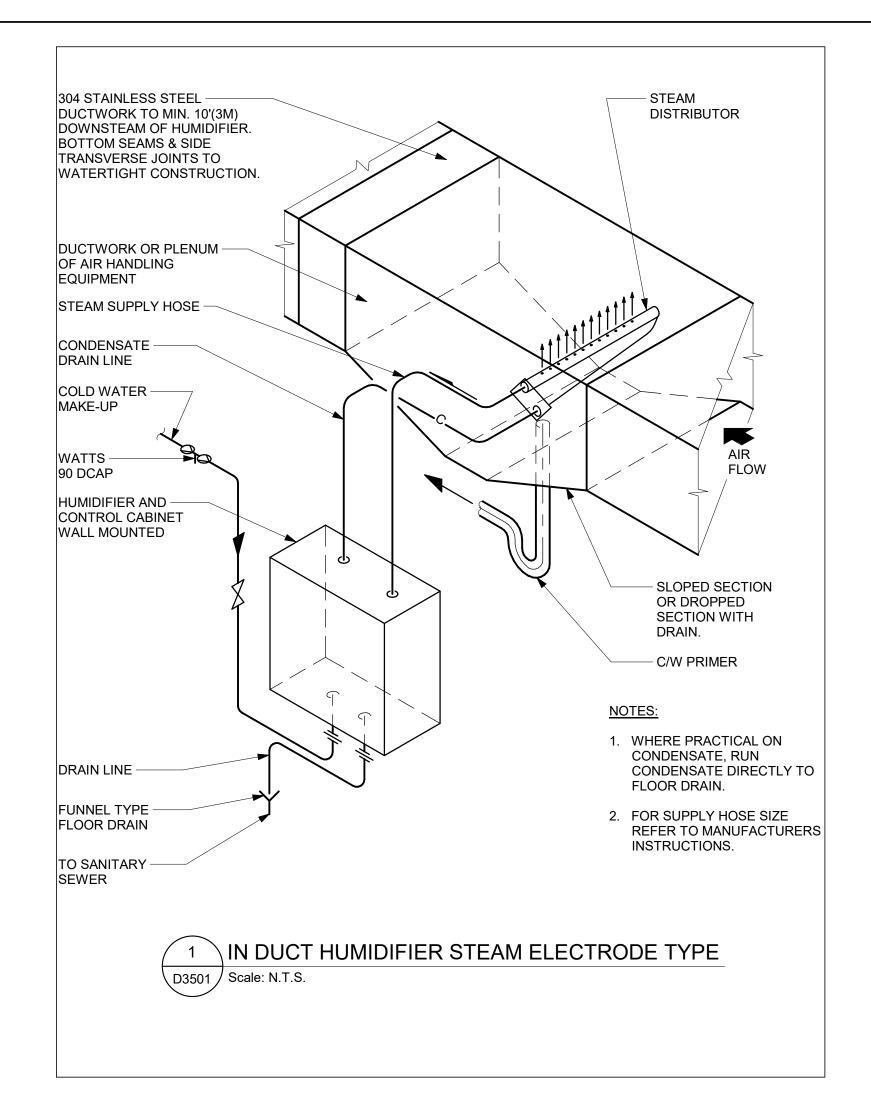


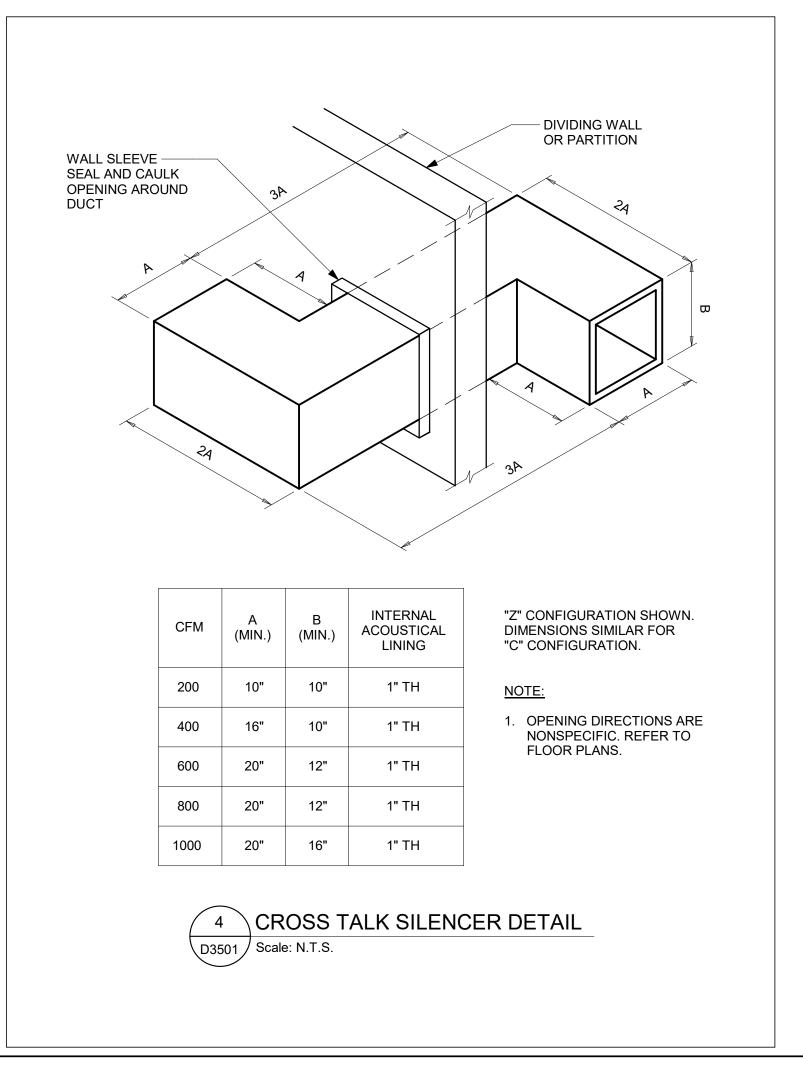


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| $- \longrightarrow$ | 100 Queen St Ŵ Toronto, ON MPG 1P5 |
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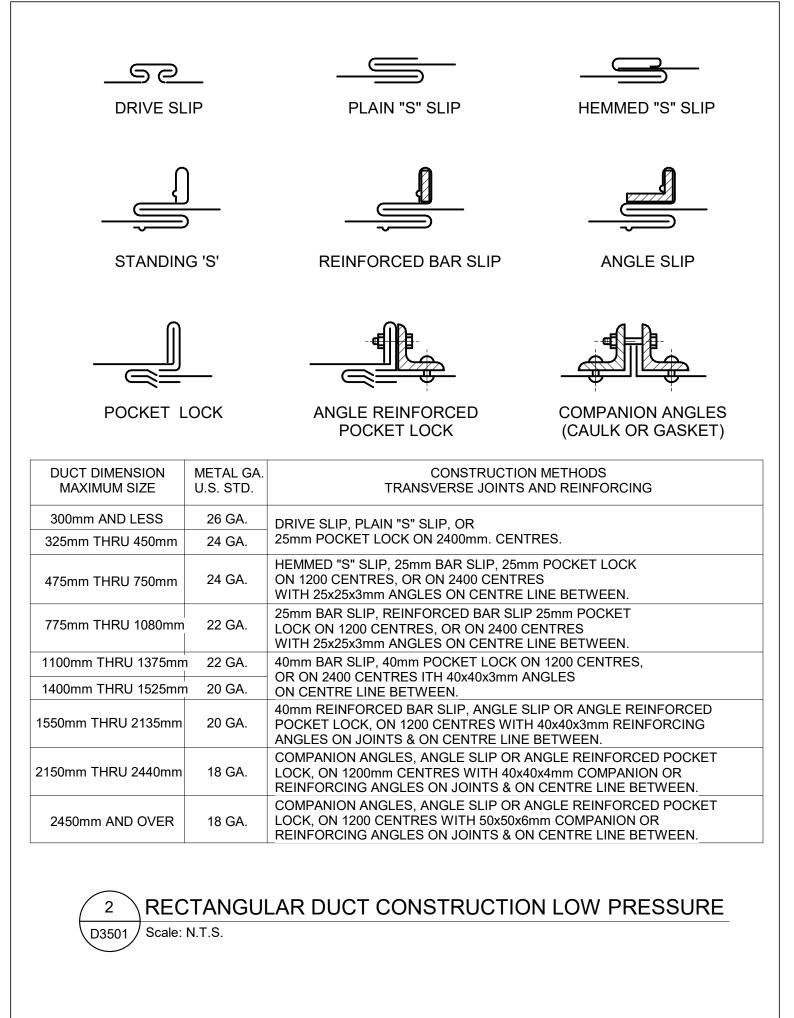


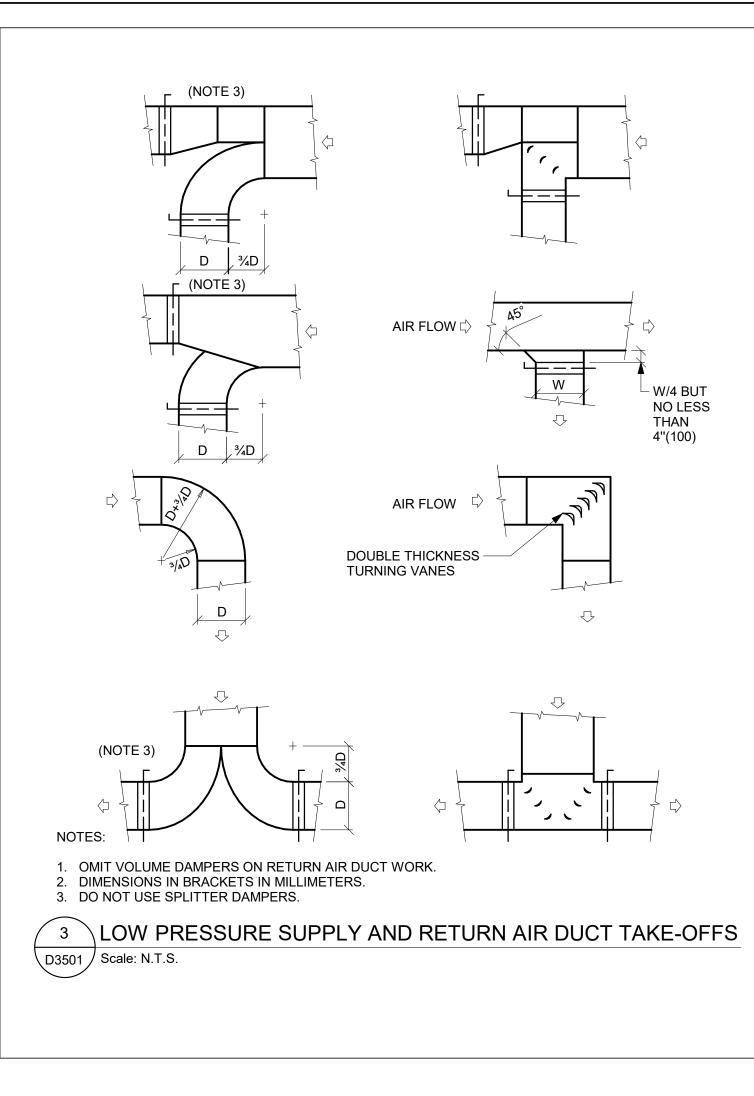
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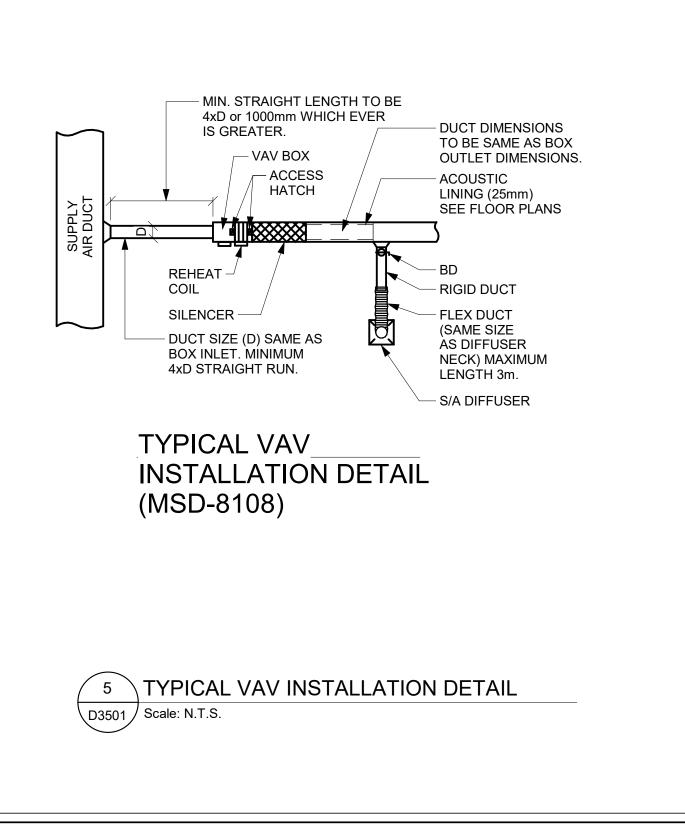




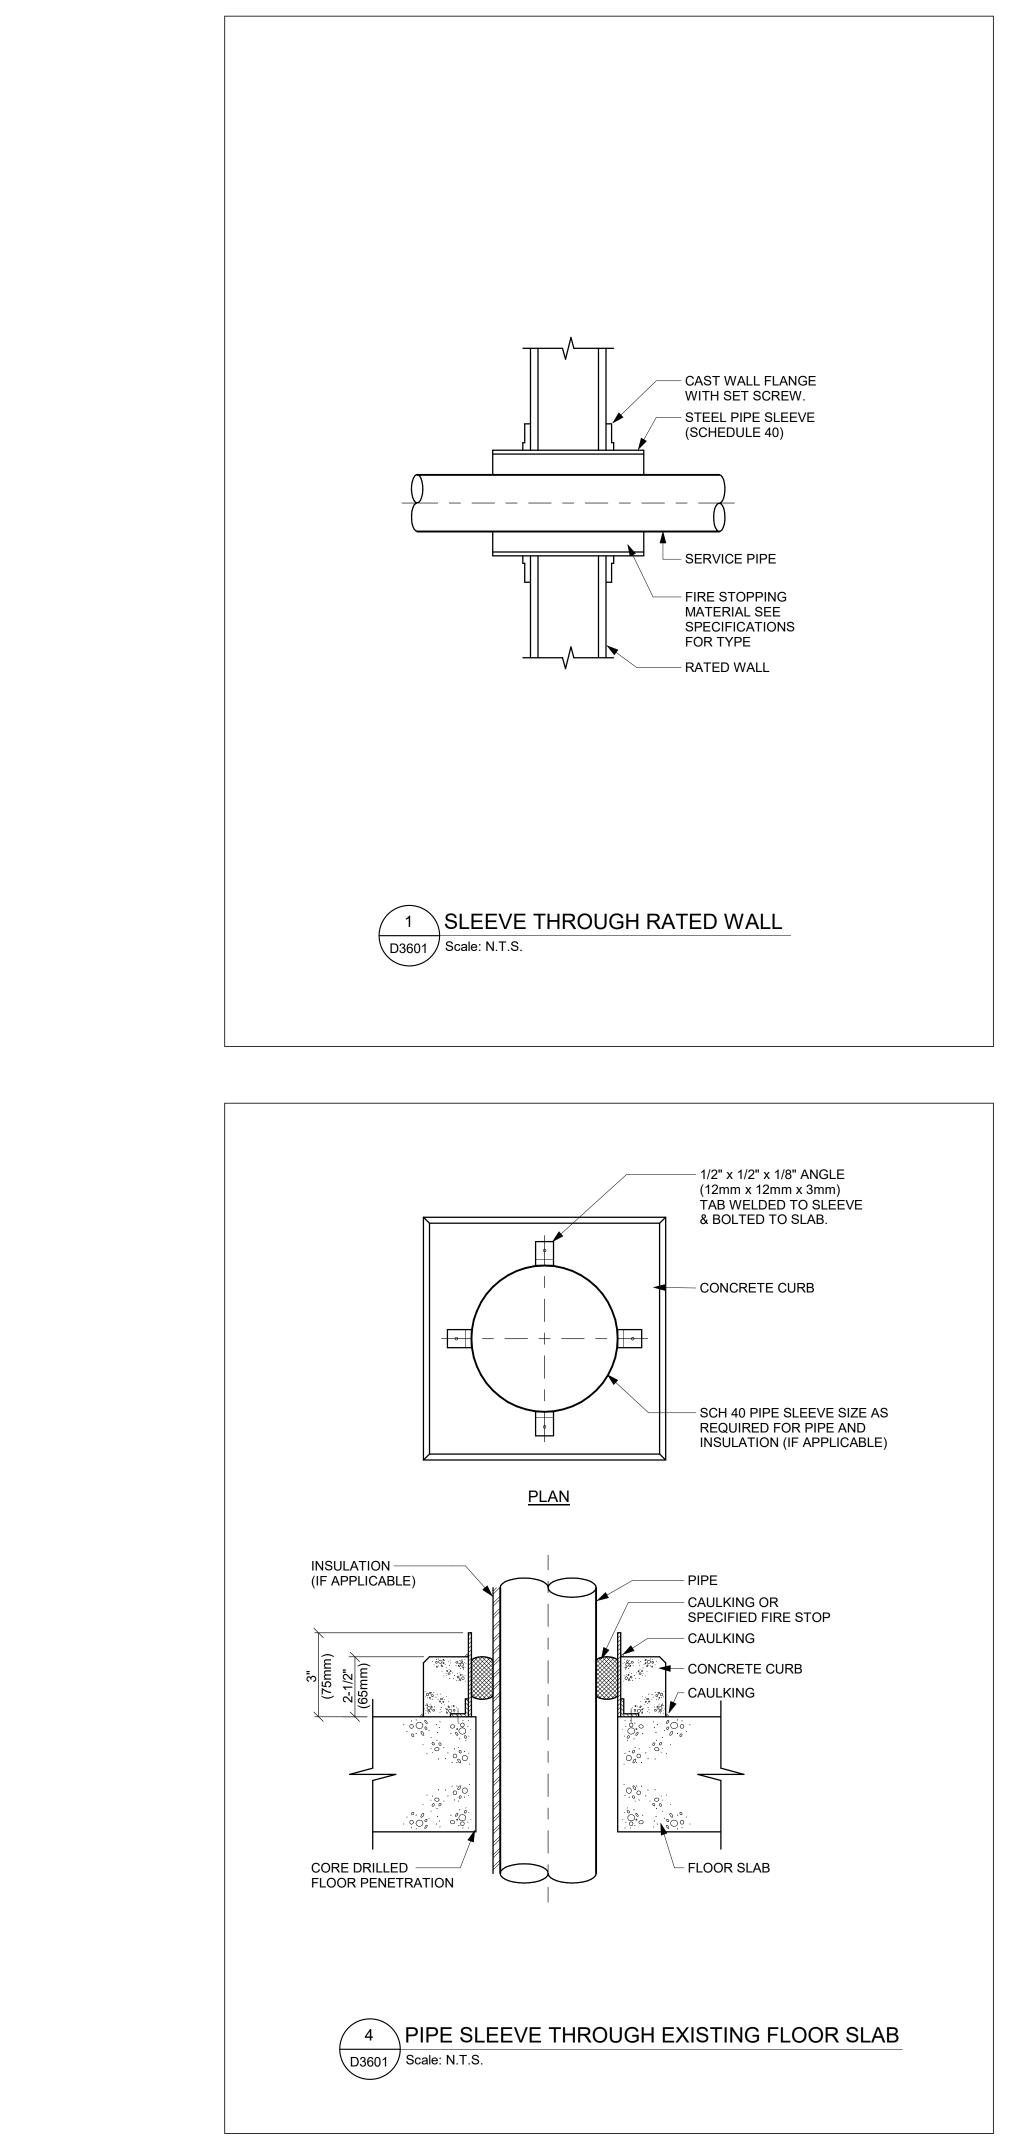
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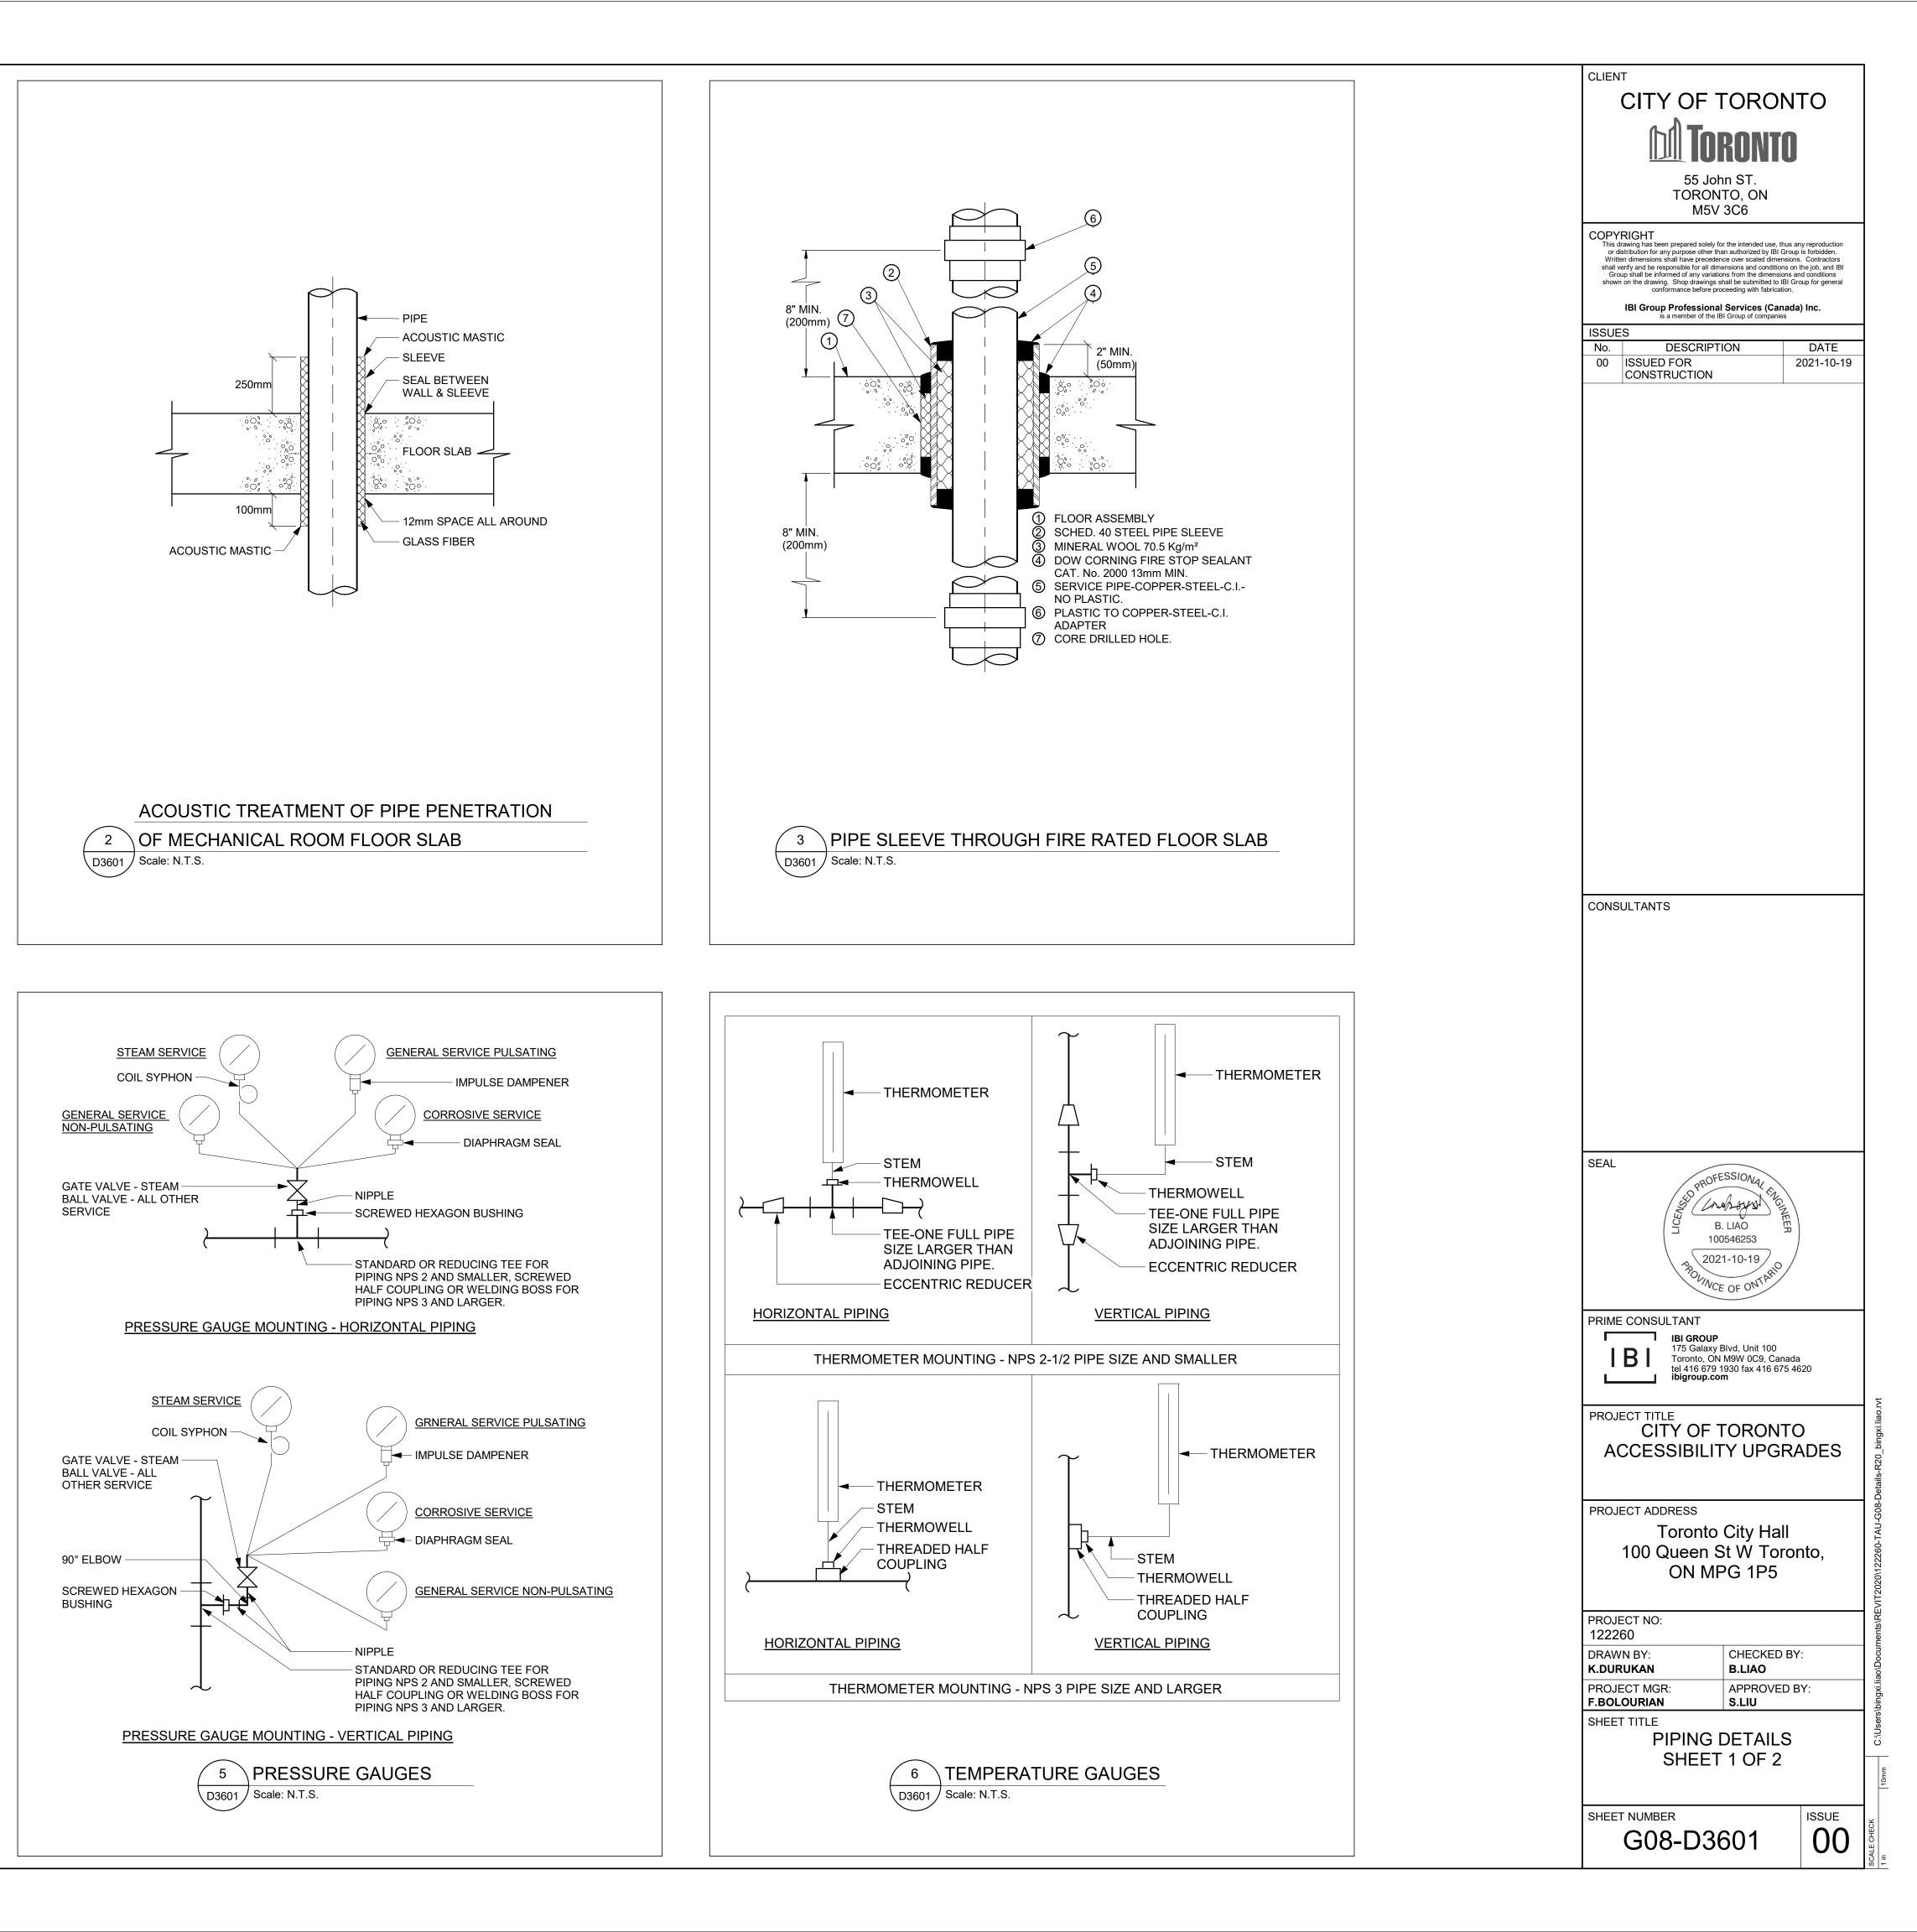


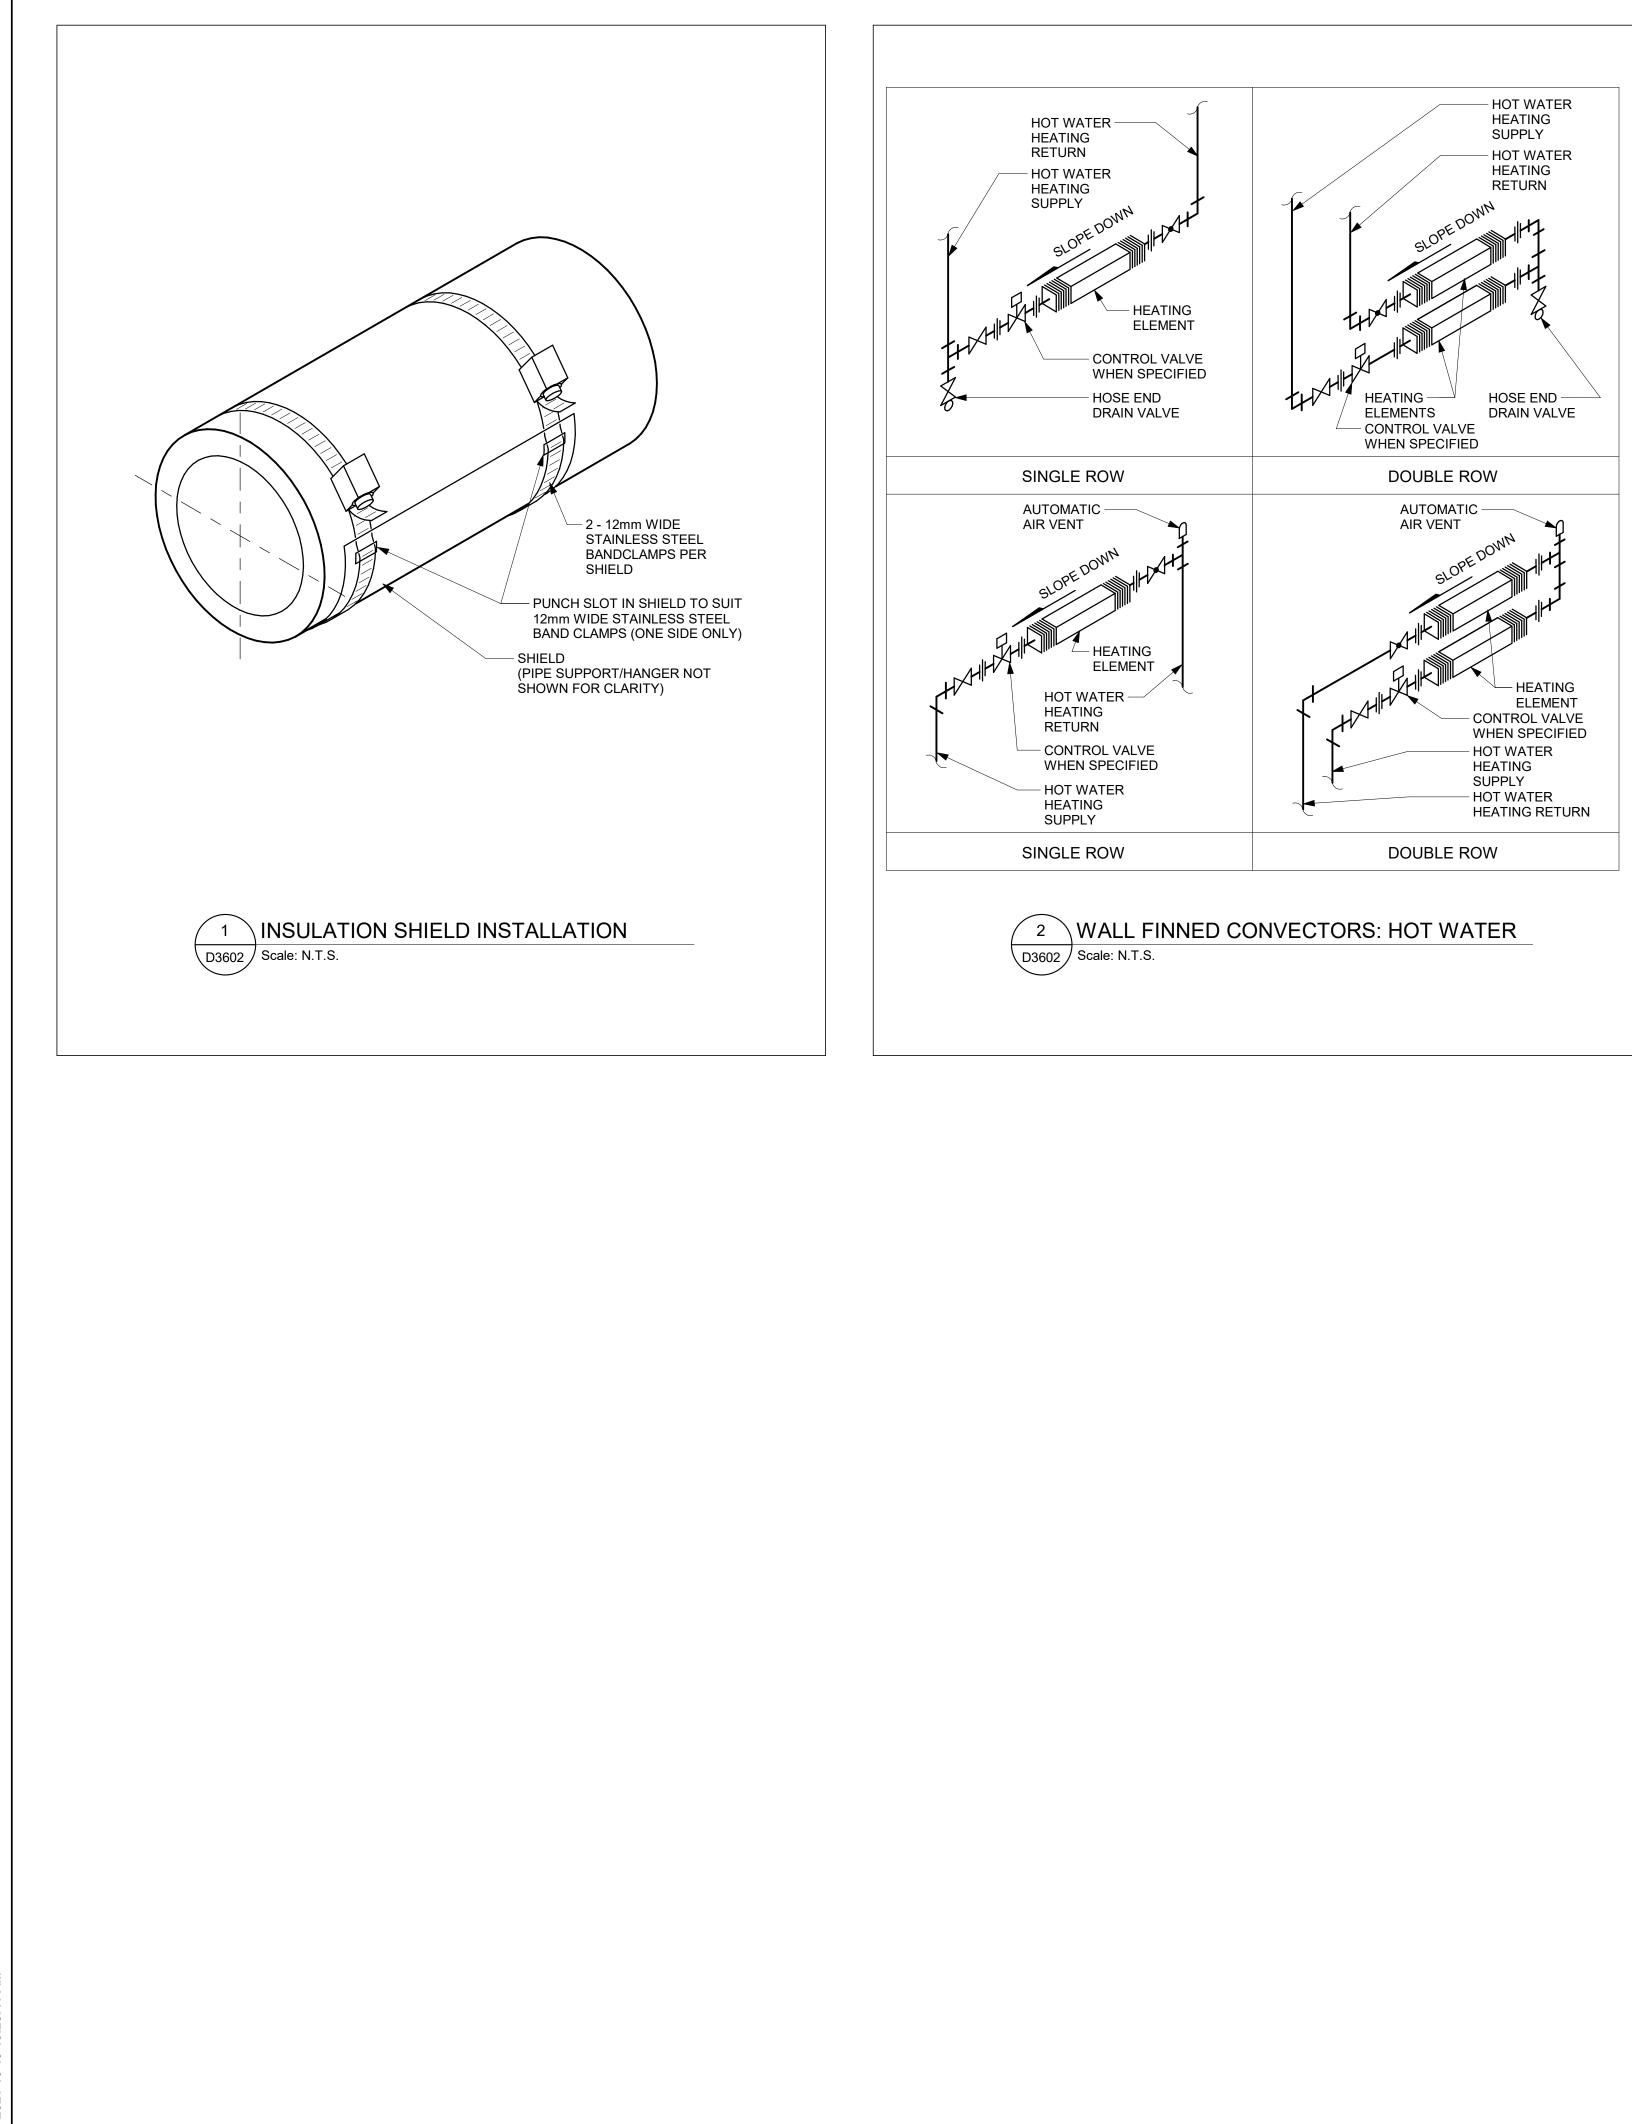


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| 100546253 2021-10-19 2021-10-19 PRIME CONSULTANT IBI GROUP 175 Galaxy Blvd, Unit 100 Toronto, ON M9W 0C9, Canada tel 416 679 1930 fax 416 675 4620 PROJECT TITLE CITY OF TORONTO ACCESSIBILITY UPGRADES PROJECT ADDRESS Toronto City Hall 100 Queen St W Toronto, ON MPG 1P5 PROJECT NO: 122260 DRAWN BY: CHECKED BY: APPROVED BY: SILIU SHEET TITLE | |
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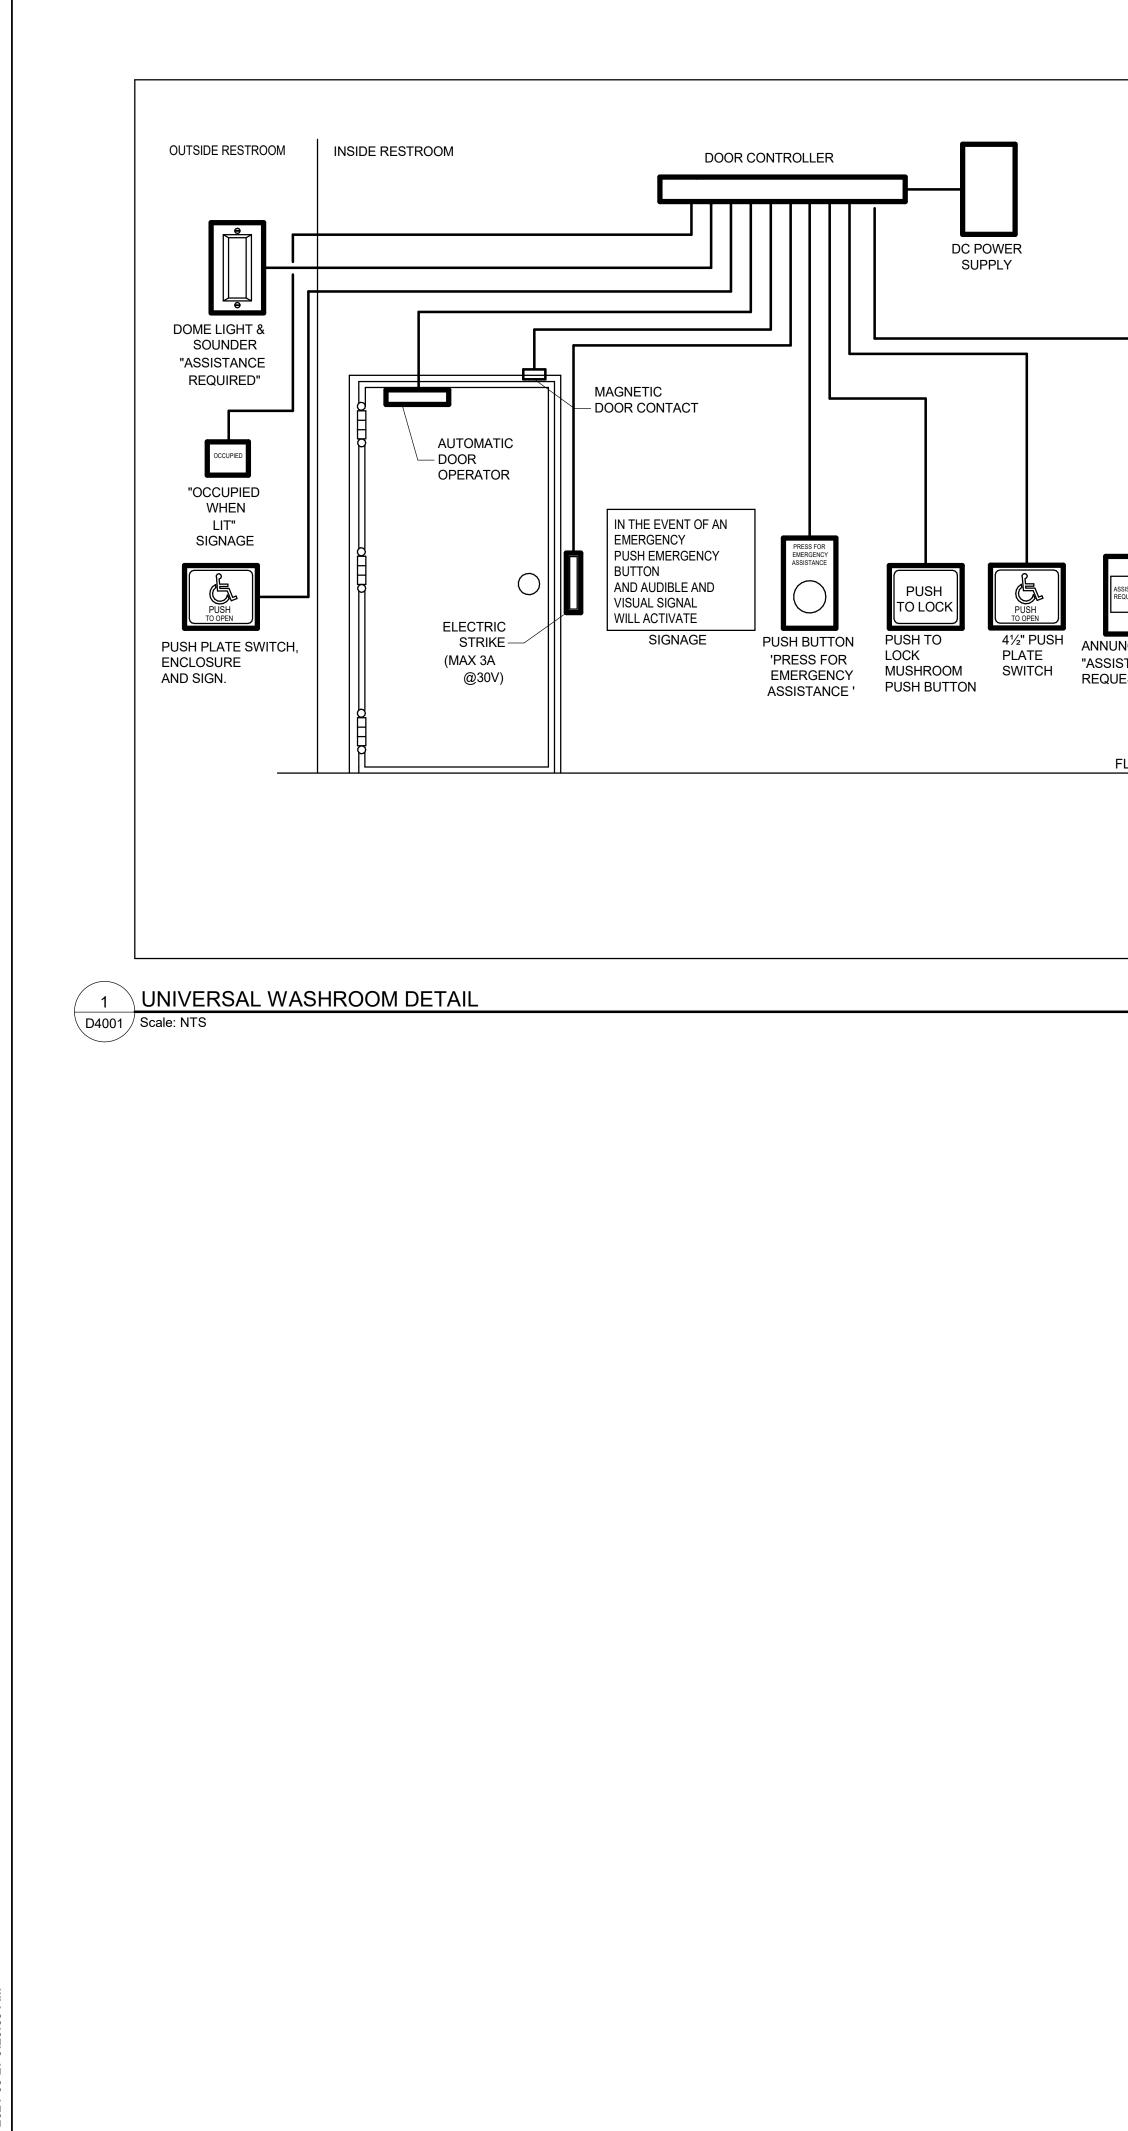


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| | NOTES |
|--------------|--|
| | . PROVIDE EMERGENCY CALL SYSTEM EQUIPMENT. PROVIDE EMPTY CONDUITS ONLY COMPLETE WITH PULL STRINGS. |
| s | . BACK BOXES AND CONDUITS SHALL BE ACCORDING TO APPROVED HOP DRAWINGS. CONDUITS SHALL BE EMT, MINIMUM SIZE 21mm DIA CONTRACTOR TO COORDINATE. |
| D | . LOCATIONS OF DEVICES SHALL BE ACCORDING TO ARCHITECTURAL RAWINGS. VERIFY EXACT LOCATION WITH THE ARCHITECT PRIOR TO OUGHING-IN. |
| | . PROVIDE DOOR OPERATOR. PROVIDE 120V CIRCUIT FOR POWER AND CONDUIT FOR CONTROL CONNECTIONS TO DOOR CONTROLLER AS REQUIRED. |
| | . PROVIDE ELECTRIC STRIKE AND CONDUIT FOR CONNECTION TO DOOR ONTROLLER AS REQUIRED. |
| | |
| | SEQUENCE OF OPERATION: |
| | 1. UPON PRESSING THE EXTERIOR PUSH PLATE, THE DOOR SHALL OPEN. |
| | 2. AFTER ENTRY, THE OCCUPANT SHALL PRESS THE "PUSH TO LOCK" PUSH PLATE, AND LOCK THE DOOR VIA ELECTRIC STRIKE. THE EXTERNAL SIGNAGE WILL BE IN THE "OCCUPIED" STATE. PRESSING THE EXTERIOR PUSH PLATE WILL NOT HAVE ANY EFFECT. |
| DR E " | 3. THE OCCUPANT WILL EXIT BY PRESSING THE INTERIOR UNIVERSAL SYMBOL FOR ACCESSIBILITY, WHICH WILL UNLOCK THE STRIKE, ACTIVATE THE DOOR OPERATOR AND AND RESET THE EXTERIOR SIGNAGE TO ITS "UNOCCUPIED" STATE. SIMILARLY, THE OCCUPANT MIGHT TURN THE DOOR HANDLE, AND OPEN THE DOOR. THE MAGNETIC DOOR CONTACT WILL REGISTER THIS AS A DOOR OPEN STATUS, AND RESET THE EXTERIOR SIGNAGE TO ITS "UNOCCUPIED" STATE AND RELEASE THE ELECTRIC STRIKE. |
| _ | IF THE EMERGENCY 'PUSH/PULL' MUSHROOM IS DEPRESSED, THE EXTERIOR DOME LIGHT AND SOUNDER WILL ACTIVATE IN CONJUNCTION WITH THE INTERIOR ANNUNCIATOR AND SOUNDER. AT THE SAME TIME, THE DOOR STRIKE WILL RELEASE AND RESET THE EXTERIOR SIGNAGE TO ITS "UNOCCUPIED" STATE |
| | 4. THE INTERIOR AND EXTERIOR REQUEST FOR EMERGENCY ASSISTANCE AUDIBLE AND VISUAL SIGNAL DEVICES WILL DEACTIVATE UPON RELEASE (PULL) OF THE MUSHROOM PUSHBUTTON. THE DOOR STRIKE WILL REMAIN UNLOCKED AND THE EXTERIOR SIGNAGE WILL BE IN ITS "UNOCCUPIED" STATE. |
| | |

| TO SECURI CONTROL I | | 1-27C MIN | DOOR DOOR CONTROL | TO POWER PANEL 1-21C (TYP.) | CLIENT CITY OF TORONTO TORONTO 55 John ST. |
|---|---|---|--|--|--|
| CEILING LINE EQUIVALENT | | | | NOTE-7 (TYP.) | TORONTO, ON M5V 3C6 COPYRIGHT |
| COORDINATE WITH PREFOR LOCATION FO | RMED DOOR | | | CONCEAL CONDUIT BELOW CEILING LINE OR 3000AFF (TYP.) DEVICE BOX FOR REQUEST TO EXIT | This drawing has been prepared solely for the intended use, thus any reproduction or distribution for any purpose other than authorized by IBI Group is forbidden. Written dimensions shall have precedence over scaled dimensions. Contractors shall verify and be responsible for all dimensions and conditions on the job, and IBI Group shall be informed of any variations from the dimensions and conditions shown on the drawing. Shop drawings shall be submitted to IBI Group for general conformance before proceeding with fabrication. |
| MONITOR SWI ACTUATING M DOOR MONITO INSTALLED IN DOOR. (NOTE: | AGNET FOR OR SWITCH | | | SENSOR AND/OR AUDIO ANNUNCIATOR WHERE REQUIRED (NOTE-8) | IBI Group Professional Services (Canada) Inc. is a member of the IBI Group of companies ISSUES DESCRIPTION DATE A 50% SUBMISSION 2021-01-21 B 90% SUBMISSION 2021-04-12 |
| EXTEND CON DOOR FRAME STRIKE POSIT DOOR POWEI PUSH BUTTO CARD READER MOUNTED ON SIDE OF WALL | IDUIT INSIDE JAMB TO TION R -SECURE SECURE | | | ELECTRICAL TRANSFER HINGE/LINK | CISSUED FOR PERMIT2021-04-12DISSUED FOR TENDER2021-05-25 |
| INDICATED. CARD READE KEY PAD ON F OF WALL WHE REQUIRED (N 1-21C (NOTE- ELECTRIC STI | ER AND/OR PUBLIC SIDE ERE IOTE-8) | | | DOOR MOUNTED BOLT RELEASE/RETRACT DEVICES WHEN USED. (NOTE-9) | |
| (NOTE-12) | | | U | | |
| 2. AL 3. SE BY 4. PC CC 5. PR | HIS CONSTRUCTION DETAIL DOR HARDWARE SCHEDULE L CONDUITS WITH PULL ST ECURITY DOOR CONTROLLE Y SECURITY VENDER WHER DWER SUPPLY, DOOR OPER DNTACT (MONITOR SWITCH ROVIDE CONTINUOUS ELEC | E FOR EXACT COMPONE FRING, JUNCTION BOXES ER, CARD READER, ALAF RE REQUIRED. RATOR/CONTROLLER, DO I), BY DOOR HARDWARE | NTS REQUIRED AND CONDUIT R S, PULL BOXES, DEVICE BOXES RM BUZZER, KEYPAD, REQUEST DOR POWER PUSH BUTTON, ELE CONTRACTOR WHERE REQUIR | AND POWER WIRES BY DIV.26. TO EXIT SENSOR AND SECURITY WIRES ECTRIC STRIKE/BOLT/LATCH, DOOR | |
| 6. JU TA | AMPER RESISTANT COVER; | SURFACE MOUNTED FO | R SOLID WALL CONSTRUCTION | x300x150 WITH REMOVABLE AND . SAME WITH 100x100x54 DEVICE BOX | CONSULTANTS |
| CC | OMMON CONDUIT, PULL BO | XES AND JUNCTION BOX | ES FOR INTRUSION DETECTION | LOCK WALL CONSTRUCTION. USE N AND ACCESS CONTROL WIRING. | |
| HC 8. DE W/ | ORIZONTAL CONDUIT ON SO EVICE BOX MOUNTED FLUS ALL CONSTRUCTION. REFE | OLID WALL ONLY SH WITH SURFACE. PRO R TO LAYOUT DRAWING | VIDE SINGLE DEVICE COVER PLA FOR LOCATION. COORDINATE V | TICAL CONDUIT. SURFACE MOUNT ASTER RING FOR CAVITY OR BLOCK WITH DOOR HARDWARE SCHEDULE FOR E DOOR HARDWARE SCHEDULE. | |
| SC 10. W | CHEDULE. 'HERE DOOR PERFORMANC | E REQUIREMENTS CALL | | NICATED IN DOOR HARDWARE ND ACCESS CONTROL, USE MAY BE MAINTAIN SEPARATION BETWEEN WIRING | |
| | F TWO SYSTEMS. SE OF BRIDGING CONDUIT A | ACCEPTABLE FOR CAVIT | TY OR BLOCK WALL CONSTUCTI | ON WHERE SITE CONDITIONS PERMIT. | SEAL |
| 12. OI | MIT WHEN ELECTRIC LATC | H IS USED. | | | |
| | | | ED AND DOOR PUSH BUTTON IS CREDENTIAL -> ACTIVATE DOO | TRIGGERED THAT MOTOR DOES NOT OR OPERATOR PUSH BUTTON | |
| 2 DOOR SECU D4001 Scale: 1:1 | RITY DETAIL - PC | WERED DOOR | S | | |
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| | | | | | DRAWN BY: CHECKED BY: M. BOJIC P.WILLIAMS |
| | | | | | PROJECT MGR: APPROVED BY: F.BOLOURIAN P. WILLIAMS SHEET TITLE ELECTRICAL DETAILS 1 |
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