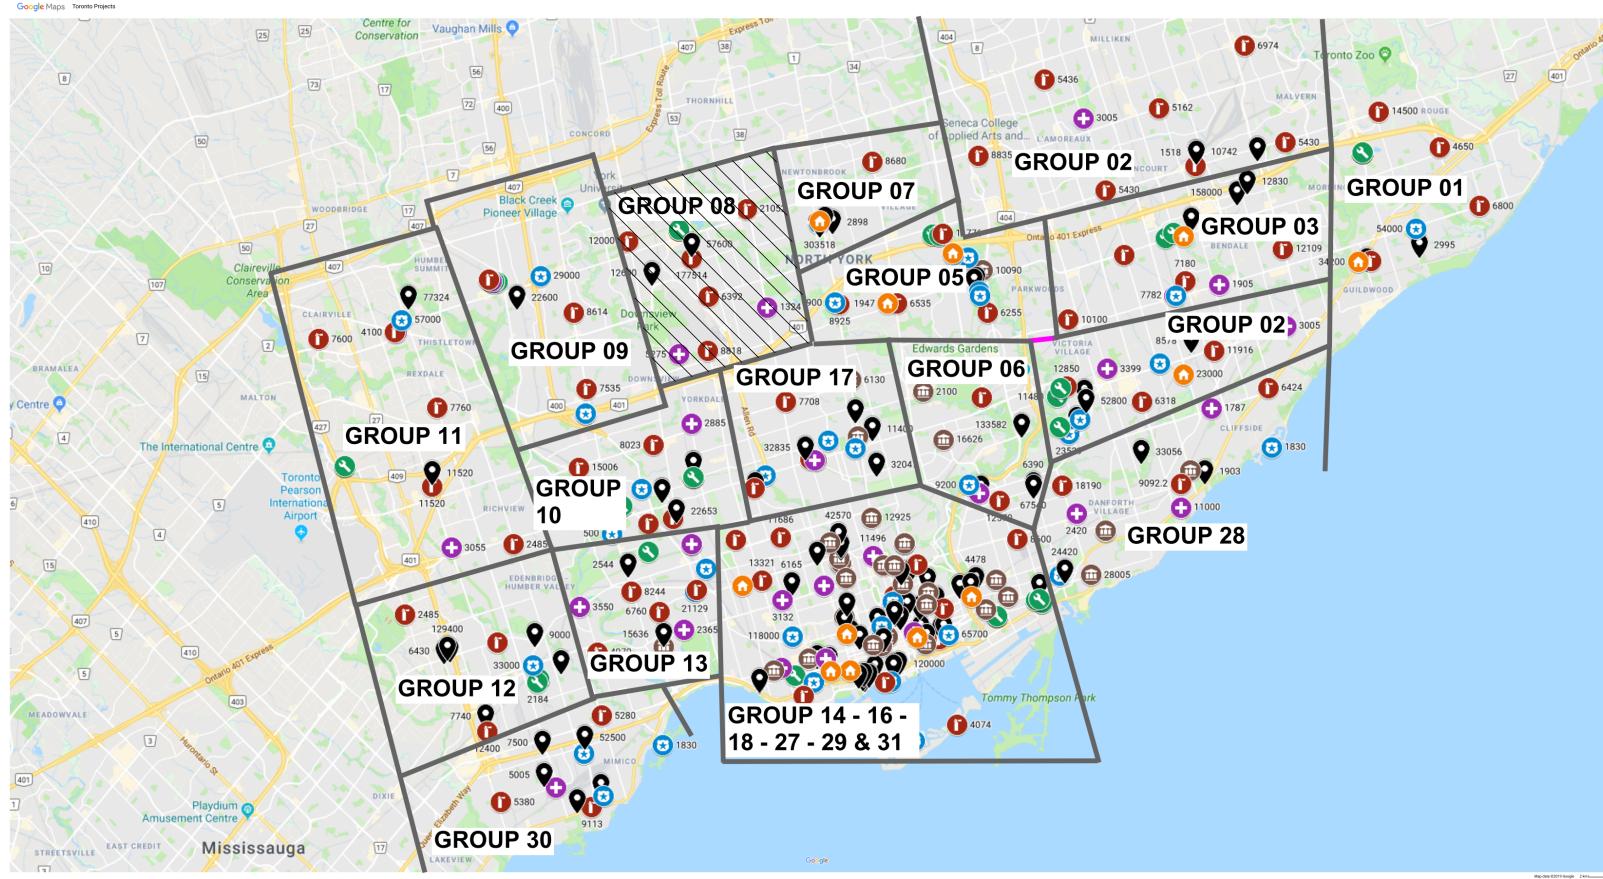
CITY OF TORONTO ACCESSIBILITY UPGRADES TYPICAL DETAILS BOOKLET 9119-19-0162 / IBI 122260



COVER PAGE GROUP 08	
SHEET	SHEET #
COVER PAGE, GENERAL DRAWING LIST, I	G08-GAL-G0001

GENERAL LAYOUTS GROU						
SHE	SHEET #					
ARCHITECTURAL GENERAL NOTES, ABE	G08-GAL-G1001					
WALL TYPES	G08-GAL-G1002					
DOOR TYPES	G08-GAL-G1003					
STRUCTURAL GENERAL NOTES	G08-GAL-G2001					
ABBREVIATIONS & SYMBOLES	G08-GAL-G2002					
MECHANICAL LEGEND SHEET 1 OF 2	G08-GAL-G3001					
MECHANICAL LEGEND SHEET 2 OF 2	G08-GAL-G3002					
ELECTRICAL LEGEND SHEET 1 OF 2	G08-GAL-G4001					
ELECTRICAL LEGEND SHEET 2 OF 2	G08-GAL-G4002					
ELECTRICAL GENERAL NOTES	G08-GAL-G4003					

GROUP 08 BUILDING INDEX

Serial #	Building Address	Building Description
10	1009 SHEPPARD AVE. WEST	FIRE HALL NO. 143
11	1026 FINCH AVE. WEST	FINCH YARD - BUILDING B
13	1026 FINCH AVE. WEST	FINCH YARD - BUILDING D
36	1300 SHEPPARD AVE. WEST	TORONTO ANIMAL SERVICES
110	20 BEFFORT ROAD	FIRE HALL NO. 145
217	4100 KEELE STREET	FIRE HALL NO. 141
229	4330 DUFFERIN STREET	FIRE/EMS HQ & EMS STATION 53
265	5700 BATHURST STREET	FIRE STATION 112 & EMS STATION 16

TOUCH AND FEEL BOOKLET

TYPICAL DETAILS BOOKLET

IMAGE SOURCES: GOOGLE MAPS

ISSUED FOR CONSTRUCTION

SKOUP 08
SHEET TITLE
/ING LIST, BUILDING LIST
TS GROUP 08
SHEET TITLE

BREVIATIONS & REFERENCE SYMBOLS

Building Description

CITY OF TORONTO



55 John ST. TORONTO, ON M5V 3C6

ISSUES No. DESCRIPTION 00 ISSUED FOR CONSTRUCTION

DATE 2021-10-19

ibigroup.com PROJECT NO: 9119- 19- 0162 / IBI 122260 DATE: 2021-10-19 ISSUE SHEET NUMBER

G08-GAL-G1001

175 Galaxy Blvd, Unit 100 tel 416 596 1930 fax 416 596 0644

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IBI GROUP

ABBREVIATIONS

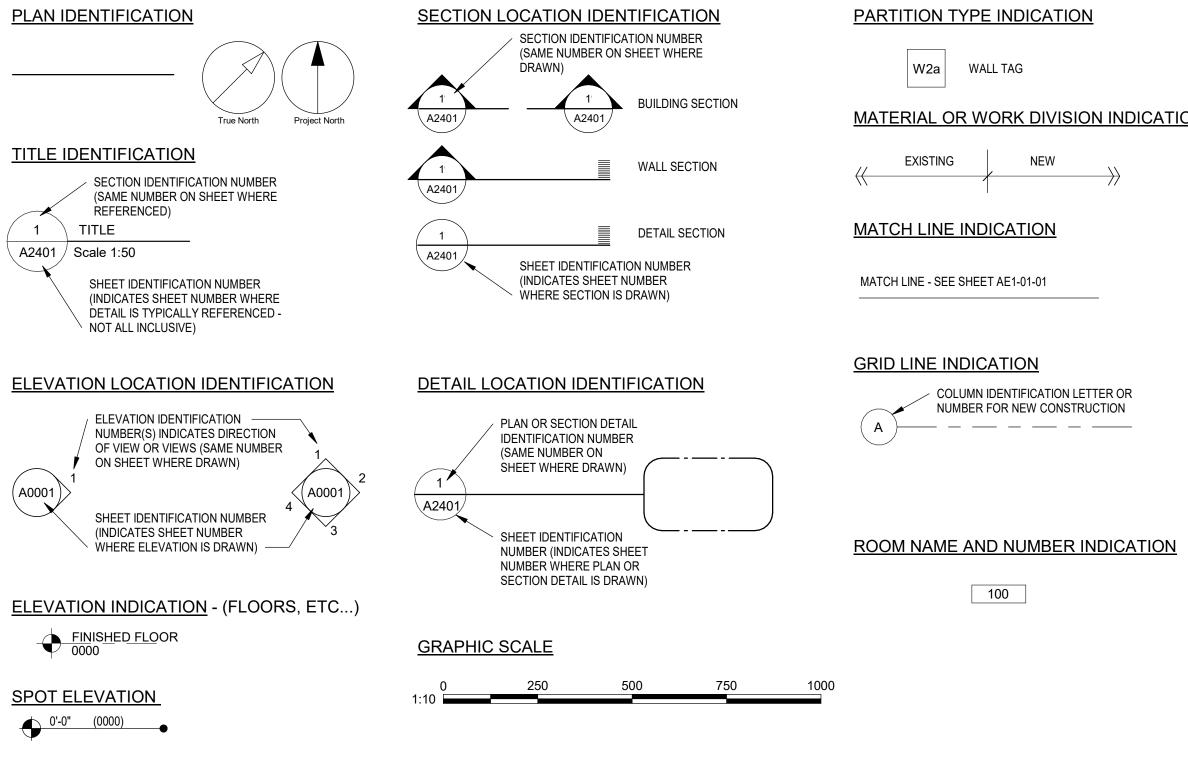
@	AT
А	ANGLE
A/C	AIR CONDITIONER / CONDITIONING
ABV	ABOVE
	ACCESSORIES
	ACCESS DOOR
	ACCESS FLOOR
ACST / ACOUS	ACOUSTICAL
ACCOUR	ACOUSTICAL CEILING TILE
AD	AREA DRAIN
=	ADDITIONAL
	ADDENDUM
ADJ	ADJUSTABLE / ADJACENT
= .	ADMINISTRATION
AFC	ABOVE FINISHED COUNTER
AFF	ABOVE FINISHED FLOOR
AFG	ABOVE FINISHED GRADE
AFS	ABOVE FINISHED SLAB
AGGR	AGGREGATE
AHR	ANCHOR
AHU	AIR HANDLING UNIT
AL /	ALUMINUM
ALUM	
	ALIGNMENT
	ALTERNATE
ANOD	ANODIZED
ANUN	ASSISTANCE REQUIRED
AP	ACCESS PANEL
APC	ACOUSTICAL PANEL CEILING
APPROX	APPROXIMATELY
	APPROVED
AR-LED	DOOR LOCK INDICATOR
ARCH	ARCHITECT(URAL)
ASPH	ASPHALT
ASTM	AMERICAN SOCIETY FOR TESTING
	MATERIALS
AUTO	AUTOMATIC
AVG	AVERAGE
BD	BOARD
BET	BETWEEN
BFACT	BARRIER FREE ADULT CHANGE TABLE
BFAO BFPB	BARRIE FREE AUTOMATIC OPENER BARRIER FREE PUSH BUTTON
	BARRIER FREE WAVE TO OPEN
BG	BUMPER GUARD
BITUM	BITUMINOUS
BL	BLACK
BLDG	BUILDING
BLK	BLOCK
BLKG	BLOCKING
BM	BEAM
BOS	BOTTOM OF STEEL
DOT	BOTTOM
ROT	
BOT BR	
BOT BR BS	BACKREST BOTH SIDES
BR	BACKREST
BR	BACKREST
BR BS	BACKREST BOTH SIDES
BR BS CAB	BACKREST BOTH SIDES CABINET
BR BS CAB CAS	BACKREST BOTH SIDES CABINET CASEWORK
BR BS CAB CAS CB	BACKREST BOTH SIDES CABINET CASEWORK CATCH BASIN
BR BS CAB CAS CB CEM CER CF	BACKREST BOTH SIDES CABINET CASEWORK CATCH BASIN CEMENT CERAMIC CUBIC FOOT
BR BS CAB CAS CB CEM CER CF CG	BACKREST BOTH SIDES CABINET CASEWORK CATCH BASIN CEMENT CERAMIC CUBIC FOOT CORNER GUARD
BR BS CAB CAS CB CEM CER CF CG CH	BACKREST BOTH SIDES CABINET CASEWORK CATCH BASIN CEMENT CERAMIC CUBIC FOOT CORNER GUARD CEILING HEIGHT
BR BS CAB CAS CB CEM CER CF CG CH CHAM	BACKREST BOTH SIDES CABINET CASEWORK CATCH BASIN CEMENT CERAMIC CUBIC FOOT CORNER GUARD CEILING HEIGHT CHAMFER
BR BS CAB CAS CB CEM CER CF CG CH CHAM CHBD	BACKREST BOTH SIDES CABINET CASEWORK CATCH BASIN CEMENT CERAMIC CUBIC FOOT CORNER GUARD CEILING HEIGHT CHAMFER CHALKBOARD
BR BS CAB CAS CB CEM CER CF CG CH CHAM CHBD CI	BACKREST BOTH SIDES CABINET CASEWORK CATCH BASIN CEMENT CERAMIC CUBIC FOOT CORNER GUARD CEILING HEIGHT CHAMFER CHALKBOARD CAST IRON
BR BS CAB CAS CB CEM CER CF CG CH CHAM CHBD CI CI	BACKREST BOTH SIDES CABINET CASEWORK CATCH BASIN CEMENT CERAMIC CUBIC FOOT CORNER GUARD CEILING HEIGHT CHAMFER CHALKBOARD CAST IRON CONTRACTOR INSTALLED
BR BS CAB CAS CB CEM CER CF CG CH CHAM CHBD CI CI CI CI P	BACKREST BOTH SIDES CABINET CASEWORK CATCH BASIN CEMENT CERAMIC CUBIC FOOT CORNER GUARD CEILING HEIGHT CHAMFER CHALKBOARD CAST IRON CONTRACTOR INSTALLED CAST IN PLACE
BR BS CAB CAS CB CEM CER CF CG CH CHAM CHBD CI CI CI CI CI CI CI CI CI CI CI CI CI	BACKREST BOTH SIDES CABINET CASEWORK CATCH BASIN CEMENT CERAMIC CUBIC FOOT CORNER GUARD CEILING HEIGHT CHAMFER CHALKBOARD CAST IRON CONTRACTOR INSTALLED CAST IN PLACE CONTROL JOINT
BR BS CAB CAS CB CEM CER CF CG CH CHAM CHBD CI CI CI CI CI CJ CL	BACKREST BOTH SIDES CABINET CASEWORK CATCH BASIN CEMENT CERAMIC CUBIC FOOT CORNER GUARD CEILING HEIGHT CHAMFER CHALKBOARD CAST IRON CONTRACTOR INSTALLED CAST IN PLACE CONTROL JOINT CENTRE LINE
BR BS CAB CAS CB CEM CER CF CG CH CHAM CHBD CI CI CI CI CI CI CL CL CL G	BACKREST BOTH SIDES CABINET CASEWORK CATCH BASIN CEMENT CERAMIC CUBIC FOOT CORNER GUARD CEILING HEIGHT CHAMFER CHALKBOARD CAST IRON CONTRACTOR INSTALLED CAST IN PLACE CONTROL JOINT CENTRE LINE CEILING
BR BS CAB CAS CB CEM CER CF CG CH CHAM CHBD CI CI CI CI CI CI CI CL CL CL CL CL CL CL O	BACKREST BOTH SIDES CABINET CASEWORK CATCH BASIN CEMENT CERAMIC CUBIC FOOT CORNER GUARD CEILING HEIGHT CHAMFER CHALKBOARD CAST IRON CONTRACTOR INSTALLED CAST IN PLACE CONTROL JOINT CENTRE LINE
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BR BS CAB CAS CB CEM CER CF CG CH CHAM CHBD CI CI CI CI CI CI CI CL CLG CLR	BACKREST BOTH SIDES CABINET CASEWORK CATCH BASIN CEMENT CERAMIC CUBIC FOOT CORNER GUARD CEILING HEIGHT CHAMFER CHALKBOARD CAST IRON CONTRACTOR INSTALLED CAST IN PLACE CONTROL JOINT CENTRE LINE CEILING CLOSET CLEAR
BR BS CAB CAS CB CEM CER CF CG CH CHAM CHBD CI CI CI CI CI CI CI CL CLG CLQ CLR CMU	BACKREST BOTH SIDES CABINET CASEWORK CATCH BASIN CEMENT CERAMIC CUBIC FOOT CORNER GUARD CEILING HEIGHT CHAMFER CHALKBOARD CAST IRON CONTRACTOR INSTALLED CAST IN PLACE CONTROL JOINT CENTRE LINE CEILING CLOSET CLEAR CONCRETE MASONRY UNIT
BR BS CAB CAS CB CEM CER CF CG CH CHAM CHBD CI CI CI CI CI CI CI CL CLG CLO CLR CMU CO COL CONC	BACKREST BOTH SIDES CABINET CASEWORK CATCH BASIN CEMENT CERAMIC CUBIC FOOT CORNER GUARD CEILING HEIGHT CHAMFER CHALKBOARD CAST IRON CONTRACTOR INSTALLED CAST IN PLACE CONTROL JOINT CENTRE LINE CEILING CLOSET CLEAR CONCRETE MASONRY UNIT CLEAN/CLEAR OUT COLUMN CONCRETE
BR BS CAB CAS CB CEM CER CF CG CH CHAM CHBD CI CI CI CI CI CI CI CL CLG CLO CLR CMU CO COL CONC	BACKREST BOTH SIDES CABINET CASEWORK CATCH BASIN CEMENT CERAMIC CUBIC FOOT CORNER GUARD CEILING HEIGHT CHAMFER CHALKBOARD CAST IRON CONTRACTOR INSTALLED CAST IN PLACE CONTROL JOINT CENTRE LINE CEILING CLOSET CLEAR CONCRETE MASONRY UNIT CLEAN/CLEAR OUT COLUMN CONCRETE CONSTRUCTION
BR BS CAB CAS CB CEM CER CF CG CH CHAM CHBD CI CI CI CI CI CI CL CLG CLO CLC CLO CLR CMU CO CONC CONST CONT	BACKREST BOTH SIDES CABINET CASEWORK CATCH BASIN CEMENT CERAMIC CUBIC FOOT CORNER GUARD CEILING HEIGHT CHAMFER CHALKBOARD CAST IRON CONTRACTOR INSTALLED CAST IN PLACE CONTROL JOINT CENTRE LINE CEILING CLOSET CLEAR CONCRETE MASONRY UNIT CLEAN/CLEAR OUT COLUMN CONCRETE CONSTRUCTION CONTRUCTION CONTINUOUS
BR BS CAB CAS CB CEM CER CF CG CH CHAM CHBD CI CI CI CI CI CI CI CL CLG CLO CLR CLO CLR CONC CONC CONST CONT CORR	BACKREST BOTH SIDES CABINET CASEWORK CATCH BASIN CEMENT CERAMIC CUBIC FOOT CORNER GUARD CEILING HEIGHT CHAMFER CHALKBOARD CAST IRON CONTRACTOR INSTALLED CAST IN PLACE CONTROL JOINT CENTRE LINE CEILING CLOSET CLEAR CONCRETE MASONRY UNIT CLEAN/CLEAR OUT COLUMN CONCRETE CONSTRUCTION CONTINUOUS CORRIDOR
BR BS CAB CAS CB CEM CER CF CG CH CHAM CHBD CI CI CI CI CI CI CL CLG CLQ CLQ CLQ CLQ CLQ CLQ CLQ CLQ CLQ CLQ	BACKREST BOTH SIDES CABINET CASEWORK CATCH BASIN CEMENT CERAMIC CUBIC FOOT CORNER GUARD CEILING HEIGHT CHAMFER CHALKBOARD CAST IRON CONTRACTOR INSTALLED CAST IN PLACE CONTROL JOINT CENTRE LINE CEILING CLOSET CLEAR CONCRETE MASONRY UNIT CLEAN/CLEAR OUT COLUMN CONCRETE CONSTRUCTION CONTINUOUS CORRIDOR CONCRETE PAVER
BR BS CAB CAS CB CEM CER CF CG CH CHAM CHBD CI CI CI CI CI CI CI CLG CLG CLQ CLG CLQ CLR CMU CO CONC CONST CONST CORR CP CPR	BACKREST BOTH SIDES CABINET CASEWORK CATCH BASIN CEMENT CERAMIC CUBIC FOOT CORNER GUARD CEILING HEIGHT CHAMFER CHALKBOARD CAST IRON CONTRACTOR INSTALLED CAST IN PLACE CONTROL JOINT CENTRE LINE CEILING CLOSET CLEAR CONCRETE MASONRY UNIT CLEAN/CLEAR OUT COLUMN CONCRETE CONSTRUCTION CONTRIDOR CONTRIDOR CONCRETE PAVER CONCRETE PAVER COPPER
BR BS CAB CAS CB CEM CER CF CG CH CHAM CHBD CI CI CI CI CI CI CI CL CLG CLO CLG CLO CLR CMU CO CONC CONST CONT CORR CP CPR CPT	BACKREST BOTH SIDES CABINET CASEWORK CATCH BASIN CEMENT CERAMIC CUBIC FOOT CORNER GUARD CUBIC FOOT CORNER GUARD CEILING HEIGHT CHAMFER CHALKBOARD CAST IRON CONTRACTOR INSTALLED CAST IN PLACE CONTROL JOINT CENTRE LINE CEILING CLOSET CLEAR CONCRETE MASONRY UNIT CLEAN/CLEAR OUT COLUMN CONCRETE CONSTRUCTION CONTRUCTION CONTRUCTION CONTRUCTION CONCRETE PAVER CONCRETE PAVER COPPER CARPET(ED)(ING)
BR BS CAB CAS CB CEM CER CF CG CH CHAM CHBD CI CI CI CI CI CI CI CL CLG CLO CLG CLO CLR CMU CO COL CONC CONC CONST CONT CORR CP CPR CPT CT	BACKREST BOTH SIDES CABINET CASEWORK CATCH BASIN CEMENT CERAMIC CUBIC FOOT CORNER GUARD CEILING HEIGHT CHAMFER CHALKBOARD CAST IRON CONTRACTOR INSTALLED CAST IN PLACE CONTROL JOINT CENTRE LINE CEILING CLOSET CLEAR CONCRETE MASONRY UNIT CLEAN/CLEAR OUT COLUMN CONCRETE CONSTRUCTION CONTINUOUS CORRIDOR CONCRETE PAVER COPPER CARPET(ED)(ING) CERAMIC TILE
BR BS CAB CAS CB CEM CER CF CG CH CHAM CHBD CI CI CI CI CI CI CI CL CLG CLO CLR CLO CLR CLO CLR CONC CONC CONST CONT CONT CORR CP CPR CPT CT CT	BACKREST BOTH SIDES CABINET CASEWORK CATCH BASIN CEMENT CERAMIC CUBIC FOOT CORNER GUARD CEILING HEIGHT CHAMFER CHALKBOARD CAST IRON CONTRACTOR INSTALLED CAST IN PLACE CONTROL JOINT CENTRE LINE CEILING CLOSET CLEAR CONCRETE MASONRY UNIT CLEAN/CLEAR OUT COLUMN CONCRETE CONSTRUCTION CONTRIDOR CONCRETE PAVER COPPER CARPET(ED)(ING) CERAMIC TILE COAT HOOK
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BR BS CAB CAS CB CEM CER CF CG CH CHAM CHBD CI CI CI CI CI CI CI CL CLG CLO CLG CLO CLG CLO CLR CMU CO CONC CONST CONT CONST CONT CONT CORR CP CPR CPT CT CT CT CT CT CT CT CT CT CT CT CT CT	BACKREST BOTH SIDES CABINET CASEWORK CATCH BASIN CEMENT CERAMIC CUBIC FOOT CORNER GUARD CEILING HEIGHT CHAMFER CHALKBOARD CAST IRON CONTRACTOR INSTALLED CAST IN PLACE CONTROL JOINT CENTRE LINE CEILING CLOSET CLEAR CONCRETE MASONRY UNIT CLEAN/CLEAR OUT COLUMN CONCRETE CONSTRUCTION CONCRETE CONSTRUCTION CONCRETE PAVER CONCRETE PAVER COPPER CARPET(ED)(ING) CERAMIC TILE COAT HOOK COUNTER
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BR BS CAB CAS CB CEM CER CF CG CH CHAM CHBD CI CI CI CI CI CI CI CI CI CI CI CI CI	BACKREST BOTH SIDES CABINET CASEWORK CATCH BASIN CEMENT CERAMIC CUBIC FOOT CORNER GUARD CEILING HEIGHT CHAMFER CHALKBOARD CAST IRON CONTRACTOR INSTALLED CAST IN PLACE CONTROL JOINT CENTRE LINE CEILING CLOSET CLEAR CONCRETE MASONRY UNIT CLEAN/CLEAR OUT COLUMN CONCRETE CONSTRUCTION CONCRETE CONSTRUCTION CONCRETE CONSTRUCTION CONCRETE PAVER COPPER CARPET(ED)(ING) CERAMIC TILE COAT HOOK COUNTER DOUBLE DEGREE DEMOLISH DEPRESSION DETAIL DRINKING FOUNTAIN DIAMETER
BR BS CAB CAS CB CEM CER CF CG CH CHAM CHBD CI CI CI CI CI CI CI CI CL CLG CLO CLG CLO CLR CMU CO CONST CONST CONST CONST CONST CONST CONST CONST CONST CONST CONST CONST CDR CDR CDR CDR CDR CDR CDR CDR CDR CD CD CD CD CD CD CD CD CD CD CD CD CD	BACKREST BOTH SIDES CABINET CASEWORK CATCH BASIN CEMENT CERAMIC CUBIC FOOT CORNER GUARD CEILING HEIGHT CHAMFER CHALKBOARD CAST IRON CONTRACTOR INSTALLED CAST IN PLACE CONTROL JOINT CENTRE LINE CEILING CLOSET CLEAR CONCRETE MASONRY UNIT CLEAN/CLEAR OUT COLUMN CONCRETE CONSTRUCTION CONCRETE CONSTRUCTION CONCRETE CONSTRUCTION CONCRETE PAVER COPPER CARPET(ED)(ING) CERAMIC TILE COAT HOOK COUNTER DOUBLE DEGREE DEMOLISH DEPRESSION DETAIL DRINKING FOUNTAIN DIAMETER DIAGONAL
BR BS CAB CAS CB CEM CER CF CG CH CHAM CHBD CI CI CI CI CI CI CI CI CI CI CI CI CI	BACKREST BOTH SIDES CABINET CASEWORK CATCH BASIN CEMENT CERAMIC CUBIC FOOT CORNER GUARD CEILING HEIGHT CHAMFER CHALKBOARD CAST IRON CONTRACTOR INSTALLED CAST IN PLACE CONTROL JOINT CENTRE LINE CEILING CLOSET CLEAR CONCRETE MASONRY UNIT CLEAN/CLEAR OUT COLUMN CONCRETE CONSTRUCTION CONCRETE CONSTRUCTION CONCRETE CONSTRUCTION CONCRETE PAVER COPPER CARPET(ED)(ING) CERAMIC TILE COAT HOOK COUNTER DOUBLE DEGREE DEMOLISH DEPRESSION DETAIL DRINKING FOUNTAIN DIAMETER DIAGONAL
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BR BS CAB CAS CB CEM CER CF CG CH CHAM CHBD CI CI CI CI CI CI CI CI CI CI CI CI CI	BACKREST BOTH SIDES CABINET CASEWORK CATCH BASIN CEMENT CERAMIC CUBIC FOOT CORNER GUARD CEILING HEIGHT CHAMFER CHALKBOARD CAST IRON CONTRACTOR INSTALLED CAST IN PLACE CONTROL JOINT CENTRE LINE CEILING CLOSET CLEAR CONCRETE MASONRY UNIT CLEAN/CLEAR OUT COLUMN CONCRETE CONSTRUCTION CONCRETE CONSTRUCTION CONCRETE PAVER COPPER CARPET(ED)(ING) CERAMIC TILE COAT HOOK COUNTER DOUBLE DEGREE DEMOLISH DEPRESSION DETAIL DRINKING FOUNTAIN DIAMETER DIAGONAL DIMENSION DOWN DOWN
BR BS CAB CAS CB CEM CER CF CG CH CHAM CHBD CI CI CI CI CI CI CI CI CI CI CI CI CI	BACKREST BOTH SIDES CABINET CASEWORK CATCH BASIN CEMENT CERAMIC CUBIC FOOT CORNER GUARD CEILING HEIGHT CHAMFER CHALKBOARD CAST IRON CONTRACTOR INSTALLED CAST IN PLACE CONTROL JOINT CENTRE LINE CEILING CLOSET CLEAR CONCRETE MASONRY UNIT CLEAN/CLEAR OUT COLUMN CONCRETE CONSTRUCTION CONCRETE CONSTRUCTION CONCRETE PAVER CONCRETE PAVER COPPER CARPET(ED)(ING) CERAMIC TILE COAT HOOK COUNTER DOUBLE DEGREE DEMOLISH DEPRESSION DETAIL DRINKING FOUNTAIN DIAMETER DIAGONAL DIMENSION DOWN DOOR DOWNSPOUT
BR BS CAB CAS CB CEM CER CF CG CH CHAM CHBD CI CI CI CI CI CI CI CI CI CI CI CI CI	BACKREST BOTH SIDES CABINET CASEWORK CATCH BASIN CEMENT CERAMIC CUBIC FOOT CORNER GUARD CEILING HEIGHT CHAMFER CHALKBOARD CAST IRON CONTRACTOR INSTALLED CAST IN PLACE CONTROL JOINT CENTRE LINE CEILING CLOSET CLEAR CONCRETE MASONRY UNIT COLOSET CLEAR CONCRETE MASONRY UNIT COLOSET CLEAR CONCRETE CONSTRUCTION CONCRETE CONSTRUCTION CONCRETE CONSTRUCTION CONCRETE PAVER COPPER CARPET(ED)(ING) CERAMIC TILE COAT HOOK COUNTER DOUBLE DEGREE DEMOLISH DEPRESSION DETAIL DRINKING FOUNTAIN DIAMETER DIAGONAL DIMENSION DOWN DOOR DOWNSPOUT DISHWASHER
BR BS CAB CAS CB CEM CER CF CG CH CHAM CHBD CI CI CI CI CI CI CI CI CI CI CI CI CI	BACKREST BOTH SIDES CABINET CASEWORK CATCH BASIN CEMENT CERAMIC CUBIC FOOT CORNER GUARD CEILING HEIGHT CHAMFER CHALKBOARD CAST IRON CONTRACTOR INSTALLED CAST IN PLACE CONTROL JOINT CENTRE LINE CEILING CLOSET CLEAR CONCRETE MASONRY UNIT CLEAN/CLEAR OUT COLUMN CONCRETE CONSTRUCTION CONCRETE CONSTRUCTION CONCRETE PAVER CONCRETE PAVER COPPER CARPET(ED)(ING) CERAMIC TILE COAT HOOK COUNTER DOUBLE DEGREE DEMOLISH DEPRESSION DETAIL DRINKING FOUNTAIN DIAMETER DIAGONAL DIMENSION DOWN DOOR DOWNSPOUT
BR BS CAB CAS CB CEM CER CF CG CH CHAM CHBD CI CI CI CI CI CI CI CI CI CI CI CI CI	BACKREST BOTH SIDES CABINET CASEWORK CATCH BASIN CEMENT CERAMIC CUBIC FOOT CORNER GUARD CEILING HEIGHT CHAMFER CHALKBOARD CAST IRON CONTRACTOR INSTALLED CAST IN PLACE CONTROL JOINT CENTRE LINE CEILING CLOSET CLEAR CONCRETE MASONRY UNIT CLEAN/CLEAR OUT COLUMN CONCRETE CONSTRUCTION CONCRETE CONSTRUCTION CONCRETE PAVER COPPER CARPET(ED)(ING) CERAMIC TILE COAT HOOK COUNTER DOUBLE DEGREE DEMOLISH DEPRESSION DETAIL DINKING FOUNTAIN DIAMETER DIAGONAL DIMENSION DISPENSER DIVISION DOWN DOOR DOWNSPOUT DISHWASHER DRAWING
BR BS CAB CAS CB CEM CER CF CG CH CHAM CHBD CI CI CI CI CI CI CI CI CLG CLG CLG CLG CLG CLG CLG CLG CLG CLG	BACKREST BOTH SIDES CABINET CASEWORK CATCH BASIN CEMENT CERAMIC CUBIC FOOT CORNER GUARD CEILING HEIGHT CHAMFER CHALKBOARD CAST IRON CONTRACTOR INSTALLED CAST IN PLACE CONTROL JOINT CENTRE LINE CEILING CLOSET CLEAR CONCRETE MASONRY UNIT CLEAN/CLEAR OUT COLUMN CONCRETE CONSTRUCTION CONTINUOUS CORRIDOR CONCRETE PAVER COPPER CARPET(ED)(ING) CERAMIC TILE COAT HOOK COUNTER DOUBLE DEGREE DEMOLISH DEPRESSION DETAIL DINKING FOUNTAIN DIAMETER DIAGONAL DIMENSION DISPENSER DIVISION DOWN DOOR DOWNSPOUT DISHWASHER DRAWING
BR BS CAB CAS CB CEM CER CF CG CH CHAM CHBD CI CI CI CI CI CI CI CI CI CI CI CI CI	BACKREST BOTH SIDES CABINET CASEWORK CATCH BASIN CEMENT CERAMIC CUBIC FOOT CORNER GUARD CEILING HEIGHT CHAMFER CHALKBOARD CAST IRON CONTRACTOR INSTALLED CAST IN PLACE CONTROL JOINT CENTRE LINE CEILING CLOSET CLEAR CONCRETE MASONRY UNIT CLEAN/CLEAR OUT COLUMN CONCRETE MASONRY UNIT CLEAN/CLEAR OUT COLUMN CONCRETE CONSTRUCTION CONTINUOUS CORRIDOR CONCRETE PAVER COPPER CARPET(ED)(ING) CERAMIC TILE COAT HOOK COUNTER DOUBLE DEGREE DEMOLISH DEPRESSION DETAIL DRINKING FOUNTAIN DIAMETER DIAGONAL DIMENSION DISPENSER DIVISION DOWN DOOR DOWNSPOUT DISHWASHER DRAWING
BR BS CAB CAS CB CEM CER CF CG CH CHAM CHBD CI CI CI CI CI CI CI CI CI CI CI CI CI	BACKREST BOTH SIDES CABINET CASEWORK CATCH BASIN CEMENT CERAMIC CUBIC FOOT CORNER GUARD CEILING HEIGHT CHAMFER CHALKBOARD CAST IRON CONTRACTOR INSTALLED CAST IN PLACE CONTROL JOINT CENTRE LINE CEILING CLOSET CLEAR CONCRETE MASONRY UNIT CLEAN/CLEAR OUT COLUMN CONCRETE MASONRY UNIT CLEAN/CLEAR OUT COLUMN CONCRETE CONSTRUCTION CONTINUOUS CORRIDOR CONCRETE PAVER COPPER CARPET(ED)(ING) CERAMIC TILE COAT HOOK COUNTER DOUBLE DEGREE DEMOLISH DEPRESSION DETAIL DRINKING FOUNTAIN DIAMETER DIAGONAL DIMENSION DISPENSER DIVISION DOWN DOOR DOWNSPOUT DISHWASHER DRAWING
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EMER EMF ENCL ENG EOD EOS EQ EQPT EST EWC EXIST EXP	ENCLOSED / ENCLOSURE ENGINEER EDGE OF DECK EDGE OF SLAB EQUAL(LY)
FE FEC FEC (R)	FIRE EXTINGUISHER FIRE EXTINGUISHER CABINET
FURR FUT GA GALV GB GBFD GC GL GND GR GRB GRV GT GWG GYP	FURRING FUTURE GAUGE GALVANIZE(D) GYPSUM BOARD GRAB BAR FOLD DOWN GENERAL CONTRACTOR GLASS / GLAZING GROUND GRADE GRAB BAR GRAVEL GLASS TILE GEORGIAN WIRED GLASS GYPSUM
HB HC HD HDR HDWR HI HM HMI HMI HMI HNDR HOR / HORIZ HP HR HT HVAC HW HYD	
IALUM ID IHM INCL INSUL INT ITGL JAN	INSIDE DIAMETER INSULATED HOLLOW METAL PANEL INCH / INCHES INCLUDE(D) / INCLUDING INSULATE / INSULATION INTERIOR INSULATED TEMPERED GLASS
JT	JOINT
KIT LAB LAV LB(S) LF LH LIB LKR LNS LNT LP LT LVR LVR LWT	KITCHEN LABORATORY LAMINATE(D) LAVATORY POUND(S) LINEAR FOOT (FEET) LEFT HAND LIBRARY LOCKER LINOLEUM SHEET LINOLEUM TILE LOW POINT LIGHT LOUVRE LIGHT WEIGHT

AAT AATL AAX AC AE AECH AEZZ AFR AIN AIR AIN AIR AIN AIN AIR AID A AID A ATL ATL AUL	MACHINE MAINTENANCE ANTI-FATIGUE MATTING MATERIAL MAXIMUM MEDICINE CABINET MECHANICAL EQUIPMENT MECHANICAL EQUIPMENT MECHANICAL MEZZANINE MANUFACTURE(R) MANHOLE MINIMUM MIRROR MISCELLANEOUS MOULDING MASONRY OPENING MOISTURE RESISTANT MOUNTED METAL MULLION MICROWAVE
I IA OR	NORTH NOT AVAILABLE / APPLICABLE
	NATIONAL FIRE PROTECTION ASSOCIATION NOT IN CONTRACT NUMBER NOMINAL NOT TO SCALE
DA DBS DC DCI DD DFF DPG / DPNG DPP	OVERALL OBSCURE ON CENTRE OCCUPIED INDICATOR OUTSIDE DIAMETER OFFICE OPENING
)PP)Z	OPPOSITE OUNCE
PED PER PERF PERP PF PF PF PL PLAM PLAS PLAM PLAS PLAM PLAS PLAM PLAS PLAM PLAS PLAM PLAS PLAM PLAS PLAM PLAS PLAS PLAS PLAS PLAS PLAS PLAS PLAS	PARTIAL PATTERN PORCELAIN BASE PARTICLE BOARD PRECAST CONCRETE PEDESTAL/PEDESTRIAN PERIMETER PERFORATED PERFORATED PERFORATED PORCELAINE FLOOR TILE POURED-IN-PLACE PLATE PLASTIC LAMINATE PLASTER PLYWOOD PAIR PRE-CAST PREFABRICATED PROPERTY
PTDF PTLB PTN PTOB PTR	PORCELAIN TILE POUNDS PER SQUARE FOOT POUNDS PER SQUARE INCH PAINT PAPER TOWEL DISPENSER PAPER TOWEL DISPENSER & WASTE RECEPTACLE PRESSURE TREATED DOUGLAS FIR PUSH TO LOCK BUTTON PARTITION PUSH TO OPEN BUTTON PAPER TOWEL RECEPTACLE POLYVINYL CHLORIDE
	QUARTZ QUANTITY
A AD AB ACP AD AEF AEF AEF AEF AESIL AESS AEST AEV AFL AM AO AS AST AST AST AST AST AST AST AST AST	RISER RADIUS RUBBER BASE REFLECTED CEILING PLAN ROOF DRAIN REFERENCE REFRIGERATOR REGISTER REINFORCE(D) REQUIRED RESILIENT SHEET RESILIENT SHEET RESILIENT TILE RETAINING REVISE / REVISION REFLECTED RIGHT HAND ROUGH OPENING RUBBER SHEET FLOORING RUBBER STAIR TREADS RUBBER STAIR TREADS RUBBER STAIR TREADS RUBBER TILE RUBBER WALL BASE REDWOOD RAIN WATER LEADER
SCD SCHED SCN	SOUTH SOLID CORE SEAT COVER DISPENSER SCHEDULE SCREEN STAINED CONCRETE

SD	SOAP DISPENSER / STORM DRAIN
SDCONC	SEALED CONCRETE
SECT	SECTION
SF	SQUARE FEET
SHLF	SHELF
SHT	SHEET
SHTG	SHEATHING
SHWC	SHOWER CURTAIN AND ROD
SHWR	SHOWER
SHWS	SHOWER SEAT
SIM	SIMILAR
SND	SANITARY NAPKIN DISPENSER
SNR	SANITARY NAPKIN RECEPTACLE
SOG	SLAB ON GRADE
SPD	SOAP DISPENSER WITH
SPEC SPK SQ	COLLECTOR SPECIFY / SPECIFICATION SPEAKER SQUARE
SQFT	SQUARE FEET
SQIN	SQUARE INCH(ES)
SS	STAINLESS STEEL
ST	STONE
STA	STATION
STC	SOUND TRANSMISSION CLASS
STD	STANDARD
STDS	STUDS
STIFF	STIFFENER
STL	STEEL
STN	STAINED
STOR	STORAGE
SV SW	STRUCTURE / STRUCTURAL STOVE SWITCH SYMMETRICAL
SYN	SYNTHETIC
SYS	SYSTEM
T&B	TOP AND BOTTOM
T&G	TONGUE AND GROOVE
TB	TOWEL BAR
TBD	TO BE DETERMINED
TC	TOP OF CURB
TEMP TER TGL	TELEPHONE TEMPORARY / TEMPERATURE TERRAZZO TEMPERED GLASS
THK	THICK
THRU	THROUGH
TOC	TOP OF CONCRETE
TOS	TOP OF STEEL
TOW	TOP OF WALL
TPD	TOILET PAPER DISPENSER
TPTN	TOILET PARTITION
TV	TELEVISION
TYP	TYPICAL
UC	UNDERCUT
UG	UNDERGROUND
UL	UNDERWRITER'S LABORATORY
UNF / UNFIN UNO UPS UR	UNFINISHED UNLESS NOTED OTHERWISE UNINTERRUPTIBLE POWER SUPPLY URINAL
V	VOLT
VAC	VACUUM
VB	VAPOR BARRIER
VCT VENT VERT	VINYL COMPOSITION TILE VENTILATE VERTICAL VESTIBULE VERIFY IN FIELD
	VENIFT IN FIELD VENEER VINYL STAIR TREADS VINTYL STAIR TREADS & RISERS VENT THRU ROOF VINYL WALLCOVERING
W	WEST
W/	WITH
W/O	WITHOUT
WC	WATER CLOSET
WCV	WALLCOVERING
WD	WOOD
WF	WIDE FLANGE
WH	WALL HOSE / HYDRANT
WI	WROUGHT IRON
WIN WK WNSCT	WROUGHT IRON WINDOW WORK WAINSCOT WATERPROOF(ING)
WP WPT WR WRR	WORK POINT WASHROOM WOOD RISER

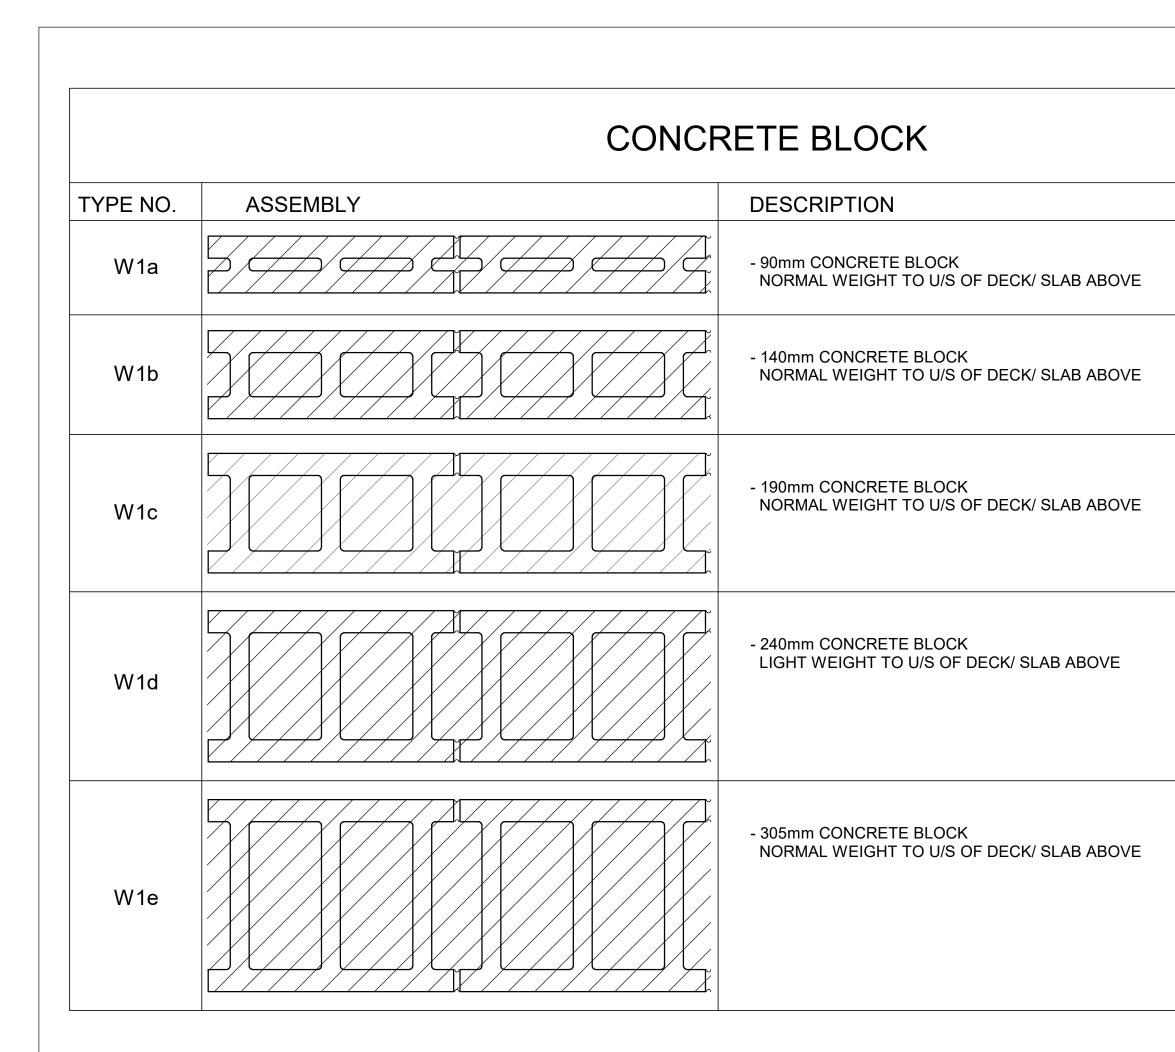
REFERENCE SYMBOLS



GENERAL NOTES

- 1. PERFORM THE WORK IN ACCORDANCE WITH THE LATEST EDITION OF THE ONTARIO BUILDING CODE, CITY OF TORONTO ACCESSIBILITY DESIGN GUIDELINES AND ANY OTHER
- 2. DRAWINGS ARE TO BE READ IN CONJUNCTION WITH THE SPECIFICATIONS AND THE ASSOCIATED STRUCTURAL, MECHANICAL, ELECTRICAL DRAWINGS AND ALL OTHER RELEV
- 3. CONTRACTOR SHALL VERIFY THE SITE INFORMATION PRIOR TO PROCEEDING WITH THE WORK. FAILURE TO REPORT ANY DISCREPANCIES SHALL CONSTITUTE ACCEPTANCE
- 4. THE CONTRACTOR SHALL REVIEW THE DRAWINGS FOR SCOPE OF DEMOLITION AND NEW WORK, INCLUDING ALL DISCIPLINES, AND SHALL COORDINATE WITH NEW WORK DRA
- 5. SCOPE OF WORK SHALL NOT BE LIMITED TO THAT SHOWN ON THE DRAWINGS AND SHALL INCLUDE WORK REQUIRED TO ELIMINATE ALL EXISTING, ABANDONED OR REDUNDA
- 6. PROVIDE 16 GA SHEET METAL REINFORCEMENT INSTALLED ON THE STUDS PRIOR TO INSTALLING THE GYPSUM BOARD IN THE LOCATIONS REQUIRED TO SUPPORT WALL MOU 7. ISOLATE ALL MECHANICAL PIPES DUCTS AND EQUIPMENT FROM INTERIOR PARTITIONS TO AVOID ACOUSTIC NOISE TRANSFER.
- 8. MAINTAIN CONTINUITY OF BUILDING ENVELOPE AIR / VAPOUR BARRIER TRANSITIONS AND PENETRATIONS WITH MEMBRANES LAPPED AND APPROVED SEALANTS COMPATIBLE 9. REINSTATE INTEGRITY OF FIRE SEPARATION WHEN PATCHING. PROVIDE AND INSTALL FIRE STOPPING AND SMOKE SEALS AT ALL NEW SERVICE PENETRATIONS THROUGH FLO REFER TO MECHANICAL DRAWINGS FOR ANY FIRE DAMPER REQUIREMENTS.
- 10. ENSURE THAT FOR ALL FIRE SEPARATIONS INDICATED ON THE DRAWINGS, ALL COMPONENTS OF THE ASSEMBLY SHALL BE OF APPROVED MATERIALS, AND INSTALLATION/FA LABORATORIES OF CANADA LTD." LATEST EDITION MANUAL AND OTHERWISE MEETING THE REQUIREMENTS OF THE ONTARIO BUILDING CODE. ALL FIRE SEPARATIONS MUST E SEPARATIONS AND PENETRATIONS WITH APPROVED U.L.C. LISTED FIRE STOPPING SYSTEMS AND FIRE SEALANTS BOTH SIDES OF PARTITIONS.
- 11. ULC LISTED FIRE-RATED SEALANT IS TO BE APPLIED TO ALL FIRE-RATED PARTITIONS AND LEFT EXPOSED FOR INSPECTION PURPOSES
- 12. WHERE ITEMS NOTED TO BE DEMOLISHED MEET EXISTING WALLS / CEILING AND/OR FLOOR TO REMAIN, PATCH REPAIR AND MAKE GOOD EXISTING SURFACES. PROVIDE NEW 13. PROVIDE CUTTING, PATCHING AND CORING OF ALL WALLS, CEILING, ROOF AND OTHER SURFACES AS REQUIRED TO PERFORM THE WORK. PRIOR TO CUTTING OR CORING, SC
- REINFORCING, CONDUITS, WIRING AND OTHER HIDDEN ITEMS. OBTAIN WRITTEN VERIFICATION OF PROPOSED DRILLING AND CUTTING LOCATIONS FROM THE STRUCTURAL EN 14. BEFORE COMMENCING WORK, ESTABLISH LOCATION AND EXTENT OF EXISTING SERVICE LINES IN AREA OF WORK AND NOTIFY CONSULTANT OF FINDINGS. WHERE UNKNOWN
- 15. PROVIDE FOR DEMOLITION OF INCLUDING BUT NOT LIMITED TO, EXISTING WALLS, FLOORS, CEILINGS, ASSOCIATED FINISHES, MECHANICAL AND ELECTRICAL FIXTURES, DEVIC REMOVAL.
- 16. CONCEAL ALL MECHANICAL AND ELECTRICAL WORK IN WALLS AND CEILINGS, EXCEPT AS INDICATED OTHERWISE OR APPROVED.
- 17. VAPOUR BARRIER TO BE CONTINUOUS UNDER ALL NEW FLOOR SLABS. PATCH ALL CONCRETE CORE TEST AREAS, DEFECTS AND DEMOLITION LOCATIONS.
- 18. ALL SPECIFIED MATERIALS SHALL BE INSTALLED AND FINISHED IN ACCORDANCE WITH MANUFACTURERS WRITTEN INSTRUCTIONS. SHOULD SUCH INSTRUCTIONS DIFFER FRO 19. DETAILS MARKED "TYPICAL" SHALL APPLY IN ALL SIMILAR CONDITIONS UNLESS NOTED OR DETAILED OTHERWISE.
- 20. BRING ALL OMISSIONS AND DISCREPANCIES, INCLUDING DIMENSIONS, TO THE ATTENTION OF THE CONSULTANT PRIOR TO COMMENCEMENT OF ANY WORK.
- 21. FULLY COORDINATE ALL ADDITIONAL SUPPORT REQUIRED FOR ANCHORAGE OF MECHANICAL EQUIPMENT OR DUCTS AND ELECTRICAL FIXTURES/EQUIPMENT. PROVIDE SEISM THE PROVINCE OF ONTARIO.
- 22. WALL ASSEMBLIES SHALL EXTEND TO UNDERSIDE OF ROOF OR STRUCTURE ABOVE UNLESS NOTED OR DETAILED OTHERWISE
- 23. REFER TO ELECTRICAL DRAWINGS FOR LOCATION OF ALL ELECTRICAL EQUIPMENT, CONDUIT, LIGHTING AND RECEPTACLE LOCATIONS.
- 24. REFER TO MECHANICAL DRAWINGS FOR LOCATION OF ALL MECHANICAL EQUIPMENT AND PROVISIONS.
- 25. REFER TO STRUCTURAL DRAWINGS FOR LOCATION AND SIZING OF ALL STRUCTURAL ELEMENTS
- 26. DIMENSIONS ARE SHOWN IN MILLIMETERS UNLESS OTHERWISE NOTED.
- 27. REMOVAL AND DISPOSAL OF HAZARDOUS MATERIALS SHALL BE IN ACCORDANCE WITH LOCAL REGULATIONS AND AUTHORITIES HAVING JURISDICTION.
- 28. UNLESS NOTED OTHERWISE, MAKE GOOD ALL AREAS DISTURBED BY EXCAVATION AND/OR INSTALLATION OF CIVIL, STRUCTURAL, MECHANICAL AND ELECTRICAL SERVICES. 29. PROPER HOARDING TO BE PROVIDED AROUND ALL NEW EXTERIOR WORK LOCATIONS.

			CLIENT CITY OF TORONTO
			DA TORONTO
	NEW DOOR NUMBER INDICATION	KEYNOTE SYMBOLS	55 John ST. TORONTO, ON
	(100)	1 DEMOLITION WORK	M5V 3C6 COPYRIGHT
<u>NC</u>	WINDOW NUMBER INDICATION		This drawing has been prepared solely for the intended use, thus any reproduction or distribution for any purpose other than authorized by IBI Group is forbidden. Written dimensions shall have precedence over scaled dimensions. Contractors shall verify and be responsible for all dimensions and conditions on the job, and IBI Group shall be informed of any variations from the dimensions and conditions shown on the drawing. Shop drawings shall be submitted to IBI Group for general
	(W101)		conformance before proceeding with fabrication. IBI Group Professional Services (Canada) Inc. is a member of the IBI Group of companies
	LOUVER NUMBER INDICATION	FLOOR FINISH TAG	ISSUESNo.DESCRIPTIONDATE00ISSUED FOR CONSTRUCTION2021-10-19
	CEILING TAG	REVISION INDICATION	
	HEIGHT AFF		
	ROOF OR RAMP PITCH INDICATION		
	6		
	ROOF OR RAMP SLOPE INDICATION	CAMERA VIEW	
	PHOTO NUMBER		
VANT (E OF T AWIN(ICABLE REQUIREMENT OF AUTHORITIES HAVING JURI CONSULTANT DRAWINGS. HE SITE CONDITIONS. GS FOR EXACT EXTENT OF DEMOLITION. OMPONENTS, AND TO FACILITATE PROPER EXECUTION		CONSULTANTS
E WIT) ITEMS. H MEMBRANE PRODUCTS USED.		
	, WALLS AND CEILINGS IN ACCORDANCE WITH OBC. L		
BE CC	ONTINUOUS, AND ALL JOINTS TO BE SMOKE TIGHT. MA	INTAIN CONTINUITY OF ALL FIRE	SEAL
	L MATERIAL TO MATCH EXISTING AND. MAINTAIN ALL I HE SLAB/WALL/ROOF AND COORDINATE DRILLING/CU EER.		
	VICES ARE ENCOUNTERED, IMMEDIATELY ADVISE AND DUCTS TO ALLOW FOR NEW WORK TO BE INSTALLED.		
ОМ ТН	E SPECIFICATIONS OR DETAILS, ADVISE CONSULTANT	T IMMEDIATELY FOR DIRECTION.	PRIME CONSULTANT IBI GROUP 175 Galaxy Blvd, Unit 100 Toronto, ON M9W 0C9, Canada tel 416 679 1930 fax 416 675 4620 ibigroup.com
MIC RI	ESTRAINT DRAWINGS STAMPED BY <u>A THIRD PARTY</u> PF	ROFESSIONAL ENGINEER LICENCED IN	PROJECT TITLE CITY OF TORONTO ACCESSIBILITY UPGRADES
			PROJECT ADDRESS CITY OF TORONTO ACCESSIBILITY UPGRADES
REFE	R TO CIVIL, STRUCTURAL, MECHANICAL, AND ELECTRI	ICAL DRAWINGS.	PROJECT NO: 9119- 19- 0162 / IBI 122260 DRAWN BY: CHECKED BY: A. BOYNARIAN A. VAN VEEN PROJECT MGR: APPROVED BY: F.BOLOURIAN E. FENUTA
			SHEET TITLE GENERAL NOTES, ABBREVIATIONS &
			REFERENCE SYMBOLS
			SHEET NUMBER ISSUE 00



WALL TYPE NOTES:

- 1. ACOUSTIC BATT INSULATION TO EXTEND FULL HEIGHT OF WALL ASSEMBLIES UNLESS NOTED OTHERWISE.
- 2. PROVIDE MOISTURE RESISTANT GYPSUM BOARD ON ALL WALLS OF WASHROOMS, KITCHEN AREAS AND BEHIND FOUNTAINS.
- 3. PROVIDE TILE BACKER BOARD BEHIND ALL CERAMIC TILE APPLICATIONS.
- 4. ANY PENETRATIONS THROUGH FIRE RATED WALLS SHOULD BE PROTECTED WITH ULC LISTED FIRE STOPPING.
- 5. AT FIRE RATED WALLS AND SMOKE BARRIERS ABOVE ACCESSIBLE CEILING, PROVIDE IDENTIFICATION SIGNAGE NOT MORE THAN 9 METRE MEASURED HORIZONTALLY, INDICATING "FIRE AND/OR SMOKE BARRIER - PROTECT O PER OBC 3.1.9".
- 6. PROVIDE FIRE BLOCKING IN CONCEALED SPACES OF STUD WALLS AND PARTITIONS VERTICALLY AT THE CEILING LEVELS AND HORIZONTALLY.
- 7. FURRING WALLS AROUND COLUMNS, SHAFTS AND PIPING THAT ARE ALSO DEMISING WALLS BETWEEN ROOMS U/S OF DECK/ SLAB ABOVE AND CARRY ACOUSTIC INSULATION CONTINUITY FROM ADJACENT WALLS.

							CLIENT
		META	LS	TUD - DRYWALL			CITY OF TORONTO
	TYPE NO.	ASSEMBLY		DESCRIPTION	FRR	STC	55 John ST.
FRR STC 44	W2		124	- 16mm FIRE RATED GYPSUM BOARD - 92mm METAL STUDS @ 400 O.C. - 16mm FIRE RATED GYPSUM BOARD - EXTEND WALL TO U/S OF DECK	1.0 HR ULC W407	38 (OBC S4C)	COPYRIGHT This drawing has been prepared solely for the intended use, thus any reproduction or distribution for any purpose other than authorized by IBI Group is forbidden. Written dimensions shall have precedence over scaled dimensions. Contractors shall verify and be responsible for all dimensions and conditions on the job, and IBI Group shall be informed of any variations from the dimensions and conditions shown on the drawing. Shop drawings shall be submitted to IBI Group for general conformance before proceeding with fabrication.
1.0 HR OBC 46 SB-2	W2a		124	- 16mm GYPSUM BOARD - 92mm METAL STUDS @ 400 O.C. - 16mm GYPSUM BOARD			IBI Group Professional Services (Canada) Inc. is a member of the IBI Group of companies ISSUES DESCRIPTION DATE 00 ISSUED FOR CONSTRUCTION 2021-10-19
2.0 HR OBC 48 SB-2	W2b		124	 - 16mm FIRE RATED GYPSUM BOARD - 92mm METAL STUDS @ 400 O.C. MAXIMUM - 92mm ACOUSTIC / THERMAL NON COMBUSTIBLE BATT INSULATION - 16mm FIRE RATED GYPSUM BOARD - EXTEND WALL TO U/S OF DECK 	1.0 HR ULC W407	45	
	W2c		124	 - 16mm GYPSUM BOARD - 92mm METAL STUDS @ 400 O.C. - 92mm ACOUSTIC / THERMAL NON COMBUSTIBLE BATT INSULATION - 16mm GYPSUM BOARD - EXTEND WALL TO U/S OF DECK 		45	
49	W2d		156	 - 2 LAYERS OF 16mm FIRE RATED GYPSUM BOARD - 92mm METAL STUDS @ 400 O.C. MAXIMUM - 92mm ACOUSTIC / THERMAL NON COMBUSTIBLE BATT INSULATION - 2 LAYERS OF 16mm FIRE RATED GYPSUM BOARD - EXTEND WALL TO U/S OF DECK 	2.0 HR ULC W414	55	
51	W2e		184	 - 16mm GYPSUM BOARD - 152mm METAL STUDS @ 400 O.C. - 152mm ACOUSTIC / THERMAL NON COMBUSTIBLE BATT INSULATION - 16mm GYPSUM BOARD - EXTEND WALL TO U/S OF DECK 		51 (OBC S7A)	
	W2f		184	- 16mm GYPSUM BOARD - 152mm METAL STUDS @ 400 O.C. - 16mm GYPSUM BOARD			CONSULTANTS
D DRINKING	W2g		140	- 2 LAYERS OF 16MM GYPSUM BOARD - 92mm METAL STUDS @ 400 O.C. - 92mm ACOUSTIC / THERMAL NON COMBUSTIBLE BATT INSULATION - 16mm GYPSUM BOARD - EXTEND WALL TO U/S OF DECK		50 (OBC S5B)	
		FURRING WAL	L T	YPES - INTERNAL			SEAL
E, SPACED AT OPENINGS AS	TYPE NO.	ASSEMBLY		DESCRIPTION	FRR		
G AND FLOOR	W3a		8	38mm FURRING - TO 150mm ABOV FIN. CEILING - 16mm GYPSUM BOARD - 22mm MIN HAT CHANNEL @ 400 O.C.			
SHALL GO TO	W3b		*	80mm FURRING - TO 150mm ABOV FIN. CEILING - 16mm GYPSUM BOARD - 64mm MIN STEEL STUDS @ 400 O.C.			
	W3c			108mm FURRING - TO 150mm ABOV FIN. CEILING UNLESS OTHERWISE NOTED - 16mm GYPSUM BOARD - 92mm MIN STEEL STUDS @ 400 O.C.			IBI 175 Galaxy Blvd, Unit 100 Toronto, ON M9W 0C9, Canada tel 416 679 1930 fax 416 675 4620 ibigroup.com PROJECT TITLE CITY OF TORONTO
	W3d			108mm FURRING - TO 150mm ABOV FIN. CEILING UNLESS OTHERWISE NOTED - 16mm GYPSUM BOARD - 92mm MIN STEEL STUDS @ 400 O.C. - 92mm ACOUSTIC NON COMBUSTIBLE BATT INSULATION			ACCESSIBILITY UPGRADES PROJECT ADDRESS
		SHAFT WALL	TYF	PES - INTERNAL			CITY OF TORONTO ACCESSIBILITY UPGRADES
	TYPE NO.	ASSEMBLY		DESCRIPTION	FRR	STC	PROJECT NO: 9119- 19- 0162 / IBI 122260 DRAWN BY: CHECKED BY:
	W4a	2. 	* 2 •	-25.4mm FIRE RATED GYPSUM BOARD -102mm "C-H" SHAPED STUD @600 O.C. - 16mm FIRE RATED GYPSUM BOARD TO U/S OF DECK/ SLAB ABOVE	1.0 HR ULC W452		A. BOYNARIAN A. VAN VEEN PROJECT MGR: APPROVED BY: F.BOLOURIAN E. FENUTA SHEET TITLE WALL TYPES
	W4b		* - - -	-25.4mm FIRE RATED GYPSUM BOARD -102mm "C-H" SHAPED STUD @600 O.C. - 102mm ACOUSTIC / THERMAL NON COMBUSTIBLE BATT INSULATION - 19.1mm FIRE RATED GYPSUM BOARD TO U/S OF DECK/ SLAB ABOVE	2.0 HR ULC W508	52	SHEET NUMBER ISSUE 00

	METAI	STUD - DR	YWALL			
TYPE NO.	ASSEMBLY	DESCRIPT	ION	FRR	STC	55 John ST.
W2		- 92mm METAL S - 16mm FIRE RA	TED GYPSUM BOARD STUDS @ 400 O.C. TED GYPSUM BOARD TO U/S OF DECK	1.0 HR ULC W407	38 (OBC S4C)	COPYRIGHT Tris drawing has been prepared solely for the intended use, thus any reproduction or distribution for any purpose other than authorized by IBI Group is forbidden. Written dimensions shall have precedence over scaled dimensions. Contractors shall verify and be responsible for all dimensions and conditions on the job, and IBI Group shall be informed of any variations from the dimensions and conditions shown on the drawing. Shop drawings shall be submitted to IBI Group for general conformance before proceeding with fabrication.
W2a		- 16mm GYPSUM - 92mm METAL S - 16mm GYPSUM	STUDS @ 400 O.C.			IBI Group Professional Services (Canada) Inc. is a member of the IBI Group of companies ISSUES No. DESCRIPTION DATE 00 ISSUED FOR CONSTRUCTION 2021-10-19
W2b		- 92mm METAL S - 92mm ACOUST - 16mm FIRE RA	TED GYPSUM BOARD STUDS @ 400 O.C. MAXIMUM IC / THERMAL NON COMBUSTIBLE BATT INSULATION TED GYPSUM BOARD TO U/S OF DECK	1.0 HR ULC W407	45	
W2c		- 92mm ACOUST INSULATION - 16mm GYPSUM	TUDS @ 400 O.C. IC / THERMAL NON COMBUSTIBLE BATT		45	
W2d		- 92mm METAL S - 92mm ACOUST INSULATION - 2 LAYERS OF 1	6mm FIRE RATED GYPSUM BOARD TUDS @ 400 O.C. MAXIMUM IC / THERMAL NON COMBUSTIBLE BATT 6mm FIRE RATED GYPSUM BOARD TO U/S OF DECK	2.0 HR ULC W414	55	
W2e		- 152mm ACOUS INSULATION - 16mm GYPSUM	STUDS @ 400 O.C. TIC / THERMAL NON COMBUSTIBLE BATT		51 (OBC S7A)	
W2f		+ - 16mm GYPSUM - 152mm METAL - 16mm GYPSUM	STUDS @ 400 O.C.			CONSULTANTS
W2g		- 92mm METAL S - 92mm ACOUST - 16mm GYPSUM	6MM GYPSUM BOARD STUDS @ 400 O.C. IC / THERMAL NON COMBUSTIBLE BATT INSULATION I BOARD TO U/S OF DECK		50 (OBC S5B)	
	FURRING WAL	. TYPES - II	NTERNAL			SEAL
TYPE NO.	ASSEMBLY	DESCRIPT	ION	FRR		
W3a		- 16mm GYPSUM	- TO 150mm ABOV FIN. CEILING I BOARD CHANNEL @ 400 O.C.			
W3b		80mm FURRING - 16mm GYPSUM	- TO 150mm ABOV FIN. CEILING			
W3c		OTHERWISE NO - 16mm GYPSUM				IBI 175 Galaxy Blvd, Unit 100 Toronto, ON M9W 0C9, Canada tel 416 679 1930 fax 416 675 4620 ibigroup.com PROJECT TITLE CITY OF TORONTO
W3d	ې چ	OTHERWISE NO - 16mm GYPSUM - 92mm MIN STE				ACCESSIBILITY UPGRADES PROJECT ADDRESS
	SHAFT WALL 7	YPES - INT	ERNAL			CITY OF TORONTO ACCESSIBILITY UPGRADES
TYPE NO.	ASSEMBLY	DESCRIPT	ION	FRR	STC	PROJECT NO: 9119- 19- 0162 / IBI 122260 DRAWN BY: CHECKED BY:
W4a	2000 	-102mm "C-H" SH	ATED GYPSUM BOARD IAPED STUD @600 O.C. TED GYPSUM BOARD X/ SLAB ABOVE	1.0 HR ULC W452		A. BOYNARIAN A. VAN VEEN PROJECT MGR: APPROVED BY: F.BOLOURIAN E. FENUTA SHEET TITLE WALL TYPES
W4b	۲ ۲ ۲	-102mm "C-H" SH - 102mm ACOUS	ATED GYPSUM BOARD IAPED STUD @600 O.C. TIC / THERMAL NON COMBUSTIBLE BATT INSULATION ATED GYPSUM BOARD {/ SLAB ABOVE	2.0 HR ULC W508	52	SHEET NUMBER ISSUE 00

TYPE NO.	ASSEMBLY	DESCRIPTION	FRR	STC	55 John ST. TORONTO, ON
W2	<u>5</u>	 - 16mm FIRE RATED GYPSUM BOARD - 92mm METAL STUDS @ 400 O.C. - 16mm FIRE RATED GYPSUM BOARD - EXTEND WALL TO U/S OF DECK 	1.0 HR ULC W407	38 (OBC S4C)	M5V 3C6 COPYRIGHT This drawing has been prepared solely for the intended use, thus any reproduction or distribution for any purpose other than authorized by IBI Group is forbidden. Written dimensions shall have precedence over scaled dimensions. Contractors shall verify and be responsible for all dimensions and conditions on the job, and IBI Group shall be informed of any variations from the dimensions and conditions shown on the drawing. Shop drawings shall be submitten to IBI Group for general conformance before proceeding with fabrication.
W2a	12 				IBI Group Professional Services (Canada) Inc. is a member of the IBI Group of companies ISSUES DESCRIPTION DATE 00 ISSUED FOR CONSTRUCTION 2021-10-19
W2b		 - 16mm FIRE RATED GYPSUM BOARD - 92mm METAL STUDS @ 400 O.C. MAXIMUM - 92mm ACOUSTIC / THERMAL NON COMBUSTIBLE BATT INSULATION - 16mm FIRE RATED GYPSUM BOARD - EXTEND WALL TO U/S OF DECK 	1.0 HR ULC W407	45	
W2c	t	 - 16mm GYPSUM BOARD - 92mm METAL STUDS @ 400 O.C. - 92mm ACOUSTIC / THERMAL NON COMBUSTIBLE BATT INSULATION - 16mm GYPSUM BOARD - EXTEND WALL TO U/S OF DECK 		45	
W2d	<u>1</u>	 - 2 LAYERS OF 16mm FIRE RATED GYPSUM BOARD - 92mm METAL STUDS @ 400 O.C. MAXIMUM - 92mm ACOUSTIC / THERMAL NON COMBUSTIBLE BATT INSULATION - 2 LAYERS OF 16mm FIRE RATED GYPSUM BOARD - EXTEND WALL TO U/S OF DECK 	2.0 HR ULC W414	55	
W2e	10 10 10 10 10 10 10 10 10 10	- 16mm GYPSUM BOARD - 152mm METAL STUDS @ 400 O.C. - 152mm ACOUSTIC / THERMAL NON COMBUSTIBLE BATT INSULATION - 16mm GYPSUM BOARD - EXTEND WALL TO U/S OF DECK		51 (OBC S7A)	
W2f	8.2.2.2.2.2.2.2.2.2.2.2.2.2.2.2.2.2.2.2	- 16mm GYPSUM BOARD - 152mm METAL STUDS @ 400 O.C. - 16mm GYPSUM BOARD			CONSULTANTS
W2g		- 2 LAYERS OF 16MM GYPSUM BOARD - 92mm METAL STUDS @ 400 O.C. - 92mm ACOUSTIC / THERMAL NON COMBUSTIBLE BATT INSULATION - 16mm GYPSUM BOARD - EXTEND WALL TO U/S OF DECK		50 (OBC S5B)	
	FURRING WALL	TYPES - INTERNAL			SEAL
TYPE NO. W3a		DESCRIPTION 38mm FURRING - TO 150mm ABOV FIN. CEILING - 16mm GYPSUM BOARD - 22mm MIN HAT CHANNEL @ 400 O.C.	FRR		
W3b		80mm FURRING - TO 150mm ABOV FIN. CEILING - 16mm GYPSUM BOARD - 64mm MIN STEEL STUDS @ 400 O.C.			PRIME CONSULTANT
W3c		108mm FURRING - TO 150mm ABOV FIN. CEILING UNLESS OTHERWISE NOTED - 16mm GYPSUM BOARD - 92mm MIN STEEL STUDS @ 400 O.C.			IBI 175 Galaxy Blvd, Unit 100 Toronto, ON M9W 0C9, Canada tel 416 679 1930 fax 416 675 4620 ibigroup.com PROJECT TITLE CITY OF TORONTO
W3d	۴	108mm FURRING - TO 150mm ABOV FIN. CEILING UNLESS OTHERWISE NOTED - 16mm GYPSUM BOARD - 92mm MIN STEEL STUDS @ 400 O.C. - 92mm ACOUSTIC NON COMBUSTIBLE BATT INSULATION			ACCESSIBILITY UPGRADES
	SHAFT WALL TY			CITY OF TORONTO ACCESSIBILITY UPGRADES	
TYPE NO.	ASSEMBLY	DESCRIPTION	FRR	STC	PROJECT NO: 9119- 19- 0162 / IBI 122260 DRAWN BY: CHECKED BY:
W4a	1 1 1 1 1 1 1 1 1 1 1 1 1 1 1 1 1 1 1	-25.4mm FIRE RATED GYPSUM BOARD -102mm "C-H" SHAPED STUD @600 O.C. - 16mm FIRE RATED GYPSUM BOARD TO U/S OF DECK/ SLAB ABOVE	1.0 HR ULC W452		A. BOYNARIAN A. VAN VEEN PROJECT MGR: APPROVED BY: F.BOLOURIAN E. FENUTA SHEET TITLE WALL TYPES
W4b		-25.4mm FIRE RATED GYPSUM BOARD -102mm "C-H" SHAPED STUD @600 O.C. - 102mm ACOUSTIC / THERMAL NON COMBUSTIBLE BATT INSULATION - 19.1mm FIRE RATED GYPSUM BOARD TO U/S OF DECK/ SLAB ABOVE	2.0 HR ULC W508	52	SHEET NUMBER ISSUE 00



CITY OF TORONTO ACCESSIBILITY UPGRADES

	TOUCH AND FEEL INDEX		
SHEET #	SHEET TITLE		
Т00	COVER PAGE		
T01	WASHROOM		
T02	WASHROOM ACCESSORIES		
Т03	WASHROOM FIXTURES & DRINKING FOUNTAIN		
T04	KITCHEN MATERIALS AND FIXTURES		
T05	RESERVED		
T06	TACTILE ATTENTION INDICATORS		
T07	TEXTURAL & COLOUR CONTRAST WARNING STRIP AND NOSING		
T08	DOOR THRESHOLDS		

TOUCH-AND-FEEL DOCUMENT SHOULD BE READ IN CONJUNCTION WITH DRAWINGS AND SPECIFICATIONS

TORONTO

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TOUCH AND FEEL INTERIOR FIXTURES AND MATERIALS

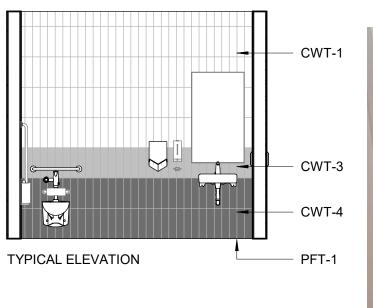
Project Number: 9119- 19- 0162 / IBI 122260 Date: 2021-10-19

VVA	SHROOM FINISHES
WASHROOM / SHOWER WALLS	COLLECTION: COLOUR & DIMENSION
CWT-1	COLOUR: ARCTIC WHITE MATTE
	SIZE: 100mm X 400mm (4"X16")
	SUPPLIER: OLYMPIA
WASHROOM / SHOWER WALL ACCENT	
CWT-2	TILE SIZE IS INDICATED ON ROOM FINISH SCHEDULE
WASHROOM / SHOWER WALL ACCENT	COLLECTION: COLOUR & DIMENSION
CWT-3	COLOUR: TAUPE, MATTE
	SIZE: 100mm X 400mm (4"X16")
	SUPPLIER: OLYMPIA
WASHROOM / SHOWER WALL ACCENT	COLLECTION: COLOUR & DIMENSION
CWT-4	COLOUR: DARK GREY MATTE
	SIZE: 100mm X 400mm (4"X16")
	SUPPLIER: OLYMPIA
FLOORS	COLLECTION: MICA, MATTE FINISH
PFT-1	SIZE: 300mm X 600mm (12"X24")
	MEETS DYNAMIC COEFFICIENT OF FRICTION
	PREFERRED SUPPLIER: D9 / EMOTION
SHOWER FLOORS	COLLECTION: STI MOSAICO
PFT-2	COLOUR: MID GREY UNGLAZ
FT 1 - 2	SIZE: 50mm X 50mm (2"X2")
	MEETS DYNAMIC COEFFICIENT OF FRICTION
	SUPPLIER: STONE TILE
FLOORS	MATCH EXISTING
PFT-3	TILE SIZE IS INDICATED ON ROOM FINISH SCHEDULE
FLOORS	COLLECTION: CORE COLLECTION TERRA
PFT-4	COLOUR: 200 SMOOTH (V)
	SIZE: 304.8mm X 609.6mm (12"X24")
	MEETS DYNAMIC COEFFICIENT OF FRICTION

FOR WASHROOMS WHERE ALL FIXTURES AND WALLS ARE BEING REMOVED ONLY



PICTURE 1





NOTE: THE FINISHES PRESENTED ON THIS PAGE ARE THE BASIS OF DESIGN - ANY ALTERNATES ARE SUBJECT TO APPROVAL BY CITY OF TORONTO, PROJECT MANAGER, FACILITY MANAGER AND STAKEHOLDERS

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CITY OF TORONTO ACCESSIBILITY UPGRADES CITY OF TORONTO ACCESSIBILITY UPGRADES DRAWING TITLE:

WASHROOM

Date: 2021-10-19

Issue: 50% SUBMISSION



NOTE: PICTURES ARE ONLY FOR ILLUSTRATION PURPOSES

Project No: 9119- 19- 0162 / IBI 122260

NO.









DECORUM WALL HUNG LAVATORY WITH EVERCLEAN 9024-901EC - VITREOUS CHINA - WHITE FINISH - 3 HOLES, 102 MM CENTER - REAR OVERFLOW -RECESSED SELF-DRAINING FAUCET LEDGE

UNDER-MOUNTED LAVATORY SINK: L2H AMERICAN STANDARD "OVALYN UNIVERSAL ACCESS™ SINK"



SOAP DISPENSER: MOEN SINGLE MOUNT MODERN STYLE -8560 ELECTRONIC SOAP DISPENSER "TOUCH FREE"



FAUCET: **MOEN ALIGN SENSOR FAUCET - 8559** ELECTRONIC 'NO-TOUCH' HARDWIRED POWERED FAUCET





TOILET: W1 WALL HUNG - WHITE FINISH - VITREOUS CHINA WITH EVERCLEAN ANTIMICROBIAL SURFACE

TOILET: W2 FLOOR MOUNTED WHITE FINISH - VITREOUS CHINA WITH EVERCLEAN ANTIMICROBIAL SURFACE



TOILET WITH TANK: W3 FLOOR MOUNTED WHITE FINISH - VITREOUS CHINA WITH EVERCLEAN ANTIMICROBIAL SURFACE

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TARANTA

CITY OF TORONTO ACCESSIBILITY UPGRADES CITY OF TORONTO ACCESSIBILITY UPGRADES

DRAWING TITLE:

WASHROOM FIXTURES & **DRINKING FOUNTAIN**

DRINKING FOUNTAIN



DRINKING FOUNTAIN: DF

EZSDWSLK GALVANIZED STEEL WALL MOUNTED, WHEELCHAIR TYPE WATER COOLER WITH STAINLESS STEEL TOP, FRONT AND SIDE MOUNTED PUSH TO OPERATE LEVER(S), SENSOR, TOUCHLESS ACTIVATION WITH AUTO SHUT OFF BOTTLE FILLER, FLEXI-GUARD SAFETY BUBBLER, AND TRAP PACKAGE.



URINAL: U1H WALL HUNG 6590.001.020 - WASHBROOK FLOWISE -EXTENDED SIDES FOR PRIVACY - WASHDOWN ACTION - FLUSHING RIM - 19 MM DIA.

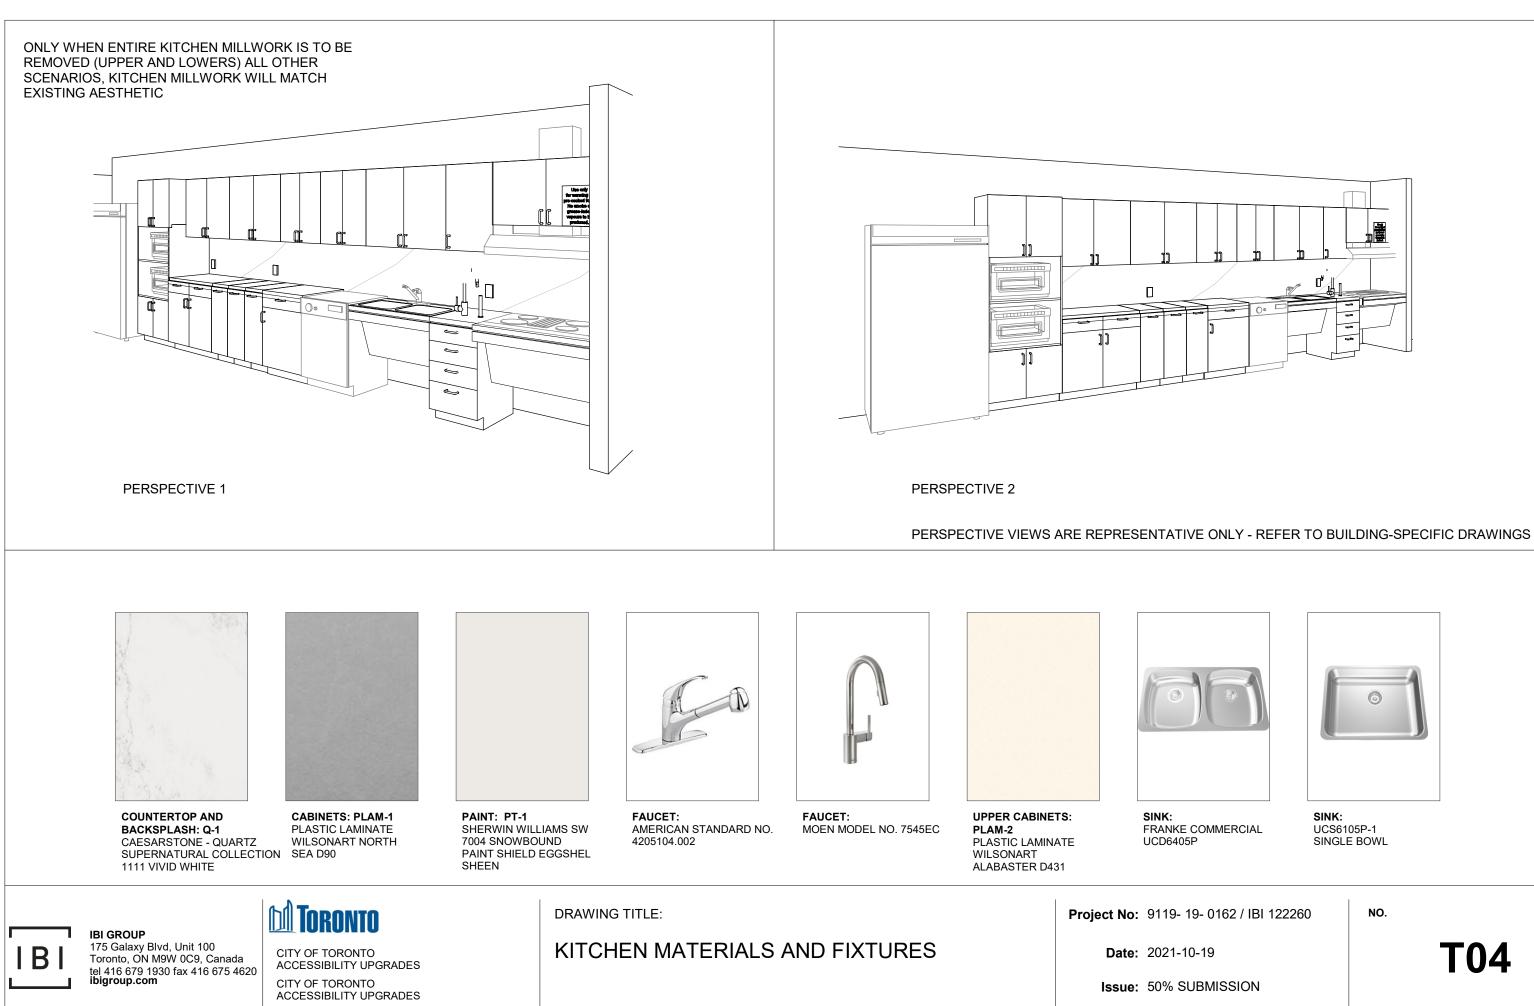
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Date: 2021-10-19

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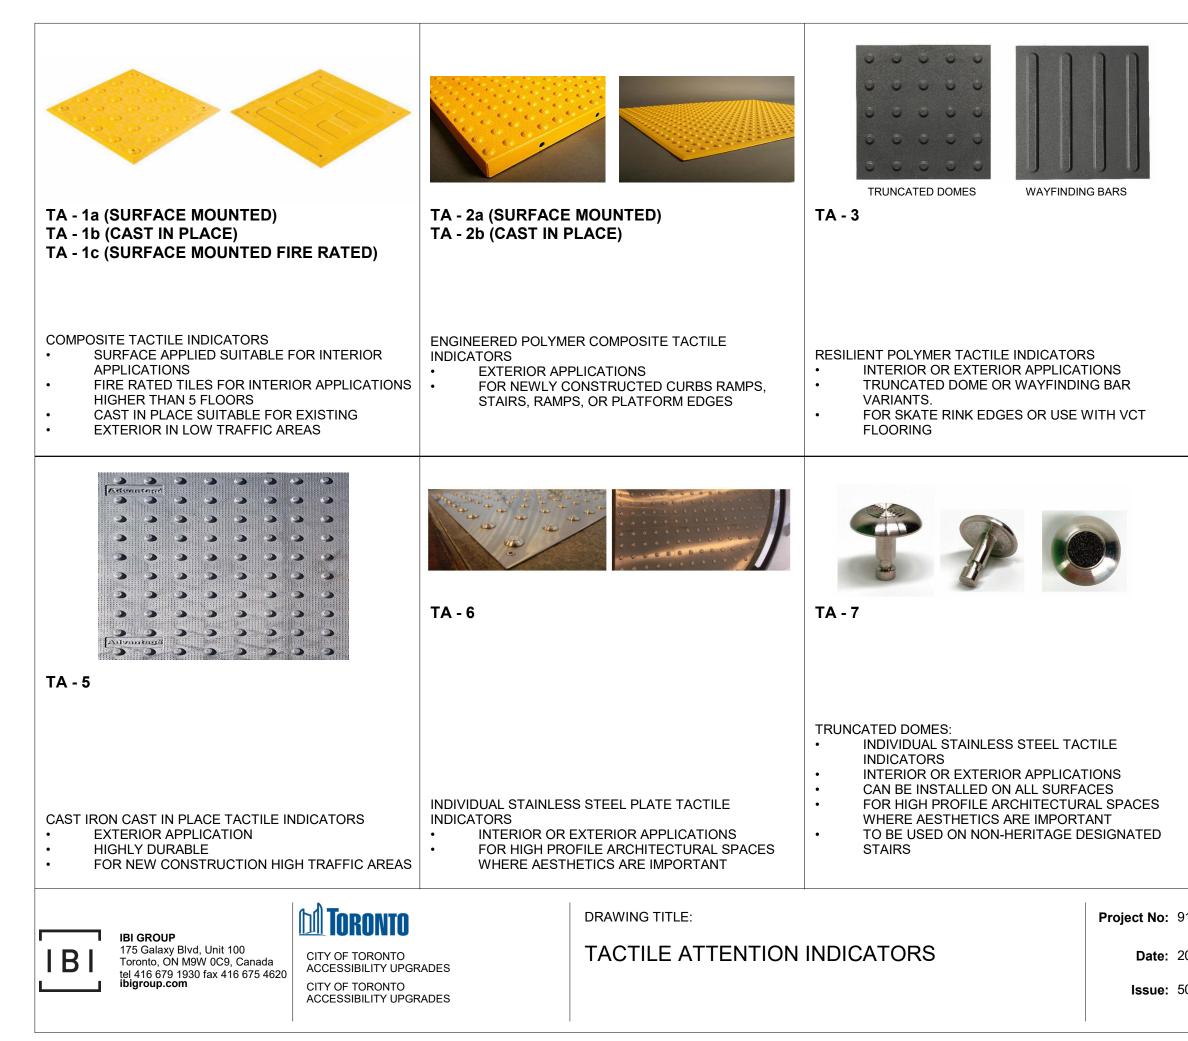
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IBI

NO.







WAYFINDING BARS

TA - 4

PORCELAIN TACTILE INDICATORS

- INTERIOR OR EXTERIOR APPLICATIONS
 TRUNCATED DOME OR WAYFINDING BAR
- VARIANTS.
- FOR USE WITH PORCELAIN TILE FLOORING



TA - 8

GUIDANCE BARS:

- INDIVIDUAL STAINLESS STEEL, BRASS, BRONZE OR ALUMINUM CARBORUNDUM NON-SLIP OR LINEAR GROOVE PATTERN.
- INTERIOR APPLICATIONS
- CAN BE INSTALLED ON ALL SURFACES
- FOR HIGH PROFILE ARCHITECTURAL SPACES
 WHERE AESTHETICS ARE IMPORTANT
 TO DE USED ON NON HERITAGE DESIGNATED
- TO BE USED ON NON-HERITAGE DESIGNATED
 STAIRS

Project No: 9119- 19- 0162 / IBI 122260

NO.

Date: 2021-10-19

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TA - 11 INTERIOR AND EXTERIOR	TA - 12 EXTERIOR CAST IN PLACE	TA - 16 INTERIOR AND EXTERIOR USE ON SMOOTH SURFACES
INTERIOR OR EXTERIOR USE ON SMOOTH SURFACES. • AFFIXED WITH ADHESIVE AND SCREWS • SIZES: 50.8MM X 203MM • REFER TO DRAWINGS FOR REQUIRED LENGTH AND WIDTH	 EXTERIOR USE IN NEW PROJECTS ON CONCRETE. TEXTURE WARNING STRIP SPECIFICALLY DESIGNED FOR INSTALLATION ON STEP EDGES WHEN CONCRETE IS POURED. INSTALLED IN WET-SET CONCRETE. SIZES: 50.8MM X 76.2MM WIDE REFER TO DRAWINGS FOR REQUIRED LENGTH AND WIDTH 	 INTERIOR AND EXTERIOR USE ON SMOOTH SURFACES ANODIZED ALUMINUM NOSE, INSTALLED WITH EITHER NON-SLIP STRIP OR WITH PHOTOLUMINESCENT CONTRAST STRIP. AVAILABLE IN 5 DIFFERENT PROFILES TO MATCH THE DESIGN OF THE STEP EDGE AFFLICTED WITH ADHESIVE OR ADHESIVE AND SCREWS SIZES: 70.1MM - 78.7MM WIDE REFER TO DRAWINGS FOR REQUIRED LENGTH AND WIDTH
	TA - 19 EXTERIOR USE ON POURED	
TA - 18 INTERIOR USE ON CARPETED FLOORING	CONCRETE EXTERIOR USE ON POURED CONCRETE:	
 INTERIOR USE ON CARPETED FLOORING. ANODIZED ALUMINUM NOSE, SPECIFICALLY DESIGNED FOR CARPETED STAIRS, INSTALLED WITH EITHER NON-SLIP STRIP OR WITH PHOTOLUMINESCENCE CONTRAST STRIP INSTALLED WITH SCREWS SIZES: 66MM - 89MM REFER TO DRAWINGS FOR REQUIRED LENGTH AND WIDTH 	 HEAT TREATED EXTRUDED ALUMINUM ALLOY 6063-T-6, FILLED WITH A MIXTURE OF VIRGIN ALUMINUM OXIDE AND SILICON CARBIDE ABRASIVE GRANULES IN AN EPOXY BINDER. FULL LENGTH, INTEGRALLY EXTRUDED 5/8" ANCHOR. SIZES: 79.4MM X 25.4MM REFER TO DRAWINGS FOR REQUIRED LENGTH AND WIDTH TO BE USED ON NON-HERITAGE DESIGNATED STAIRS 	
IBI GROUP 175 Galaxy Blvd, Unit 100 Toronto, ON M9W 0C9, Canada tol 416 670 4020 faw 416 675 4620 CITY OF TORONTO ACCESSIBILITY UPG	DRAWING TITLE: TEXTURAL & COLOU WARNING STRIP AND	Data

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ACCESSIBILITY UPGRADES CITY OF TORONTO ACCESSIBILITY UPGRADES

WARNING STRIP AND NOSING

Issue: 50% SUBMISSION





INTERIOR USE ON TILED STAIRS.

- ALUMINUM NOSE SPECIFICALLY DESIGNED FOR •
- INSTALLATION ON TILED STAIRS.
- 3.2MM TILED STAIRS OR 2.54MM TILED STAIRS. • REFER TO DRAWINGS FOR REQUIRED LENGTH •
- AND WIDTH

9119-19-0162 / IBI 122260

NO.

T07

Date: 2021-10-19

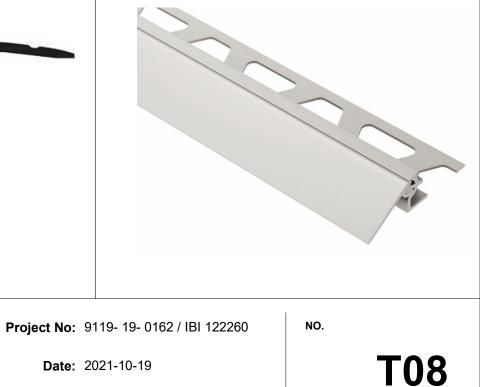


ANODIZED ALUMINUM THRESHOLD FOR TRANSITION BETWWEEN NEW AND EXISTING FLOOR



TH-5a

SATIN ANODIZED ALUMINUM THRESHOLD FOR NEW FLOORING ON BOTH SIDE VARIES HEIGHTS (TILE TO ANY FLOOR SURFACE)



Issue: 50% SUBMISSION

CITY OF TORONTO ACCESSIBILITY UPGRADES TYPICAL DETAILS BOOKLET

9119-19-0162 / IBI 122260

ARCHITECTURAL TYPICAL DETAILS INDEX

SHEET #	SHEET TITLE
D1000	COVER PAGE & TYPICAL DETAIL LIST
D1001	ACCESSIBILITY DESIGN STANDARDS AND DOOR CLEARANCES
D1002	DOOR ENLARGEMENT
D1201	ACCESSIBLE WASHROOM, SHOWER & ACCESSORIES DETAILS
D1202	UNIVERSAL WASHROOM & SHOWER PLANS
D1203	UNIVERSAL WASHROOM ELEVATIONS
D1204	MULTI-STALL WASHROOM PLANS
D1205	UW - EMERGENCY CALL SYSTEM
D1301	KITCHEN MILLWORK PLANS & ELEVATIONS
D1302	KITCHEN MILLWORK DETAIL SECTIONS
D1303	KITCHEN HOOD VENT DETAIL
D1305	RECEPTION DESK MILLWORK PLANS & ELEVATIONS
D1401	STAIR DETAILS - 01
D1402	STAIR DETAILS - 02
D1403	RAMP DETAILS - 01
D1404	RAMP DETAILS - 02
D1405	TACTILE DETAILS
D1501	MISCELLANEOUS DETAILS - 01
D1502	MISCELLANEOUS DETAILS - 02
D1601	ELEVATOR DETAILS
D1602	ELEVATOR CONTROL & INTERIOR CABIN DETAILS
D1701	ACCESSIBLE PARKING AND SITE MARKING DETAILS
D1702	CURB DETAILS
D1801	PHASING / HOARDING DETAILS

STRUCTURAL TYPICAL DETAILS INDEX		MECHANICAL TYPICAL DETAILS INDEX			ELECTR
SHEET #	SHEET TITLE	SHEET #	SHEET TITLE	SHEET #	
D2100	CONCRETE - TYPICAL DETAIL	D3201	PLUMBING DETAILS	D4001	ELECTRICAL DET
D2200	STRUCTURAL STEEL DETAILS - 1	D3301	DRAINAGE DETAILS		
D2201	STRUCTURAL STEEL DETAILS - 2	D3401	FIRE PROTECTION DETAILS		
D2300	MASONRY DETAILS	D3501	HVAC DETAILS		
		D3601	PIPING DETAILS SHEET 1 OF 2		
		D3602	PIPING DETAILS SHEET 2 OF 2		

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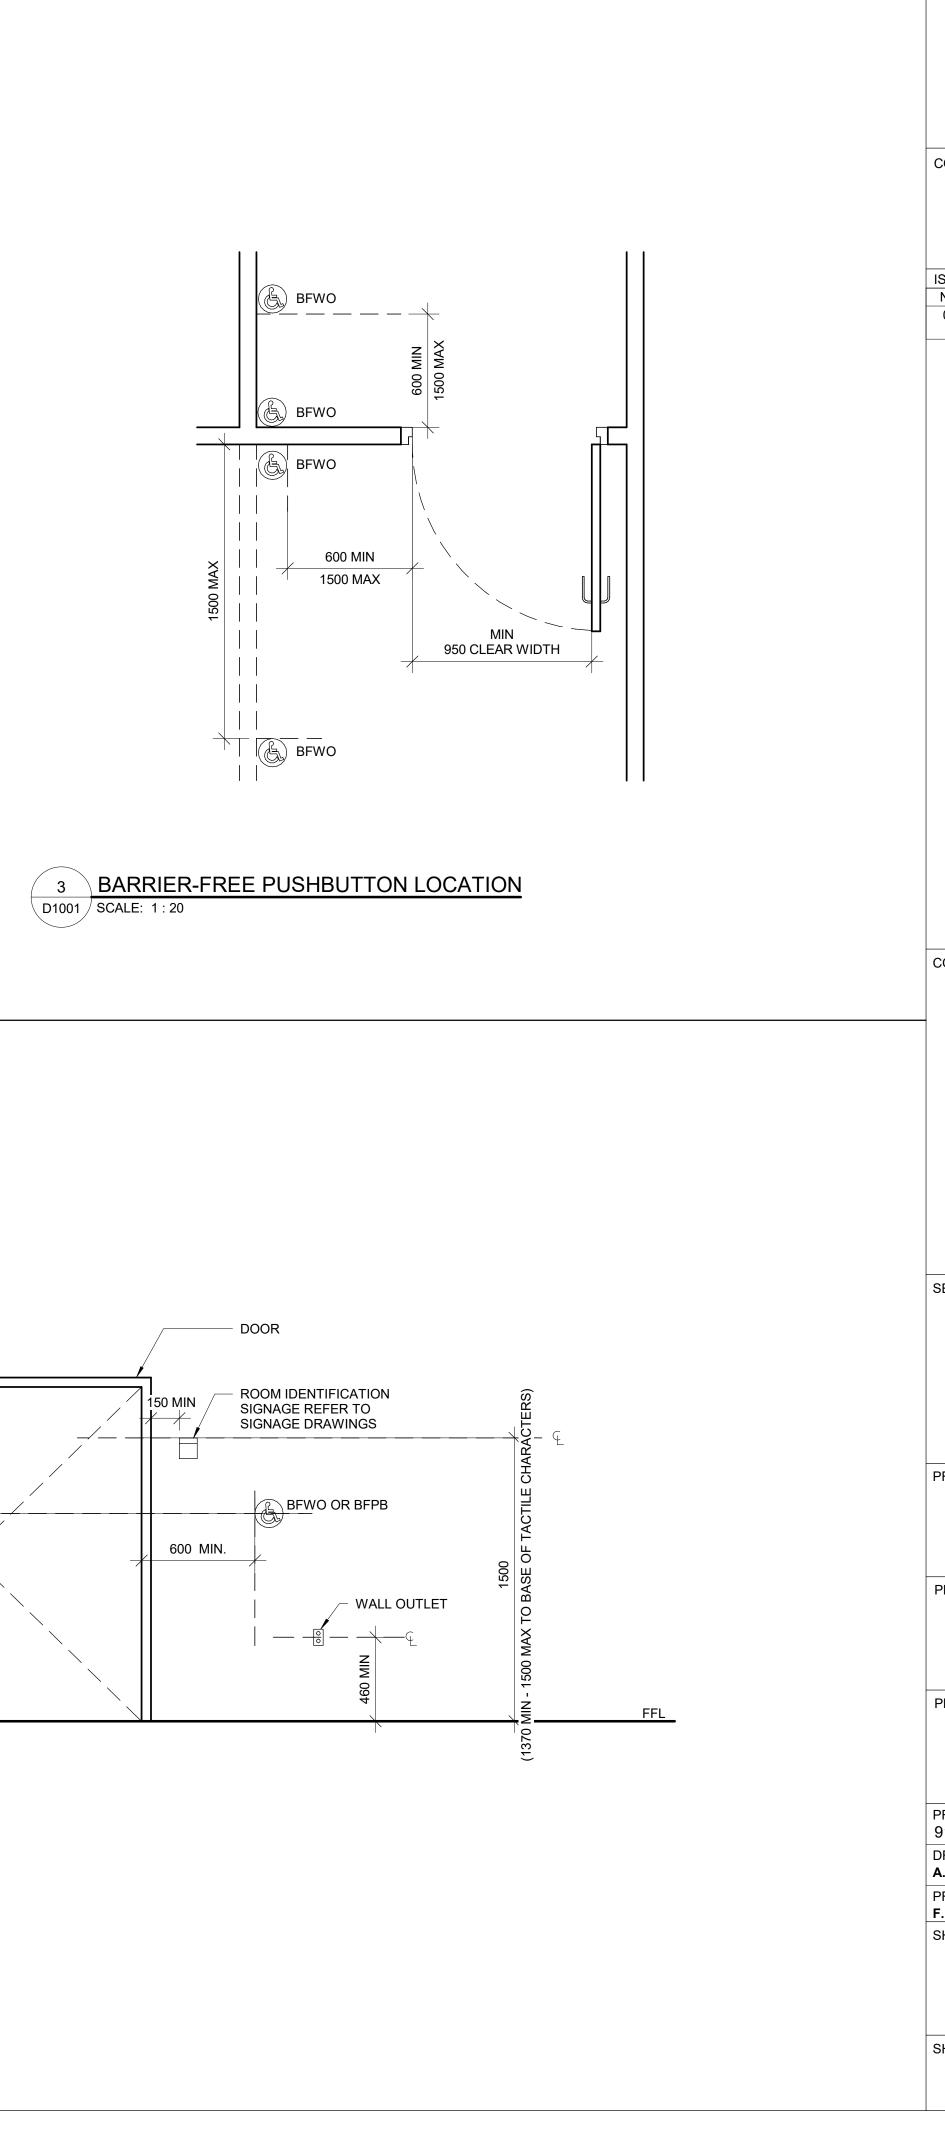
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2021-10-19 SHEET NUMBER	ISSUE
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TRICAL TYPICAL DETAILS INDEX

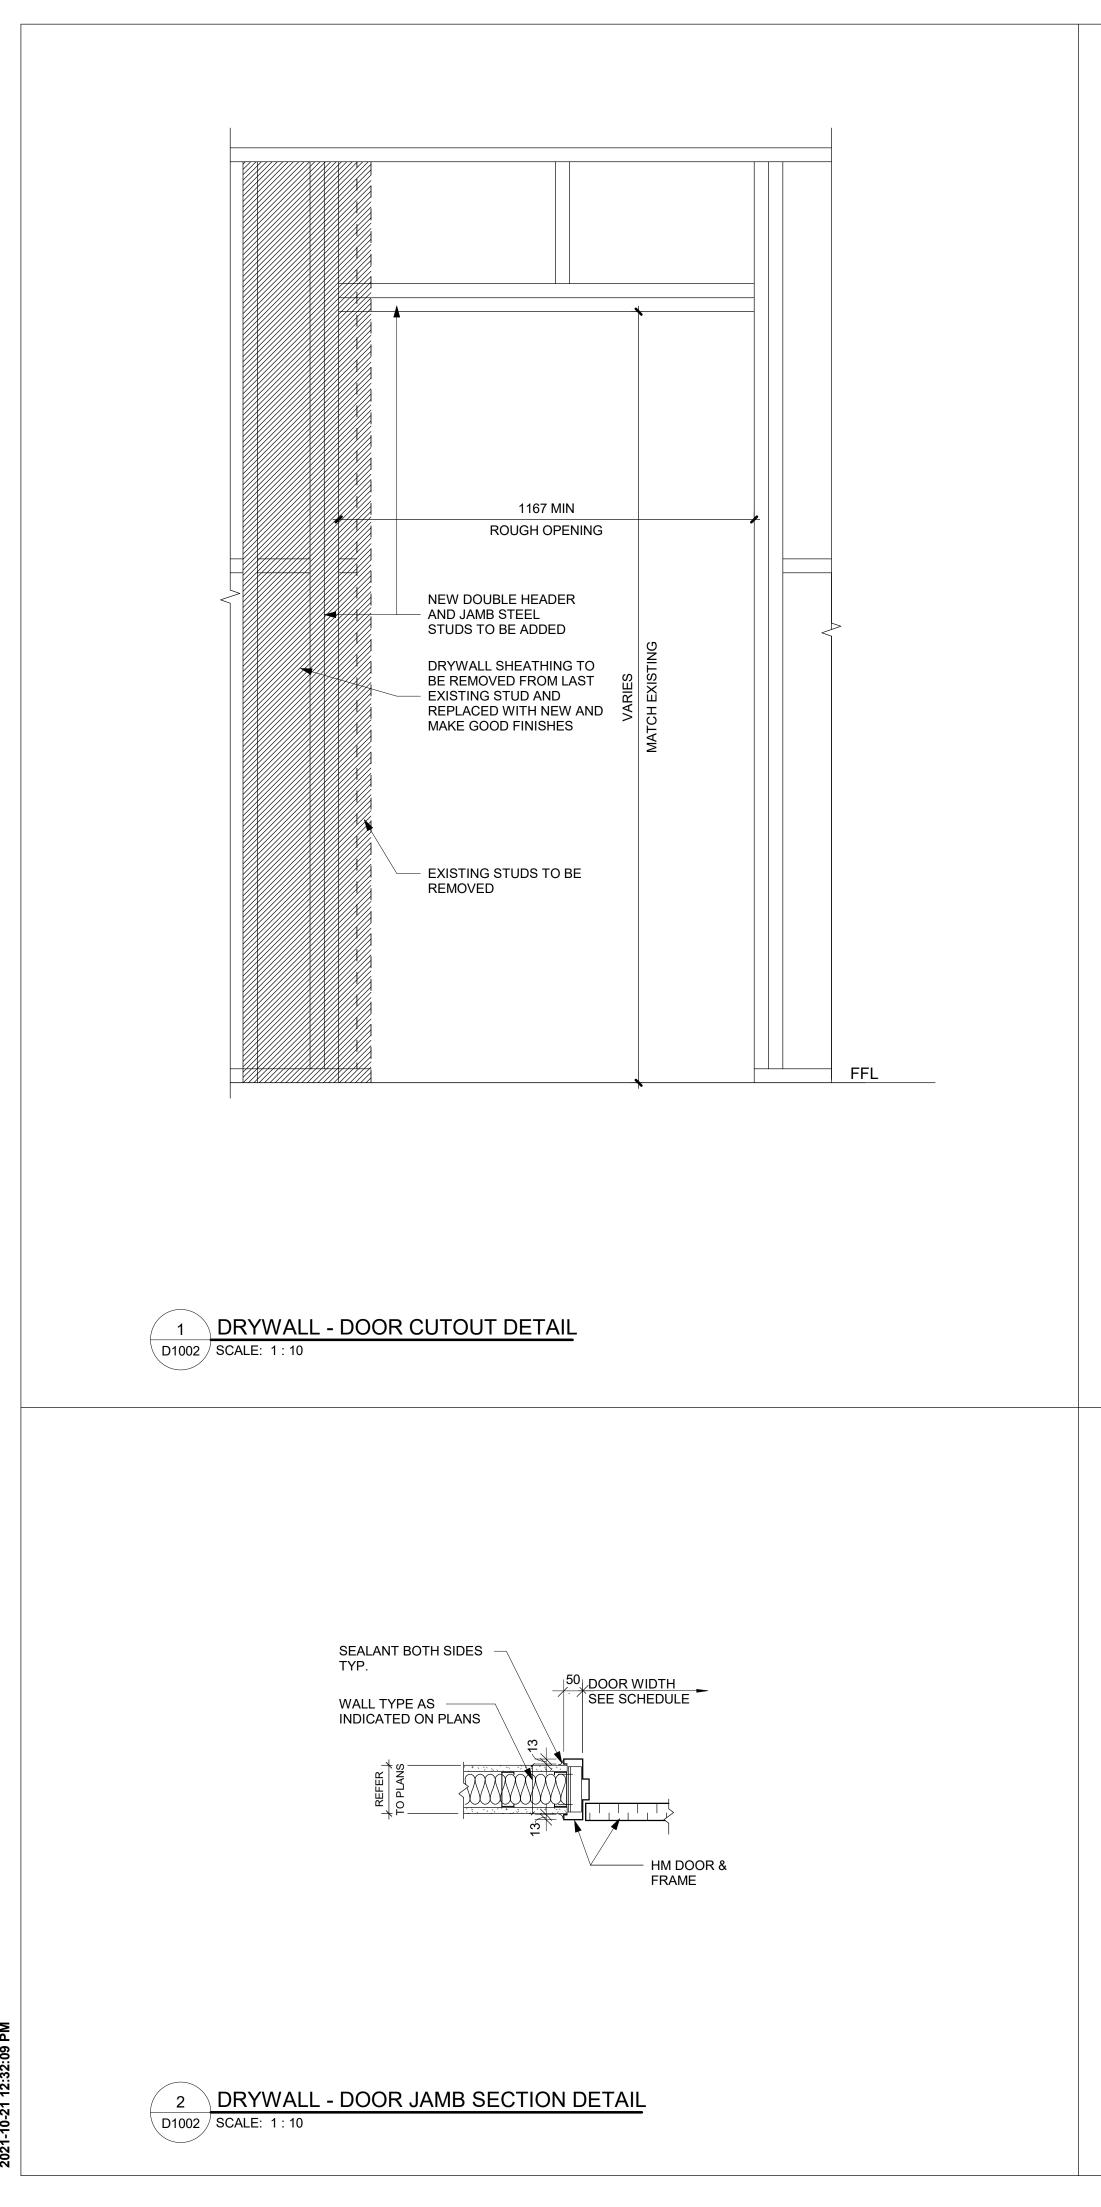
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ETAILS 1

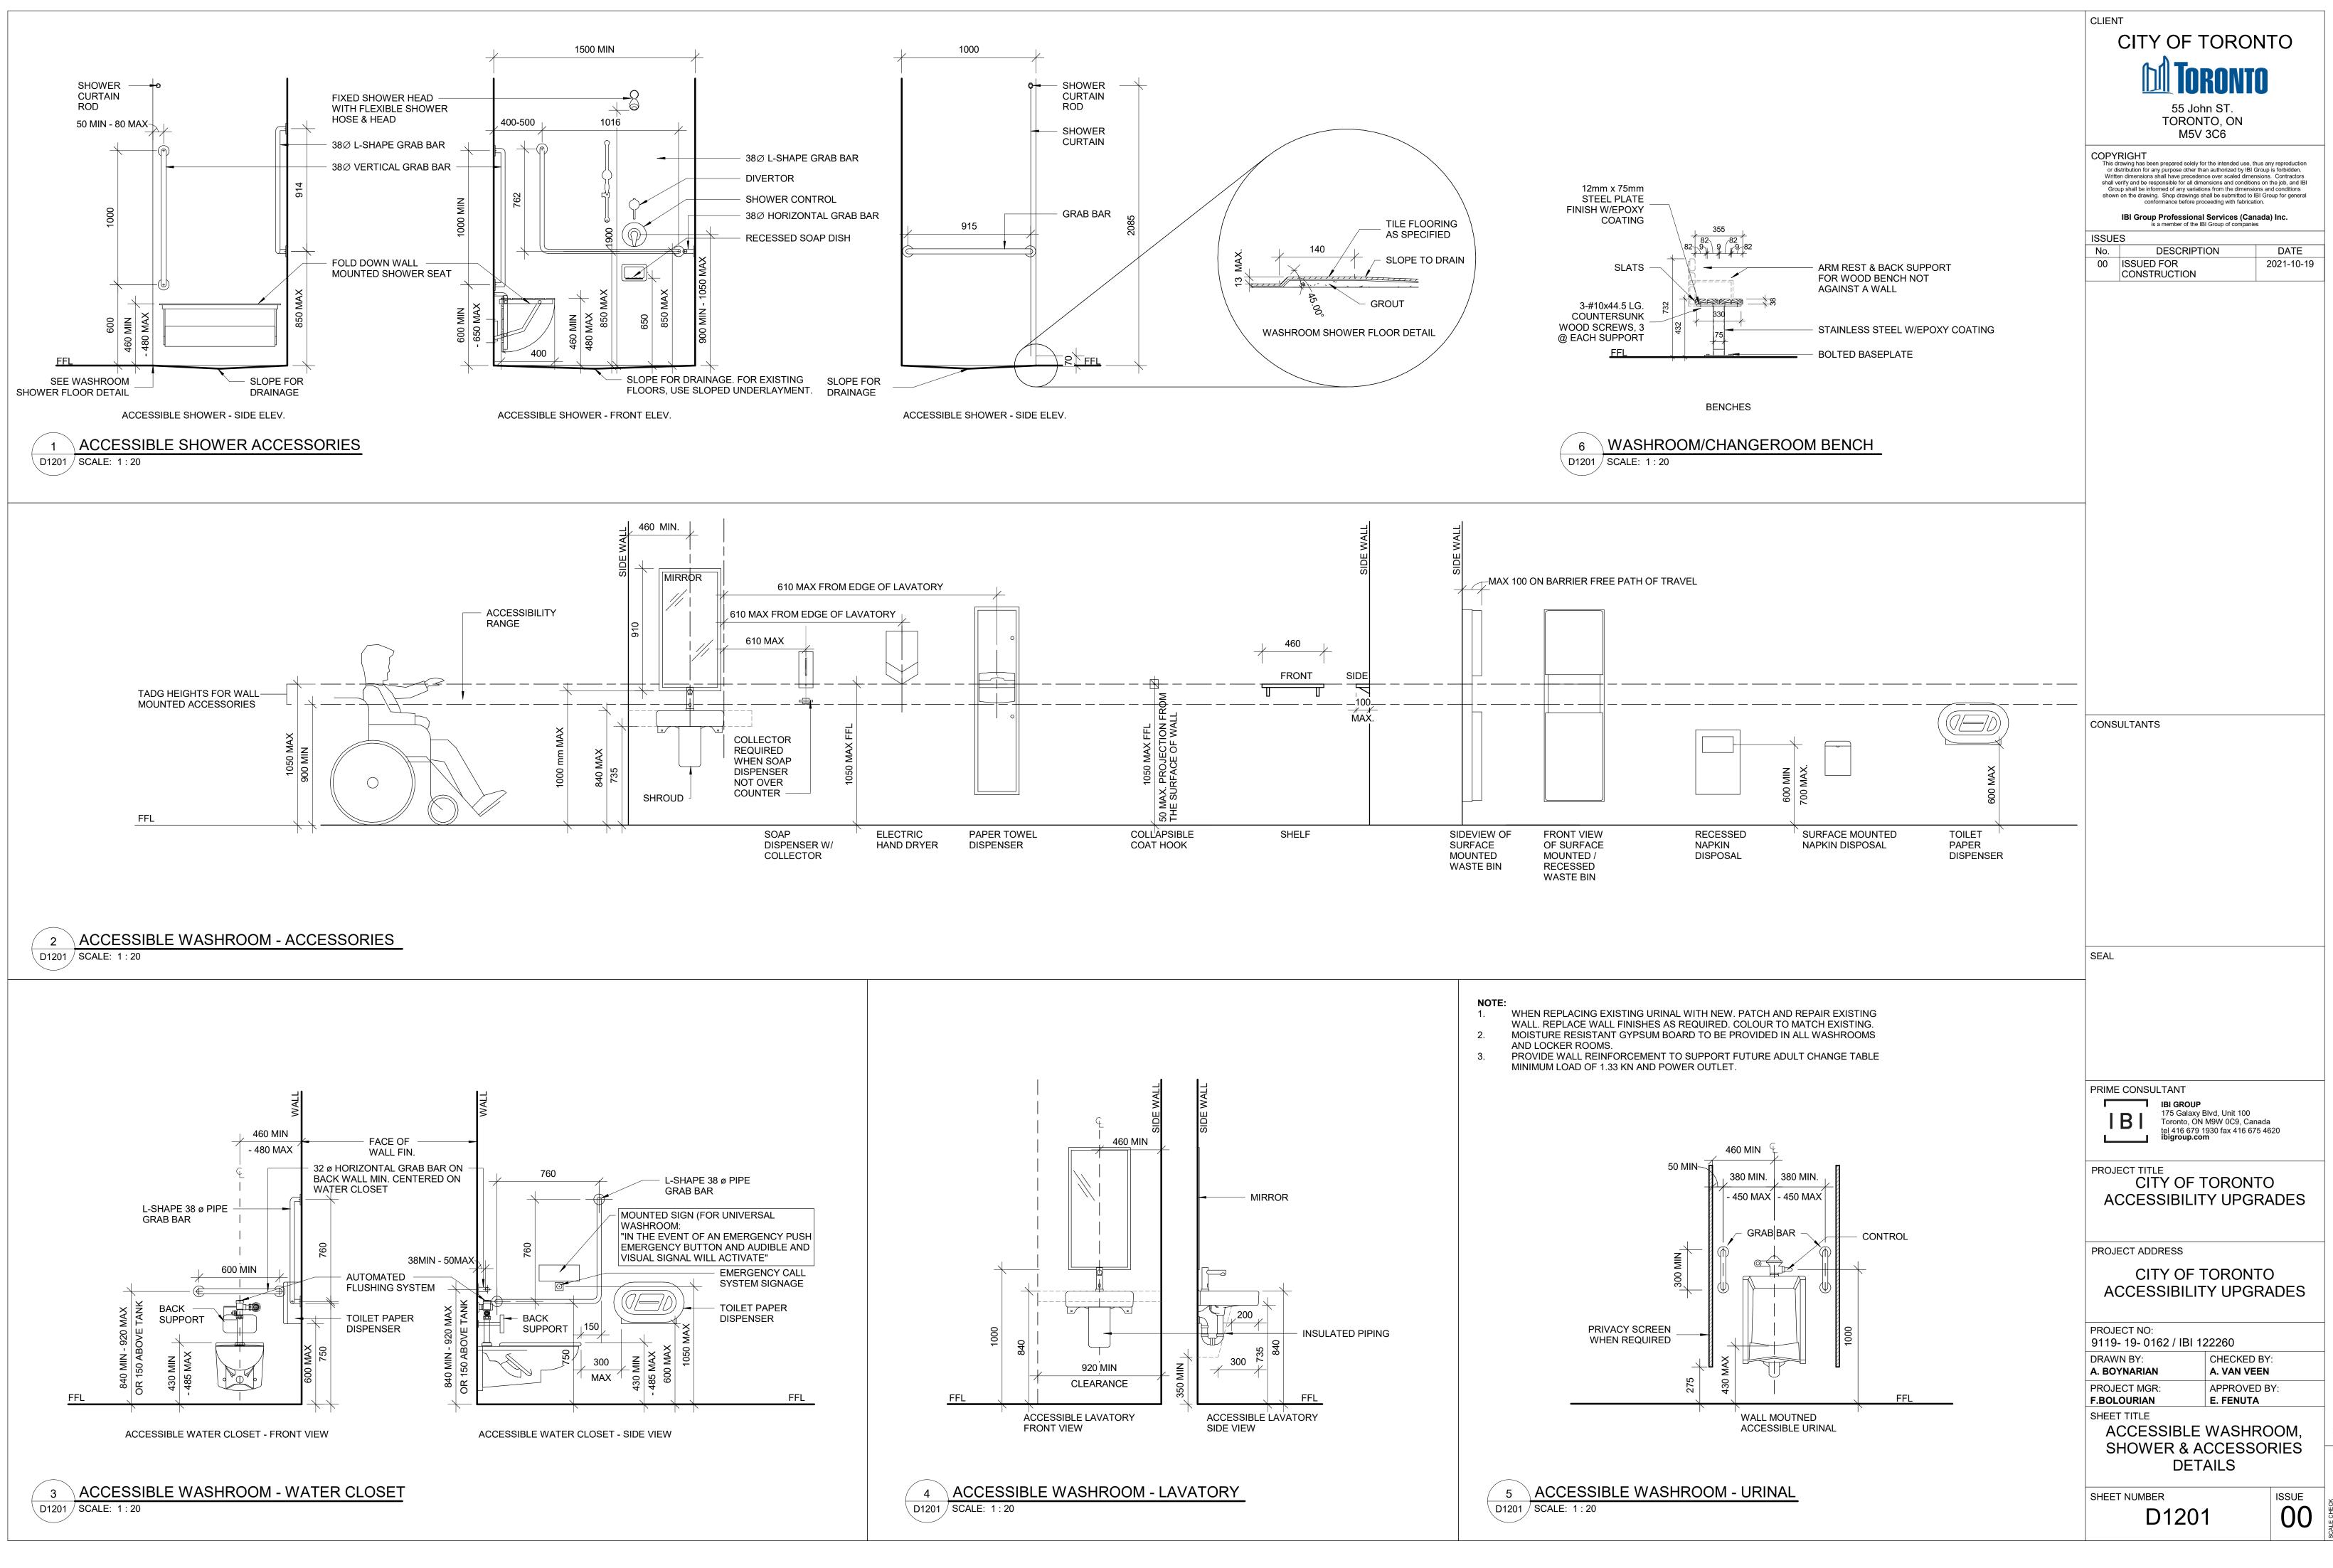




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ACCESSIBILITY UPGRA	
PROJECT ADDRESS	
CITY OF TORONTO	
PROJECT NO: 9119- 19- 0162 / IBI 122260	
DRAWN BY: CHECKED BY A. BOYNARIAN A. VAN VEEN	:
PROJECT MGR: APPROVED B	Y:
F.BOLOURIAN E. FENUTA SHEET TITLE	
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	A: DO INAMIAN A: VAR VEEN PROJECT MGR: APPROVED BY: F.BOLOURIAN E. FENUTA SHEET TITLE DRYWALL CUT OUT	
NOTE: FOR MASONRY WALL CUT OUT, REFER TO STRUCTURAL DETAIL	SHEET NUMBER ISSUE 00	



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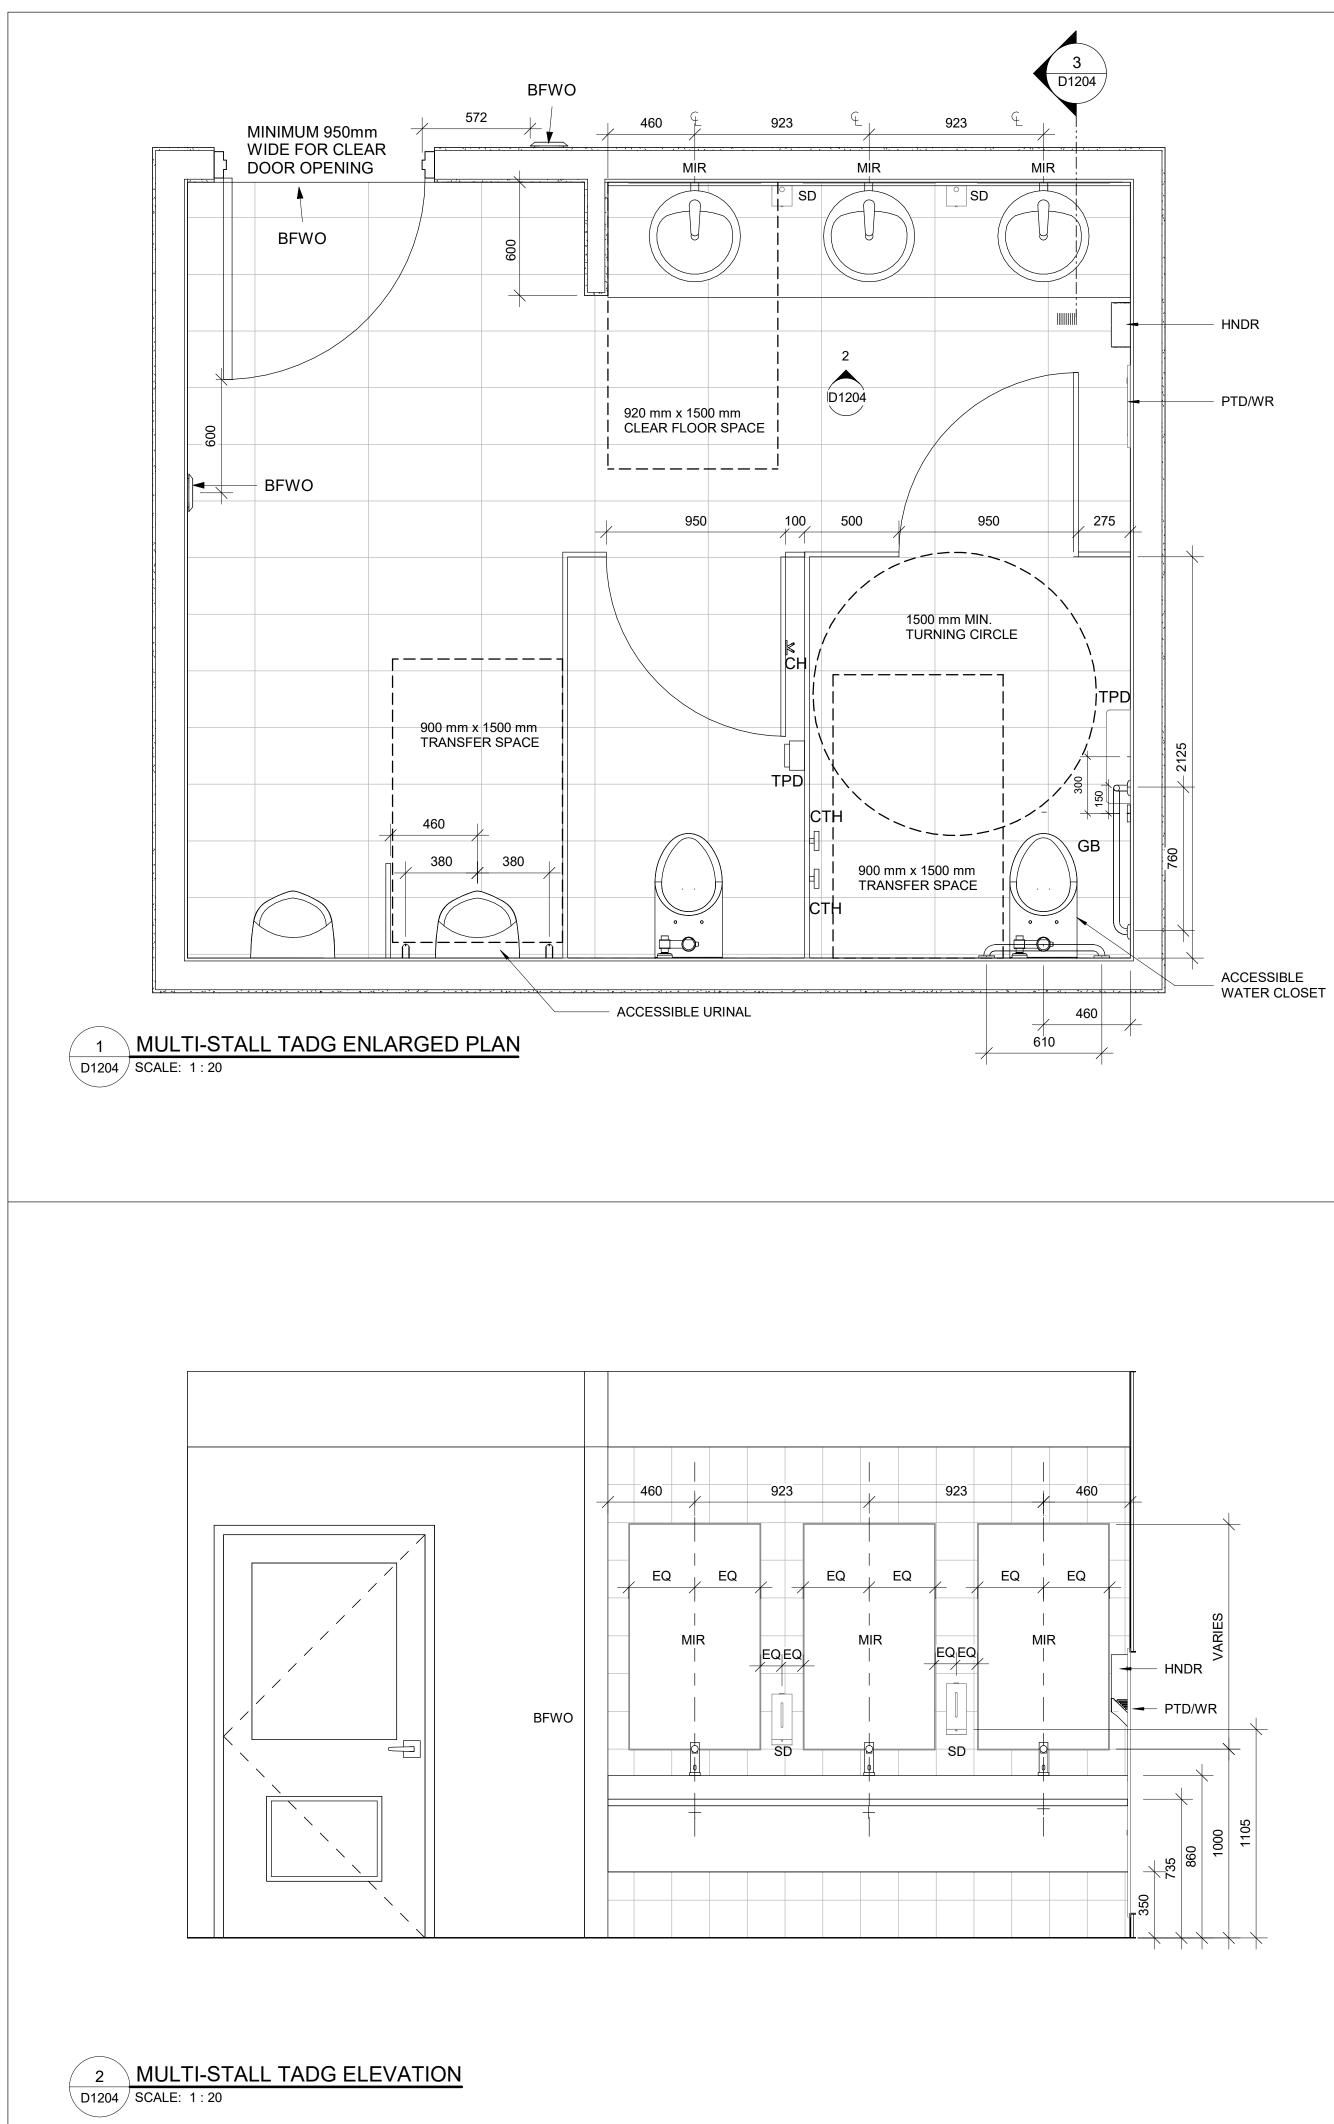
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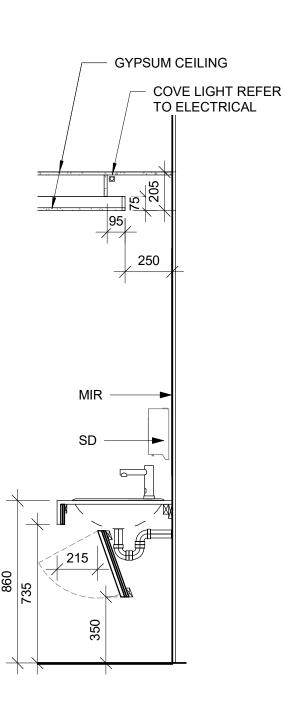
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WASHROOM ACCESSORIES		
ABR	DESCRIPTION	
ANUN	ASSISTANCE REQUIRED INDICATOR/ALARM	
AR-LED	DOOR LOCK INDICATOR	
BFACT	BARRIER FREE ADULT CHANGE TABLE	
BFPB	BARRIER FREE PUSH BUTTON	
BR	BACKREST	
CTH	COAT HOOK	
ECB	EMERGENCY CALL BUTTON	
ECS	EMERGENCY CALL SIGNAGE	
FFL	FINISH FLOOR LEVEL	
GRB	GRAB BAR	
GBFD	GRAB BAR FOLD DOWN	
HNDR	HAND DRYER	
MIR	MIRROR	
OCI	OCCUPIED INDICATOR	
PTD	PAPER TOWEL DISPENSER	
PTD/WR	PAPER TOWEL DISPENSER & WASTE RECEPTACLE	
PTLB	PUSH TO LOCK BUTTON	
PTOB	PUSH TO OPEN BUTTON	
SD	SOAP DISPENSER	
SHLF	SHELF	
SHWC	SHOWER CURTAIN AND ROD	
SHWS	SHOWER SEAT	
SPD	SOAP DISPENSER WITH COLLECTOR	
TPD	TOILET PAPER DISPENSER	



3 MULTI-STALL TADG SECTION D1204 SCALE: 1:20

 UNIVERSAL WASHROOM GENERAL NOTES: 1. ALL DIMENSIONS ARE TAKEN FROM FINISH FLOOR SURFACE. 2. MOISTURE RESISTANT GYPSUM BOARD TO BE PROVIDED IN ALL WASHROOMS AND LOCKER ROOMS. 3. PROVIDE WALL REINFORCEMENT TO SUPPORT FUTURE ADULT CHANGE TABLE MINIMUM LOAD OF 1.33 KN AND POWER OUTLET 	CLIENT CITY OF TORONTO CITY OF TORONTO CONCLASSING CONCLASSING S5 John ST, DORONTO, ON M5V 3C6 COPYRIGHT Marking has been prepared solely for the intended use, thus any reproduction of stribution for any purpose other than authorized by BI Group report Stribution for any purpose other than authorized by BI Group is forbidder. Stribution for any purpose other than authorized by BI Group is forbidder. Shigh cardinal have precedence over scaled dimensions. Contractors solar verify and be responsible for all dimensions and conditions on the job, and BI Group shall be informed of any variations from the dimensions and conditions show no the drawing. Shop drawings shall be submitted to BI Group for general conformance before proceeding with fabrication.
 SEE STANDARD MOUNTING HEIGHT DETAILS 2/D1201, 3/D1201, 4/D1201 & 5/D1202 WASHROOM ARRANGMENTS FOR ILLUSTRATION PURPOSES - REFER TO EACH BUILDING ENLARGED 	ISSUES No. DESCRIPTION DATE 00 ISSUED FOR 2021-10-19 CONSTRUCTION CONSTRUCTION
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	PRIME CONSULTANT BI GROUP 175 Galaxy Blvd, Unit 100 Toronto, ON M9W 0C9, Canada tel 416 679 1930 fax 416 675 4620 ibigroup.com PROJECT TITLE
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	ACCESSIBILITY UPGRADES
	9119- 19- 0162 / IBI 122260 DRAWN BY: CHECKED BY: A. BOYNARIAN A. VAN VEEN PROJECT MGR: APPROVED BY:
	F.BOLOURIANE. FENUTASHEET TITLEMULTI-STALL WASHROOMPLANS
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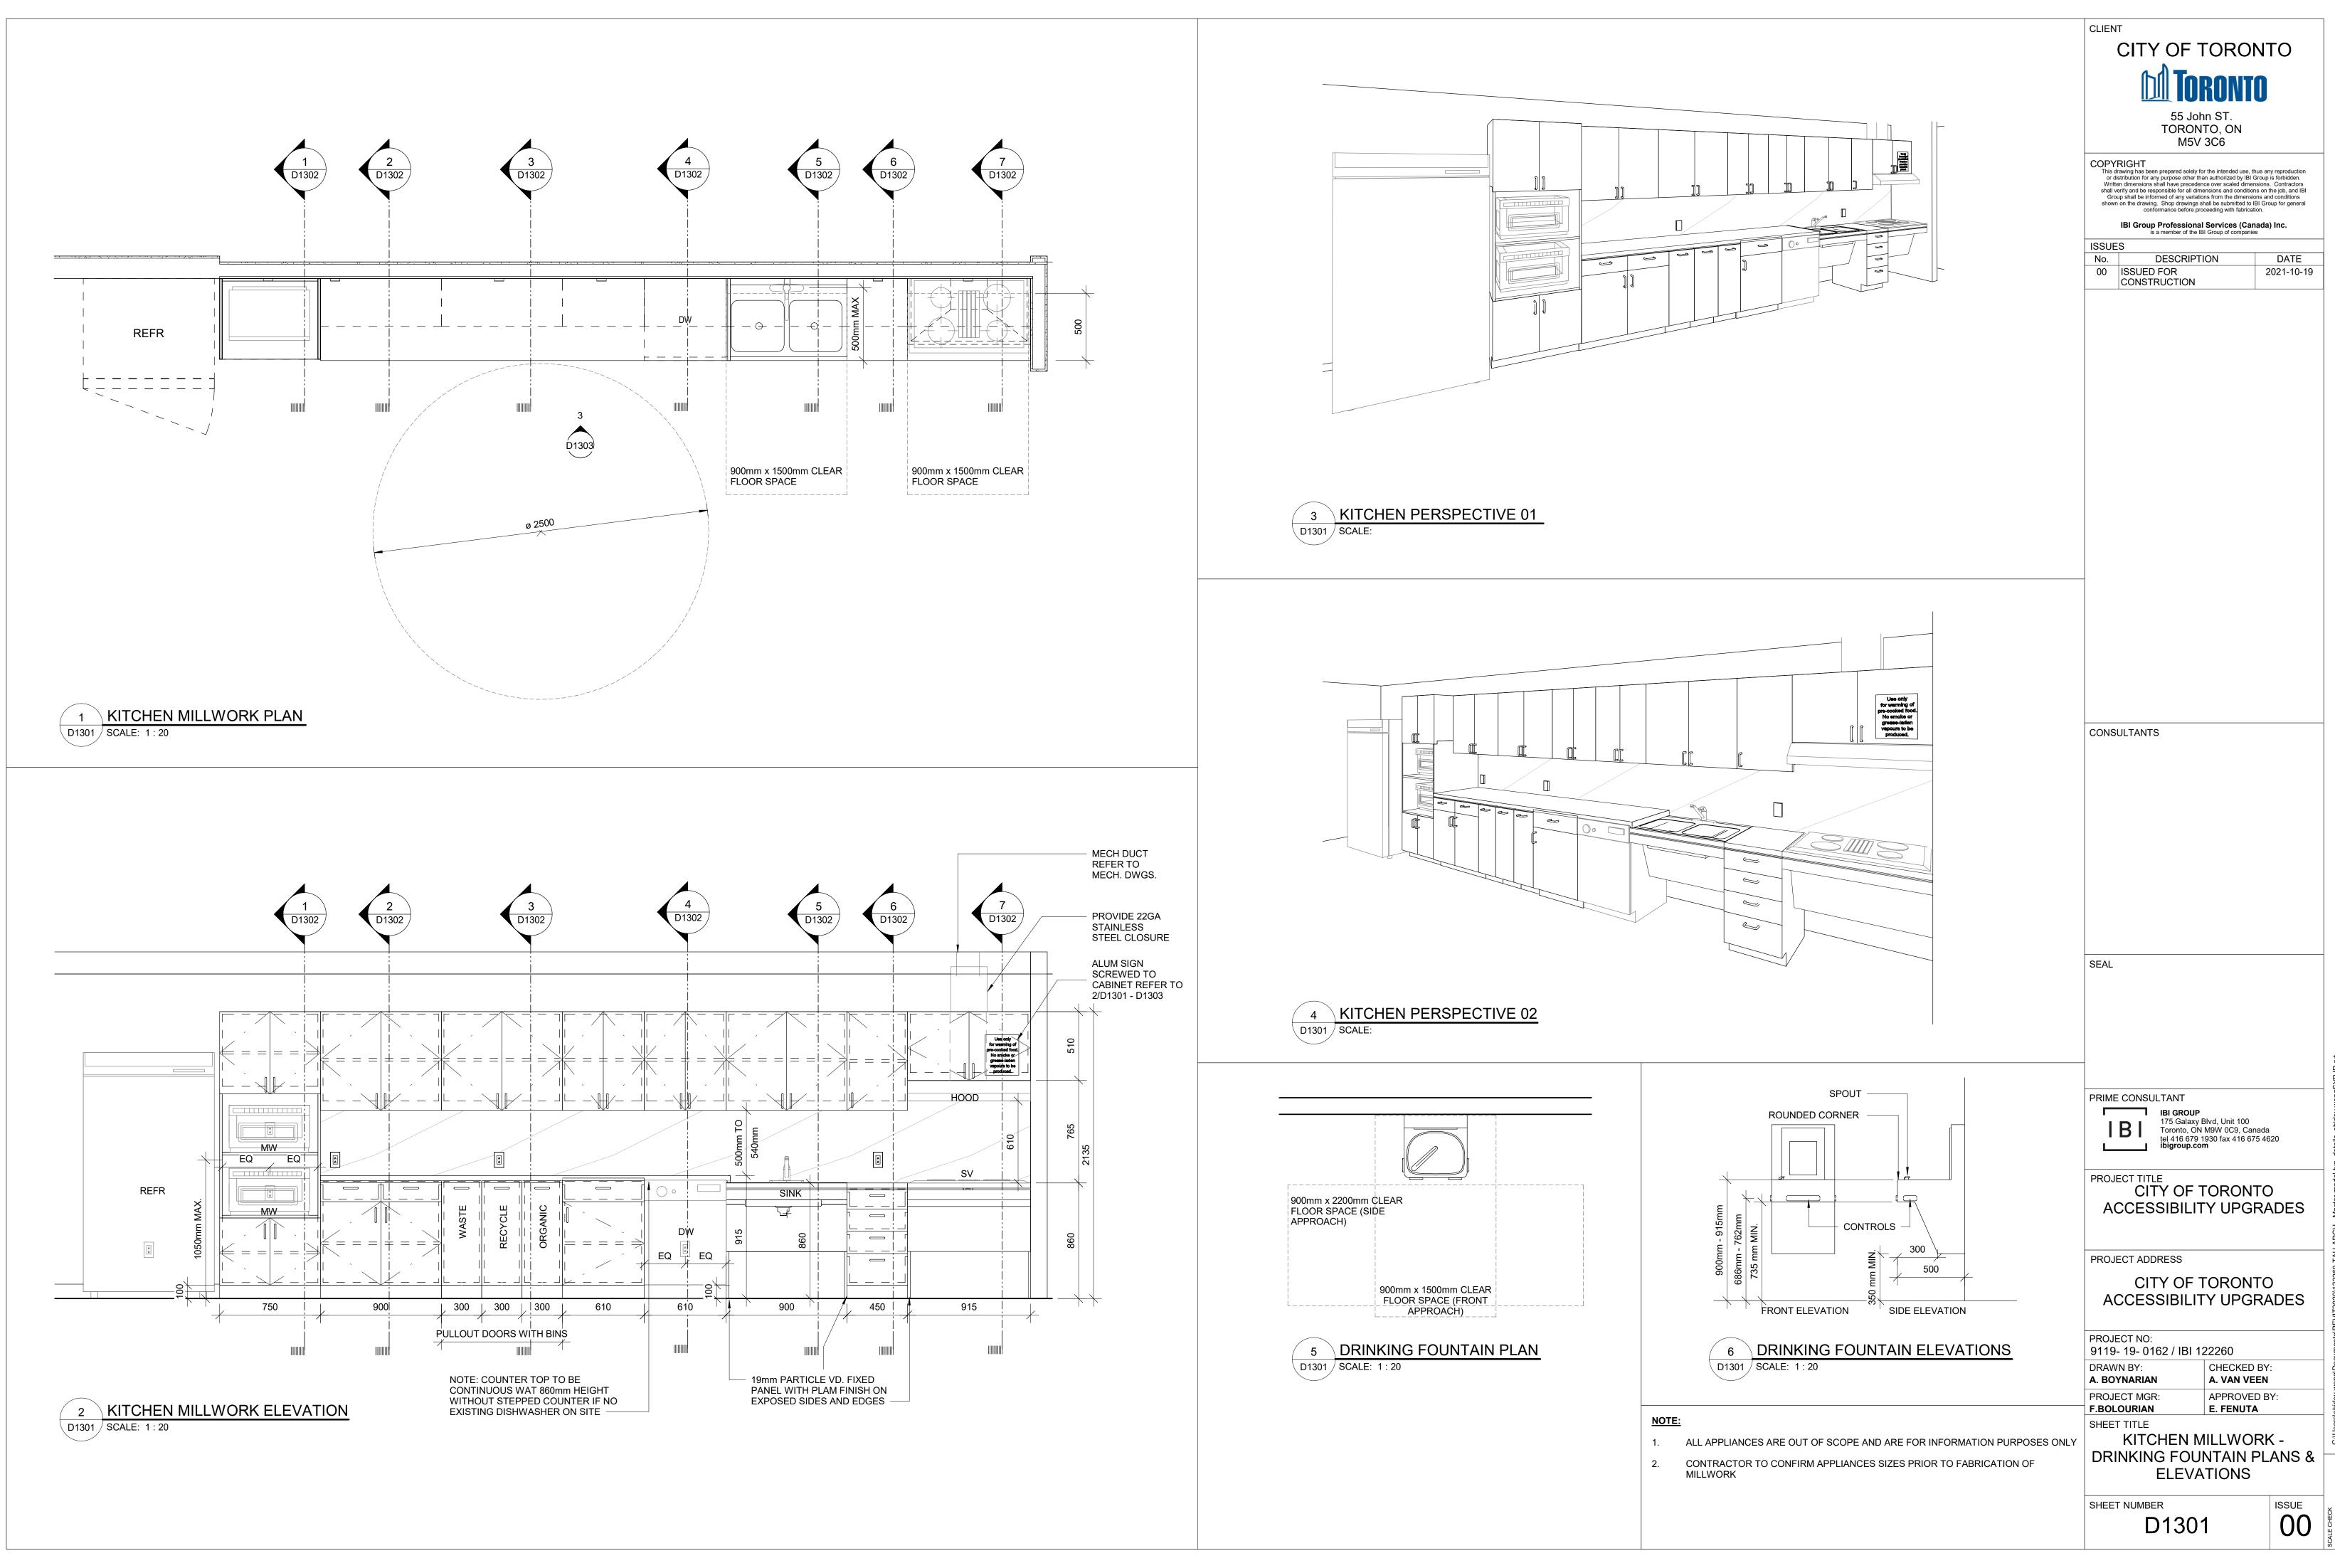
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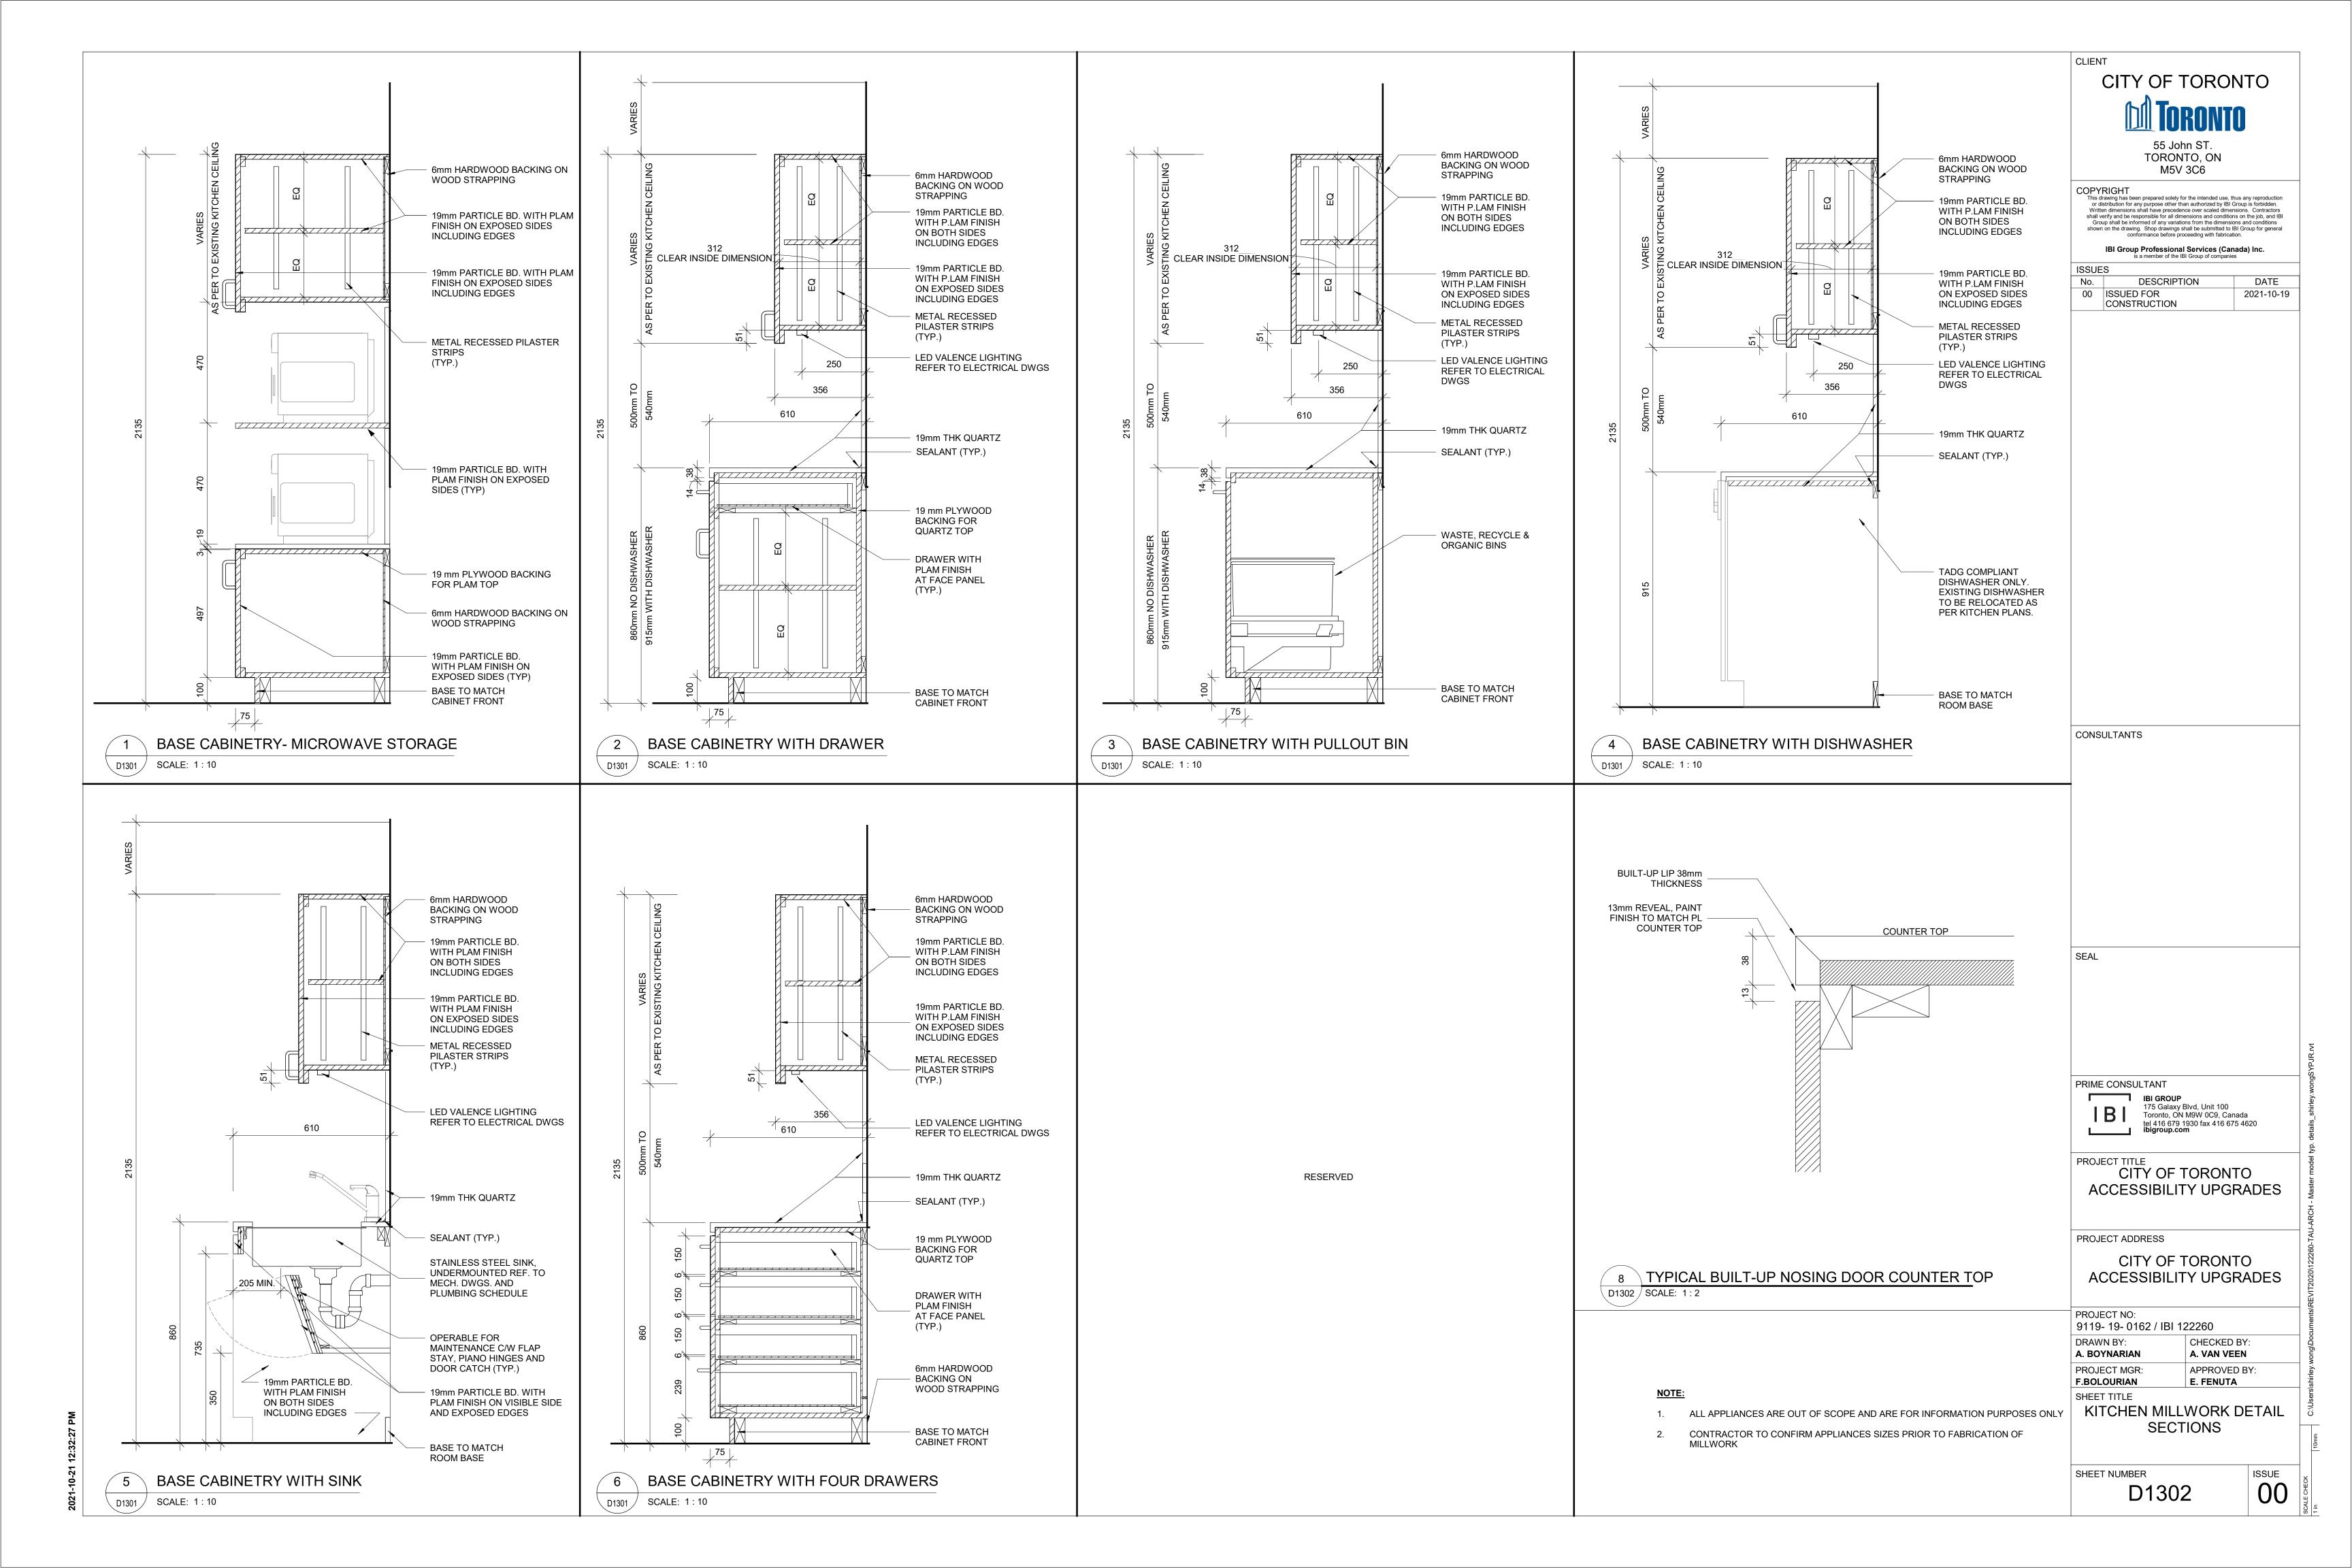
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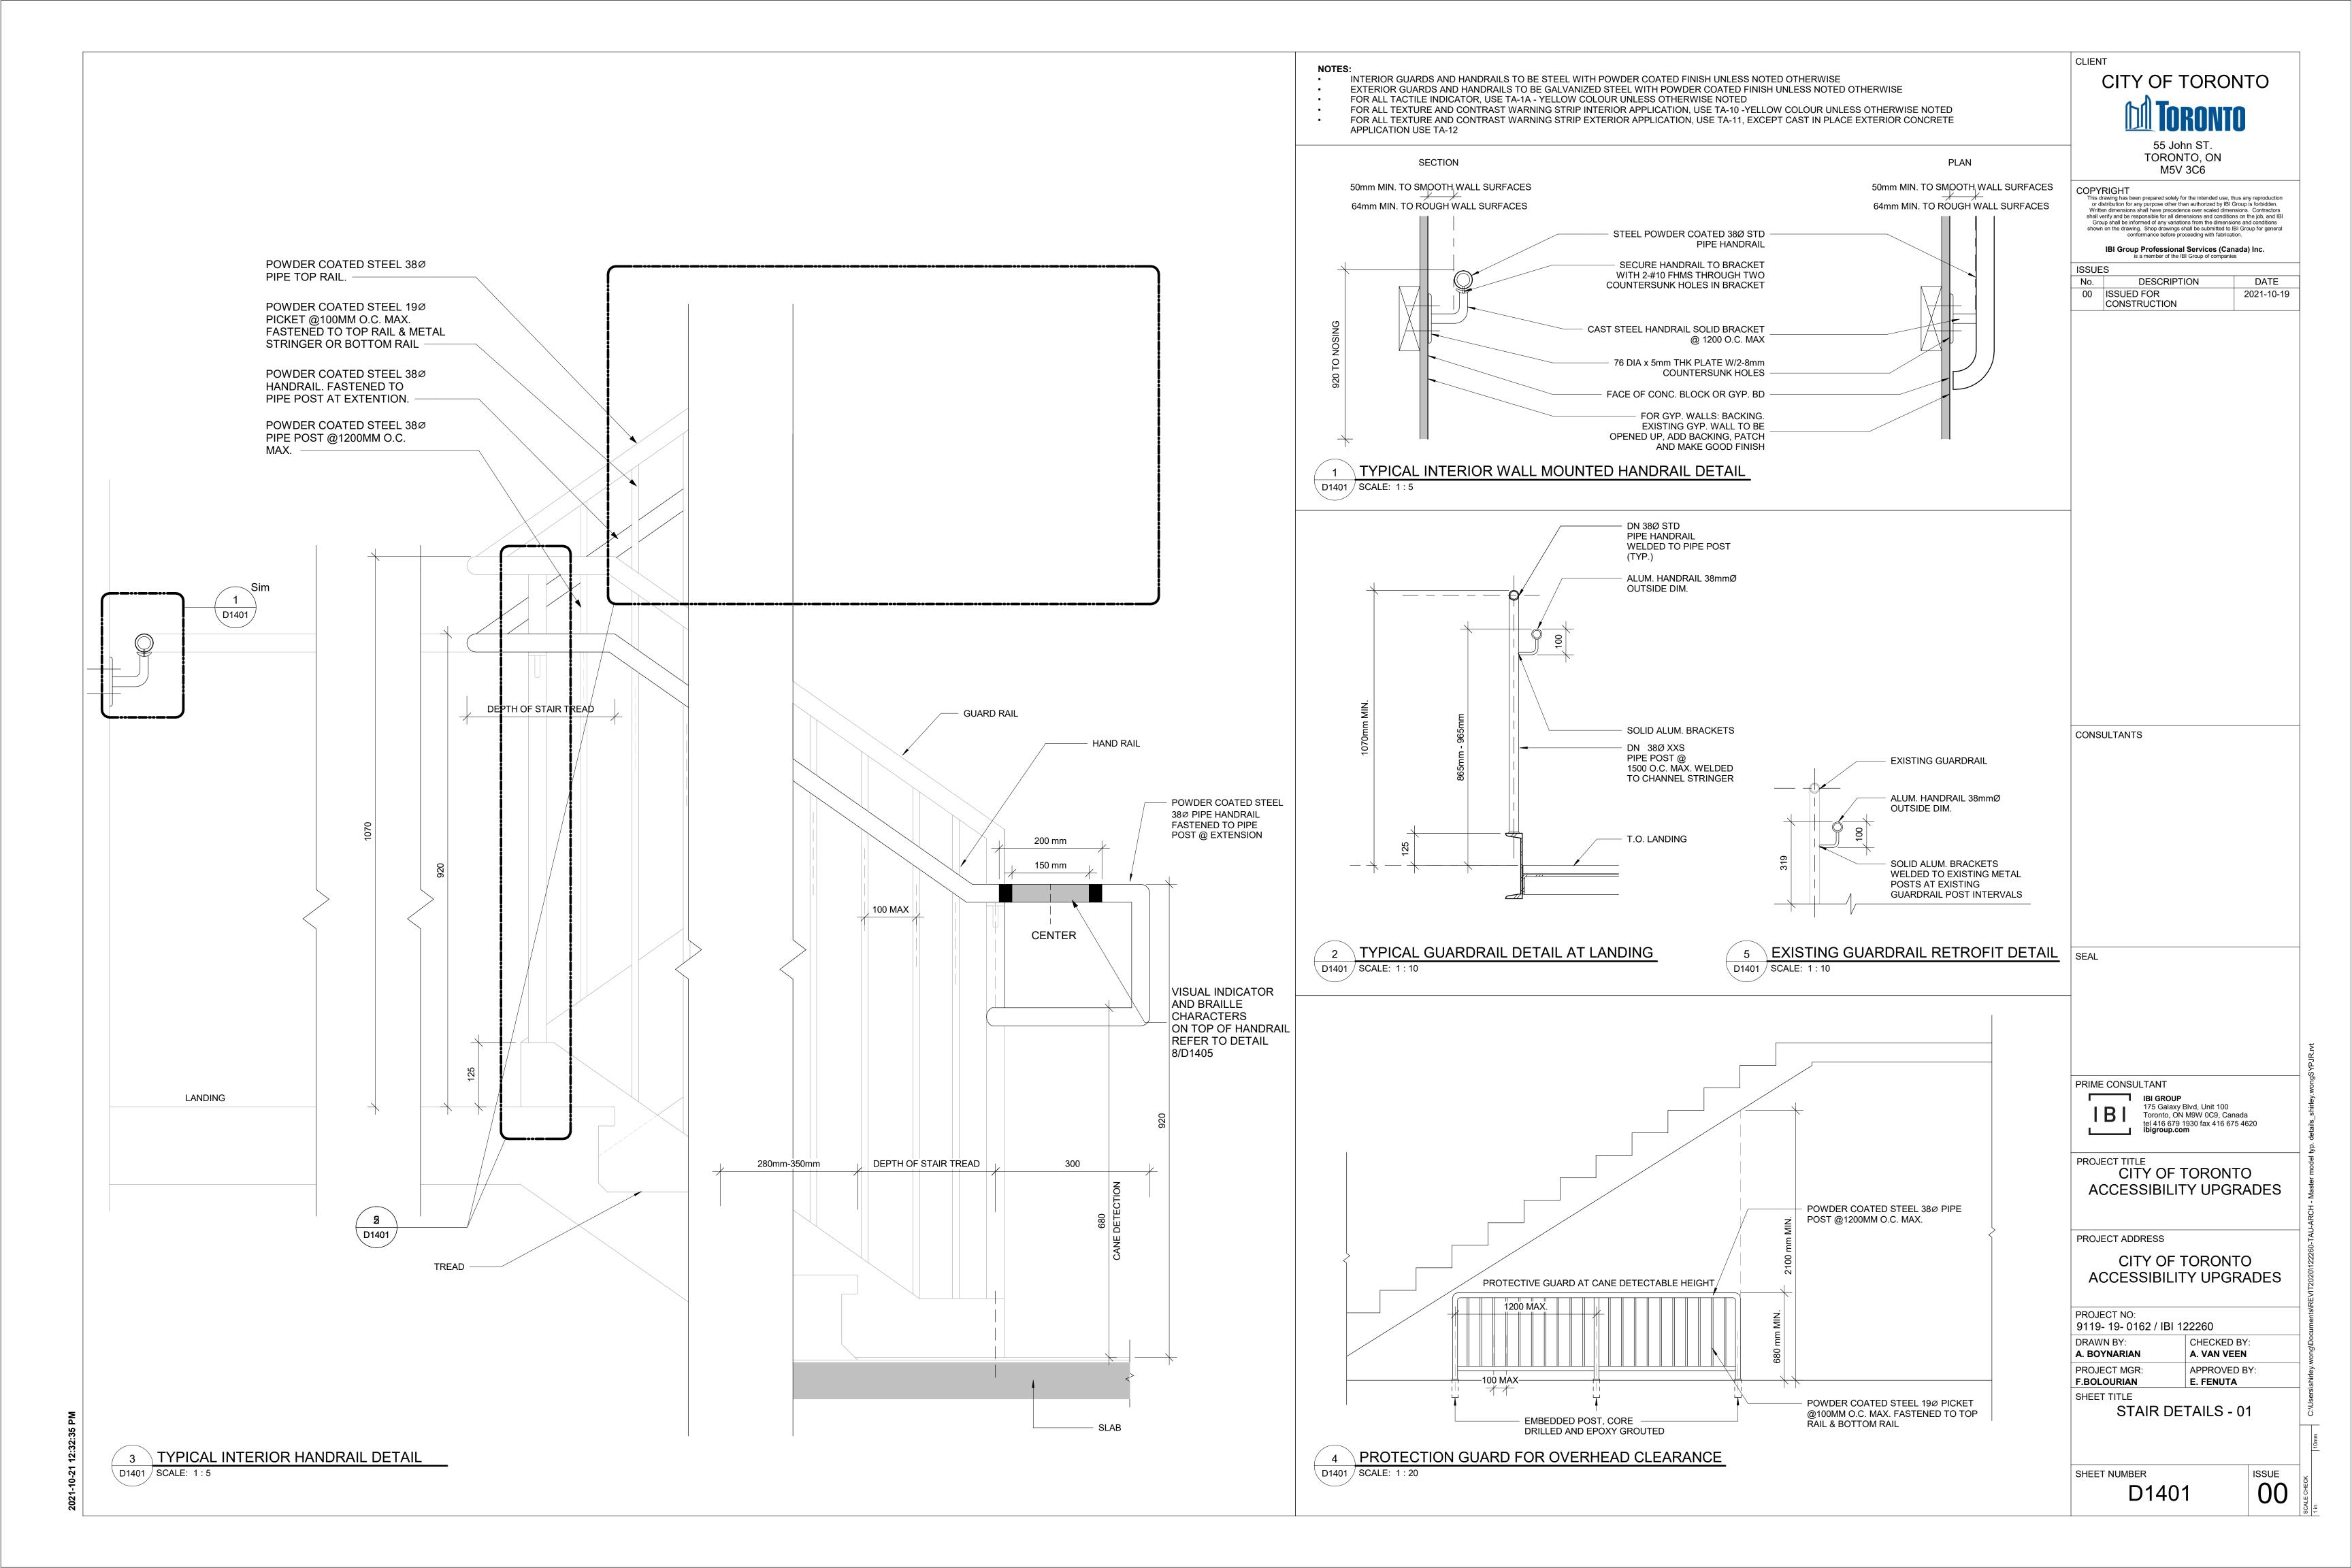
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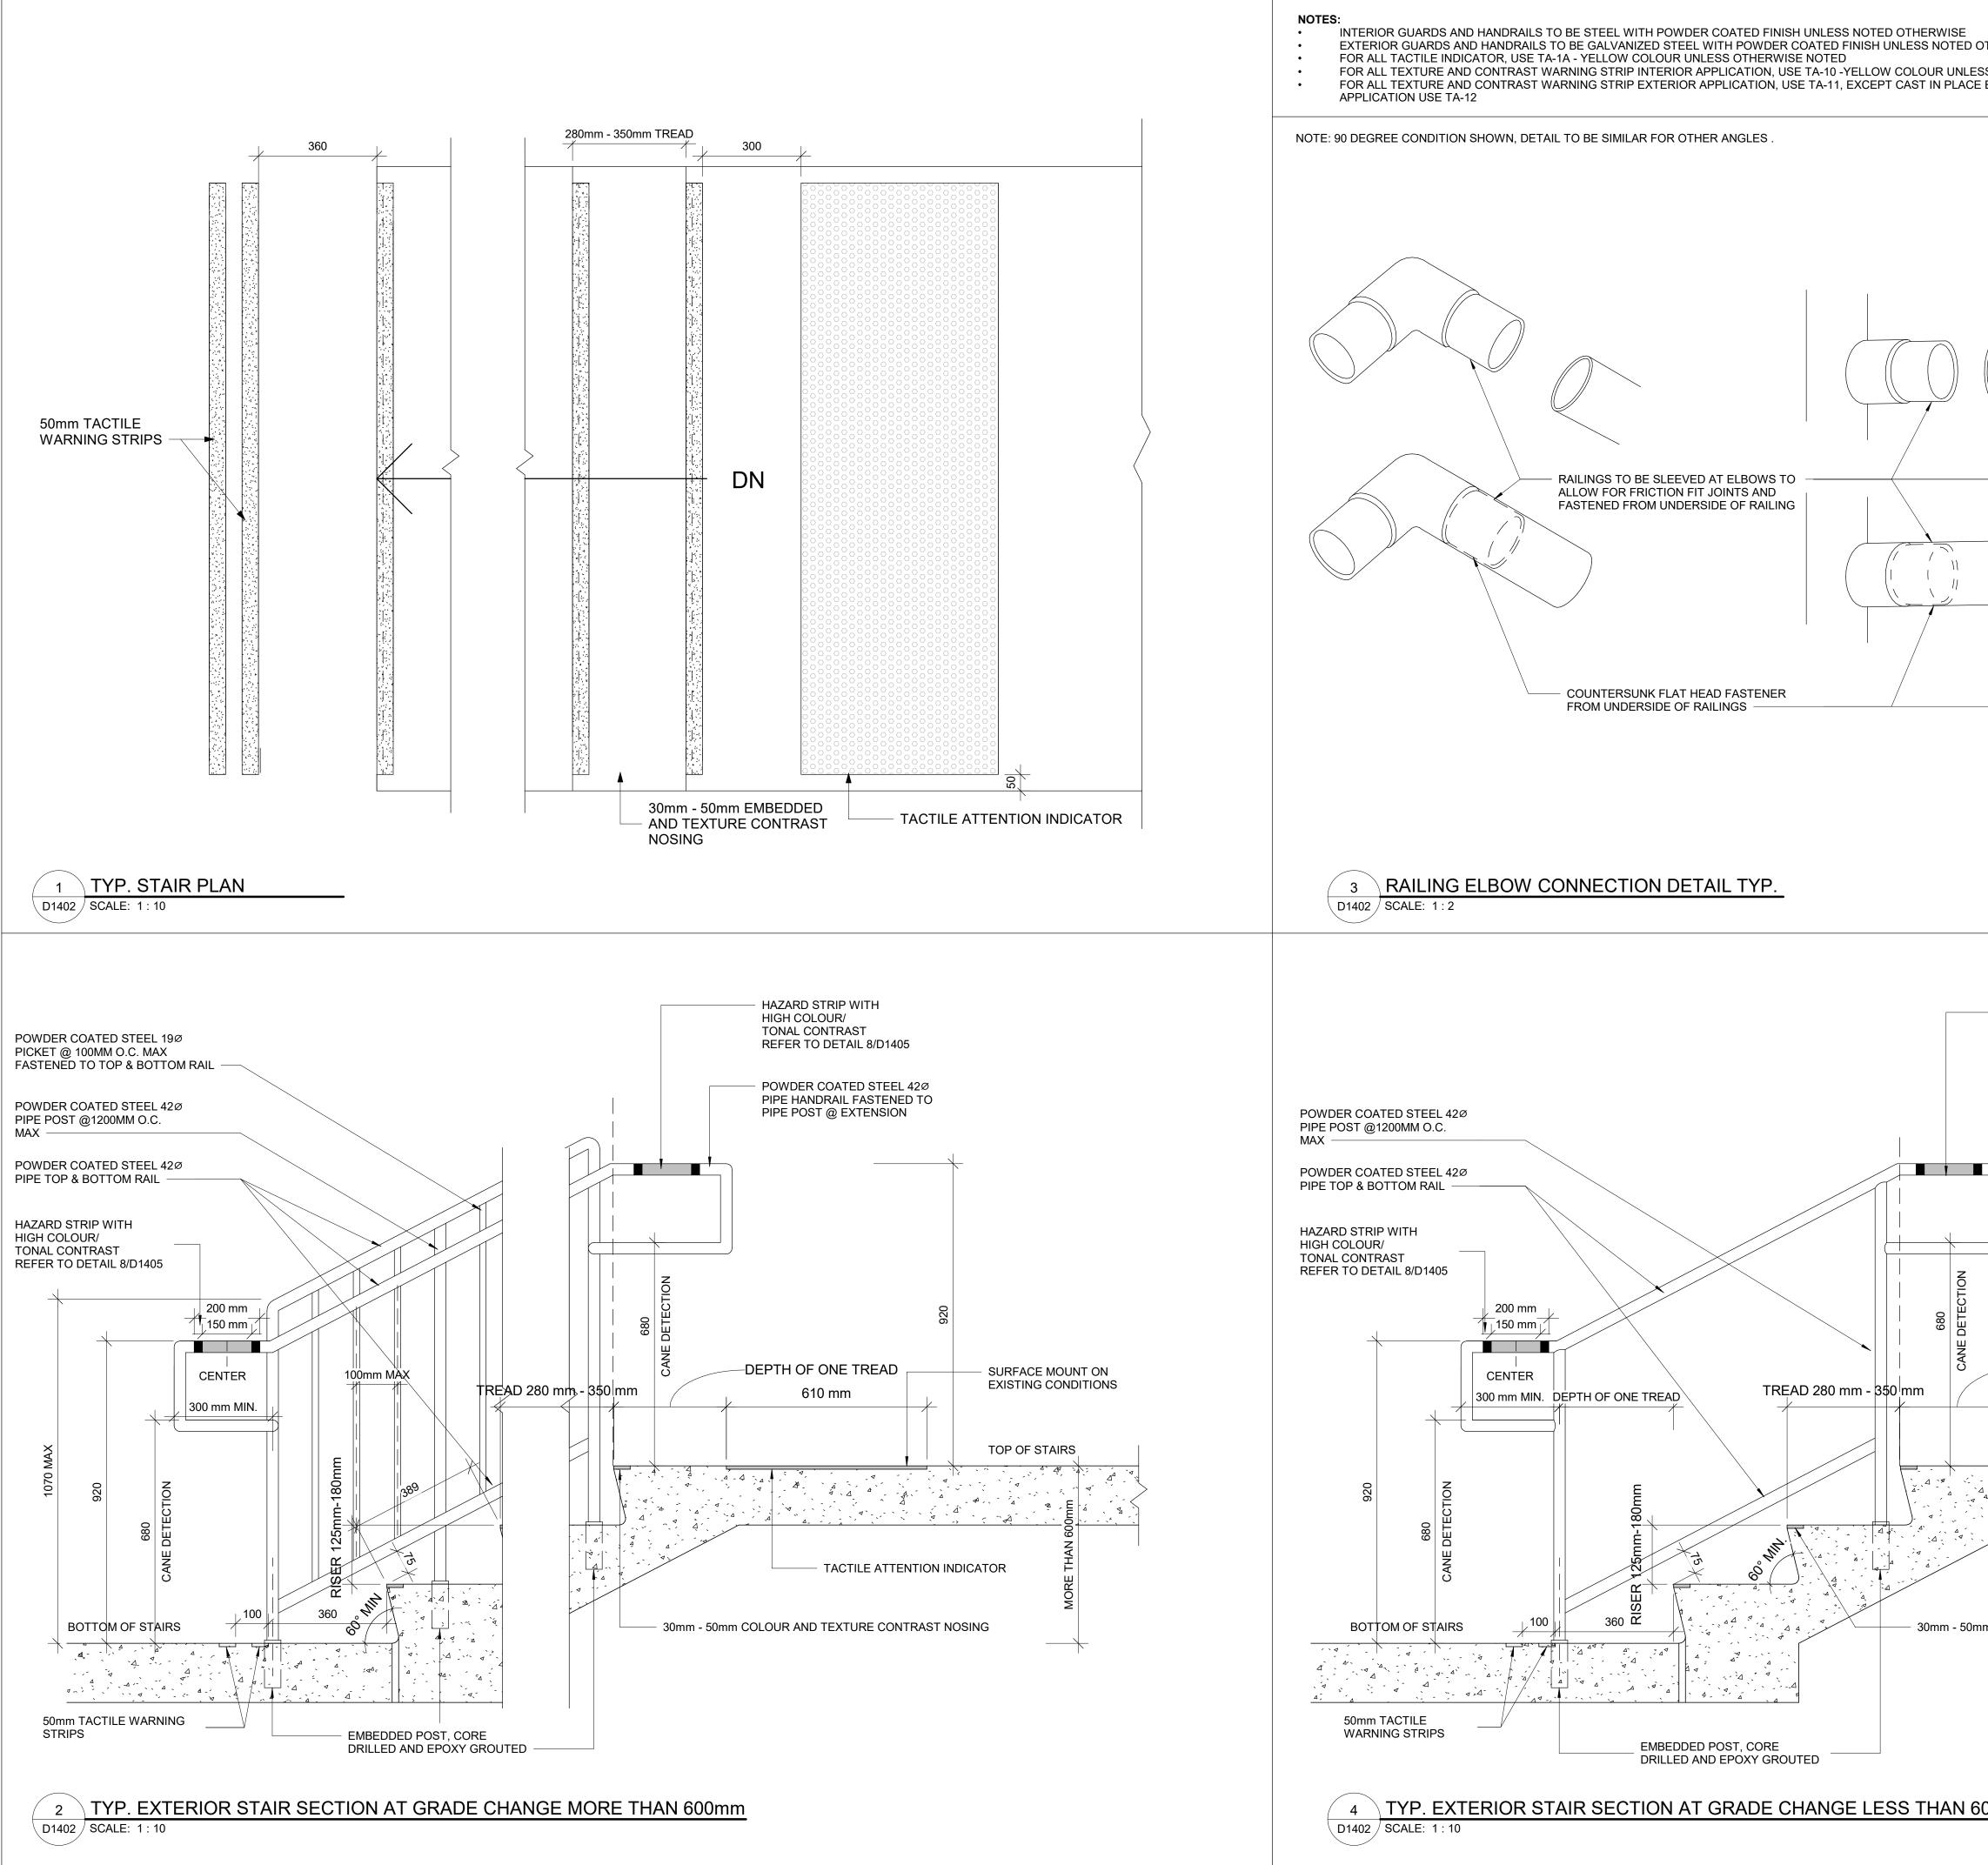
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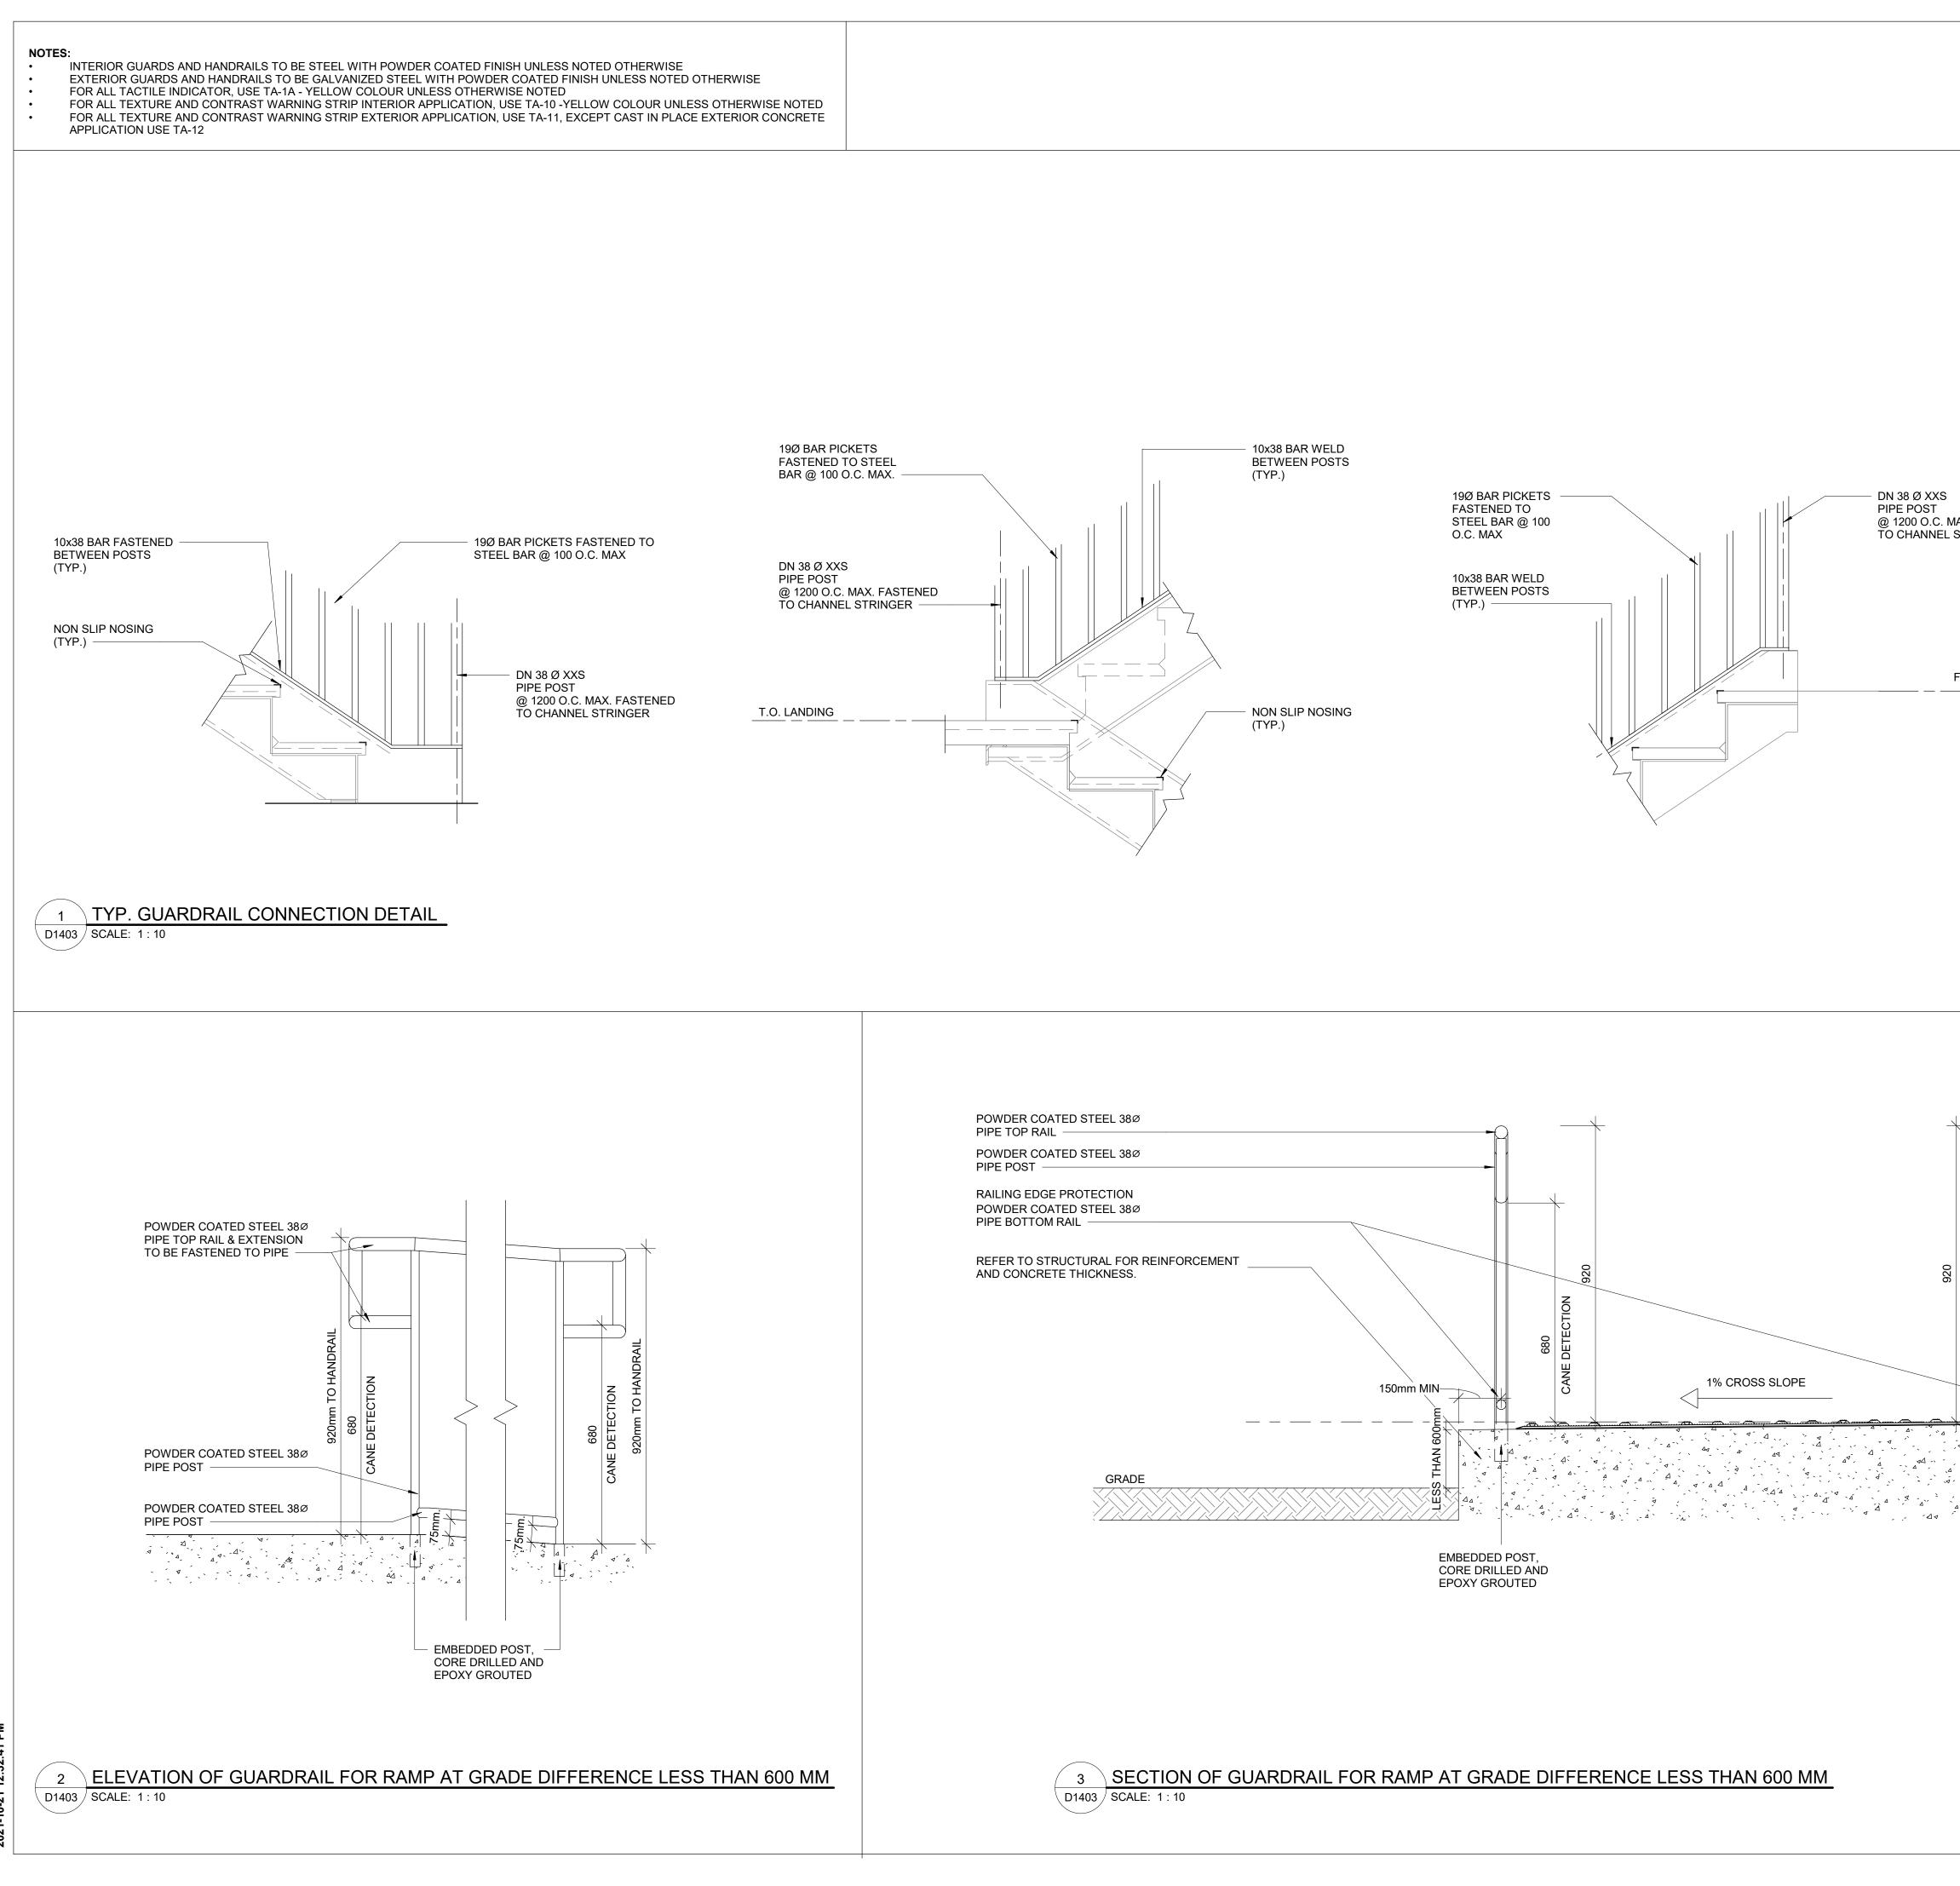
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	A. BOYNARIANA. VAN VEENPROJECT MGR:APPROVED BY:
	F.BOLOURIAN E. FENUTA SHEET TITLE
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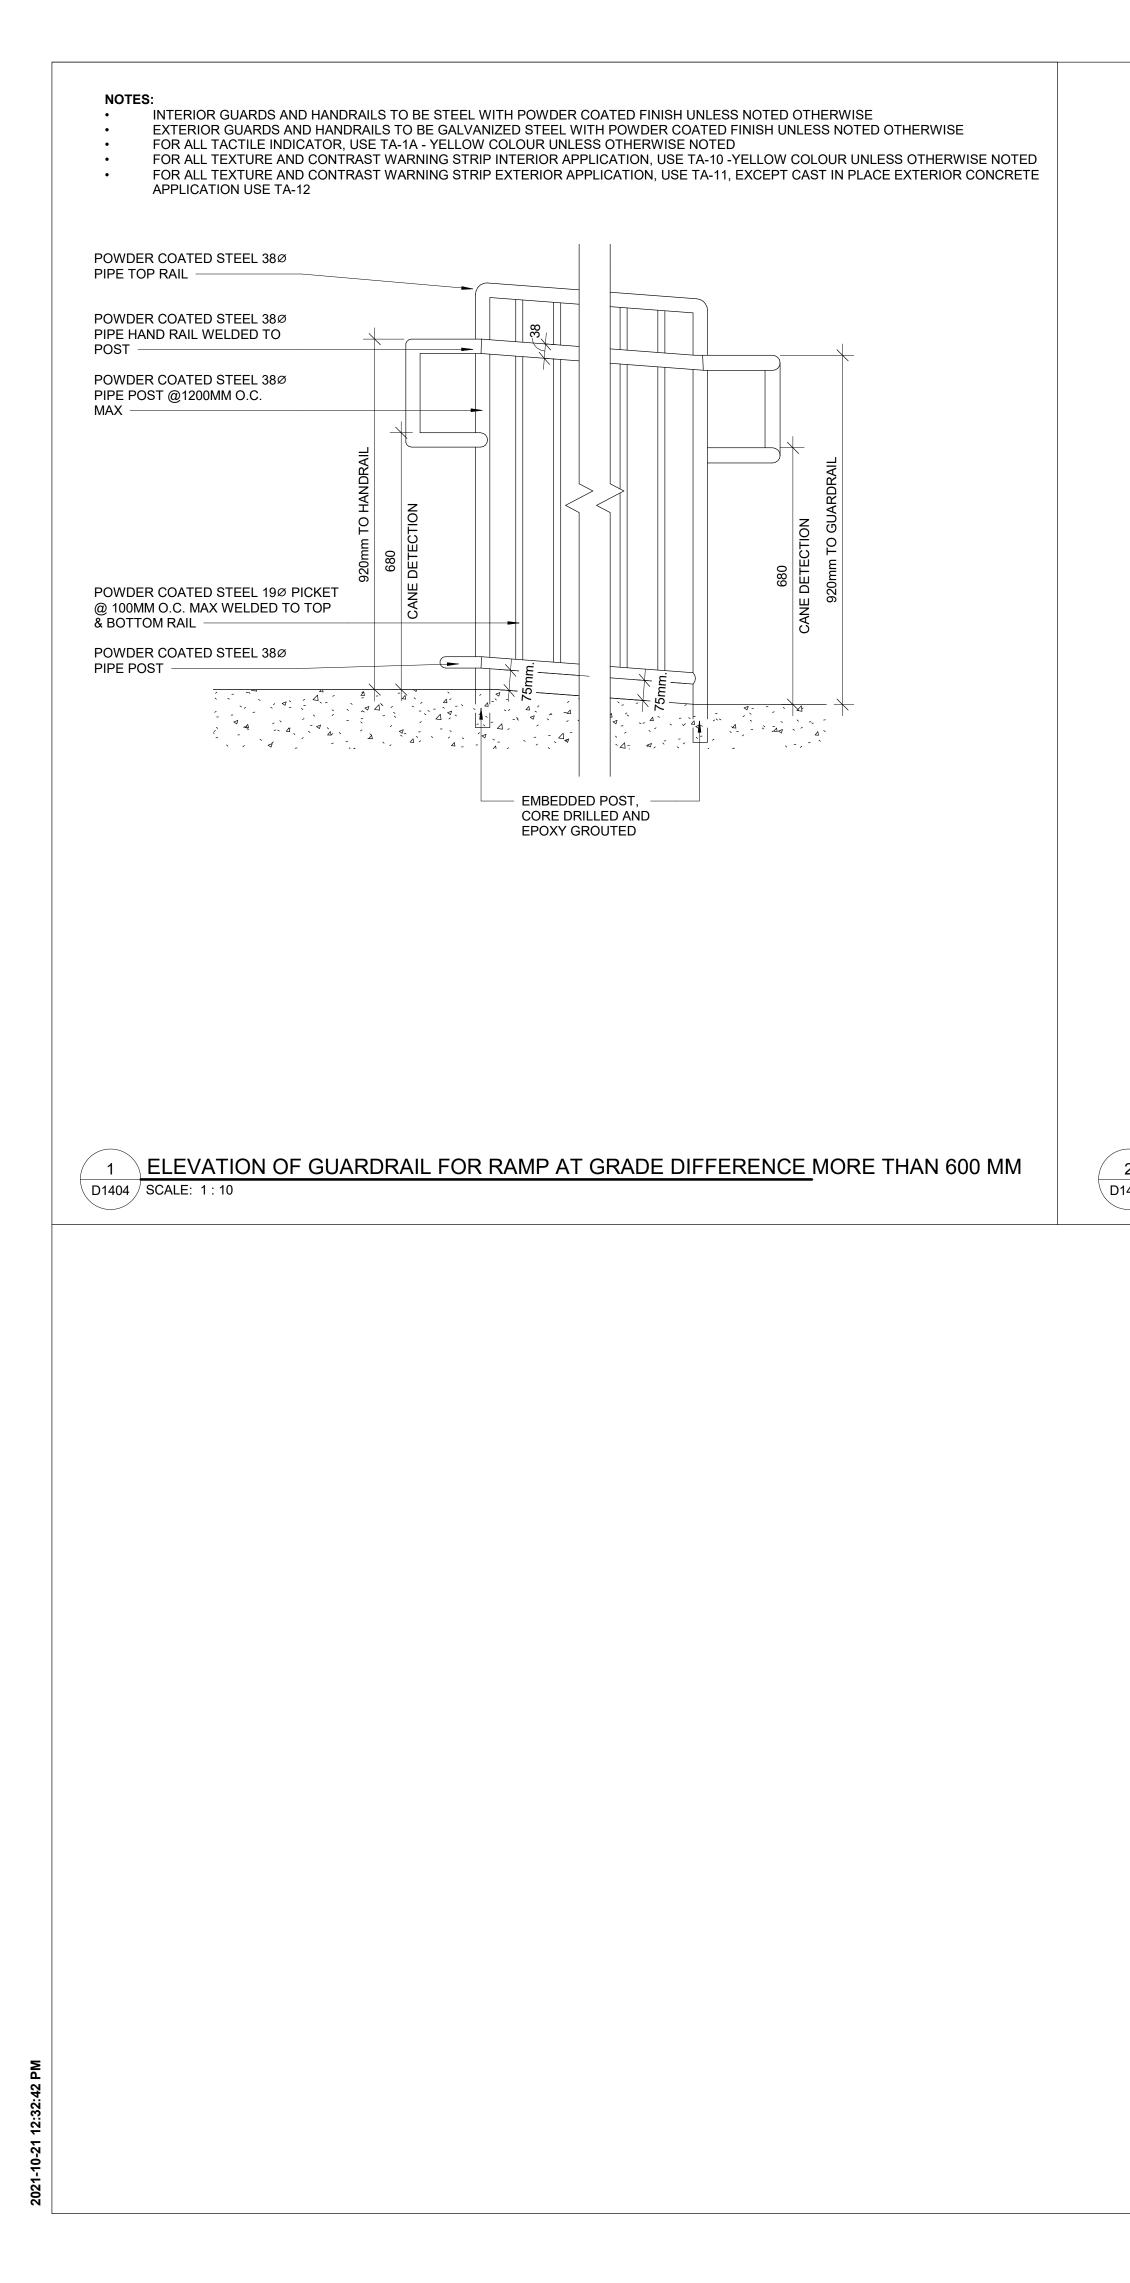


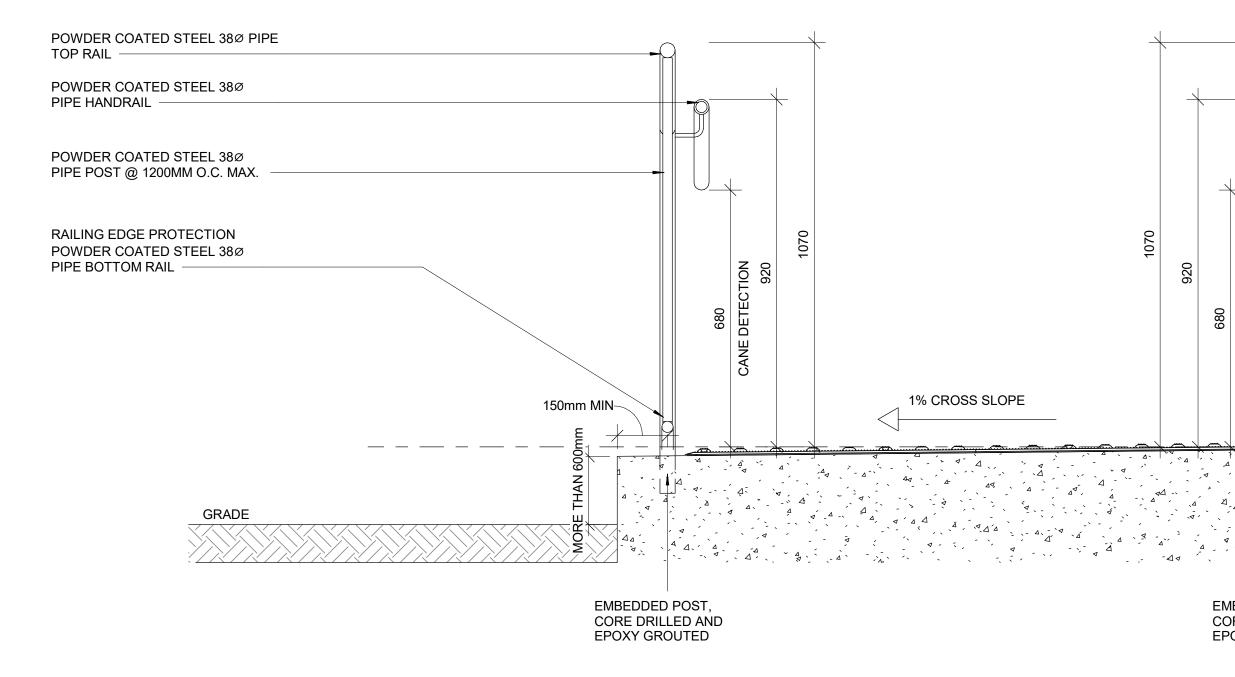
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2 SECTION OF GUARDRAIL FOR RAMP AT GRADE DIFFERENCE MORE THAN 600 MM D1404 SCALE: 1:10

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RAMP DETAILS	
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TA - 1a EXTERIOR AND INTERIOR APPLICATION

	-/	VARIES (610mm - 915mm - 1220mm)														
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VARIES (610mm - 915mm - 1220mm)

1 TACTILE ATTENTION INDICATOR D1405 SCALE: 1:5

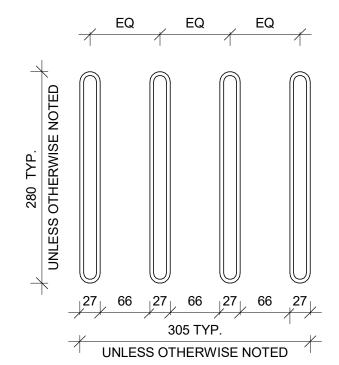
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TA-8 INTERIOR APPLICATION



2 GUIDANCE BARS PLAN D1405 SCALE: 1:5

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BRAILLE INDICA LEVEL AND NUM OF RAILING. SEI



150mm LONG YELLOW COLOUR WAYFINDING SIGN WITH BRAILI 25mm WIDE RED COLOUR ON E SIDE OF THE SIGN

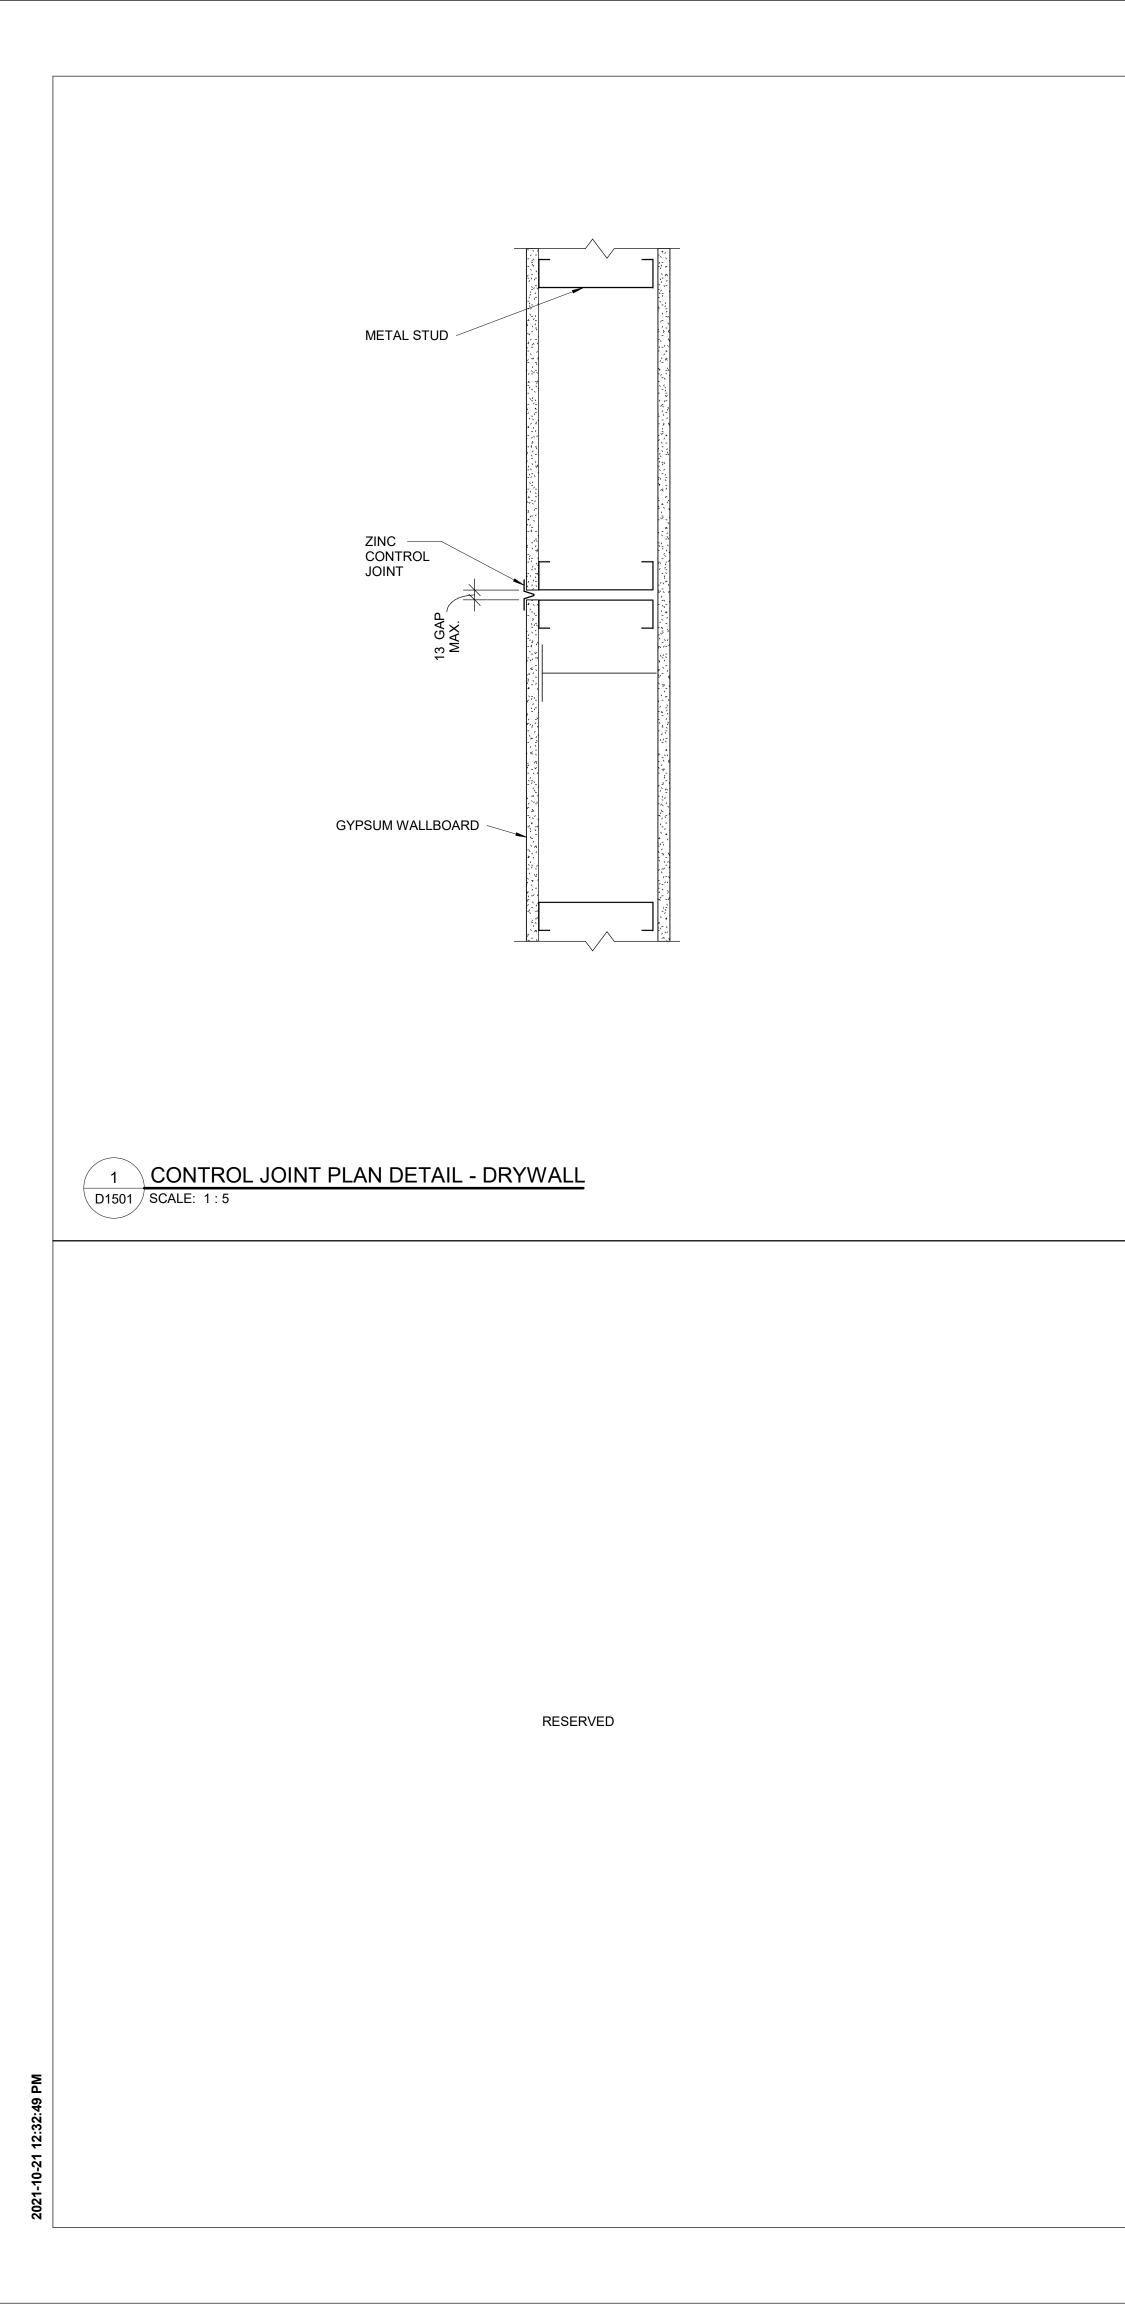
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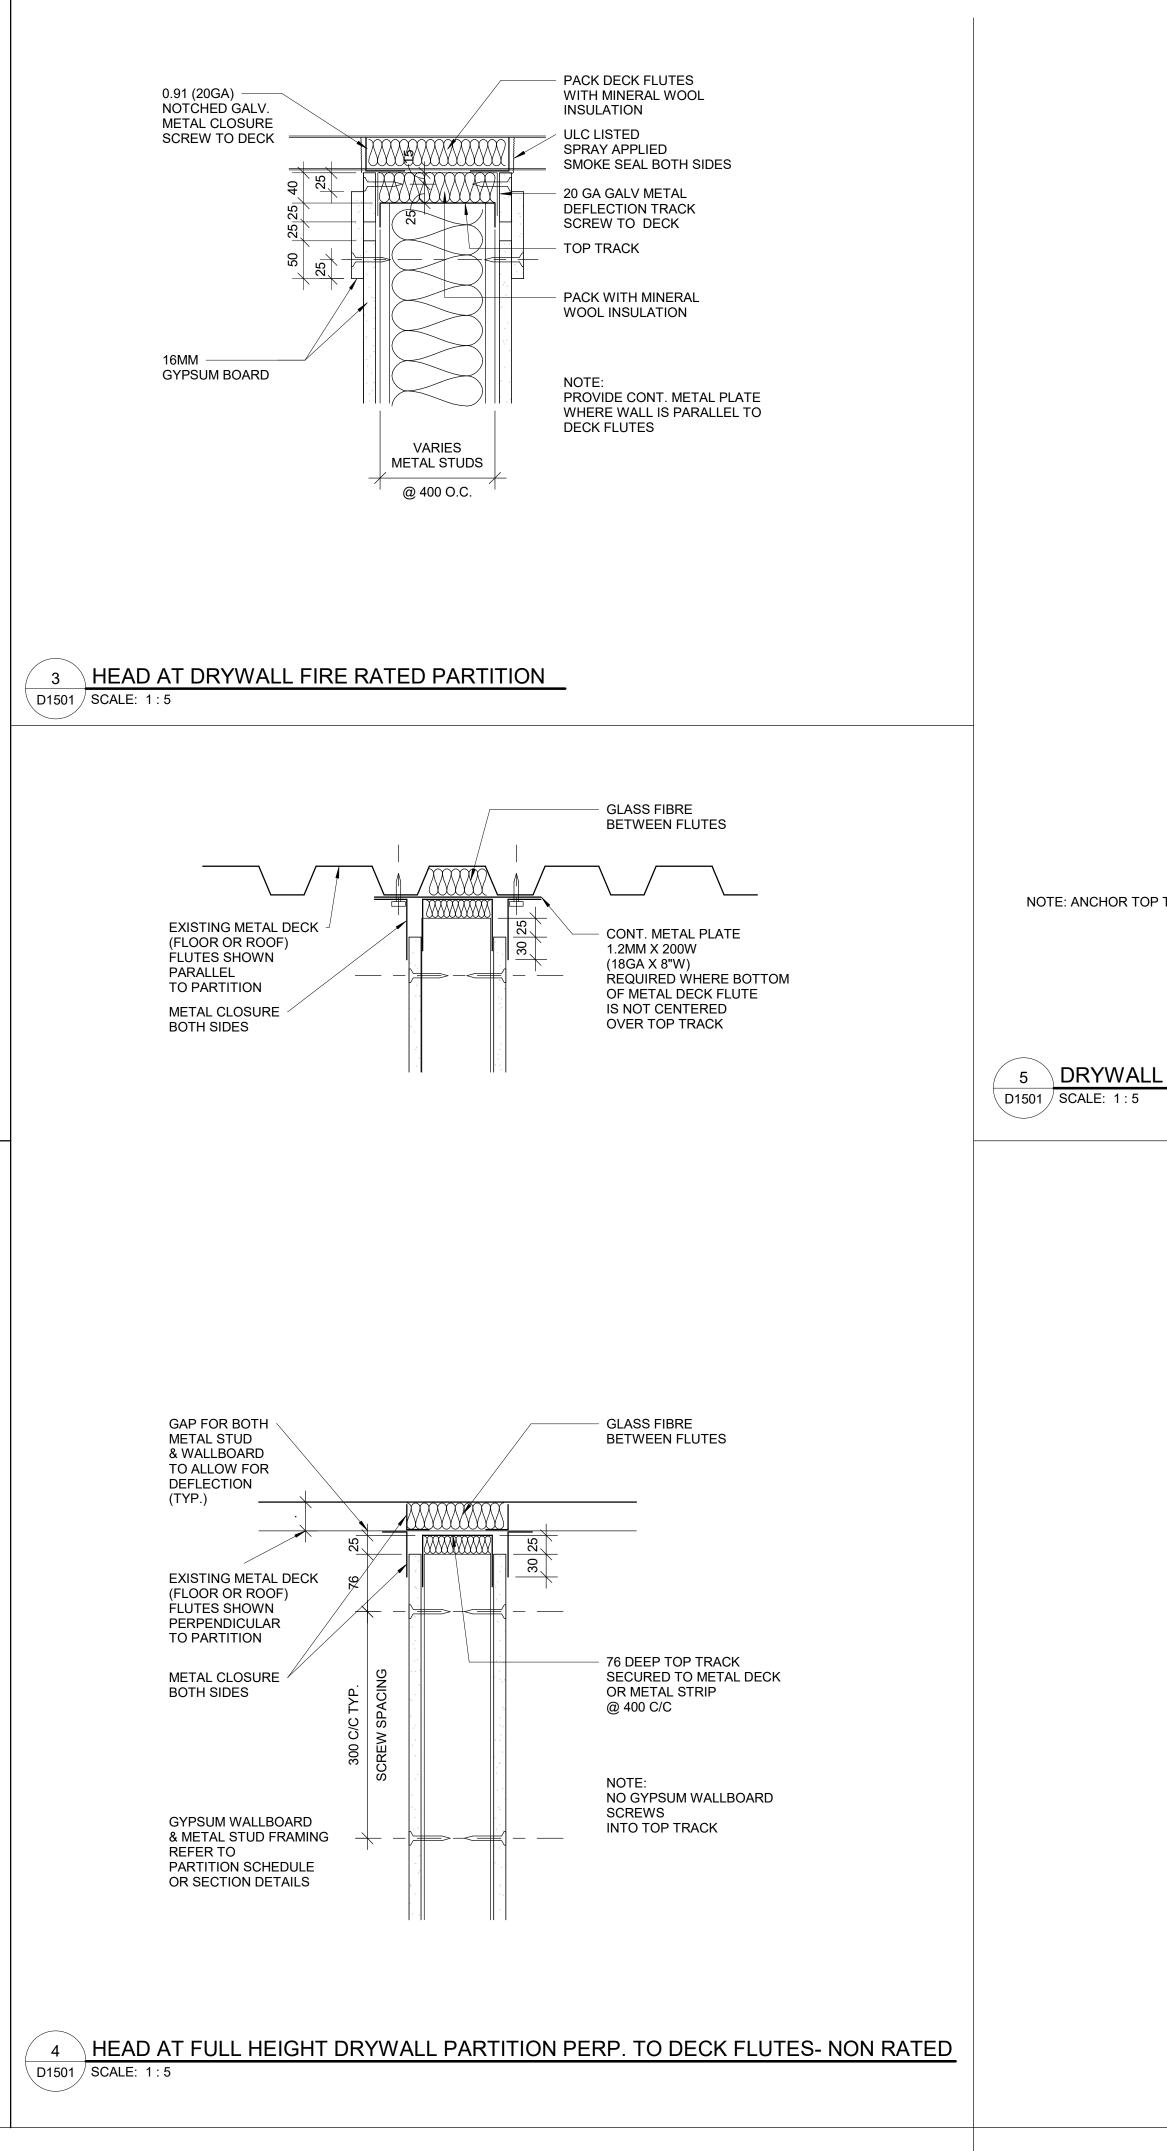
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10 HANDRAIL I D1405 SCALE: 1:5

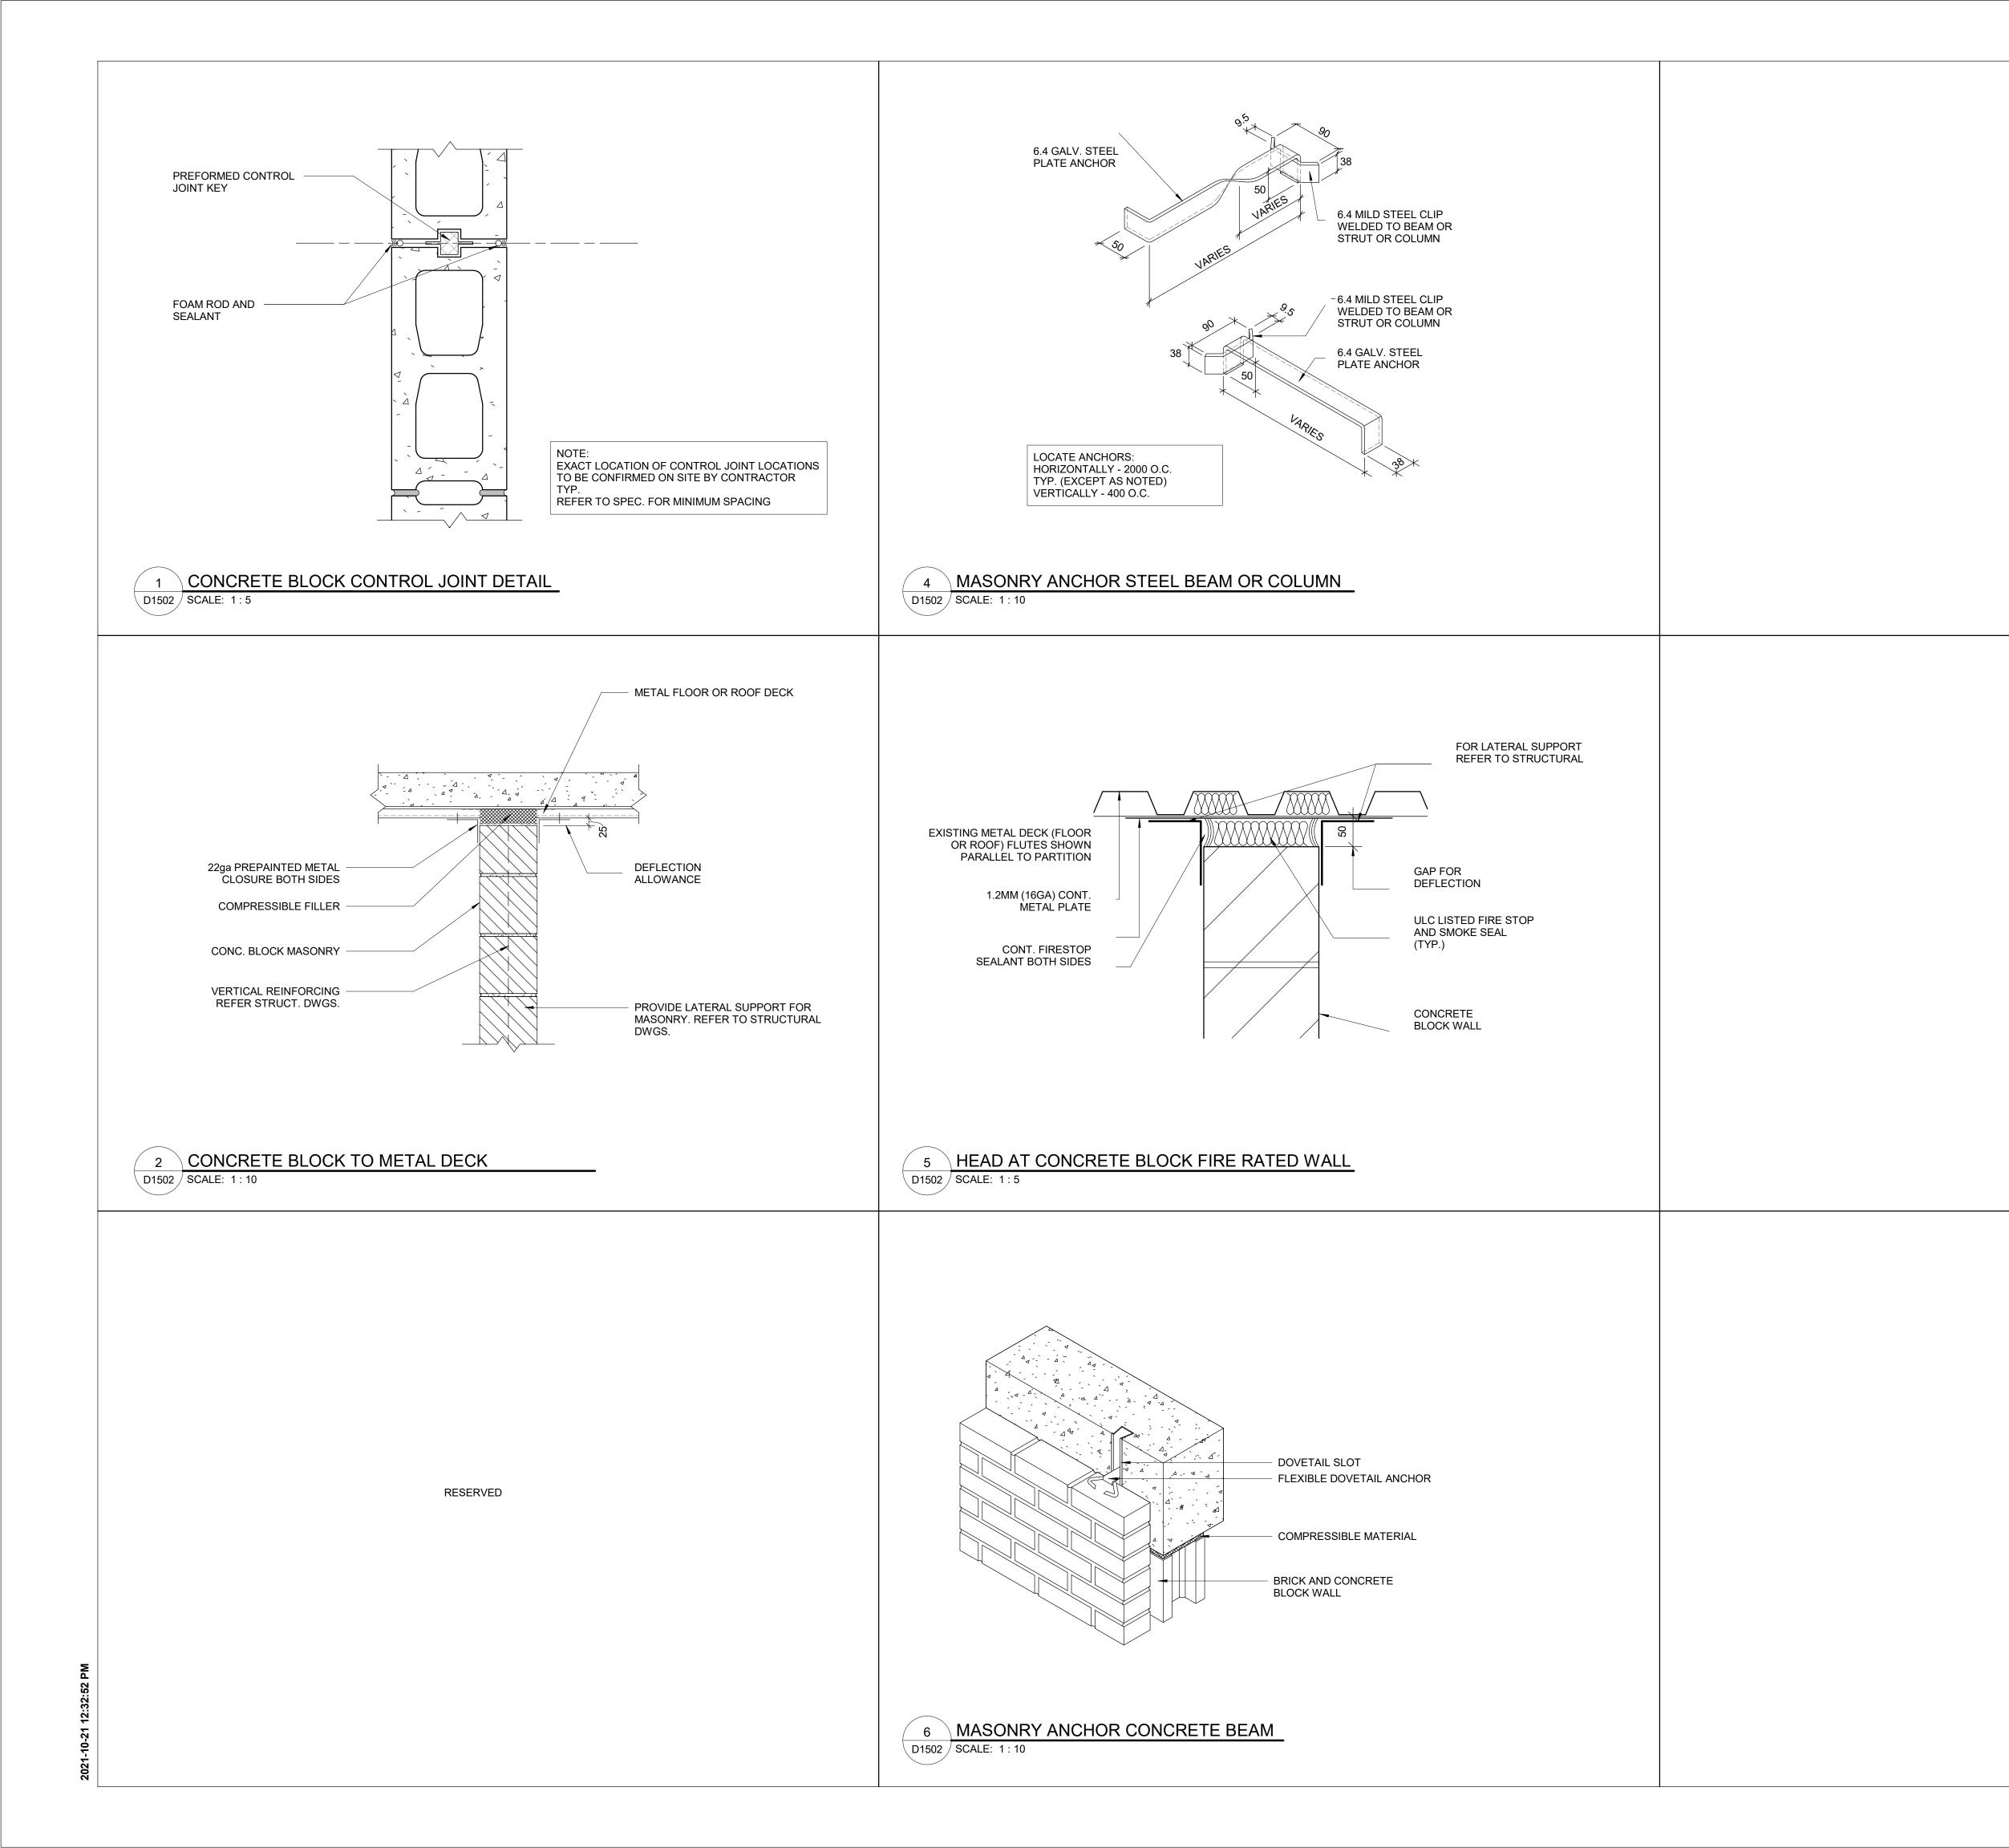
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HAZARD STRIP	PRIME CONSULTANT IBI GROUP 175 Galaxy Blvd, Unit 100 Toronto, ON M9W 0C9, Canada tel 416 679 1930 fax 416 675 462 ibigroup.com PROJECT TITLE				
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HAZARD STRIP PLAN	SHEET NUMBER D1405				

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		CLIENT CITY OF TORONTO TORONTO, ON M5V 3C6		
TRACK TO T-BAR WITH CLIPS OR FASTENERS	 U/S OF SLAB OR DECK PROVIDE ACOUSTIC SEALANT WHERE BAFFLE MEETS SURFACE 2 SHEETS 1" RIGID INSULATION W/ FOIL BACKING. FOIL TAPE ALL EXPOSED EDGES OF MINERAL WOOL INSULATION FINISHED CEILING AS SPECIFIED CLOSED CELL FOAM TAPE CENTER PARTITION ON T-BAR UNLESS NOTED SINGLE LAYER 16MM GWB ONE SIDE 2 12.7MM METAL STUDS AT 400MM O/C 51MM BATT INSULATION SOUND ATTENUATION BLANKET APPLIED BASE AS SPECIFIED ACOUSTIC SEALANT FINISHED FLOOR 	<text><text><section-header><text><text></text></text></section-header></text></text>		
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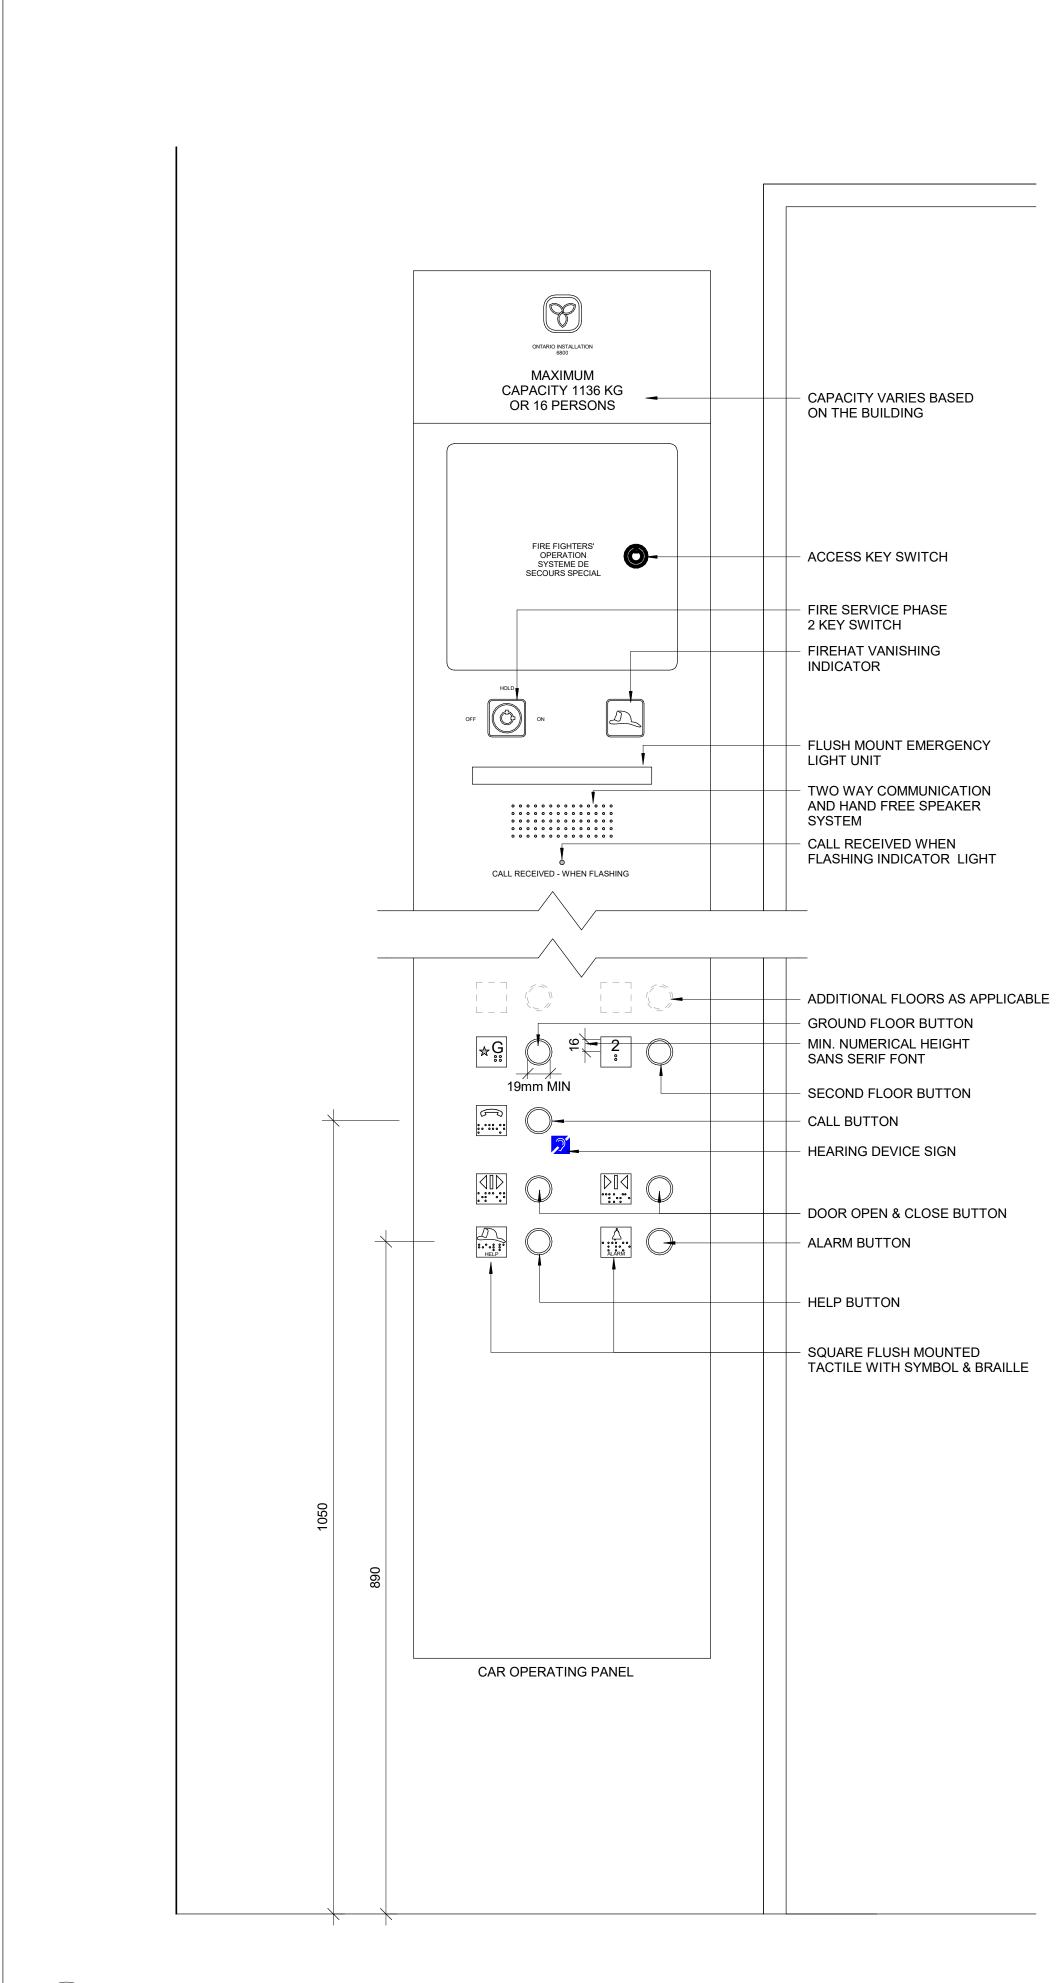


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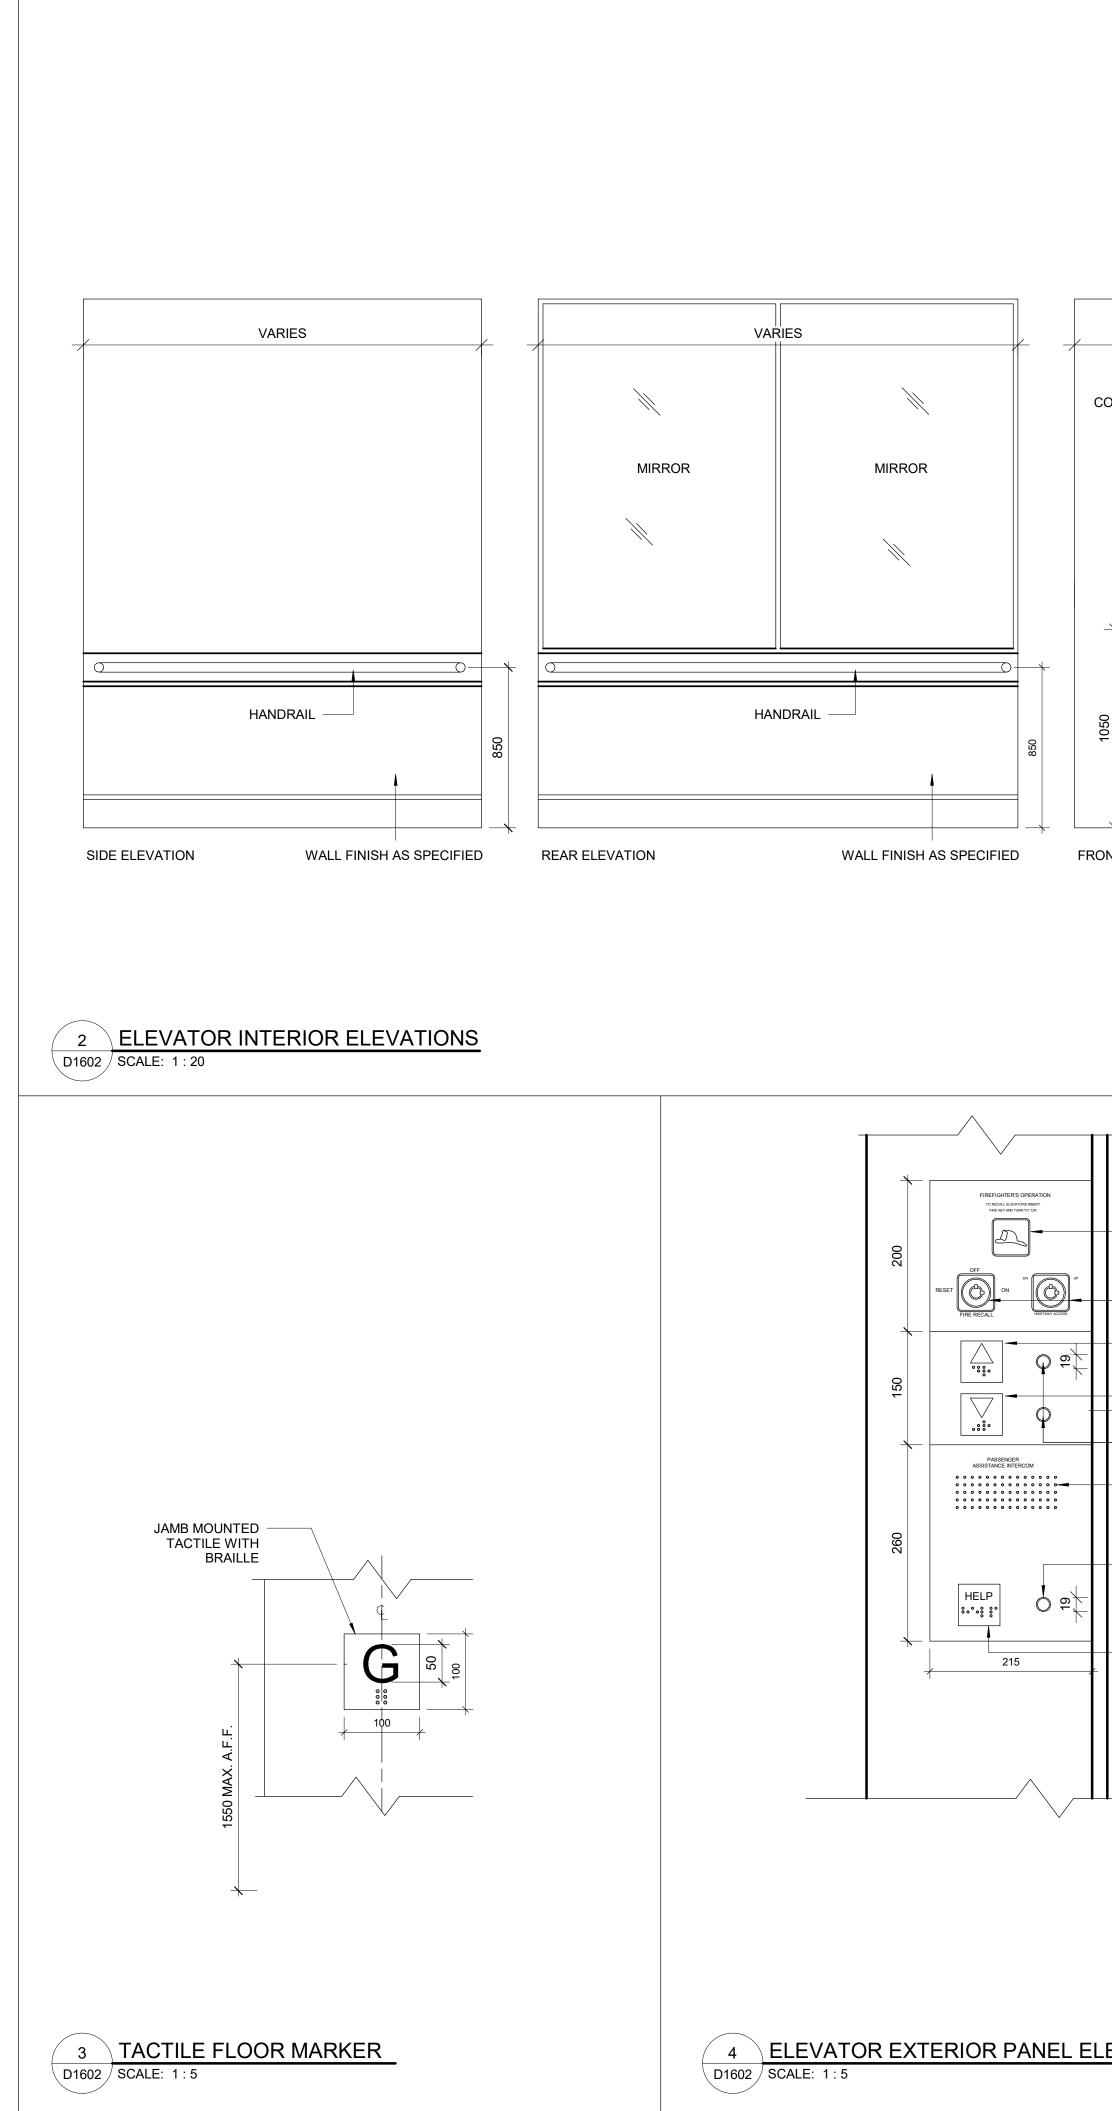
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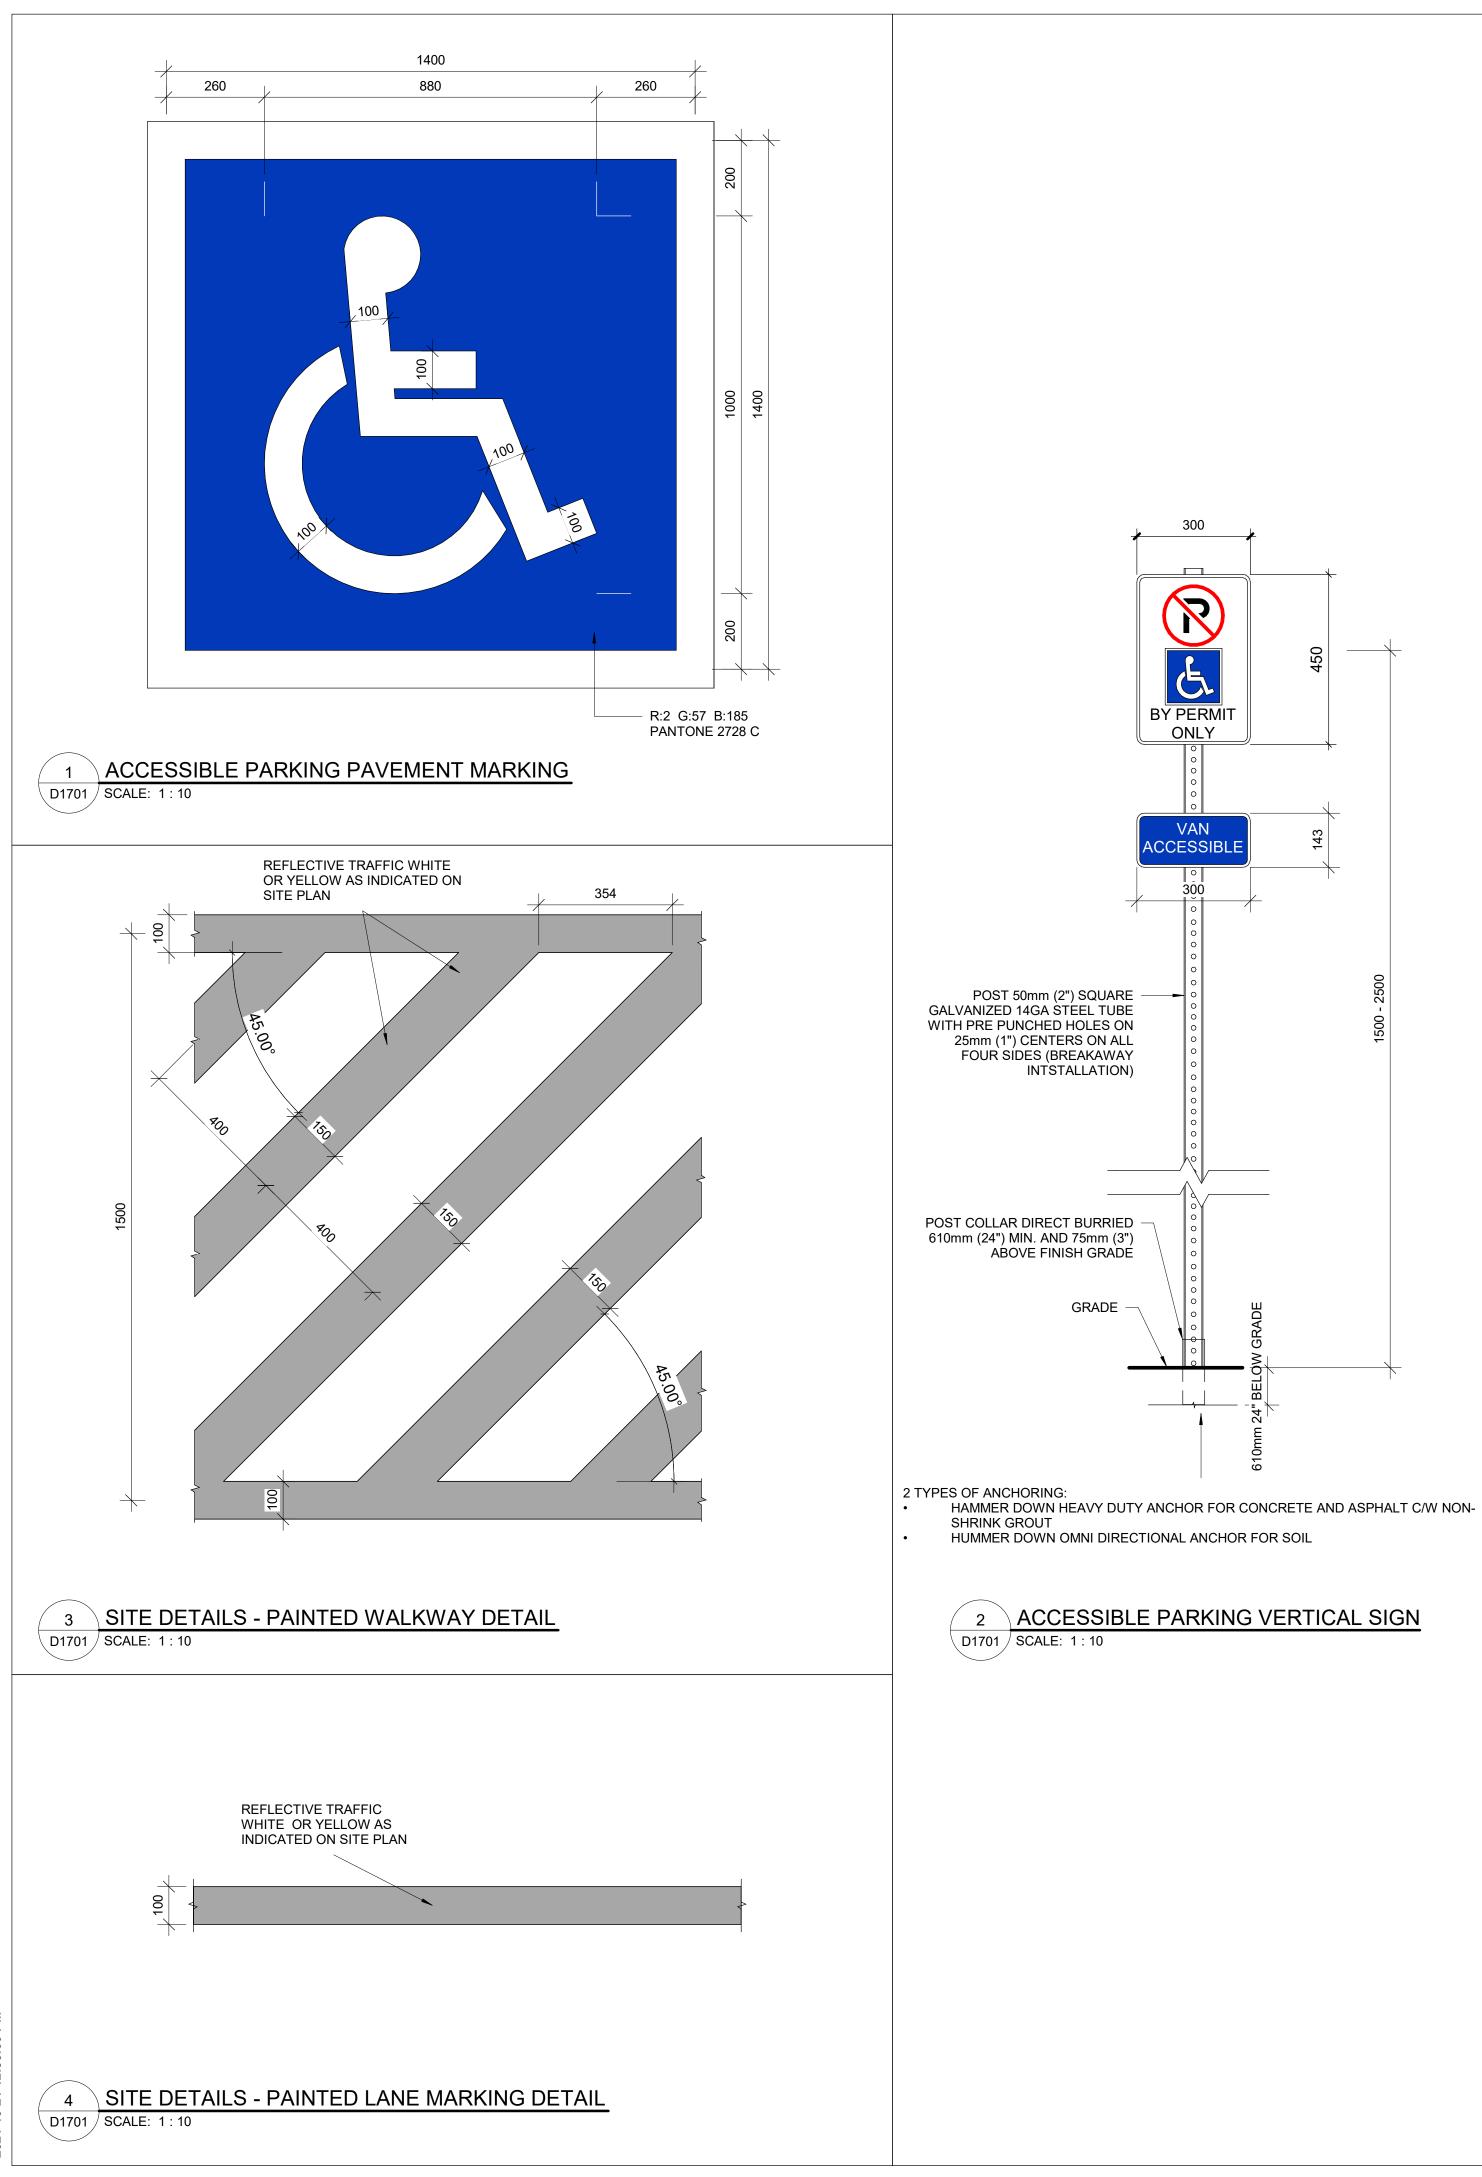
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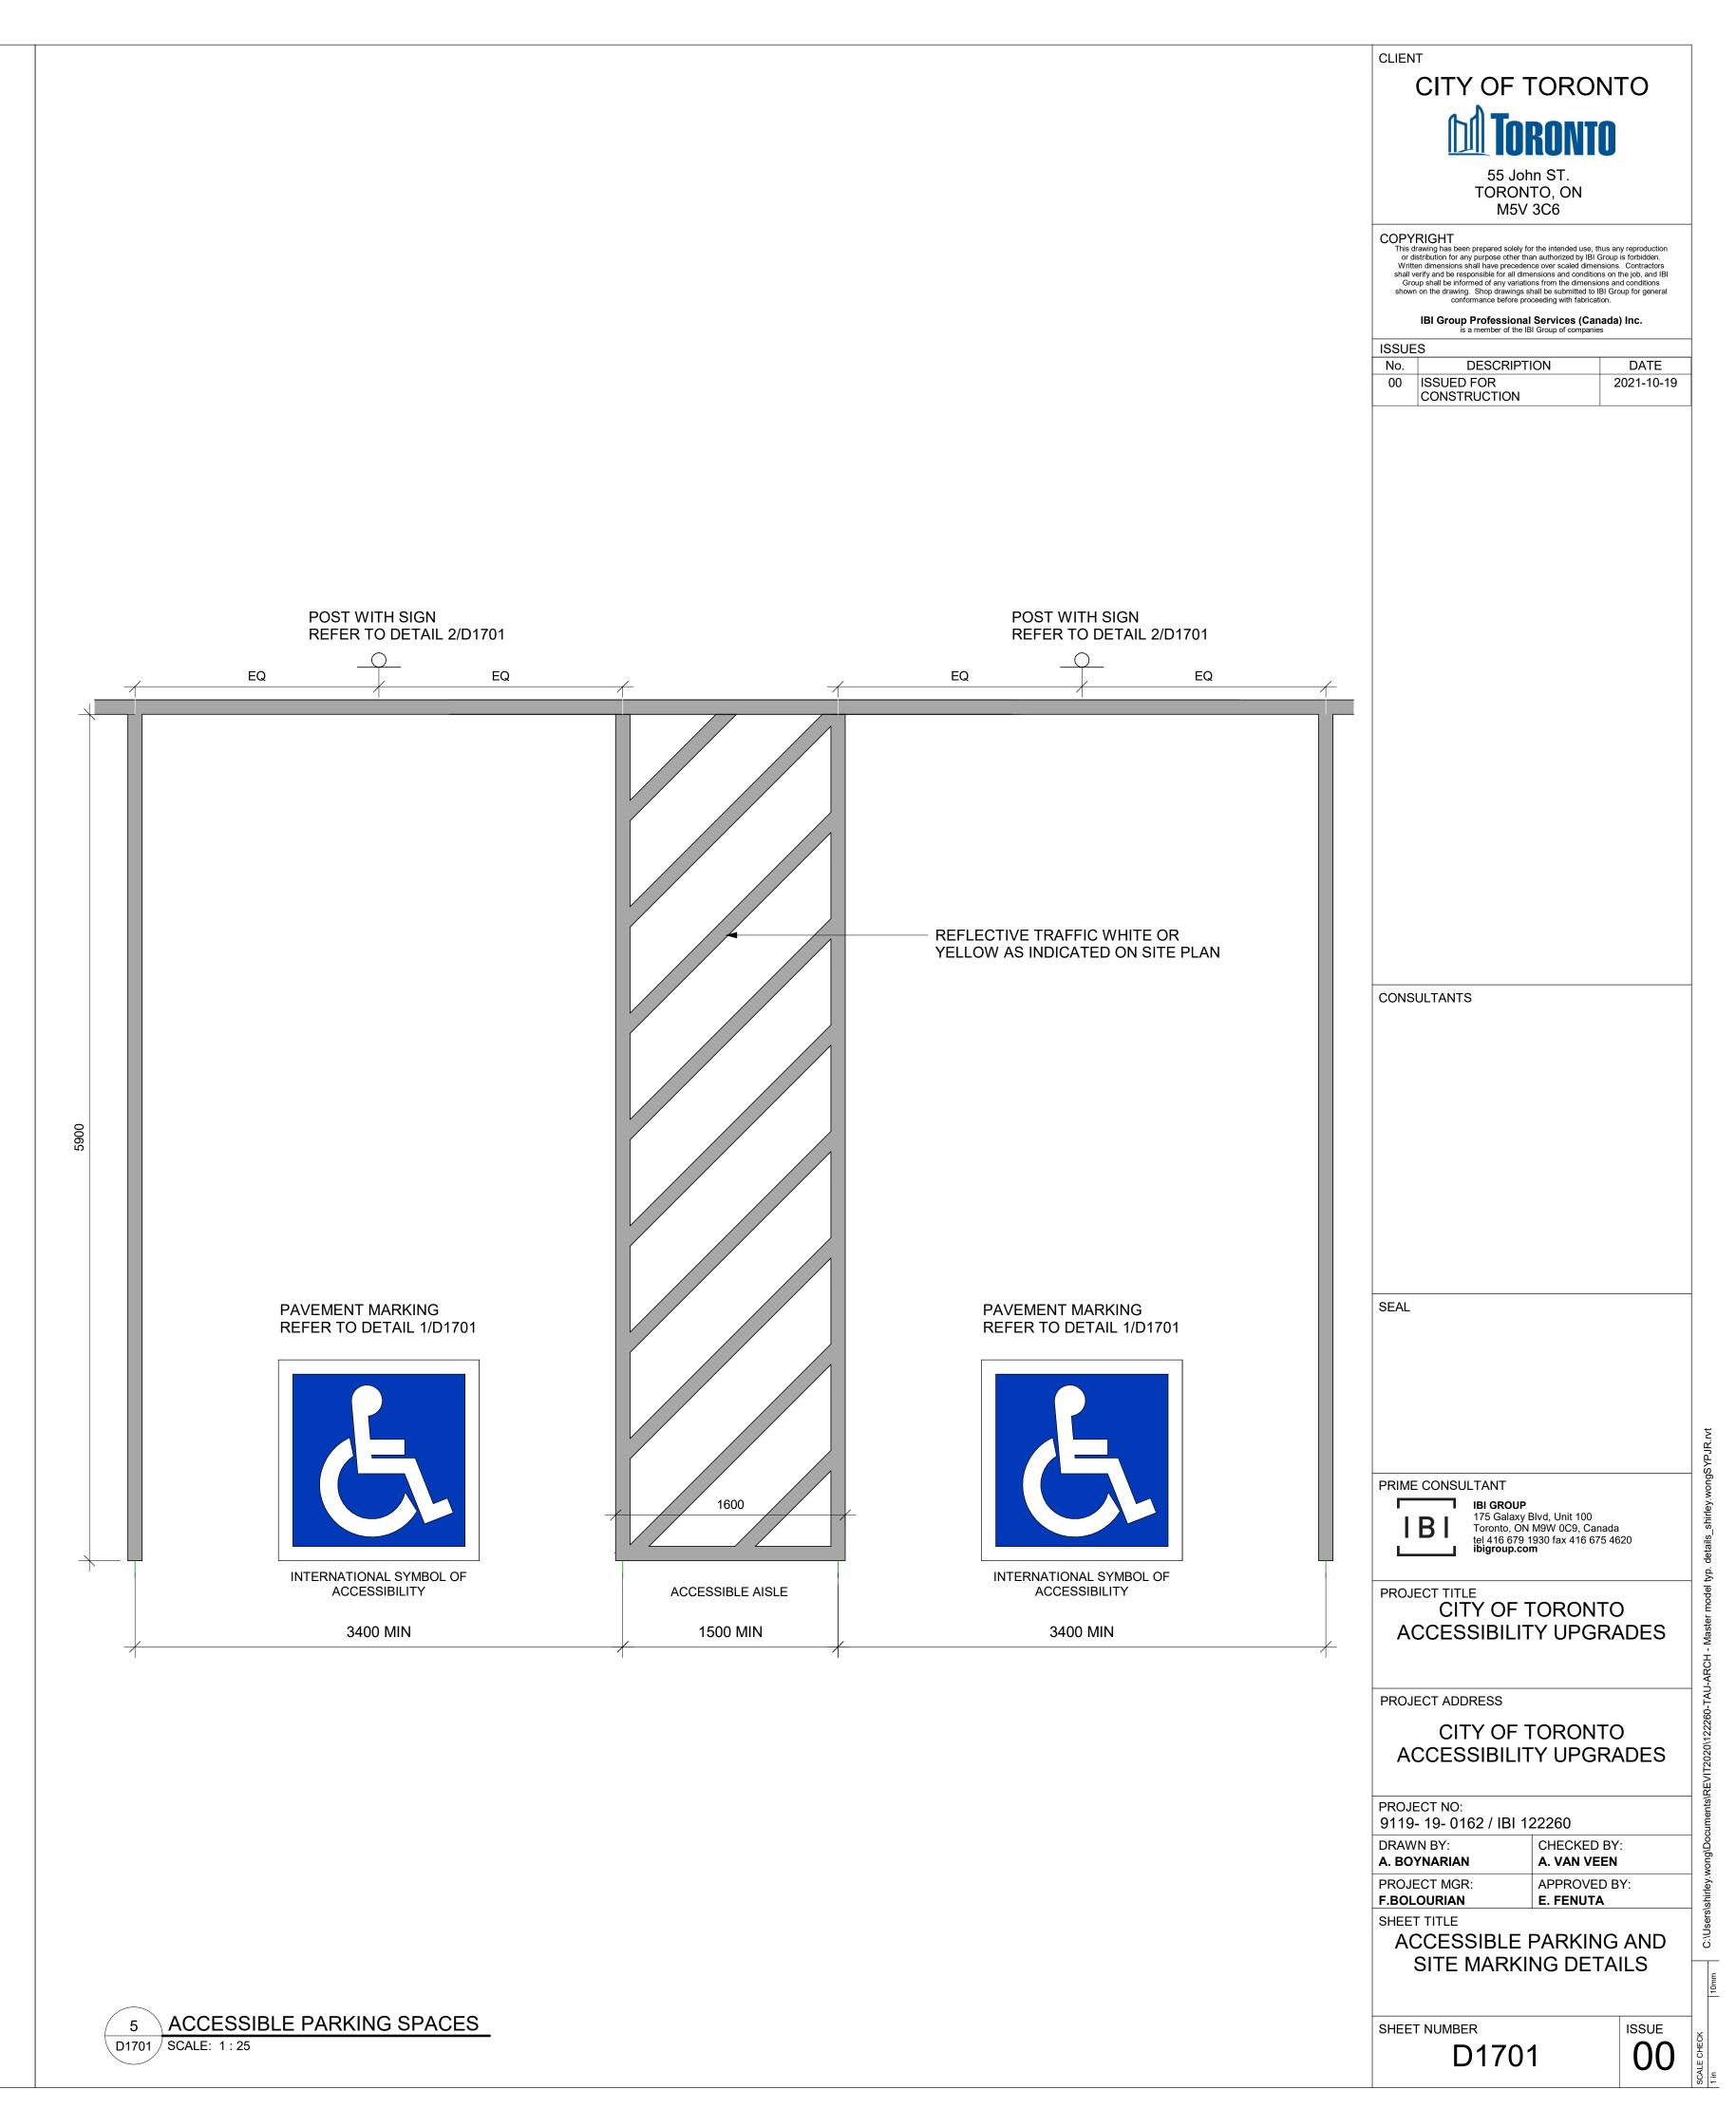
1 INTERIOR ELEVATOR CONTROLS D1602 SCALE: 1:5

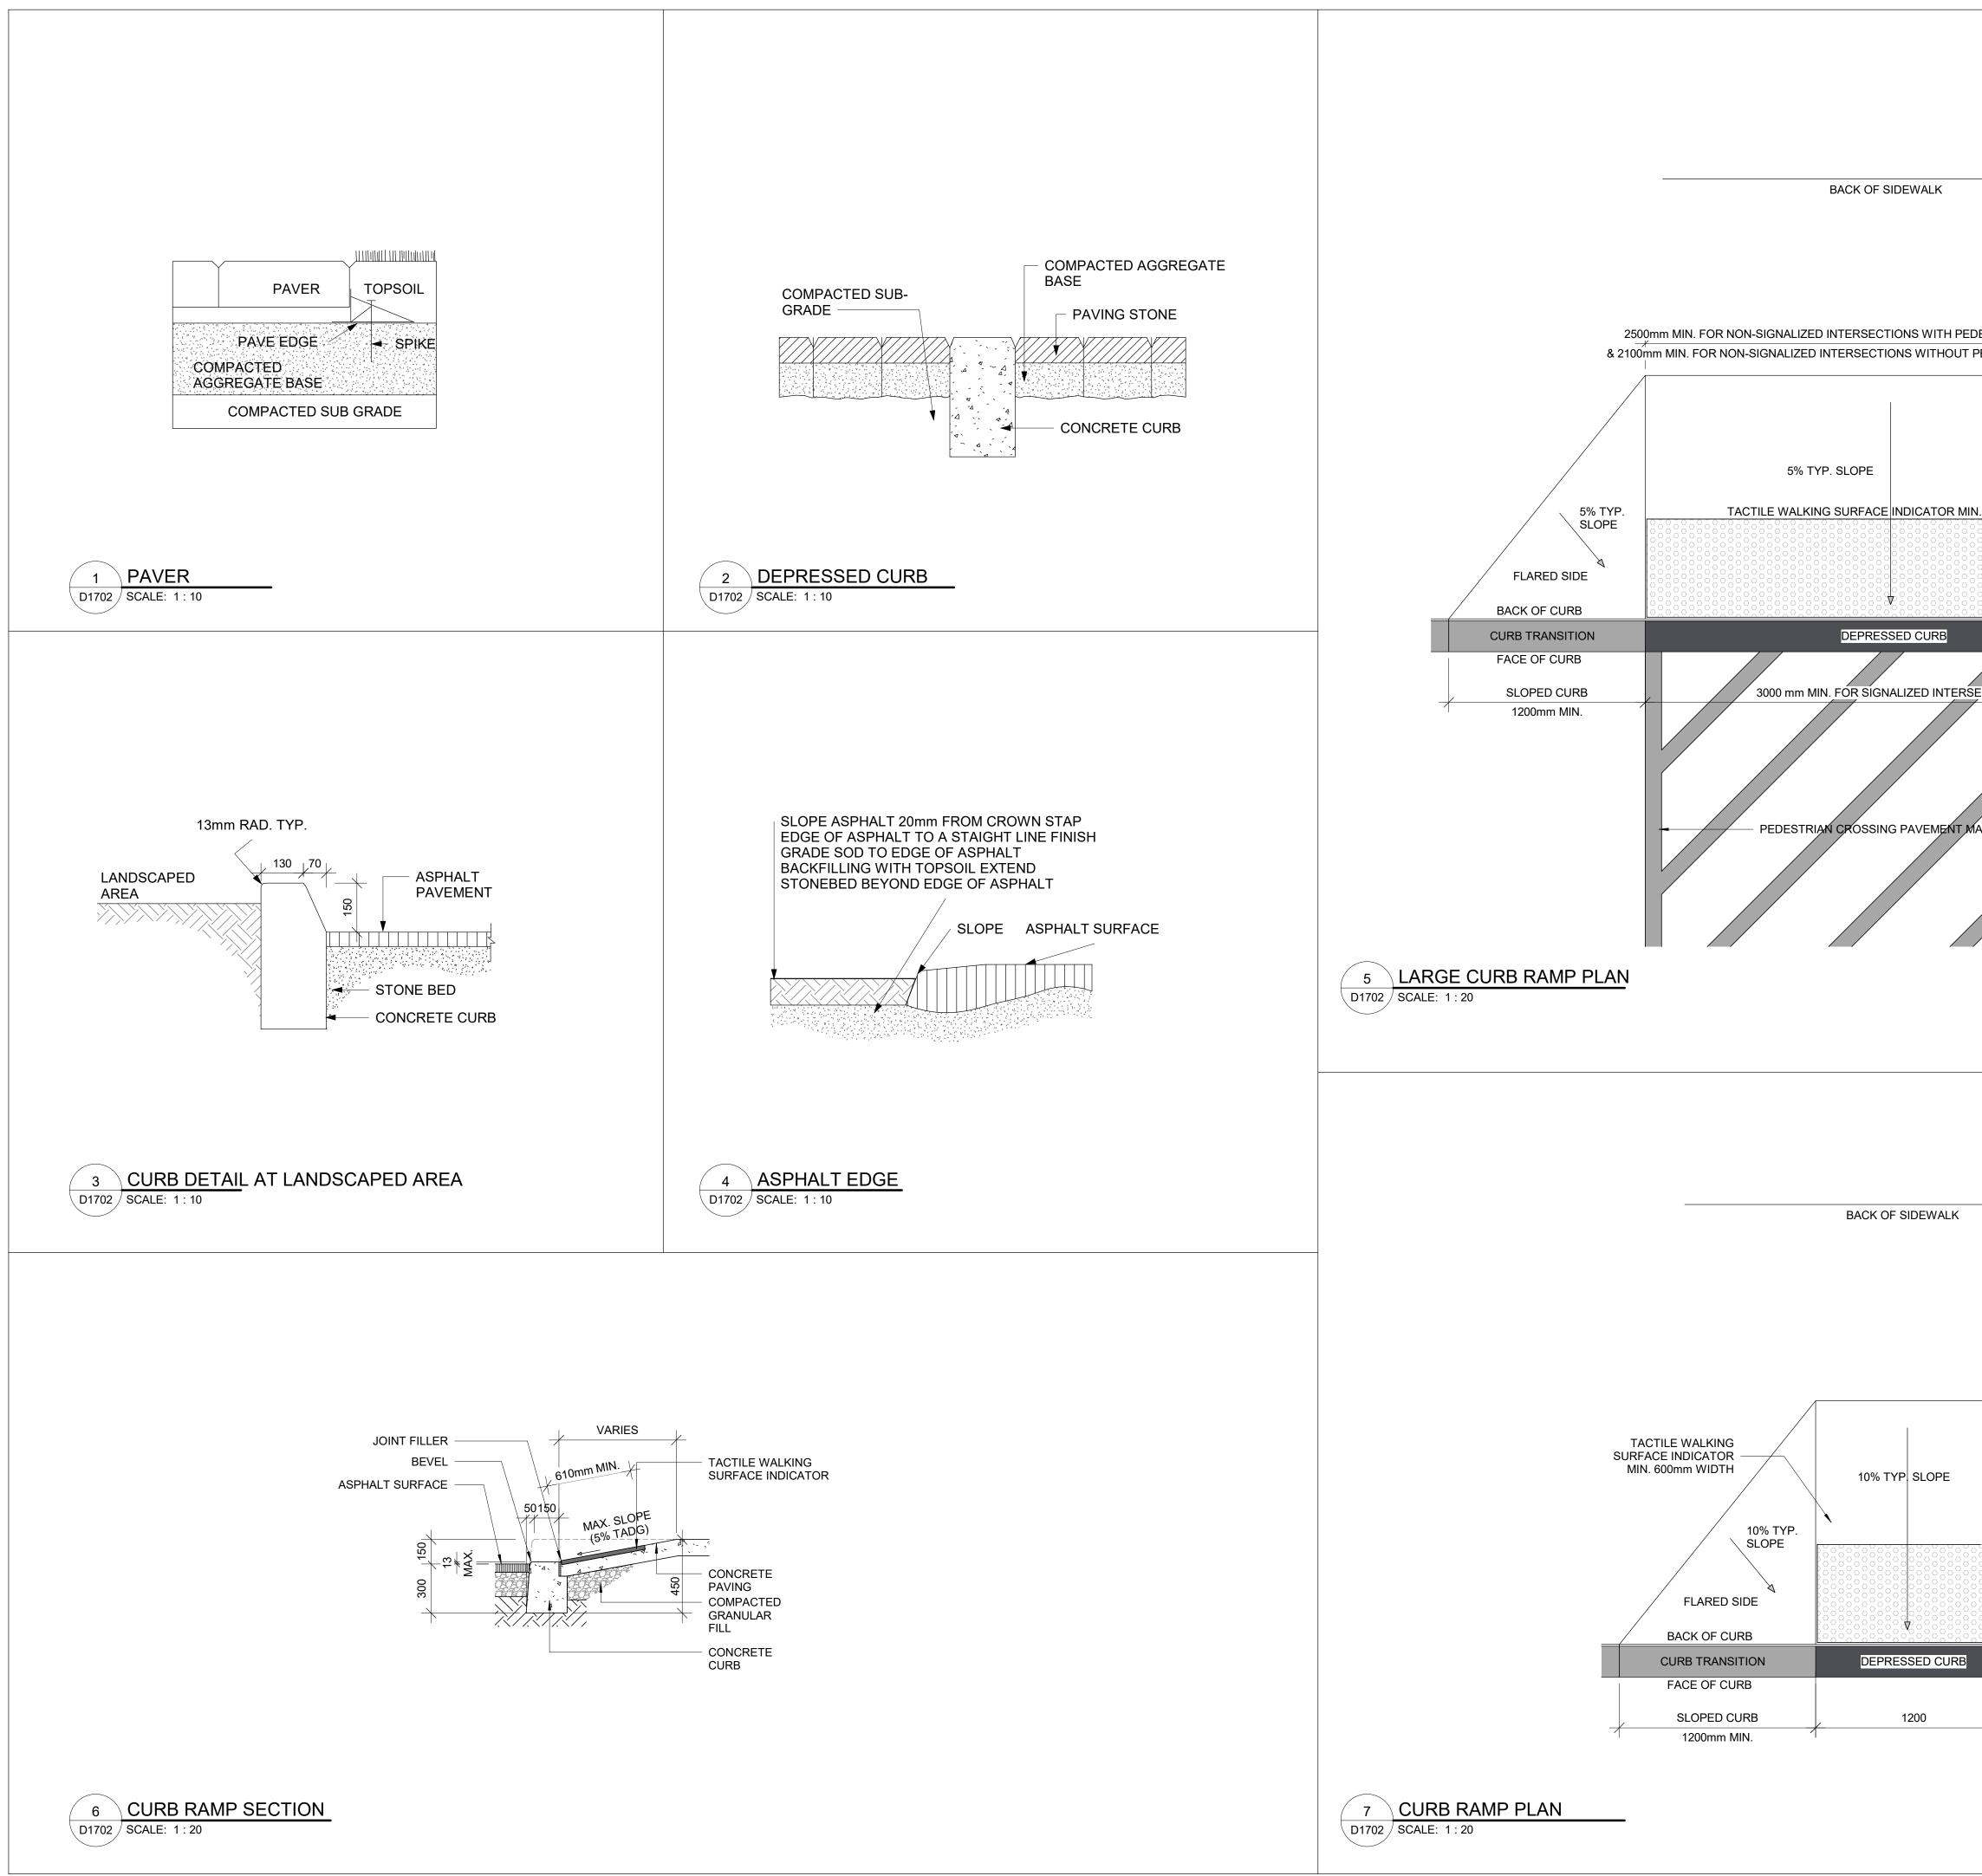


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SQUARE FLUSH MOUNTED TACTILE SQUARE FLUSH MOUNTED TACTILE WITH 'DOWN' SYMBOL & BRAILLE						
UP & DOWN ELEVATOR CALL BUTTON TWO WAY	PRIME CONSULTANT					
COMMUNICATION AND HAND FREE SPEAKER SYSTEM	IBI GROUP 175 Galaxy Blvd, Unit 100 Toronto, ON M9W 0C9, Canada tel 416 679 1930 fax 416 675 46 ibigroup.com	20				
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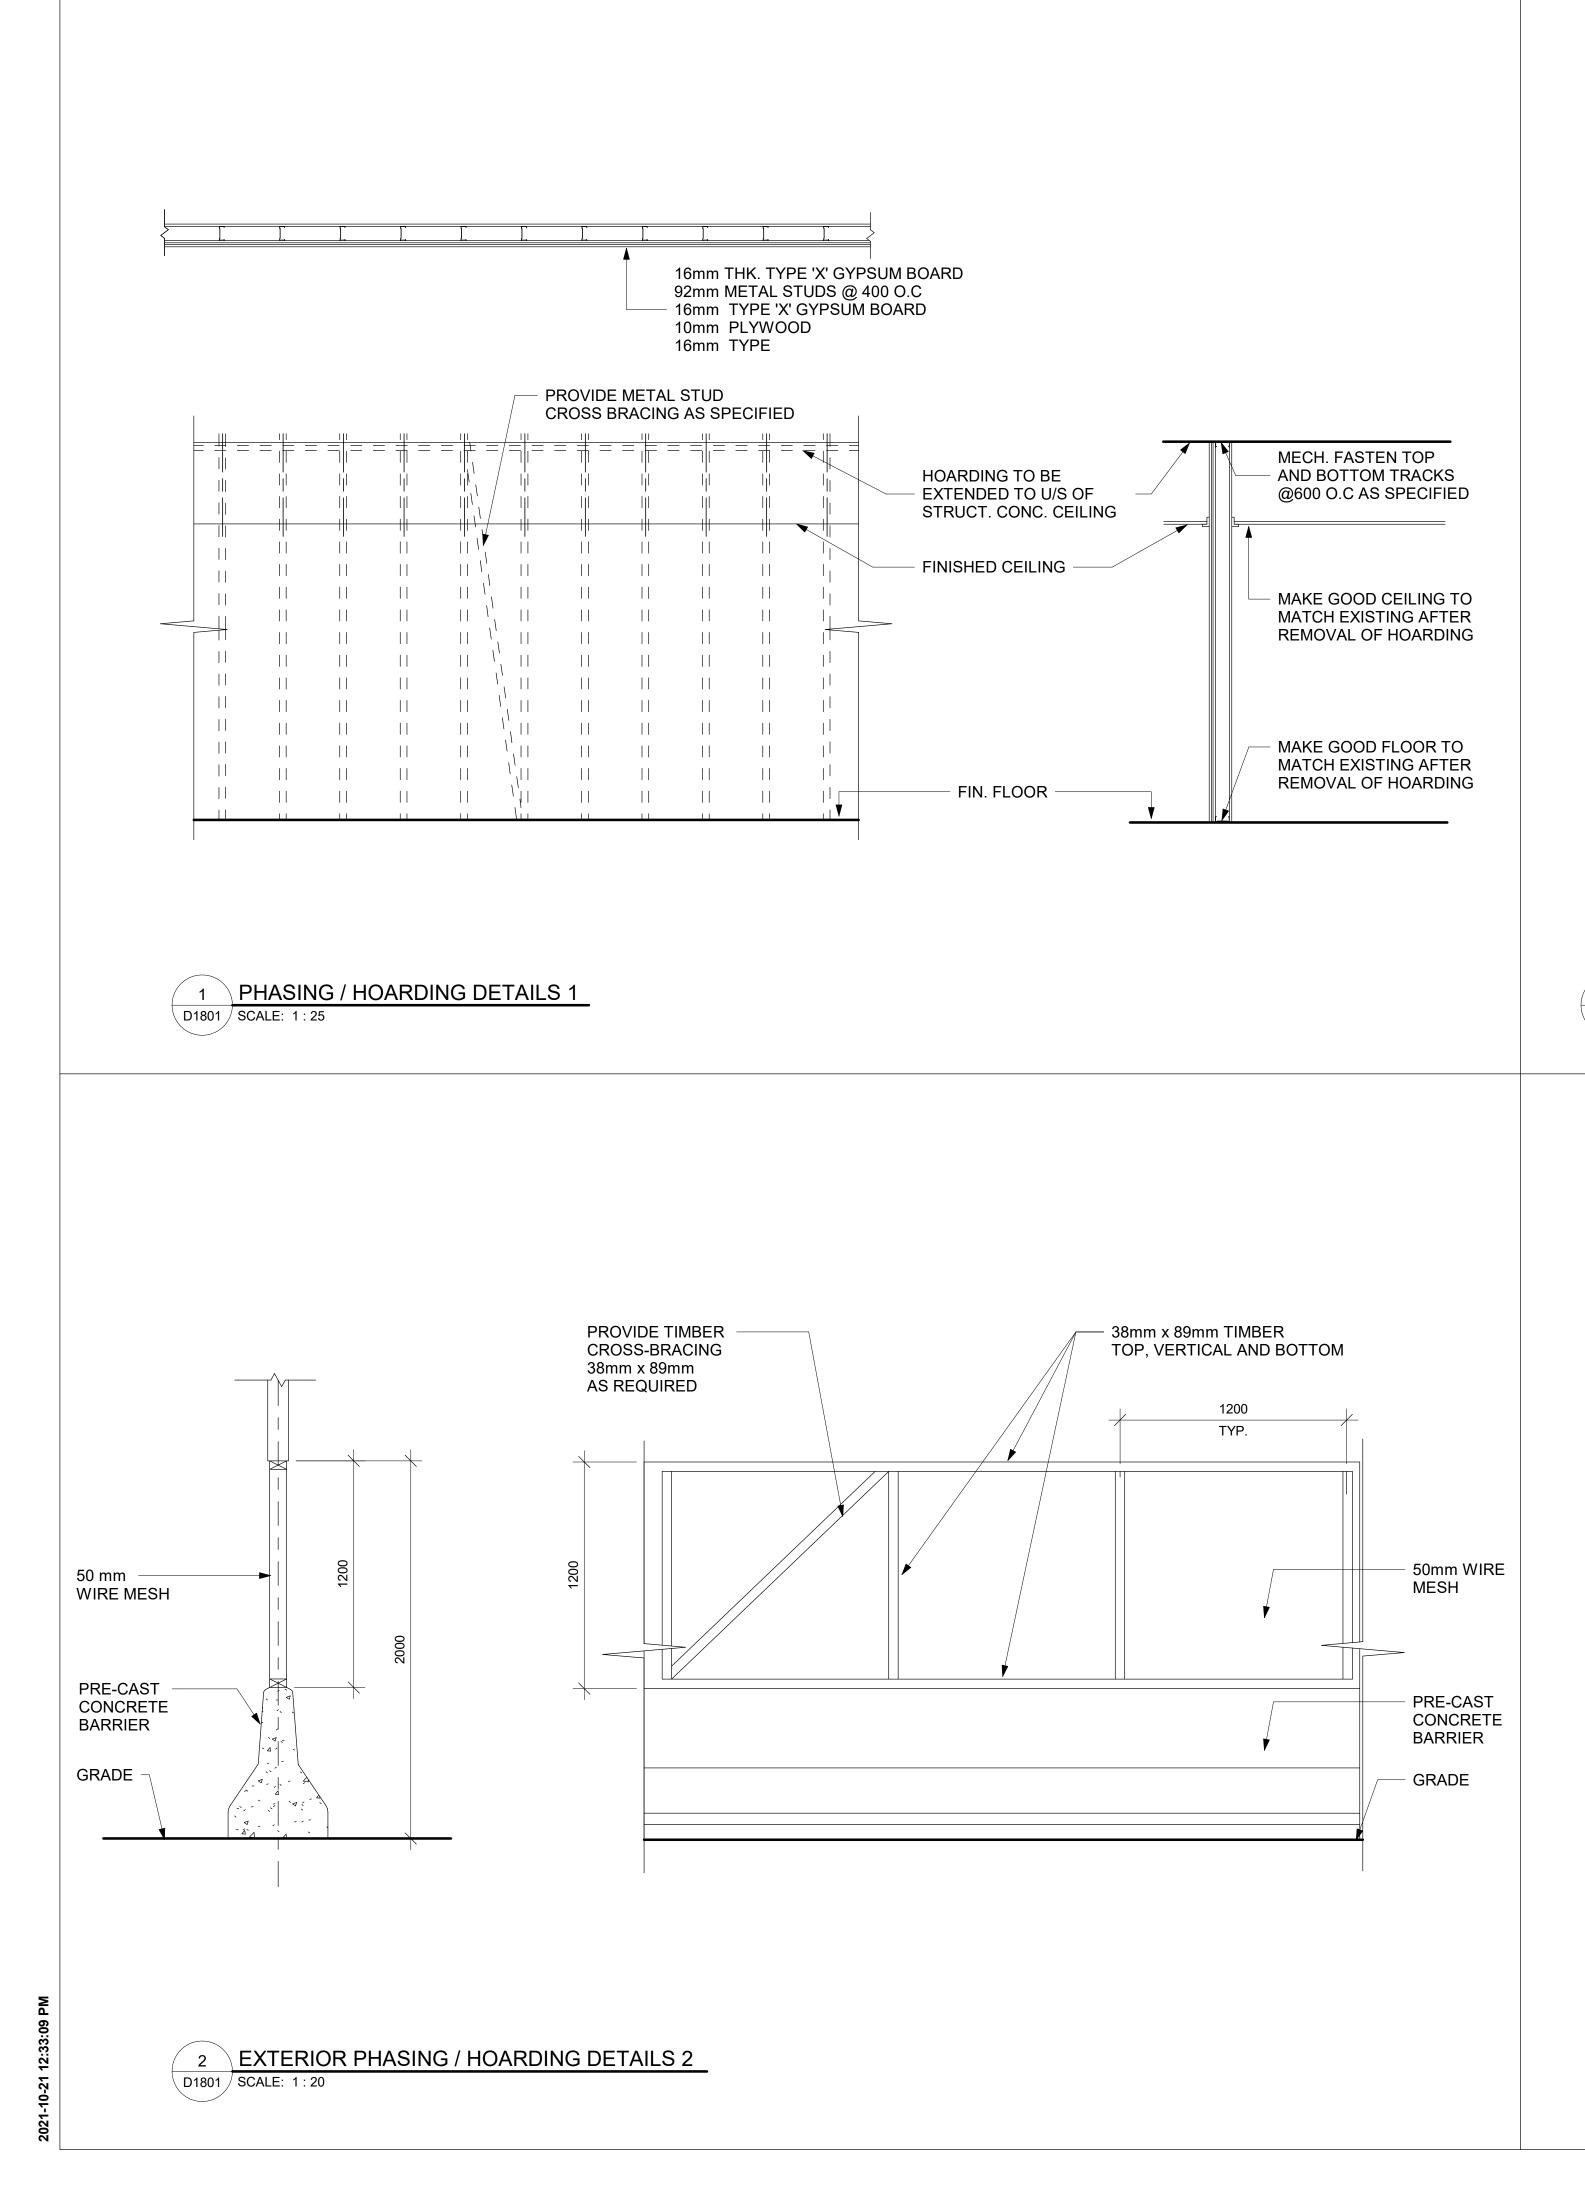


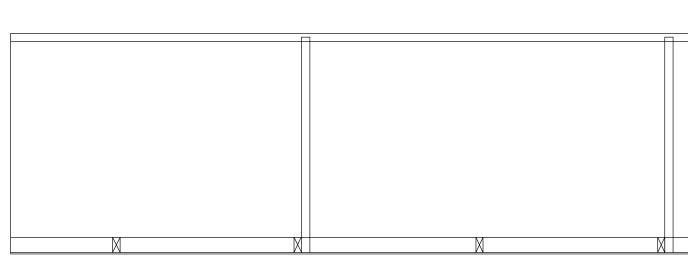


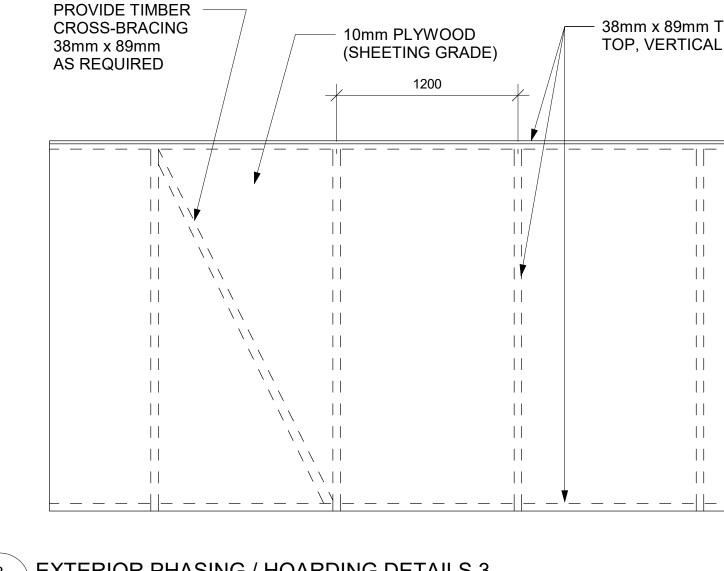


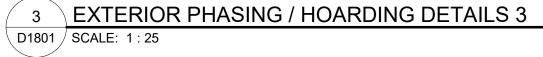
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PRIME CONSULTANT IBI GROUP 175 Galaxy Blvd, Unit 100 Toronto, ON M9W 0C9, Canada 1416 679 1930 fax 416 675 4620 Ibigroup.com PROJECT TITLE CITY OF TORONTO ACCESSIBILITY UPGRADES PROJECT ADDRESS CITY OF TORONTO ACCESSIBILITY UPGRADES PROJECT NO: 9119- 19- 0162 / IBI 122260 DRAWN BY: CHECKED BY: A. BOYNARIAN A. VAN VEEN PROJECT MGR: APPROVED BY: F.BOLOURIAN E. FENUTA SHEET TITLE HOARDING DETAILS
A. DO MARIAN A. VAN VLEIN PROJECT MGR: APPROVED BY: F.BOLOURIAN E. FENUTA SHEET TITLE HOARDING DETAILS SHEET NUMBER ISSUE D1801 00

UNIVERS - CONDENSED Base font used throughout the signage for the City of Toronto

UNIVERS - BOLD CONDENSED Used for numeric identifiers, eg: Stairwell IDs or Building Street Number

GRADE 1 BRAILLE

ABCDEFGHIJKLMNOPQRSTUVWXYZ abcdefghijklmnopqrstuvwxyz 1234567890

ABCDEFGHIJKLMNOPQRSTUVWXYZ abcdefghijklmnopqrstuvwxyz 1234567890

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WHITE

Matthews Acrylic: MP-32071 White Wonder Semi-Gloss Finish

Vinyl 3M7725-20 Opaque Matte White



CITY OF TORONTO BLUE Pantone 647C

Semi-Gloss Finish Vinyl Avery SC95750 Opaque Interstate Blue

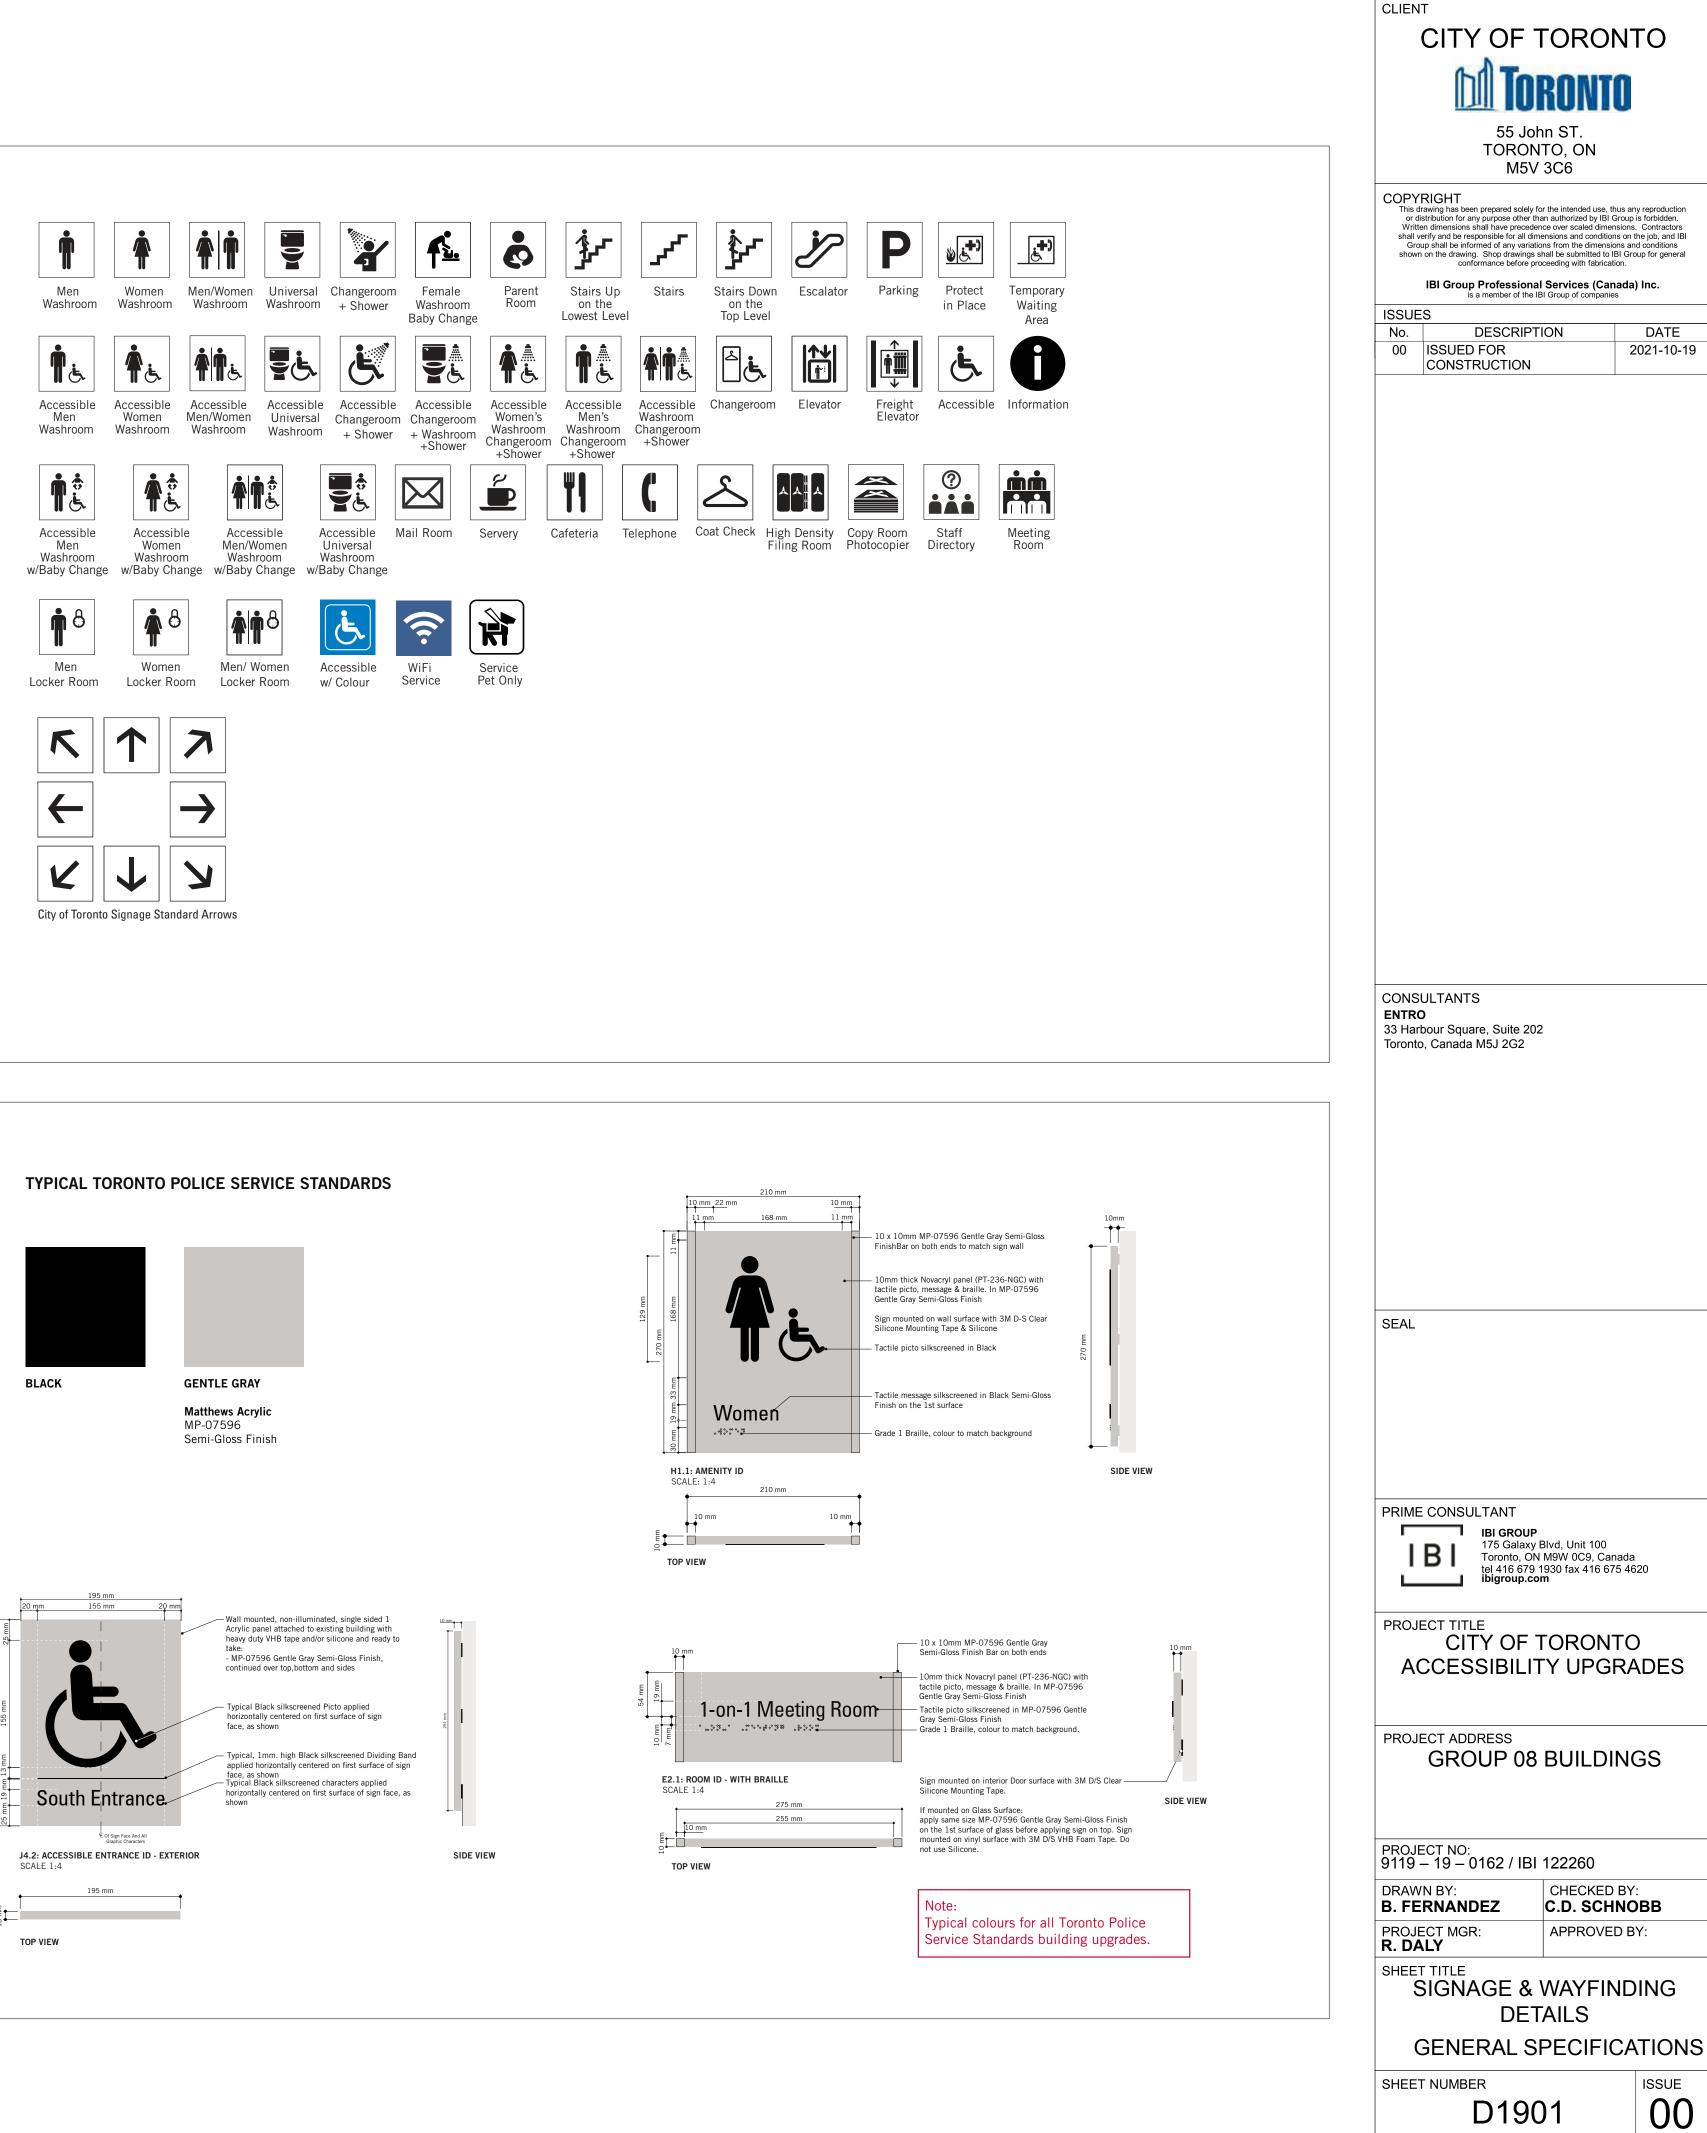
MP-11183 Franco Blue

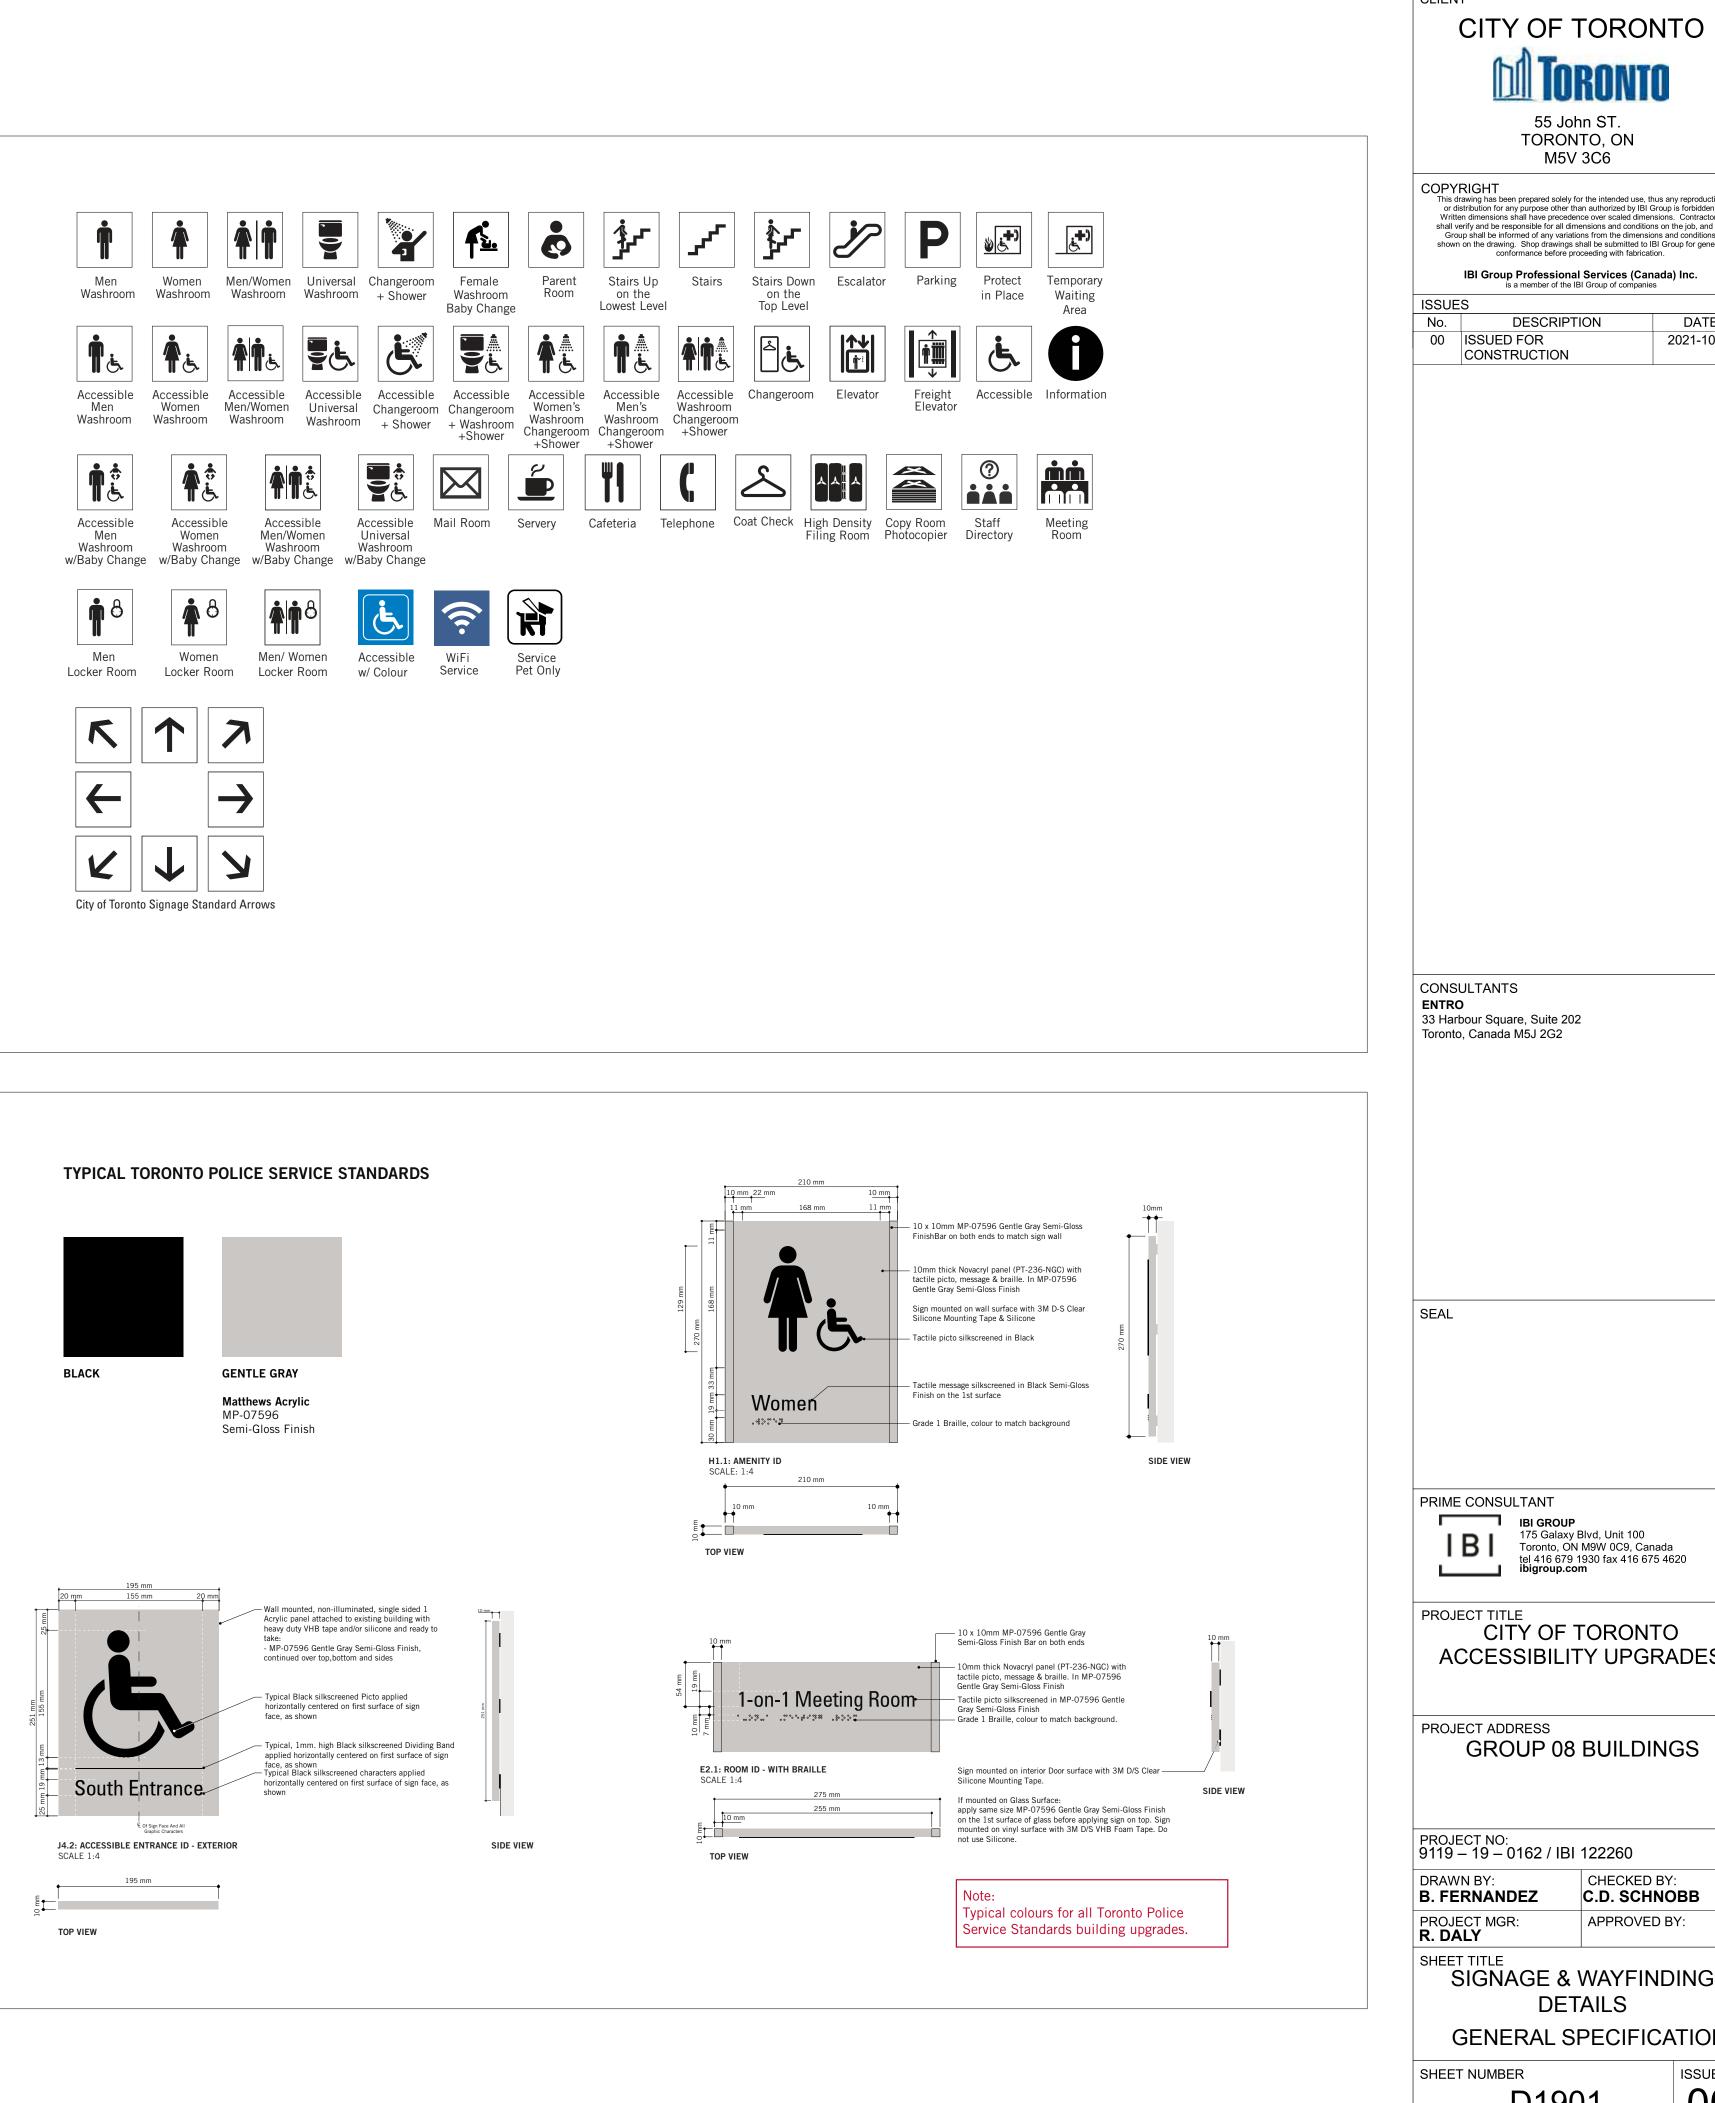
Matthews Acrylic:

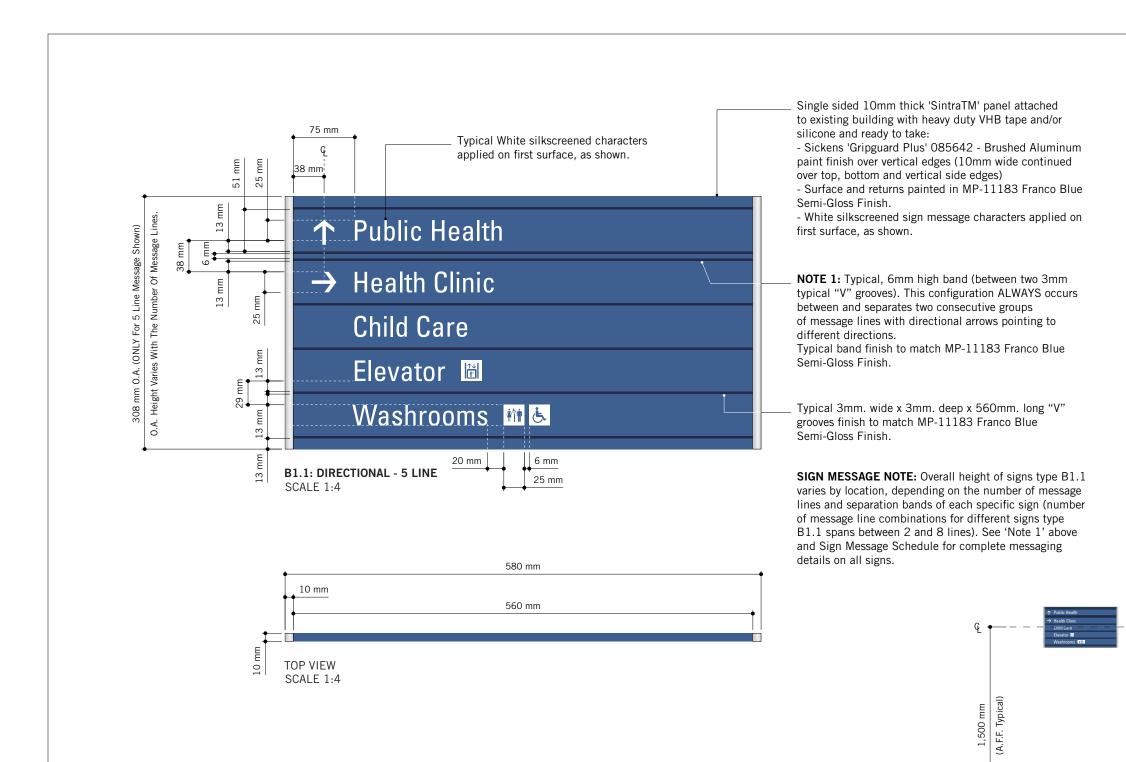
BRUSHED ALUMINUM OR SILVER Pantone 877C Gripguard Plus 085642 Brushed Aluminum Semi-Gloss Finish

Vinyl 3M 180C-220 Opaque Light Silver Metallic Vinyl

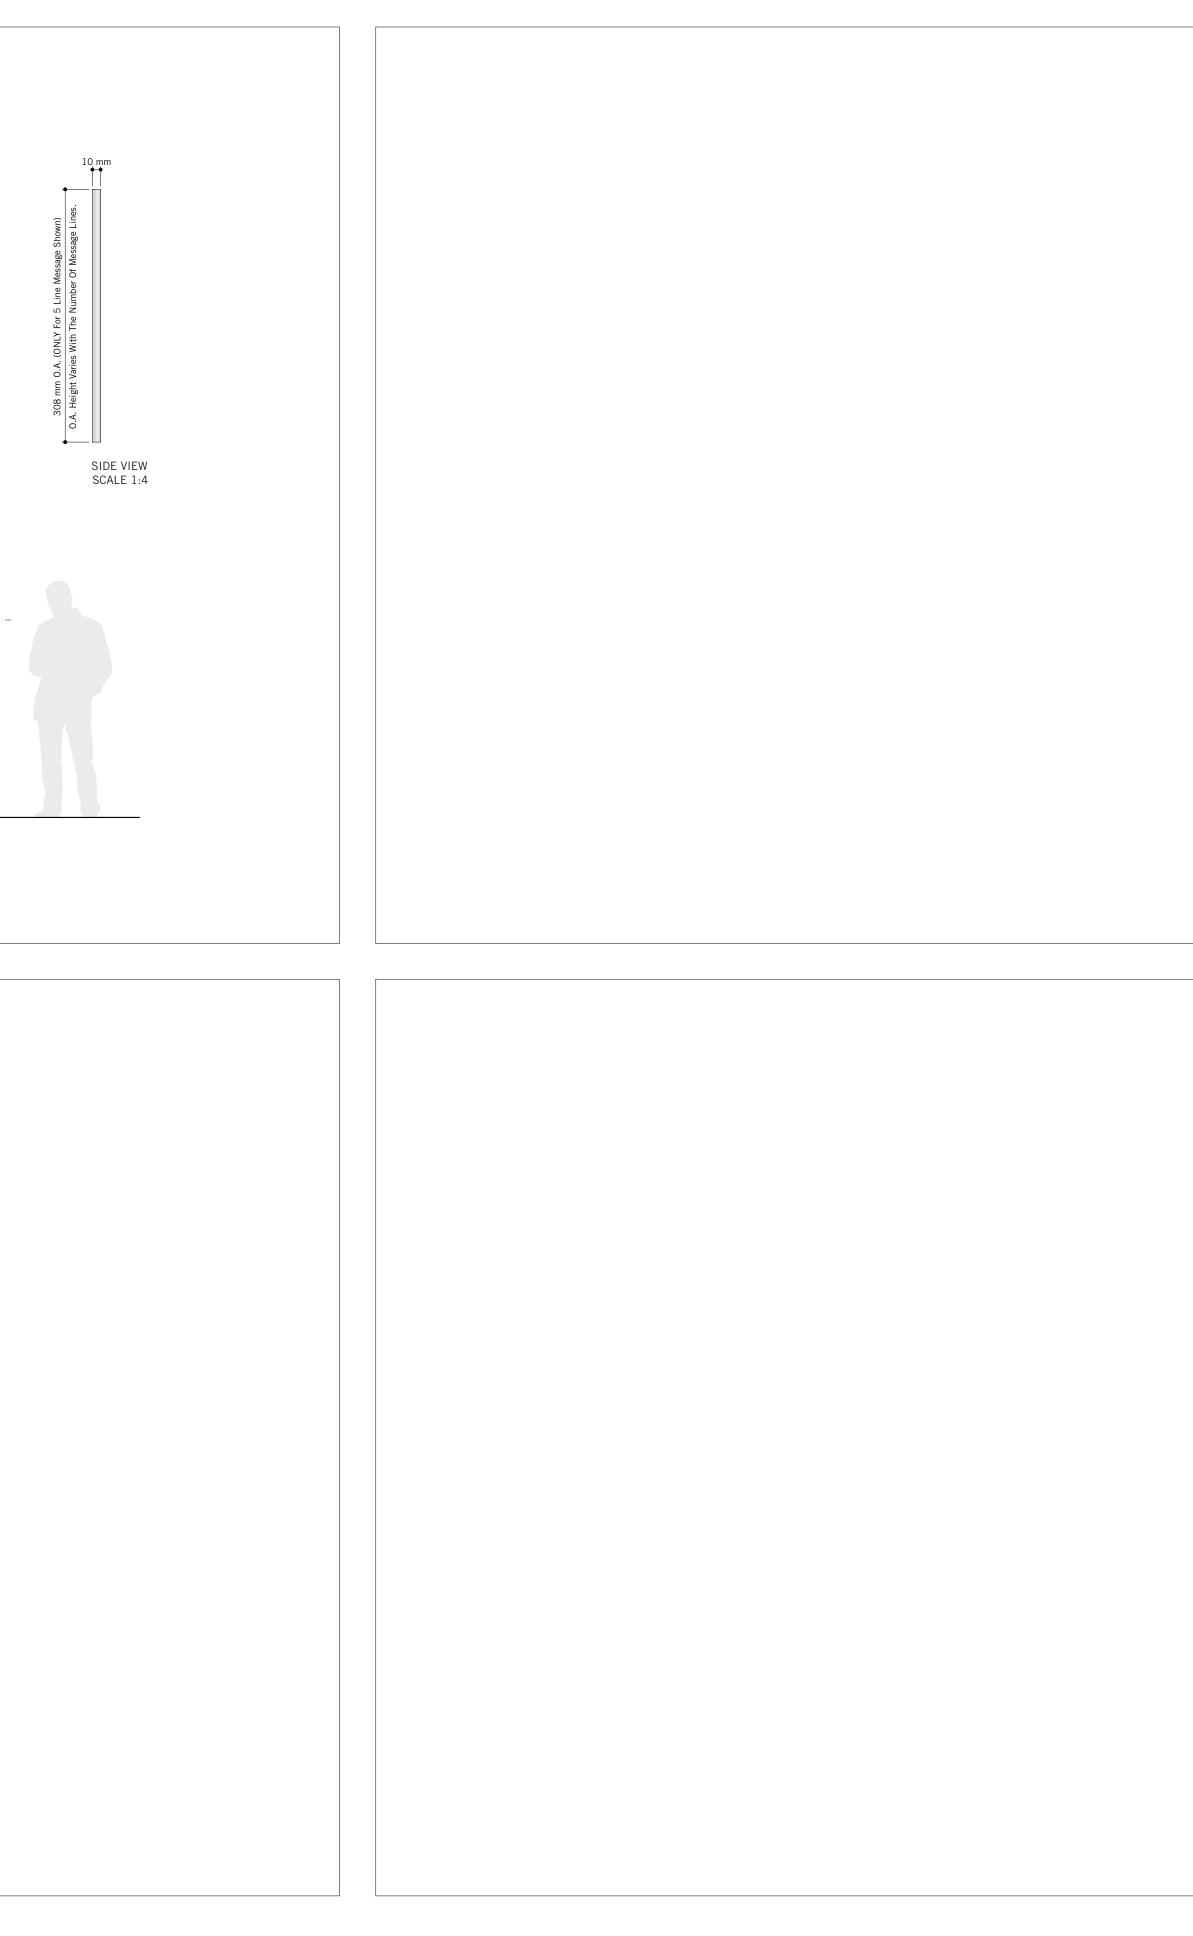




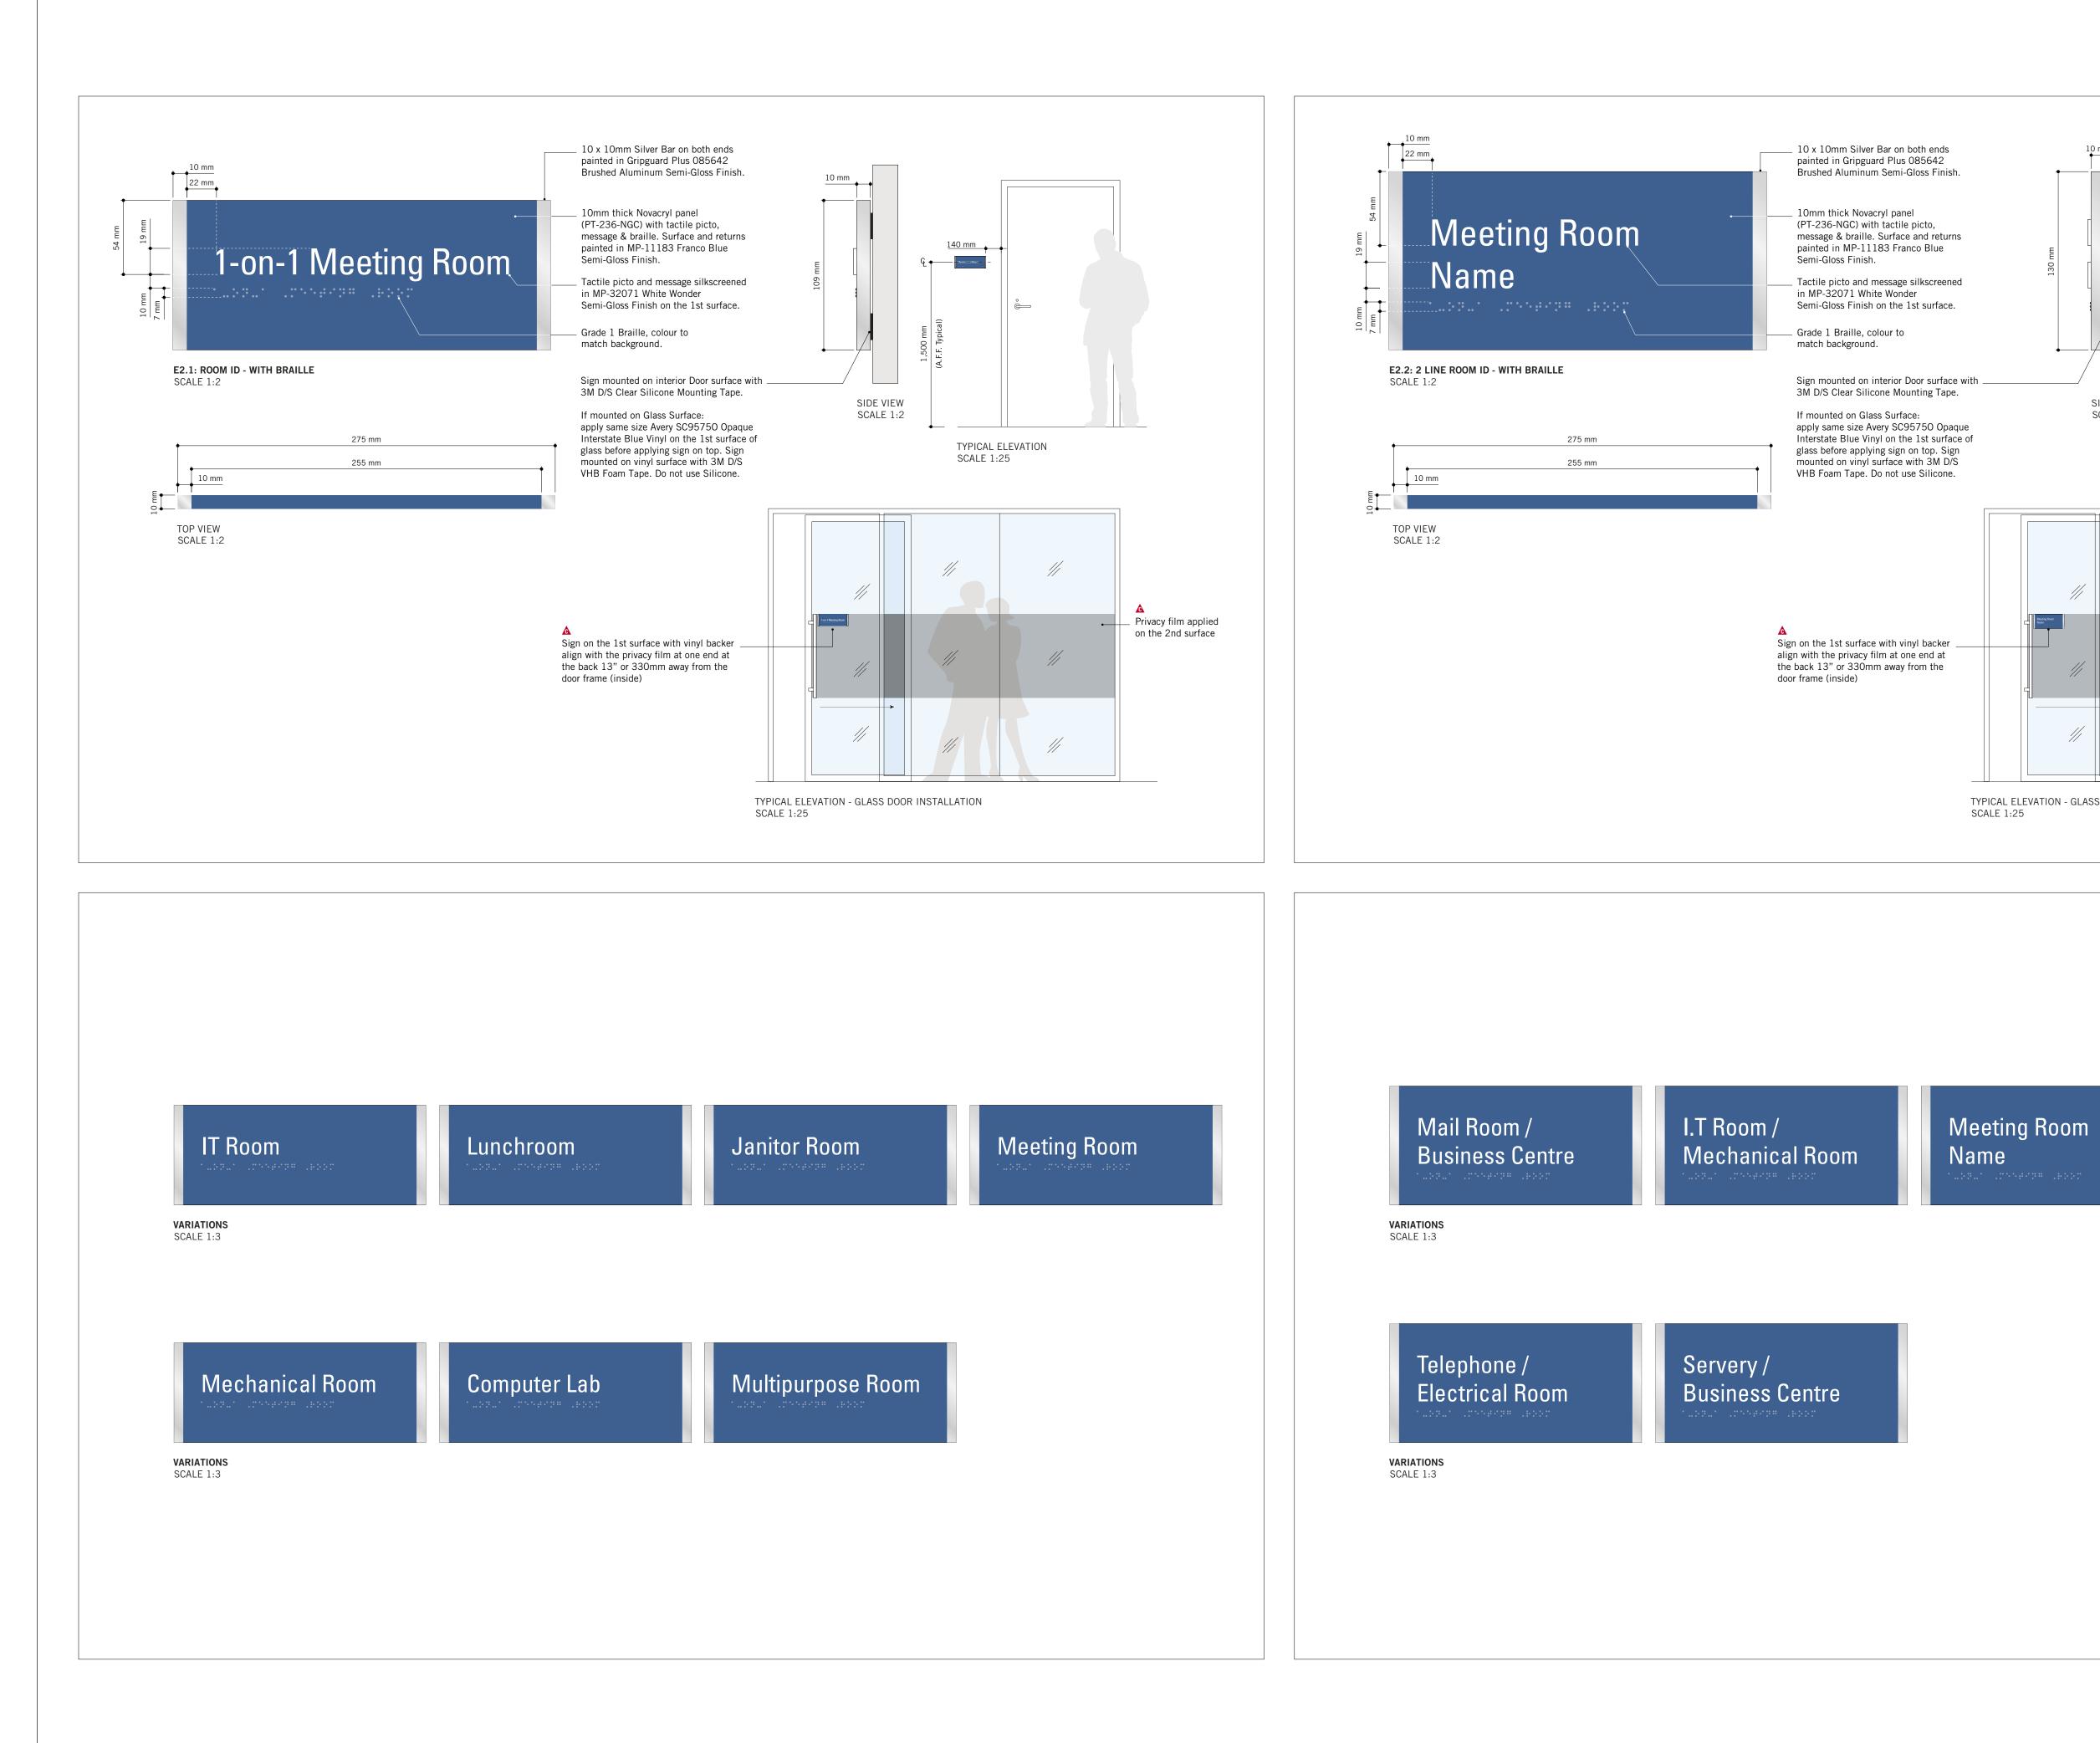


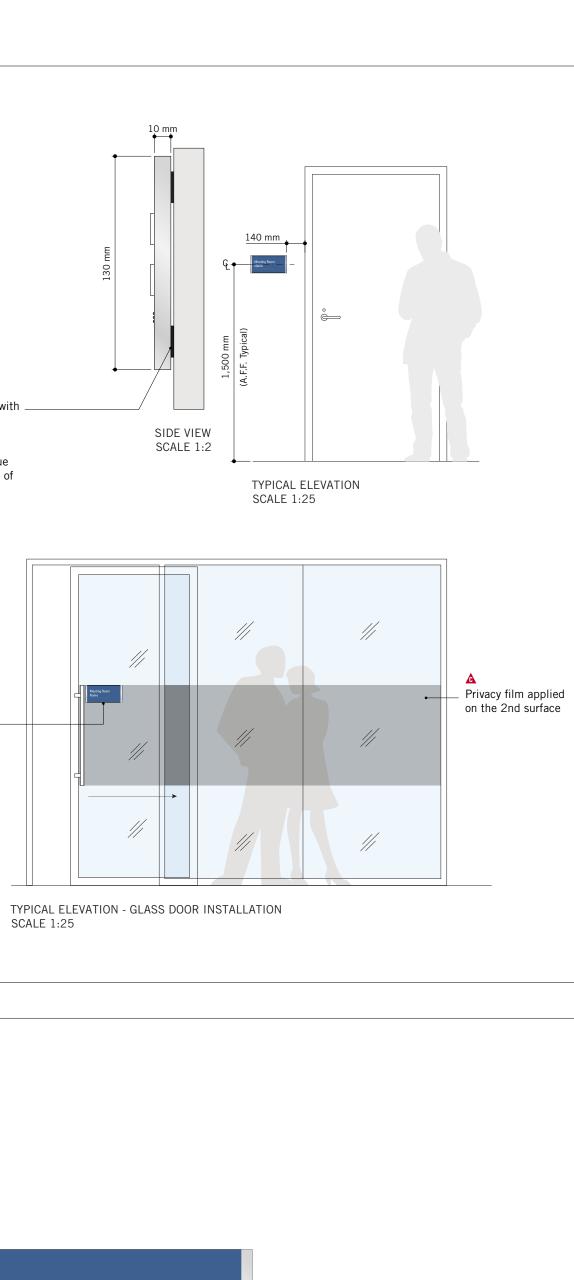




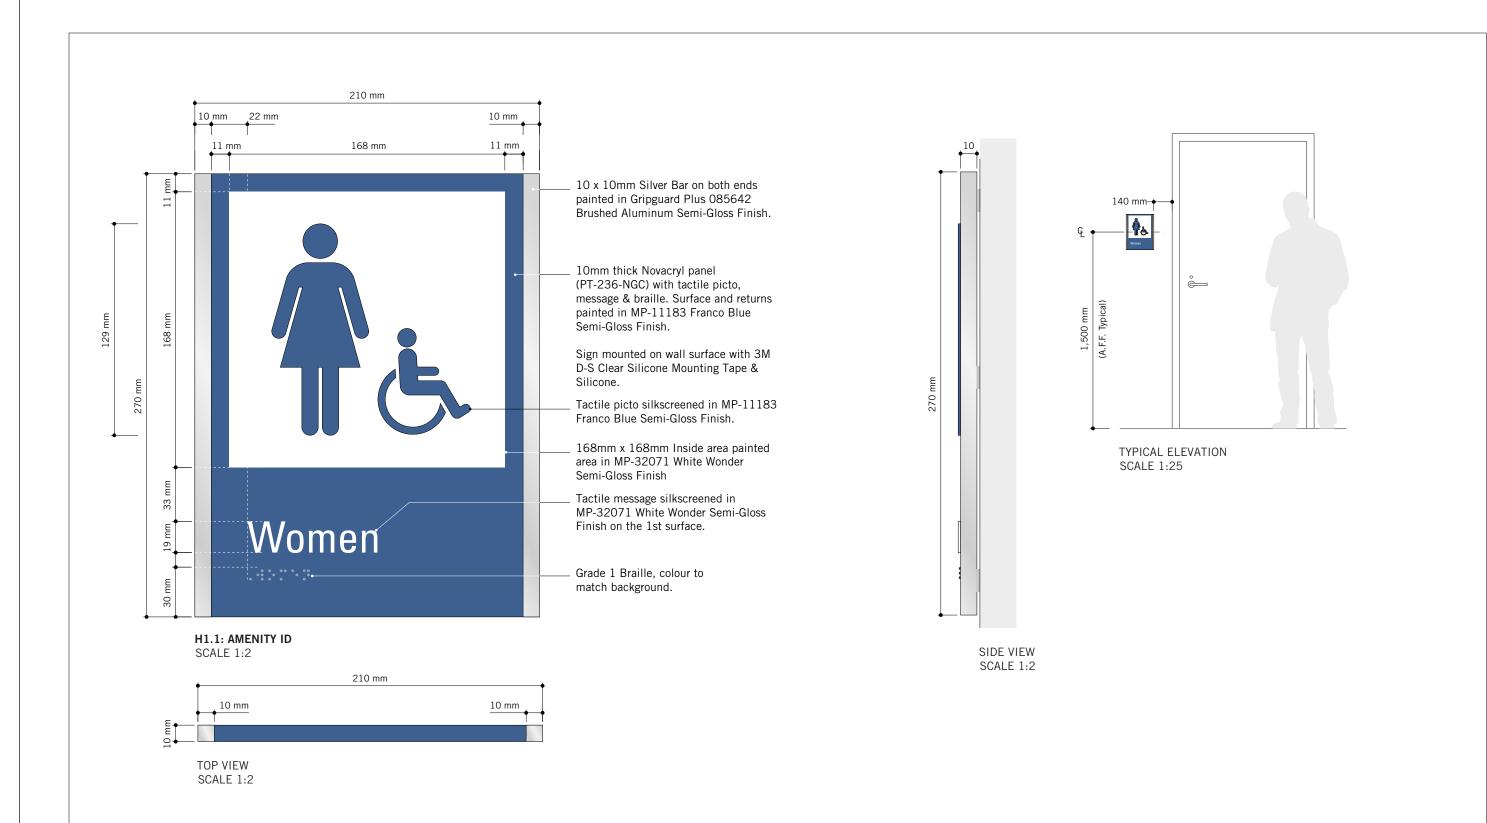


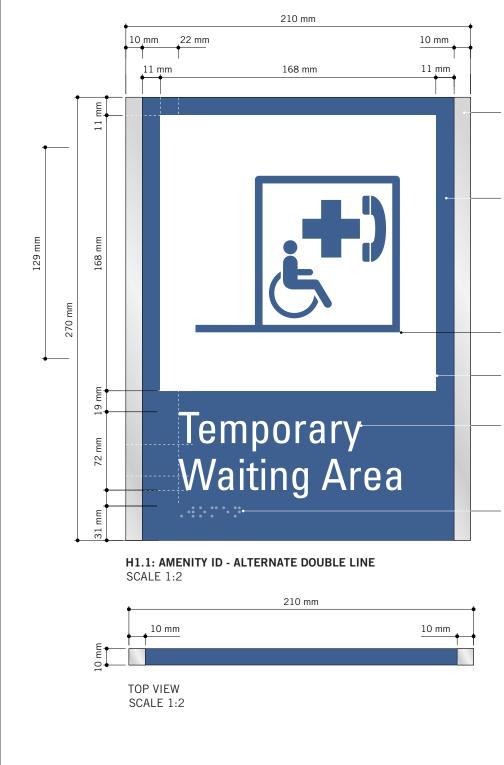
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COPYRIGHT This drawing has been prepared solely for the intended use, thus ar or distribution for any purpose other than authorized by IBI Group Written dimensions shall have precedence over scaled dimensions shall verify and be responsible for all dimensions and conditions on Group shall be informed of any variations from the dimensions ar shown on the drawing. Shop drawings shall be submitted to IBI Group conformance before proceeding with fabrication. IBI Group Professional Services (Canada	is forbidden. 5. Contractors the job, and IBI nd conditions oup for general
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CONSULTANTS ENTRO 33 Harbour Square, Suite 202 Toronto, Canada M5J 2G2	
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IBI GROUP 175 Galaxy Blvd, Unit 100 Toronto, ON M9W 0C9, Canada tel 416 679 1930 fax 416 675 46 ibigroup.com	
PROJECT TITLE CITY OF TORONTO ACCESSIBILITY UPGRA	
PROJECT ADDRESS GROUP 08 BUILDIN	GS
PROJECT NO: 9119 – 19 – 0162 / IBI 122260 DRAWN BY: B. FERNANDEZ C.D. SCHNC PROJECT MGR: R. DALY	DBB
SHEET TITLE SIGNAGE & WAYFIND DETAILS	_
B1.1: DIRECTIONAL SIC SHEET NUMBER D1902	ISSUE





CLIENT





10 x 10mm Silver Bar on both ends painted in Gripguard Plus 085642 Brushed Aluminum Semi-Gloss Finish.

10mm thick Novacryl panel (PT-236-NGC) with tactile picto, message & braille. Surface and returns painted in MP-11183 Franco Blue Semi-Gloss Finish.

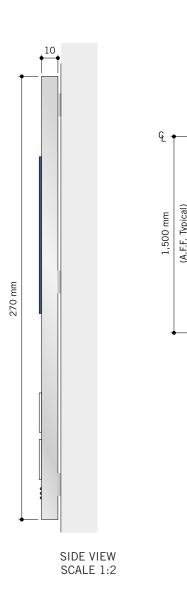
Sign mounted on wall surface with 3M D-S Clear Silicone Mounting Tape & Silicone.

_ Tactile picto silkscreened in MP-11183 Franco Blue Semi-Gloss Finish.

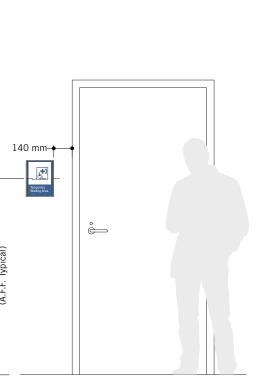
168mm x 168mm Inside area painted area in MP-32071 White Wonder Semi-Gloss Finish

_ Tactile message silkscreened in MP-32071 White Wonder Semi-Gloss Finish on the 1st surface.

Grade 1 Braille, colour to match background.

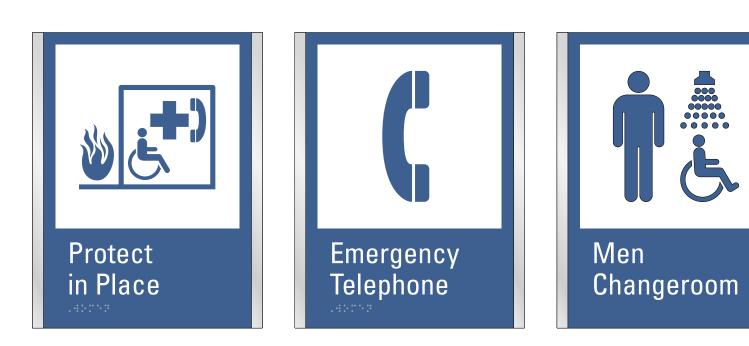


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TYPICAL ELEVATION SCALE 1:25

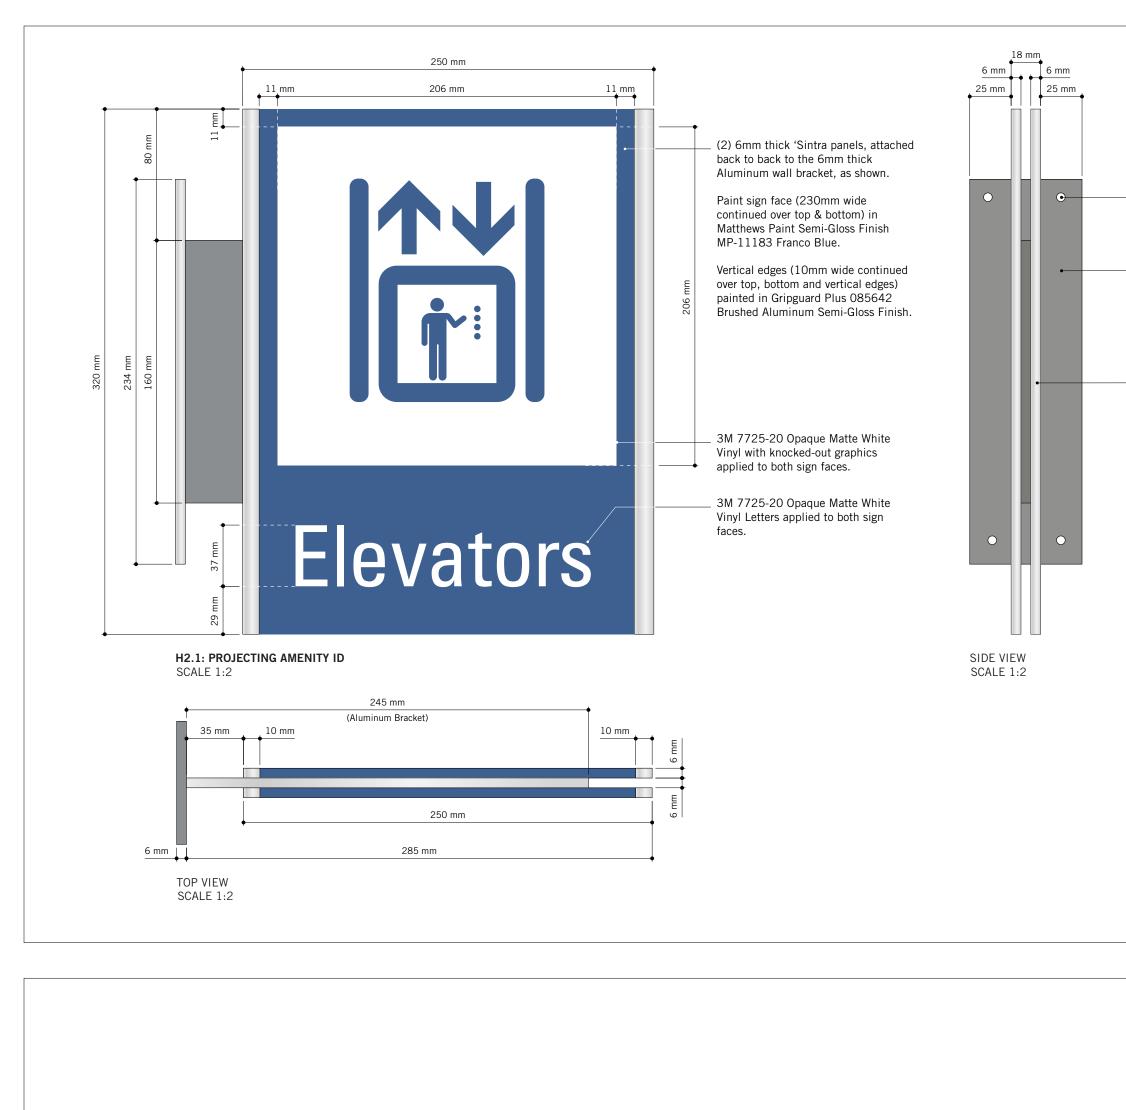




VARIATIONS SCALE 1:3

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CLIENT CITY OF TORON TORONTO 55 John ST. TORONTO, ON	
COPYRIGHT This drawing has been prepared solely for the intended use, thus a or distribution for any purpose other than authorized by IBI Group Written dimensions shall have precedence over scaled dimensions shall verify and be responsible for all dimensions and conditions on Group shall be informed of any variations from the dimensions at shown on the drawing. Shop drawings shall be submitted to IBI Group Orfeessional Services (Canada is a member of the IBI Group of companies)	 is forbidden. contractors the job, and IBI nd conditions oup for general
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PROJECT ADDRESS GROUP 08 BUILDIN	GS
PROJECT NO: 9119 – 19 – 0162 / IBI 122260 DRAWN BY: B. FERNANDEZ PROJECT MGR: R. DALY C.D. SCHNC	DBB
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SHEET NUMBER D1904	ISSUE



(4) 1/4" C/S Toggle bolts into existing drywall (TBC). Heads painted to match.

 6mm (1/4") thick Aluminum Wall Plate Painted in Gripguard Plus 085642 Brushed Aluminum.
 C/W (2) grooves to accept aluminum support bracket - welded through plate.

 (2) 6mm thick Sintra panels, attached back to back to 6mm thick Aluminum bracket.



TYPICAL ELEVATION SCALE 1:25



VARIATIONS SCALE 1:4

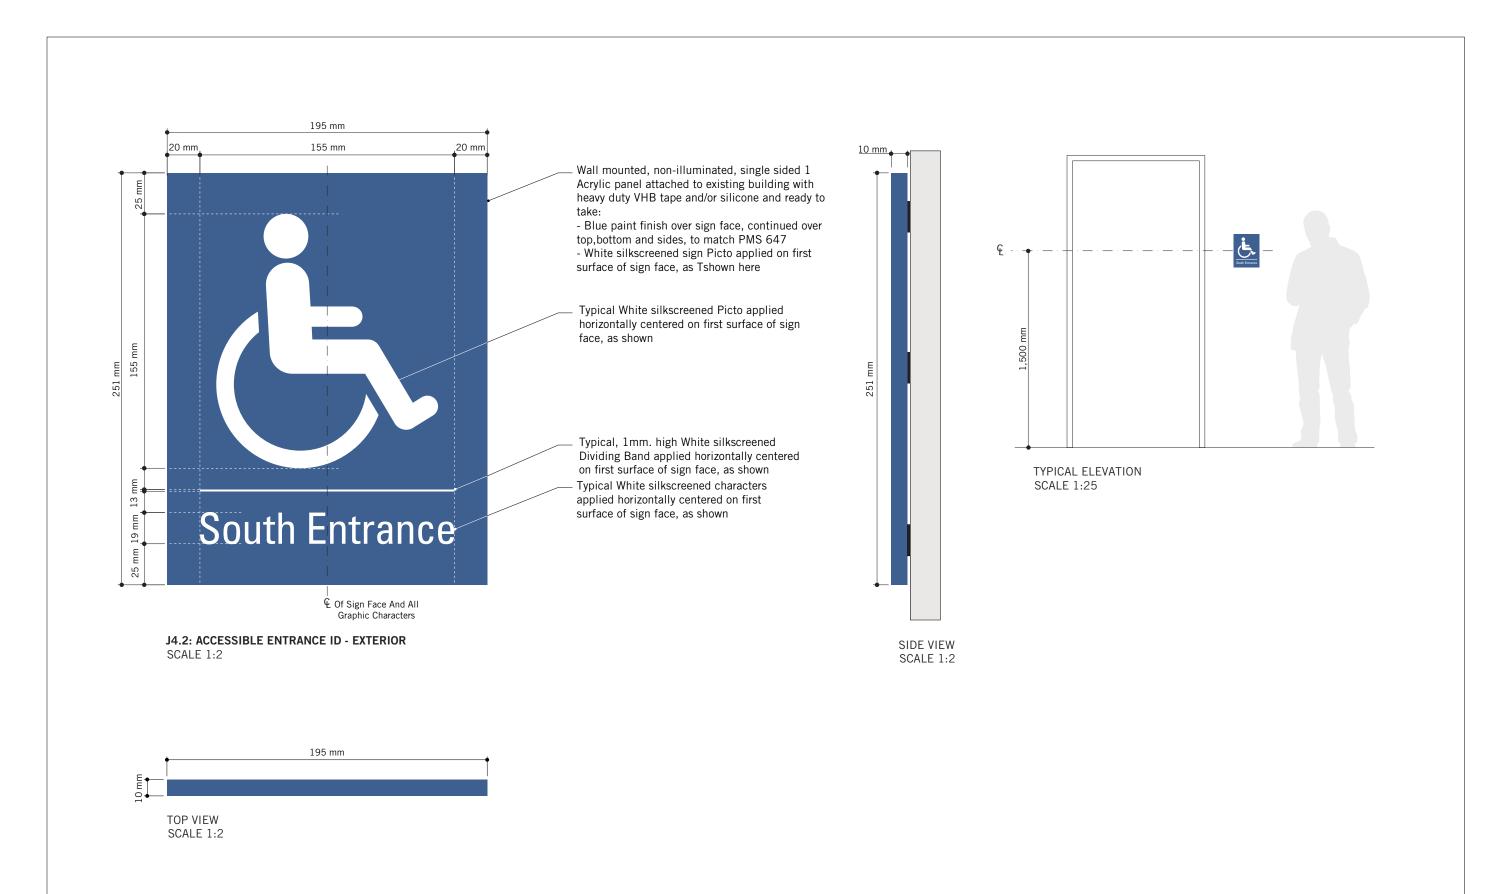


VARIATIONS SCALE 1:4





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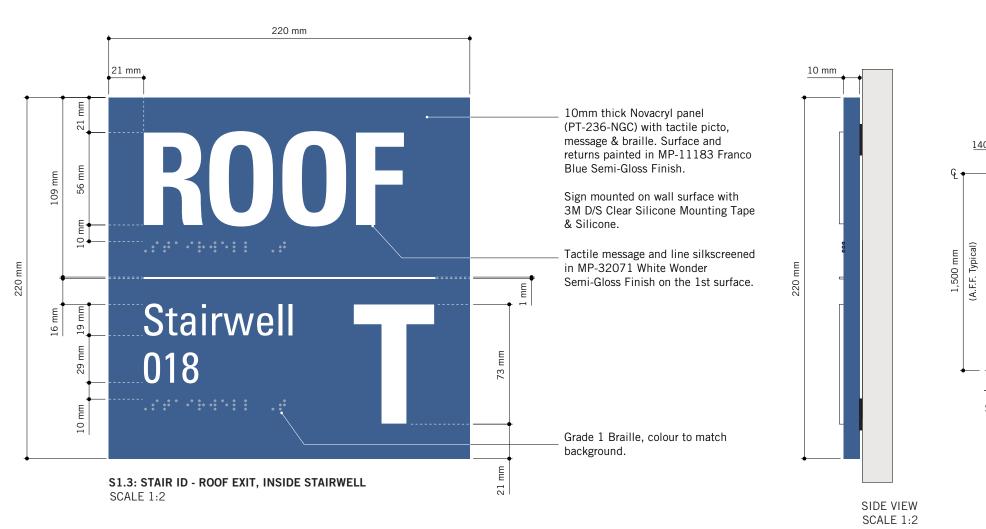
VARIATIONS SCALE 1:3

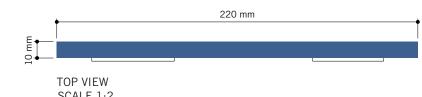




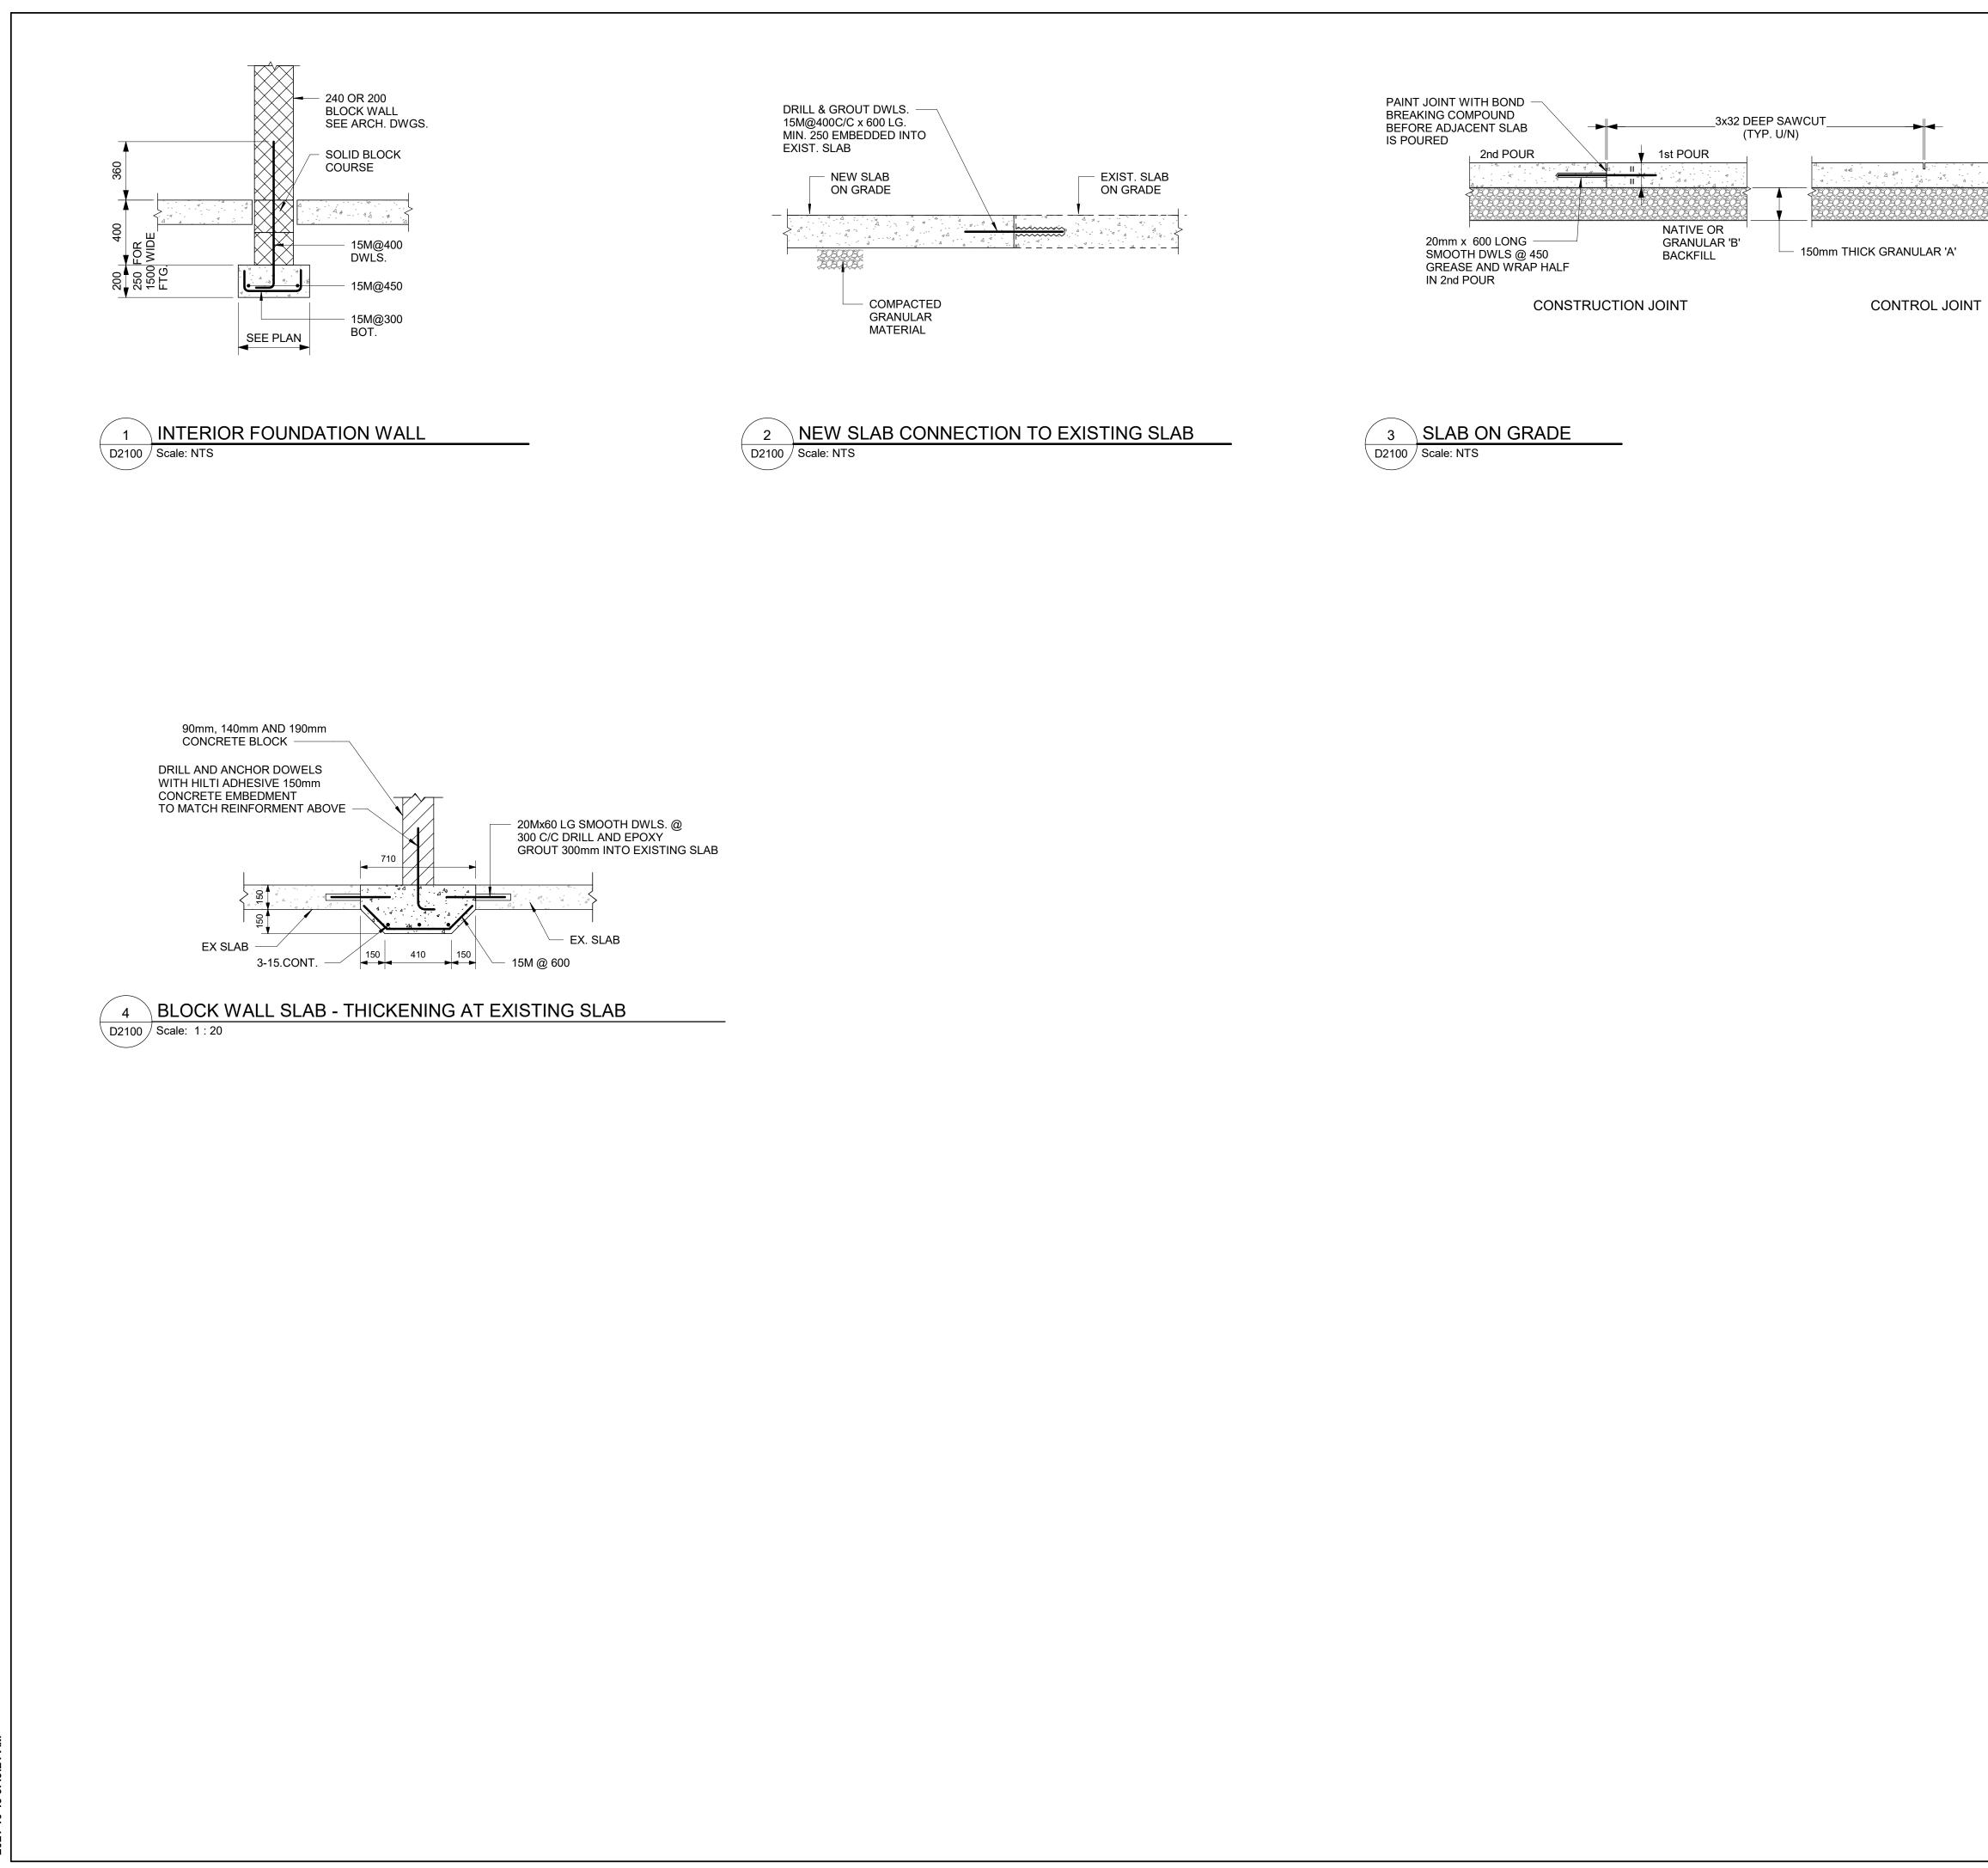
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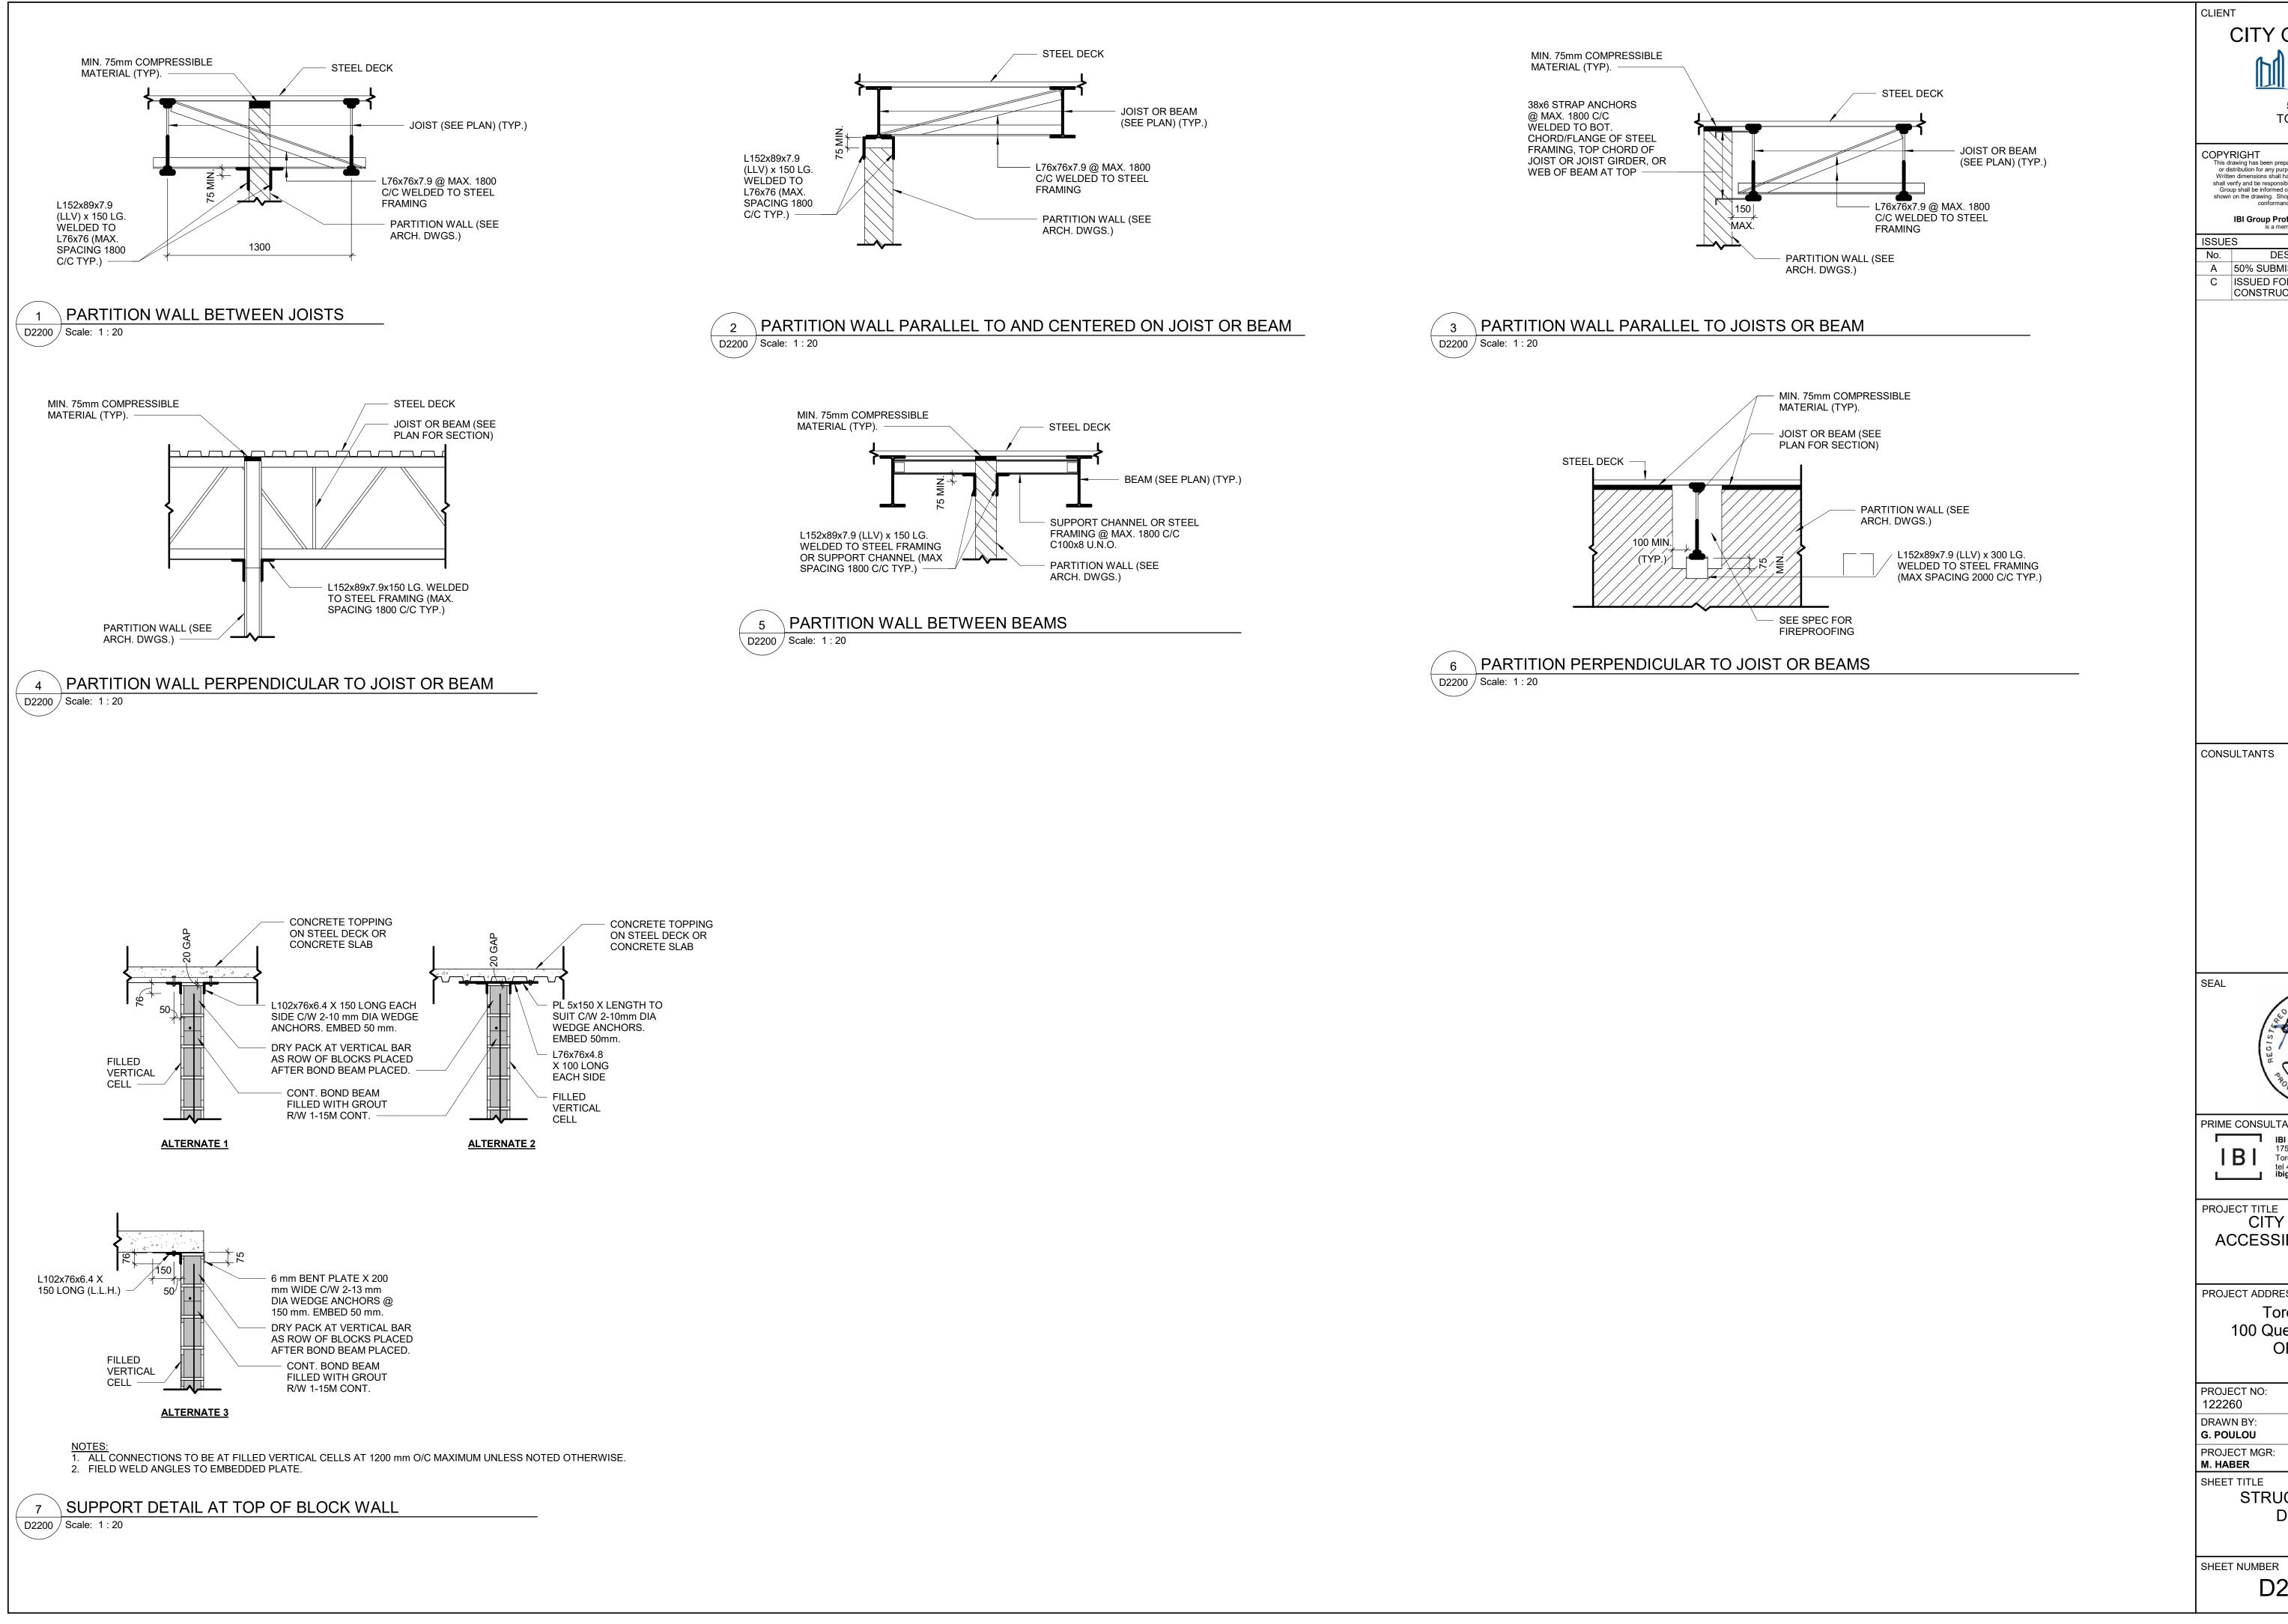




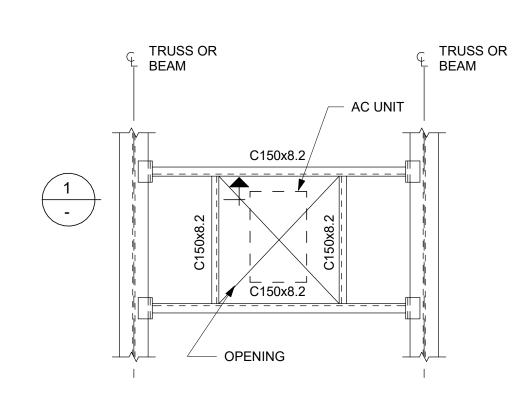
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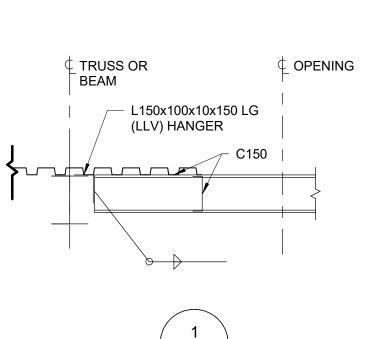
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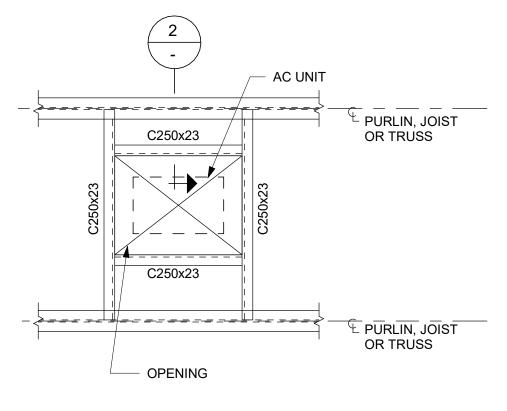
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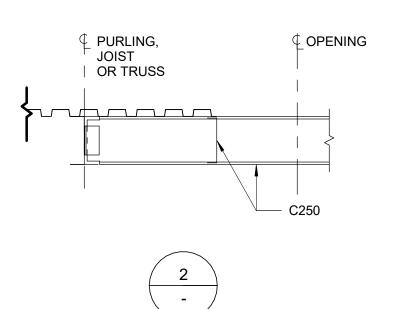




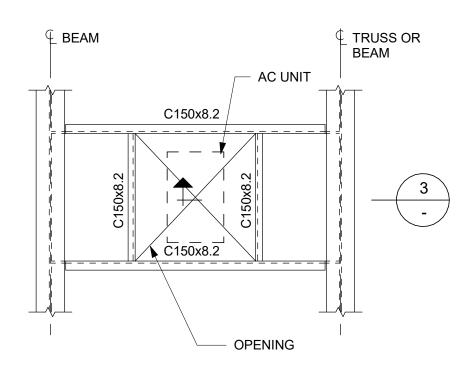
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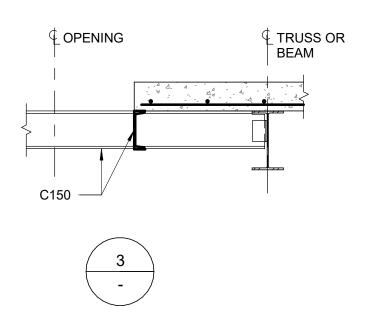
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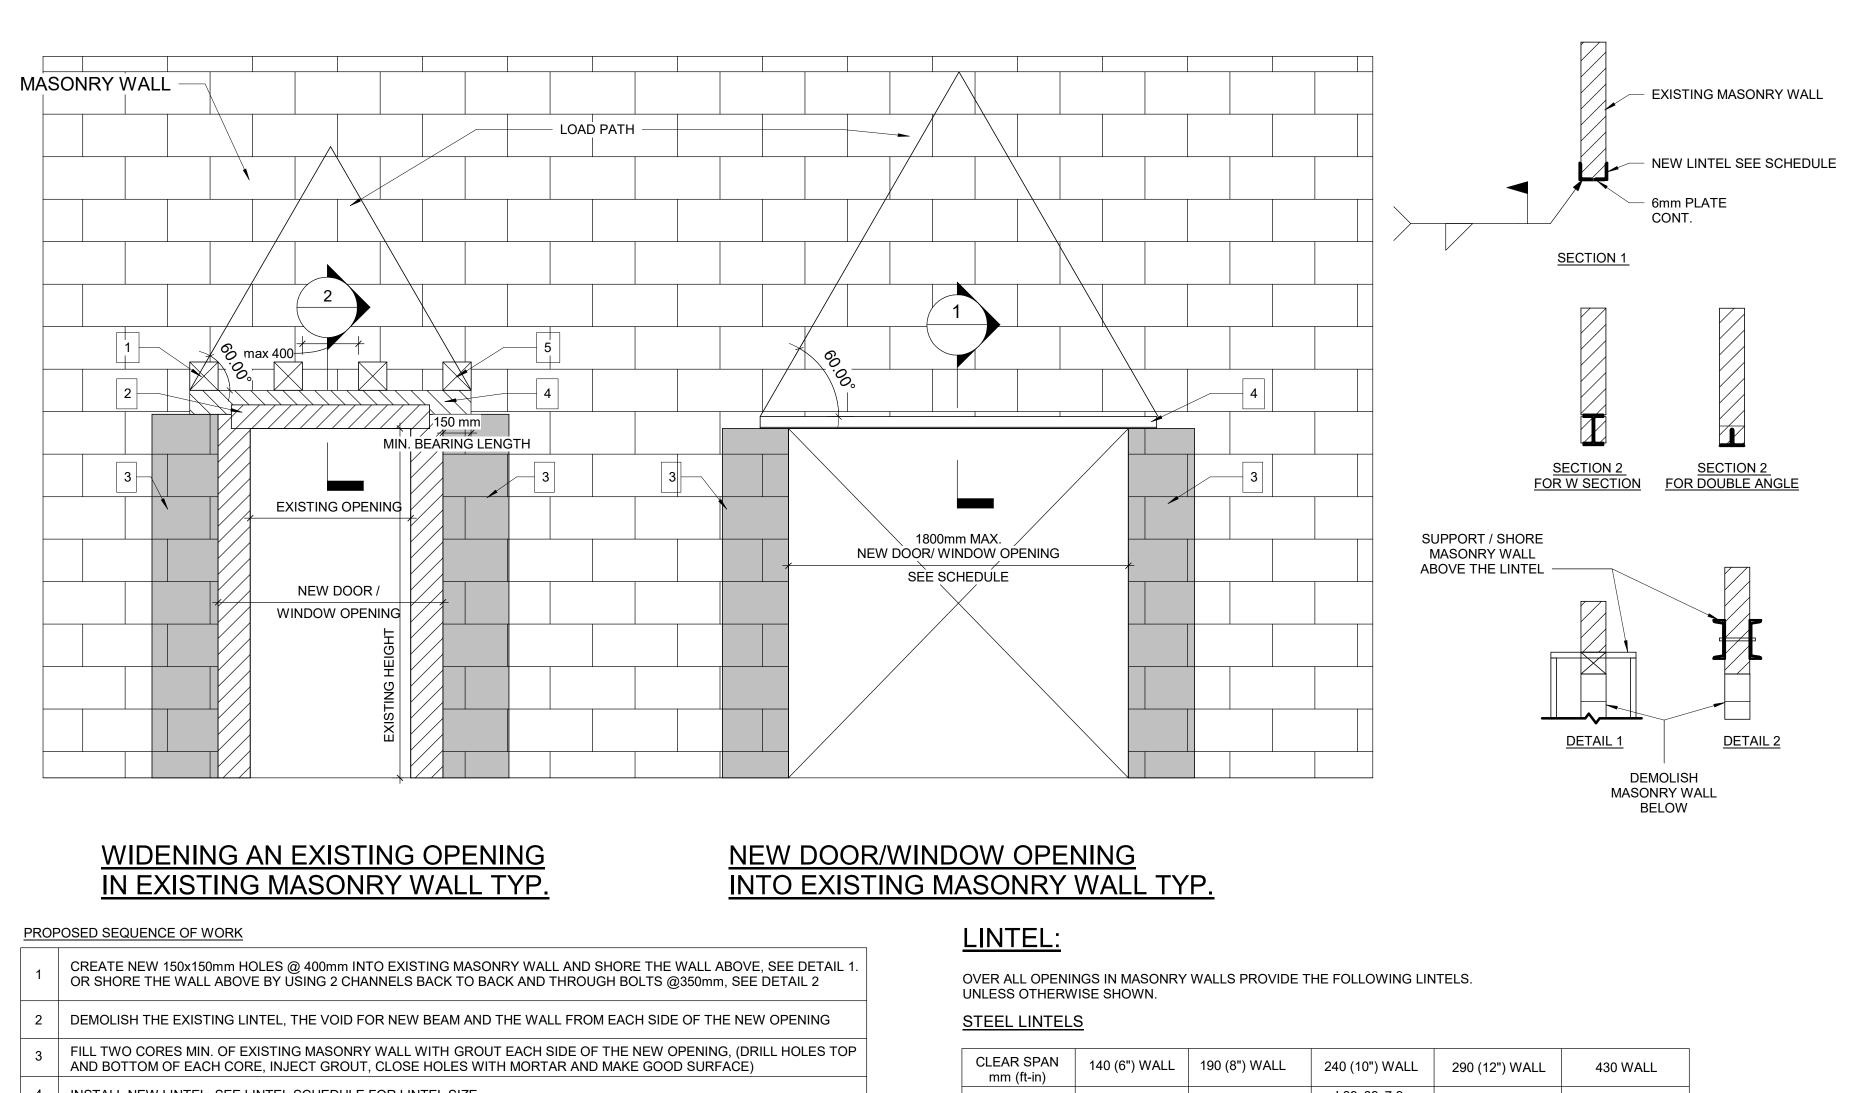
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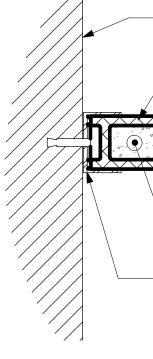
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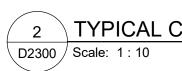




4 INSTALL NEW LINTEL. SEE LINTEL SCHEDULE FOR LINTEL SIZE

5 ADD MASONRY FACES AT LINTEL AND REPAIR MASONRY COURSE





CLEAR SPAN mm (ft-in)	140 (6") WALL	190 (8") WALL	240 (10") WALL	290 (12") WALL	430 WALL
UP TO 1200 (4'-0")	L127x127x7.9	2-L89x89x7.9 +170x6mm PL	L89x89x7.9 +L127x89x7.9 LLV +220x6mm PL	3-L89x89x7.9 +270x6mm PL	3-L127X127X7.9 +410X6mm PL
1201 TO 1800 (4'0 - 6'-)	2-L89x64x6.4LLV	2-L127x89x7.9LLV	L127x89x7.9LLV +L127x127x7.9	3-L127x89x7.9LLV	
1801 TO 3100 (6'- 10')	2-L89x64x9.5LLV	2-L152x89x9.5LLV	2-L152x89x9.5LLV	3-L152x89x9.5LLV	

	CLIENT CITY OF TORONTO TORONTO, ON M5V 3C6
FACE OF EXIST. WALL MASONRY WALL REFER TO PLAN	COPYRIGHT This drawing has been prepared solely for the intended use, thus any reproduction or distribution for any purpose other than authorized by IBI Group is forbidden. Written dimensions shall have precedence over scaled dimensions. Contractors shall verify and be responsible for all dimensions and conditions on the job, and IBI Group shall be informed of any variations from the dimensions and conditions shown on the drawing. Shop drawings shall be submitted to IBI Group for general conformance before proceeding with fabrication. IBI Group Professional Services (Canada) Inc. is a member of the IBI Group of companies
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 1-15M FOR 2-FULL GROUTED CORES 6 GALV. BENT PL. CONT. C/W 13ØX89 EMBED HILTI KWIK OR EQUIVALENT BOLT II @ 600 O/C INTO CORE FILLED CONC. BLOCK/CONC. SURFACE. USE 13Ø HILTI HIT HY-20 ADHESIVE ANCHOR C/W 51 EMBED OR EQUIVALENT FOR HOLLOW CONC. BLOCK AND 86 EMBED FOR BRICK VENEER WITH HOLES 	
MU WALL CONNECTION TO EXISTING WALL	
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	SEAL
	PRIME CONSULTANT IBI GROUP 175 Galaxy Blvd, Unit 100 Toronto, ON M9W 0C9, Canada tel 416 679 1930 fax 416 675 4620 ibigroup.com
	PROJECT TITLE CITY OF TORONTO ACCESSIBILITY UPGRADES
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PLUMBING FIXTURE SCHEDULE

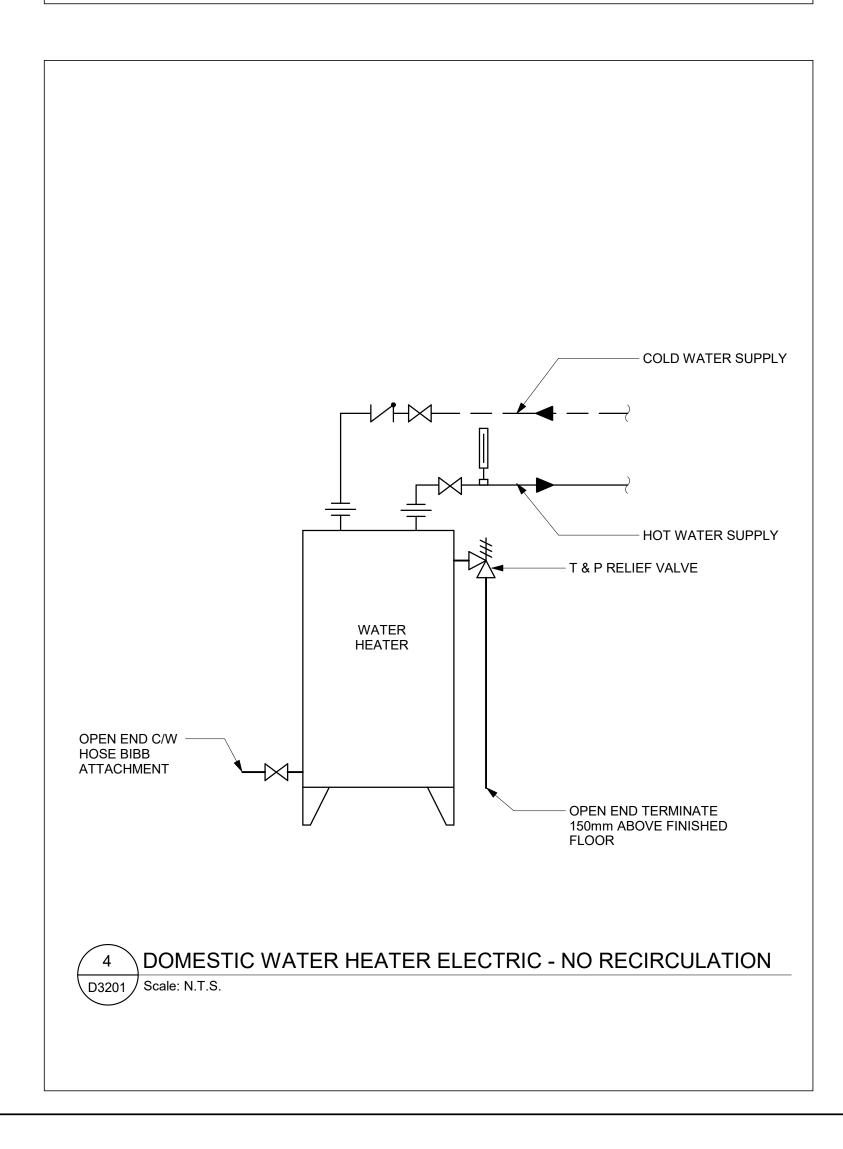
DECODIDION		SERV	DEMARKS		
DESCRIPTION	CW	HW	WASTE	VENT	REMARKS
WATER CLOSET (FLUSH VALVE)	25	-	75	40	
WATER CLOSET (FLUSH TANK)	12	-	75	40	
URINAL (FLUSH VALVE)	20	-	50	40	
URINAL (FLUSH TANK)	12	-	40	32	
LAVATORY	12	12	32	32	
SHOWER	12	12	75	32	
SERVICE SINK	12	12	75	40	
DRINKING FOUNTAIN	12	-	32	32	
SINKS	12	12	40	32	
GROUP WASH FOUNTAIN	25	25	40	40	

NOTES:

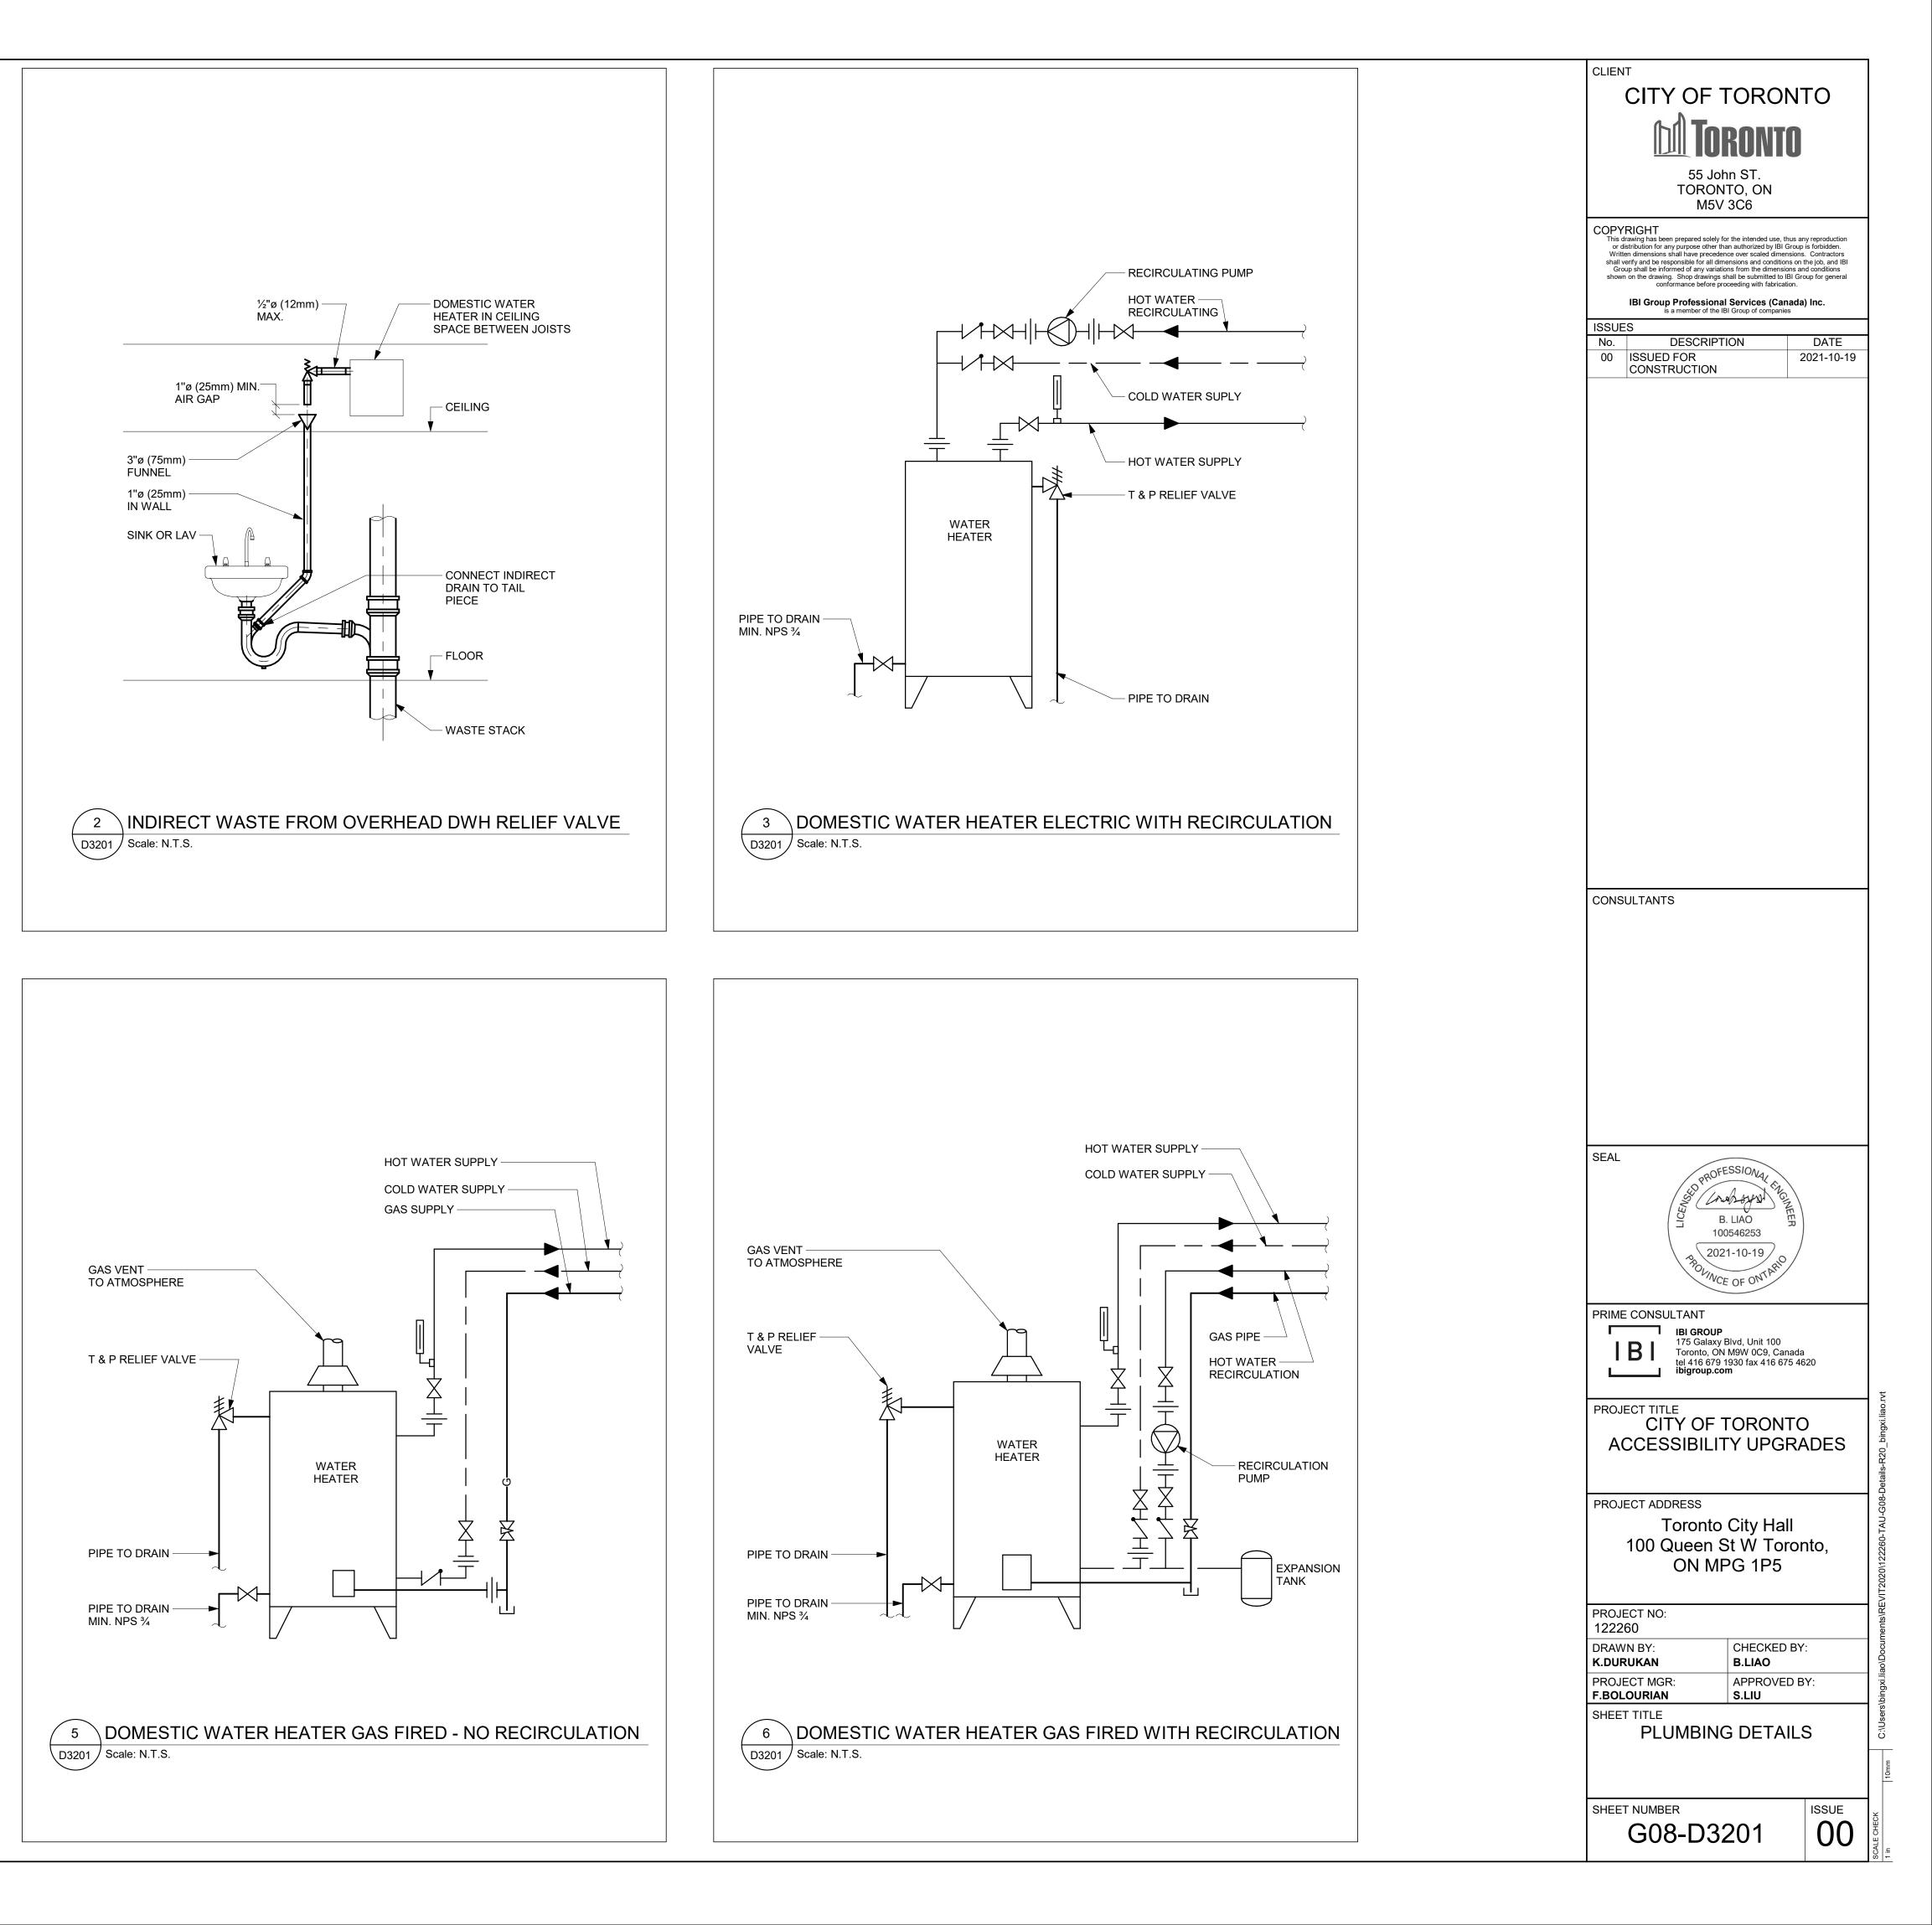
1. SIZING OF SUPPLIES INSIDE WASHROOM TO BE BASED ON 35 KPa PRESSURE DROP PER 30m OF PIPE OR MAXIMUM VELOCITY OF 1.2 mps.

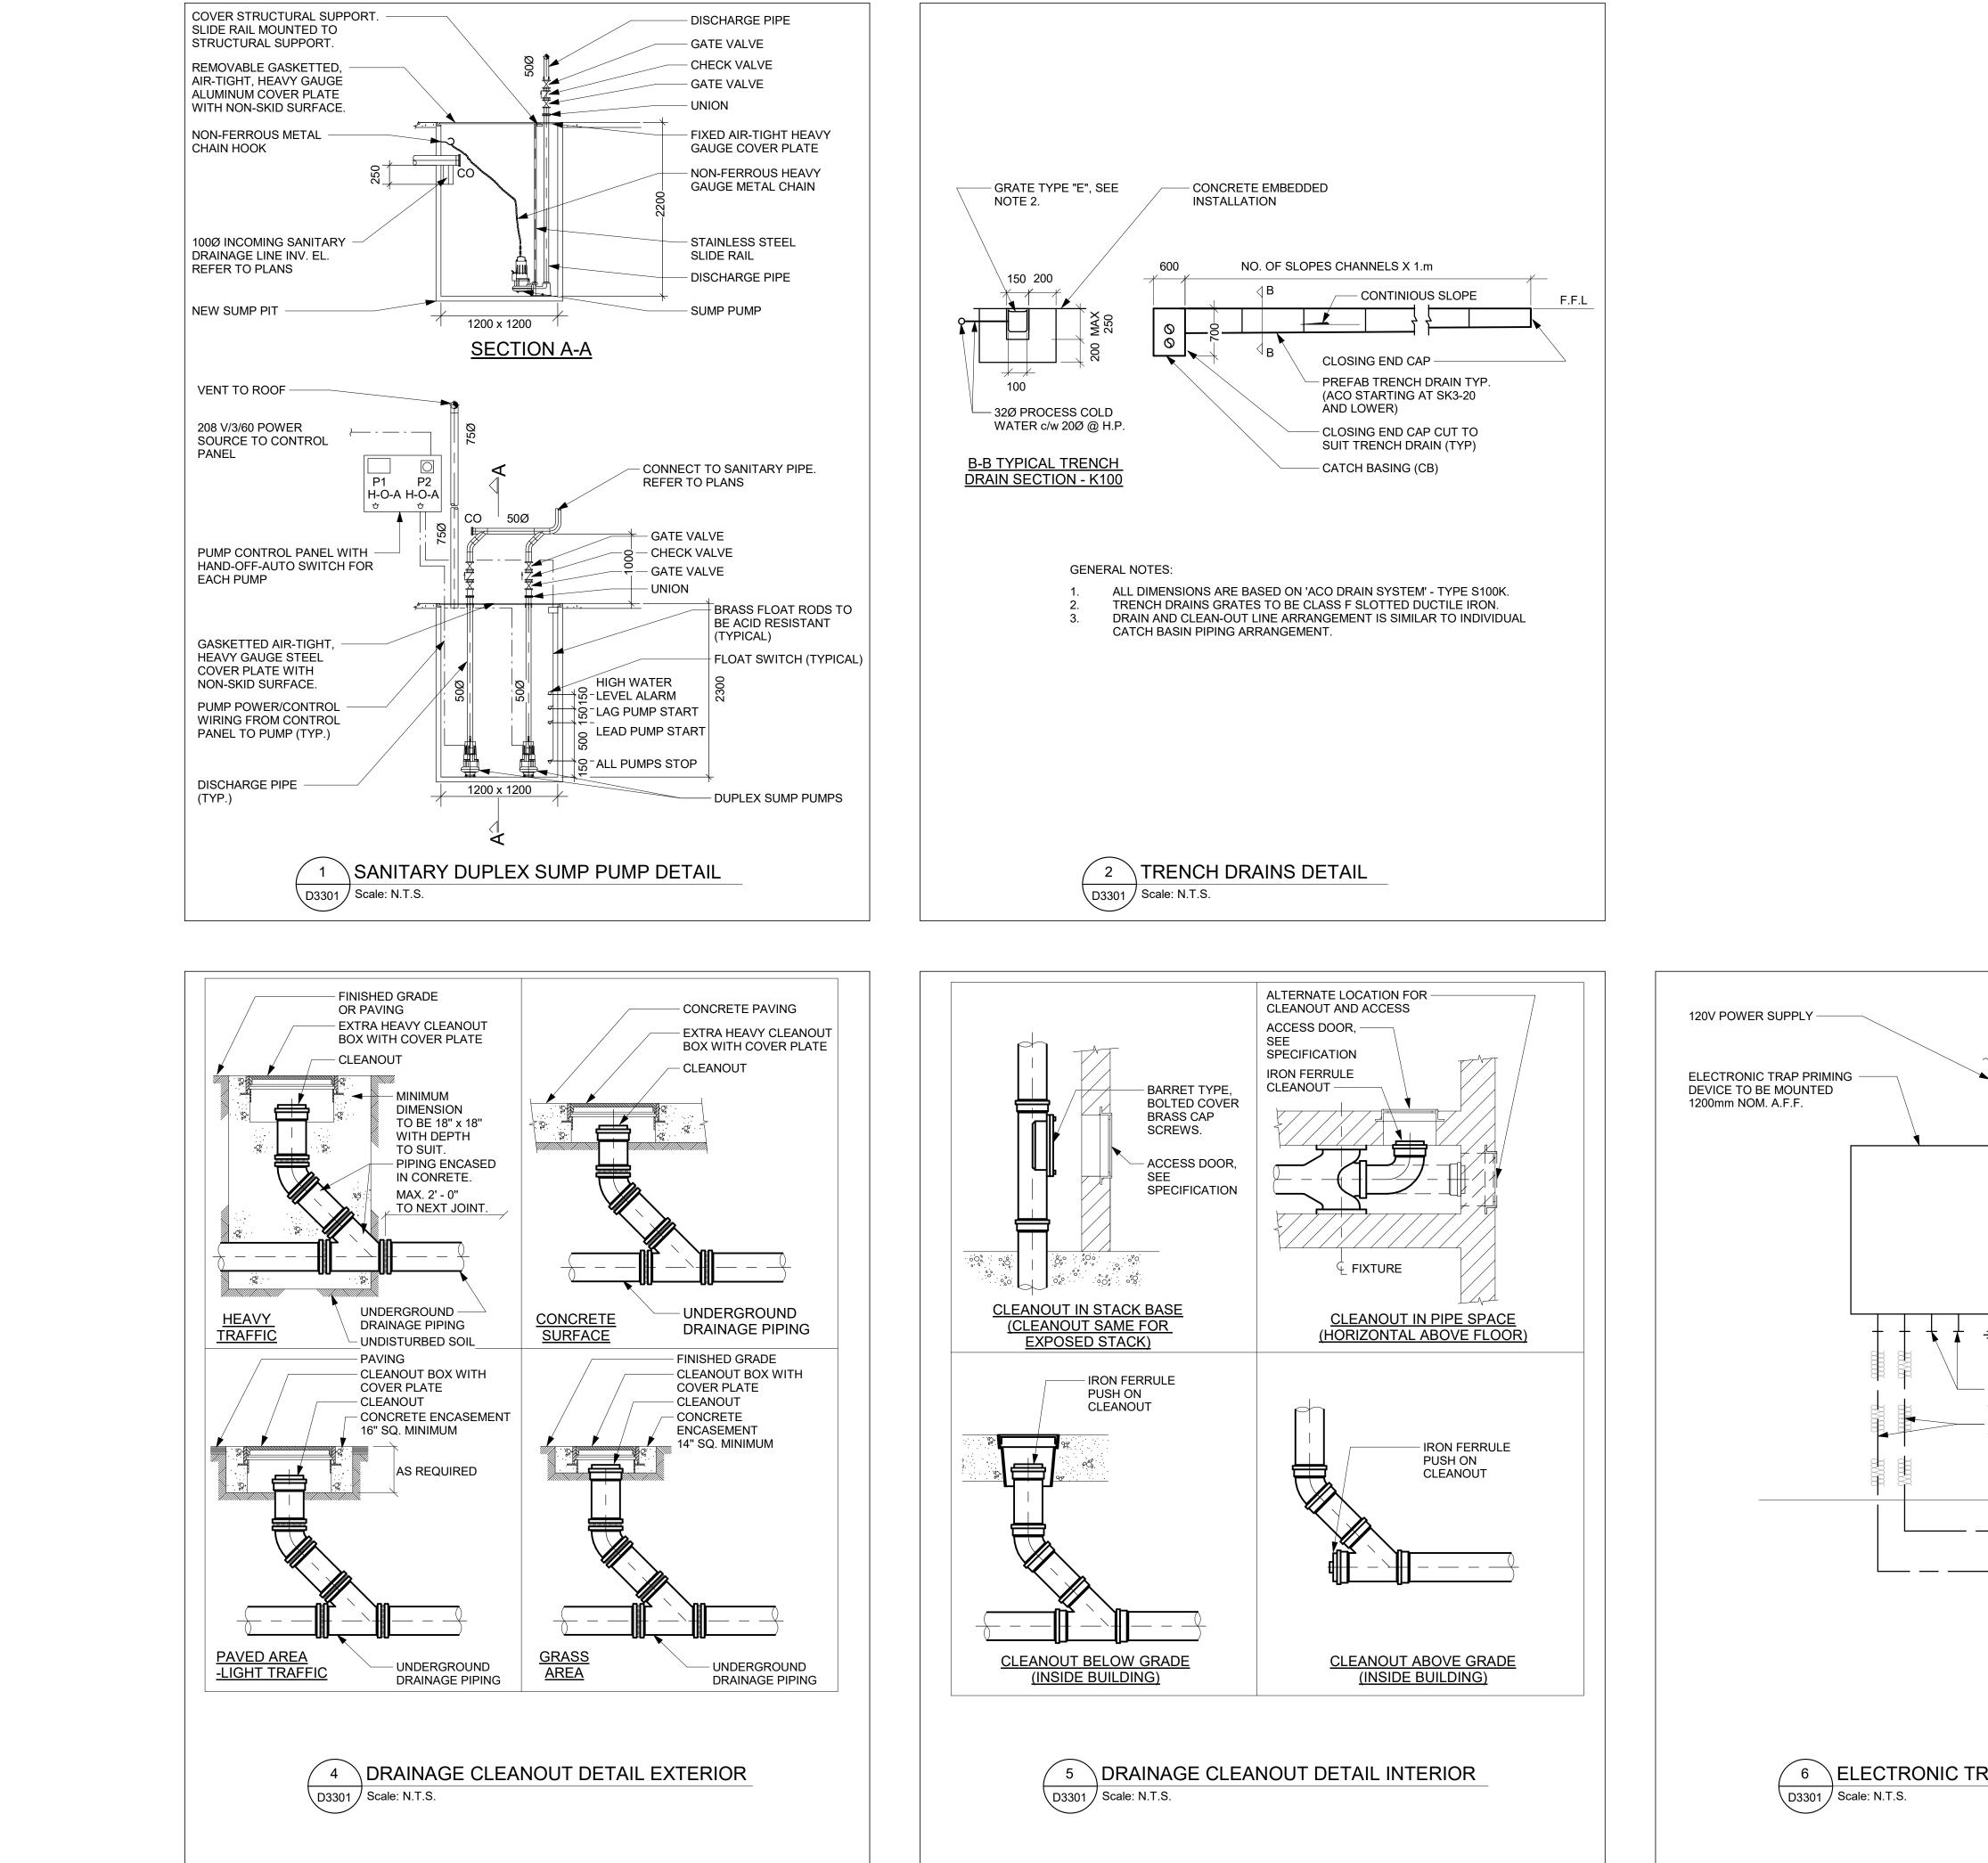
2. CONTRACTOR SHALL PROVIDE SHOP DRAWING OF PLUMBING AND DRAINAGE INSIDE WASHROOM AREA FOR ALL WASHROOMS.

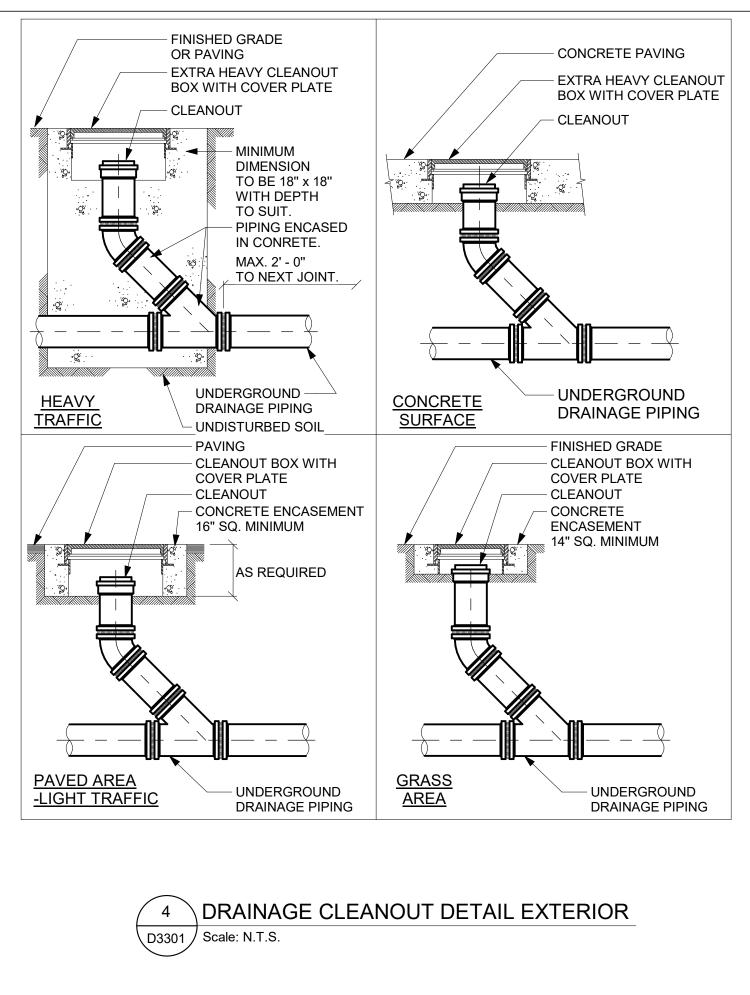
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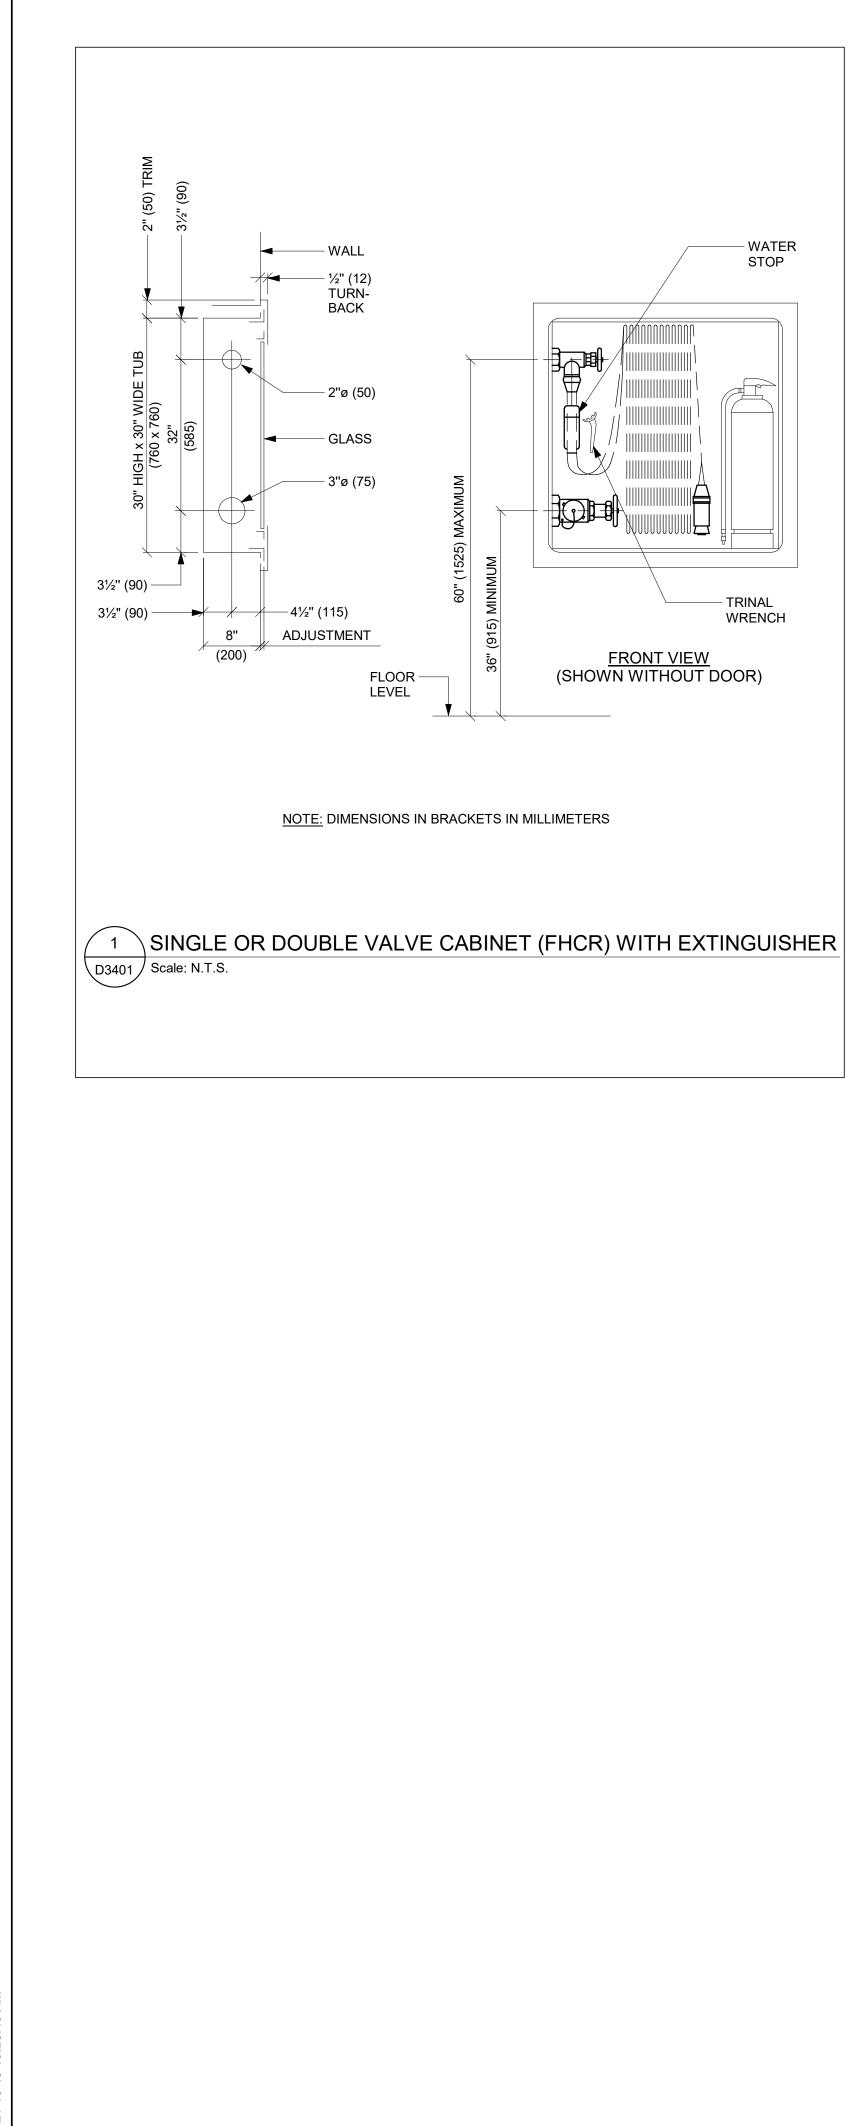
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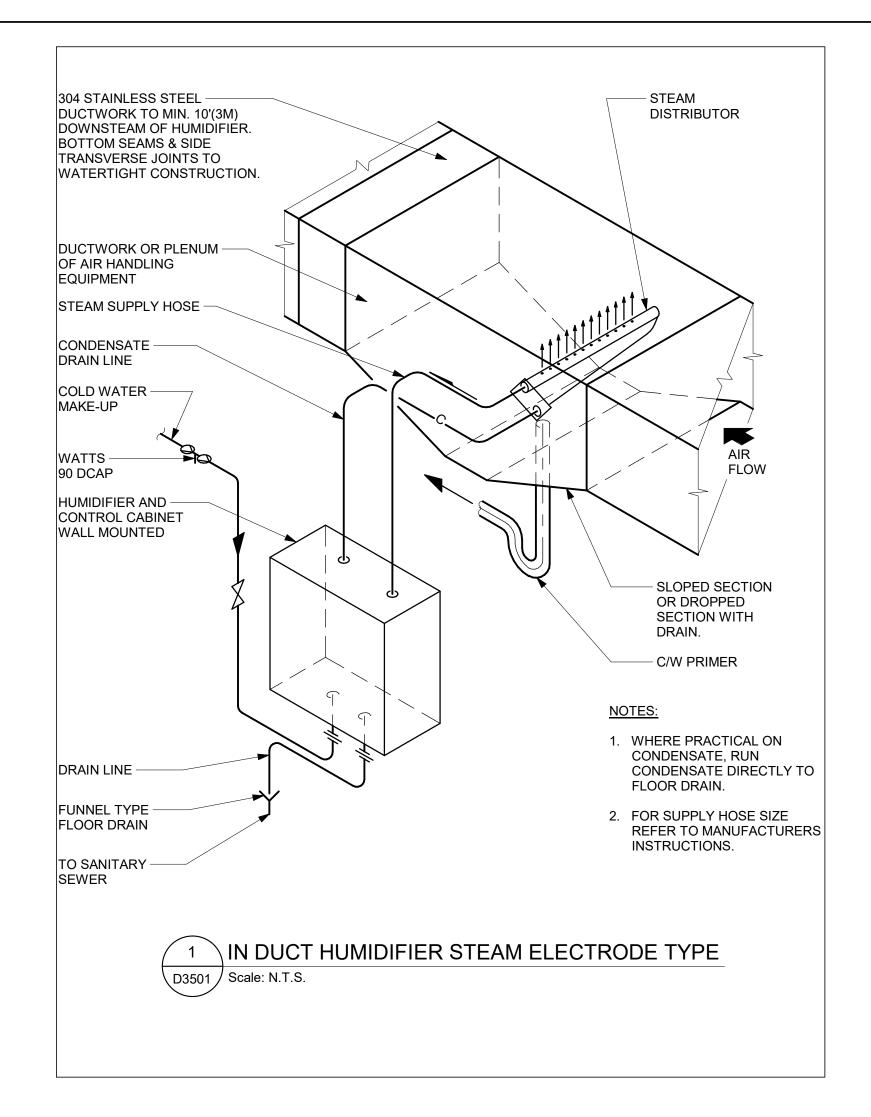


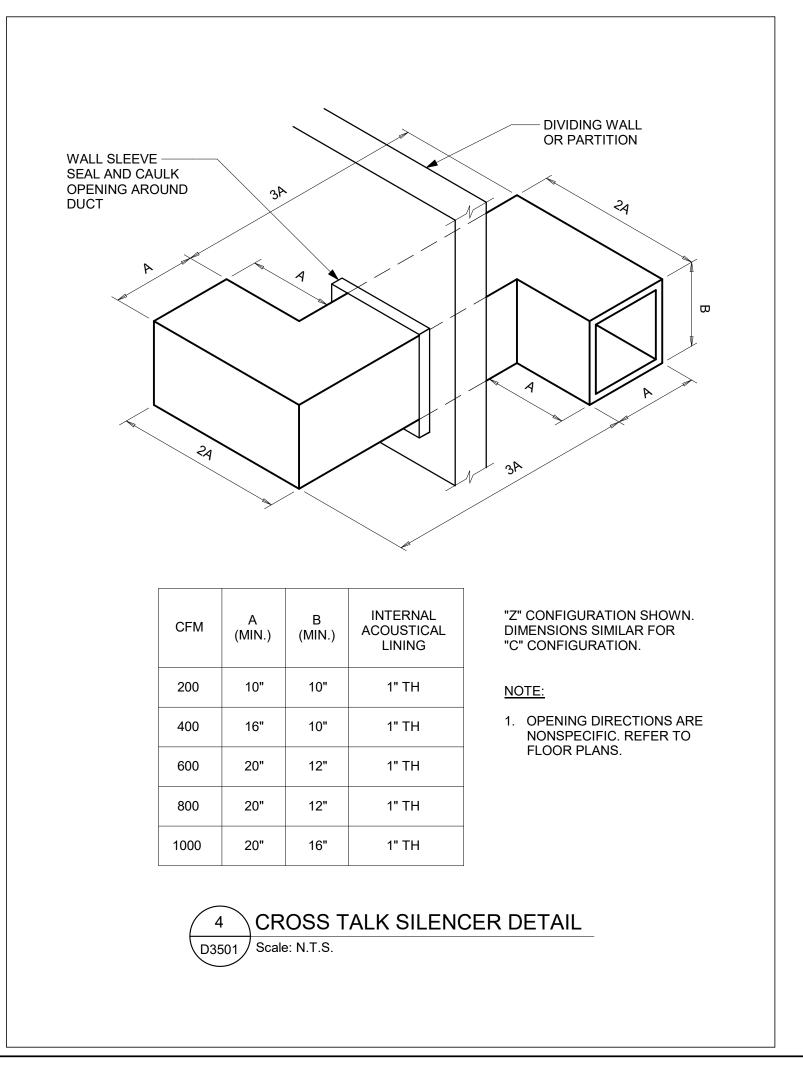


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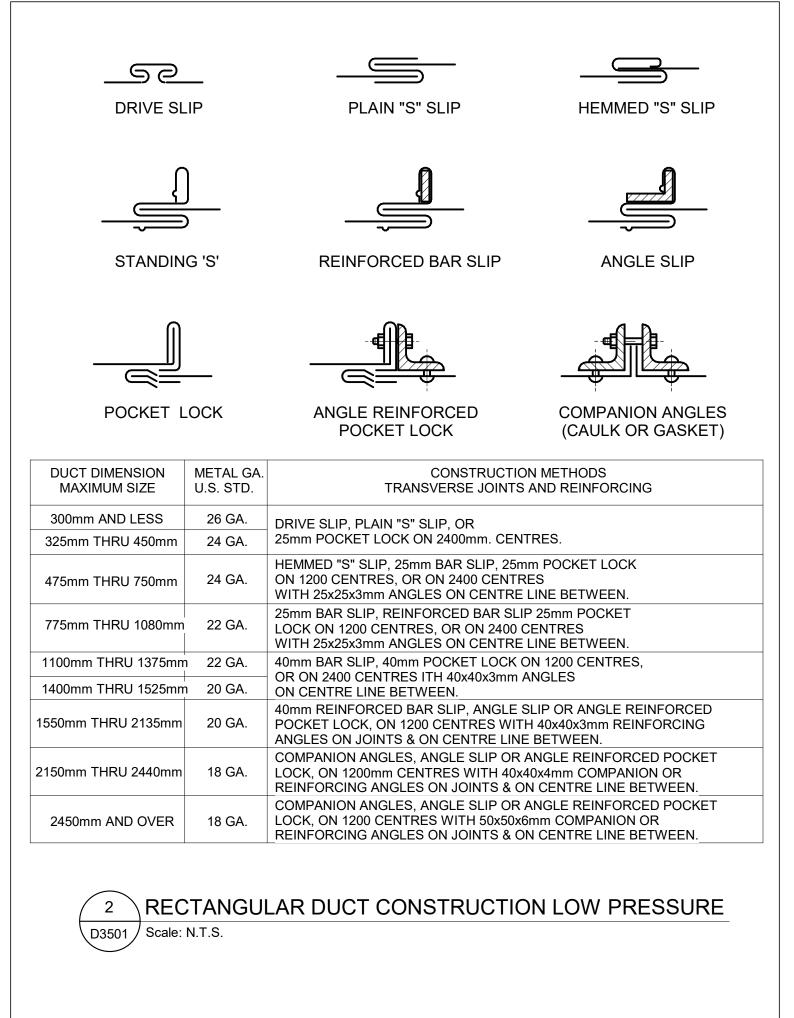


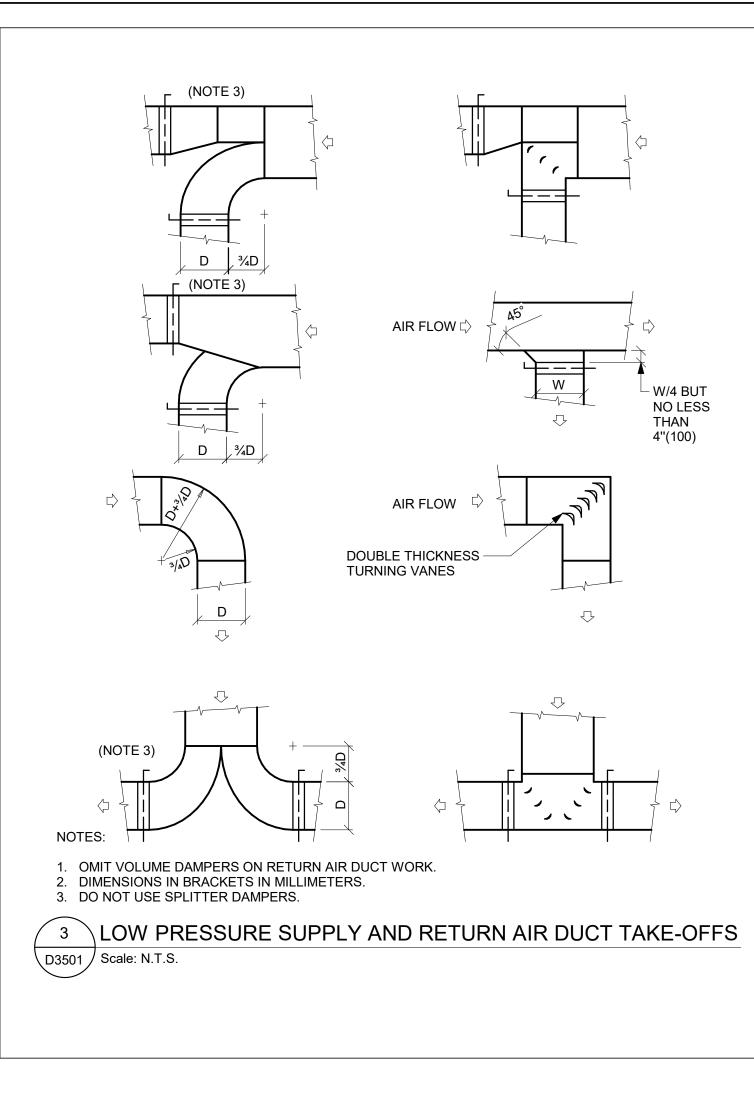
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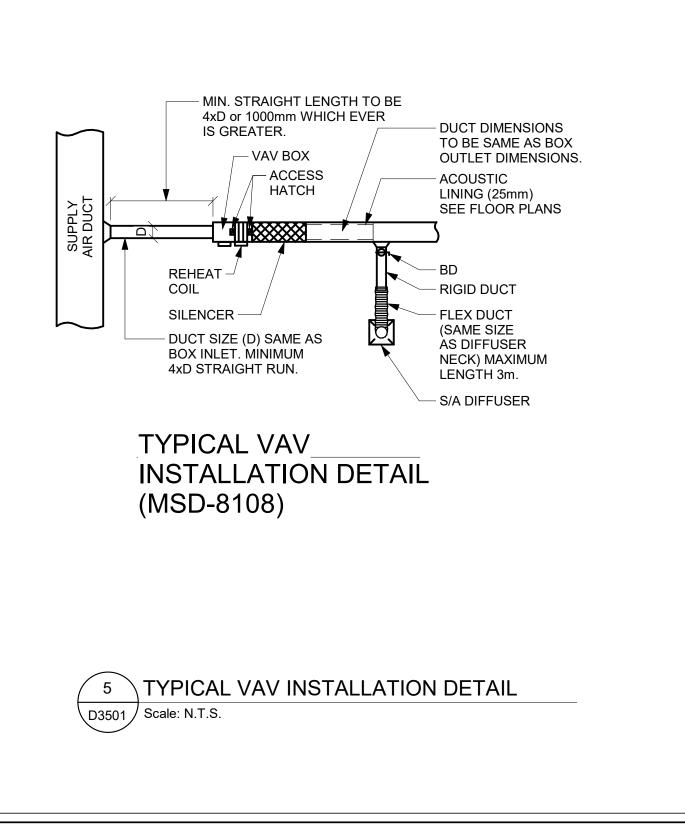




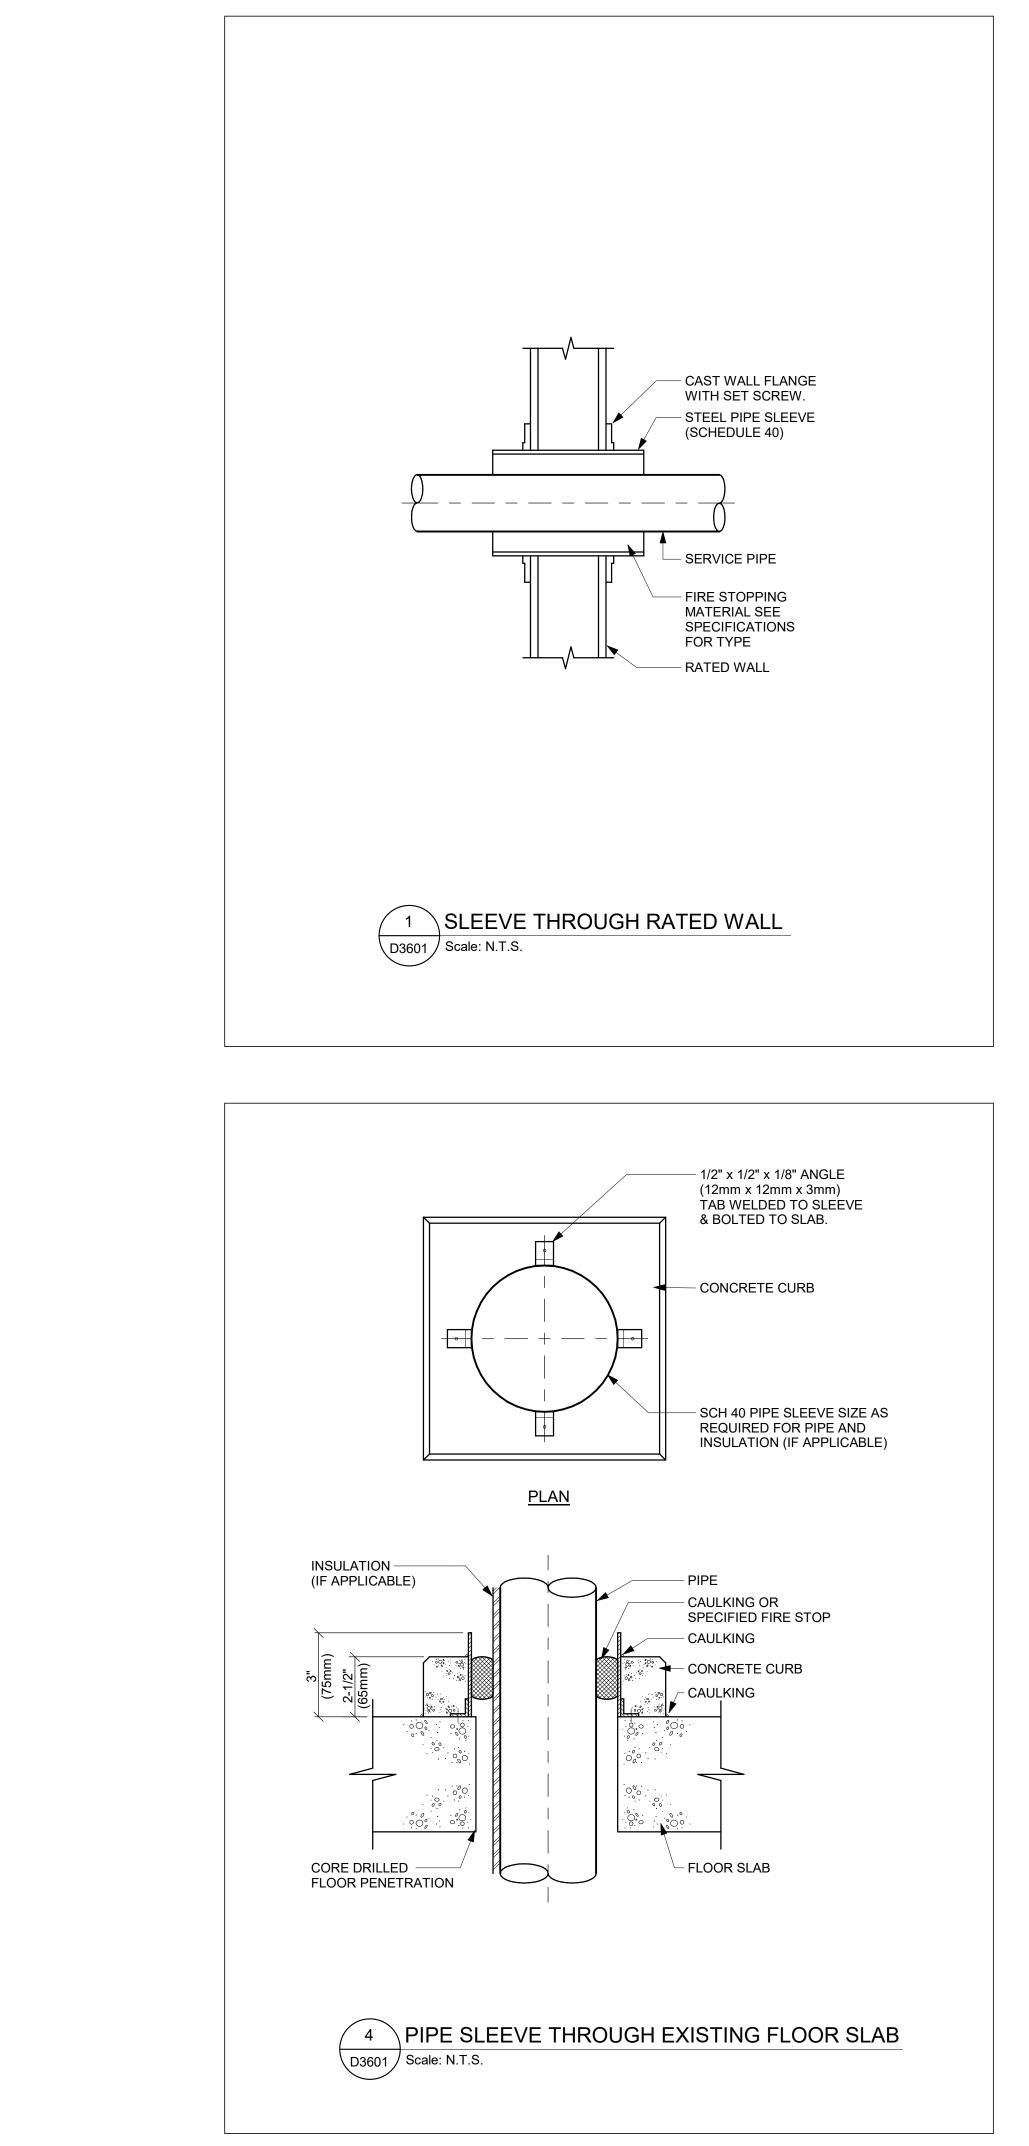
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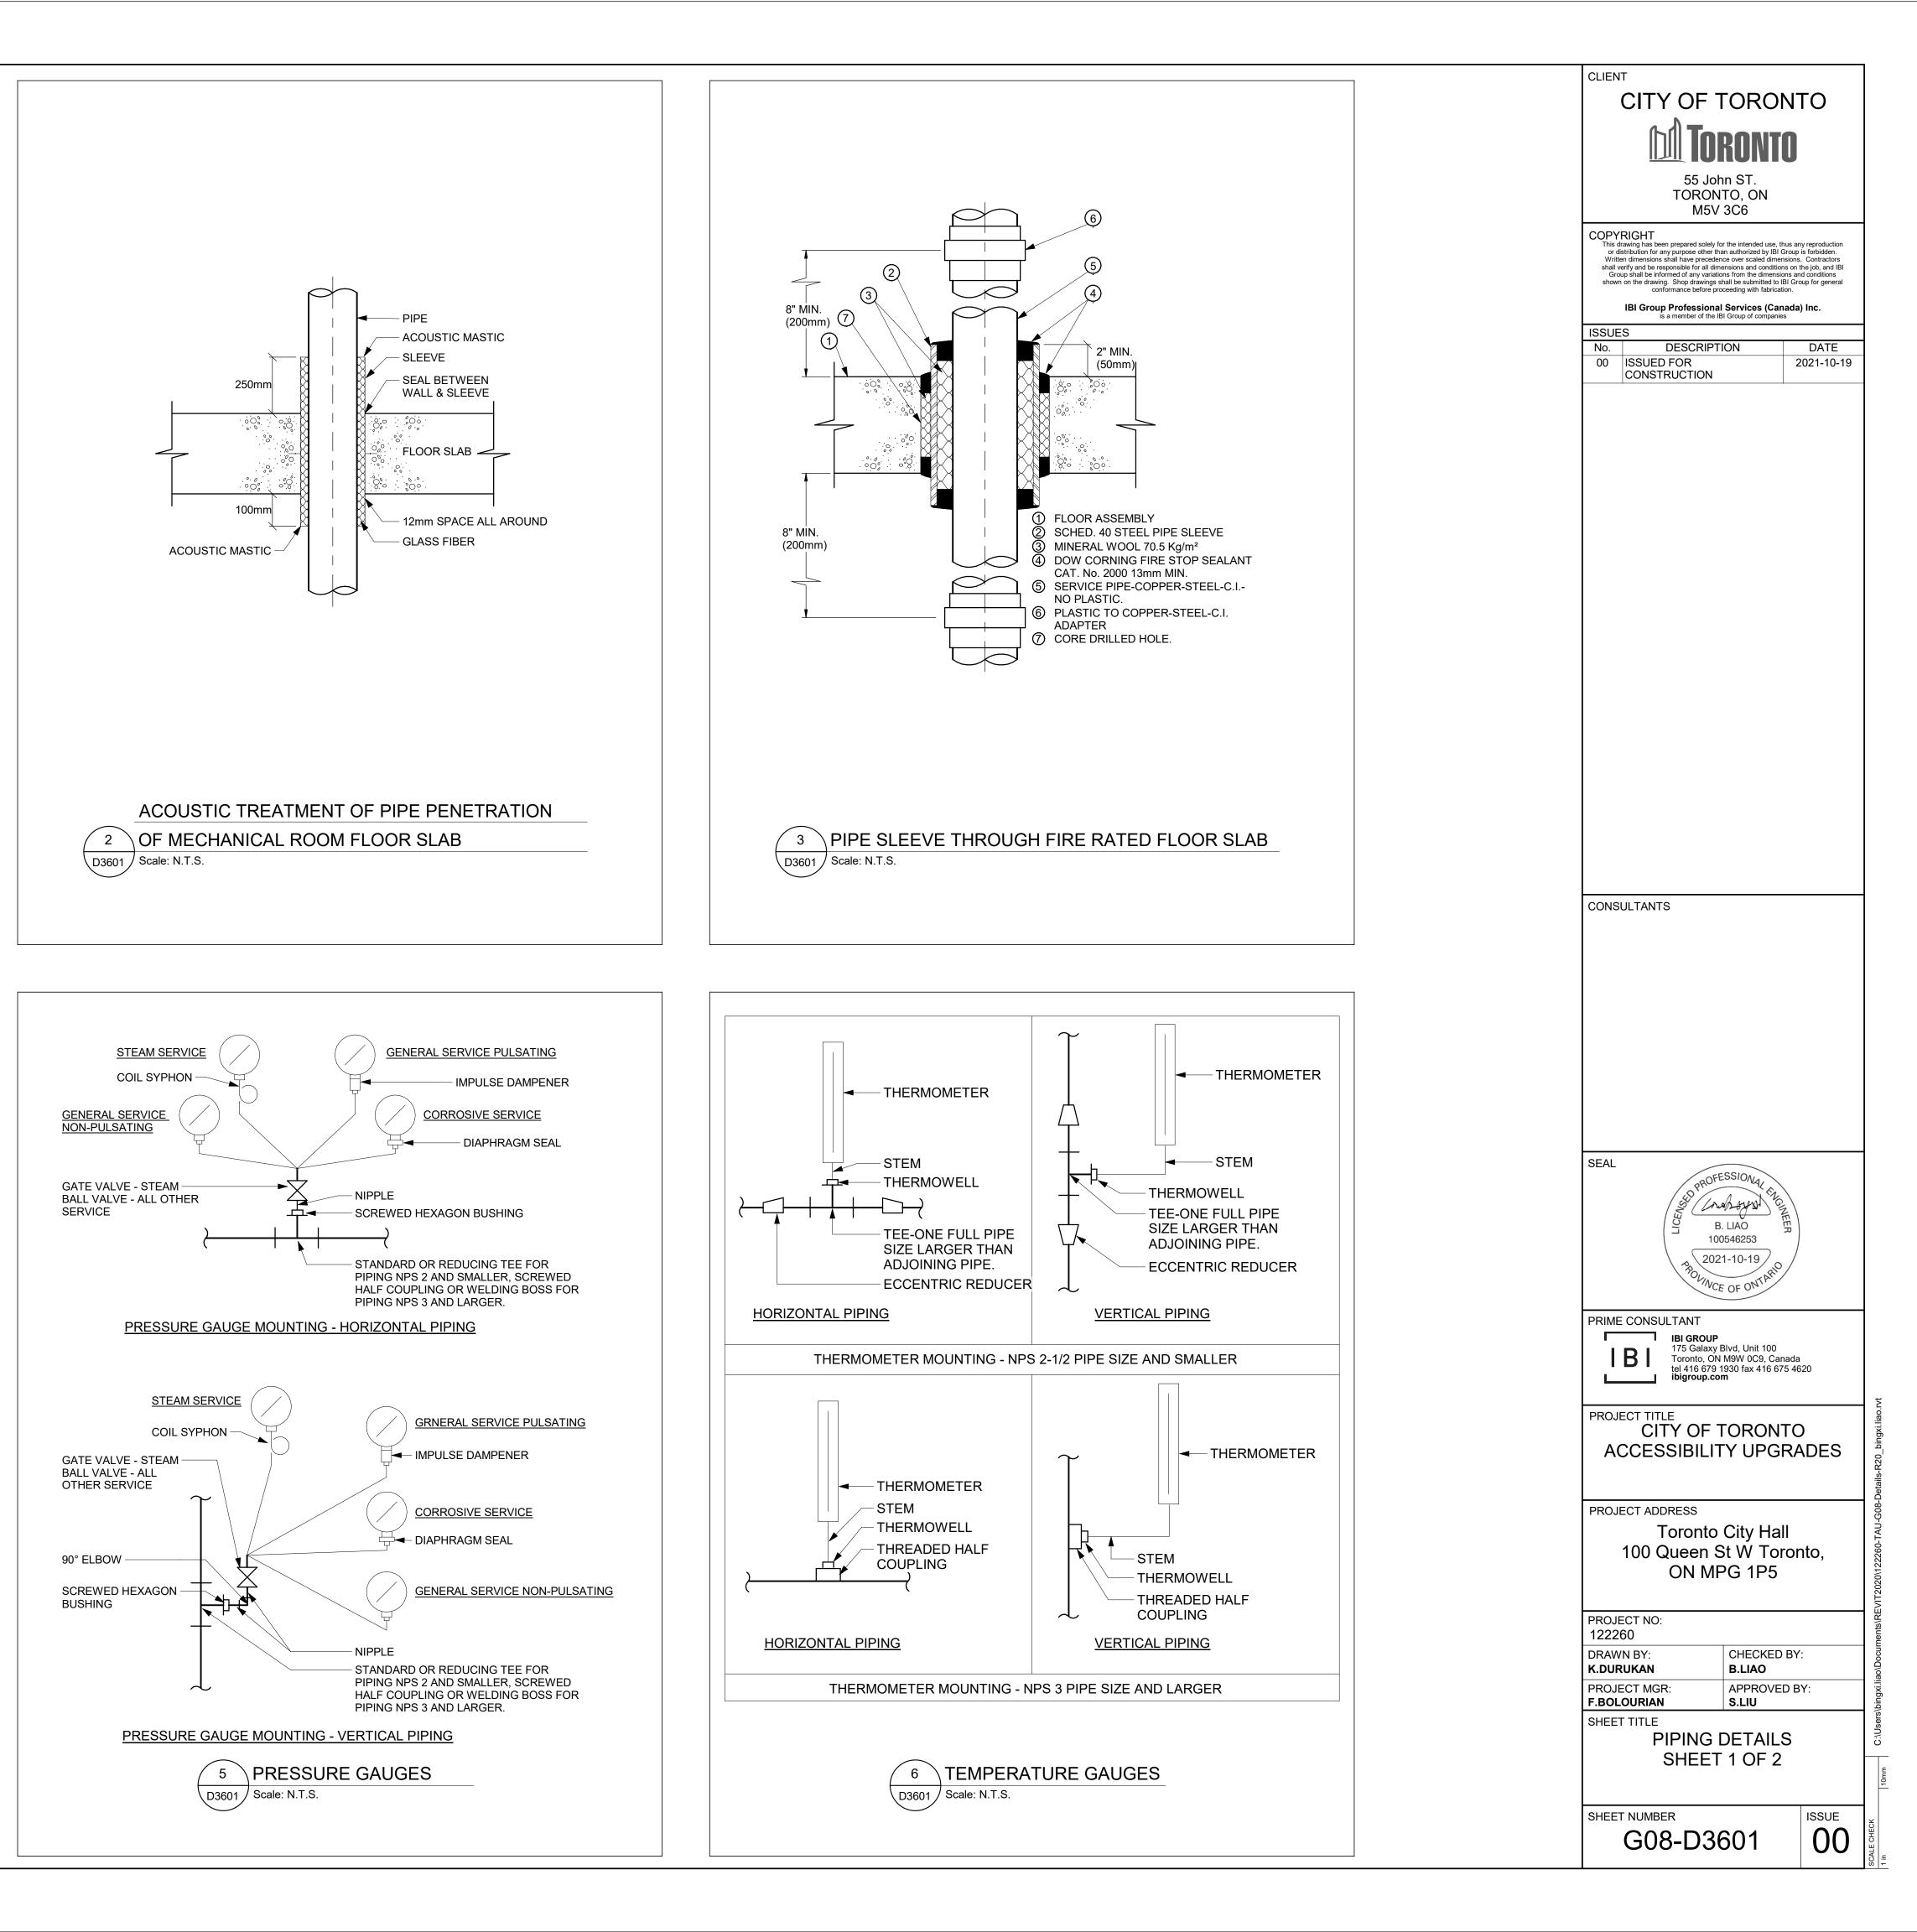


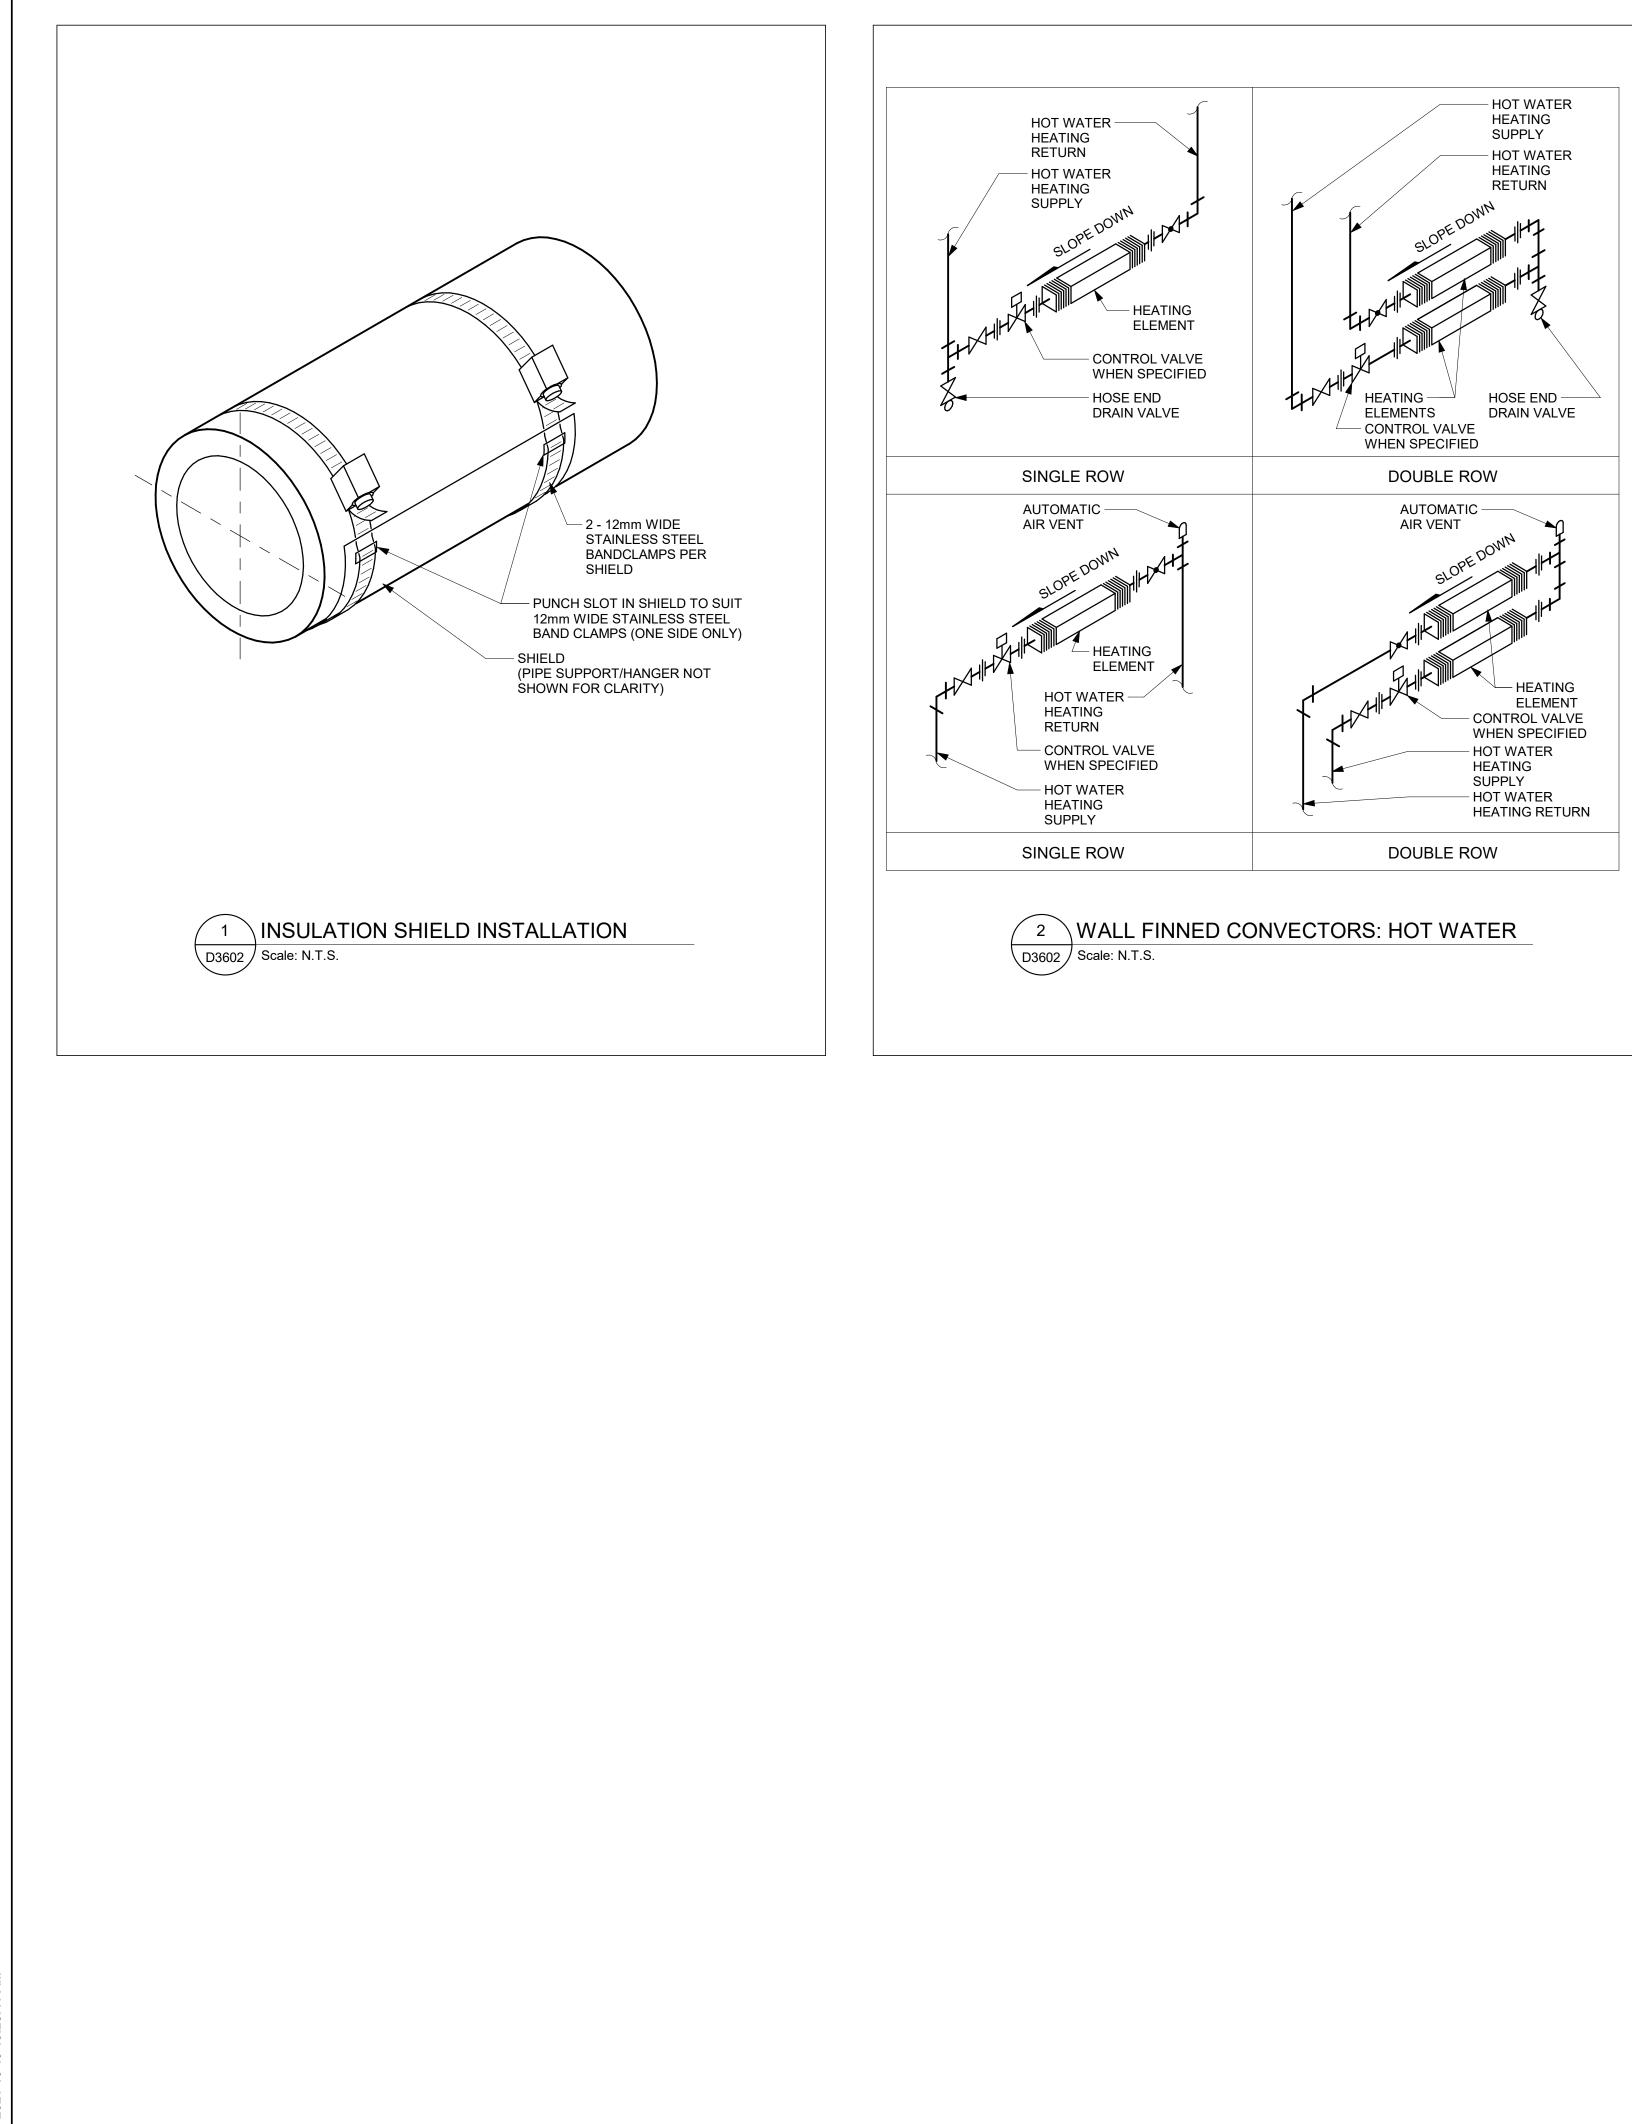


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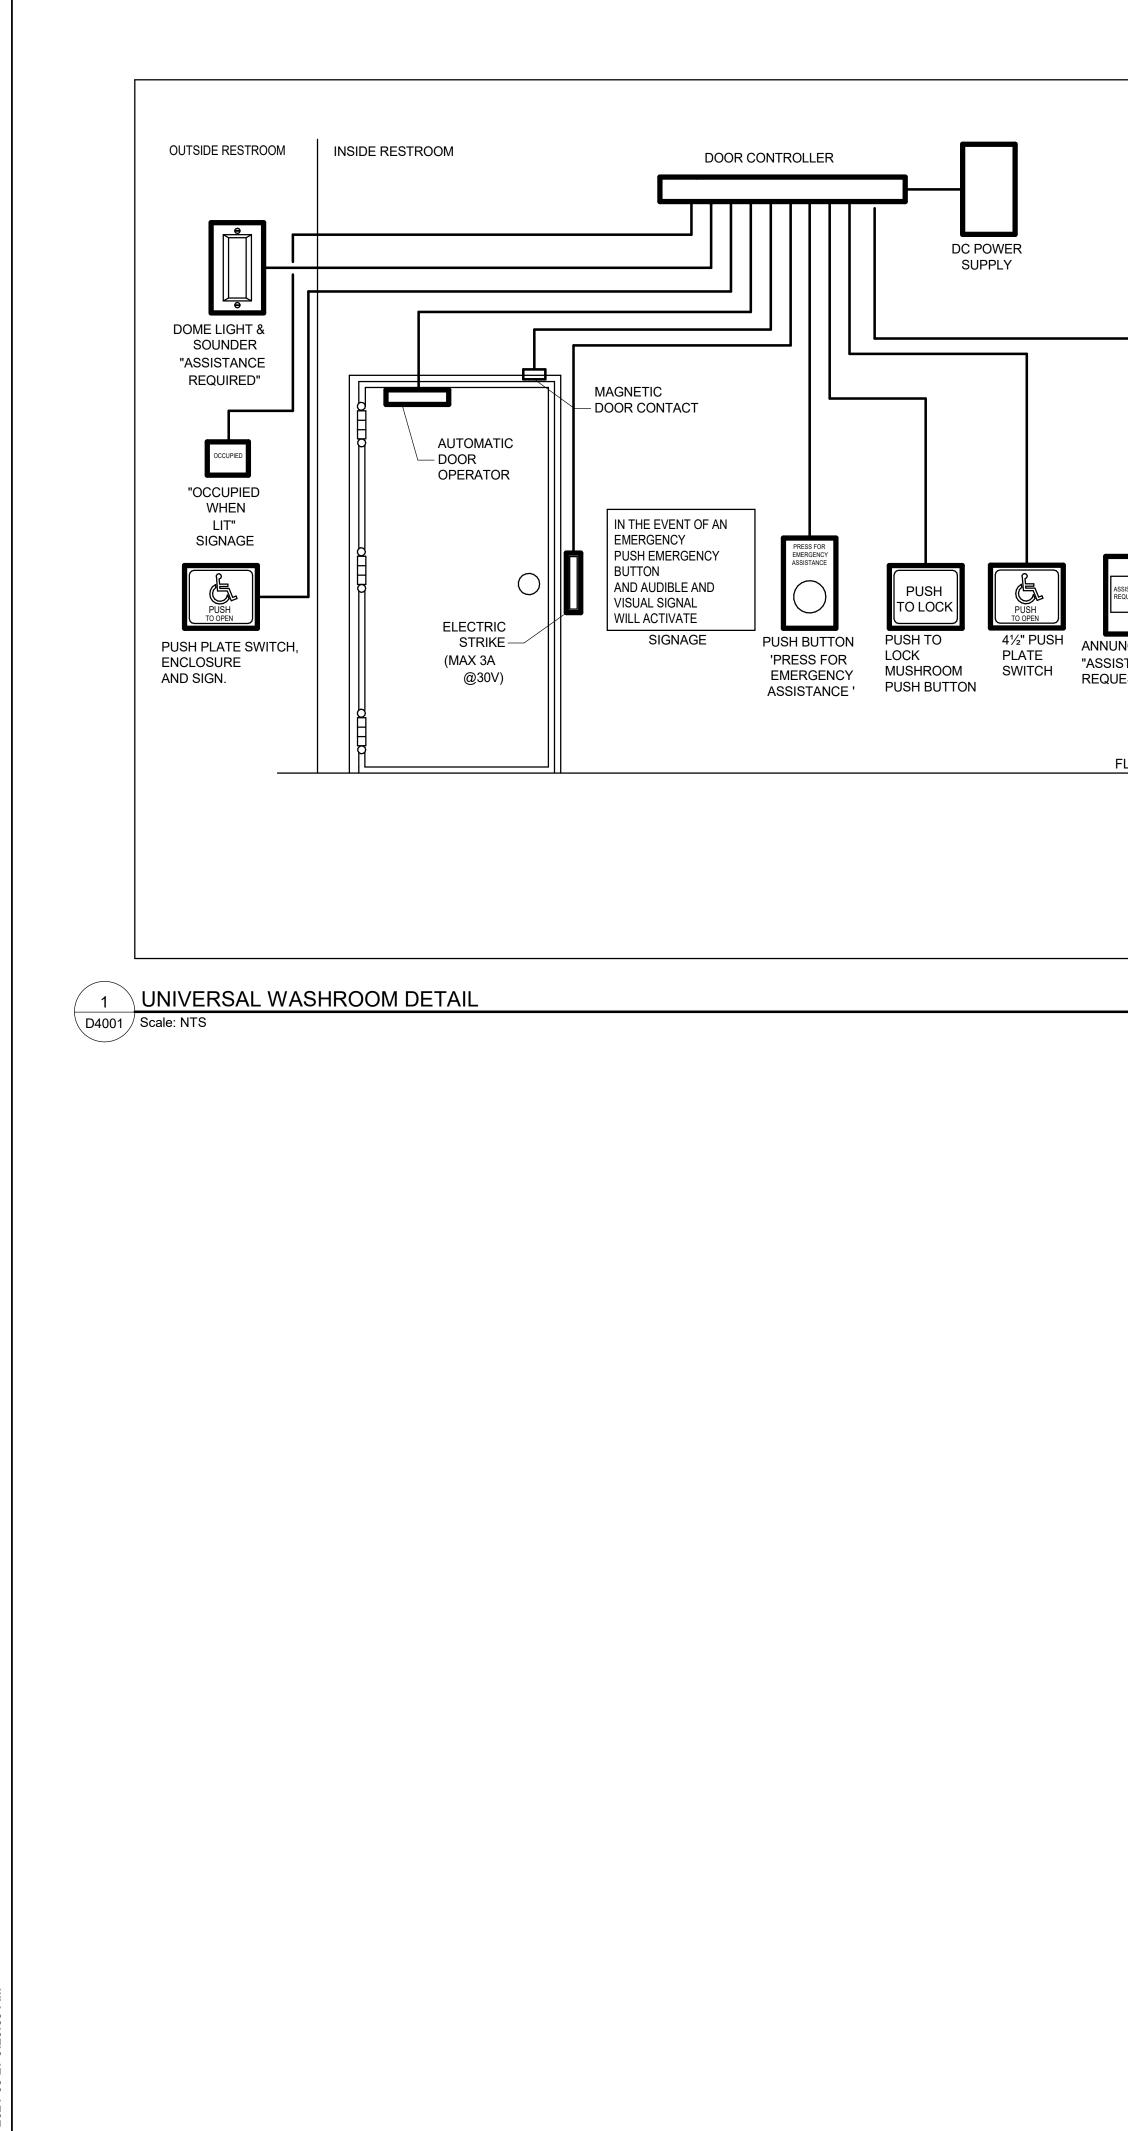


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	NOTES
	. PROVIDE EMERGENCY CALL SYSTEM EQUIPMENT. PROVIDE EMPTY CONDUITS ONLY COMPLETE WITH PULL STRINGS.
s	. BACK BOXES AND CONDUITS SHALL BE ACCORDING TO APPROVED HOP DRAWINGS. CONDUITS SHALL BE EMT, MINIMUM SIZE 21mm DIA CONTRACTOR TO COORDINATE.
D	. LOCATIONS OF DEVICES SHALL BE ACCORDING TO ARCHITECTURAL RAWINGS. VERIFY EXACT LOCATION WITH THE ARCHITECT PRIOR TO OUGHING-IN.
	. PROVIDE DOOR OPERATOR. PROVIDE 120V CIRCUIT FOR POWER AND CONDUIT FOR CONTROL CONNECTIONS TO DOOR CONTROLLER AS REQUIRED.
	. PROVIDE ELECTRIC STRIKE AND CONDUIT FOR CONNECTION TO DOOR ONTROLLER AS REQUIRED.
	SEQUENCE OF OPERATION:
	1. UPON PRESSING THE EXTERIOR PUSH PLATE, THE DOOR SHALL OPEN.
	2. AFTER ENTRY, THE OCCUPANT SHALL PRESS THE "PUSH TO LOCK" PUSH PLATE, AND LOCK THE DOOR VIA ELECTRIC STRIKE. THE EXTERNAL SIGNAGE WILL BE IN THE "OCCUPIED" STATE. PRESSING THE EXTERIOR PUSH PLATE WILL NOT HAVE ANY EFFECT.
DR E "	3. THE OCCUPANT WILL EXIT BY PRESSING THE INTERIOR UNIVERSAL SYMBOL FOR ACCESSIBILITY, WHICH WILL UNLOCK THE STRIKE, ACTIVATE THE DOOR OPERATOR AND AND RESET THE EXTERIOR SIGNAGE TO ITS "UNOCCUPIED" STATE. SIMILARLY, THE OCCUPANT MIGHT TURN THE DOOR HANDLE, AND OPEN THE DOOR. THE MAGNETIC DOOR CONTACT WILL REGISTER THIS AS A DOOR OPEN STATUS, AND RESET THE EXTERIOR SIGNAGE TO ITS "UNOCCUPIED" STATE AND RELEASE THE ELECTRIC STRIKE.
_	IF THE EMERGENCY 'PUSH/PULL' MUSHROOM IS DEPRESSED, THE EXTERIOR DOME LIGHT AND SOUNDER WILL ACTIVATE IN CONJUNCTION WITH THE INTERIOR ANNUNCIATOR AND SOUNDER. AT THE SAME TIME, THE DOOR STRIKE WILL RELEASE AND RESET THE EXTERIOR SIGNAGE TO ITS "UNOCCUPIED" STATE
	4. THE INTERIOR AND EXTERIOR REQUEST FOR EMERGENCY ASSISTANCE AUDIBLE AND VISUAL SIGNAL DEVICES WILL DEACTIVATE UPON RELEASE (PULL) OF THE MUSHROOM PUSHBUTTON. THE DOOR STRIKE WILL REMAIN UNLOCKED AND THE EXTERIOR SIGNAGE WILL BE IN ITS "UNOCCUPIED" STATE.

TO SECURI CONTROL I		1-27C MIN	DOOR DOOR CONTROL	TO POWER PANEL 1-21C (TYP.)	CLIENT CITY OF TORONTO TORONTO 55 John ST.
CEILING LINE EQUIVALENT				NOTE-7 (TYP.)	TORONTO, ON M5V 3C6 COPYRIGHT
COORDINATE WITH PREFOR LOCATION FO	RMED DOOR			CONCEAL CONDUIT BELOW CEILING LINE OR 3000AFF (TYP.) DEVICE BOX FOR REQUEST TO EXIT	This drawing has been prepared solely for the intended use, thus any reproduction or distribution for any purpose other than authorized by IBI Group is forbidden. Written dimensions shall have precedence over scaled dimensions. Contractors shall verify and be responsible for all dimensions and conditions on the job, and IBI Group shall be informed of any variations from the dimensions and conditions shown on the drawing. Shop drawings shall be submitted to IBI Group for general conformance before proceeding with fabrication.
MONITOR SWI ACTUATING M DOOR MONITO INSTALLED IN DOOR. (NOTE:	AGNET FOR OR SWITCH			SENSOR AND/OR AUDIO ANNUNCIATOR WHERE REQUIRED (NOTE-8)	IBI Group Professional Services (Canada) Inc. is a member of the IBI Group of companies ISSUES DESCRIPTION DATE A 50% SUBMISSION 2021-01-21 B 90% SUBMISSION 2021-04-12
EXTEND CON DOOR FRAME STRIKE POSIT DOOR POWEI PUSH BUTTO CARD READER MOUNTED ON SIDE OF WALL	IDUIT INSIDE JAMB TO TION R -SECURE SECURE			ELECTRICAL TRANSFER HINGE/LINK	CISSUED FOR PERMIT2021-04-12DISSUED FOR TENDER2021-05-25
INDICATED. CARD READE KEY PAD ON F OF WALL WHE REQUIRED (N 1-21C (NOTE- ELECTRIC STI	ER AND/OR PUBLIC SIDE ERE IOTE-8)			DOOR MOUNTED BOLT RELEASE/RETRACT DEVICES WHEN USED. (NOTE-9)	
(NOTE-12)			U		
2. AL 3. SE BY 4. PC CC 5. PR	HIS CONSTRUCTION DETAIL DOR HARDWARE SCHEDULE L CONDUITS WITH PULL ST ECURITY DOOR CONTROLLE Y SECURITY VENDER WHER DWER SUPPLY, DOOR OPER DNTACT (MONITOR SWITCH ROVIDE CONTINUOUS ELEC	E FOR EXACT COMPONE FRING, JUNCTION BOXES ER, CARD READER, ALAF RE REQUIRED. RATOR/CONTROLLER, DO I), BY DOOR HARDWARE	NTS REQUIRED AND CONDUIT R S, PULL BOXES, DEVICE BOXES RM BUZZER, KEYPAD, REQUEST DOR POWER PUSH BUTTON, ELE CONTRACTOR WHERE REQUIR	AND POWER WIRES BY DIV.26. TO EXIT SENSOR AND SECURITY WIRES ECTRIC STRIKE/BOLT/LATCH, DOOR	
6. JU TA	AMPER RESISTANT COVER;	SURFACE MOUNTED FO	R SOLID WALL CONSTRUCTION	x300x150 WITH REMOVABLE AND . SAME WITH 100x100x54 DEVICE BOX	CONSULTANTS
CC	OMMON CONDUIT, PULL BO	XES AND JUNCTION BOX	ES FOR INTRUSION DETECTION	LOCK WALL CONSTRUCTION. USE N AND ACCESS CONTROL WIRING.	
HC 8. DE W/	ORIZONTAL CONDUIT ON SO EVICE BOX MOUNTED FLUS ALL CONSTRUCTION. REFE	OLID WALL ONLY SH WITH SURFACE. PRO R TO LAYOUT DRAWING	VIDE SINGLE DEVICE COVER PLA FOR LOCATION. COORDINATE V	TICAL CONDUIT. SURFACE MOUNT ASTER RING FOR CAVITY OR BLOCK WITH DOOR HARDWARE SCHEDULE FOR E DOOR HARDWARE SCHEDULE.	
SC 10. W	CHEDULE. 'HERE DOOR PERFORMANC	E REQUIREMENTS CALL		NICATED IN DOOR HARDWARE ND ACCESS CONTROL, USE MAY BE MAINTAIN SEPARATION BETWEEN WIRING	
	F TWO SYSTEMS. SE OF BRIDGING CONDUIT A	ACCEPTABLE FOR CAVIT	TY OR BLOCK WALL CONSTUCTI	ON WHERE SITE CONDITIONS PERMIT.	SEAL
12. OI	MIT WHEN ELECTRIC LATC	H IS USED.			
			ED AND DOOR PUSH BUTTON IS CREDENTIAL -> ACTIVATE DOO	TRIGGERED THAT MOTOR DOES NOT OR OPERATOR PUSH BUTTON	
2 DOOR SECU D4001 Scale: 1:1	RITY DETAIL - PC	WERED DOOR	S		
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