	SINGLE LINE DIAGRAM LEGEND
	FUSIBLE HIGH VOLTAGE (H.V.) ISOLATION SWITCH
~~~	TRANSFORMER
	ISOLATION TRANSFORMER WITH ELECTROSTATIC SHIELD
<b>⊸ ⊶</b>	LIGHTNING ARRESTOR
<i>─</i> ≪००००≫	DRAW-OUT AIR CIRCUIT BREAKER WITH LIMITTER
<b></b>	DRAW-OUT AIR CIRCUIT BREAKER
	MOLDED CASE CIRCUIT BREAKER
<b>⊸</b> >□	SWITCH AND FUSE UNIT
	UNFUSED LOAD INTERRUPTED SWITCH.
NO	NORMALLY OPEN DEVICE
NC o	NORMALLY CLOSED DEVICE
8	CURRENT TRANSFORMER
<b>-</b> - <b>◊</b> >	POTENTIAL TRANSFORMER
M	KILOWATTHOUR METER WITH PEAK DEMAND INDICATOR
(195KW)	DENOTES CONNECT LOAD APPLIED TO DESIGNATED APPARATUS.
G	GENERATOR
□ ₁ XXA	DISCONNECT (UNFUSED)
D-J XXA/XXA	DISCONNECT (FUSED)
°   °	AUTOMATIC TRANSFER SWITCH
	AUTOMATIC TRANSFER SWITCH WITH BY-PASS
(K) (K)	KEY INTERLOCK SYSTEM - THREE LOCKS; TWO KEYS
	SECURITY LEGEND
CR	SECURITY CARD READER ROUGH—IN
ES	SECURITY ELECTRIC STRIKE ROUGH-IN
ML	SECURITY MAGNETIC LOCK ROUGH-IN C/W FIRE ALARM TIE-IN
DC	DOOR CONTACT ROUGH-IN
DA	SECURITY DOOR ALARM ROUGH-IN
BG	BREAK GLASS SENSOR ROUGH-IN
ADO	AUTOMATIC DOOR OPERATOR ROUGH-IN
REX WALL MOUNTED SECURITY REQUEST TO EXIT MOTION SENSOR ROUGH-IN	
[IC]	WALL MOUNTED INTERCOM ROUGH-IN
K	SECURITY KEY PAD ROUGH-IN
•	PUSH BUTTON ROUGH-IN
	SECURITY CAMERA ROUGH-IN
Ø8 €	DOOR BELL/CHIME
NOTE: NOT ALL	SYMBOLS APPLY. CONTRACTOR TO REFER TO FLOOR PLANS.

## ABOVE COUNTER DUPLEX RECEPTACLE 120 VOLT, 15 AMP, CSA 5-15R OR AS NOTED  ## WALL MOUNTED DUPLEX RECEPTACLE 120 VOLT, 20 AMP, CSA 5-20R  ## ABOVE COUNTER DUPLEX RECEPTACLE 120 VOLT, 20 AMP, CSA 5-20R  ## ABOVE COUNTER GPCI DUPLEX RECEPTACLE 120 VOLT, 15 AMP, CSA 5-15R, DEDICATED CIRCUIT  ## ABOVE COUNTER GFCI DUPLEX RECEPTACLE 120 VOLT, 15 AMP, CSA 5-15R, DEDICATED CIRCUIT  ## ABOVE COUNTER GFCI DUPLEX RECEPTACLE 120 VOLT, 20 AMP, CSA 5-20R, DEDICATED CIRCUIT  ## ABOVE COUNTER GFCI DUPLEX RECEPTACLE 120 VOLT, 20 AMP, CSA 5-20R, DEDICATED CIRCUIT  ## CEILING MOUNTED DUPLEX RECEPTACLE 120 VOLT, 15 AMP, CSA 5-15R  ## CEILING MOUNTED DUPLEX RECEPTACLE 120 VOLT, 15 AMP, CSA 5-15R  ## CEILING MOUNTED PUPLEX RECEPTACLE 120 VOLT, 15 AMP, CSA 5-15R  ## WALL MOUNTED PUPLEX RECEPTACLE 120 VOLT, 15 AMP, CSA 5-15R  ## WALL MOUNTED RECEPTACLES 2 DUPLEX CSA 5-15R  ## ABOVE COUNTER RECEPTACLES 2 DUPLEX CSA 5-15R  ## ONE BACKBOX C/W ONE MINIMUM 1-1/4" CONDUIT OR AS SPECIFIED ON DE STUBBED INTO CEILING SPACE C/W TWO CONNECTORS WITH NYLON BUSHINDS PULL STRINGS FOR USE BY COMMUNICATIONS CONTRACTOR. ONE CONDUIT PER BOX.  ## ABOVE COUNTER INSTALLATION OF ONE BACKBOX C/W ONE MINIMUM 1-1/4" CONDUIT OR AS SPECIFIED ON DETAILS, STUBBED INTO CEILING SPACE C/W TWO CONNECTORS WITH NYLON BUSHINGS AND PULL STRINGS FOR USE BY AUDIO CONTRACTOR. ONE CONDUIT OR AS SPECIFIED ON DETAILS, STUBBED INTO CEILING SPACE OF TO AUDIO VISUAL DEVICE C/W TWO CONNECTORS WITH NYLON BUSHINGS AND PULL STRINGS FOR USE BY AUDIO CONTRACTOR.  ## ABOVE COUNTER INSTALLATION OF ONE GANG BACKBOX C/W MINIMUM 1-1/4" CONDUIT OR AS SPECIFIED ON DETAILS, STUBBED INTO CEILING SPACE OR TO AUDIO VISUAL DEVICE C/W TWO CONNECTORS WITH NYLON BUSHINGS AND PULL STRINGS FOR USE BY AUDIO VISUAL DEVICE C/W TWO CONNECTORS WITH NYLON BUSHINGS AND PULL STRINGS FOR USE BY AUDIO VISUAL DEVICE C/W TWO CONNECTORS WITH NYLON BUSHINGS AND PULL STRINGS FOR USE BY AUDIO VISUAL DEVICE C/W TWO CONNECTORS WITH NYLON BUSHINGS AND PULL STRINGS FOR USE BY AUDIO VISUAL DEVICE C/W TWO CONNECTORS WITH	Φ	WALL MOUNTED DUPLEX RECEPTACLE 120 VOLT, 15 AMP, CSA 5-15R OR AS
# WALL YOUNTED DUPLEX RECEPTACLE 129 YOUT, 20 AMP, CSA 5-208  # AROW COUNTER DUPLEX RECEPTACLE 129 YOUT, 20 AMP, CSA 5-208  # AROW COUNTED DUPLEX RECEPTACLE 129 YOUT, 15 AMP, CSA 5-108, DEDOCATE CIRCUIT CIRCUIT  # AROW COUNTED ORD DUPLEX RECEPTACLE 129 YOUT, 20 AMP, CSA 5-128, DEDOCATE CIRCUIT CIRCUIT  # AROW COUNTED ORD DUPLEX RECEPTACLE 129 YOUT, 20 AMP, CSA 5-128, DEDOCATE DIRECT CIRCUIT CIRCUIT  # AROW COUNTED ORD DUPLEX RECEPTACLE 129 YOUT, 20 AMP, CSA 5-128, DEDOCATE DIRECT SPECIAL TO YOUT, 15 AMP, CSA 5-128, DEDOCATE DIRECT SPECIAL TO YOUT, 15 AMP, CSA 5-128, DEDOCATE DIRECT SPECIAL TO YOUT, 15 AMP, CSA 5-138  # AROW COUNTED SPECIALTY RECEPTACLE 129 YOUT, 15 AMP, CSA 5-138  # AROW COUNTED RECEPTACLES 2 DUPLEX CSA 5-138  # AROW COUNTED RECEPTACLES 3 DUPLEX CSA 5-138  # TOO COUNTED DUPLEX CSA 5-138  # DUPLEY ROUTED A DUPLEX CSA 5-138  # DUPLEY ROUTED A DUPLEX CSA 5-138  # DUPLEY ROUTED A DUPLEX CSA 5-138  # DUPL		ABOVE COUNTER DUPLEX RECEPTACLE 120 VOLT, 15 AMP, CSA 5-15R OR AS
## ABOVE COUNTER DUPLEY RECEPTACLE 120 YOUT, 10 AMP, CSA 5-208  WALL MOUNTED DUPLEY RECEPTACLE 120 YOUT, 15 AMP, CSA 5-16R, OPTION TO DECORD DECORD.  ## ABOVE COUNTER OF DUPLEY RECEPTACLE 120 YOUT, 16 AMP, CSA 5-15R, DEDOCTED ORGANI  ## ABOVE COUNTER OF DUPLEY RECEPTACLE 120 YOUT, 20 AMP, CSA 5-20R, OEDOCTED ORGANI  ## ABOVE COUNTER OF DUPLEY RECEPTACLE 120 YOUT, 15 AMP, CSA 5-15R  ## CELLING MOUNTED DUPLEY RECEPTACLE 120 YOUT, 15 AMP, CSA 5-15R  ## CELLING MOUNTED DUPLEY RECEPTACLE 120 YOUT, 15 AMP, CSA 5-15R  ## ABOVE COUNTER POSTPACHES 2 DUPLEY CSA 5-15R  ## ABOVE COUNTER RECEPTACLES 3 DUPLEY CSA 5-15R  ## ORGANIZATION SONT SAYOR, DIVE COUNTER SONT MAINT SAYOR OF THE MA		
WALL MOUNTED BUPLEX RECEIPAGE 120 VOIT, 15 WAP, GSA 5-108, DEDOCATIO DIRECTION OF THE ACTION OF THE		
ABOVE COUNTER SECTIONERS RECEIPMENT PLOS VOIT, 15 AMP, CSA 5-168, DEDOCATE OF CHUT OF DEPLEY RECEIPMENT 120 VOIT, 20 AMP, CSA 5-208, DEDOCATE OF CHUT OF THE RECEIPMENT 120 VOIT, 20 AMP, CSA 5-208, DEDOCATE OF CHUT OF THE RECEIPMENT 120 VOIT, 15 AMP, CSA 5-168 CELING MOUNTED GLAD RECEIPMENT 120 VOIT, 15 AMP, CSA 5-158 CELING MOUNTED SECRETY RECEIPMENT 120 VOIT, 15 AMP, CSA 5-158 CELING MOUNTED RECEIPMENT RECEIPMENT 120 VOIT, 15 AMP, CSA 5-158 AMP COUNTER RECEIPMENT RECEIPMENT 120 VOIT, 15 AMP, CSA 5-158 AMP COUNTER RECEIPMENT RECEIPMENT COUNTED ON MAIN MAIN 1-1/4 CONDUIT OR AS SECRETION OF THE AS INDICATED ON MAIN MAIN 1-1/4 CONDUIT OR AS SECRETION OF THE AS INDICATED ON DEPLET SHOWS FOR USE BY COMMUNICATIONS OMNETORS WITH MAIN BENEFICE OF THE COMMUNICATIONS OMNETORS WITH MAIN BENEFICE OF THE COMMUNICATIONS OMNETORS WITH MAIN MICH BENEFICE OF THE COMMUNICATIONS OMNETORS WITH MAIN MICH BENEFICE OF THE COMMUNICATIONS OF THE COMMUNICATION OF THE COMMUNICATIONS OF THE COMMUNICATION OF THE COMMUNICATIO		WALL MOUNTED DUPLEX RECEPTACLE 120 VOLT, 15 AMP, CSA 5-15R,
## SALL MOUNTED GROUP DUPLEX RECEPTACLE 120 VOLT, 20 AMP, CSA 5-206, BROWNED COUNTER FOR DUPLEX RECEPTACLE 120 VOLT, 20 AMP, CSA 5-206, COLORADO CRAUM  CELLING MOUNTED DUPLEX RECEPTACLE 120 VOLT, 15 AMP, CSA 5-158  CELLING MOUNTED QUAD RECEPTACLE 120 VOLT, 15 AMP, CSA 5-158  CELLING MOUNTED QUAD RECEPTACLE 120 VOLT, 15 AMP, CSA 5-158  CELLING MOUNTED GUAD RECEPTACLE 120 VOLT, 15 AMP, CSA 5-158  RADIOL COUNTER RECEPTACLES 2 DUPLEX CSA 5-158  MADDIE BOCKBOX C/W ONE MINIMUM 1-1/4* CONDUIT OR AS SPECIFIED ON DESTRUBBING THE COUNTER RECEPTACLES 2 DUPLEX CSA 5-158  MADDIE BOCKBOX C/W ONE MINIMUM 1-1/4* CONDUIT OR AS SPECIFIED ON DESTRUBBING THE MINIMUM SPECIFICATION OF CONNECTIONS WITH INTO SELECTION OF CONNECTION OF COUNTER THAT AND CHARGE SPECIFIED ON DEPARS, STUBBED INTO CELLING SPACE C/W TWO CONNECTIONS WITH INTO SELECTION OF CONNECTION OF COUNTER THAT AND COUNT		ABOVE COUNTER GFCI DUPLEX RECEPTACLE 120 VOLT, 15 AMP, CSA 5-15R,
## ABOVE COUNTER FORD DUPLEX RECEPTACLE 120 VOLT, 20 AMP, CSA 5 20R.  © CEUNG MOUNTED DUPLEX RECEPTACLE 120 VOLT, 15 AMP, CSA 5-15R  © CEUNG MOUNTED DUPLEX RECEPTACLE 120 VOLT, 15 AMP, CSA 5-15R  © WALL MOUNTED SECRETARY RECEPTACLE 120 VOLT, 15 AMP, CSA 5-15R  © WALL MOUNTED RECEPTACLES 2 DUPLEX CSA 5-15R  Ø ABOVE COUNTER RECEPTACLES 2 DUPLEX CSA 5-15R  Ø ABOVE COUNTER RECEPTACLES 2 DUPLEX CSA 5-15R  Ø CHEROGROX CAY NORM MINIMAL 1-1/4* CONDUIT OR AS SPECIALD ON DUPLEX SERVED SEARCH OF THE MOUNT OF CHING SPACE CAY  PULL STRAIGS FOR USE BY COMPUNICATIONS CONTRACTOR, ONE CONDUIT PRIVATE CONDUIT OR AS SPECIAL OR CONDUCTORS WITH OR CONDUIT OR C		WALL MOUNTED GFCI DUPLEX RECEPTACLE 120 VOLT, 20 AMP, CSA 5-20R,
CELING MOUNTED CURBER RECEPTACLE 120 VOLT, 15 AMP, CSA S-15R  CELING MOUNTED QUAD RECEPTACLE 120 VOLT, 15 AMP, CSA S-15R  CELING MOUNTED GUAD RECEPTACLE 120 VOLT, 15 AMP, CSA S-15R  WALL MOUNTED RECEPTACLES 2 DUPLEX CSA S-15R  WALL MOUNTED RECEPTACLES 2 DUPLEX CSA S-15R  O'NE BACKBOX C/W ONE MINIMUM 1-1/4" CONDUIT OR AS SPECIFIED ON DESCRIPTION TO CELING SPACE COUNTER RECEPTACLES 2 DUPLEX CSA S-15R  O'NE BACKBOX C/W ONE MINIMUM 1-1/4" CONDUIT OR AS SPECIFIED ON DESCRIPTION TO CELING SPACE COUNTED RECEPTACLES 2 DUPLEX CSA S-15R  O'NE BACKBOX C/W ONE MINIMUM 1-1/4" CONDUIT OR AS SPECIFIED ON DESCRIPTION OF USE SPACE CONDUIT OR AS SPECIFIED ON DETAILS, STUDBED INTO CELING SPACE CONDUIT OR AS SPECIFIED ON DETAILS, STUDBED INTO CELING SPACE CONDUIT OR AS SPECIFIED ON DETAILS, STUDBED INTO CELING SPACE OR 70 AMD ADMINISTRATION OF CONNECTIONS WITH INTO PLANS SPACE OR 70 AMD ADMINISTRATE C/W TWO CONNECTIONS WITH INTO CELING SPACE OR 70 AMD ADMINISTRATE C/W TWO CONNECTIONS WITH INTO CELING SPACE OR 70 AMD ADMINISTRATE C/W TWO CONNECTIONS WITH INTO CELING SPACE OR 70 AMD ADMINISTRATE OR 70 CONNECTION WITH INTO CELING SPACE OR 70 AMD ADMINISTRATE OR 70 CONNECTION WITH INTO CELING SPACE OR 70 AMD OF SP		ABOVE COUNTER GFCI DUPLEX RECEPTACLE 120 VOLT, 20 AMP, CSA 5-20R,
## CFILING MOUNTED QUAD RECEPTACE F 120 YOLT, 18 AMP, CSA 5—158   ## WALL MOUNTED RECEPTACLES 2 DUPLEX CSA 5—158  ## ABOVE COUNTER INSTALLATION OF ONE BECKERS 6/M 10 WINNER DUPLE STRINGS FOR USE BY COMMUNICATIONS CONTRACTOR, ONE CONDUIT OR AS SPECIFED ON DE TO COUNTED RESERVED ON DETERMINED THE MOUNTED STALL STRINGS FOR USE BY COMMUNICATIONS CONTRACTOR. ONE CONDUIT PER BEAUTY COUNTED RESERVED ON DETERMINED STRINGS FOR USE BY COMMUNICATIONS CONTRACTOR. ONE CONDUIT PER BEAUTY COUNTED RESERVED ON DETERMINED STRINGS FOR USE BY COMMUNICATIONS CONTRACTOR. ONE CONTRACTOR. THE WINNES FOR USE BY COMMUNICATION STRINGS FOR USE BY AUDIO CONTRACTOR. THE WINNESS FOR USE BY AUDIO CONTRACTOR WINNESS FOR USE BY AUDIO CONTRACTOR WINNESS FOR USE BY AUDIO CONTRACTOR WINNESS FOR USE BY COMMUNICATION CONTRACTOR WINNESS FOR USE BY COMMUNICATION CONTRACTOR WINNESS FOR USE BY COMMUNICATION CONTRACTOR AS SPECIFIED FURTHAL FOR BOX AS SPECIFIED USE BY COMMUNICATION CONTRACTOR AS SPECIFIED FURTHAL FOR FOR USE BY COMMUNICATION CONTRACTOR AS SPECIFIED FURTHAL FOR FOR USE BY COMMUNICATION CONTRACTOR AS SPECIFIED USE BY COMMUNICATION CONTRACTOR AS SPECIFIED FURTHAL FOR FOR MOUNTED FOR BOX AS SPECIFIED CAN TYPE AS		
WALL MOUNTED SPECIALTY RECEPTACLE, TYPE AS INDICATED ON PLAN  WALL MOUNTED RECEPTACLES 2 DUPLEX CSA 5-15R  ### ABOVE COUNTER RECEPTACLES 2 DUPLEX CSA 5-15R  ### ABOVE COUNTER RECEPTACLES 2 DUPLEX CSA 5-15R  ### COMBE BACKBOX C/W ONE MINIMUM 1-1/4" COMBUT OR AS SPECIFIED ON DE STUBBER INTO CHINING SPACE C/W TWO CONNECTORS WITH MION BUSHNOSS PULL STRINGS FOR USE BY COMMUNICATIONS CONTROLLED ON DE MISS. STUBBER DIVID CELINO SPACE C/W TWO CONNECTORS WITH MION BUSHNOSS AND PULL STRINGS FOR USE BY COMMUNICATIONS CONTROLLED ON DEATH S. TUBBER DIVID CELINO SPACE C/W TWO CONNECTORS WITH MICH BUSHNOSS AND PULL STRINGS FOR USE BY AUDIO CONNECTORS WITH MICH BUSHNOSS AND PULL STRINGS FOR USE BY AUDIO CONNECTORS WITH MICH BUSHNOSS AND PULL STRINGS FOR USE BY AUDIO CONNECTORS WITH MICH BUSHNOSS AND PULL STRINGS FOR USE BY AUDIO CONNECTORS WITH MICH BUSHNOSS AND PULL STRINGS FOR USE BY AUDIO CONNECTORS WITH MICH BUSHNOSS AND PULL STRINGS FOR USE BY AUDIO CONNECTORS WITH MICH BUSHNOSS AND PULL STRINGS FOR USE BY AUDIO CONNECTORS WITH MICH BUSHNOSS AND PULL STRINGS FOR USE BY AUDIO CONNECTORS WITH MICH BUSHNOSS AND PULL STRINGS FOR USE BY AUDIO CONNECTORS WITH MICH BUSHNOSS AND PULL STRINGS FOR USE BY AUDIO CONNECTORS WITH MICH BUSHNOSS AND PULL STRINGS FOR USE BY AUDIO CONNECTORS WITH MICH BUSHNOSS AND PULL STRINGS FOR USE BY AUDIO CONNECTORS WITH MICH BUSHNOSS AND PULL STRINGS FOR USE BY AUDIO CONNECTORS WITH MICH BUSHNOSS AND PULL STRINGS FOR USE BY AUDIO CONNECTORS WITH MICH BUSHNOSS AND PULL STRINGS FOR USE BY COMMUNICATION CONTRACTOR.  ### CAULL F = ELECTOR WITH AUDIOUS CSA 5-15R  ### CONNECTION TO THE ELECTOR WITH AUDIOUS FOR USE BY COMMUNICATION CONTRACTOR AS SPECIFIED  ### PLOGS BOX C/W CSA 5-15R AND OPENING FOR USE BY COMMUNICATION CONTRACTOR AS SPECIFIED C/W TYPE AND QUANTITY OF DEVICES MINICATED  ### CORRECTION TO MICH BUSHNOSS AND PULL STRINGS FOR TYPE ADDITION TO MICH BUSHNOSS AND PULL STRINGS FOR TYPE ADDITION TO MICH BUSHNOSS AND PULL STRINGS FOR TYPE ADDITION TO AUDIO PULL STRINGS FOR USE BY COMMUNICATION CONTR		
## WALL MOUNTED RECEPTACLES 2 DUPLEX CSA 5-15R  ## ABOVE COUNTER RECEPTACLES 2 DUPLEX CSA 5-15R  ## ONE BACKDOX C/W ONE MINIMUM 1-1/4* CONDUIT OR AS SPECIFIED ON DE STUBBED INTO CEURING SPACE C/W TWO CONNECTORS WITH NYTION BUSHNOS FOR USE BY COMMUNICATIONS CONTRACTOR. ONE CONDUIT OR AS SPECIFIED ON DE PROXICOX C/W ONE MINIMUM 1-1/4* CONDUIT OR AS SPECIFIED ON DEPAIRS, STUBBED INTO CEURING SPACE C/W TO CONNECTORS WITH NYTION BUSHNOS AND PULL STRINGS FOR USE BY COMMUNICATION SOUTHWARDS ON FOUR CONTRACTORS.  ## ONE-GANG BACKBOX/ANDRING C/W MINIMUM 1-1/4* CONDUIT OR AS SPECIFIED ON DECINIC SPACE ON COMMUNICATION SOUTHWARDS AND PULL STRINGS FOR USE BY AUDIO CONNECTORS WITH INTO BUSHNOS AND PULL STRINGS FOR USE BY AUDIO CONNECTORS WITH INTO BUSHNOS AND PULL STRINGS FOR USE BY AUDIO CONNECTORS WITH INTO BUSHNOS AND PULL STRINGS FOR USE BY AUDIO CONNECTORS WITH INTO BUSHNOS AND PULL STRINGS FOR USE BY AUDIO CONNECTORS WITH INTO BUSHNOS AND PULL STRINGS FOR USE BY AUDIO CONNECTORS WITH INTO BUSHNOS AND PULL STRINGS FOR USE BY AUDIO CONNECTORS WITH INTO BUSHNOS AND PULL STRINGS FOR USE BY AUDIO CONNECTORS WITH INTO BUSHNOS FOR USE BY COMMUNICATION WITH INTO BUSHNOS FOR USE BY COMMUNICATION WITH INTO BUSHNOS FOR USE BY COMMUNICATION ON FOR WITH INTO BUSHNOS FOR USE BY COMMUNICATION WITH INTO BUSHNOS FOR USE BY COMMUNICATION ON FOR USE BY COMMUNICATION OF BUSINGS FOR USE BY COMMUNICATION ON FOR USE BY COMMUNICATION OF BUSINGS FOR		
## ABOVE COUNTER RECEPTACLES 2 DUPLEX CSA 5—15R   ▼ ONE BACKBOX C/W ONE MINIMUM 1—1/4" CONDUIT OR AS SPECIFED ON DE STUBBED INTO CEILING SPACE C/W TWO CONNECTORS WITH WYDON BUSINENSS POLLS STRINGS FOR USE BY COMMUNICATIONS CONTRACTOR, ONE CONDUIT OR AS SPECIFIED ON DETAILS, STUBBED INTO CEILING SPACE C/W TO CONNECTORS WITH MYDION BUSINENSS AND PULL STRINGS FOR USE BY COMMUNICATIONS CONTRACTOR. ONE CONDUIT OR AS SPECIFIED ON DETAILS, STUBBED INTO CEILING SPACE C/W TO CONNECTORS WITH MYDION BUSINENSS AND PULL STRINGS FOR USE BY COMMUNICATIONS CONTRACTOR.   ### CONNECTORS WITH MYDION BUSINENSS AND PULL STRINGS FOR USE BY AUDIO CONTRACTOR.  ### CONNECTORS WITH MYDION BUSINENSS AND PULL STRINGS FOR USE BY AUDIO CONTRACTOR.  ### CONNECTORS WITH MYDION BUSINENSS AND PULL STRINGS FOR USE BY AUDIO CONNECTORS WITH WYDION BUSINESS AND PULL STRINGS FOR USE BY AUDIO CONNECTORS WITH WYDION BUSINESS AND PULL STRINGS FOR USE BY AUDIO CONNECTORS WITH WYDION BUSINESS AND PULL STRINGS FOR USE BY AUDIO CONNECTORS WITH WYDION BUSINESS AND PULL STRINGS FOR USE BY AUDIO CONNECTORS WITH WYDION BUSINESS AND PULL STRINGS FOR USE BY COMMUNICATION WE WILL F = FLOOR, WM = MREBIOLD, P = PAG POLE  ### COOR MOUNTED QUITLET 2 DUPLEX CSA 5—15R  ### FLOOR BOX C/W 2 CSA 5—15R AND OPENING FOR USE BY COMMUNICATION CONTRACTOR AS SPECIFIED  ### CONNECTION TO ELECTRIFIED FURNITURE, LETTER DENOTES FEED LOCATION: WE SPECIFIED CONTRACTOR AS SPECIFIED C/W TYPE AS SPECIFIE	——————————————————————————————————————	
STUBBO INTO CRIMS SPACE OF WIND CONNECTORS WITH WIND BUSHINGS PULL STRINGS FOR USE BY COMMUNICATIONS CONTROCTOR, ONE CONDUTTOR AS SPECIFIED ON DETAILS, STUBBED INTO CRIMS SPACE OF WITH CONDUTTOR AS SPECIFIED ON DETAILS, STUBBED INTO CRIMS SPACE OF WITH CONDUTTOR AS SPECIFIED ON DETAILS, STUBBED INTO CRIMS SPACE OF WITH CONNECTORS WITH WINDOW SUBHINGS AND PULL STRINGS FOR USE BY COMMUNICATION CONNECTORS WITH WINDOW SUBHINGS AND PULL STRINGS FOR USE BY CONNECTORS WITH WINDOW SUBHINGS FACE OF TO MINIMUM 1-1/4" CONDUIT OR AS SPECIFIED ON DETAILS, STUBBED INTO CRIMS SPACE OR TO MINIMUM 1-1/4" CONDUIT OR AS SPECIFIED ON DETAILS, STUBBED INTO CRIMS SPACE OR TO MINIMUM 1-1/4" CONDUIT OR AS SPECIFIED ON DETAILS, STUBBED INTO CRIMS SPACE OR TO MINIMUM 1-1/4" CONDUIT OR AS SPECIFIED ON DETAILS, STUBBED INTO CRIMS SPACE OR TO MINIMUM 1-1/4" CONDUIT OR AS SPECIFIED ON DETAILS, STUBBED INTO CRIMS SPACE OR TO MINIMUM 1-1/4" CONDUIT OR AS SPECIFIED ON DETAILS, STUBBED INTO CRIMS SPACE OR TO MINIMUM 1-1/4" CONDUIT OR AS SPECIFIED ON DETAILS, STUBBED INTO CRIMS SPACE OR TO MINIMUM 1-1/4" CONDUIT OR AS SPECIFIED ON DETAILS, STUBBED INTO CRIMS SPACE OR TO MINIMUM 1-1/4" CONDUIT OR AS SPECIFIED ON DETAILS, STUBBED INTO CRIMS SPACE OR TO MINIMUM 1-1/4" CONDUIT OR AS SPECIFIED ON DETAILS, STUBBED INTO CRIMS SPACE OR TO MINIMUM 1-1/4" CONDUIT OR AS SPECIFIED ON DETAILS, STUBBED INTO CRIMS SPACE OR TO MINIMUM 1-1/4" CONDUIT OR DETAILS, STUBBED INTO CRIMS SPACE OR TO MINIMUM 1-1/4" CONDUIT OR DETAILS, STUBBED INTO CRIMS SPACE OR TO MINIMUM 1-1/4" CONDUIT OR DETAILS MINIMUM 1-1/4" CONDUIT OR		
STUDBED INTO CELING SPACE C/W TWO CONNECTORS ONE CONDUIT FOR POLLS ISTRINGS FOR USE BY COMMUNICATIONS CONTEXCED ON ECONDUIT FOR AS SPECIFED ON DEFAILS, STUBBED INTO CALING SPACE C/W 1 CONNECTORS WITH INTOIN BUSINESS AND PULL STRINGS FOR USE BY COMMUNICATIONS CONTEXTORS WITH INTOIN BUSINESS AND PULL STRINGS FOR USE BY AUDIO CONNECTORS WITH INTOIN BUSINESS AND PULL STRINGS FOR USE BY AUDIO CONNECTORS WITH INTOIN BUSINESS AND PULL STRINGS FOR USE BY AUDIO CONNECTORS WITH INTOIN BUSINESS AND PULL STRINGS FOR USE BY AUDIO CONNECTORS WITH INTOIN BUSINESS AND PULL STRINGS FOR USE BY AUDIO CONNECTORS WITH INTOIN BUSINESS AND PULL STRINGS FOR USE BY AUDIO CONTRACTOR.   TWO—GANG BACKBOX/MUDBING C/W MINIMUM 1—1/4" CONDUIT OR AS SPECIFIC ON DEFAILS, STUBBED INTO CELING SPACE OR TO AUDIO VISIAL DEVICE C/W TWO CONNECTORS WITH INTOIN BUSINESS AND PULL STRINGS FOR USE BY AUDIO CONTRACTOR.  TWO—GANG BACKBOX/MUDBING C/W MINIMUM 1—1/4" CONDUIT OR AS SPECIFIC DETAILS, STUBBED INTO CELING SPACE OR TO AUDIO VISIAL DEVICE C/W TWO CONNECTORS WITH INTOIN BUSINESS AND PULL STRINGS FOR USE BY AUDIO CONTRACTOR.  CONNECTOR WITH INTOIN BUSINESS AND PULL STRINGS FOR USE BY AUDIO CONTRACTOR.  FLOOR BOX COMPLETE WITH DUPLEX CSA 5—15R  FLOOR BOX COMPLETE WITH D	<u>т</u>	
OONDUTT OR AS SPECIFIED ON DETAILS, STUBBED INTO CEUING SPACE C/W TOONNECTORS WITH HYLON BUSHNOS AND PLLL STRINGS FOR USE BY COMMUNICATIONS CONTRACTOR. ONE CONDUTT PER BOX.  □ ONE—CANG BACKBOX/MUDRING C/W MINMUM 1—1/4" CONDUIT OR AS SPECIFIC ON TO AUDIO VISIAL DEMCE C/W TWO CONNECTORS WITH HYLON BUSHNOS AND PULL STRINGS FOR USE BY AUDIO CONNECTORS WITH HYLON BUSHNOS AND PULL STRINGS FOR USE BY AUDIO CONNECTORS WITH HYLON BUSHNOS AND PULL STRINGS FOR USE BY AUDIO CONNECTORS WITH HYLON BUSHNOS AND PULL STR FOR USE BY AUDIO VISUAL EXCECT C/W TWO CONNECTORS WITH HYLON BUSHNOS AND PULL STR FOR USE BY AUDIO VISUAL CONNECTORS WITH HYLON BUSHNOS FOR USE BY AUDIO CONNECTORS WITH HYLON BUSHNOS FOR USE BY AUDIO CONNECTORS WITH HYLON BUSHNOS FOR USE BY AUDIO CONNECTORS WITH HYLON BUSHNOS AND PULL STR CONNECTORS WITH HYLON BUSHNOS FOR USE BY AUDIO CONNECTORS WITH HYLON BUSHNOS AND PULL STR AUDIO CONNECTORS WITH HYLON BUSHNOS AND PULL STR AUDIO CONNECTORS WITH HYLON BUSHNOS AND PULL STR AUDIO CONNECTION TO ELECTRIFIED FURNITURE. LETTER DENOTES FEED LOCATION:  □ FLOOR BOX COMPLETE WITH DUPLEX CSA 5—15R  □ FLOOR BOX COMPLETE WITH DUPLEX CSA 5—15R  □ FLOOR BOX C/W CSA 5—15R AND OPENING FOR USE BY COMMUNICATION CONTRACTOR AS SPECIFIED  □ FLOOR BOX C/W CSA 5—15R AND OPENING FOR USE BY COMMUNICATION CONTRACTOR AS SPECIFIED  □ FLOOR BOX C/W CSA 5—15R AND OPENING FOR USE BY COMMUNICATION CONTRACTOR AS SPECIFIED  □ FLOOR BOX C/W CSA 5—15R AND OPENING FOR USE BY COMMUNICATION CONTRACTOR AS SPECIFIED C/W TYPE AND QUANTITY OF DEVICES INDICATED  □ FLOOR BOX C/W CSA 5—15R AND OPENING FOR USE BY COMMUNICATION CONTRACTOR AS SPECIFIED C/W TYPE AND QUANTITY OF DEVICES INDICATED  □ SERVEL POLE. TYPE AS SPECIFIED C/W TYPE AND QUANTITY OF DEVICES INDICATED  □ DISCONNECT SWITCH	•	ONE BACKBOX C/W ONE MINIMUM 1-1/4" CONDUIT OR AS SPECIFIED ON DE- STUBBED INTO CEILING SPACE C/W TWO CONNECTORS WITH NYLON BUSHINGS PULL STRINGS FOR USE BY COMMUNICATIONS CONTRACTOR. ONE CONDUIT PER
### DETAILS, STUBBED INTO CELING SPACE OR TO AUDIO YSUAL BENCE C/W TWO CONTRACTOR.  ### ABOVE COUNTER INSTALLATION OF ONE—GANG BACKBOX C/W MINIMUM 1—1/4 CONDUIT OR AS SPECIFIED ON DETAILS, STUBBED INTO CELING SPACE OR TO YOU WIS ALL POWER C/W TWO CONNECTORS WITH PYLON BUSHINGS AND PULL STREET OF TO YOU USE BY AUDIO VISUAL EVOLE C/W TWO CONNECTORS.  #### TWO—GANG BACKBOX/AMUDRING C/W MINIMUM 1—1/4* CONDUIT OR AS SPECIFIED ON DETAILS, STUBBED INTO CELING SPACE OR TO AUDIO VISUAL DEVICE C/W TWO CONTRACTOR.  #### CABLE TV OUTLET WALL MOUNTED ROUGH—IN  ### CONNECTION TO ELECTRIFIED FURNITURE, LETTER DENOTES FEED LOCATION: W = WALL, F = FLOOR, WM = WIREMOLD, P = PAC POLE  ### FLOOR MOUNTED OUTLET 2 DUPLEX CSA 5—15R  ### FLOOR MOUNTED OUTLET 2 DUPLEX CSA 5—15R  ### FLOOR BOX C/W CSA 5—15R AND OPENING FOR USE BY COMMUNICATION CONTRACTOR AS SPECIFIED  ### FLOOR BOX C/W 2 CSA 5—15R AND OPENING FOR USE BY COMMUNICATION CONTRACTOR AS SPECIFIED  ### FLOOR MOUNTED WIREMOLD RACEWAY, TYPE AS SPECIFIED C/W TYPE AD QUANTITY OF DEVICES INDICATED  ### SERVICE POLE, TYPE AS SPECIFIED C/W TYPE AND QUANTITY OF DEVICES INDICATED  ### PANEL—FLUSH MOUNT  ### DISCONNECT SWITCH  ### CONNECTION TO MOUTOR  ### MANUAL STARTER  ### CONNECTION TO MOUTOR  ### MANUAL STARTER  ### CONNECTION TO SPECIFICATION LETTER DENOTES FOR TYPE  ### CABLE TRAY REPER TO SPECIFICATION LETTER DENOTES FOR TYPE  ### SIGNAL BULL  ### PAGING SPEAKER	*	
CONDUIT OR AS SPECIFIED ON DETAILS, STUBBED INTO CEILUNG SPACE OR TO VISUAL DEVICE C/W TWO CONNECTORS WITH NYLON BUSHNOS AND PULL STR FOR USE BY AUDIO VISUAL CONTRACTOR.  TWO-GANG BACKBOX/MUDRING C/W MINIMUM 1-1/4" CONDUIT OR AS SPECIFIC OCCURRACTOR.  TWO-GANG BACKBOX/MUDRING C/W MINIMUM 1-1/4" CONDUIT OR AS SPECIFIC DETAILS, STUBBED INTO CEILING SPACE OR TO AUDIO VISUAL DEVICE C/W TWO CONNECTORS WITH NYLON BUSHNOS AND PULL STRINGS FOR USE BY AUDIO CONTRACTOR.  CABLE TV OUTLET WALL MOUNTED ROUGH—N  CONNECTION TO ELECTRIFED FURNITURE, LETTER DENOTES FEED LOCATION: W = WALL, F = FLOOR, WM = WIREMOLD, P = FAC POLE  FLOOR BOX COMPLETE WITH DUPLEX CSA 5-15R  FLOOR BOX COMPLETE WITH DUPLEX CSA 5-15R  FLOOR BOX C/W CSA 5-15R AND OPENING FOR USE BY COMMUNICATION CONTRACTOR AS SPECIFIED  FLOOR BOX C/W CSA 5-15R AND OPENING FOR USE BY COMMUNICATION CONTRACTOR AS SPECIFIED  FLOOR BOX C/W 2. CSA 5-15R AND OPENING FOR USE BY COMMUNICATION CONTRACTOR AS SPECIFIED  FLOOR BOX C/W 2. CSA 5-15R AND OPENING FOR USE BY COMMUNICATION CONTRACTOR AS SPECIFIED  WALL/FLOOR MOUNTED WIREMOLD RACEWAY, TYPE AS SPECIFIED C/W TYPE AUDIOUNTITY OF DEVICES INJUNCATED  SERVICE POLE, TYPE AS SPECIFIED C/W TYPE AND QUANTITY OF DEVICES NOUNTITY OF DEVICES MUNICATED  PANEL-SURFACE MOUNT  PANEL-FLUSH MOUNT  DIRECT CONNECTION TO EQUIPMENT AS NOTED  COMBINATION DISCONNECT/STARTER  DISCONNECT SWITCH  TRANSFORMER  CONNECTION TO MOTOR  MANUAL STARTER  CONTACTOR  GROUNDING BUS BAR  CABLE TRAY REFER TO SPECIFICATION LETTER DENOTES FOR TYPE  SIGNAL BELL  PAGING SPEAKER	<b>†</b>	ONE-GANG BACKBOX/MUDRING C/W MINIMUM 1-1/4" CONDUIT OR AS SPECIF DETAILS, STUBBED INTO CEILING SPACE OR TO AUDIO VISUAL DEVICE C/W TWO CONNECTORS WITH NYLON BUSHINGS AND PULL STRINGS FOR USE BY AUDIO CONTRACTOR.
DETAILS, STUBBED INTO CEILING SPACE OR TO AUDIO VISUAL DEVOCE C/W TWO CONNECTORS WITH NYLON BUSHINGS AND PULL STRINGS FOR USE BY AUDIO CONTRACTOR.  CABLE TV OUTLET WALL MOUNTED ROUGH—IN  CONNECTION TO ELECTRIFIED FURNITURE, LETTER DENOTES FEED LOCATION: W = WALL, F = FLOOR, WM = WIREMOLD, P = PAC POLE  FLOOR BOX COMPLETE WITH DUPLEX CSA 5—15R  FLOOR MOUNTED OUTLET 2 DUPLEX CSA 5—15R  FLOOR MOUNTED OUTLET 2 DUPLEX CSA 5—15R  FLOOR BOX C/W CSA 5—15R AND OPENING FOR USE BY COMMUNICATION CONTRACTOR AS SPECIFIED  FLOOR BOX C/W 2 CSA 5—15R AND OPENING FOR USE BY COMMUNICATION CONTRACTOR AS SPECIFIED  FLUSH POKE—THROUGH FLOOR BOX AS SPECIFIED  WALL/FLOOR MOUNTED WIREMOLD RACEWAY, TYPE AS SPECIFIED C/W TYPE AUDIONATED  SERVICE POLE, TYPE AS SPECIFIED C/W TYPE AND QUANTITY OF DEVICES INDICATED  PANEL—SURFACE MOUNT  PANEL—FLUSH MOUNT  DIRECT CONNECTION TO EQUIPMENT AS NOTED  COMBINATION DISCONNECT/STARTER  DISCONNECT SWITCH  TRANSFORMER  CONNECTION TO MOTOR  MANUAL STARTER  CONNECTION TO MOTOR  MANUAL STARTER  CONTACTOR  BUZZER  GROUNDING BUS BAR  CABLE TRAY REFER TO SPECIFICATION LETTER DENOTES FOR TYPE  SIGNAL BELL  PAGING SPEAKER	<b>*</b>	ABOVE COUNTER INSTALLATION OF ONE-GANG BACKBOX C/W MINIMUM 1-1/4 CONDUIT OR AS SPECIFIED ON DETAILS, STUBBED INTO CEILING SPACE OR TO VISUAL DEVICE C/W TWO CONNECTORS WITH NYLON BUSHINGS AND PULL STR FOR USE BY AUDIO VISUAL CONTRACTOR.
CABLE TV OUTLET WALL MOUNTED ROUGH-IN  CONNECTION TO ELECTRIFIED FURNITURE, LETTER DENOTES FEED LOCATION:  W = WALL, F = FLOOR, WM = WIREMOLD, P = PAC POLE  FLOOR BOX COMPLETE WITH DUPLEX CSA 5-15R  FLOOR MOUNTED OUTLET 2 DUPLEX CSA 5-15R  FLOOR BOX C/W CSA 5-15R AND OPENING FOR USE BY COMMUNICATION CONTRACTOR AS SPECIFIED  FLOOR BOX C/W 2. CSA 5-15R AND OPENING FOR USE BY COMMUNICATION CONTRACTOR AS SPECIFIED  FLOOR BOX C/W 2. CSA 5-15R AND OPENING FOR USE BY COMMUNICATION CONTRACTOR AS SPECIFIED  WALL/FLOOR BOX C/W 2. CSA 5-15R AND OPENING FOR USE BY COMMUNICATION CONTRACTOR AS SPECIFIED  FLUSH POKE-THOUGH FLOOR BOX AS SPECIFIED  WALL/FLOOR MOUNTED WIREMOLD RACEWAY, TYPE AS SPECIFIED C/W TYPE AND QUANTITY OF DEVICES INDICATED  SERVICE POLE, TYPE AS SPECIFIED C/W TYPE AND QUANTITY OF DEVICES INDICATED  PANEL-SURFACE MOUNT  PANEL-FLUSH MOUNT  COMBINATION DISCONNECT/STARTER  DISCONNECT SWITCH  TRANSFORMER  COMMUNICATION TO MOTOR  MANUAL STARTER  CONTACTOR  BUZZER  CROUNDING BUS BAR  CABLE TRAY REFER TO SPECIFICATION LETTER DENOTES FOR TYPE  SIGNAL BELL  PAGING SPEAKER	<b>*</b>	TWO-GANG BACKBOX/MUDRING C/W MINIMUM 1-1/4" CONDUIT OR AS SPECIF DETAILS, STUBBED INTO CEILING SPACE OR TO AUDIO VISUAL DEVICE C/W TWO CONNECTORS WITH NYLON BUSHINGS AND PULL STRINGS FOR USE BY AUDIO CONTRACTOR
CONNECTION TO ELECTRIFIED FURNITURE, LETTER DENOTES FEED LOCATION:  W = WALL, F = FLOOR, WM = WIREMOLD, P = PAC POLE  FLOOR BOX COMPLETE WITH DUPLEX CSA 5-15R  FLOOR MOUNTED OUTLET 2 DUPLEX CSA 5-15R  FLOOR BOX C/W CSA 5-15R AND OPENING FOR USE BY COMMUNICATION CONTRACTOR AS SPECIFIED  FLOOR BOX C/W 2 CSA 5-15R AND OPENING FOR USE BY COMMUNICATION CONTRACTOR AS SPECIFIED  FLUSH POKE-THROUGH FLOOR BOX AS SPECIFIED  WALL/FLOOR MOUNTED WIREMOLD RACEWAY, TYPE AS SPECIFIED C/W TYPE / QUANTITY OF DEVICES INDICATED  WALL-SURFACE MOUNT  PANEL-SURFACE MOUNT  PANEL-FLUSH MOUNT  DIRECT CONNECTION TO EQUIPMENT AS NOTED  COMBINATION DISCONNECT/STARTER  CONNECTION TO MOTOR  TRANSFORMER  CONNECTION TO MOTOR  MANUAL STARTER  CONTACTOR  BUZZER  GROUNDING BUS BAR  CABLE TRAY REFER TO SPECIFICATION LETTER DENOTES FOR TYPE  GIGNAL BELL  PAGING SPEAKER	+	
FLOOR BOX COMPLETE WITH DUPLEX CSA 5-15R  FLOOR BOX C/W CSA 5-15R AND OPENING FOR USE BY COMMUNICATION CONTRACTOR AS SPECIFIED  FLOOR BOX C/W CSA 5-15R AND OPENING FOR USE BY COMMUNICATION CONTRACTOR AS SPECIFIED  FLOOR BOX C/W 2 CSA 5-15R AND OPENING FOR USE BY COMMUNICATION CONTRACTOR AS SPECIFIED  FLUSH POKE-THROUGH FLOOR BOX AS SPECIFIED  PAUL_FLOOR MOUNTED WIREMOLD RACEWAY, TYPE AS SPECIFIED C/W TYPE / QUANTITY OF DEVICES INDICATED  SERVICE POLE, TYPE AS SPECIFIED C/W TYPE AND QUANTITY OF DEVICES INDICATED  PANEL-FLUSH MOUNT  PANEL-FLUSH MOUNT  DIRECT CONNECTION TO EQUIPMENT AS NOTED  COMBINATION DISCONNECT/STARTER  DISCONNECT SWITCH  TRANSFORMER  CONNECTION TO MOTOR  MANUAL STARTER  CONTACTOR  BUZZER  GROUNDING BUS BAR  CABLE TRAY REFER TO SPECIFICATION LETTER DENOTES FOR TYPE  SIGNAL BELL  PAGING SPEAKER	<u> </u>	
FLOOR MOUNTED OUTLET 2 DUPLEX CSA 5-15R  FLOOR BOX C/W CSA 5-15R AND OPENING FOR USE BY COMMUNICATION CONTRACTOR AS SPECIFIED  FLOOR BOX C/W 2 CSA 5-15R AND OPENING FOR USE BY COMMUNICATION  FLUSH POKE-THROUGH FLOOR BOX AS SPECIFIED  WALL/FLOOR MOUNTED WIREMOLD RACEWAY, TYPE AS SPECIFIED C/W TYPE / QUANTITY OF DEVICES INDICATED  SERVICE POLE, TYPE AS SPECIFIED C/W TYPE AND QUANTITY OF DEVICES INDICATED  PANEL-FLUSH MOUNT  PANEL-FLUSH MOUNT  DIRECT CONNECTION TO EQUIPMENT AS NOTED  COMBINATION DISCONNECT/STARTER  DISCONNECT SWITCH  TRANSFORMER  CONNECTION TO MOTOR  MANUAL STARTER  CONTACTOR  BUZZER  GROUNDING BUS BAR  CABLE TRAY REFER TO SPECIFICATION LETTER DENOTES FOR TYPE  SIGNAL BELL  PAGING SPEAKER		
FLOOR BOX C/W CSA 5-15R AND OPENING FOR USE BY COMMUNICATION CONTRACTOR AS SPECIFIED  FLOOR BOX C/W 2 CSA 5-15R AND OPENING FOR USE BY COMMUNICATION CONTRACTOR AS SPECIFIED  FLUSH POKE—THROUGH FLOOR BOX AS SPECIFIED  WALL/FLOOR MOUNTED WIREMOLD RACEWAY, TYPE AS SPECIFIED C/W TYPE A QUANTITY OF DEVICES INDICATED  SERVICE POLET, TYPE AS SPECIFIED C/W TYPE AND QUANTITY OF DEVICES INDICATED  PANEL—SURFACE MOUNT  PANEL—FLUSH MOUNT  DIRECT CONNECTION TO EQUIPMENT AS NOTED  COMBINATION DISCONNECT/STARTER  DISCONNECT SWITCH  TRANSFORMER  CONNECTION TO MOTOR  MANUAL STARTER  CONTACTOR  BUZZER  GROUNDING BUS BAR  CABLE TRAY REFER TO SPECIFICATION LETTER DENOTES FOR TYPE  SIGNAL BELL  PAGING SPEAKER		
CONTRACTOR AS SPECIFIED  FLOOR BOX C/W 2 CSA 5-15R AND OPENING FOR USE BY COMMUNICATION CONTRACTOR AS SPECIFIED  FLUSH POKE-THROUGH FLOOR BOX AS SPECIFIED  WALL/FLOOR MOUNTED WIREMOLD RACEWAY, TYPE AS SPECIFIED C/W TYPE / QUANTITY OF DEVICES INDICATED  PANEL—SURFACE MOUNT  PANEL—SURFACE MOUNT  PANEL—FLUSH MOUNT  COMBINATION DISCONNECT/STARTER  COMBINATION DISCONNECT/STARTER  TRANSFORMER  CONNECTION TO MOTOR  MANUAL STARTER  CONTACTOR  BUZZER  GROUNDING BUS BAR  CABLE TRAY REFER TO SPECIFICATION LETTER DENOTES FOR TYPE  SIGNAL BELL  PAGING SPEAKER		
CONTRACTOR AS SPECIFIED  FLUSH POKE—THROUGH FLOOR BOX AS SPECIFIED  WALL/FLOOR MOUNTED WIREMOLD RACEWAY, TYPE AS SPECIFIED C/W TYPE / QUANTITY OF DEVICES INDICATED  SERVICE POLE, TYPE AS SPECIFIED C/W TYPE AND QUANTITY OF DEVICES INDICATED  PANEL—SURFACE MOUNT  PANEL—FLUSH MOUNT  DIRECT CONNECTION TO EQUIPMENT AS NOTED  COMBINATION DISCONNECT/STARTER  DISCONNECT SWITCH  TRANSFORMER  CONNECTION TO MOTOR  MANUAL STARTER  CONTACTOR  BUZZER  A CROUNDING BUS BAR  CABLE TRAY REFER TO SPECIFICATION LETTER DENOTES FOR TYPE  SIGNAL BELL  PAGING SPEAKER		CONTRACTOR ÁS SPECIFIED
■ WALL/FLOOR MOUNTED WIREMOLD RACEWAY, TYPE AS SPECIFIED C/W TYPE A QUANTITY OF DEVICES INDICATED  SERVICE POLE, TYPE AS SPECIFIED C/W TYPE AND QUANTITY OF DEVICES INDICATED  PANEL—SURFACE MOUNT  PANEL—FLUSH MOUNT  COMBINATION DISCONNECT/STATTER  DISCONNECT SWITCH  TRANSFORMER  CONNECTION TO MOTOR  MANUAL STARTER  CONTACTOR  BUZZER  GROUNDING BUS BAR  CABLE TRAY REFER TO SPECIFICATION LETTER DENOTES FOR TYPE  SIGNAL BELL  PAGING SPEAKER		CONTRACTOR AS SPECIFIED
QUANTITY OF DEVICES INDICATED  SERVICE POLE, TYPE AS SPECIFIED C/W TYPE AND QUANTITY OF DEVICES INDICATED  PANEL—SURFACE MOUNT  PANEL—FLUSH MOUNT  DIRECT CONNECTION TO EQUIPMENT AS NOTED  COMBINATION DISCONNECT/STARTER  DISCONNECT SWITCH  TRANSFORMER  CONNECTION TO MOTOR  MANUAL STARTER  CONTACTOR  BUZZER  BUZZER  GROUNDING BUS BAR  CABLE TRAY REFER TO SPECIFICATION LETTER DENOTES FOR TYPE  SIGNAL BELL  PAGING SPEAKER		
PANEL - SURFACE MOUNT		QUANTITY OF DEVICES INDICATED
PANEL—FLUSH MOUNT  DIRECT CONNECTION TO EQUIPMENT AS NOTED  COMBINATION DISCONNECT/STARTER  DISCONNECT SWITCH  TRANSFORMER  CONNECTION TO MOTOR  MANUAL STARTER  CONTACTOR  BUZZER  GROUNDING BUS BAR  CABLE TRAY REFER TO SPECIFICATION LETTER DENOTES FOR TYPE  SIGNAL BELL  PAGING SPEAKER		
▲ DIRECT CONNECTION TO EQUIPMENT AS NOTED   ☑ COMBINATION DISCONNECT/STARTER   ☐ DISCONNECT SWITCH   ☑ TRANSFORMER   ✓ CONNECTION TO MOTOR   ☑ MANUAL STARTER   ☑ CONTACTOR   ☐ BUZZER   ☑ GROUNDING BUS BAR   ☐ CABLE TRAY REFER TO SPECIFICATION LETTER DENOTES FOR TYPE   ⑥ SIGNAL BELL   ⑤ PAGING SPEAKER		PANEL-SURFACE MOUNT
☑→ COMBINATION DISCONNECT/STARTER   ☐→ DISCONNECT SWITCH   ☑ TRANSFORMER   ✓ CONNECTION TO MOTOR   ☑ MANUAL STARTER   ☑ CONTACTOR   ☐→ BUZZER   ☑ GROUNDING BUS BAR   ☐→ CABLE TRAY REFER TO SPECIFICATION LETTER DENOTES FOR TYPE   ☑ SIGNAL BELL   ⑤ PAGING SPEAKER		PANEL-FLUSH MOUNT
□□□□□□□□□□□□□□□□□□□□□□□□□□□□□□□□□□□□□	<b>(A)</b>	DIRECT CONNECTION TO EQUIPMENT AS NOTED
TRANSFORMER  CONNECTION TO MOTOR  MANUAL STARTER  CONTACTOR  BUZZER  GROUNDING BUS BAR  CABLE TRAY REFER TO SPECIFICATION LETTER DENOTES FOR TYPE  SIGNAL BELL  PAGING SPEAKER		COMBINATION DISCONNECT/STARTER
CONNECTION TO MOTOR  MANUAL STARTER  CONTACTOR  BUZZER  GROUNDING BUS BAR  CABLE TRAY REFER TO SPECIFICATION LETTER DENOTES FOR TYPE  SIGNAL BELL  PAGING SPEAKER	마	DISCONNECT SWITCH
MANUAL STARTER   CONTACTOR   BUZZER   GROUNDING BUS BAR   CABLE TRAY REFER TO SPECIFICATION LETTER DENOTES FOR TYPE   SIGNAL BELL   PAGING SPEAKER		TRANSFORMER
CONTACTOR  BUZZER  GROUNDING BUS BAR  CABLE TRAY REFER TO SPECIFICATION LETTER DENOTES FOR TYPE  SIGNAL BELL  PAGING SPEAKER	<b>\( </b>	CONNECTION TO MOTOR
BUZZER  GROUNDING BUS BAR  CABLE TRAY REFER TO SPECIFICATION LETTER DENOTES FOR TYPE  SIGNAL BELL  PAGING SPEAKER		MANUAL STARTER
GROUNDING BUS BAR  CABLE TRAY REFER TO SPECIFICATION LETTER DENOTES FOR TYPE  SIGNAL BELL  PAGING SPEAKER		CONTACTOR
CABLE TRAY REFER TO SPECIFICATION LETTER DENOTES FOR TYPE  SIGNAL BELL  PAGING SPEAKER		BUZZER
SIGNAL BELL  PAGING SPEAKER	$\Delta \Delta$	GROUNDING BUS BAR
PAGING SPEAKER		CABLE TRAY REFER TO SPECIFICATION LETTER DENOTES FOR TYPE
	(B)	SIGNAL BELL
AUDIO VISUAL SPEAKER	 	PAGING SPEAKER
<u> </u>	A	AUDIO VISUAL SPEAKER

FIRE ALARM STROBE — CEILING MOUNTED / WALL MOUNTED  FIRE ALARM EVACUATION SPEAKER STROBE COMBINATION  FIRE ALARM EVACUATION SPEAKER STROBE COMBINATION  FIRE ALARM CONTROL PANEL / ANNUNCIATOR PANEL  FIRE ALARM END OF LINE RESISTOR  LIGHTING LEGEND  EXISTING BASE BUILDING LUMINAIRE TO REMAIN  EXISTING BASE BUILDING LUMINAIRE TO BE REMOVED AND RELOCATED  BASE BUILDING LUMINAIRE RELOCATED OR NEW  EXISTING BASE BUILDING EMERGENCY LUMINAIRE TO BE REACOVED AND RELOCATED  BASE BUILDING LUMINAIRE RELOCATED AND OR NEW EMER RELOCATED  TRACK LIGHTING C/W NUMBER OF FIXTURES SHOWN  CEILING MOUNTED LUMINAIRE EMERGENCY CIRCUIT  CEILING MOUNTED LUMINAIRE  CEILING MOUNTED LUMINAIRE  SINGLE POLE LINE VOLTAGE LIGHT SWITCH  SINGLE	PRE ALARM BELL  SMOKE DETECTOR  PEAT DETECTOR  DUCT MOUNTED SMOKE DETECTOR / HEAT DETECTOR  PERE ALARM HOLD OPEN DEVICE — CONNECTION ONLY  PERE ALARM HOLD OPEN DEVICE — CONNECTION ONLY  PERE ALARM HOLD OPEN DEVICE — CONNECTION ONLY  PERE ALARM EVACUATION SPEAKER — CEILING MOUNTED / WALL MOUNTED  PERE ALARM EVACUATION SPEAKER STROBE CONBRATION — CEILING MOUNTED  PERE ALARM EVACUATION SPEAKER STROBE CONBRATION — CEILING MOUNTED  PERE ALARM EVACUATION SPEAKER STROBE CONBRATION — CEILING MOUNTED  PERE ALARM HORN/STROBE COVBINATION  PERE ALARM END OF LINE RESISTOR  LIGHTING LEGEND  EXISTING BASE BUILDING LUMINAIRE TO BE REMOVED AND OR  PELOCATED  EXISTING BASE BUILDING LUMINAIRE TO BE REMOVED AND OR  PELOCATED  SASE BUILDING LUMINAIRE RELOCATED OR NEW  EXISTING BASE BUILDING EMERGENCY LUMINAIRE TO BE REMOVED AND OR  PELOCATED  PERE ALARM END OF LUMINAIRE PELOCATED AND OR NEW EMERGENCY CIRCUIT  PERCENTING MOUNTED LUMINAIRE RELOCATED AND OR NEW EMERGENCY CIRCUIT  PERCENTING MOUNTED LUMINAIRE EMERCENCY CIRCUIT  PELOCATED  PERDANT FATURE  SINGLE POLE LINE VOLTAGE LIGHT SWITCH  SO WAY — LINE VOLTAGE LIGHT SWITCH  SO WALL MOUNTED OCCUPANCY SENSOR  WALL MOUNTED OCCUPANCY SENSOR  WALL MOUNTED DEMERGENCY SENSOR  WALL MOUNTED EMERGENCY DOUBLE REMOTE HEAD  CHELING MOUNTED EMERGENCY DOUBLE REMO
HEAT DETECTOR  FIRE ALARM HOUD OPEN DEVICE — CONNECTION ONLY  FIRE ALARM HOUD OPEN DEVICE — CONNECTION ONLY  HEAT ALARM EVACUATION SPEAKER — CEILING MOUNTED /  HEAT ALARM EVACUATION SPEAKER STROBE COMBINATION  HEAT ALARM EVACUATION SPEAKER STROBE CELING MOUNTED SHORT STROBE  HEAT ALARM EVACUATION SPEAKER STROBE COMBINATION  HEAT ALARM EVACUATION SPEAKER STROBE COMBINATION  HEAT ALARM EVACUATION SPEAKER STROBE COMBINATION  HEAT ALAR	EMAKE DETECTOR  HEAT DETECTOR  DUCT MOUNTED SMOKE DETECTOR / HEAT DETECTOR  FREMAN'S HANDSET  FRE ALARM HORN SINGLE  FIRE ALARM HORN SINGLE  FIRE ALARM EVACUATION SPEAKER — CEILING MOUNTED / WALL MOUNTED  FIRE ALARM EVACUATION SPEAKER — CEILING MOUNTED / WALL MOUNTED  FIRE ALARM EVACUATION SPEAKER STROBE COMBINATION — CEILING MOUNTED  FIRE ALARM EVACUATION SPEAKER STROBE COMBINATION — CEILING MOUNTED  FIRE ALARM HORN/STROBE COMBINATION  FIRE ALARM END OF LINE RESISTOR  LIGHTING LEGEND  EXISTING BASE BUILDING LUMINAIRE TO BE REMOVED AND OR  FECOLATED  EXISTING BASE BUILDING LUMINAIRE TO BE REMOVED AND OR  FECOLATED  EXISTING BASE BUILDING LUMINAIRE TO BE REMOVED AND OR  FECOLATED  EXISTING BASE BUILDING LUMINAIRE TO BE REMOVED AND OR  FECOLATED  FERCE LUMINAIRE RELOCATED AND OR NEW EMERGENCY CIRCUIT  FERCE LUMINAIRE PREFERENCY CIRCUIT  FERCE LUMINAIRE DUMINAIRE EMERGENCY CIRCUIT  FERCE LUMINAIRE DUMINAIRE EMERGENCY CIRCUIT  FERCE LUMINAIRE WASHER LUMINAIRE  SELLING MOUNTED LUMINAIRE EMERGENCY CIRCUIT  FERCE LUNE VOLTAGE LIGHT SWITCH  SOMY — LINE VOLTAGE LIGHT SWITCH  SOMY LIGHT PHOTO SENSOR  WALL MOUNTED DECEMPANCY SENSOR SWITCH  MALL MOUNTED EMERGENCY SINGLE REMOTE HEAD  CHERGENCY LIGHTING BATTERY UNIT C/W NUMBER OF HEADS SHOWN  CHERCENCY LIGHTING BATTERY UNIT C/W NUMBER OF HEADS SHOWN  CHERCENCY LIGHTING BATTERY UNIT C/W NUMBER OF HEADS SHOWN  CHERCENCY LIGHTING BATTERY UNIT C/W NUMBER OF HEADS SHOWN  CHERCENCY LIGHTING BATTERY UNIT C/W NUMBER OF HEADS SHOWN  CHERCENCY LIGHTING BATTERY UNIT C/W NUMBER OF HEADS SHOWN  CHERCENCY LIGHTING BATTERY UNIT C/W NUMBER OF HEADS SHOWN  CHERCENCY LIGHTING BATTERY UNIT C/W NUMBER OF HEADS SHOWN  CHERCENCY LIGHTING BATTERY UNIT C/W NUMBER OF HEADS SHOWN
HEAT DETECTOR  THE OUT MOUNTED SMOKE DETECTOR / HEAT DETECTOR  FIRE MARM'S HANDSET  FIRE ALARM HORN SINGLE  FIRE ALARM HORN SINGLE  FIRE ALARM EVACUATION SPEAKER — CEILING MOUNTED / WALL SENSOR / CEILING MOUNTED LUMINAIRE TO BE REMOVED AND RELOCATED OR NEW / CEILING MOUNTED LUMINAIRE RELOCATED AND OR NEW EMER PLAY / WALL SCONCE / PENDANT FIXTURE  SINGLE POLE LINE VOLTAGE LIGHT SWITCH / WALL SCONCE / PENDANT FIXTURE  SINGLE POLE LINE VOLTAGE LIGHT SWITCH / WALL SCONCE / PENDANT FIXTURE  SINGLE POLE LINE VOLTAGE LIGHT SWITCH / WALL SCONCE / PENDANT FIXTURE  SINGLE POLE LINE VOLTAGE LIGHT SWITCH / WALL SCONCE / PENDANT FIXTURE / WALL MOUNTED COUPANCY SENSOR SWITCH / WALL MOUNTED DOCUPANCY SENSOR SWITCH / WALL MOUNTED DOCUPANCY SENSOR SWITCH / WALL MOUNTED DEMERGENCY DOUBLE REMOTE HEAD / WALL MOUNTED EMERGENCY SINGLE REMOTE HEAD / WALL MOUNTED EMERGENCY DOUBLE REMOTE HEAD / WALL MOUNTED EMERGENCY SINGLE REMOTE	PLAT DETECTOR  DUCT MOUNTED SWOKE DETECTOR / HEAT DETECTOR  PREMAN'S HANDSET  PRE ALARM HORN SINGLE  PRE ALARM EVACUATION SPEAKER — CEILING MOUNTED / WALL MOUNTED  PREMAN STROBE — CEILING MOUNTED / WALL MOUNTED  PREMAN EVACUATION SPEAKER STROBE COMBINATION — CEILING MOUNTED  PREMAN EVACUATION PAREL / ANNUNCIATOR PANEL  PREMAN END OF LINE RESISTOR  LIGHTING LEGEND  EXISTING BASE BUILDING LUMINAIRE TO BE REMOVED AND OR  EXISTING BASE BUILDING LUMINAIRE TO BE REMOVED AND OR  EXISTING BASE BUILDING LUMINAIRE RELOCATED OR NEW  EXISTING BASE BUILDING LUMINAIRE TO BE REMOVED AND OR  EXISTING BASE BUILDING EMERGENCY LUMINAIRE  EXISTING BASE BUILDING LUMINAIRE TO BE REMOVED AND OR  EXISTING BASE BUILDING LUMINAIRE TO BE REMOVED AND OR  EXISTING BASE BUILDING LUMINAIRE TELOCATED AND OR NEW EVERGENCY CIRCUIT  TREACK LICHTING C/W NUMBER OF FIXTURES SHOWN  CEILING MOUNTED LUMINAIRE  EXCLING MOUNTED WALL WASHER LUMINAIRE  PENDANT FIXTURE  SINGLE POLE LINE VOLTAGE LICHT SWITCH  3 WAY — LINE VOLTAGE LICHT SWITCH  3 WAY — LINE VOLTAGE LICHT SWITCH  5 WALL MOUNTED COUPANCY SENSOR SWITCH  CEILING MOUNTED OCCUPANCY SENSOR SWITCH  EXELING MOUNTED DEVERGENCY SENSOR  WALL MOUNTED EMERGENCY DOUBLE REMOTE HEAD  CEILING MOUNTED CHARGENCY DOUBLE REMOTE HEAD  CEILING MOUNTED EMERGENCY DOUBLE REMOTE HEAD
FIREMAN'S HANDSET  FIRE ALARM HOLD OPEN DEVICE — CONNECTION ONLY  FIRE ALARM HORN SINGLE  FIRE ALARM EVACUATION SPEAKER — CELING MOUNTED /  FIRE ALARM STROBE — CELING MOUNTED / WALL MOUNTED  FIRE ALARM PORTUGE COMBINATION  FIRE ALARM HORN/STROBE COMBINATION  FIRE ALARM END OF LINE RESISTOR  LIGHTING LEGEND  EXISTING BASE BUILDING LUMINAIRE TO REMAIN  EXISTING BASE BUILDING LUMINAIRE TO BE REMOVED AND RELOCATED  BASE BUILDING LUMINAIRE RELOCATED OR NEW  EXISTING BASE BUILDING LUMINAIRE  EXISTING BASE BUILDING STREEGENCY LUMINAIRE  EXISTING BASE BUILDING STREEGENCY LUMINAIRE TO BE REMOVED AND RELOCATED  BASE BUILDING LUMINAIRE RELOCATED AND OR NEW EMER PLOCATED  TARCK LIGHTING C/W NUMBER OF FIXTURES SHOWN  CEILING MOUNTED LUMINAIRE  CEILING MOUNTED LUMINAIRE  CEILING MOUNTED WALL WASHER LUMINAIRE  WALL SCONCE  PENDANT FIXTURE  SINGLE POLE LINE VOLTAGE LIGHT SWITCH  SMY  LOW VOLTAGE LIGHT SWITCH — 'M' DENOTES MASTER SWITCH  WALL SCONCE  PENDANT FIXTURE  SINGLE POLE LINE VOLTAGE LIGHT SWITCH  SMY  LOW VOLTAGE LIGHT SWITCH — 'M' DENOTES MASTER SWITCH  CEILING MOUNTED OCCUPANCY SENSOR  DIMMER TYPE TO SUIT LOAD (6-600W,10-1000W,15-150  CEILING MOUNTED DEREGENCY SINGLE REMOTE HEAD  WALL MOUNTED EMERGENCY SINGLE REMOTE HEAD  WALL MOUNTED EMERGENCY SINGLE REMOTE HEAD  CELING MOUNTED EMERGENCY SINGLE REMOTE HEAD  WALL MOUNTED EMERGENCY SINGLE REMOTE HEAD  CELING MOUNTED EMERGENCY SINGLE REMOTE HEAD	TREMAN'S HANDSET  TIRE ALARM HOLD OPEN DEVICE — CONNECTION ONLY  TIRE ALARM HORN SINGLE  TIRE ALARM HORN SINGLE  TIRE ALARM STROBE — CEILING MOUNTED / WALL MOUNTED  TIRE ALARM STROBE — CEILING MOUNTED / WALL MOUNTED  TIRE ALARM STROBE — CEILING MOUNTED / WALL MOUNTED  TIRE ALARM FONCYSTROBE COMBINATION  TIRE ALARM HORN/STROBE COMBINATION  TIRE ALARM CONTROL PANEL / ANNUNCIATOR PANEL  TIRE ALARM END OF LINE RESISTOR  LIGHTING LEGEND  EXISTING BASE BUILDING LUMINAIRE TO BE REMOVED AND OR  TREACHED BASE BUILDING LUMINAIRE TO BE REMOVED AND OR  TREACHED BASE BUILDING LUMINAIRE TO BE REMOVED AND OR  TREACHED BASE BUILDING EMERGENCY LUMINAIRE  EXISTING BASE BUILDING EMERGENCY LUMINAIRE  TREACH LIGHTING C/W NUMBER OF FIXTURES SHOWN  CEILING MOUNTED LUMINAIRE EMERGENCY CIRCUIT  TREACH LIGHTING C/W NUMBER OF FIXTURES SHOWN  CEILING MOUNTED LUMINAIRE  STOLE POLE LINE VOLTAGE LIGHT SWITCH  SOMEY LINE VOLTAGE LIGHT SWITCH  SOMEY LINE VOLTAGE LIGHT SWITCH  COW VOLTAGE LIGHT SWITCH — 'M' DENOTES MASTER SWITCH  CHILING MOUNTED COUPANCY SENSOR  THAT INTURE  SINGLE POLE LINE VOLTAGE LIGHT SWITCH  COW VOLTAGE LIGHT SWITCH — 'M' DENOTES MASTER SWITCH  CHILING MOUNTED COUPANCY SENSOR  THAT MOUNTED COUPANCY SENSOR  THAT MOUNTED EMERGENCY SINGLE REMOTE HEAD  CHILING MOUNTED EMERGENCY DOUBLE REMOTE HEAD  CHILING MOUNTED EMERGENCY DOUBLE REMOTE HEAD  CHERGENCY LIGHTING BATTERY UNIT  CEXT LIGHT WALL MOUNTED C/W FACES AND ARROWS AS INDICATED  EXT LIGHT WALL MOUNTED C/W FACES AND ARROWS AS INDICATED
FIREMAN'S HANDSET  FIRE ALARM HOLD OPEN DEVICE — CONNECTION ONLY  FIRE ALARM HORN SINGLE  FIRE ALARM EVACUATION SPEAKER — CELING MOUNTED /  FIRE ALARM STROBE — CELING MOUNTED / WALL MOUNTED  FIRE ALARM PORTUGE COMBINATION  FIRE ALARM HORN/STROBE COMBINATION  FIRE ALARM END OF LINE RESISTOR  LIGHTING LEGEND  EXISTING BASE BUILDING LUMINAIRE TO REMAIN  EXISTING BASE BUILDING LUMINAIRE TO BE REMOVED AND RELOCATED  BASE BUILDING LUMINAIRE RELOCATED OR NEW  EXISTING BASE BUILDING LUMINAIRE  EXISTING BASE BUILDING STREEGENCY LUMINAIRE  EXISTING BASE BUILDING STREEGENCY LUMINAIRE TO BE REMOVED AND RELOCATED  BASE BUILDING LUMINAIRE RELOCATED AND OR NEW EMER PLOCATED  TARCK LIGHTING C/W NUMBER OF FIXTURES SHOWN  CEILING MOUNTED LUMINAIRE  CEILING MOUNTED LUMINAIRE  CEILING MOUNTED WALL WASHER LUMINAIRE  WALL SCONCE  PENDANT FIXTURE  SINGLE POLE LINE VOLTAGE LIGHT SWITCH  SMY  LOW VOLTAGE LIGHT SWITCH — 'M' DENOTES MASTER SWITCH  WALL SCONCE  PENDANT FIXTURE  SINGLE POLE LINE VOLTAGE LIGHT SWITCH  SMY  LOW VOLTAGE LIGHT SWITCH — 'M' DENOTES MASTER SWITCH  CEILING MOUNTED OCCUPANCY SENSOR  DIMMER TYPE TO SUIT LOAD (6-600W,10-1000W,15-150  CEILING MOUNTED DEREGENCY SINGLE REMOTE HEAD  WALL MOUNTED EMERGENCY SINGLE REMOTE HEAD  WALL MOUNTED EMERGENCY SINGLE REMOTE HEAD  CELING MOUNTED EMERGENCY SINGLE REMOTE HEAD  WALL MOUNTED EMERGENCY SINGLE REMOTE HEAD  CELING MOUNTED EMERGENCY SINGLE REMOTE HEAD	TREMAN'S HANDSET  TIRE ALARM HOLD OPEN DEVICE — CONNECTION ONLY  TIRE ALARM HORN SINGLE  TIRE ALARM FORN SINGLE  TIRE ALARM STROBE — CEILING MOUNTED / WALL MOUNTED  TIRE ALARM STROBE — CEILING MOUNTED / WALL MOUNTED  TIRE ALARM STROBE — CEILING MOUNTED / WALL MOUNTED  TIRE ALARM FONCULTION SPEAKER STROBE COMBINATION — CEILING MOUNTED  TIRE ALARM HORN/STROBE COMBINATION  TIRE ALARM HORN/STROBE BUILDING LUMINATIRE  TIRE ALARM HORN/STROBE BUILDING LUMINATIRE TO BE REMOVED AND OR  TIRE ALARM HORN/STROBE BUILDING LUMINATIRE  TIRE ALARM HORN/STROBE BUILDING HORN/STROBE SHOWN  TIRE ALARM HORN/STROBE BUILDING LUMINATIRE  TIRE ALARM HORN/STROBE COMBINET HORN  TIRE ALARM HORN/STROBE BUILDING HORN/STROBE AND ARROWS AS INDICATED  TIRE ALARM HORN/STROBE BUILDING  TIRE ALARM HORN/STROBE STROBE  TIRE A
FIRE ALARM HOLD OPEN DEVICE — CONNECTION ONLY  FIRE ALARM HORN SINGLE  FIRE ALARM EVACUATION SPEAKER — CEILING MOUNTED / FIRE ALARM EVACUATION SPEAKER — CEILING MOUNTED / WALL MOUNTED  FIRE ALARM EVACUATION SPEAKER STROBE COMBINATION  FIRE ALARM EVACUATION SPEAKER STROBE COMBINATION  FIRE ALARM EVACUATION SPEAKER STROBE COMBINATION  FIRE ALARM CONTROL PANEL / ANNUNCIATOR PANEL  FIRE ALARM END OF LINE RESISTOR  LIGHTING LEGEND  EXISTING BASE BUILDING LUMINAIRE TO BE REMOVED AND RELOCATED  BASE BUILDING LUMINAIRE RELOCATED OR NEW  EXISTING BASE BUILDING EMERGENCY LUMINAIRE  EXISTING BASE BUILDING EMERGENCY LUMINAIRE TO BE RELOCATED  BASE BUILDING LUMINAIRE RELOCATED AND OR NEW EMER RELOCATED  BASE BUILDING LUMINAIRE RELOCATED AND OR NEW EMER PRELOCATED  TRACK LIGHTING C/W NUMBER OF FIXTURES SHOWN  CEILING MOUNTED LUMINAIRE  CEILING MOUNTED LUMINAIRE  CEILING MOUNTED LUMINAIRE  WALL SCONCE  PENDANT FIXTURE  SINGLE POLE LINE VOLTAGE LIGHT SWITCH  SWY.  LOW VOLTAGE LIGHT SWITCH — 'M' DENOTES MASTER SWITCH  SWY.  LOW VOLTAGE LIGHT SWITCH — 'M' DENOTES MASTER SWITCH  DIMMER TYPE TO SUIT LOAD (6-600W,10-1000W,15-150  DAY LIGHT PHOTO SENSOR  DAY LIGHT PHOTO SENSOR  WALL MOUNTED EMERGENCY SINGLE REMOTE HEAD  WALL MOUNTED EMERGENCY DOUBLE REMOTE HEAD  CEILING MOUNTED EMERGENCY DOUBLE REMOTE HEAD	TREE ALARM HOLD OPEN DEVICE — CONNECTION ONLY  TREE ALARM HORN SINGLE  THE ALARM EVACUATION SPEAKER — CELLING MOUNTED / WALL MOUNTED  THEE ALARM EVACUATION SPEAKER STROBE COMBINATION — CELLING MOUNTED  THEE ALARM PROPERTY OF THE RESISTOR  LIGHTING LEGEND  EXISTING BASE BUILDING LUMINAIRE TO REMAIN  EXISTING BASE BUILDING LUMINAIRE TO BE REMOVED AND OR  EXISTING BASE BUILDING LUMINAIRE TO BE REMOVED AND OR  EXISTING BASE BUILDING LUMINAIRE TO BE REMOVED AND OR  EXISTING BASE BUILDING LUMINAIRE TO BE REMOVED AND OR  EXISTING BASE BUILDING LUMINAIRE TO BE REMOVED AND OR  EXISTING BASE BUILDING LUMINAIRE TO BE REMOVED AND OR  EXISTING BASE BUILDING LUMINAIRE TO BE REMOVED AND OR  EXISTING BASE BUILDING LUMINAIRE TO BE REMOVED AND OR  EXISTING BASE BUILDING LUMINAIRE TO BE REMOVED AND OR  EXISTING BASE BUILDING LUMINAIRE RELOCATED AND OR NEW EMERGENCY CIRCUIT  FRACK LIGHTING C/W NUMBER OF FIXTURES SHOWN  SELLING MOUNTED LUMINAIRE EMERGENCY CIRCUIT  CELLING MOUNTED LUMINAIRE EMERGENCY CIRCUIT  CELLING MOUNTED LUMINAIRE  SELLING MOUNTED WALL WASHER LUMINAIRE  SHALL SCONGE  PENDANT FIXTURE  SINGLE POLE LINE VOLTAGE LIGHT SWITCH  SOWY — LINE VOLTAGE LIG
FIRE ALARM HORN SINGLE  FIRE ALARM EVACUATION SPEAKER — CEILING MOUNTED / FIRE ALARM STROBE — CEILING MOUNTED / WALL MOUNTED / FIRE ALARM EVACUATION SPEAKER STROBE COMBINATION FIRE ALARM HORN/STROBE COMBINATION FIRE ALARM HORN/STROBE COMBINATION FIRE ALARM HORN/STROBE COMBINATION FIRE ALARM END OF LINE RESISTOR  LIGHTING LEGEND  EXISTING BASE BUILDING LUMINAIRE TO REMAIN EXISTING BASE BUILDING LUMINAIRE TO BE REMOVED AND RELOCATED  BASE BUILDING LUMINAIRE RELOCATED OR NEW EXISTING BASE BUILDING LUMINAIRE EXISTING BASE BUILDING EMERGENCY LUMINAIRE EXISTING BASE BUILDING EMERGENCY LUMINAIRE EXISTING BASE BUILDING EMERGENCY CIRCUIT  CEILING MOUNTED LUMINAIRE EMERGENCY CIRCUIT  TRACK LIGHTING C/W NUMBER OF FIXTURES SHOWN CEILING MOUNTED LUMINAIRE  TRACK LIGHTING C/W NUMBER OF FIXTURES SHOWN CEILING MOUNTED LUMINAIRE  WALL SCONCE  PENDANT FIXTURE  SINGLE POLE LINE VOLTAGE LIGHT SWITCH  SMY LINE VOLTAGE LIGHT SWITCH  SMY LOW VOLTAGE LIGHT SWITCH — 'M' DENOTES MASTER SWIT  DIMMER TYPE TO SUIT LOAD (6=600W,10=1000W,15=150)  WALL MOUNTED EMERGENCY SENSOR  DAY LIGHT PHOTO SENSOR  WALL MOUNTED EMERGENCY SINGLE REMOTE HEAD  WALL MOUNTED EMERGENCY SINGLE REMOTE HEAD  WALL MOUNTED EMERGENCY DOUBLE REMOTE HEAD  WALL MOUNTED EMERGENCY DOUBLE REMOTE HEAD  CEILING MOUNTED EMERGENCY DOUBLE REMOTE HEAD	TIRE ALARM HORN SINGLE  TIRE ALARM EVACUATION SPEAKER — CEILING MOUNTED / WALL MOUNTED  TIRE ALARM STROBE — CEILING MOUNTED / WALL MOUNTED  TIRE ALARM STROBE — CEILING MOUNTED / WALL MOUNTED  TIRE ALARM EVACUATION SPEAKER STROBE COMBINATION — CEILING MOUNTED  TIRE ALARM HORN/STROBE COMBINATION  TIRE ALARM CONTROL PANEL / ANNUNCIATOR PANEL  TIRE ALARM END OF LINE RESISTOR  LIGHTING LEGEND  EXISTING BASE BUILDING LUMINAIRE TO BE REMOVED AND OR  RELOCATED  EXISTING BASE BUILDING LUMINAIRE TO BE REMOVED AND OR  RELOCATED  EXISTING BASE BUILDING EMERGENCY LUMINAIRE TO BE REMOVED AND OR  RELOCATED  EXISTING BASE BUILDING EMERGENCY LUMINAIRE TO BE REMOVED AND OR  RELOCATED  EXISTING BASE BUILDING EMERGENCY CIRCUIT  TRACK LIGHTING C/W NUMBER OF FIXTURES SHOWN  CEILING MOUNTED LUMINAIRE RELOCATED AND OR NEW EMERGENCY CIRCUIT  DELING MOUNTED LUMINAIRE REMERGENCY CIRCUIT  DELING MOUNTED LUMINAIRE  SEILING MOUNTED LUMINAIRE  SEILING MOUNTED WALL WASHER LUMINAIRE  SINGLE POLE LINE VOLTAGE LIGHT SWITCH  SO WAY — LINE VOLTAGE LIGHT SWITCH  SOUNTED COCUPANCY SENSOR SWITCH  SOUNTED COCUPANCY SENSOR  WALL MOUNTED COCUPANCY SENSOR  WALL MOUNTED EMERGENCY SINGLE REMOTE HEAD  SOULING MOUNTED EMERGENCY SINGLE REMOTE HEAD  SOULING MOUNTED EMERGENCY DOUBLE REMOTE HEAD  SO
FIRE ALARM EVACUATION SPEAKER — CEILING MOUNTED / FIRE ALARM STROBE — CEILING MOUNTED / WALL MOUNTED FIRE ALARM EVACUATION SPEAKER STROBE COMBINATION WALL MOUNTED FIRE ALARM HORN/STROBE COMBINATION  FIRE ALARM HORN/STROBE COMBINATION  FIRE ALARM CONTROL PANEL / ANNUNCIATOR PANEL  FIRE ALARM END OF LINE RESISTOR  LIGHTING LEGEND  EXISTING BASE BUILDING LUMINAIRE TO REMAIN  EXISTING BASE BUILDING LUMINAIRE TO BE REMOVED AND RELOCATED  BASE BUILDING LUMINAIRE RELOCATED OR NEW  EXISTING BASE BUILDING EMERGENCY LUMINAIRE TO BE REPOSED AND RELOCATED  BASE BUILDING LUMINAIRE RELOCATED AND OR NEW EMER RELOCATED  TRACK LIGHTING C/W NUMBER OF FIXTURES SHOWN  CEILING MOUNTED LUMINAIRE  TRACK LIGHTING C/W NUMBER OF FIXTURES SHOWN  CEILING MOUNTED LUMINAIRE  CEILING MOUNTED LUMINAIRE  WALL SCONCE  PENDANT FIXTURE  SINGLE POLE LINE VOLTAGE LIGHT SWITCH  SWY  LOW VOLTAGE LIGHT SWITCH — 'M' DENOTES MASTER SWIT  DIMMER TYPE TO SUIT LOAD (6–600W,10–1000W,15–150  WALL MOUNTED DECUPANCY SENSOR  DAY LIGHT PHOTO SENSOR  WALL MOUNTED EMERGENCY DOUBLE REMOTE HEAD  WALL MOUNTED EMERGENCY DOUBLE REMOTE HEAD  WALL MOUNTED EMERGENCY DOUBLE REMOTE HEAD  CEILING MOUNTED EMERGENCY DOUBLE REMOTE HEAD	FIRE ALARM EVACUATION SPEAKER — CEILING MOUNTED / WALL MOUNTED  FIRE ALARM STROBE — CEILING MOUNTED / WALL MOUNTED  FIRE ALARM STROBE — CEILING MOUNTED / WALL MOUNTED  FIRE ALARM POACUATION SPEAKER STROBE COMBINATION — CEILING MOUNTED  FIRE ALARM HORN/STROBE COMBINATION  FIRE ALARM HORN/STROBE COMBINATION  FIRE ALARM CONTROL PANEL / ANNUNCIATOR PANEL  FIRE ALARM END OF LINE RESISTOR  LIGHTING LEGEND  EXISTING BASE BUILDING LUMINAIRE TO BE REMOVED AND OR  FIRE BLUDING LUMINAIRE RELOCATED OR NEW  EXISTING EMERGENCY BASE BUILDING LUMINAIRE TO BE REMOVED AND OR  FIREACK LIGHTING C/W NUMBER OF FIXTURES SHOWN  DELING MOUNTED LUMINAIRE EMERGENCY CIRCUIT  FIREACK LIGHTING C/W NUMBER OF FIXTURES SHOWN  DELING MOUNTED LUMINAIRE EMERGENCY CIRCUIT  CEILING MOUNTED LUMINAIRE EMERGENCY CIRCUIT  CEILING MOUNTED WALL WASHER LUMINAIRE  WALL SCONCE  PENDANT FIXTURE  SINGLE POLE LINE VOLTAGE LIGHT SWITCH  3 WAY — LINE VOLTAGE LIGHT SWITCH  5 WALL MOUNTED OCCUPANCY SENSOR SWITCH  5 WALL MOUNTED CCUPANCY SENSOR  WALL MOUNTED CCUPANCY SENSOR  WALL MOUNTED EMERGENCY SINGLE REMOTE HEAD  5 WALL MOUNTED EMERGENCY SINGLE REMOTE HEAD  5 WALL MOUNTED EMERGENCY DOUBLE REMOTE HEAD  5 WALL MOUNTED EMERGENCY DOUBLE REMOTE HEAD  5 WERGENCY LIGHTING BATTERY UNIT  5 WALL MOUNTED EMERGENCY DOUBLE REMOTE HEAD  5 WERGENCY LIGHTING BATTERY UNIT  5 WAT LIGHT CEILING MOUNTED C/W FACES AND ARROWS AS INDICATED  5 WIT LIGHT CEILING MOUNTED C/W FACES AND ARROWS AS INDICATED
FIRE ALARM STROBE — CEILING MOUNTED / WALL MOUNTED  FIRE ALARM EVACUATION SPEAKER STROBE COMBINATION  FIRE ALARM HORN/STROBE COMBINATION  FIRE ALARM CONTROL PANEL / ANNUNCIATOR PANEL  FIRE ALARM END OF LINE RESISTOR   LIGHTING LEGEND  EXISTING BASE BUILDING LUMINAIRE TO REMAIN  EXISTING BASE BUILDING LUMINAIRE TO BE REMOVED AND RELOCATED  BASE BUILDING LUMINAIRE RELOCATED OR NEW  EXISTING BASE BUILDING EMERGENCY LUMINAIRE TO BE REMOVED AND RELOCATED  BASE BUILDING LUMINAIRE RELOCATED AND OR NEW EMER RELOCATED  BASE BUILDING LUMINAIRE RELOCATED AND OR NEW EMER PELOCATED  TRACK LIGHTING C/W NUMBER OF FIXTURES SHOWN  CEILING MOUNTED LUMINAIRE EMERGENCY CIRCUIT  CEILING MOUNTED LUMINAIRE  CEILING MOUNTED LUMINAIRE  WALL SCONCE  PENDANT FIXTURE  SINGLE POLE LINE VOLTAGE LIGHT SWITCH  SMAY — LINE VOLTAGE LIGHT SWITCH  SMAY — LINE VOLTAGE LIGHT SWITCH  SMAY — LINE VOLTAGE LIGHT SWITCH  MALL MOUNTED OCCUPANCY SENSOR SWITCH  COS CEILING MOUNTED DEMERGENCY DOUBLE REMOTE HEAD  WALL MOUNTED EMERGENCY DOUBLE REMOTE HEAD  WALL MOUNTED EMERGENCY SINGLE REMOTE HEAD  CEILING MOUNTED EMERGENCY DOUBLE REMOTE HEAD	FIRE ALARM STROBE — CEILING MOUNTED / WALL MOUNTED  FIRE ALARM EVACUATION SPEAKER STROBE COMBINATION — CEILING MOUNTED  FIRE ALARM CONTROL PANEL / ANNUNCIATOR PANEL  FIRE ALARM CONTROL PANEL / ANNUNCIATOR PANEL  FIRE ALARM END OF LINE RESISTOR  LIGHTING LEGEND  EXISTING BASE BUILDING LUMINAIRE TO REMAIN  EXISTING BASE BUILDING LUMINAIRE TO BE REMOVED AND OR  EXISTING BASE BUILDING LUMINAIRE TO BE REMOVED AND OR  EXISTING BASE BUILDING EMERGENCY LUMINAIRE  EXISTING BASE BUILDING EMERGENCY LUMINAIRE TO BE REMOVED AND OR  EXECUCATED  BASE BUILDING LUMINAIRE RELOCATED AND OR NEW EMERGENCY CIRCUIT  FIRACK LIGHTING C/W NUMBER OF FIXTURES SHOWN  CEILING MOUNTED LUMINAIRE EMERGENCY CIRCUIT  CEILING MOUNTED LUMINAIRE EMERGENCY CIRCUIT  CEILING MOUNTED LUMINAIRE  SINGLE POLE LINE VOLTAGE LIGHT SWITCH  3 WAY — LINE VOLTAGE LIGHT SWITCH  30 WAY — LINE VOLTAGE LIGHT SWITCH  31 WAY — LINE VOLTAGE LIGHT SWITCH  32 WAY — LINE VOLTAGE LIGHT SWITCH  33 WAY — LINE VOLTAGE LIGHT SWITCH  34 WAY — LINE VOLTAGE LIGHT SWITCH  35 WAY — LINE VOLTAGE LIGHT SWITCH  36 WAY — LINE VOLTAGE LIGHT SWITCH  36 WAY — LINE VOLTAGE LIGHT SWITCH  37 WAY — LINE VOLTAGE LIGHT SWITCH  38 WAY — LINE VOLTAGE LIGHT SWITCH  38 WAY — LINE VOLTAGE LIGHT SWITCH  39 WAY — LINE VOLTAGE LIGHT SWITCH  30 WAY — LINE VOLTAGE LIGHT SWITCH  30 WAY — LINE VOLTAGE LIGHT SWITCH  30 WAY — LINE VOLTAGE LIGHT SWITCH  31 WAY — LINE VOLTAGE LIGHT SWITCH  32 WAY — LINE VOLTAGE LIGHT SWITCH  33 WAY — LINE VOLTAGE LIGHT SWITCH  34 WAY — LINE VOLTAGE LIGHT SWITCH  35 WAY — LINE VOLTAGE LIGHT SWITCH  36 WAY — LINE VOLTAGE LIGHT SWITCH  37 WAY — LINE VOLTAGE LIGHT SWIT
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FIRE ALARM HORN/STROBE COMBINATION  FIRE ALARM CONTROL PANEL / ANNUNCIATOR PANEL  FIRE ALARM END OF LINE RESISTOR  LIGHTING LEGEND  EXISTING BASE BUILDING LUMINAIRE TO REMAIN  EXISTING BASE BUILDING LUMINAIRE TO BE REMOVED AND RELOCATED  BASE BUILDING LUMINAIRE RELOCATED OR NEW  EXISTING EMERGENCY BASE BUILDING LUMINAIRE  EXISTING BASE BUILDING EMERGENCY LUMINAIRE TO BE RELOCATED  BASE BUILDING LUMINAIRE RELOCATED AND OR NEW EMER RELOCATED  BASE BUILDING LUMINAIRE RELOCATED AND OR NEW EMER RELOCATED  CEILING MOUNTED LUMINAIRE EMERGENCY CIRCUIT  CEILING MOUNTED LUMINAIRE  CEILING MOUNTED LUMINAIRE  WALL SCONCE  PENDANT FIXTURE  SINGLE POLE LINE VOLTAGE LIGHT SWITCH  SMY.  LOW VOLTAGE LIGHT SWITCH - 'M' DENOTES MASTER SWIT  DIMMER TYPE TO SUIT LOAD (6–600W,10–1000W,15–150  WALL MOUNTED OCCUPANCY SENSOR  DED  DAY LIGHT PHOTO SENSOR  WALL MOUNTED EMERGENCY SINGLE REMOTE HEAD  WALL MOUNTED EMERGENCY SINGLE REMOTE HEAD  CEILING MOUNTED EMERGENCY SINGLE REMOTE HEAD  CEILING MOUNTED EMERGENCY DOUBLE REMOTE HEAD  CEILING MOUNTED EMERGENCY DOUBLE REMOTE HEAD  CEILING MOUNTED EMERGENCY DOUBLE REMOTE HEAD	THE ALARM HORN/STROBE COMBINATION  THE ALARM CONTROL PANEL / ANNUNCIATOR PANEL  THE ALARM END OF LINE RESISTOR  LIGHTING LEGEND  EXISTING BASE BUILDING LUMINAIRE TO REMAIN  EXISTING BASE BUILDING LUMINAIRE TO BE REMOVED AND OR  EXISTING BASE BUILDING LUMINAIRE TO BE REMOVED AND OR  EXISTING EMERGENCY BASE BUILDING LUMINAIRE  EXISTING BASE BUILDING EMERGENCY LUMINAIRE  EXISTING BASE BUILDING LUMINAIRE RELOCATED AND OR NEW EMERGENCY CIRCUIT  TRACK LIGHTING C/W NUMBER OF FIXTURES SHOWN  CELLING MOUNTED LUMINAIRE  CELLING MOUNTED LUMINAIRE  CELLING MOUNTED LUMINAIRE  SINGLE POLE LINE VOLTAGE LIGHT SWITCH  SWAY — LINE VOLTAGE LIGHT SWITCH  COMMER TYPE TO SUIT LOAD (6–600W,10–1000W,15–1500W)  WALL MOUNTED OCCUPANCY SENSOR  WALL MOUNTED COUPANCY SENSOR  WALL MOUNTED EMERGENCY DOUBLE REMOTE HEAD  WALL MOUNTED EMERGENCY SINGLE REMOTE HEAD  CELLING MOUNTED EMERGENCY DOUBLE REMOTE HEAD  EMERGENCY LIGHTING BATTERY UNIT C/W NUMBER OF HEADS SHOWN  EMERGENCY LIGHTING BATTERY UNIT  EXIT LIGHT WALL MOUNTED C/W FACES AND ARROWS AS INDICATED  EXIT LIGHT WALL MOUNTED C/W FACES AND ARROWS AS INDICATED
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EXISTING BASE BUILDING LUMINAIRE TO REMAIN  EXISTING BASE BUILDING LUMINAIRE TO BE REMOVED AND RELOCATED  BASE BUILDING LUMINAIRE RELOCATED OR NEW  EXISTING BASE BUILDING BERREGENCY LUMINAIRE  EXISTING BASE BUILDING EMERGENCY CIRCUIT  TRACK LIGHTING C/W NUMBER OF FIXTURES SHOWN  CEILING MOUNTED LUMINAIRE  CEILING MOUNTED LUMINAIRE  CEILING MOUNTED WALL WASHER LUMINAIRE  WALL SCONCE  PENDANT FIXTURE  SINGLE POLE LINE VOLTAGE LIGHT SWITCH  SINGLE POLE LINE VOLTAGE LIGHT SWITCH  WALL SCONCE  DIMMER TYPE TO SUIT LOAD (6=600W,10=1000W,15=150)  WALL MOUNTED OCCUPANCY SENSOR SWITCH  CEILING MOUNTED OCCUPANCY SENSOR  DAY LIGHT PHOTO SENSOR  WALL MOUNTED EMERGENCY SINGLE REMOTE HEAD  WALL MOUNTED EMERGENCY SINGLE REMOTE HEAD  CEILING MOUNTED EMERGENCY SINGLE REMOTE HEAD  CEILING MOUNTED EMERGENCY SINGLE REMOTE HEAD  CEILING MOUNTED EMERGENCY DOUBLE REMOTE HEAD	EXISTING BASE BUILDING LUMINAIRE TO REMAIN  EXISTING BASE BUILDING LUMINAIRE TO BE REMOVED AND OR  RELOCATED  EXISTING BASE BUILDING LUMINAIRE TO BE REMOVED AND OR  RELOCATED  EXISTING BASE BUILDING LUMINAIRE RELOCATED OR NEW  EXISTING BASE BUILDING EMERGENCY LUMINAIRE  EXISTING BASE BUILDING LUMINAIRE  EXISTING BASE BUILDING EMERGENCY CIRCUIT  TRACK LIGHTING C/W NUMBER OF FIXTURES SHOWN  CELLING MOUNTED LUMINAIRE  EXELUNG MOUNTED LUMINAIRE  EXELUNG MOUNTED LUMINAIRE  EXELUNG MOUNTED WALL WASHER LUMINAIRE  SINGLE POLE LINE VOLTAGE LIGHT SWITCH  3 WAY — LINE VOLTAGE LIGHT SWITCH  3. WAY — LINE VOLTAGE LIGHT SWITCH  5. WALL MOUNTED OCCUPANCY SENSOR SWITCH  CEILING MOUNTED OCCUPANCY SENSOR  WALL MOUNTED GEOGRACY SINGLE REMOTE HEAD  CEILING MOUNTED EMERGENCY DOUBLE REMOTE H
EXISTING BASE BUILDING LUMINAIRE TO REMAIN  EXISTING BASE BUILDING LUMINAIRE TO BE REMOVED AND RELOCATED  BASE BUILDING LUMINAIRE RELOCATED OR NEW  EXISTING BASE BUILDING EMERGENCY LUMINAIRE  BASE BUILDING LUMINAIRE RELOCATED AND OR NEW EMER RELOCATED  BASE BUILDING LUMINAIRE RELOCATED AND OR NEW EMER RELOCATED  BASE BUILDING LUMINAIRE RELOCATED AND OR NEW EMER RELOCATED  BASE BUILDING LUMINAIRE RELOCATED AND OR NEW EMER RELOCATED  CEILING MOUNTED LUMINAIRE  CEILING MOUNTED LUMINAIRE  CEILING MOUNTED WALL WASHER LUMINAIRE  WALL SCONCE  PENDANT FIXTURE  SINGLE POLE LINE VOLTAGE LIGHT SWITCH  WALL MOUNTED CCUPANCY SENSOR SWITCH  COS  CEILING MOUNTED OCCUPANCY SENSOR  DL  DAY LIGHT PHOTO SENSOR  WALL MOUNTED EMERGENCY SINGLE REMOTE HEAD  WALL MOUNTED EMERGENCY SINGLE REMOTE HEAD  CEILING MOUNTED EMERGENCY DOUBLE REMOTE HEAD  CEILING MOUNTED EMERGENCY DOUBLE REMOTE HEAD  CEILING MOUNTED EMERGENCY DOUBLE REMOTE HEAD	EXISTING BASE BUILDING LUMINAIRE TO REMAIN  EXISTING BASE BUILDING LUMINAIRE TO BE REMOVED AND OR  EXISTING BASE BUILDING LUMINAIRE RELOCATED OR NEW  EXISTING EMERGENCY BASE BUILDING LUMINAIRE  EXISTING BASE BUILDING EMERGENCY LUMINAIRE  EXISTING BASE BUILDING EMERGENCY LUMINAIRE  EXISTING BASE BUILDING LUMINAIRE RELOCATED AND OR NEW EMERGENCY CIRCUIT  TRACK LIGHTING C/W NUMBER OF FIXTURES SHOWN  CEILING MOUNTED LUMINAIRE  CEILING MOUNTED LUMINAIRE  EMELING MOUNTED WALL WASHER LUMINAIRE  SINGLE POLE LINE VOLTAGE LIGHT SWITCH  SOWAY — LINE VOLTAGE LIGHT SWITCH  LOW VOLTAGE LIGHT SWITCH — 'M' DENOTES MASTER SWITCH  DIMMER TYPE TO SUIT LOAD (6=600W,10=1000W,15=1500W)  WALL MOUNTED OCCUPANCY SENSOR  WALL MOUNTED CCUPANCY SENSOR  WALL MOUNTED EMERGENCY SINGLE REMOTE HEAD  CEILING MOUNTED EMERGENCY DOUBLE REMOTE HEAD  CEILING MOUNTED EMERGENCY SINGLE REMOTE HEAD  CEILING MOUNTED EMERGENCY DOUBLE REMOTE HEAD  CEILING MOUNTED EMERGENCY
EXISTING BASE BUILDING LUMINAIRE TO REMAIN  EXISTING BASE BUILDING LUMINAIRE TO BE REMOVED AND RELOCATED  BASE BUILDING LUMINAIRE RELOCATED OR NEW  EXISTING BASE BUILDING EMERGENCY LUMINAIRE  EXISTING BASE BUILDING EMERGENCY LUMINAIRE TO BE RELOCATED  BASE BUILDING LUMINAIRE RELOCATED AND OR NEW EMER RELOCATED  BASE BUILDING LUMINAIRE RELOCATED AND OR NEW EMER RELOCATED  TRACK LIGHTING C/W NUMBER OF FIXTURES SHOWN  CEILING MOUNTED LUMINAIRE  CEILING MOUNTED LUMINAIRE  CEILING MOUNTED WALL WASHER LUMINAIRE  WALL SCONCE  PENDANT FIXTURE  \$ SINGLE POLE LINE VOLTAGE LIGHT SWITCH  \$ J WAY - LINE VOLTAGE LIGHT SWITCH  \$ J WAY - LINE VOLTAGE LIGHT SWITCH  \$ J WALL MOUNTED OCCUPANCY SENSOR SWITCH  CEILING MOUNTED OCCUPANCY SENSOR  DL DAY LIGHT PHOTO SENSOR  WALL MOUNTED EMERGENCY SINGLE REMOTE HEAD  WALL MOUNTED EMERGENCY SINGLE REMOTE HEAD  CEILING MOUNTED EMERGENCY SINGLE REMOTE HEAD  CEILING MOUNTED EMERGENCY SINGLE REMOTE HEAD  CEILING MOUNTED EMERGENCY SINGLE REMOTE HEAD	EXISTING BASE BUILDING LUMINAIRE TO BE REMOVED AND OR RELOCATED  BASE BUILDING LUMINAIRE RELOCATED OR NEW  EXISTING BASE BUILDING LUMINAIRE RELOCATED OR NEW  EXISTING BASE BUILDING EMERGENCY LUMINAIRE TO BE REMOVED AND OR RELOCATED  BASE BUILDING LUMINAIRE RELOCATED AND OR NEW EMERGENCY CIRCUIT  TRACK LIGHTING C/W NUMBER OF FIXTURES SHOWN  CEILING MOUNTED LUMINAIRE EMERGENCY CIRCUIT  CEILING MOUNTED LUMINAIRE  CEILING MOUNTED WALL WASHER LUMINAIRE  WALL SCONCE  PENDANT FIXTURE  SINGLE POLE LINE VOLTAGE LIGHT SWITCH  SWAY — LINE VOLTAGE LIGHT SWITCH  COW VOLTAGE LIGHT SWITCH — 'M' DENOTES MASTER SWITCH  COMMERT TYPE TO SUIT LOAD (6-600W,10-1000W,15-1500W)  MALL MOUNTED OCCUPANCY SENSOR SWITCH  CEILING MOUNTED OCCUPANCY SENSOR  CHALL MOUNTED EMERGENCY SINGLE REMOTE HEAD  WALL MOUNTED EMERGENCY SINGLE REMOTE HEAD  CEILING MOUNTED EMERGENCY SINGLE REMOTE HEAD  CEILING MOUNTED EMERGENCY SINGLE REMOTE HEAD  CEILING MOUNTED EMERGENCY DOUBLE REMOTE HEAD  CEMERGENCY LIGHTING BATTERY UNIT  EXECUTED TO THE COURT OF THE COURT
EXISTING BASE BUILDING LUMINAIRE TO BE REMOVED AND RELOCATED  BASE BUILDING LUMINAIRE RELOCATED OR NEW  EXISTING EMERGENCY BASE BUILDING LUMINAIRE  EXISTING BASE BUILDING EMERGENCY LUMINAIRE TO BE RELOCATED  BASE BUILDING LUMINAIRE RELOCATED AND OR NEW EMERICATED  BASE BUILDING LUMINAIRE RELOCATED AND OR NEW EMERICATED  TRACK LIGHTING C/W NUMBER OF FIXTURES SHOWN  CEILING MOUNTED LUMINAIRE  CEILING MOUNTED LUMINAIRE  CEILING MOUNTED WALL WASHER LUMINAIRE  WALL SCONCE  PENDANT FIXTURE  SINGLE POLE LINE VOLTAGE LIGHT SWITCH  STATE OF THE WOLTAGE LIGHT SWITCH  STATE OF TO SUIT LOAD (6=600W,10=1000W,15=150)  DIMMER TYPE TO SUIT LOAD (6=600W,10=1000W,15=150)  DIMMER TYPE TO SUIT LOAD (6=600W,10=1000W,15=150)  WALL MOUNTED OCCUPANCY SENSOR  DL DAY LIGHT PHOTO SENSOR  WALL MOUNTED EMERGENCY SINGLE REMOTE HEAD  WALL MOUNTED EMERGENCY DOUBLE REMOTE HEAD  CEILING MOUNTED EMERGENCY SINGLE REMOTE HEAD  CEILING MOUNTED EMERGENCY DOUBLE REMOTE HEAD	EXISTING BASE BUILDING LUMINAIRE TO BE REMOVED AND OR RECOCATED  RASE BUILDING LUMINAIRE RELOCATED OR NEW  EXISTING EMERGENCY BASE BUILDING LUMINAIRE  EXISTING BASE BUILDING EMERGENCY LUMINAIRE TO BE REMOVED AND OR RELOCATED  RASE BUILDING LUMINAIRE RELOCATED AND OR NEW EMERGENCY CIRCUIT  RACK LIGHTING C/W NUMBER OF FIXTURES SHOWN  CEILING MOUNTED LUMINAIRE EMERGENCY CIRCUIT  CEILING MOUNTED LUMINAIRE  CEILING MOUNTED LUMINAIRE  CEILING MOUNTED WALL WASHER LUMINAIRE  MALL SCONCE  PENDANT FIXTURE  SINGLE POLE LINE VOLTAGE LIGHT SWITCH  LOW VOLTAGE LIGHT SWITCH — 'M' DENOTES MASTER SWITCH  DIMMER TYPE TO SUIT LOAD (6=600W,10=1000W,15=1500W)  MALL MOUNTED OCCUPANCY SENSOR  DAY LIGHT PHOTO SENSOR  MALL MOUNTED EMERGENCY SINGLE REMOTE HEAD  MALL MOUNTED EMERGENCY DOUBLE REMOTE HEAD  CEILING MOUNTED EMERGENCY DOUBLE REMOTE HEAD  CEMERGENCY LIGHTING BATTERY UNIT C/W NUMBER OF HEADS SHOWN  EMERGENCY LIGHTING BATTERY UNIT  EXIT LIGHT CEILING MOUNTED C/W FACES AND ARROWS AS INDICATED
EXISTING BASE BUILDING LUMINAIRE TO BE REMOVED AND RELOCATED  BASE BUILDING LUMINAIRE RELOCATED OR NEW  EXISTING EMERGENCY BASE BUILDING LUMINAIRE  EXISTING BASE BUILDING EMERGENCY LUMINAIRE TO BE RELOCATED  BASE BUILDING LUMINAIRE RELOCATED AND OR NEW EMERICATED  BASE BUILDING LUMINAIRE RELOCATED AND OR NEW EMERICATED  TRACK LIGHTING C/W NUMBER OF FIXTURES SHOWN  CEILING MOUNTED LUMINAIRE EMERGENCY CIRCUIT  CEILING MOUNTED WALL WASHER LUMINAIRE  CEILING MOUNTED WALL WASHER LUMINAIRE  WALL SCONCE  PENDANT FIXTURE  SINGLE POLE LINE VOLTAGE LIGHT SWITCH  SINGLE POLE LINE VOLTAGE LIGHT SWITCH  SIMPY  LOW VOLTAGE LIGHT SWITCH - 'M' DENOTES MASTER SWITCH  DIMMER TYPE TO SUIT LOAD (6=600W,10=1000W,15=150)  WALL MOUNTED OCCUPANCY SENSOR  DL DAY LIGHT PHOTO SENSOR  WALL MOUNTED EMERGENCY SINGLE REMOTE HEAD  WALL MOUNTED EMERGENCY DOUBLE REMOTE HEAD  CEILING MOUNTED EMERGENCY SINGLE REMOTE HEAD  CEILING MOUNTED EMERGENCY SINGLE REMOTE HEAD	EXISTING BASE BUILDING LUMINAIRE TO BE REMOVED AND OR RELOCATED  RASE BUILDING LUMINAIRE RELOCATED OR NEW  EXISTING EMERGENCY BASE BUILDING LUMINAIRE  EXISTING BASE BUILDING EMERGENCY LUMINAIRE  EXISTING BASE BUILDING EMERGENCY LUMINAIRE TO BE REMOVED AND OR RELOCATED  RASE BUILDING LUMINAIRE RELOCATED AND OR NEW EMERGENCY CIRCUIT  TRACK LIGHTING C/W NUMBER OF FIXTURES SHOWN  CEILING MOUNTED LUMINAIRE  CEILING MOUNTED LUMINAIRE  CEILING MOUNTED WALL WASHER LUMINAIRE  WALL SCONCE  PENDANT FIXTURE  SINGLE POLE LINE VOLTAGE LIGHT SWITCH  LOW VOLTAGE LIGHT SWITCH — 'M' DENOTES MASTER SWITCH  DIMMER TYPE TO SUIT LOAD (6=600W,10=1000W,15=1500W)  WALL MOUNTED OCCUPANCY SENSOR SWITCH  CEILING MOUNTED OCCUPANCY SENSOR  DAY LIGHT PHOTO SENSOR  WALL MOUNTED EMERGENCY DOUBLE REMOTE HEAD  CEILING MOUNTED EMERGENCY DOUBLE REMOTE HEAD  CEMERGENCY LIGHTING BATTERY UNIT  EMERGENCY LIGHTING BATTERY UNIT  EXIT LIGHT CEILING MOUNTED C/W FACES AND ARROWS AS INDICATED
BASE BUILDING LUMINAIRE RELOCATED OR NEW  EXISTING EMERGENCY BASE BUILDING LUMINAIRE  EXISTING BASE BUILDING EMERGENCY LUMINAIRE TO BE R RELOCATED  BASE BUILDING LUMINAIRE RELOCATED AND OR NEW EMER  TRACK LIGHTING C/W NUMBER OF FIXTURES SHOWN  CEILING MOUNTED LUMINAIRE EMERGENCY CIRCUIT  CEILING MOUNTED LUMINAIRE  CEILING MOUNTED LUMINAIRE  WALL SCONCE  PENDANT FIXTURE  SINGLE POLE LINE VOLTAGE LIGHT SWITCH  SINGLE POLE LINE VOLTAGE LIGHT SWITCH  LOW VOLTAGE LIGHT SWITCH - 'M' DENOTES MASTER SWITCH  DIMMER TYPE TO SUIT LOAD (6=600W,10=1000W,15=150)  WALL MOUNTED OCCUPANCY SENSOR  DL DAY LIGHT PHOTO SENSOR  WALL MOUNTED EMERGENCY SINGLE REMOTE HEAD  WALL MOUNTED EMERGENCY DOUBLE REMOTE HEAD  CEILING MOUNTED EMERGENCY SINGLE REMOTE HEAD  CEILING MOUNTED EMERGENCY DOUBLE REMOTE HEAD	BASE BUILDING LUMINAIRE RELOCATED OR NEW  EXISTING EMERGENCY BASE BUILDING LUMINAIRE  EXISTING BASE BUILDING EMERGENCY LUMINAIRE TO BE REMOVED AND OR REVELOCATED  BASE BUILDING LUMINAIRE RELOCATED AND OR NEW EMERGENCY CIRCUIT  TRACK LIGHTING C/W NUMBER OF FIXTURES SHOWN  CEILING MOUNTED LUMINAIRE EMERGENCY CIRCUIT  CEILING MOUNTED LUMINAIRE  CEILING MOUNTED WALL WASHER LUMINAIRE  BINGLE POLE LINE VOLTAGE LIGHT SWITCH  COW VOLTAGE LIGHT SWITCH - 'M' DENOTES MASTER SWITCH  COW VOLTAGE LIGHT SWITCH - 'M' DENOTES MASTER SWITCH  COMMER TYPE TO SUIT LOAD (6=600W,10=1000W,15=1500W)  WALL MOUNTED OCCUPANCY SENSOR  WALL MOUNTED OCCUPANCY SENSOR  WALL MOUNTED EMERGENCY SINGLE REMOTE HEAD  CEILING MOUNTED EMERGENCY DOUBLE REMOTE HEAD  CEMERGENCY LIGHTING BATTERY UNIT C/W NUMBER OF HEADS SHOWN  EMERGENCY LIGHTING BATTERY UNIT  EXIT LIGHT CEILING MOUNTED C/W FACES AND ARROWS AS INDICATED
EXISTING EMERGENCY BASE BUILDING LUMINAIRE  EXISTING BASE BUILDING EMERGENCY LUMINAIRE TO BE R RELOCATED  BASE BUILDING LUMINAIRE RELOCATED AND OR NEW EMER TRACK LIGHTING C/W NUMBER OF FIXTURES SHOWN  CEILING MOUNTED LUMINAIRE EMERGENCY CIRCUIT  CEILING MOUNTED LUMINAIRE  CEILING MOUNTED WALL WASHER LUMINAIRE  WALL SCONCE  PENDANT FIXTURE  SINGLE POLE LINE VOLTAGE LIGHT SWITCH  \$ 3 WAY - LINE VOLTAGE LIGHT SWITCH  \$ LOW VOLTAGE LIGHT SWITCH - 'M' DENOTES MASTER SWITCH  DIMMER TYPE TO SUIT LOAD (6=600W,10=1000W,15=150)  WALL MOUNTED OCCUPANCY SENSOR  DAY LIGHT PHOTO SENSOR  WALL MOUNTED EMERGENCY SINGLE REMOTE HEAD  WALL MOUNTED EMERGENCY SINGLE REMOTE HEAD  CEILING MOUNTED EMERGENCY DOUBLE REMOTE HEAD  CEILING MOUNTED EMERGENCY DOUBLE REMOTE HEAD  CEILING MOUNTED EMERGENCY DOUBLE REMOTE HEAD	EXISTING EMERGENCY BASE BUILDING LUMINAIRE  EXISTING BASE BUILDING EMERGENCY LUMINAIRE TO BE REMOVED AND OR RELOCATED  BASE BUILDING LUMINAIRE RELOCATED AND OR NEW EMERGENCY CIRCUIT  BRACK LIGHTING C/W NUMBER OF FIXTURES SHOWN  CEILING MOUNTED LUMINAIRE EMERGENCY CIRCUIT  CEILING MOUNTED LUMINAIRE  CEILING MOUNTED WALL WASHER LUMINAIRE  MALL SCONCE  PENDANT FIXTURE  SINGLE POLE LINE VOLTAGE LIGHT SWITCH  JOHNER TYPE TO SUIT LOAD (6=600W,10=1000W,15=1500W)  WALL MOUNTED OCCUPANCY SENSOR SWITCH  CEILING MOUNTED EMERGENCY SINGLE REMOTE HEAD  WALL MOUNTED EMERGENCY SINGLE REMOTE HEAD  CEILING MOUNTED EMERGENCY DOUBLE REMOTE HEAD  CEILING MOUNTED EMERGENCY DOUBLE REMOTE HEAD  CEILING MOUNTED EMERGENCY DOUBLE REMOTE HEAD  EMERGENCY LIGHTING BATTERY UNIT C/W NUMBER OF HEADS SHOWN  EMERGENCY LIGHTING BATTERY UNIT  EXIT LIGHT CEILING MOUNTED C/W FACES AND ARROWS AS INDICATED
EXISTING BASE BUILDING EMERGENCY LUMINAIRE TO BE R RELOCATED  BASE BUILDING LUMINAIRE RELOCATED AND OR NEW EMER  TRACK LIGHTING C/W NUMBER OF FIXTURES SHOWN  CEILING MOUNTED LUMINAIRE EMERGENCY CIRCUIT  CEILING MOUNTED LUMINAIRE  CEILING MOUNTED WALL WASHER LUMINAIRE  WALL SCONCE  PENDANT FIXTURE  SINGLE POLE LINE VOLTAGE LIGHT SWITCH  SINGLE POLE LINE VOLTAGE LIGHT SWITCH  LOW VOLTAGE LIGHT SWITCH - 'M' DENOTES MASTER SWITCH  DIMMER TYPE TO SUIT LOAD (6=600W,10=1000W,15=150)  WALL MOUNTED OCCUPANCY SENSOR SWITCH  WALL MOUNTED OCCUPANCY SENSOR  DAY LIGHT PHOTO SENSOR  WALL MOUNTED EMERGENCY SINGLE REMOTE HEAD  WALL MOUNTED EMERGENCY SINGLE REMOTE HEAD  CEILING MOUNTED EMERGENCY DOUBLE REMOTE HEAD  CEILING MOUNTED EMERGENCY DOUBLE REMOTE HEAD	EXISTING BASE BUILDING EMERGENCY LUMINAIRE TO BE REMOVED AND OR RELOCATED  BASE BUILDING LUMINAIRE RELOCATED AND OR NEW EMERGENCY CIRCUIT  BRACK LIGHTING C/W NUMBER OF FIXTURES SHOWN  CEILING MOUNTED LUMINAIRE EMERGENCY CIRCUIT  CEILING MOUNTED LUMINAIRE  CEILING MOUNTED WALL WASHER LUMINAIRE  MALL SCONCE  PENDANT FIXTURE  SINGLE POLE LINE VOLTAGE LIGHT SWITCH  COW VOLTAGE LIGHT SWITCH - 'M' DENOTES MASTER SWITCH  DIMMER TYPE TO SUIT LOAD (6=600W,10=1000W,15=1500W)  MALL MOUNTED OCCUPANCY SENSOR  DAY LIGHT PHOTO SENSOR  WALL MOUNTED EMERGENCY SINGLE REMOTE HEAD  CEILING MOUNTED EMERGENCY DOUBLE REMOTE HEAD  CEMERGENCY LIGHTING BATTERY UNIT C/W NUMBER OF HEADS SHOWN  EMERGENCY LIGHTING BATTERY UNIT  EXIT LIGHT CEILING MOUNTED C/W FACES AND ARROWS AS INDICATED  EXIT LIGHT CEILING MOUNTED C/W FACES AND ARROWS AS INDICATED
BASE BUILDING LUMINAIRE RELOCATED AND OR NEW EMER  TRACK LIGHTING C/W NUMBER OF FIXTURES SHOWN  CEILING MOUNTED LUMINAIRE EMERGENCY CIRCUIT  CEILING MOUNTED LUMINAIRE  CEILING MOUNTED WALL WASHER LUMINAIRE  WALL SCONCE  PENDANT FIXTURE  SINGLE POLE LINE VOLTAGE LIGHT SWITCH  SAMPAND LINE VOLTAGE LIGHT SWITCH  LOW VOLTAGE LIGHT SWITCH - 'M' DENOTES MASTER SWITCH  DIMMER TYPE TO SUIT LOAD (6=600W,10=1000W,15=150)  WALL MOUNTED OCCUPANCY SENSOR SWITCH  CEILING MOUNTED OCCUPANCY SENSOR  DAY LIGHT PHOTO SENSOR  WALL MOUNTED EMERGENCY SINGLE REMOTE HEAD  WALL MOUNTED EMERGENCY DOUBLE REMOTE HEAD  CEILING MOUNTED EMERGENCY DOUBLE REMOTE HEAD  CEILING MOUNTED EMERGENCY DOUBLE REMOTE HEAD  CEILING MOUNTED EMERGENCY DOUBLE REMOTE HEAD	BASE BUILDING LUMINAIRE RELOCATED AND OR NEW EMERGENCY CIRCUIT  TRACK LIGHTING C/W NUMBER OF FIXTURES SHOWN  CEILING MOUNTED LUMINAIRE  CEILING MOUNTED LUMINAIRE  CEILING MOUNTED LUMINAIRE  CEILING MOUNTED WALL WASHER LUMINAIRE  WALL SCONCE  PENDANT FIXTURE  SINGLE POLE LINE VOLTAGE LIGHT SWITCH  COW VOLTAGE LIGHT SWITCH - 'M' DENOTES MASTER SWITCH  COW VOLTAGE LIGHT SWITCH - 'M' DENOTES MASTER SWITCH  COMMER TYPE TO SUIT LOAD (6=600W,10=1000W,15=1500W)  WALL MOUNTED OCCUPANCY SENSOR SWITCH  CEILING MOUNTED OCCUPANCY SENSOR  WALL MOUNTED EMERGENCY SINGLE REMOTE HEAD  CEILING MOUNTED EMERGENCY DOUBLE REMOTE HEAD  CEMERGENCY LIGHTING BATTERY UNIT  EMERGENCY LIGHTING BATTERY UNIT  EXIT LIGHT CEILING MOUNTED C/W FACES AND ARROWS AS INDICATED  EXIT LIGHT WALL MOUNTED C/W FACES AND ARROWS AS INDICATED
TRACK LIGHTING C/W NUMBER OF FIXTURES SHOWN  CEILING MOUNTED LUMINAIRE EMERGENCY CIRCUIT  CEILING MOUNTED LUMINAIRE  CEILING MOUNTED WALL WASHER LUMINAIRE  WALL SCONCE  PENDANT FIXTURE  SINGLE POLE LINE VOLTAGE LIGHT SWITCH  SMAY - LINE VOLTAGE LIGHT SWITCH  LOW VOLTAGE LIGHT SWITCH - 'M' DENOTES MASTER SWITCH  DIMMER TYPE TO SUIT LOAD (6=600W,10=1000W,15=150)  WALL MOUNTED OCCUPANCY SENSOR SWITCH  DAY LIGHT PHOTO SENSOR  WALL MOUNTED EMERGENCY SINGLE REMOTE HEAD  WALL MOUNTED EMERGENCY DOUBLE REMOTE HEAD  CEILING MOUNTED EMERGENCY DOUBLE REMOTE HEAD  CEILING MOUNTED EMERGENCY DOUBLE REMOTE HEAD  CEILING MOUNTED EMERGENCY DOUBLE REMOTE HEAD	TRACK LIGHTING C/W NUMBER OF FIXTURES SHOWN  DEILING MOUNTED LUMINAIRE EMERGENCY CIRCUIT  DEILING MOUNTED LUMINAIRE  DEILING MOUNTED WALL WASHER LUMINAIRE  MALL SCONCE  PENDANT FIXTURE  SINGLE POLE LINE VOLTAGE LIGHT SWITCH  3 WAY — LINE VOLTAGE LIGHT SWITCH  LOW VOLTAGE LIGHT SWITCH — 'M' DENOTES MASTER SWITCH  DIMMER TYPE TO SUIT LOAD (6=600W,10=1000W,15=1500W)  WALL MOUNTED OCCUPANCY SENSOR  DAY LIGHT PHOTO SENSOR  WALL MOUNTED EMERGENCY SINGLE REMOTE HEAD  DEILING MOUNTED EMERGENCY DOUBLE REMOTE HEAD  DEMERGENCY LIGHTING BATTERY UNIT  EMERGENCY LIGHTING BATTERY UNIT  EXIT LIGHT CEILING MOUNTED C/W FACES AND ARROWS AS INDICATED  EXIT LIGHT CEILING MOUNTED C/W FACES AND ARROWS AS INDICATED
CEILING MOUNTED LUMINAIRE EMERGENCY CIRCUIT  CEILING MOUNTED LUMINAIRE  CEILING MOUNTED WALL WASHER LUMINAIRE  WALL SCONCE  PENDANT FIXTURE  SINGLE POLE LINE VOLTAGE LIGHT SWITCH  SINGLE POLE LINE VOLTAGE LIGHT SWITCH  LOW VOLTAGE LIGHT SWITCH — 'M' DENOTES MASTER SWITCH  DIMMER TYPE TO SUIT LOAD (6=600W,10=1000W,15=150)  WALL MOUNTED OCCUPANCY SENSOR SWITCH  CEILING MOUNTED OCCUPANCY SENSOR  DAY LIGHT PHOTO SENSOR  WALL MOUNTED EMERGENCY SINGLE REMOTE HEAD  WALL MOUNTED EMERGENCY DOUBLE REMOTE HEAD  CEILING MOUNTED EMERGENCY SINGLE REMOTE HEAD  CEILING MOUNTED EMERGENCY DOUBLE REMOTE HEAD	CEILING MOUNTED LUMINAIRE EMERGENCY CIRCUIT  CEILING MOUNTED LUMINAIRE  CEILING MOUNTED WALL WASHER LUMINAIRE  WALL SCONCE  PENDANT FIXTURE  SINGLE POLE LINE VOLTAGE LIGHT SWITCH  3 WAY - LINE VOLTAGE LIGHT SWITCH  LOW VOLTAGE LIGHT SWITCH - 'M' DENOTES MASTER SWITCH  DIMMER TYPE TO SUIT LOAD (6=600W,10=1000W,15=1500W)  WALL MOUNTED OCCUPANCY SENSOR SWITCH  CEILING MOUNTED OCCUPANCY SENSOR  DAY LIGHT PHOTO SENSOR  WALL MOUNTED EMERGENCY SINGLE REMOTE HEAD  CEILING MOUNTED EMERGENCY DOUBLE REMOTE HEAD  CEMERGENCY LIGHTING BATTERY UNIT C/W NUMBER OF HEADS SHOWN  EMERGENCY LIGHTING BATTERY UNIT  EXIT LIGHT CEILING MOUNTED C/W FACES AND ARROWS AS INDICATED
CEILING MOUNTED LUMINAIRE  CEILING MOUNTED WALL WASHER LUMINAIRE  WALL SCONCE  PENDANT FIXTURE  SINGLE POLE LINE VOLTAGE LIGHT SWITCH  SINGLE POLE LINE VOLTAGE LIGHT SWITCH  LOW VOLTAGE LIGHT SWITCH - 'M' DENOTES MASTER SWITCH  DIMMER TYPE TO SUIT LOAD (6=600W,10=1000W,15=150)  WALL MOUNTED OCCUPANCY SENSOR SWITCH  CEILING MOUNTED OCCUPANCY SENSOR  DL DAY LIGHT PHOTO SENSOR  WALL MOUNTED EMERGENCY SINGLE REMOTE HEAD  WALL MOUNTED EMERGENCY DOUBLE REMOTE HEAD  CEILING MOUNTED EMERGENCY SINGLE REMOTE HEAD  CEILING MOUNTED EMERGENCY DOUBLE REMOTE HEAD	CEILING MOUNTED LUMINAIRE  CEILING MOUNTED WALL WASHER LUMINAIRE  WALL SCONCE  PENDANT FIXTURE  SINGLE POLE LINE VOLTAGE LIGHT SWITCH  COW VOLTAGE LIGHT SWITCH — 'M' DENOTES MASTER SWITCH  COW VOLTAGE LIGHT SWITCH — 'M' DENOTES MASTER SWITCH  DIMMER TYPE TO SUIT LOAD (6=600W,10=1000W,15=1500W)  WALL MOUNTED OCCUPANCY SENSOR SWITCH  CEILING MOUNTED OCCUPANCY SENSOR  DAY LIGHT PHOTO SENSOR  WALL MOUNTED EMERGENCY SINGLE REMOTE HEAD  CEILING MOUNTED EMERGENCY DOUBLE REMOTE HEAD  CEMERGENCY LIGHTING BATTERY UNIT C/W NUMBER OF HEADS SHOWN  EMERGENCY LIGHTING BATTERY UNIT  EXIT LIGHT CEILING MOUNTED C/W FACES AND ARROWS AS INDICATED
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\$ SINGLE POLE LINE VOLTAGE LIGHT SWITCH  \$	SINGLE POLE LINE VOLTAGE LIGHT SWITCH  3 WAY — LINE VOLTAGE LIGHT SWITCH  LOW VOLTAGE LIGHT SWITCH — 'M' DENOTES MASTER SWITCH  DIMMER TYPE TO SUIT LOAD (6=600W,10=1000W,15=1500W)  WALL MOUNTED OCCUPANCY SENSOR SWITCH  CEILING MOUNTED OCCUPANCY SENSOR  DAY LIGHT PHOTO SENSOR  WALL MOUNTED EMERGENCY SINGLE REMOTE HEAD  WALL MOUNTED EMERGENCY DOUBLE REMOTE HEAD  CEILING MOUNTED EMERGENCY DOUBLE REMOTE HEAD  CEILING MOUNTED EMERGENCY DOUBLE REMOTE HEAD  EMERGENCY LIGHTING BATTERY UNIT C/W NUMBER OF HEADS SHOWN  EMERGENCY LIGHTING BATTERY UNIT  EXIT LIGHT CEILING MOUNTED C/W FACES AND ARROWS AS INDICATED  EXIT LIGHT WALL MOUNTED C/W FACES AND ARROWS AS INDICATED
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\$\frac{L}{M}\text{V}\$.  LOW VOLTAGE LIGHT SWITCH — 'M' DENOTES MASTER SWITCH  DIMMER TYPE TO SUIT LOAD (6=600W,10=1000W,15=150)  WALL MOUNTED OCCUPANCY SENSOR SWITCH  CEILING MOUNTED OCCUPANCY SENSOR  DAY LIGHT PHOTO SENSOR  WALL MOUNTED EMERGENCY SINGLE REMOTE HEAD  WALL MOUNTED EMERGENCY DOUBLE REMOTE HEAD  CEILING MOUNTED EMERGENCY SINGLE REMOTE HEAD  CEILING MOUNTED EMERGENCY DOUBLE REMOTE HEAD  CEILING MOUNTED EMERGENCY DOUBLE REMOTE HEAD	LOW VOLTAGE LIGHT SWITCH — 'M' DENOTES MASTER SWITCH  DIMMER TYPE TO SUIT LOAD (6=600W,10=1000W,15=1500W)  WALL MOUNTED OCCUPANCY SENSOR  DAY LIGHT PHOTO SENSOR  WALL MOUNTED EMERGENCY SINGLE REMOTE HEAD  WALL MOUNTED EMERGENCY DOUBLE REMOTE HEAD  CEILING MOUNTED EMERGENCY SINGLE REMOTE HEAD  CEILING MOUNTED EMERGENCY DOUBLE REMOTE HEAD  EMERGENCY LIGHTING BATTERY UNIT C/W NUMBER OF HEADS SHOWN  EMERGENCY LIGHTING BATTERY UNIT  EXIT LIGHT CEILING MOUNTED C/W FACES AND ARROWS AS INDICATED  EXIT LIGHT WALL MOUNTED C/W FACES AND ARROWS AS INDICATED
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DL DAY LIGHT PHOTO SENSOR  WALL MOUNTED EMERGENCY SINGLE REMOTE HEAD  WALL MOUNTED EMERGENCY DOUBLE REMOTE HEAD  CEILING MOUNTED EMERGENCY SINGLE REMOTE HEAD  CEILING MOUNTED EMERGENCY DOUBLE REMOTE HEAD	DAY LIGHT PHOTO SENSOR  MALL MOUNTED EMERGENCY SINGLE REMOTE HEAD  MALL MOUNTED EMERGENCY DOUBLE REMOTE HEAD  CEILING MOUNTED EMERGENCY SINGLE REMOTE HEAD  CEILING MOUNTED EMERGENCY DOUBLE REMOTE HEAD  EMERGENCY LIGHTING BATTERY UNIT C/W NUMBER OF HEADS SHOWN  EMERGENCY LIGHTING BATTERY UNIT  EXIT LIGHT CEILING MOUNTED C/W FACES AND ARROWS AS INDICATED  EXIT LIGHT WALL MOUNTED C/W FACES AND ARROWS AS INDICATED
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CEILING MOUNTED EMERGENCY SINGLE REMOTE HEAD  CEILING MOUNTED EMERGENCY DOUBLE REMOTE HEAD	CEILING MOUNTED EMERGENCY SINGLE REMOTE HEAD  CEILING MOUNTED EMERGENCY DOUBLE REMOTE HEAD  EMERGENCY LIGHTING BATTERY UNIT C/W NUMBER OF HEADS SHOWN  EMERGENCY LIGHTING BATTERY UNIT  EXIT LIGHT CEILING MOUNTED C/W FACES AND ARROWS AS INDICATED  EXIT LIGHT WALL MOUNTED C/W FACES AND ARROWS AS INDICATED
CEILING MOUNTED EMERGENCY DOUBLE REMOTE HEAD	CEILING MOUNTED EMERGENCY DOUBLE REMOTE HEAD  EMERGENCY LIGHTING BATTERY UNIT  EMERGENCY LIGHTING BATTERY UNIT  EXIT LIGHT CEILING MOUNTED C/W FACES AND ARROWS AS INDICATED  EXIT LIGHT WALL MOUNTED C/W FACES AND ARROWS AS INDICATED
	EMERGENCY LIGHTING BATTERY UNIT  EMERGENCY LIGHTING BATTERY UNIT  EXIT LIGHT CEILING MOUNTED C/W FACES AND ARROWS AS INDICATED  EXIT LIGHT WALL MOUNTED C/W FACES AND ARROWS AS INDICATED
EMERGENCY LIGHTING BATTERY UNIT C/W NUMBER OF HE	EMERGENCY LIGHTING BATTERY UNIT  EXIT LIGHT CEILING MOUNTED C/W FACES AND ARROWS AS INDICATED  EXIT LIGHT WALL MOUNTED C/W FACES AND ARROWS AS INDICATED
	EXIT LIGHT CEILING MOUNTED C/W FACES AND ARROWS AS INDICATED  EXIT LIGHT WALL MOUNTED C/W FACES AND ARROWS AS INDICATED
EMERGENCY LIGHTING BATTERY UNIT	EXIT LIGHT WALL MOUNTED C/W FACES AND ARROWS AS INDICATED
EXIT LIGHT CEILING MOUNTED C/W FACES AND ARROWS A	
EXIT LIGHT WALL MOUNTED C/W FACES AND ARROWS AS	CEILING PANIC ALARM BEACON
B CEILING PANIC ALARM BEACON	

	FIRE ALARM SYSTEMS		DRAWIN	G LIST		
	MANUAL PULL STATION	DRAWING No.	DRAWING NAME			
	FIRE ALARM BELL	E-0.1	DRAWING LIST AND ELECTRICAL L	DRAWING LIST AND ELECTRICAL LEGENDS		
€	SMOKE DETECTOR	E-0.2	ELECTRICAL DETAILS			
	HEAT DETECTOR		ELECTRICAL DETAILS			
<b>⊋</b> m <b>⊘</b> m	DUCT MOUNTED SMOKE DETECTOR / HEAT DETECTOR	E-3.0	LEVEL 3 – KEY PLAN			
HS	FIREMAN'S HANDSET	E-3.1A	PARTIAL LEVEL 3 — LIGHTING AN	ID FIRE ALARM LAYO	DUT (PART A)	
<b>_</b>	FIRE ALARM HOLD OPEN DEVICE — CONNECTION ONLY	E-3.1B	PARTIAL LEVEL 3 — LIGHTING AN	ID FIRE ALARM LAYO	DUT (PART B)	
	FIRE ALARM HORN SINGLE	E-3.2A	PARTIAL LEVEL 3 — POWER AND	SYSTEMS LAYOUT	(PART A)	
	FIRE ALARM EVACUATION SPEAKER — CEILING MOUNTED / WALL MOUNTED	E-3.2B	PARTIAL LEVEL 3 — POWER AND	SYSTEMS LAYOUT	(PART B)	
<u>∓</u>	FIRE ALARM STROBE — CEILING MOUNTED / WALL MOUNTED	E-3.3A	PARTIAL LEVEL 3 — CEILING DEN	MOLITION LAYOUT (P.	ART A)	
St +St	FIRE ALARM EVACUATION SPEAKER STROBE COMBINATION — CEILING MOUNTED / WALL MOUNTED	E-3.3B	PARTIAL LEVEL 3 — CEILING DEN	MOLITION LAYOUT (P.	ART A)	
	FIRE ALARM HORN/STROBE COMBINATION	E-3.4A	PARTIAL LEVEL 3 — POWER DEM	OLITION LAYOUT (PA	ART B)	
			·			
			<u>'</u>			
	TINE NETITION OF LINE NESISTAN	E-3.6	LEVEL 3 WASHROOMS - POWER			
	LIGHTING LEGEND	E-3.7	LEVEL 3 WASHROOMS — CEILING			
	EVICTING DAGE DUU DING LUMINAIDE TO DEMAIN	E-3.8	LEVEL 3 WASHROOMS - POWER			
	EXISTING BASE BUILDING LUMINAIRE TO REMAIN  EXISTING BASE BUILDING LUMINAIRE TO BE REMOVED AND OR	E-3.6	LEVEL 3 WASHROOMS - POWER	DEMOLITION LATOU		
	RELOCATED		ABBREV	IATIONS		
	BASE BUILDING LUMINAIRE RELOCATED OR NEW				LOW VOLTAGE	
	EXISTING EMERGENCY BASE BUILDING LUMINAIRE  EXISTING BASE BUILDING EMERGENCY LUMINAIRE TO BE REMOVED AND OR	A	AMPS	LV	LOW VOLTAGE	
	RELOCATED	AD	ACCESS DOOR	МО	MOTOR OPERATED	
	BASE BUILDING LUMINAIRE RELOCATED AND OR NEW EMERGENCY CIRCUIT	AFCI	ARC FAULT CIRCUIT INTERRUPTER	MOD	MOTOR OPERATED DAMPER	
$\nabla \nabla \nabla \nabla_{\parallel}$	TRACK LIGHTING C/W NUMBER OF FIXTURES SHOWN	AFF	ABOVE FINISHED FLOOR	MW	MICROWAVE	
- <b>®</b> -	CEILING MOUNTED LUMINAIRE EMERGENCY CIRCUIT	ВВН	BASEBOARD HEATER	N	NEW	
<b>\( \rightarrow\)</b>	CEILING MOUNTED LUMINAIRE	BU	BATTERY UNIT	NC	NORMALLY CLOSED	
<del>\</del>	CEILING MOUNTED WALL WASHER LUMINAIRE	С	CONDUIT	NIC	NOT IN CONTRACT	
<u>ф</u>	WALL SCONCE	CL	CEILING MOUNTED	NL	NIGHT LIGHT	
<del>-</del>	PENDANT FIXTURE	COF	COFFEE MACHINE	NO	NORMALLY OPEN	
\$	SINGLE POLE LINE VOLTAGE LIGHT SWITCH	CS	CHARGING STATION	OC	OVER COUNTER	
<b>\$</b> 3	3 WAY — LINE VOLTAGE LIGHT SWITCH	D	DEDICATED	OL	OBSTRUCTION LIGHT	
\$ ^{L.V.}	LOW VOLTAGE LIGHT SWITCH — 'M' DENOTES MASTER SWITCH	DG	DEDICATED GROUND	Р	PARABOLIC LOUVRE	
Ф	DIMMER TYPE TO SUIT LOAD (6=600W,10=1000W,15=1500W)	DHWT	DOMESTIC HOT WATER TANK	PL	PATIENT LIFT	
OS	WALL MOUNTED OCCUPANCY SENSOR SWITCH	DNC	DEDICATED NEUTRAL + BOND	R	RELOCATE	
OS)	CEILING MOUNTED OCCUPANCY SENSOR	DR	LAUNDRY DRYER	RA	RANGE	
DL	DAY LIGHT PHOTO SENSOR	DW	DISHWASHER	RC	REUSE EXISTING CIRCUIT	
↦	WALL MOUNTED EMERGENCY SINGLE REMOTE HEAD	E	EXISTING	RH	RANGE HOOD	
	WALL MOUNTED EMERGENCY DOUBLE REMOTE HEAD	EF	EXHAUST FAN	RIC	ROUGH IN AND CONNECT	
<b>→</b>	CEILING MOUNTED EMERGENCY SINGLE REMOTE HEAD	EM	EMERGENCY CIRCUIT	RO	ROUGH IN ONLY	
<>>	CEILING MOUNTED EMERGENCY DOUBLE REMOTE HEAD	EP	ELECTRICAL SUITE PANEL	RR	REMOVE AND REINSTALL	
B	EMERGENCY LIGHTING BATTERY UNIT C/W NUMBER OF HEADS SHOWN	ER	EXISTING TO BE REMOVED	SC	SEPARATE CIRCUIT	
В	EMERGENCY LIGHTING BATTERY UNIT	F	REFRIGERATOR	SF	SYSTEM FURNITURE	
<b>3</b>	EXIT LIGHT CEILING MOUNTED C/W FACES AND ARROWS AS INDICATED	FF	FLOOR FEED	SP	SUITE ALARM PANEL	
$\overline{\mathbf{z}}$	EXIT LIGHT WALL MOUNTED C/W FACES AND ARROWS AS INDICATED	FFH	FORCE FLOW HEATER	TYP	TYPICAL	
B	CEILING PANIC ALARM BEACON	FL	FLOOR MOUNTED	UC	UNDER CABINET MOUNTED	
		GFCI	GROUND FAULT CIRCUIT INTERRUPTER	UH	UNIT HEATER	
		GFI	GROUND FAULT INTERRUPTER	UPS	UNINTERRUPTIBLE POWER SUPPLY	
		GND	GROUND	V	VOLTS	
		HK	HOUSE KEEPING	W	WATTS	
		HMT	HARMONIC MITIGATING TRANSFORMER	WA	LAUNDRY WASHER	
		ICE	ICE MACHINE	WAP	WIRELESS ACCESS POINT	
		IG	ISOLATED GROUND	WF	WALL FEED	
			ISOLATED GROUND	***	WALL FEED	

JUNCTION BOX

NOTE: NOT ALL SYMBOLS APPLY. CONTRACTOR TO REFER TO FLOOR PLANS.

- CONTRACTOR MUST CHECK AND VERIFY ALL DIMENSIONS, DETAILS AND SPECIFICATIONS ON SITE AND REPORT ANY DISCREPANCIES IN WRITING TO YORK REGION REPRESENTATIVE BEFORE PROCEEDING WITH THE WORK
- 2. DRAWINGS ARE NOT TO BE SCALED

GENERAL NOTES:

- 3. BEFORE PROCEEDING WITH THE WORK, CONTRACTOR MUST SUBMIT ALL NECESSARY SAMPLES AND SHOP DRAWINGS TO YORK REGION REPRESENTATIVE FOR APPROVAL
- 4. ALL DRAWINGS AND SPECIFICATIONS ARE THE PROPERTY OF YORK REGION. AS SUCH, THEY ARE NOT INTENDED FOR USE ON OTHER PROJECTS OR EXTENSIONS OF THE PROJECT SPECIFIED

SUBMISSION	DATE	DESCRIPTION
6	2021-03-19	ISSUED FOR CONSTRUCTION
5	2020-11-30	ISSUED FOR ADDENDUM E-01
4	2020-11-05	ISSUED FOR TENDER
3	2020-05-25	ISSUED FOR PERMIT/TENDER
2	2020-05-18	ISSUED FOR 90% REVIEW
1	2020-03-18	ISSUED FOR 60% REVIEW

# G.Bruce Stratton Architects

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Smith + Andersen

PROJECT CONTACT

AME: ANGELICA SABANDAL L: 416-218-7021 EMAIL: angelica.sabandal@smithandandersen.com THIS DRAWING SHALL BE READ IN CONJUNCTION WITH ELECTRICAL SPECIFICATION SUBMITTED FOR THIS PROJECT.

York Region

# PROPERTY SERVICES

**BUILDING & FACILITIES** DEPARTMENT: FLOOR: 03-01-2020 BASE DATE:

PROJECT:

PROJECT # 14008.009

# YORK REGION

Administrative Centre 17250 Yonge Street Newmarket, Ontario

SCALE: N.T.S DRAWN BY: AS

WEATHERPROOF

EXPLOSION PROOF DEVICE + BACK BOX


SUBMITTED TO: MUNICIPALITY OF YORK


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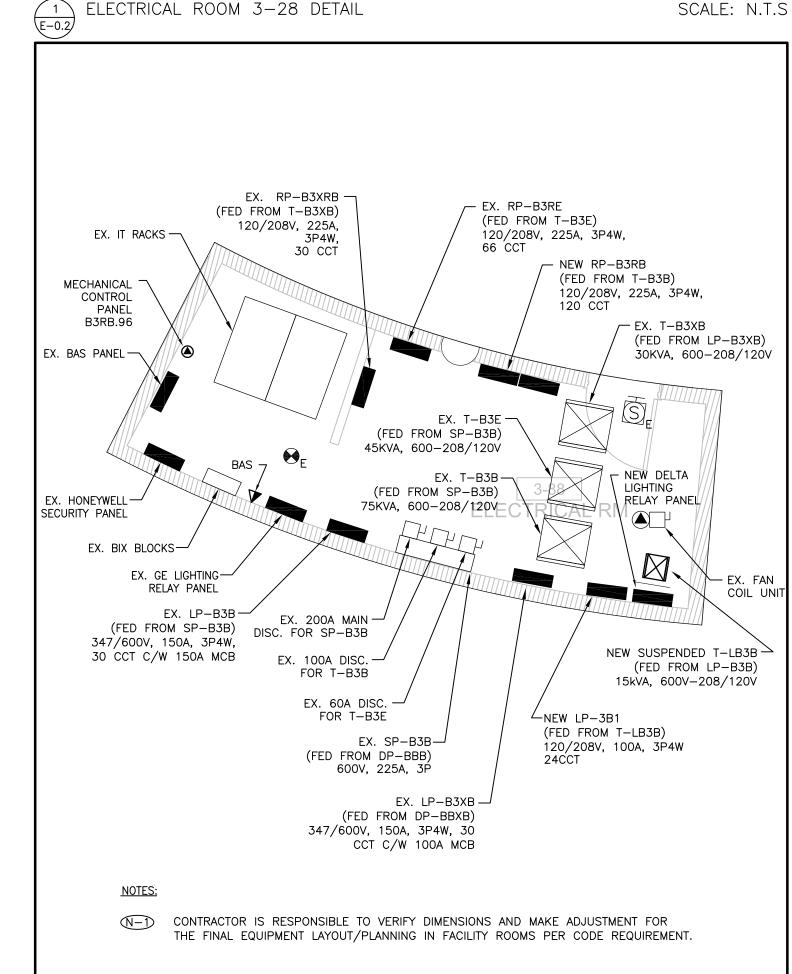
DRAWING LIST AND ELECTRICAL LEGENDS


SHEET NUMBER:

E-0.1



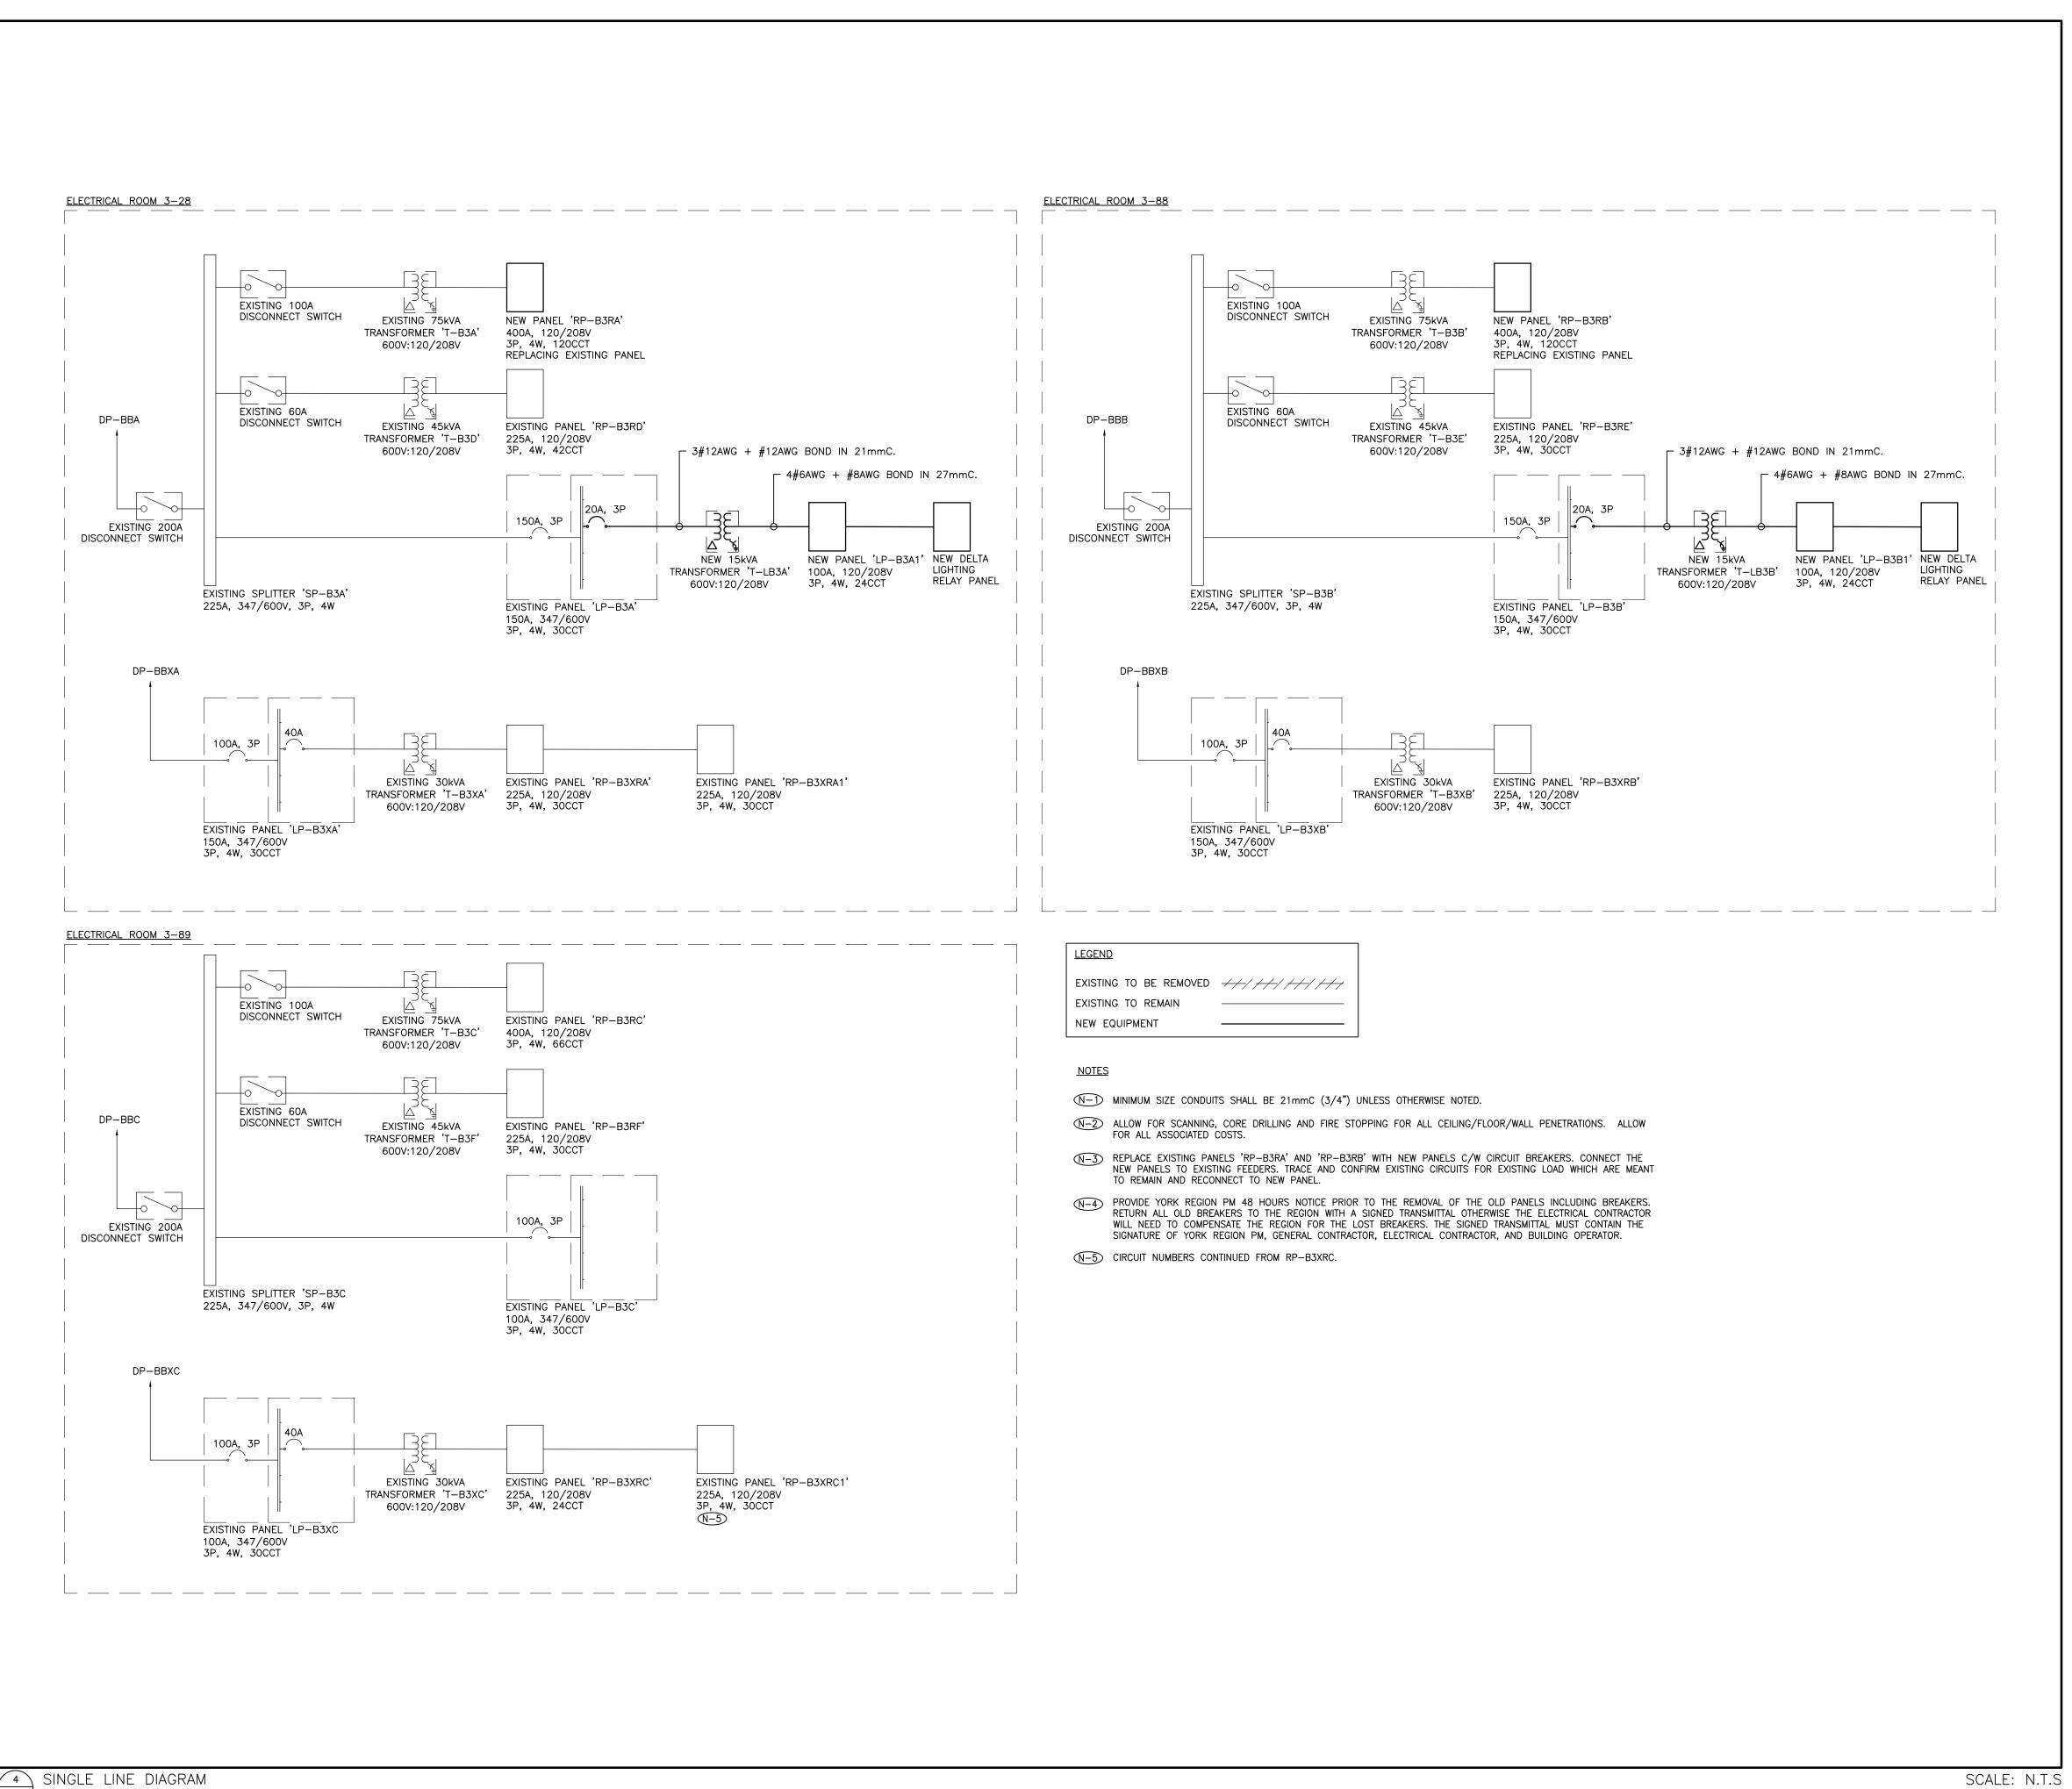

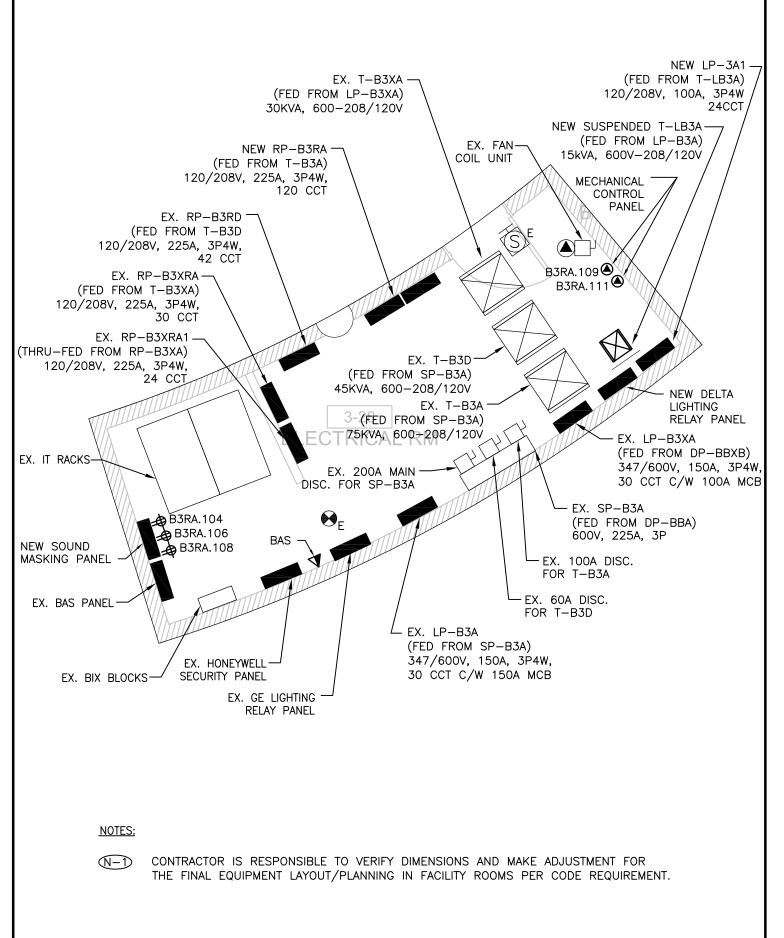

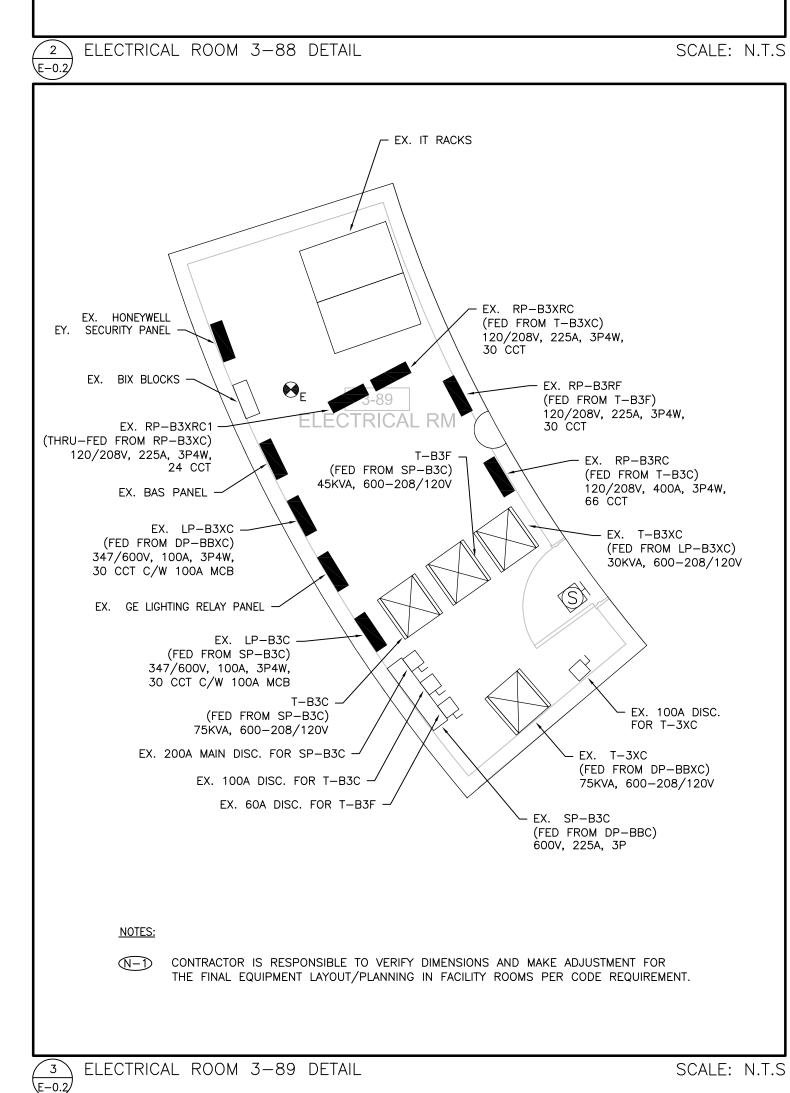

- 1. CONTRACTOR MUST CHECK AND VERIFY ALL
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  REPORT ANY DISCREPANCIES IN WRITING TO YORK REGION
  REPRESENTATIVE BEFORE PROCEEDING WITH THE WORK
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SUBMISSION	DATE	DESCRIPTION
	2024 22 42	JOSUED FOR CONSTRUCTION
6	2021-03-19	ISSUED FOR CONSTRUCTION
5	2020-11-30	ISSUED FOR ADDENDUM E-01
4	2020-11-05	ISSUED FOR TENDER
3	2020-05-25	ISSUED FOR PERMIT/TENDER
2	2020-05-18	ISSUED FOR 90% REVIEW
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### **G.Bruce Stratton Architects**

217 Richmond Street West, Suite 300 Toronto Ontario M5V 1W2 telephone: 416.351.8145 facsimile: 416.351.8146



Smith + Andersen

1100 - 100 Sheppard Ave. East, Toronto On, M2N 6N5
416 487 8151 f 416 487 9104 smithandandersen.com

PROJECT CONTACT


NAME: ANGELICA SABANDAL

TEL: 416-218-7021

EMAIL: angelica.sabandal@smithandandersen.com

THIS DRAWING SHALL BE READ IN CONJUNCTION

WITH ELECTRICAL SPECIFICATION SUBMITTED FO

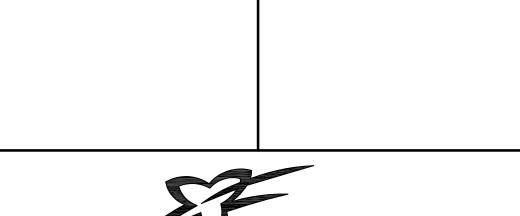

# PROPERTY SERVICES

DEPARTMENT: BUILDING & FACILITIES

FLOOR: 003

BASE DATE: 03-01-2020

PROJECT:

# PROJECT # 14008.009

# YORK REGION

Administrative Centre 17250 Yonge Street Newmarket, Ontario

SCALE: AS SHOWN

DRAWN BY: AS


SUBMITTED TO: MUNICIPALITY OF YORK

SHEET TITLE:

ELECTRICAL DETAILS


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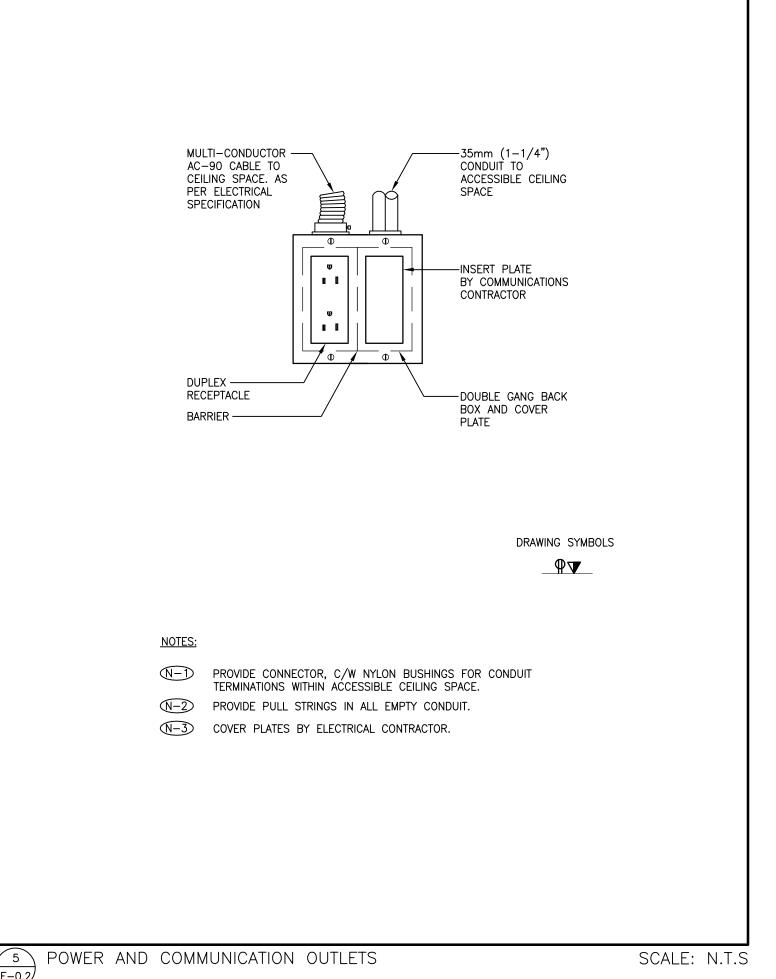
E-0.2

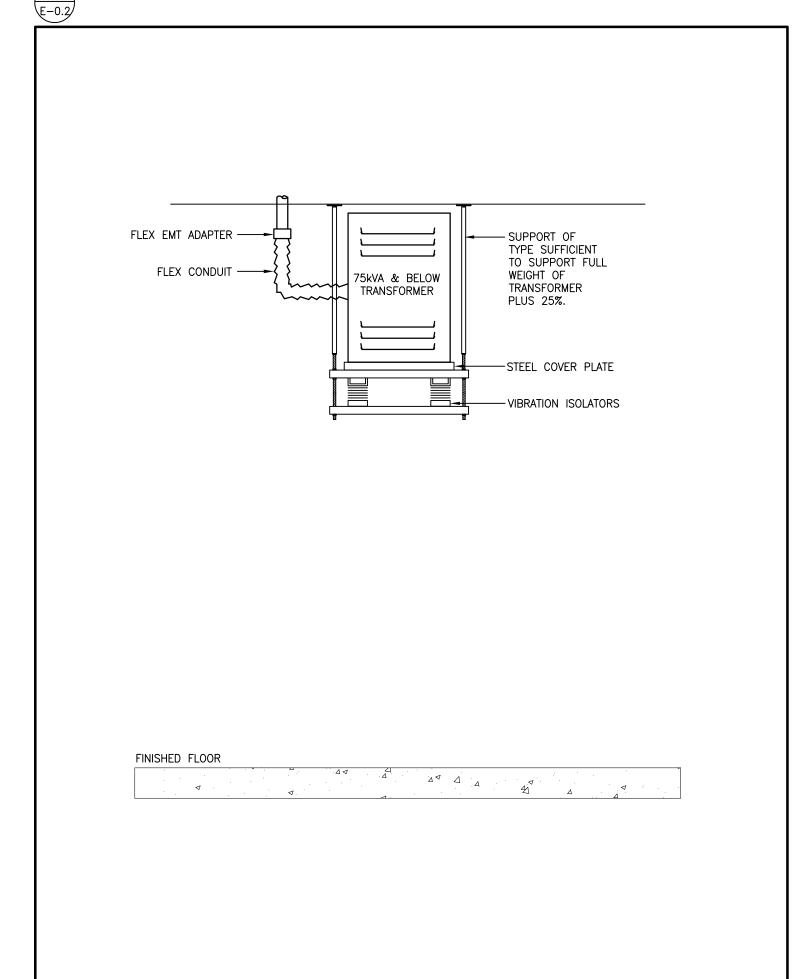



SCALE: N.T.S

7 TRANSFORMER INSTALLATION DETAIL



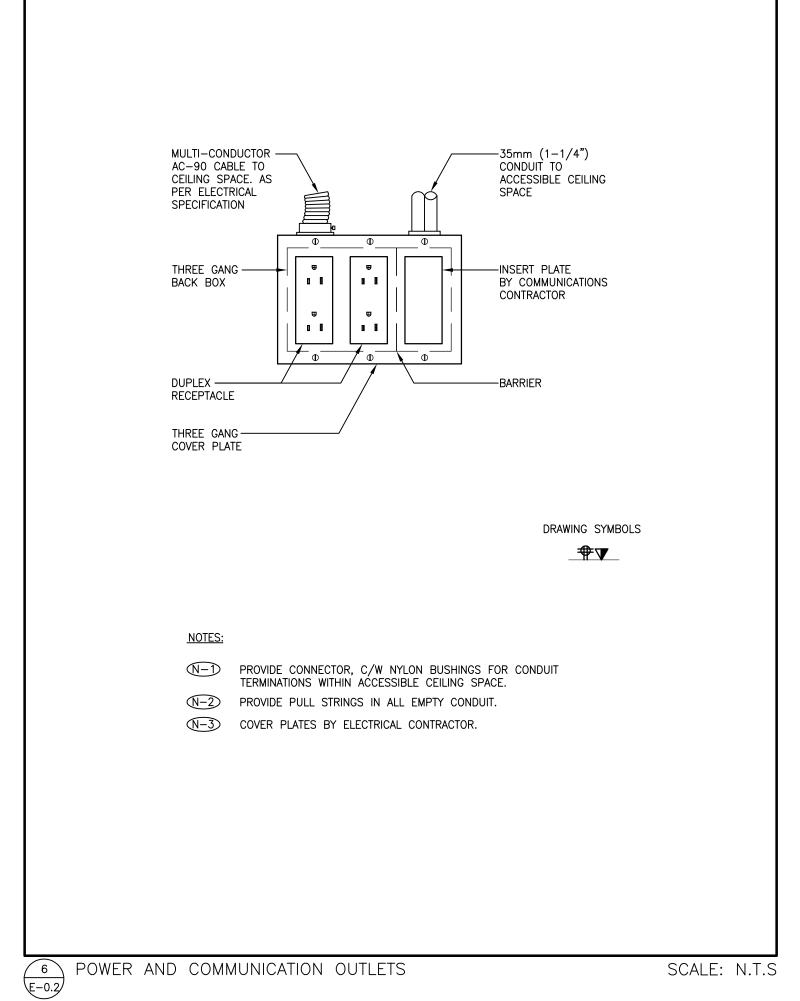

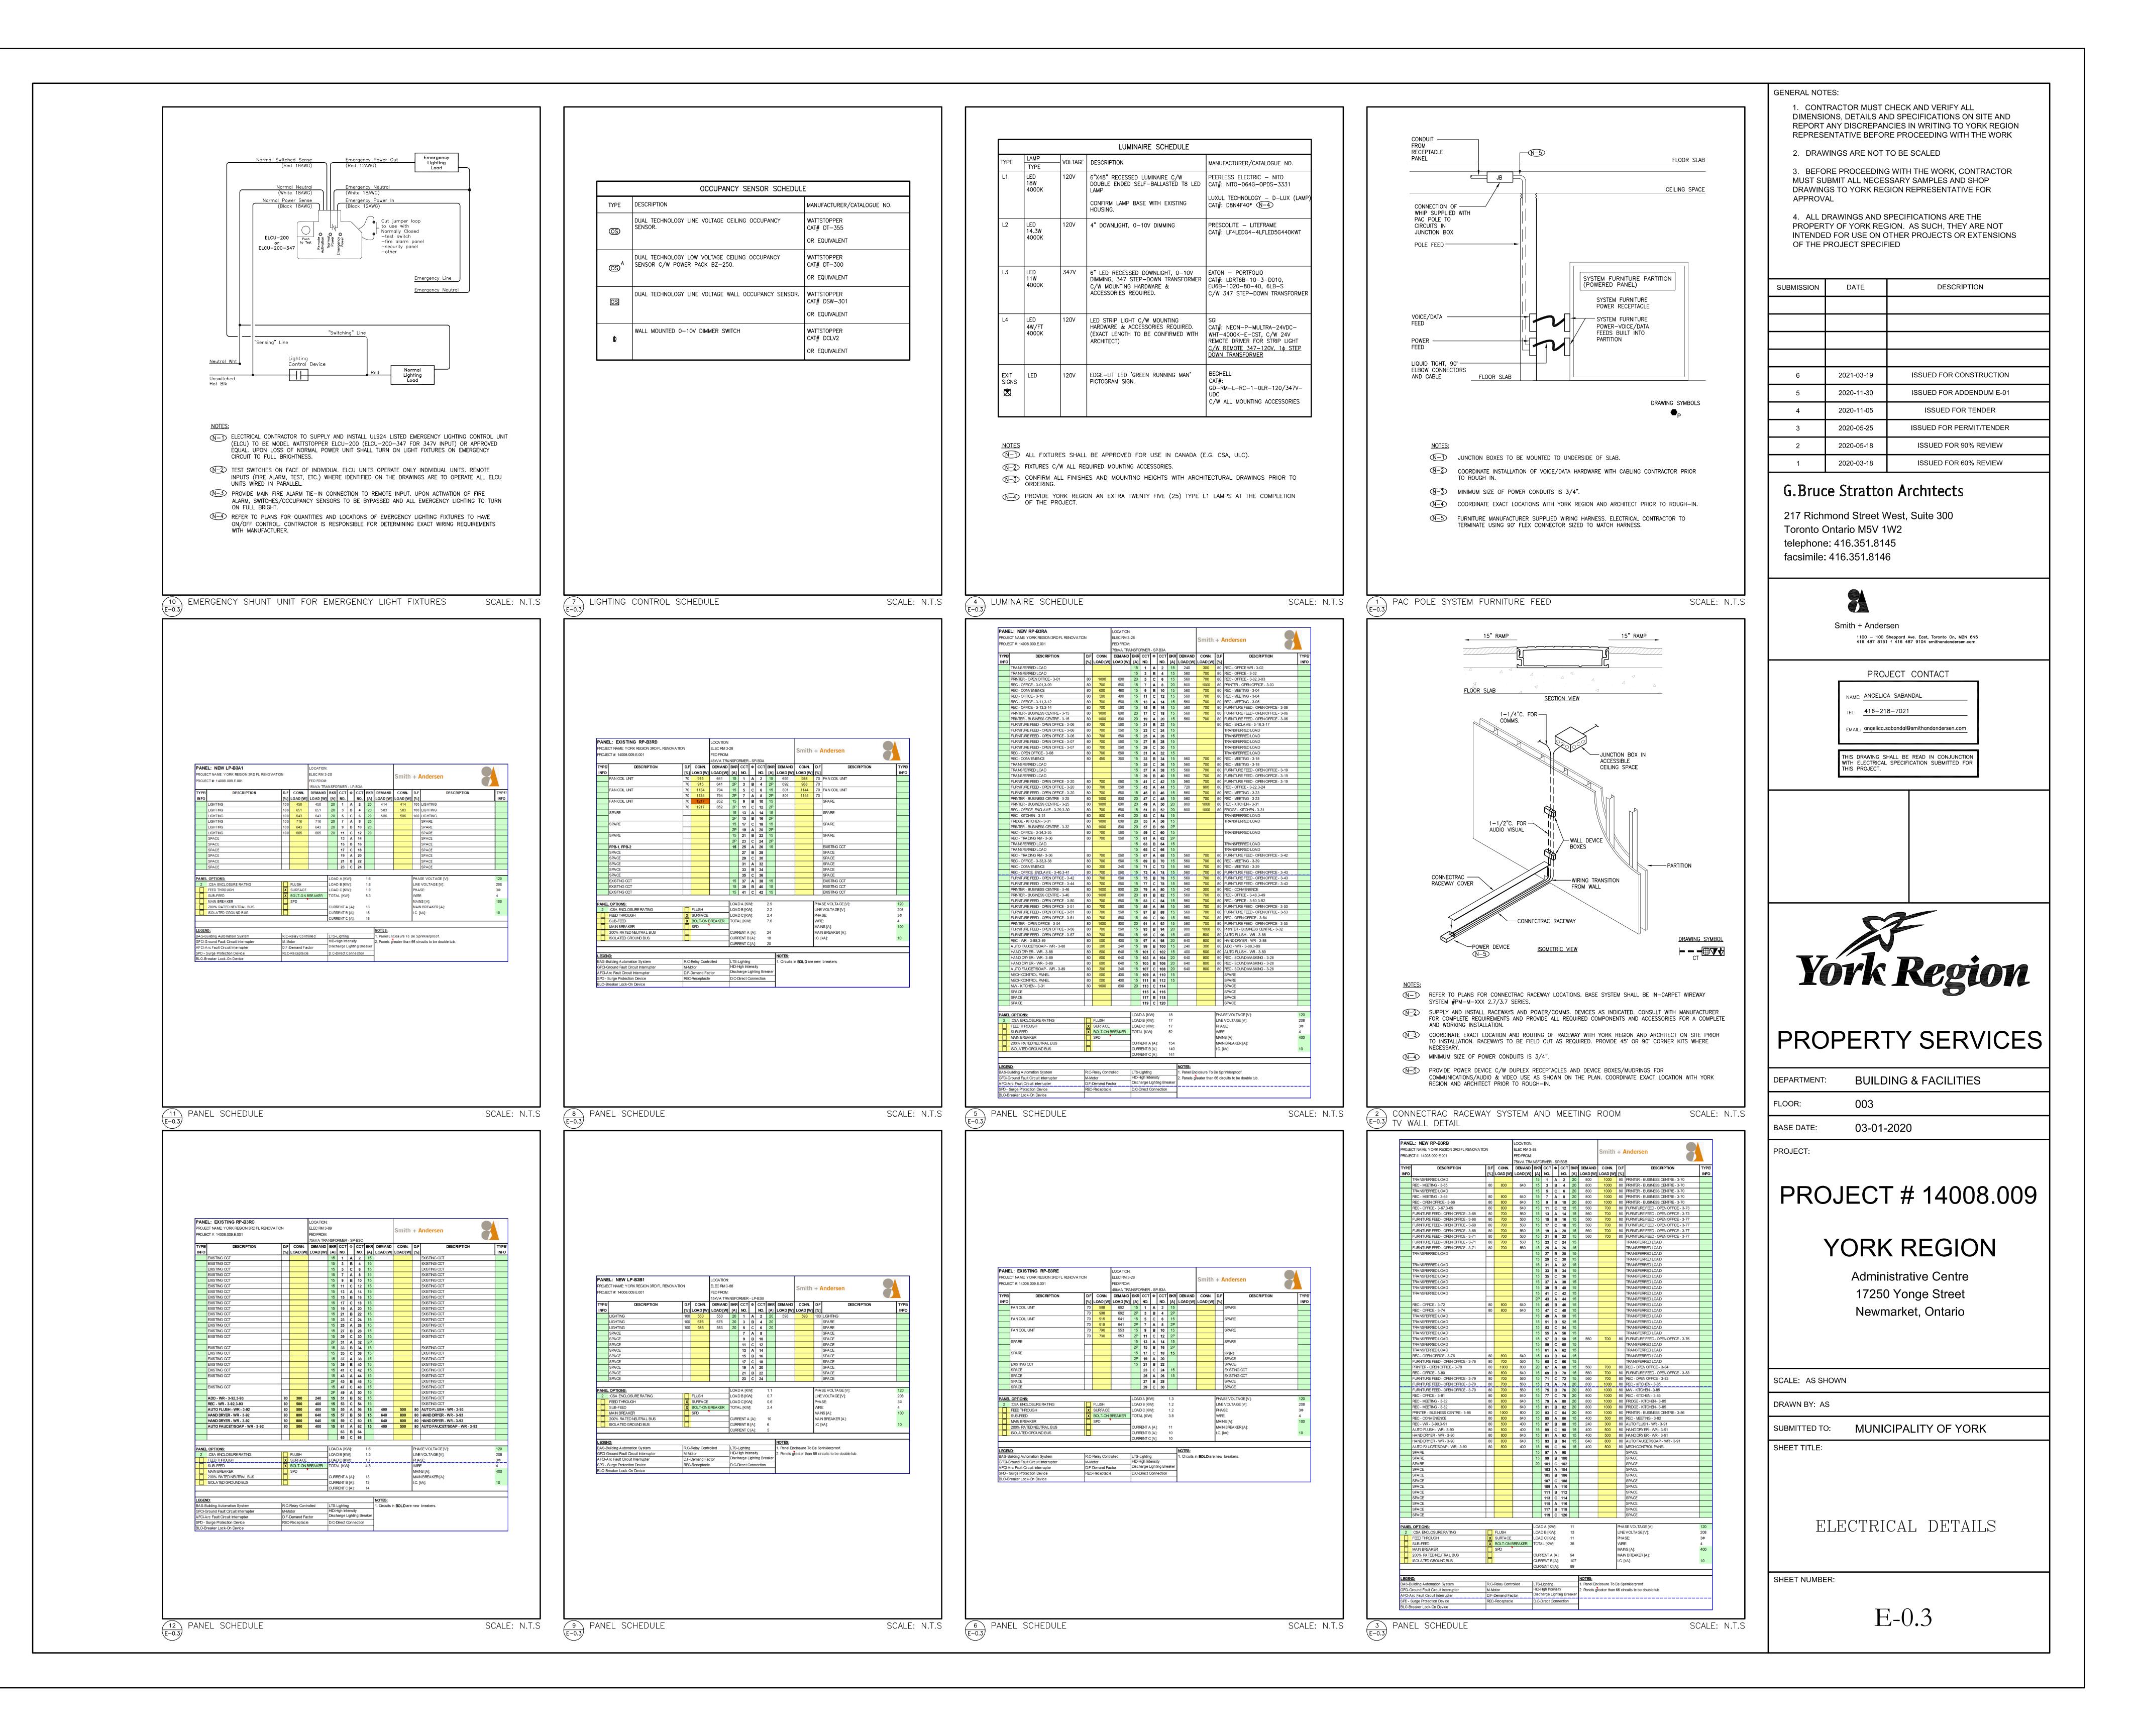

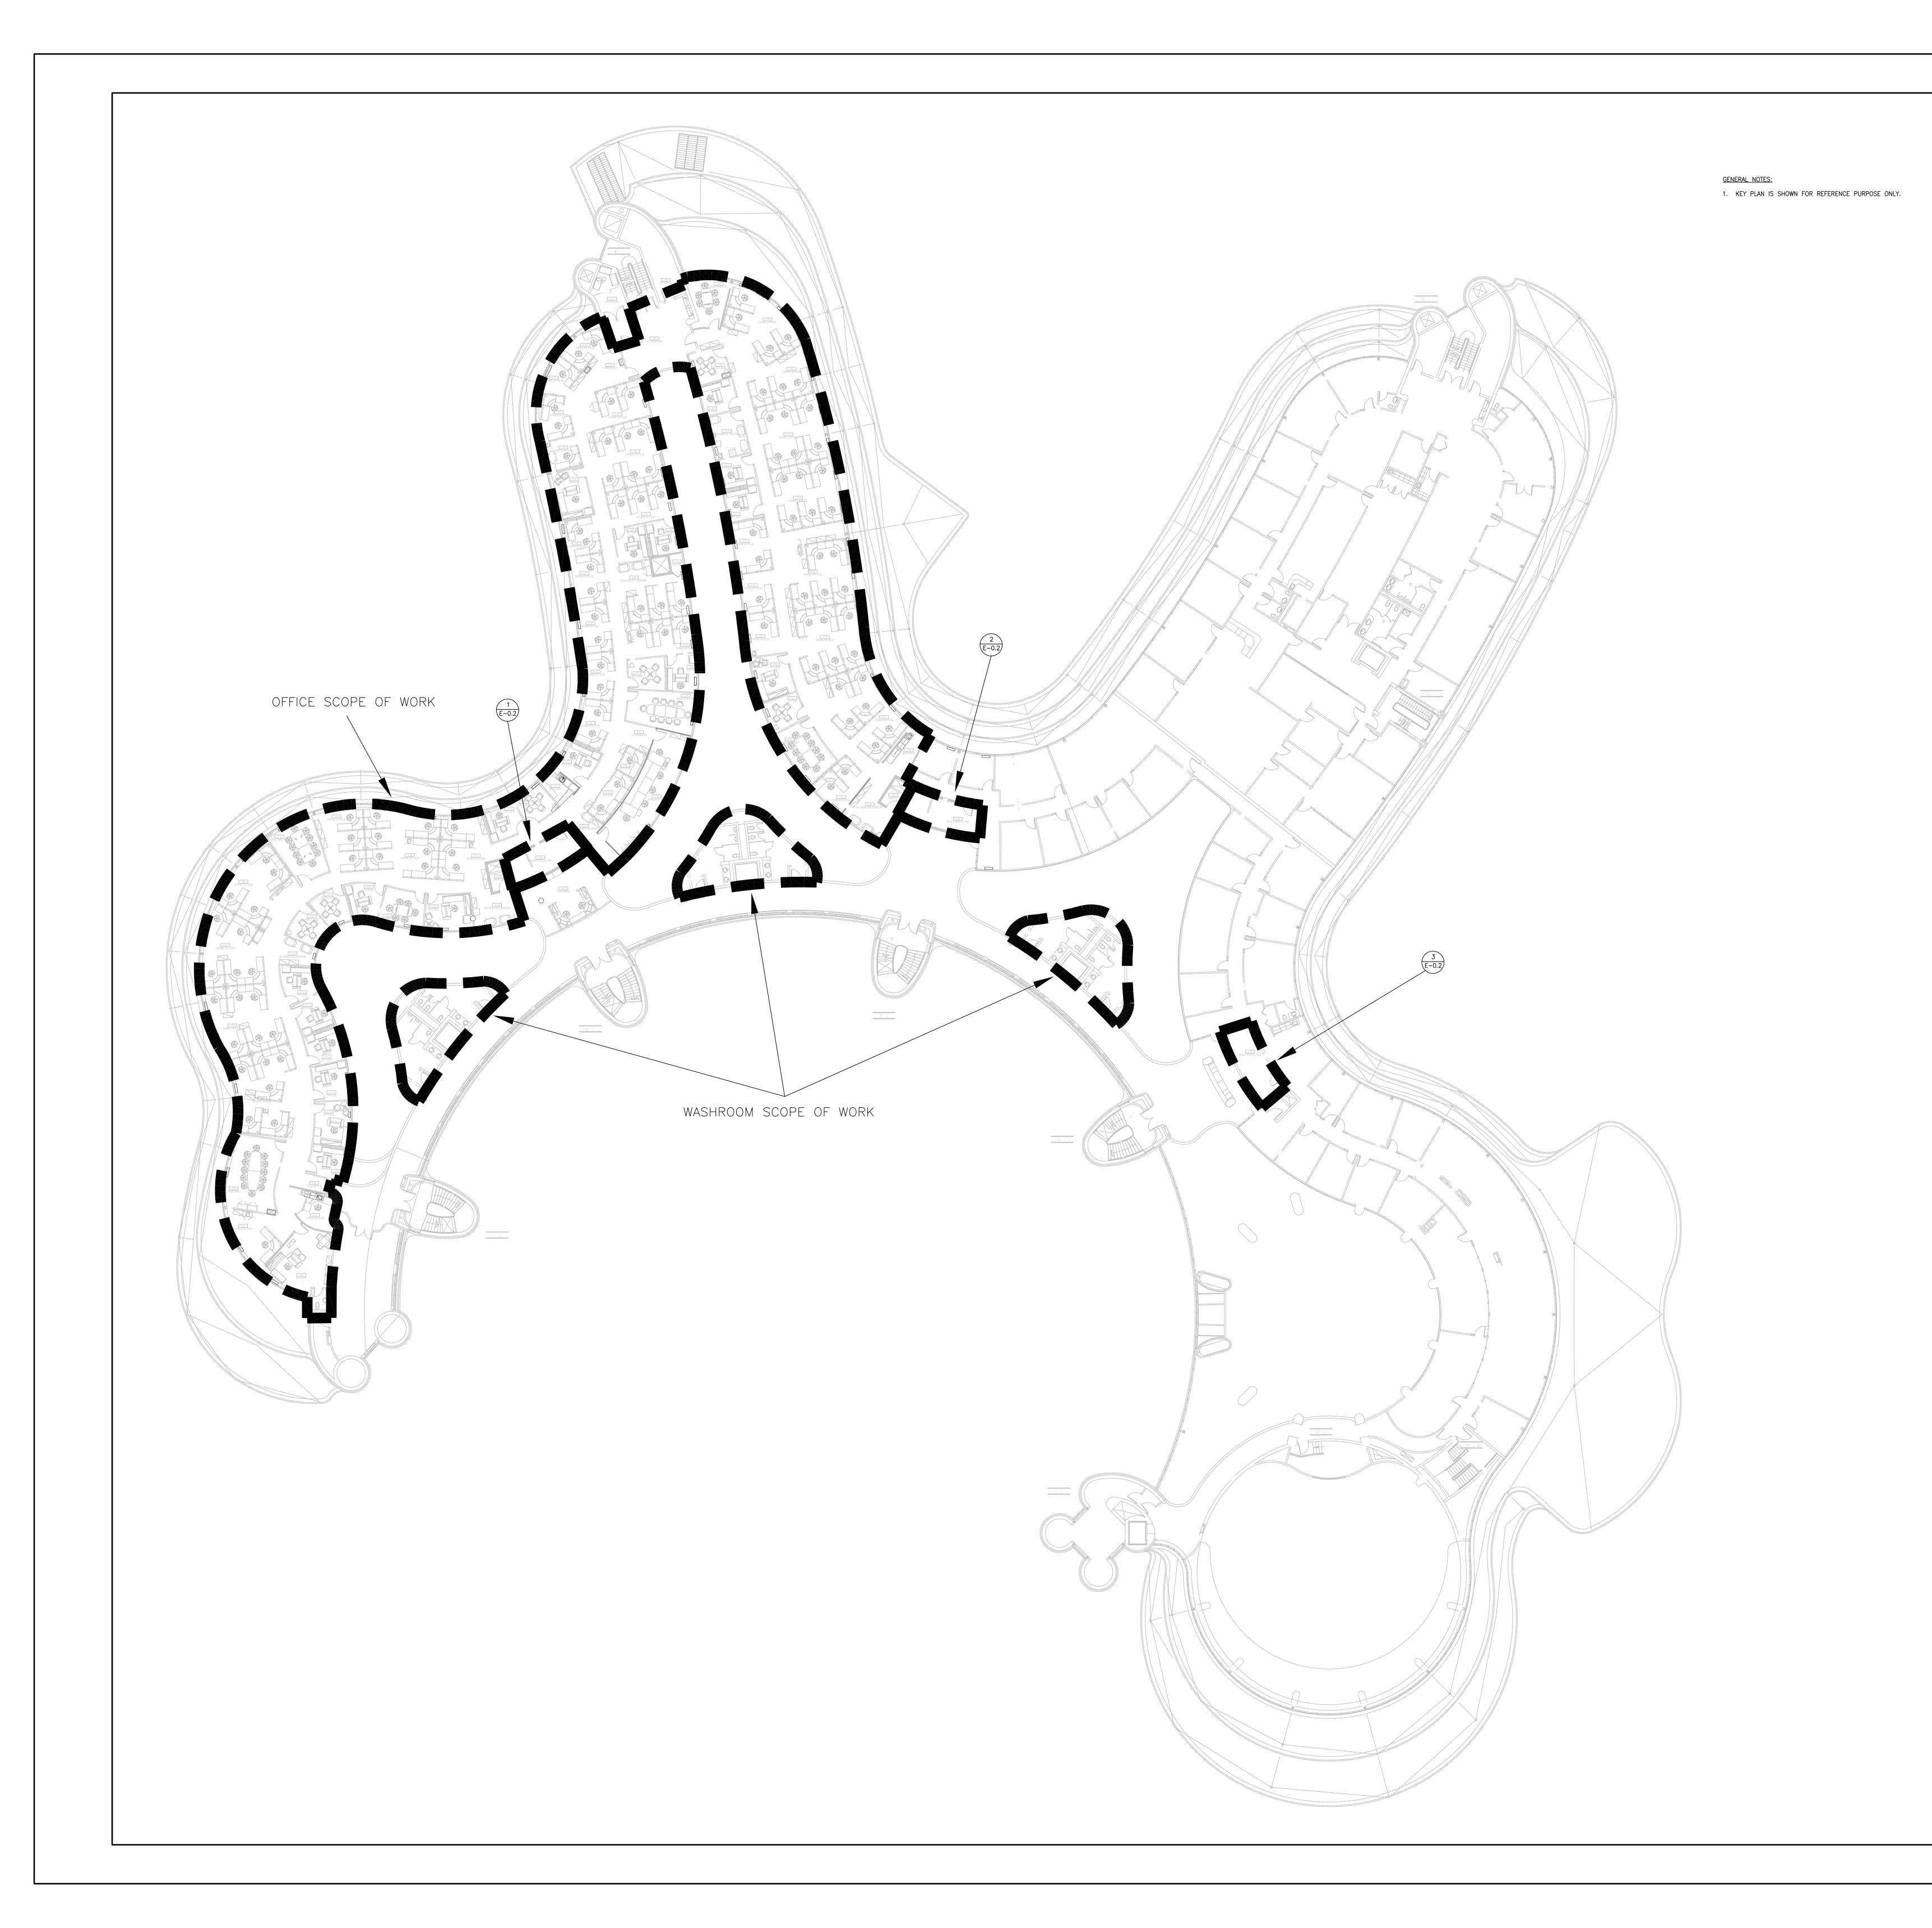

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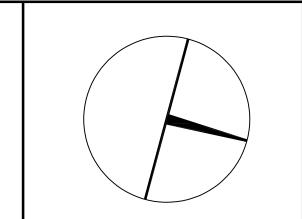
### PROJECT CONTACT

NAME: ANGELICA SABANDAL

TEL: 416-218-7021

EMAIL: angelica.sabandal@smithandandersen.com

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# PROPERTY SERVICES

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FLOOR: 003

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DRAWN BY: AS

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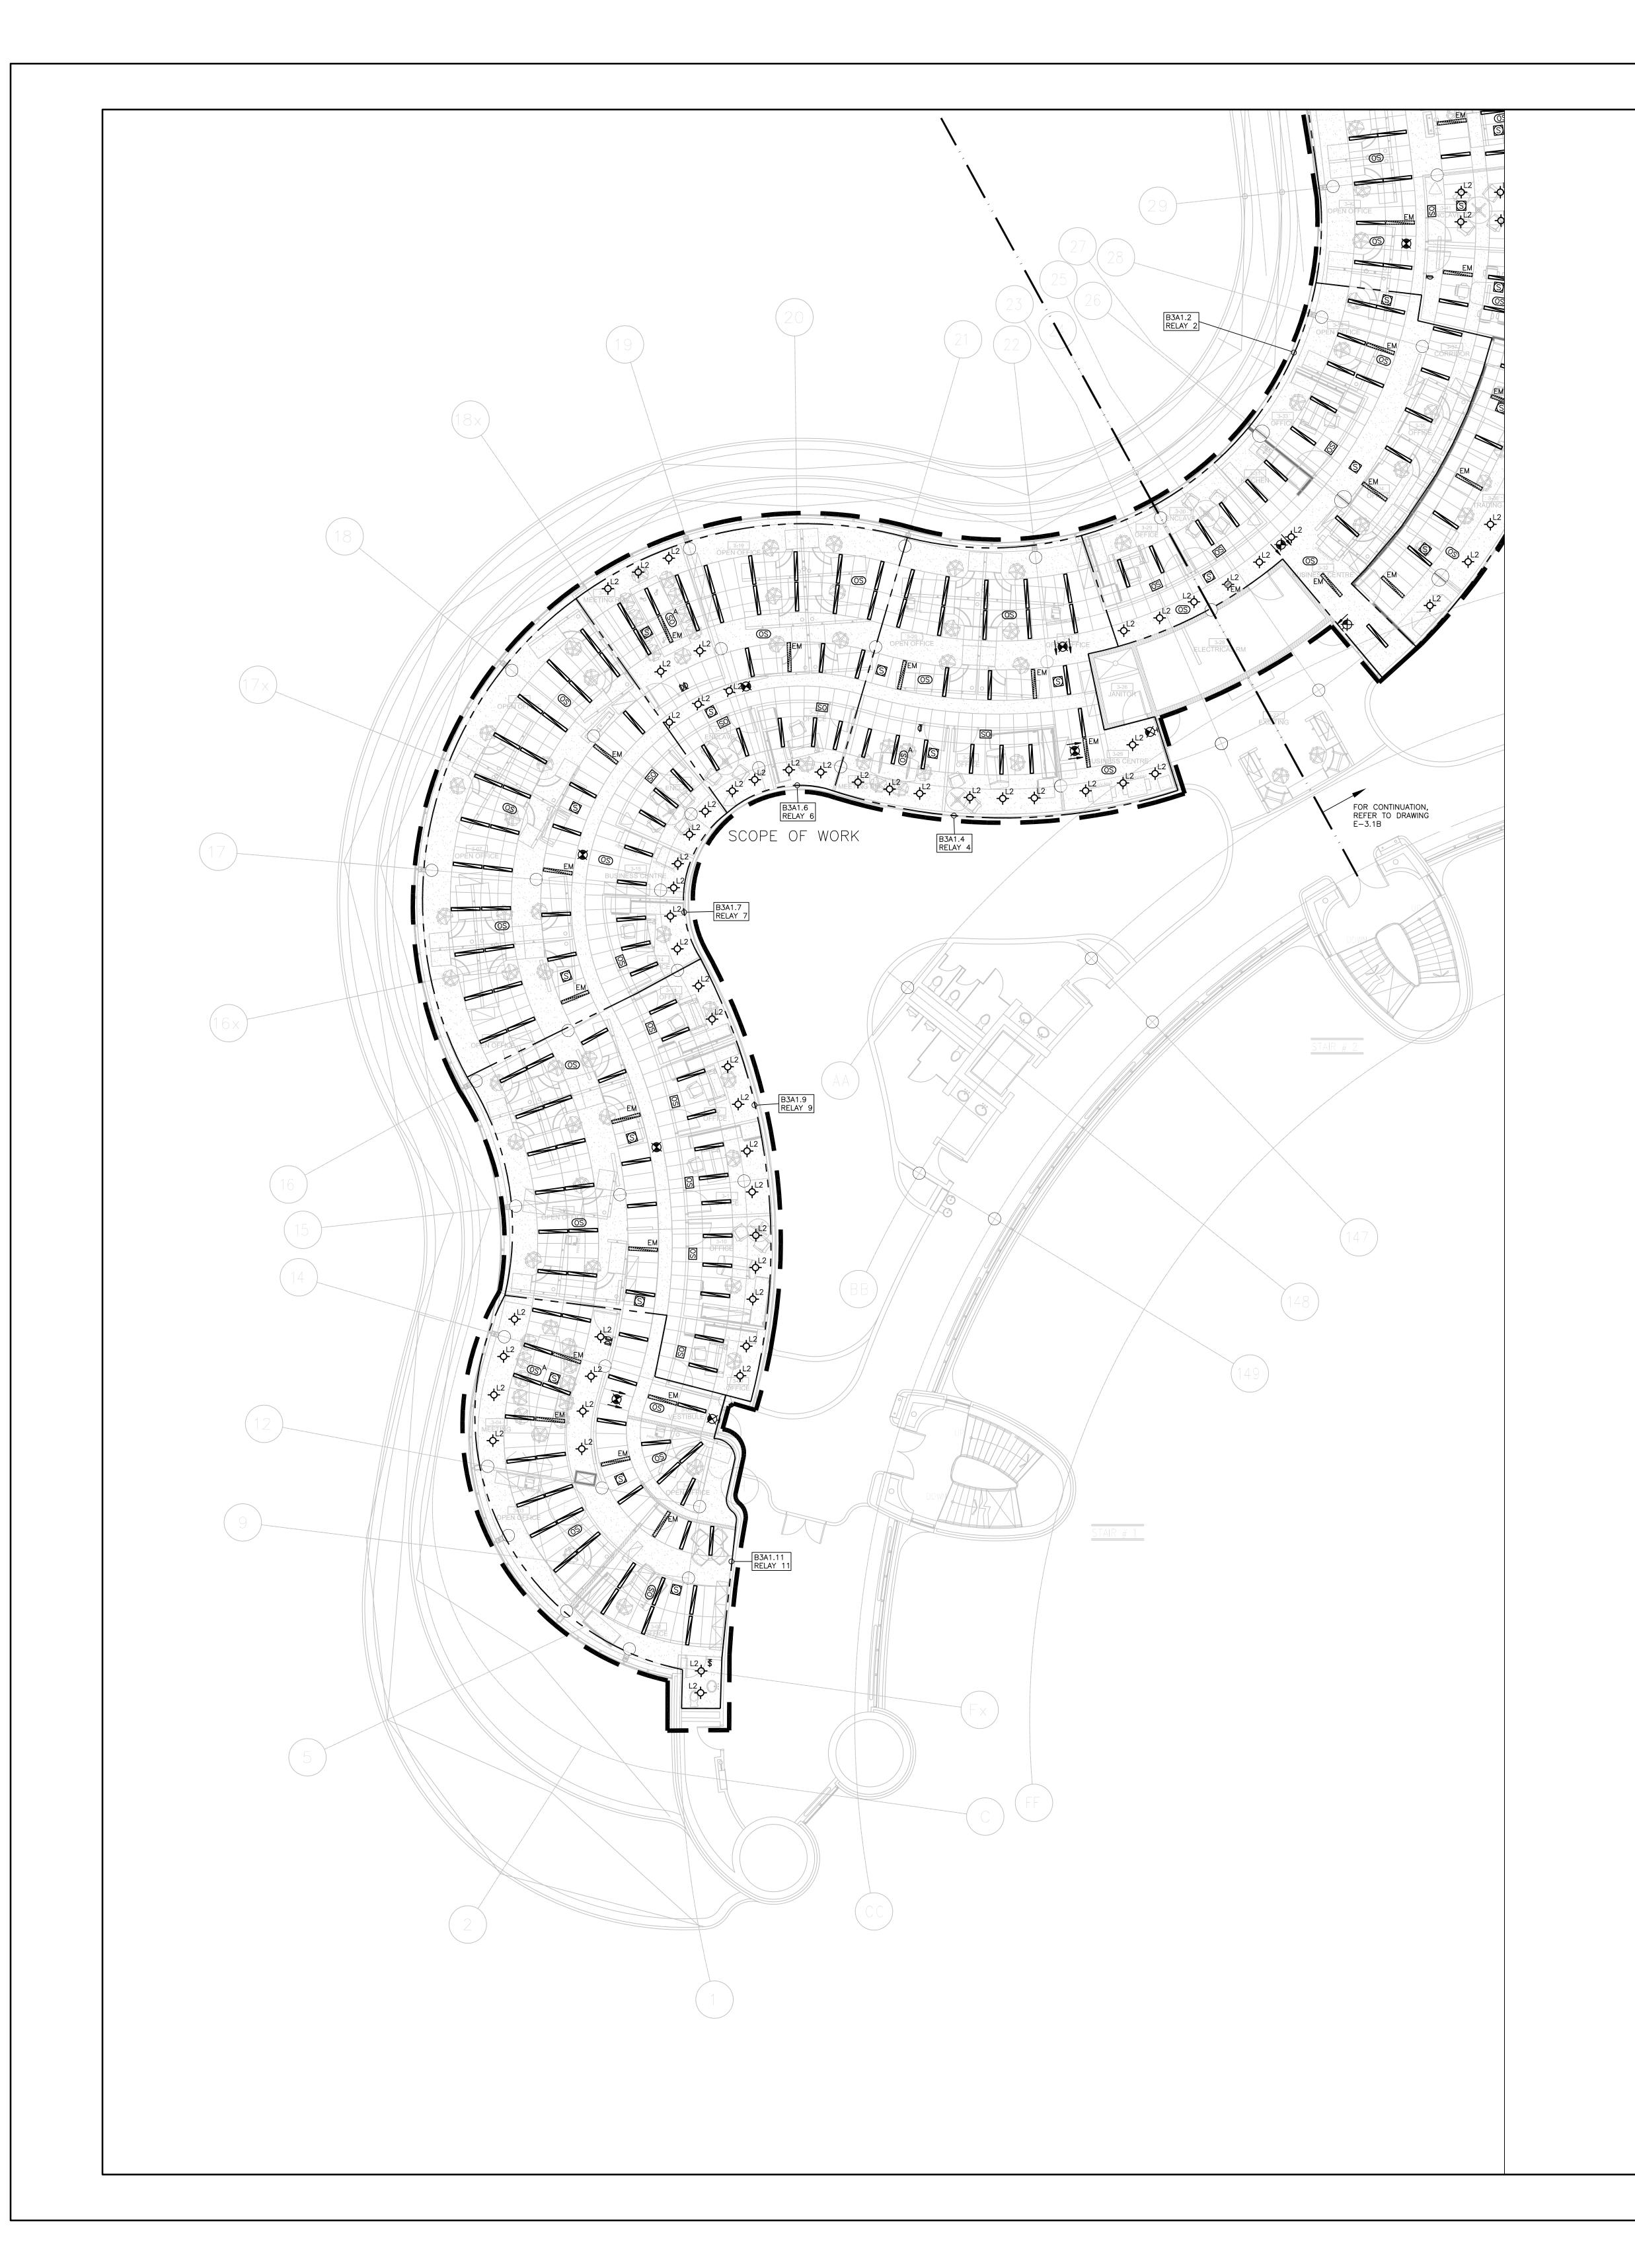
SUBMITTED TO: MUNICIPALITY OF YORK

SHEET TITLE:

OFFICE TITE

LEVEL 3 — KEY PLAN

SHEET NUMBER:



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REGION. DISPOSE OF ALL LUMINAIRES REJECTED BY THE REGION.

AND PANEL DESIGNATION.

3. REFER TO LIGHTING LAYOUT SHOWN FOR FINAL LOCATION ONLY. VISIT THE SITE AND COORDINATE EXACT QUANTITY OF LIGHTING LUMINAIRES TO BE NEW, RELOCATED AND/OR RETAINED IN EXISTING LOCATION. PROVIDE NEW LUMINAIRES TO MATCH EXISTING WHERE INSUFFICIENT QUANTITY EXIST TO SUIT. ALL RELOCATED LUMINAIRES SHALL HAVE WIRING EXTENDED TO SUIT NEW LOCATION. OFFER ALL UNUSED EXISTING LUMINAIRES TO THE

2. CIRCUITING IN PART IS DIAGRAMMATIC INTENDED TO SHOW GENERAL CIRCUIT ARRANGEMENT

4. ALL NEW/RELOCATED BASE BUILDING STANDARD LUMINAIRES AND NEW RECESSED DOWN LIGHTS SHALL BE CHAIN HUNG AND SUPPORTED FROM THE SLAB ABOVE. PROVIDE LETTER TO BE INCLUDED AS PART OF CLOSE—OUT DOCUMENT SUBMITTAL PACKAGE.

REGION AND TURN OVER ALL SELECTED LUMINAIRES AT A PLACE DESIGNATED BY THE

- 5. REWORK EXISTING EMERGENCY LIGHTING TO ACHIEVE NEW EMERGENCY LIGHTING AS SHOWN. CONNECT NEW AND/OR RELOCATED LUMINAIRES TO NEAREST EMERGENCY LIGHTING CIRCUITS ON THIS FLOOR. IF NEW EMERGENCY BRANCH CIRCUITS ARE REQUIRED FOR EMERGENCY LIGHTING AND EXISTING EMERGENCY LIGHTING PANEL IS LOCATED ON A DIFFERENT STOREY (i.e. NOT LOCATED ON SAME FLOOR), THEN NEW BRANCH CIRCUIT WIRING SHALL BE 2—HOUR FIRE RATED (i.e. MI CABLE) TO FIRST EMERGENCY LIGHT FED. IF EXISTING EMERGENCY LIGHTING PANEL IS LOCATED ON THE SAME STOREY, THE NEW BRANCH CIRCUIT WIRING DOES NOT NEED TO BE FIRE RATED. PROVIDE LOCK—ON BREAKERS TO SUIT.
- 6. MEASURE THE ILLUMINATION OF THE FLOOR AT NIGHT WITH EMERGENCY LIGHTING ON ONLY, AND SEND A DRAWING SHOWING THE MAXIMUM AND MINIMUM LEVEL OF ILLUMINATION, TO THE CONSULTING ENGINEER, FOR REVIEW. PROVIDE WRITTEN CONFIRMATION THAT EMERGENCY LIGHTING HAS BEEN INSTALLED IN ACCORDANCE WITH CONTRACT DOCUMENTS AND LATEST EDITION OF THE ONTARIO BUILDING CODE SECTIONS 3.2.7.3 AND 3.2.7.4. LETTER TO BE INCLUDED AS PART OF CLOSE—OUT DOCUMENT SUBMITTAL PACKAGE.
- 7. PROVIDE NEW PICTOGRAM (RUNNING MAN) TYPE EXIT SIGNS. EQUAL TO THOMAS AND BETTS EA SERIES COMPLETE WITH BRUSHED ALUMINUM FINISH, FACES AND INDICATOR ARROWS AS PER DRAWINGS AND UNIVERSAL 120-347VAC VOLTAGE INPUT UNLESS OTHERWISE NOTED. OR MATCH EXISTING BASE BUILDING STANDARD UNLESS OTHERWISE NOTED. CONNECT NEW EXIT SIGNS TO THE NEAREST AVAILABLE SPARE EXIT LIGHTING CIRCUIT. DO NOT OVERLOAD THE CIRCUIT. ALLOW FOR THREE (3) ADDITIONAL EXIT SIGNS (COMPLETE WITH MATERIAL AND LABOUR) TO BE INSTALLED AS PER BUILDING INSPECTORS REQUIREMENTS UPON FINAL INSPECTION.

8. LOCATE AND POSITION EXIT SIGNS SUCH THAT THEY DO NOT INTERFERE WITH ADJACENT

- EXIT SIGNS AND EMERGENCY LIGHTING COVERAGE. 9. ALL MODIFICATIONS TO FIRE ALARM SYSTEM AND DEVICES TO BE COMPLETED BY BASE BUILDING FIRE ALARM CONTRACTOR AND VENDOR/MANUFACTURER. BASE BUILDING FIRE ALARM CONTRACTOR/VENDOR/MANUFACTURER IS RESPONSIBLE TO ENSURE THAT ALL ADDITIONAL COMPONENTS (MATERIAL, SOFTWARE, INCLUDING ANY LABOUR TO INSTALL OR MODIFY FIRE ALARM DEVICES) ARE INCLUDED FOR BASED ON ISSUED DRAWINGS. ELECTRICAL CONTRACTOR TO ALLOW FOR ALL ASSOCIATED COSTS. NEW FIRE ALARM SPEAKER/STROBES ARE TO MATCH EXISTING AND BE CONNECTED TO NEAREST AVAILABLE SPARE EMERGENCY ZONE CIRCUIT(S). CONNECT NEW SPEAKER/STROBES TO EXISTING CIRCUITS, WHERE THERE IS SPARE CAPACITY ON RESPECTIVE CIRCUITS. IF THERE IS NO CAPACITY ON EXISTING CIRCUITS, PROVIDE NEW FIRE ALARM CIRCUITS. ALLOW FOR ALL ASSOCIATED COSTS INCLUDING BUT NOT LIMITED TO; ASSOCIATED EQUIPMENT, DEVICES, PROGRAMMING, TESTING AND VERIFICATION TO MAKE SYSTEM OPERATIONAL AND CODE COMPLIANT. ALL FIRE ALARM VERIFICATION SHALL CONFORM TO CAN/ULC-S537 LATEST EDITION. FIRE ALARM SYSTEM SHALL BE INSTALLED IN CONFORMANCE WITH CAN/ULC-S524 LATEST EDITION. INCLUDE IN THE COST TO PROVIDE TWO (2) ADDITIONAL FIRE ALARM SPEAKERS AND ONE (1) ADDITIONAL AUDIBILITY VERIFICATION.
- 10. ENSURE THAT ALL LIGHTING FIXTURES ARE CLEAN AND ILLUMINATED BY END OF PROJECT.11. REWORK EXISTING SWITCHING TO ACCOMMODATE THE NEW LIGHTING LAYOUT WITHIN THE TENANT SPACE.
- 12. THE ELECTRICAL CONTRACTOR SHALL PROVIDE POWER EXTENDERS ON ALL DIMMERS AS REQUIRED. REFER TO SPECIFICATIONS FOR DETAILS ON DIMMER RATINGS.
- 13. REUSE EXISTING CIRCUIT FOUND IN CEILING SPACE FOR ALL NEW LIGHTING FIXTURES UNLESS OTHERWISE NOTED. CONTRACTOR TO PROVIDE ADDITIONAL CIRCUITS WHERE REQUIRED. NEW LOW VOLTAGE SWITCH ARRANGEMENT OF LIGHTING TO BE CO—ORDINATED WITH THE REGION AND REARRANGED TO SUIT NEW LAYOUT. ALL LIGHTING, EXCLUDING EMERGENCY, WITHIN THE TENANT PREMISES TO BE ON A SEPARATE LIGHTING ZONE AND TO BE CONTROLLED BY BASE BUILDING LIGHTING CONTROL SYSTEM. PROVIDE ALL NECESSARY RELAYS, CONTACTORS, RELAY PANELS, AND DRY INTERFACES REQUIRED FOR SUCH CONTROL. INCLUDE COST IN THIS CONTRACT.
- 14. PROVIDE NEW LUMINAIRE DISCONNECTS THAT COMPLY WITH REQUIREMENTS SPECIFIED IN OESC PART 1, RULE 30-308(4) LATEST EDITION FOR ALL LIGHT FIXTURES THAT EXCEED 150V SHOWN AS NEW AND OR RELOCATED. ALL NEW AND RELOCATED FIXTURES (THAT EXCEED 150V) SHALL BE MARKED IN A CONSPICUOUS, LEGIBLE, AND PERMANENT MANNER ADJACENT TO THE DISCONNECTING MEANS, IDENTIFYING THE SPECIFIC PURPOSE.
- 15. LIGHTING FIXTURES IDENTIFIED AS EMERGENCY ARE TO BE CONNECTED SO THAT UNDER NORMAL CONDITIONS THEY WORK IN CONJUNCTION WITH THE SWITCHING AS IDENTIFIED. IN THE EVENT OF AN EMERGENCY, THESE LIGHTS ARE TO BE FORCED ON WITH THE USE OF A UL-924 LISTED RELAY. UPON POWER FAILURE THE RELAY IS TO ACTIVATE THE LIGHTS TO FULL BRIGHTNESS. REFER TO DETAIL 10/E-0.3 FOR REQUIREMENTS.
- 16. COORDINATE INSTALLATION OF FIXTURES WITH MECHANICAL EQUIPMENT, ELECTRICAL EQUIPMENT, SPRINKLERS AND DUCT WORK WITH OTHER TRADES PRIOR TO WORK COMMENCING.
- 17. ALL CEILING MOUNTED OCCUPANCY SENSORS PROVIDED AS PART OF THIS SCOPE OF WORK MUST BE LOCATED AT LEAST 6'0" AWAY FROM ANY SUPPLY AIR DIFFUSER AND RETURN AIR GRILLE AS PER MANUFACTURER'S RECOMMENDATION. COORDINATE INSTALLATION ON SITE WITH MECHANICAL CONTRACTOR PRIOR TO COMMENCING WORK.

DRAWING NOTES:

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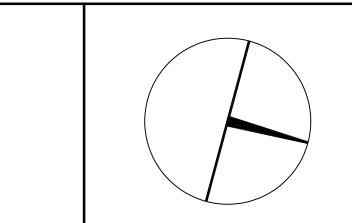
### PROJECT CONTACT

NAME: ANGELICA SABANDAL

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# PROPERTY SERVICES

DEPARTMENT: BUILDING & FACILITIES

FLOOR: 003

BASE DATE: 03-01-2020

# PROJECT:

# PROJECT # 14008.009

# YORK REGION

Administrative Centre 17250 Yonge Street Newmarket, Ontario

SCALE: 1:100

DRAWN BY: AS


SUBMITTED TO: MUNICIPALITY OF YORK

SHEET TITLE:

PARTIAL LEVEL 3 – LIGHTING AND FIRE ALARM LAYOUT (PART A)

SHEET NUMBER:

E-3.1A

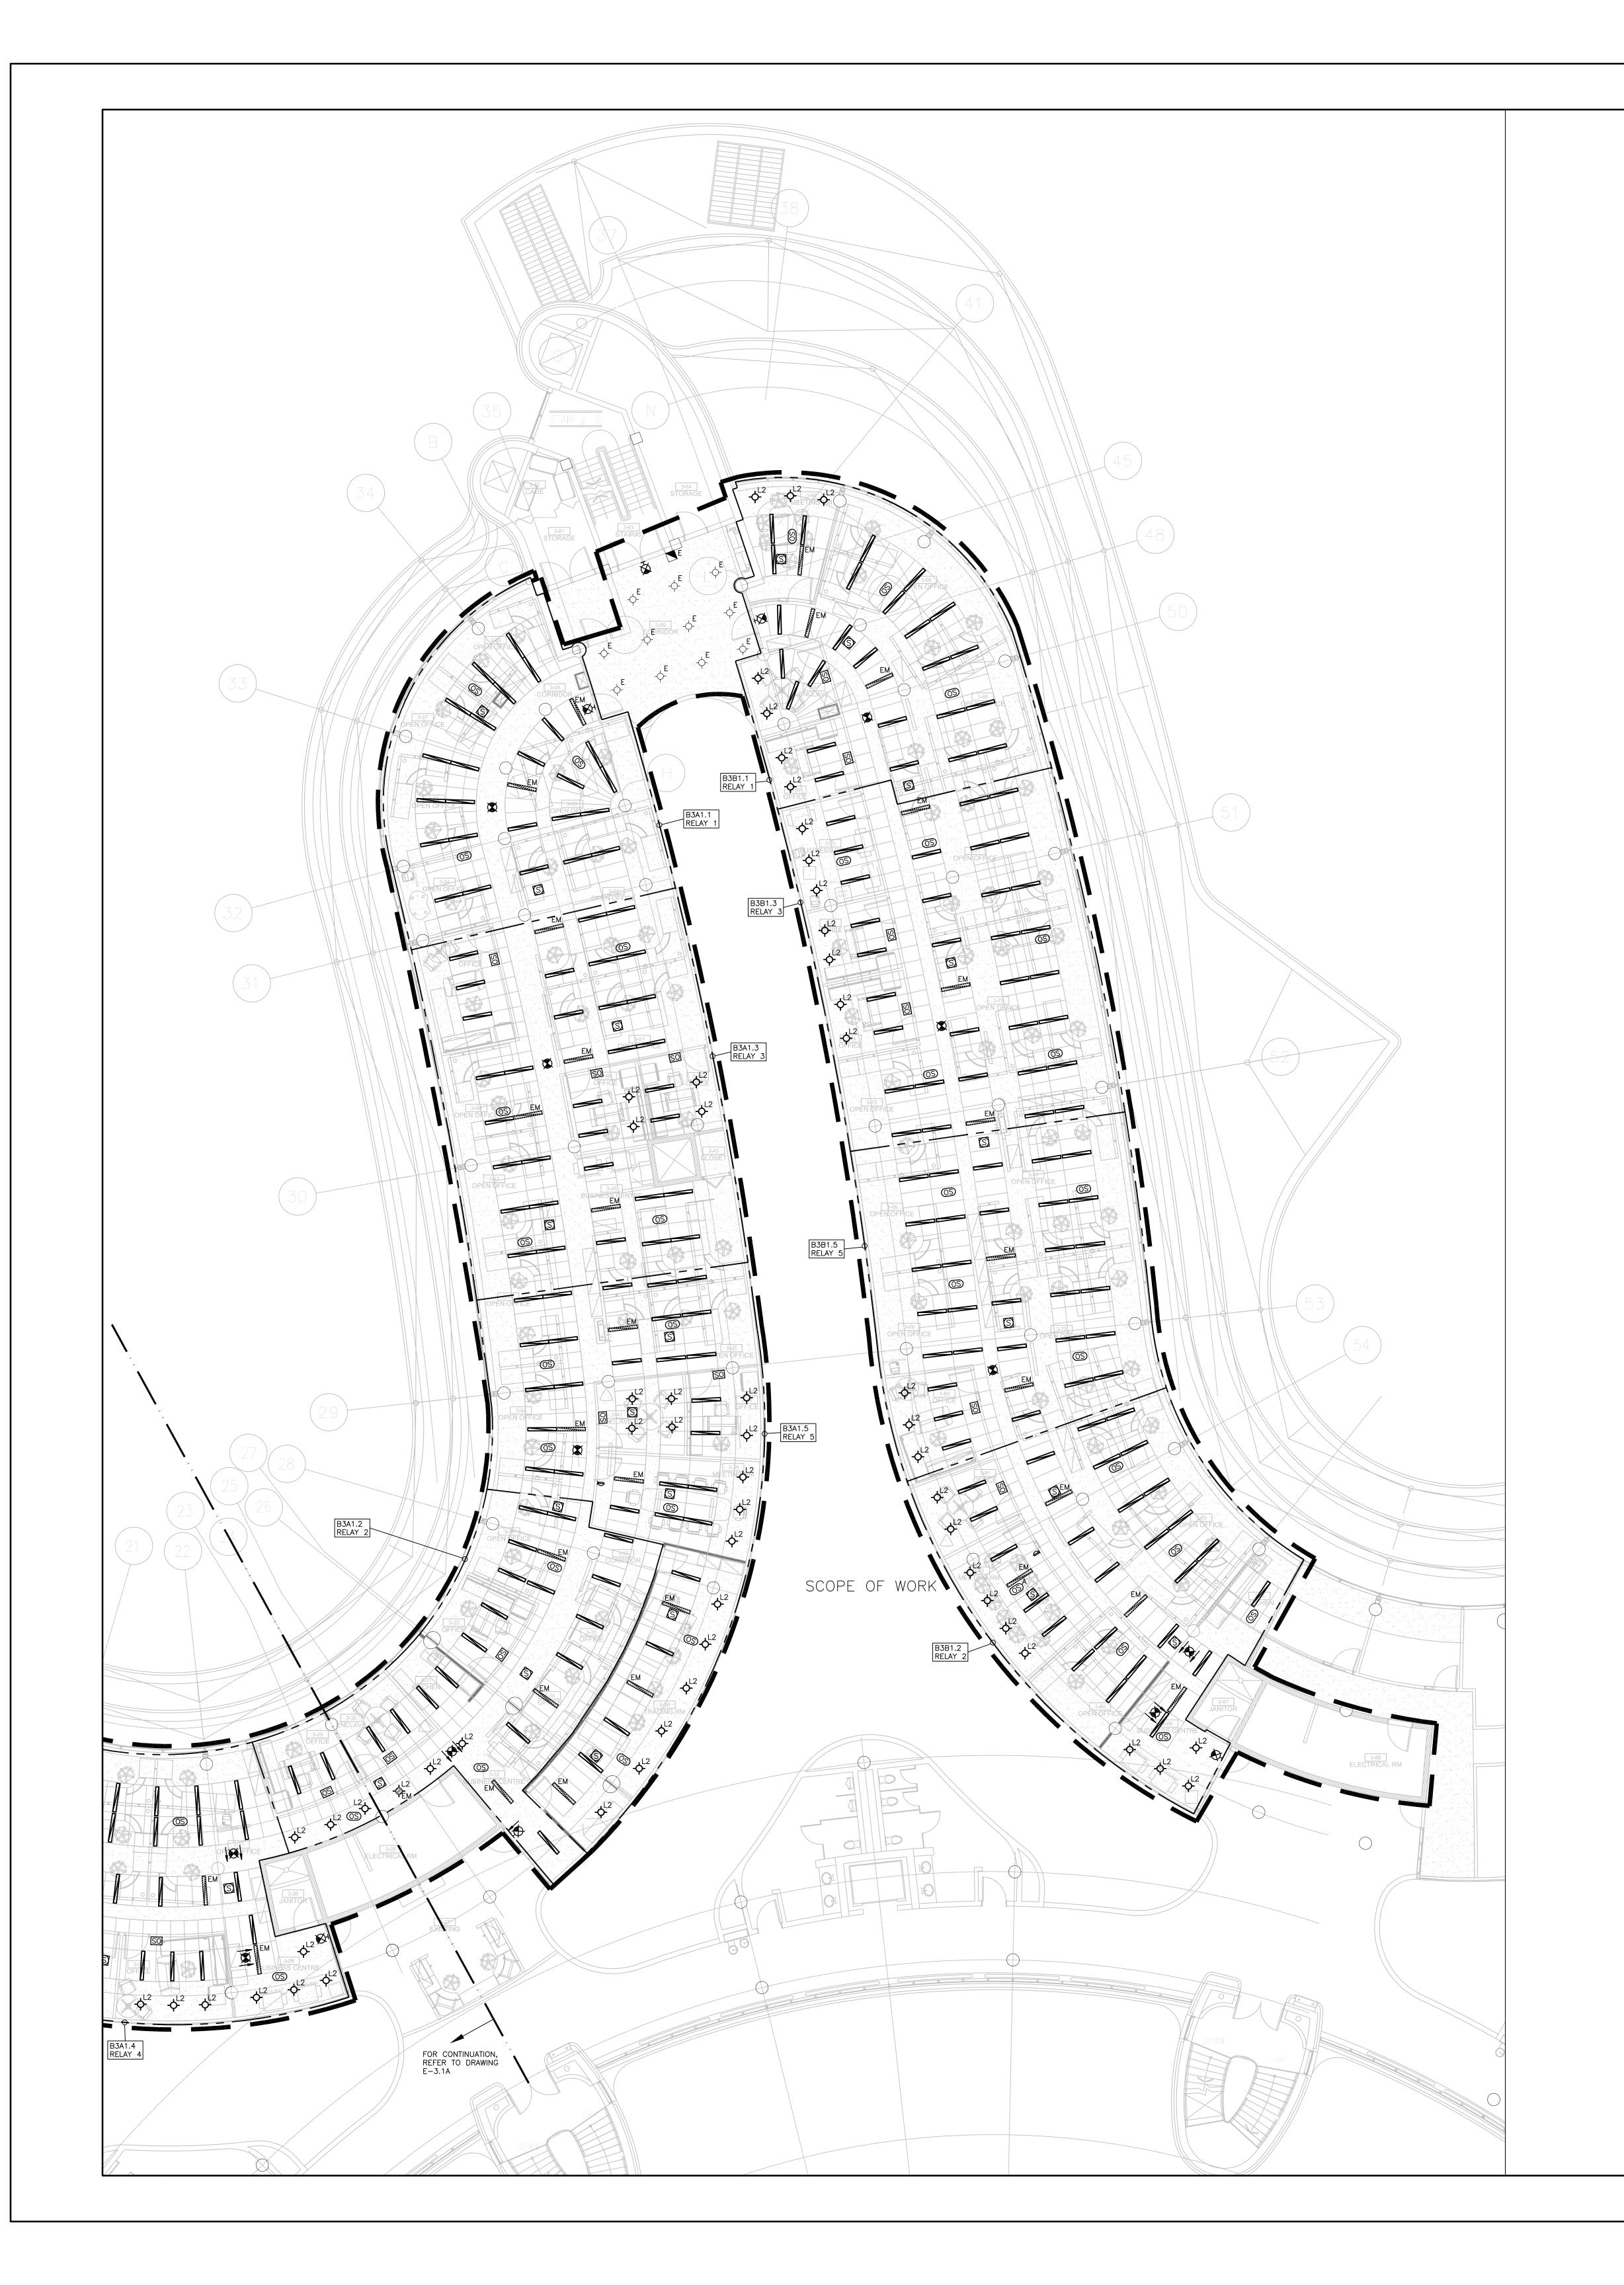

1. THESE DRAWINGS SHALL BE READ IN CONJUNCTION WITH ARCHITECT'S DRAWINGS FOR DIMENSIONS, HEIGHTS, CONSTRUCTION DETAILING, FINISHES AND COLOURS.

REGION. DISPOSE OF ALL LUMINAIRES REJECTED BY THE REGION.

CIRCUITING IN PART IS DIAGRAMMATIC INTENDED TO SHOW GENERAL CIRCUIT ARRANGEMENT AND PANEL DESIGNATION.
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  11. REWORK EXISTING SWITCHING TO ACCOMMODATE THE NEW LIGHTING LAYOUT WITHIN THE TENANT SPACE.

PROGRAMMING, TESTING AND VERIFICATION TO MAKE SYSTEM OPERATIONAL AND CODE

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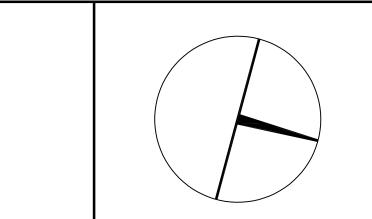
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FLOOR: 003

BASE DATE: 03-01-2020

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# PROJECT # 14008.009

# YORK REGION

Administrative Centre 17250 Yonge Street Newmarket, Ontario

SCALE: 1:100

DRAWN BY: AS


BMITTED TO: MUNICIPALITY OF YORK

SHEET TITLE:

PARTIAL LEVEL 3 – LIGHTING AND FIRE ALARM LAYOUT (PART B)

SHEET NUMBER:

E-3.1B

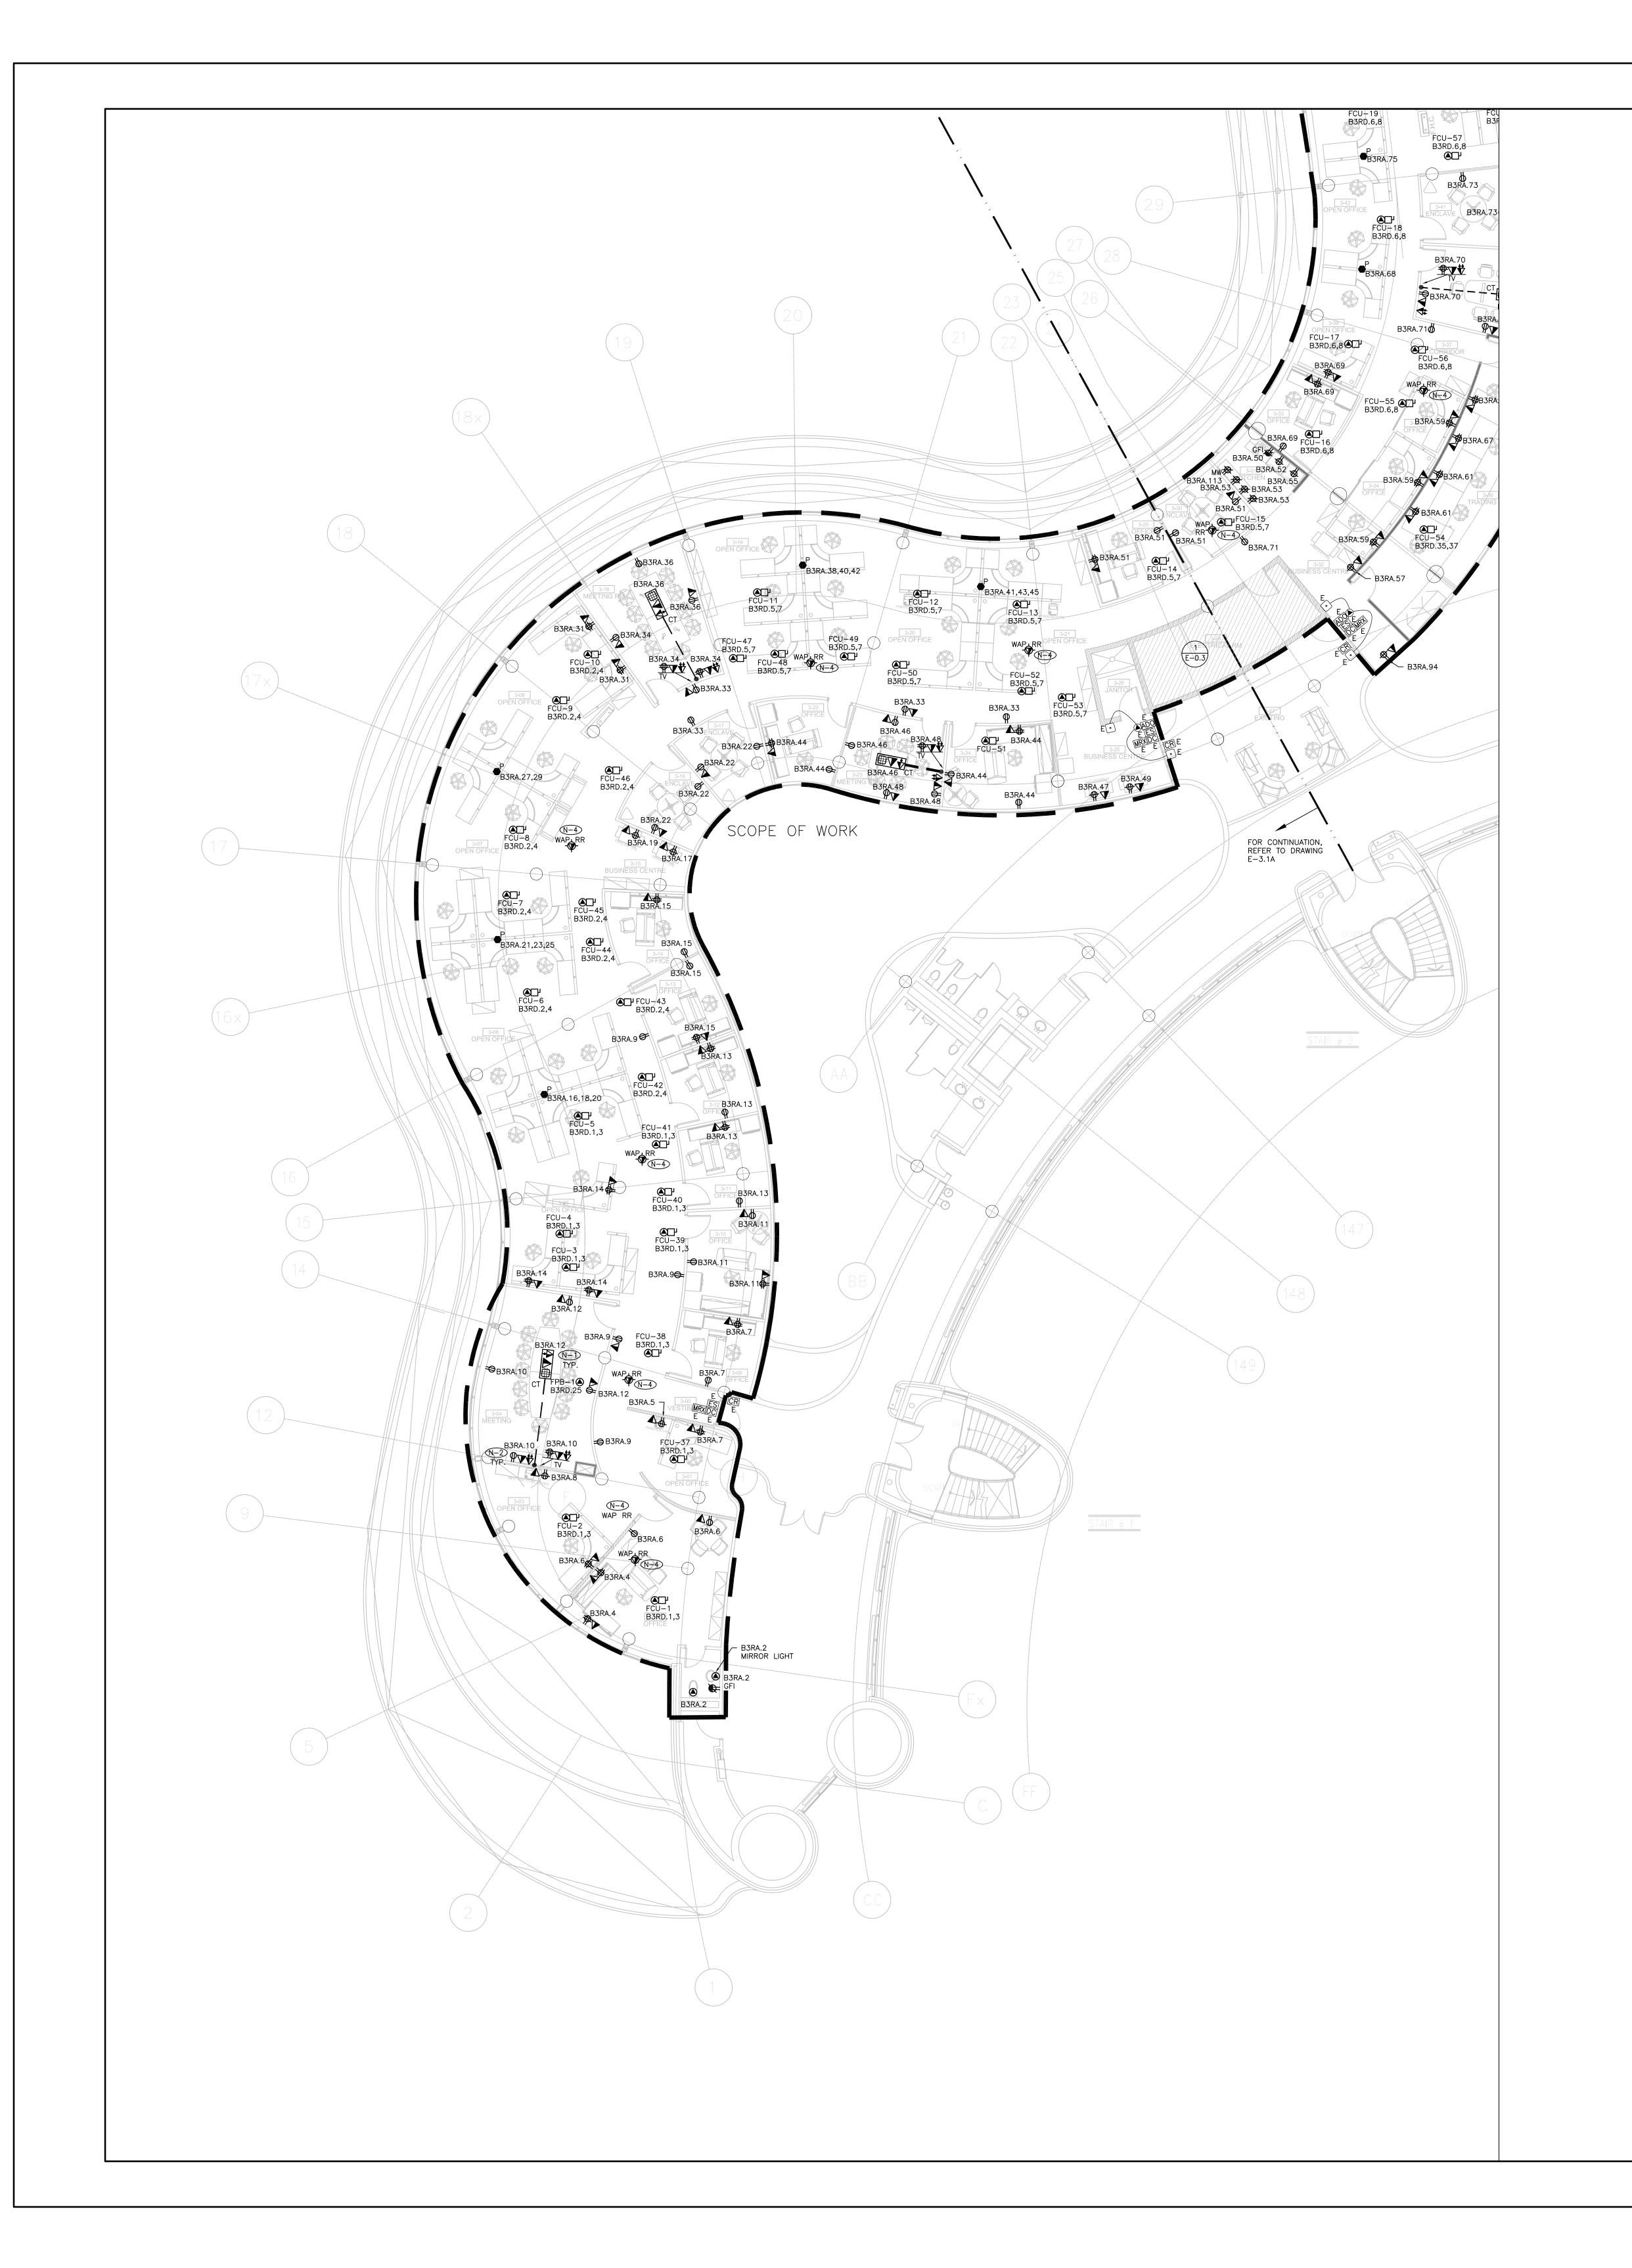

- THESE DRAWINGS SHALL BE READ IN CONJUNCTION WITH ARCHITECT'S DRAWINGS FOR DIMENSIONS, HEIGHTS, CONSTRUCTION DETAILING, FINISHES AND COLOURS.
   CIRCUITING IN PART IS DIAGRAMMATIC INTENDED TO SHOW GENERAL CIRCUIT ARRANGEMENT AND PANEL DESIGNATION.
- 3. PROVIDE EMT CONDUIT IN AREAS WITH EXPOSED CEILINGS, BX CABLING IS NOT ACCEPTABLE UNLESS OTHERWISE NOTED. BX CABLES MAY BE USED FOR FINAL CONNECTIONS TO LIGHTING FIXTURES OR EQUIPMENT WITH A MAXIMUM HORIZONTAL RUN LENGTH OF 3 FEET / 1 METER. PAINT CONDUITS TO MATCH ARCHITECTURAL BACKGROUNDS. MOUNT EXIT SIGNS, OCCUPANCY SENSORS, EXIT SIGNS, CAMERAS, WAPS AND ALL OTHER CEILING MOUNTED DEVICES WITH STEMS SUCH THAT THEY ARE ON THE SAME PLANE AS SUSPENDED LIGHTING FIXTURES. COORDINATE CEILINGS AND WALL HEIGHTS WITH INTERIOR DESIGNER DRAWINGS.
- 4. REUSE CIRCUITS OBTAINED THROUGH DEMOLITION IS ACCEPTABLE.
- 5. CIRCUITS HAVE BEEN RE—ASSIGNED BASED ON AS BUILT DRAWINGS. VERIFY ACCURACY AND INFORM CONSULTANT OTHERWISE.6. VERIFY EXACT POWER REQUIREMENTS AND RECEPTACLE TYPES FOR SPECIAL EQUIPMENT WITH
- MANUFACTURER PRIOR TO INSTALLATION. PROVIDE HARDWIRE CONNECTIONS FOR DISHWASHERS AND COPIERS ETC. IN LIEU OF RECEPTACLES OR VICE VERSA, AS REQUIRED.

  7. REFER TO ARCHITECT'S DRAWINGS FOR THE COLOUR OF COVERPLATES AND MOUNTING
- 8. MARK UP OUTLET AND DEVICE LOCATIONS AND OBTAIN APPROVAL BY DESIGN CONSULTANT PRIOR TO INSTALLATION.
- 9. PROVIDE SUITABLE LABELS ON ALL RECEPTACLES, SYSTEM FURNITURE FEEDS, AND FAN COIL UNITS. LABELS TO INCLUDE BOTH PANEL AND CIRCUIT DESIGNATION. REVIEW LABEL SIZE AND TYPE WITH CONSULTANT PRIOR TO INSTALLATION.
- 10. TRACE ALL EXISTING OUTLETS, NOTED AS EXISTING, AND IDENTIFY ON AS BUILT DRAWING AS PER SPECIFICATION.11. ALLOW FOR THE REMOVAL AND RE-INSTALLATION OF SYSTEMS FURNITURE CONNECTIONS.
- CONFIRM ELECTRICAL REQUIREMENTS AND EXACT LOCATION OF ALL MECHANICAL EQUIPMENT WITH MECHANICAL DRAWINGS AND CONTRACTOR PRIOR TO ROUGH—INS.
   ROUTE ALL CONDUIT SYSTEMS AROUND DUCT WORK, BEAMS AND PIPING AS REQUIRED TO
- ACCOMMODATE LAYOUT SHOWN. REFER TO MECHANICAL DRAWINGS AND ARCHITECTURAL DRAWINGS FOR ADDITIONAL DETAILS.

### DRAWING NOTES:

- THE CONNECTRAC UNDER-CARPET RACEWAY SYSTEM SHALL CONSIST OF TWO (2)
  DUPLEX RECEPTACLES, PROVISION FOR DATA AND HDMI CABLING AND OUTLETS.
  CONTRACTOR SHALL COORDINATE THE FINAL LOCATIONS OF CONNECTRAC FLOOR
  MONUMENT AND RACEWAY ROUTING WITH YORK REGION PRIOR TO INSTALLATION. (TYP.)
- N-2 MEETING ROOM TV WALL OUTLETS AT THE FLOOR LEVEL AND BEHIND THE TV SHALL BE ALIGNED VERTICALLY, COORDINATE MOUNTING HEIGHT AND LOCATION WITH YORK REGION PRIOR TO INSTALLATION. (TYP.)
- N-3 NOT USED.
- N-4 EXISTING WIRELESS ACCESS POINT TO REMAIN. (EXISTING WAP LOCATIONS ON DRAWINGS ARE APPROXIMATE). LABEL AND MAP OUT EACH WAP EXACT LOCATION PRIOR TO REMOVAL THEN REMOVE AND REINSTALL WIRELESS ACCESS POINT AT THE SAME LOCATION AS REQUIRED.

### GENERAL NOTES:

- CONTRACTOR MUST CHECK AND VERIFY ALL
  DIMENSIONS, DETAILS AND SPECIFICATIONS ON SITE AND
  REPORT ANY DISCREPANCIES IN WRITING TO YORK REGION
- 2. DRAWINGS ARE NOT TO BE SCALED
- 3. BEFORE PROCEEDING WITH THE WORK, CONTRACTOR MUST SUBMIT ALL NECESSARY SAMPLES AND SHOP DRAWINGS TO YORK REGION REPRESENTATIVE FOR APPROVAL

REPRESENTATIVE BEFORE PROCEEDING WITH THE WORK

4. ALL DRAWINGS AND SPECIFICATIONS ARE THE PROPERTY OF YORK REGION. AS SUCH, THEY ARE NOT INTENDED FOR USE ON OTHER PROJECTS OR EXTENSIONS OF THE PROJECT SPECIFIED

	SUBMISSION	DATE	DESCRIPTION
L D			
5			
	6	2021-03-19	ISSUED FOR CONSTRUCTION
	5	2020-11-30	ISSUED FOR ADDENDUM E-01
	4	2020-11-05	ISSUED FOR TENDER
	3	2020-05-25	ISSUED FOR PERMIT/TENDER
	2	2020-05-18	ISSUED FOR 90% REVIEW
	1	2020-03-18	ISSUED FOR 60% REVIEW

### G.Bruce Stratton Architects

217 Richmond Street West, Suite 300 Toronto Ontario M5V 1W2 telephone: 416.351.8145 facsimile: 416.351.8146



ith + Andersen


### PROJECT CONTACT

NAME: ANGELICA SABANDAL

TEL: 416-218-7021

EMAIL: angelica.sabandal@smithandandersen.com

THIS DRAWING SHALL BE READ IN CONJUNCTION WITH ELECTRICAL SPECIFICATION SUBMITTED FOR THIS PROJECT.

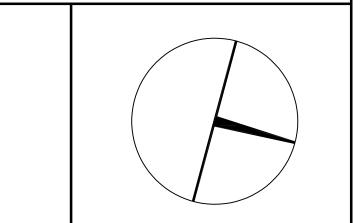



# PROPERTY SERVICES

DEPARTMENT: BUILDING & FACILITIES

FLOOR: 003

BASE DATE: 03-01-2020

PROJECT:

# PROJECT # 14008.009

# YORK REGION

Administrative Centre 17250 Yonge Street Newmarket, Ontario

SCALE: 1:100

DRAWN BY: AS


SUBMITTED TO: MUNICIPALITY OF YORK

SHEET TITLE:

PARTIAL LEVEL 3 – POWER AND SYSTEMS LAYOUT (PART A)

SHEET NUMBER:

E-3.2A

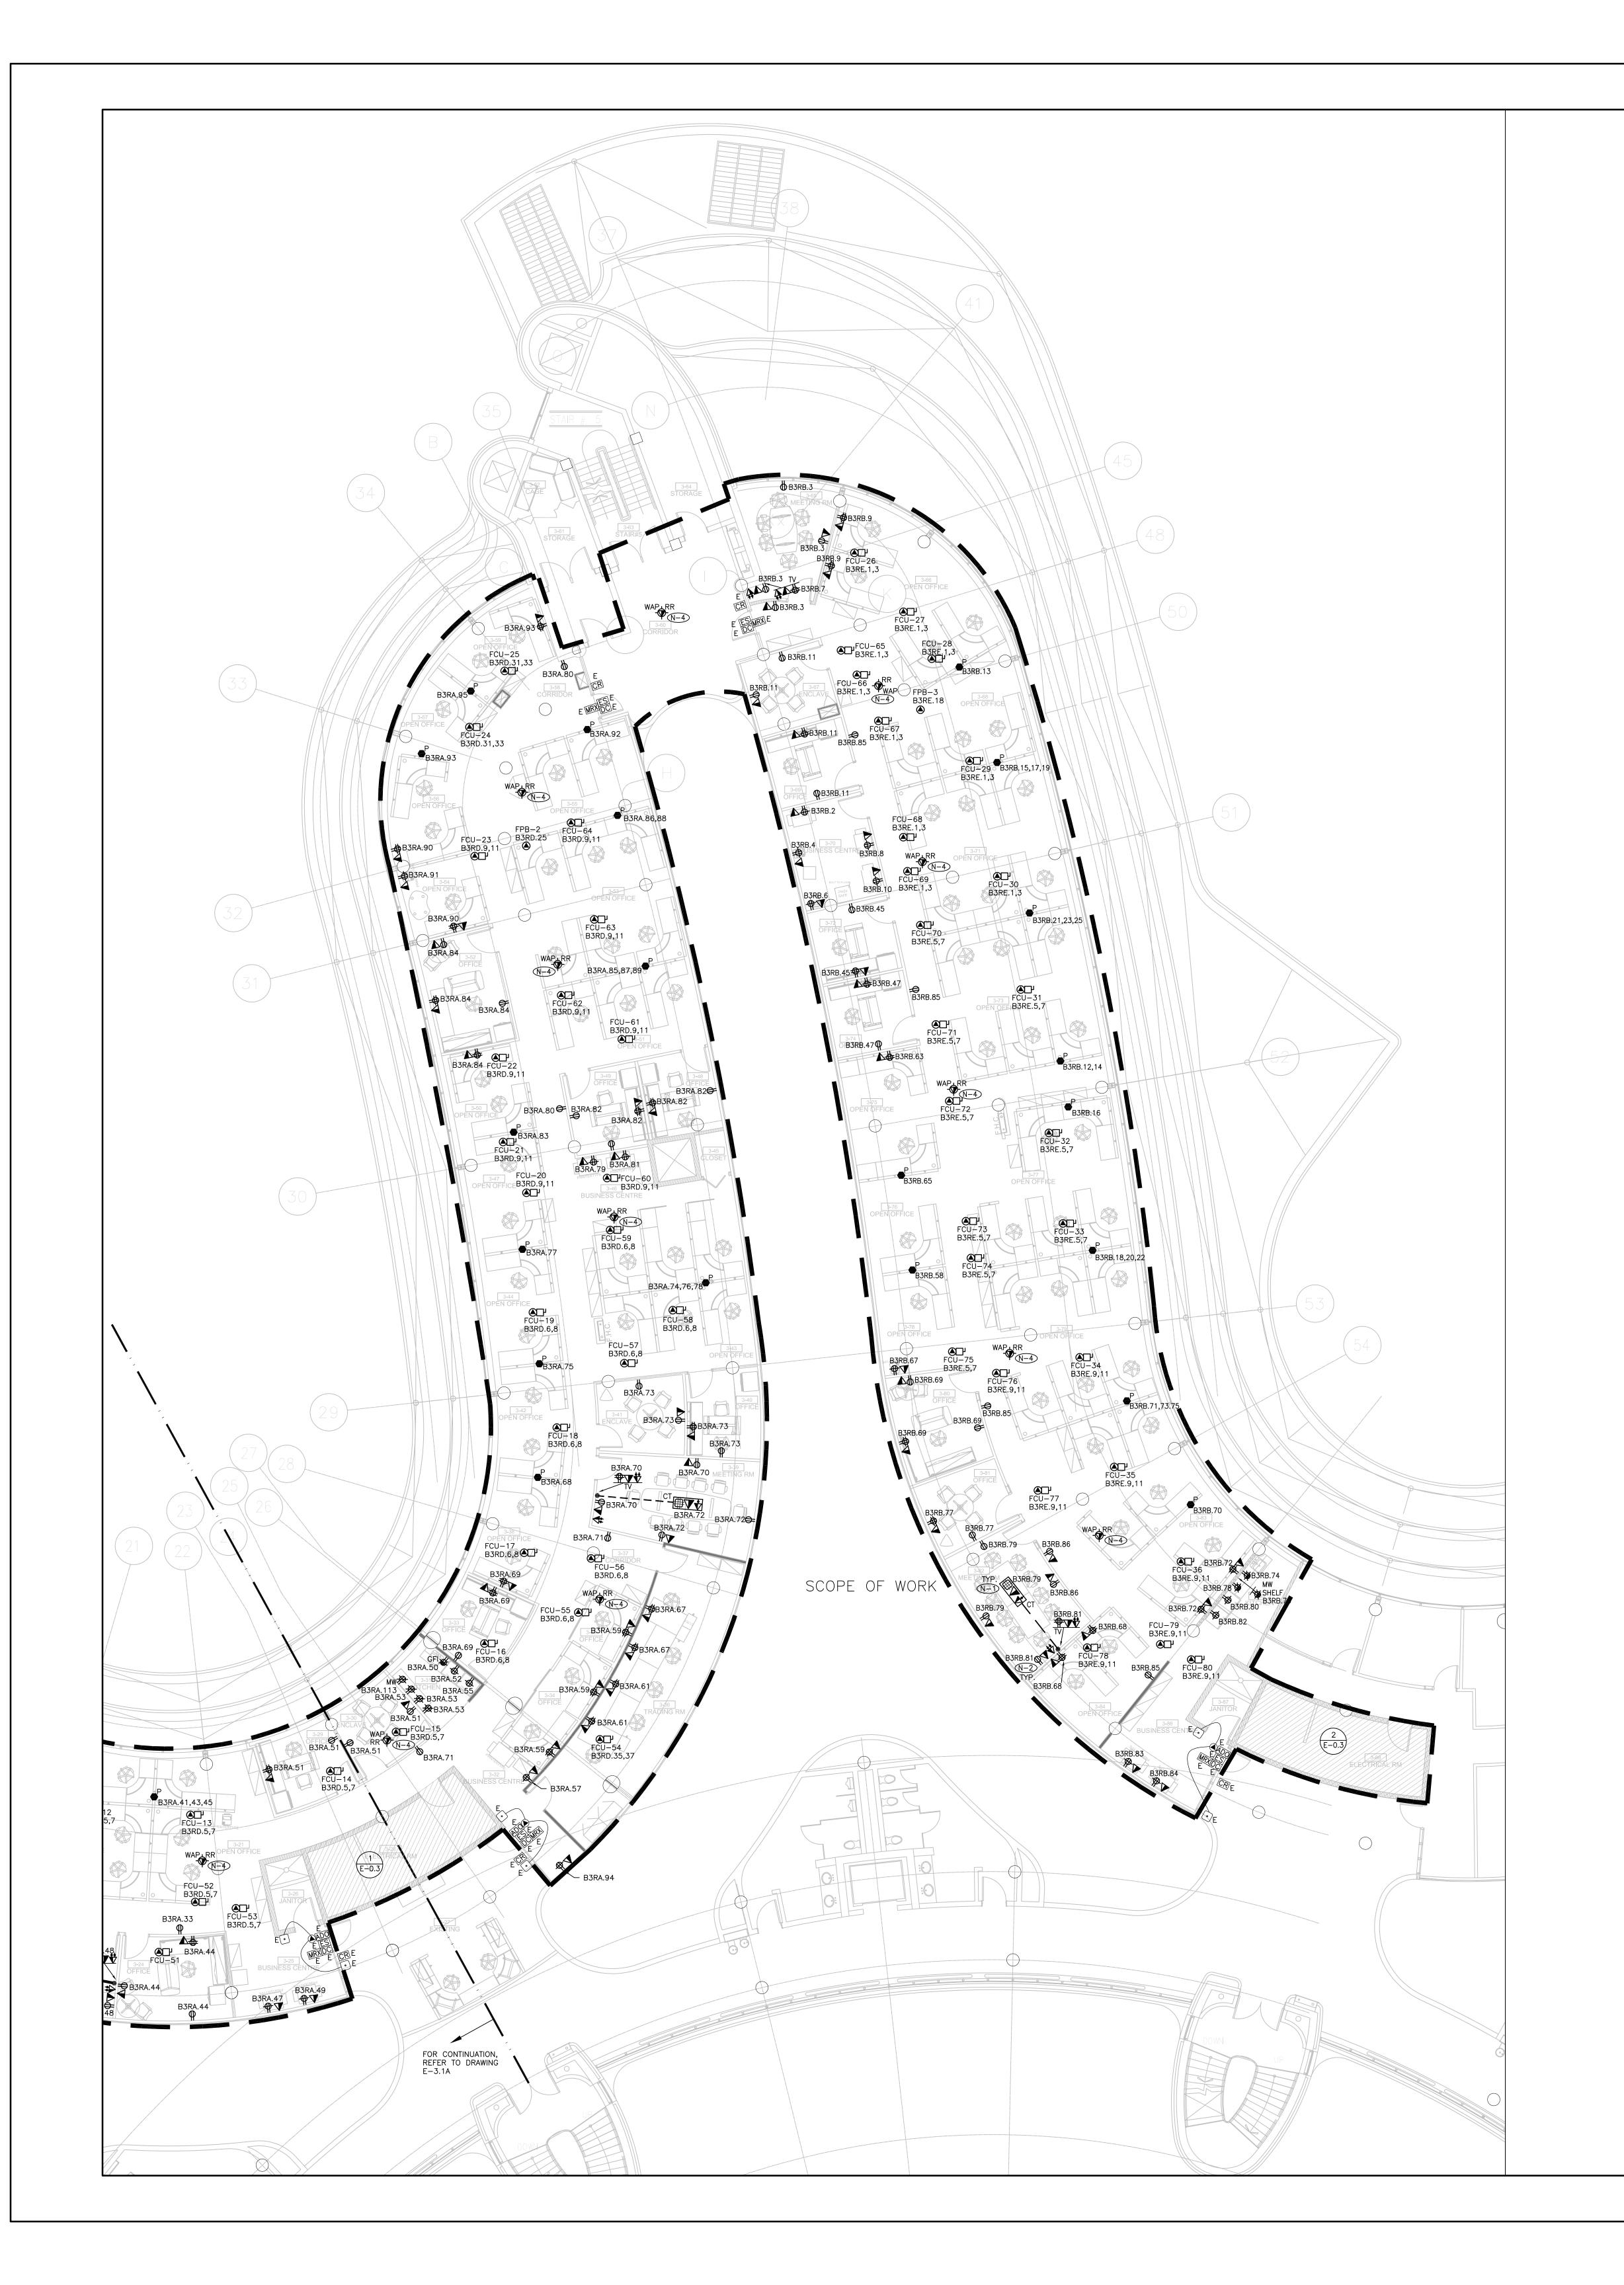

- THESE DRAWINGS SHALL BE READ IN CONJUNCTION WITH ARCHITECT'S DRAWINGS FOR DIMENSIONS, HEIGHTS, CONSTRUCTION DETAILING, FINISHES AND COLOURS.
   CIRCUITING IN PART IS DIAGRAMMATIC INTENDED TO SHOW GENERAL CIRCUIT ARRANGEMENT
- AND PANEL DESIGNATION.

  3. PROVIDE EMT CONDUIT IN AREAS WITH EXPOSED CEILINGS, BX CABLING IS NOT ACCEPTABLE UNLESS OTHERWISE NOTED. BX CABLES MAY BE USED FOR FINAL CONNECTIONS TO LIGHTING FIXTURES OR EQUIPMENT WITH A MAXIMUM HORIZONTAL RUN LENGTH OF 3 FEET / 1 METER. PAINT CONDUITS TO MATCH ARCHITECTURAL BACKGROUNDS. MOUNT EXIT SIGNS, OCCUPANCY SENSORS, EXIT SIGNS, CAMERAS, WAPS AND ALL OTHER CEILING MOUNTED DEVICES WITH STEMS SUCH THAT THEY ARE ON THE SAME PLANE AS SUSPENDED LIGHTING FIXTURES. COORDINATE CEILINGS AND WALL HEIGHTS WITH INTERIOR DESIGNER DRAWINGS.
- 4. REUSE CIRCUITS OBTAINED THROUGH DEMOLITION IS ACCEPTABLE.
- 5. CIRCUITS HAVE BEEN RE—ASSIGNED BASED ON AS BUILT DRAWINGS. VERIFY ACCURACY AND INFORM CONSULTANT OTHERWISE.6. VERIFY EXACT POWER REQUIREMENTS AND RECEPTACLE TYPES FOR SPECIAL EQUIPMENT WITH
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  7. REFER TO ARCHITECT'S DRAWINGS FOR THE COLOUR OF COVERPLATES AND MOUNTING
- 8. MARK UP OUTLET AND DEVICE LOCATIONS AND OBTAIN APPROVAL BY DESIGN CONSULTANT PRIOR TO INSTALLATION.
- 9. PROVIDE SUITABLE LABELS ON ALL RECEPTACLES, SYSTEM FURNITURE FEEDS, AND FAN COIL UNITS. LABELS TO INCLUDE BOTH PANEL AND CIRCUIT DESIGNATION. REVIEW LABEL SIZE AND TYPE WITH CONSULTANT PRIOR TO INSTALLATION.
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- CONFIRM ELECTRICAL REQUIREMENTS AND EXACT LOCATION OF ALL MECHANICAL EQUIPMENT WITH MECHANICAL DRAWINGS AND CONTRACTOR PRIOR TO ROUGH—INS.
   ROUTE ALL CONDUIT SYSTEMS AROUND DUCT WORK, BEAMS AND PIPING AS REQUIRED TO ACCOMMODATE LAYOUT SHOWN. REFER TO MECHANICAL DRAWINGS AND ARCHITECTURAL

# DRAWING NOTES:

DRAWINGS FOR ADDITIONAL DETAILS.

- THE <u>CONNECTRAC UNDER-CARPET RACEWAY SYSTEM</u> SHALL CONSIST OF TWO (2) DUPLEX RECEPTACLES, PROVISION FOR DATA AND HDMI CABLING AND OUTLETS. CONTRACTOR SHALL COORDINATE THE FINAL LOCATIONS OF CONNECTRAC FLOOR MONUMENT AND RACEWAY ROUTING WITH YORK REGION PRIOR TO INSTALLATION. (TYP.)
- MEETING ROOM TV WALL OUTLETS AT THE FLOOR LEVEL AND BEHIND THE TV SHALL BE ALIGNED VERTICALLY, COORDINATE MOUNTING HEIGHT AND LOCATION WITH YORK REGION PRIOR TO INSTALLATION. (TYP.)

### N-3 NOT USED.

N-4 EXISTING WIRELESS ACCESS POINT TO REMAIN. (EXISTING WAP LOCATIONS ON DRAWINGS ARE APPROXIMATE). LABEL AND MAP OUT EACH WAP EXACT LOCATION PRIOR TO REMOVAL THEN REMOVE AND REINSTALL WIRELESS ACCESS POINT AT THE SAME LOCATION AS REQUIRED.

### GENERAL NOTES:

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SUBMISSION	DATE	DESCRIPTION
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1	2020-03-18	ISSUED FOR 60% REVIEW

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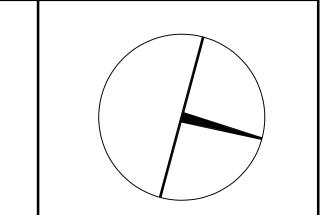
### PROJECT CONTACT

NAME: ANGELICA SABANDAL

TEL: 416-218-7021

EMAIL: angelica.sabandal@smithandandersen.cd

HIS DRAWING SHALL BE READ IN CONJUNCTION ITH ELECTRICAL SPECIFICATION SUBMITTED FOR HIS PROJECT.





# PROPERTY SERVICES

DEPARTMENT: BUILDING & FACILITIES

FLOOR: 003

BASE DATE: 03-01-2020

PROJECT:

# PROJECT # 14008.009

# YORK REGION

Administrative Centre 17250 Yonge Street Newmarket, Ontario

SCALE: 1:100

DRAWN BY: AS


SUBMITTED TO: MUNICIPALITY OF YORK

SHEET TITLE:

PARTIAL LEVEL 3 – POWER AND SYSTEMS LAYOUT (PART B)

SHEET NUMBER:

E-3.2B

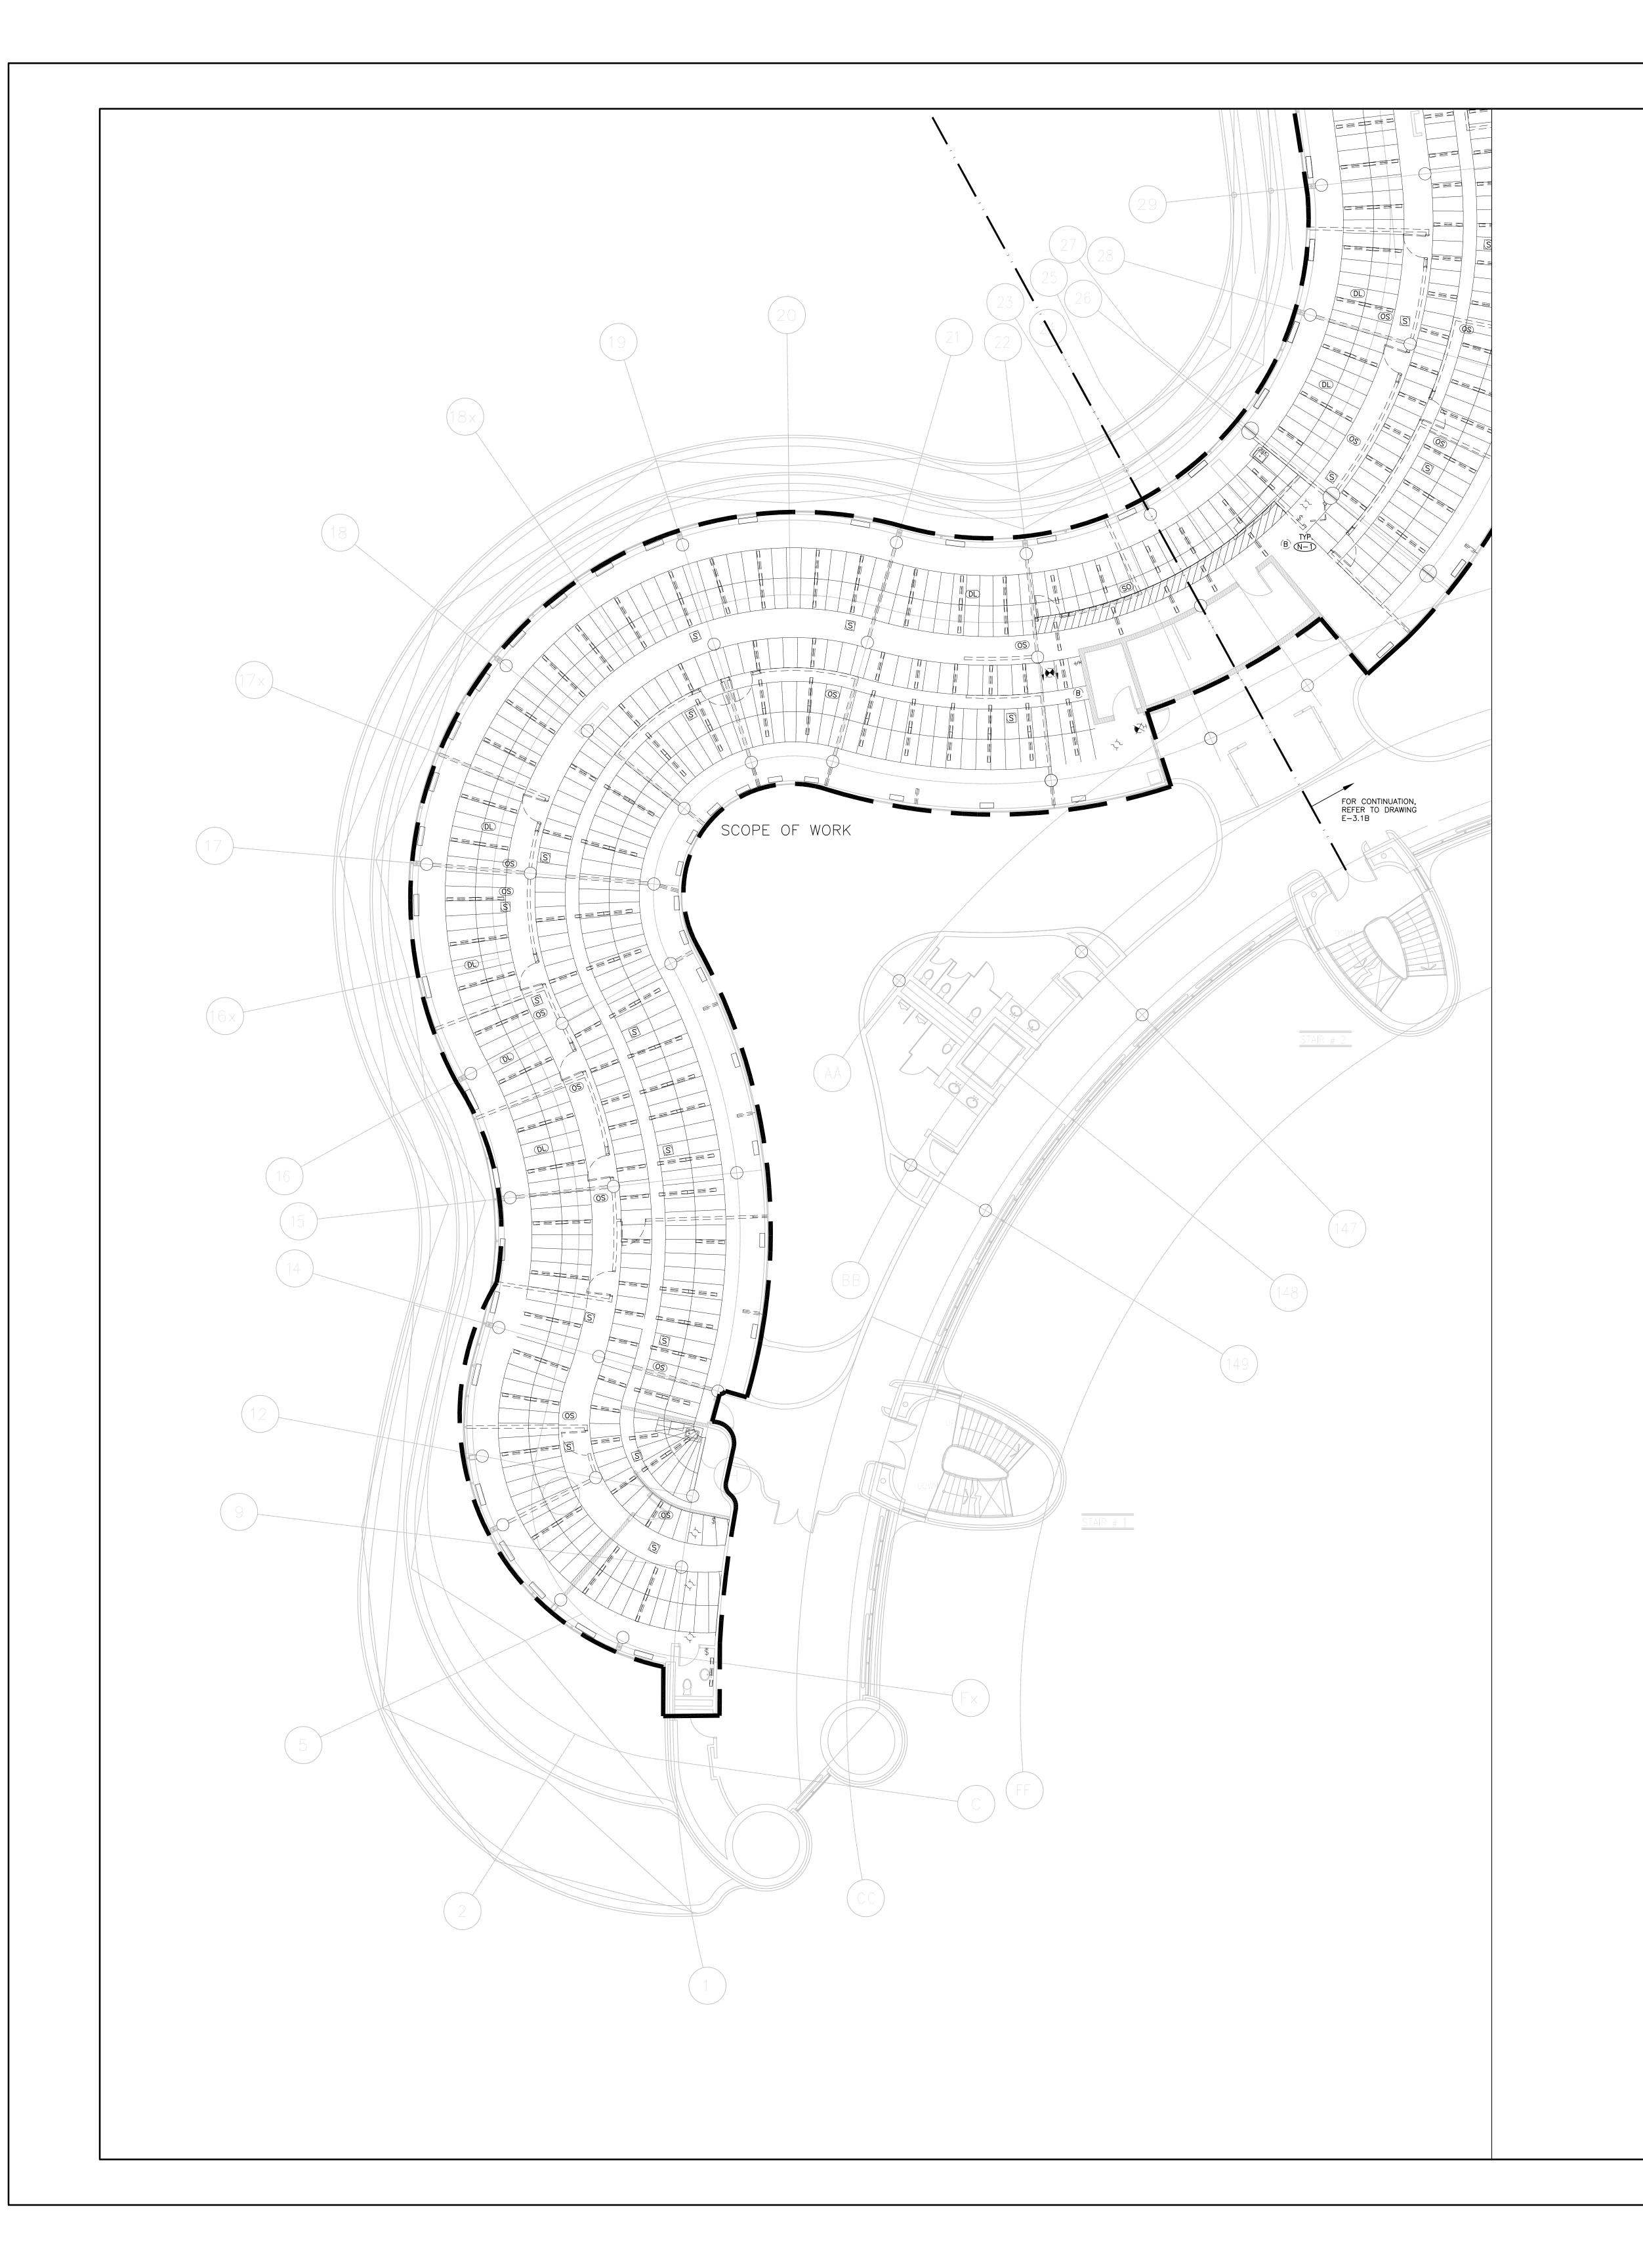

- REFER TO THE ARCHITECT'S DRAWINGS TO DETERMINE COMPLETE EXTENT OF DEMOLITION AND ALLOW FOR ALL COSTS. COMPLETE EXTENT OF DEMOLITION IS NOT SHOWN.
   REMOVE ALL LIGHTING EQUIPMENT, CABLING AND CONDUIT NOT REQUIRED, TO SUIT NEW LAYOUT AND MAKE SAFE. VISIT SITE TO DETERMINE EXACT REQUIREMENTS AND REFER TO DEMOLITION DRAWINGS.
- DEMOLITION DRAWINGS.

  3. HOUSING FOR DEMO'D LINEAR FIXTURES SHALL BE RE-USED FOR TYPE L1 LIGHTING.
  REFER TO DRAWINGS E-3.1A AND E-3.1B FOR NEW LOCATIONS.
- 4. REMOVE ALL ASSOCIATED CONDUIT(S) AND WIRE BACK TO SOURCE. MAKE GOOD ALL FLOOR PENETRATIONS TO COMPLY WITH CURRENT LOCAL APPLICABLE CODES.
- ENSURE THAT ALL EXISTING ELECTRICAL DEVICES, EQUIPMENT AND LIGHTING WITHIN BASE BUILDING ROOMS, STAIRWELLS AND AREAS DEEMED NOT IN SCOPE, REMAIN LIVE OPERATIONAL, ISOLATED AND PROTECTED DURING CONSTRUCTION.
   NO ADDITIONAL COST WILL BE APPROVED FOR ANY REVISIONS/MODIFICATIONS REQUIRED BY ANY TRADE OR CONTRACTOR DUE TO THE LACK OF COORDINATION BETWEEN TRADES AND
- 7. COORDINATE WITH GENERAL CONTRACTOR AND THE REGION FOR DISPOSAL OF ALL MATERIALS FROM SITE.
- DRAWING NOTES:
- N-1) COORDINATE WITH YORK REGION SECURITY REPRESENTATIVE FOR THE REMOVE OF EXISTING PANIC ALARM BLUE BEACONS. (TYP.)

### GENERAL NOTES:

- 1. CONTRACTOR MUST CHECK AND VERIFY ALL DIMENSIONS, DETAILS AND SPECIFICATIONS ON SITE AND REPORT ANY DISCREPANCIES IN WRITING TO YORK REGION REPRESENTATIVE BEFORE PROCEEDING WITH THE WORK
- 2. DRAWINGS ARE NOT TO BE SCALED
- 3. BEFORE PROCEEDING WITH THE WORK, CONTRACTOR MUST SUBMIT ALL NECESSARY SAMPLES AND SHOP DRAWINGS TO YORK REGION REPRESENTATIVE FOR APPROVAL
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Smith + Andersen


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# PROPERTY SERVICES

DEPARTMENT: BUILDING & FACILITIES

FLOOR: 003

BASE DATE: 03-01-2020

PROJECT:
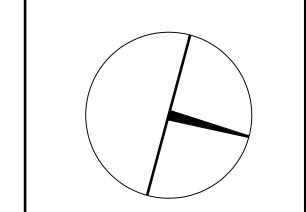
# PROJECT # 14008.009

# YORK REGION

Administrative Centre 17250 Yonge Street Newmarket, Ontario

SCALE: 1:100

DRAWN BY: AS


SUBMITTED TO: MUNICIPALITY OF YORK

SHEET TITLE:

PARTIAL LEVEL 3 – CEILING DEMOLITION LAYOUT (PART A)

SHEET NUMBER:

E-3.3A

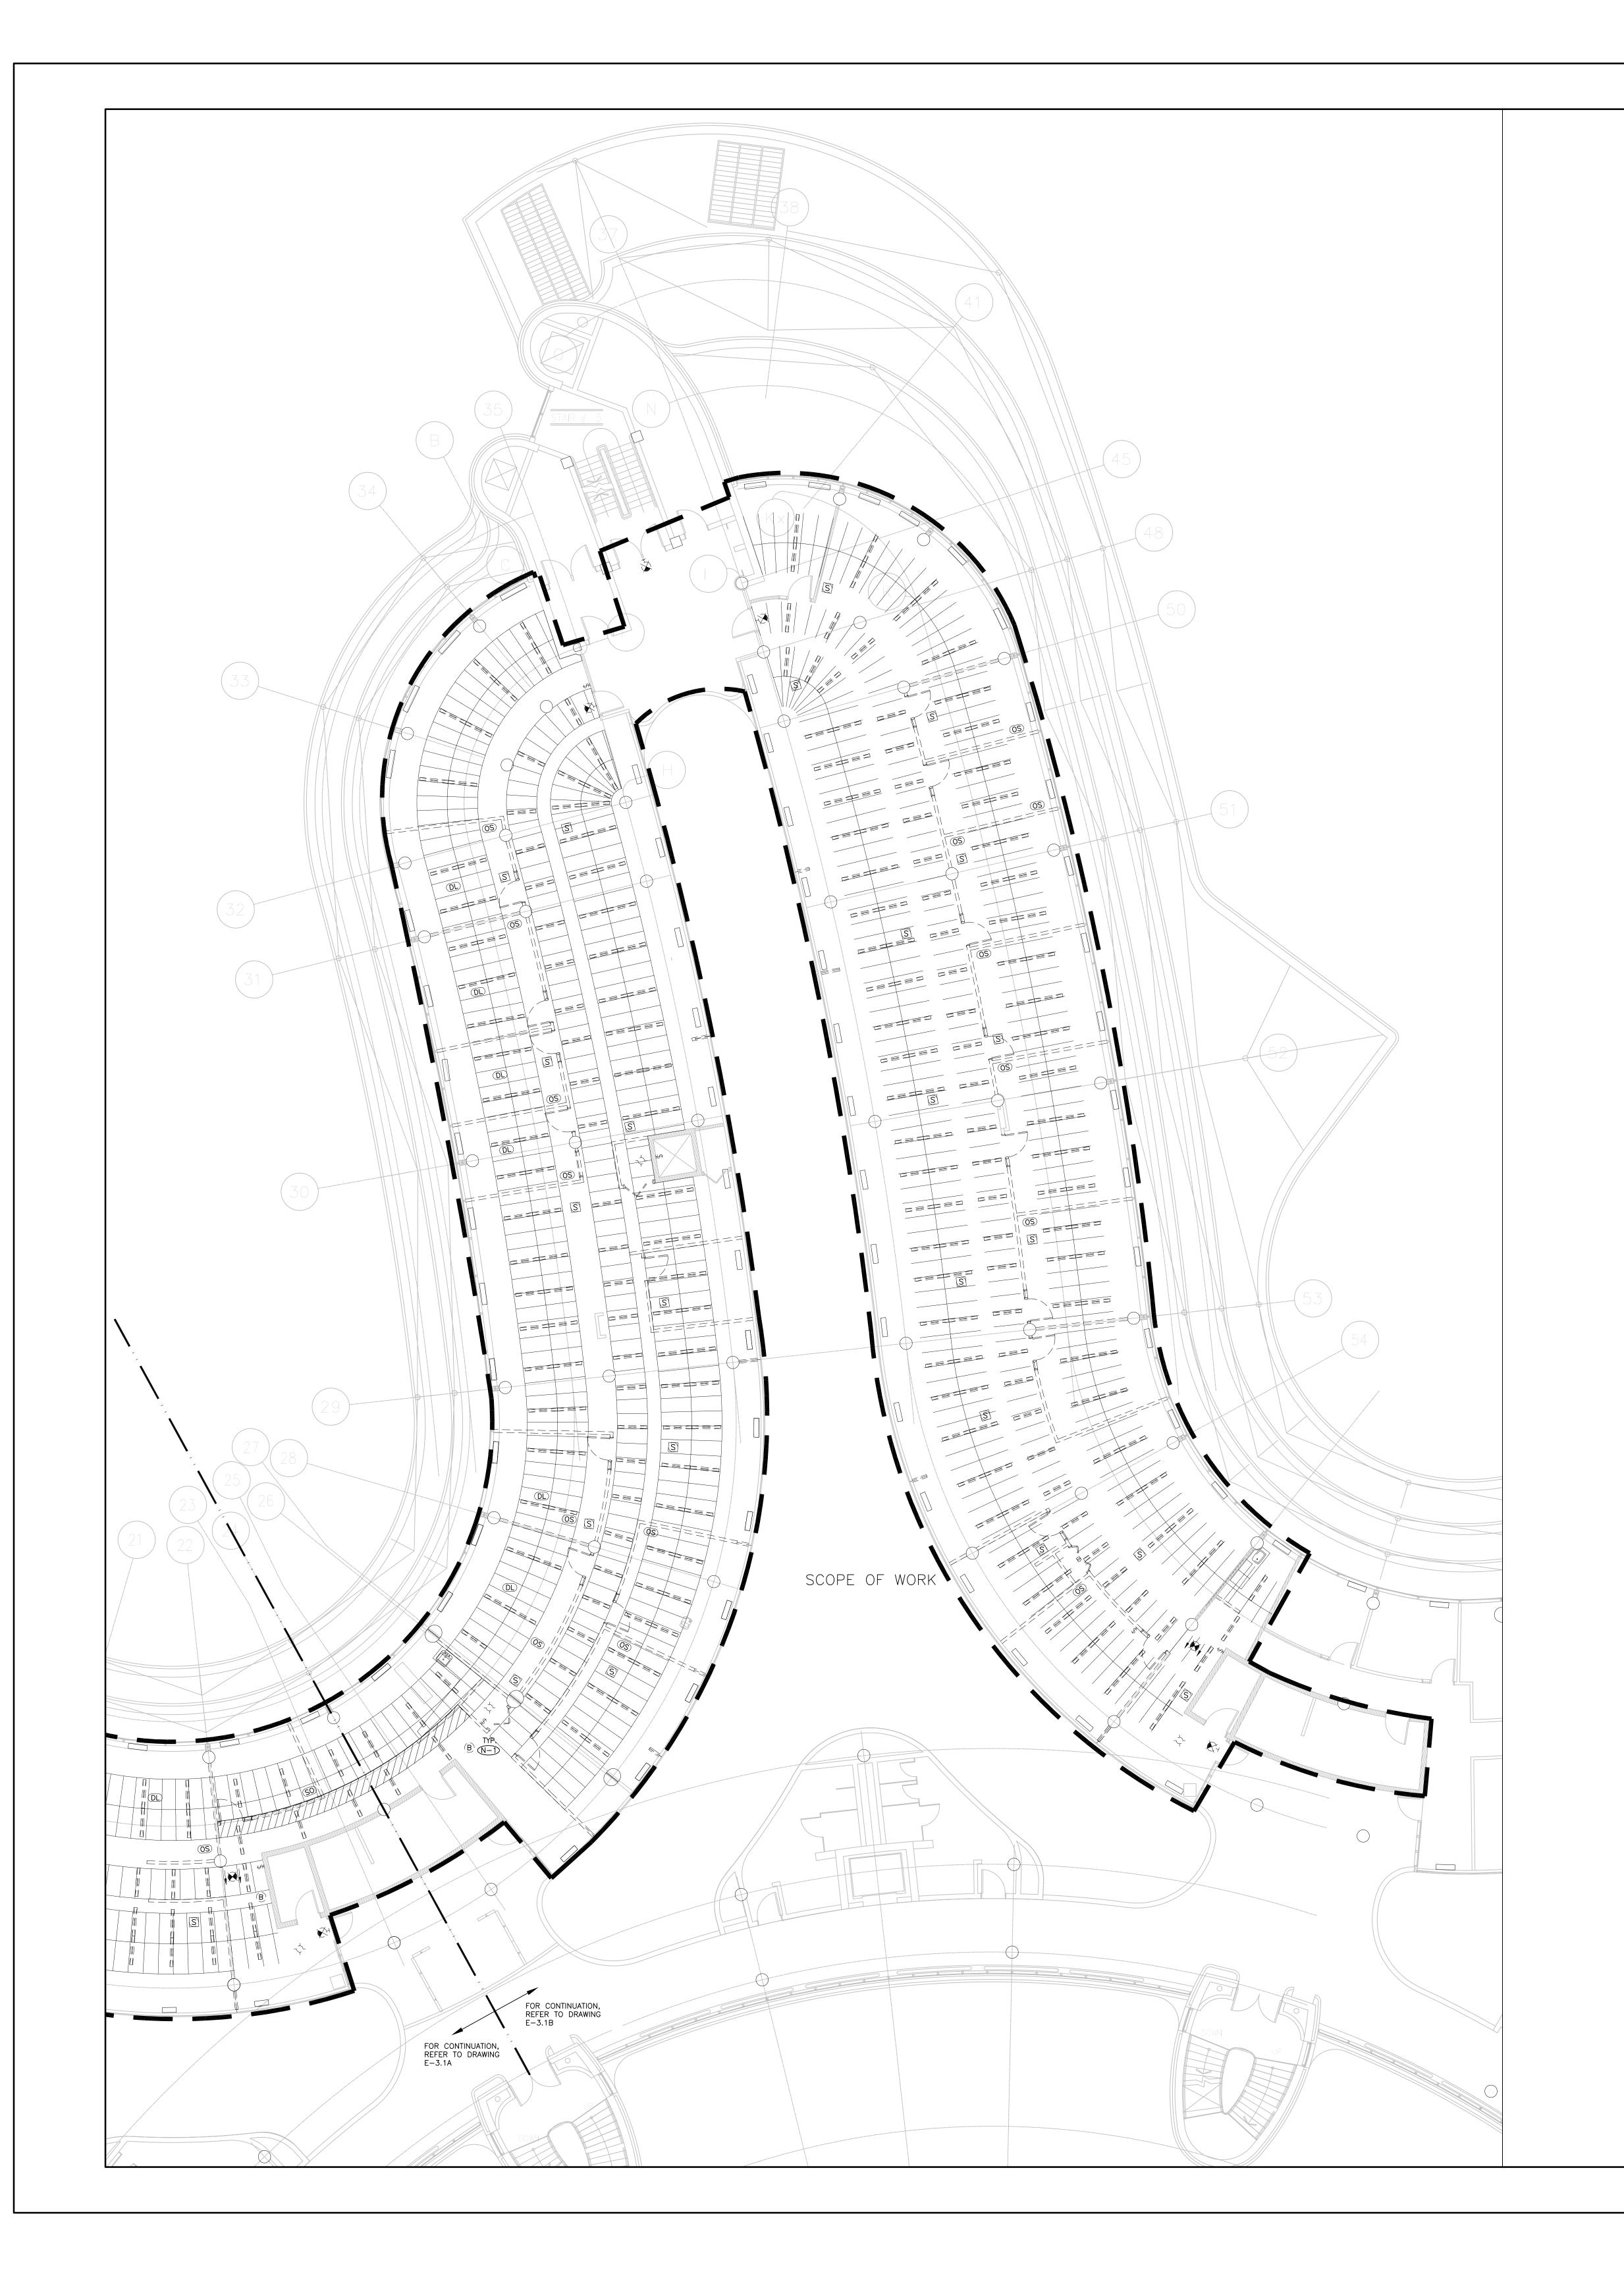

- REFER TO THE ARCHITECT'S DRAWINGS TO DETERMINE COMPLETE EXTENT OF DEMOLITION AND ALLOW FOR ALL COSTS. COMPLETE EXTENT OF DEMOLITION IS NOT SHOWN. REMOVE ALL LIGHTING EQUIPMENT, CABLING AND CONDUIT NOT REQUIRED, TO SUIT NEW LAYOUT AND MAKE SAFE. VISIT SITE TO DETERMINE EXACT REQUIREMENTS AND REFER TO DEMOLITION DRAWINGS.
- 3. HOUSING FOR DEMO'D LINEAR FIXTURES SHALL BE RE-USED FOR TYPE L1 LIGHTING. REFER TO DRAWINGS E-3.1A AND E-3.1B FOR NEW LOCATIONS. REMOVE ALL ASSOCIATED CONDUIT(S) AND WIRE BACK TO SOURCE. MAKE GOOD ALL FLOOR PENETRATIONS TO COMPLY WITH CURRENT LOCAL APPLICABLE CODES.
- 5. ENSURE THAT ALL EXISTING ELECTRICAL DEVICES, EQUIPMENT AND LIGHTING WITHIN BASE BUILDING ROOMS, STAIRWELLS AND AREAS DEEMED NOT IN SCOPE, REMAIN LIVE OPERATIONAL, ISOLATED AND PROTECTED DURING CONSTRUCTION.

6. NO ADDITIONAL COST WILL BE APPROVED FOR ANY REVISIONS/MODIFICATIONS REQUIRED BY

ANY TRADE OR CONTRACTOR DUE TO THE LACK OF COORDINATION BETWEEN TRADES AND

- COORDINATE WITH GENERAL CONTRACTOR AND THE REGION FOR DISPOSAL OF ALL MATERIALS FROM SITE.
- **DRAWING NOTES:**
- N-1) COORDINATE WITH YORK REGION SECURITY REPRESENTATIVE FOR THE REMOVE OF EXISTING PANIC ALARM BLUE BEACONS. (TYP.)

### GENERAL NOTES:

- CONTRACTOR MUST CHECK AND VERIFY ALL DIMENSIONS, DETAILS AND SPECIFICATIONS ON SITE AND REPORT ANY DISCREPANCIES IN WRITING TO YORK REGION REPRESENTATIVE BEFORE PROCEEDING WITH THE WORK
- 2. DRAWINGS ARE NOT TO BE SCALED
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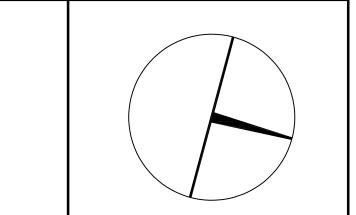
217 Richmond Street West, Suite 300 Toronto Ontario M5V 1W2 telephone: 416.351.8145 facsimile: 416.351.8146



Smith + Andersen

### PROJECT CONTACT

ME: ANGELICA SABANDAL IL: angelica.sabandal@smithandandersen.com





# PROPERTY SERVICES

**BUILDING & FACILITIES** 03-01-2020 BASE DATE:

PROJECT:

# PROJECT # 14008.009

# YORK REGION

Administrative Centre 17250 Yonge Street Newmarket, Ontario

SCALE: 1:100

DRAWN BY: AS

MUNICIPALITY OF YORK

SHEET TITLE:

PARTIAL LEVEL 3 -CEILING DEMOLITION LAYOUT (PART B)

SHEET NUMBER:

E-3.3B

# =====(1) ----SCOPE OF WORK

### GENERAL NOTES:

- REFER TO THE ARCHITECT'S DRAWINGS TO DETERMINE COMPLETE EXTENT OF DEMOLITION AND ALLOW FOR ALL COSTS. COMPLETE EXTENT OF DEMOLITION IS NOT SHOWN.

   REMOVE ALL FLOOR, COLUMN, CEILING, AND WALL MOUNTED POWER, TELEPHONE/DATA
- REMOVE ALL FLOOR, COLUMN, CEILING, AND WALL MOUNTED POWER, TELEPHONE/DATA OUTLETS, AND CONDUIT NOT REQUIRED, TO SUIT NEW LAYOUT AND MAKE SAFE. VISIT SITE TO DETERMINE EXACT REQUIREMENTS AND REFER TO DEMOLITION DRAWINGS.
   REMOVE ALL HORIZONTAL DATA/VOICE CABLING.
- EXISTING COMMUNICATION FIBRE CABLES AND COMMUNICATION MULTIPAIR COPPER CABLES TO REMAIN AS IS.
   MAKE GOOD ALL CORE HOLES FROM ELECTRICAL EQUIPMENT AND DEVICES DISCONNECTED, RELOCATED AND OR REMOVED IN THIS PROJECT.
- REMOVE FLOOR MONUMENT(S) AND ALL ASSOCIATED CONDUIT(S) AND WIRE BACK TO SOURCE. MAKE GOOD ALL FLOOR PENETRATIONS TO COMPLY WITH CURRENT LOCAL APPLICABLE CODES.
- ENSURE THAT ALL EXISTING ELECTRICAL DEVICES, EQUIPMENT AND LIGHTING WITHIN BASE BUILDING ROOMS, STAIRWELLS AND AREAS DEEMED NOT IN SCOPE, REMAIN LIVE OPERATIONAL, ISOLATED AND PROTECTED DURING CONSTRUCTION.
   NO ADDITIONAL COST WILL BE APPROVED FOR ANY REVISIONS/MODIFICATIONS REQUIRED BY ANY TRADE OR CONTRACTOR DUE TO THE LACK OF COORDINATION BETWEEN TRADES AND
- COORDINATE WITH GENERAL CONTRACTOR AND THE REGION FOR DISPOSAL OF ALL MATERIALS FROM SITE.

### GENERAL NOTES:

- CONTRACTOR MUST CHECK AND VERIFY ALL DIMENSIONS, DETAILS AND SPECIFICATIONS ON SITE AND REPORT ANY DISCREPANCIES IN WRITING TO YORK REGION
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+ Andersen


### PROJECT CONTACT

NAME: ANGELICA SABANDAL

TEL: 416-218-7021

EMAIL: angelica.sabandal@smithandandersen.com

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# PROPERTY SERVICES

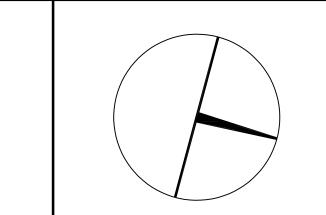DEPARTMENT: BUILDING & FACILITIES

FLOOR: 003

BASE DATE: 03-01-2020

PROJECT:

# PROJECT # 14008.009

# YORK REGION

Administrative Centre 17250 Yonge Street Newmarket, Ontario

SCALE: 1:100

DRAWN BY: AS


SUBMITTED TO: MUNICIPALITY OF YORK

SHEET TITLE:

PARTIAL LEVEL 3 – POWER DEMOLITION LAYOUT (PART A)

SHEET NUMBER:

E-3.4A

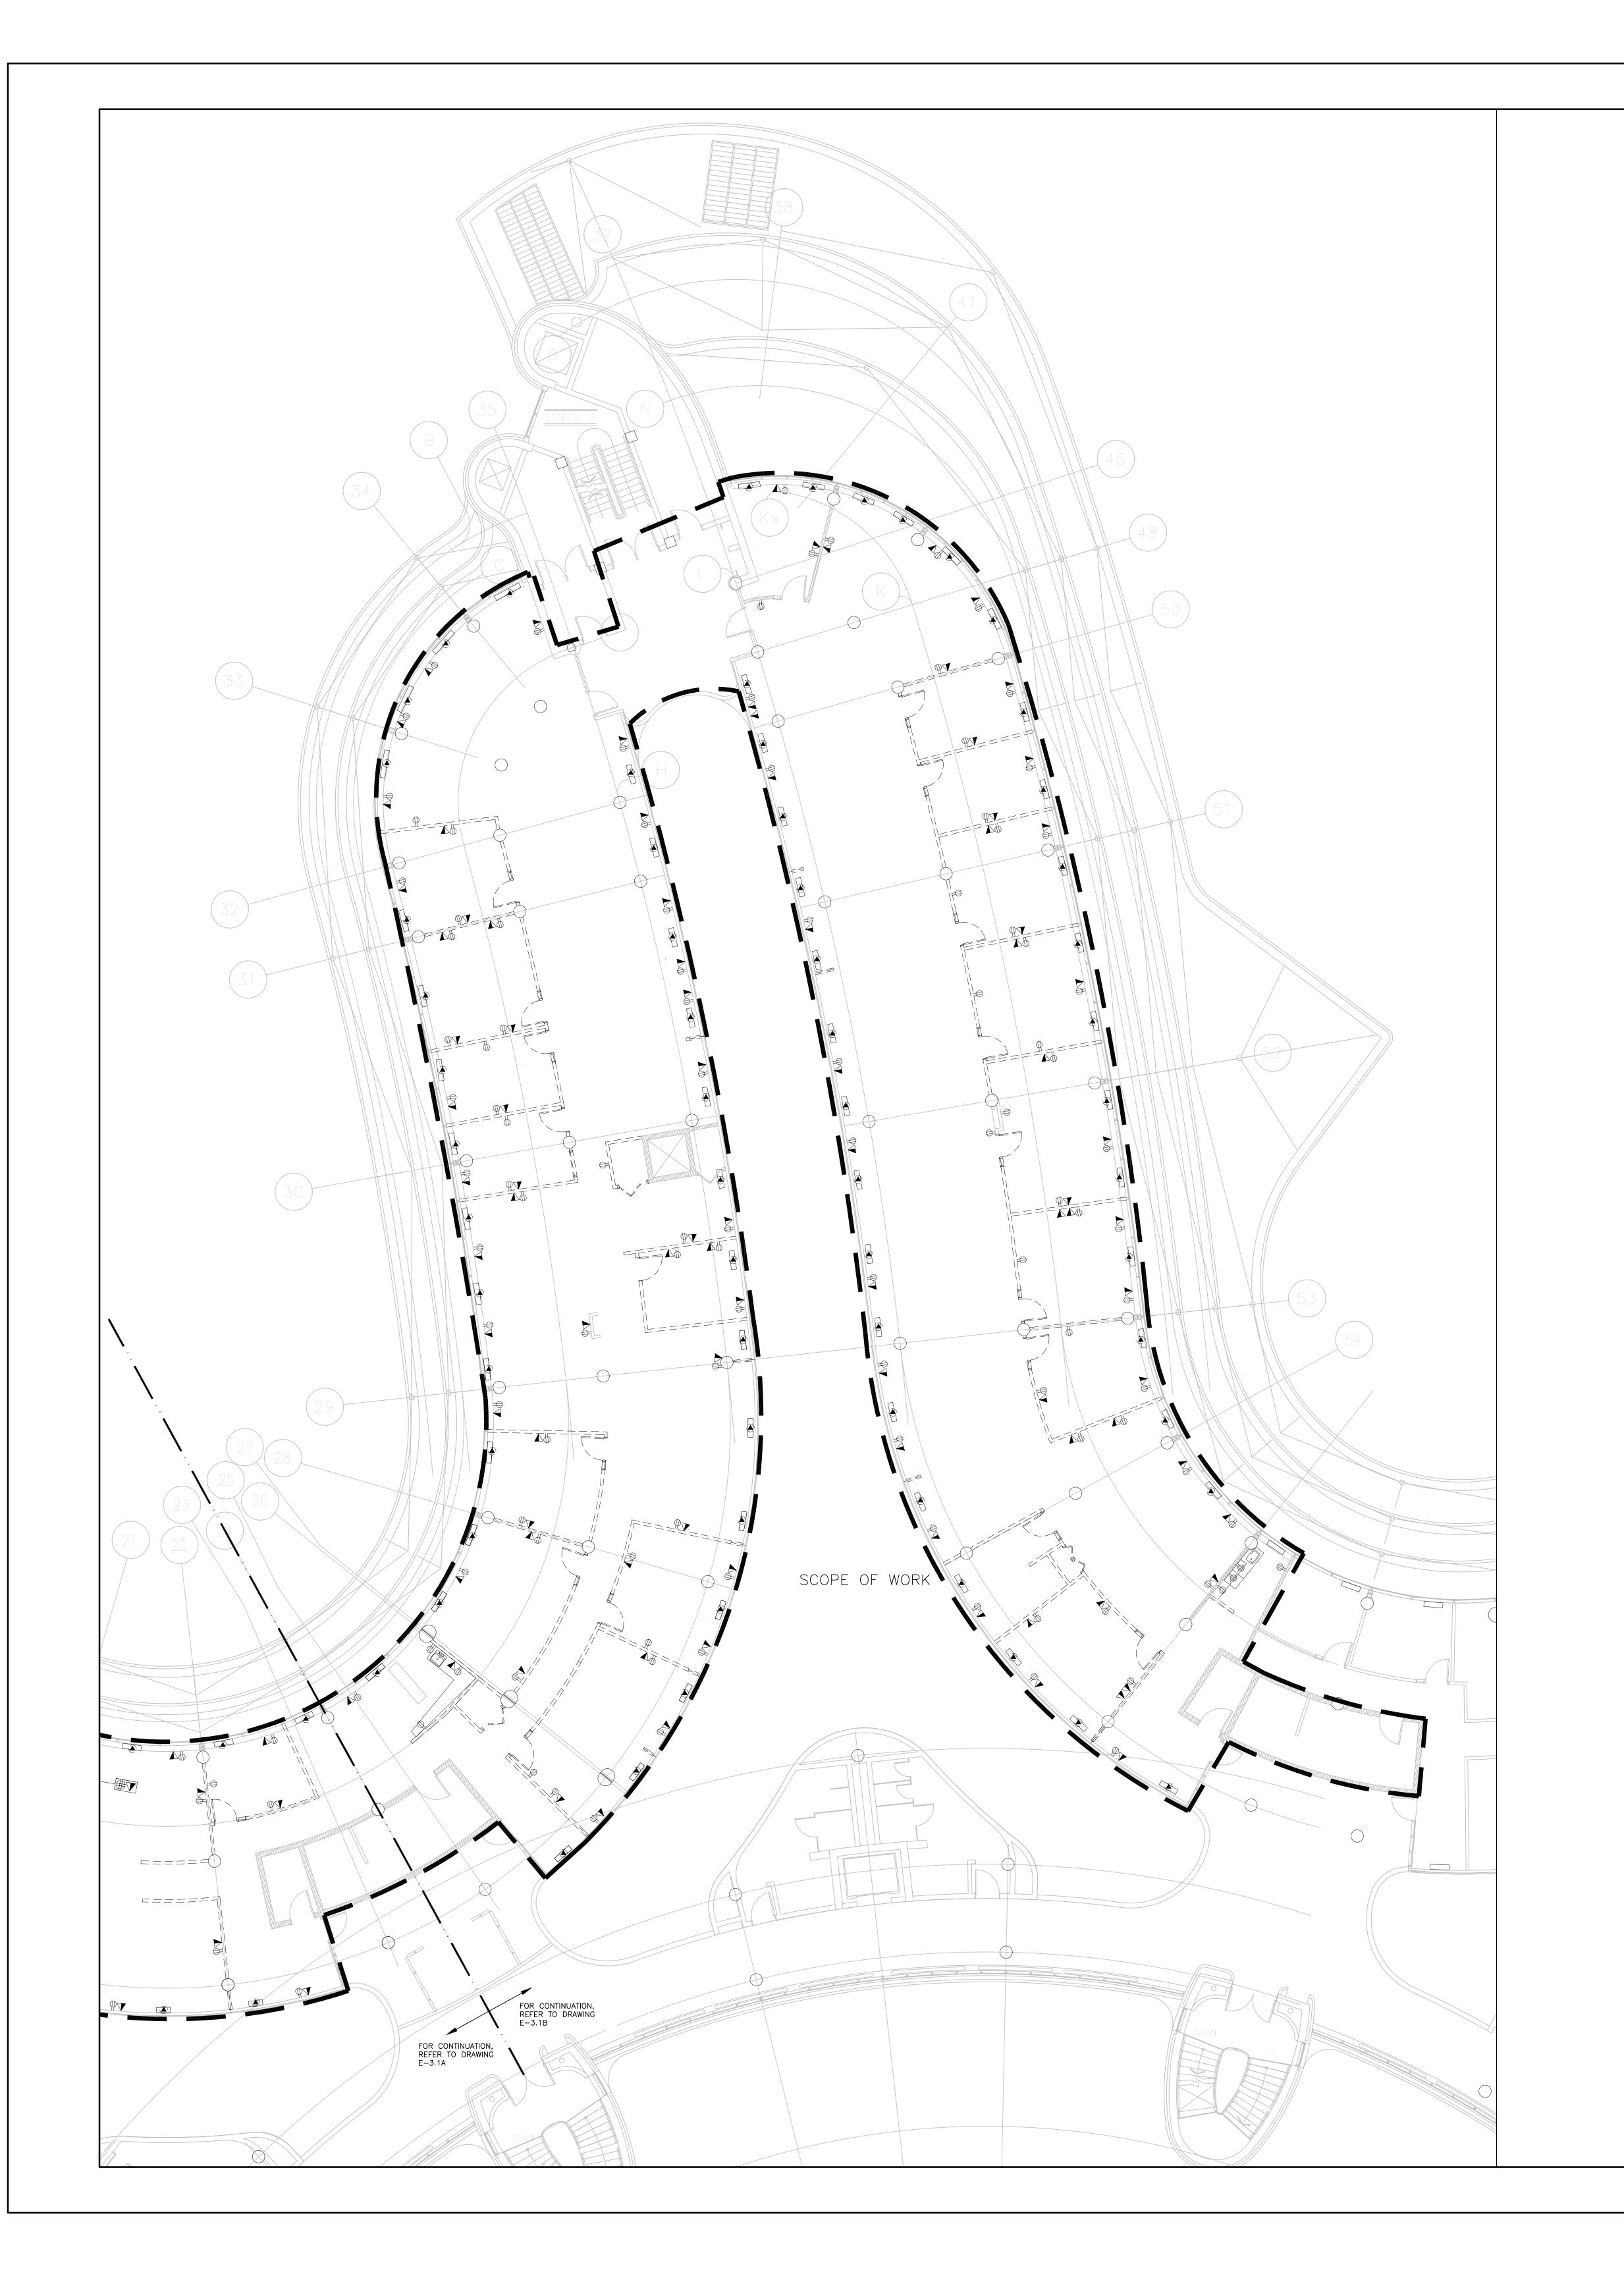

- REFER TO THE ARCHITECT'S DRAWINGS TO DETERMINE COMPLETE EXTENT OF DEMOLITION AND ALLOW FOR ALL COSTS. COMPLETE EXTENT OF DEMOLITION IS NOT SHOWN.

   REMOVE ALL FLOOR COLUMN CELLING AND WALL MOUNTED DOWER TELEPHONE (DATA).
- REMOVE ALL FLOOR, COLUMN, CEILING, AND WALL MOUNTED POWER, TELEPHONE/DATA OUTLETS, AND CONDUIT NOT REQUIRED, TO SUIT NEW LAYOUT AND MAKE SAFE. VISIT SITE TO DETERMINE EXACT REQUIREMENTS AND REFER TO DEMOLITION DRAWINGS.
   REMOVE ALL HORIZONTAL DATA/VOICE CABLING.
- EXISTING COMMUNICATION FIBRE CABLES AND COMMUNICATION MULTIPAIR COPPER CABLES TO REMAIN AS IS.
   MAKE GOOD ALL CORE HOLES FROM ELECTRICAL EQUIPMENT AND DEVICES DISCONNECTED, RELOCATED AND OR REMOVED IN THIS PROJECT.
- REMOVE FLOOR MONUMENT(S) AND ALL ASSOCIATED CONDUIT(S) AND WIRE BACK TO SOURCE. MAKE GOOD ALL FLOOR PENETRATIONS TO COMPLY WITH CURRENT LOCAL APPLICABLE CODES.
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1100 - 100 Sheppard Ave. East, Toronto On, M2N 6N
416 487 8151 f 416 487 9104 smithandandersen.com


### PROJECT CONTACT

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EMAIL: angelica.sabandal@smithandandersen.com

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# PROPERTY SERVICES

DEPARTMENT: BUILDING & FACILITIES

FLOOR: 003

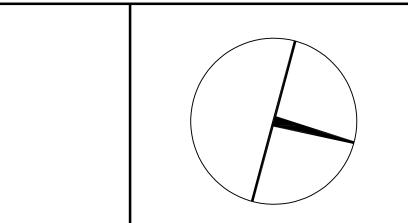BASE DATE: 03-01-2020

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Administrative Centre 17250 Yonge Street Newmarket, Ontario

SCALE: 1:100

DRAWN BY: AS

BMITTED TO: MUNICIPALITY OF YORK

SHEET TITLE:

PARTIAL LEVEL 3 – POWER DEMOLITION LAYOUT (PART B)

SHEET NUMBER:

E-3.4B



3 LEVEL 3 CEILING PLAN - W/R'S 3-88 & 3-89 E-3.5 SCALE: 1:50



2 LEVEL 3 CEILING PLAN - W/R'S 3-90 & 3-91 E-3.5 SCALE: 1:50



1 LEVEL 3 CEILING PLAN - W/R'S 3-92 & 3-93 E-3.5 SCALE: 1:50

- THESE DRAWINGS SHALL BE READ IN CONJUNCTION WITH ARCHITECT'S DRAWINGS FOR DIMENSIONS, HEIGHTS, CONSTRUCTION DETAILING, FINISHES AND COLOURS. CIRCUITING IN PART IS DIAGRAMMATIC INTENDED TO SHOW GENERAL CIRCUIT ARRANGEMENT AND PANEL DESIGNATION.
- 3. RE-USE CIRCUITS OBTAINED THROUGH DEMOLITION. 4. ALL NEW LED LUMINAIRES SHALL BE CHAIN HUNG AND SUPPORTED FROM THE SLAB ABOVE. PROVIDE LETTER TO BE INCLUDED AS PART OF CLOSE-OUT

RATED. PROVIDE LOCK-ON BREAKERS TO SUIT.

- DOCUMENT SUBMITTAL PACKAGE. 5. REWORK EXISTING EMERGENCY LIGHTING TO ACHIEVE NEW EMERGENCY LIGHTING AS SHOWN. CONNECT NEW AND/OR RELOCATED LUMINAIRES TO NEAREST EMERGENCY LIGHTING CIRCUITS ON THIS FLOOR. IF NEW EMERGENCY BRANCH CIRCUITS ARE REQUIRED FOR EMERGENCY LIGHTING AND EXISTING EMERGENCY LIGHTING PANEL IS LOCATED ON A DIFFERENT STOREY (i.e. NOT LOCATED ON SAME FLOOR), THEN NEW BRANCH CIRCUIT WIRING SHALL BE 2-HOUR FIRE RATED (i.e. MI CABLE) TO FIRST EMERGENCY LIGHT FED. IF EXISTING EMERGENCY LIGHTING PANEL IS LOCATED ON
- 6. MEASURE THE ILLUMINATION OF THE FLOOR AT NIGHT WITH EMERGENCY LIGHTING ON ONLY, AND SEND A DRAWING SHOWING THE MAXIMUM AND MINIMUM LEVEL OF ILLUMINATION, TO THE CONSULTING ENGINEER, FOR REVIEW. PROVIDE WRITTEN CONFIRMATION THAT EMERGENCY LIGHTING HAS BEEN INSTALLED IN ACCORDANCE WITH CONTRACT DOCUMENTS AND LATEST EDITION OF THE ONTARIO BUILDING CODE SECTIONS 3.2.7.4 LETTER TO BE INCLUDED AS PART OF CLOSE—OUT DOCUMENT SUBMITTAL PACKAGE.

THE SAME STOREY, THE NEW BRANCH CIRCUIT WIRING DOES NOT NEED TO BE FIRE

- 7. ALL MODIFICATIONS TO FIRE ALARM SYSTEM AND DEVICES TO BE COMPLETED BY BASE BUILDING FIRE ALARM CONTRACTOR AND VENDOR/MANUFACTURER. BASE BUILDING FIRE ALARM CONTRACTOR/VENDOR/MANUFACTURER IS RESPONSIBLE TO ENSURE THAT ALL ADDITIONAL COMPONENTS (MATERIAL, SOFTWARE, INCLUDING ANY LABOUR TO INSTALL OR MODIFY FIRE ALARM DEVICES) ARE INCLUDED FOR BASED ON ISSUED DRAWINGS. ELECTRICAL CONTRACTOR TO ALLOW FOR ALL ASSOCIATED COSTS. NEW FIRE ALARM SPEAKER/STROBES ARE TO MATCH EXISTING AND BE CONNECTED TO NEAREST AVAILABLE SPARE EMERGENCY ZONE CIRCUIT(S). CONNECT NEW SPEAKER/STROBES TO EXISTING CIRCUITS, WHERE THERE IS SPARE CAPACITY ON RESPECTIVE CIRCUITS. IF THERE IS NO CAPACITY ON EXISTING CIRCUITS, PROVIDE NEW FIRE ALARM CIRCUITS. ALLOW FOR ALL ASSOCIATED COSTS INCLUDING BUT NOT LIMITED TO; ASSOCIATED EQUIPMENT, DEVICES, PROGRAMMING, TESTING AND VERIFICATION TO MAKE SYSTEM OPERATIONAL AND CODE COMPLIANT. ALL FIRE ALARM VERIFICATION SHALL CONFORM TO CAN/ULC-S537 LATEST EDITION. FIRE ALARM SYSTEM SHALL BE INSTALLED IN CONFORMANCE WITH CAN/ULC-S524 LATEST EDITION. INCLUDE IN THE COST TO PROVIDE TWO (2) ADDITIONAL FIRE ALARM SPEAKERS AND ONE (1) ADDITIONAL AUDIBILITY VERIFICATION.
- 8. ENSURE THAT ALL LIGHTING FIXTURES ARE CLEAN AND ILLUMINATED BY END OF 9. REUSE EXISTING CIRCUIT FOUND IN CEILING SPACE FOR ALL NEW LIGHTING FIXTURES UNLESS OTHERWISE NOTED. CONTRACTOR TO PROVIDE ADDITIONAL
- CIRCUITS WHERE REQUIRED. NEW LOW VOLTAGE SWITCH ARRANGEMENT OF LIGHTING TO BE CO-ORDINATED WITH THE REGION AND REARRANGED TO SUIT NEW LAYOUT. ALL LIGHTING, EXCLUDING EMERGENCY, WITHIN THE TENANT PREMISES TO BE ON A SEPARATE LIGHTING ZONE AND TO BE CONTROLLED BY BASE BUILDING LIGHTING CONTROL SYSTEM. PROVIDE ALL NECESSARY RELAYS, CONTACTORS, RELAY PANELS, AND DRY INTERFACES REQUIRED FOR SUCH CONTROL. INCLUDE COST IN THIS
- 10. COORDINATE INSTALLATION OF FIXTURES WITH MECHANICAL EQUIPMENT, ELECTRICAL EQUIPMENT, SPRINKLERS AND DUCT WORK WITH OTHER TRADES PRIOR TO WORK COMMENCING.
- 11. ALL CEILING MOUNTED OCCUPANCY SENSORS PROVIDED AS PART OF THIS SCOPE OF WORK MUST BE LOCATED AT LEAST 6'0" AWAY FROM ANY SUPPLY AIR DIFFUSER AND RETURN AIR GRILLE AS PER MANUFACTURER'S RECOMMENDATION. COORDINATE INSTALLATION ON SITE WITH MECHANICAL CONTRACTOR PRIOR TO COMMENCING WORK.

### **DRAWING NOTES:** ONE (1) SECTION OF TYPE 'L3' LED COVE LIGHT TO RUN ABOVE AND BEHIND THE MIRROR,

- AND ONE (1) SECTION TO RUN BELOW AND BEHIND MIRROR FOR ACCENT LIGHTING. (TYP.)
- N-2) PROVIDE ONE (1) 250VA, 347V-120V, 1¢ STEP DOWN TRANSFORMER INSTALLED IN THE CEILING SPACE FOR ALL THE TYPE 'L3' LED STRIP LIGHT (COVE AND MIRROR) 120V REMOTE DRIVER IN EACH WASHROOM. COORDINATE EXACT TRANSFORMER MOUNTING LOCATION ON SITE. (TYP.)
- N-3 RE-USE CIRCUITS OBTAINED THROUGH DEMOLITION WHERE POSSIBLE. CIRCUITING SHOWN ON THE PLAN ARE FOR REFERENCE ONLY. INCLUDE IN THE COST TO UTILIZE TWIN BREAKERS WHERE NECESSARY DUE TO LIMITED BRANCH SPACE AVAILABLE ON THE EXISTING PANEL.

### GENERAL NOTES:

- 1. CONTRACTOR MUST CHECK AND VERIFY ALL DIMENSIONS, DETAILS AND SPECIFICATIONS ON SITE AND REPORT ANY DISCREPANCIES IN WRITING TO YORK REGION REPRESENTATIVE BEFORE PROCEEDING WITH THE WORK
- 2. DRAWINGS ARE NOT TO BE SCALED
- 3. BEFORE PROCEEDING WITH THE WORK, CONTRACTOR MUST SUBMIT ALL NECESSARY SAMPLES AND SHOP DRAWINGS TO YORK REGION REPRESENTATIVE FOR APPROVAL
- 4. ALL DRAWINGS AND SPECIFICATIONS ARE THE PROPERTY OF YORK REGION. AS SUCH, THEY ARE NOT INTENDED FOR USE ON OTHER PROJECTS OR EXTENSIONS OF THE PROJECT SPECIFIED

SUBMISSION	DATE	DESCRIPTION
6	2021-03-19	ISSUED FOR CONSTRUCTION
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2	2020-05-18	ISSUED FOR 90% REVIEW
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## G.Bruce Stratton Architects

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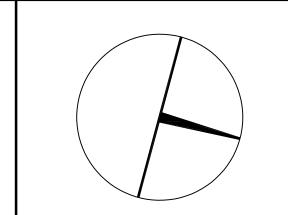


Smith + Andersen 1100 - 100 Sheppard Ave. East, Toronto On, M2N 6N5 416 487 8151 f 416 487 9104 smithandandersen.com

### PROJECT CONTACT

_{IE:} ANGELICA SABANDAL 416-218-7021 IL: angelica.sabandal@smithandandersen.com

THIS DRAWING SHALL BE READ IN CONJUNCTION WITH ELECTRICAL SPECIFICATION SUBMITTED FO THIS PROJECT.





# PROPERTY SERVICES

DEPARTMENT:	BUILDING & FACILITIES
FLOOR:	003
BASE DATE:	03-01-2020

PROJECT:

# PROJECT # 14008.009

# YORK REGION

Administrative Centre 17250 Yonge Street Newmarket, Ontario

SCALE: AS SHOWN


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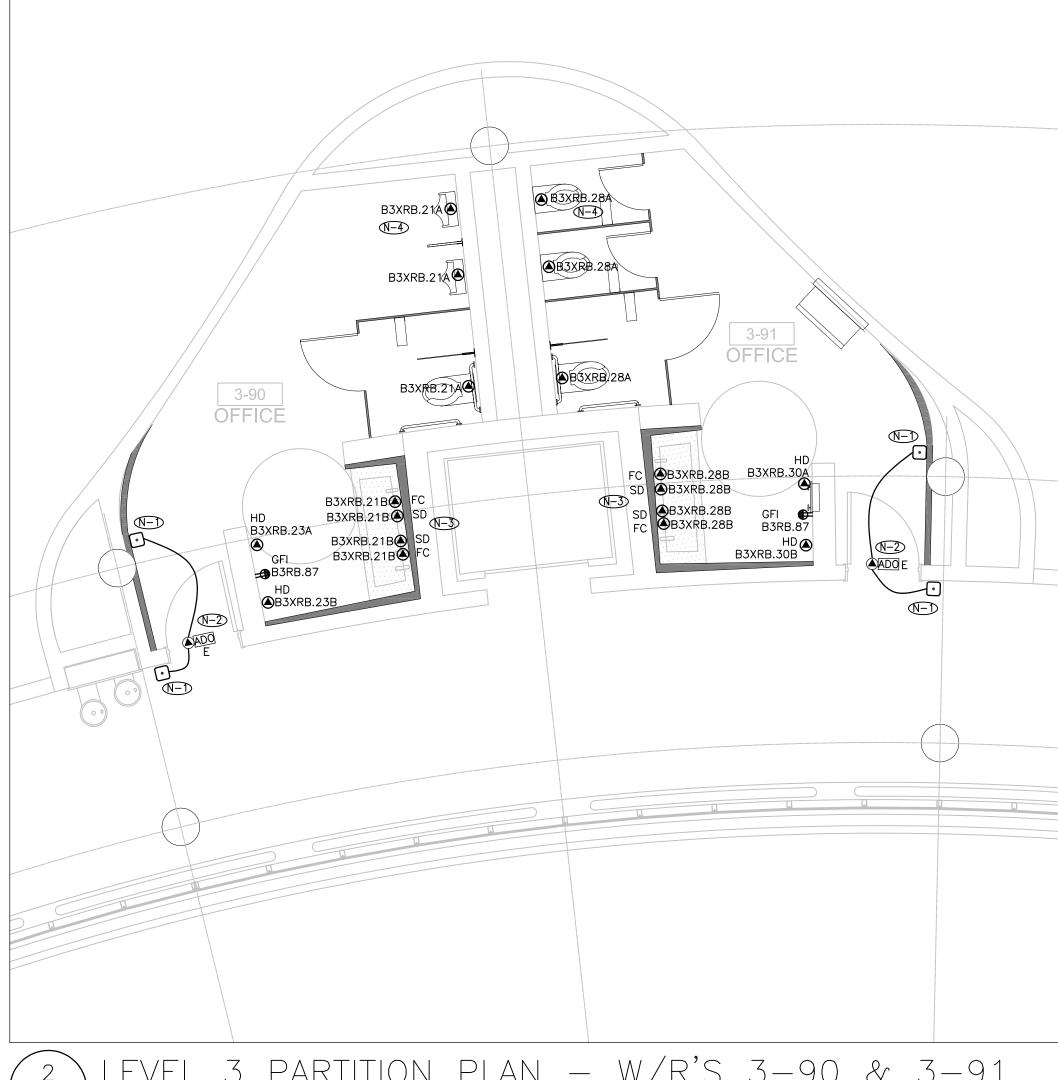
SHEET TITLE:

LEVEL 3 WASHROOMS -LIGHTING AND FIRE ALARM LAYOUT

SHEET NUMBER:



LEVEL 3 PARTITION PLAN – W/R'S 3-88 & 3-89E-3.6 SCALE: 1:50

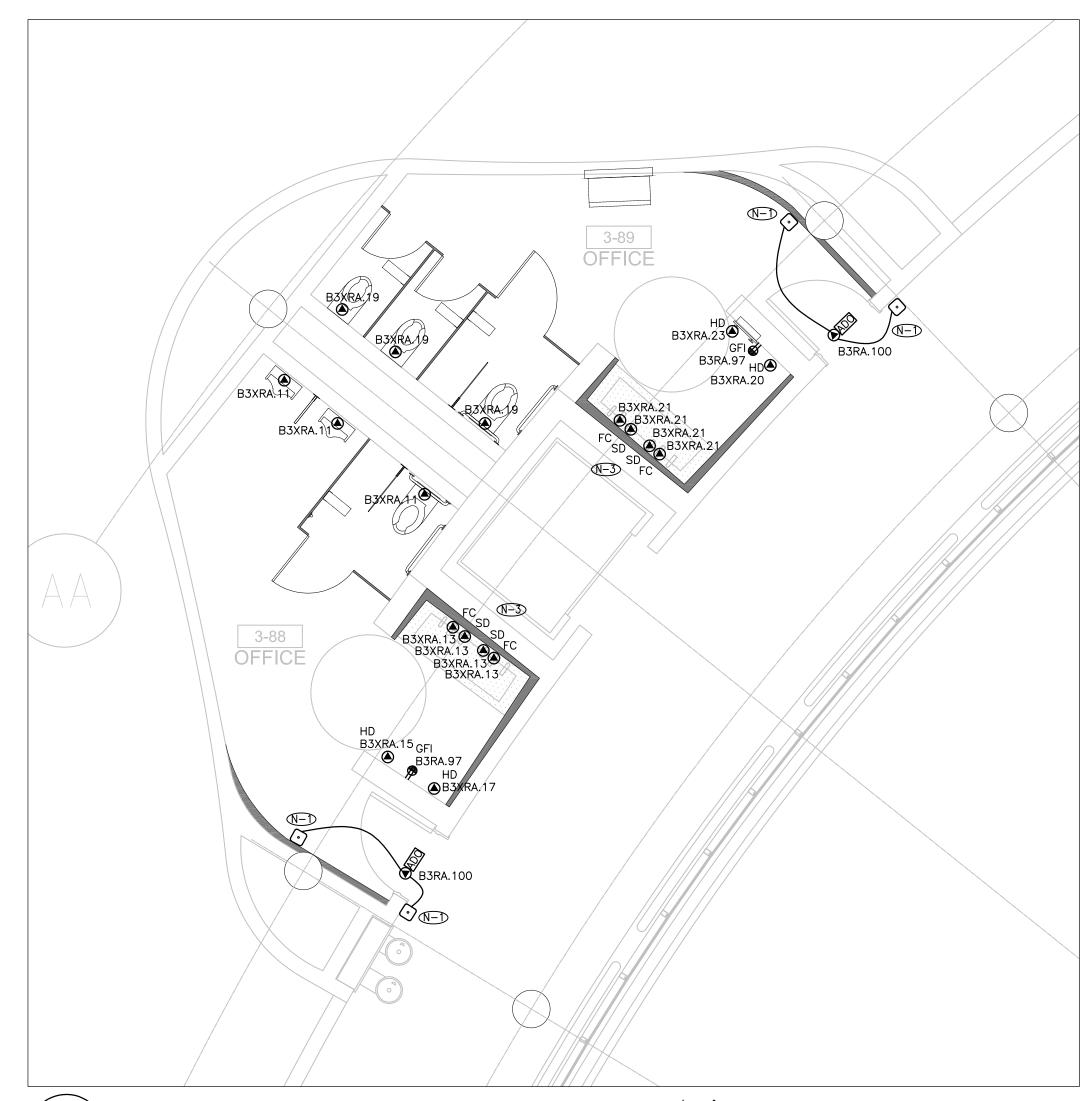

2 LEVEL 3 PARTITION PLAN - W/R'S 3-90 & 3-91 SCALE: 1:50



LEVEL 3 PARTITION PLAN – W/R'S 3-92 & 3-93 SCALE: 1:50

- THESE DRAWINGS SHALL BE READ IN CONJUNCTION WITH ARCHITECT'S DRAWINGS FOR DIMENSIONS, HEIGHTS, CONSTRUCTION DETAILING, FINISHES AND COLOURS.
   CIRCUITING IN PART IS DIAGRAMMATIC INTENDED TO SHOW GENERAL CIRCUIT ARRANGEMENT AND PANEL DESIGNATION.
- 3. REUSE CIRCUITS OBTAINED THROUGH DEMOLITION IS ACCEPTABLE.
- REFER TO ARCHITECT'S DRAWINGS FOR THE COLOUR OF COVERPLATES AND MOUNTING
- HEIGHTS.

  5. MARK UP OUTLET AND DEVICE LOCATIONS AND OBTAIN APPROVAL BY DESIGN CONSULTANT
- PRIOR TO INSTALLATION.
- PROVIDE SUITABLE LABELS ON ALL RECEPTACLES AND SYSTEM FURNITURE FEEDS. LABELS TO INCLUDE BOTH PANEL AND CIRCUIT DESIGNATION. REVIEW LABEL SIZE AND TYPE WITH CONSULTANT PRIOR TO INSTALLATION.
- TRACE ALL EXISTING OUTLETS, NOTED AS EXISTING, AND IDENTIFY ON AS BUILT DRAWING AS PER SPECIFICATION.
   CONFIRM ELECTRICAL REQUIREMENTS AND EXACT LOCATION OF ALL MECHANICAL EQUIPMENT WITH MECHANICAL DRAWINGS AND CONTRACTOR PRIOR TO ROUGH—INS.
- ROUTE ALL CONDUIT SYSTEMS AROUND DUCT WORK, BEAMS AND PIPING AS REQUIRED TO ACCOMMODATE LAYOUT SHOWN. REFER TO MECHANICAL DRAWINGS AND ARCHITECTURAL DRAWINGS FOR ADDITIONAL DETAILS.
- PROVIDE FIRE STOPPING AS REQUIRED. PROVIDE PULL STRINGS IN ALL EMPTY CONDUIT. COORDINATE ROUTING AND TERMINATION POINTS OF ALL CONDUITS WITH GENERAL CONTRACTOR.
- DRAWING NOTES:

  PROVIDE NEW CAMDEN TOUCHLESS AUTOMATIC DOOR OPERATOR. COORDINATE INSTALLATION WITH THE DRYWALL CONTRACTOR ON SITE. (TYP.)
- RECONNECT NEW TOUCHLESS AUTOMATIC DOOR OPERATOR TO THE EXISTING AUTOMATIC DOOR OPERATOR TO ENSURE FULL FUNCTIONALITY.
- VERIFY EXACT POWER REQUIREMENTS AND RECEPTACLE TYPES FOR SPECIAL EQUIPMENT WITH MANUFACTURER PRIOR TO INSTALLATION. PROVIDE HARDWIRE CONNECTIONS FOR AUTOMATIC WATER FAUCET 'FC', SOAP DISPENSER 'SD', AND HAND DRYER 'HD', ETC. IN LIEU OF RECEPTACLES OR VICE VERSA, AS REQUIRED.
- PROVIDE TANDEM BREAKERS FOR CIRCUITS SHOWN AS A/B. (TYP.)

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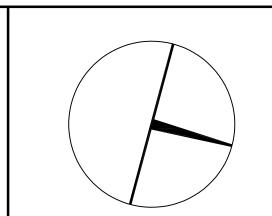
### PROJECT CONTACT

NAME: ANGELICA SABANDAL

TEL: 416-218-7021

EMAIL: angelica.sabandal@smithandandersen.com

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# PROPERTY SERVICES

DEPARTMENT: BUILDING & FACILITIES

FLOOR: 003

BASE DATE: 03-01-2020

PROJECT:

# PROJECT # 14008.009

# YORK REGION

Administrative Centre 17250 Yonge Street Newmarket, Ontario

SCALE: AS SHOWN


DRAWN BY: AS

SUBMITTED TO: MUNICIPALITY OF YORK

SHEET TITLE:

LEVEL 3 WASHROOMS POWER AND SYSTEMS
LAYOUT

SHEET NUMBER:

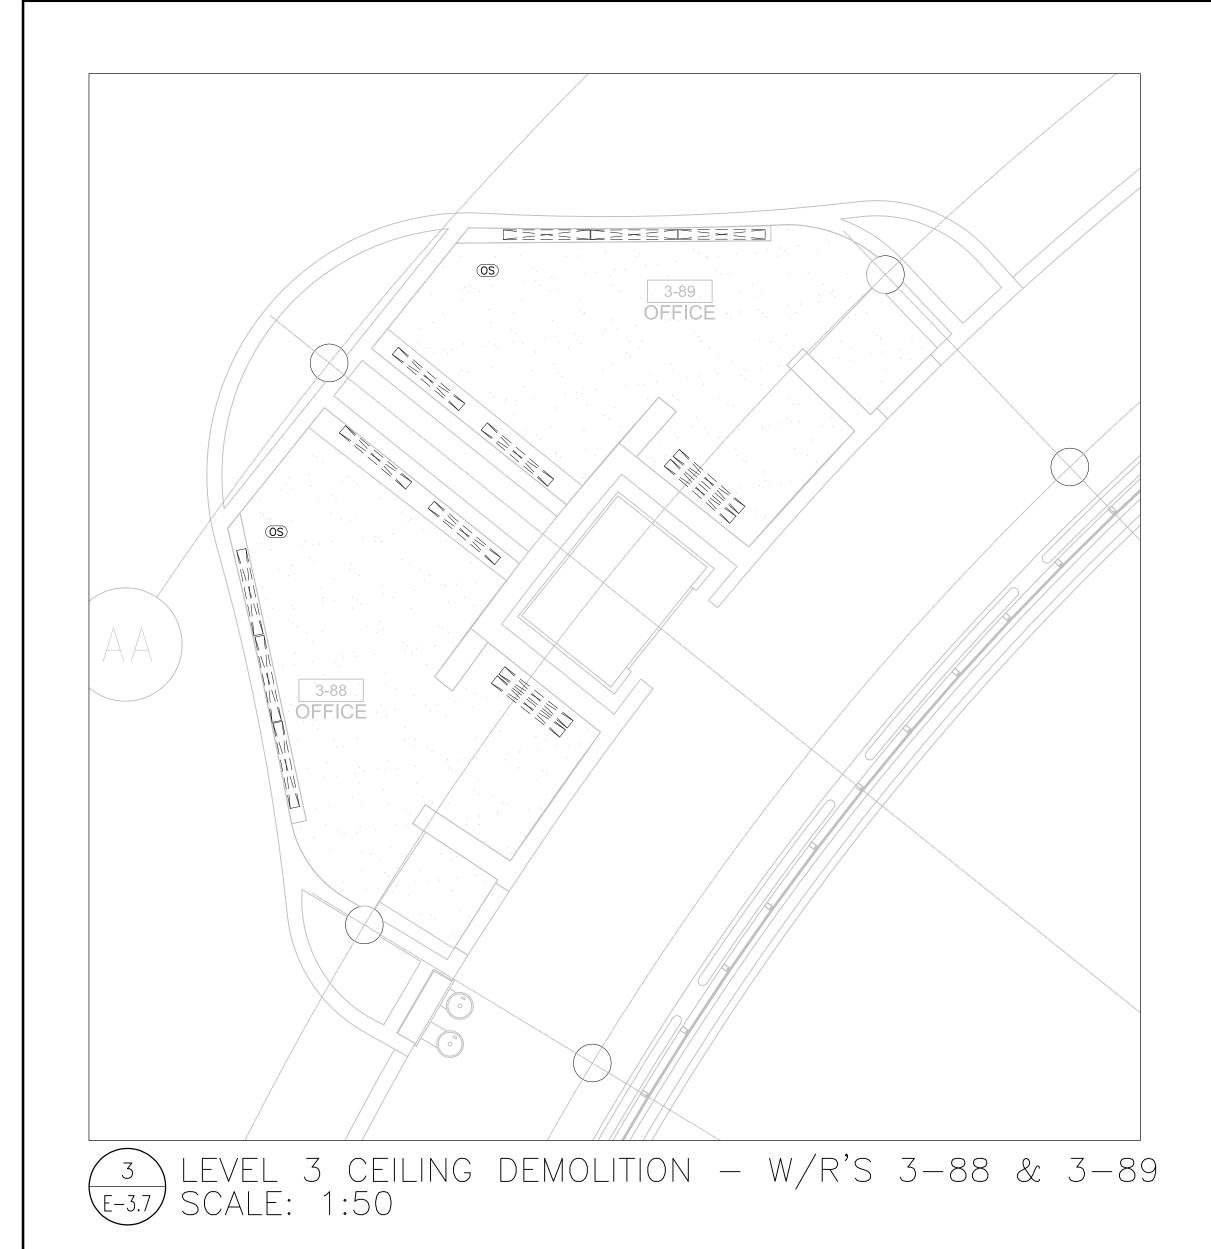





- REFER TO THE ARCHITECT'S DRAWINGS TO DETERMINE COMPLETE EXTENT OF DEMOLITION AND ALLOW FOR ALL COSTS. COMPLETE EXTENT OF DEMOLITION IS NOT SHOWN.

   REMOVE ALL LIGHTING EQUIPMENT, CABLING AND CONDUIT NOT REQUIRED, TO SUIT NEW
- REMOVE ALL LIGHTING EQUIPMENT, CABLING AND CONDUIT NOT REQUIRED, TO SUIT NEW LAYOUT AND MAKE SAFE. VISIT SITE TO DETERMINE EXACT REQUIREMENTS AND REFER TO DEMOLITION DRAWINGS.
- 3. ENSURE THAT ALL EXISTING ELECTRICAL DEVICES, EQUIPMENT AND LIGHTING WITHIN BASE BUILDING ROOMS, STAIRWELLS AND AREAS DEEMED NOT IN SCOPE, REMAIN LIVE OPERATIONAL, ISOLATED AND PROTECTED DURING CONSTRUCTION.
- 5. COORDINATE WITH GENERAL CONTRACTOR AND THE REGION FOR DISPOSAL OF ALL MATERIALS FROM SITE.

4. NO ADDITIONAL COST WILL BE APPROVED FOR ANY REVISIONS/MODIFICATIONS REQUIRED BY ANY TRADE OR CONTRACTOR DUE TO THE LACK OF COORDINATION BETWEEN TRADES AND

### GENERAL NOTES:

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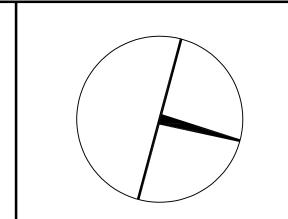
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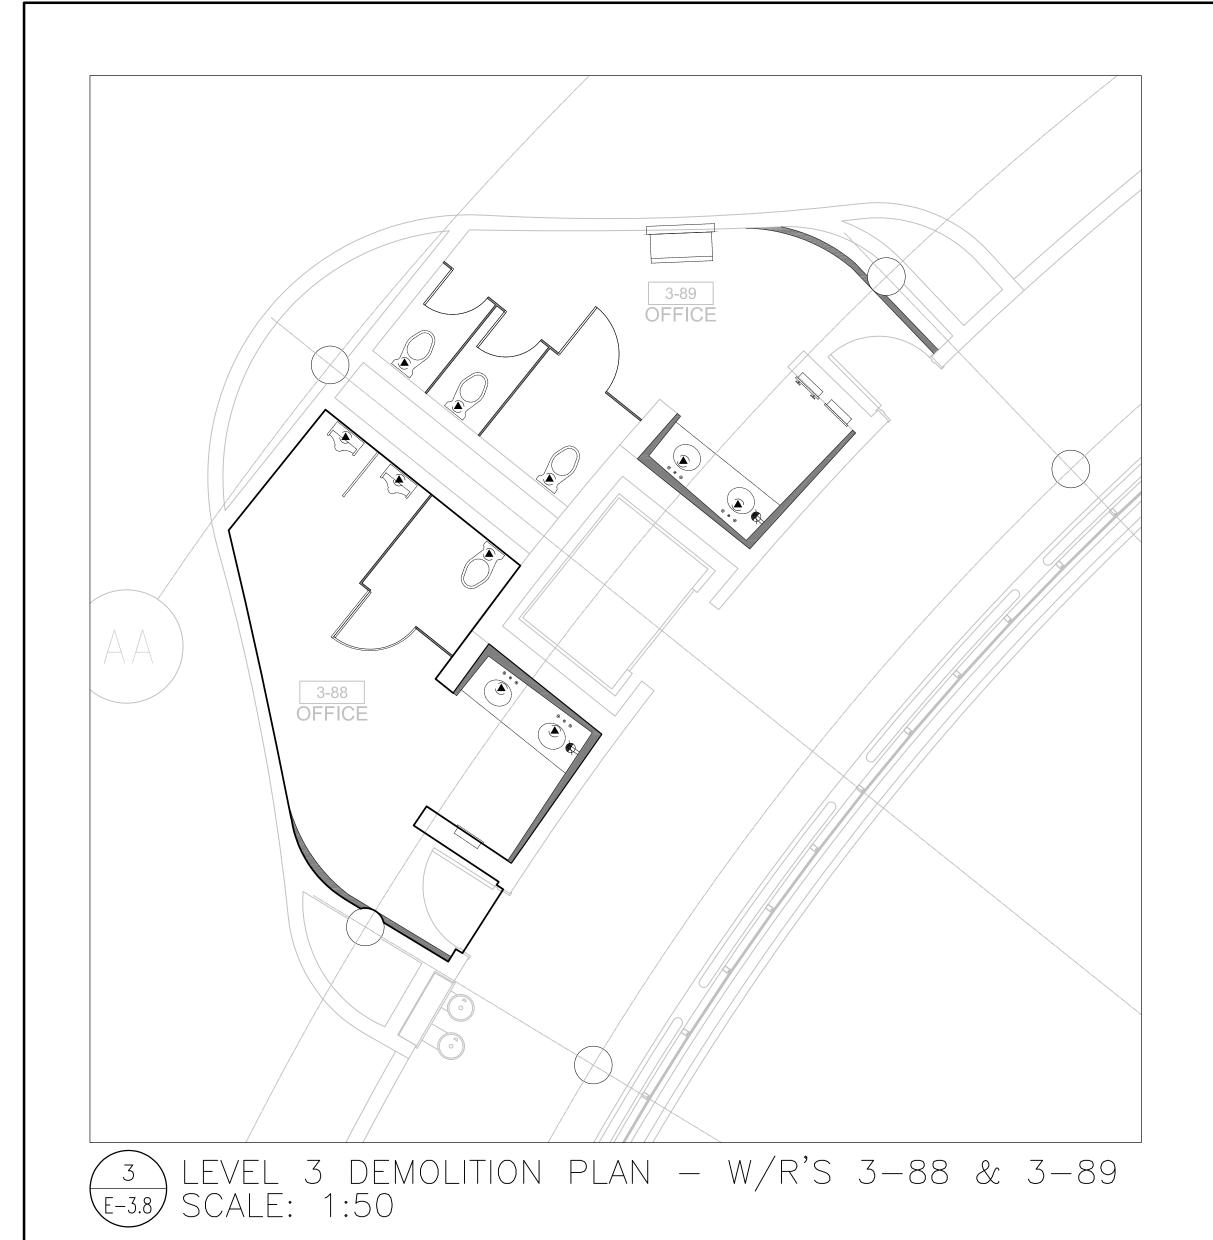
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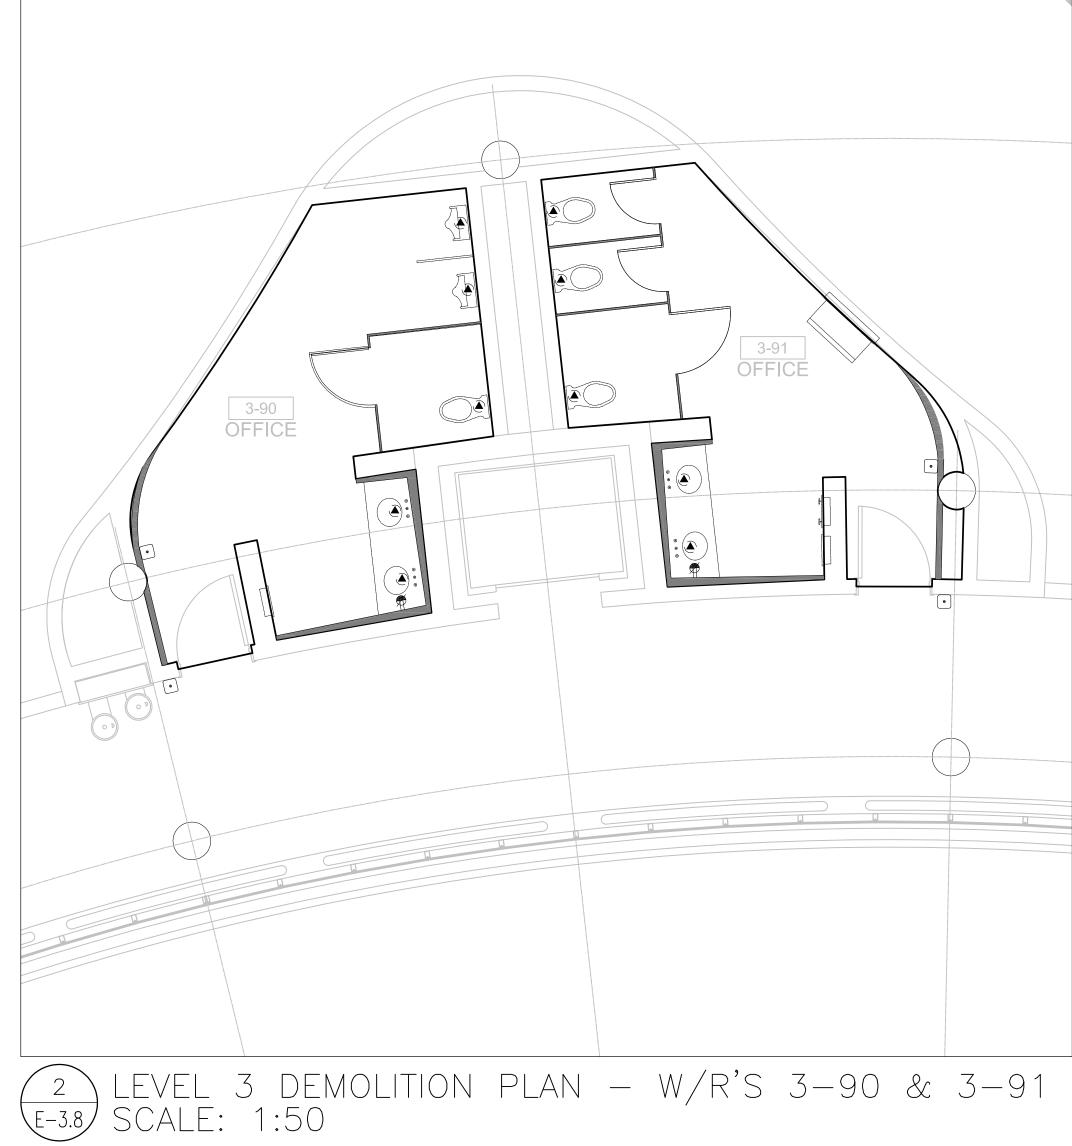
SUBMITTED TO: MUNICIPALITY OF YORK

SHEET TITLE:

LEVEL 3 WASHROOMS - CEILING DEMOLITION LAYOUT

SHEET NUMBER:







1 LEVEL 3 DEMOLITION PLAN - W/R'S 3-92 & 3-93 SCALE: 1:50

- REFER TO THE ARCHITECT'S DRAWINGS TO DETERMINE COMPLETE EXTENT OF DEMOLITION AND ALLOW FOR ALL COSTS. COMPLETE EXTENT OF DEMOLITION IS NOT SHOWN.
- REMOVE ALL FLOOR, COLUMN, CEILING, AND WALL MOUNTED POWER, TELEPHONE/DATA OUTLETS, CABLING AND CONDUIT NOT REQUIRED, TO SUIT NEW LAYOUT AND MAKE SAFE. VISIT SITE TO DETERMINE EXACT REQUIREMENTS AND REFER TO DEMOLITION DRAWINGS.
- 3. ENSURE THAT ALL EXISTING ELECTRICAL DEVICES, EQUIPMENT AND LIGHTING WITHIN BASE BUILDING ROOMS, STAIRWELLS AND AREAS DEEMED NOT IN SCOPE, REMAIN LIVE OPERATIONAL, ISOLATED AND PROTECTED DURING CONSTRUCTION.
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- COORDINATE WITH GENERAL CONTRACTOR AND THE REGION FOR DISPOSAL OF ALL MATERIALS FROM SITE.

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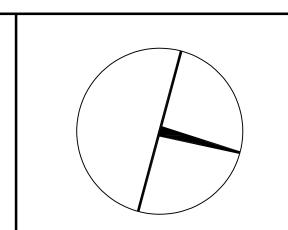


Smith + Andersen

### PROJECT CONTACT

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# PROPERTY SERVICES

**BUILDING & FACILITIES** DEPARTMENT: 003 FLOOR: 03-01-2020 BASE DATE:

PROJECT:

# PROJECT # 14008.009

# YORK REGION

Administrative Centre 17250 Yonge Street Newmarket, Ontario

SCALE: AS SHOWN

DRAWN BY: AS

MUNICIPALITY OF YORK SUBMITTED TO:

SHEET TITLE:

LEVEL 3 WASHROOMS -POWER DEMOLITION LAYOUT

SHEET NUMBER: