

- LEGEND**
T100 - COMMUNICATIONS, IT AND ACCESS CONTROL TITLE PAGE
T101 - COMMUNICATIONS, IT AND ACCESS CONTROL SCHEMATICS
T102 - B-WING FLOOR 1 COMMUNICATIONS AND SECURITY LAYOUT
T103 - B-WING FLOOR 2 COMMUNICATIONS AND SECURITY LAYOUT
T104 - COMMUNICATIONS PATHWAYS DETAILS
T105 - COMMUNICATIONS INSTALLATION DETAILS
T106 - COMMUNICATIONS GROUNDING AND BONDING DETAILS
T107 - RACK ELEVATIONS DETAIL
T108 - AV ELEVATIONS WING B LEVEL 1
T109 - AV LAYOUT DRAWINGS
T110 AV ELEVATIONS WING B LEVEL 2

GENERAL CONSTRUCTION NOTES:

- REFER TO EACH T DRAWINGS FOR SYMBOLS AND ABBREVIATIONS.
- CONFIRM ALL OUTLET MOUNTING HEIGHTS PRIOR TO INSTALLATION AS PER DRAWINGS.
- THE CONTRACTOR SHALL BE RESPONSIBLE FOR COORDINATION AND TO INFORM ANY AFFECTED SERVICES SUCH AS BUT NOT LIMITED TO BUILDING MANAGEMENT, OR SECURITY OF ANY FORESEEN NETWORK OUTAGES.
- DRAWINGS ARE DIAGRAMMATIC IN NATURE CONTRACTORS TO VERIFY DIMENSIONS PRIOR TO INSTALLATION
- THESE DRAWINGS ARE TO BE READ WITH THE DIVISION 27 SPECIFICATIONS

DIVISION 26 NOTES:


-
- COORDINATE ALL LOCATIONS WITH DIV. 27
 - ALL CONDUITS SHALL MEET THE FILL CAPACITY AS SHOWN ON DRAWING IN THE CHART BELOW. WHERE CONDUIT OR BASKET TRAY IS UNDERSIZED, THE CONTRACTOR SHALL INFORM THE CLIENT BEFORE PROCEEDING.
 - ALL DATA CABLES TO BE INSTALLED IN CONDUIT HOMERUN TO WIRE BASKET TRAY.
 - ALL CONDUITS TO HAVE PULL STRINGS.
 - CONTRACTOR TO FIELD VERIFY AND OBTAIN WRITTEN APPROVAL FOR FINAL LOCATIONS PRIOR TO INSTALLATION OF PATHWAYS
 - DO NOT USE CONDUIT SIZES 13mm (1/2")
 - IF CONDUIT HAS INTERNAL DIAMETER OF 50MM (2") OR LESS, THE BAND RADIUS MUST BE AT LEAST 6 TIMES THE INTERNAL CONDUIT DIAMETER.
 - IF THE CONDUIT HAS AN INTERNAL DIAMETER OF MORE THEN 50MM (2"), THE BEND RADIUS MUST BE AT LEAST 10 TIMES THE INTERNAL CONDUIT DIAMETER.
 - ALL CONDUIT SIZES SHOWN REPRESENT NOMINAL TRADE DIMENSIONS AND MAY DIFFER FROM ACTUAL DIMENSIONS.
 - CONTRACTOR TO ENSURE ALL PULL BOXES FOR DIVISION 27 WORK ARE SIZED AS SHOWN IN TABLE.
 - WHERE PULL BOXES ARE NOT READILY AVAILABLE IN THE SIZES INDICATED IN THE TABLES, "OFF-THE-SHELF" SMALLER PULL BOXES MAY BE USED WHEN APPROVED BY THE CONSULTANT
 - ALL PENETRATIONS OF FIRE RATED WALLS ARE TO BE FIRST FIRE STOPPED BACK TO ORIGINAL WALL RATING. CHECK ARCHITECTURAL DRAWINGS FOR WALL RATINGS
 - PLEASE SEE DRAWINGS T102, T103, T104, T105, T108, T109 AND T110 AS A MINIMUM FOR DIVISION 26 DETAILS
 - PLEASE READ SPECIFICATION SECTIONS 27 00 03 AND 27 05 128 AS A MINIMUM FOR DIVISION 26 DETAILS

DIVISION 27 NOTES:

- COORDINATE ALL LOCATIONS WITH DIV. 26
- DATA CABLING FROM JACKS TO BE CONTINUOUS (NO SPLICING)
- THE CONTRACTOR SHALL BE RESPONSIBLE TO COORDINATE WITH EXTERNAL SERVICE PROVIDERS SUCH AS BELL, COGECO, OR OTHERS FOR ANY EQUIPMENT WHICH MAY NEED TO BE MOVED OR INSTALLED DURING THE UPGRADE. THE CONTRACTOR SHALL PROVIDE ALTERNATIVE SERVICES TO INSURE NO DOWN TIME IS EXPERIENCED DURING THE UPGRADE.
- CONTRACTOR TO VERIFY AND ENSURE CONDUIT PATHWAYS DO NOT EXCEED FILL CAPACITY AS PER THE TABLE BELOW

CONDUIT INSIDE DIAMETER mm (in)	TRADE SIZE	NUMBER OF CABLES AT 40% FILL RATIO					
		4 (0.15)	5 (0.19)	6 (0.23)	7 (0.27)	8 (0.31)	9 (0.35)
21 (0.82)	19.05mm	11	7	5	3	3	2
27 (1.04)	25.4mm	18	11	8	6	4	3
35 (1.38)	31.75mm	30	19	13	10	8	6
41 (1.61)	38.1mm	41	26	18	13	10	8
50 (2.06)	50.8mm	68	43	30	22	17	13
63 (2.46)	63.5mm	96	62	43	31	24	19
75 (3.06)	76.2mm	149	95	66	49	37	29
91 (3.54)	88.9mm	199	127	88	65	50	39
100 (4.02)	101.6mm	255	163	113	83	64	50

MAXIMUM SIZE OF CONDUIT IN MILLIMETERS	SIZE OF BOX IN MILLIMETERS			FOR EACH ADDITIONAL CONDUIT INCREASE WIDTH
	WIDTH	LENGTH	DEPTH	
19.05	101.6	304.8	76.2	50.8MM
25.4	101.6	406.4	76.2	50.8MM
31.75	152.4	508	76.2	76.2MM
38.1	203.2	685.8	101.6	101.6MM
50.8	203.2	914.4	101.6	127MM
63.5	254	1066.8	127	152.4MM
76.2	304.8	1219.2	127	152.4MM
88.9	304.8	1371.6	152.4	152.4MM
101.6	381	1524	203.2	203.2MM

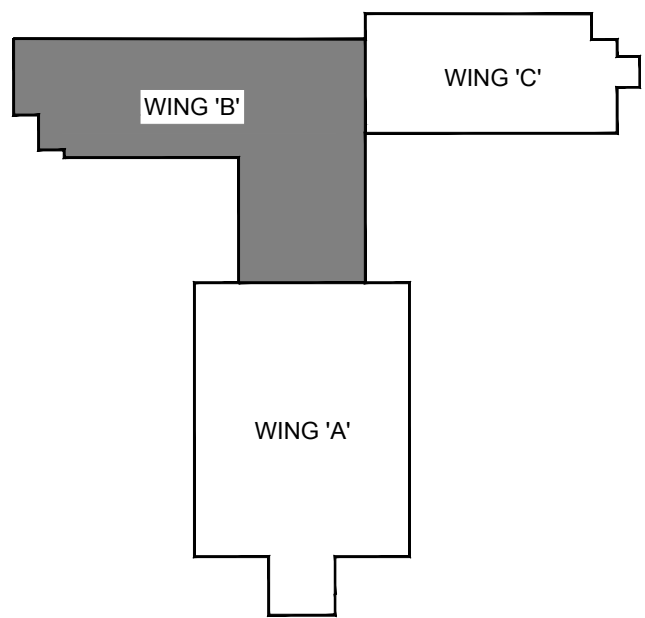

Key Plan

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UNEXPECTED DISCOVERY OF ASBESTOS:

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-
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B = Drawing number where detailed

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1	ISSUED FOR 65% REVIEW	TA	JULY 12, 2018
NO.	ISSUED	BY	DATE

Orientation

Seal



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Project
BUILDING #046 RENOVATIONS

Drawing Title
TITLE PAGE

Project No.
504034

Location
UNIVERSITY OF GUELPH BUILDING #046

Scale
AS SHOWN

Date
FEB 22, 2019

Drawn by
K.C.

Checked By
D.C.


Approved By
B.W.

JLR #


Drawing No.
T100

of


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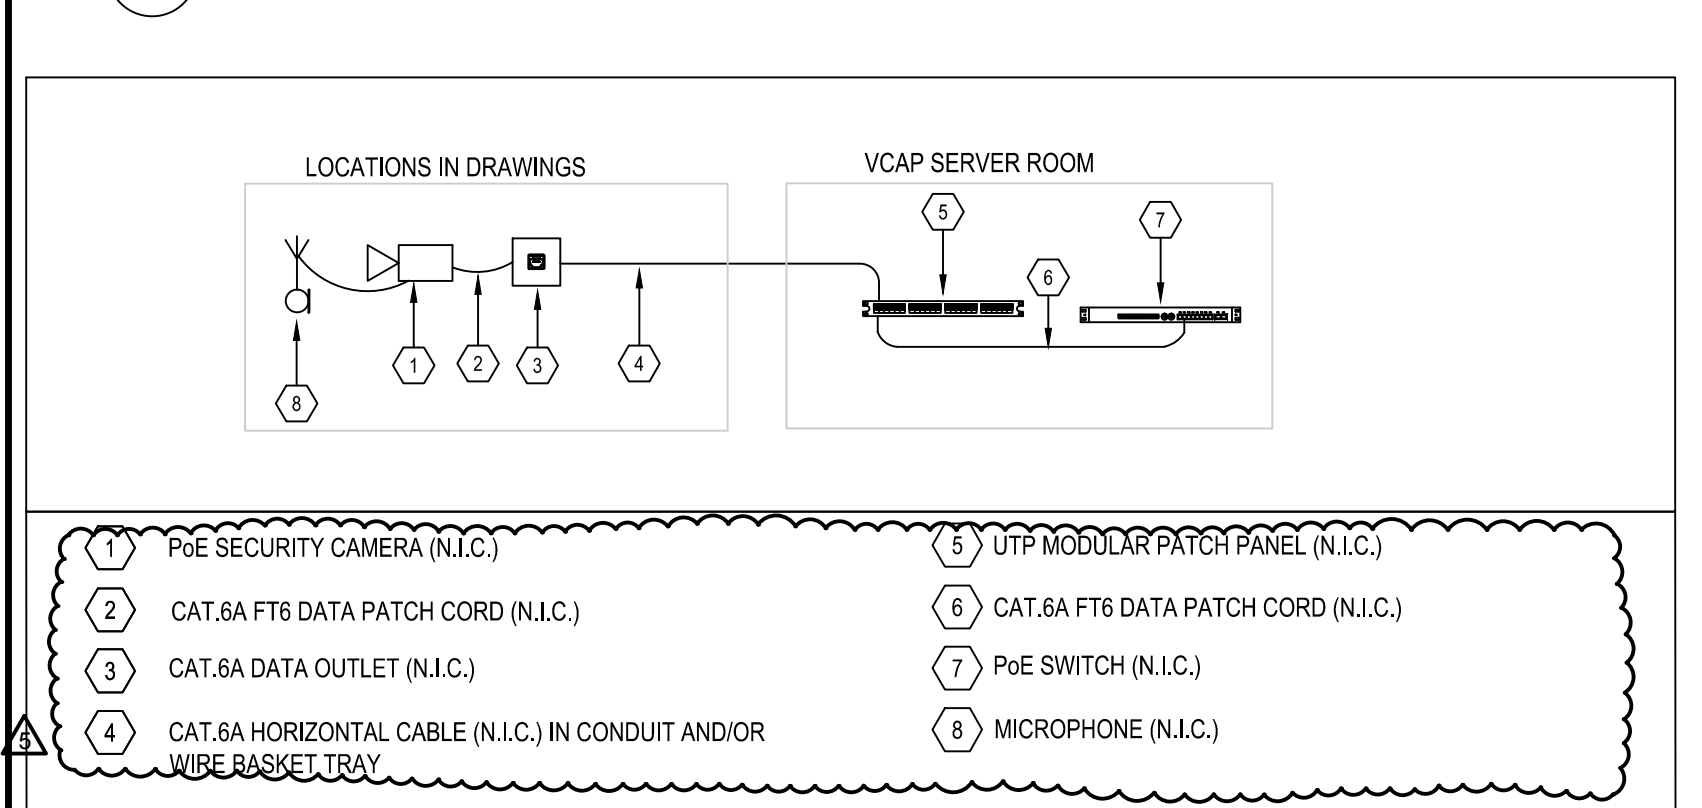
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T101 SCALE: N.T.S.

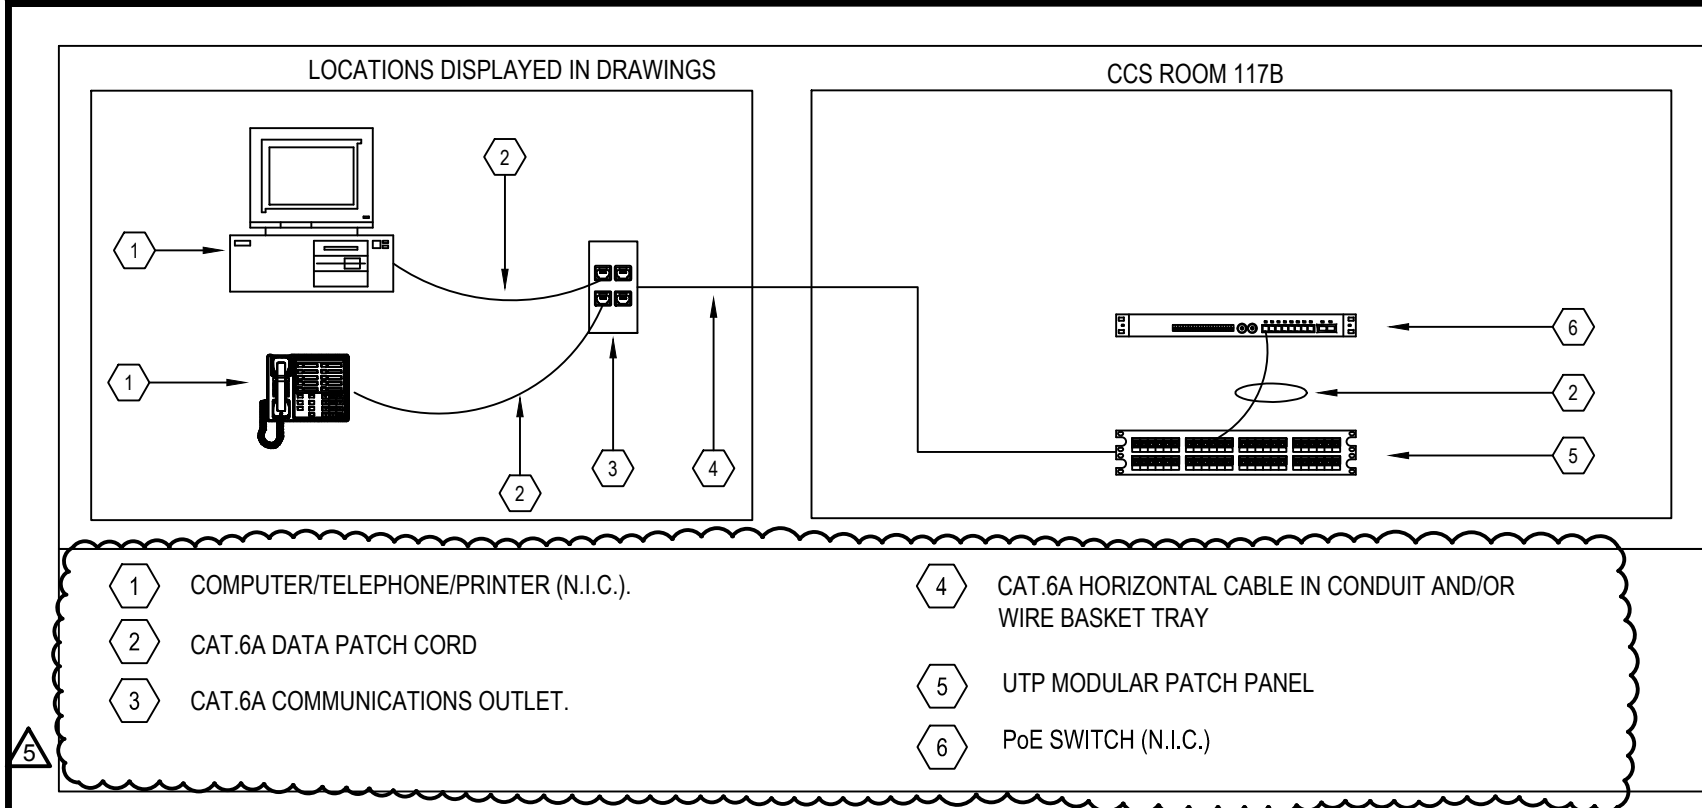


2 WIRELESS ACCESS POINT CONNECTIVITY SCHEMATIC
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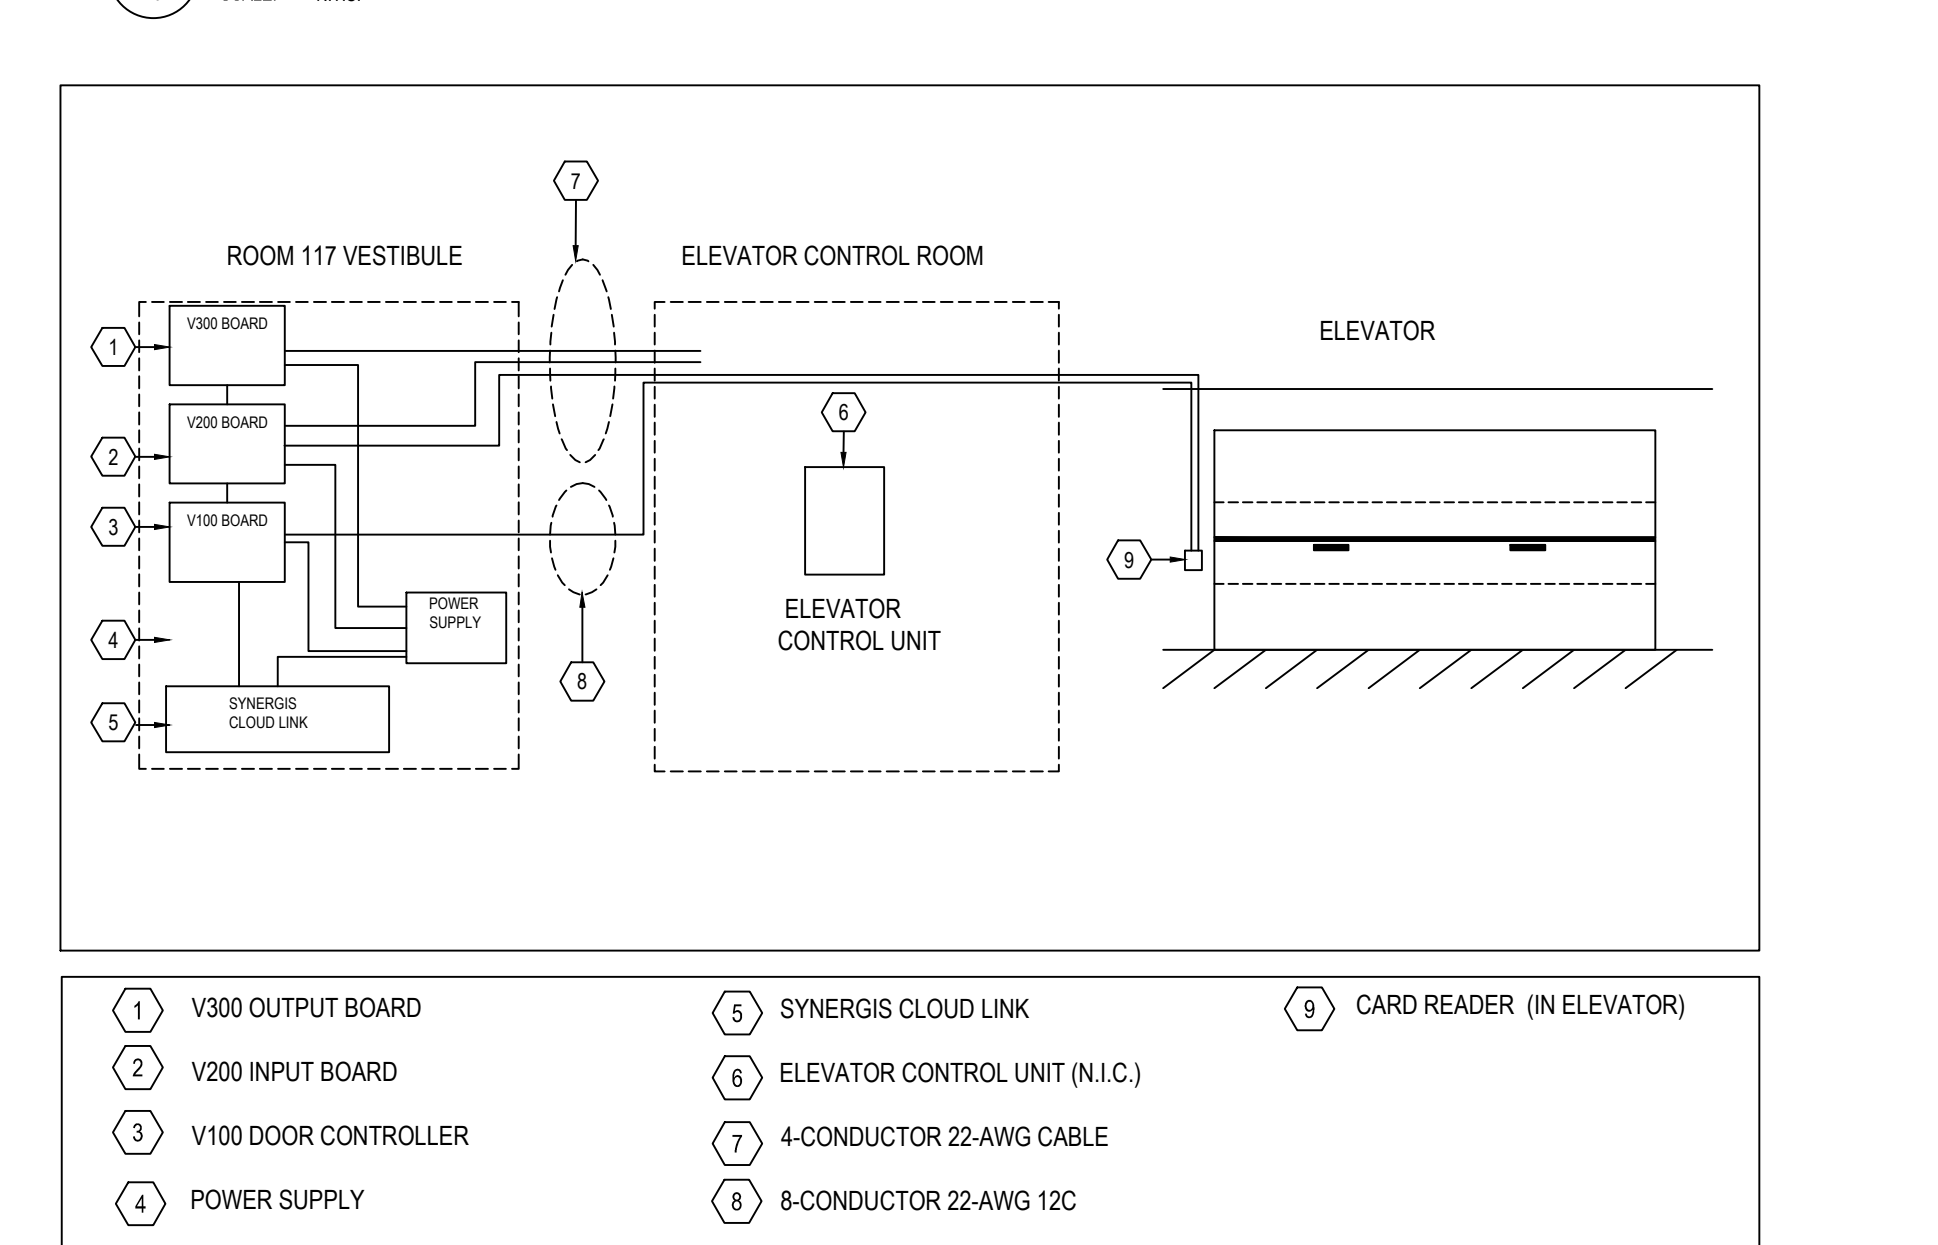
3 SECURITY CAMERA CONNECTIVITY SCHEMATIC
T101 SCALE: N.T.S.

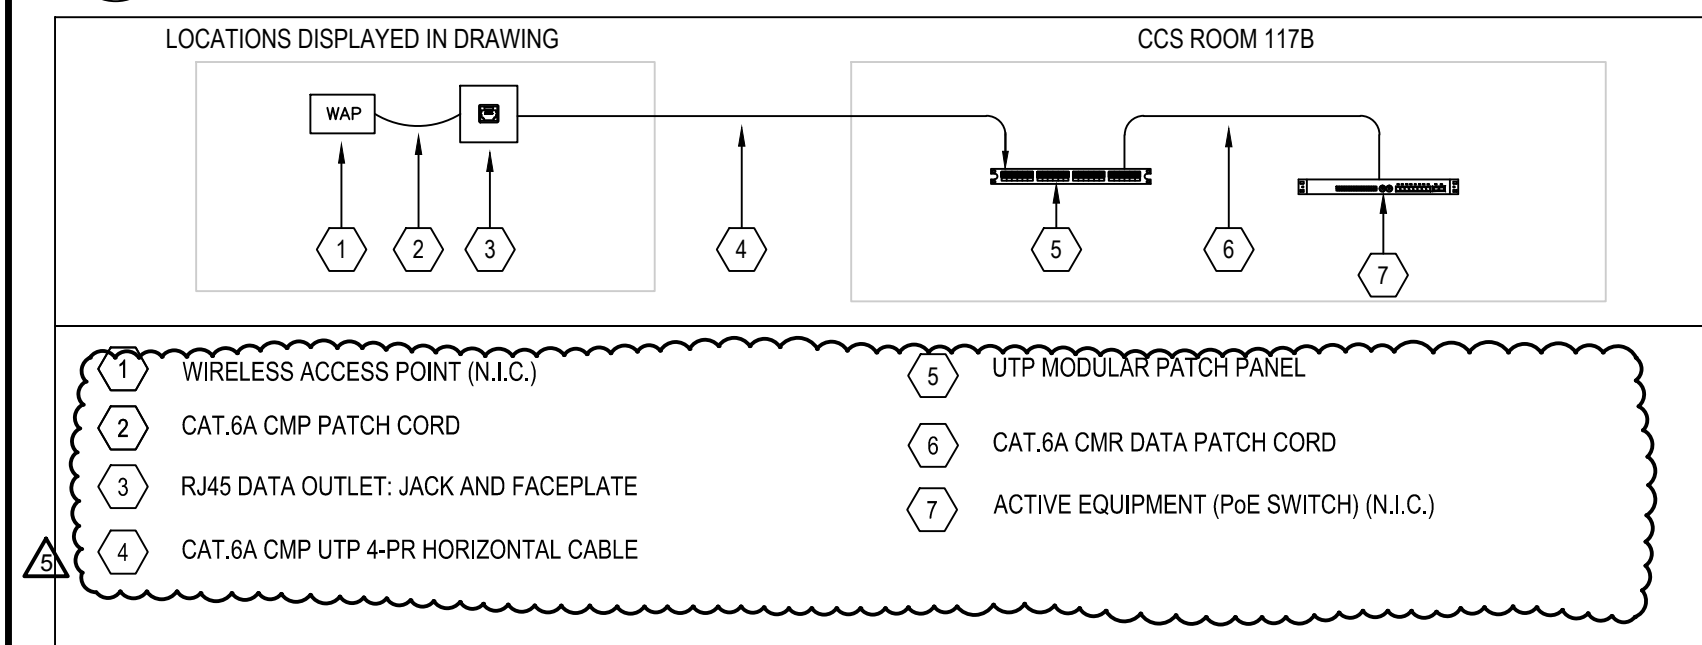


4 VIDEO CAPTURE CONNECTIVITY SCHEMATIC
T101 SCALE: N.T.S.

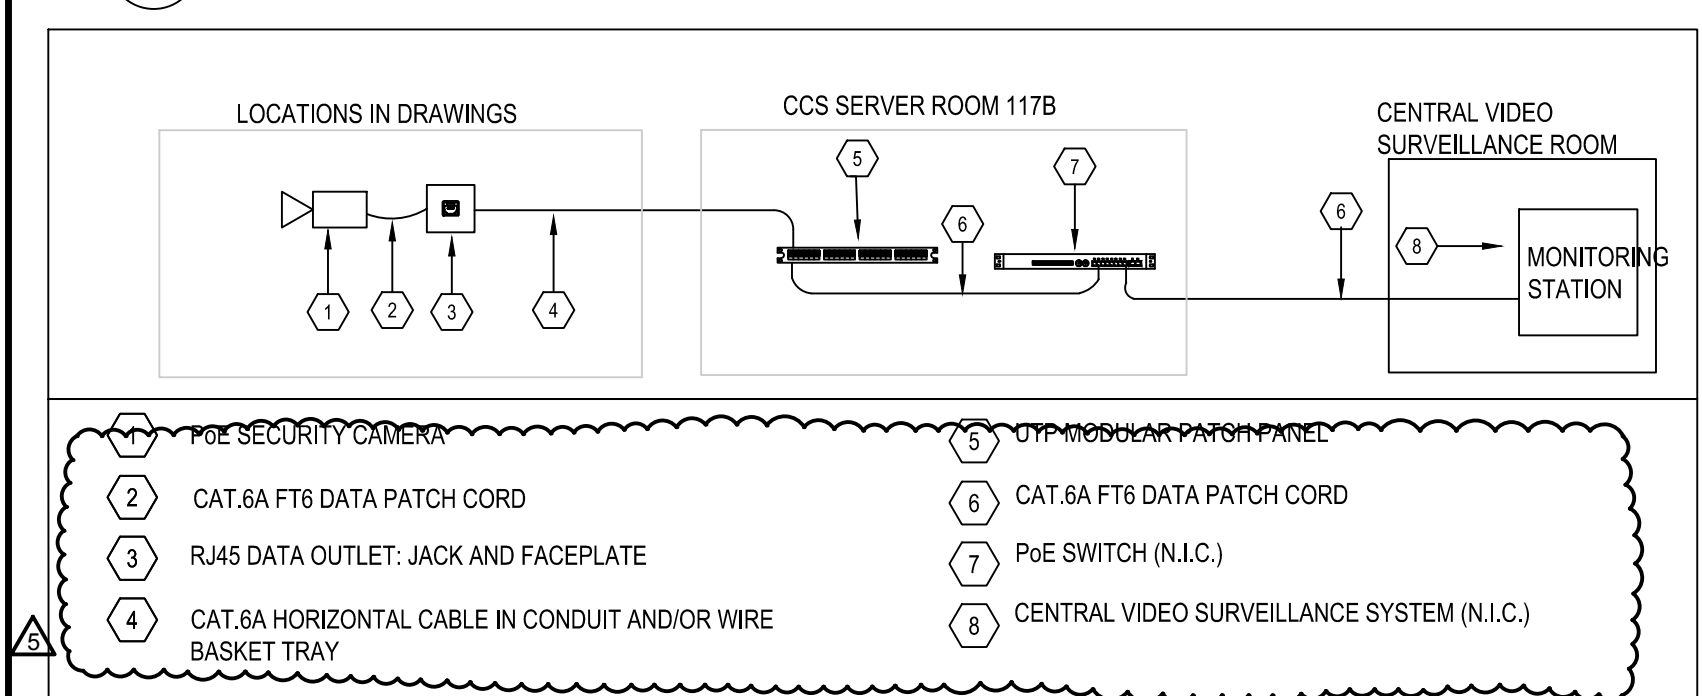

5 ACCESS CONTROL SYSTEM SCHEMATIC
T101 SCALE: N.T.S.

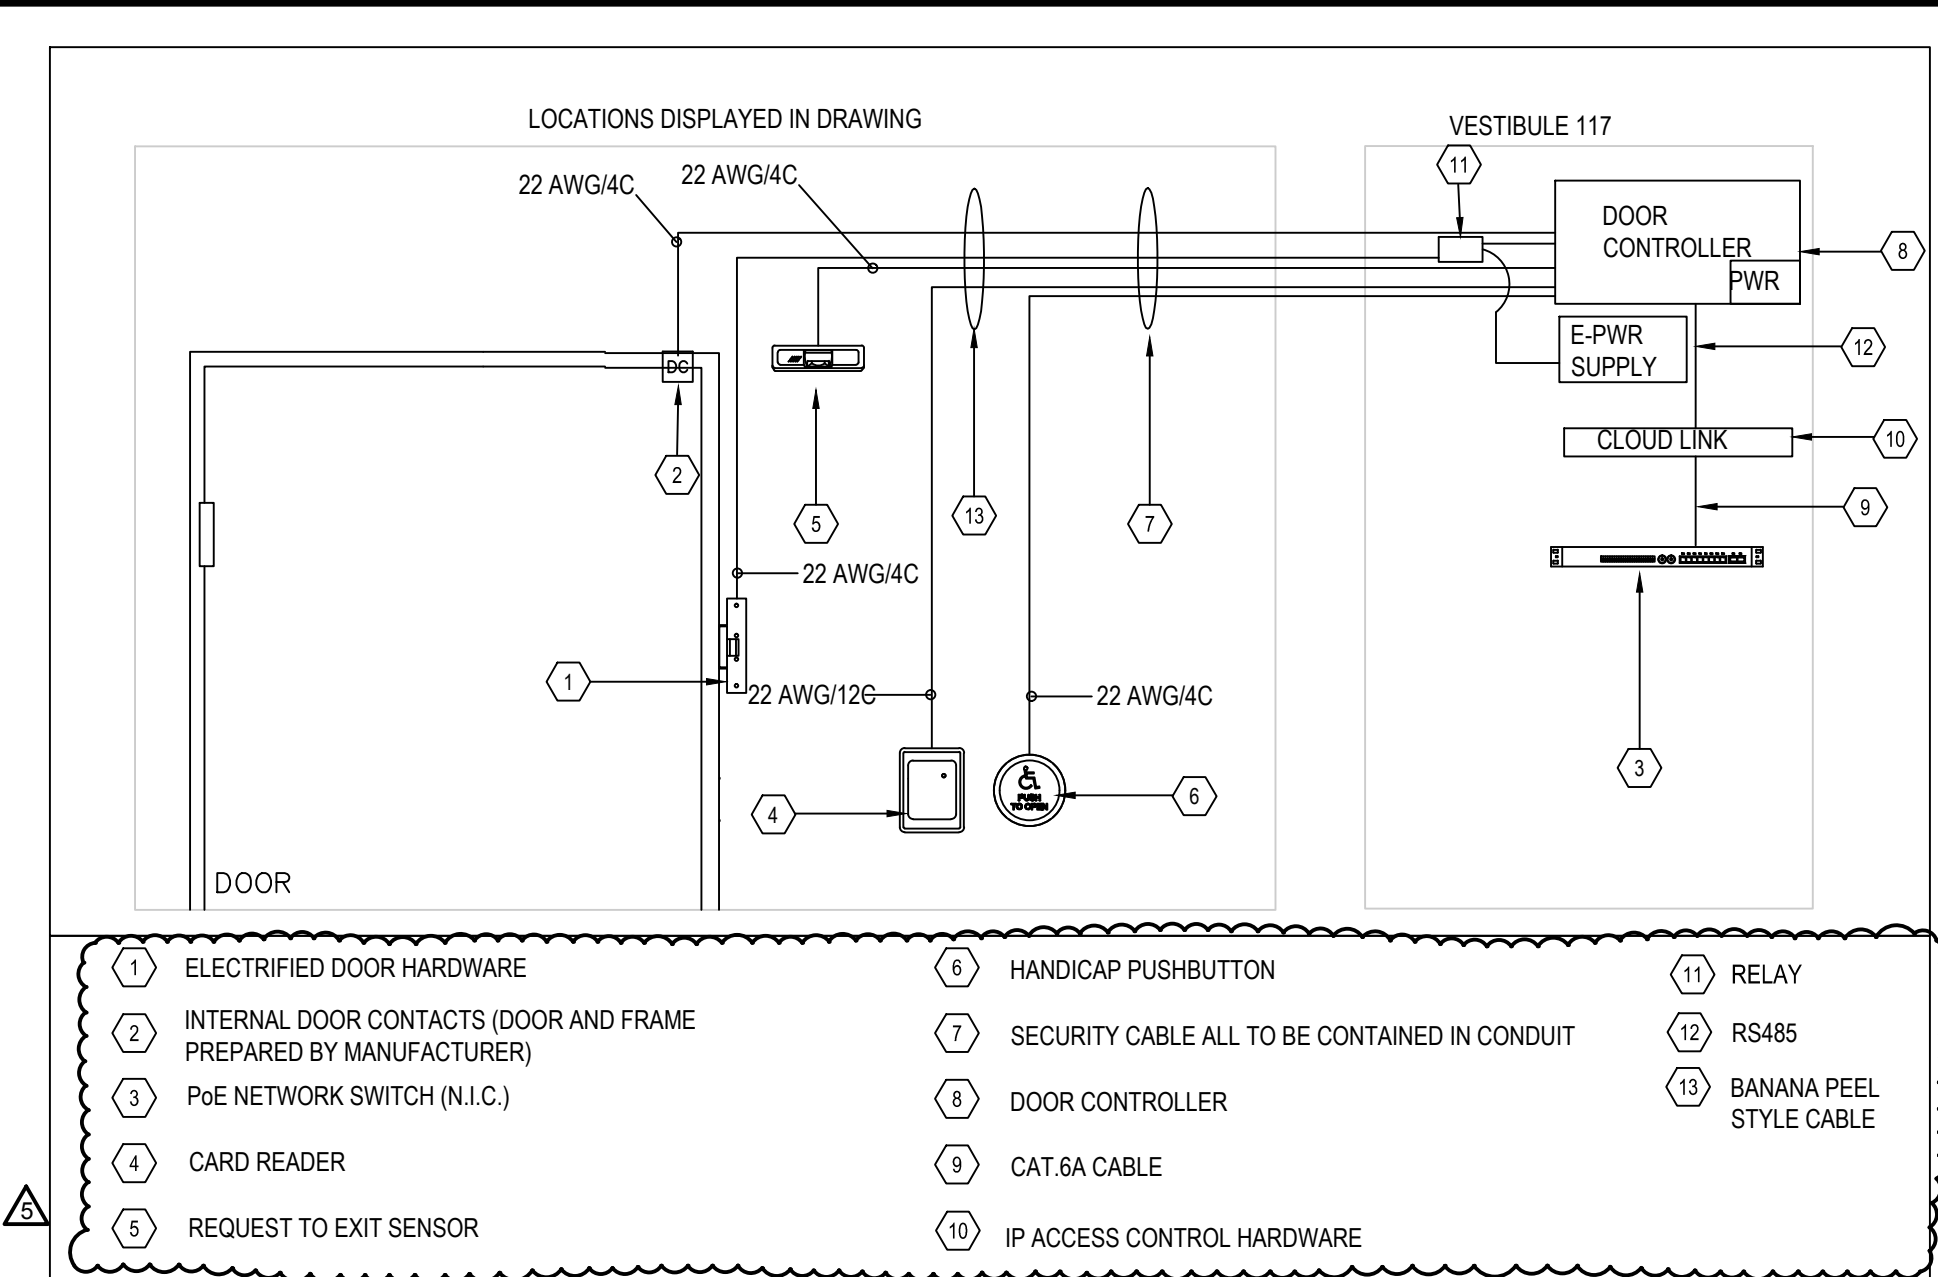


6 ELEVATOR CONTROL SCHEMATIC
T101 SCALE: N.T.S.

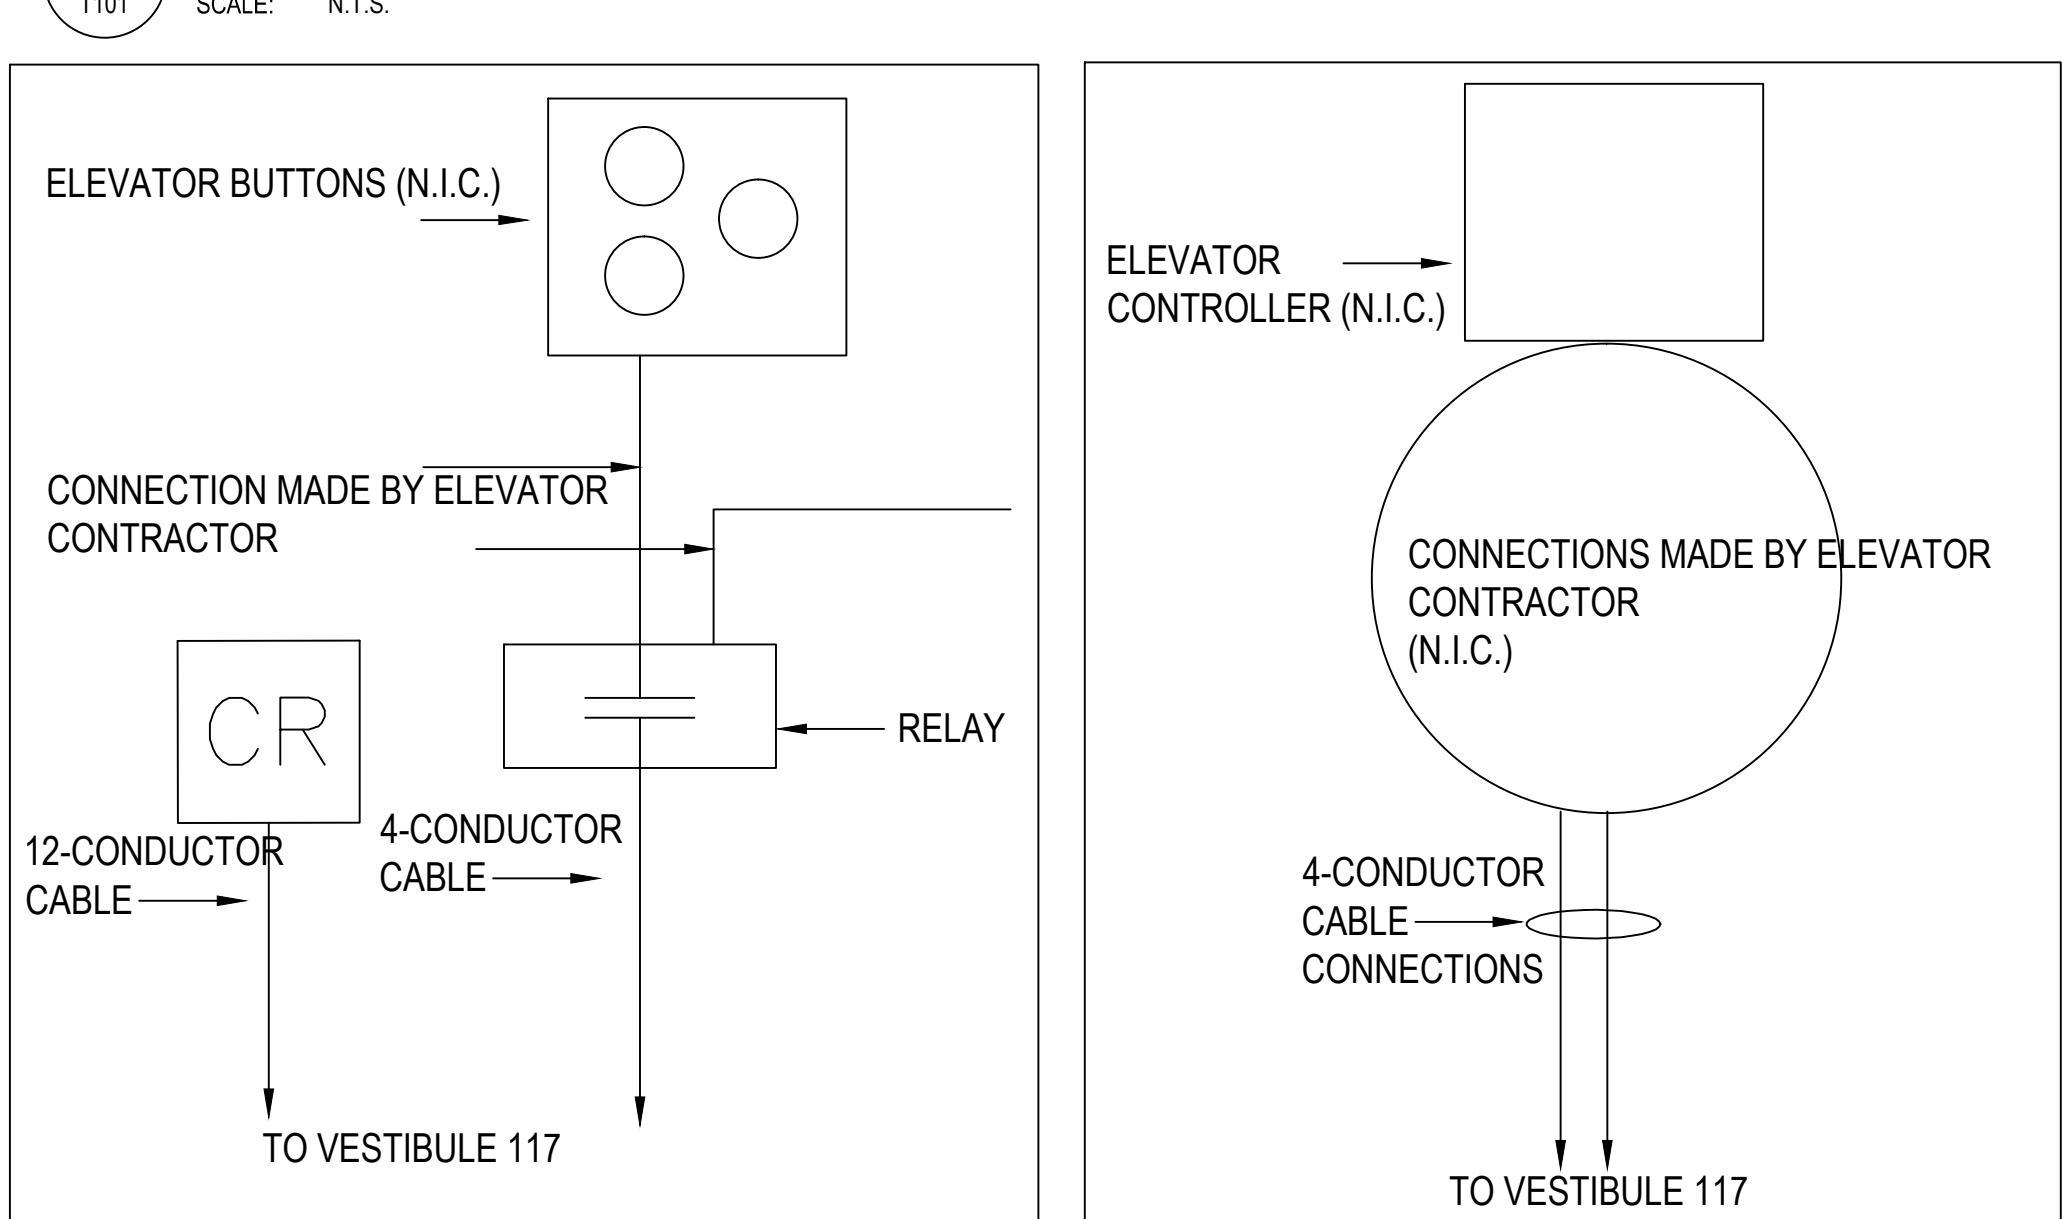


7 ELEVATOR CALL BUTTON
T101 SCALE: N.T.S.


8 ELEVATOR CONTROL ROOM
T101 SCALE: N.T.S.

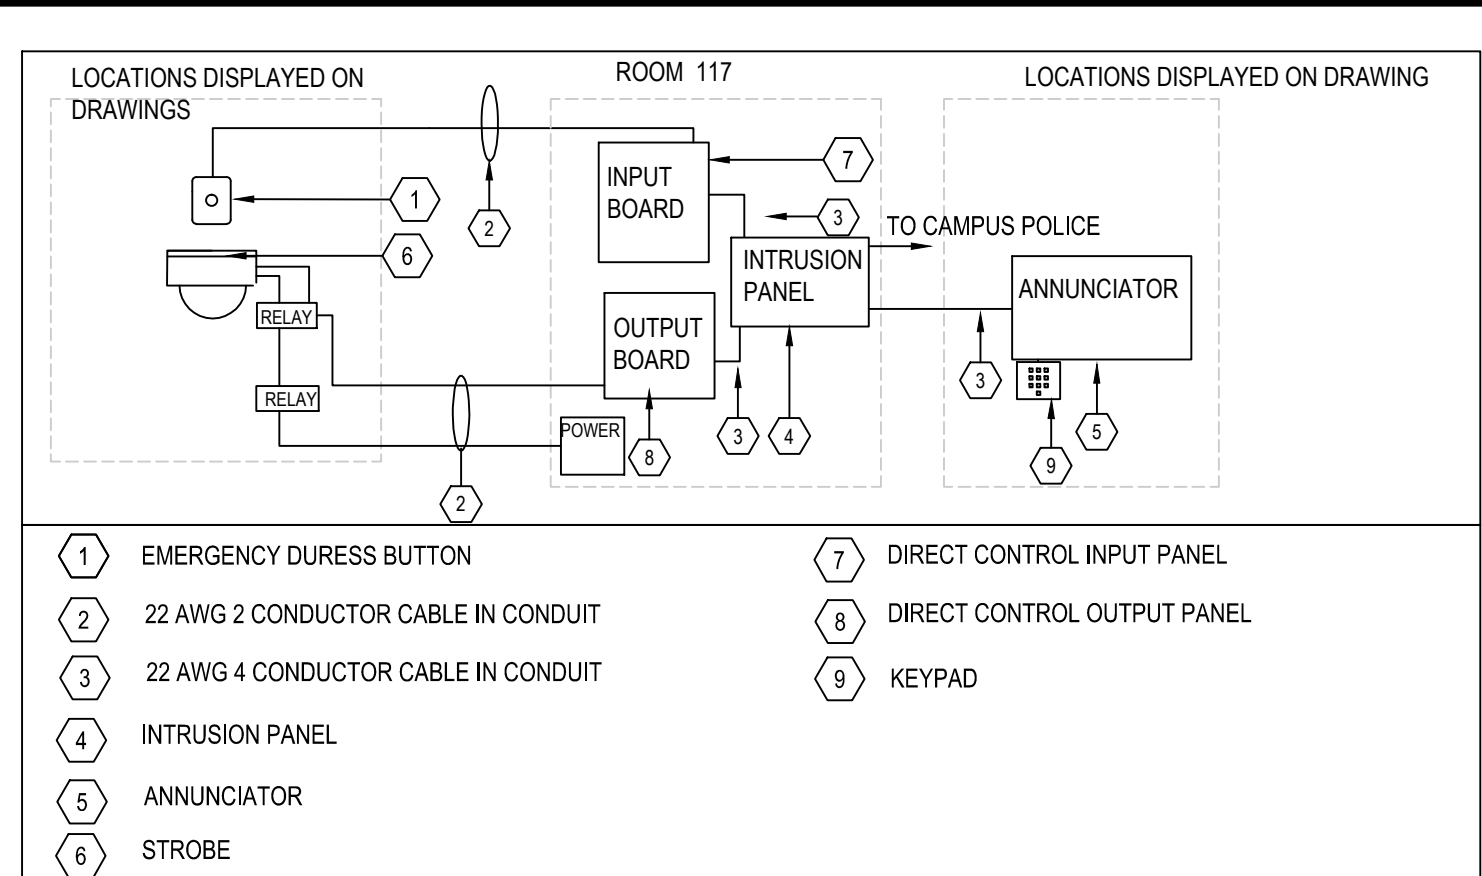


9 CAMPUS EMERGENCY ASSISTANCE/DURESS BUTTONS
T101 SCALE: N.T.S.

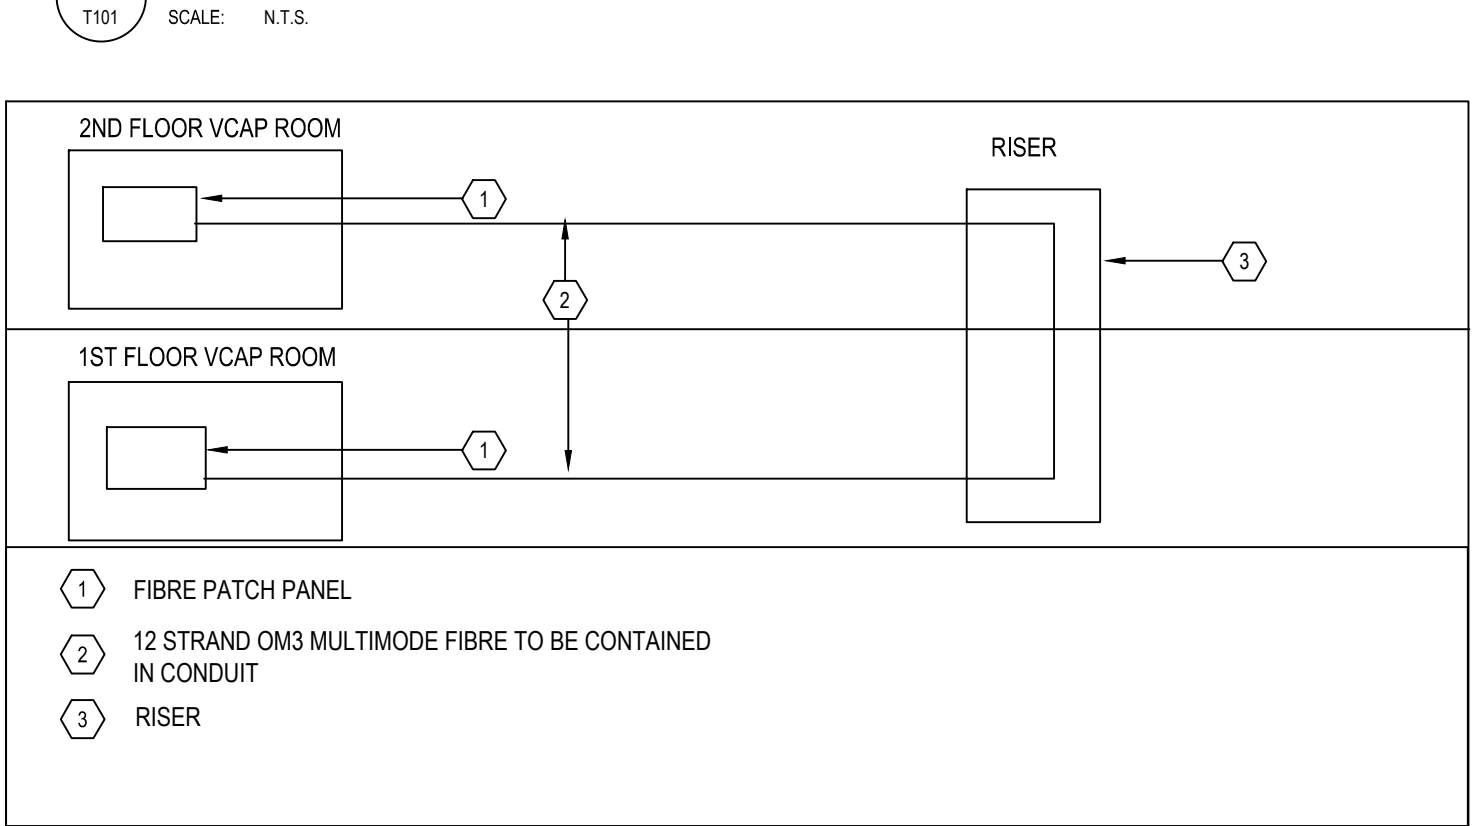

10 VCAP FIBRE CONNECTIVITY RISER SCHEMATIC
T101 SCALE: N.T.S.

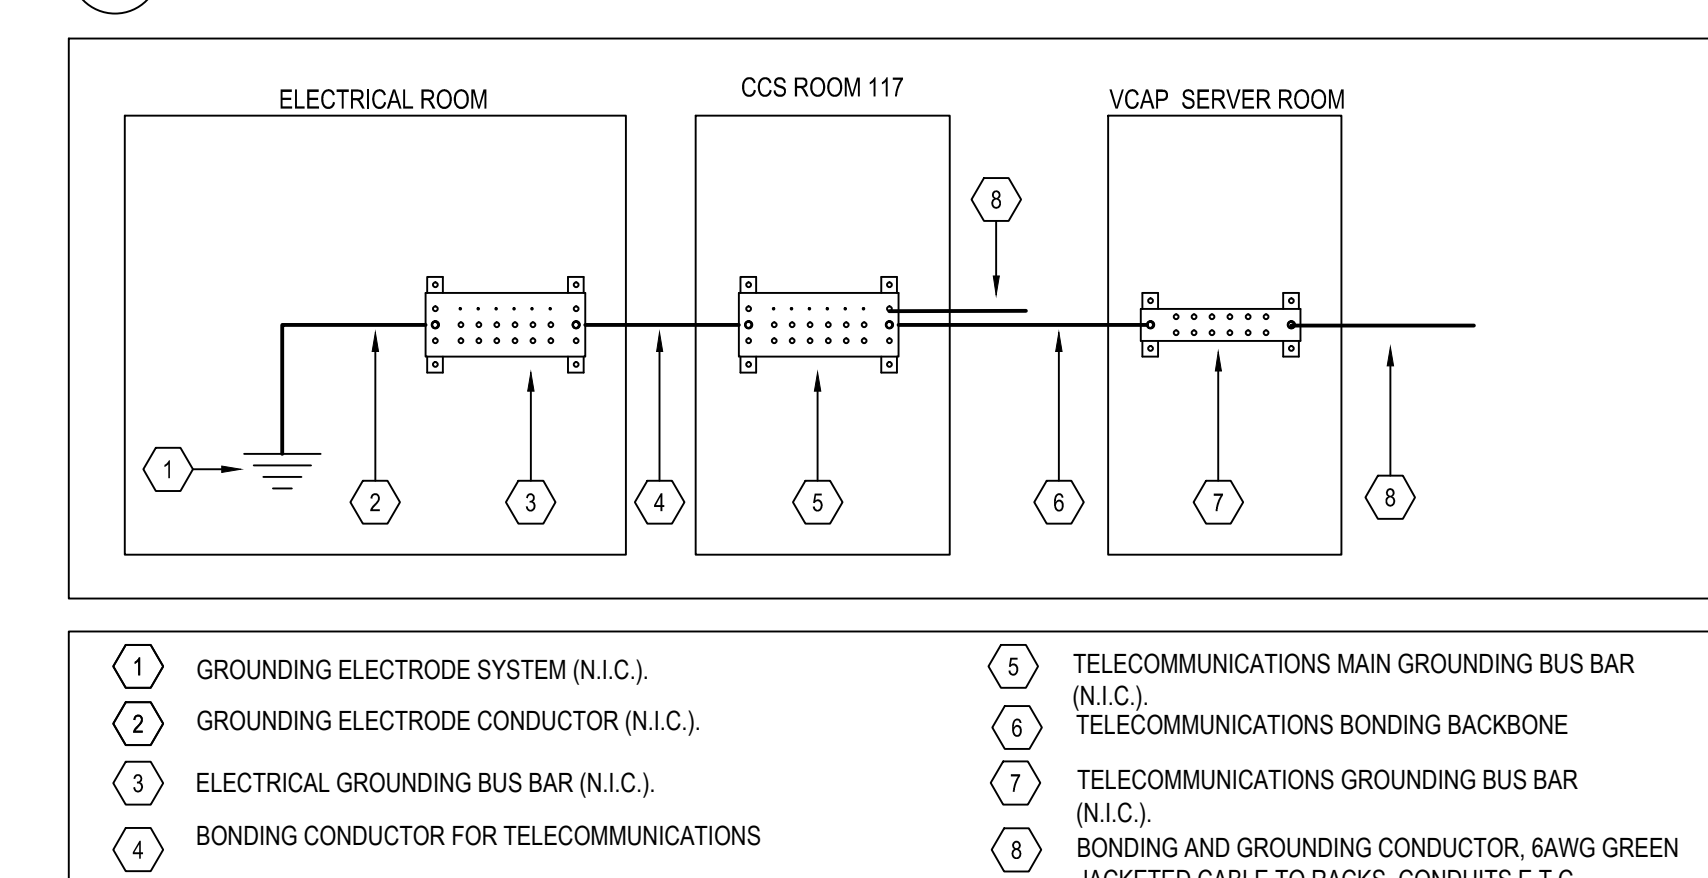

11 GROUNDING AND BONDING SCHEMATIC
T101 SCALE: N.T.S.

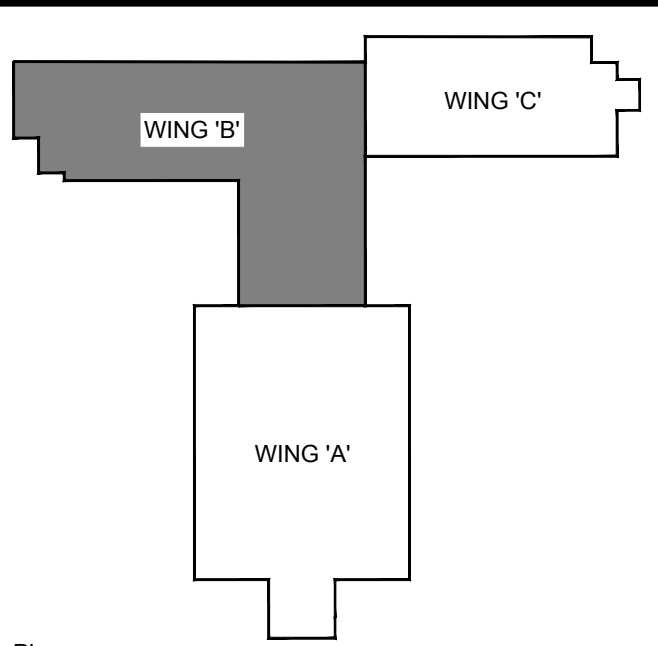

Key Plan

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Orientation

Seal

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Guelph, Ontario. N1G 2W1

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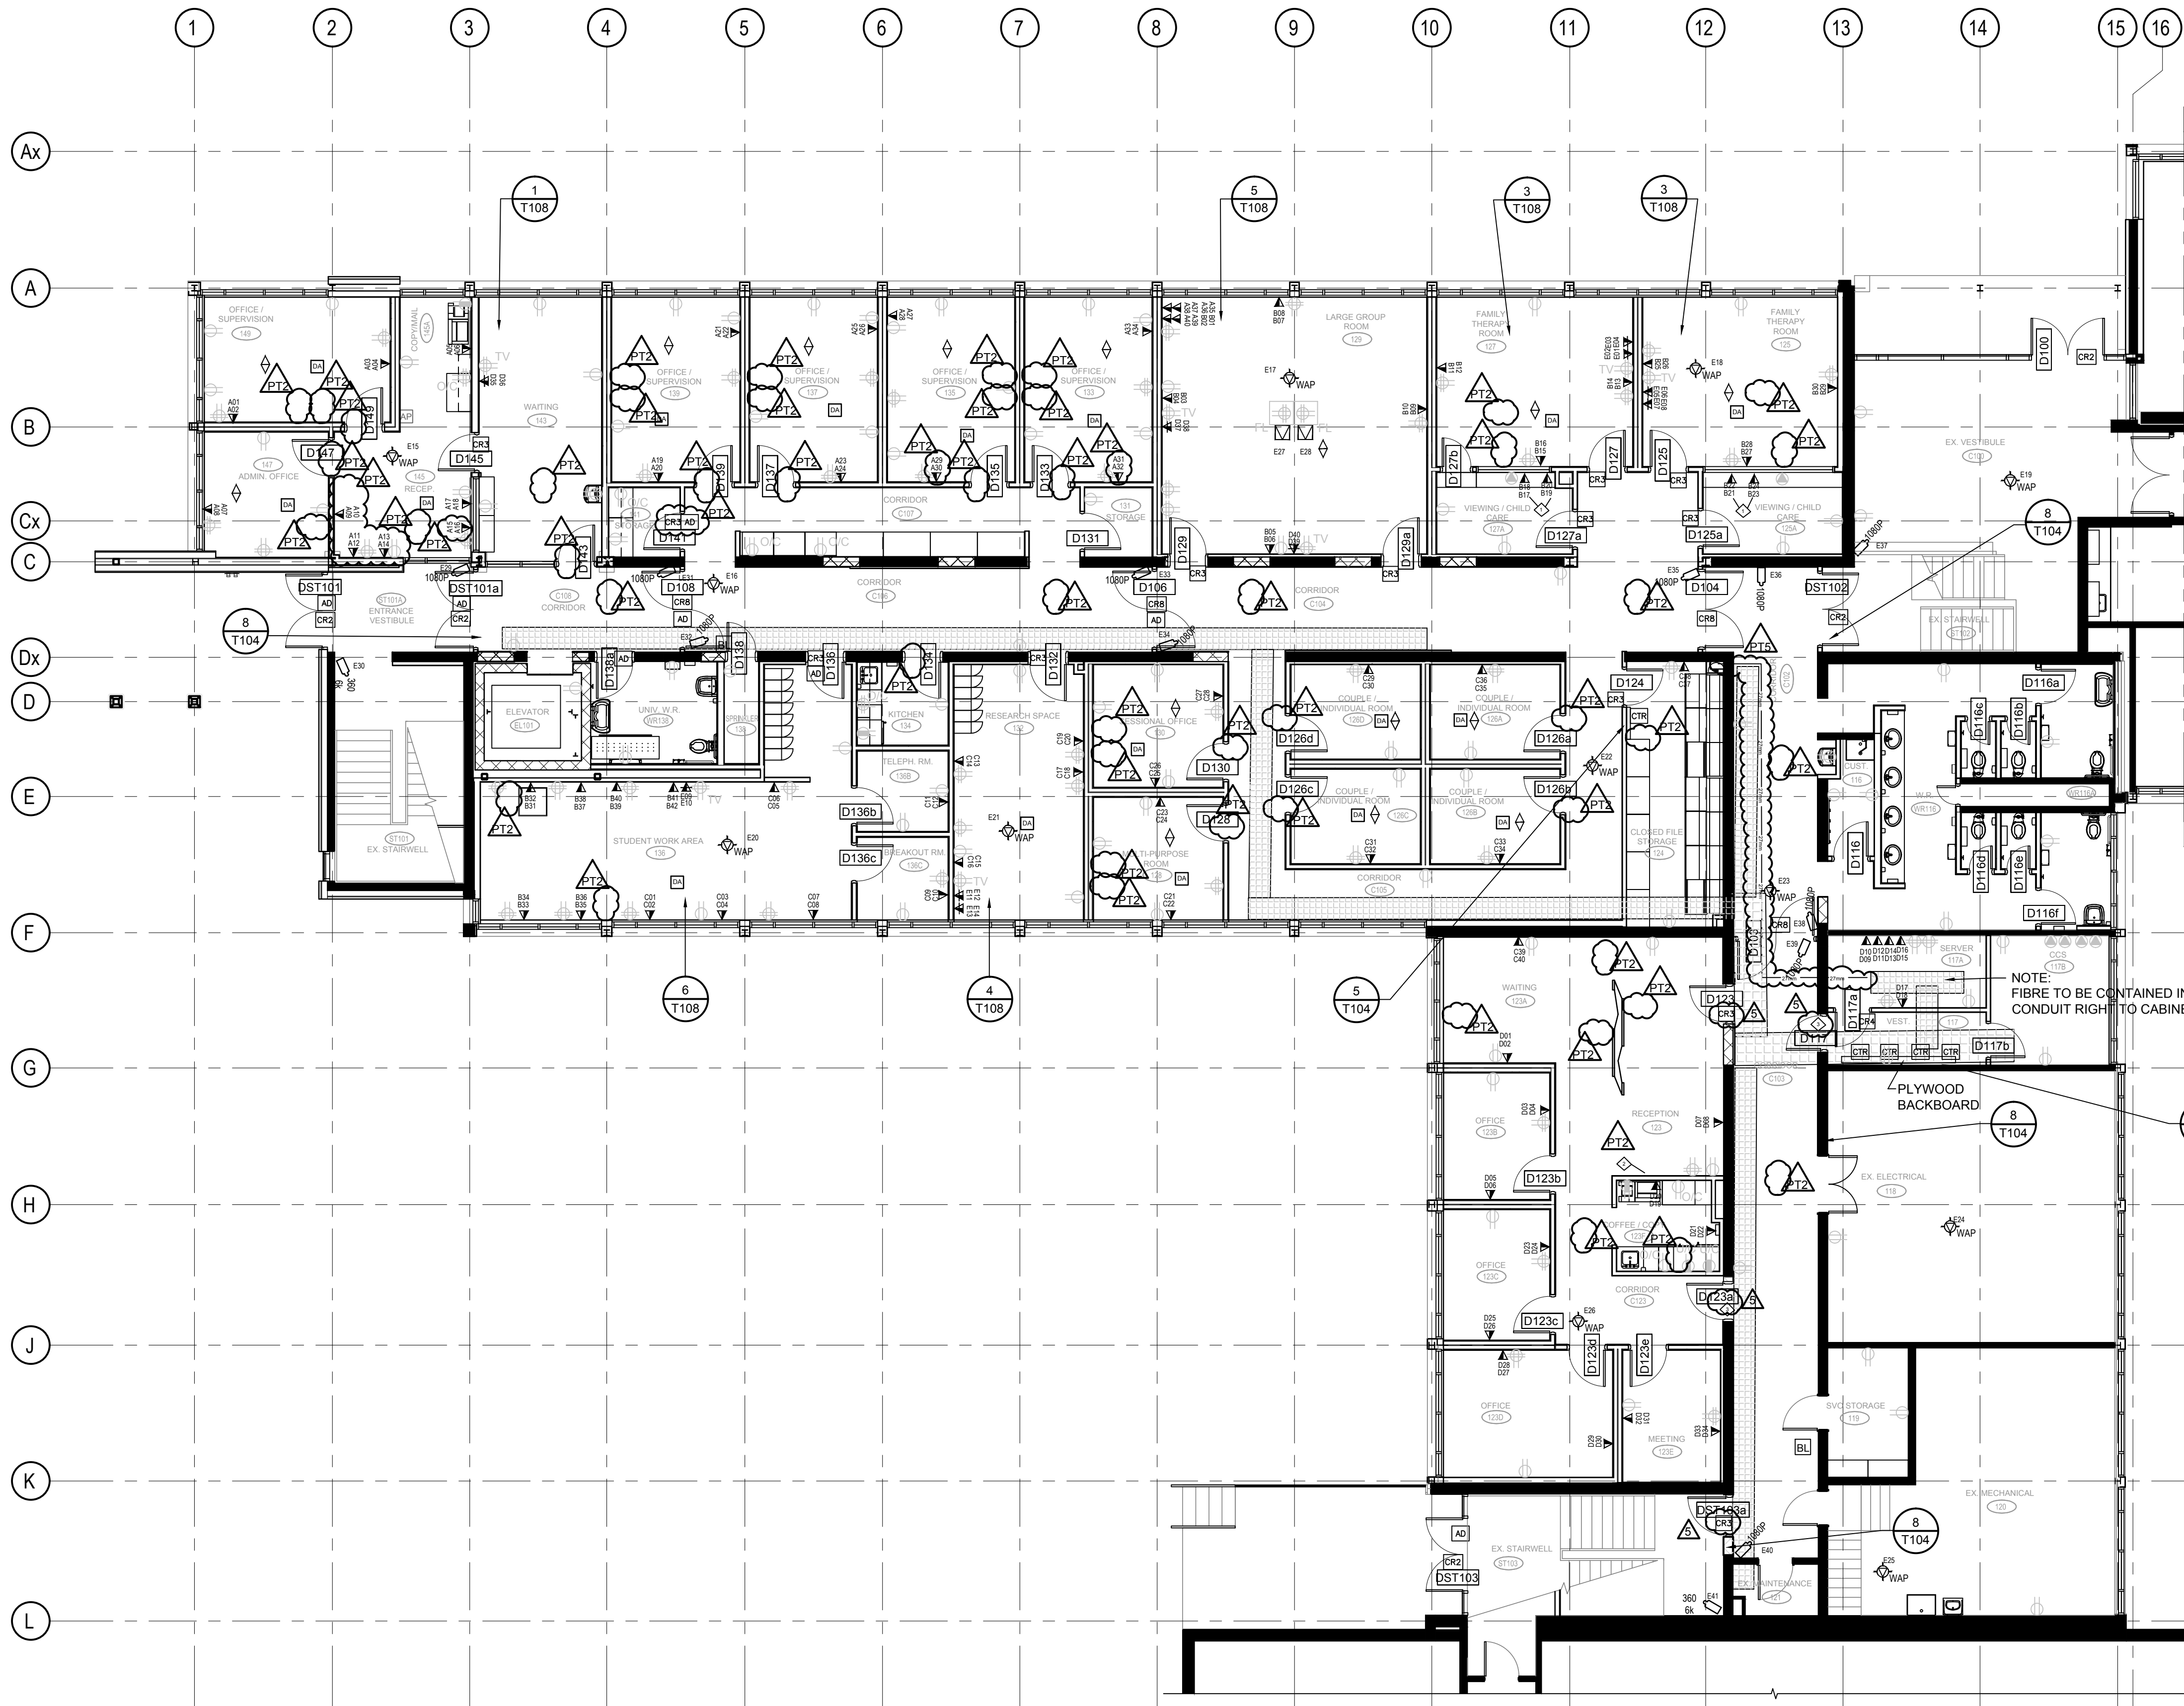
Project
BUILDING #046 RENOVATIONS
Drawing Title
SCHEMATICS

Project No.
504034
Location
UNIVERSITY OF GUELPH BUILDING #046

Scale AS SHOWN	Date FEB 22, 2019
Drawn by K.C.	Drawing No.
Checked By D.C.	
Approved By B.W.	
JLR #	
Cad File No.	

T101

of



LEGEND


- VCAP PATHWAY LOCATION FROM CLOSEST WIRE BASKET TRAY POINT(2" CONDUIT REQUIRED) BY DIVISION 26
- AUTOMATIC DOOR OPERATOR
- SECURITY SYSTEM CAMERA DROP WITH RESOLUTION REQUIRED
- ACCESS CONTROL DOOR WITH DETAIL X / T105
- WALL MOUNT 4-PORT 2 DATA OUTLET INSTALLED @ 350mm (14") O.C. A.F.F. . UNLESS SPECIFIED OTHERWISE
- WALL MOUNT 4-PORT 2 DATA OUTLET INSTALLED @ 1525mm (60") O.C. A.F.F. . UNLESS SPECIFIED OTHERWISE
- FLOOR MOUNT COMMUNICATIONS OUTLET. COORDINATE LOCATIONS WITH ELECTRICAL.
- CEILING MOUNT DATA DROP FOR WIRELESS ACCESS POINT
- CONTROLLER LOCATION SEE ELEVATION DETAIL
- 300mm (12")W x 100mm (4")H WIRE BASKET TRAY OR 457mm (18")W x 100mm (4")H WIRE BASKET TRAY BY VESTIBULE 117 BY DIVISION 26
- VERTICAL PATHWAY
- CONDUIT (WITH SI-ING) BY DIVISION 26
- DURESS ALARM LOCATION
- CODE BLUE STATION LOCATION
- DURESS ALARM SYSTEM ANNUNCIATOR PANEL LOCATION

- NOTES:**
1. ALL CABLING TO END POINTS, TO BE CONTAINED IN CONDUIT AND HOME RUN TO THE WIRE BASKET TRAY. SEE T100 FOR CONDUIT SI-ING AND JUNCTION BOX SI-ING
 2. EXACT PLACEMENT OF DURESS BUTTON IS TO BE COORDINATED WITH THE CLIENT PRIOR TO GYPSUM INSTALLATION.
 3. ALLOW FOR SECURITY CAMERAS TO HAVE +/- 25M OF MOVEMENT
 4. COMMUNICATIONS CONTRACTOR TO COORDINATE WITH DIVISION 26 FOR SI-ING OF FLOOR BOX AND FILLER PLATES FOR DATA AND AV JACKS

- CONSTRUCTION NOTES:**
- DATA DROP TO BE ABOVE MILLWORK OR EASILY ACCESSIBLE THROUGH MILLWORK. EXACT LOCATION TO BE DETERMINED ON SITE
 - POSSIBLE LOCATION FOR 204A(-)3. TBD AT LATER DATE.
 - PREPARE FOR FUTURE CARD READER

1 B-WING FLOOR 1 LAYOUT
T108 SCALE: 1:100

CONTRACTOR TO COORDINATE ON SITE EXACT LOCATIONS WITH BUILDING OWNER, BUILDING OWNERS FURNITURE SYSTEM LAYOUTS AND ALL MILLWORK PRIOR TO START OF WORK AND INSTALLATION OF ANY POWER AND/OR TELECOM DATA OUTLETS IN ALL ROOMS.

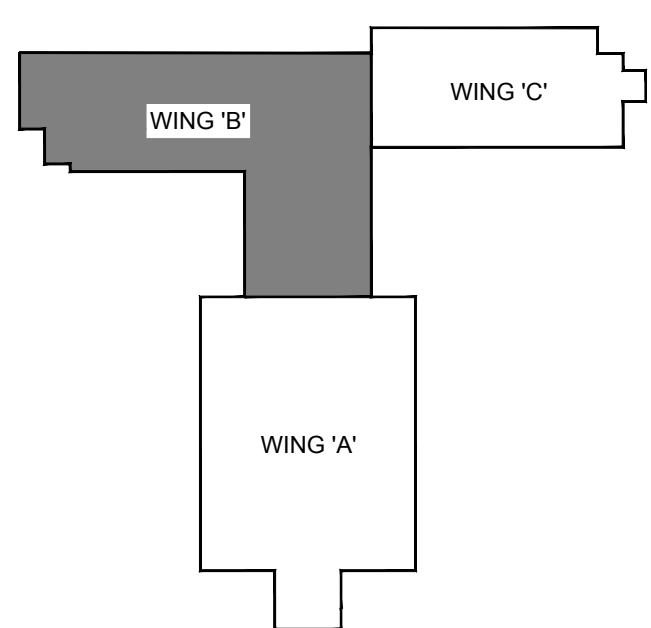

Key Plan

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Orientation	
Seal	

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Project

BUILDING #046 RENOVATIONS

Drawing Title

B-WING FLOOR 1 LAYOUT

Project No.

504034

Location

UNIVERSITY OF GUELPH BUILDING #046

Scale	AS SHOWN	Date	NOV 2, 2018
Drawn by	K.C.	Drawing No.	T102
Checked By	D.C.		
Approved By	B.W.		
JLR #			
Cad File No.			



1 B-WING FLOOR 2 LAYOUT
T103 SCALE: 1:100

CONTRACTOR TO COORDINATE ON SITE EXACT LOCATIONS WITH BUILDING OWNER, BUILDING OWNERS FURNITURE SYSTEM LAYOUTS AND ALL MILLWORK PRIOR TO START OF WORK AND INSTALLATION OF ANY POWER AND/OR TELECOM DATA OUTLETS IN ALL ROOMS.

LEGEND


- VCAP PATHWAY LOCATION FROM CLOSEST WIRE BASKET TRAY POINT(2" CONDUIT REQUIRED) BY DIVISION 26
- AUTOMATIC DOOR OPERATOR
- SECURITY SYSTEM CAMERA DROP WITH RESOLUTION REQUIRED
- ACCESS CONTROL DOOR WITH DETAIL X / T105
- WALL MOUNT 4-PORT 2 DATA OUTLET INSTALLED @ 350mm (14") O.C. A.F.F. , UNLESS SPECIFIED OTHERWISE
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- VERTICAL PATHWAY
- CONDUIT (WITH S.I.-ING) BY DIVISION 26
- DURESS ALARM LOCATION
- CODE BLUE STATION LOCATION
- DURESS ALARM SYSTEM ANNUNCIATOR PANEL LOCATION

NOTES:

1. ALL CABLING TO END POINTS, TO BE CONTAINED IN CONDUIT AND HOME RUN TO THE WIRE BASKET TRAY. SEE T100 FOR CONDUIT SIZING AND JUNCTION BOX SIZING
2. EXACT PLACEMENT OF DURESS BUTTON IS TO BE COORDINATED WITH THE CLIENT PRIOR TO GYPSUM INSTALLATION.
3. ALLOW FOR SECURITY CAMERAS TO HAVE +/- 25M OF MOVEMENT
4. COMMUNICATIONS CONTRACTOR TO COORDINATE WITH DIVISION 26 FOR SIZING OF FLOOR BOX AND FILLER PLATES FOR DATA AND AV JACKS. FLOOR BOXES TO BE POKE THROUGH.

CONSTRUCTION NOTES:

- DATA DROP TO BE ABOVE MILLWORK OR EASILY ACCESSIBLE THROUGH MILLWORK. EXACT LOCATION TO BE DETERMINED ON SITE
- RECESSED WALL ENCLOSURE CONTAINING POWER SUPPLY FOR MAG LOCKS BESIDE ELECTRICAL PANELS.

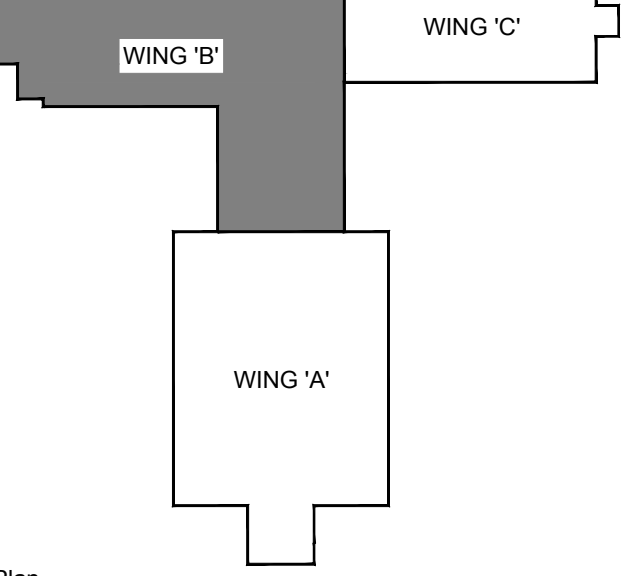

Key Plan

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Orientation	
Seal	

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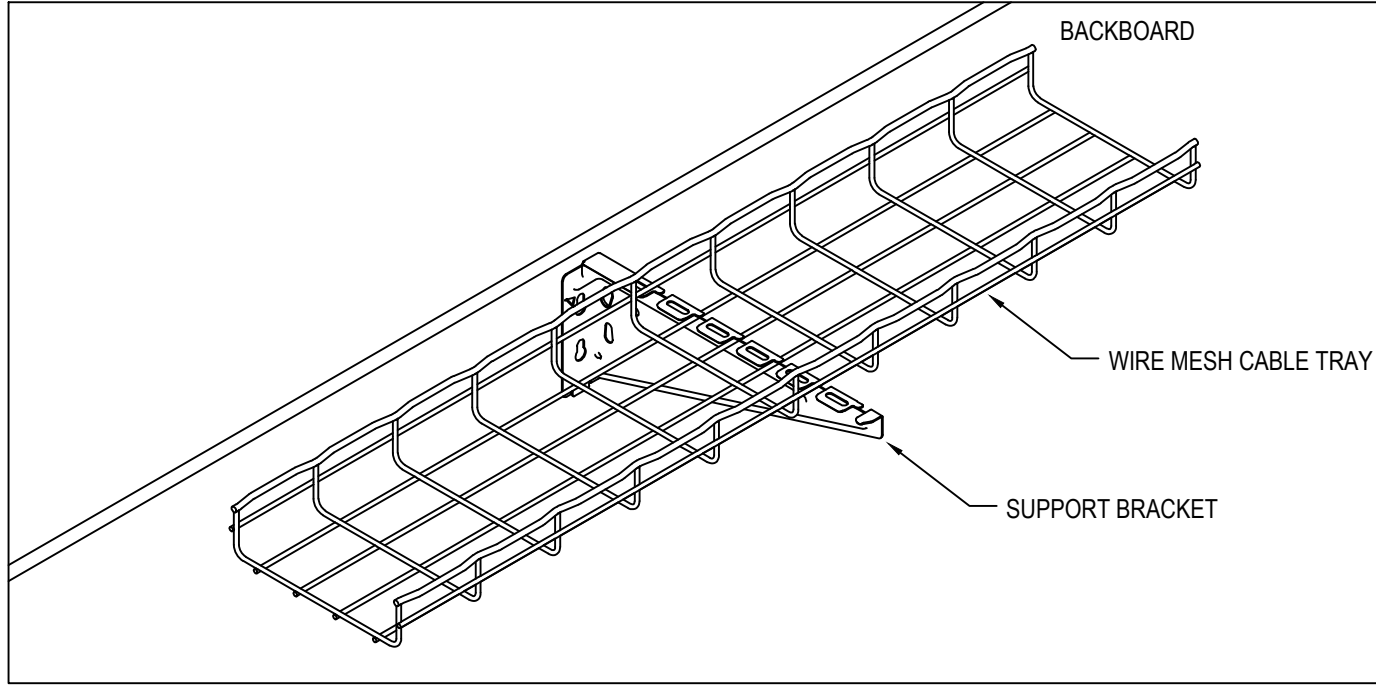
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Project
BUILDING #046 RENOVATIONS


Drawing Title
B WING FLOOR 2 LAYOUT

Project No.
504034


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Scale AS SHOWN	Date NOV 2, 2018
Drawn by K.C.	Drawing No. T103




1 CABLE TRAY SUPPORT
T104 SCALE: N.T.S.

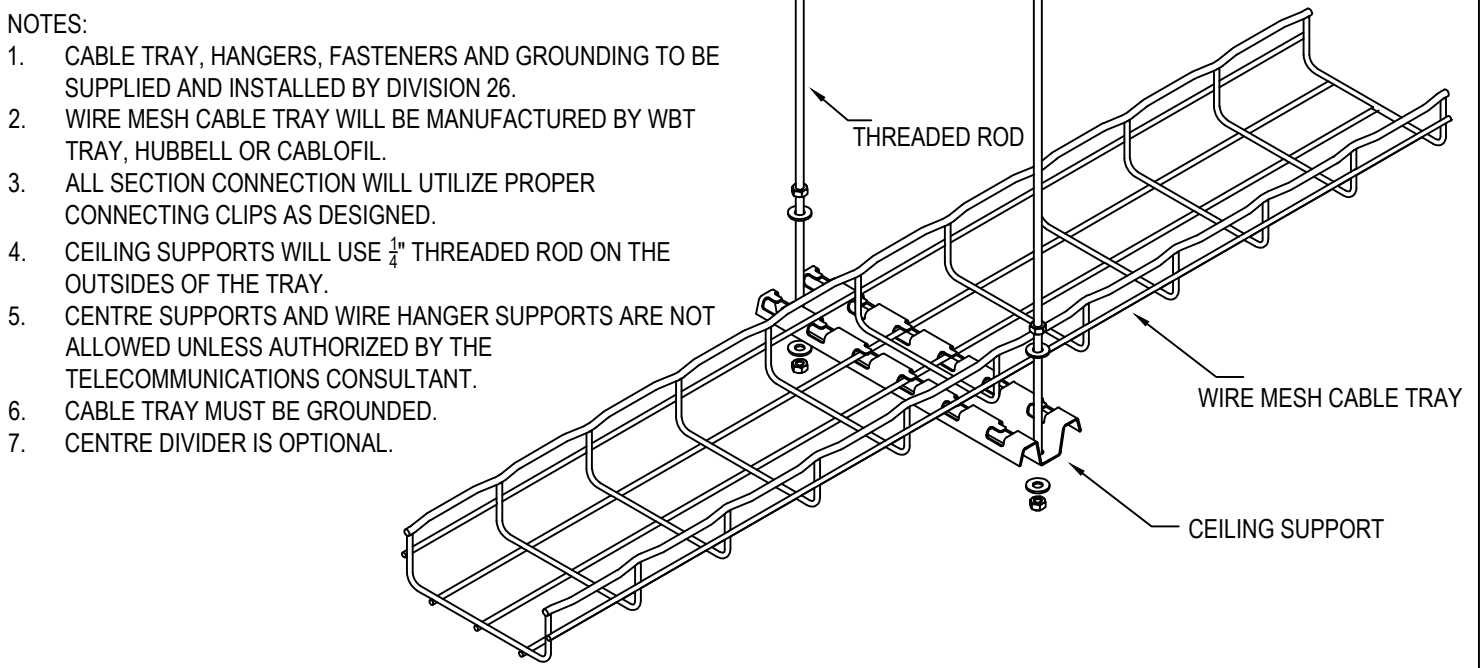


2 CABLE TRAY DETAIL
T104 SCALE: N.T.S.

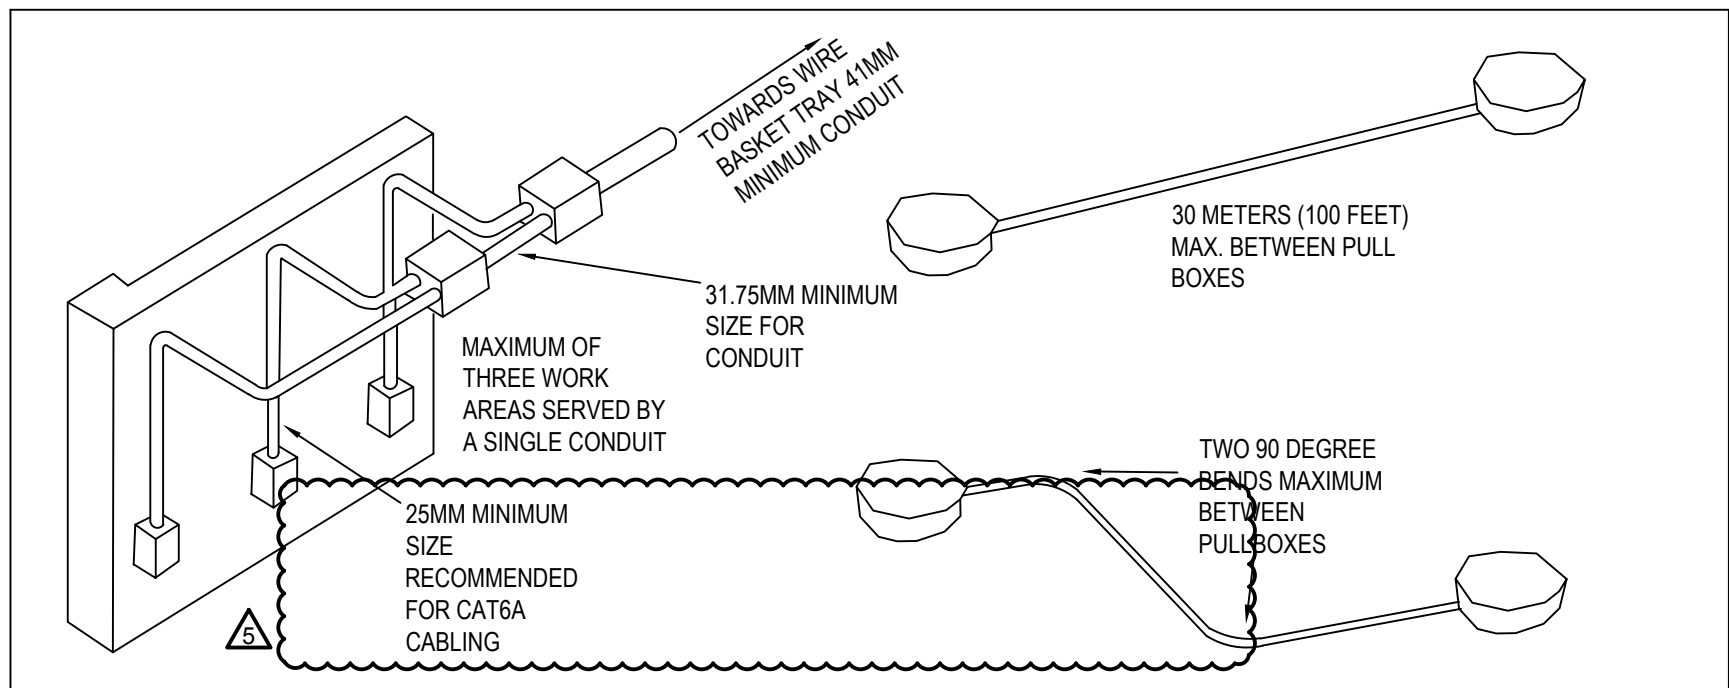


3 COMMUNICATIONS CONDUIT AND PULLBOX INSTRUCTIONS
T104 SCALE: N.T.S.

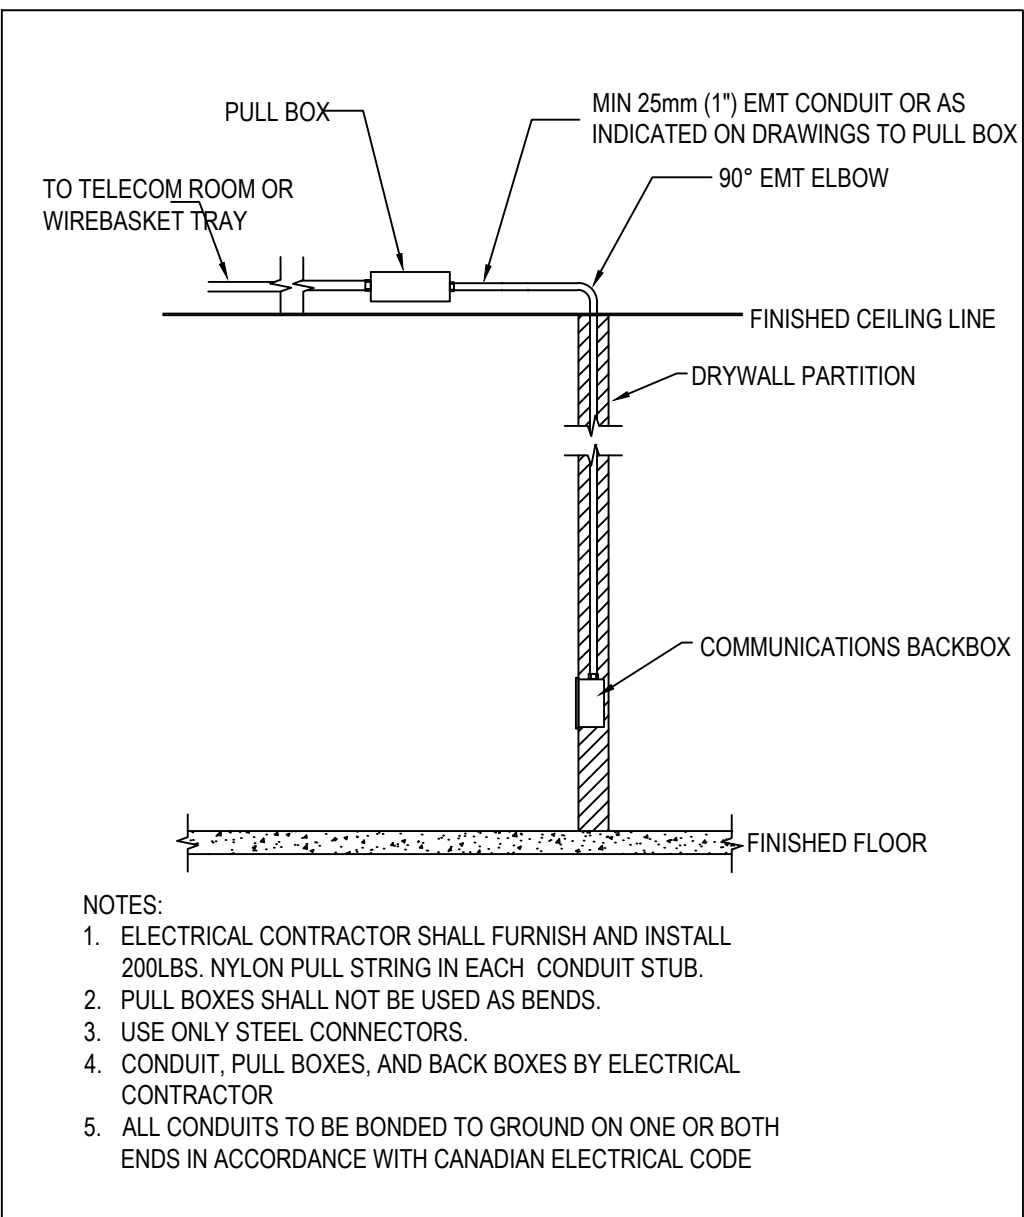


4 FLUSHED-MOUNT OUTLET DETAILS
T104 SCALE: N.T.S.

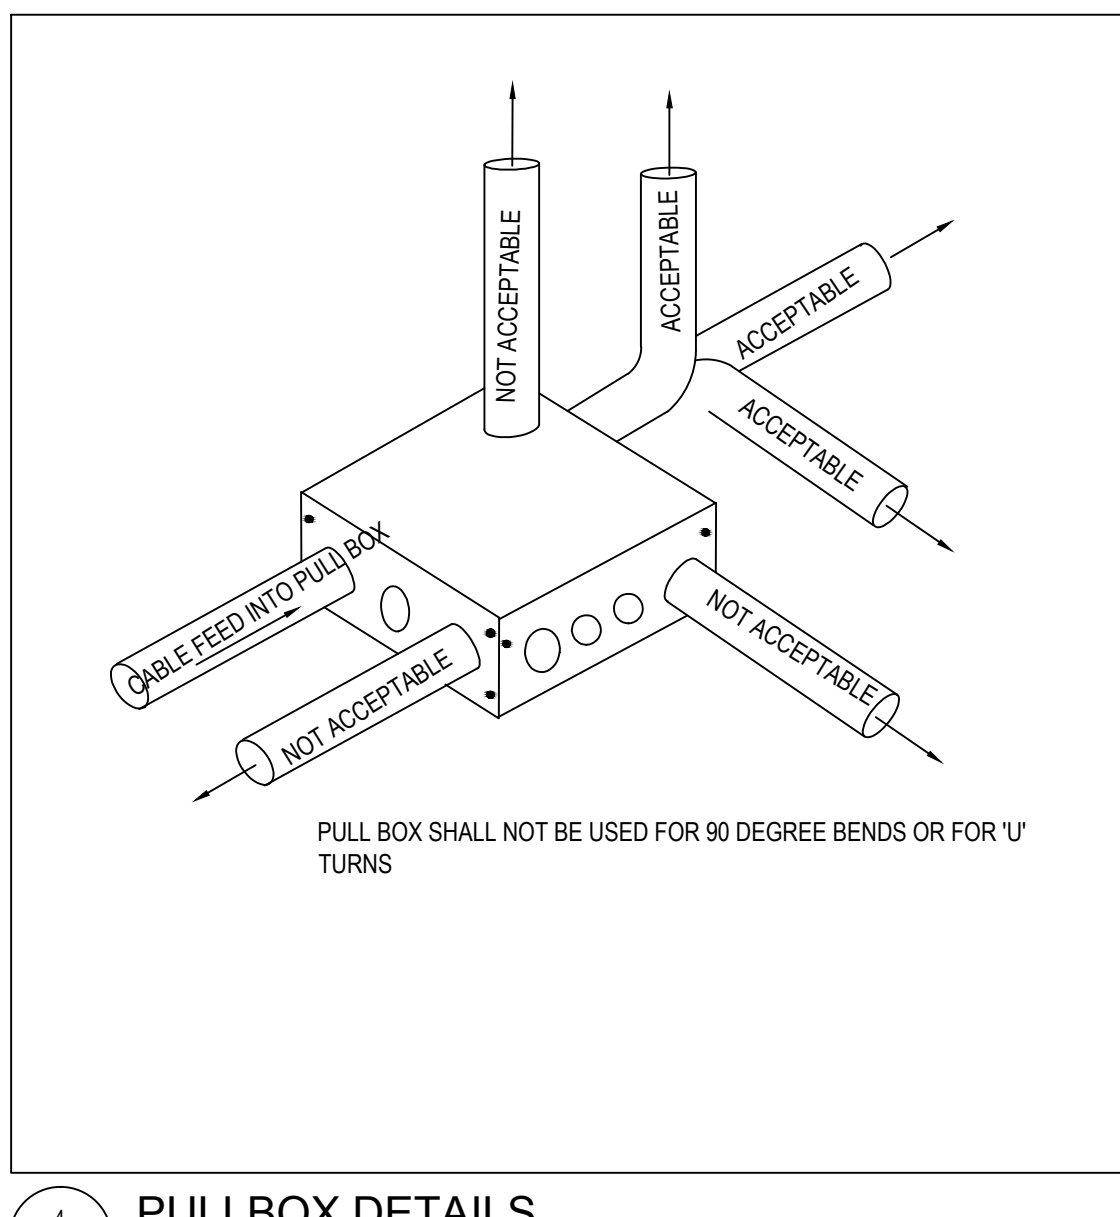


5 PULLBOX DETAILS
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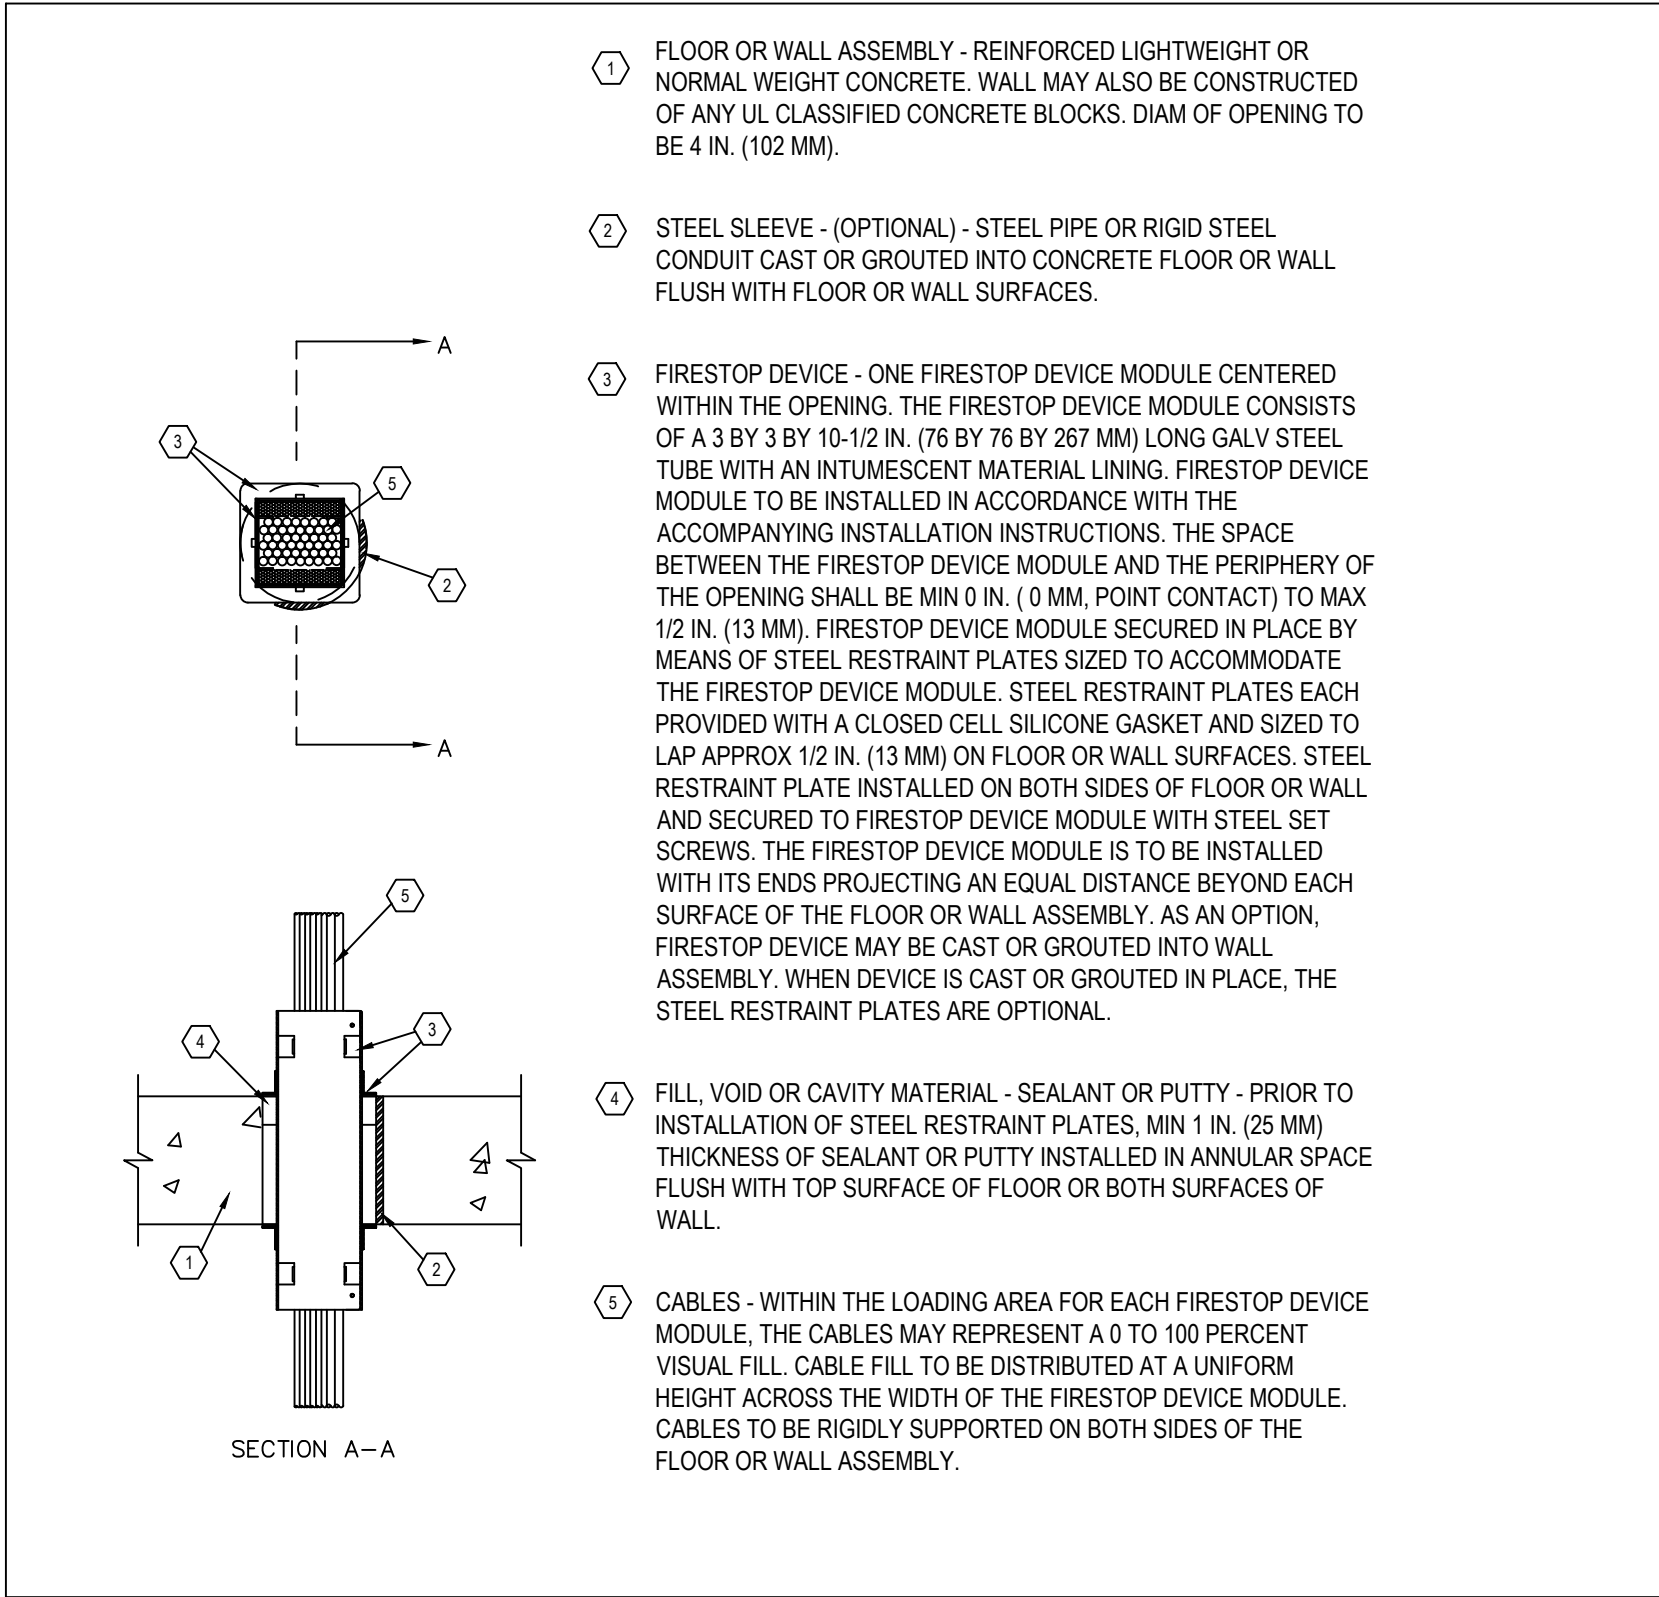
6 PA SPEAKERS ELEVATION
T104 SCALE: N.T.S.

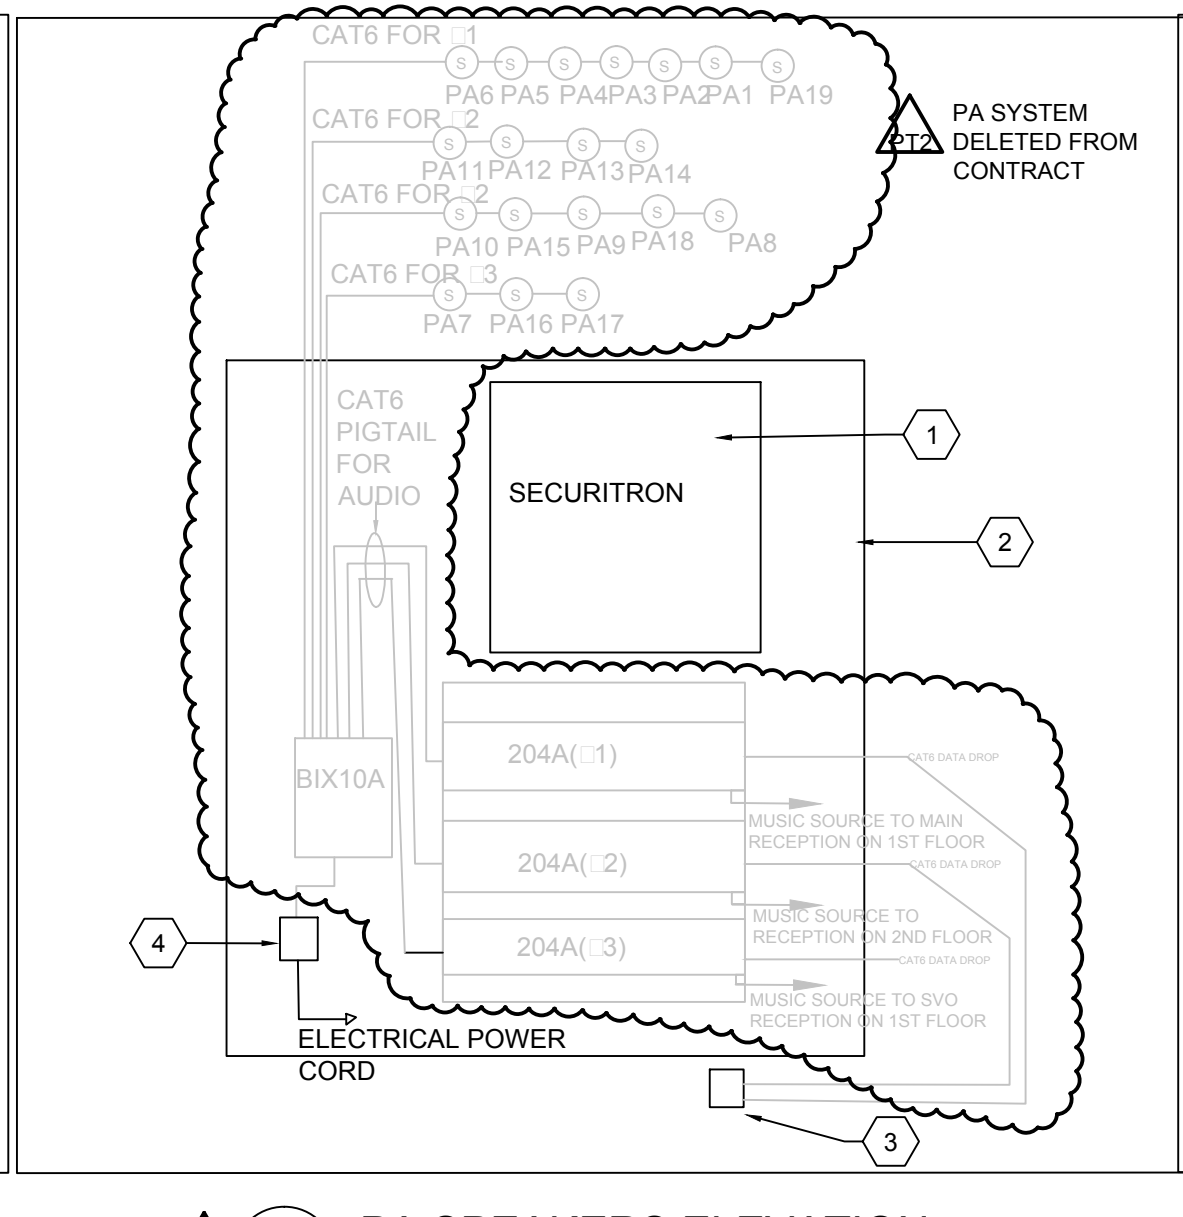


7 CONDUIT ENTRY INTO CABLE TRAY 1
T104 SCALE: N.T.S.

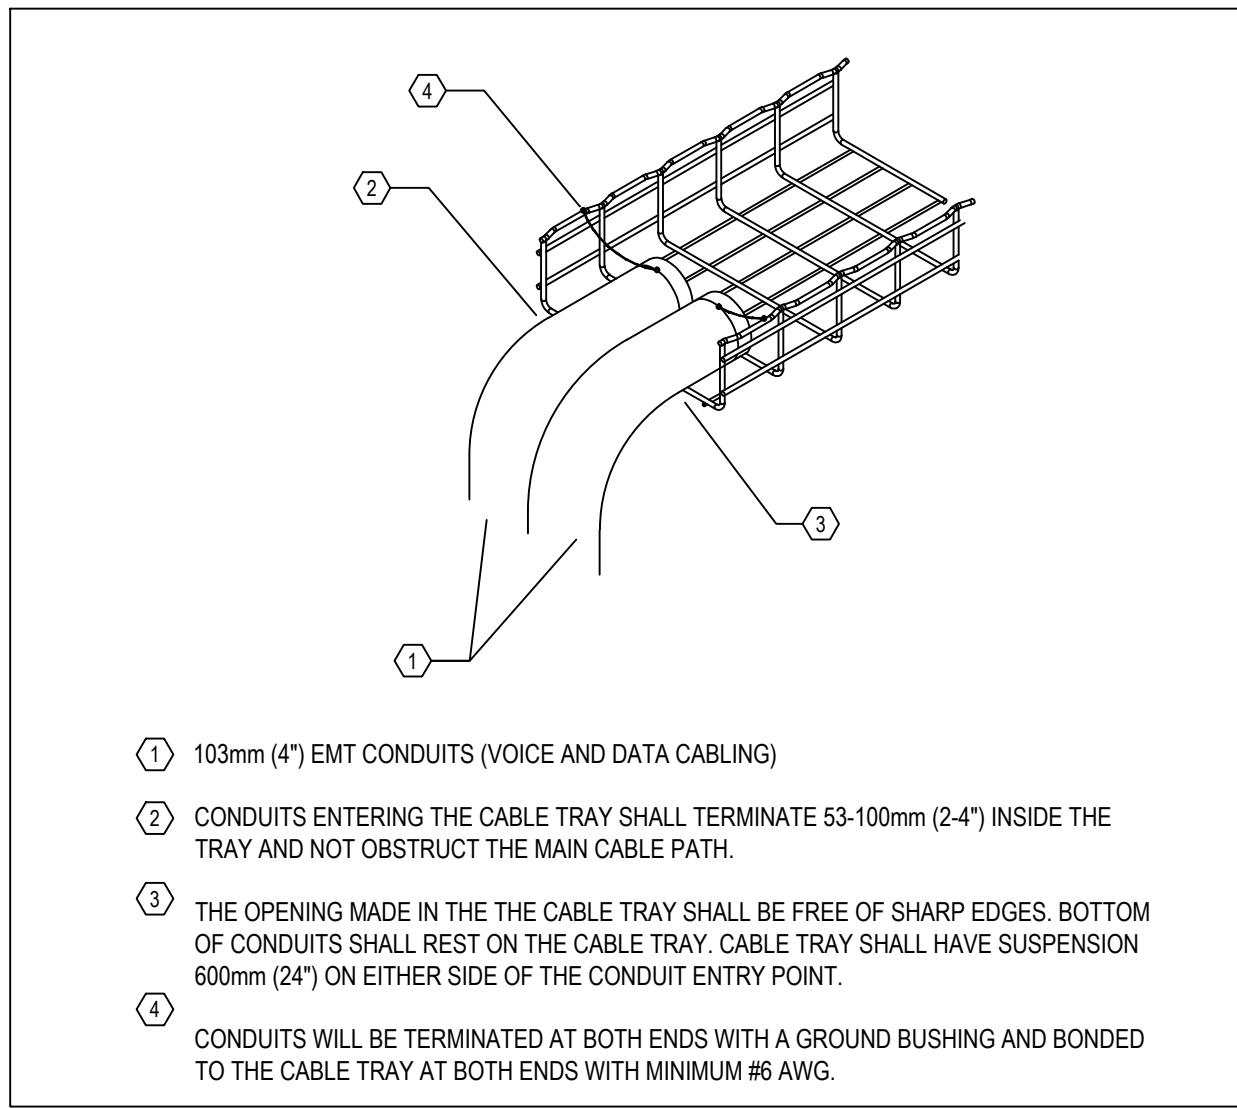

8 CONDUIT ENTRY INTO CABLE TRAY 2
T104 SCALE: N.T.S.

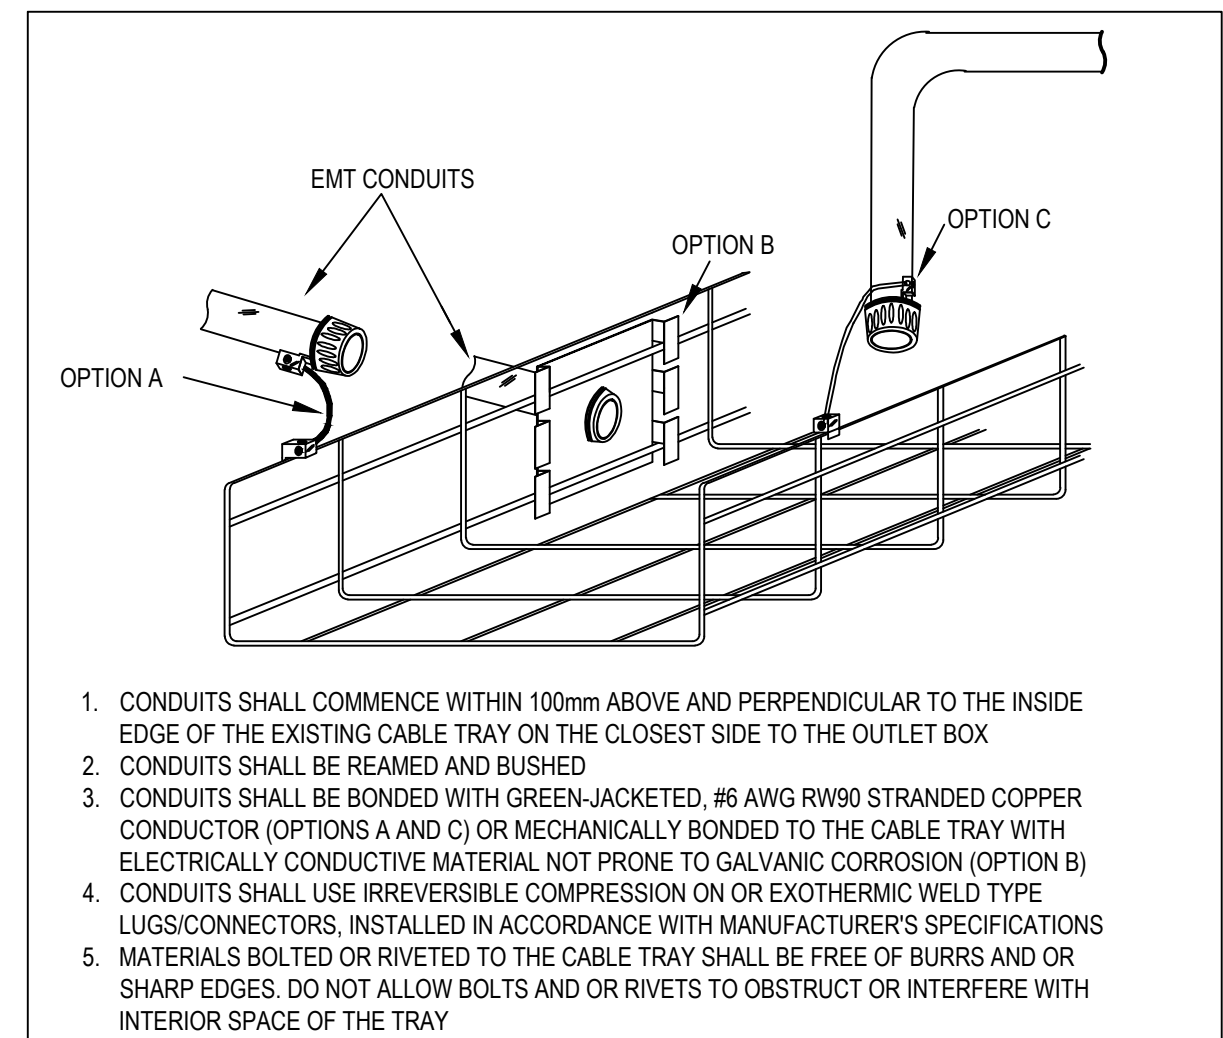

9 CONDUIT FIRESTOPPING DETAILS
T104 SCALE: N.T.S.

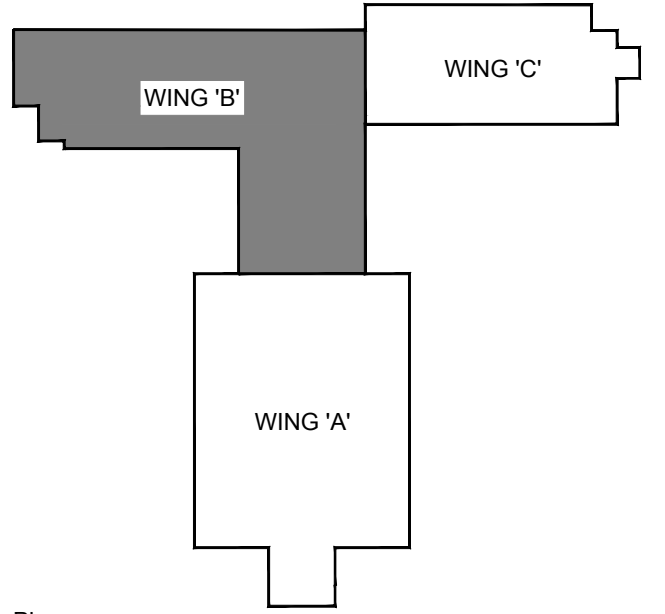

Key Plan
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Orientation	
Seal	Seal

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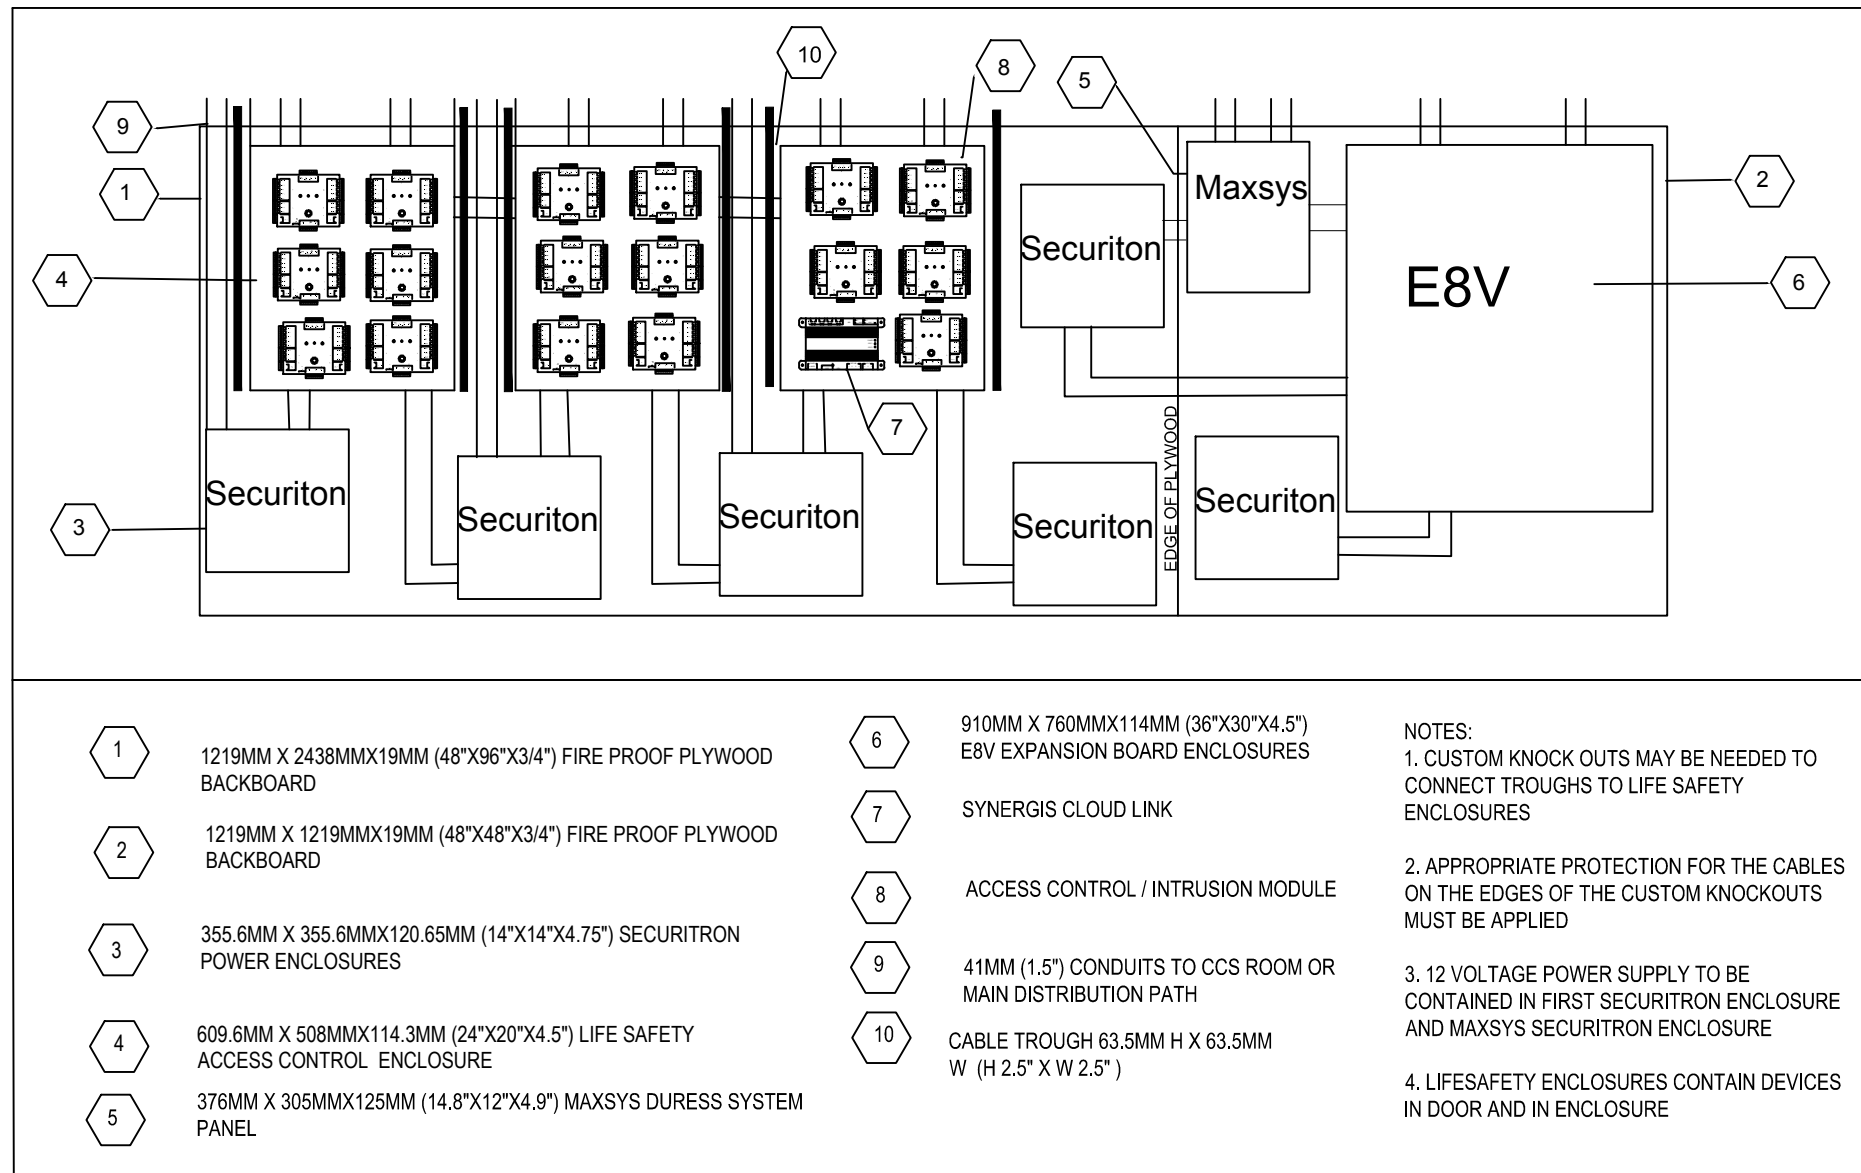
Project
BUILDING #046 RENOVATIONS

Drawing Title
PATHWAYS DETAILS

Project No.
504034


Location
UNIVERSITY OF GUELPH BUILDING #046

Scale AS SHOWN	Date NOV 2, 2018
Drawn by K.C.	Drawing No. T104
Checked By D.C.	
Approved By B.W.	
JLR #	
Cad File No.	of




1 ACCESS CONTROL AND SECURITY ELECTRICAL ROOM ELEVATION

SCALE: N.T.S.

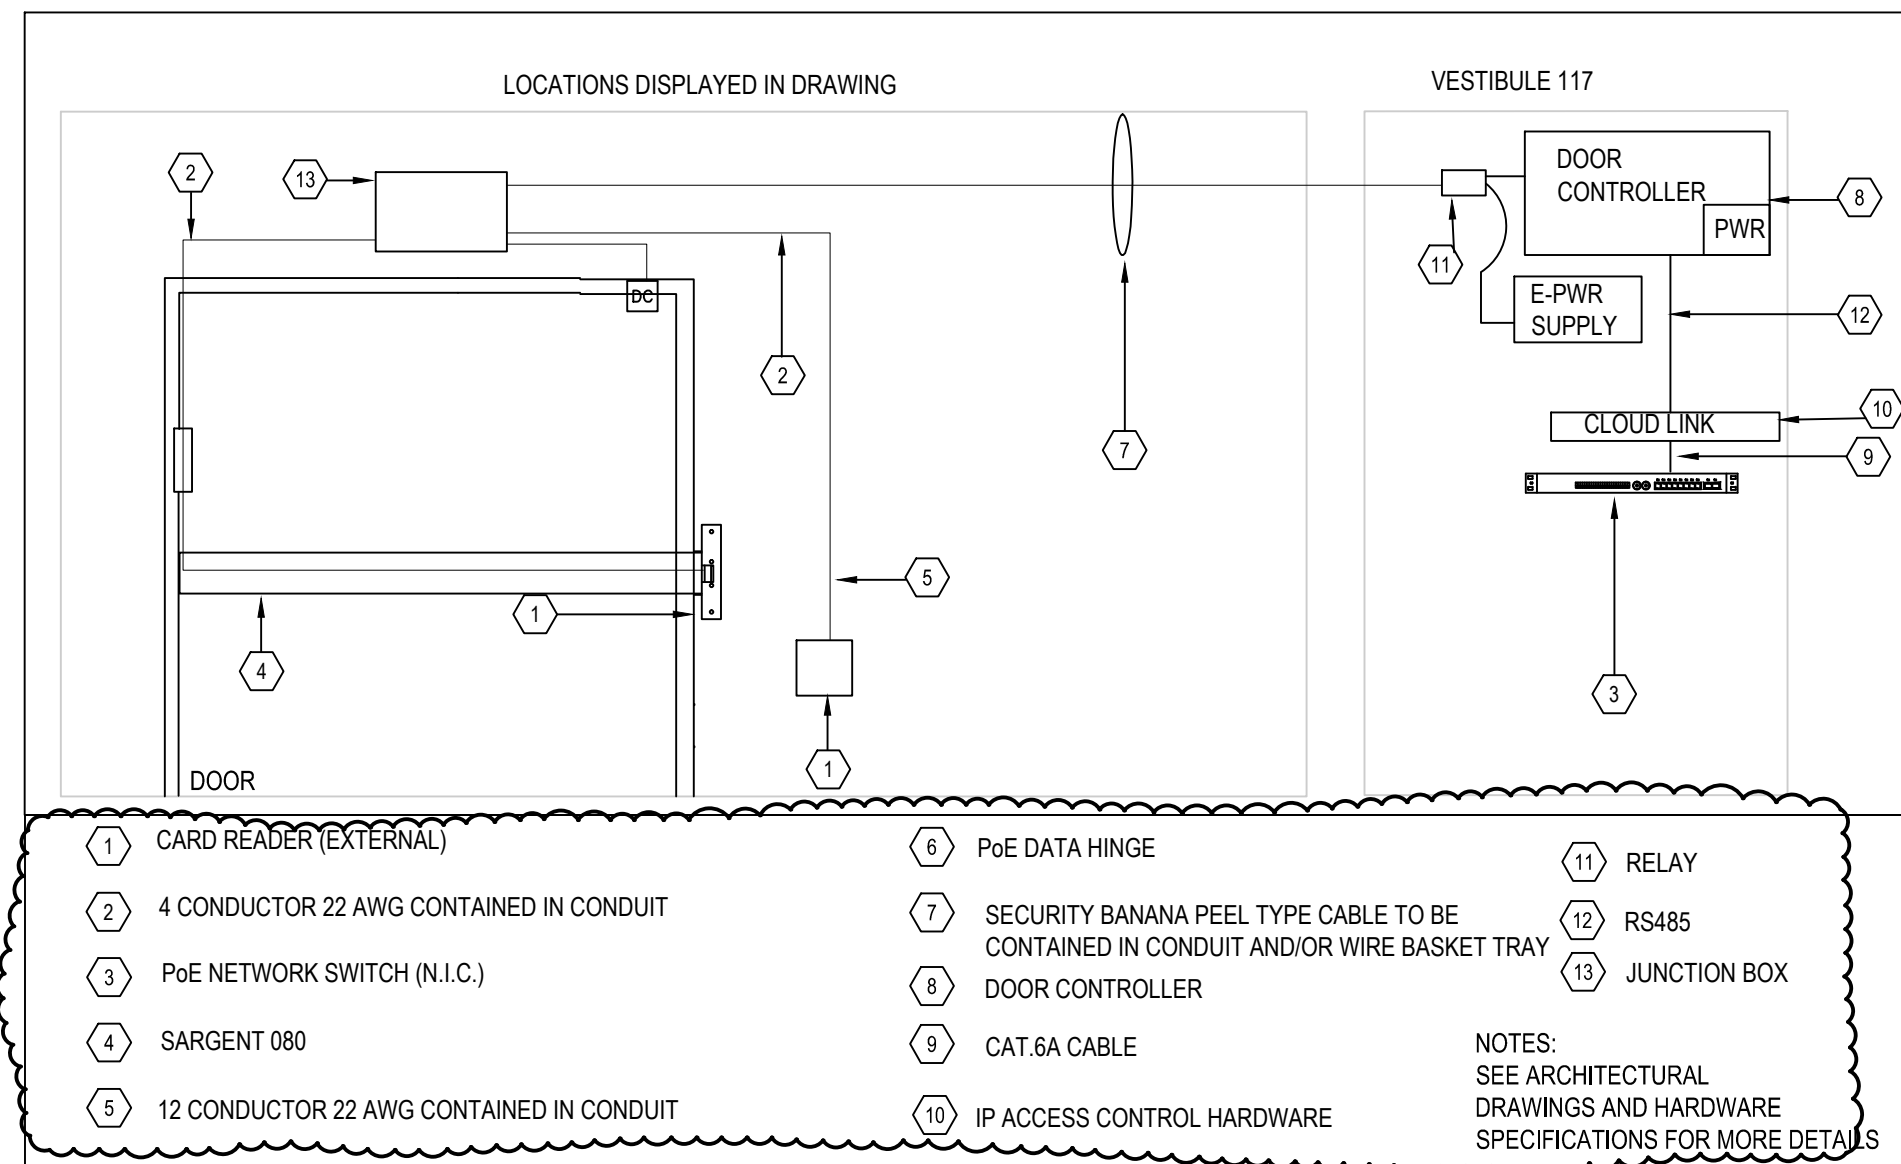


2 ACCESS CONTROL SARGENT 080

SCALE: N.T.S.

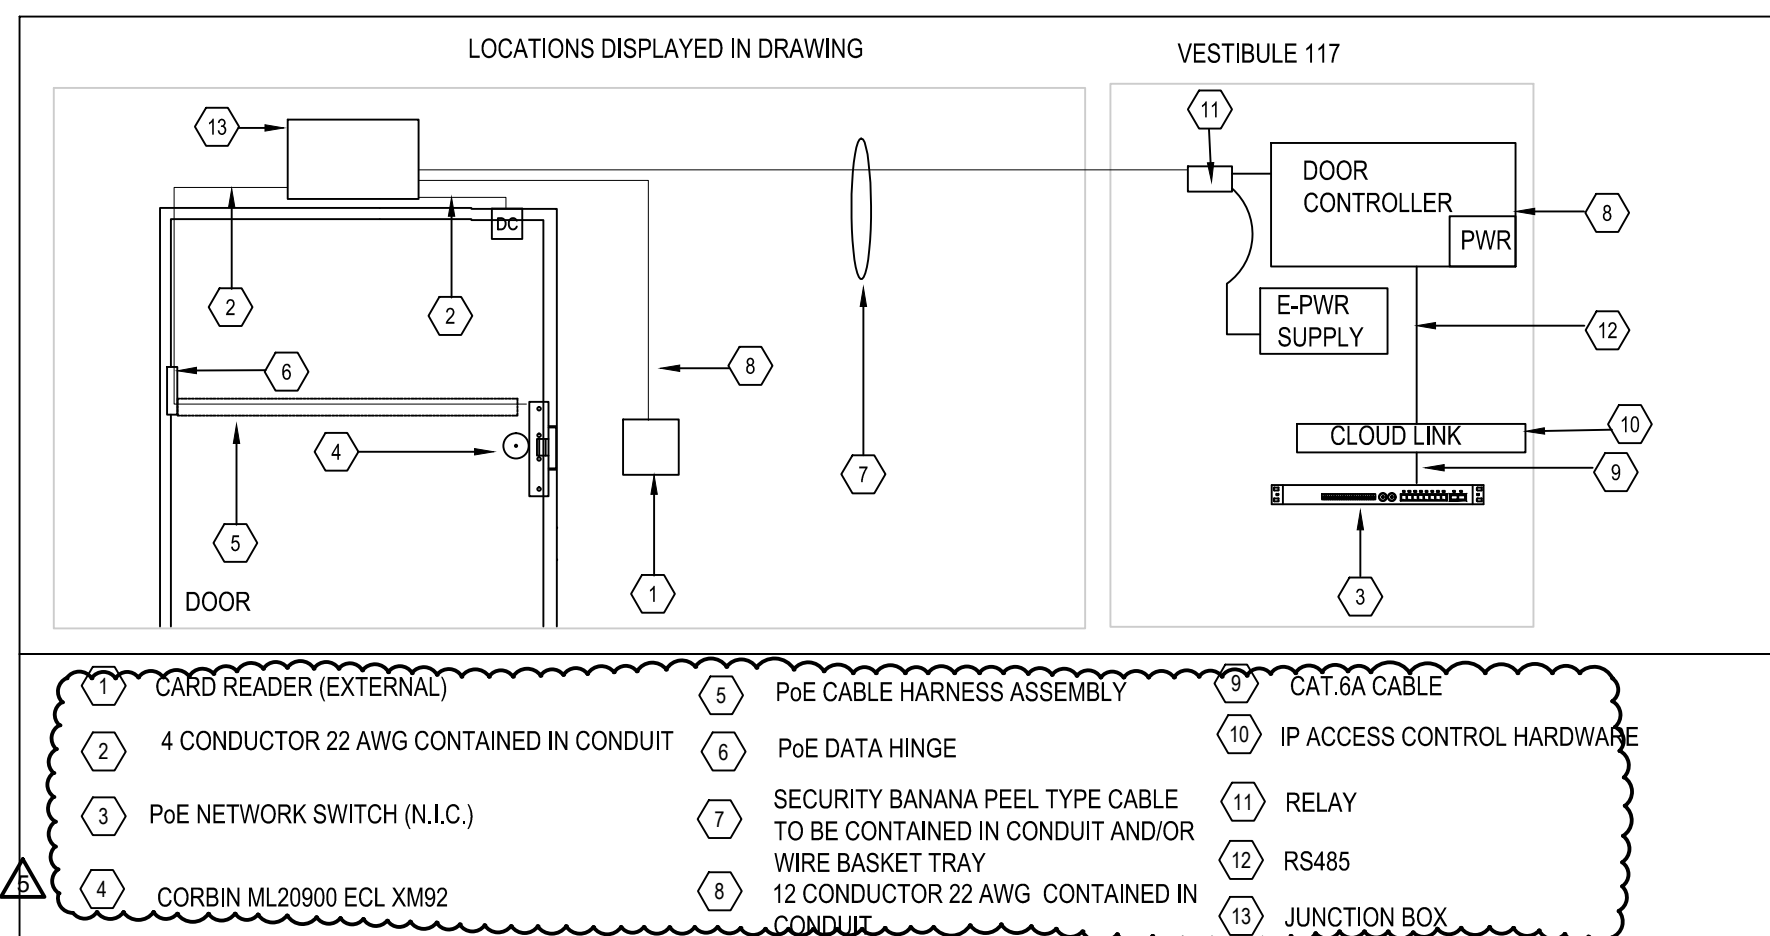


3 ACCESS CONTROL CORBIN ML20900

SCALE: N.T.S.

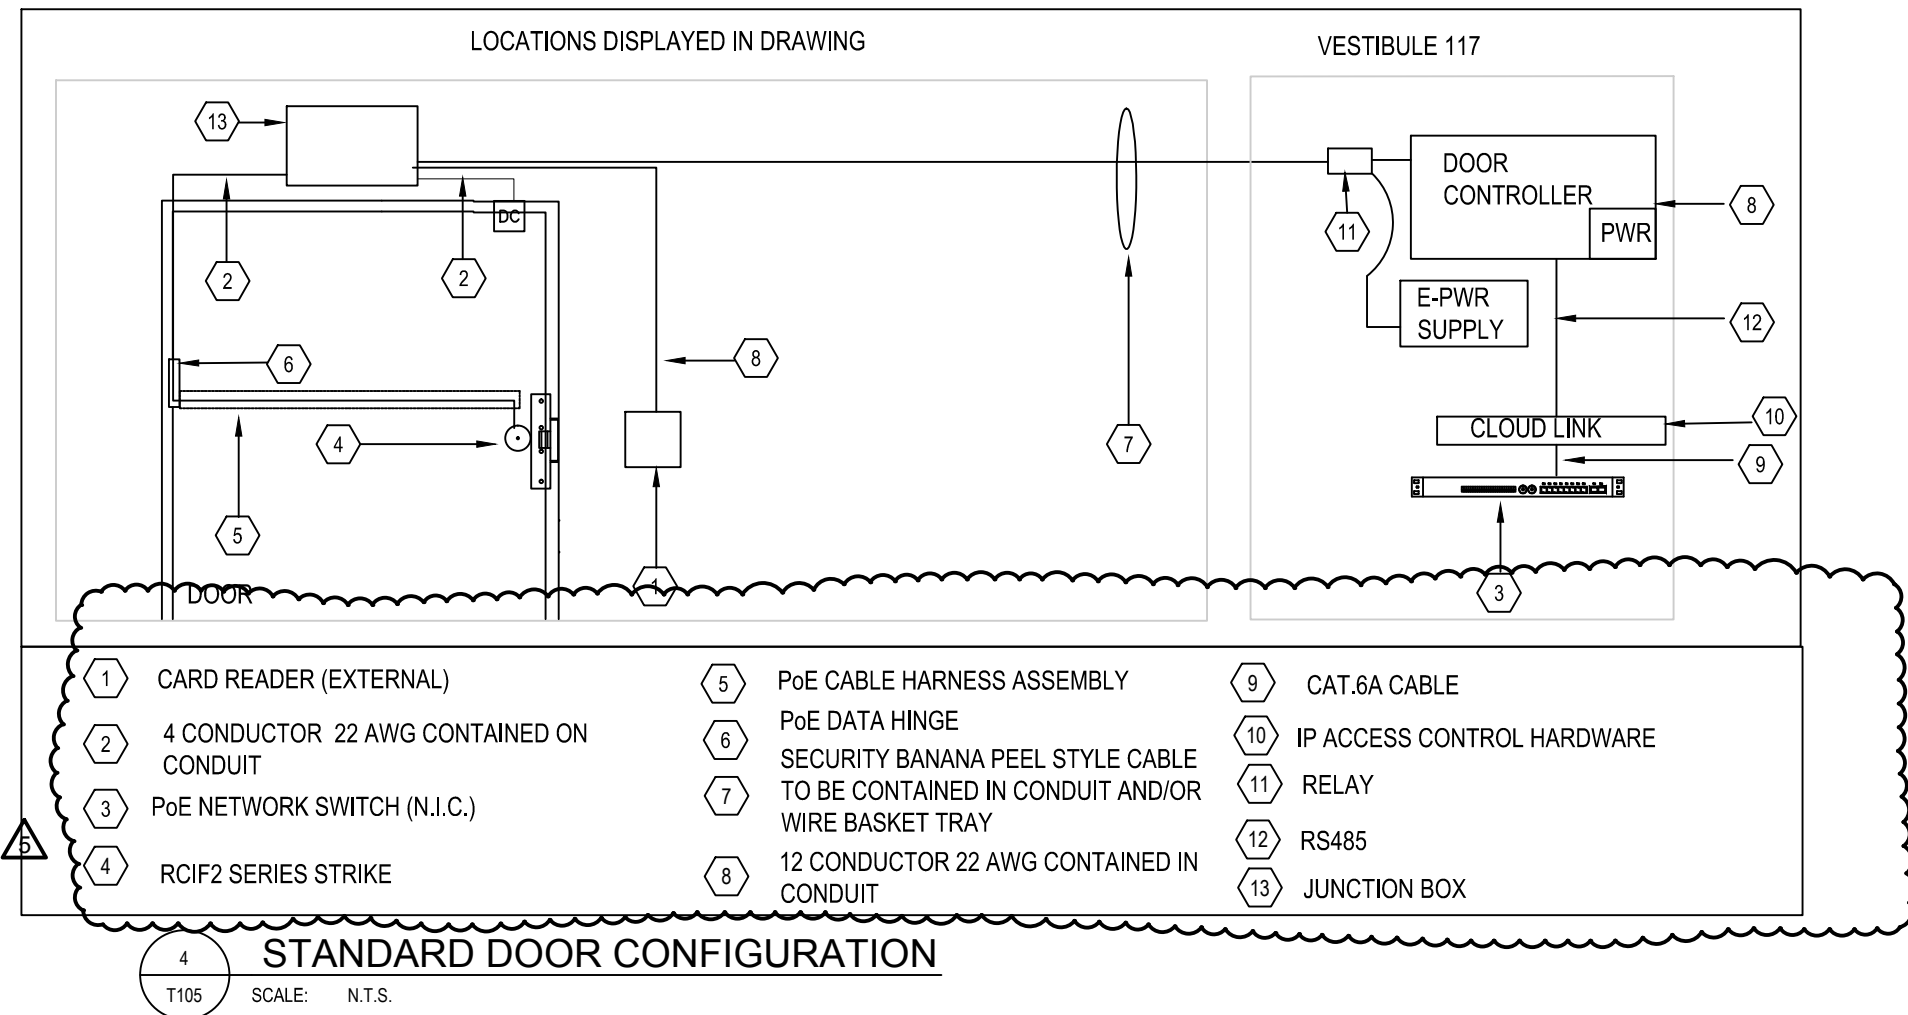


4 STANDARD DOOR CONFIGURATION

SCALE: N.T.S.

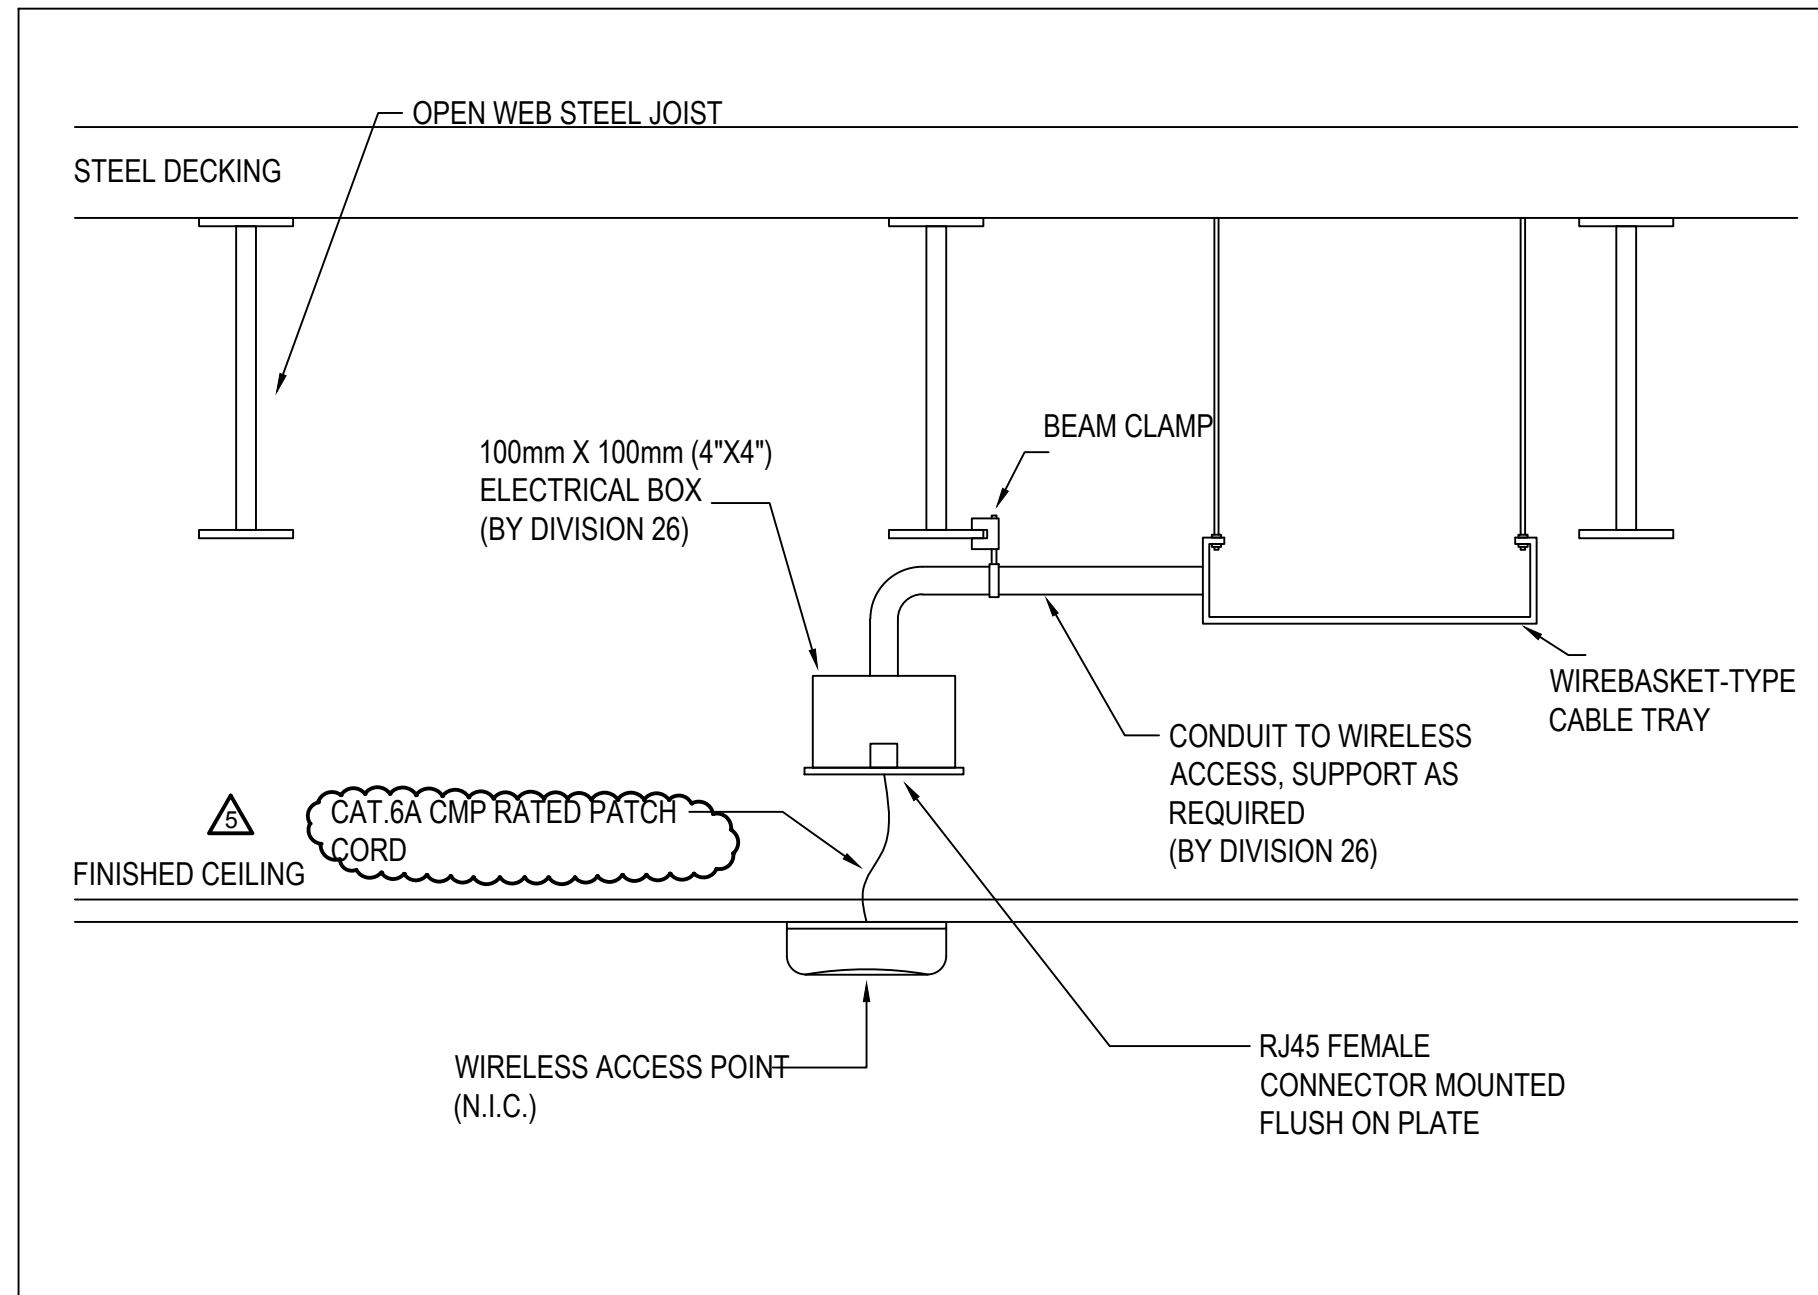


5 WIRELESS ACCESS POINT INSTALLATION

SCALE: N.T.S.

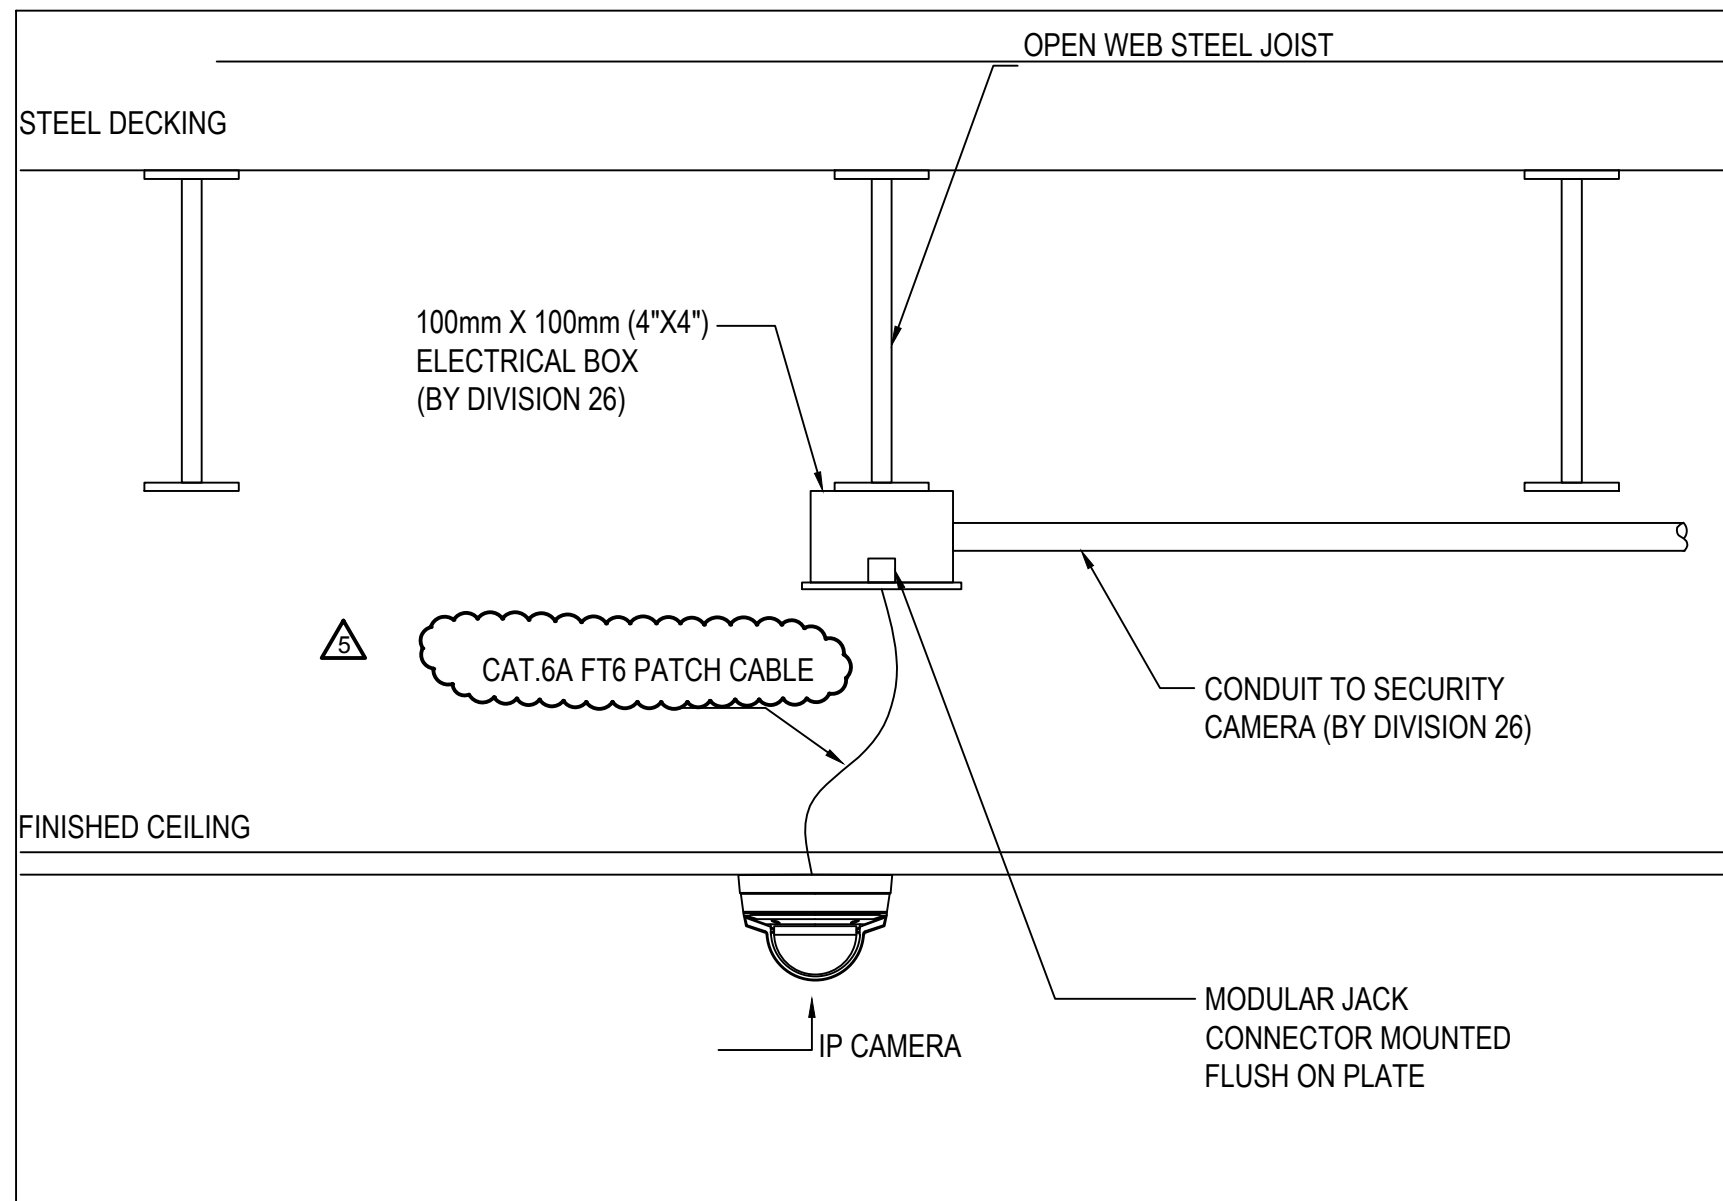


6 ROOF CAMERA OUTLET

SCALE: N.T.S.

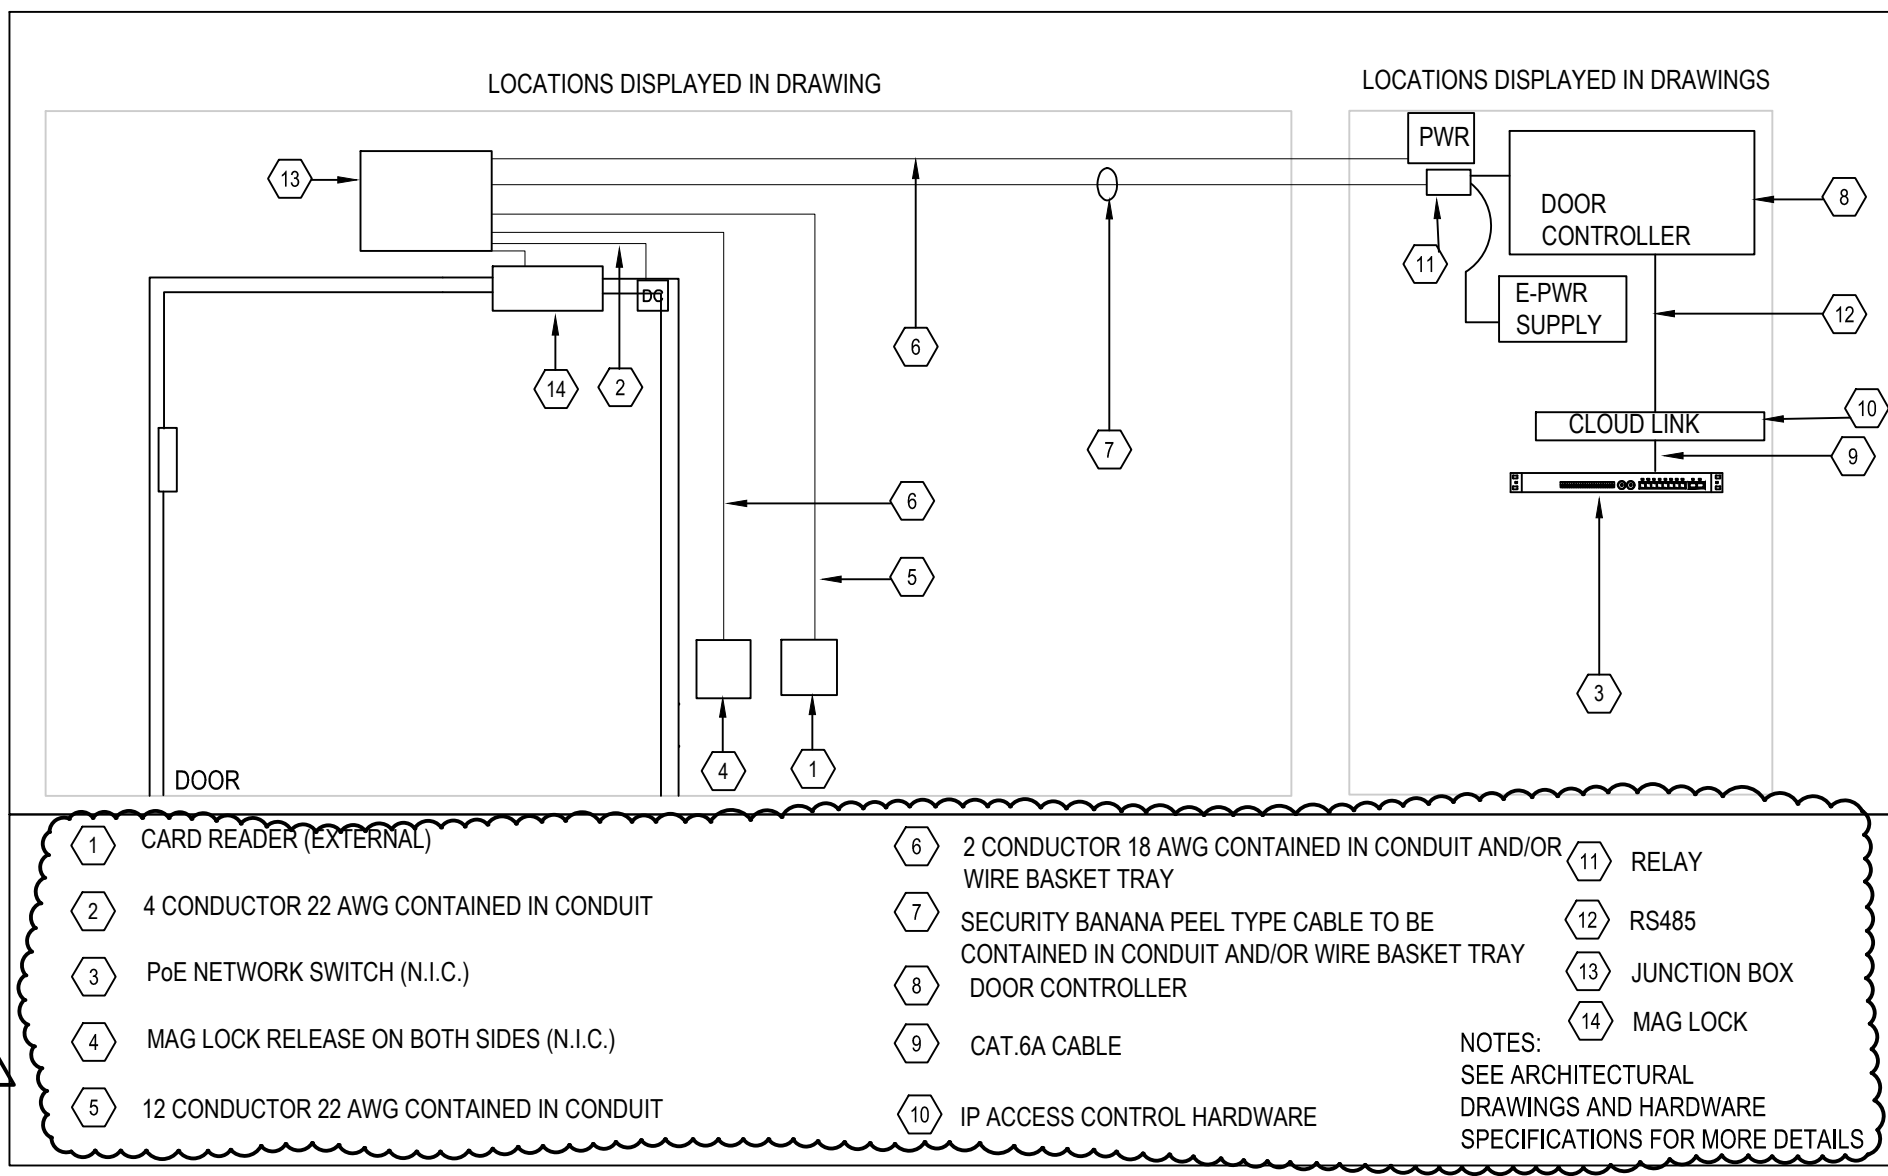


8 ACCESS CONTROL SARGENT 080 WITH MAG LOCK

SCALE: N.T.S.

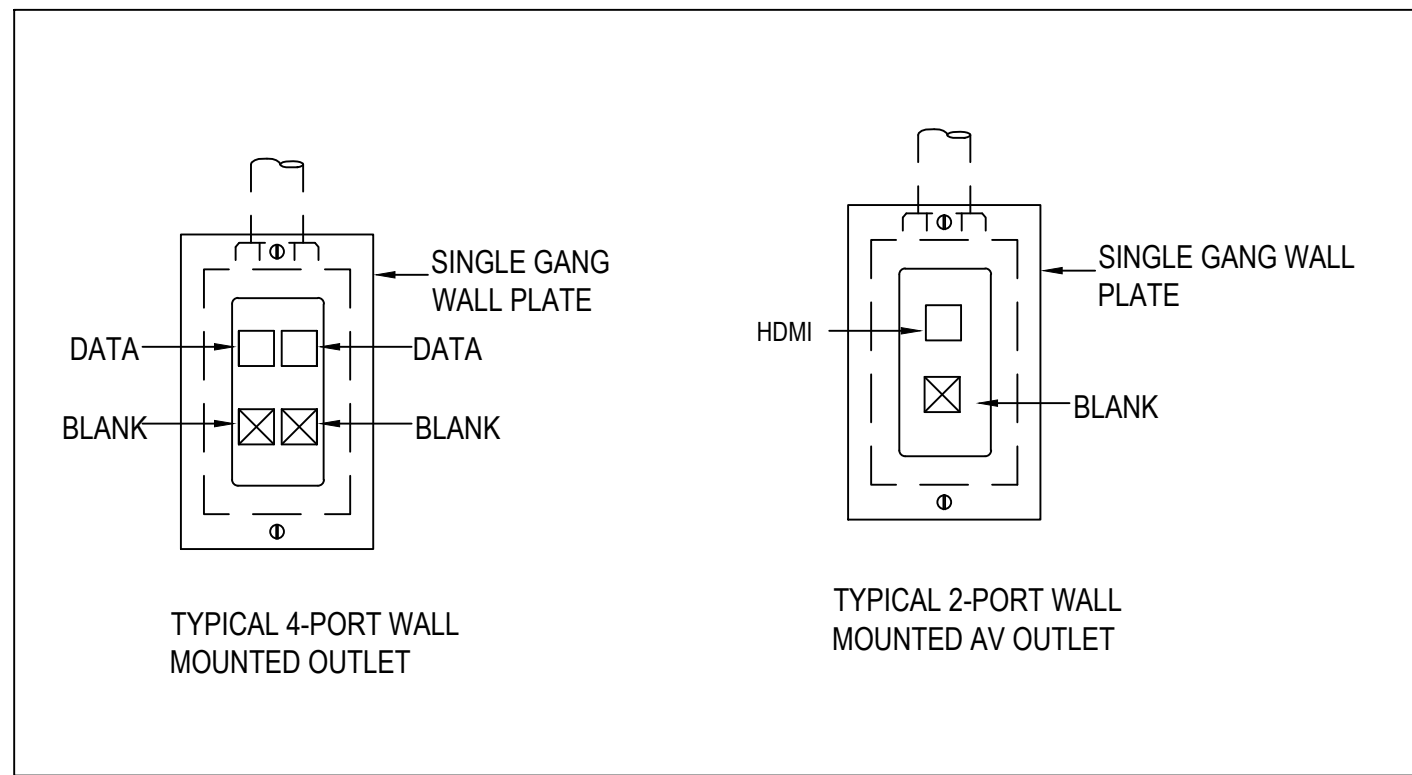

7 OUTLET DETAILS

SCALE: N.T.S.

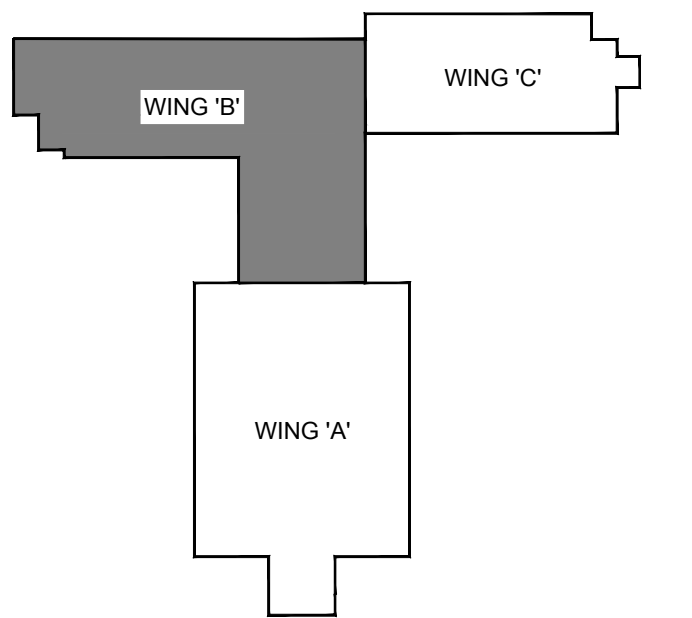

Key Plan

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NO.	ISSUED	BY	DATE

Orientation	
Seal	Seal

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Project
BUILDING #046 RENOVATIONS

Drawing Title
INSTALLATIONS DETAILS

Project No.
504034

Location
UNIVERSITY OF GUELPH BUILDING #046

Scale
AS SHOWN

Date
FEB 22, 2019

Drawn by
K.C.

Checked By
D.C.


Approved By
B.W.

JLR #

Cad File No.


T105

of

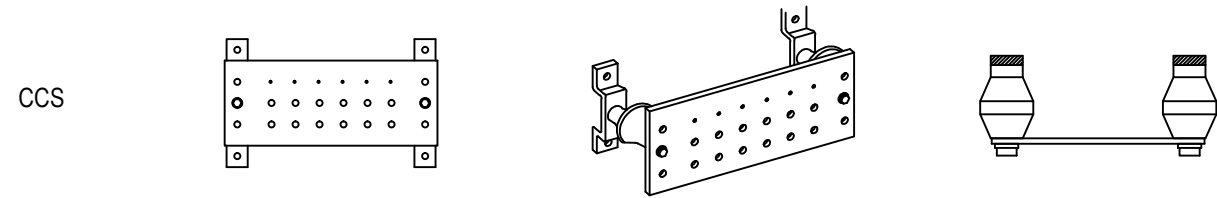

TYPICAL SERVER ROOM COPPER BUS BAR

AN INSULATED PRE-DRILLED ELECTRO TIN PLATED COPPER BUSBAR, MINIMUM DIMENSIONS OF 6MM THICK X 100MM WIDE X 300MM LONG (0.24" X 4" X 12"), (LONGER LENGTH MAY BE REQUIRED TO ACCOMMODATE LARGE OR FUTURE CONNECTION REQUIREMENTS), SHALL BE INSTALLED ON THE WALL OF THE CCS ADJACENT TO THE CABLE ENTRANCE CONDUITS, 150MM (6") FROM THE CORNER OF THE CCS AND 150MM (6") AFF. THIS BUSBAR IS KNOWN AS THE TELECOMMUNICATIONS MAIN GROUNDING BUSBAR (TMGB) AND SHALL BE INSULATED FROM ITS SUPPORT BY A MINIMUM OF 50MM (2").

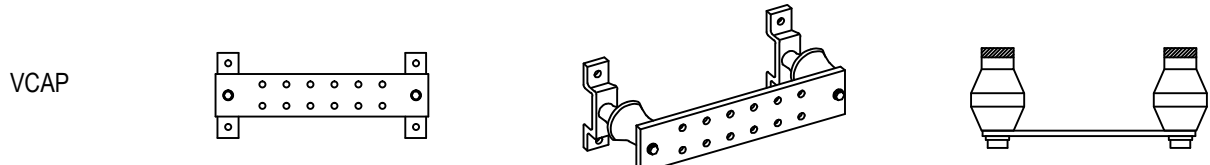


TYPICAL TR BUS BAR


AN INSULATED PRE-DRILLED ELECTRO TIN PLATED COPPER BUSBAR, MINIMUM DIMENSIONS OF 6MM THICK X 50MM WIDE X 255MM LONG (0.24" X 2" X 10"), (LONGER LENGTH MAY BE REQUIRED TO ACCOMMODATE LARGE OR FUTURE CONNECTION REQUIREMENTS), SHALL BE INSTALLED ON THE WALL OF EACH VCAP ROOM, ADJACENT TO THE CABLE ENTRANCE SLEEVES, 150MM (6") FROM THE CORNER OF THE VCAP ROOM AND 150MM (6") AFF. THESE BUSBARS ARE KNOWN AS THE TELECOMMUNICATIONS GROUNDING BUSBAR (TGB) AND SHALL BE INSULATED FROM ITS SUPPORT BY A MINIMUM OF 50MM (2").

NOTES:

- THE ELECTRICAL CONTRACTOR SHALL FURNISH AND INSTALL ONE MOUNTED GROUND BUS AT EACH VOICE/DATA EQUIPMENT ROOM.
- GROUND BUS BAR SHALL BE INSTALLED 150mm (6") AFF.
- ALL BRANCH GROUNDING WITHIN THE CCS AND VCAP ROOMS SHALL BE FURNISHED AND INSTALLED BY THE COMMUNICATIONS CONTRACTOR.
- THE ELECTRICAL CONTRACTOR SHALL PROVIDE A GROUND CONNECTION BETWEEN THE BASE BUILDING SERVICE ENTRANCE GROUNDING ELECTRODE AND THE MDF GROUND BUS. ALSO PROVIDE A GROUND CONNECTION BETWEEN THE MDF AND IDF GROUND BUSES (WHERE REQUIRED).
- ALL GROUNDING TERMINATIONS SHALL BE DONE WITH U.L. LISTED HYPRESS LUGS AND GROUNDING CLAMPS.
- TGB TO BE LOCATED IN CCS ROOM.

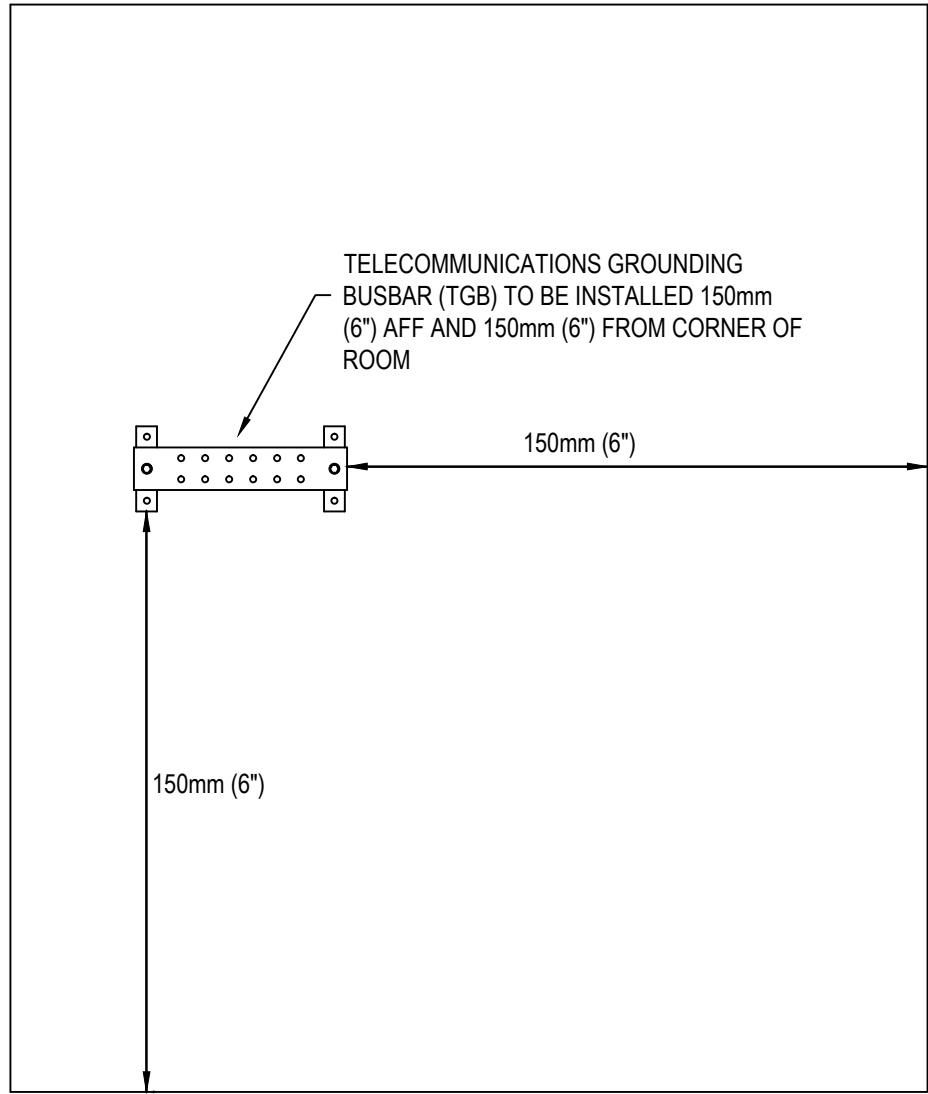


3 BUS BAR INSTALLATION DETAIL
T106 SCALE: N.T.S.

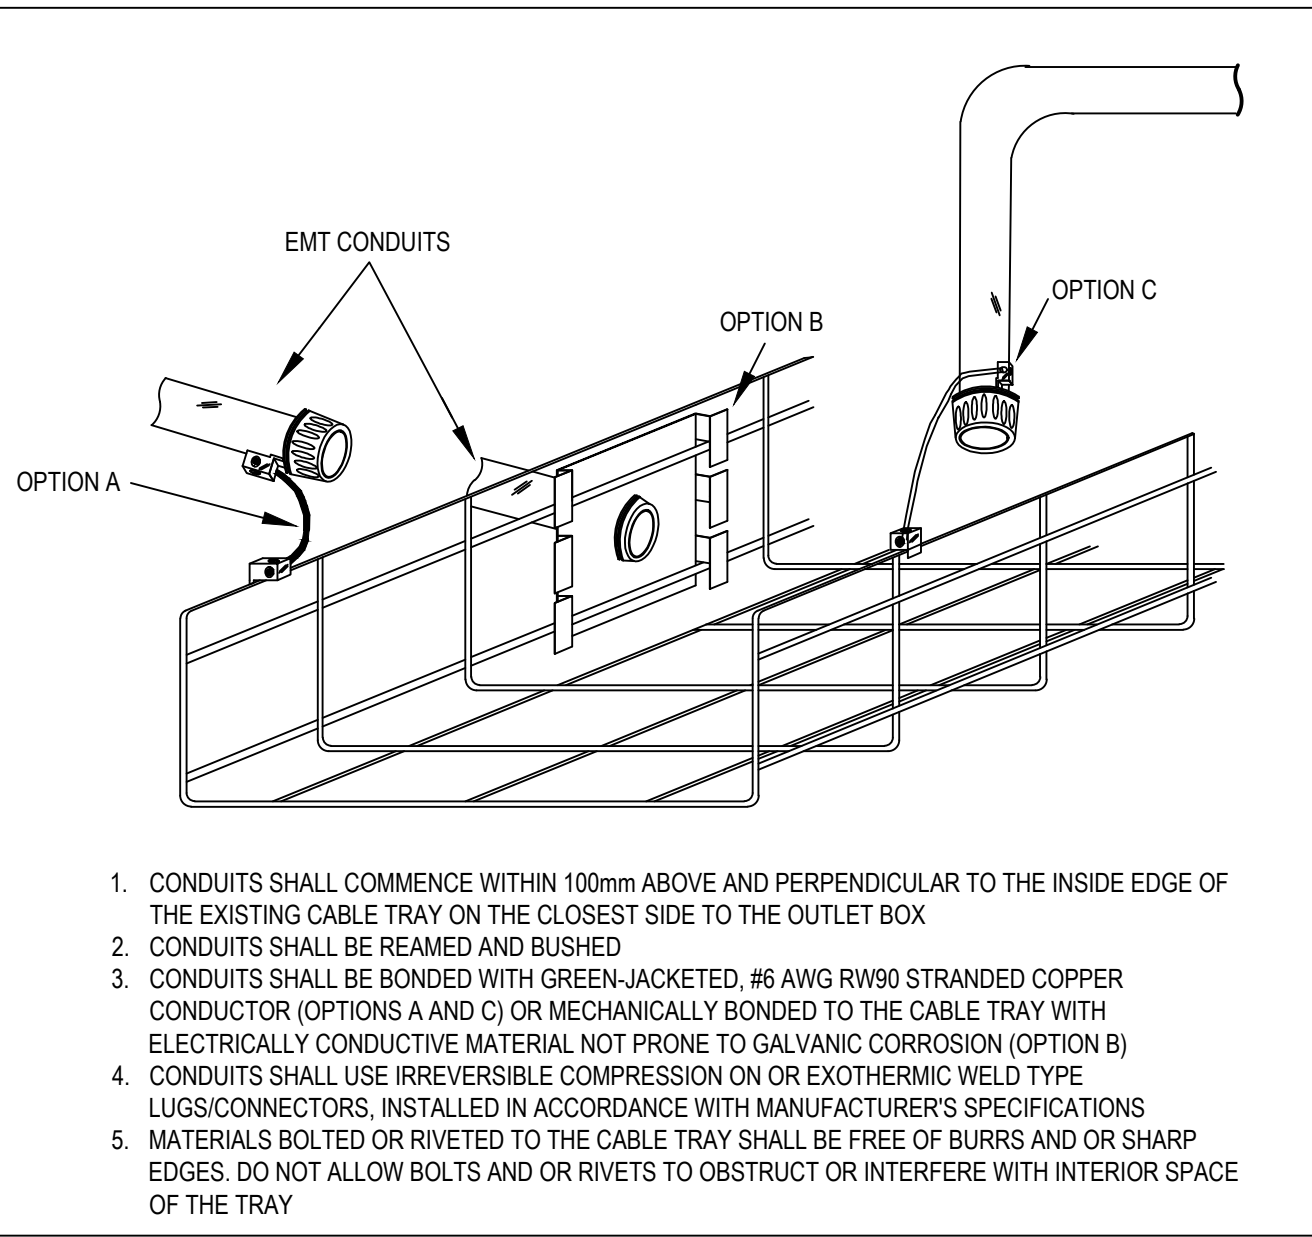


- CONDUITS SHALL COMMENCE WITHIN 100mm ABOVE AND PERPENDICULAR TO THE INSIDE EDGE OF THE EXISTING CABLE TRAY ON THE CLOSEST SIDE TO THE OUTLET BOX
- CONDUITS SHALL BE REAMED AND BUSHED
- CONDUITS SHALL BE BONDED WITH GREEN-JACKETED, #6 AWG RW90 STRANDED COPPER CONDUCTOR (OPTIONS A AND C) OR MECHANICALLY BONDED TO THE CABLE TRAY WITH ELECTRICALLY CONDUCTIVE MATERIAL NOT PRONE TO GALVANIC CORROSION (OPTION B)
- CONDUITS SHALL USE IRREVERSIBLE COMPRESSION ON OR EXOTHERMIC WELD TYPE LUGS/CONNECTORS, INSTALLED IN ACCORDANCE WITH MANUFACTURER'S SPECIFICATIONS
- MATERIALS BOLTED OR RIVETED TO THE CABLE TRAY SHALL BE FREE OF BURRS AND OR SHARP EDGES. DO NOT ALLOW BOLTS AND OR RIVETS TO OBSTRUCT OR INTERFERE WITH INTERIOR SPACE OF THE TRAY

4 CABLE TRAY/CONDUIT GROUNDING DETAIL
T106 SCALE: N.T.S.

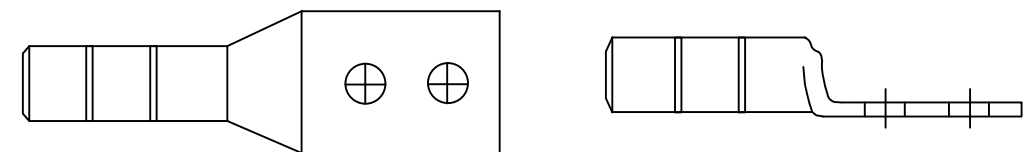


TWO HOLE, TIN PLATED, LONG BARREL COMPRESSION LUGS MUST BE USED. THE COMPRESSION LUG MUST BE SIZED TO ACCOMMODATE A 6 AWG STRANDED COPPER WIRE. THE DISTANCE BETWEEN THE TWO HOLES ARE 16mm (0.63") CENTRE. THE HOLES ARE TO BE 6.35mm (0.25") IN DIAMETER.

2 GROUNDING LUG DETAIL
T106 SCALE: N.T.S.

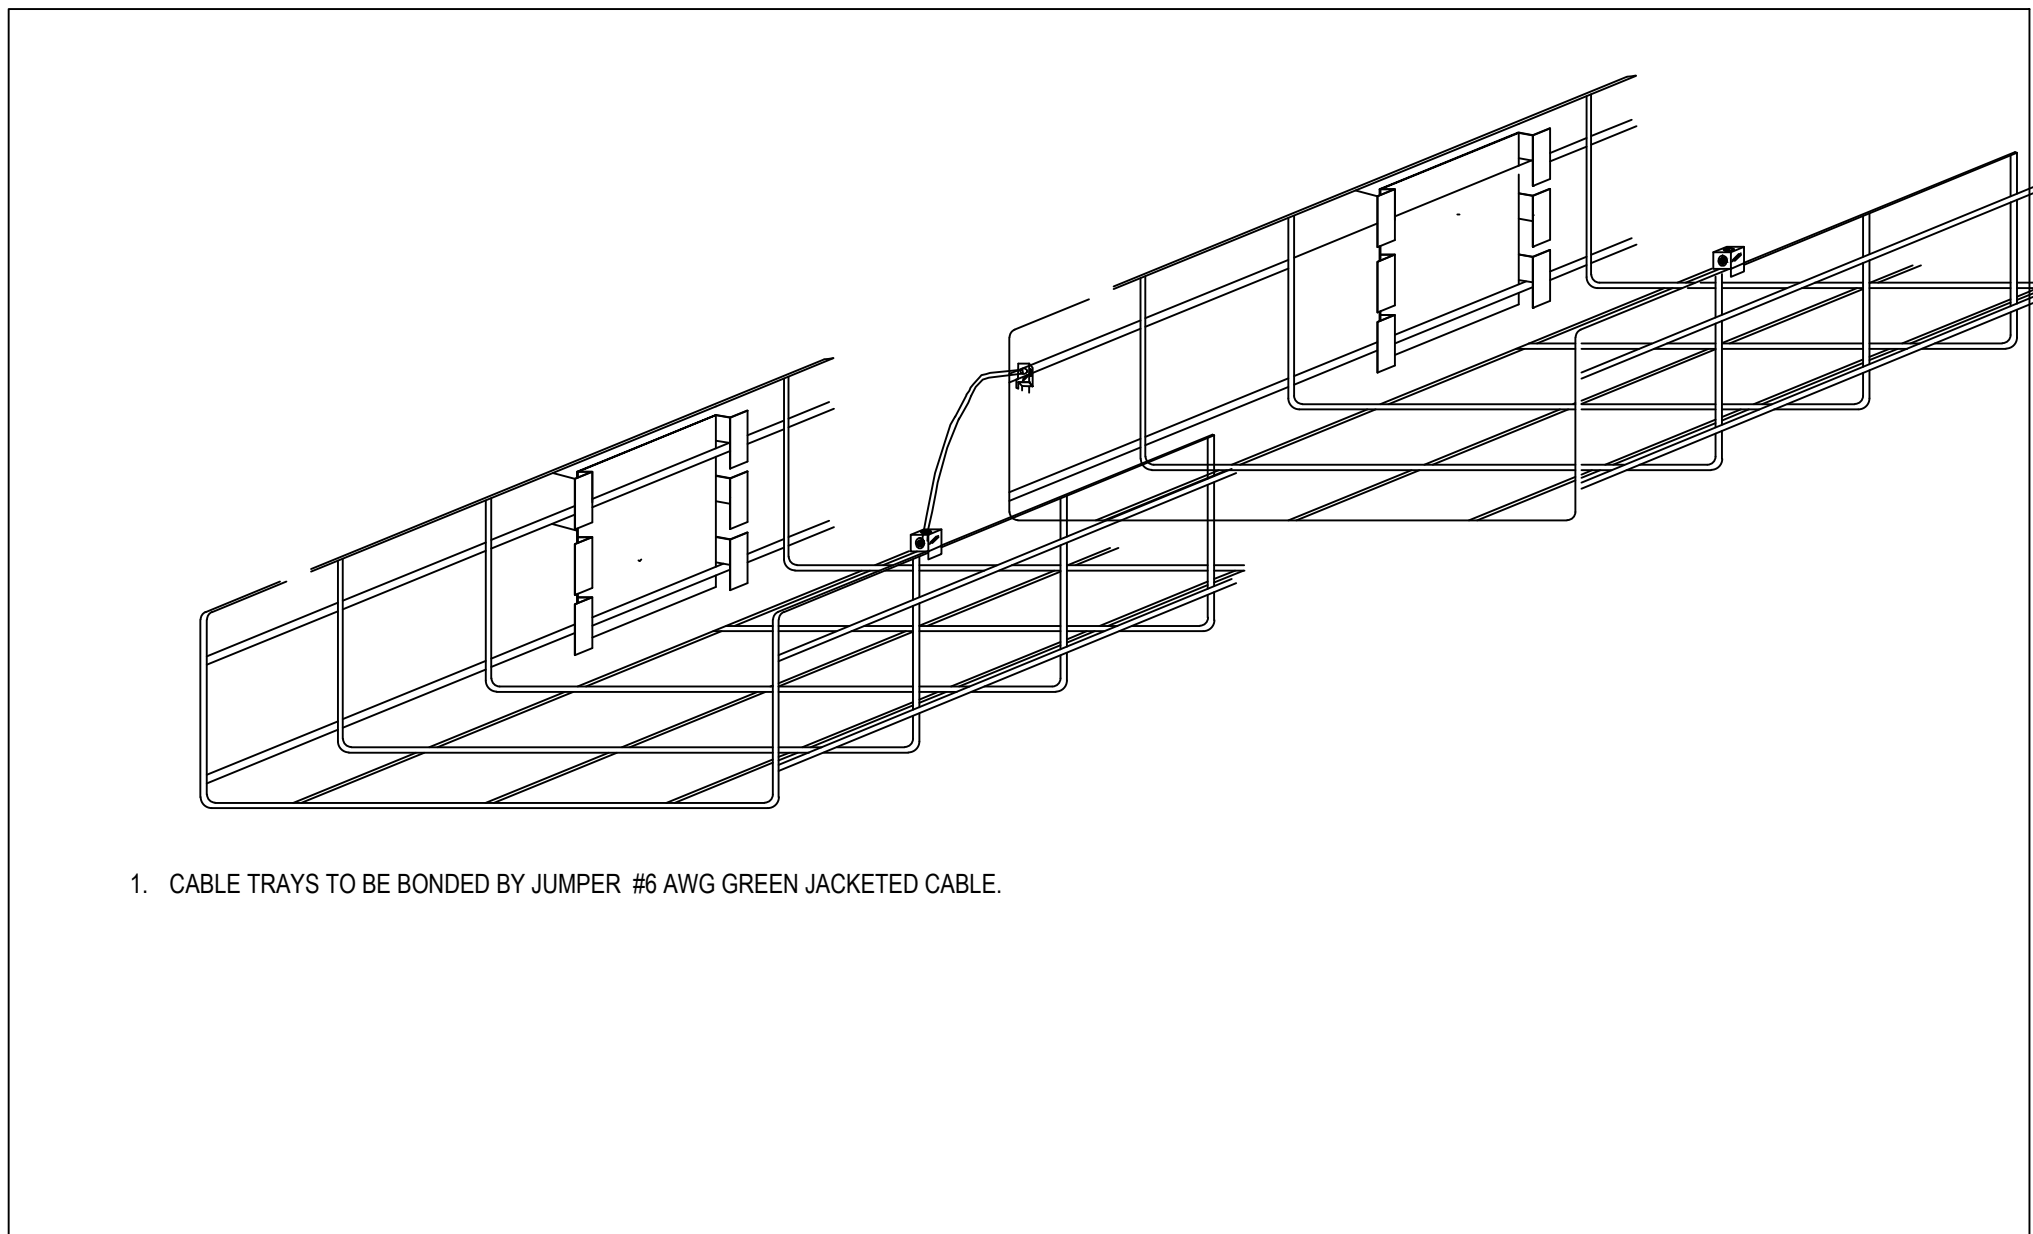

- CABLE TRAYS TO BE BONDED BY JUMPER #6 AWG GREEN JACKETED CABLE.

5 CABLE TRAY BONDING DETAIL
T106 SCALE: N.T.S.

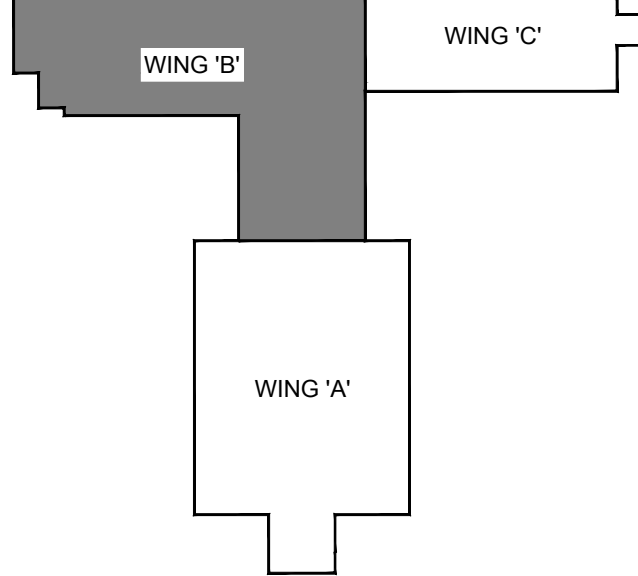

Key Plan

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Orientation	
Seal	Seal

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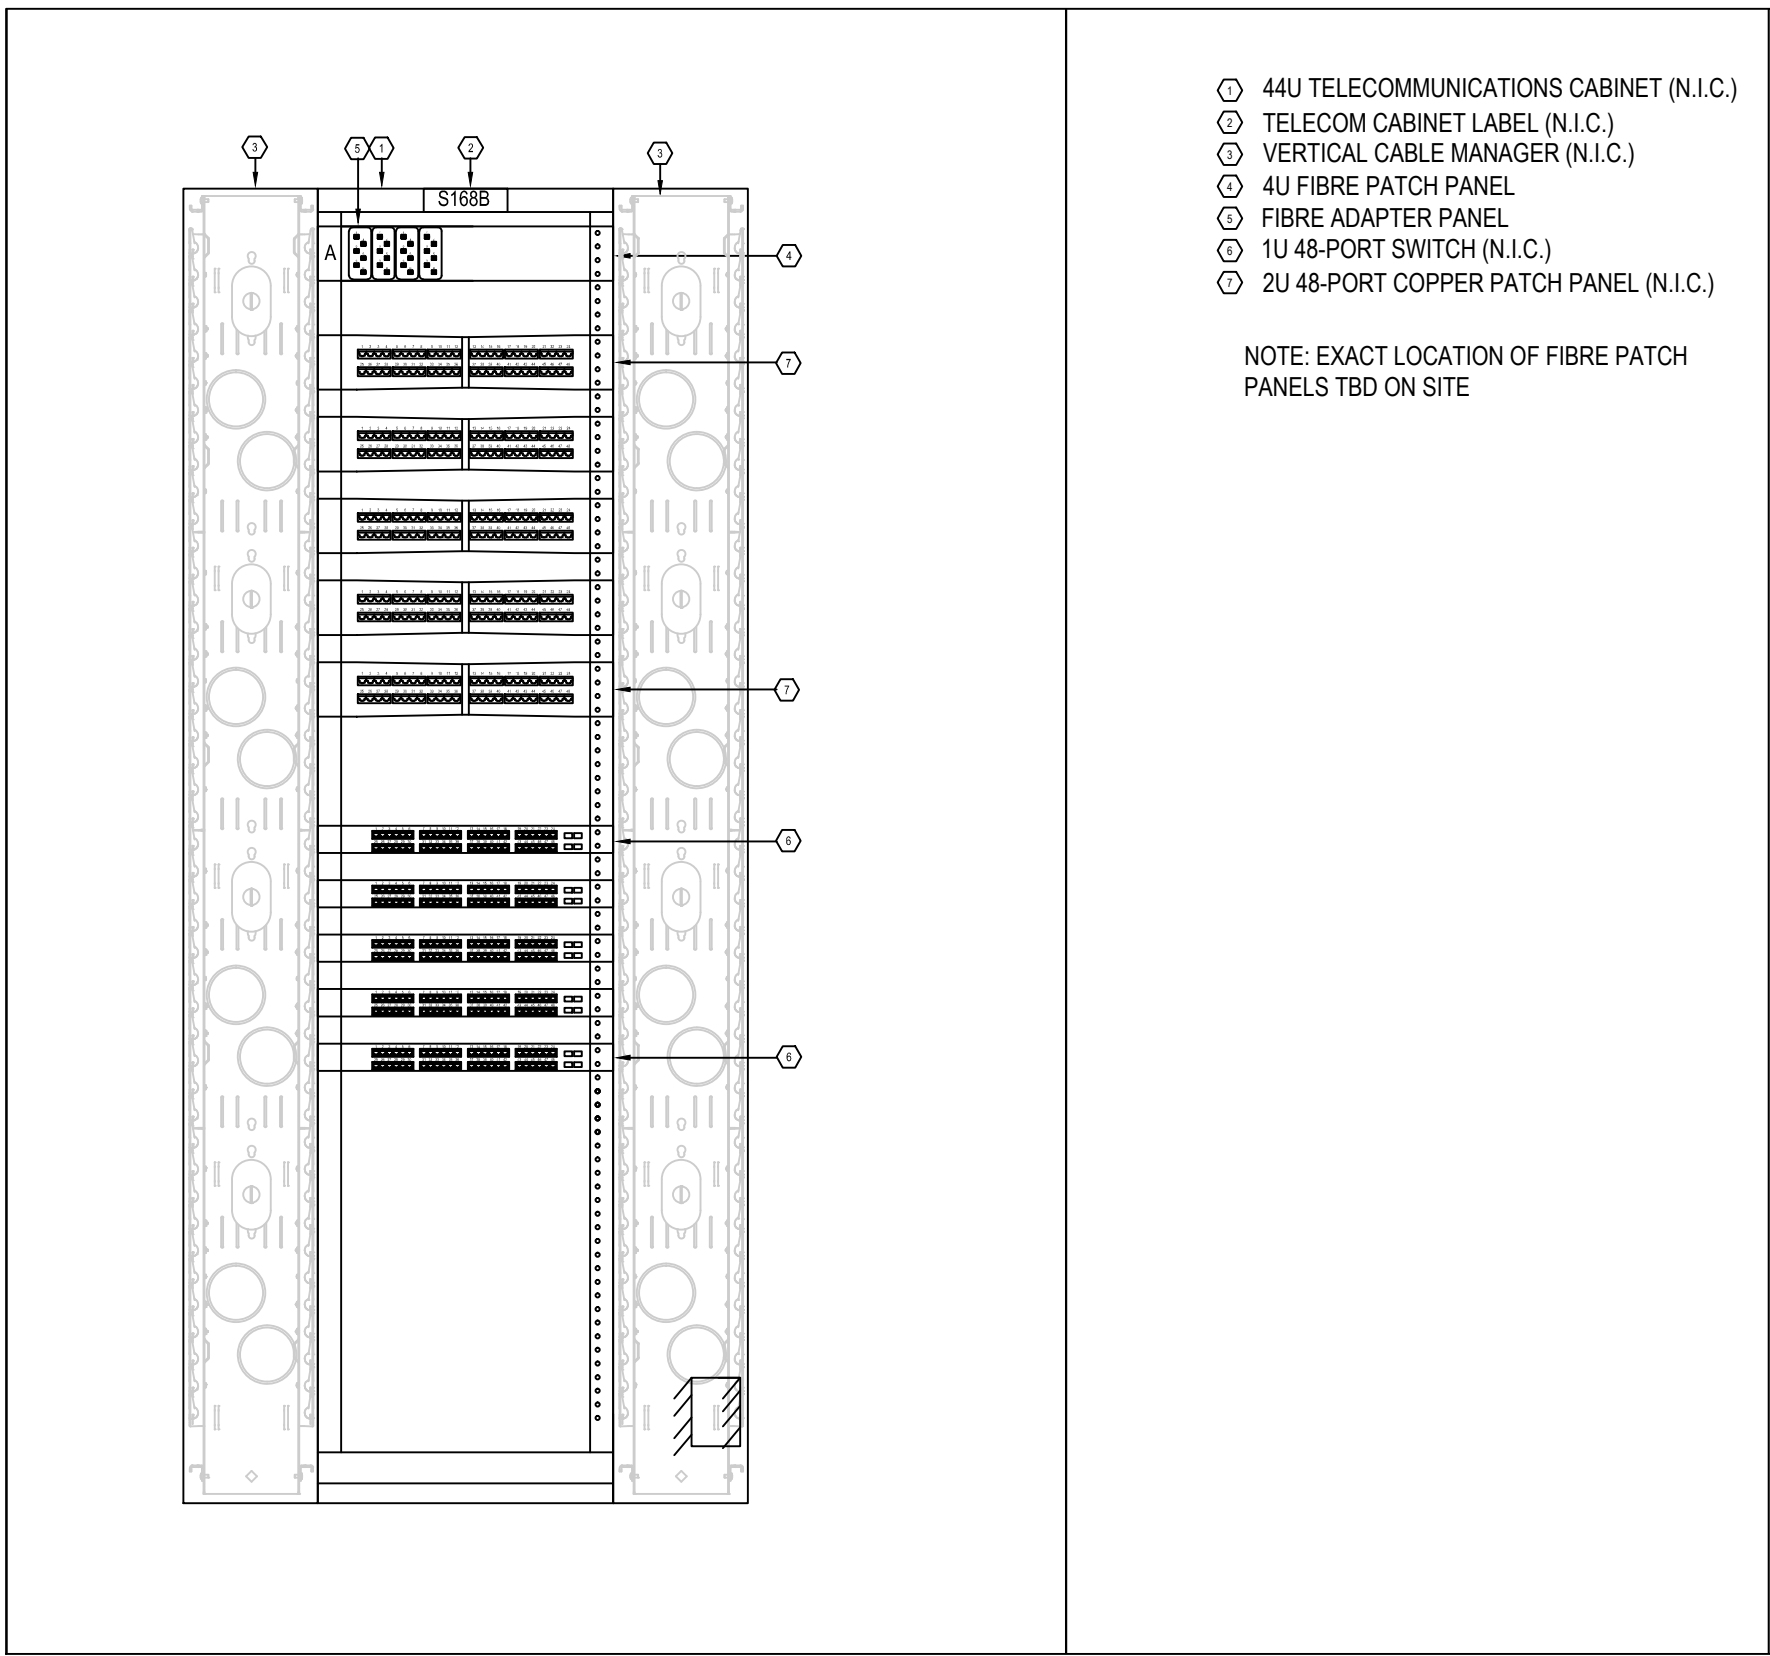
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Project
BUILDING #046
RENOVATIONS
Drawing Title
GROUNDING AND
BONDING DETAILS


Project No.
504034

Location
UNIVERSITY OF GUELPH
BUILDING #046


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Drawn by K.C.	Drawing No. T106 <div>of</div>
Checked By D.C.	
Approved By B.W.	
JLR #	
Cad File No.	




1 VCAP TELECOMMUNICATIONS CABINET
T107 SCALE: N.T.S.

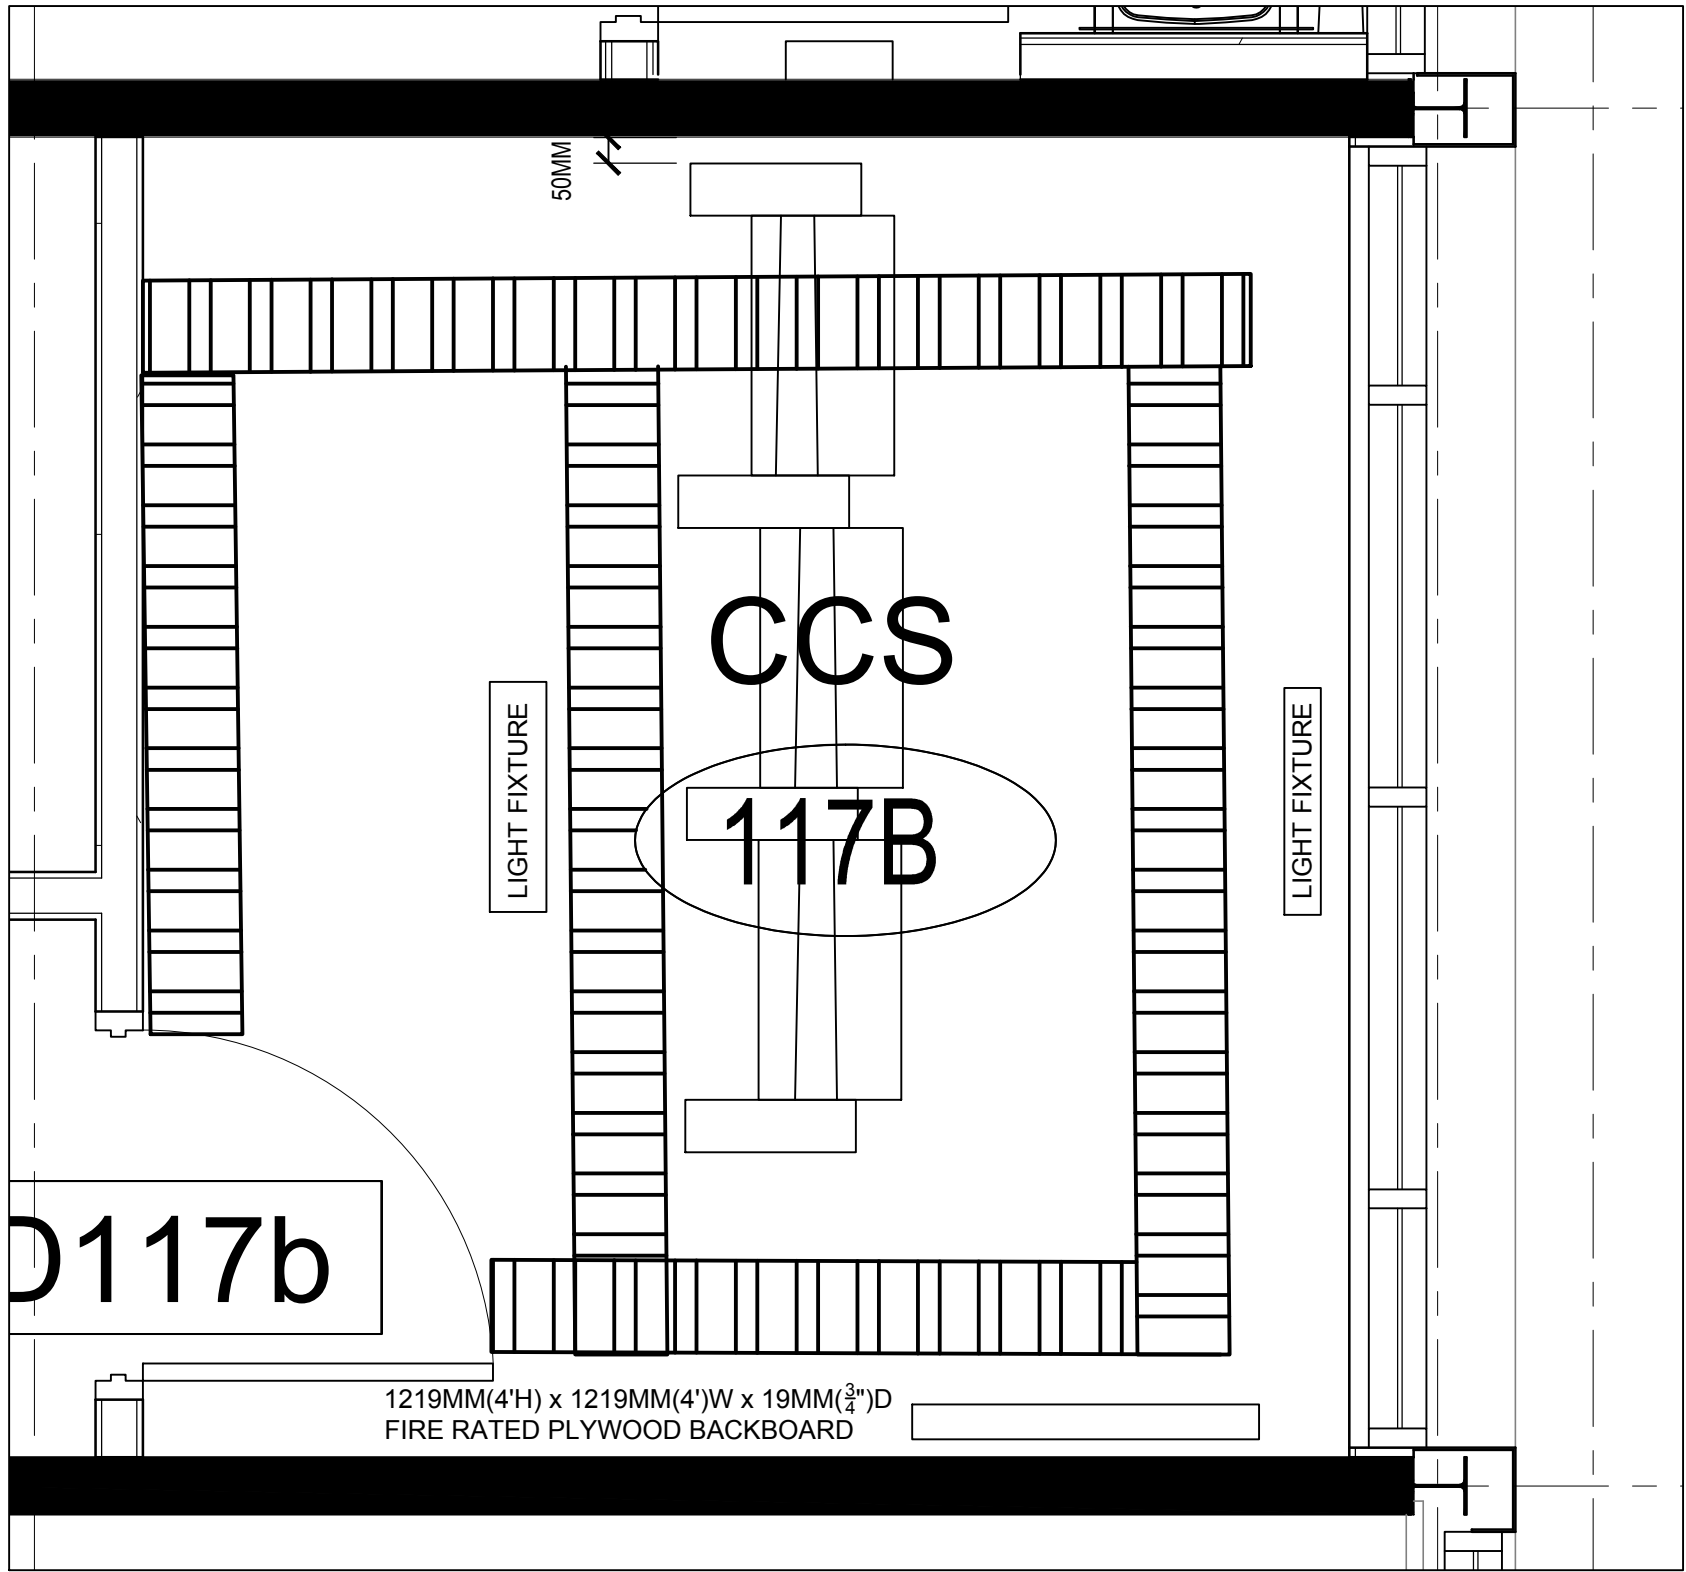

2 CCS ROOM LAYOUT DRAWING
T107 SCALE: N.T.S.

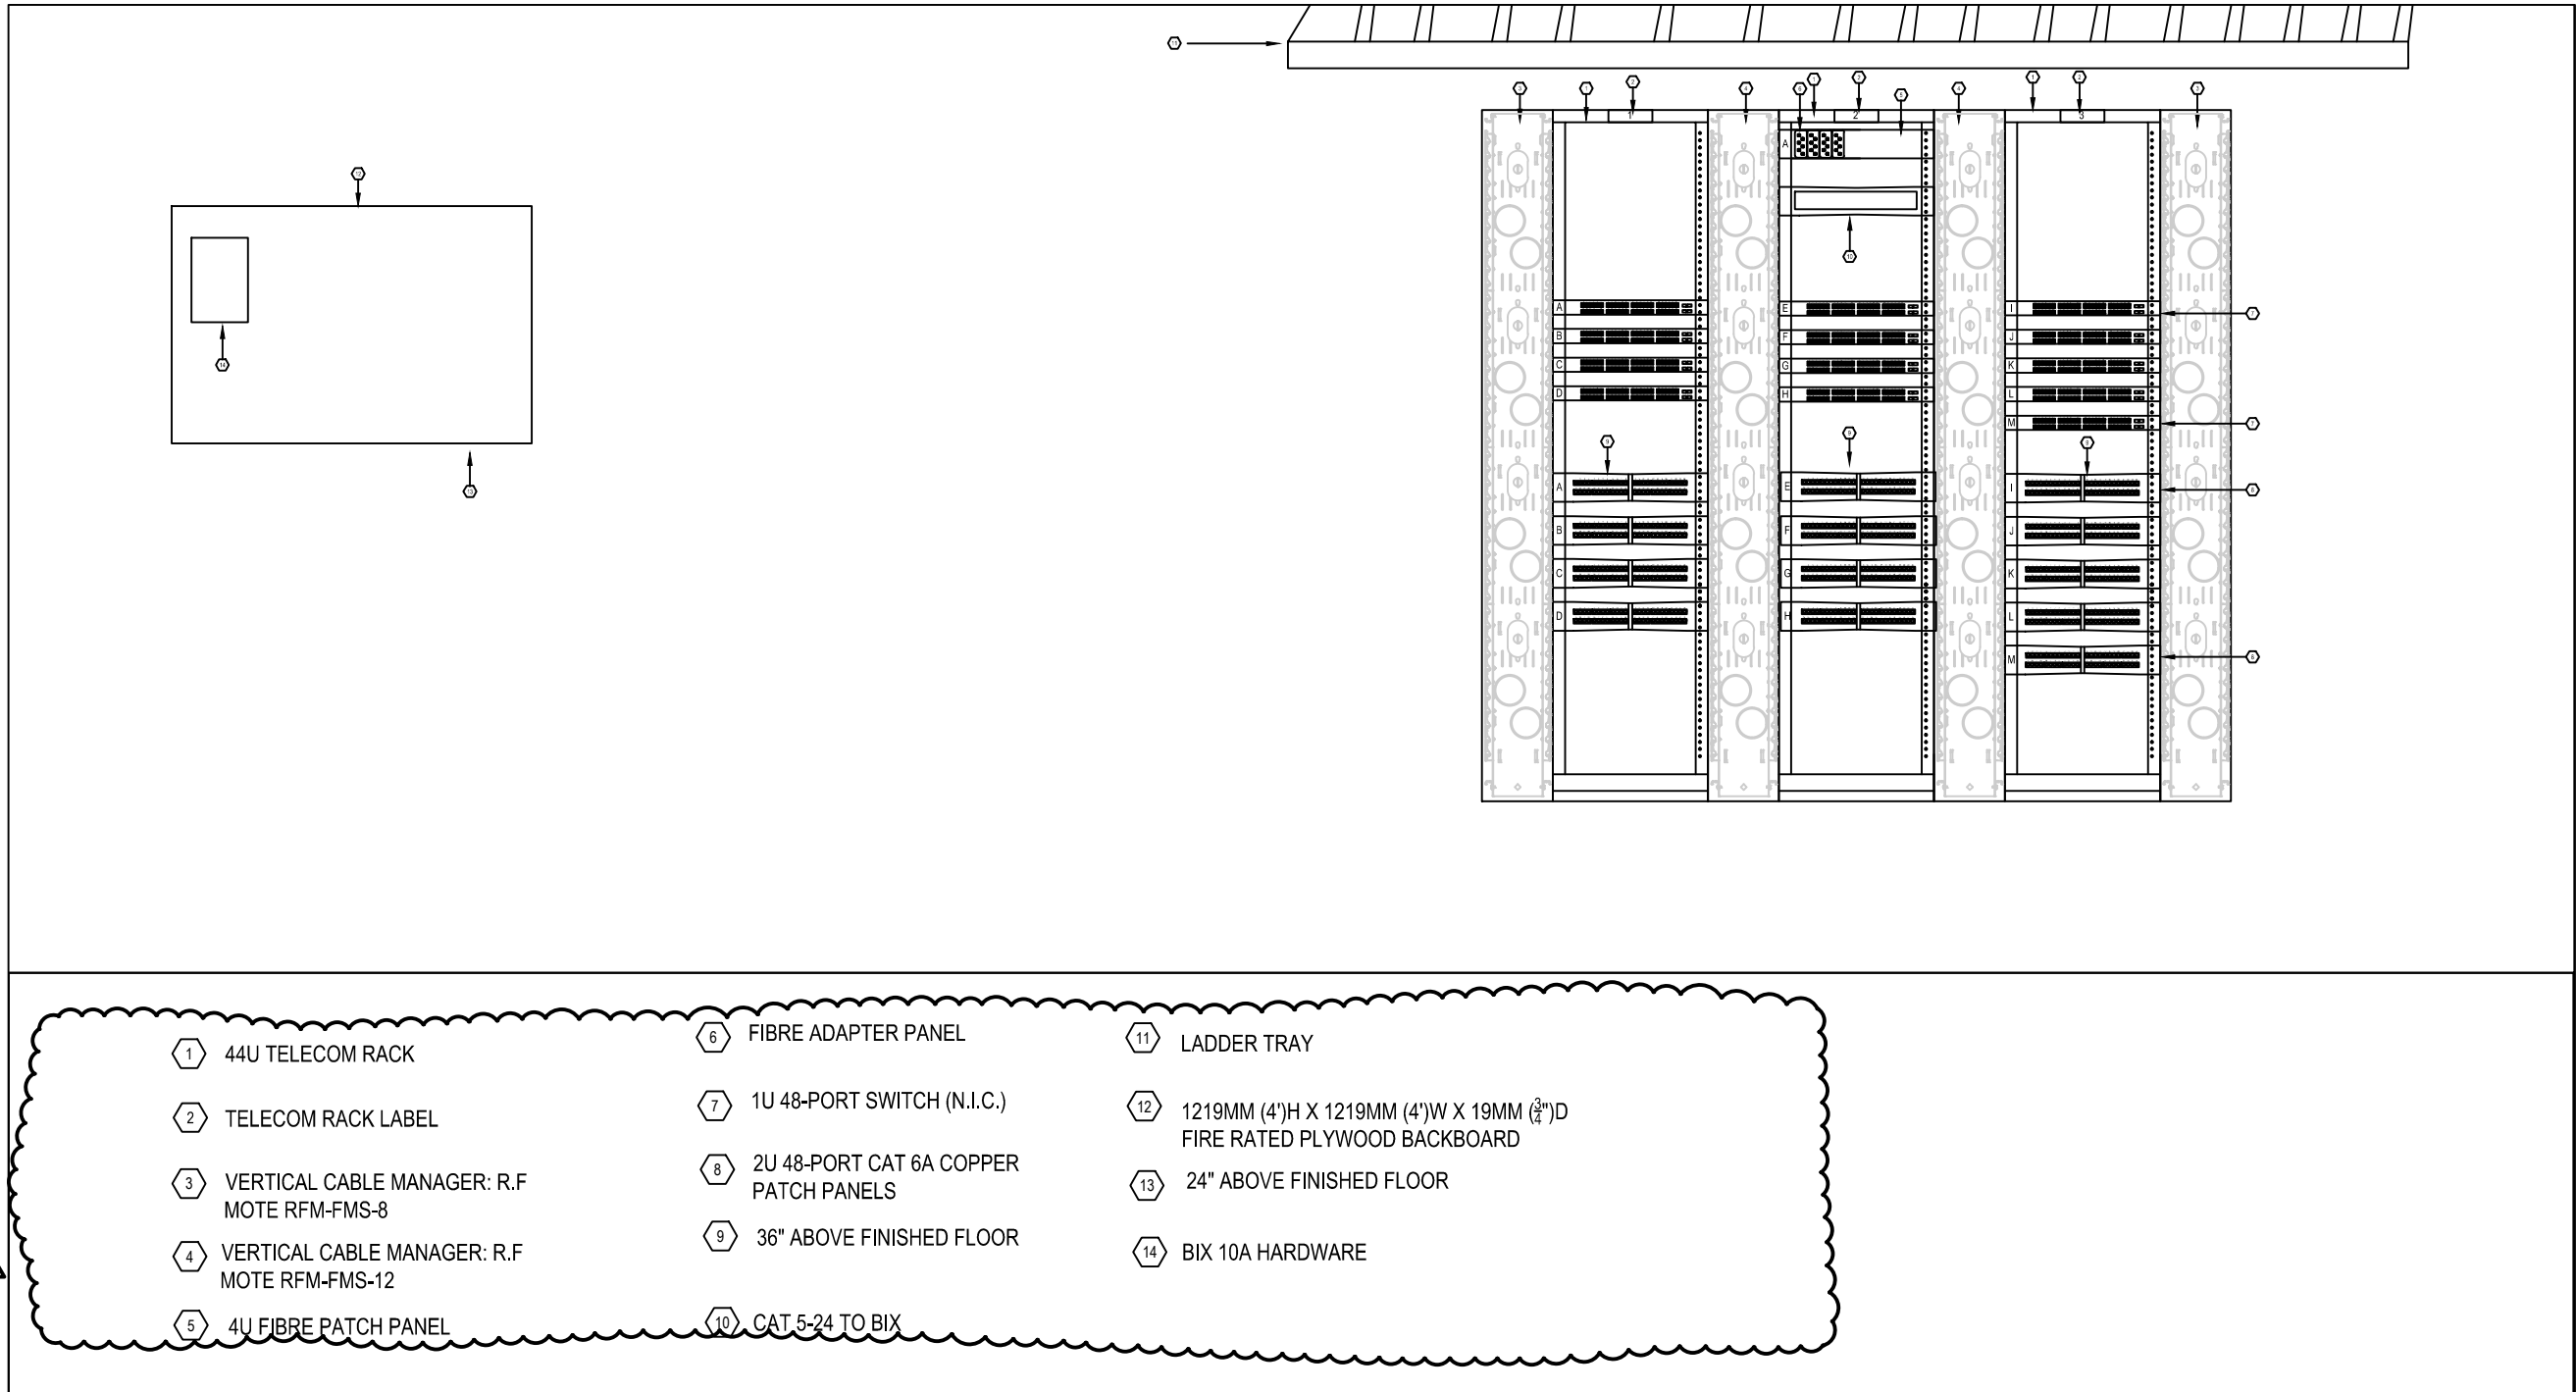

3 CCS TELECOMMUNICATIONS CABINET
T107 SCALE: N.T.S.

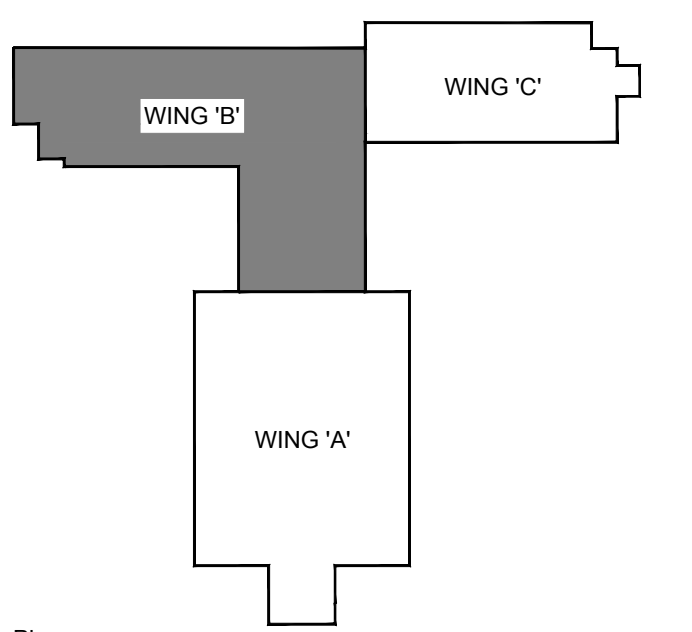

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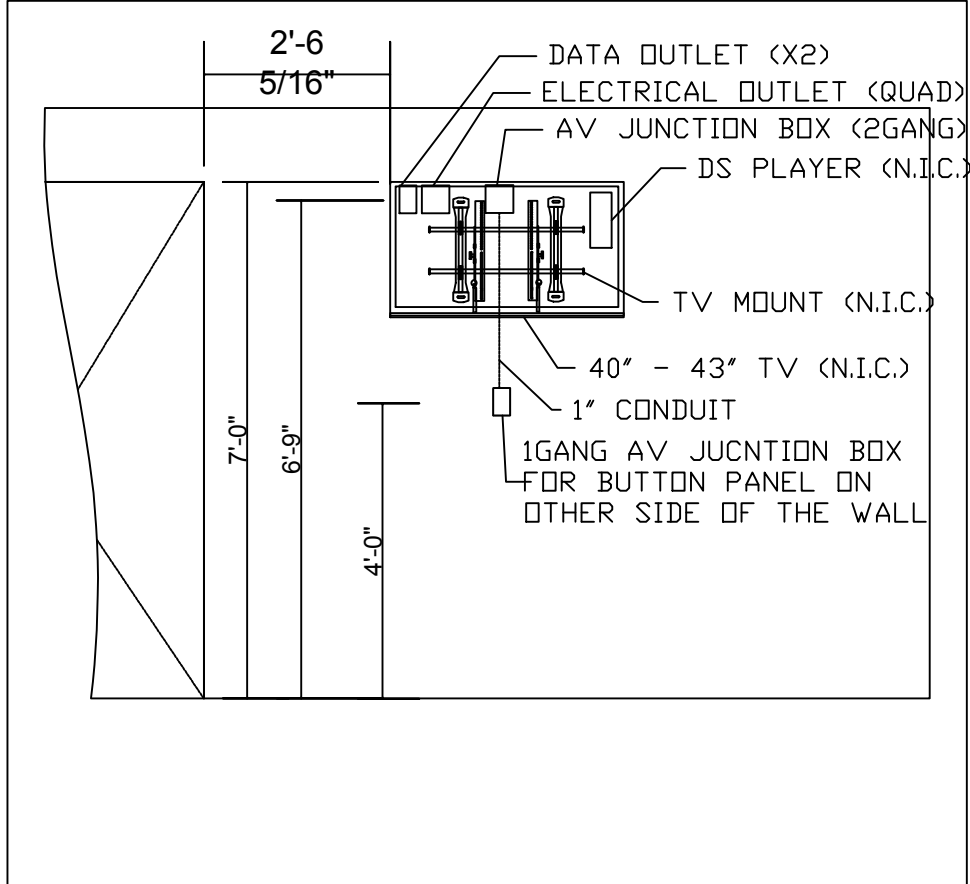
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ENGINEERS - ARCHITECTS - PLANNERS

Project
BUILDING #046 RENOVATIONS
Drawing Title
RACK ELEVATIONS


Project No.
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Location
UNIVERSITY OF GUELPH BUILDING #046


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Checked By D.C.	
Approved By B.W.	
JLR #	
Cad File No.	




1 WAITING RM 143 AV ELEVATION
T108 SCALE: N.T.S.

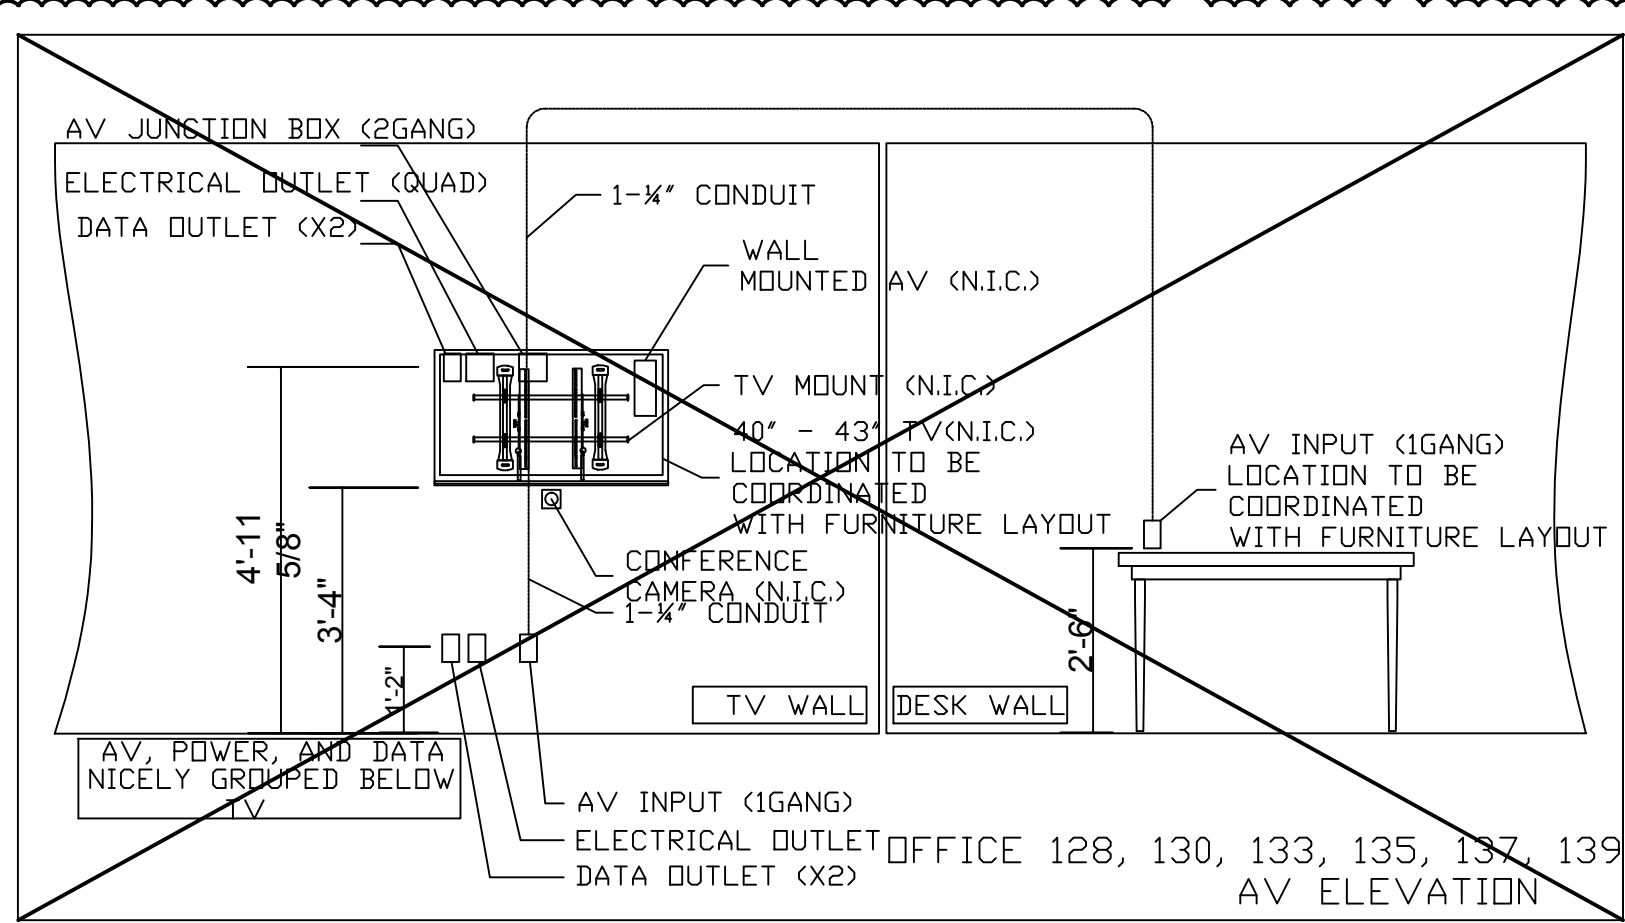


2 OFFICE AV ELEVATIONS
T108 SCALE: N.T.S.

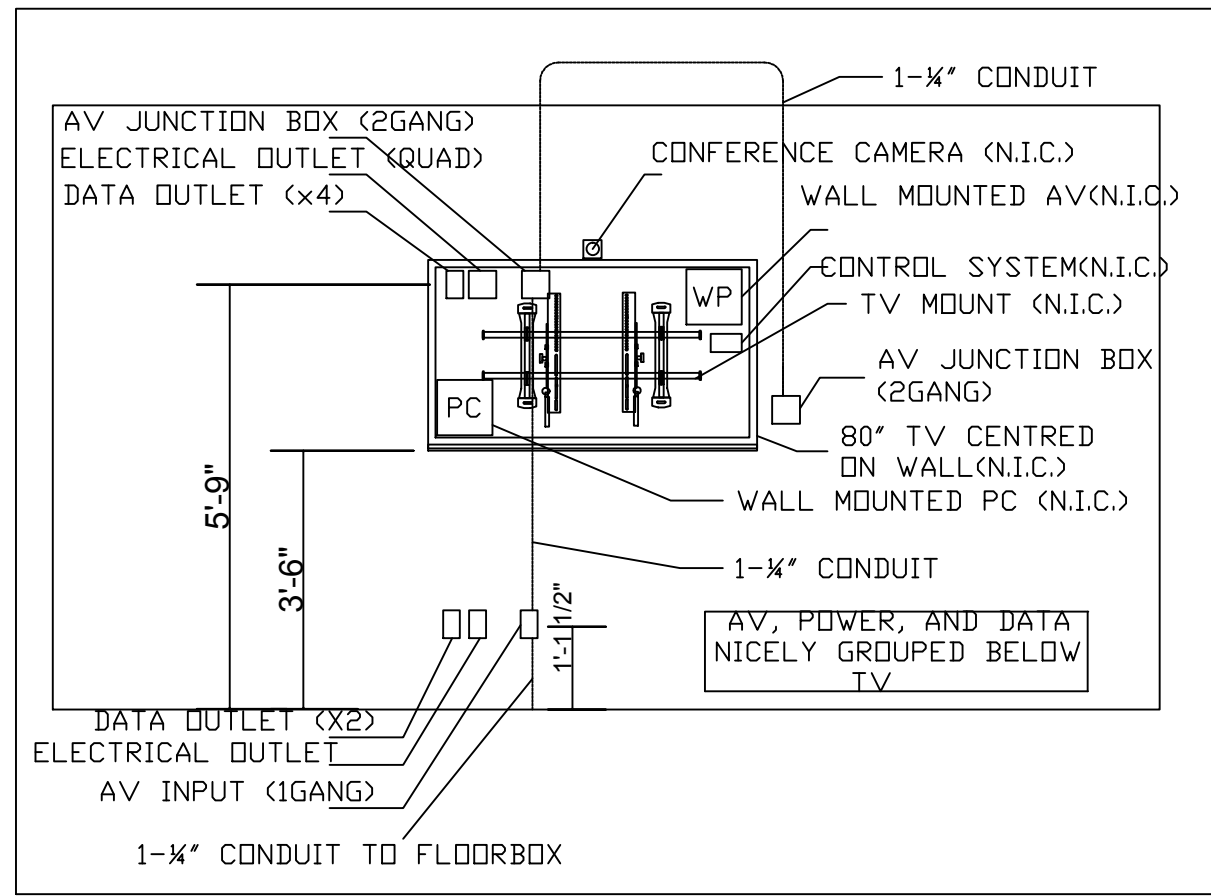


3 THERAPY ROOM 125, 127 AV ELEVATION
T108 SCALE: N.T.S.

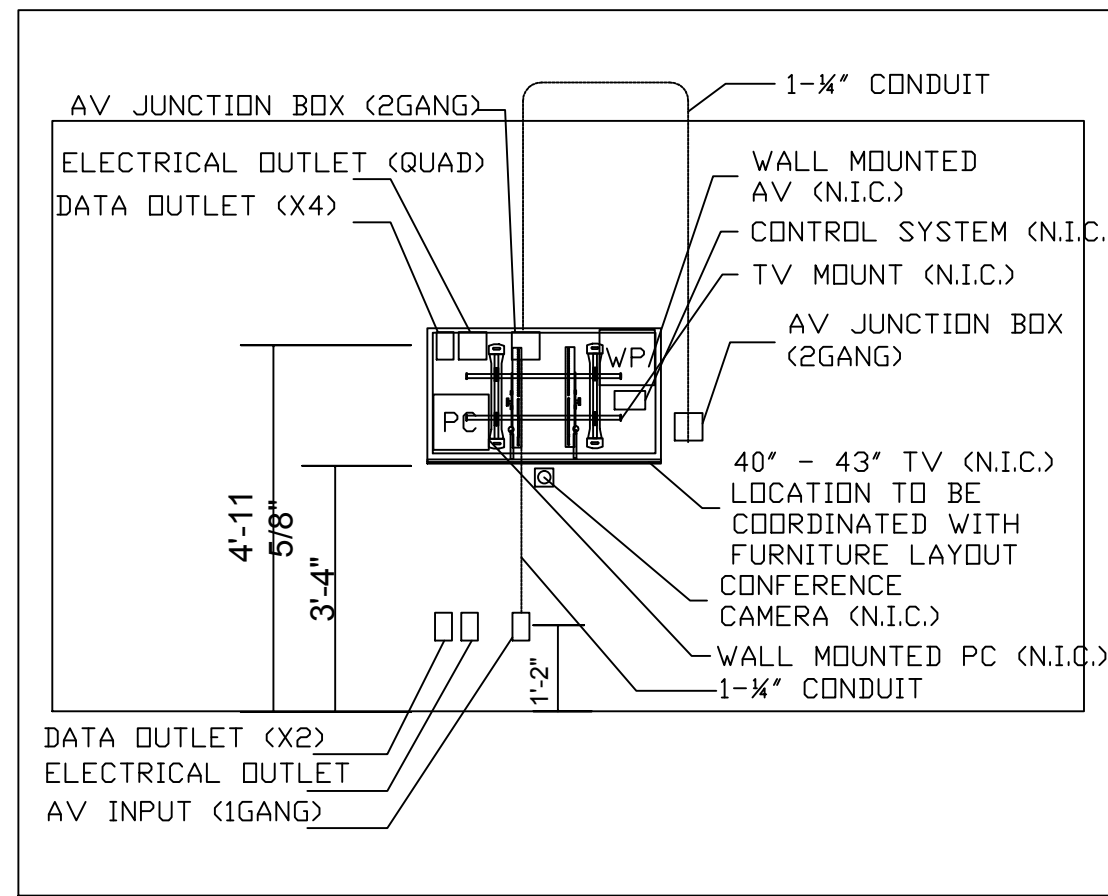


4 RESEARCH SPACE 132 AV ELEVATION
T108 SCALE: N.T.S.

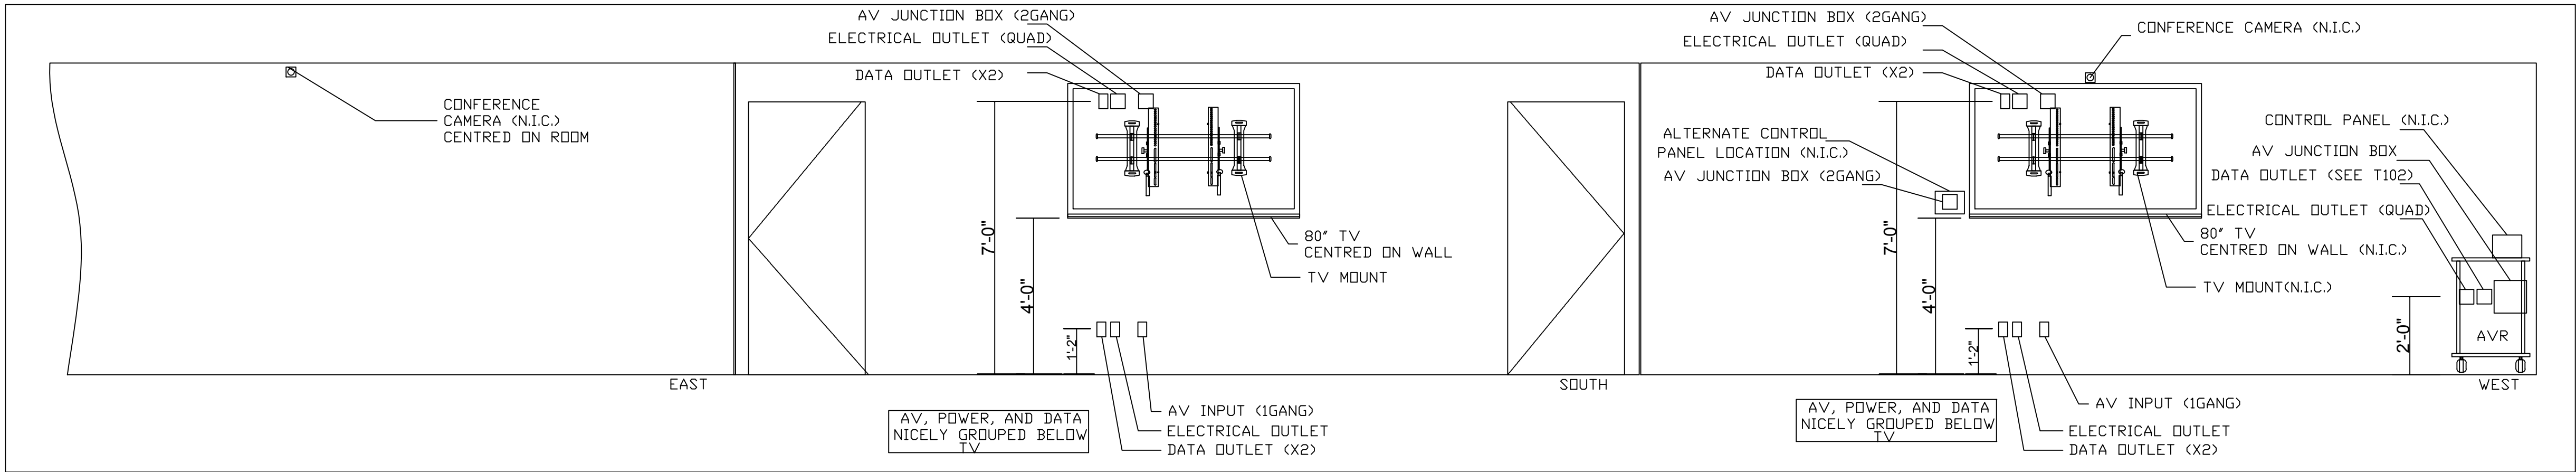


5 LARGE GROUP ROOM 129 AV ELEVATION
T108 SCALE: N.T.S.

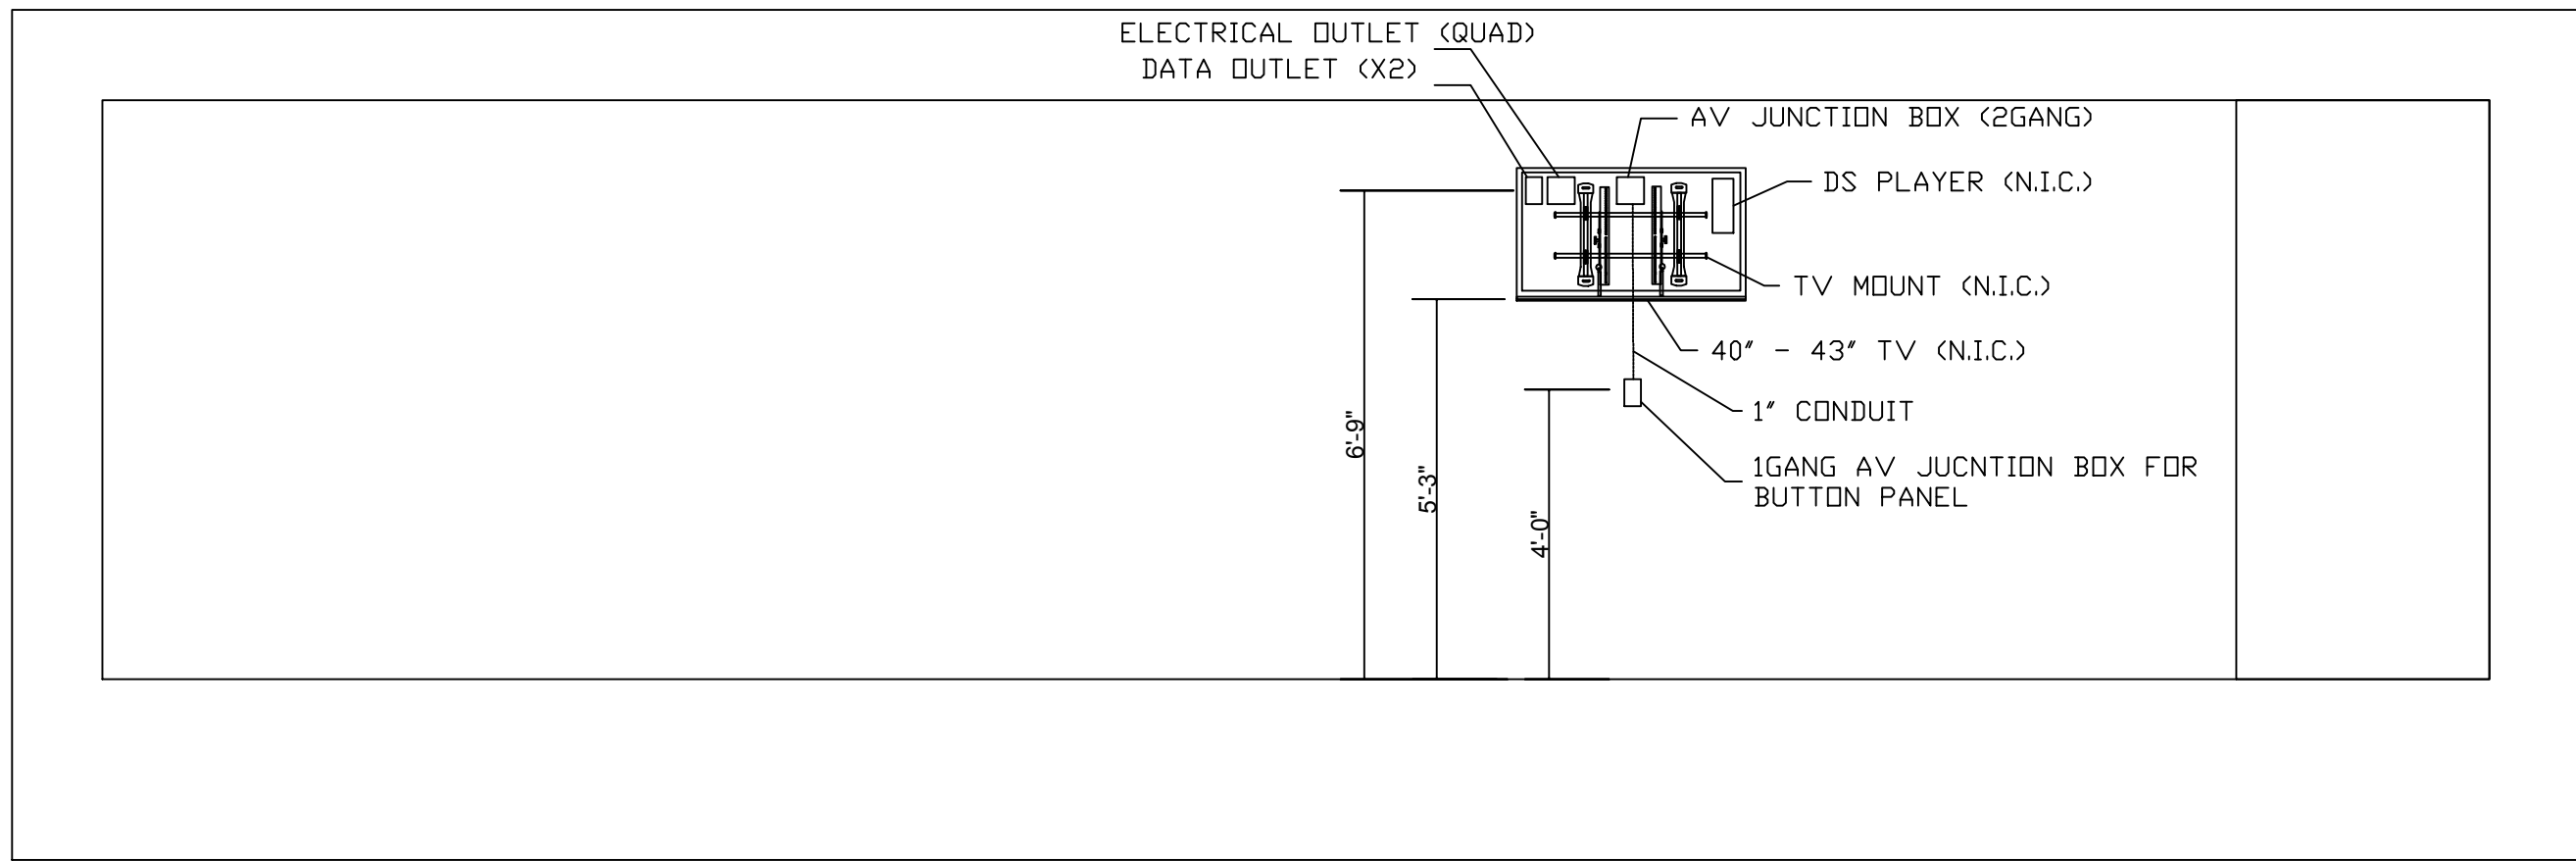

6 STUDENT WORK ROOM 136 AV ELEVATION
T108 SCALE: N.T.S.

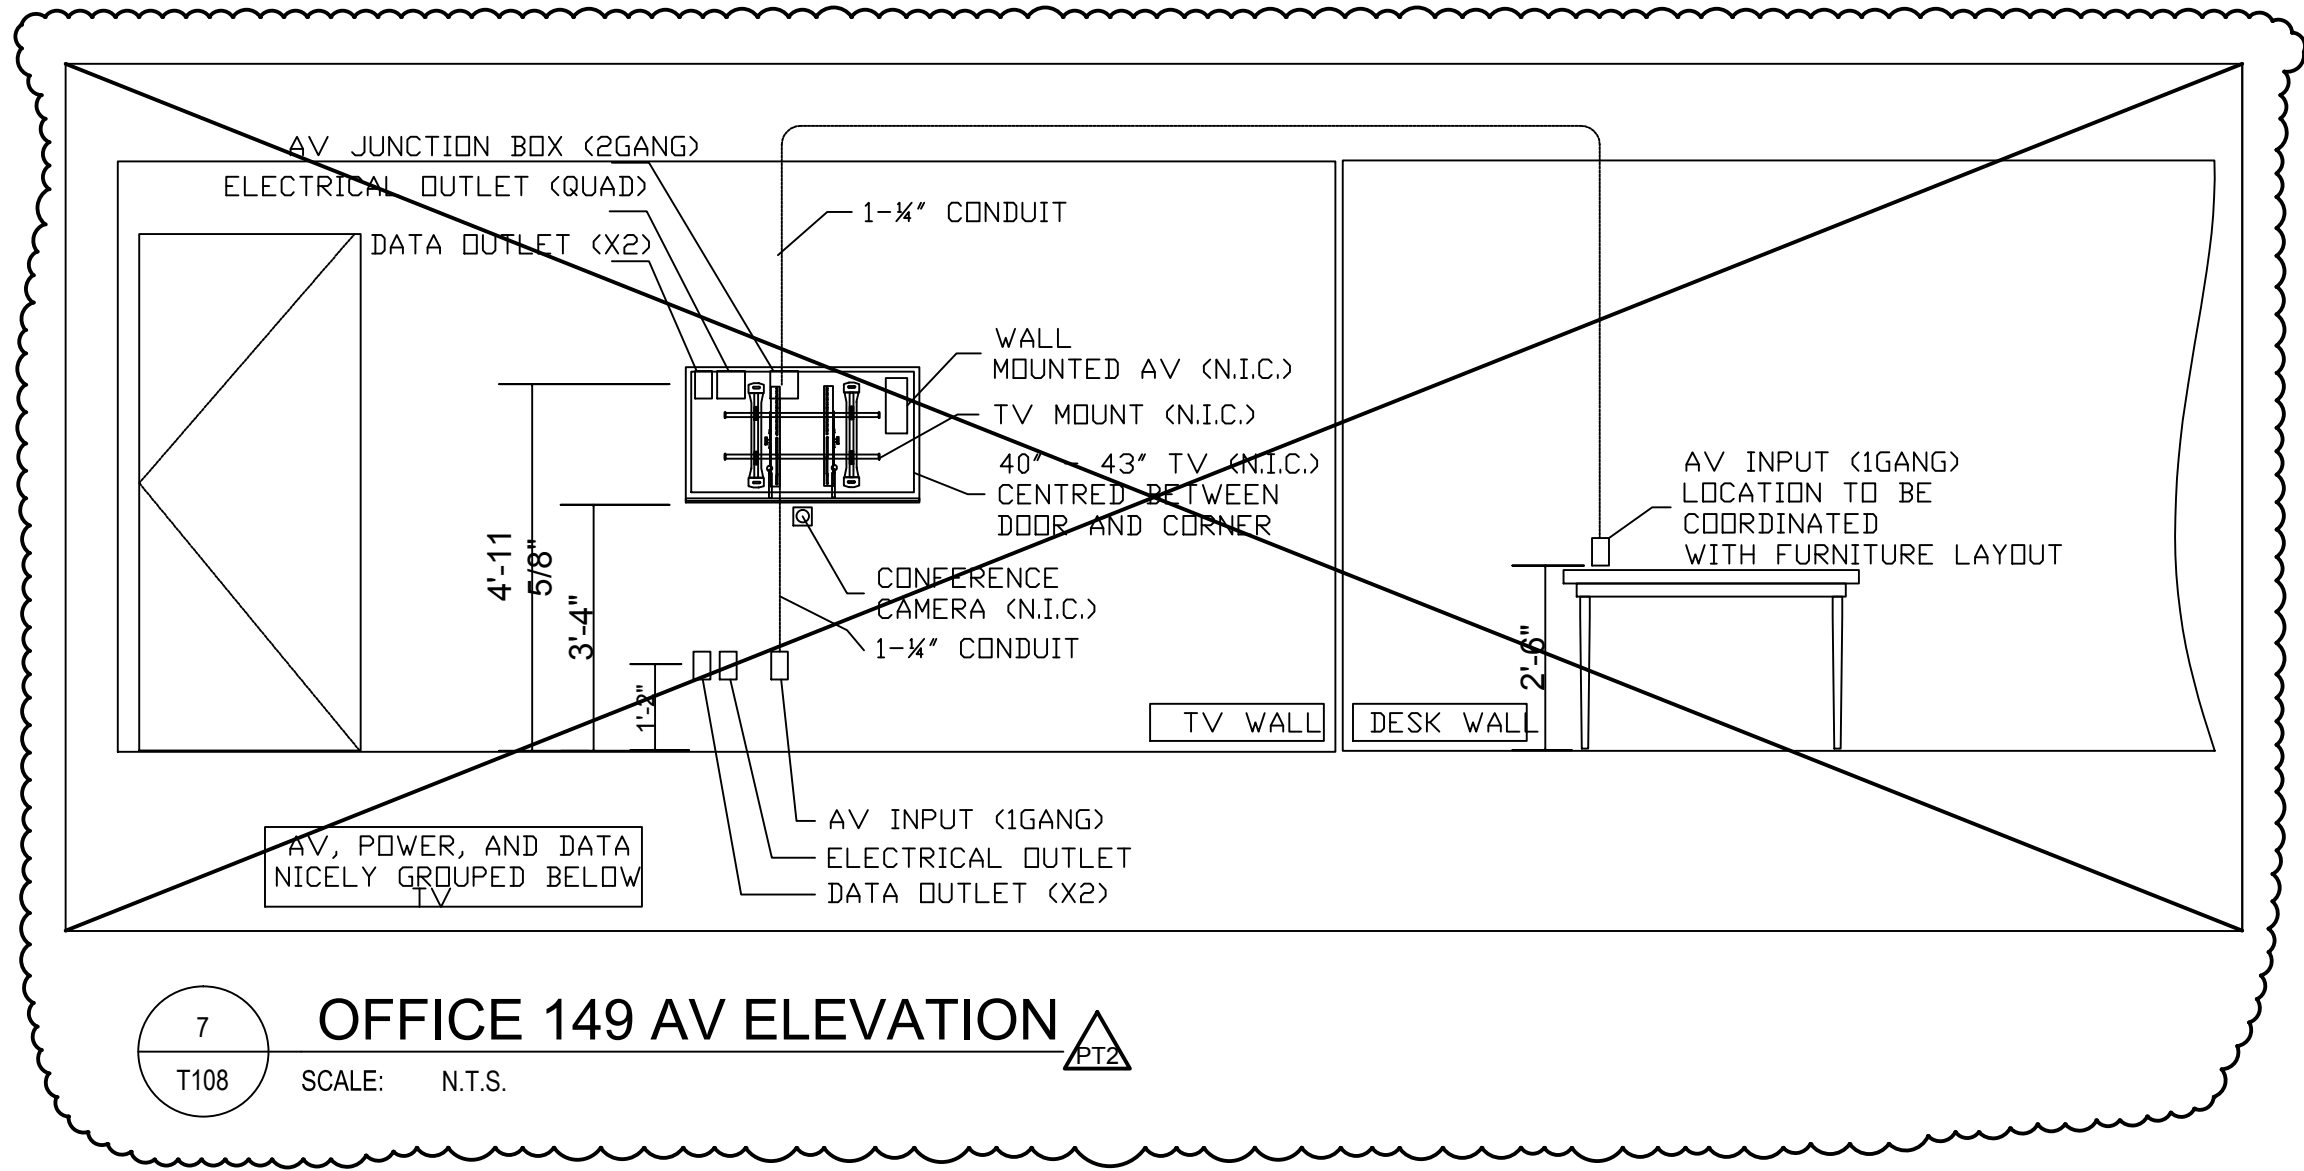

7 OFFICE 149 AV ELEVATION
T108 SCALE: N.T.S.

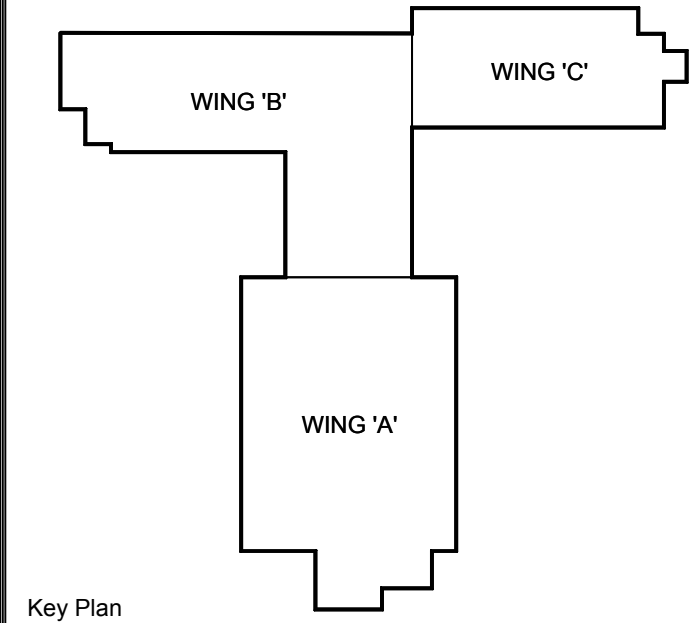

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ENGINEERS - ARCHITECTS - PLANNERS

Project

BUILDING #046
RENOVATIONS

Drawing Title

AV ELEVATIONS
WING B LEVEL 1

Project No.


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Location

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BUILDING #046


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Drawn by	K.C.	Drawing No.	T108
Checked By	D.C.		
Approved By	B.W.		
JLR #			

Cad File No.

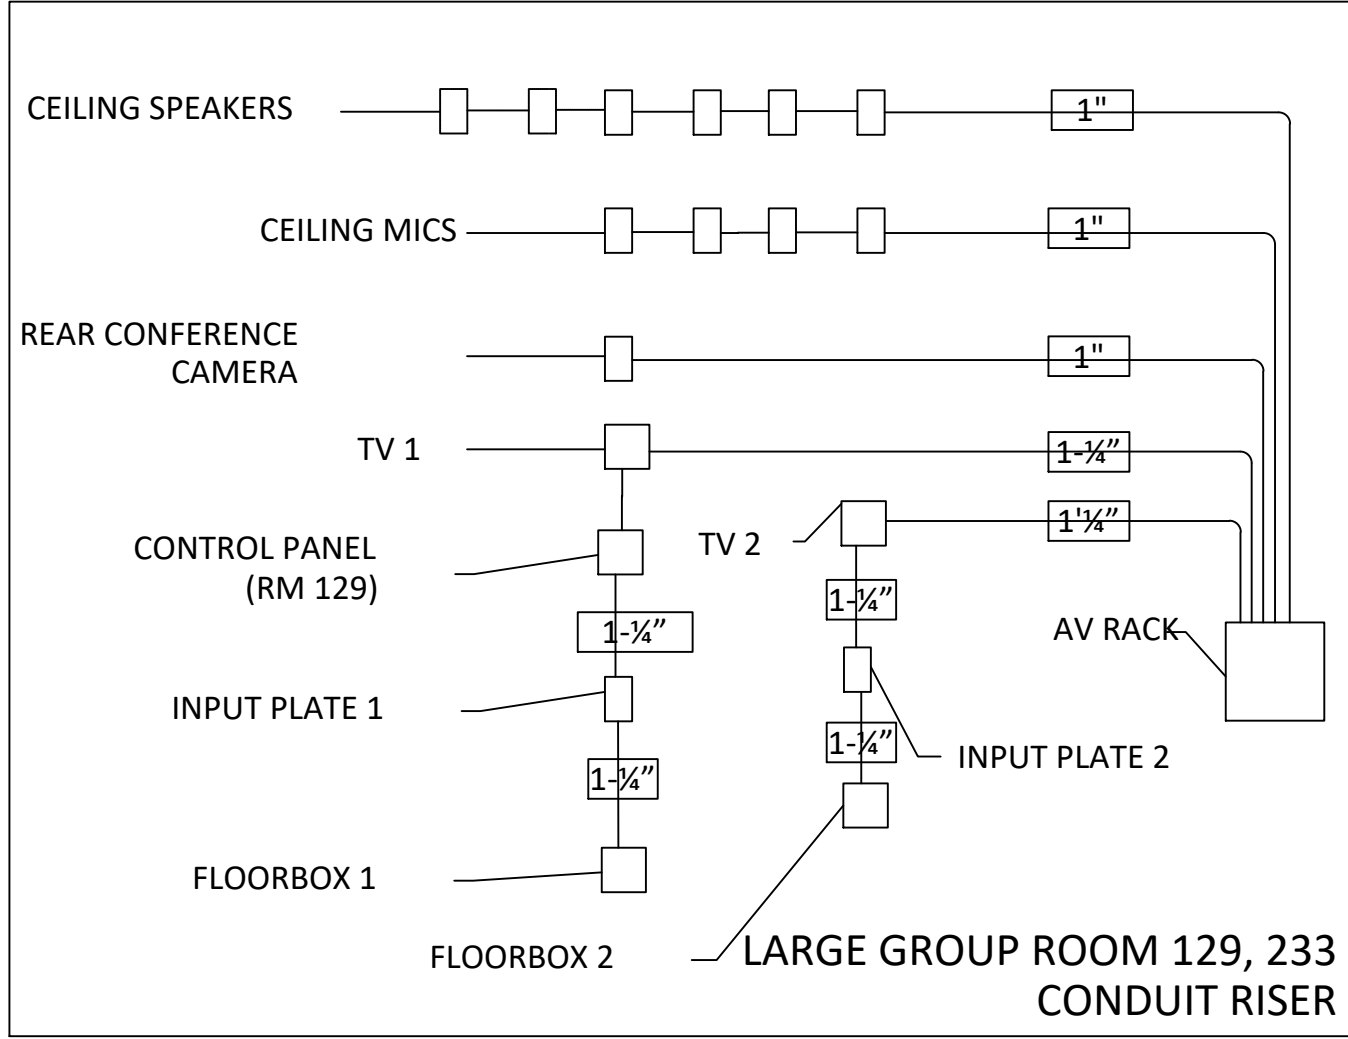


1 GROUP ROOM 129, 233 CONDUIT RISER

SCALE: N.T.S.

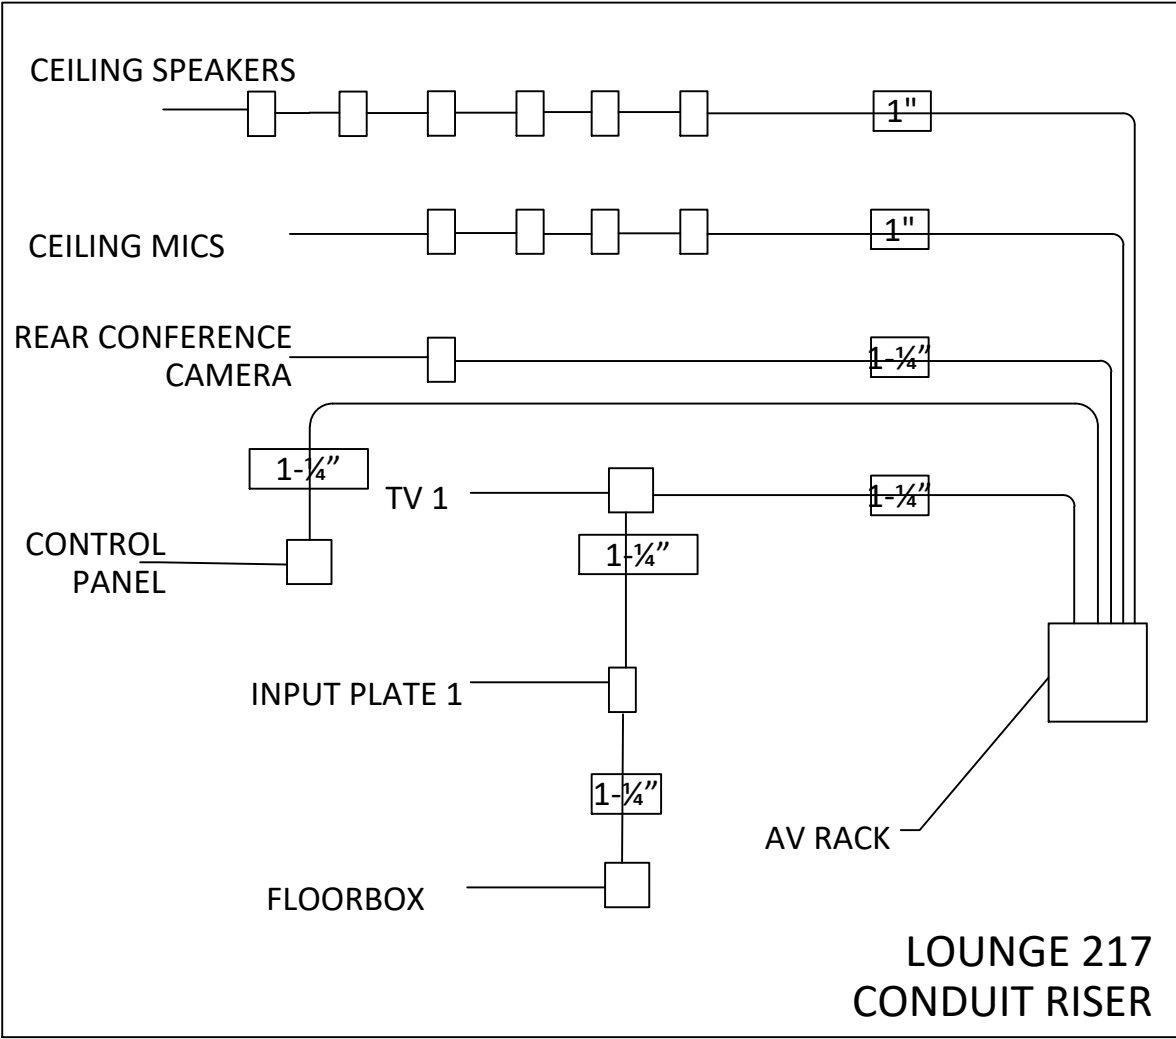

2 LOUNGE 217 CONDUIT RISER

SCALE: N.T.S.

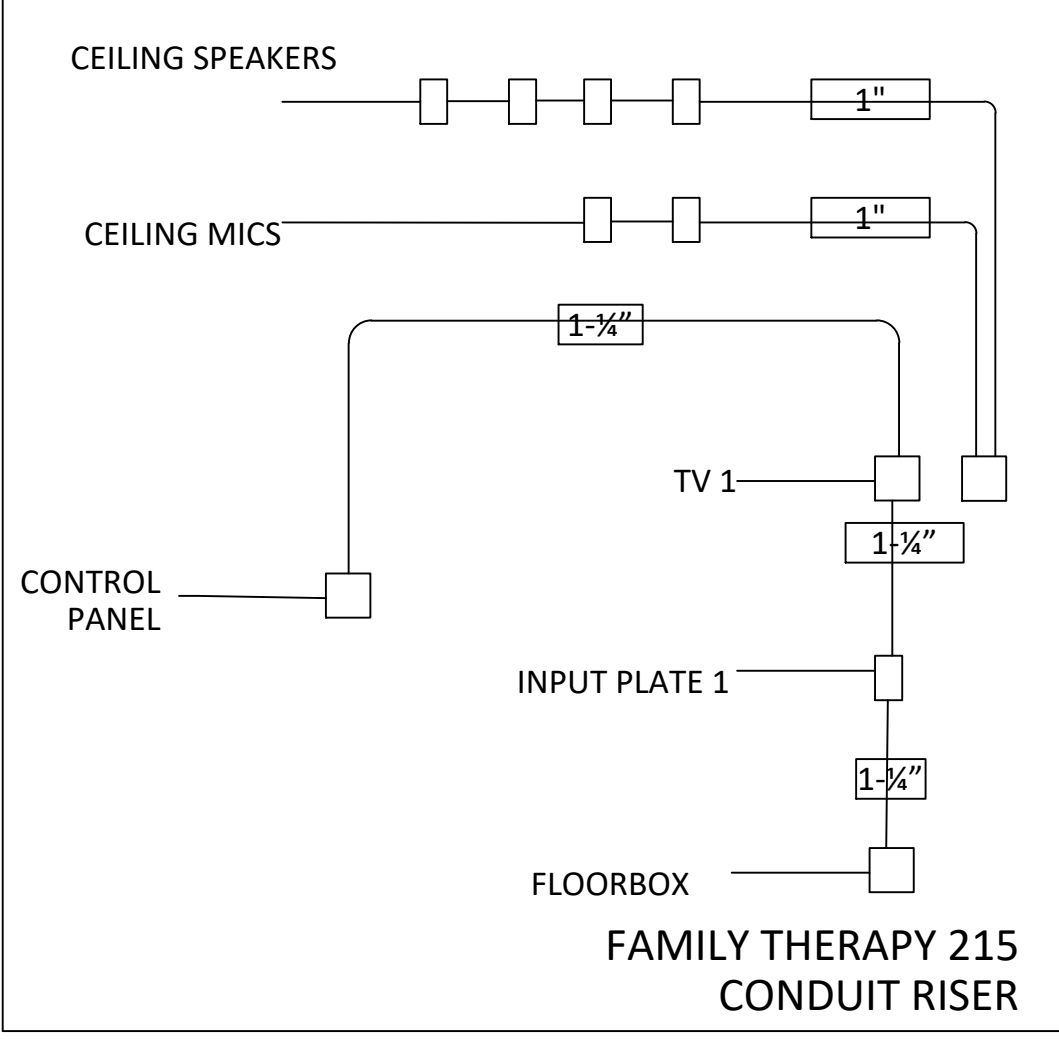


3 FAMILY THERAPY 215 CONDUIT RISER

SCALE: N.T.S.

- LEGEND**
- | SYMBOL | DESCRIPTION |
|--------------------|--|
| MIC ^C | CEILING MIC |
| SPK ^C | CEILING SPEAKER |
| CAM ^{W92} | WALL MOUNT CAMERA (TYPE, MOUNT HEIGHT) |
| TV ^{W48U} | WALL MOUNT TV (SIZE, MOUNT HEIGHT) |
| RK ^{FLR} | FLOOR MOUNT EQUIPMENT RACK |
| CAM ^C | CEILING MOUNT CAMERA |

NOTES: CONTRACTOR TO INSTALL ALL CEILING MOUNT ITEMS. TO BE SUPPLIED BY OTHERS

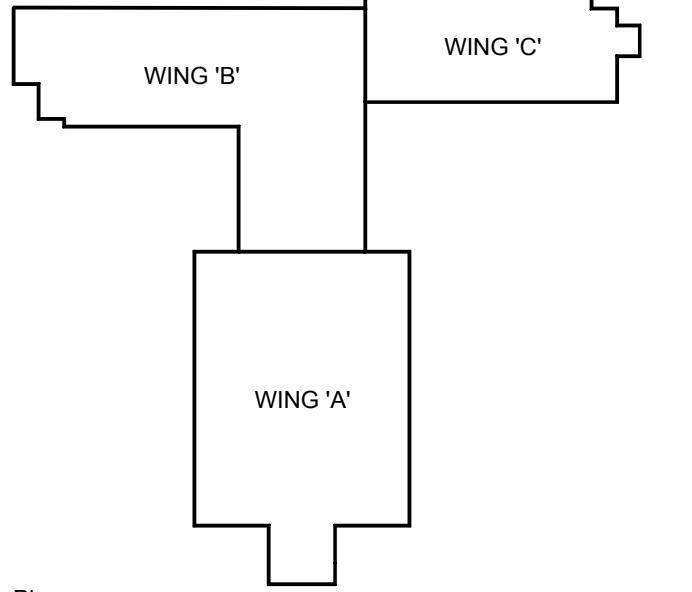

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Project

BUILDING #046
RENOVATIONS

Drawing Title

AV LAYOUT AND
RISERS

Project No.

504034

Location

UNIVERSITY OF GUELPH
BUILDING #046

Scale

AS SHOWN

Date

FEB 22, 2019

Drawn by

K.C.

Checked By

D.C.

Approved By


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JLR #

T109


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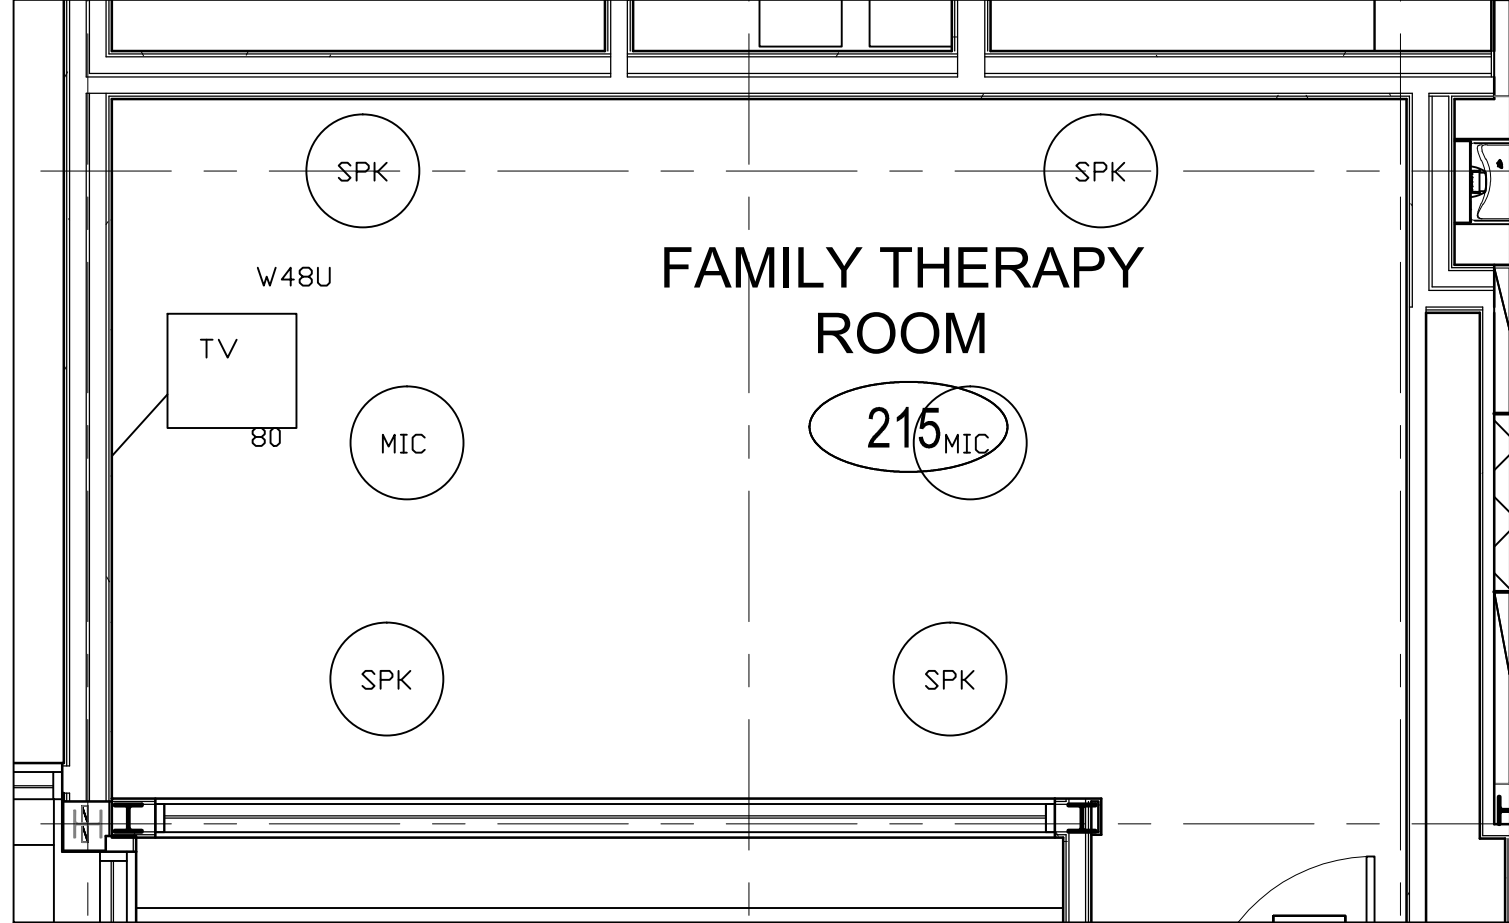
4 LARGE GROUP ROOM 129

SCALE: N.T.S.

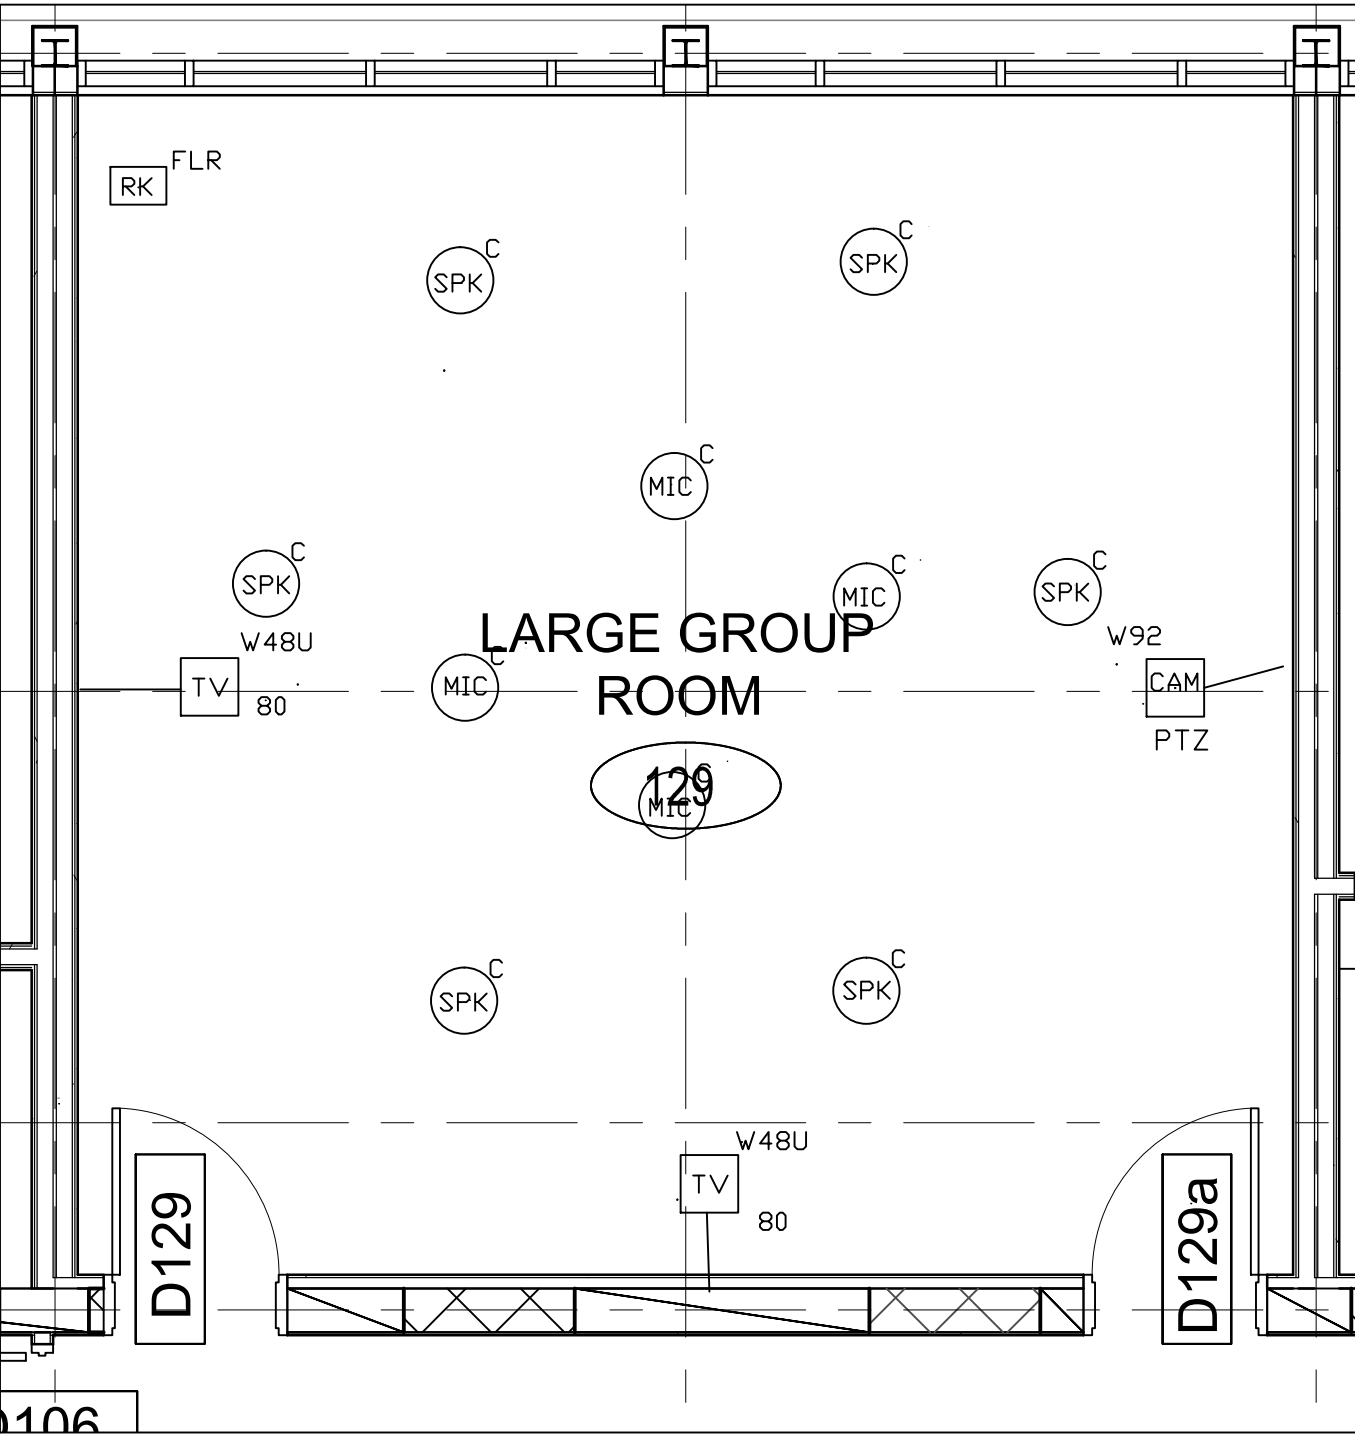


5 LARGE GROUP ROOM 233

SCALE: N.T.S.

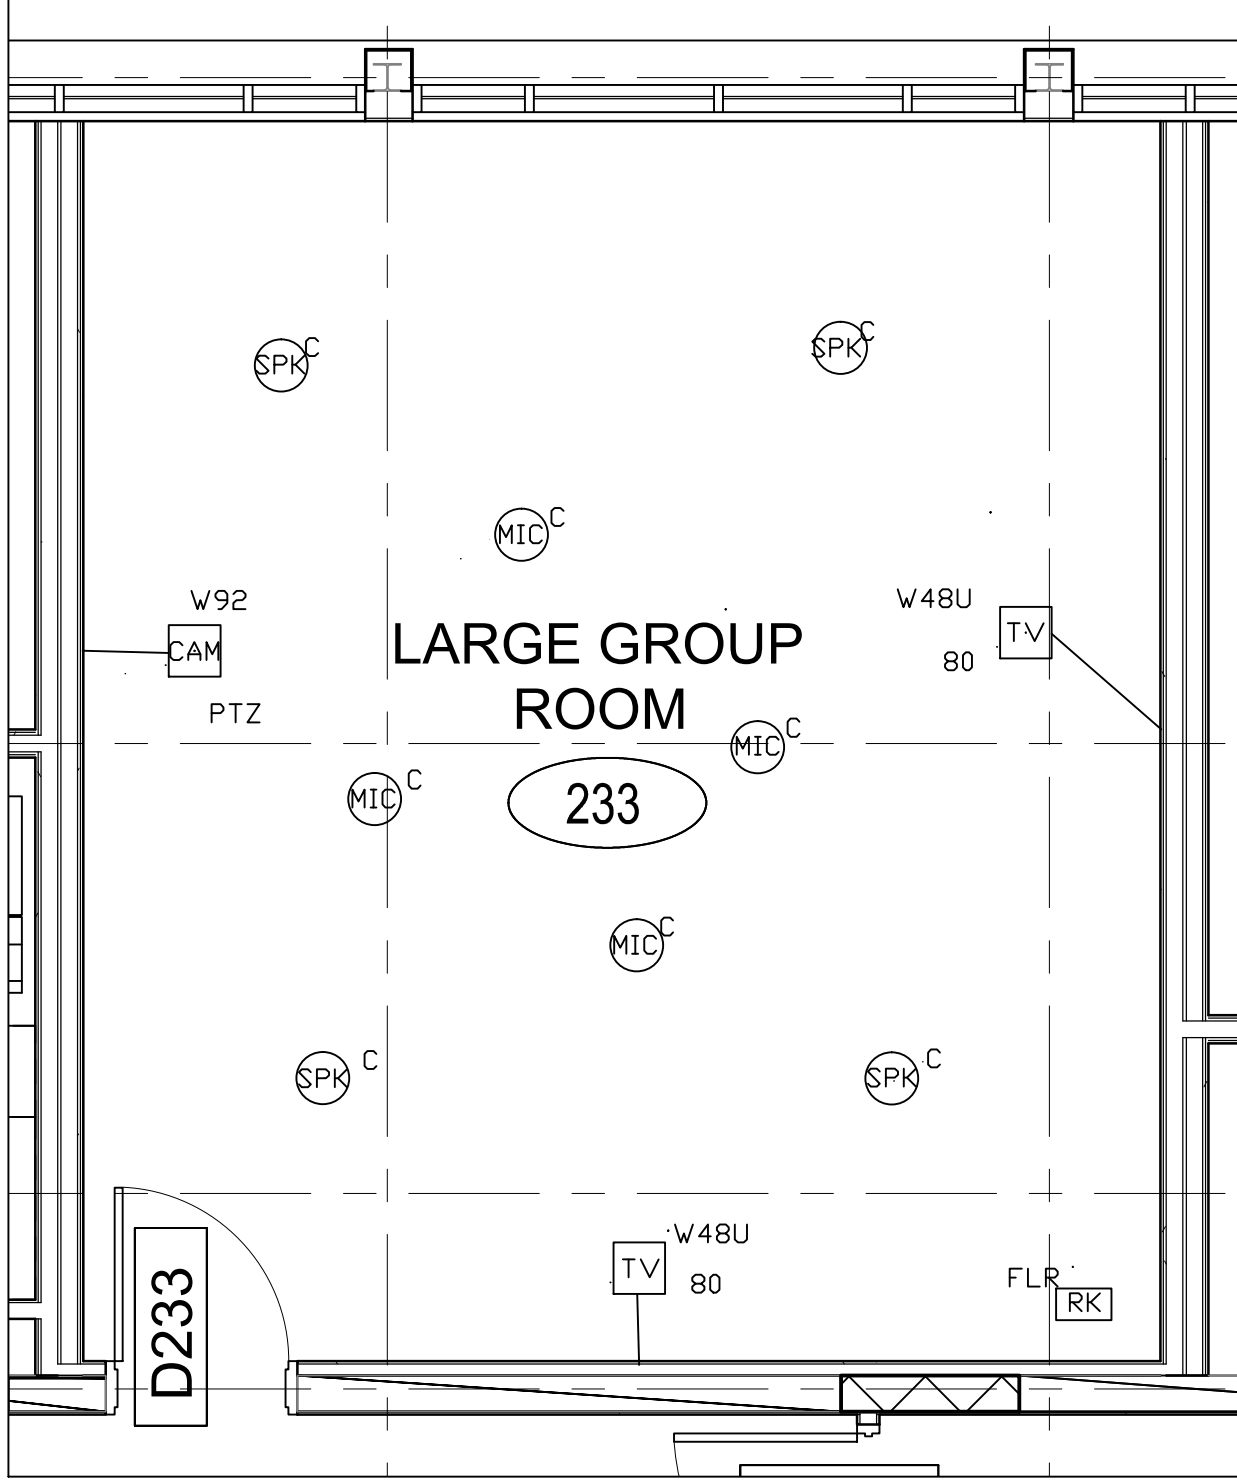





6 FAMILY THERAPY 215

SCALE: N.T.S.

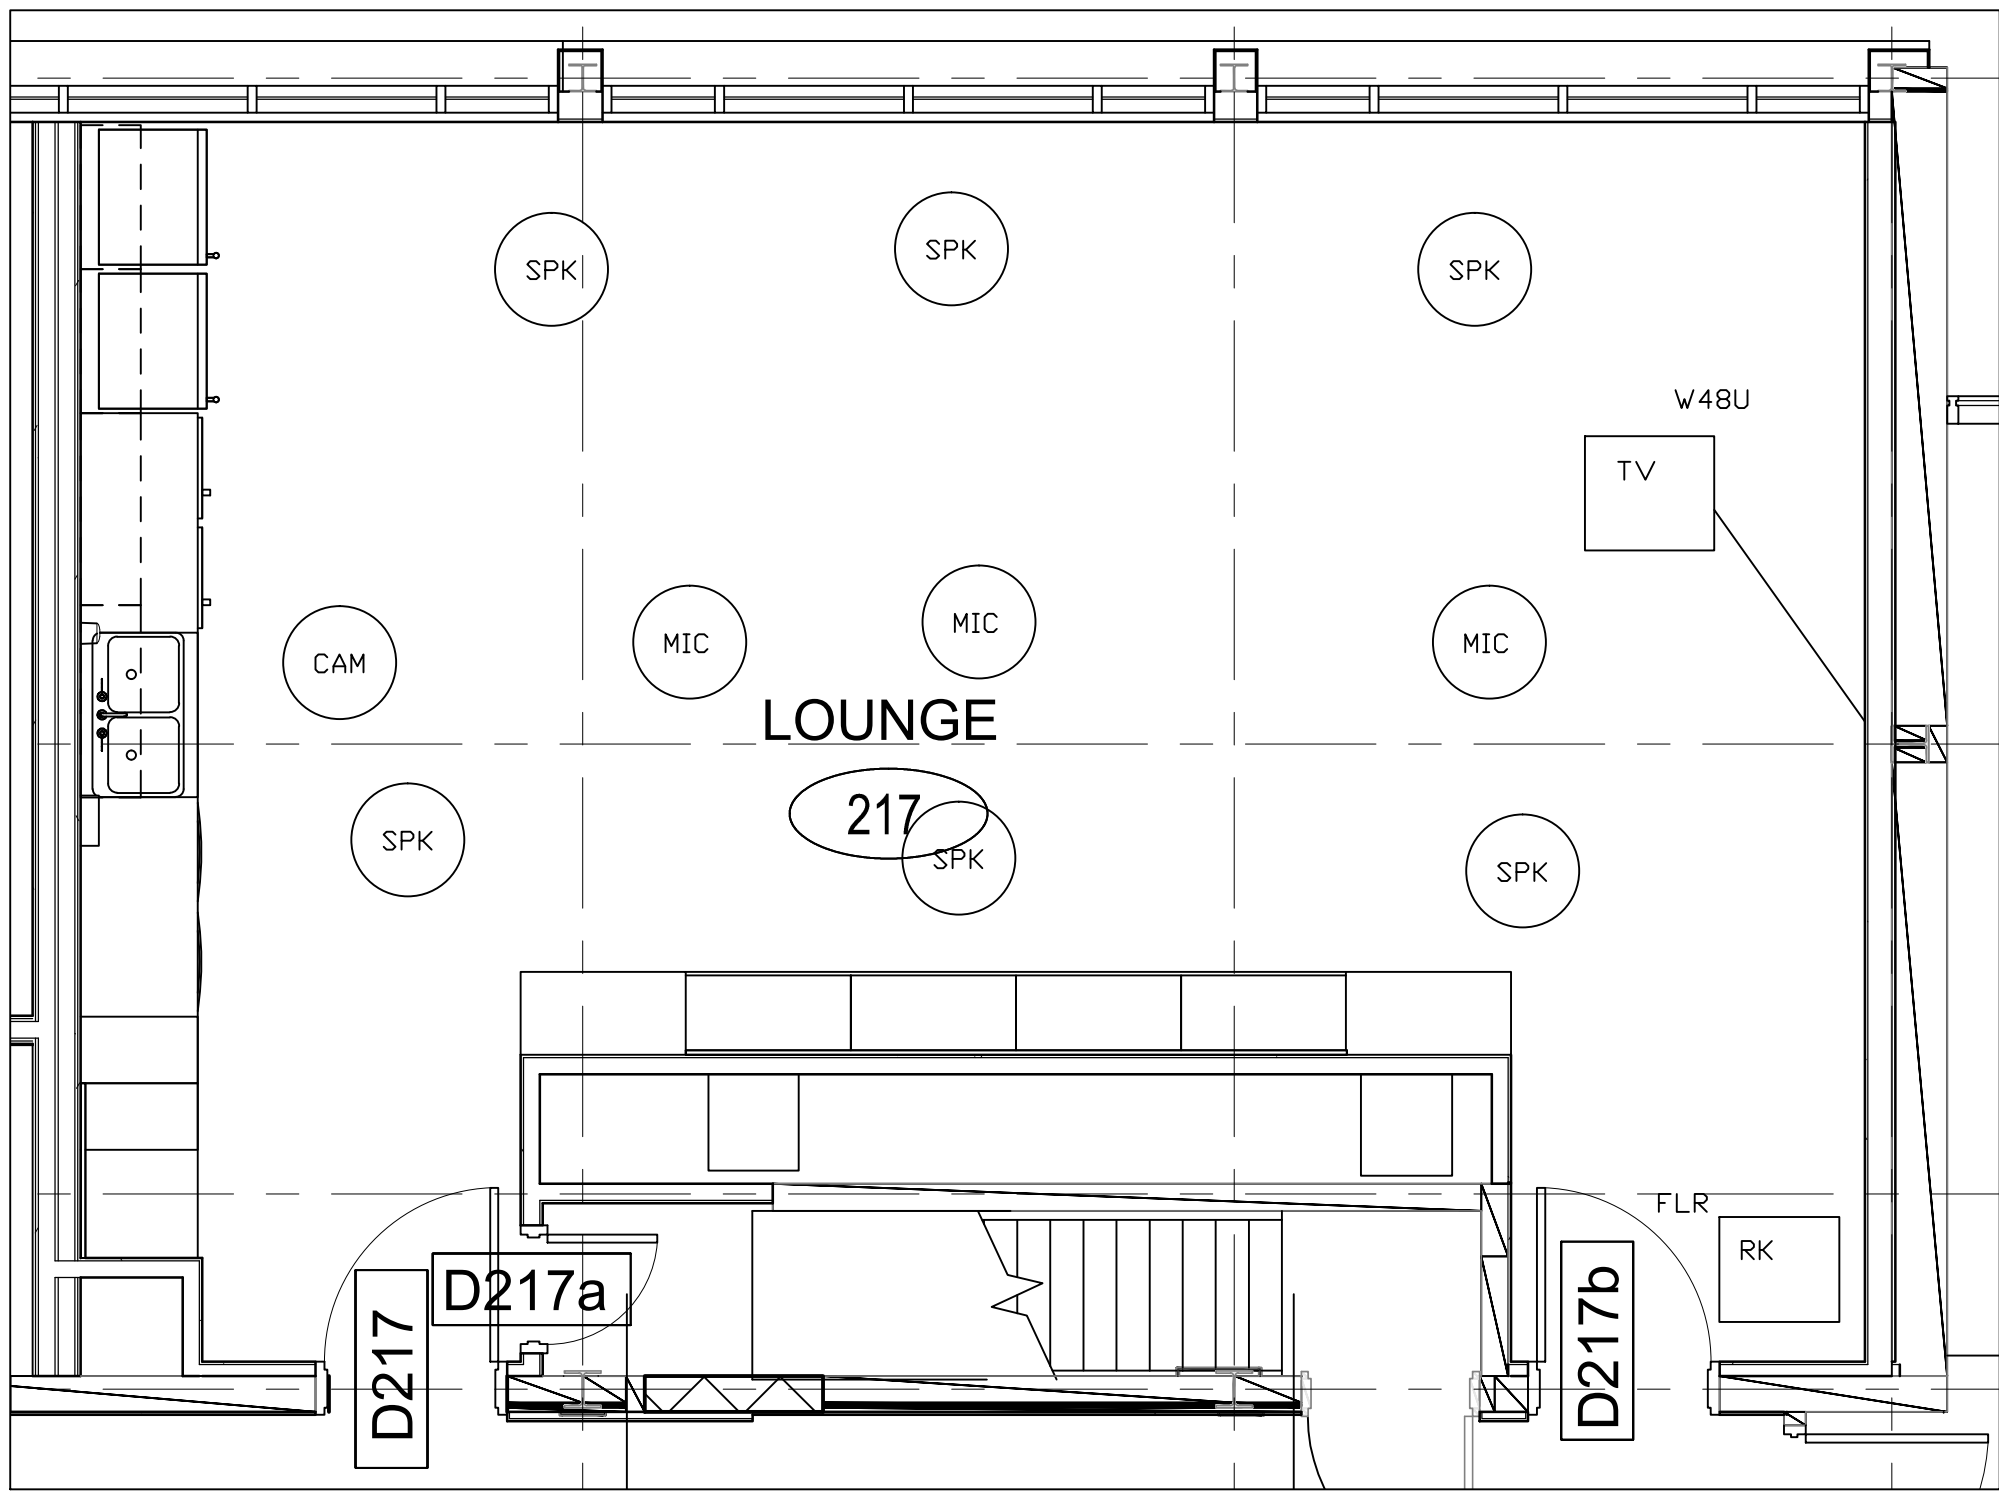


7 LOUNGE 217


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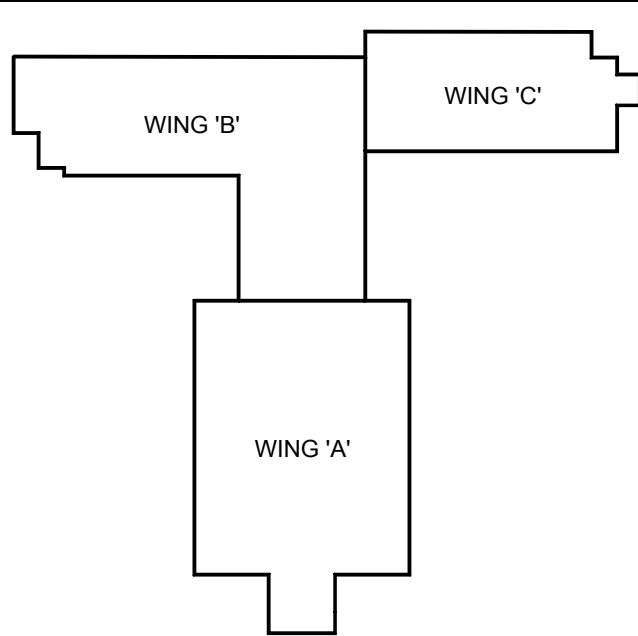
4 LARGE GROUP ROOM 233 AV ELEVATION
T110 SCALE: N.T.S.

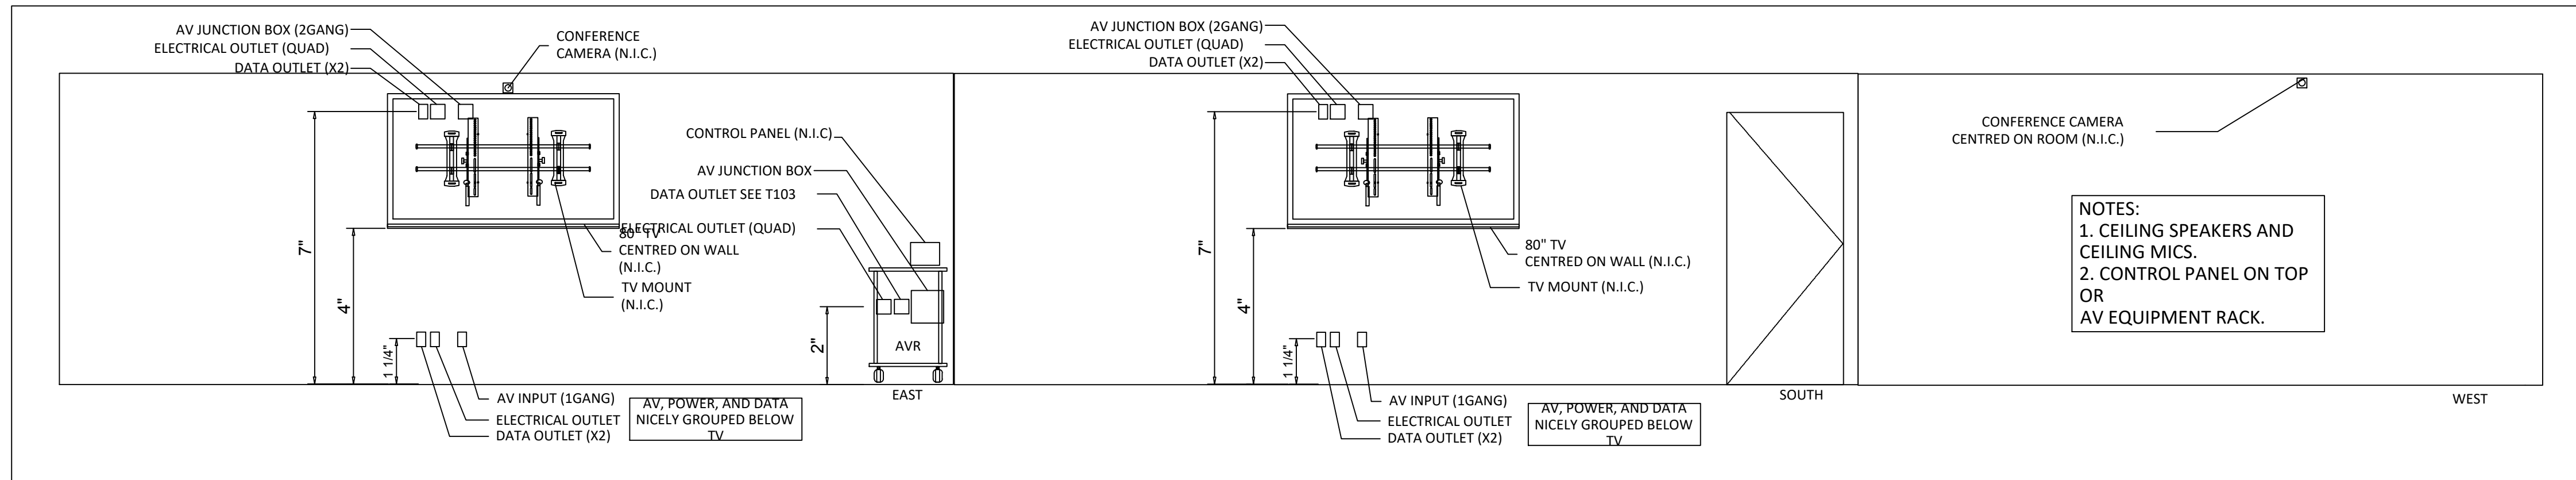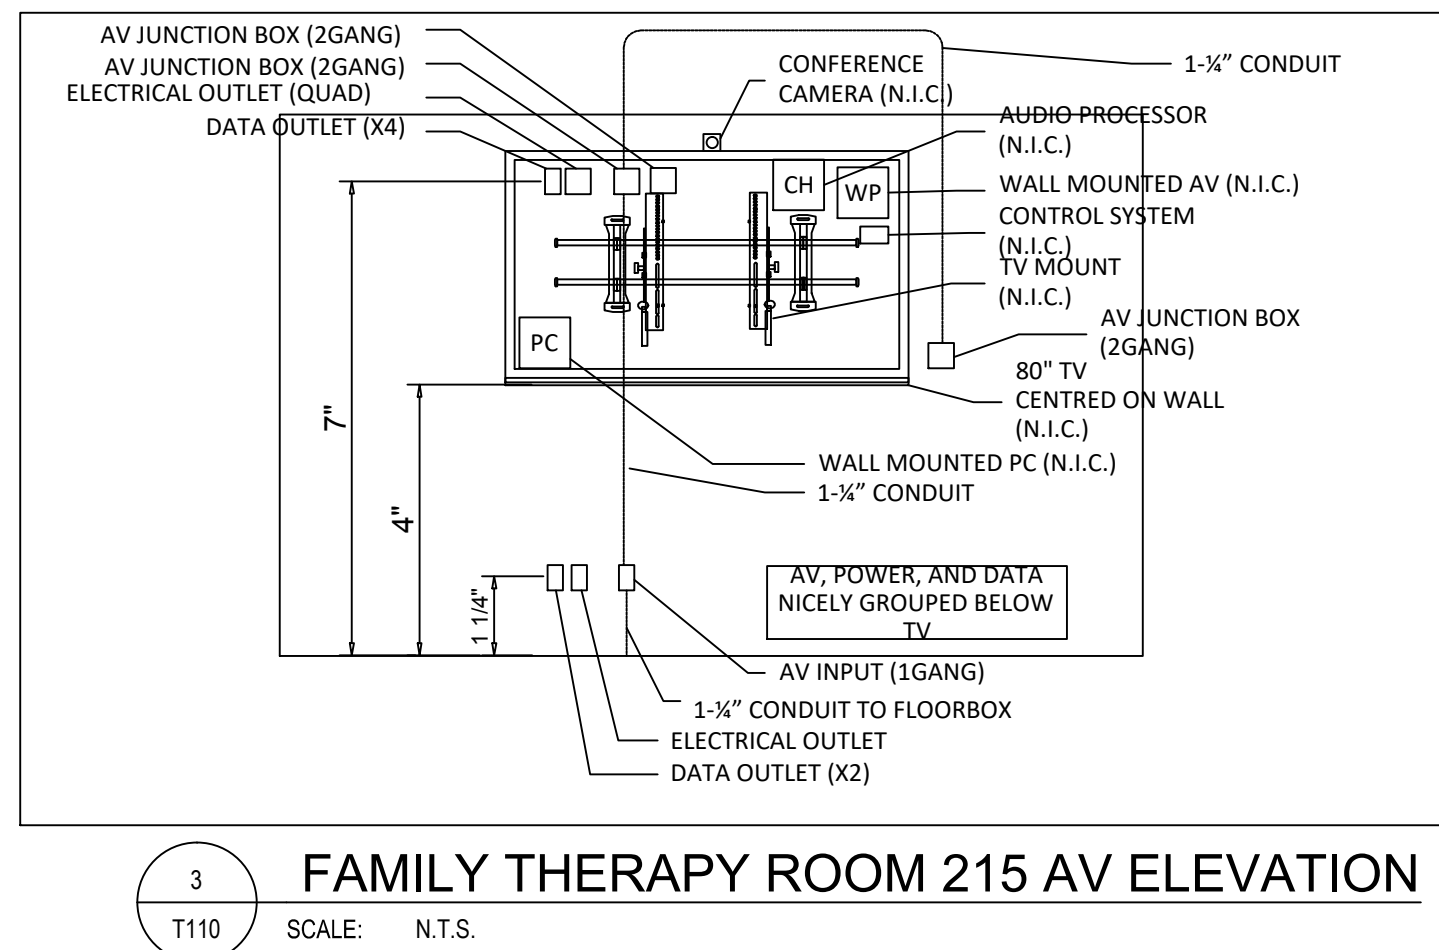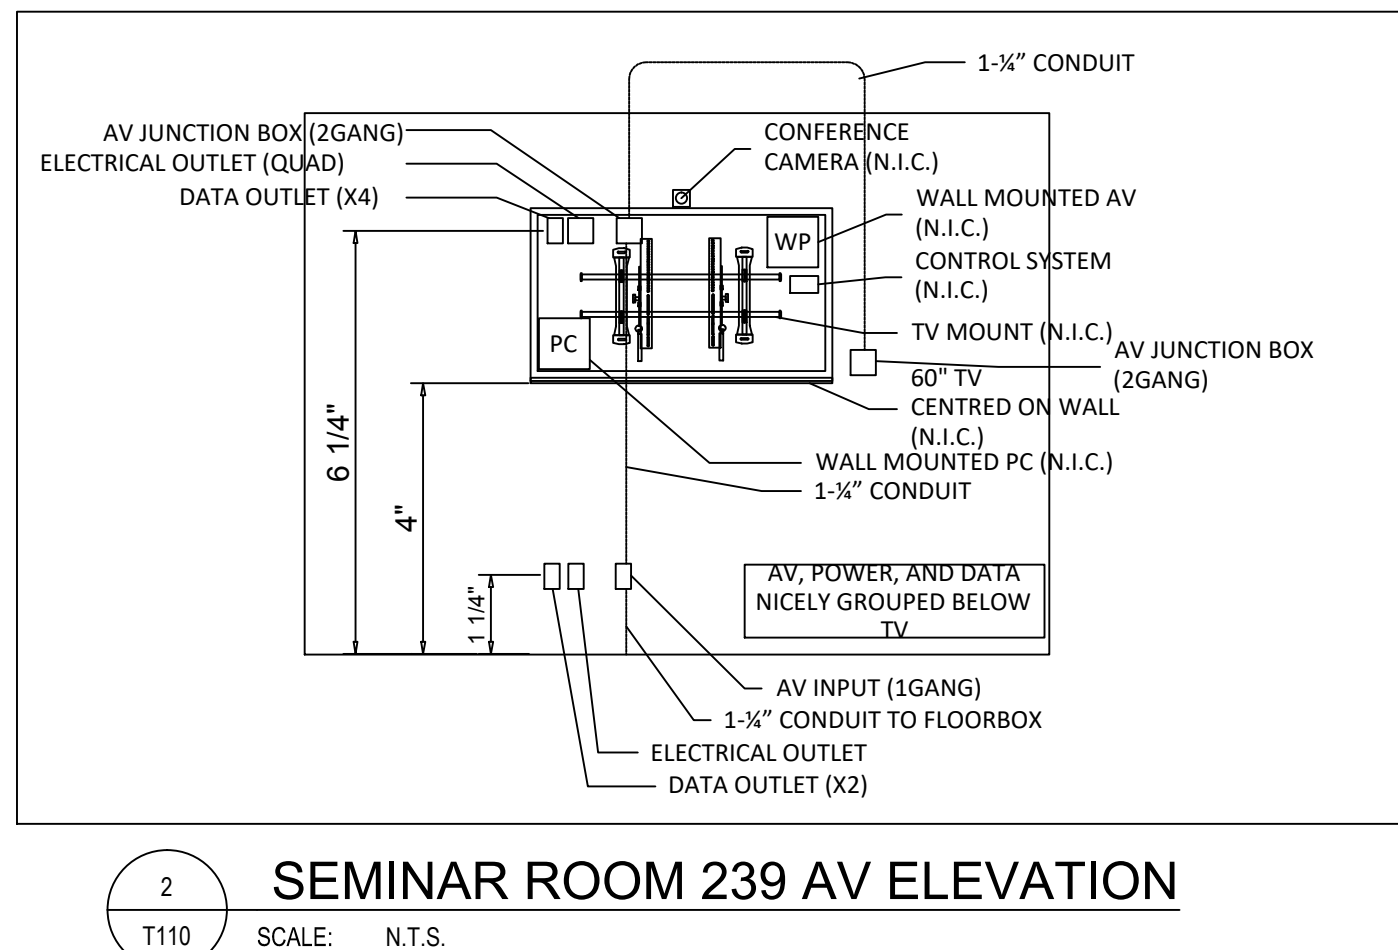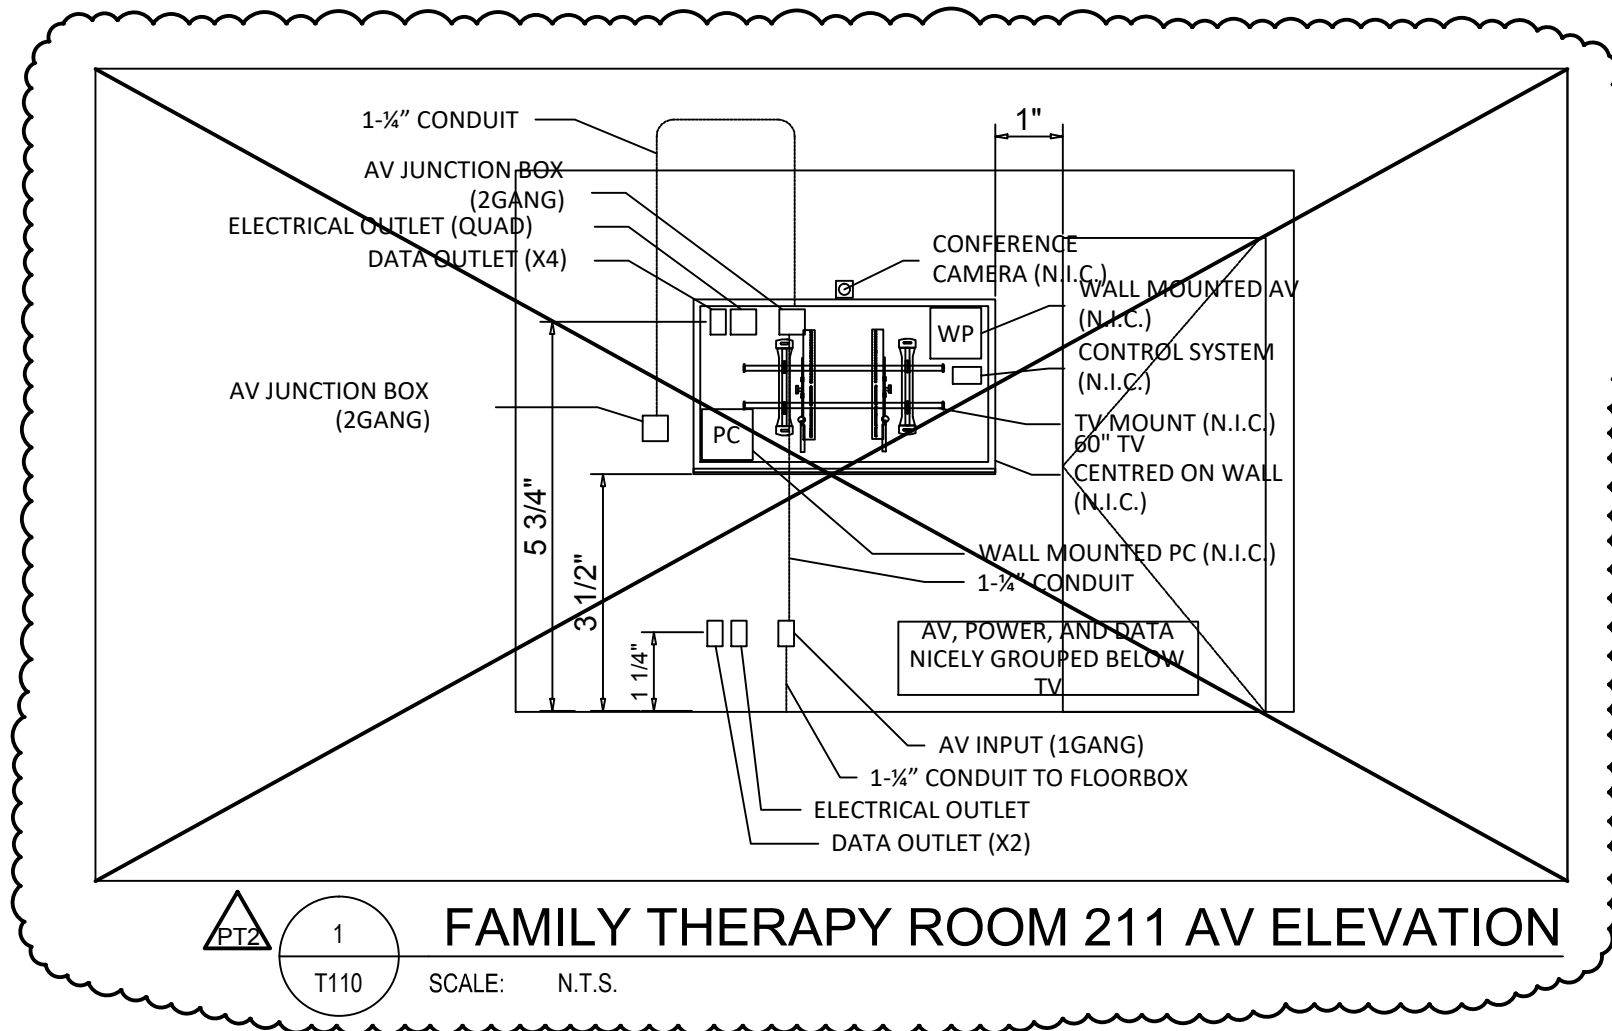

5 LOUNGE 217 AV ELEVATION
T110 SCALE: N.T.S.

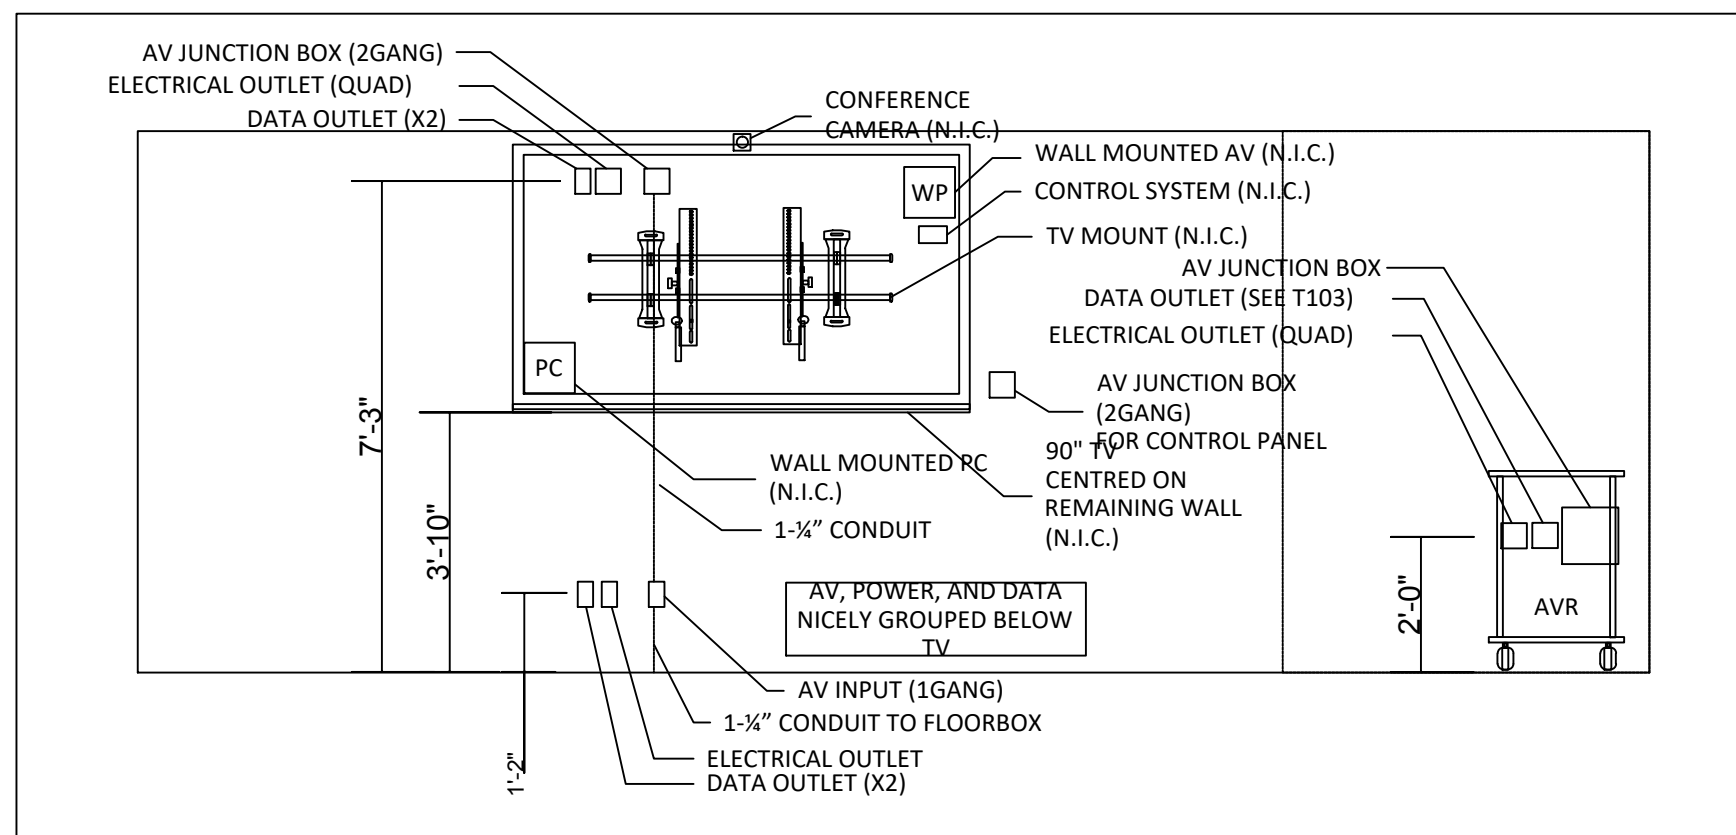

6 OFFICE 221, 223, 235, 227, 229 AV ELEVATION
T110 SCALE: N.T.S.

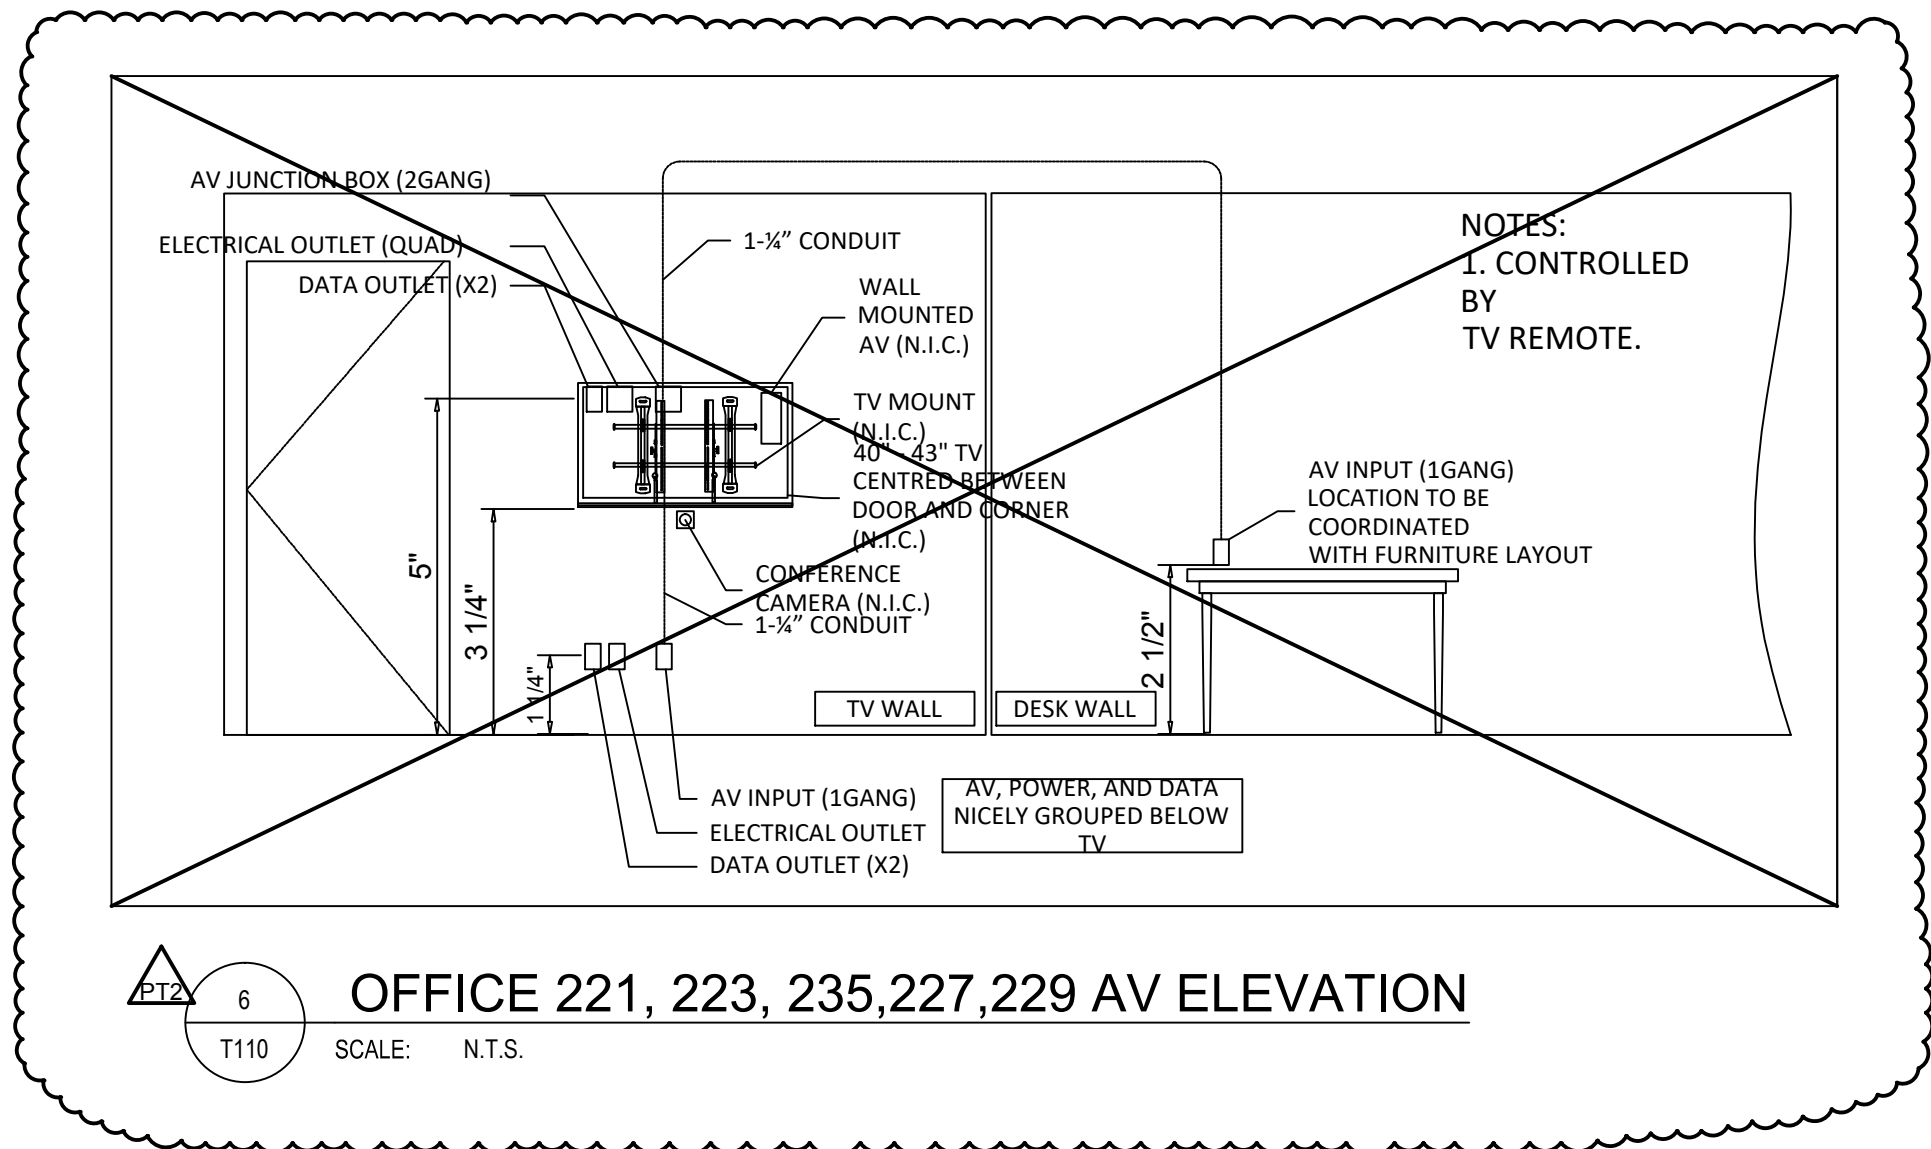

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Seal	Seal

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Project
**BUILDING #046
RENOVATIONS**

Drawing Title
**AV ELEVATIONS
WIND B LEVEL 2**

Project No.
504034

Location
**UNIVERSITY OF GUELPH
BUILDING #046**

Scale
AS SHOWN

Date
NOV 2, 2018

Drawn by
K.C.

Checked By
D.C.

Approved By
B.W.

JLR #

T110

of

Cad File No.