1.1 Ontario Building Code Analysis

1.1.1 General Introduction

The purpose of this review is to identify the Ontario Building Code (OBC) requirements and summarize JLR's approach with regard to fire and life safety applicable for the extensive renovation to Building 046 for the University of Guelph, located at 50 College Avenue West in Guelph, Ontario. This document is based on the requirements of the 2012 OBC, Ontario Regulation 332/12. [] indicates an OBC article reference. All references are to Division B unless otherwise noted.

The scope of this project involves extensive renovation [11.3.3.2.] to wings B and C of Building 046. As described in OBC Appendix A, when an existing building undergoes an extensive renovation, it should generally conform to the requirements of Part 3 once the renovations are complete.

Wings B and C will be occupied by separate tenants, both under the same occupancy classification. The project is organized to accommodate program spaces as noted below:

Ground Floor

Ground Floor		
 Entrance foyer 	 Mechanical room 	 Storage rooms
 Vestibule 	 Washrooms 	 Elevator
 Therapy rooms 	 Custodian room 	 Electrical room
 Viewing rooms 	 Research rooms 	 IT Server room
 Large group room 	 Student Work area 	Exits
 Offices 	 Kitchenette 	Exit stairs
 Administration spaces 	 Closed file storage 	 Corridor
 Waiting area 	 Medical records room 	
0		

 vvaiting area 	 Medical records room 	
Second Floor		
Lounge	Therapy rooms	 Classrooms
 Offices 	 Viewing rooms 	 Playrooms
 Large group room 	 Washrooms 	 Storage rooms
 Administration spaces 	 Custodian room 	 IT server rooms
 Waiting area 	 Wellness room 	Exit stairs
 Elevator 	 Prayer room 	 Corridor

Wings B and C will be considered separate suites. Roof, floors, walls and ceilings are being removed and replaced in Wing B. All ceilings are removed and replaced in Wing C. Therefore, the renovation must comply

.1 All structural and fire-resistance elements shall be constructed in compliance with all other

.2 Wing B must comply to [3.8] Barrier-Free Design [11.3.3.2.(2)(a)].

The remainder of this section will relate to Part 3 of the OBC.

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- The building is served by an elevator. [3.3.1.7] Corridors are greater than 1,100 mm. [3.3.1.9]
- No obstructions within the corridor will project more than 100 mm between 680 mm and 1,980
- mm above the floor. No doors open into access to exits. [3.3.1.10]
- Capacity of access to exits are as follows (6.1mm/person [3.3.1.16(2)]):
- .1 Doors (narrowest door DST203) = 158 people (965 mm) (2nd fl) Corridor (typical width location) = 375 people (2,275 mm) (2nd fl)
- Corridor (narrowest width location) = 150 people (1,200 mm) (2nd fl)
- Guards are required in the following locations: .1 At stairs and landings
- No transparent panels are used that could be mistaken as a means of egress. [3.3.1.18.(3)]
- No obstructions exist within means of egress. Owner is required to comply with this requirement. [3.3.1.22]
- No welding or cutting is planned within the building. [3.3.1.24]
- Classrooms have occupancy loads less than 200. [3.3.2.2.(8)]
- The building is sprinklered; no fire rating is required at the corridor. [3.3.2.5.(3)]

1.1.5 Exits [3.4]

- Each floor area is served by two exits. [3.4.2.1.(1)]
- The travel distance within the building is less than 45 m. [3.4.2.5.(1).(c)]
- Capacity of existing exits are as follows [3.4.3.2]:

Area	Wing B – Level 1	Wing B – Level 2	Wing C
Occupant Load	258	333	65
Occupant Load Contributing to each Exit Stair	129	167	33
Required Width of Exit Doors (6.1 mm/person)	787 mm	1,019 mm	201 mm
Provided Width of Exit Doors (smallest represented)	965 mm	1,930 mm	1,930 mm
Required Width of Exit Stair (8 mm/person)	1,032 mm	1,336 mm	N/A
Provided Width of Exit Stair	1,400 mm	1,400 mm	N/A
Required Exit Door Width to the Exterior (6.1 mm/person)	787 mm	1,019 mm	201 mm
Provided Exit Door Width to the Exterior	1,930 mm	1,930 mm	1,930 mm

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Building 046 - Renovations 1.1.2 General [3.1]

Rating of Firewall [3.1.10]

The rating of the existing firewall separating Wing A and Wing B shall be constructed from masonry or and shall have a fire-resistance rating of not less than 2hrs

Occupant Load [3.1.17]

The occupant load of Building 046 is as follows:

- Ground Floor Wing B = 258 persons
- Second Floor Wing B = 333 persons Wing C = 65

1.1.3 Building Fire Safety [3.2]

Occupancy Classification	
Major occupancy:	College and schools - Assembly - Group A, Division
Building area:	1,858.1 sq.m

- Building area: Building height: Two (2) Storeys 1,844.7 sq.m (19,856 sq.ft.) Ground floor area:
- Second floor area: 1,151 sq.m (12,389 sq.ft.) Mezzanine area:
- 2,995.7 (32,245 sq.ft.) Gross building area: # of streets facing: One (1)
- 2012 OBC classification: Group A, Division 2, up to 2 storeys, increased area, sprinklered [3.2.2.26]

Max permitted building area: 2,400 sq.m [3.2.2.26]

Building Size and Construction Relative to Occupancy

Construction Required: Combustible or non-combustible construction shall be used singly, and,

.1 Floor assemblies shall be fire separations with a 0hr fire resistance rating (frr).

.2 Loadbearing walls, columns and arches shall be of non-combustible construction. [3.2.2.26]

Proposed Construction:

.1	Construction:	Non-combustibl
.2	Roof assembly:	No rating
.3	Sprinklers:	Required
.4	No mezzanine is propo	sed within the building
.5	Floor assembly:	frr Ohr

.6 Load bearing components: frr 0hr

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JLR No: 27915-000 University No: 504034

 Headroom clearance for stairs are more than 2,050 mm; doorways are more than 2,050 mm; door closers will not reduce headroom to less than 1,980 mm. [3.4.3.5]

November 2018

• Exits' openings shall conform to OBC 3.4.4.1 – exit stairs to have a frr 45 mins.

Door Release Hardware [3.4.6.16]

- To achieve required security of the facility, electromagnetic locks will be installed on one leaf of the following doors which provide access to exit:
- D108, D106, D103, D202a, D206a
- Electromagnetic locks will not incorporate latches, pins or other similar devices to keep the door in the closed position and are designed in conformance with [3.4.6.16(4)]

1.1.6 Vertical Transportation [3.5]

- The elevator hoistway is separated from the remainder of the building by a fire separation having an
- The elevator machine room is separated from the remainder of the building by a fire separation having an frr of 45 min. [3.5.3.3]

1.1.7 Service Facilities [3.6]

- Access to the roof is for personnel servicing roof top equipment and general maintenance only. Access to roof top is by stairway. [3.3.1.3.(10)]
- Mechanical rooms shall be separated from the remainder of the building by a fire separation having
- an frr of 1 hour. [3.6.2.1.(1)] All other service rooms shall be separated from the remainder of the building by a fire separation
- having an frr of 1 hour. [3.5.3.3]
- · Vertical services spaces to be separated from the remainder of the building by a fire separation having an frr of 0 hour. [3.6.3.1]

1.1.8 Health Requirements [3.7]

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• Toilet fixtures required for the building are as follows [3.7.4.3.(15)]:

Wing	Level	Occupant Load	Ratio	Fixtures Required	Fixtures Provided
В	1	258 = 129 male 129 female	1/100 Person 1/75 Person	2 2	7
В	2	333 = 167 male 167 female	1/100 Person 1/75 Person	3 3	7
С	3	65 = 33 male 33 female	1/100 Person 1/75 Person	1	2

• There are barrier free washrooms provided on all floors of the building, and universal washrooms provided on all floors of each wing (three (3) universal washrooms total).

November 2018

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Ontario Building Code Review University of Guelph

Building 046 - Renovations

Spatial Separation and Exposure Protection [3.2.3]

- Exterior walls of exit enclosures will not be exposed to fire from:
 - Openings in the exterior walls of the building. [3.2.3.13]
- No openings in exterior wall of a fire compartment will be exposed to openings in the exterior walls of another fire compartment.
- Based on the limiting distances in [Table 3.2.3.1.D], the areas of unprotected openings permitted in the exposing building faces are as follows:

Proposed Building Face	Area (sq.m)	Limiting Distance	%Unprotected openings permitted	% Openings	
	Fire Compartment 1 (Wing C)				
North	> 137.1	> 9 m	100 %	< 46.6%	
South	> 127.8	> 9 m	100 %	< 49.5%	
East	> 22.4	> 4 m	90 %	< 38.2%	
West	> 19.2	> 7.2 m	100 %	< 27.5%	
	Fire Co	mpartment	2 (Vestibule C100)		
North	> 573.8	> 9 m	100 %	< 90.3%	
South	N/A	N/A	N/A	N/A	
East	N/A	N/A	N/A	N/A	
West	N/A	N/A	N/A	N/A	
	Fir	e Compartm	nent 3 (Wing B)		
North	> 304.5	> 9 m	100 %	< 58.1%	
South	> 200.1	> 9 m	100 %	< 50.4%	
East -1	> 10.2	> 7.2 m	100 %	< 0%	
East -2	> 113.19	> 9 m	100 %	< 56.9%	
West	> 153.7	> 9 m	100 %	< 54.0%	
	Fir	e Compartm	nent 4 (Wing B)		
North	N/A	N/A	N/A	N/A	
South	N/A	N/A	N/A	N/A	
East	N/A	N/A	N/A	N/A	
West	> 16.5	> 9 m	100 %	< 90.0%	
Fire Compartment 5 (Wing B)					
North	N/A	N/A	N/A	N/A	
South	> 26.3	> 9 m	100 %	< 0%	
East	N/A	N/A	N/A	N/A	
West	> 61.7	> 9 m	100 %	< 8.0%	

Construction of Exposing Building face [3.2.3.7]

 Building faces where the permitted % of unprotected openings is greater than 25% and less that 100% shall have a fire-resistance rating of 45 min and are permitted to be of combustible or non-combustible construction.

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1.1.9 Barrier Free Design [3.8]

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• There are four (4) pedestrian entrances, requiring two (2) to be barrier free. This project

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- will look to upgrading the west and north elevations to be barrier free. [3.8.1.2] The approach to the main entrance from the sidewalk is designed in conformance with
- OBC 3.8.3.2 "exterior walks".
- Door from exterior to vestibule will be equipped with power door operators. [3.8.3.3]
- Barrier free washrooms are designed in accordance with OBC 3.8.3.8 to 3.8.3.11. Universal washrooms are designed in accordance with OBC 3.8.3.12.

Ontario Building Code Review University of Guelph

Building 046 - Renovations

 As per 3.2.3.1(3) for determination of the construction of the assembly, the limiting distance shall be taken as the project of the exterior wall onto a vertical plane located so that no portion of the exterior wall of the building or of a fire compartment is beyond that vertical plane. This impacts one elevation listed below.

Proposed Building Face	Area (sq.m)	Limiting Distance	%Unprotected openings permitted	Required Rating of Exposed Building Face
30	Fi	re Compartn	nent 1 (Wing C)	
East	> 22.4	> 3.0 m	60 %	45 min

Fire Alarm [3.2.4]

- A fire alarm is required for the building. [3.2.4.1 (2) (f)]
- Manual pull stations are required as per [3.2.4.18]

Provisions for Fire Fighting [3.2.5]

- The building is sprinklered.
- Openings for access to above grade storeys are not required. [3.2.5.1]
- Roof access is not required. [3.2.5.3] A sprinkler fire department connection is being added. No revisions to the existing fire-route
- will be required.
- Portable fire extinguishers will be provided as per part 6 of the fire code. [3.2.5.17]
- Emergency lighting will be provided. [3.2.7.3] • There are no mezzanines or openings through floor assemblies. [3.2.8]
- The building does not contain an interconnected floor space. [3.2.8.1]

• As per [3.2.8.2.(6)], Articles [3.2.8.3] to [3.2.8.11] do not apply to the building.

Removal of Existing Standpipe [3.2.9]

and Enterprise City of Guelph - August 28, 2018).

- A standpipe system is not required.[3.2.9.1 (1) to (6)] An existing standpipe system exists within the building.
- Through the removal of the standpipe and installation of a sprinkler system, the performance
- level of fire protective equipment is not being decreased. · Correspondence with the City of Guelph officials established this approach is acceptable. (Becky Montyro, CBCO, Plans Examiner III, Building Services, Infrastructure, Development

1.1.4 Safety Within Floor Areas [3.3]

- General Safety There are two suites within the building. A fire separation with a fire-resistance rating of 45 min will be required between suites. [3.3.1.1(2)]
- There is no storage of hazardous substances within the building. [3.3.1.2]

Access to roof top is by stairway and access ladders. [3.3.1.3.(10)]

- Access to the roof is for personnel servicing roof top equipment and general maintenance only.
- There is no public corridor within the building. [1.4.1.2], [3.3.1.4]

Two egress doors are to be provided from each. [3.3.1.5]

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DO NOT SCALE DRAWINGS:

Contractors must check and verify all site conditions. Notify the Owner's Representative in writing before proceeding with the work if discrepancies are evident between the drawings and the site condition. No extras to the contract will be allowed if discrepancies were evident prior to start of work.

UNEXPECTED DISCOVERY OF ASBESTOS:

Where a friable material is discovered during construction, renovations and/or demolition, and it is suspected to contain asbestos, the Contractor must stop all work that may disturb the material. The Contractor shall advise the Owner of the discovery and await instructions from the owner.



NO. ISSUED

Orientation

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Drawing Title

BUILDING #046 RENOVATIONS

OBC REVIEW

Project No. 504034

UNIVERSITY OF GUELPH BUILDING #046


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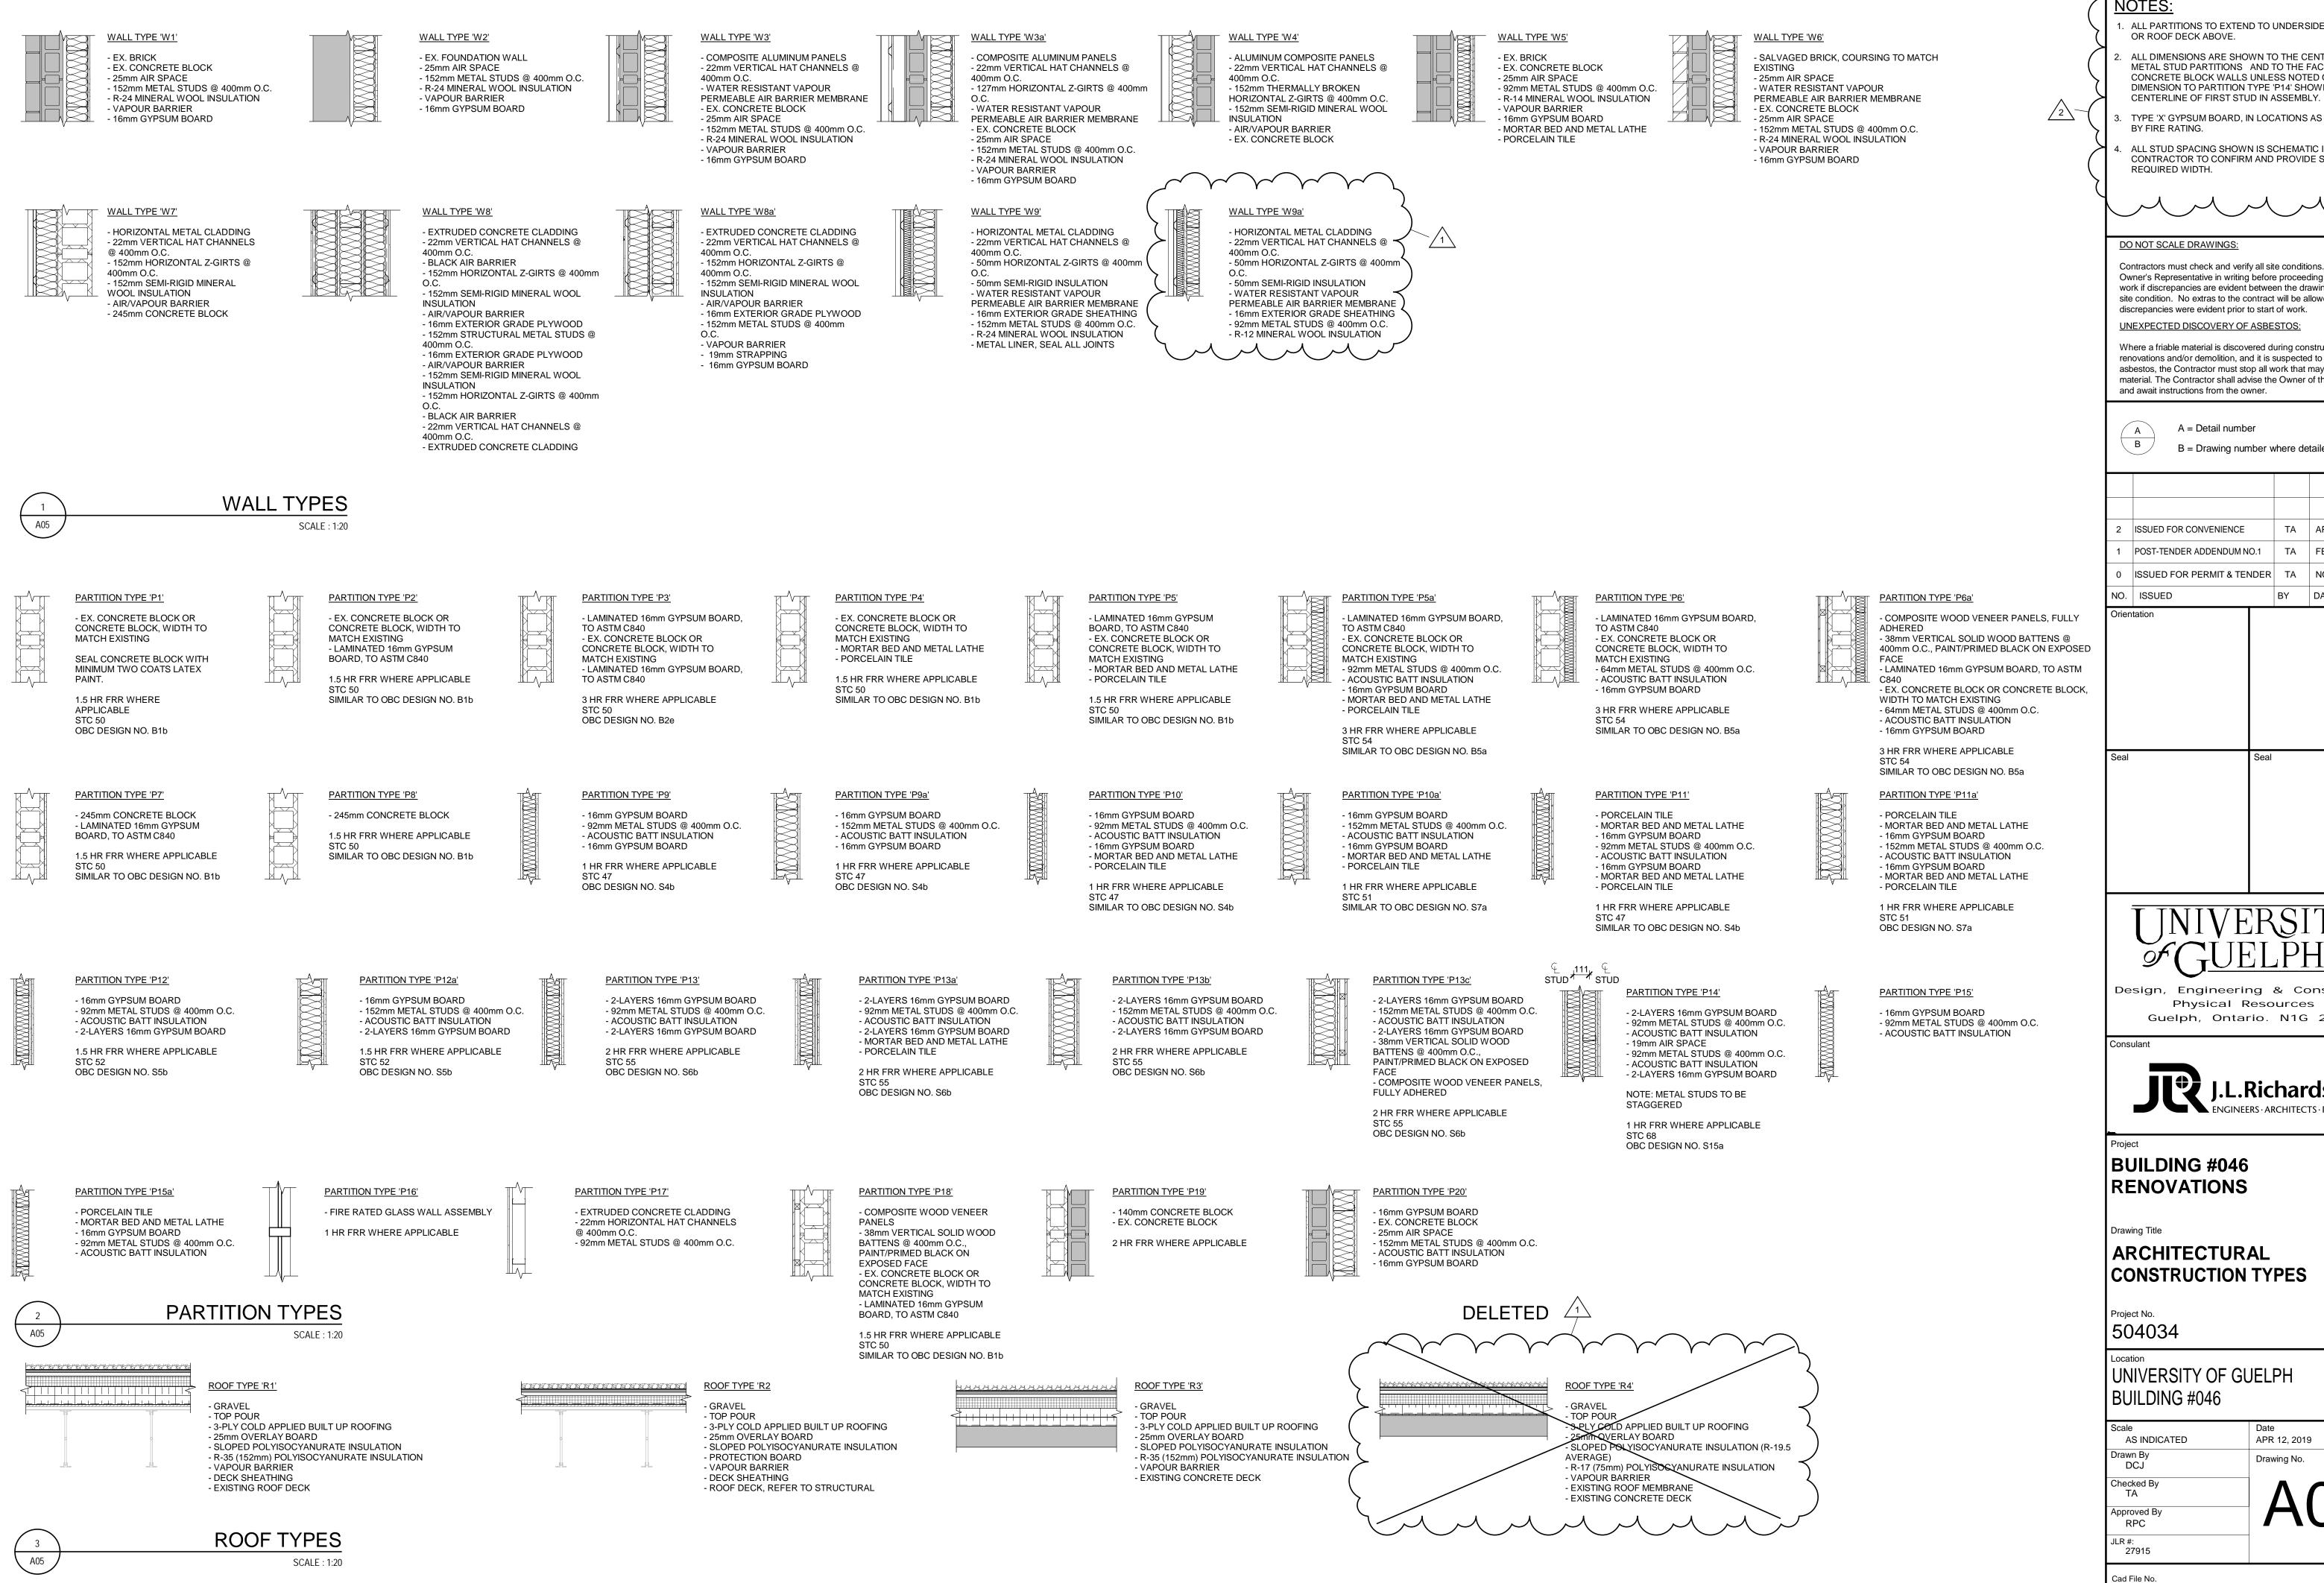
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Cad File No.

JIR#:

27915



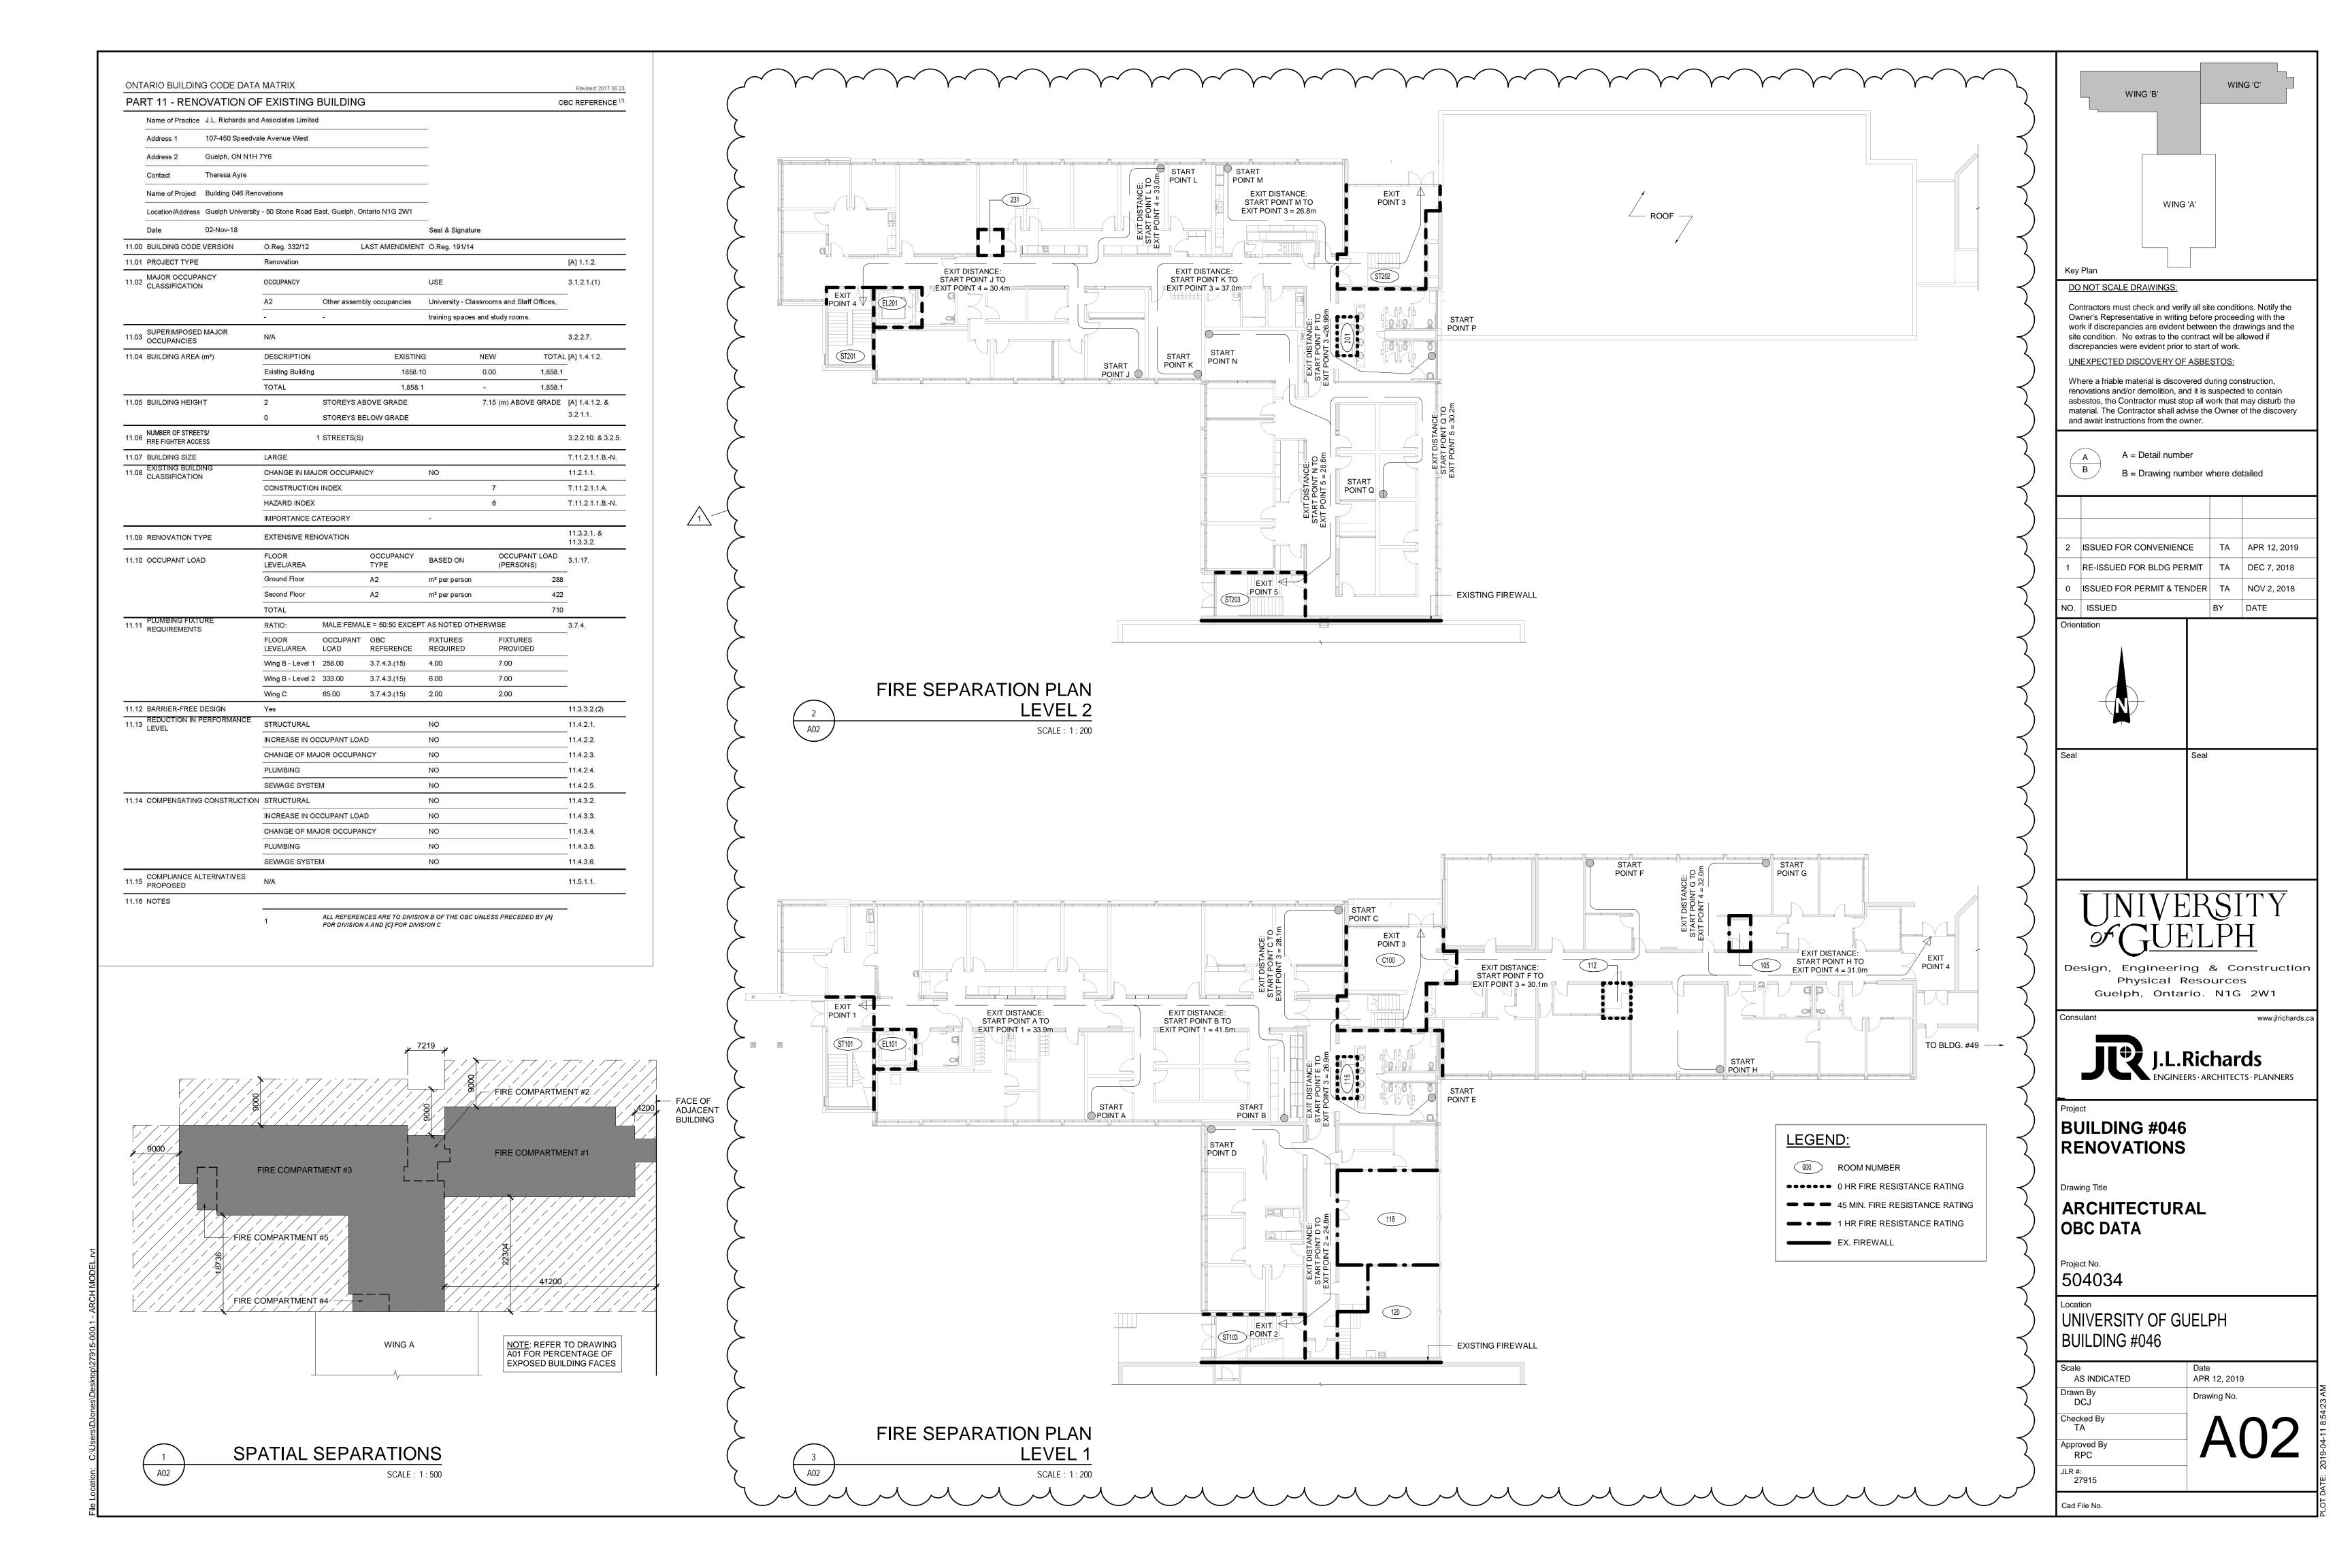

ALL PARTITIONS TO EXTEND TO UNDERSIDE OF FLOOR OR ROOF DECK ABOVE.

ALL DIMENSIONS ARE SHOWN TO THE CENTERLINE OF METAL STUD PARTITIONS AND TO THE FACE OF CONCRETE BLOCK WALLS UNLESS NOTED OTHERWISE. DIMENSION TO PARTITION TYPE 'P14' SHOWN TO

TYPE 'X' GYPSUM BOARD, IN LOCATIONS AS REQUIRED BY FIRE RATING.

ALL STUD SPACING SHOWN IS SCHEMATIC IN NATURE. ≺ CONTRACTOR TO CONFIRM AND PROVIDE STUDS AT

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BUILDING #046 RENOVATIONS

Drawing Title


ARCHITECTURAL CONSTRUCTION TYPES

Project No. 504034


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AS INDICATED APR 12, 2019

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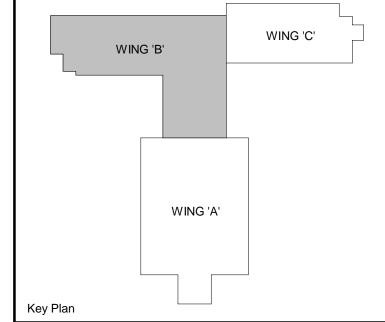


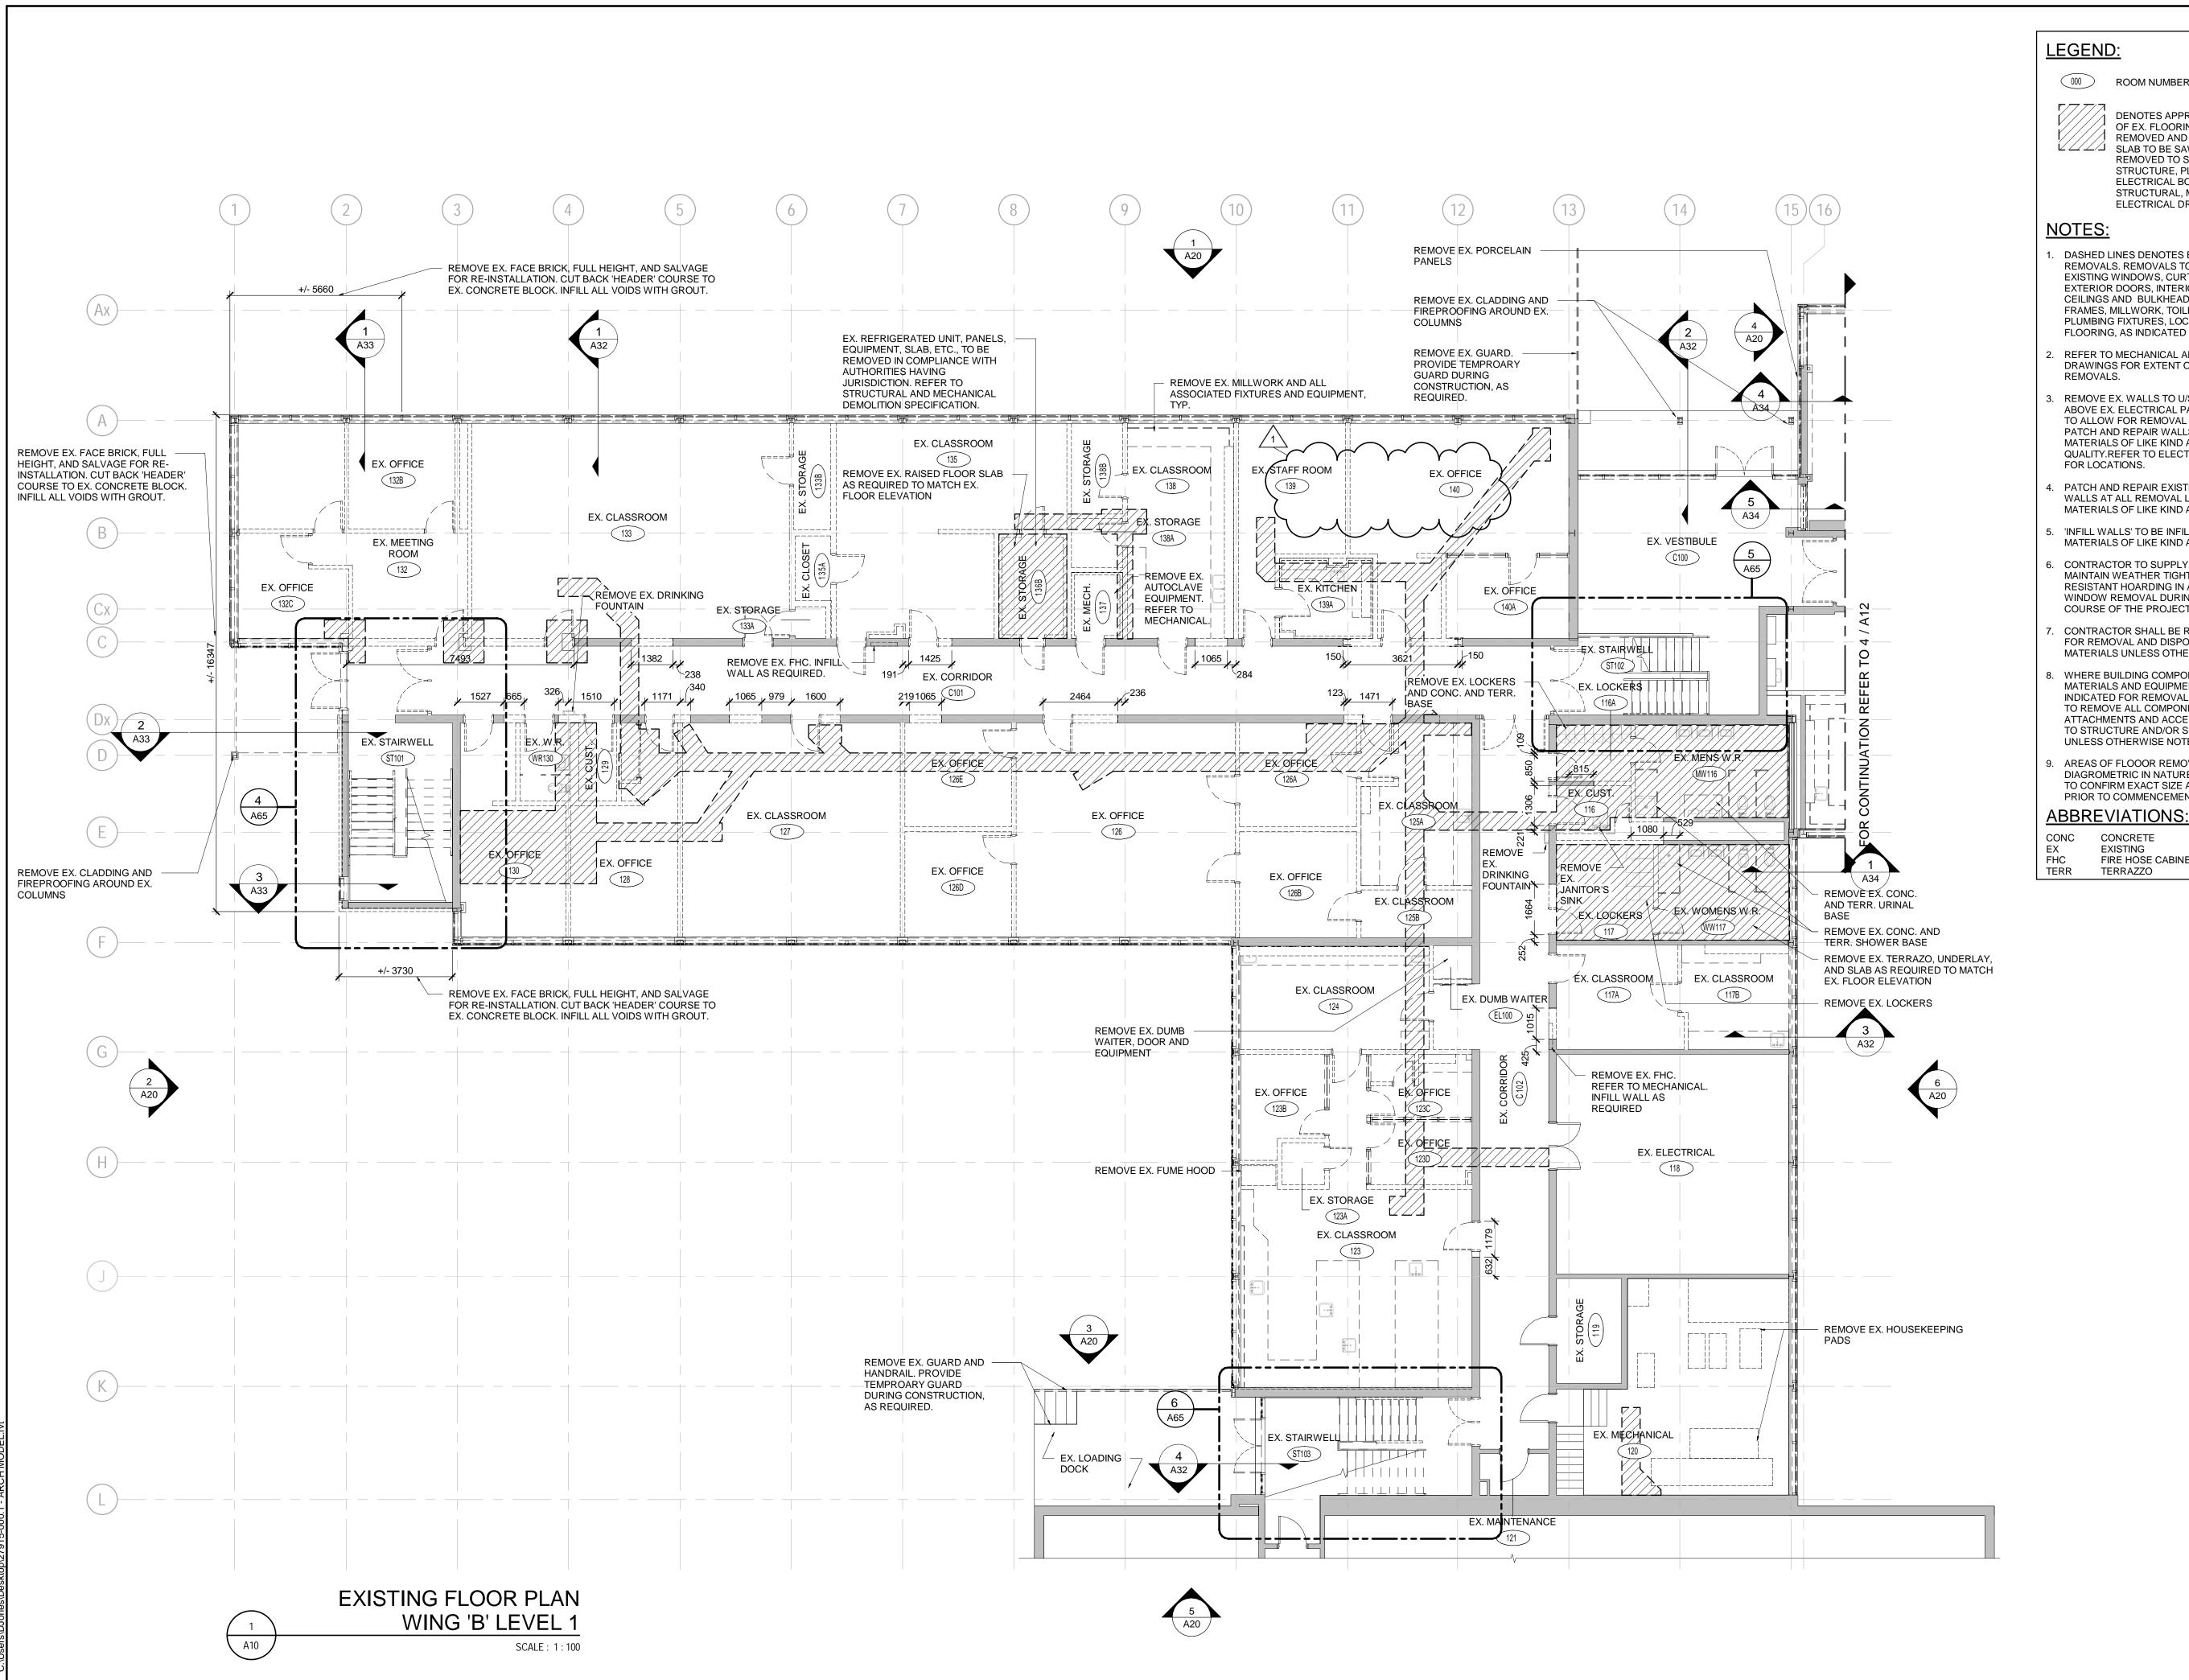

DENOTES APPROXIMATE EXTENT OF EX. FLOORING TO BE REMOVED AND EX. CONCRETE ∠∠/∠/」 SLAB TO BE SAWCUT AND REMOVED TO SUIT NEW STRUCTURE, PLUMBING OR ELECTRICAL BOXES. REFER TO STRUCTURAL, MECHANICAL AND ELECTRICAL DRAWINGS.

- DASHED LINES DENOTES EXTENT OF REMOVALS. REMOVALS TO INCLUDE EXISTING WINDOWS, CURTAIN WALLS, EXTERIOR DOORS, INTERIOR WALLS, CEILINGS AND BULKHEADS, DOORS AND FRAMES, MILLWORK, TOILET PARTITIONS, PLUMBING FIXTURES, LOCKERS AND FLOORING, AS INDICATED ON DRAWINGS.
- REFER TO MECHANICAL AND ELECTRICAL DRAWINGS FOR EXTENT OF M&E REMOVALS.
- REMOVE EX. WALLS TO U/S OF CEILING ABOVE EX. ELECTRICAL PANEL REMOVALS TO ALLOW FOR REMOVAL OF EX. CONDUIT. PATCH AND REPAIR WALLS WITH MATERIALS OF LIKE KIND AND QUALITY.REFER TO ELECTRICAL DRAWING FOR LOCATIONS.
- PATCH AND REPAIR EXISTING FLOORS AND WALLS AT ALL REMOVAL LOCATIONS WITH MATERIALS OF LIKE KIND AND QUALITY.
- 'INFILL WALLS' TO BE INFILLED WITH MATERIALS OF LIKE KIND AND QUALITY.
- CONTRACTOR TO SUPPLY, INSTALL AND MAINTAIN WEATHER TIGHT AND VANDAL RESISTANT HOARDING IN AREAS OF WINDOW REMOVAL DURING THE ENTIRE COURSE OF THE PROJECT.
- CONTRACTOR SHALL BE RESPONSIBLE FOR REMOVAL AND DISPOSAL OF ALL MATERIALS UNLESS OTHERWISE NOTED.
- WHERE BUILDING COMPONENTS, MATERIALS AND EQUIPMENT ARE INDICATED FOR REMOVAL, CONTRACTOR TO REMOVE ALL COMPONENTS, ATTACHMENTS AND ACCESSORIES BACK TO STRUCTURE AND/OR SUBSTRATE UNLESS OTHERWISE NOTED.
- AREAS OF FLOOOR REMOVALS/REPAIRS DIAGROMETRIC IN NATURE. CONTRACTOR TO CONFIRM EXACT SIZE AND LOCATION PRIOR TO COMMENCEMENT OF WORK.

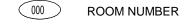CONCRETE **EXISTING** FIRE HOSE CABINET



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Where a friable material is discovered during construction, renovations and/or demolition, and it is suspected to contain asbestos, the Contractor must stop all work that may disturb the material. The Contractor shall advise the Owner of the discovery and await instructions from the owner.



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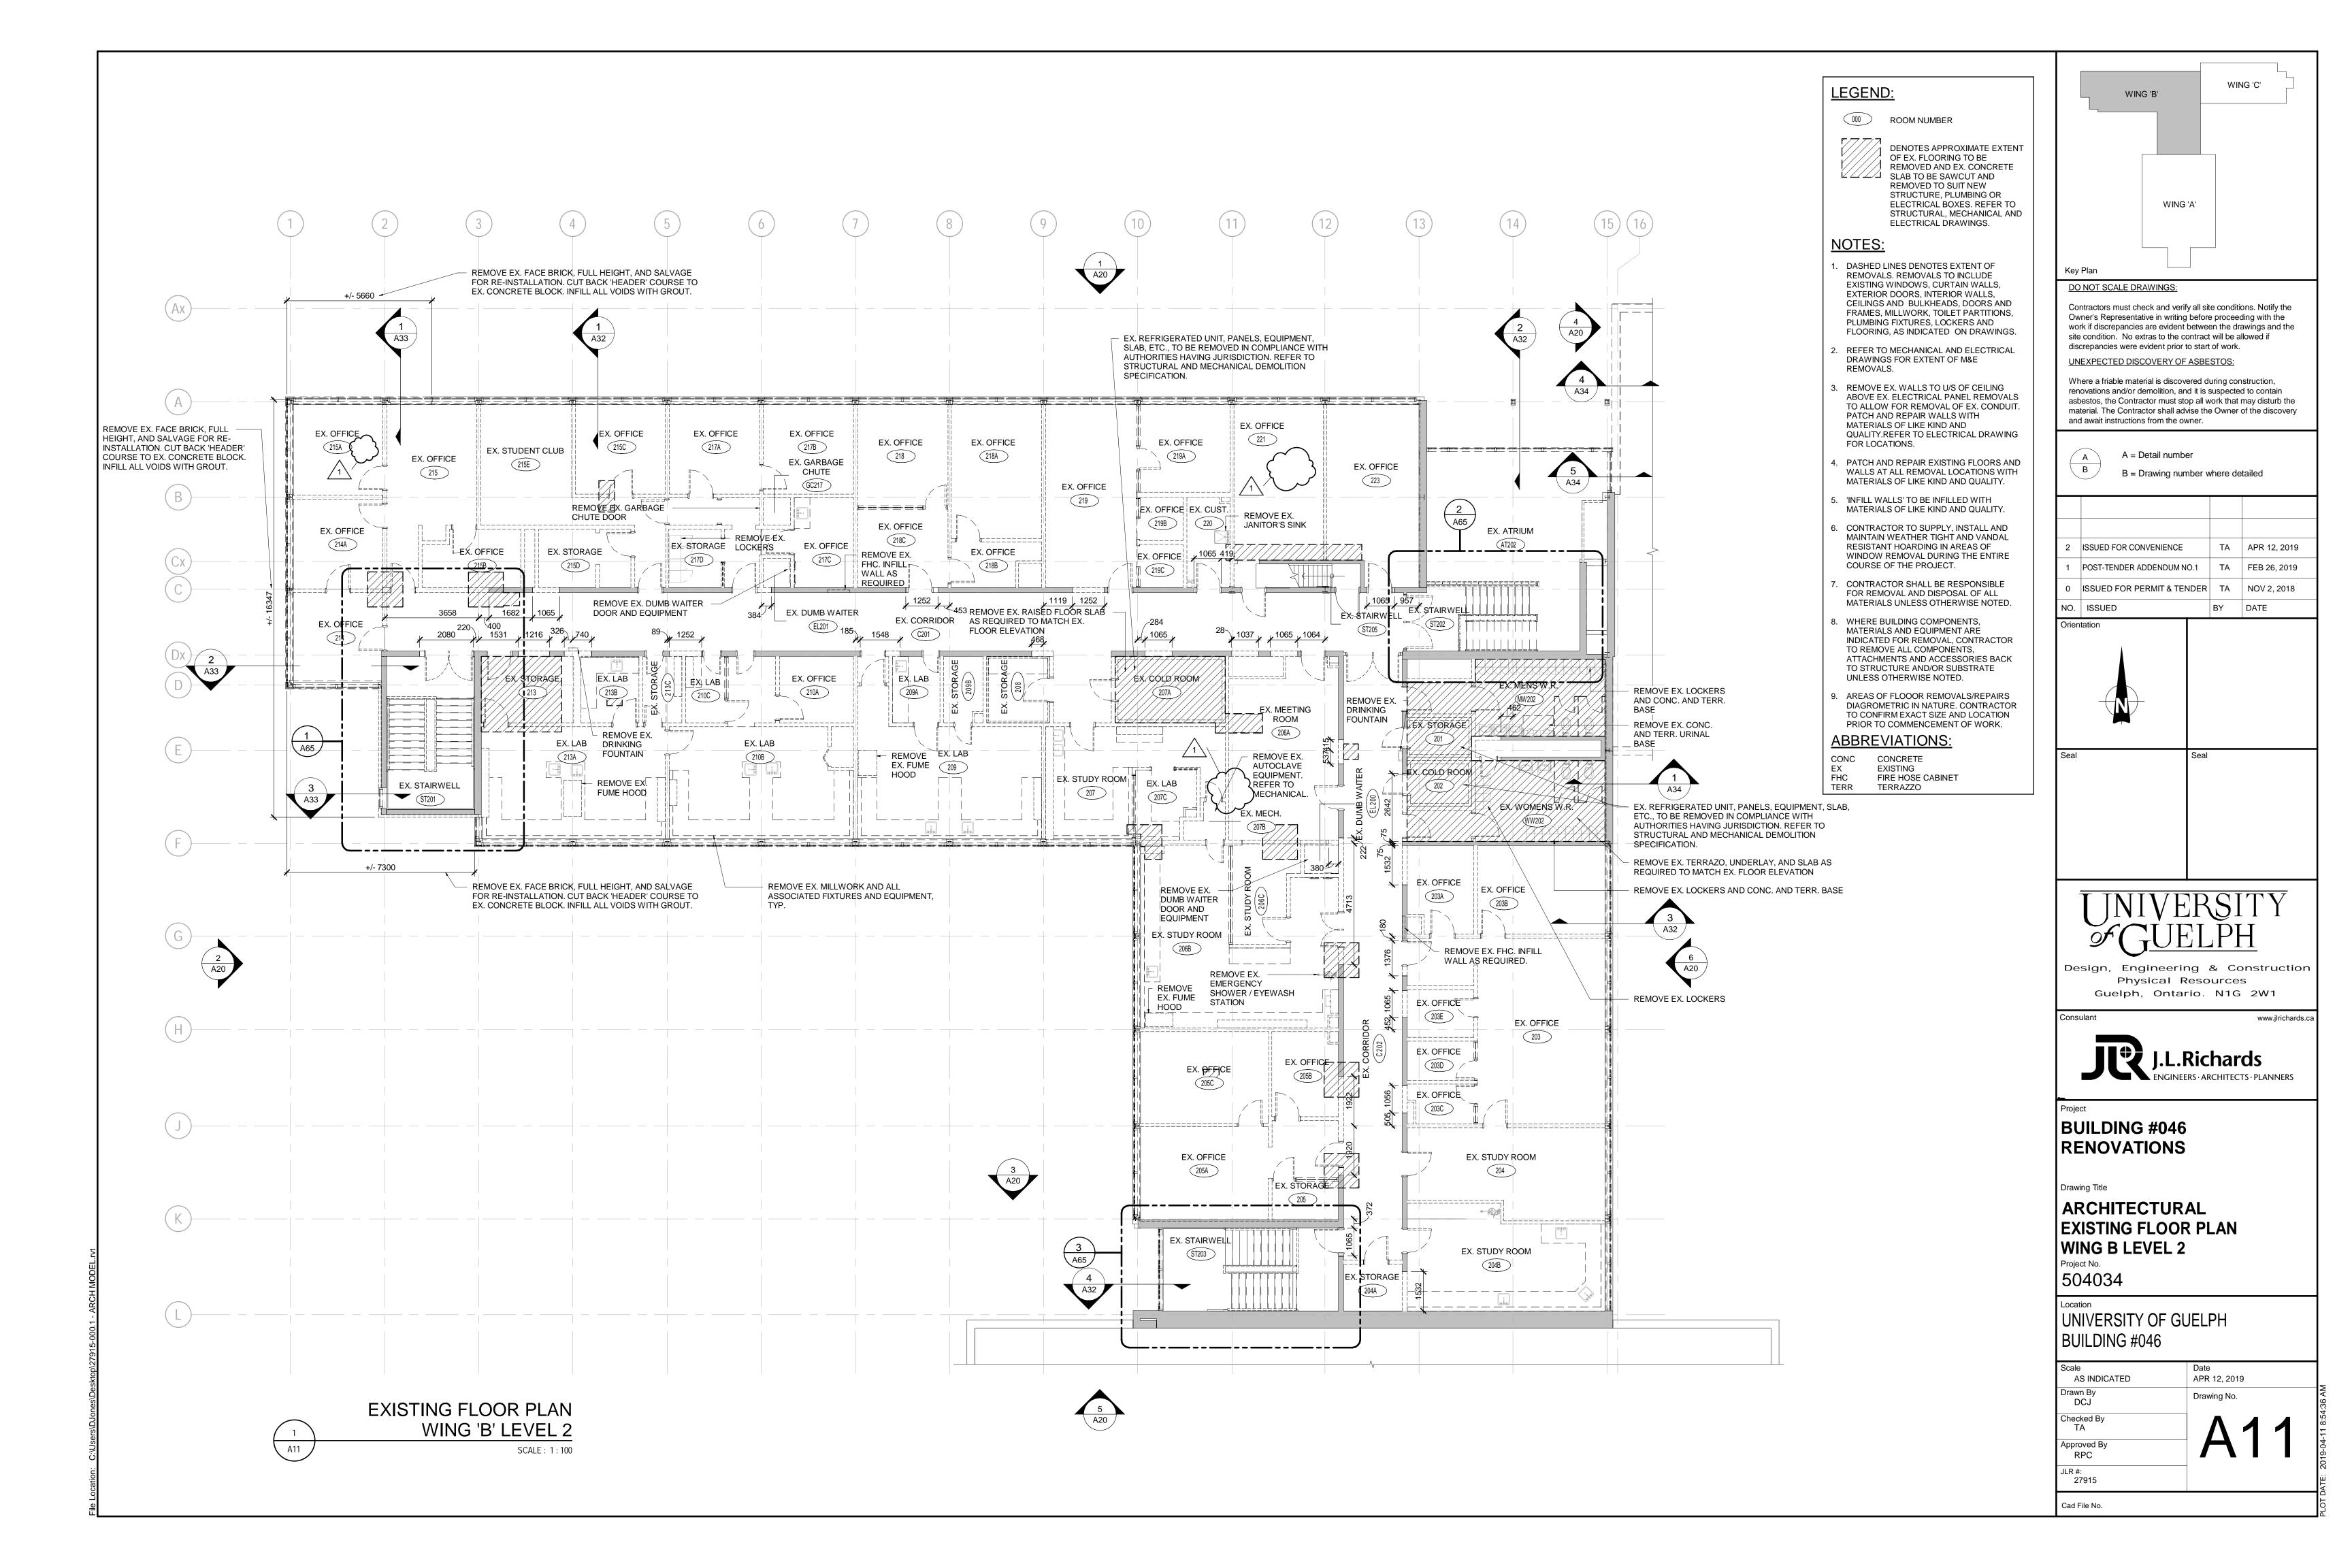
BUILDING #046 RENOVATIONS


Drawing Title

ARCHITECTURAL **EXISTING FLOOR PLAN** WING B LEVEL 1

Project No. 504034

Scale AS INDICATED	Date APR 12, 2019
Drawn By DCJ	Drawing No.
Checked By TA	Λ 10
Approved By RPC	-A10
JLR #: 27915	
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WING 'C' WING 'B' REFER TO DETAIL 4 REFER TO DETAIL 1 WING 'A'

TA APR 12, 2019

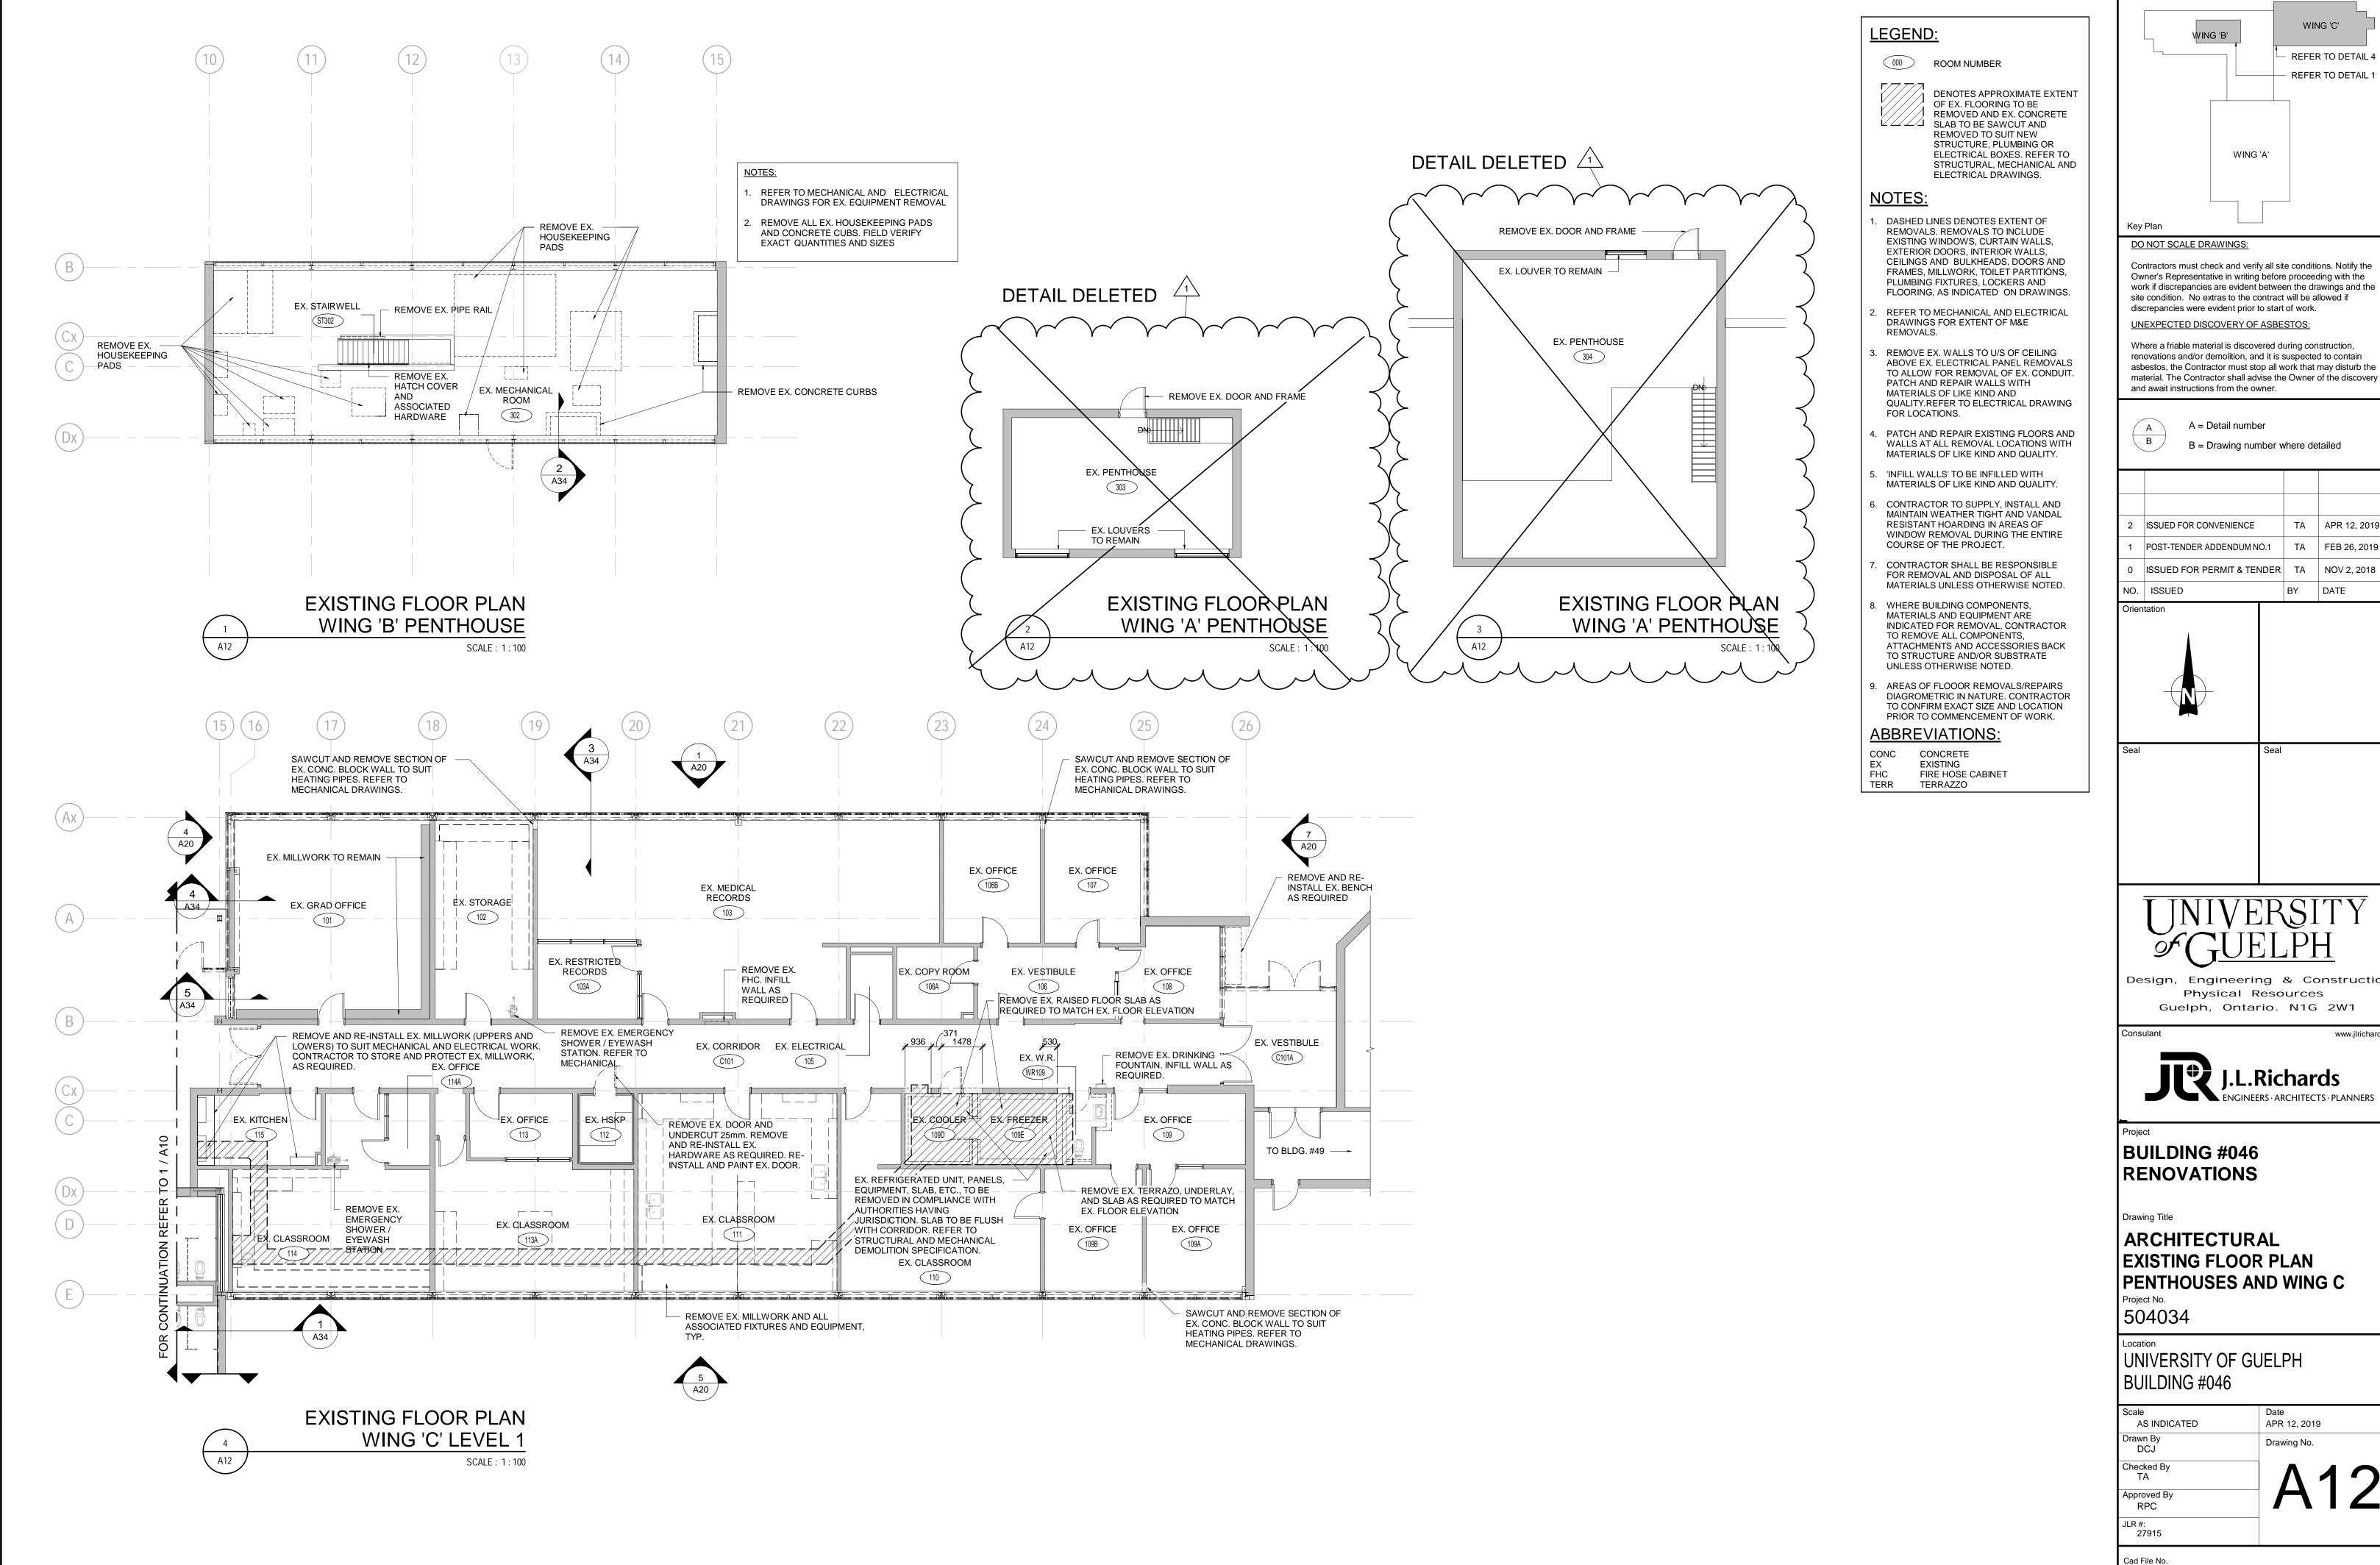BY DATE

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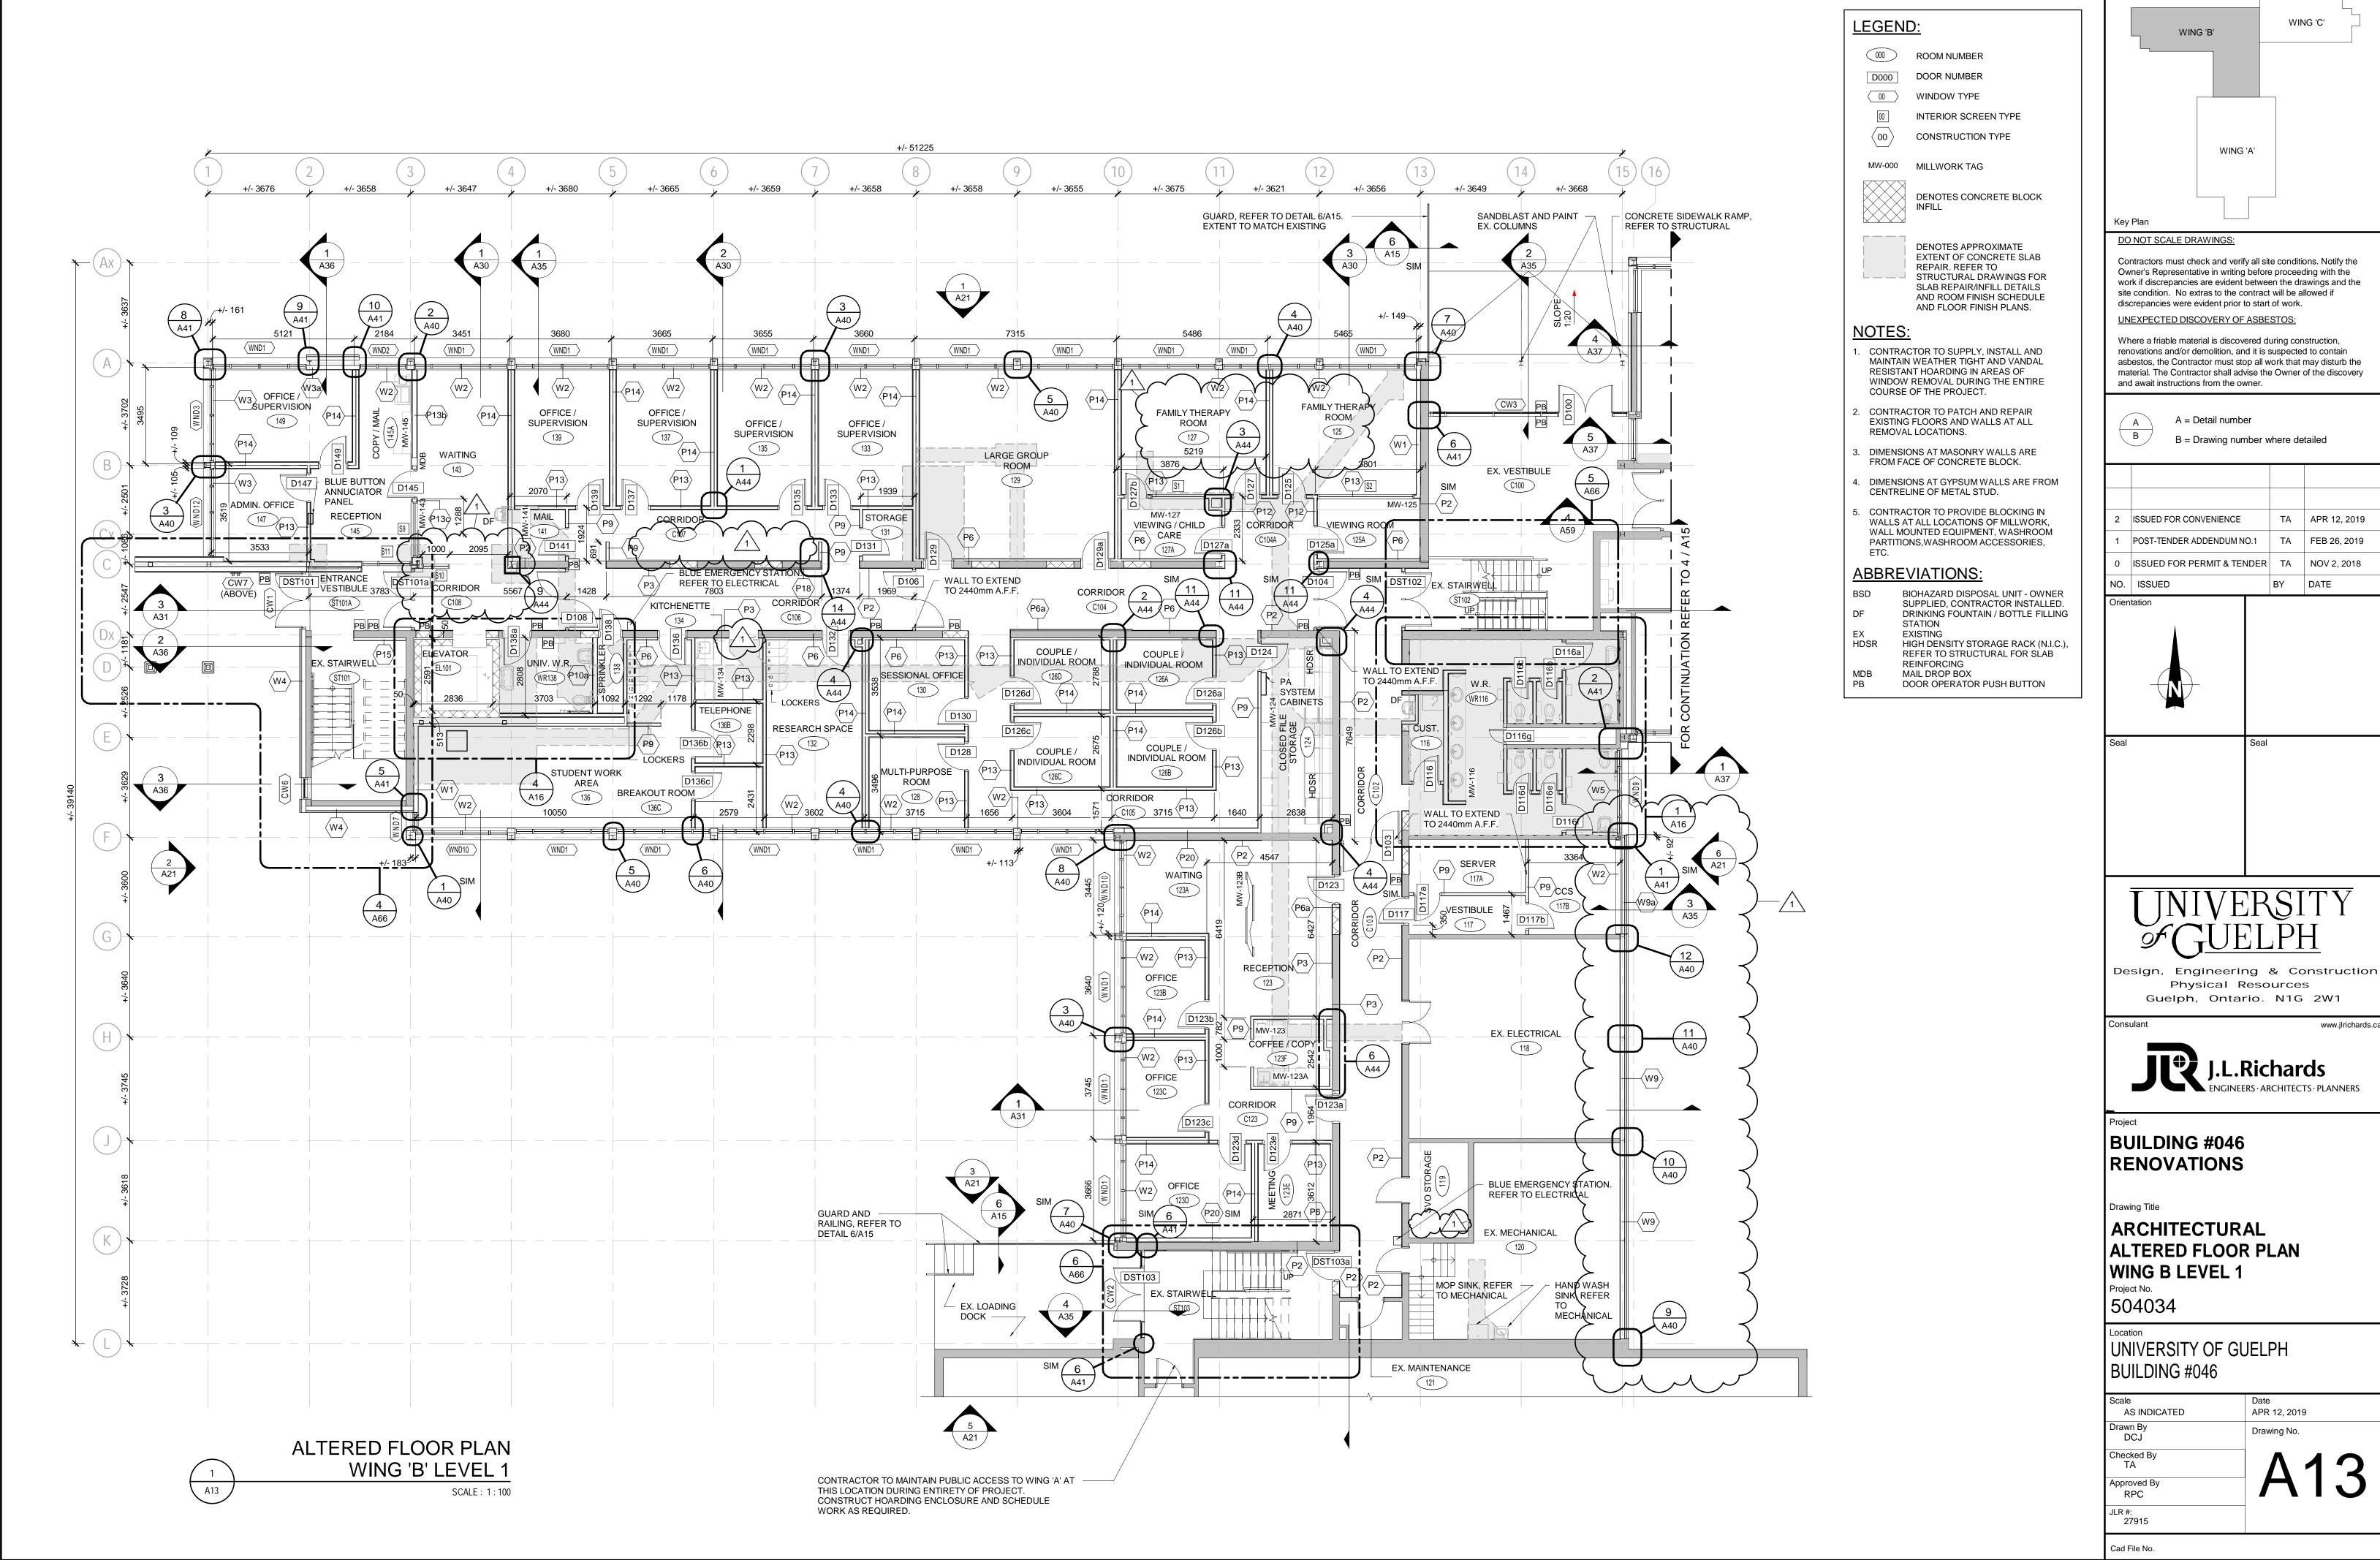



BUILDING #046

ARCHITECTURAL EXISTING FLOOR PLAN PENTHOUSES AND WING C

UNIVERSITY OF GUELPH BUILDING #046

APR 12, 2019 Drawing No.



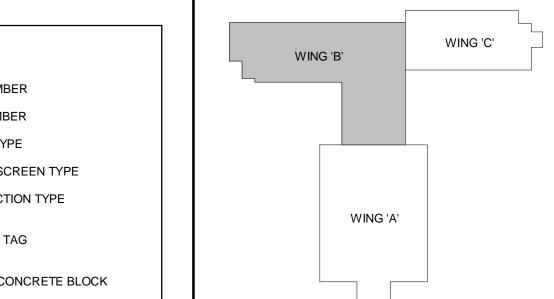

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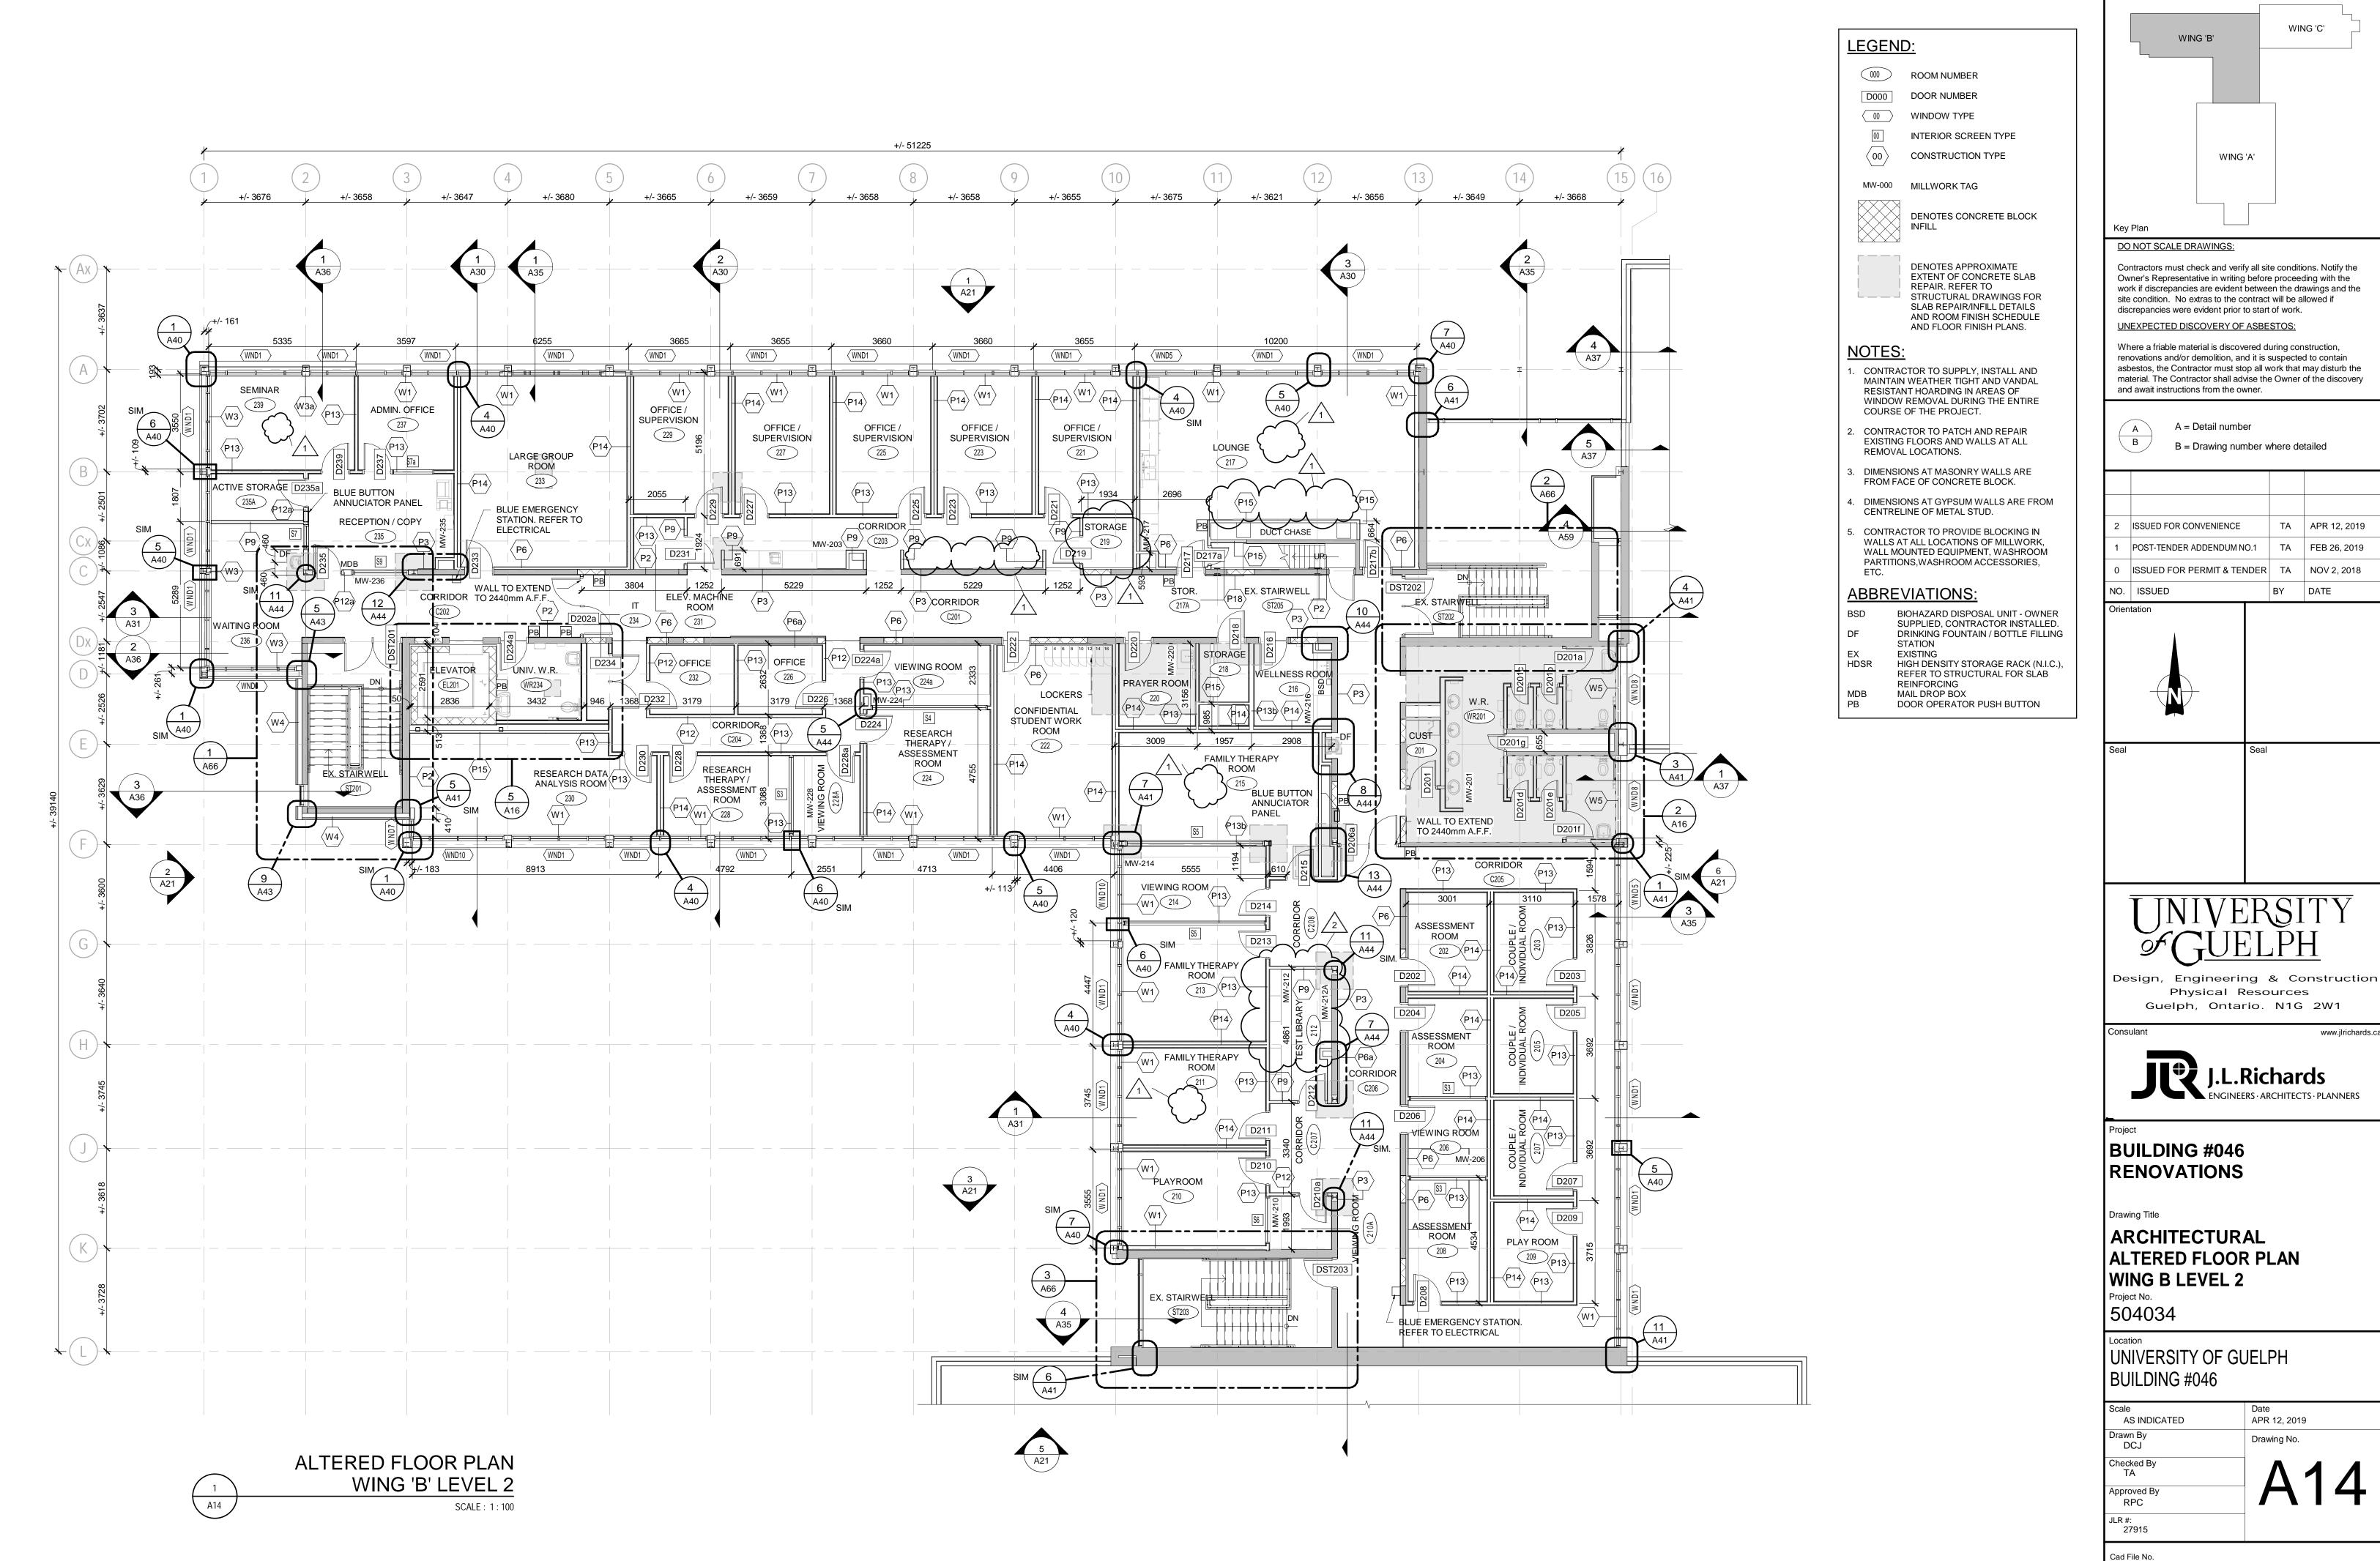
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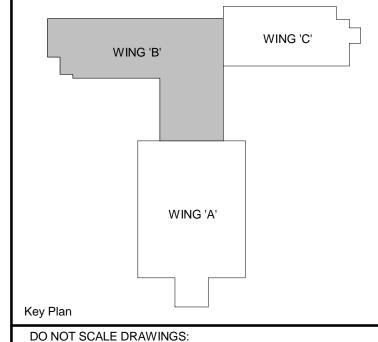


BUILDING #046 RENOVATIONS

ARCHITECTURAL ALTERED FLOOR PLAN WING B LEVEL 1

Scale AS INDICATED	Date APR 12, 2019
Drawn By DCJ	Drawing No.
Checked By TA	1 1 2
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RPC	
JLR #: 27915	





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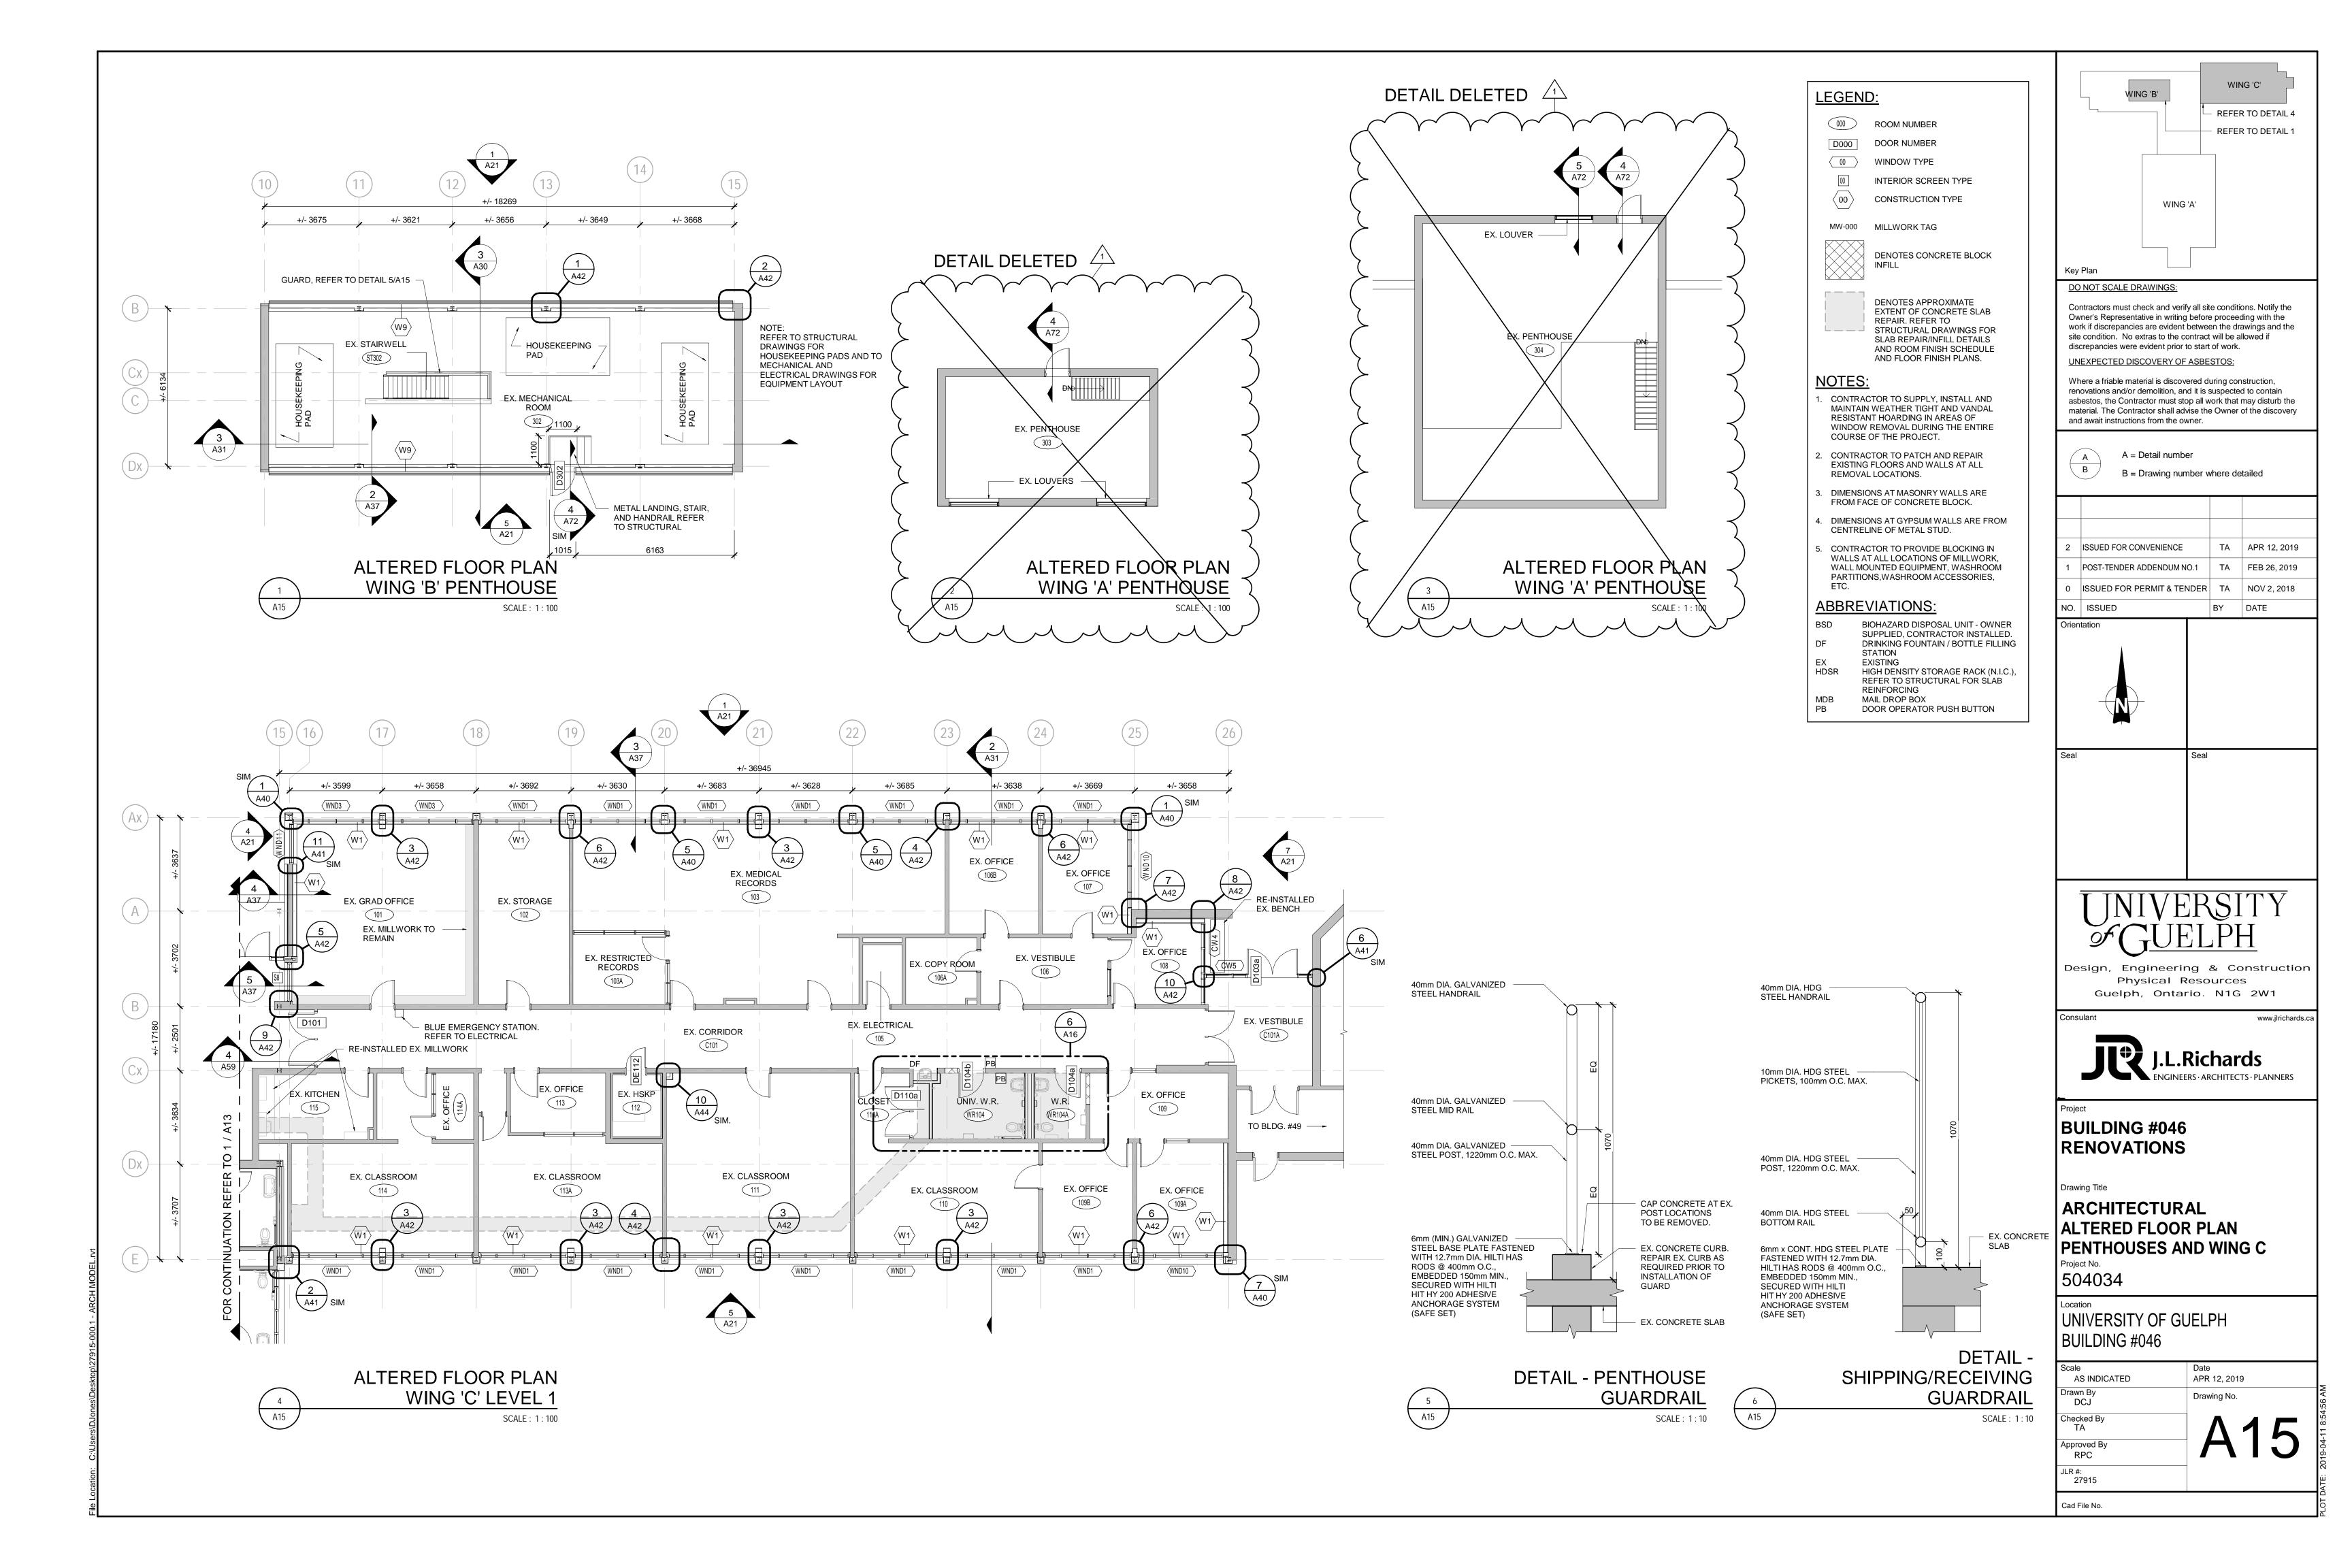



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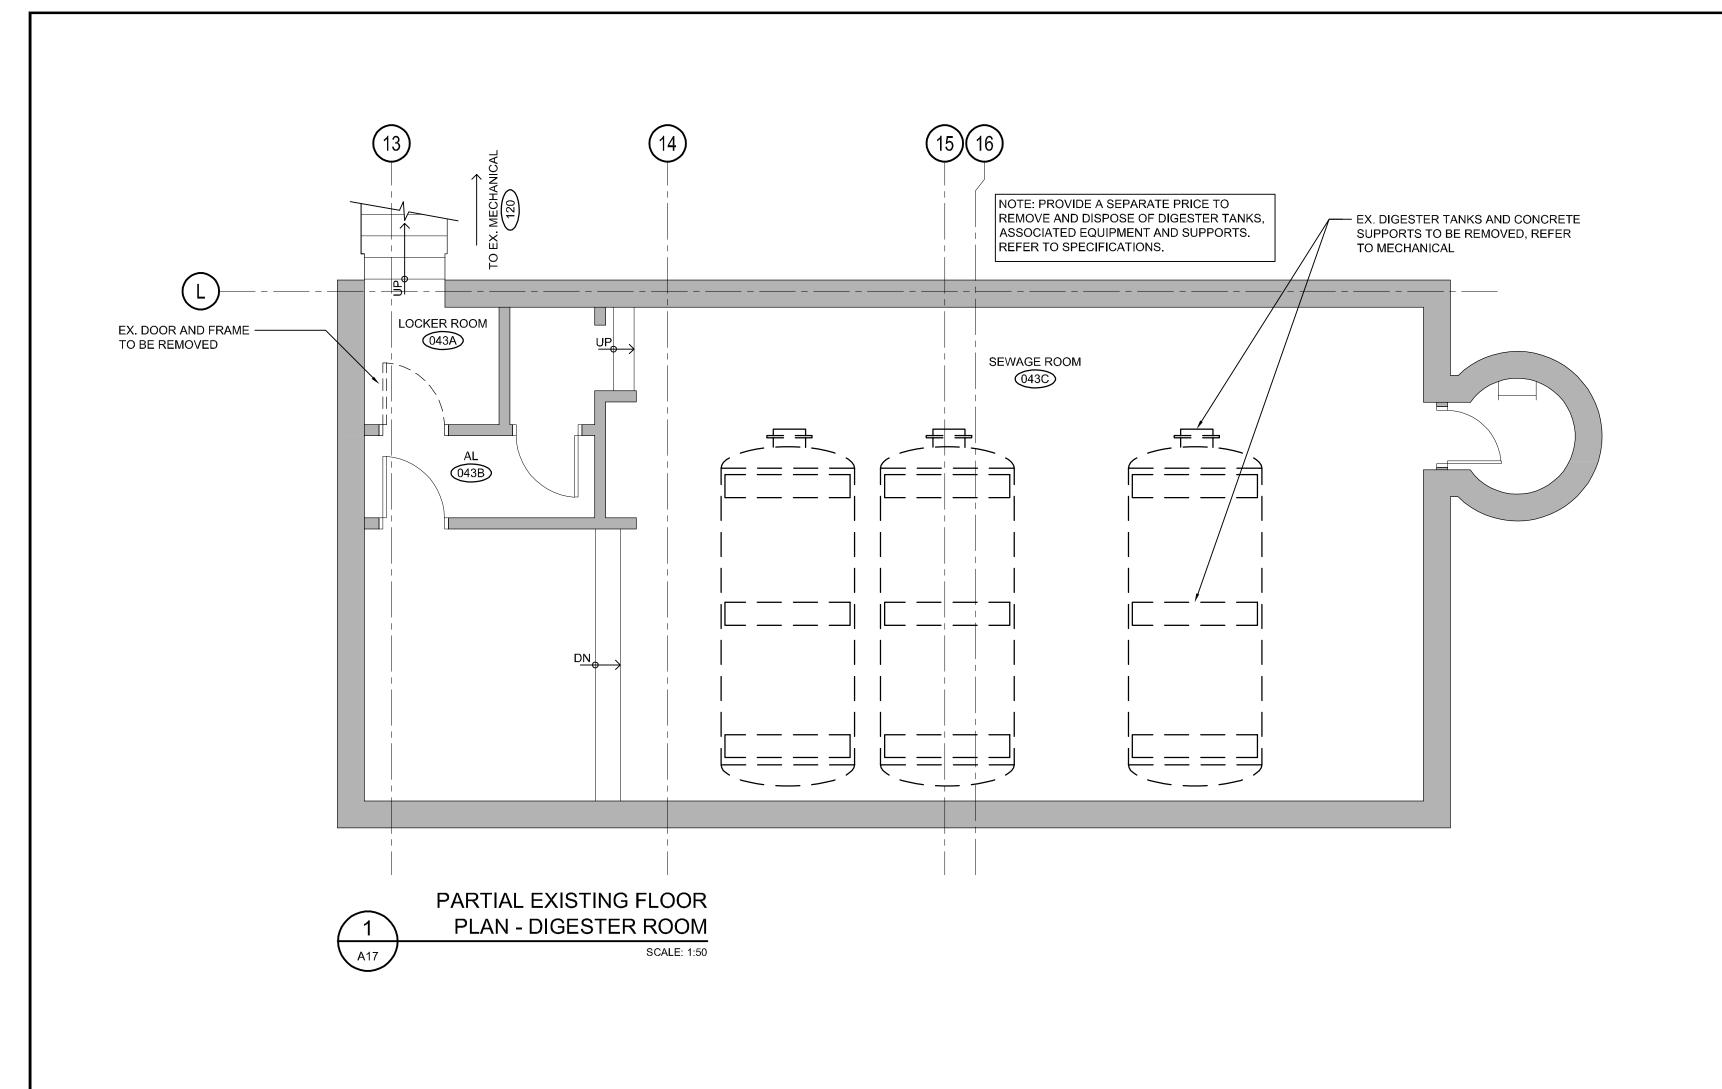
ARCHITECTURAL ALTERED FLOOR PLAN WING B LEVEL 2


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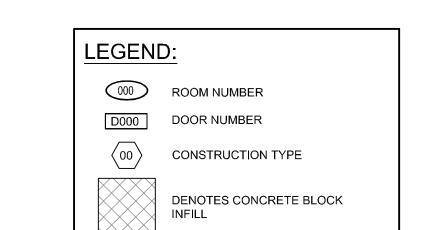
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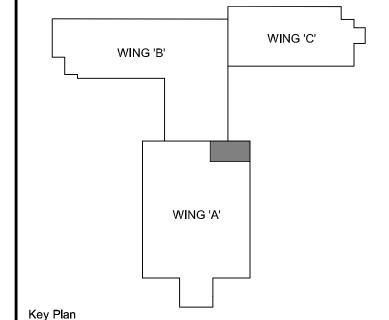








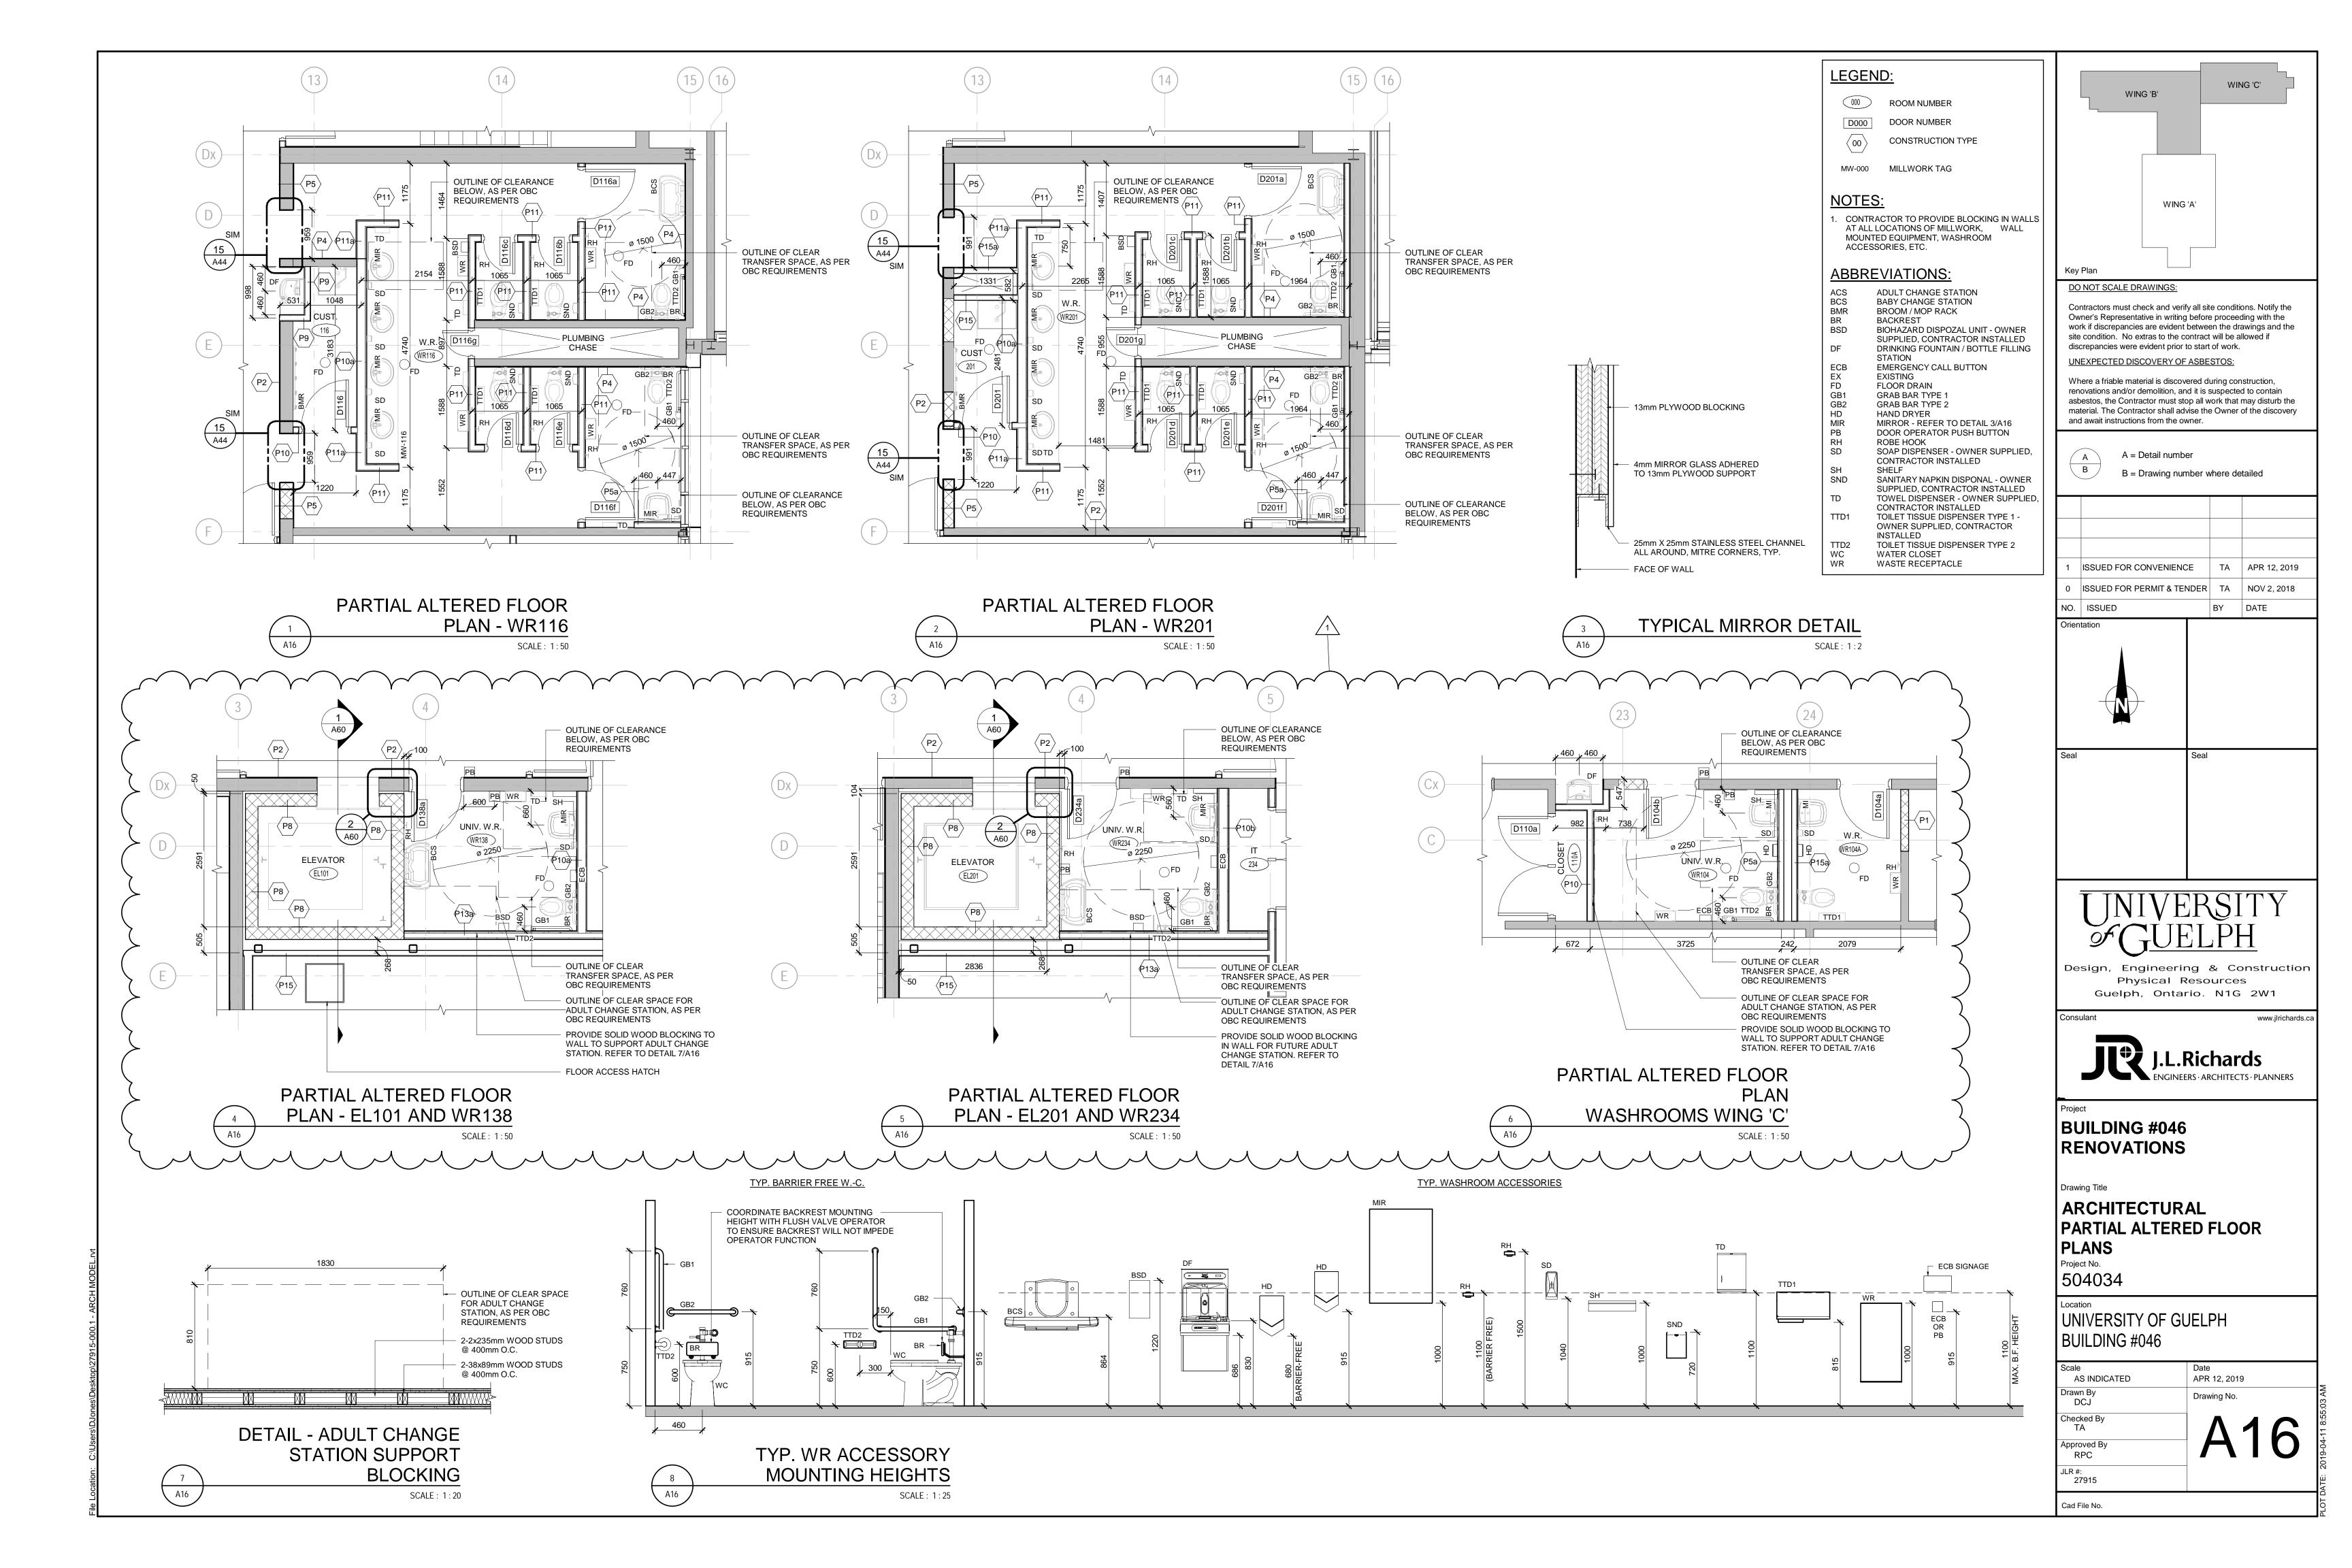

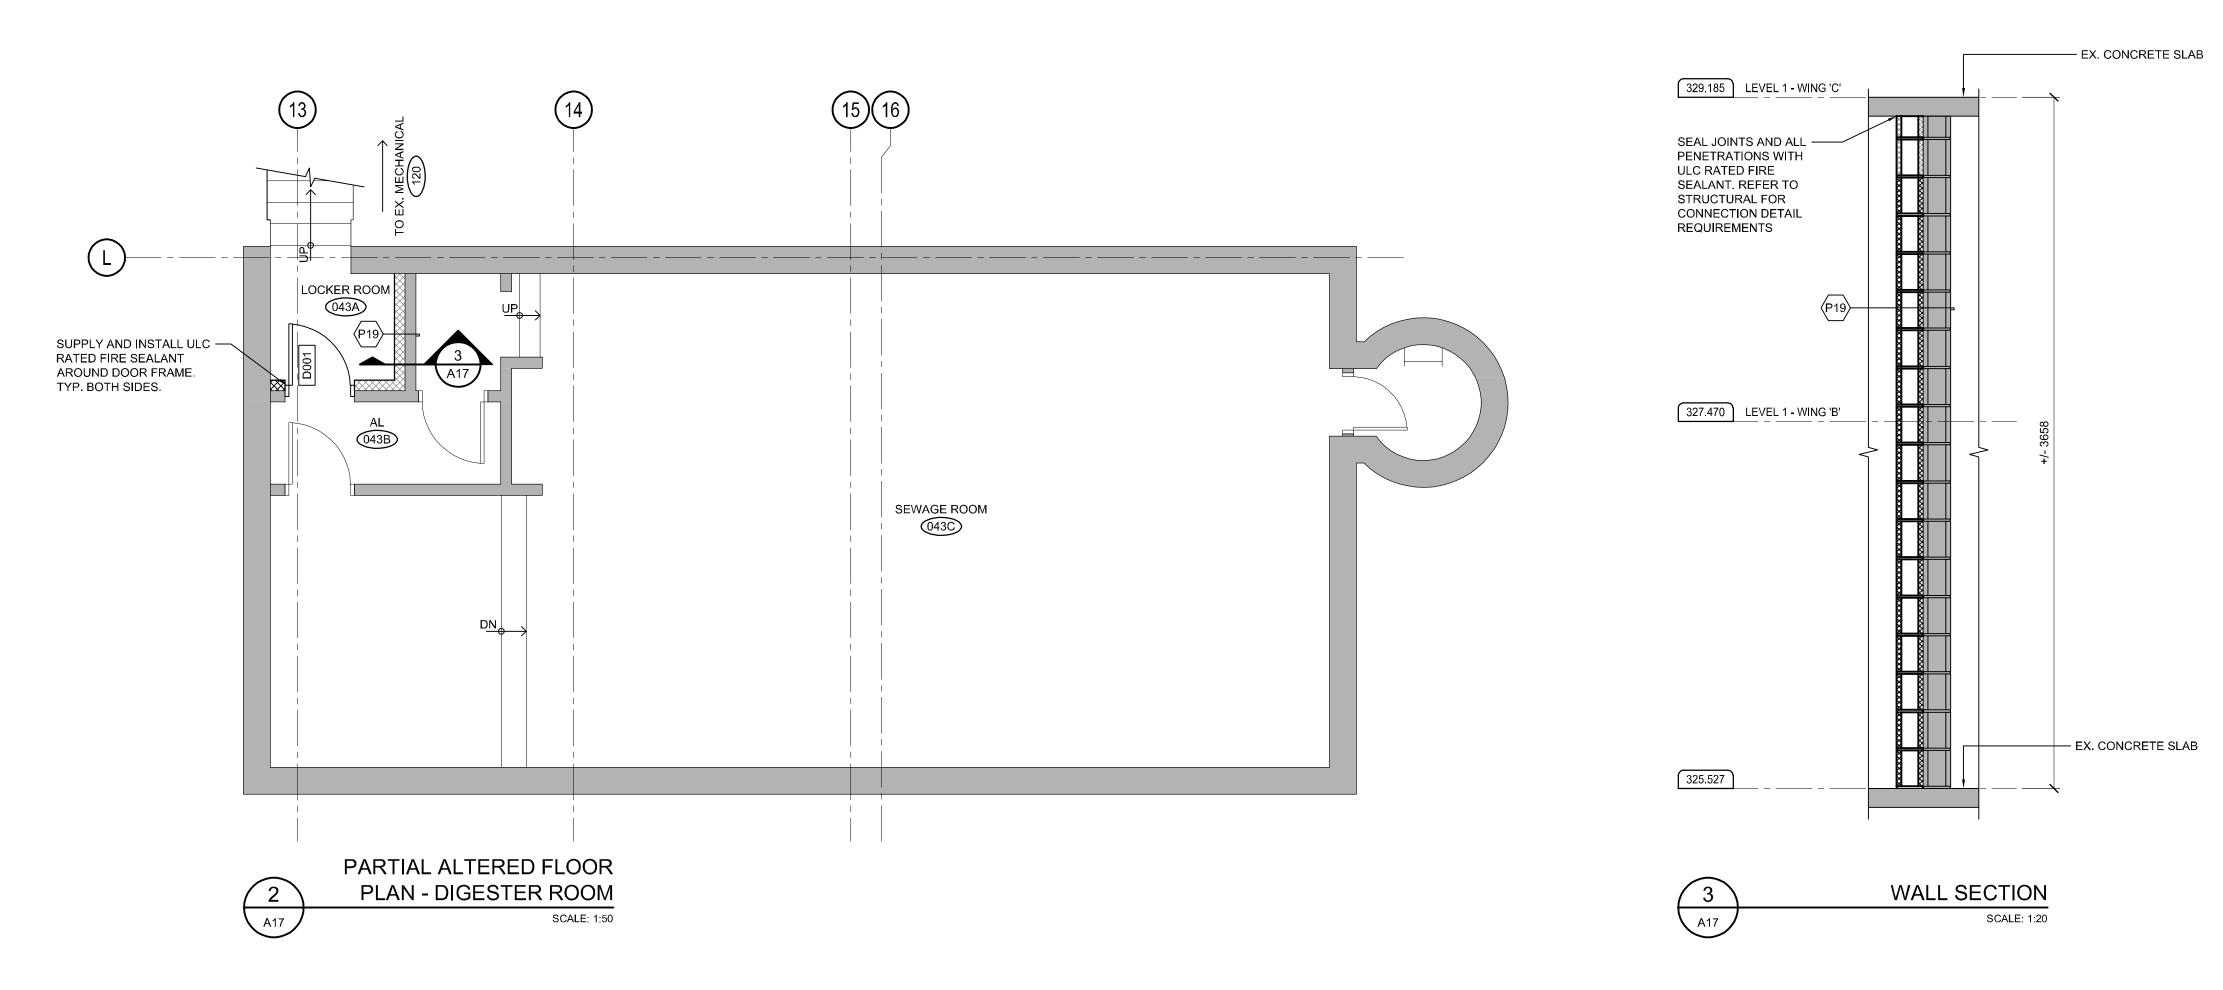

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www.



BUILDING #046


RENOVATIONS


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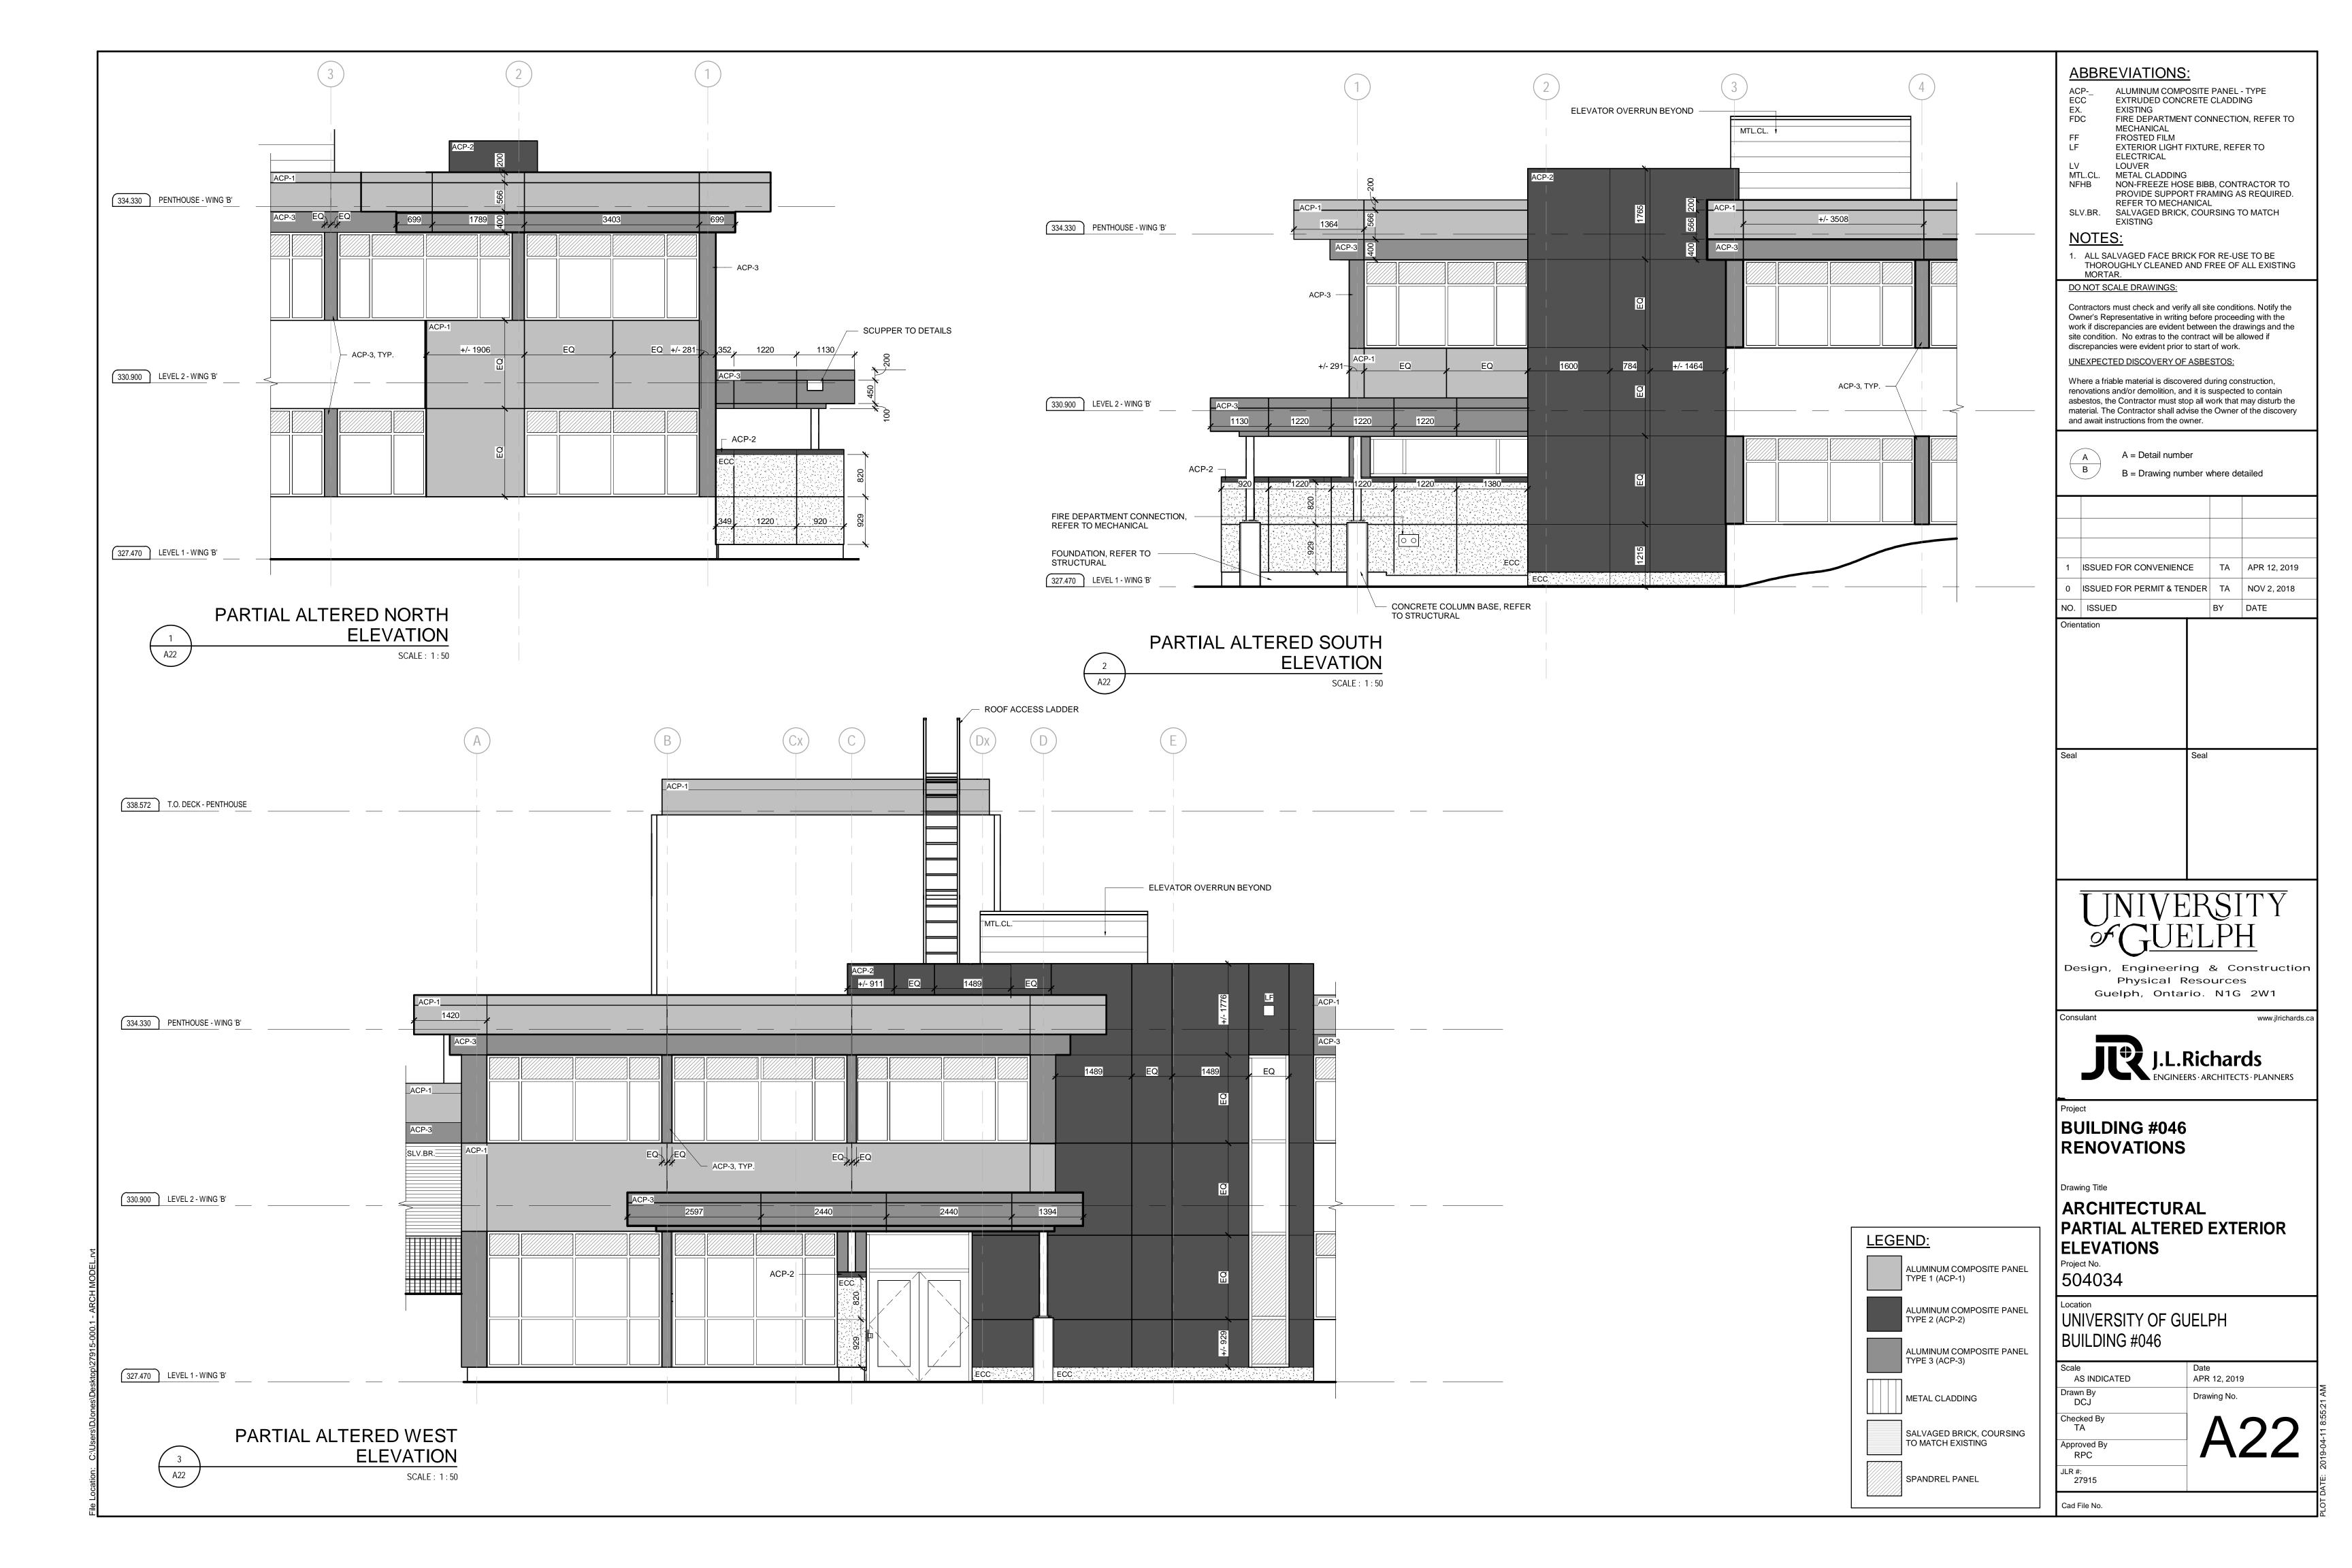
ARCHITECTURAL ALTERATIONS TO DIGESTER ROOM


Project No. 504034


Scale AS NOTED	Date APR 12, 2019
Drawn by KM	Drawing No.
Checked By	
TA	
Approved By	
RPC	
JLR#	
27915	




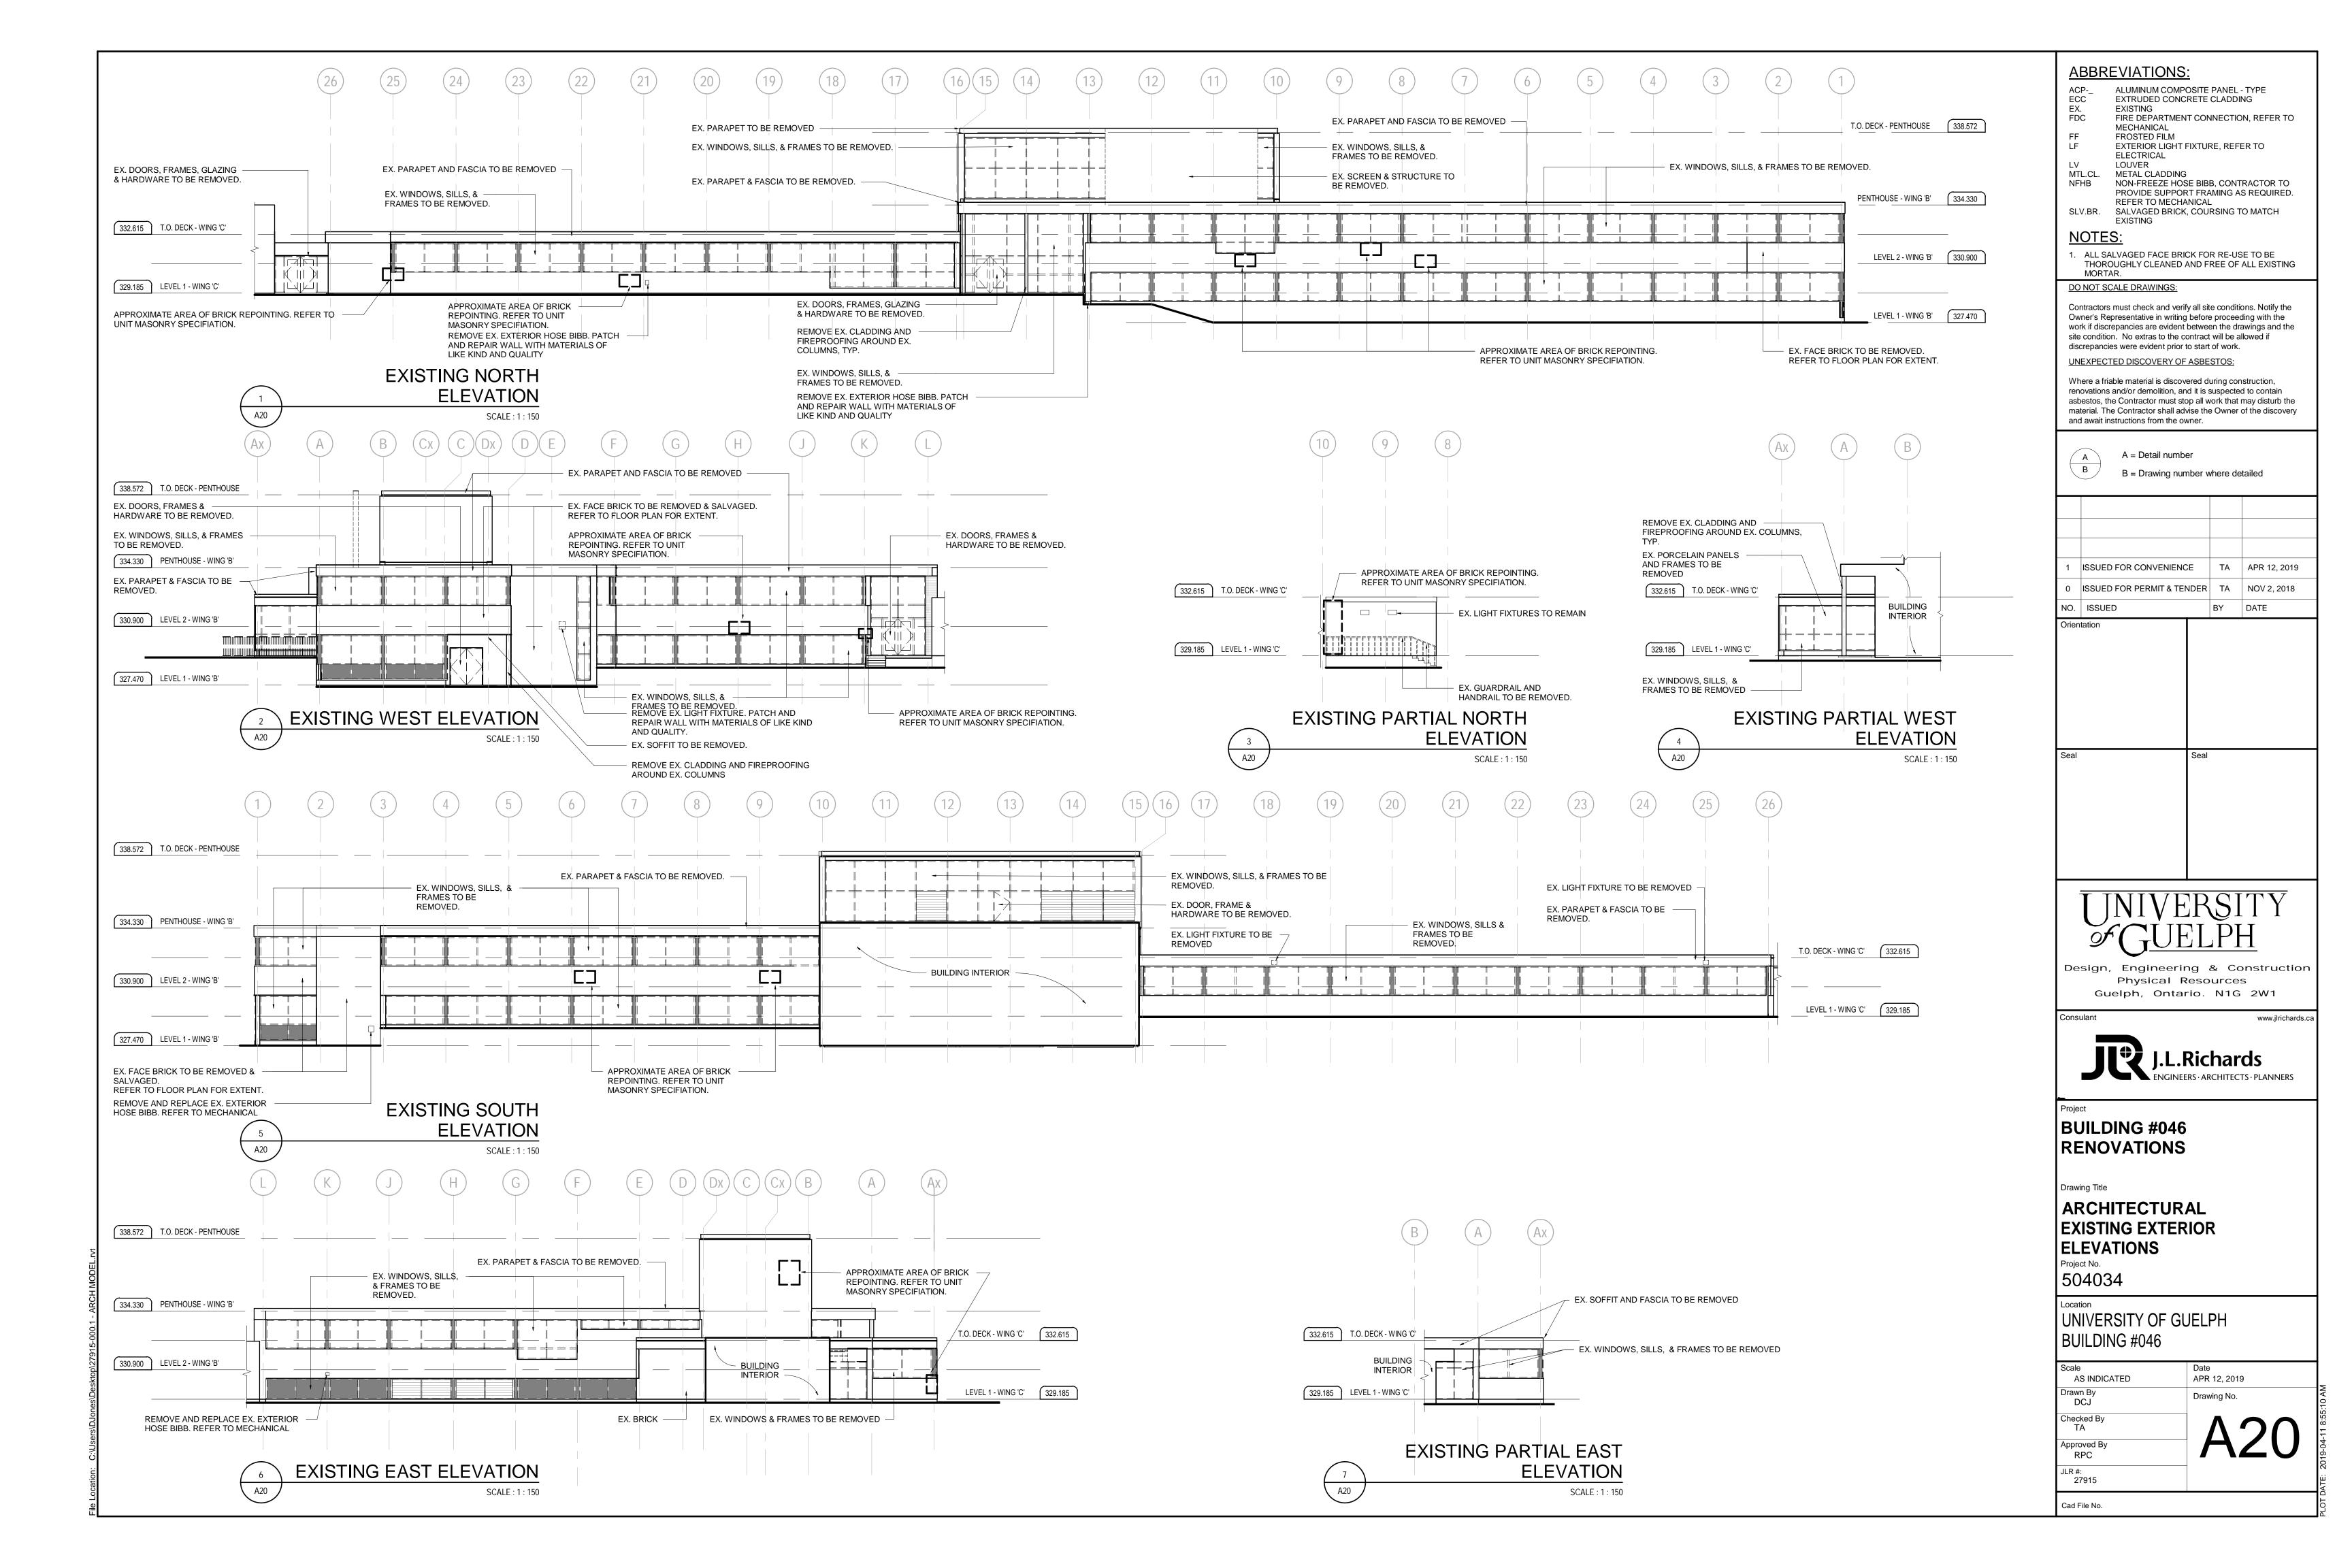


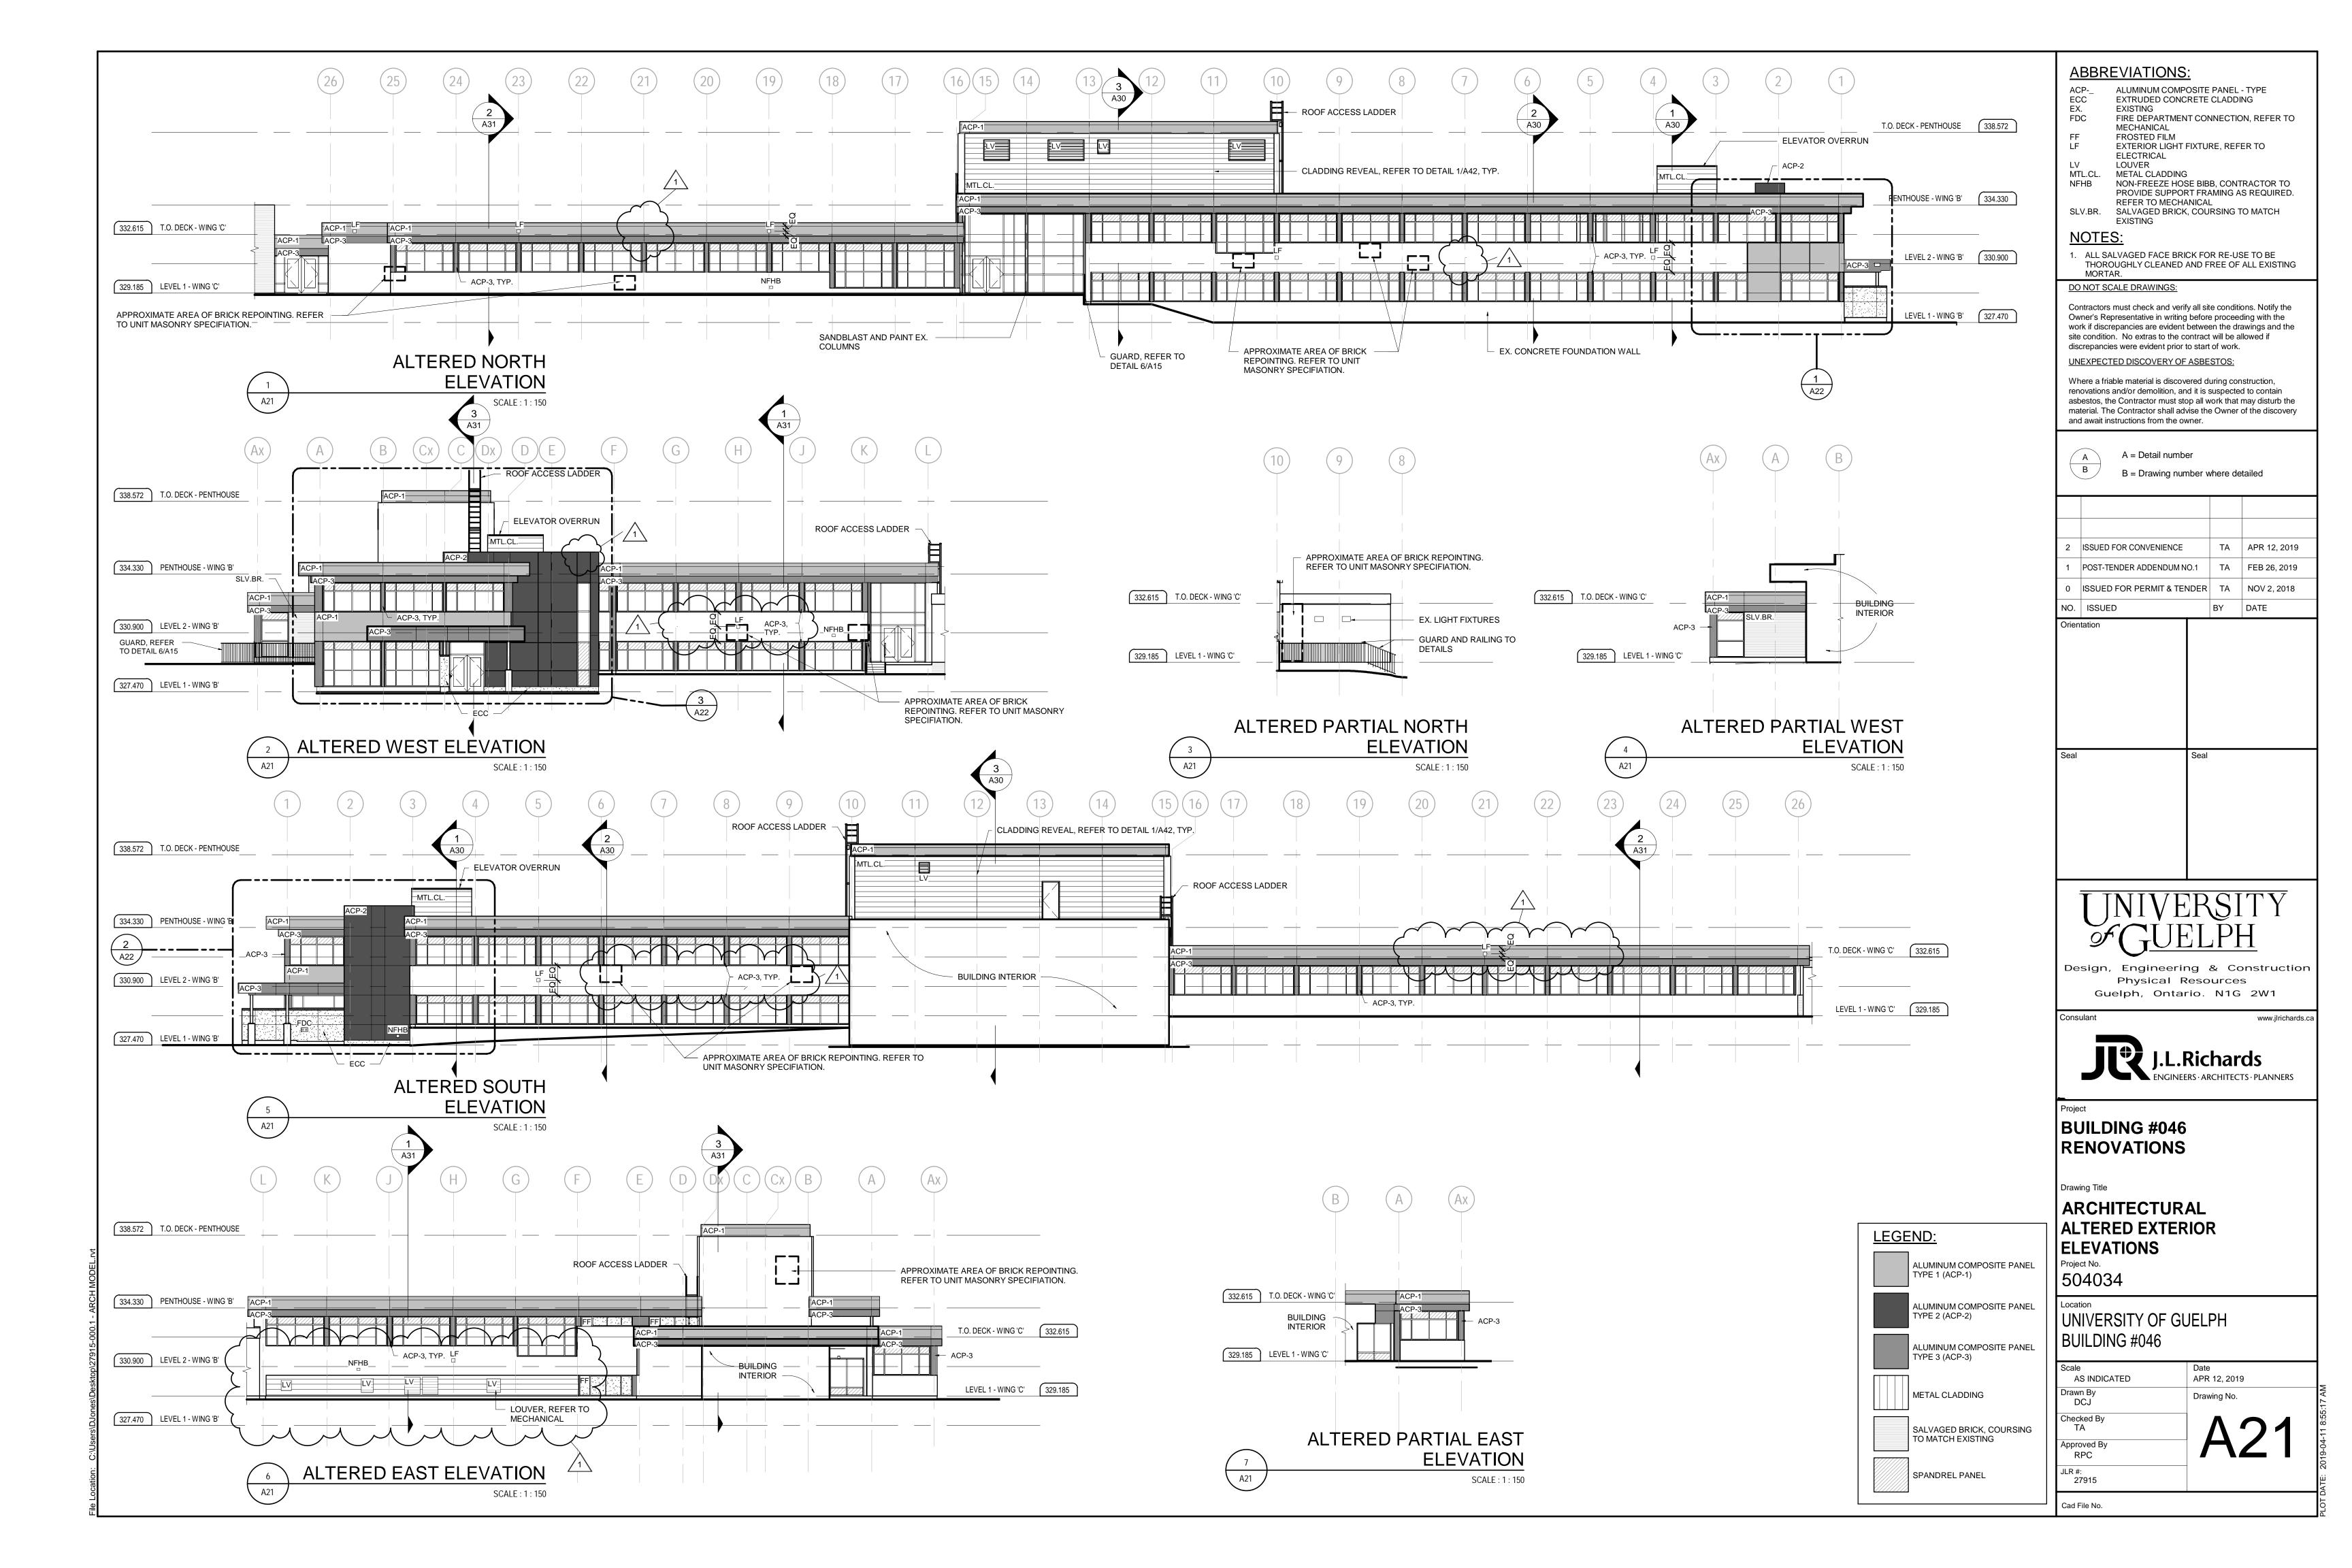


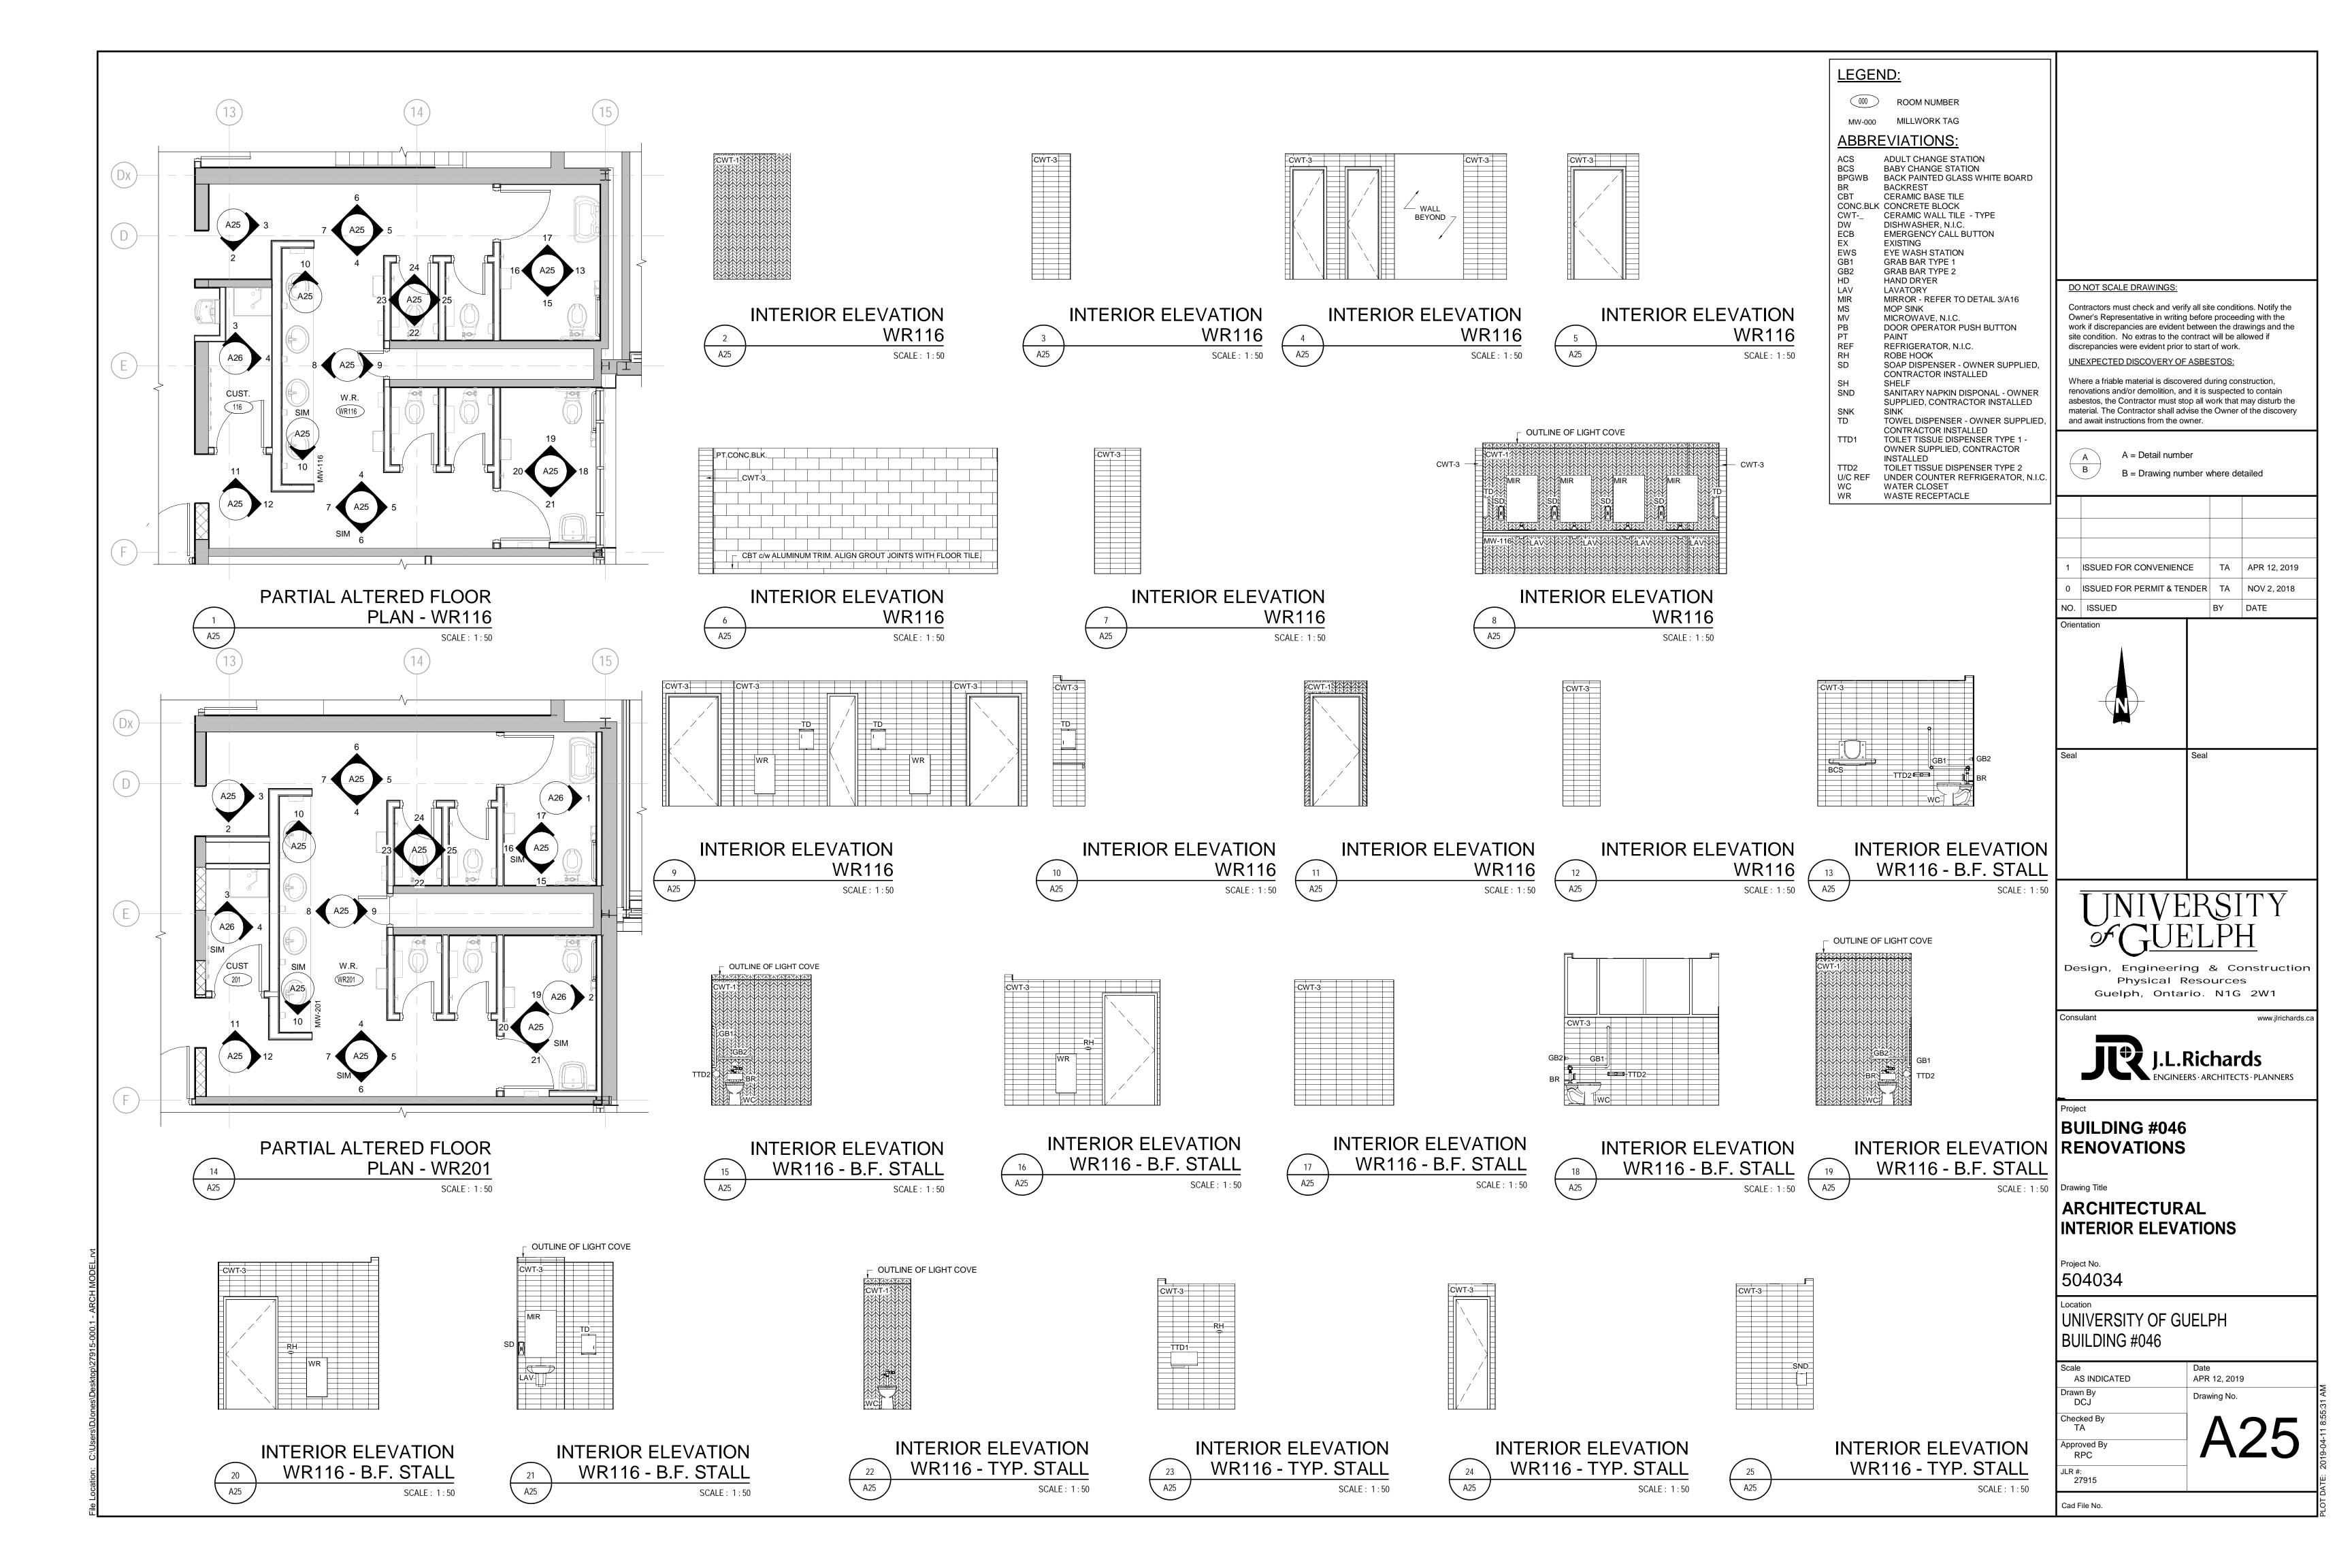


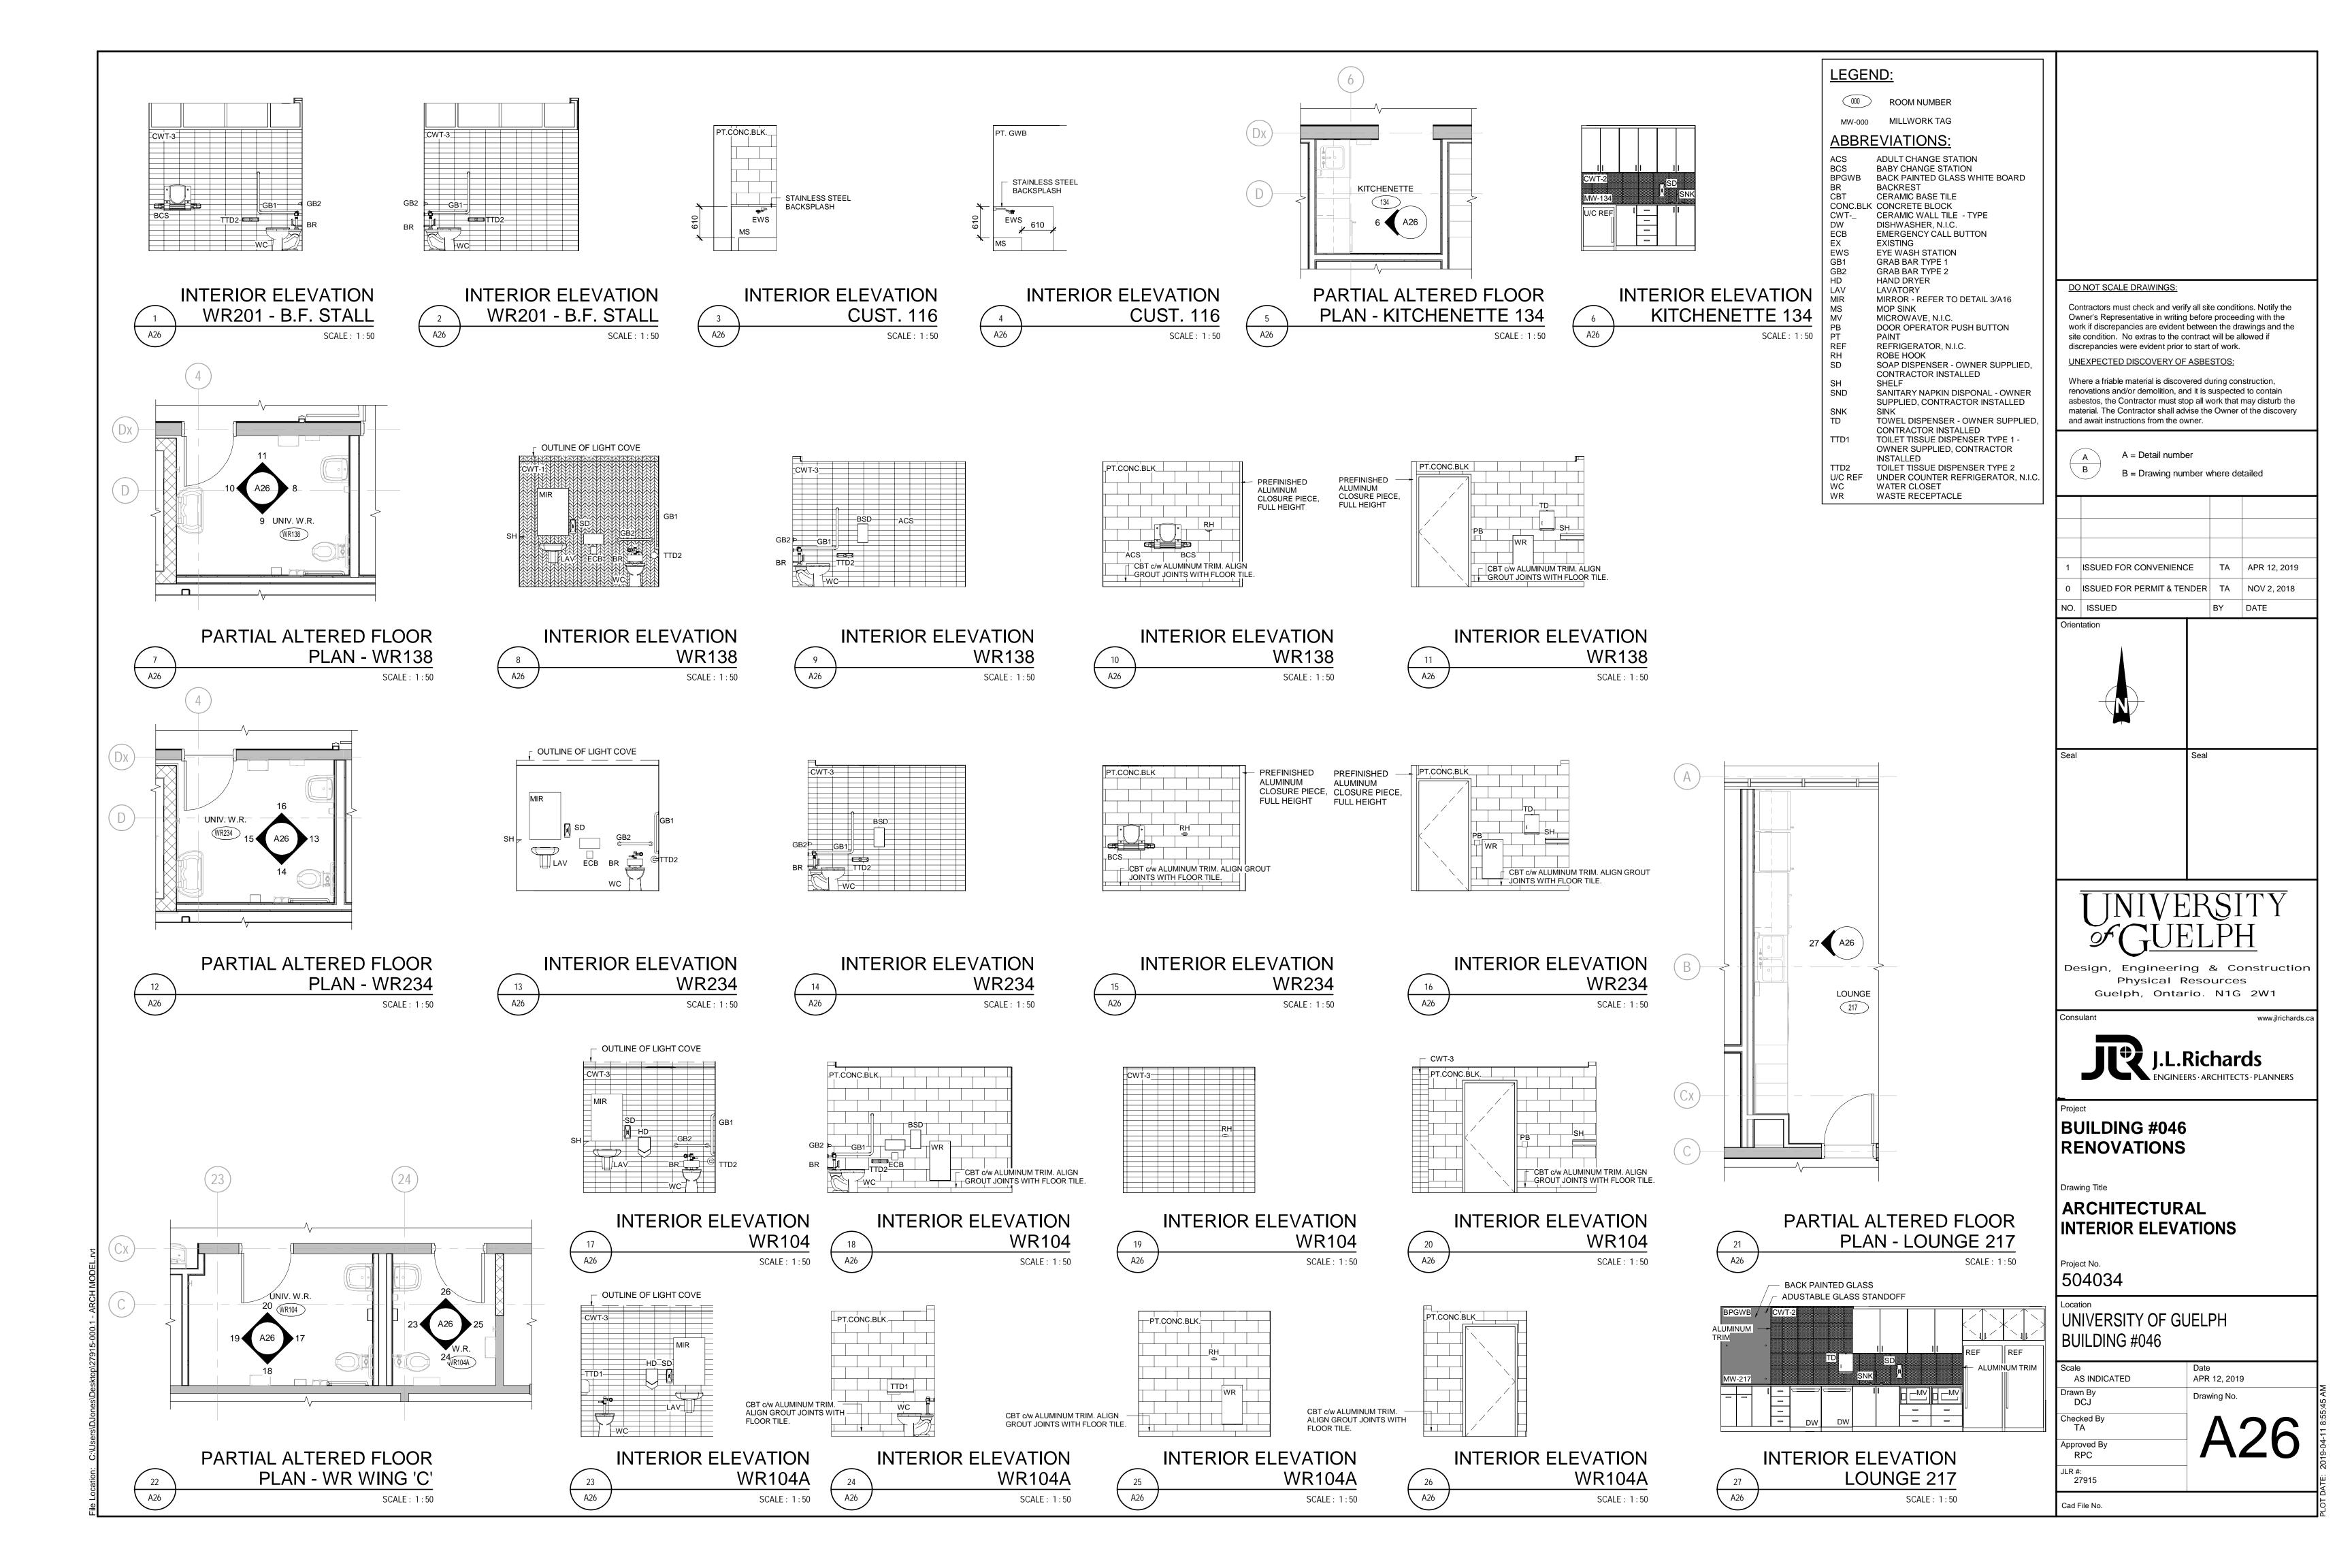

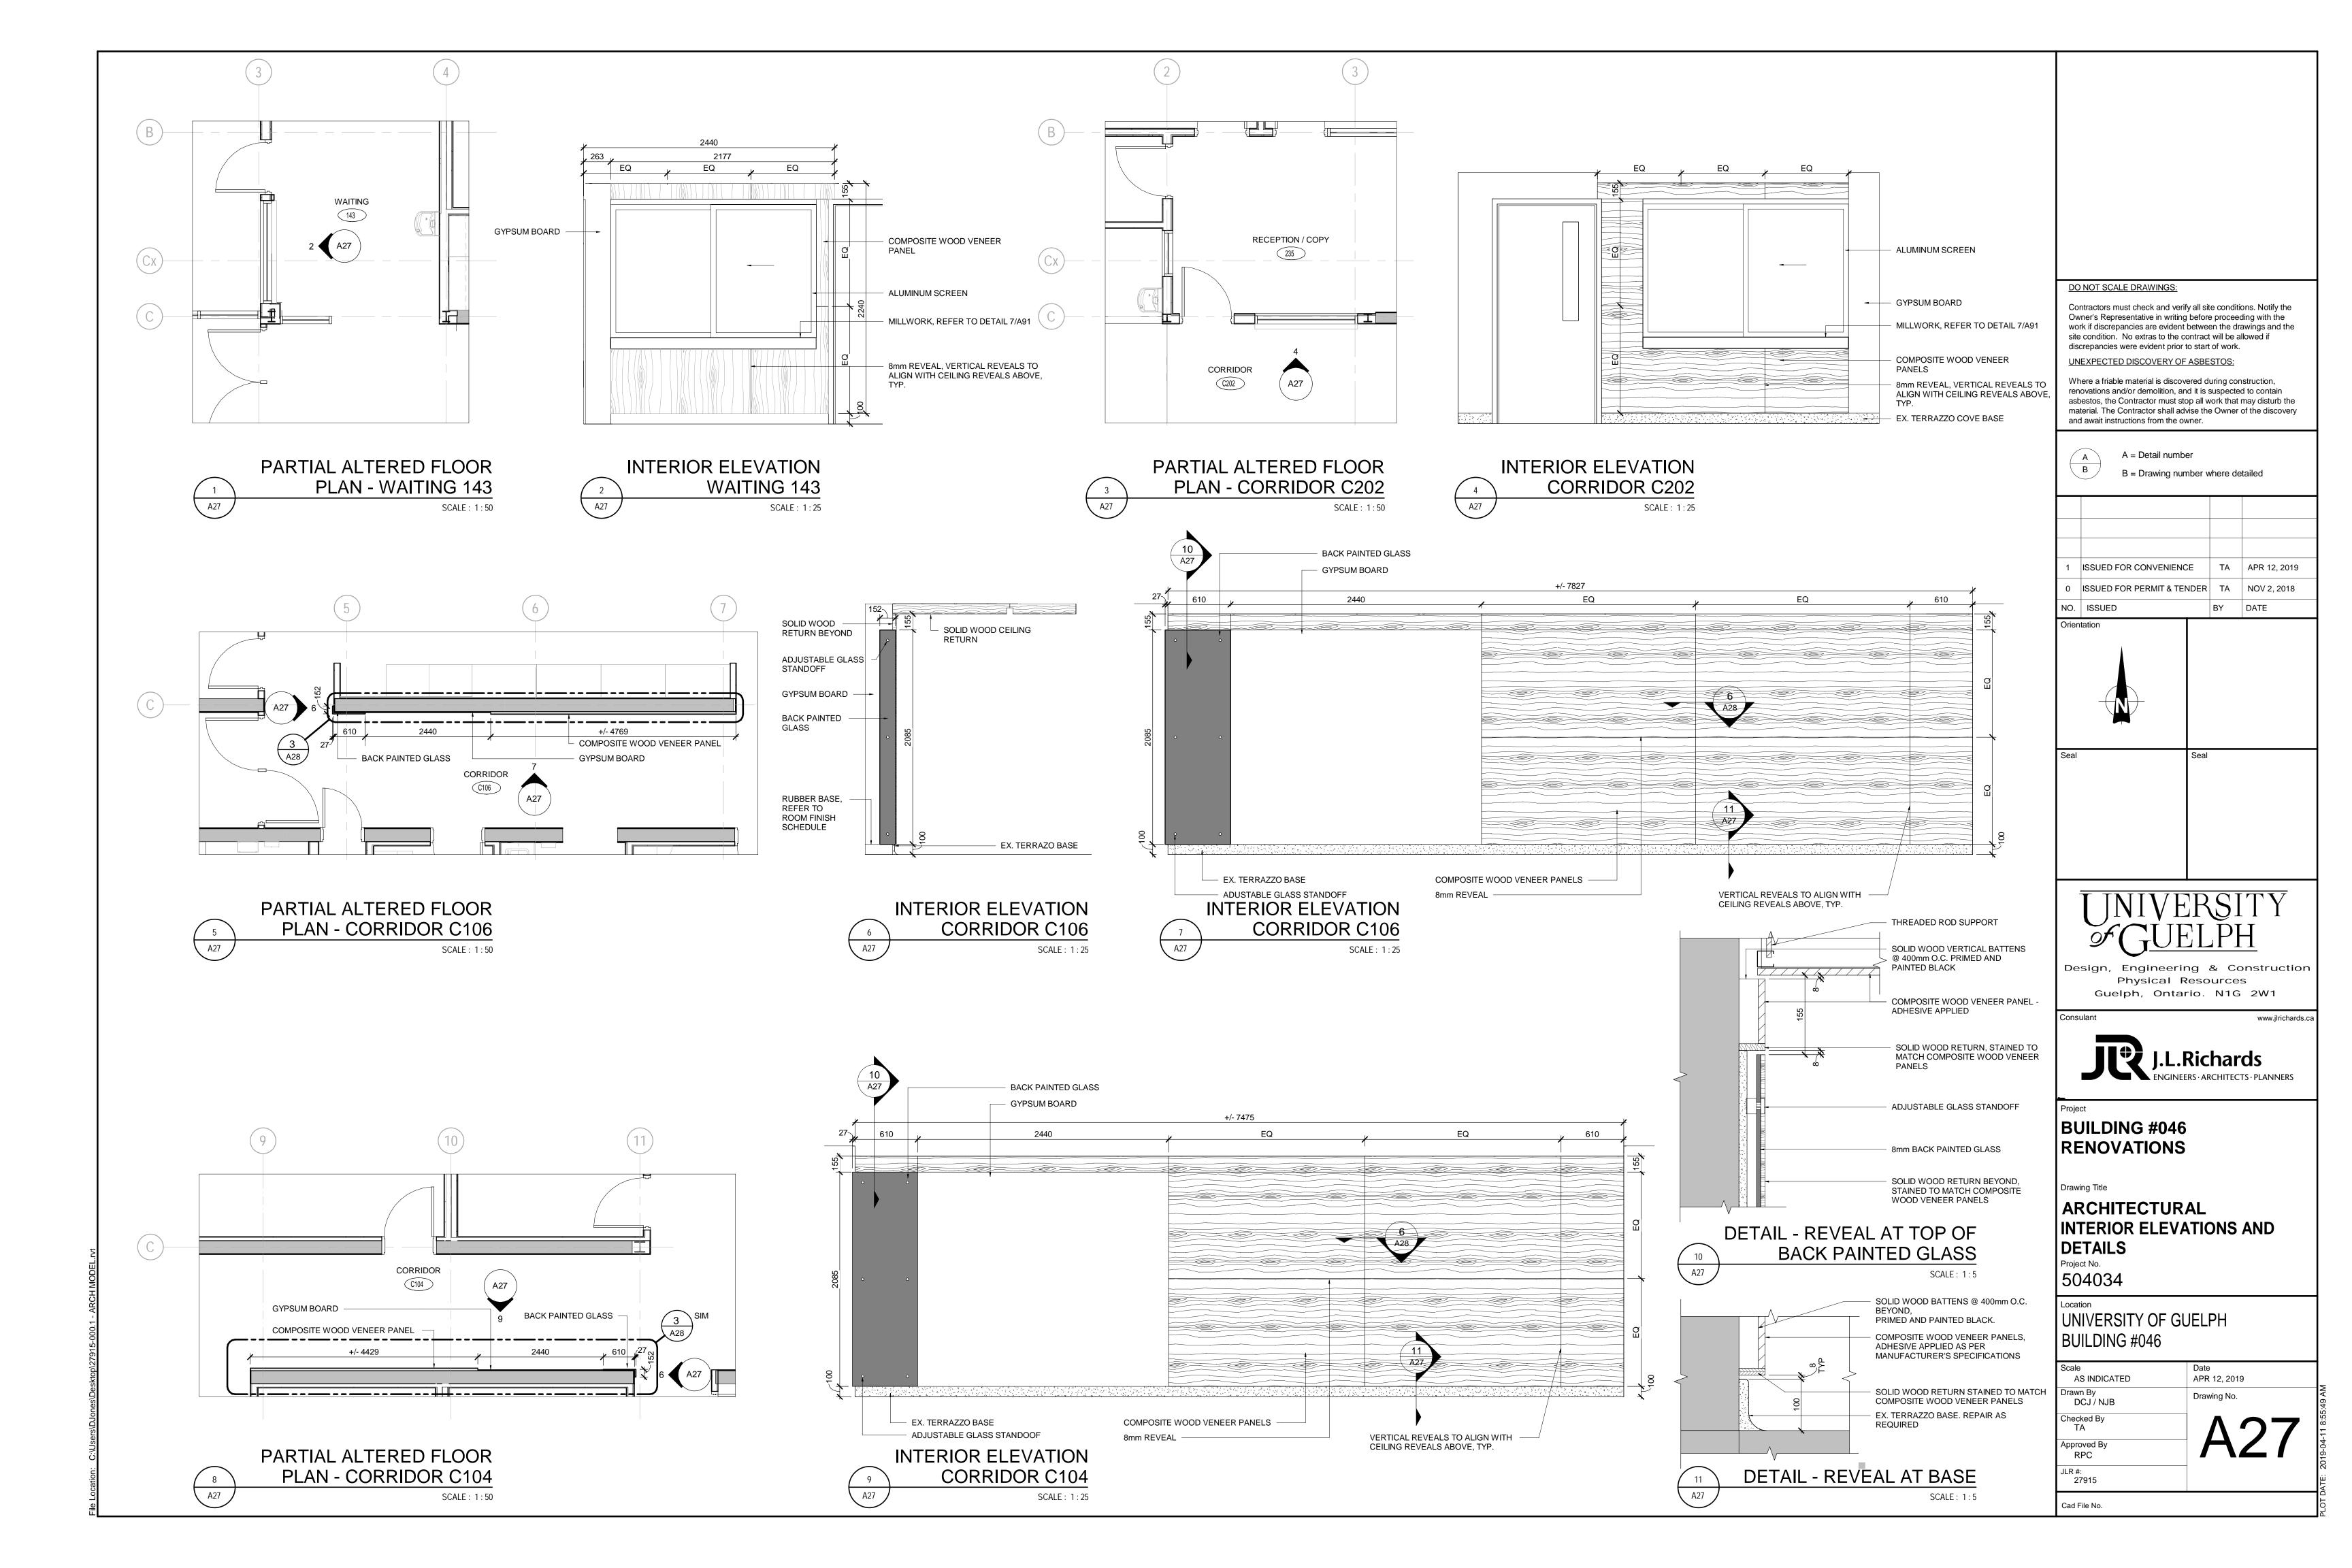

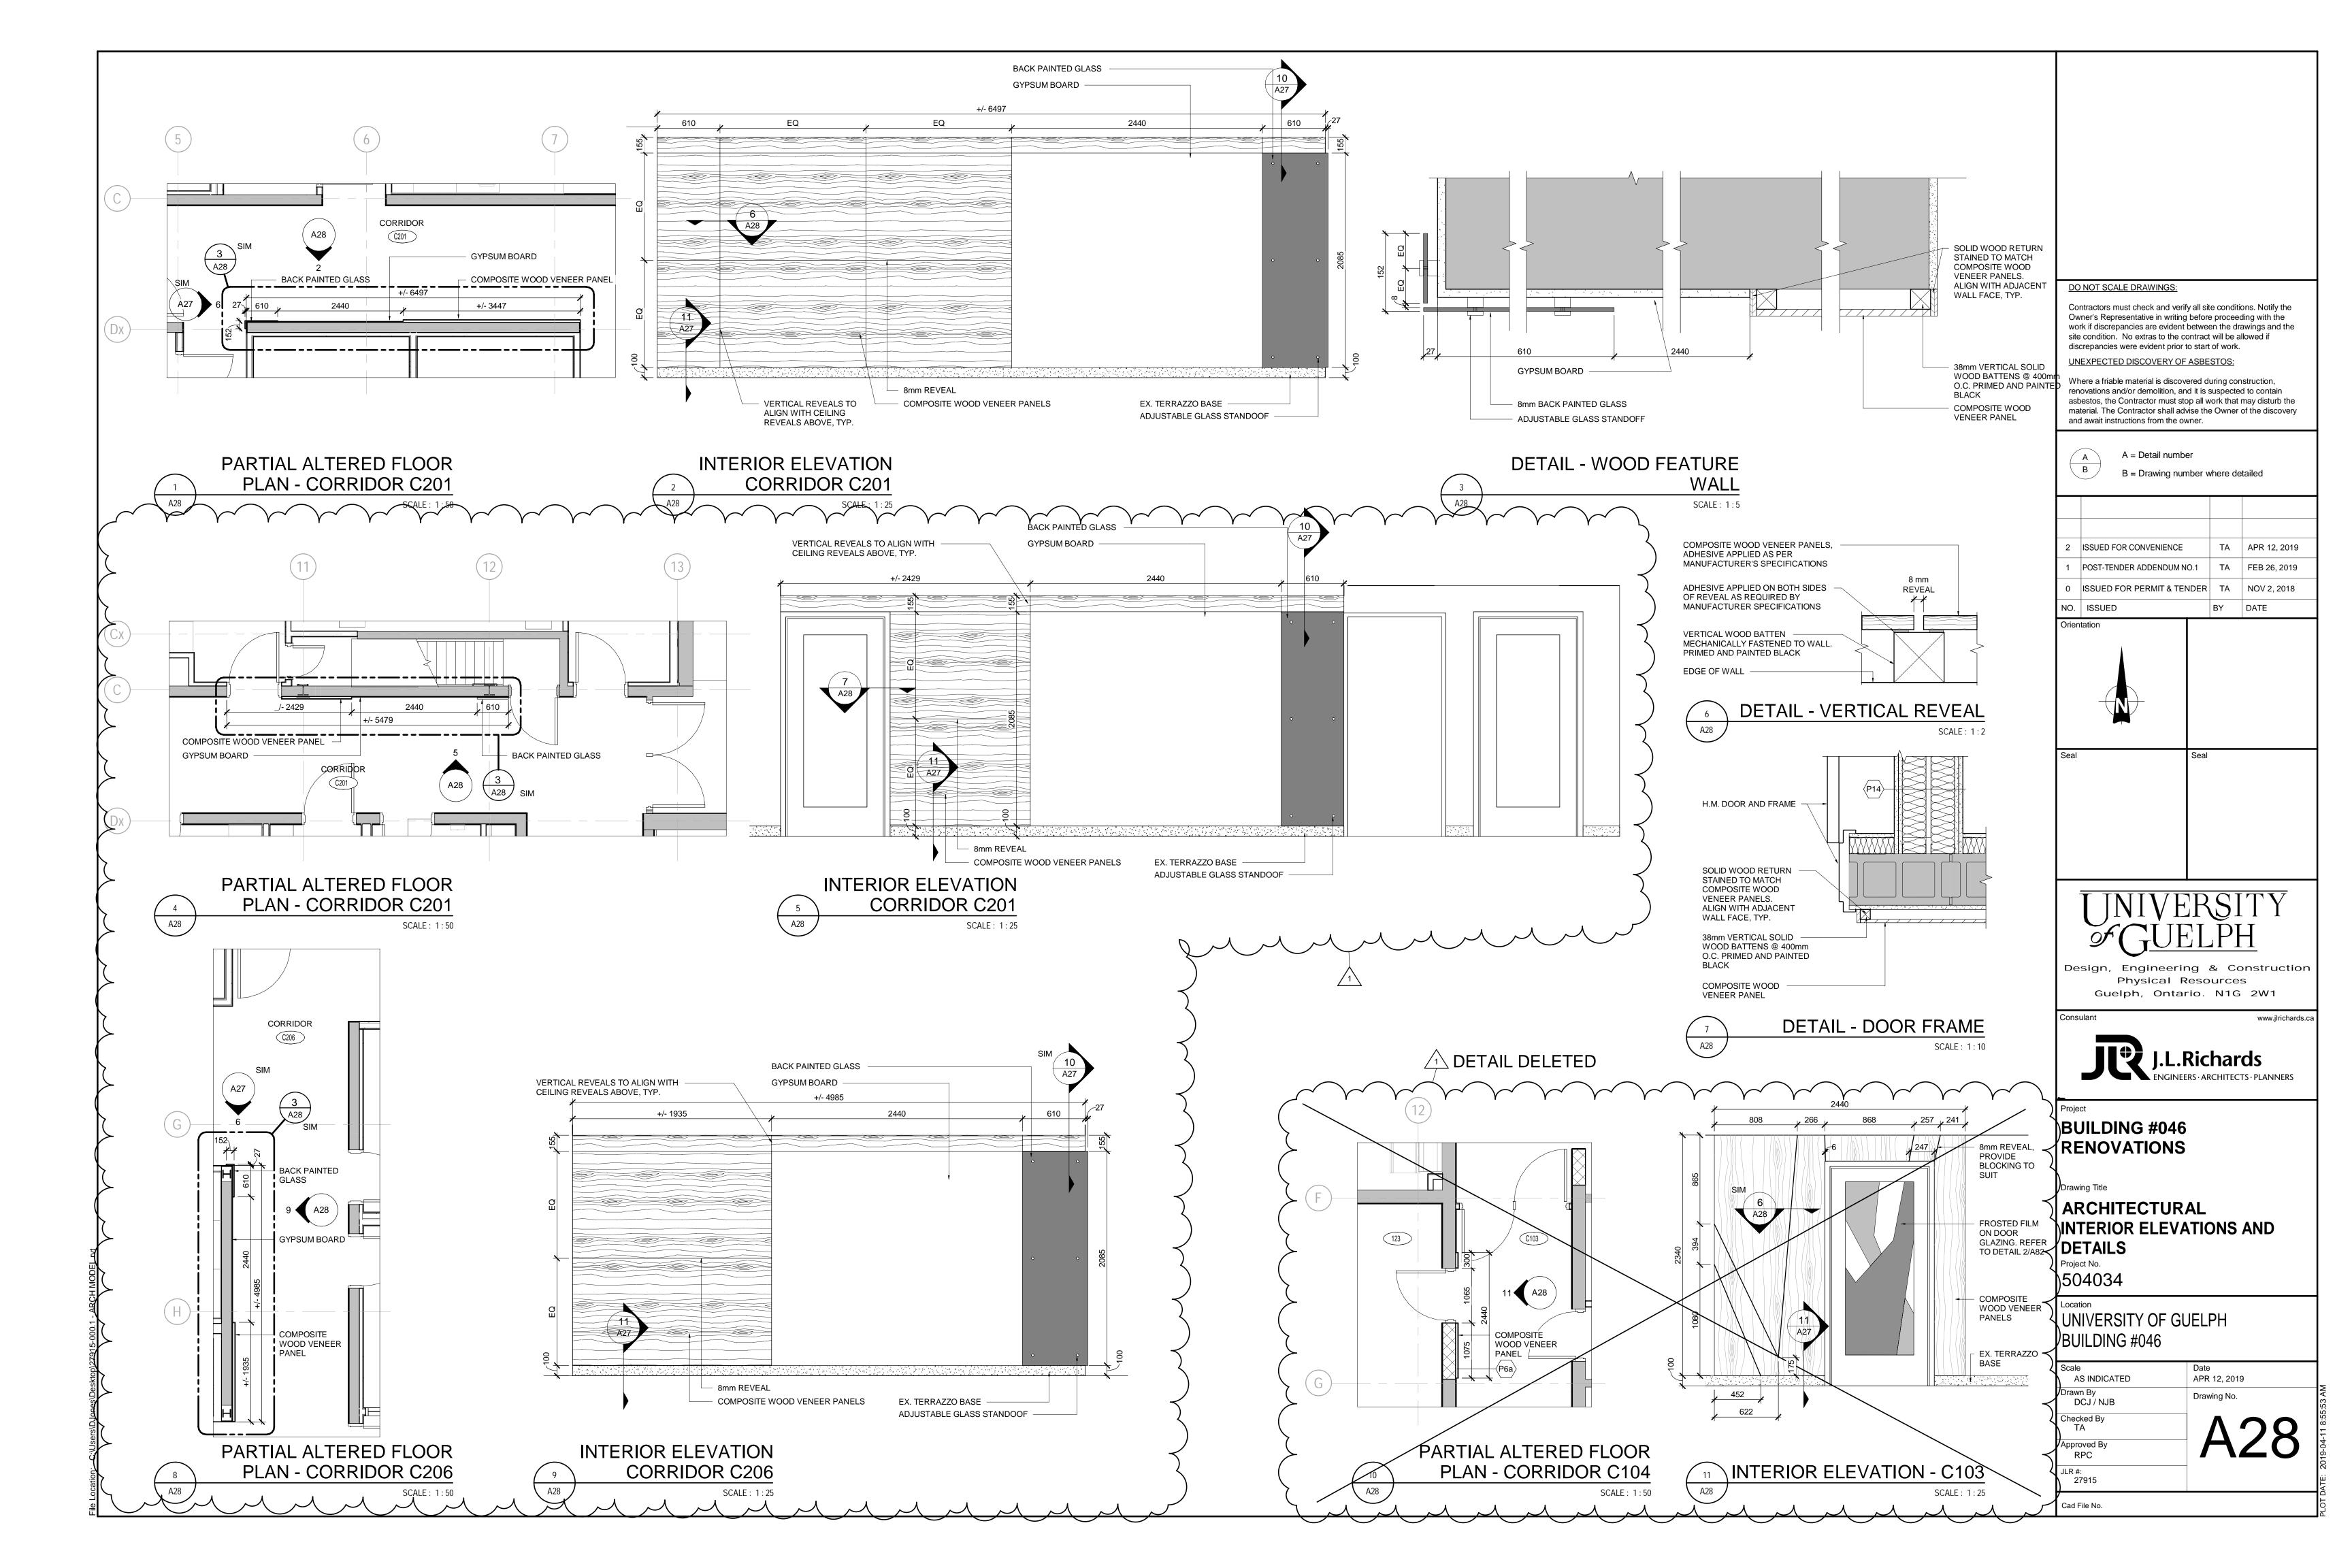

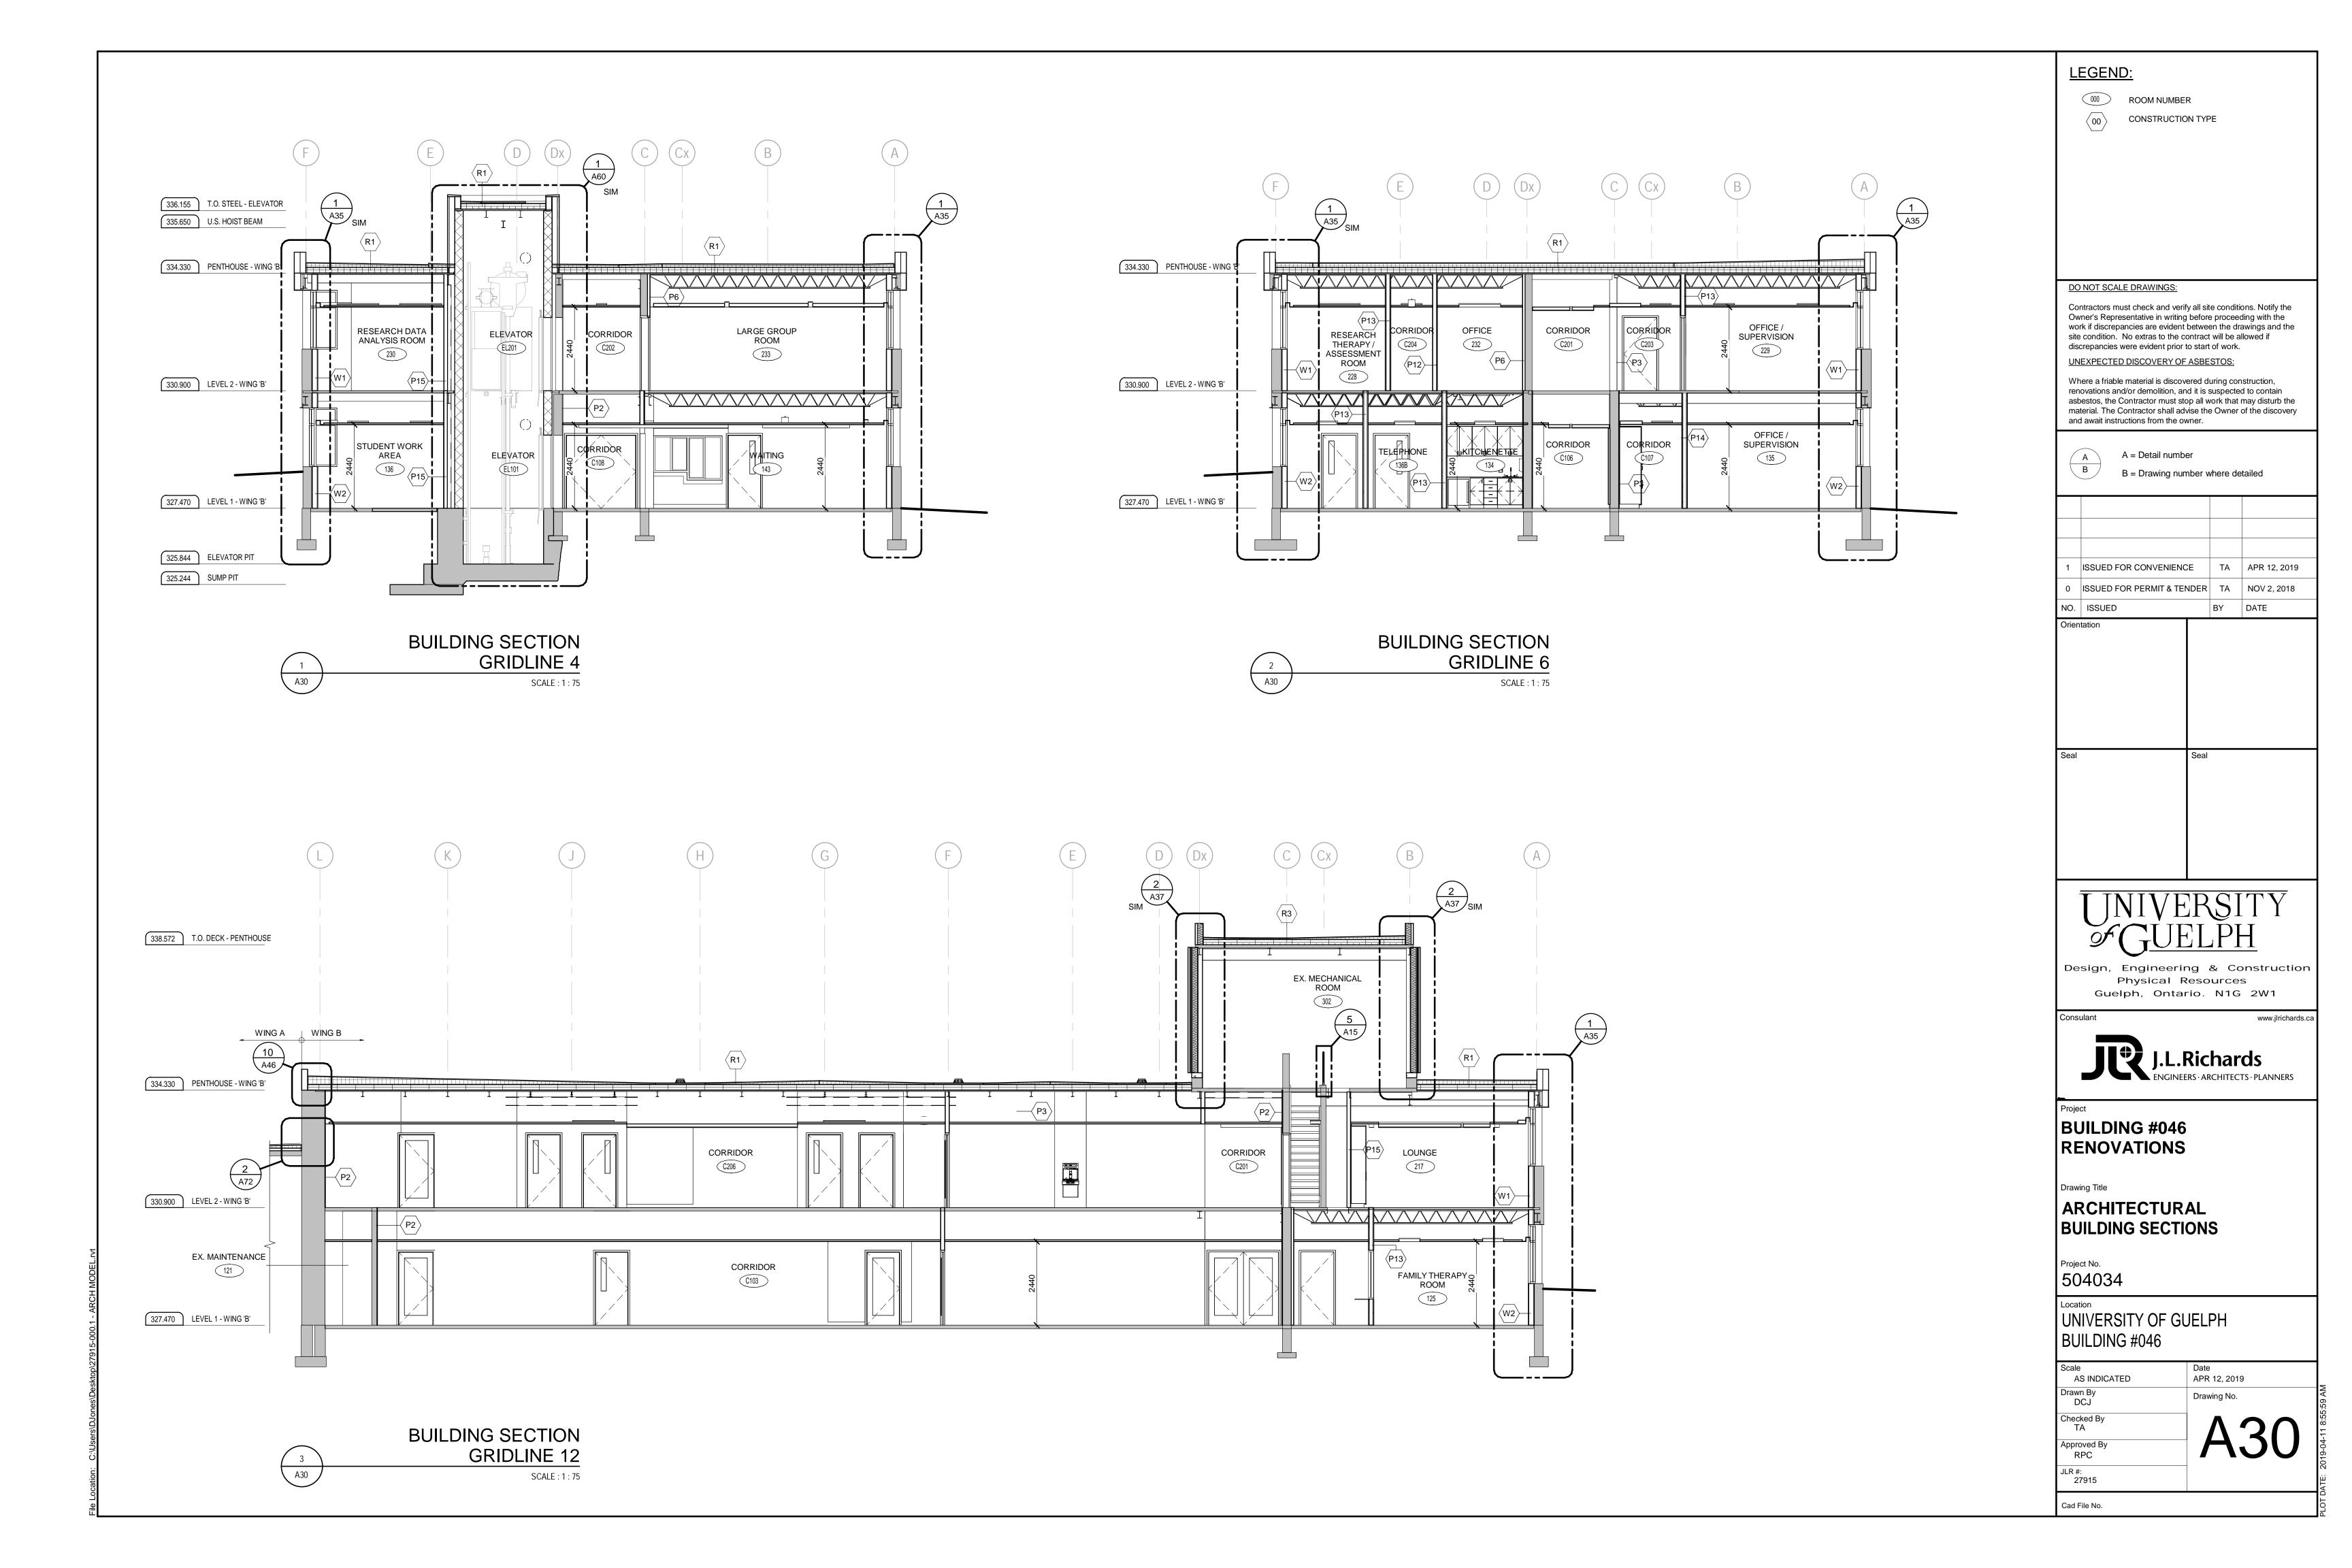

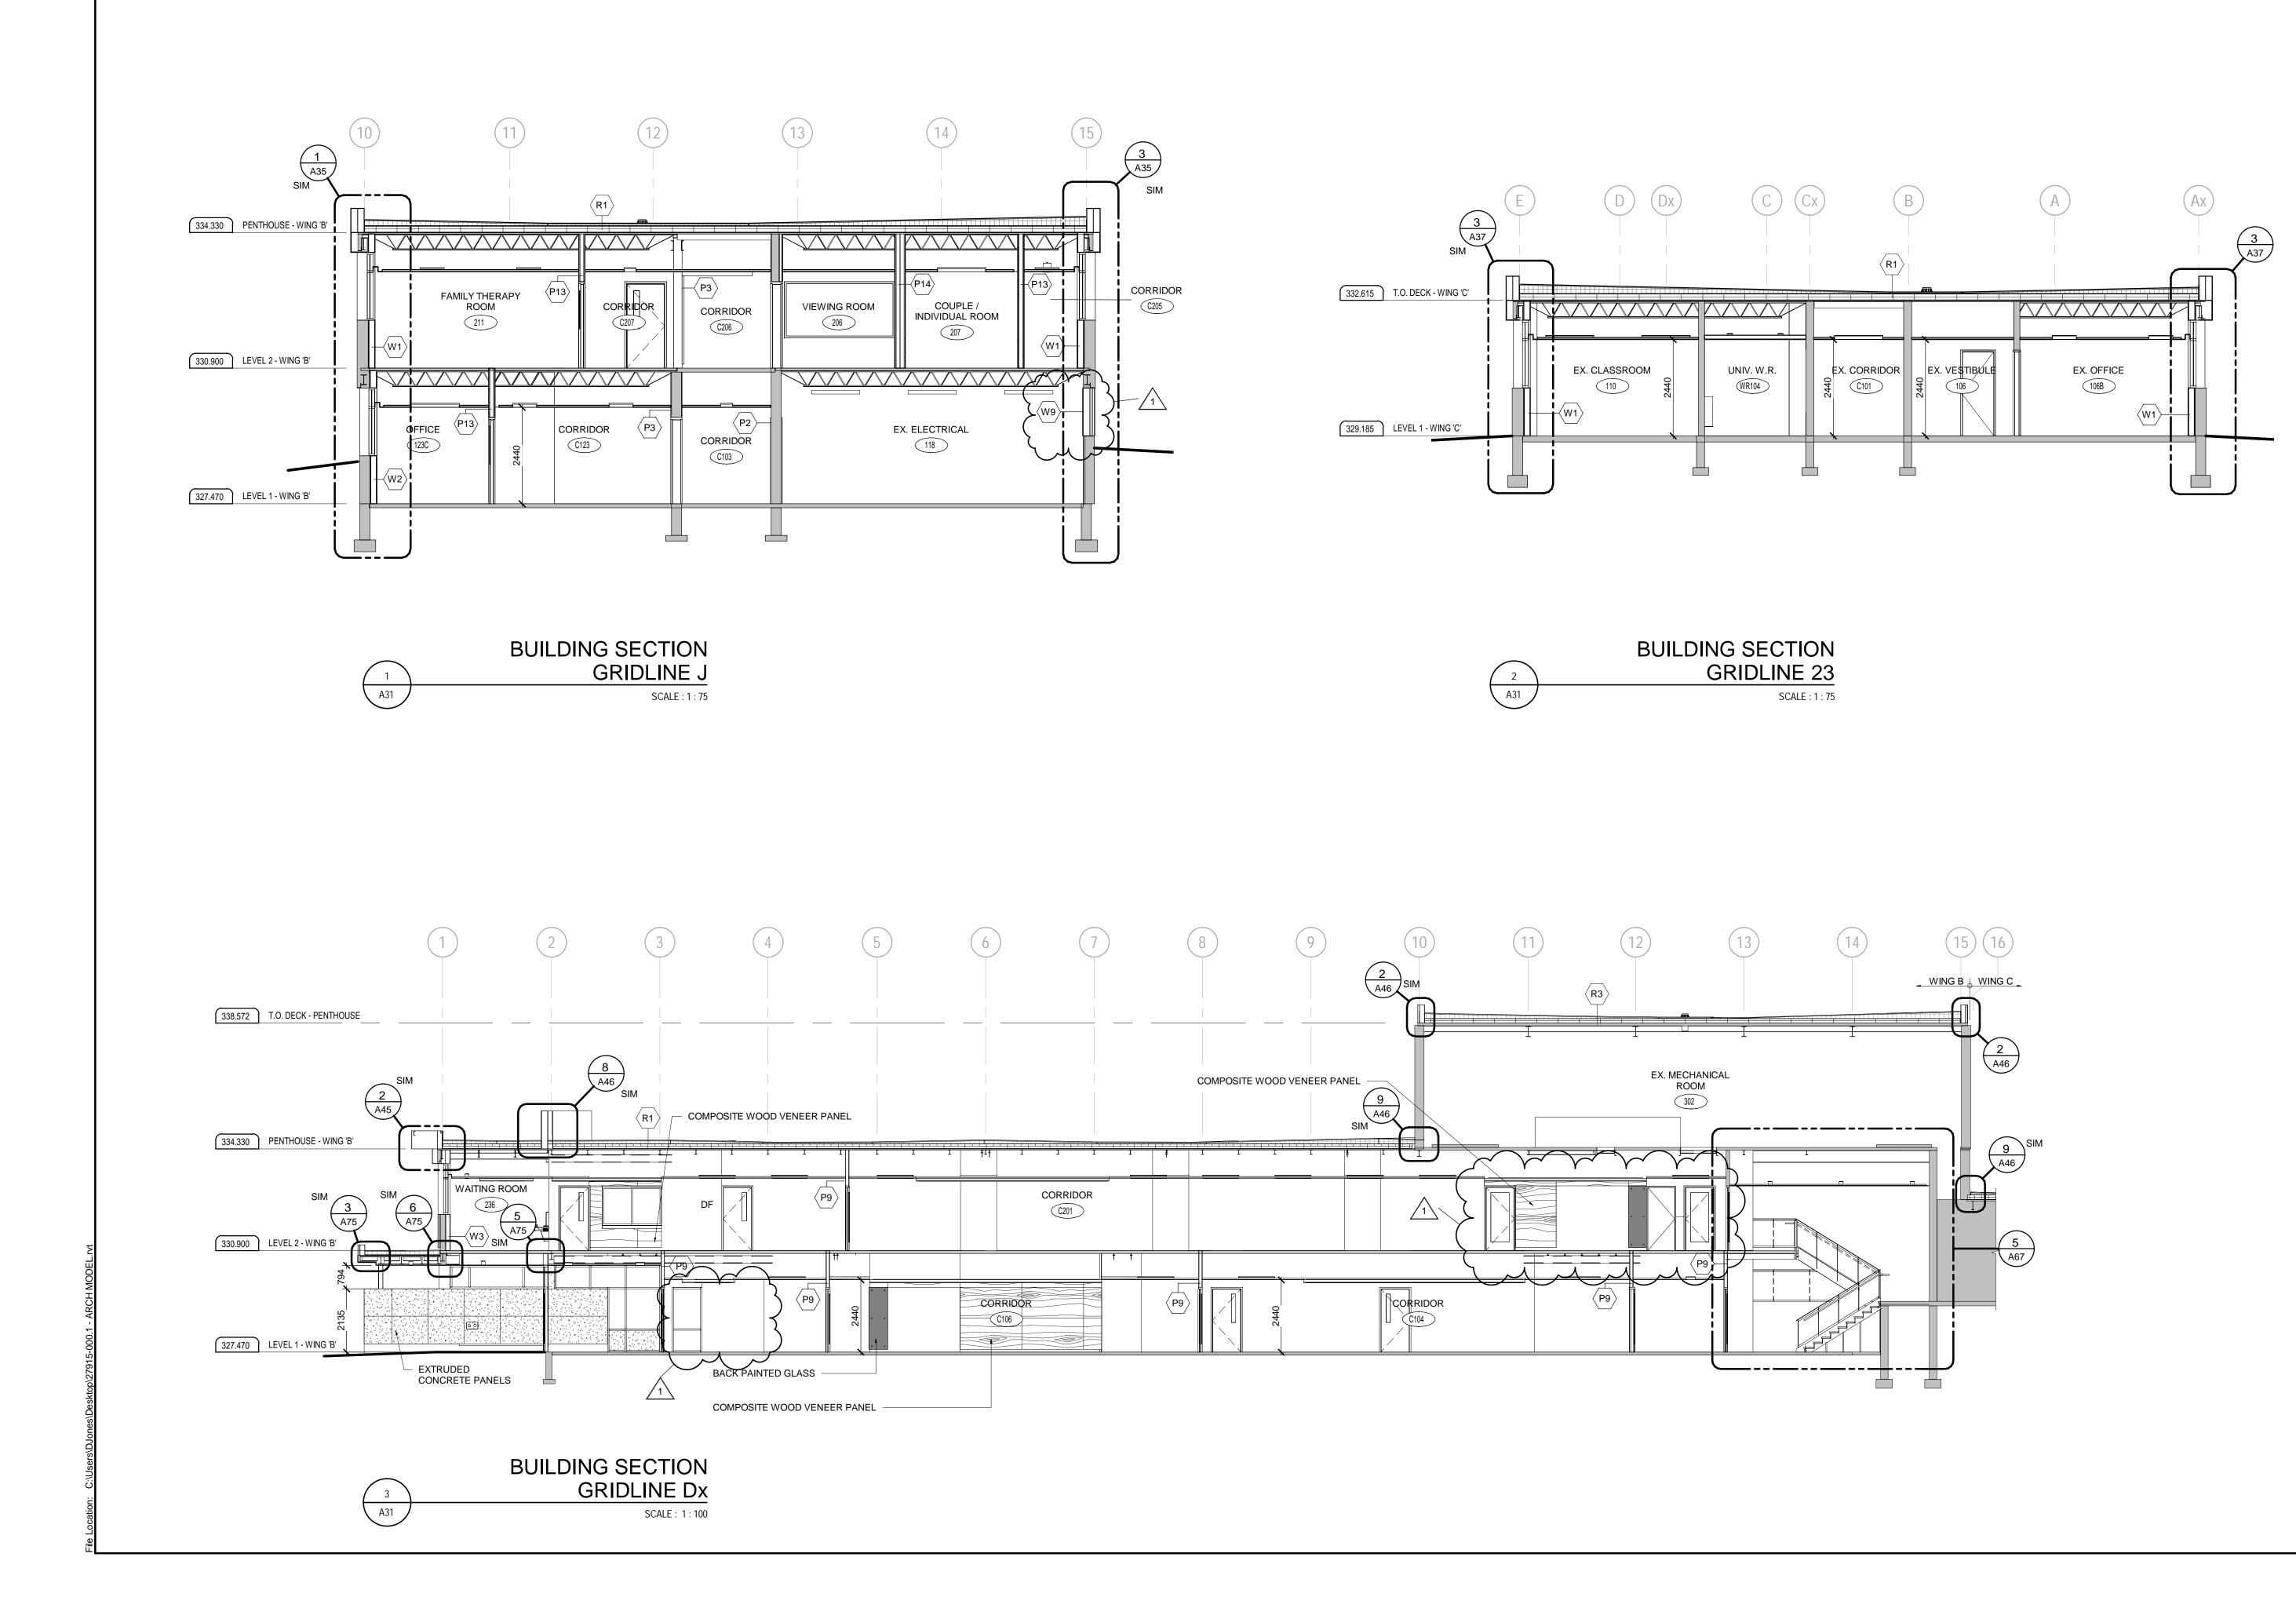

LEGEND:

ROOM NUMBER

CONSTRUCTION TYPE

DO NOT SCALE DRAWINGS:

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A = Detail number

B = Drawing number where detailed

ISSUED FOR CONVENIENCE TA APR 12, 2019 POST-TENDER ADDENDUM NO.1 TA FEB 26, 2019 ISSUED FOR PERMIT & TENDER | TA | NOV 2, 2018 NO. ISSUED BY DATE

Orientation

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BUILDING #046 RENOVATIONS


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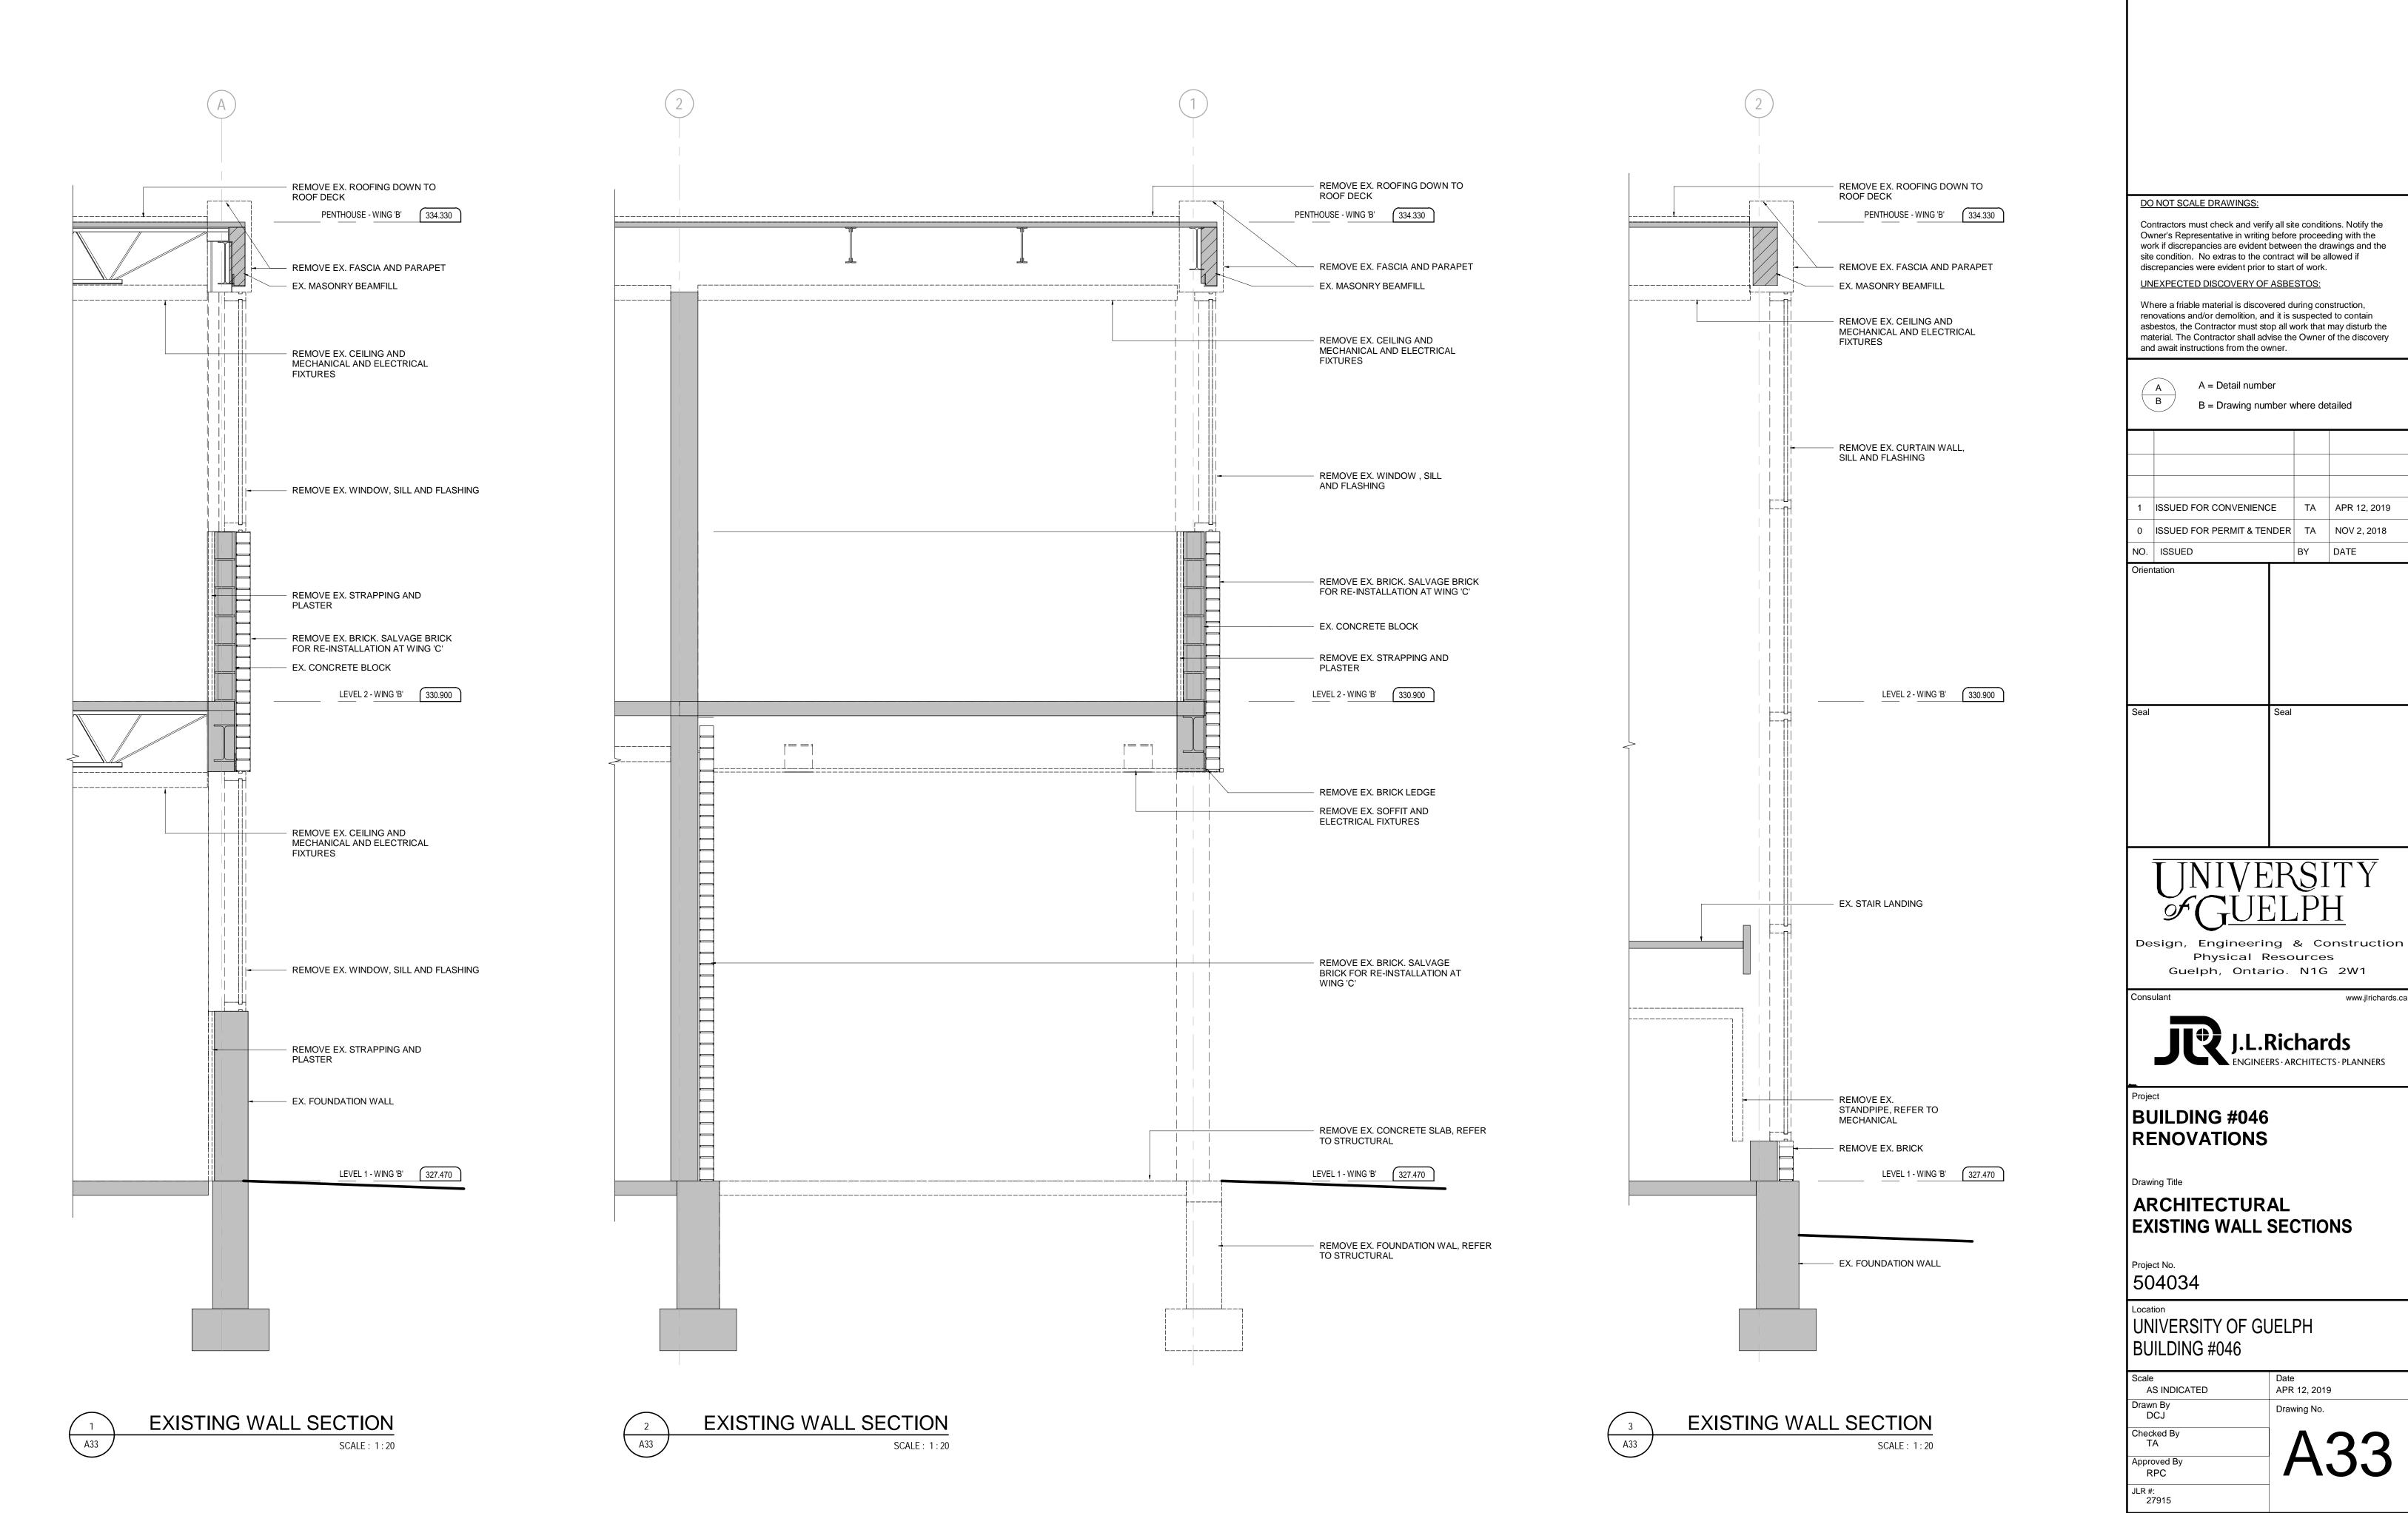
ARCHITECTURAL **BUILDING SECTIONS**

Project No. 504034

UNIVERSITY OF GUELPH BUILDING #046

APR 12, 2019 AS INDICATED Drawing No. Checked By Approved By JLR #: 27915 Cad File No.



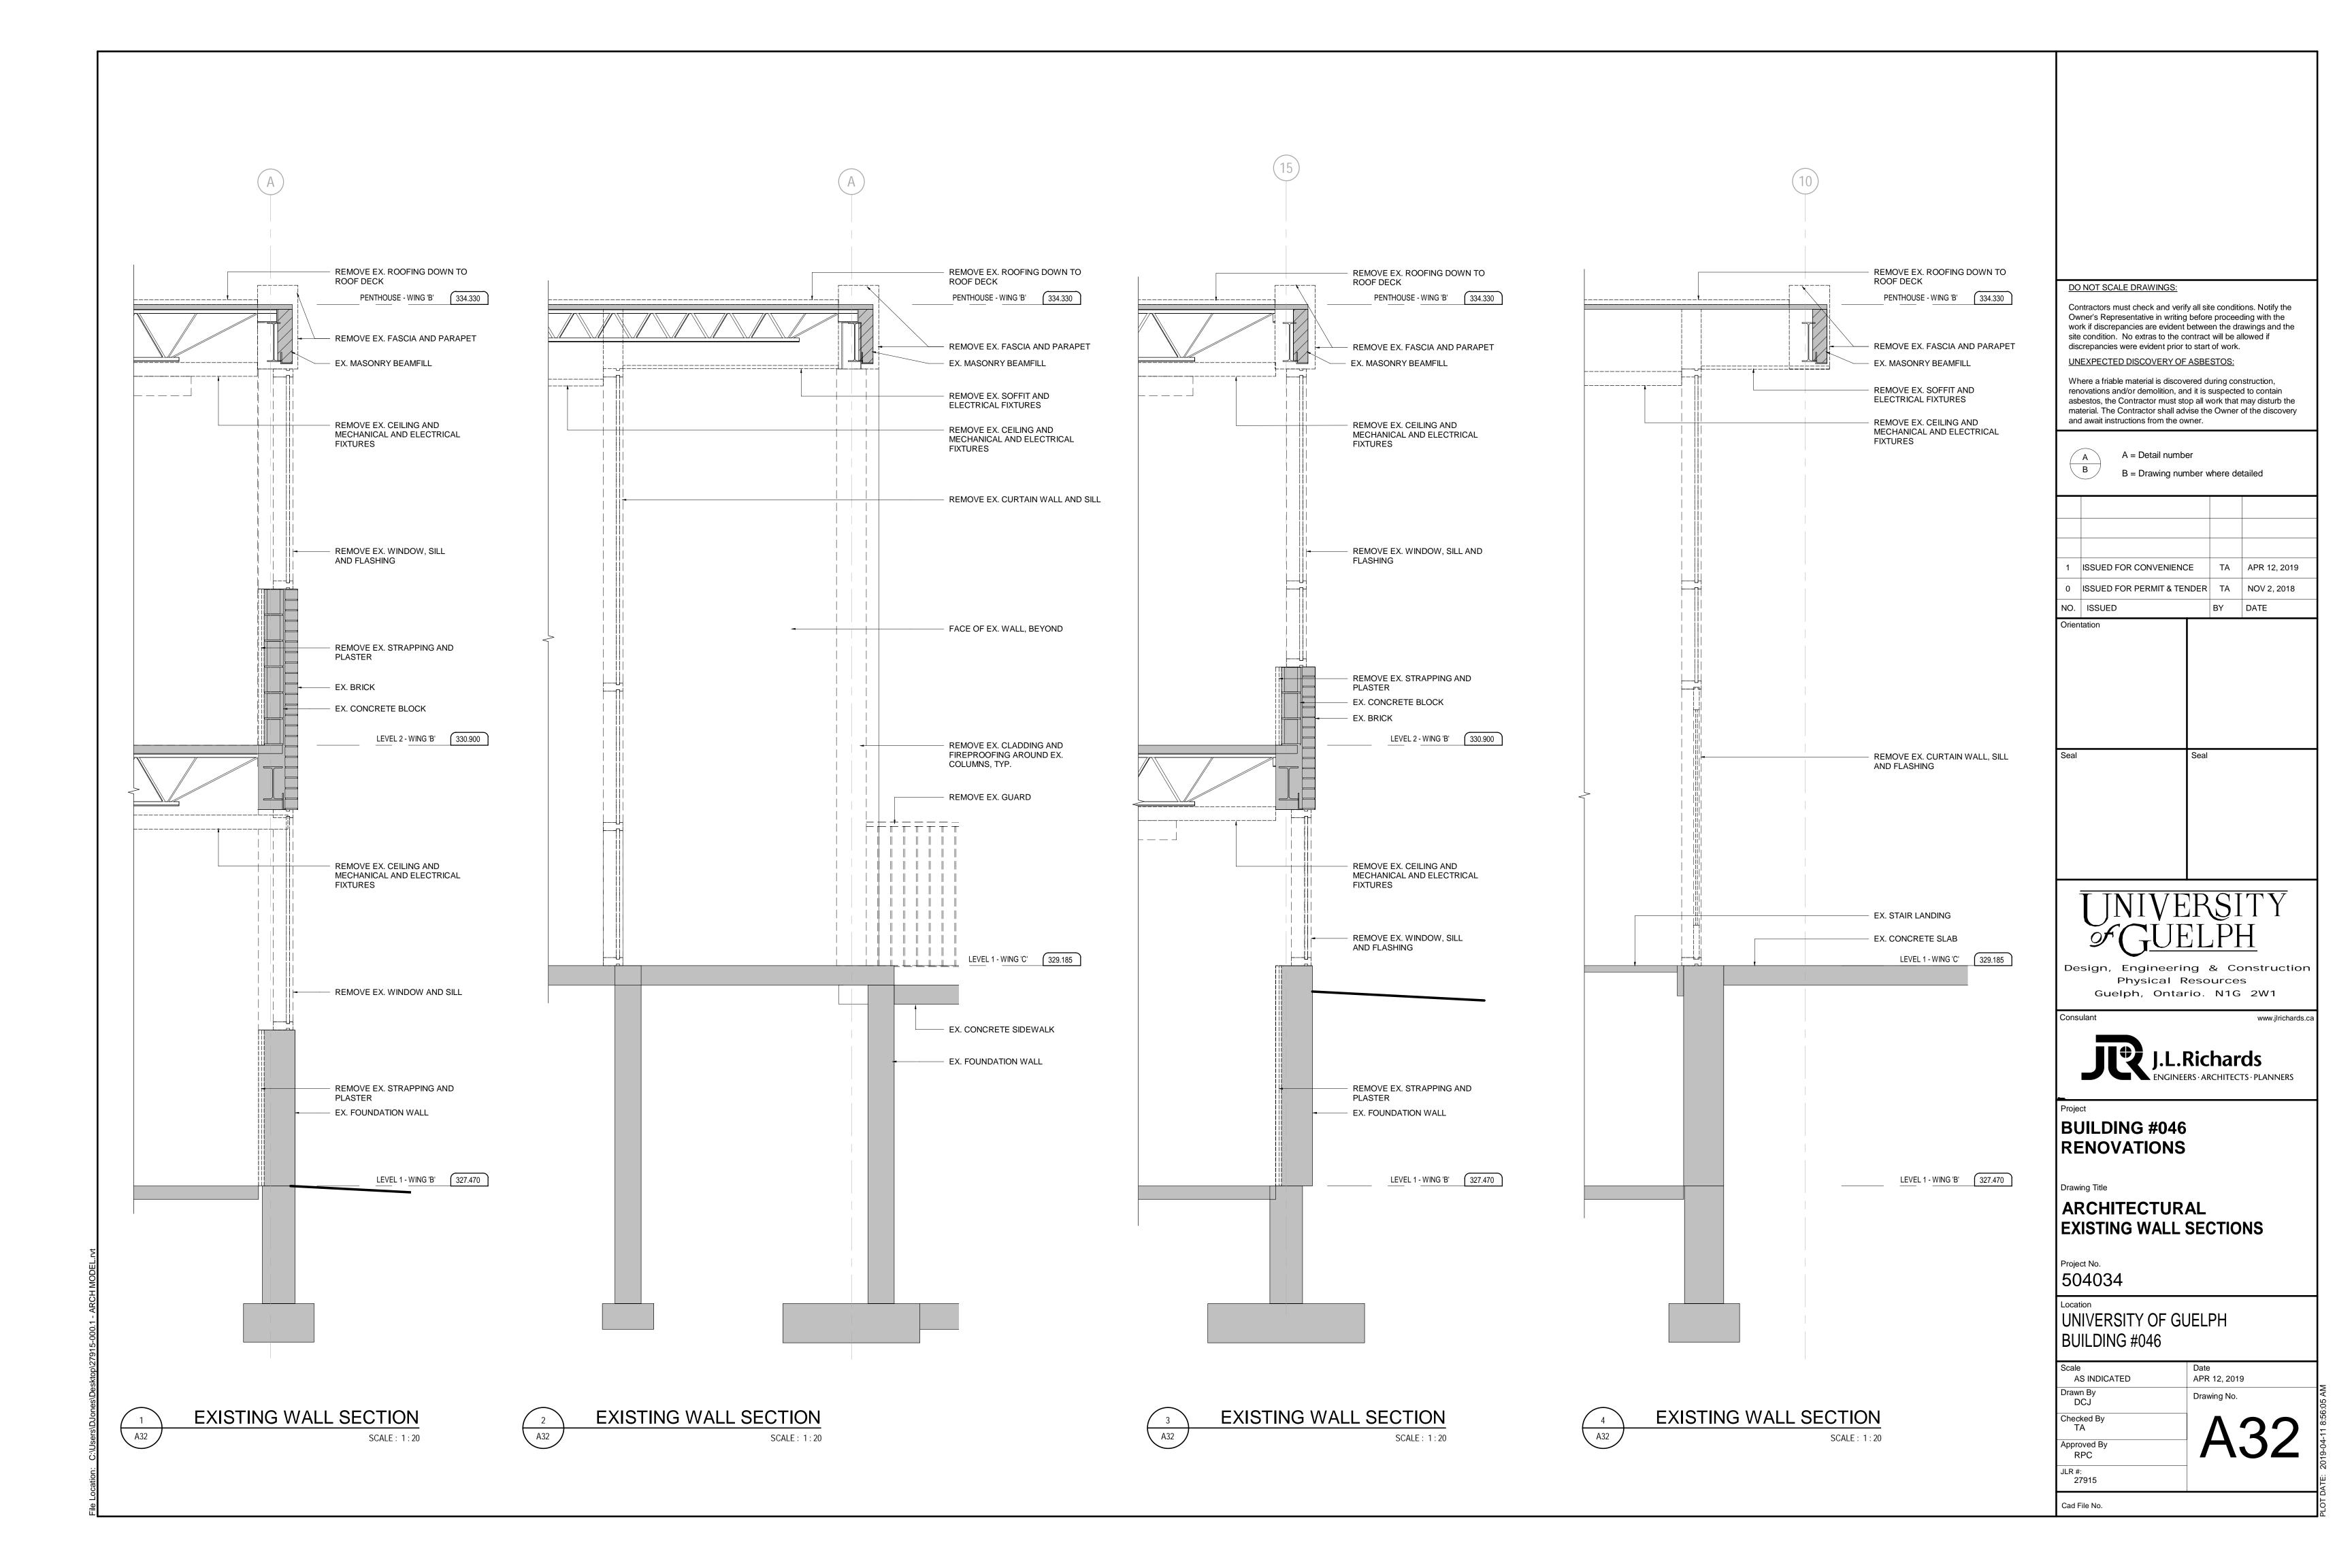



Owner's Representative in writing before proceeding with the work if discrepancies are evident between the drawings and the


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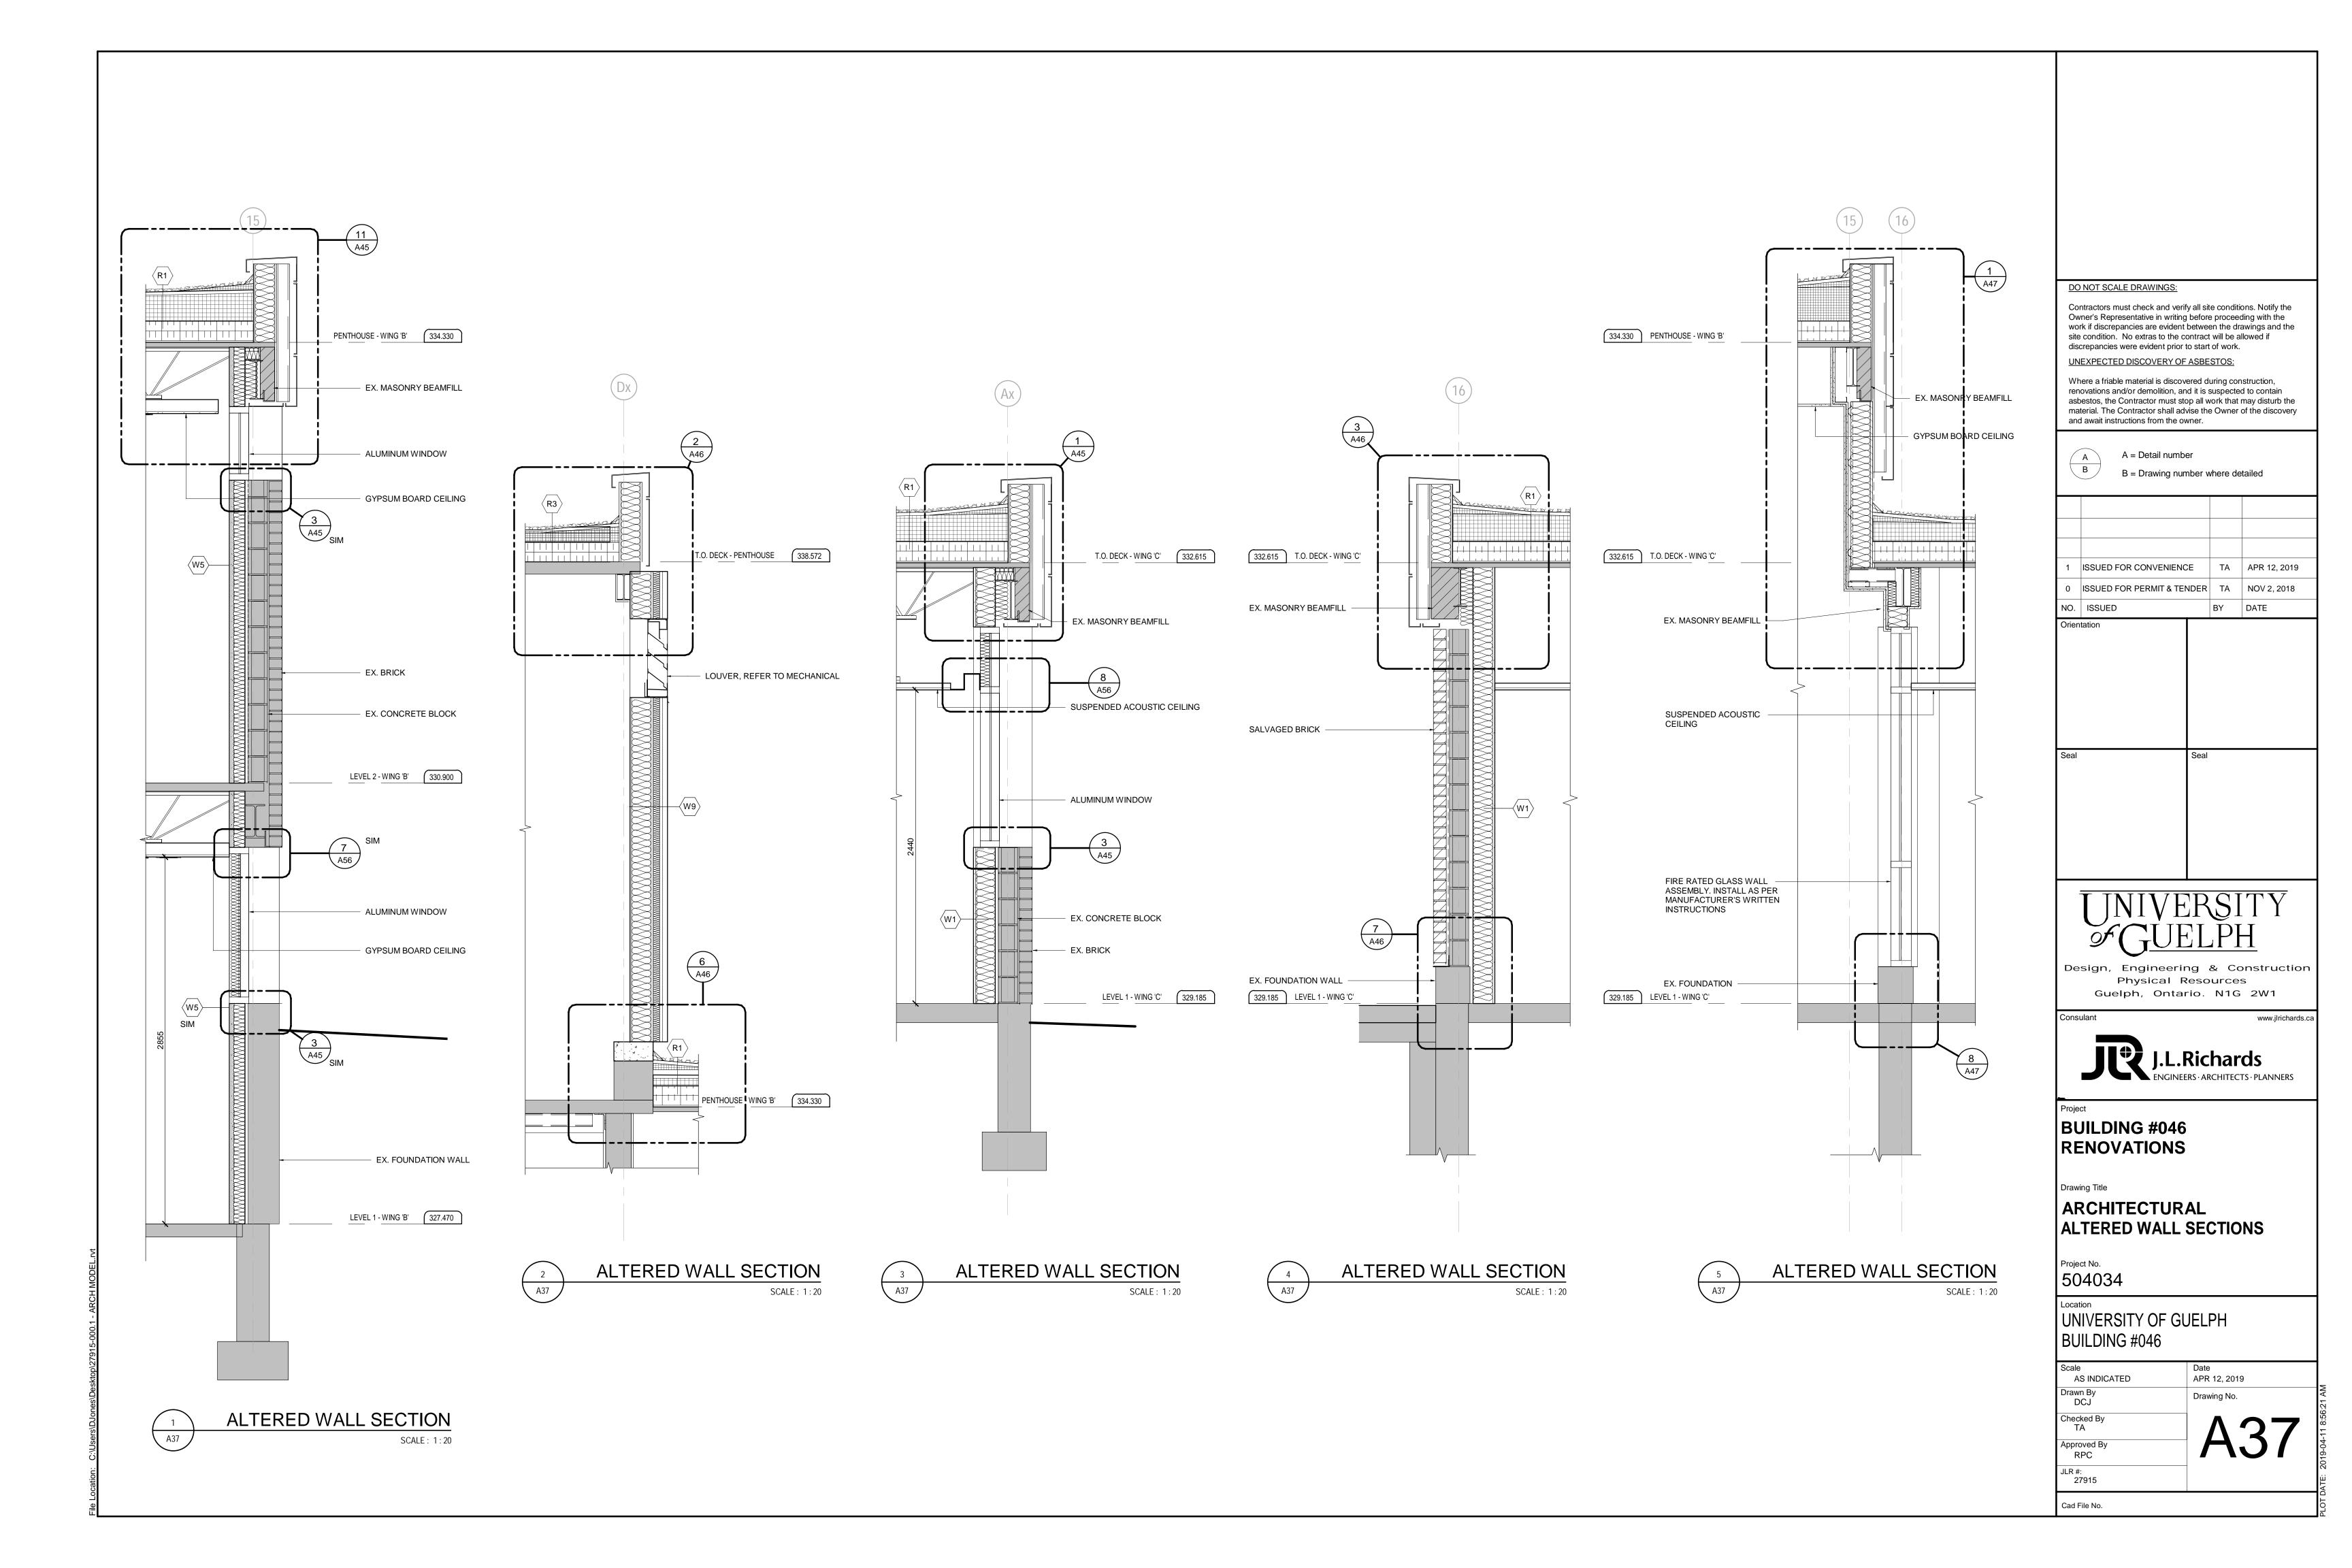
ISSUED FOR CONVENIENCE TA APR 12, 2019 ISSUED FOR PERMIT & TENDER TA NOV 2, 2018


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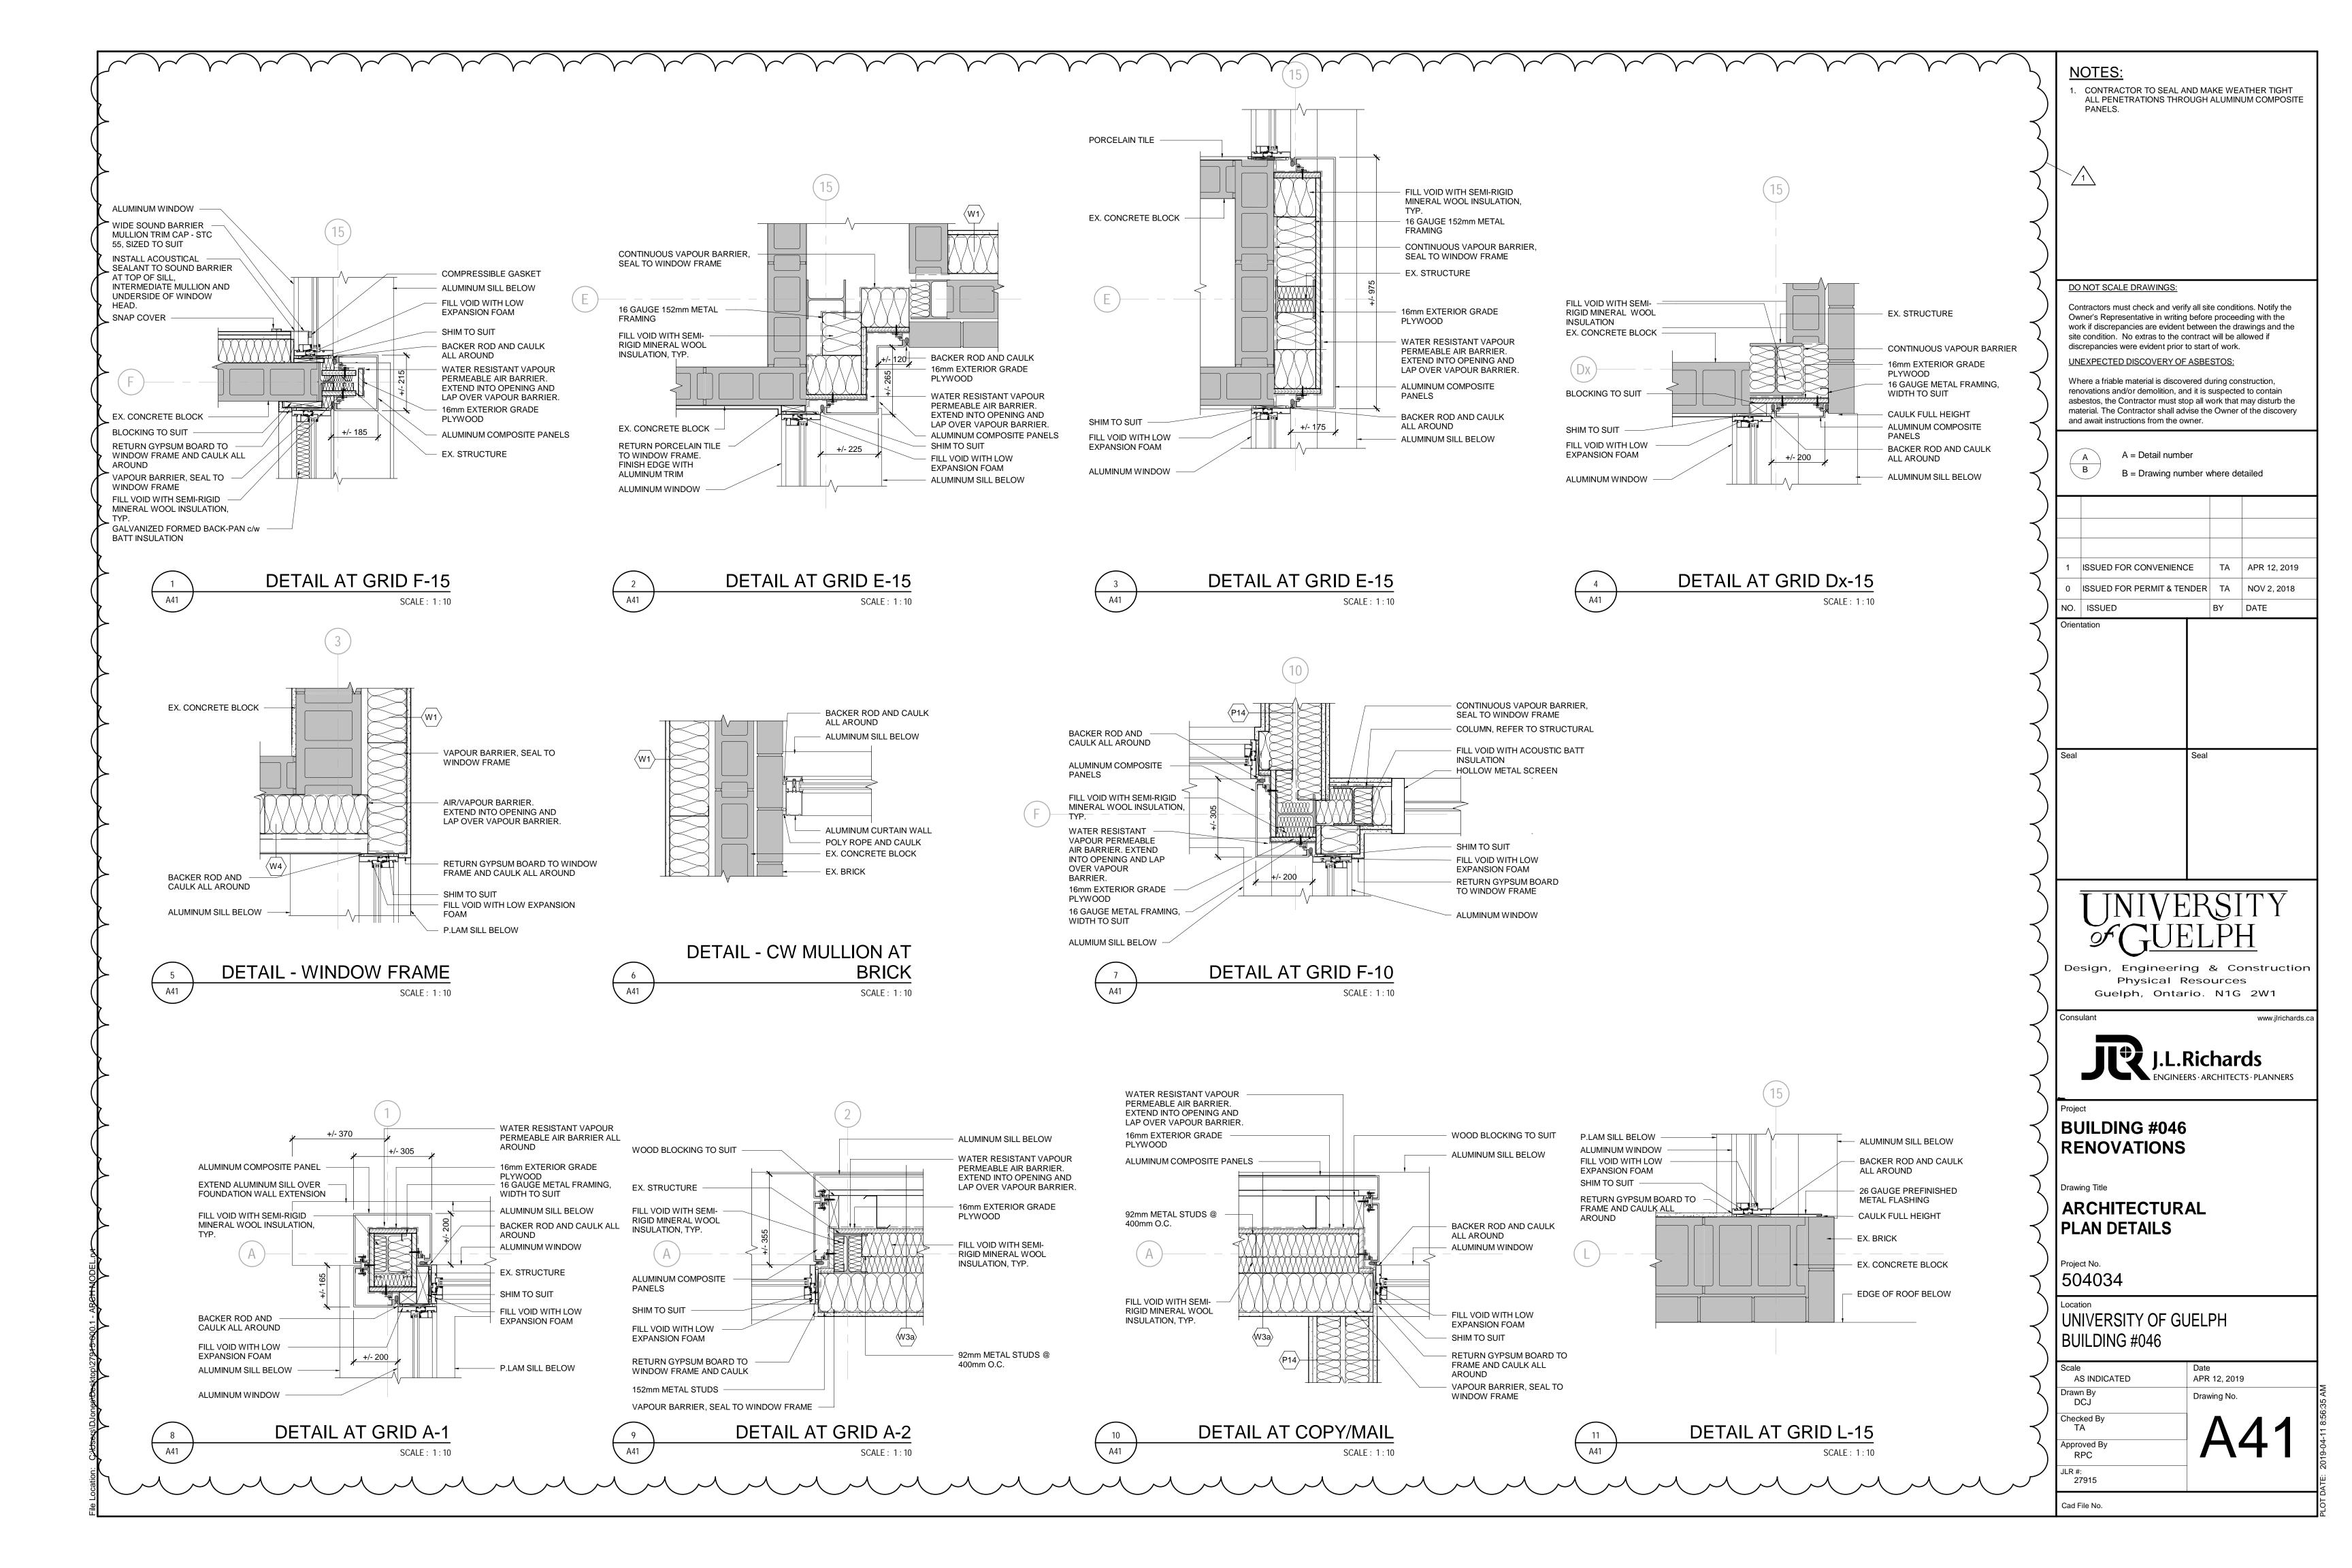





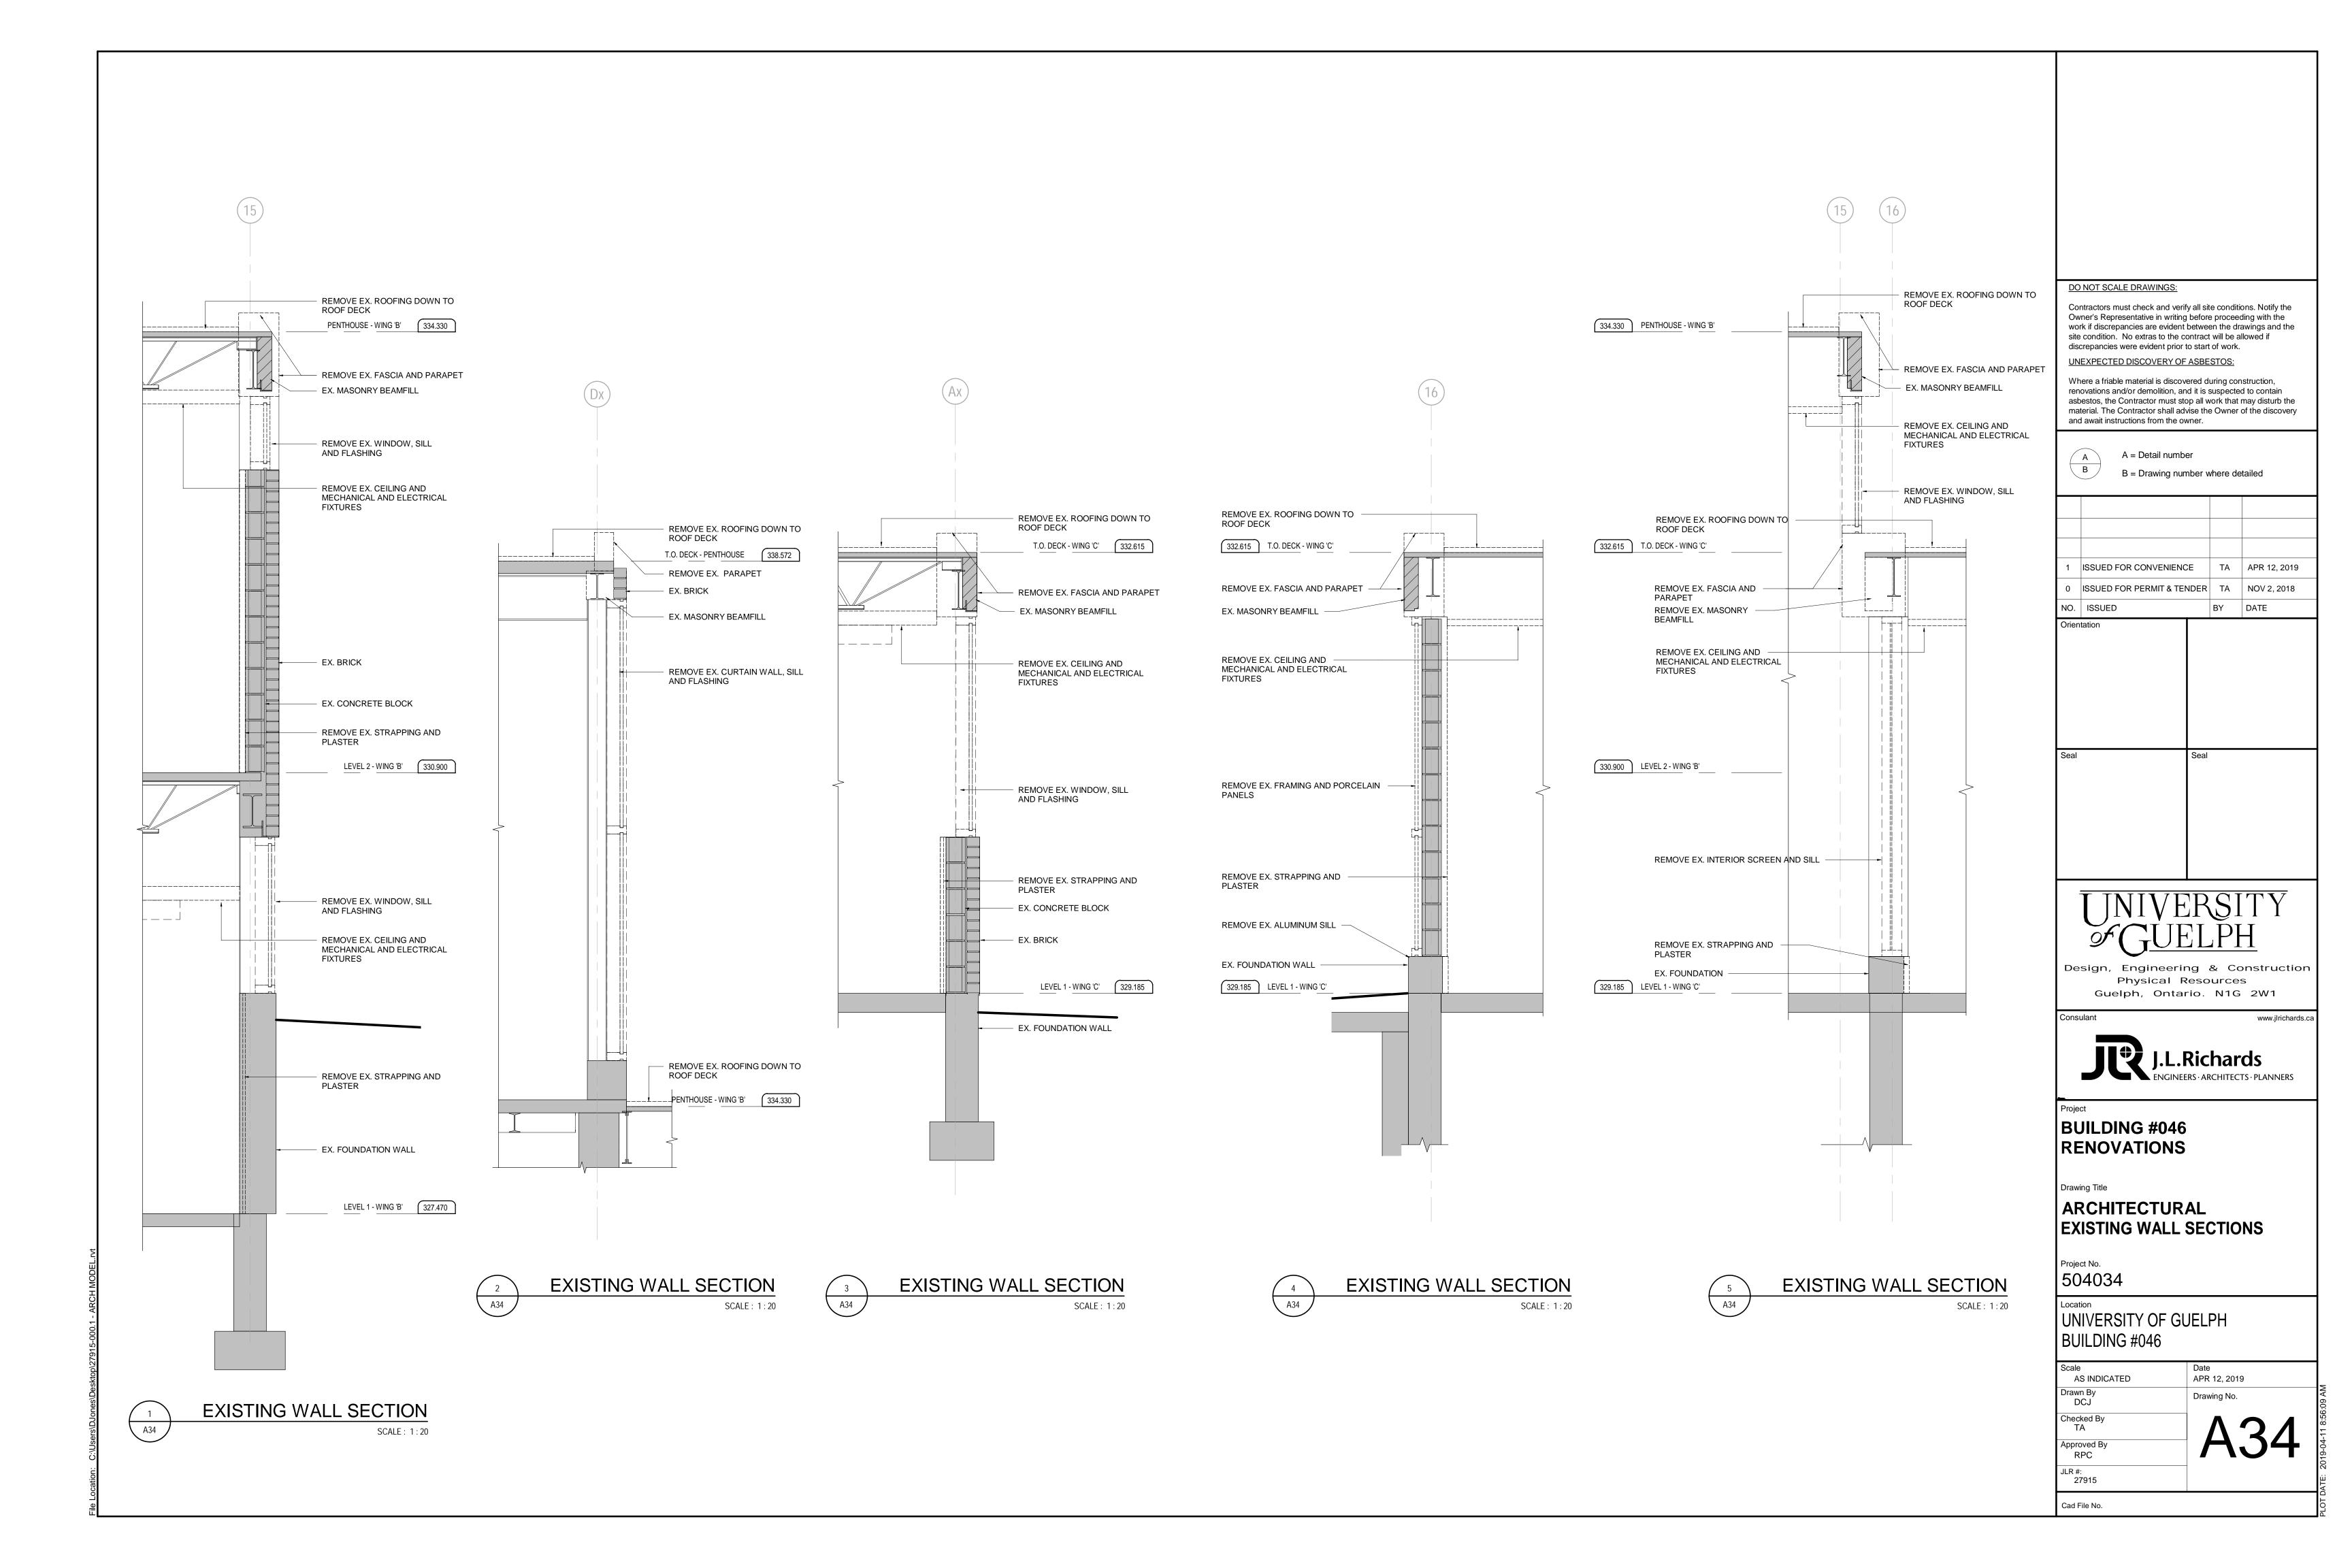


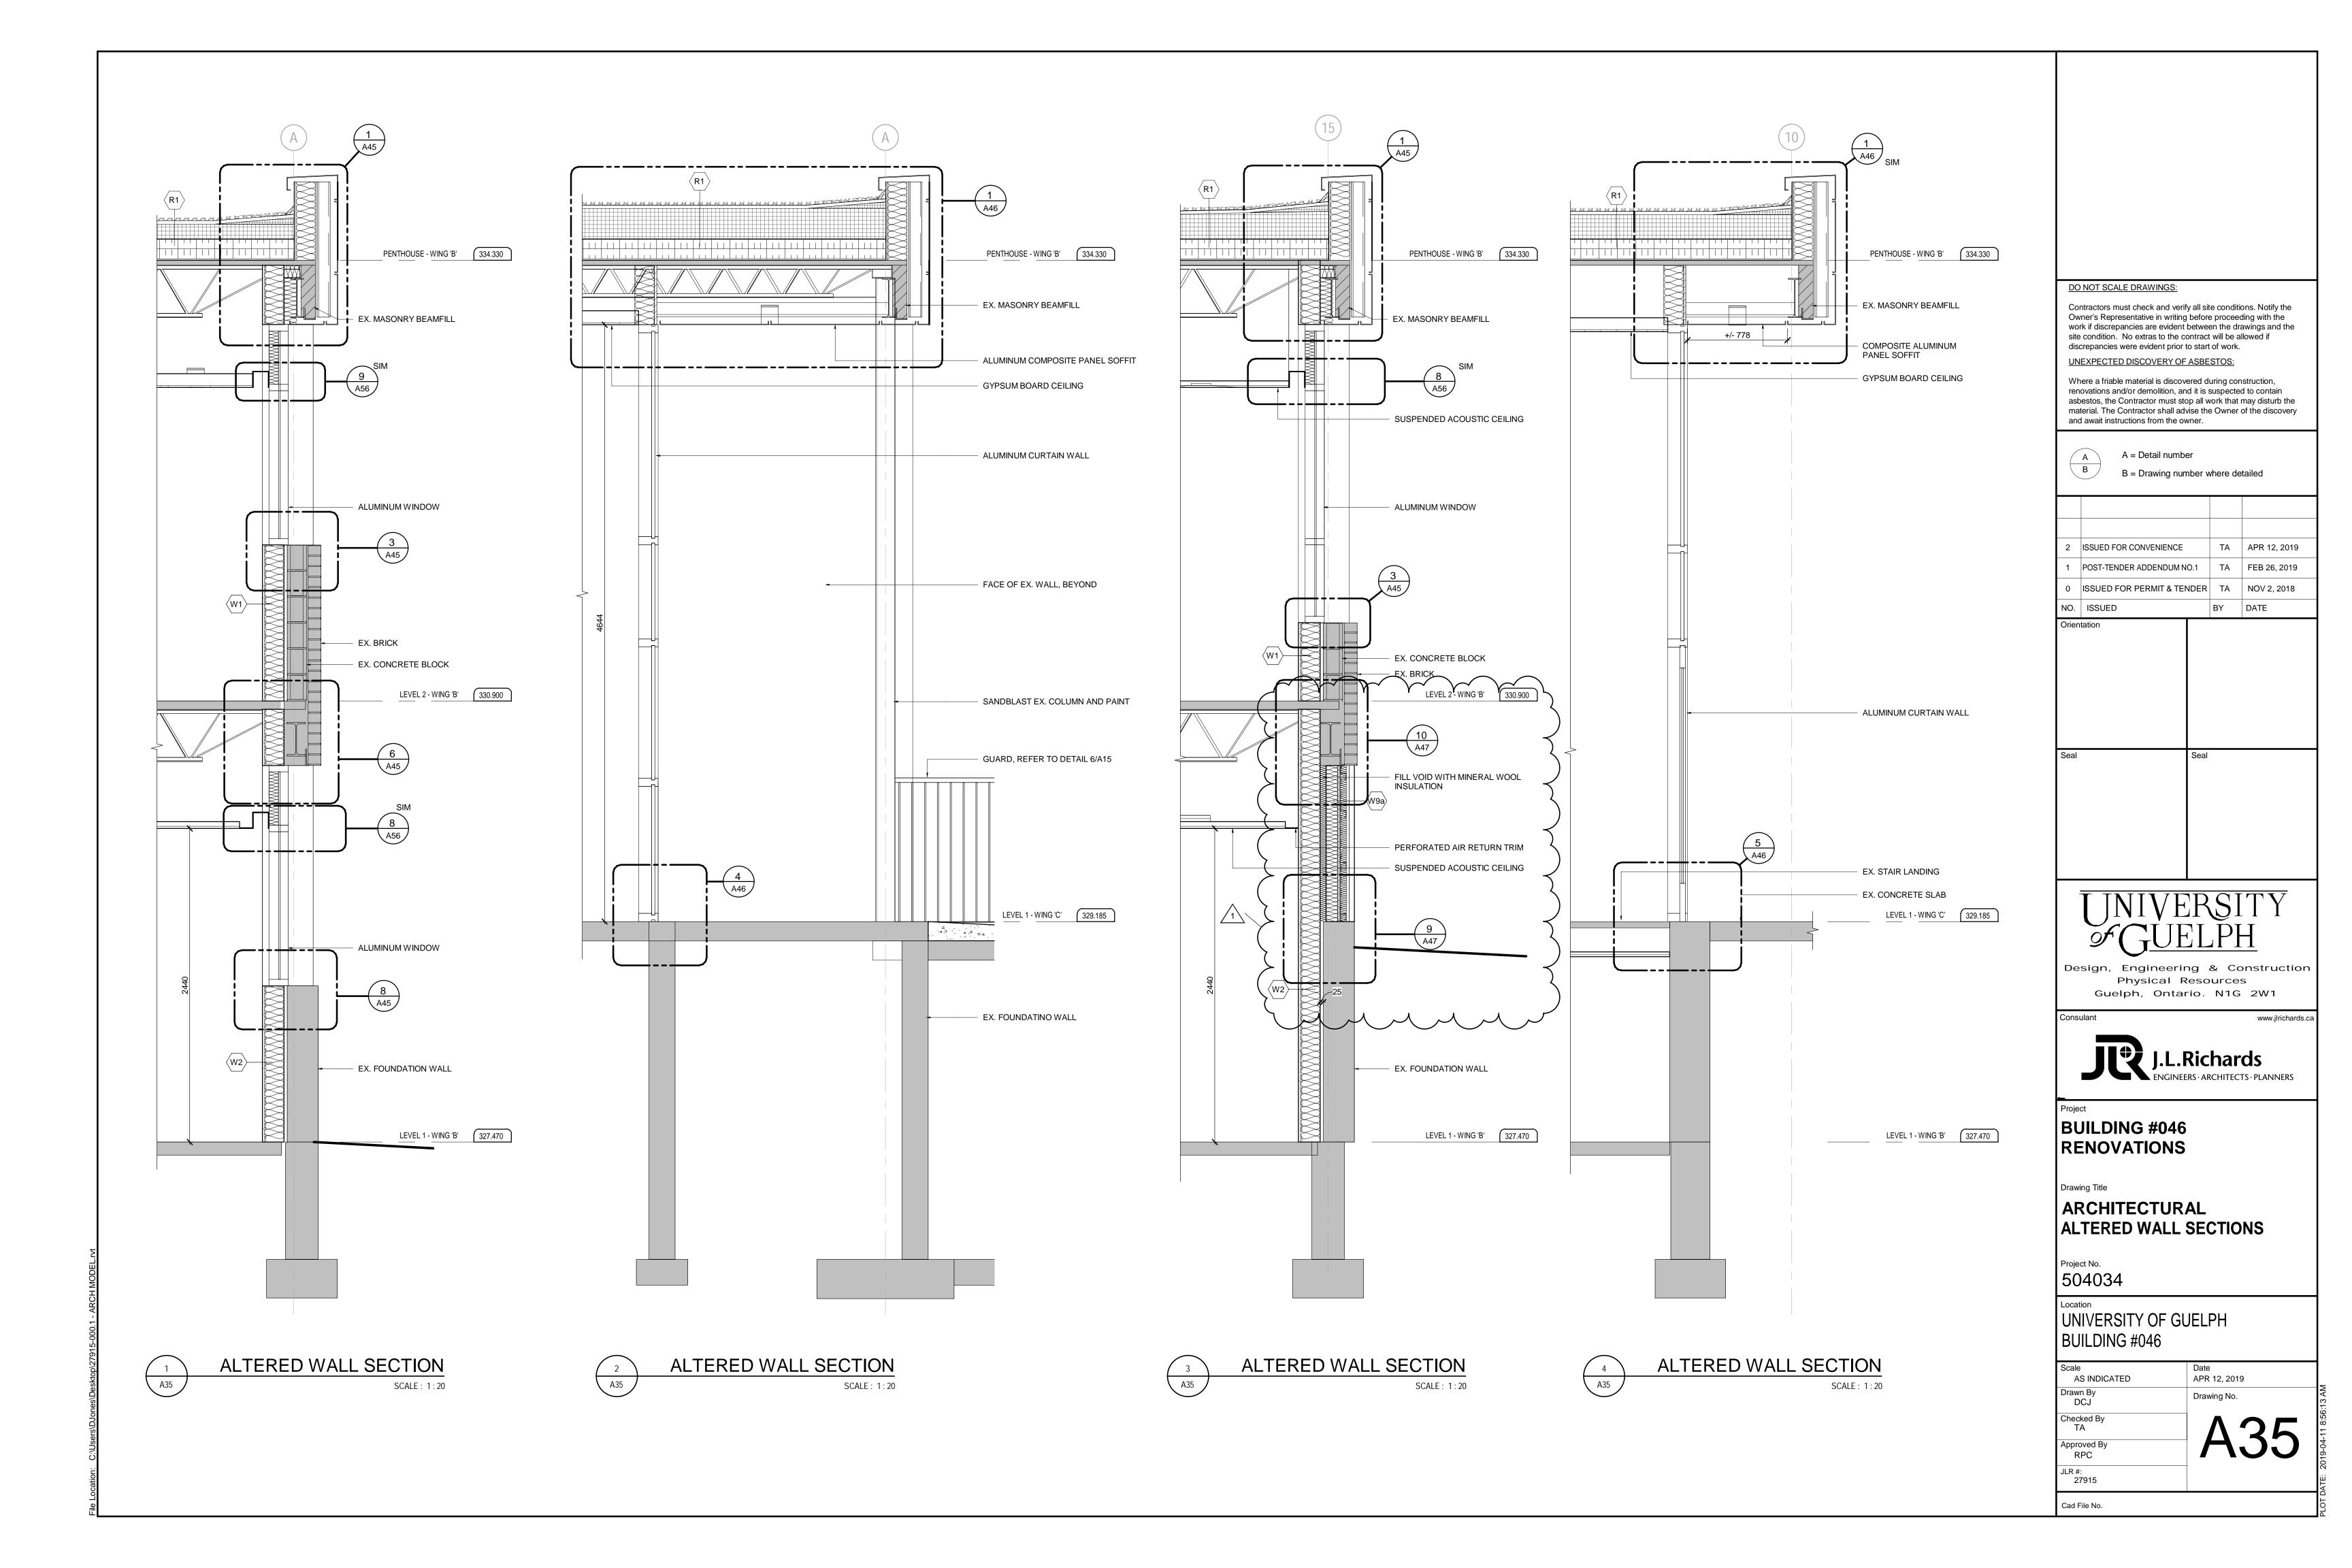


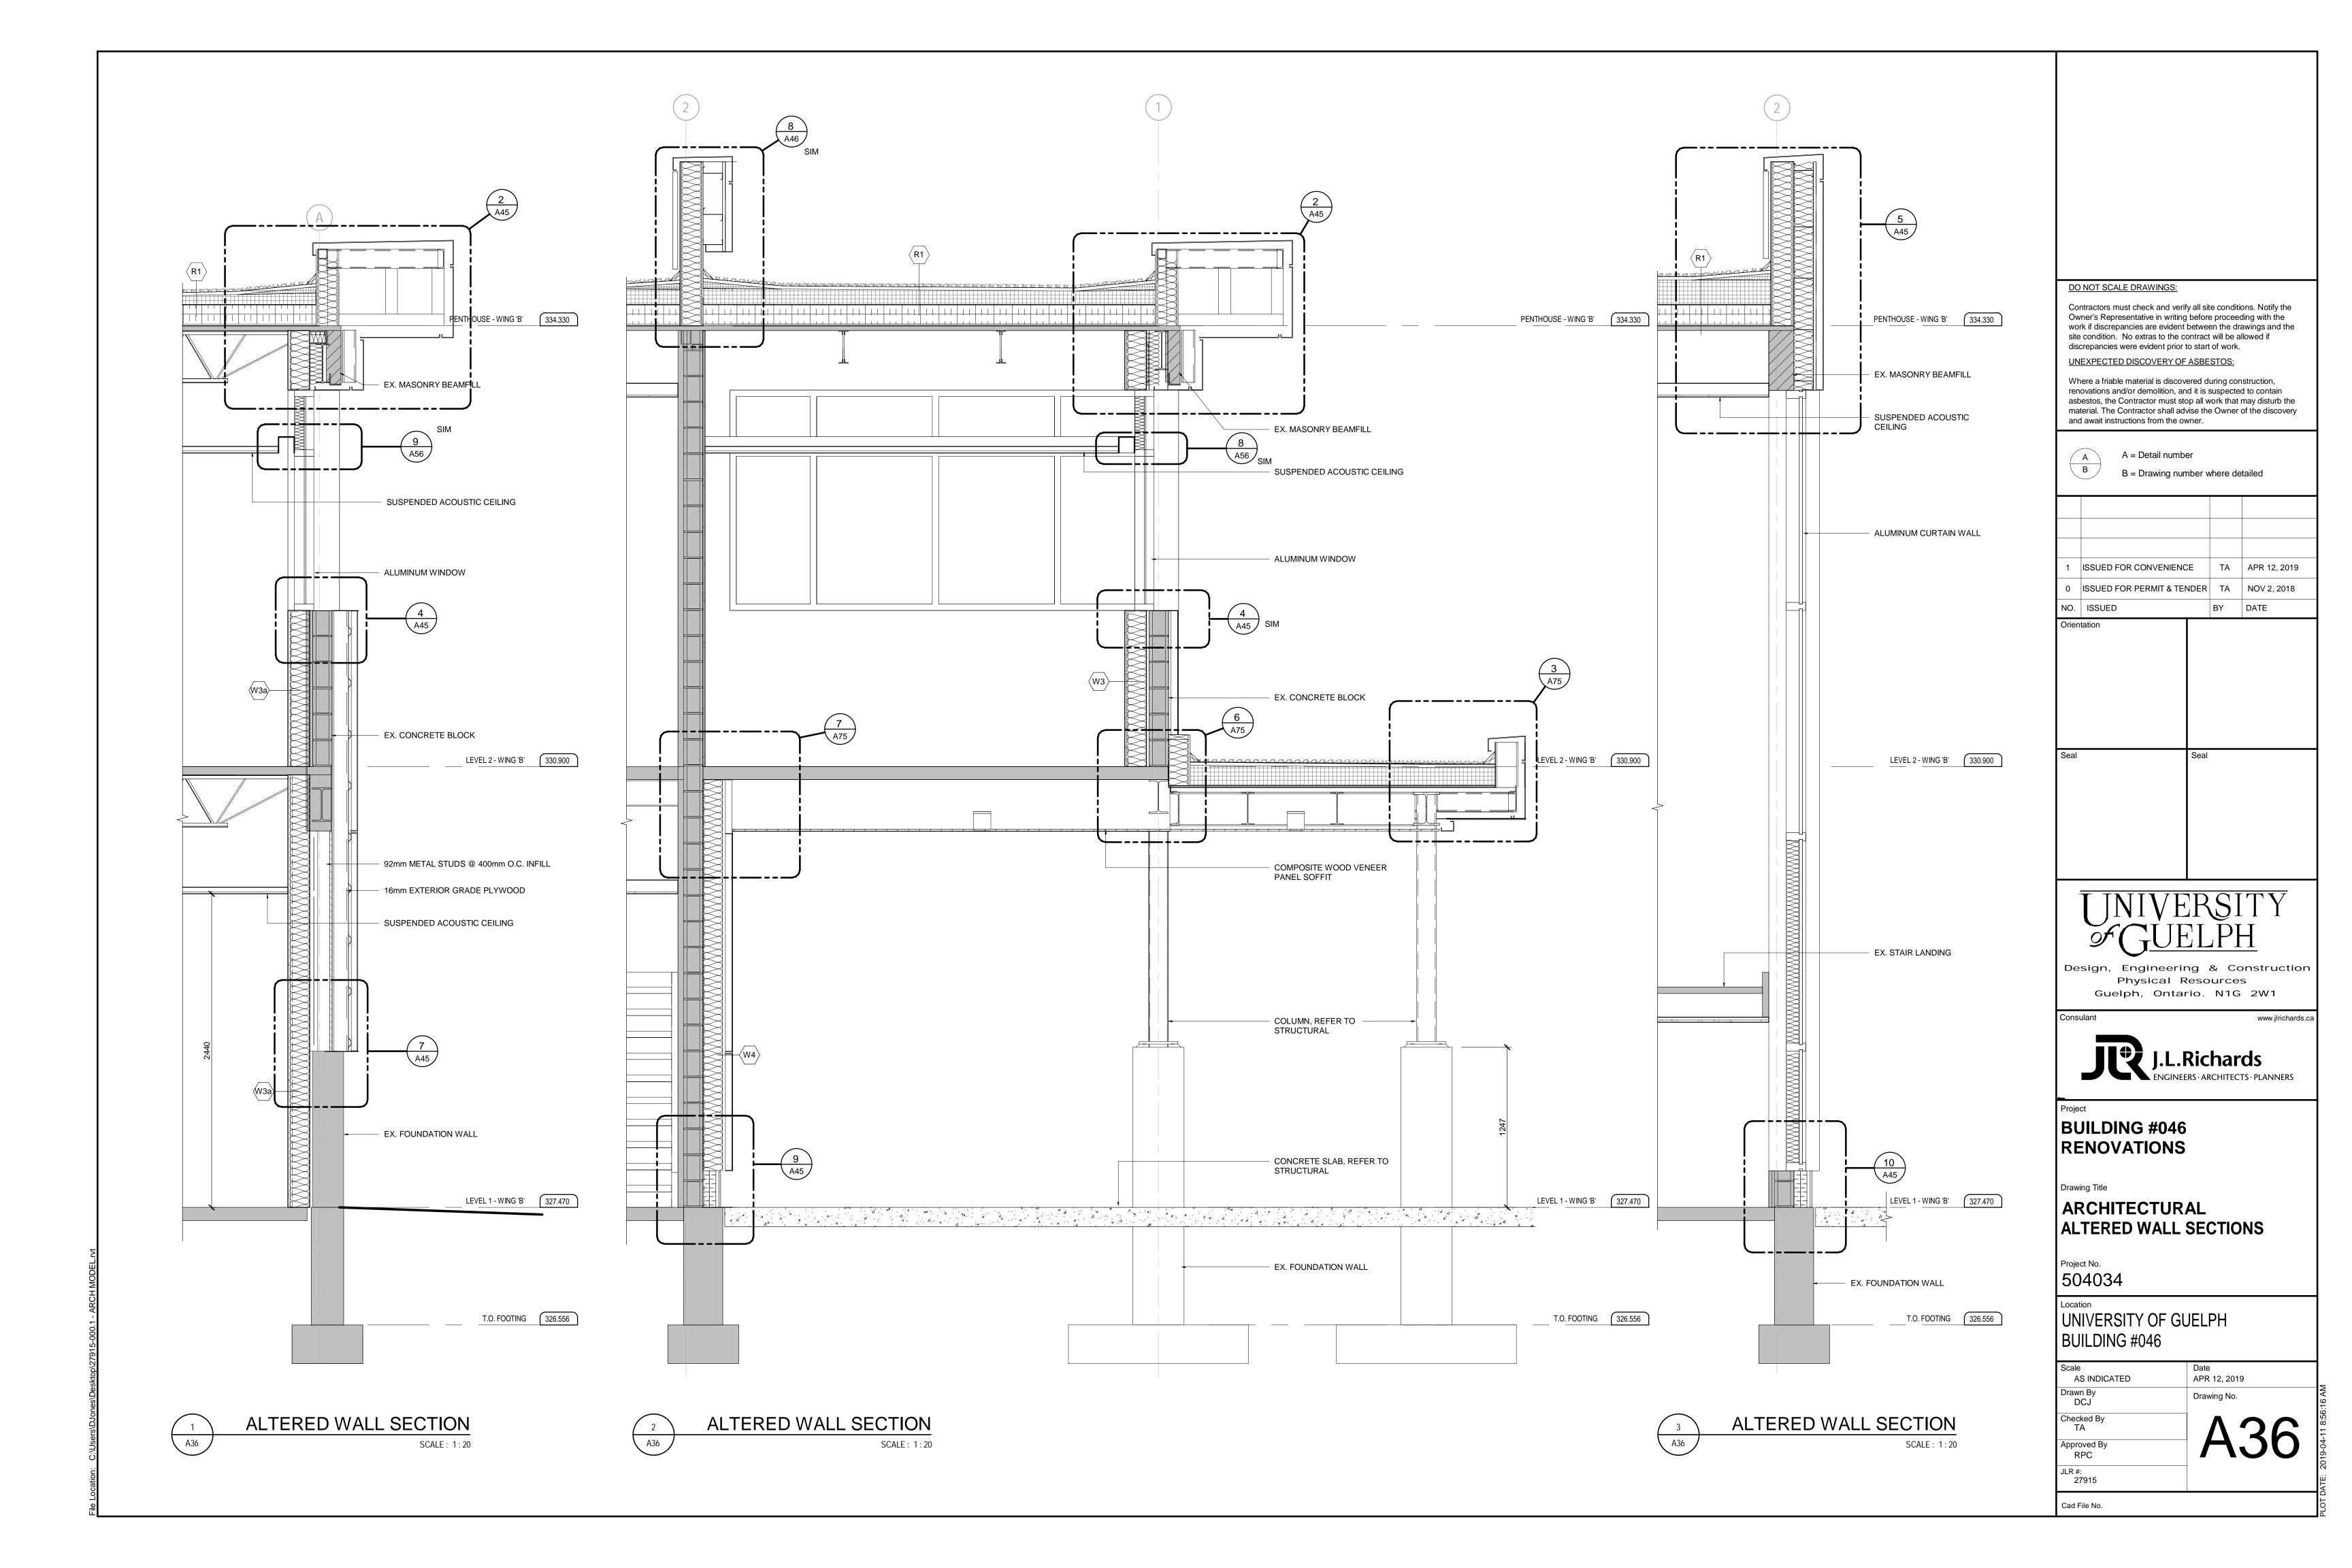


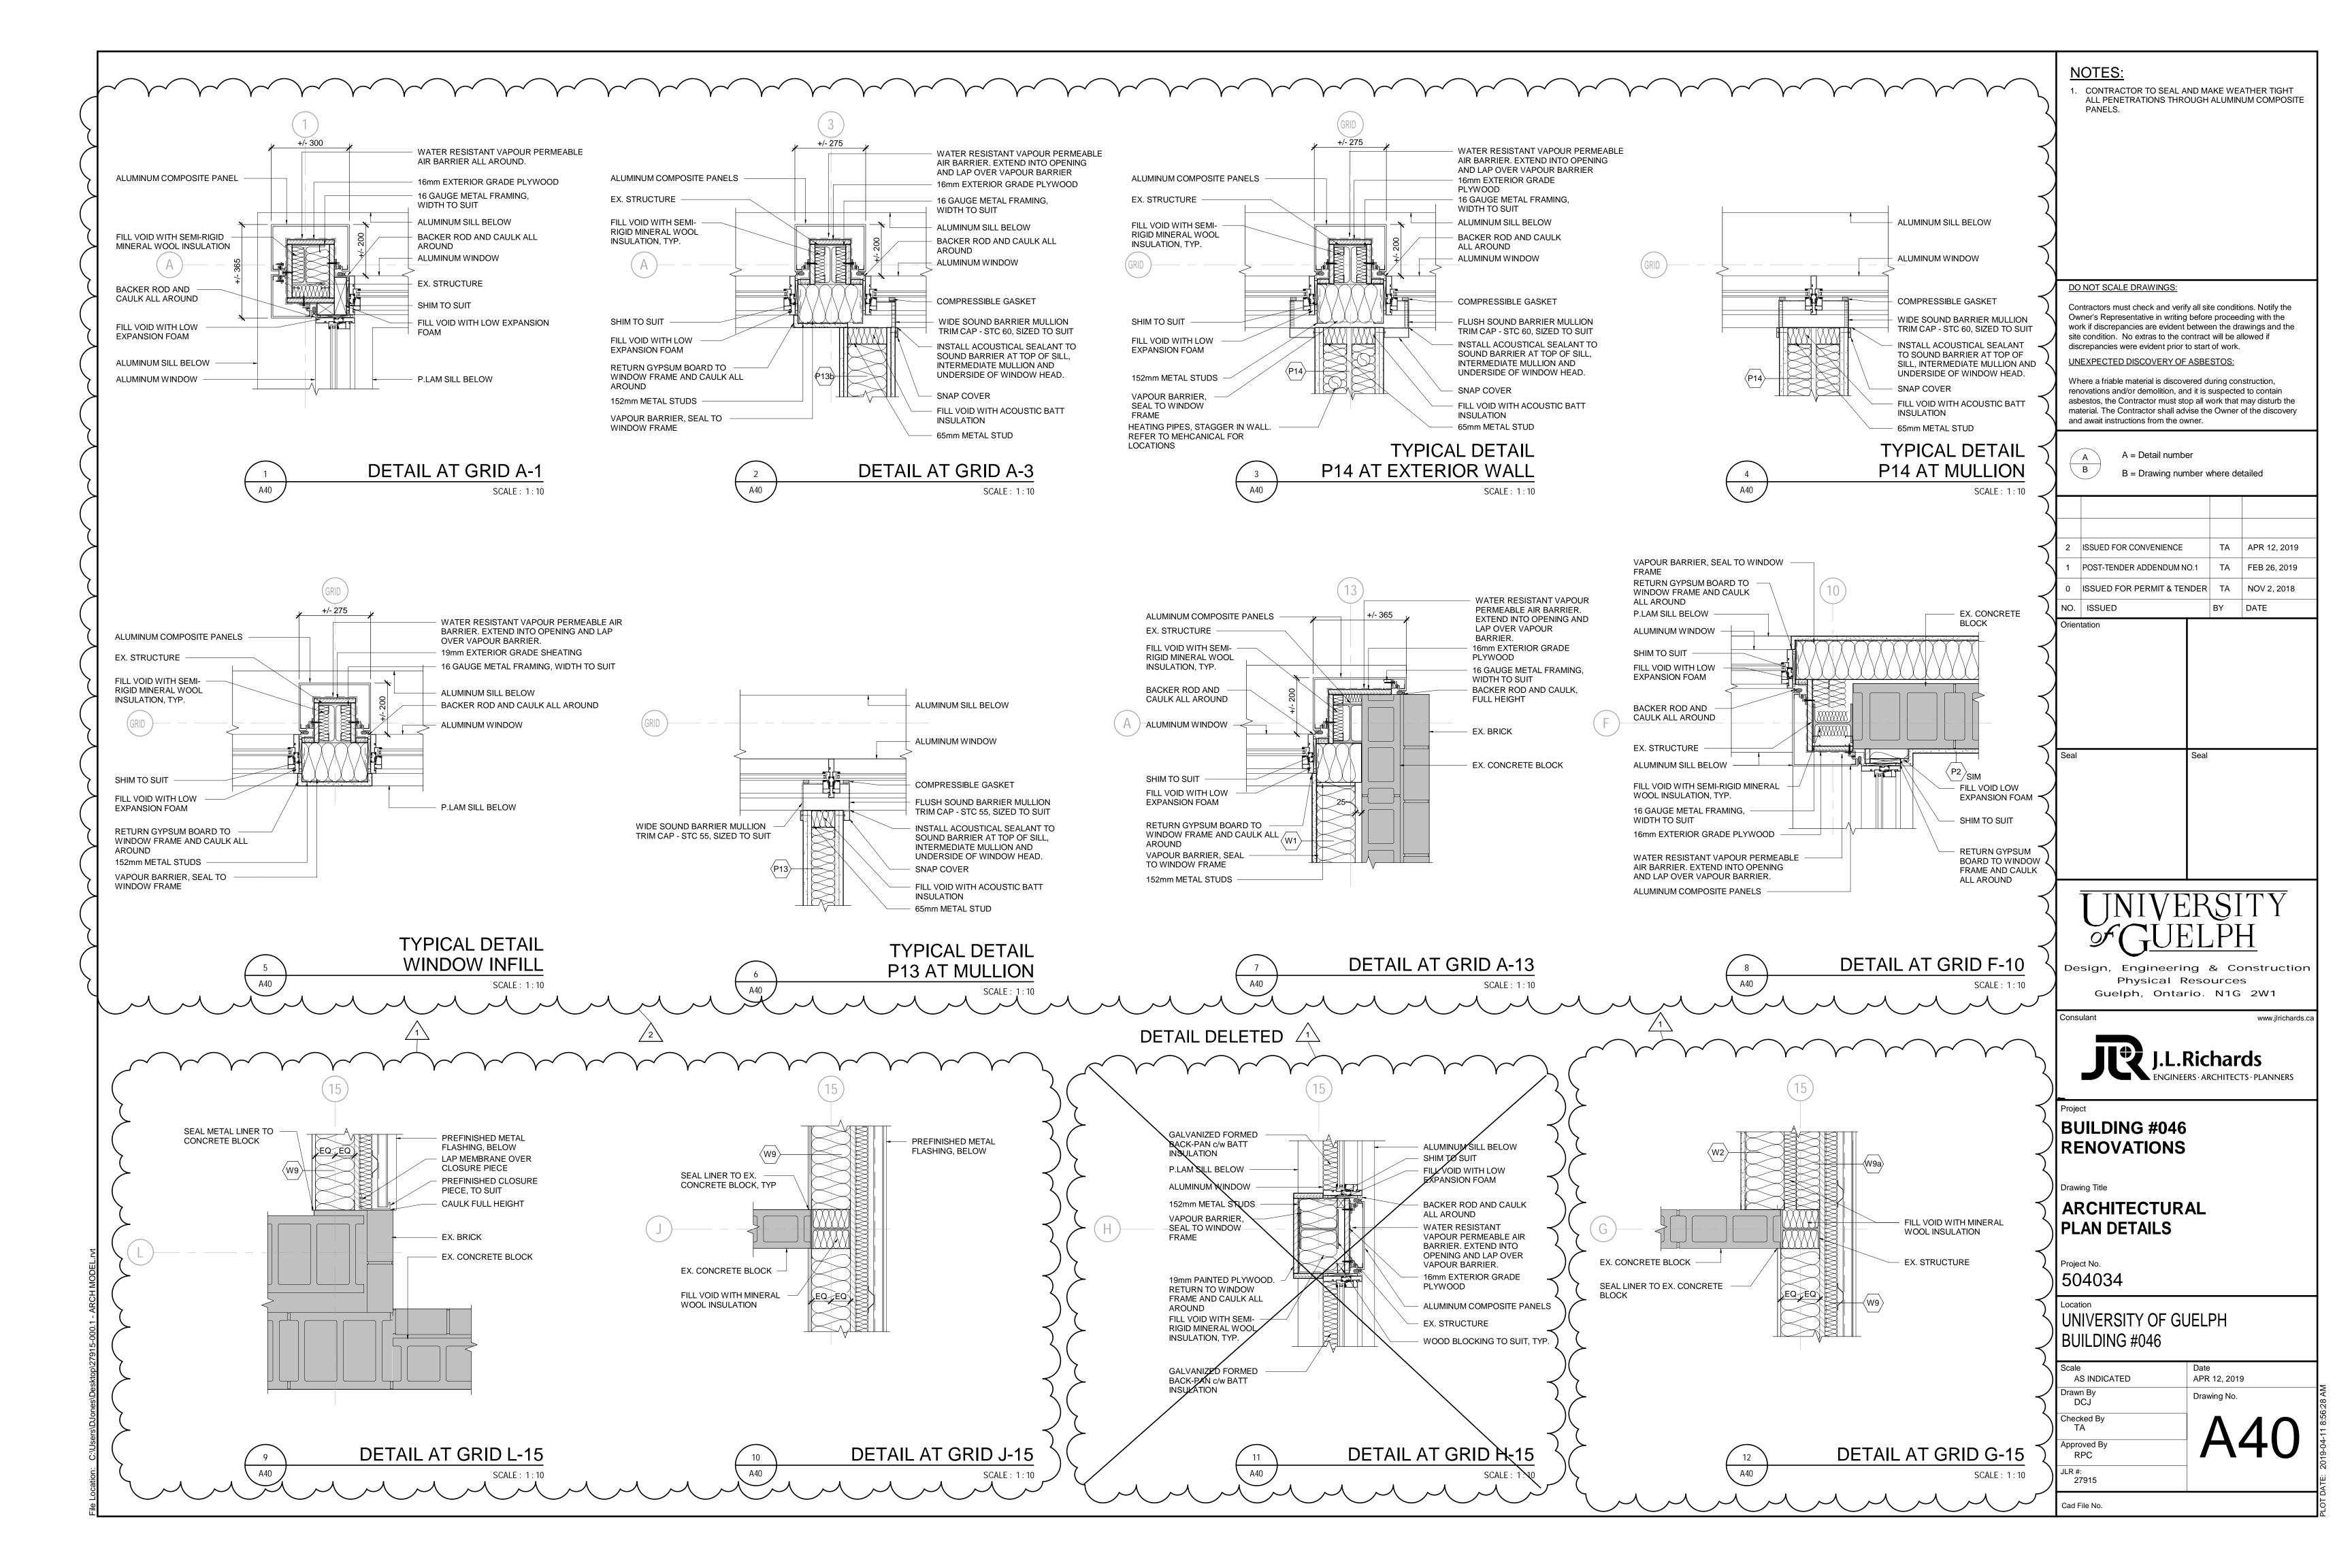


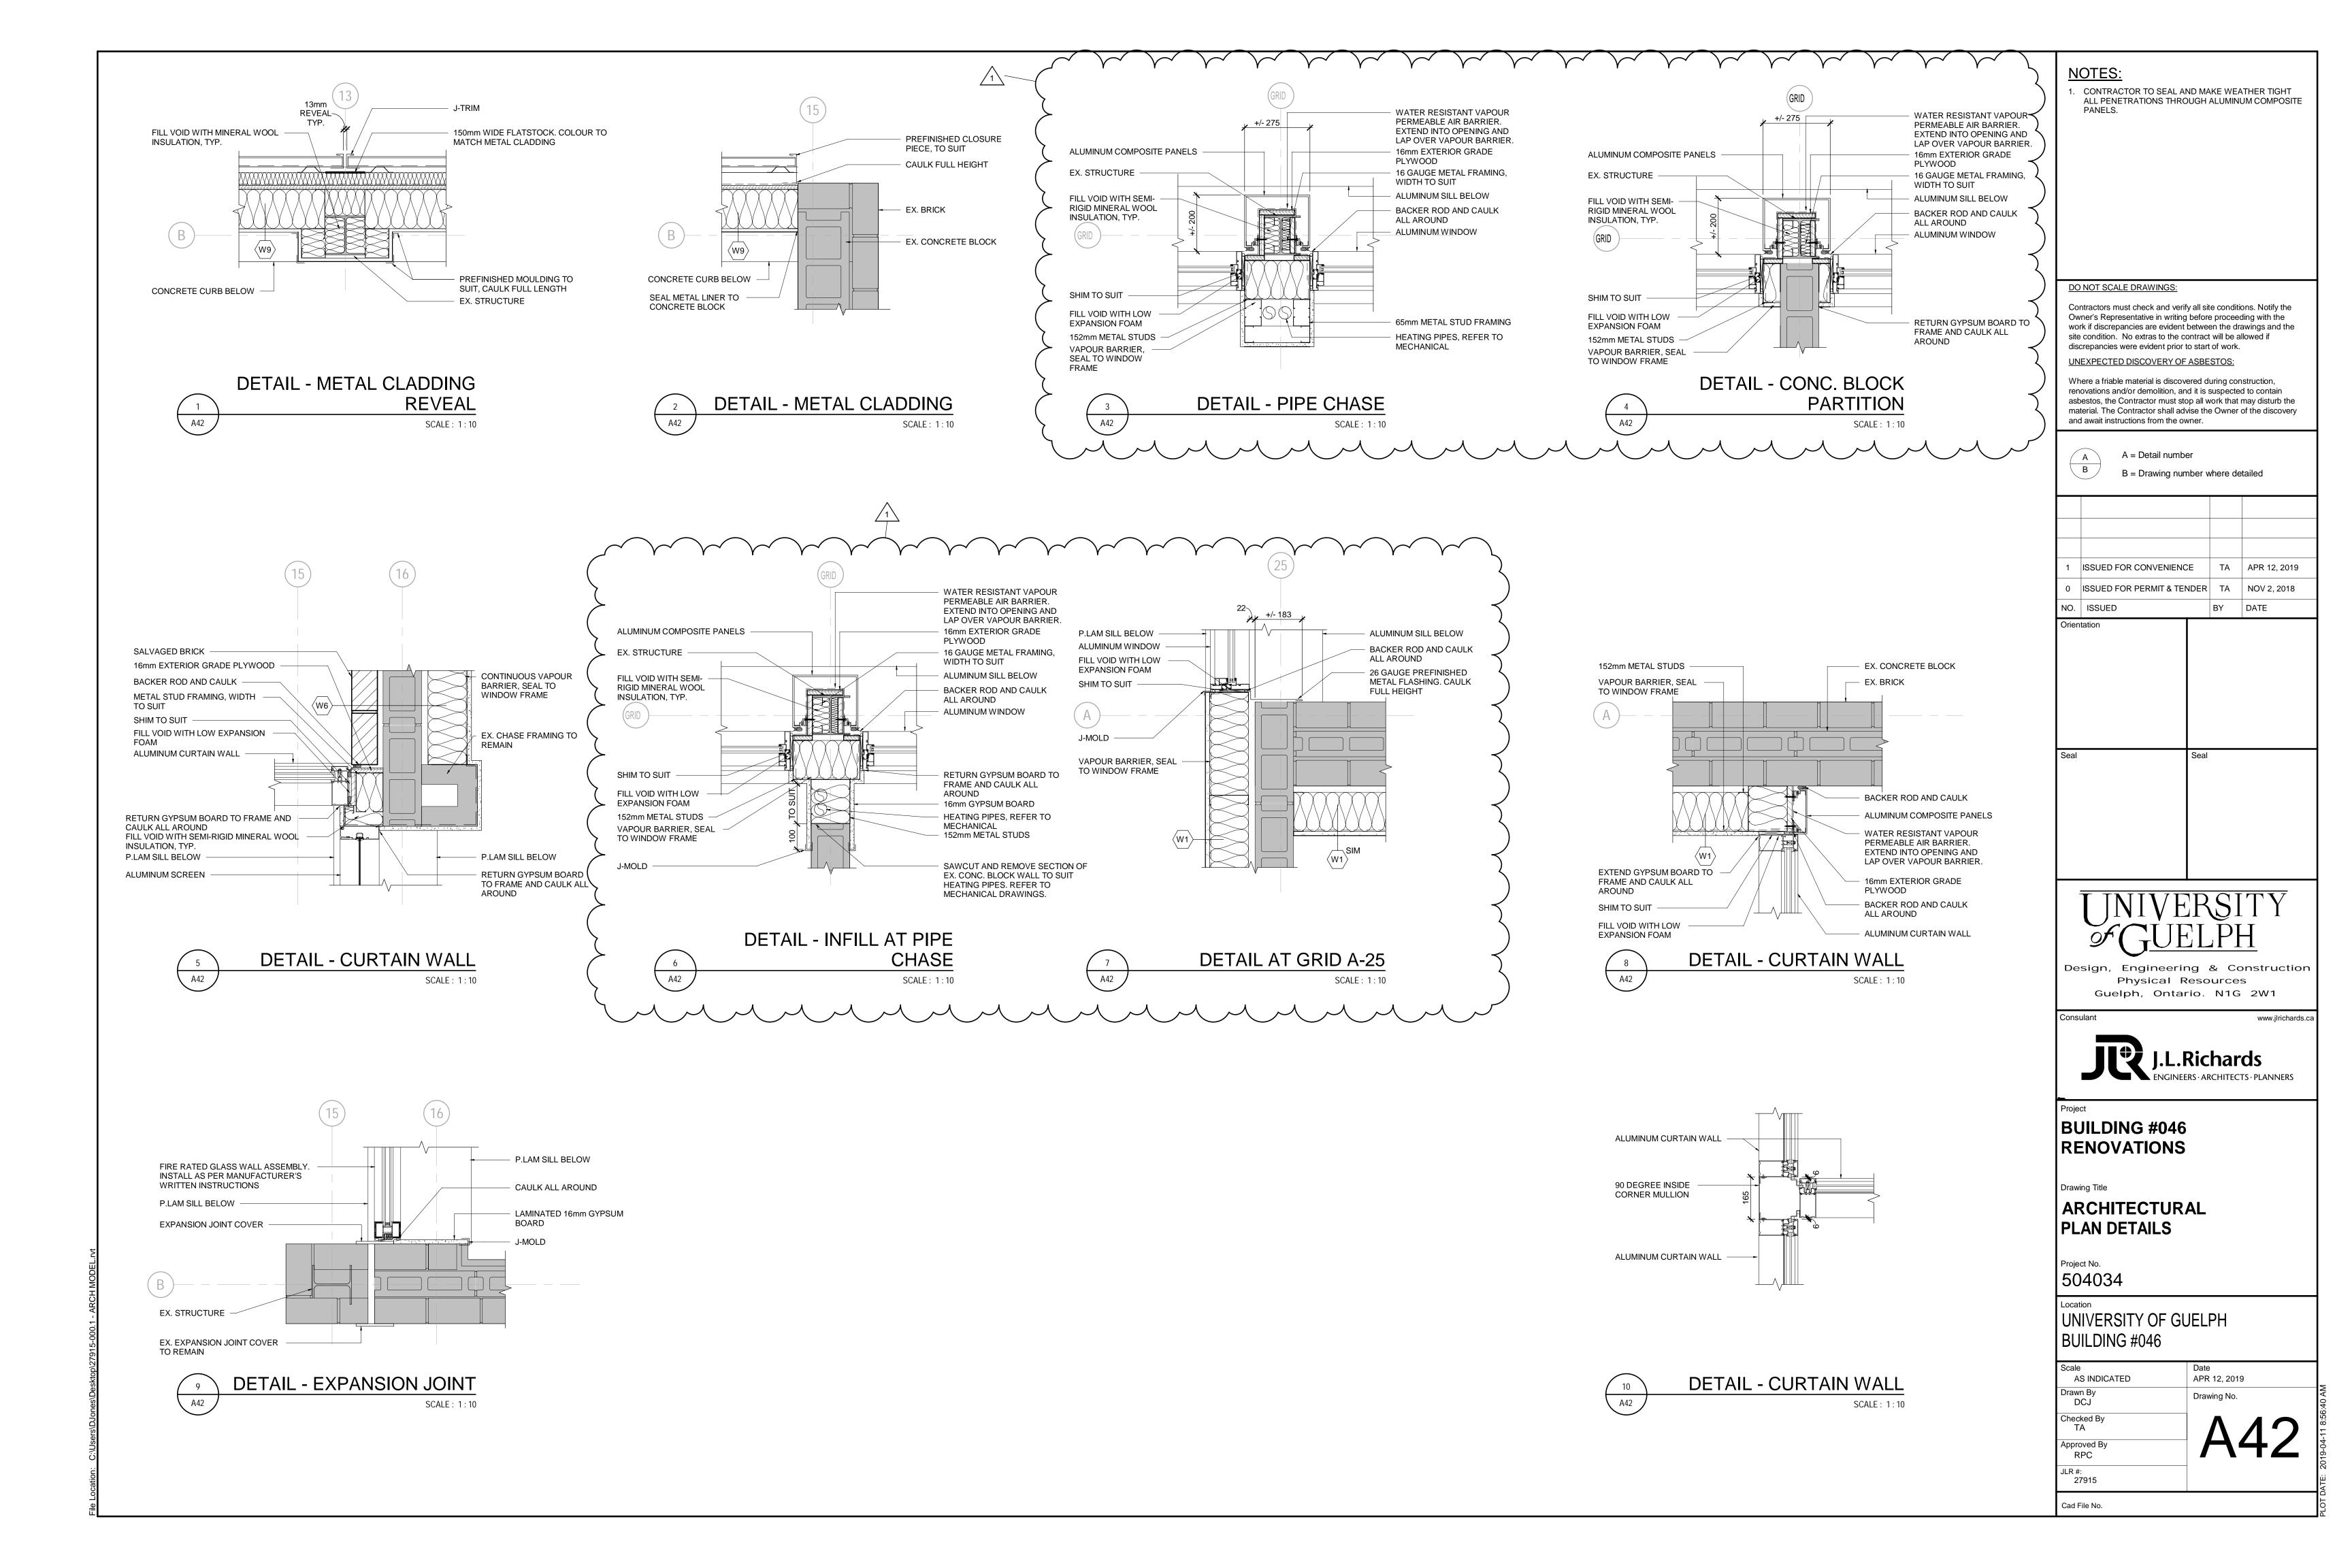


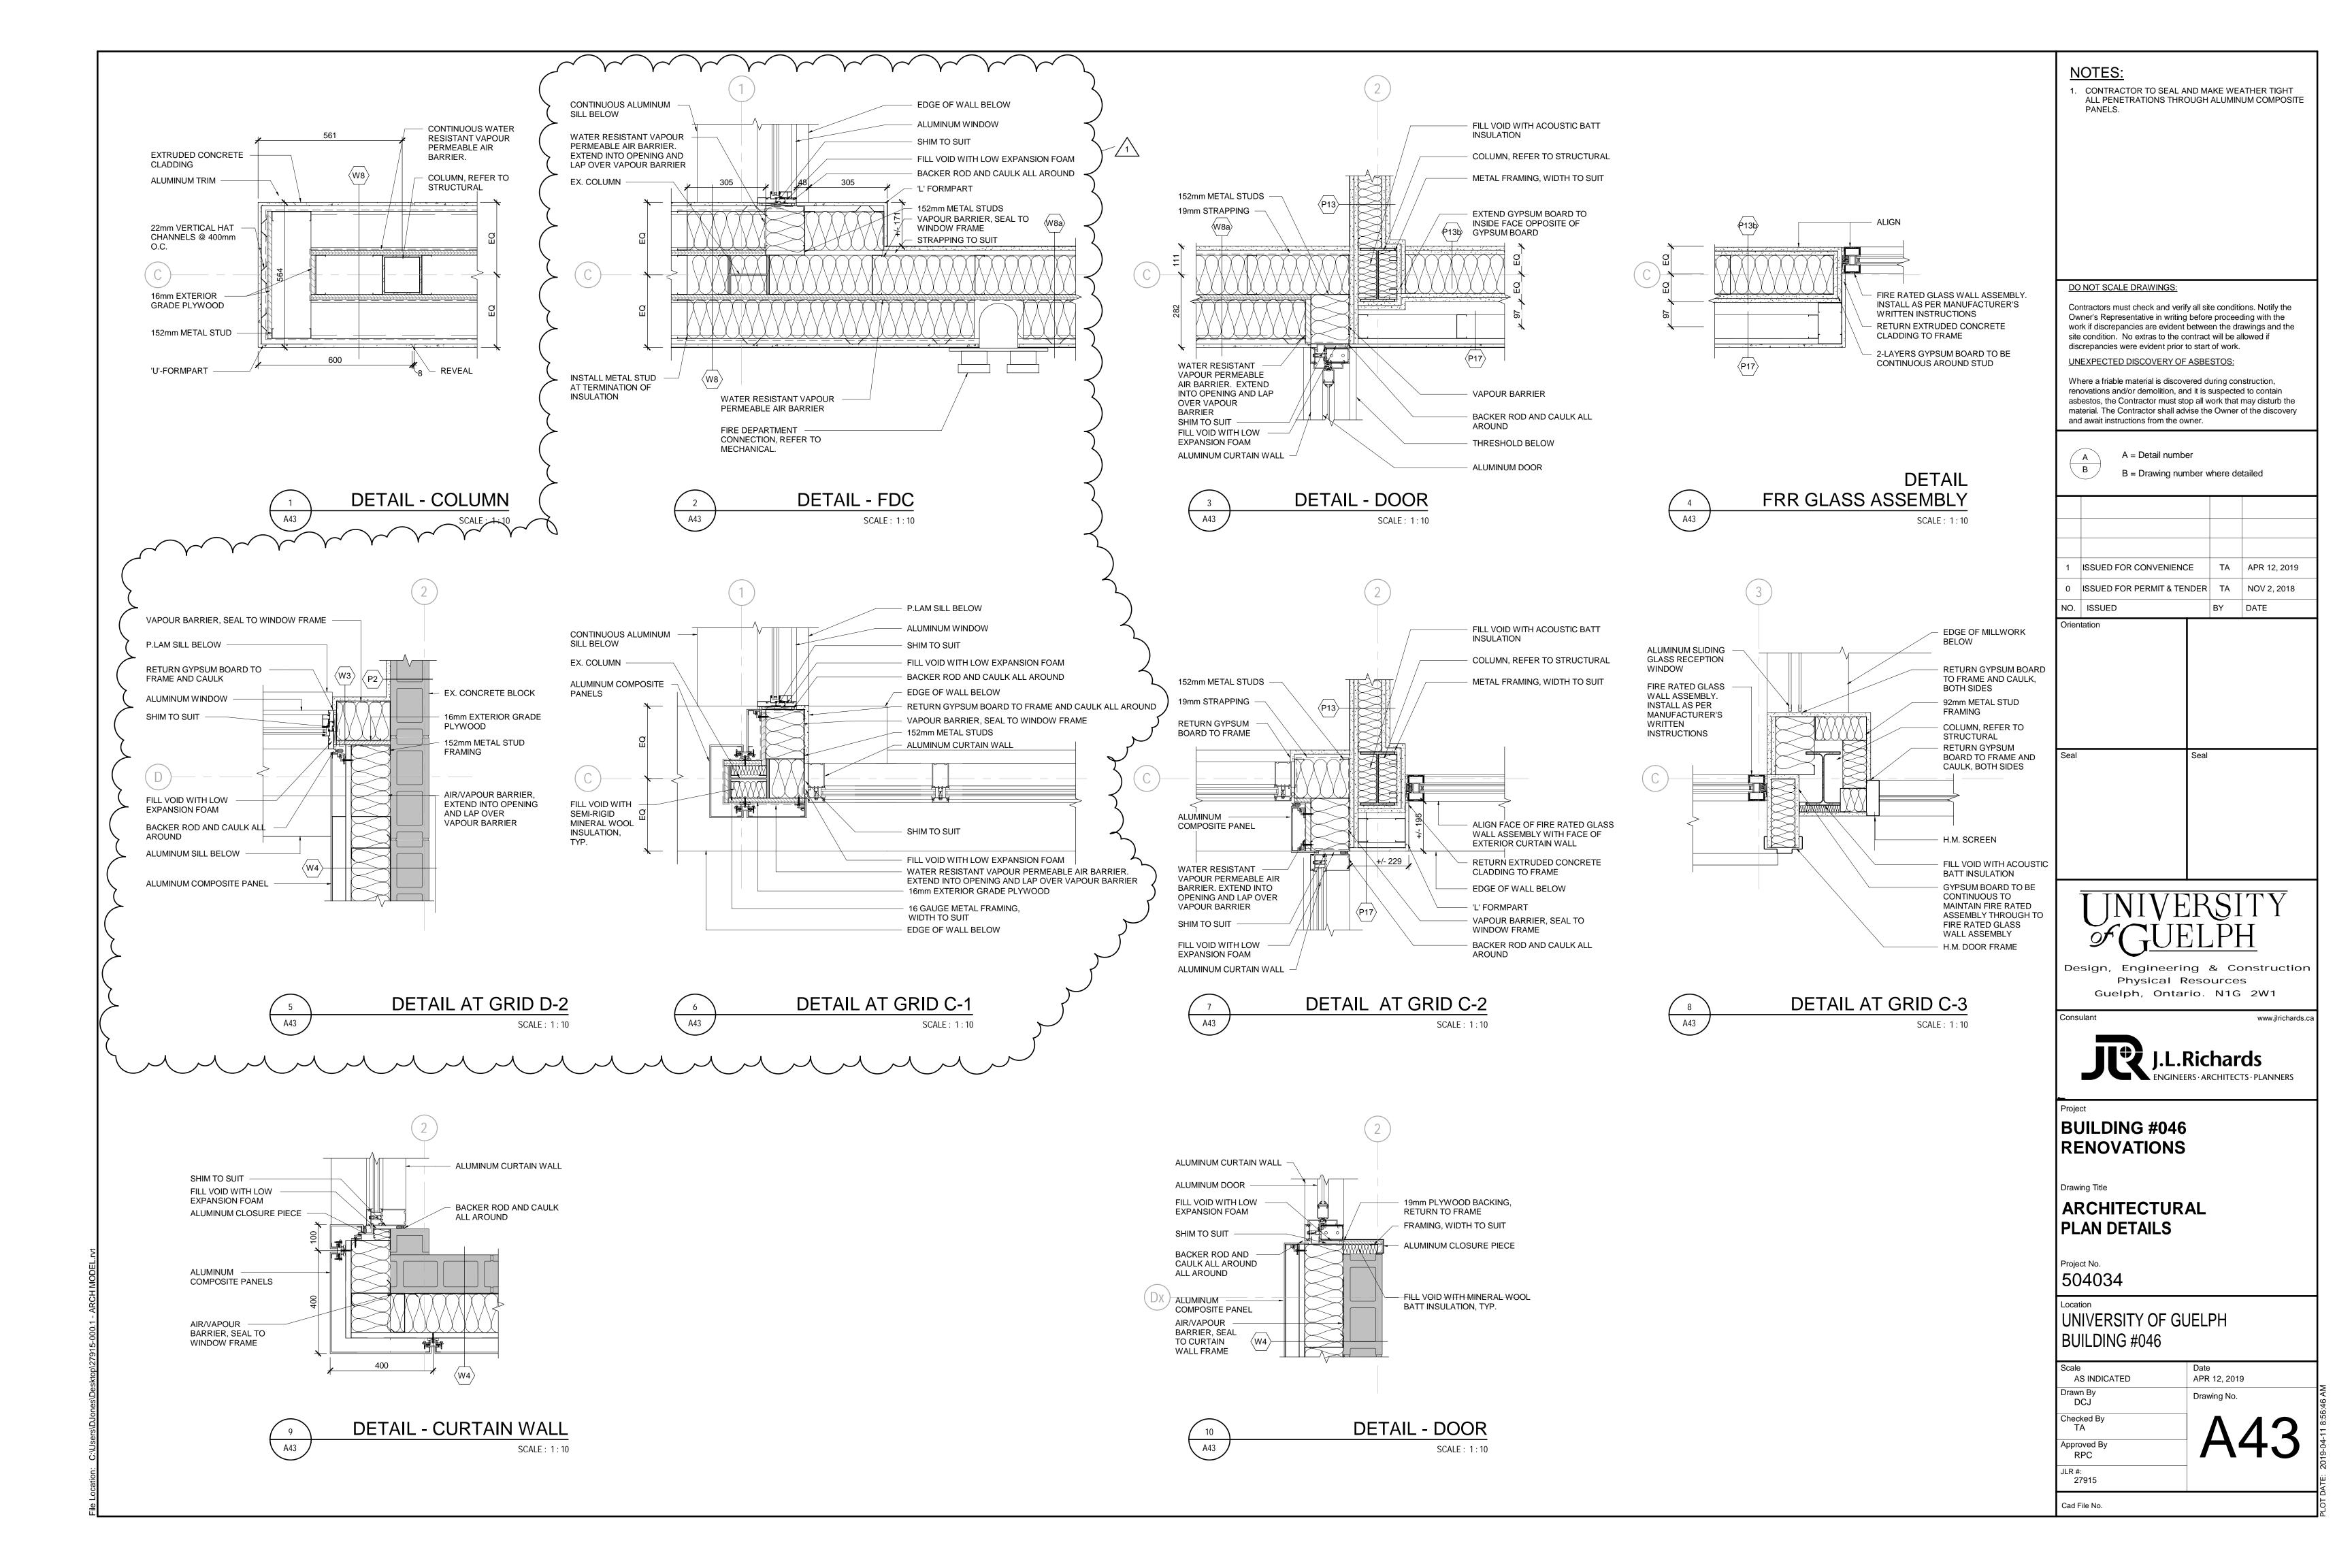


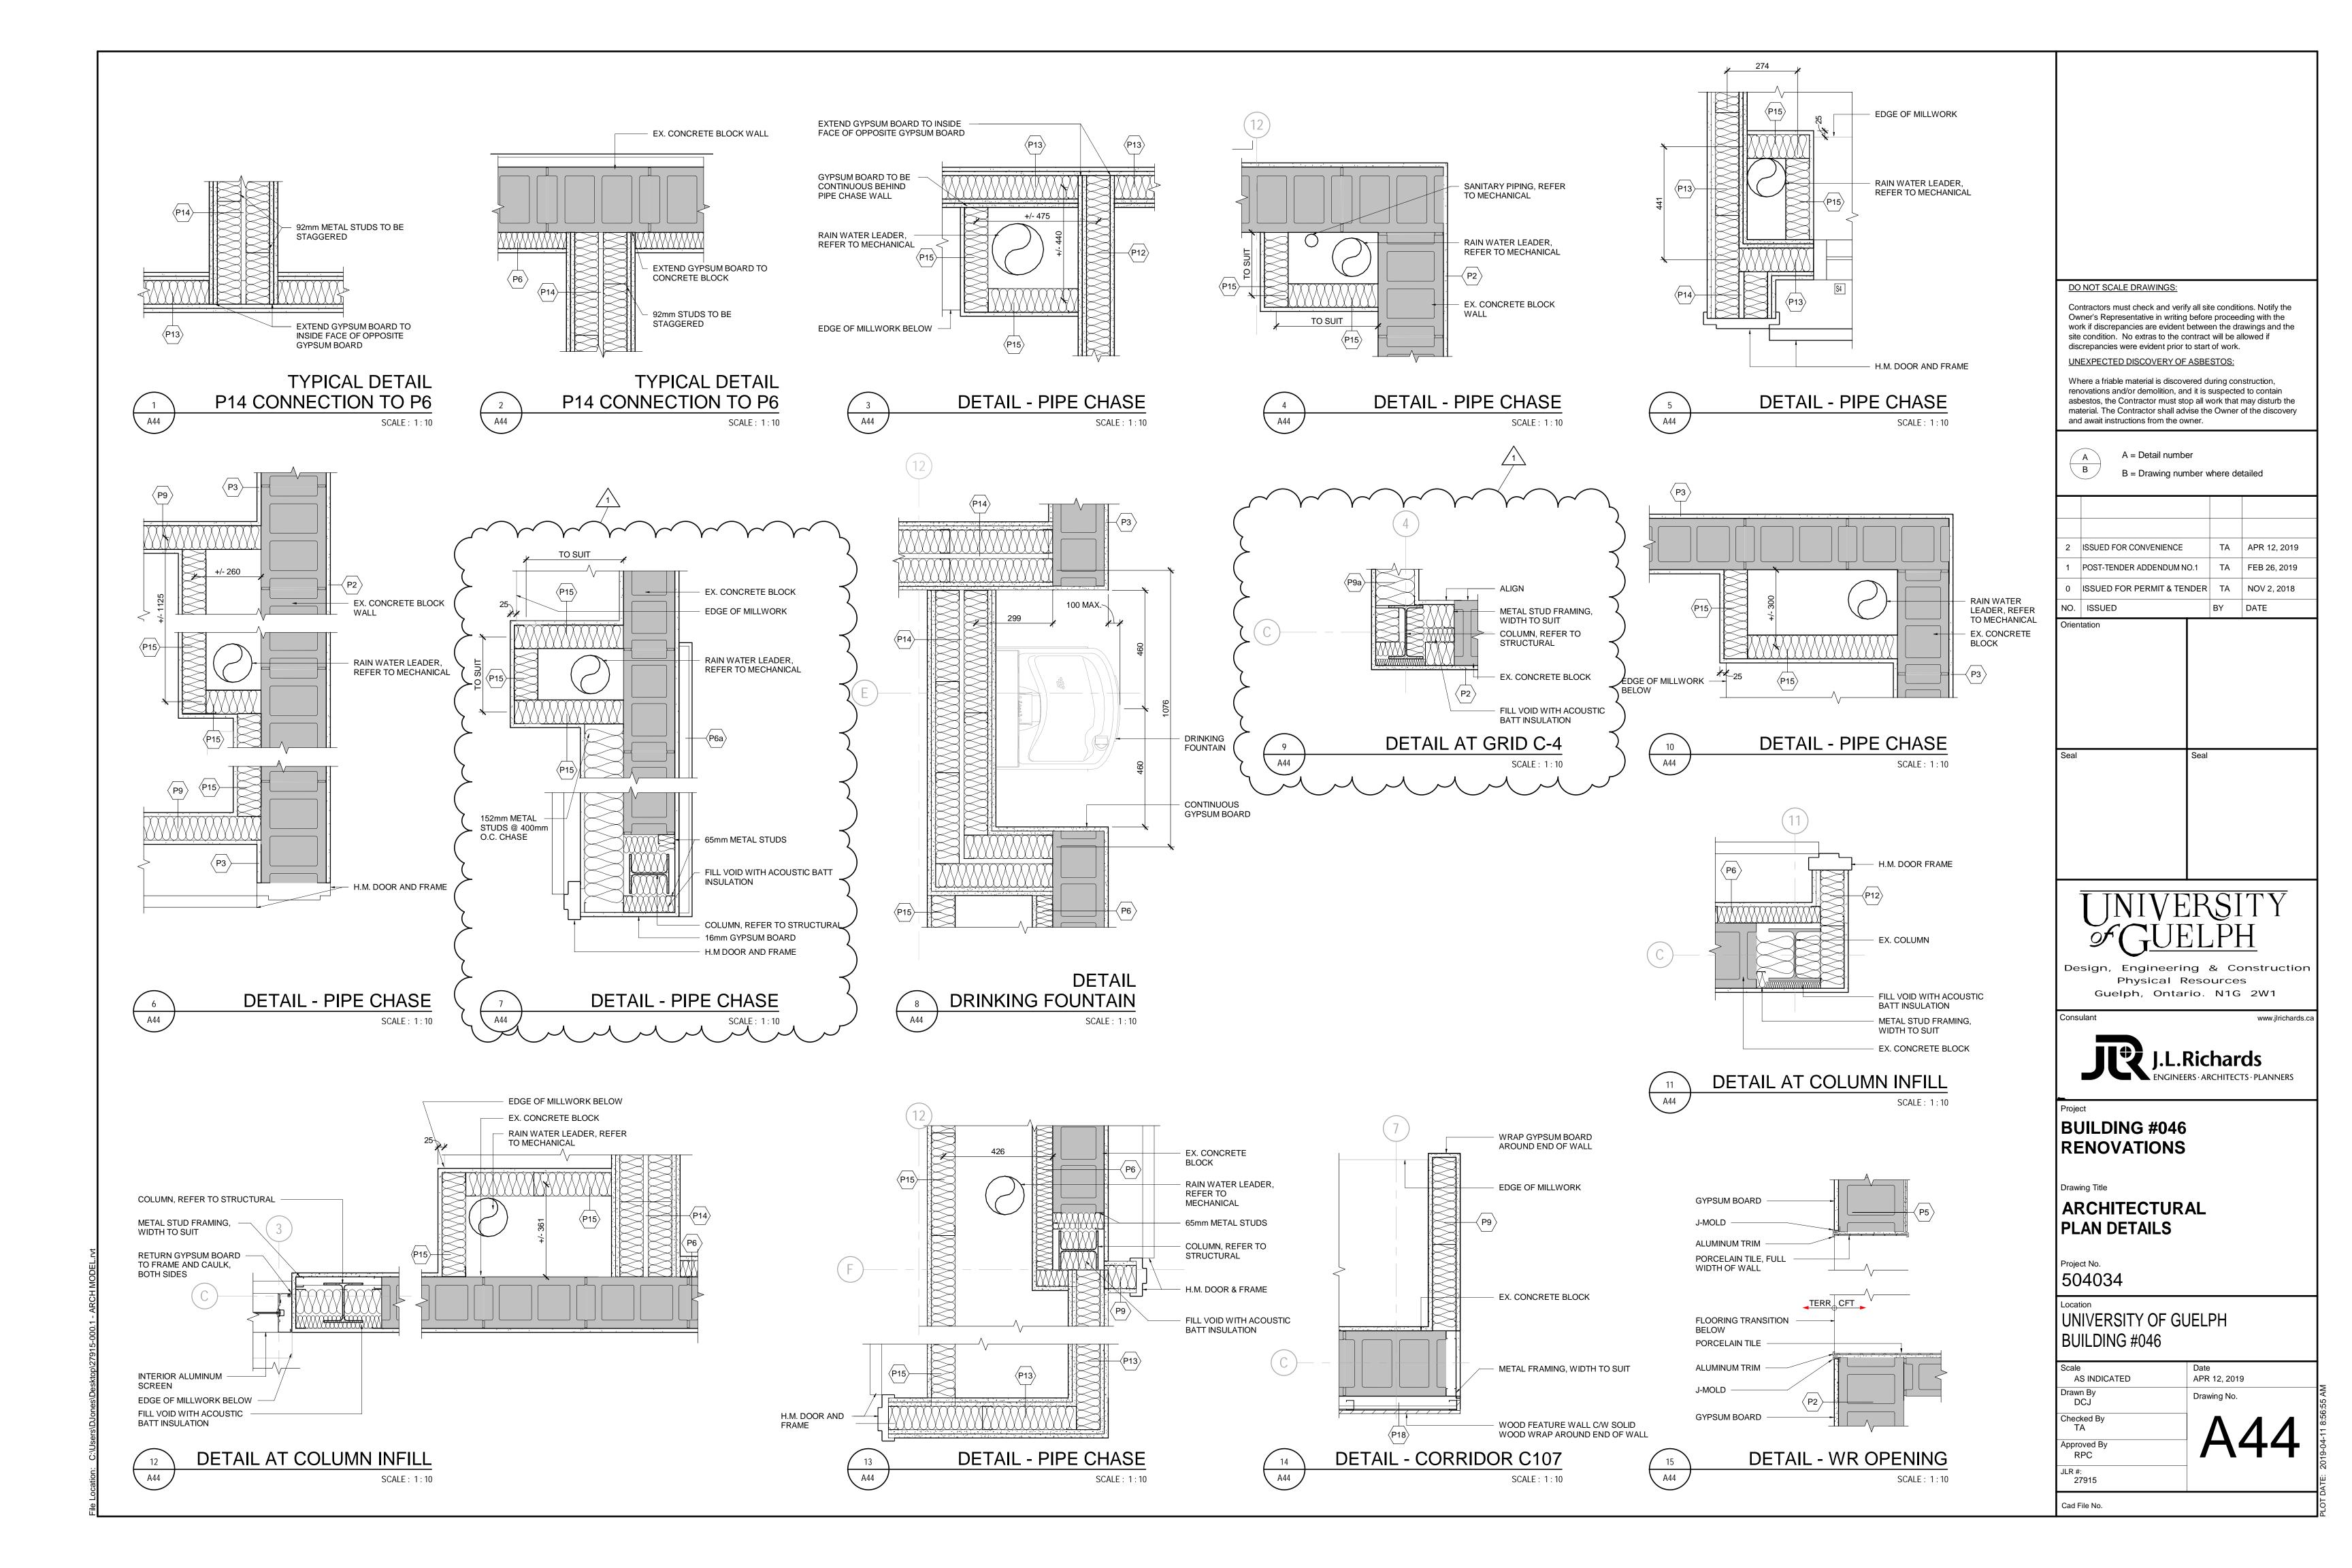


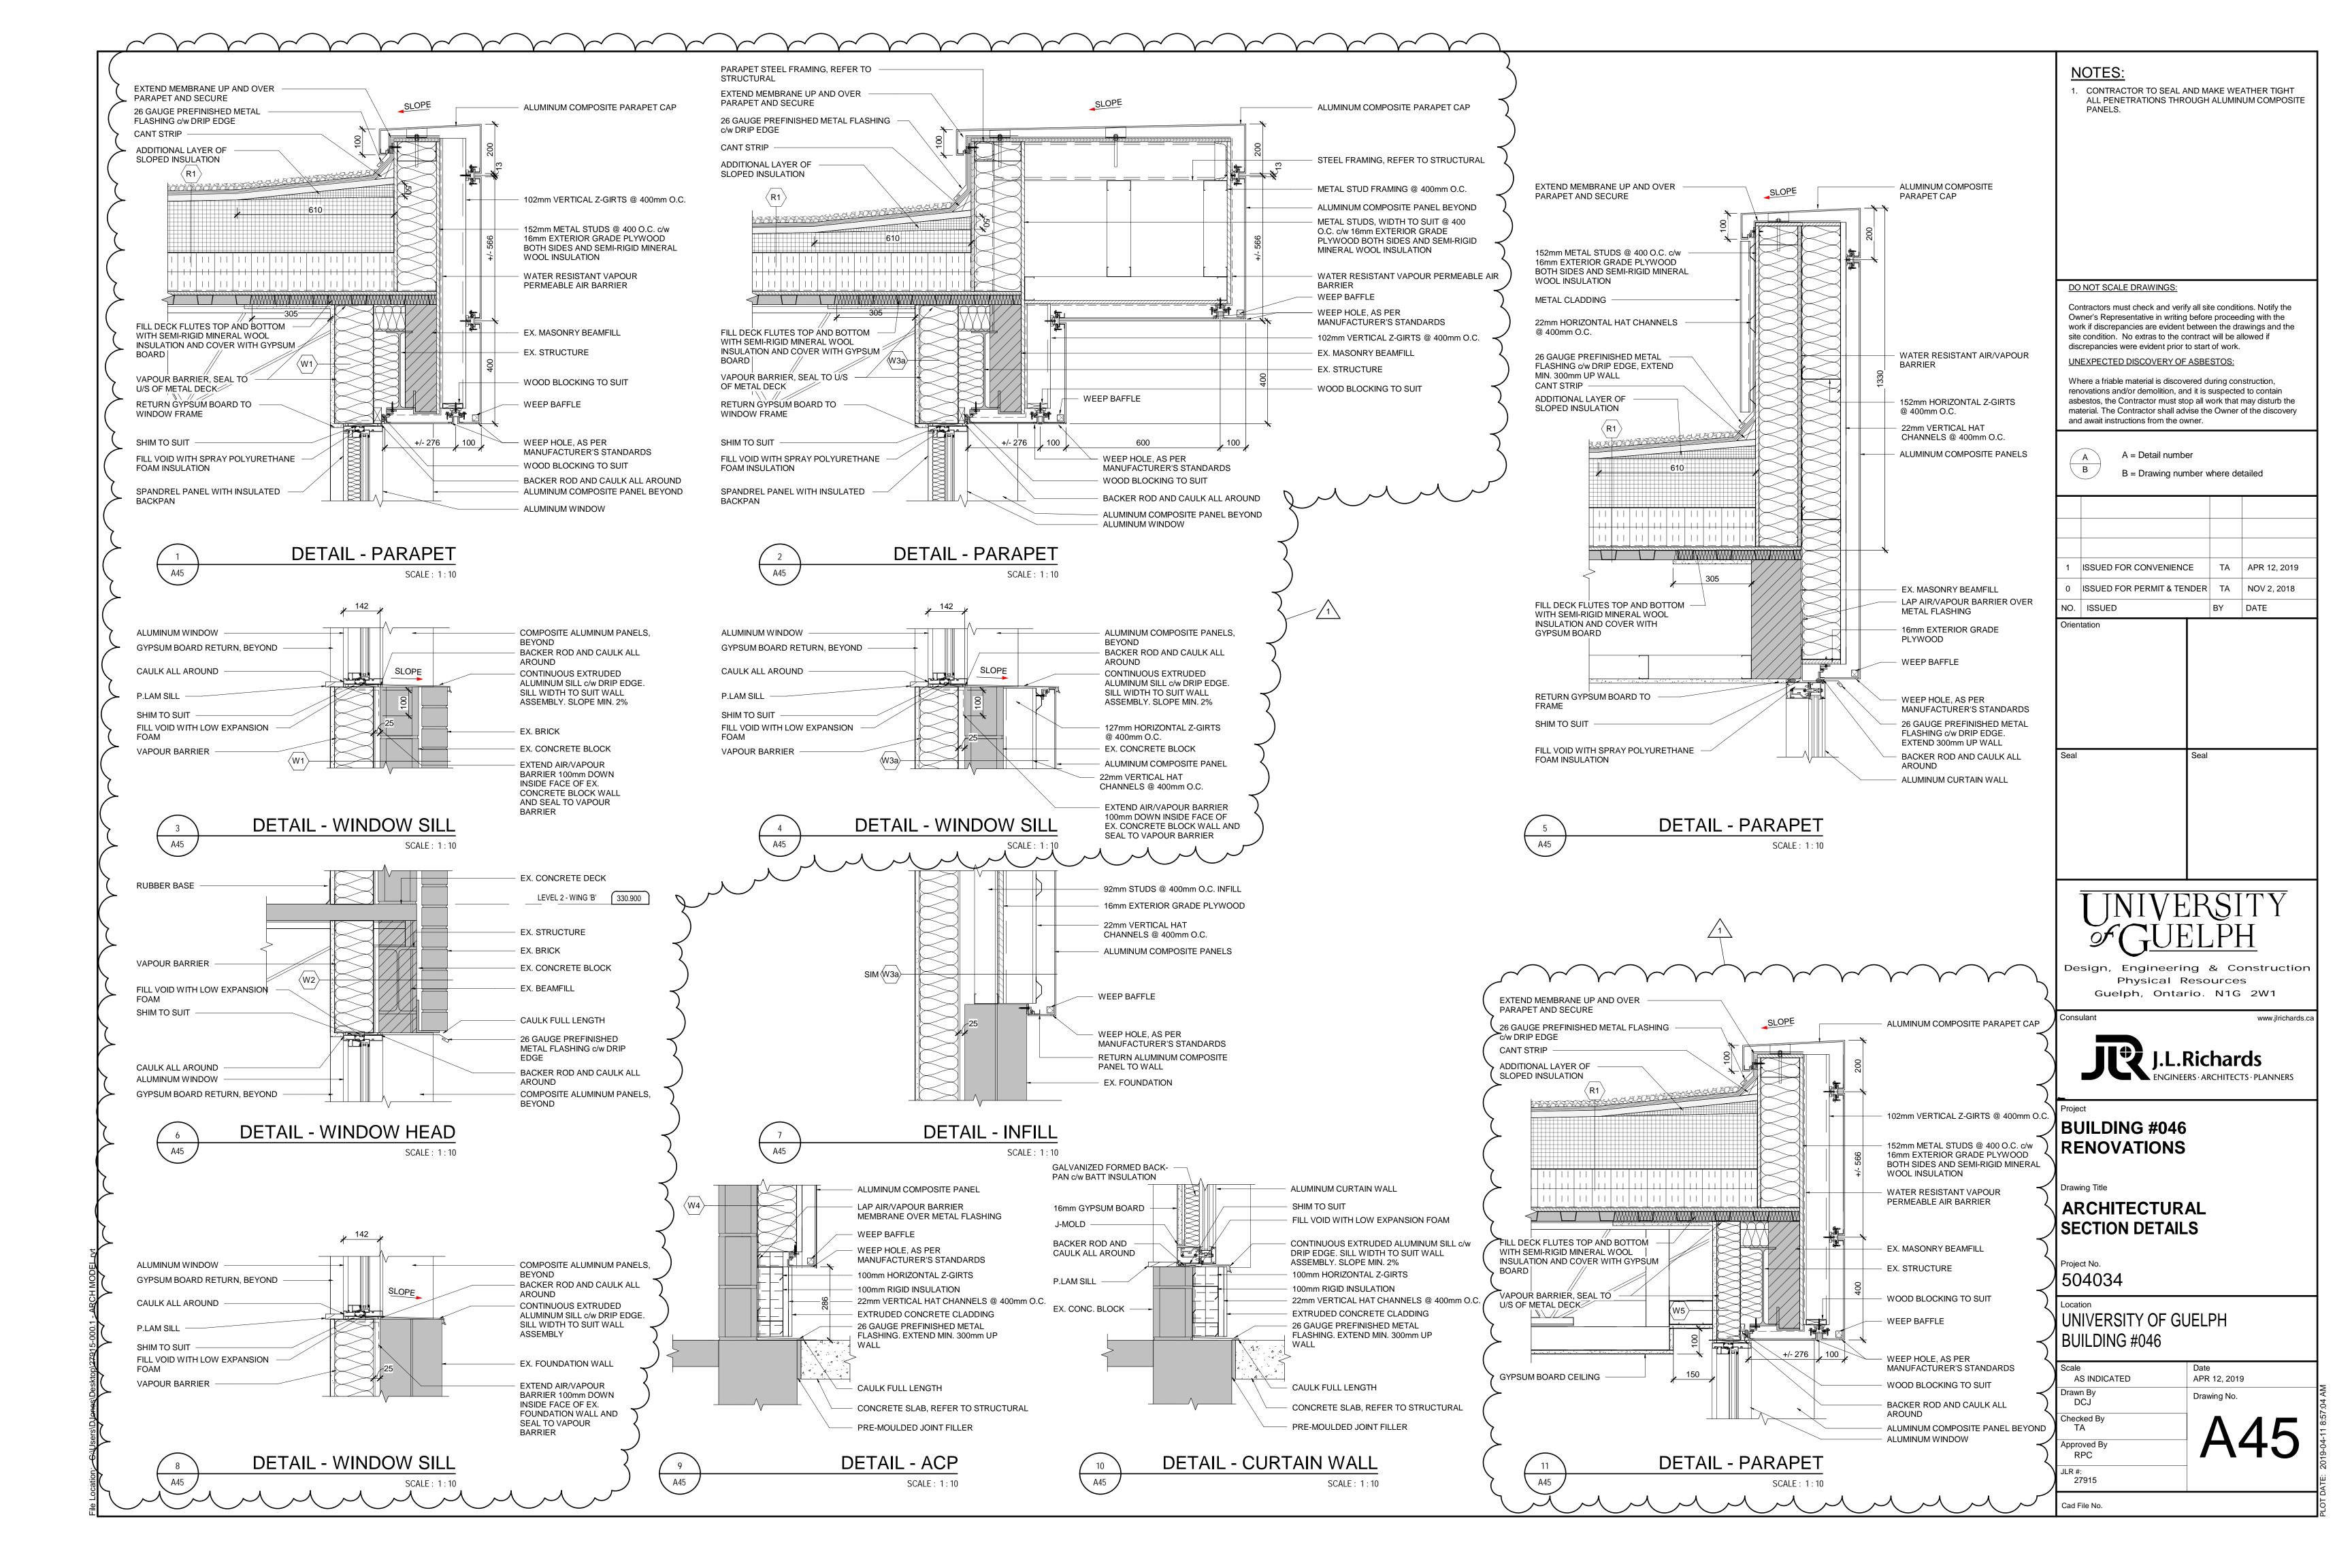

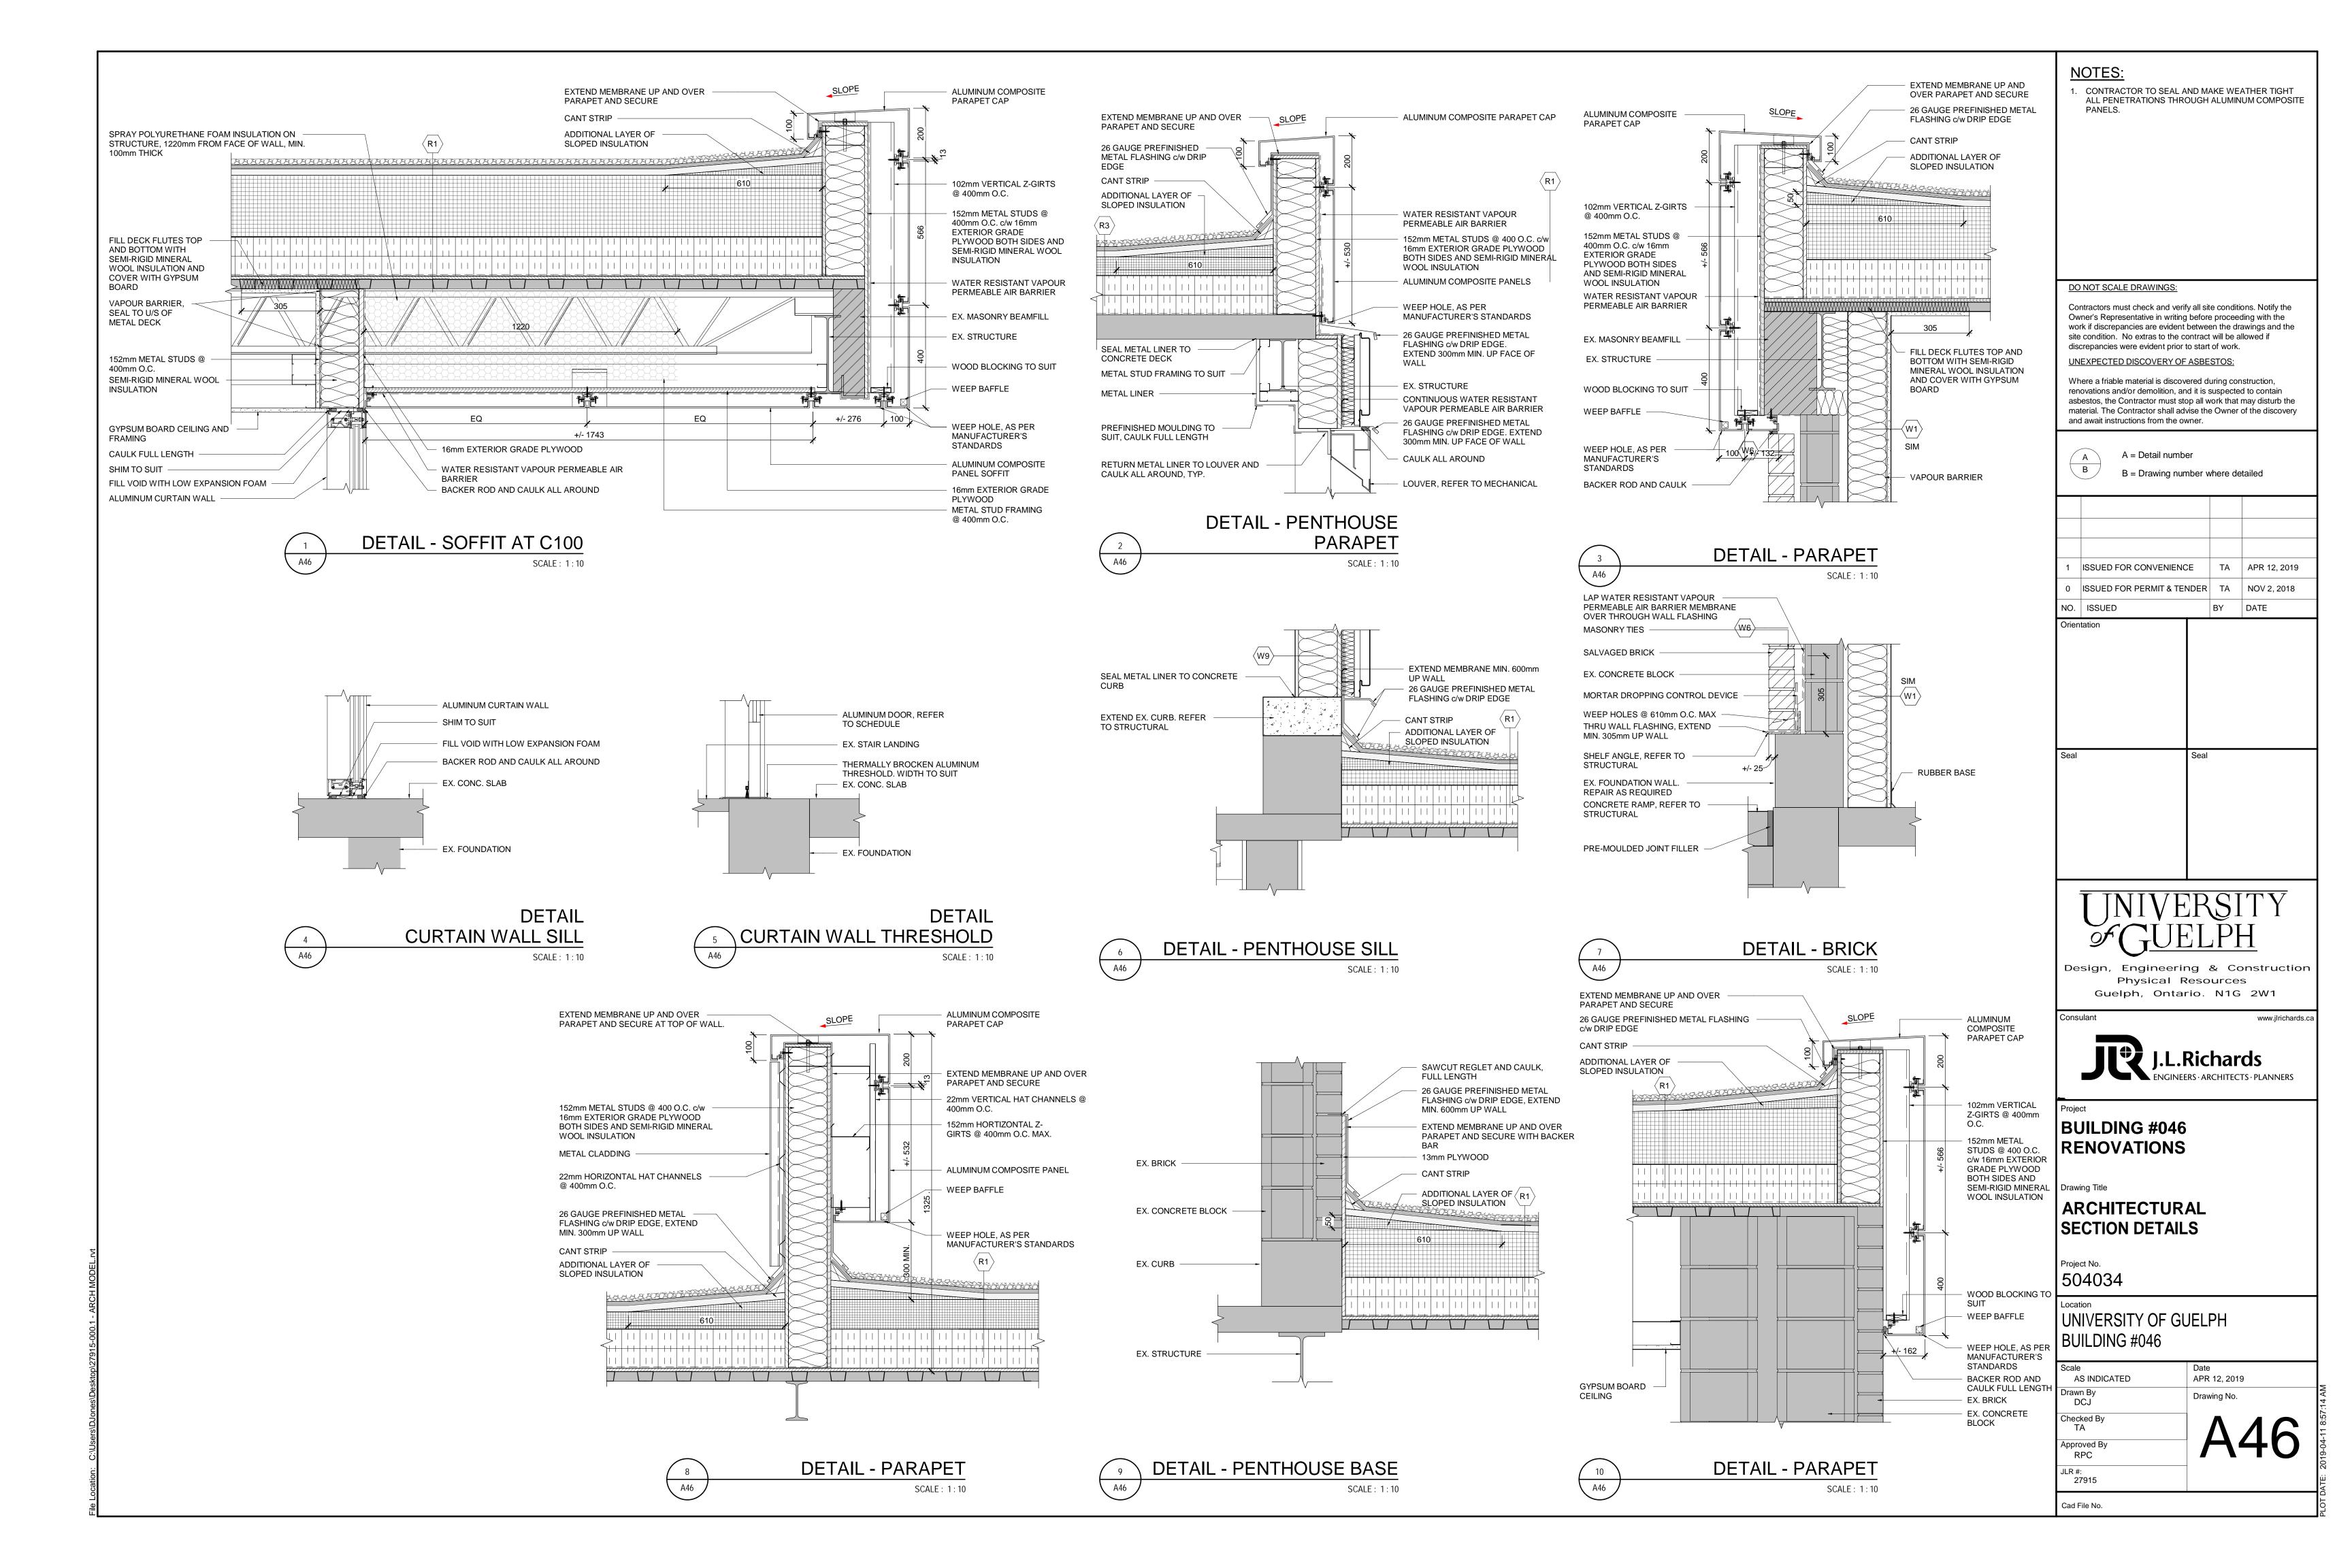

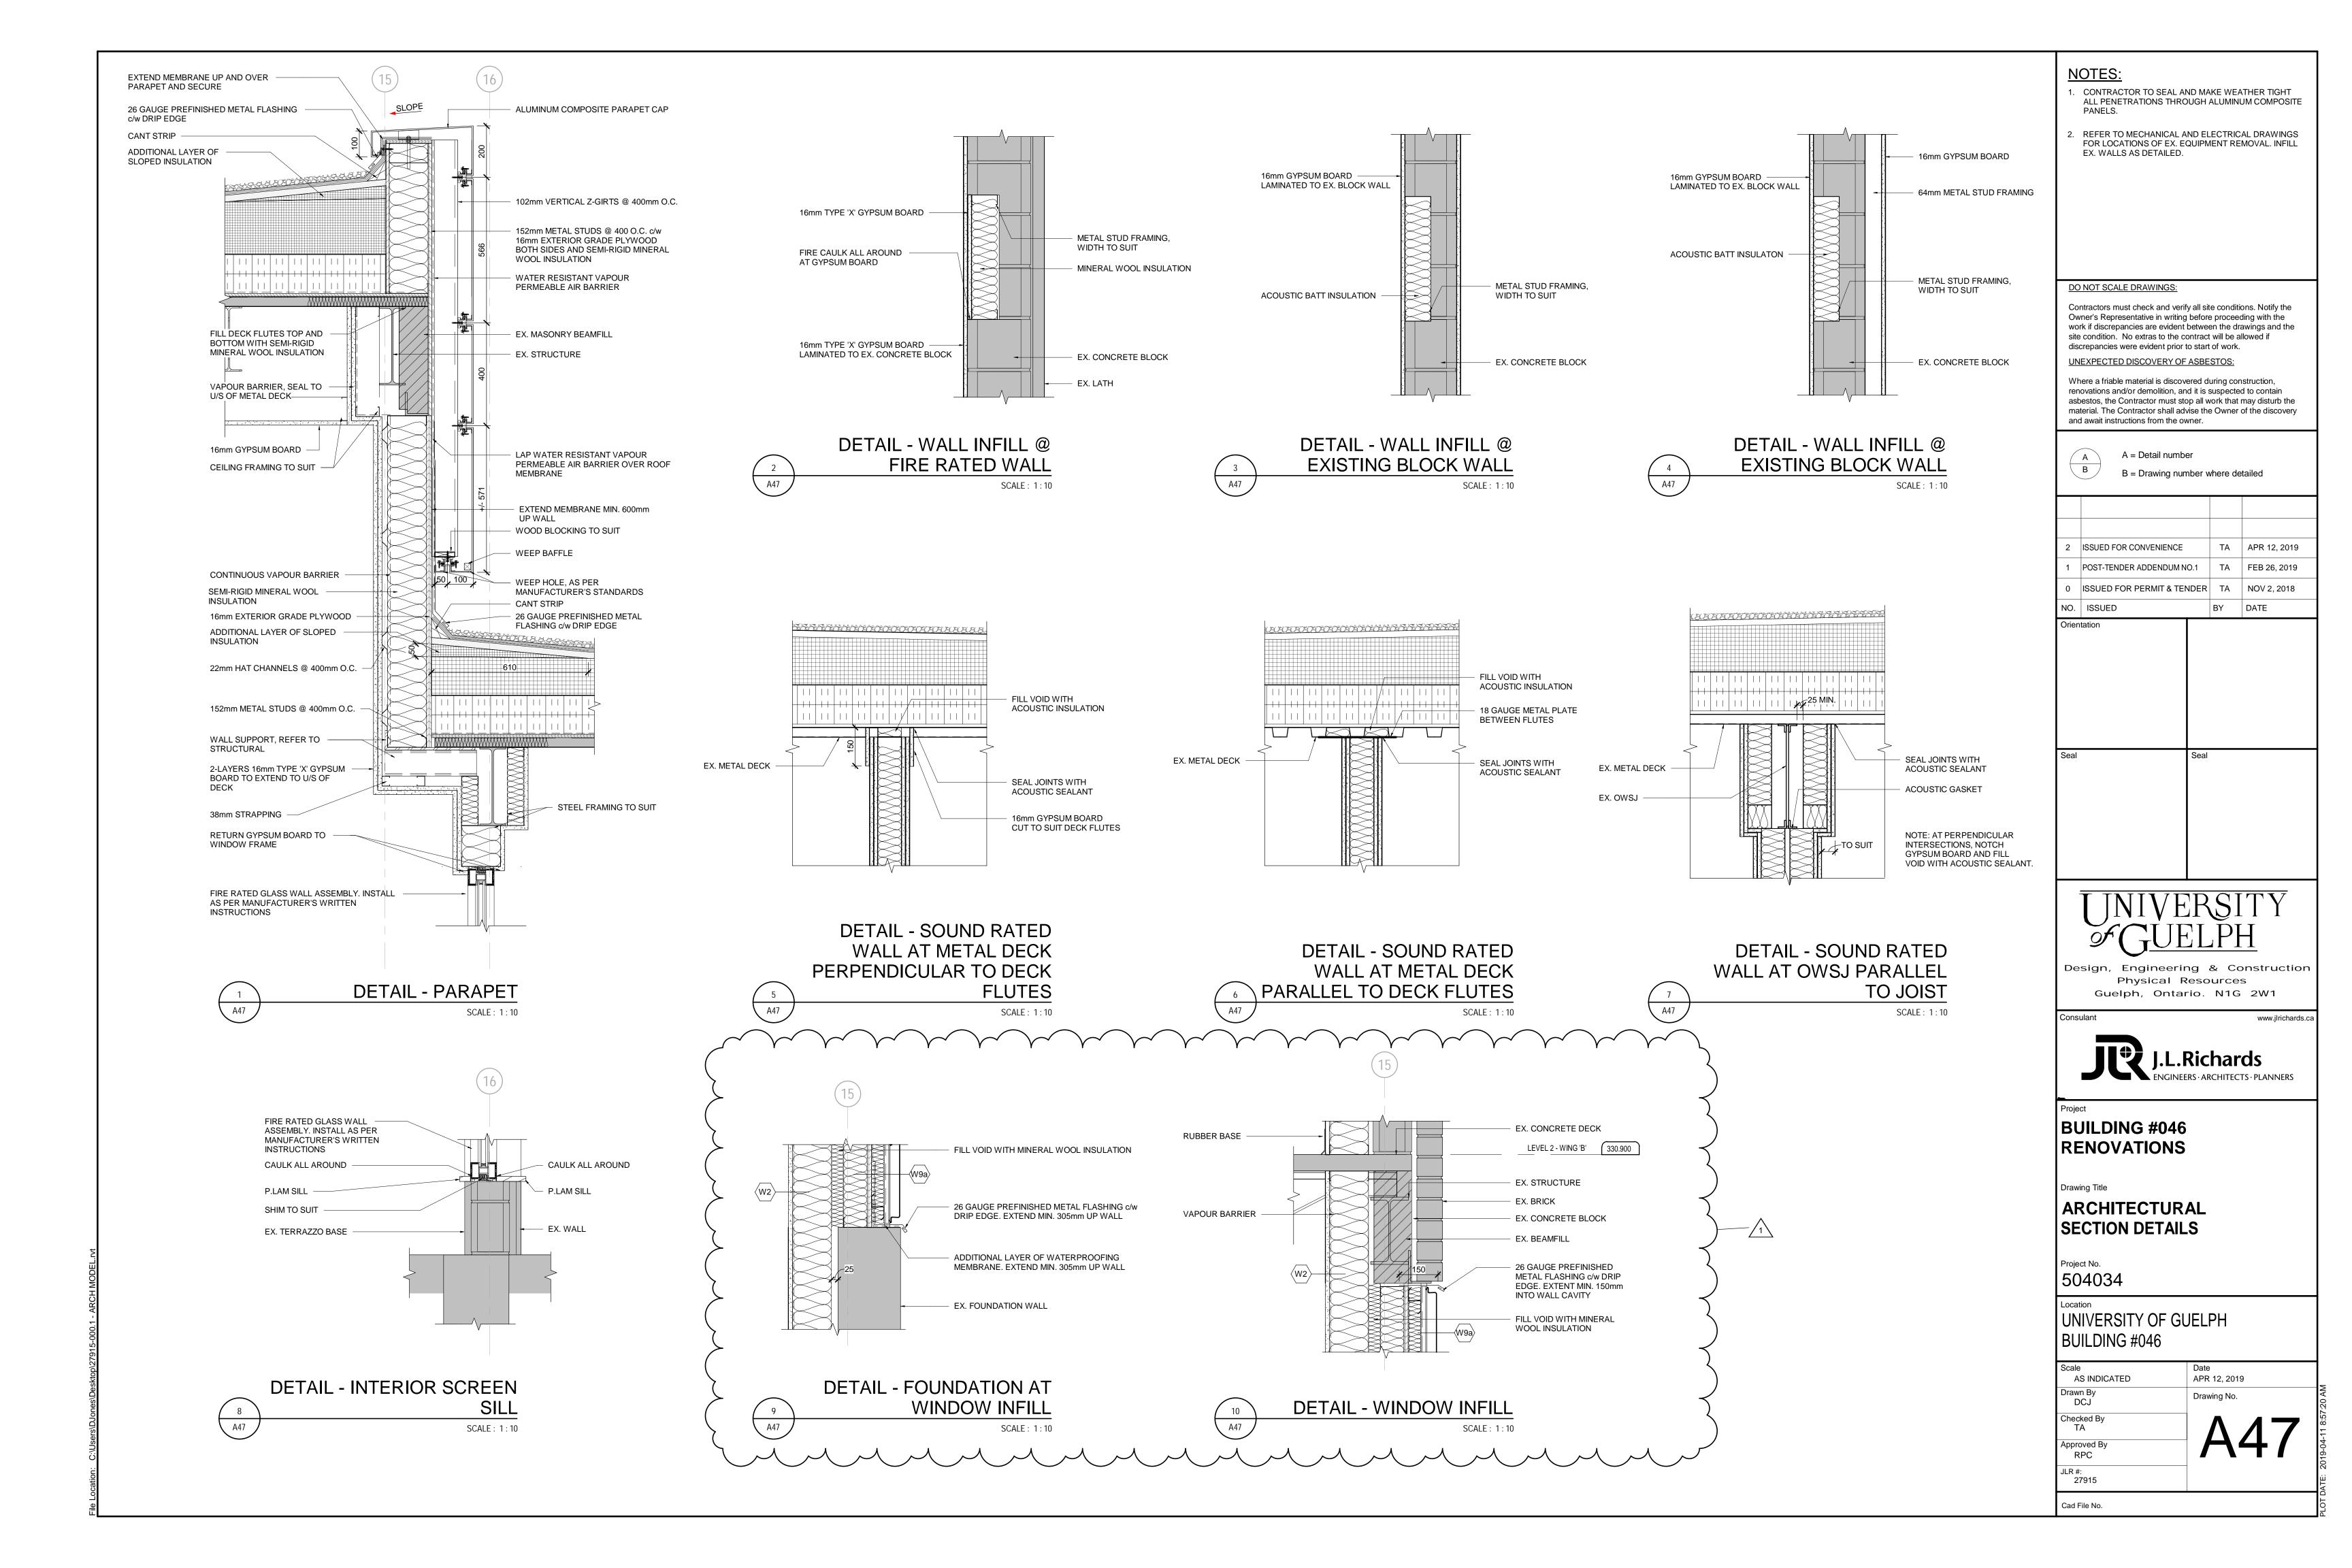

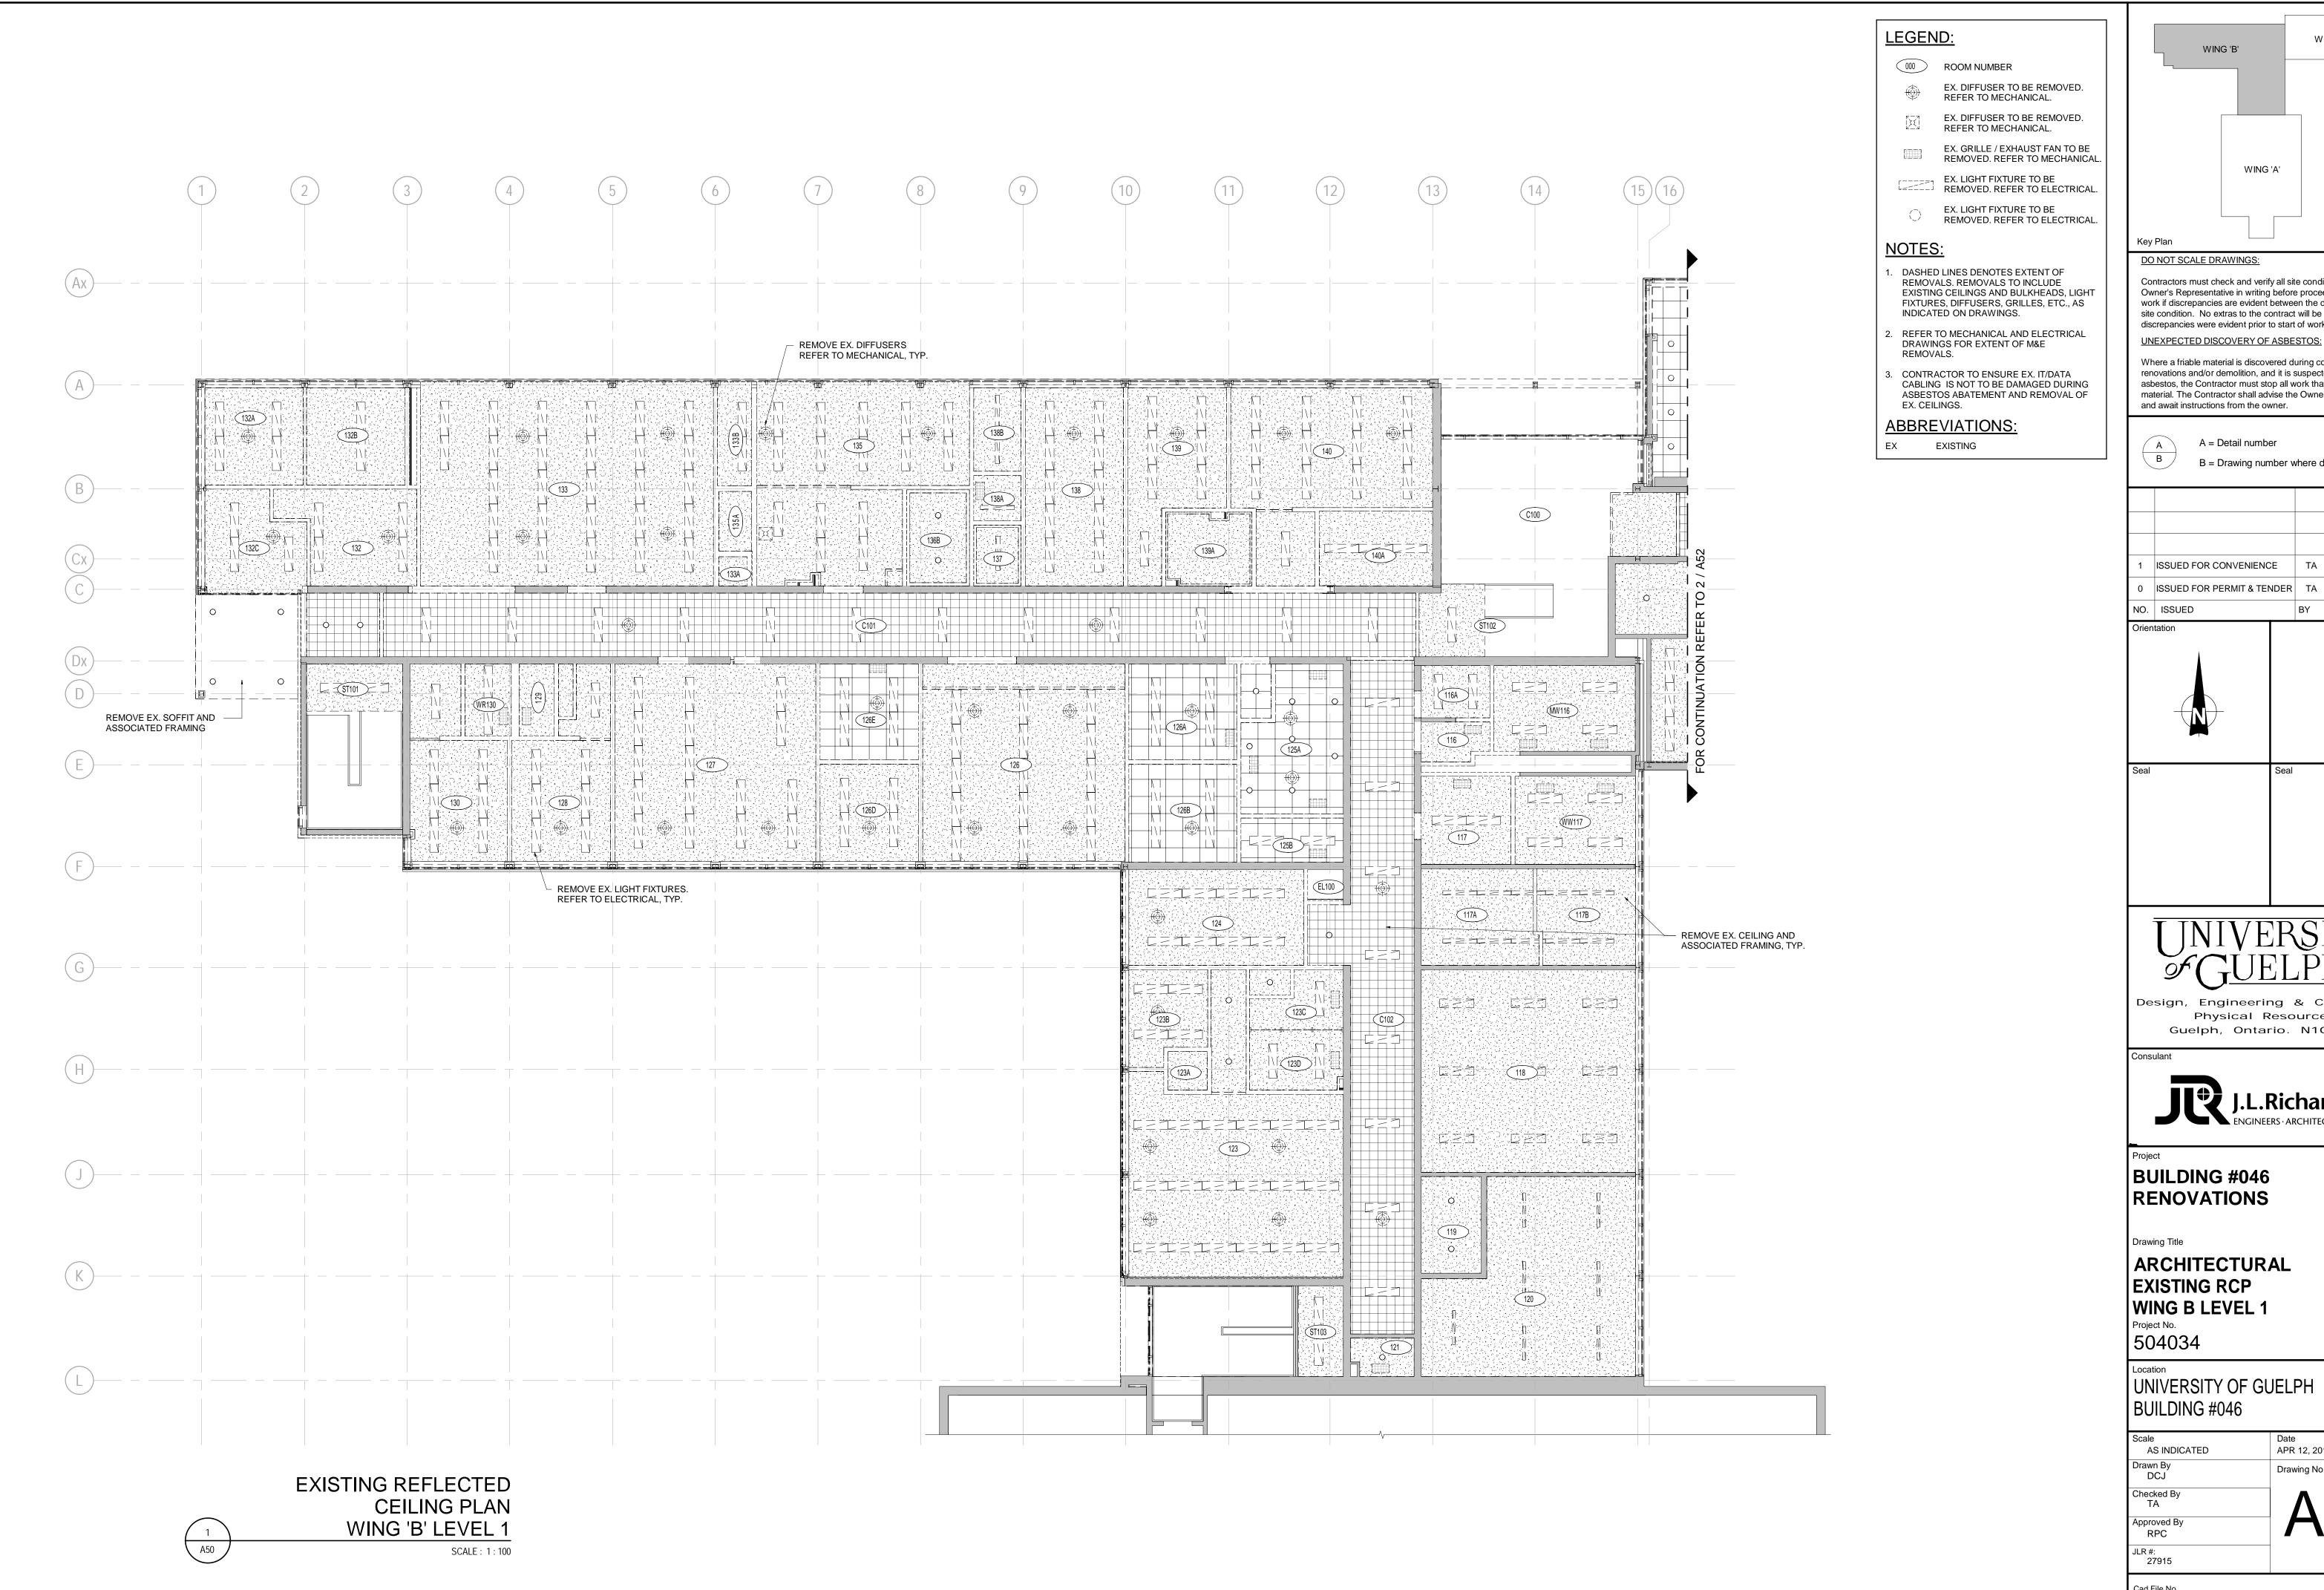

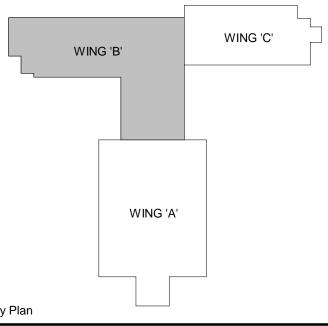

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BUILDING #046 RENOVATIONS

ARCHITECTURAL **EXISTING RCP** WING B LEVEL 1

Scale AS INDICATED	Date APR 12, 2019
Drawn By DCJ	Drawing No.
Checked By TA	$\Lambda E \Omega$
Approved By RPC	AJU
JLR #: 27915	
Cad File No.	



LEGEND:

000 ROOM NUMBER

EX. DIFFUSER TO BE REMOVED. REFER TO MECHANICAL.

EX. DIFFUSER TO BE REING REFER TO MECHANICAL. EX. DIFFUSER TO BE REMOVED.

EX. GRILLE / EADAGOT 17.00.0 __ REMOVED. REFER TO MECHANICAL.

EX. GRILLE / EXHAUST FAN TO BE

EX. LIGHT FIXTURE TO BE REMOVED. REFER TO ELECTRICAL.

EX. LIGHT FIXTURE TO BE REMOVED. REFER TO ELECTRICAL.


NOTES:

DASHED LINES DENOTES EXTENT OF REMOVALS. REMOVALS TO INCLUDE EXISTING CEILINGS AND BULKHEADS, LIGHT FIXTURES, DIFFUSERS, GRILLES, ETC., AS INDICATED ON DRAWINGS.

- REFER TO MECHANICAL AND ELECTRICAL DRAWINGS FOR EXTENT OF M&E REMOVALS.
- CONTRACTOR TO ENSURE EX. IT/DATA CABLING IS NOT TO BE DAMAGED DURING ASBESTOS ABATEMENT AND REMOVAL OF EX. CEILINGS.

ABBREVIATIONS:

EXISTING

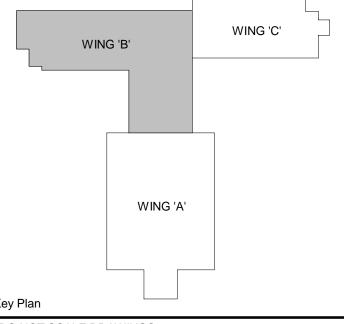

DO NOT SCALE DRAWINGS:

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Orientation

NO. ISSUED



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BUILDING #046 RENOVATIONS

Drawing Title

ARCHITECTURAL EXISTING RCP WING B LEVEL 2


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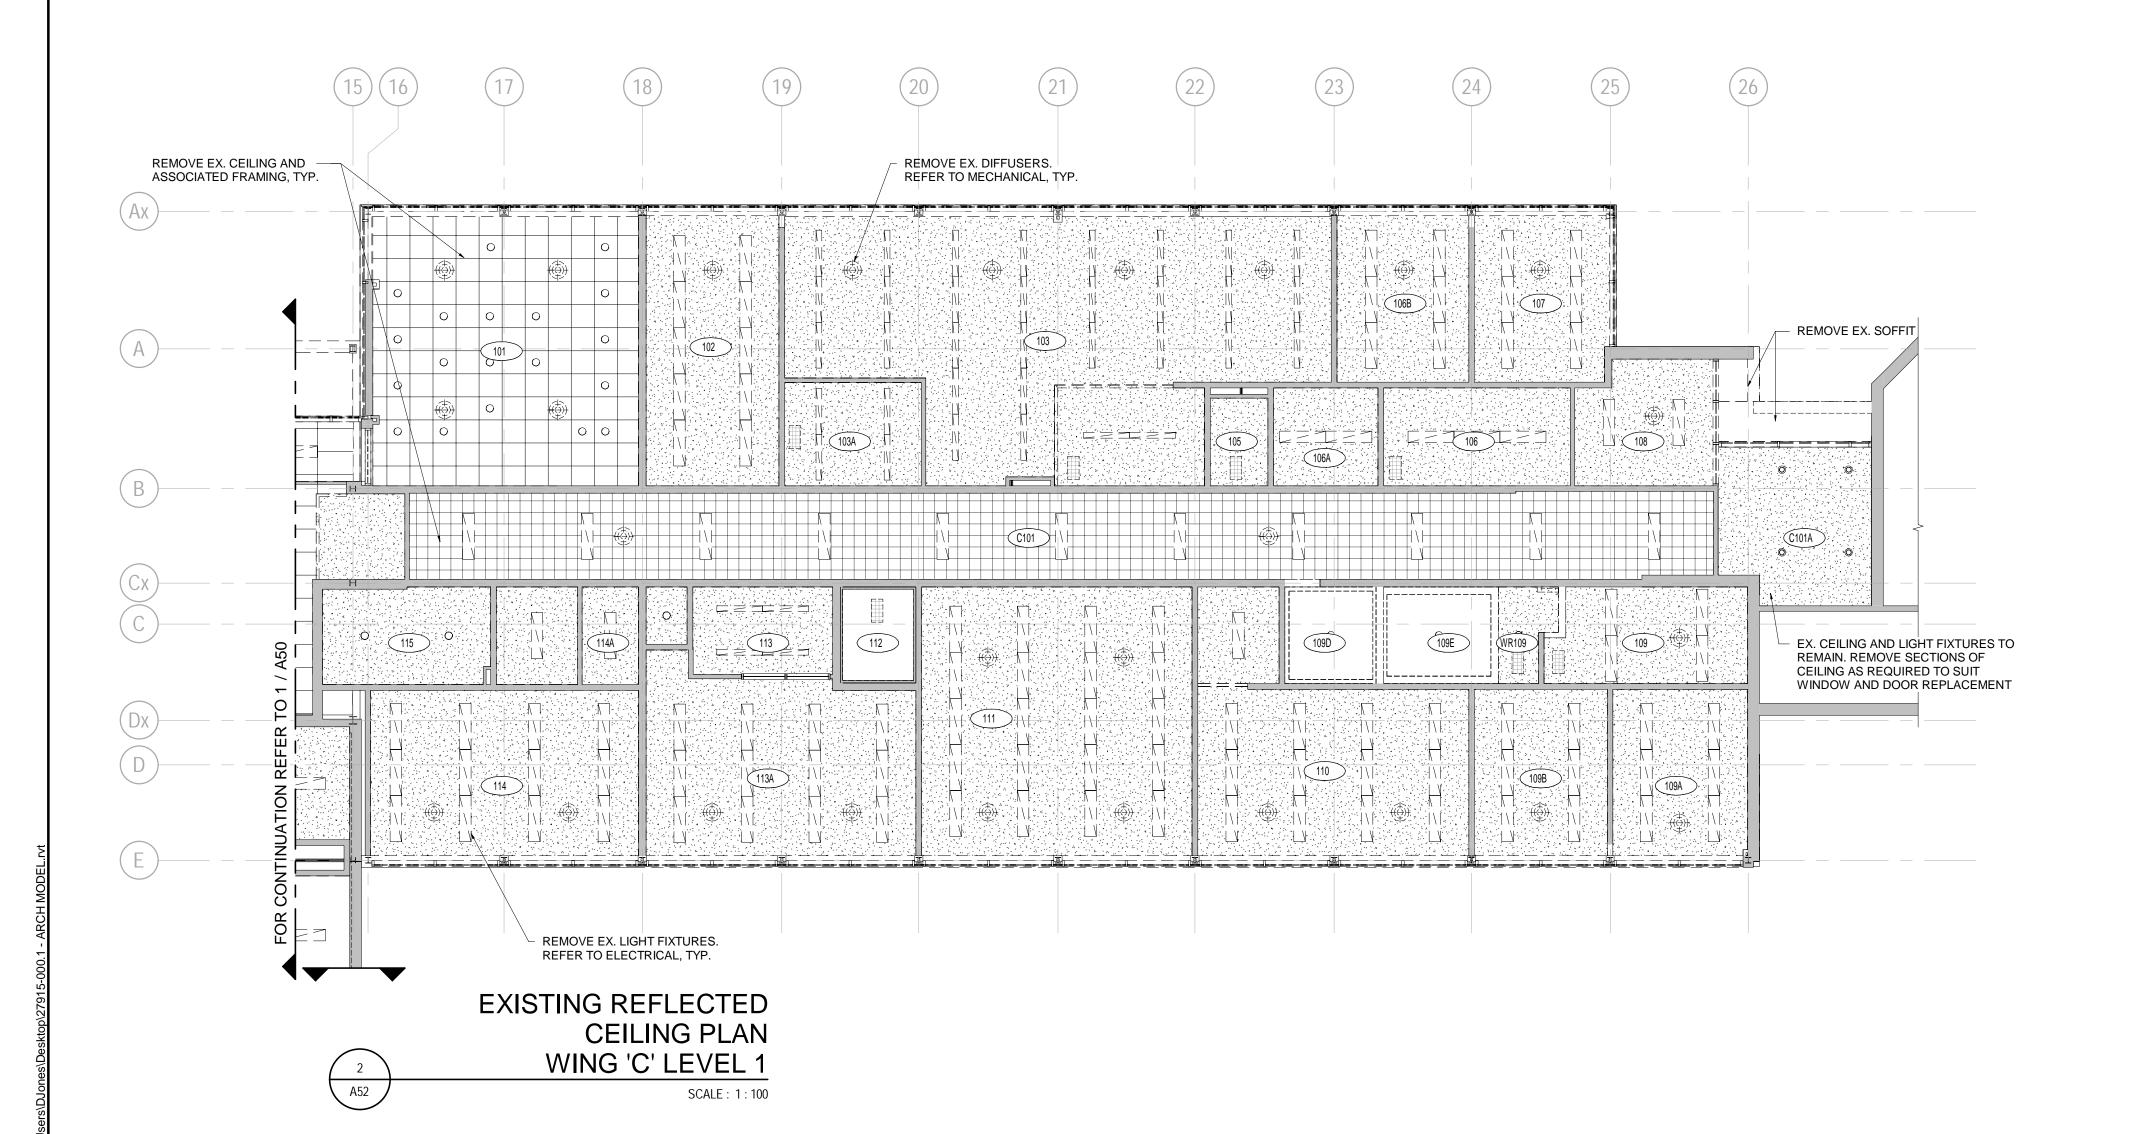
Cad File No.

UNIVERSITY OF GUELPH BUILDING #046

AS INDICATED APR 12, 2019 Drawn By Drawing No. Checked By Approved By RPC JLR #: 27915

SCALE: 1:100



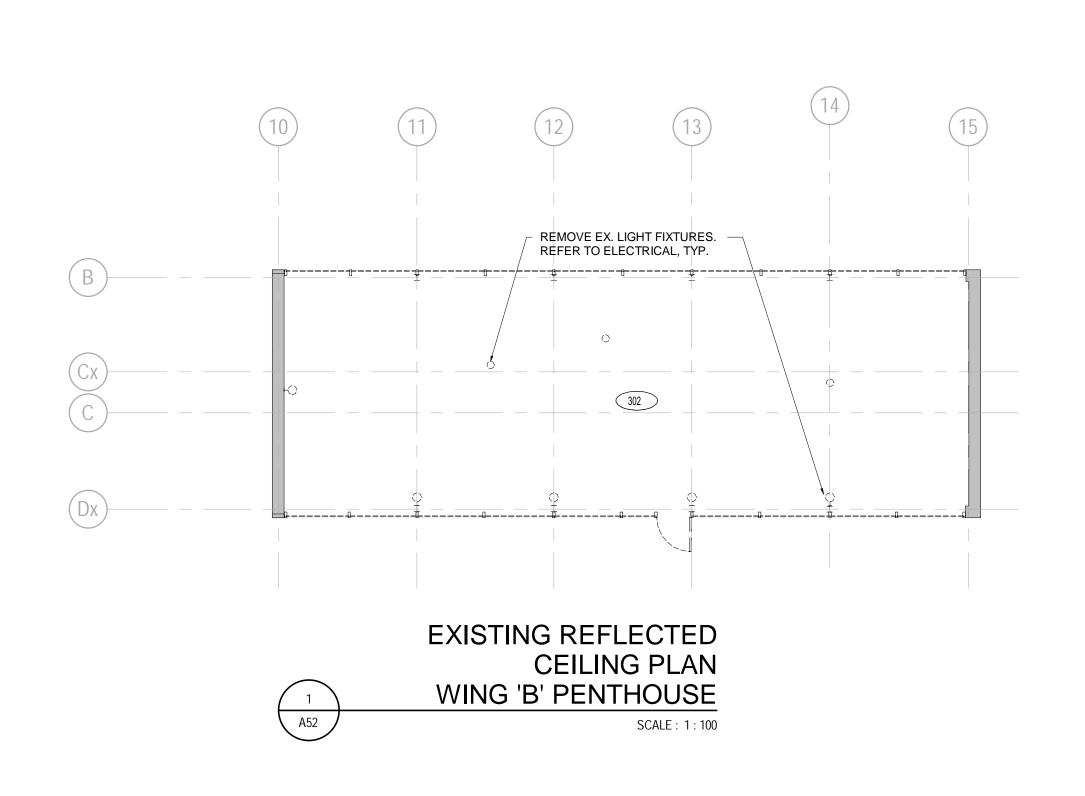

LEGEND:

ROOM NUMBER

EX. DIFFUSER TO BE REMOVED.

REFER TO MECHANICAL.

EX. DIFFUSER TO BE REMORED TO MECHANICAL. EX. GRILLE / EXHAUST FAN TO BE

EX. DIFFUSER TO BE REMOVED.

EX. LIGHT FIXTURE TO BE REMOVED. REFER TO ELECTRICAL.


> EX. LIGHT FIXTURE TO BE REMOVED. REFER TO ELECTRICAL.

NOTES:

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- REFER TO MECHANICAL AND ELECTRICAL DRAWINGS FOR EXTENT OF M&E REMOVALS.
- 3. CONTRACTOR TO ENSURE EX. IT/DATA CABLING IS NOT TO BE DAMAGED DURING ASBESTOS ABATEMENT AND REMOVAL OF EX. CEILINGS.

ABBREVIATIONS:

EXISTING

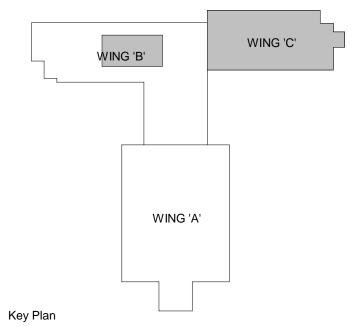


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BUILDING #046 RENOVATIONS


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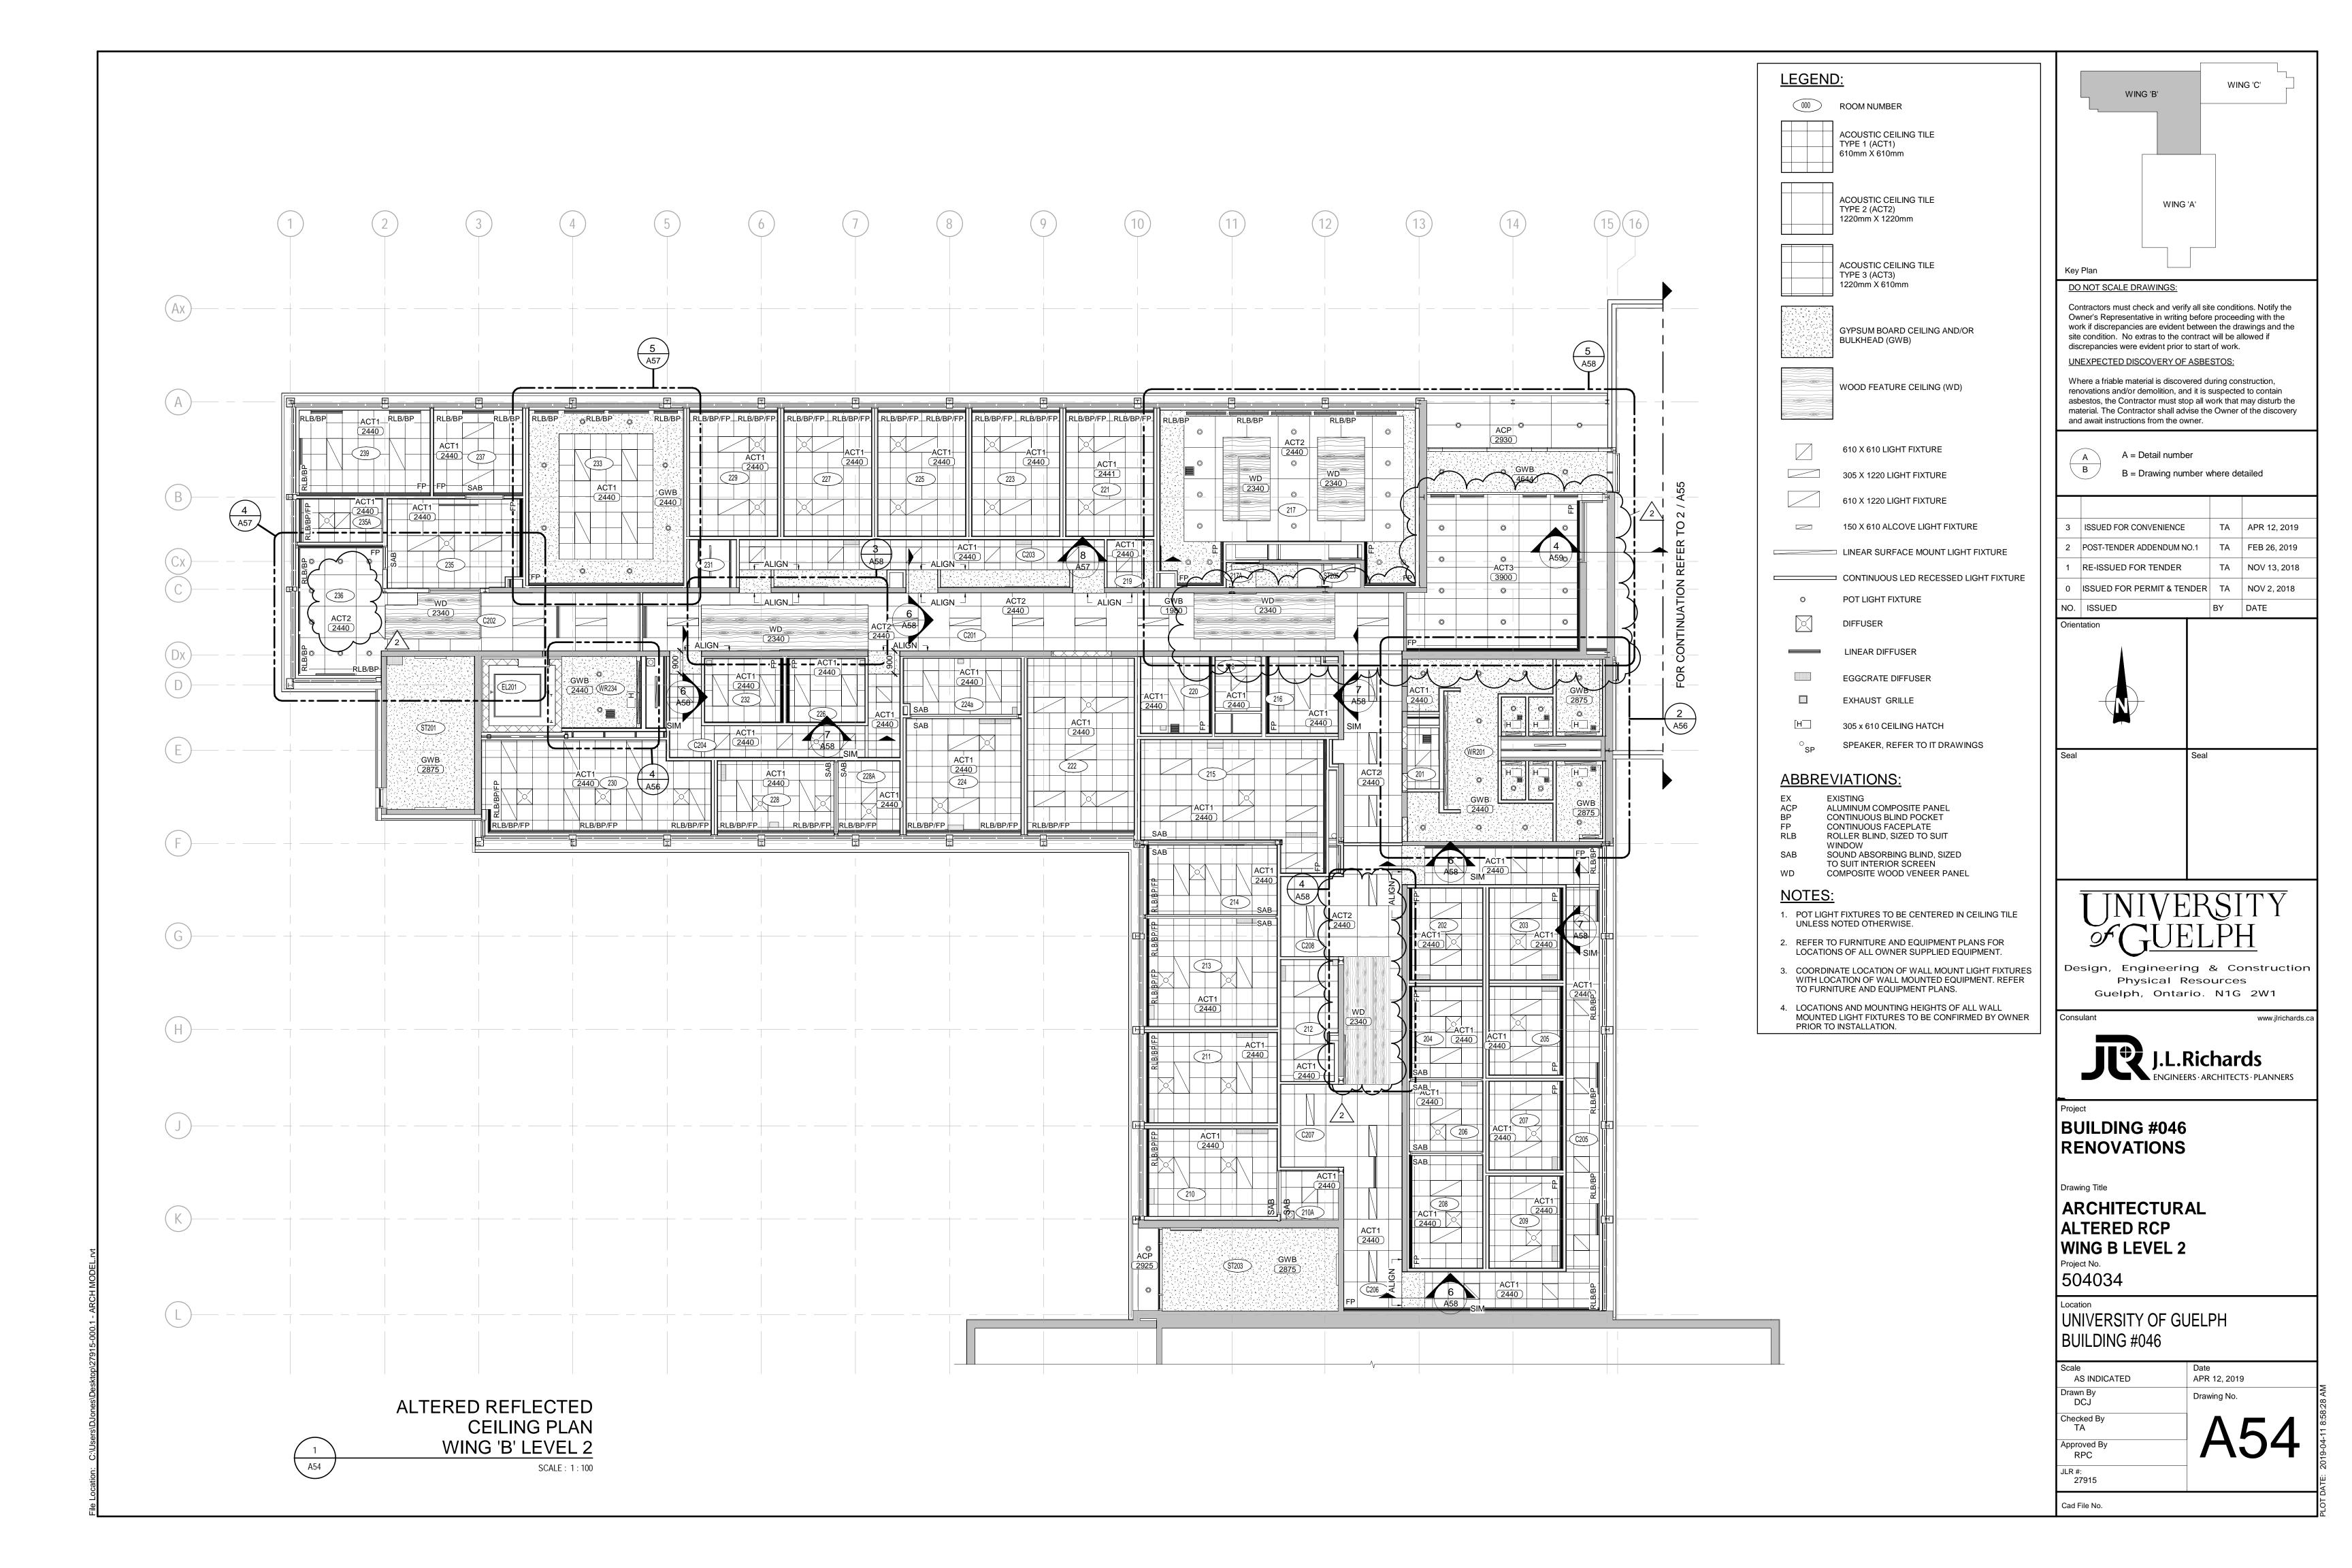
ARCHITECTURAL **EXISTING RCP** PENTHOUSE AND WING C


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UNIVERSITY OF GUELPH BUILDING #046

Scale	Date
AS INDICATED	APR 12, 2019
Drawn By	Drawing No.
DCJ	
Checked By	^ ~ ~ ~
TA	$ \Lambda L' \rangle$
Approved By	
RPC	7102
JLR #:	
27915	



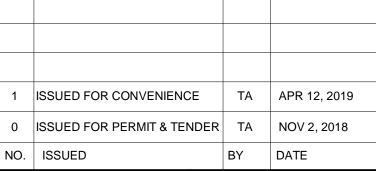


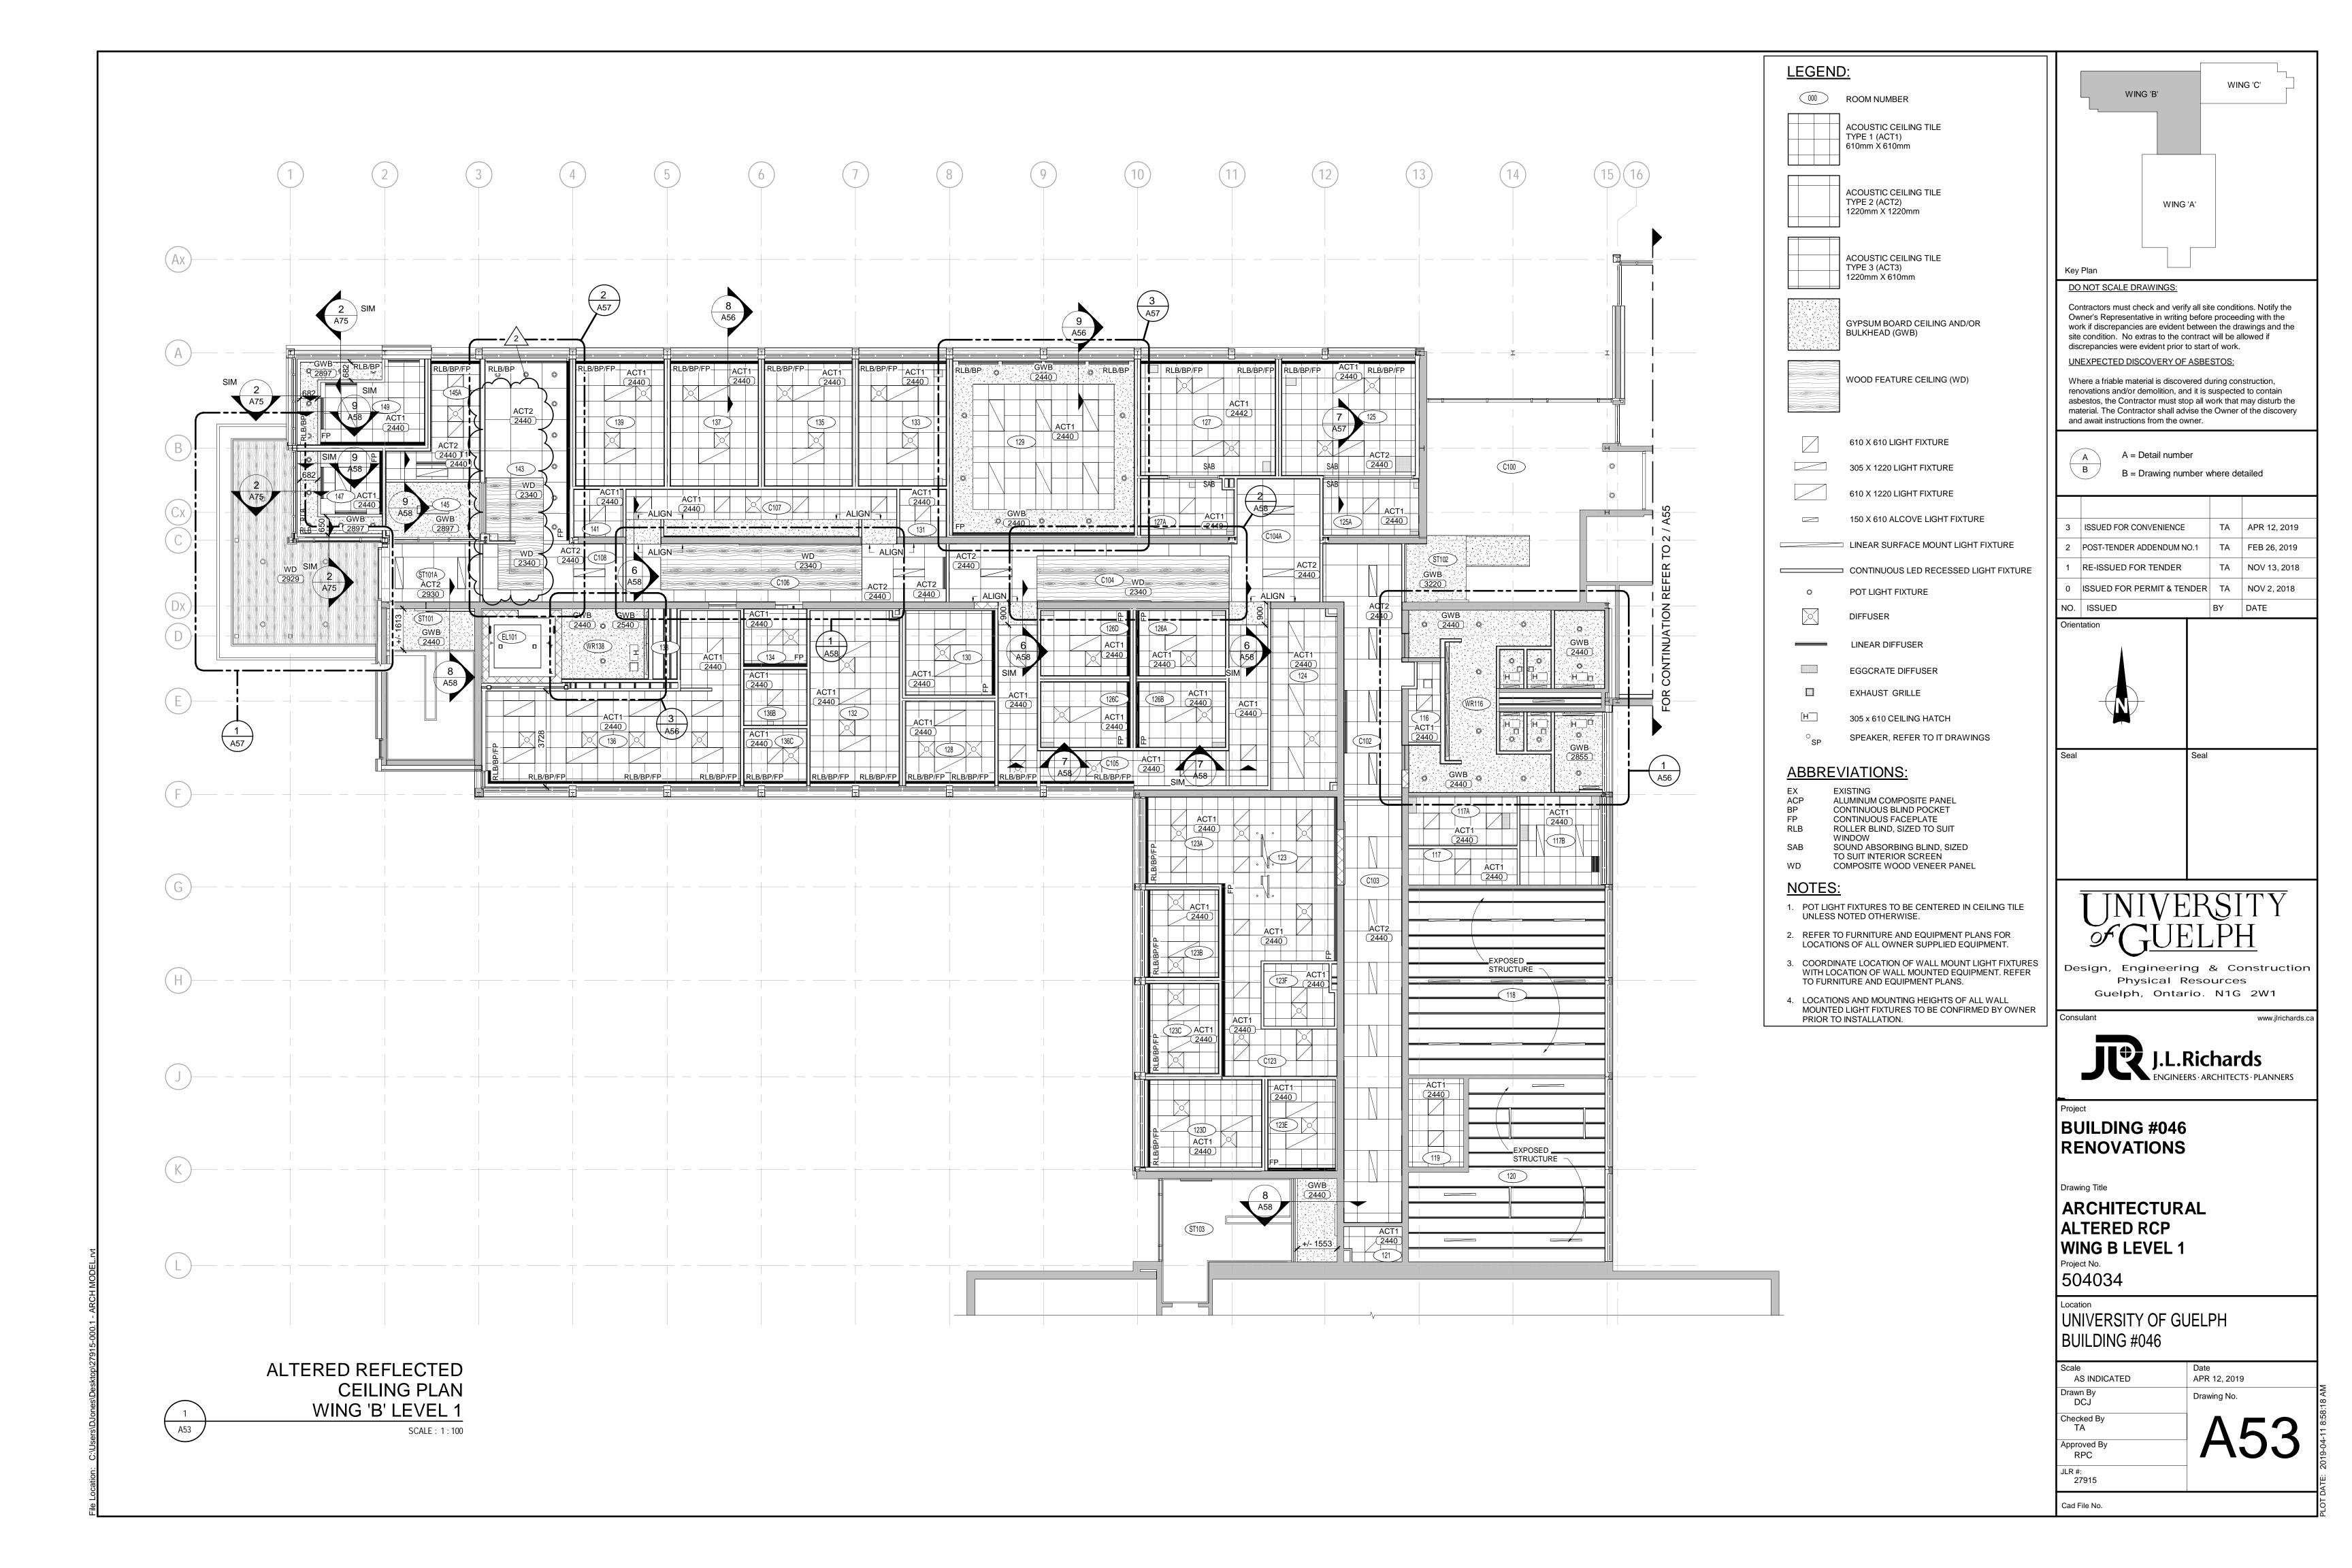


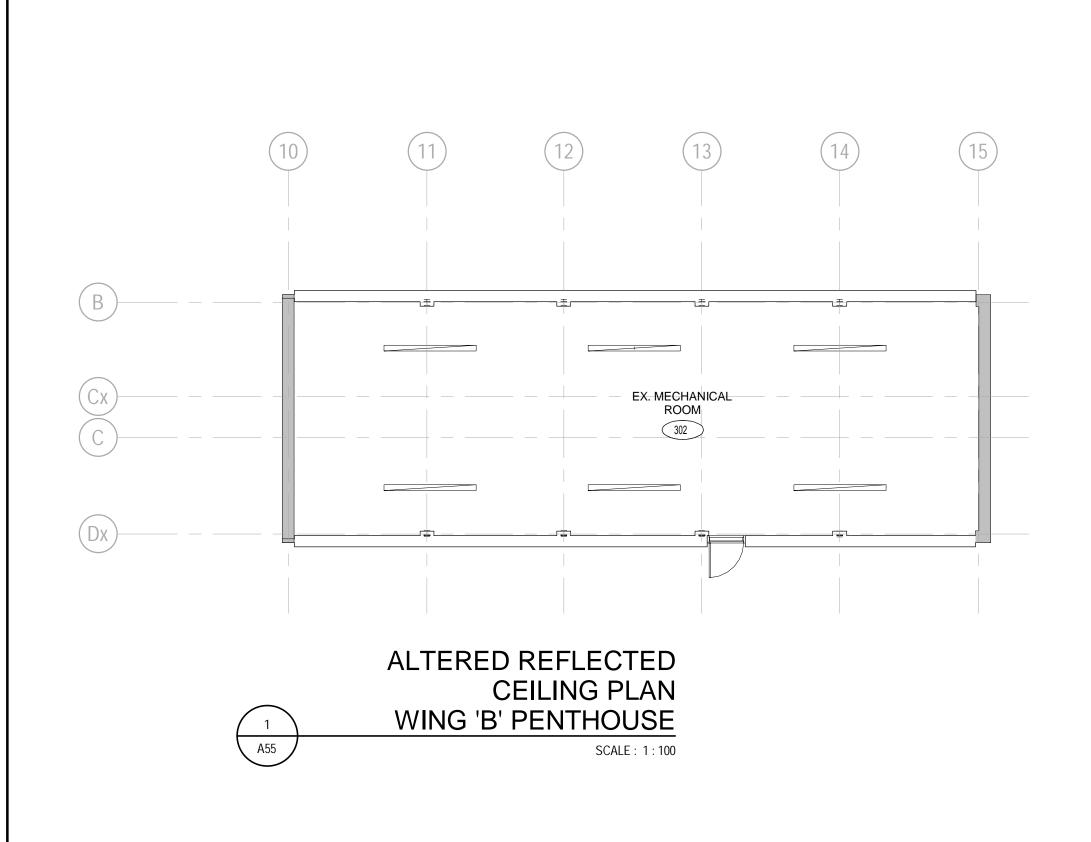
WING 'C' LEVEL 1

SCALE: 1:100

2 A55

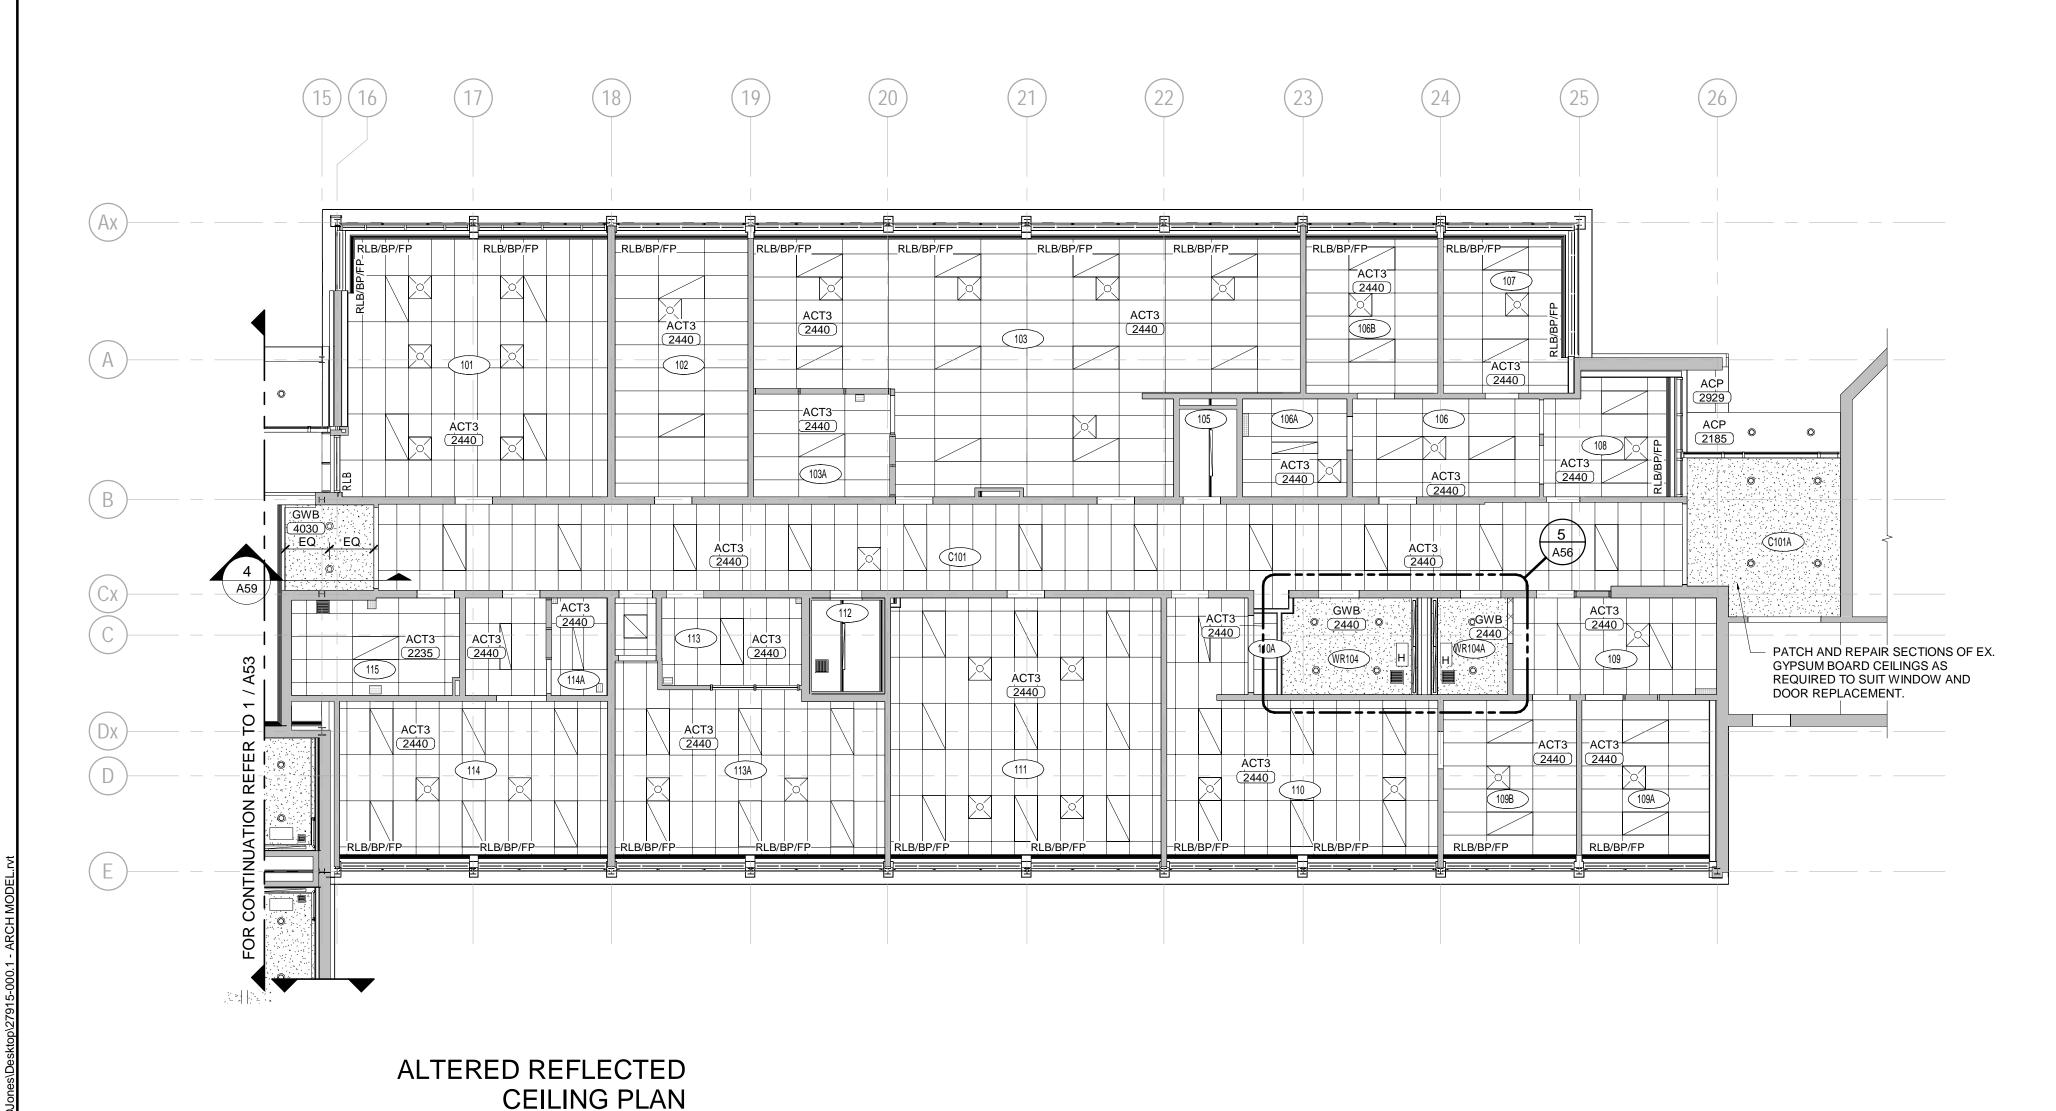

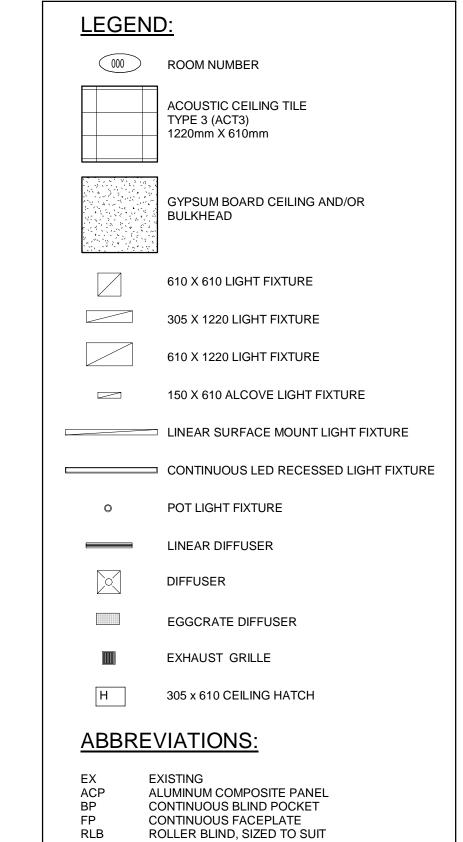

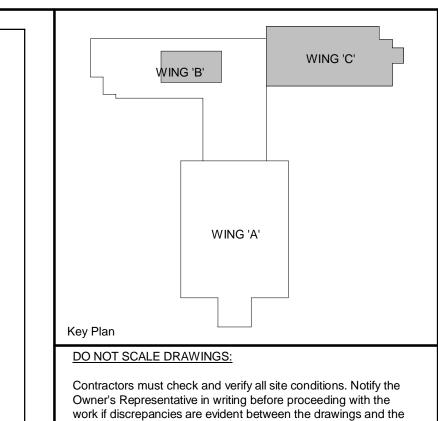

Contractors must check and verify all site conditions. Notify the Owner's Representative in writing before proceeding with the work if discrepancies are evident between the drawings and the site condition. No extras to the contract will be allowed if discrepancies were evident prior to start of work.

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A B

Orientation

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2 ISSUED FOR CONVENIENCE TA APR 12, 2019
1 RE-ISSUED FOR TENDER TA NOV 13, 2018
0 ISSUED FOR PERMIT & TENDER TA NOV 2, 2018
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BUILDING #046 RENOVATIONS


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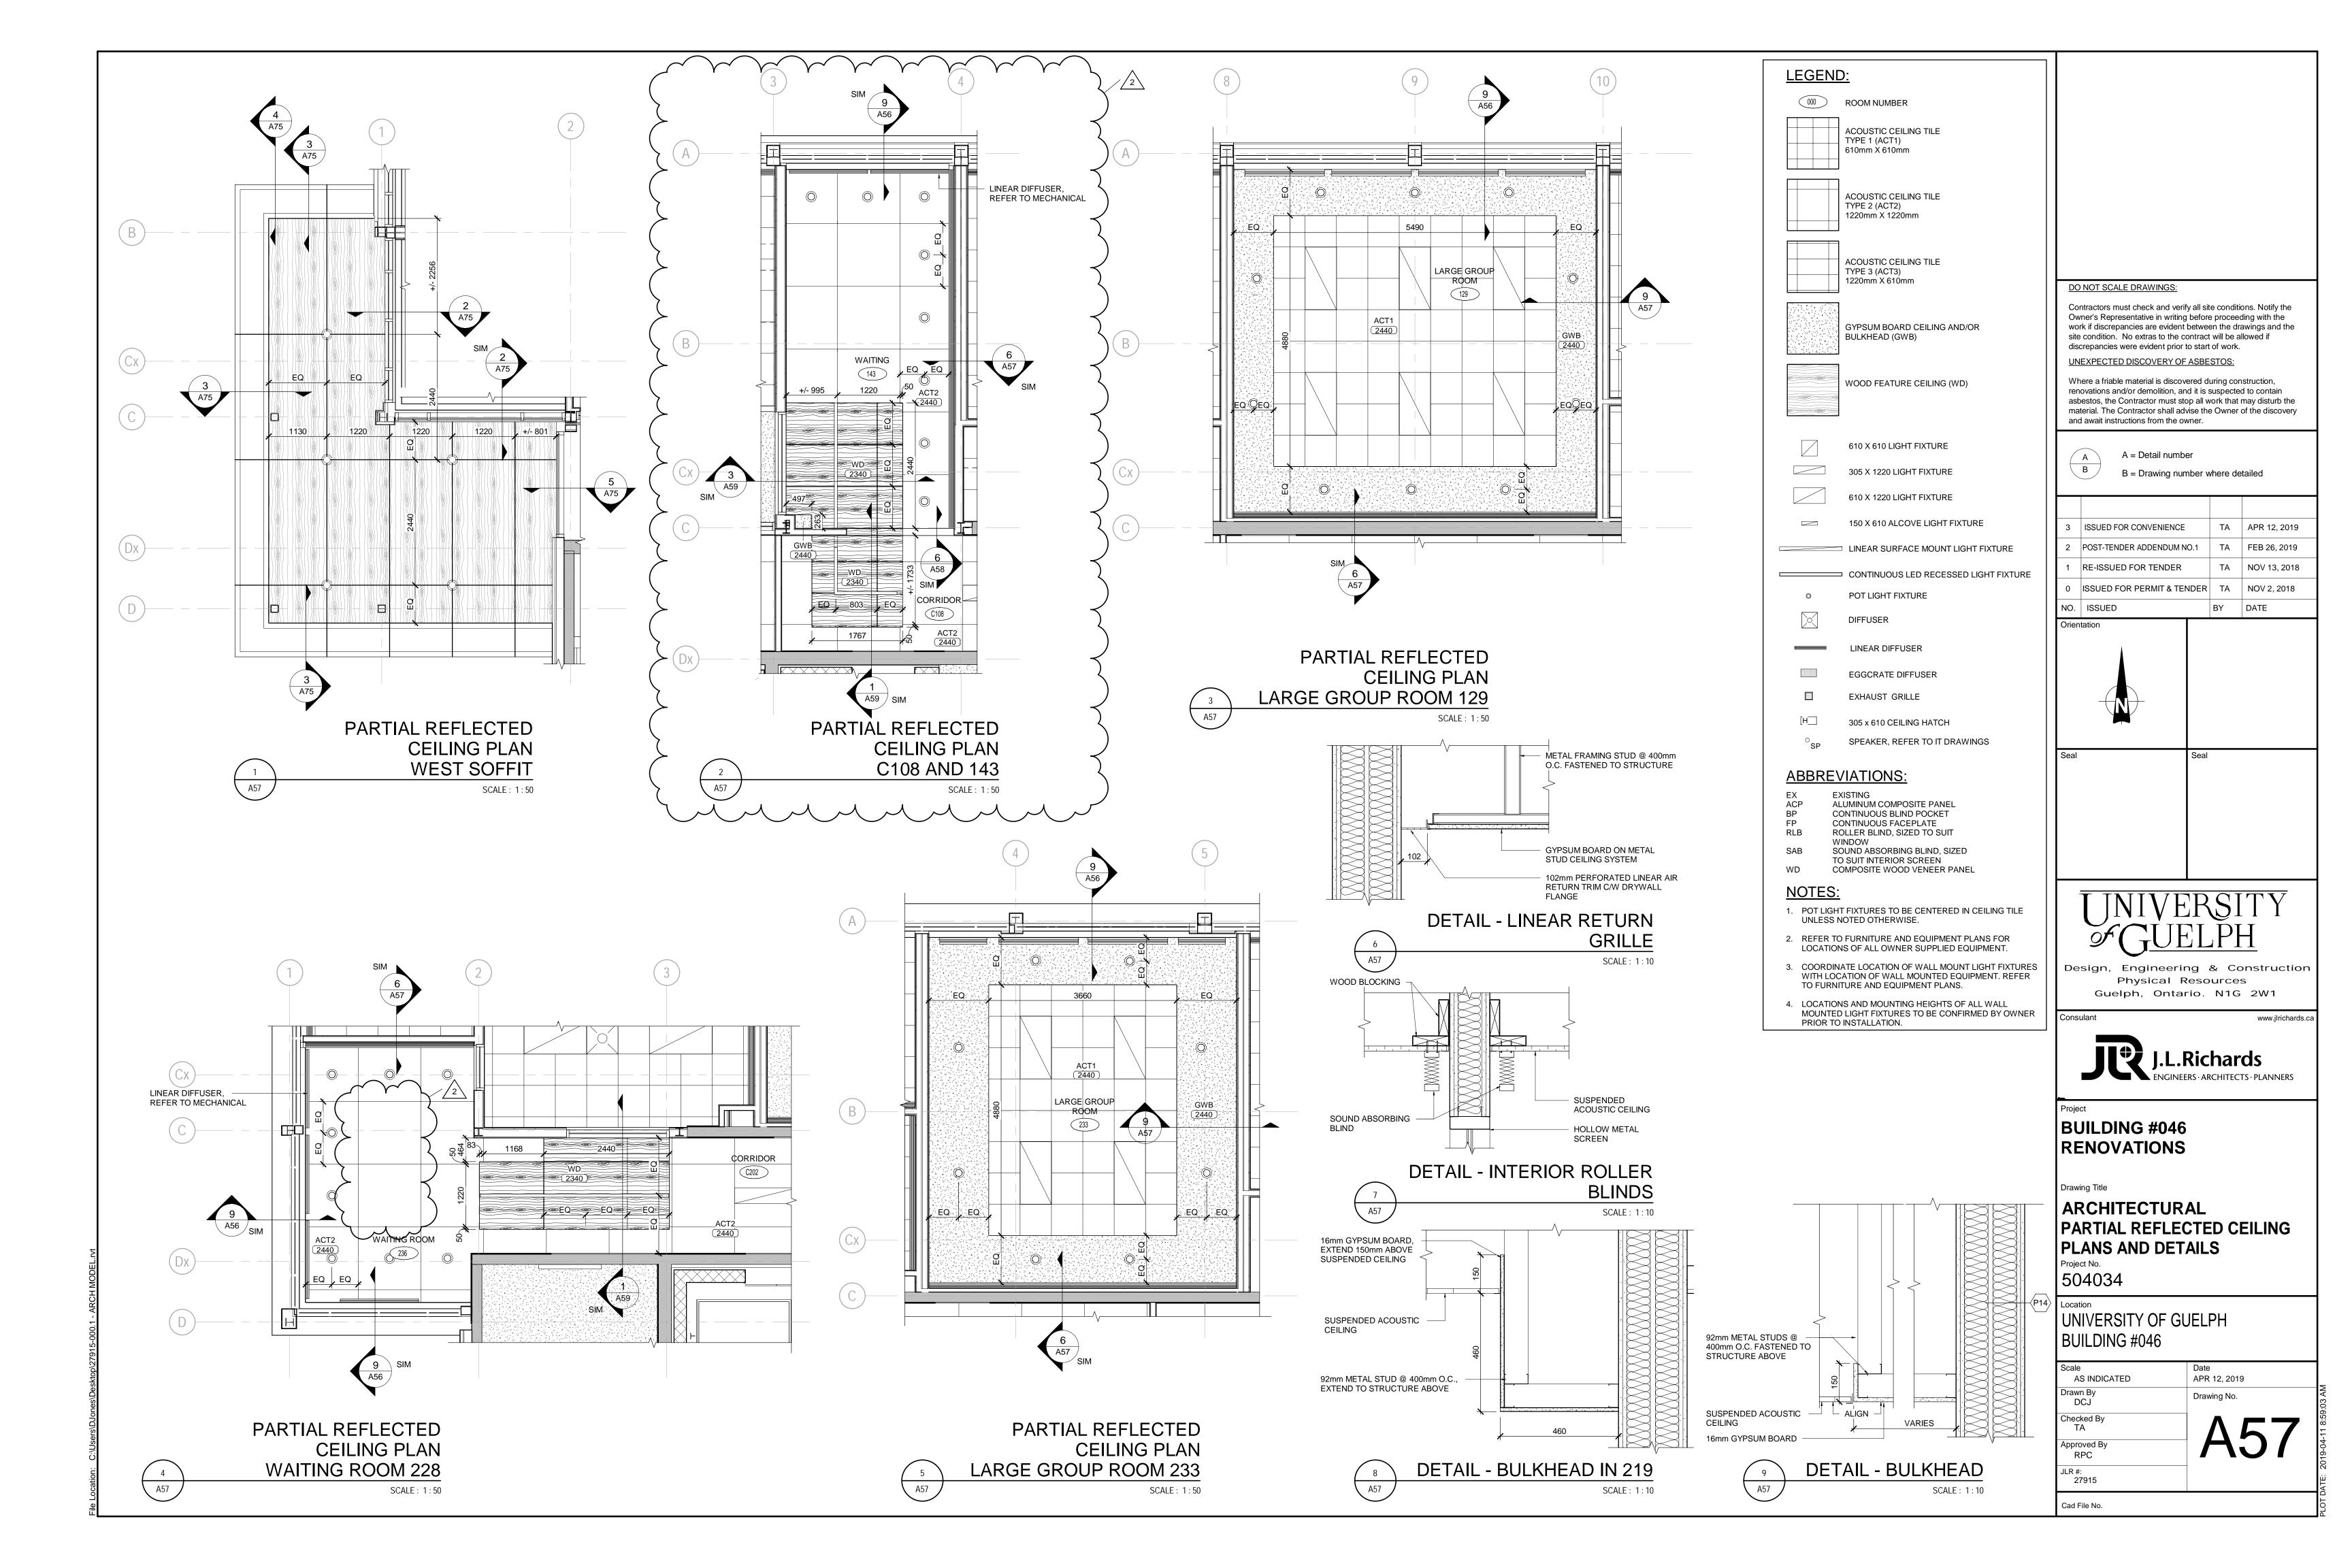
ARCHITECTURAL
ALTERED RCP
PENTHOUSE AND WING C


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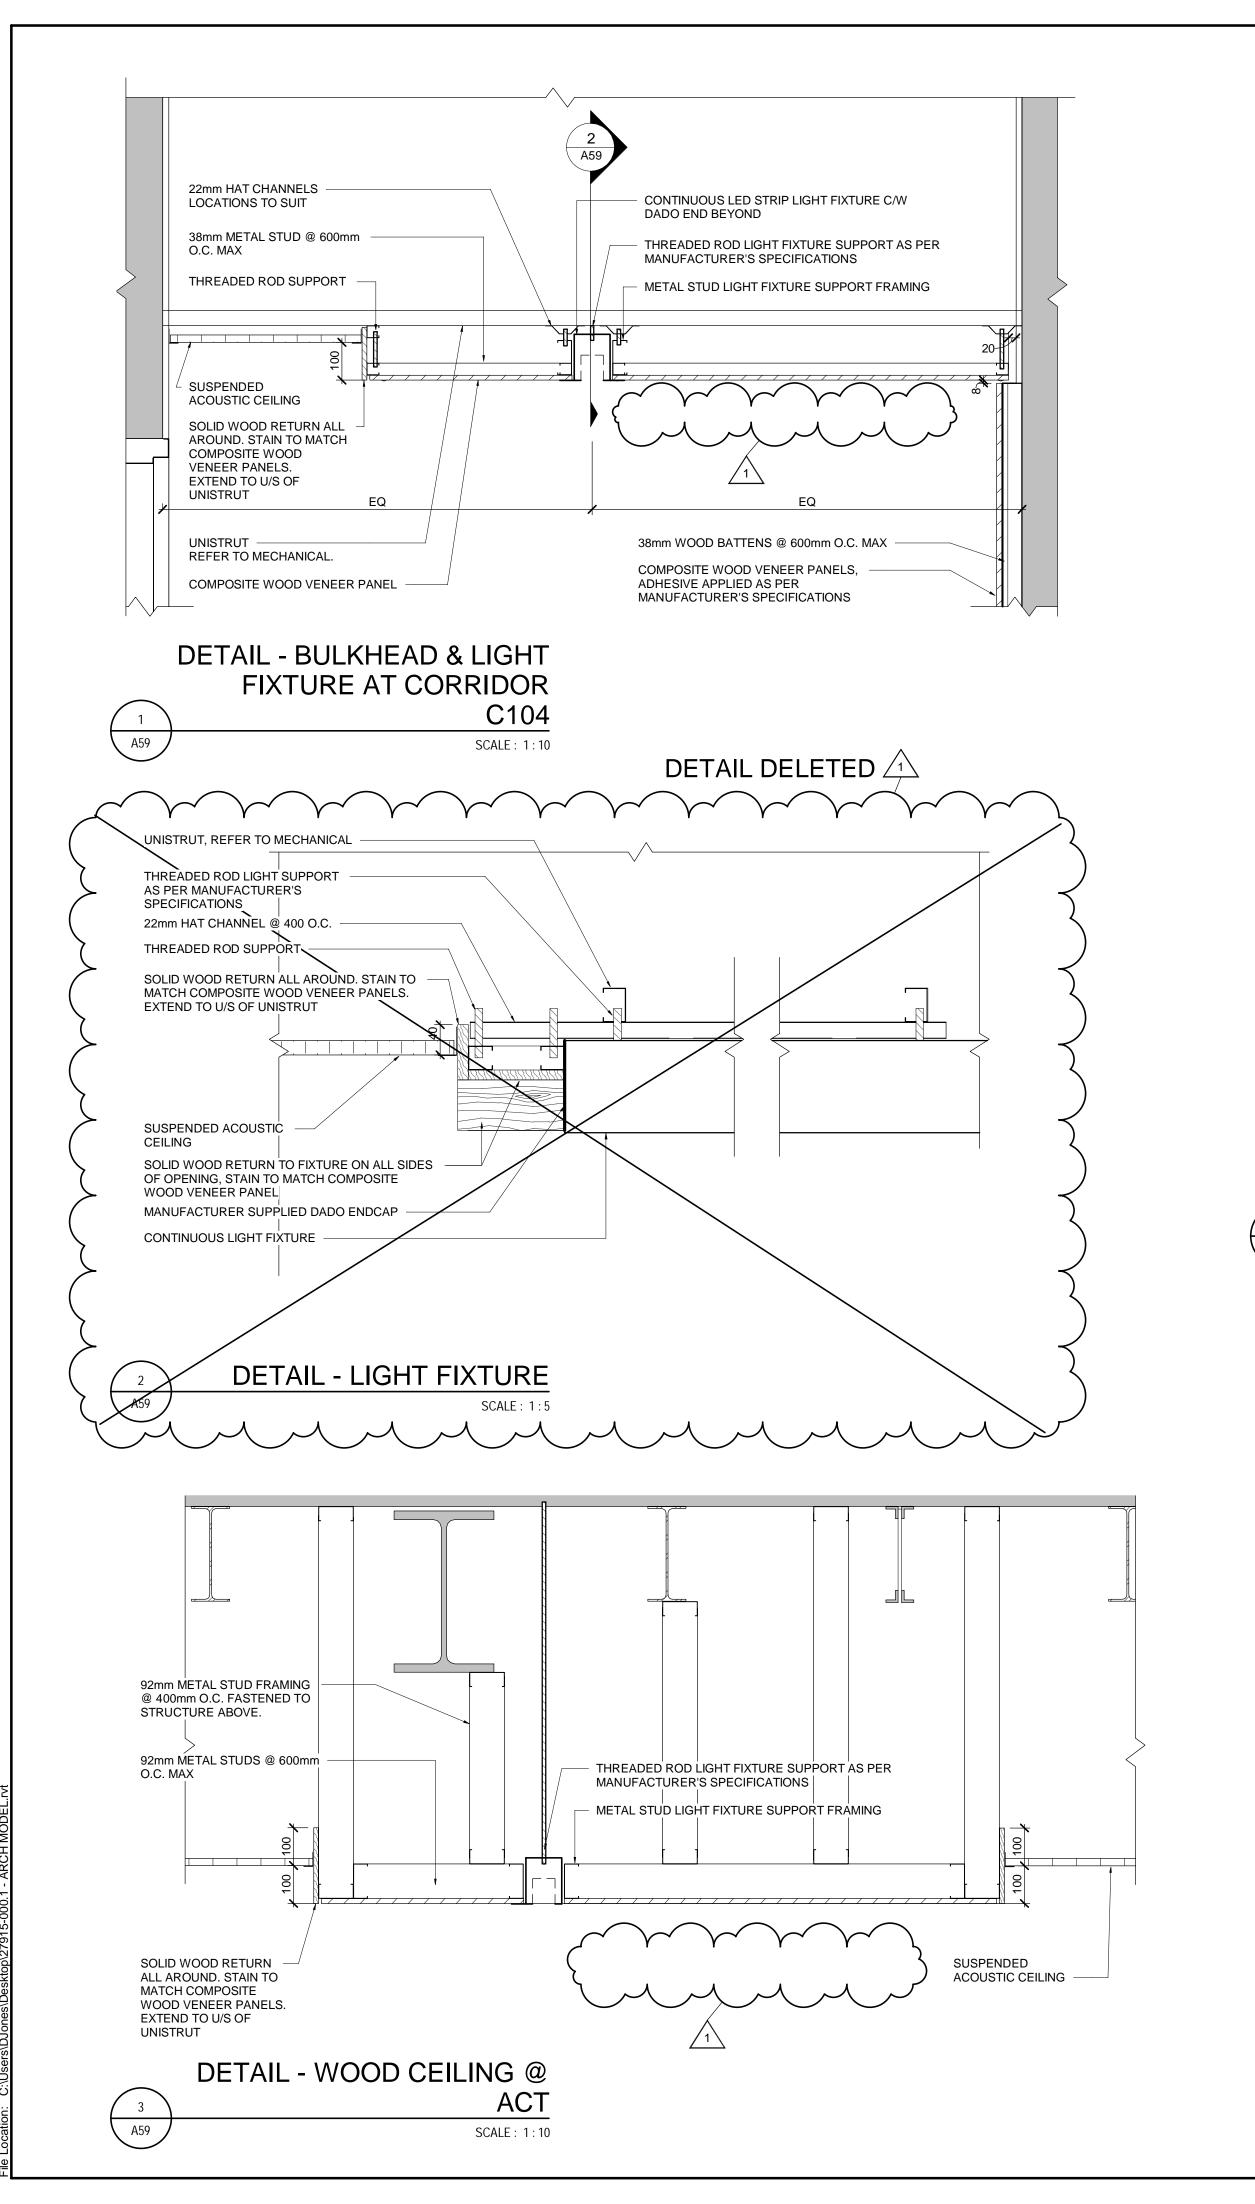
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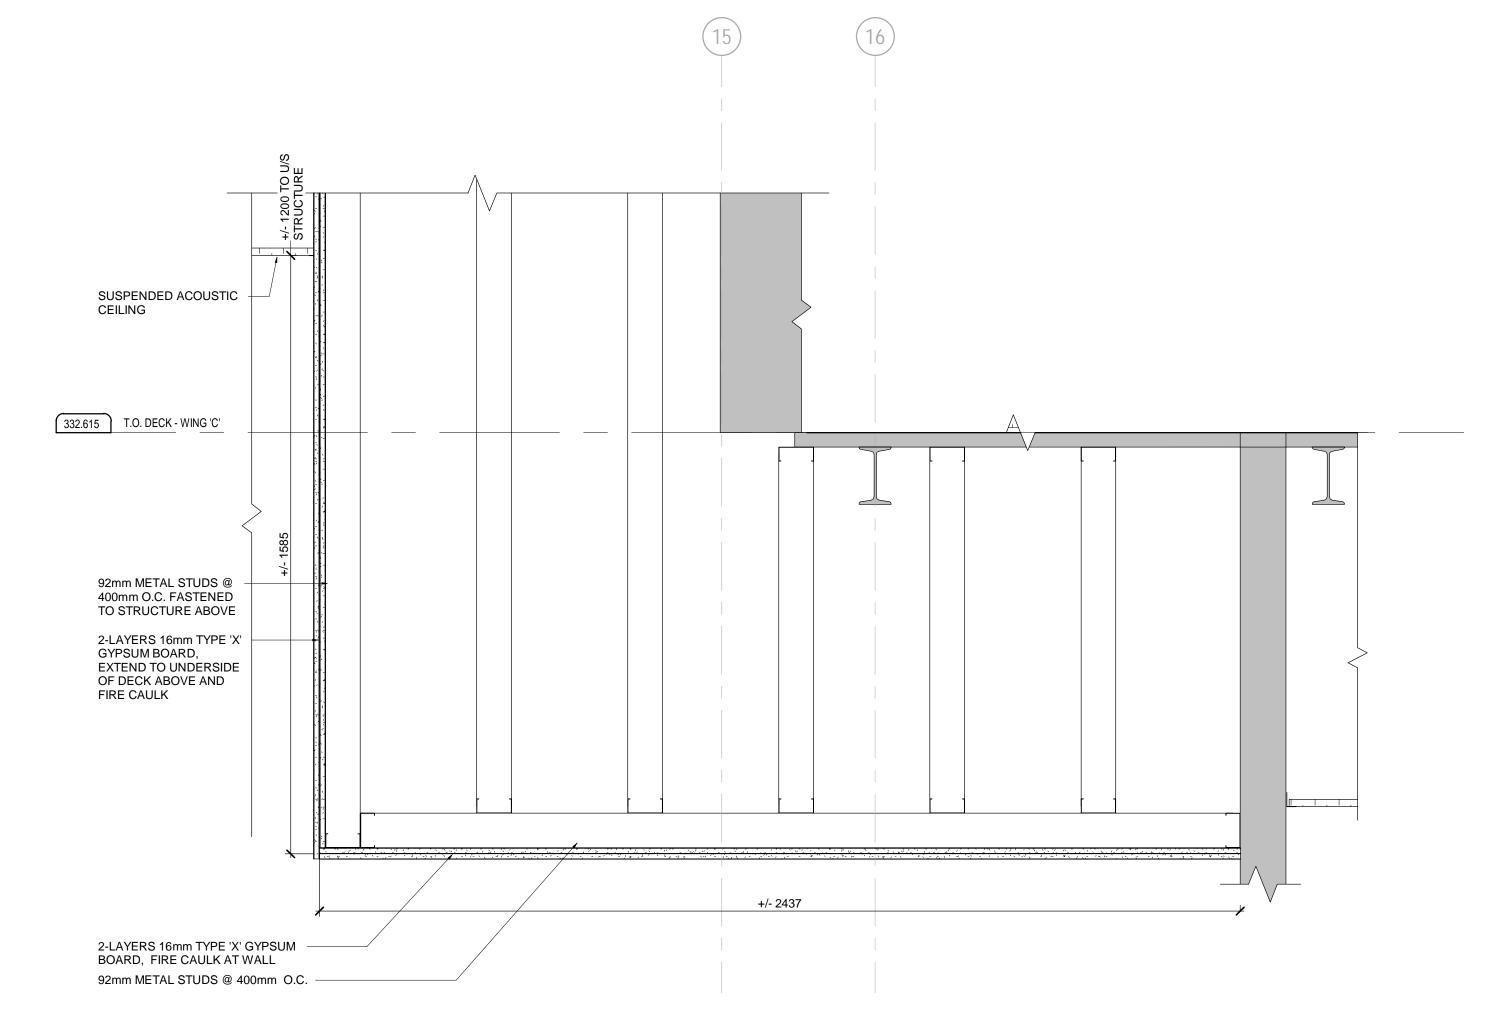
Scale
AS INDICATED
Drawn By
DCJ
Checked By
TA
Approved By
RPC
JLR #:
27915
Cad File No.







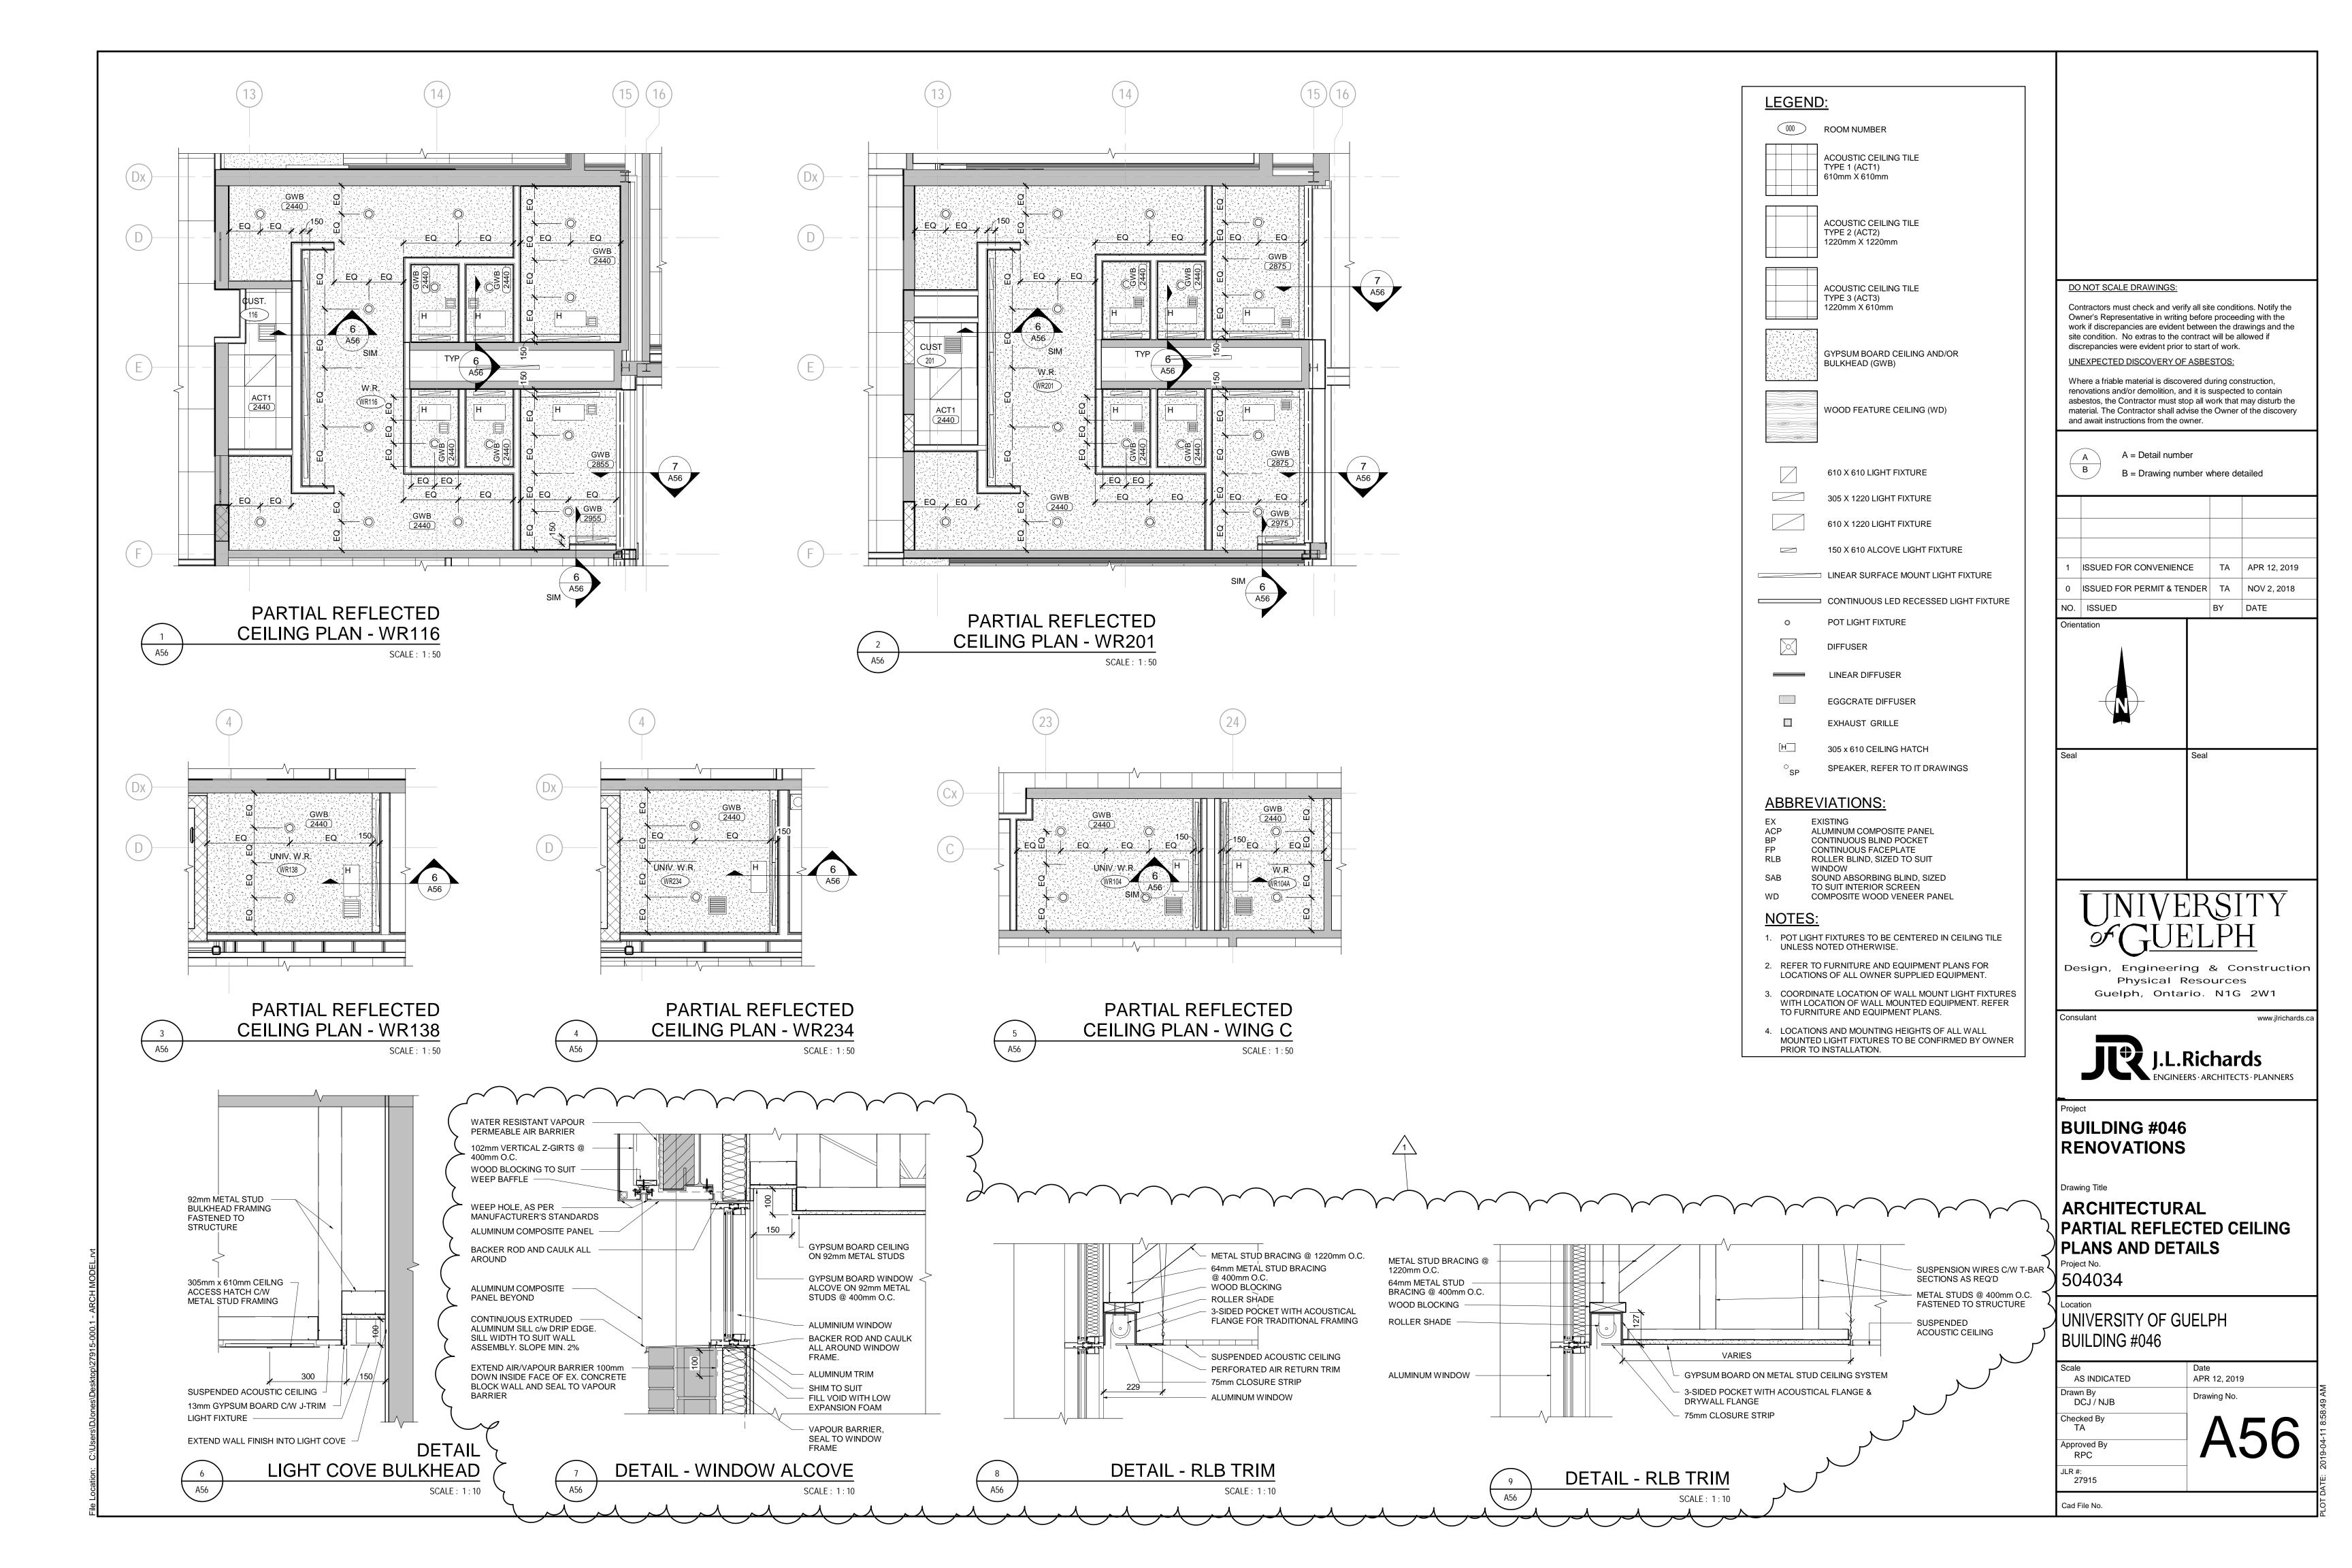

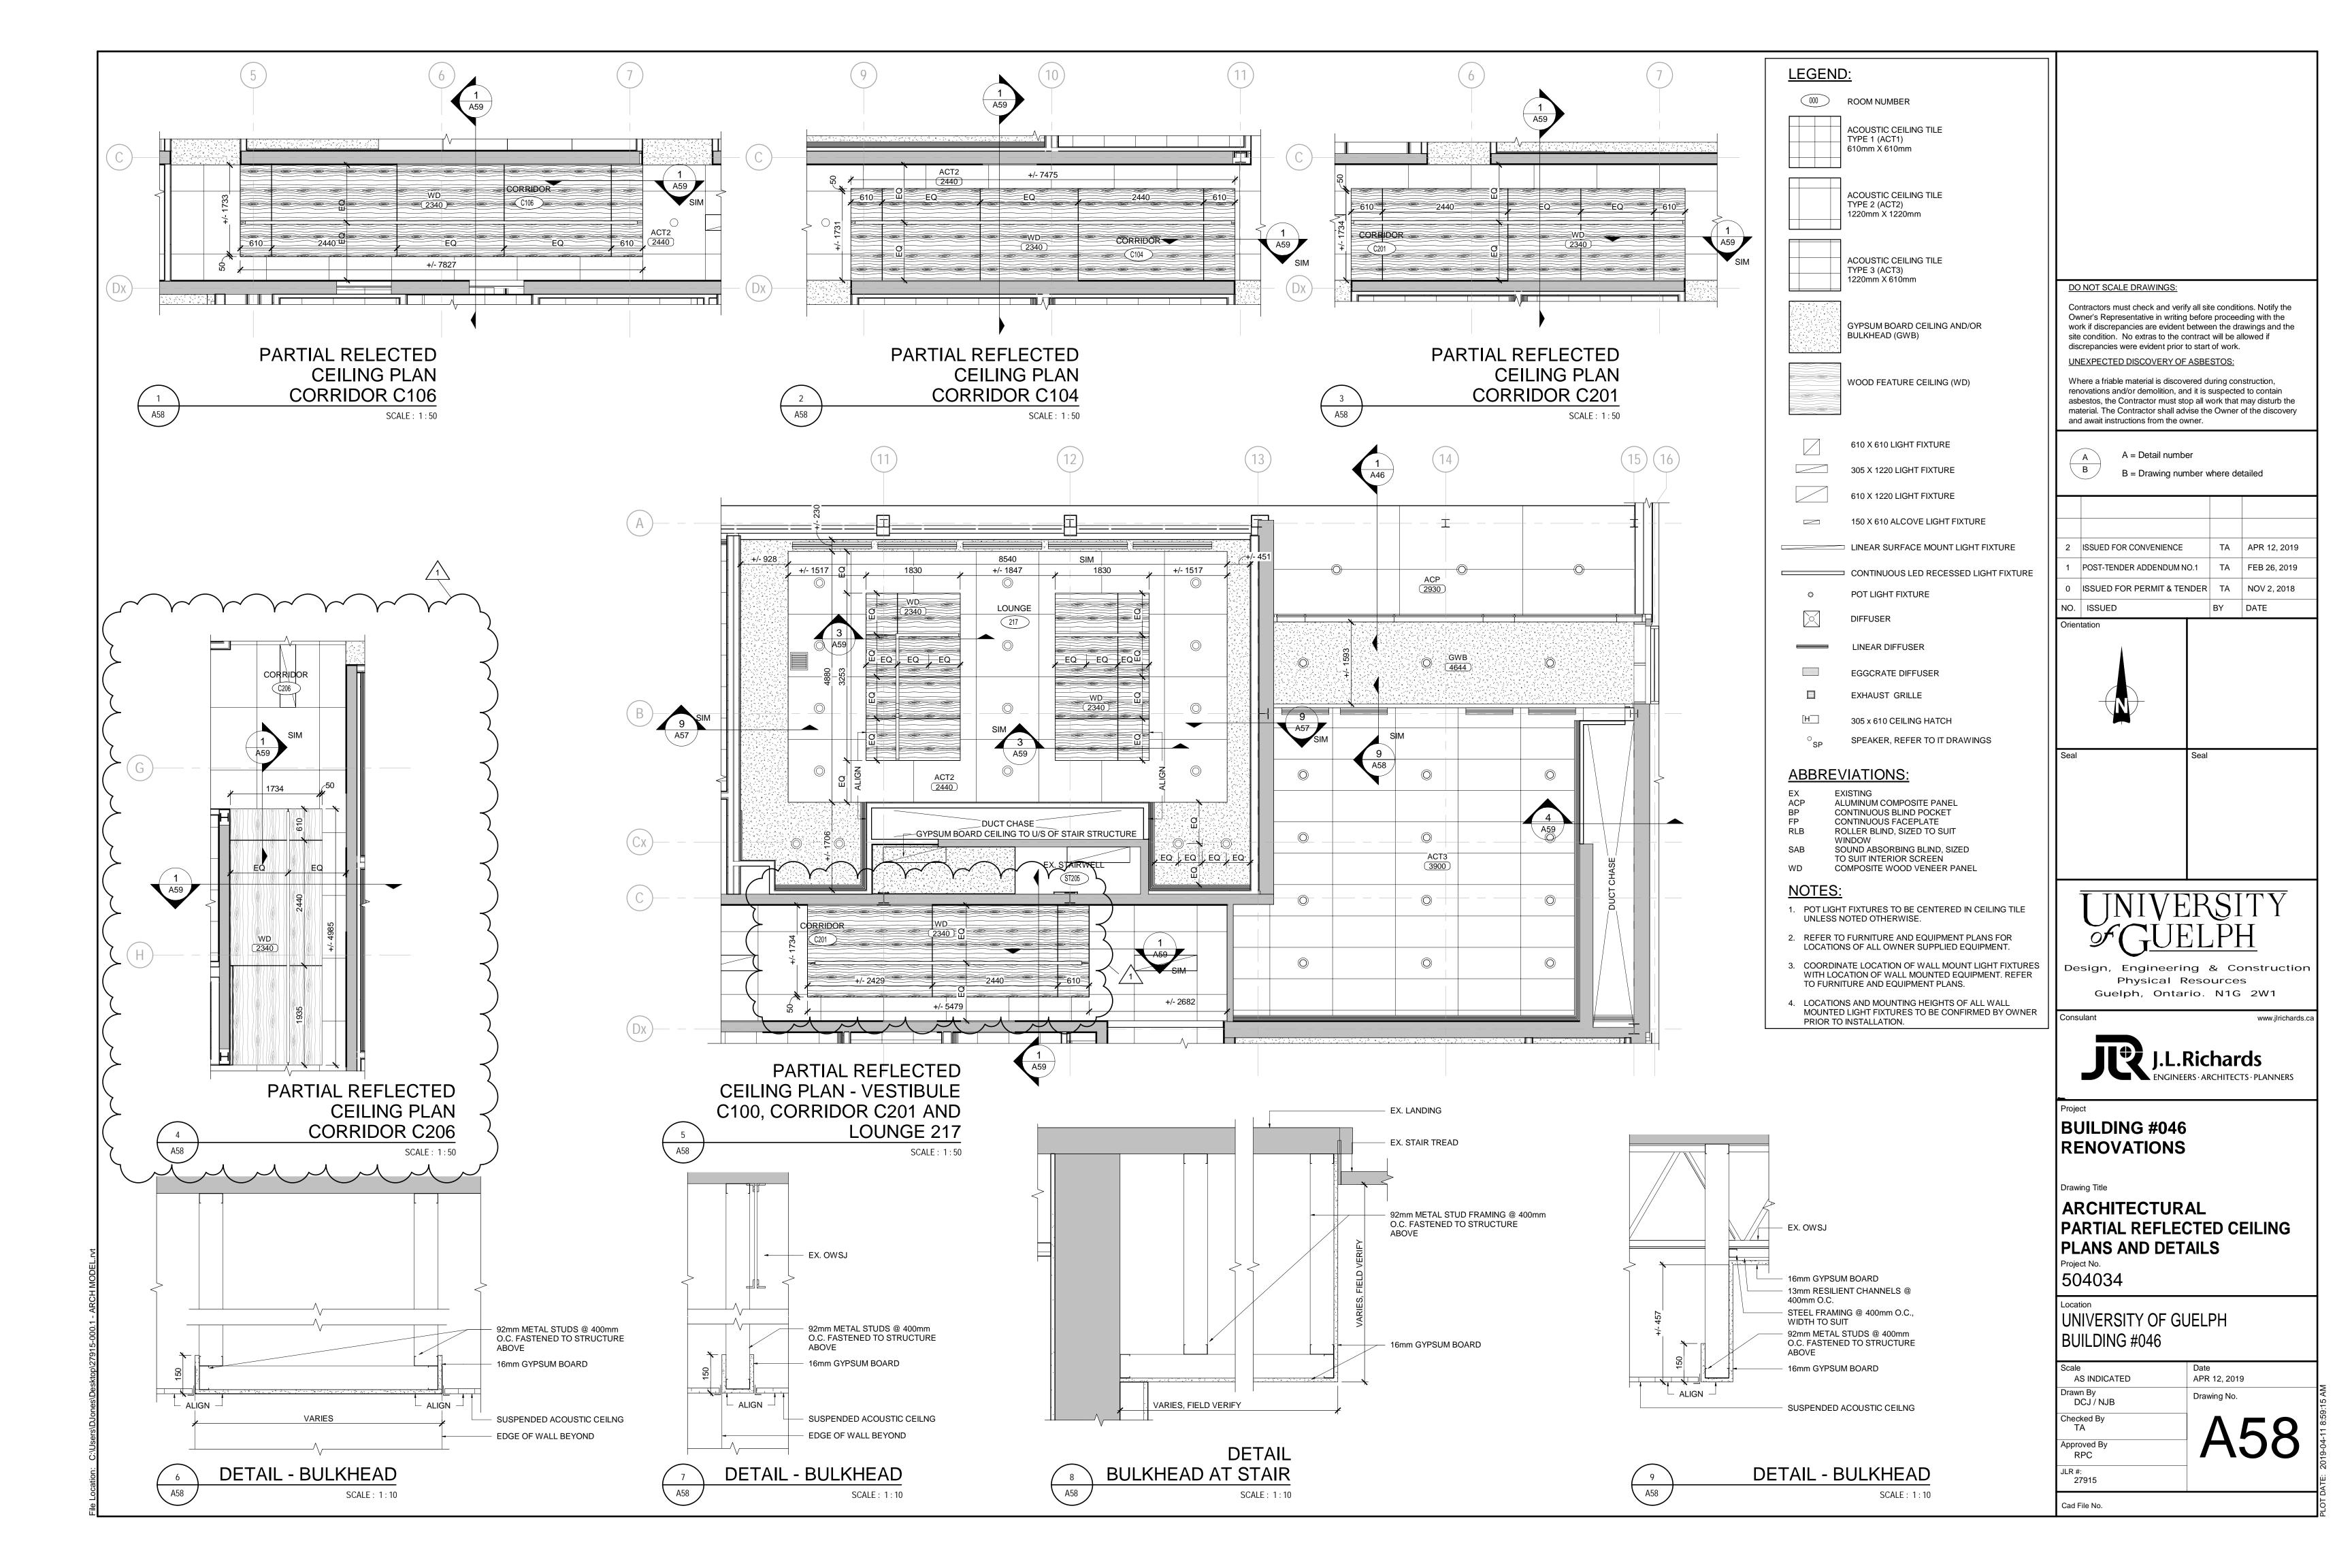

DETAIL - BULKHEAD AT

A59

LOBBY

SCALE: 1:10

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AB

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NO. ISSUED BY DATE

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Consulant



Project

BUILDING #046 RENOVATIONS

Drawing Title

ARCHITECTURAL
CEILING AND BULKHEAD
DETAILS

Project No. **504034**

UNIVERSITY OF GUELPH BUILDING #046

AS INDICATED


Drawn By
DCJ / NJB


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TA


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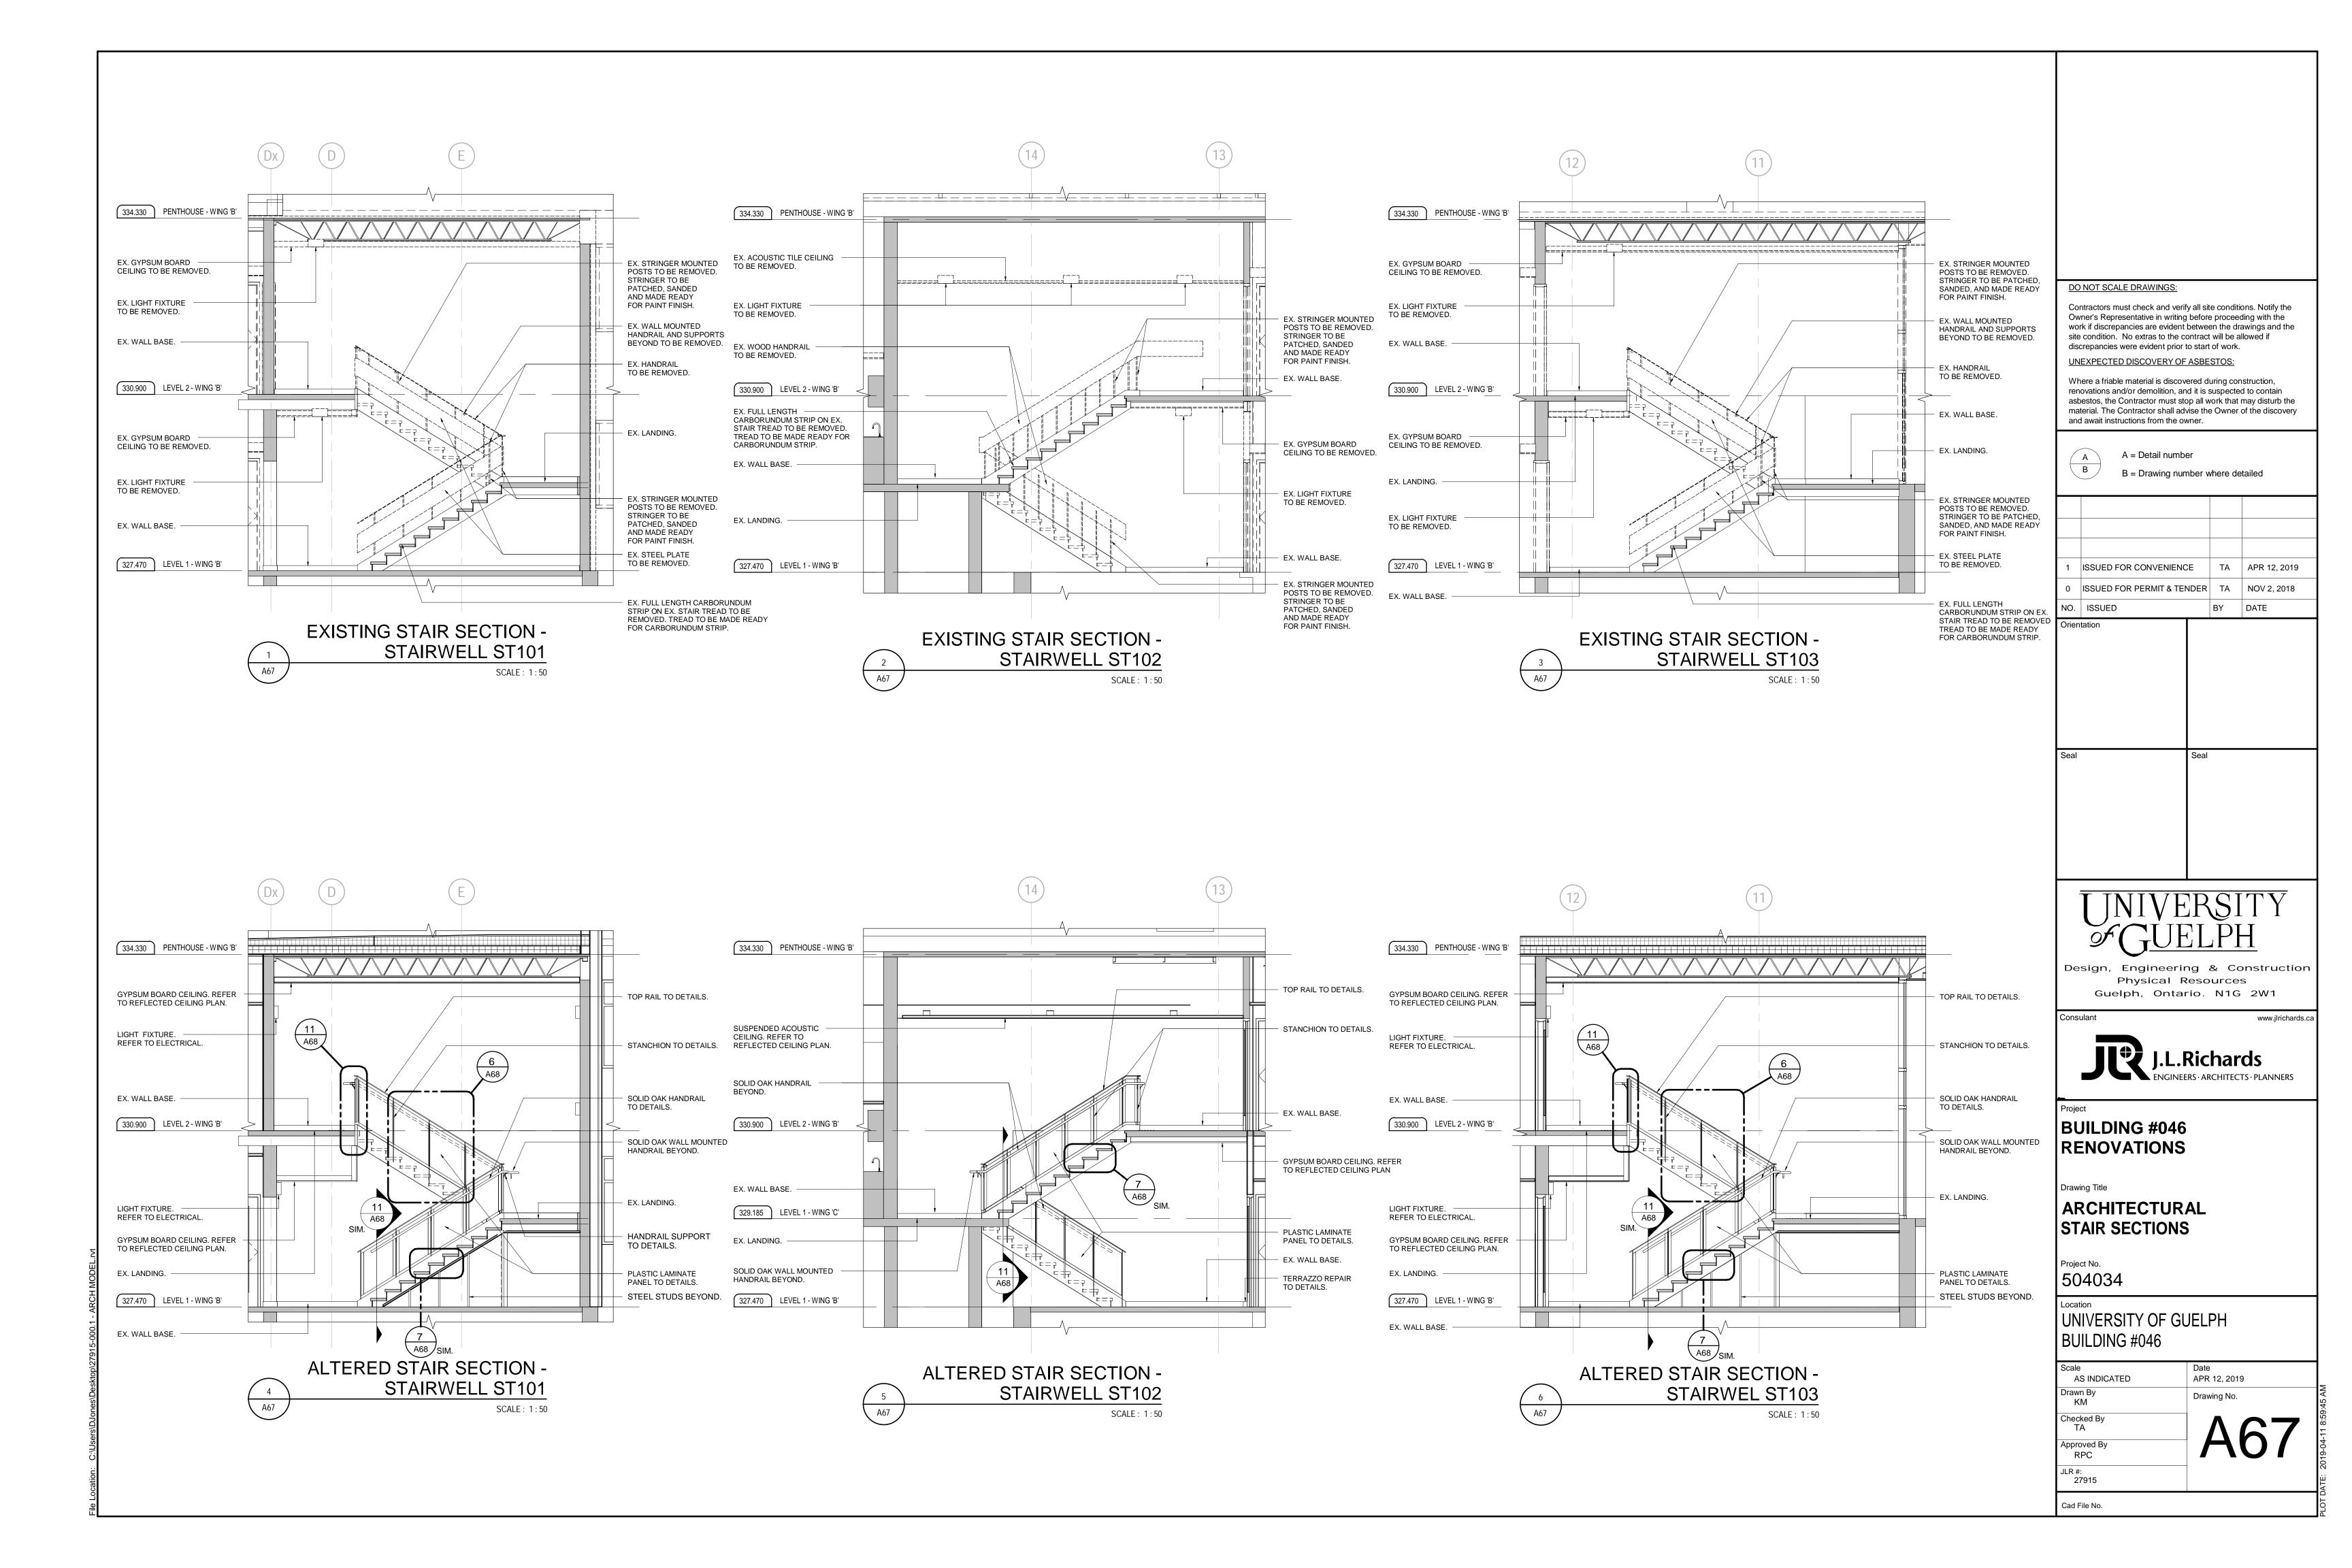
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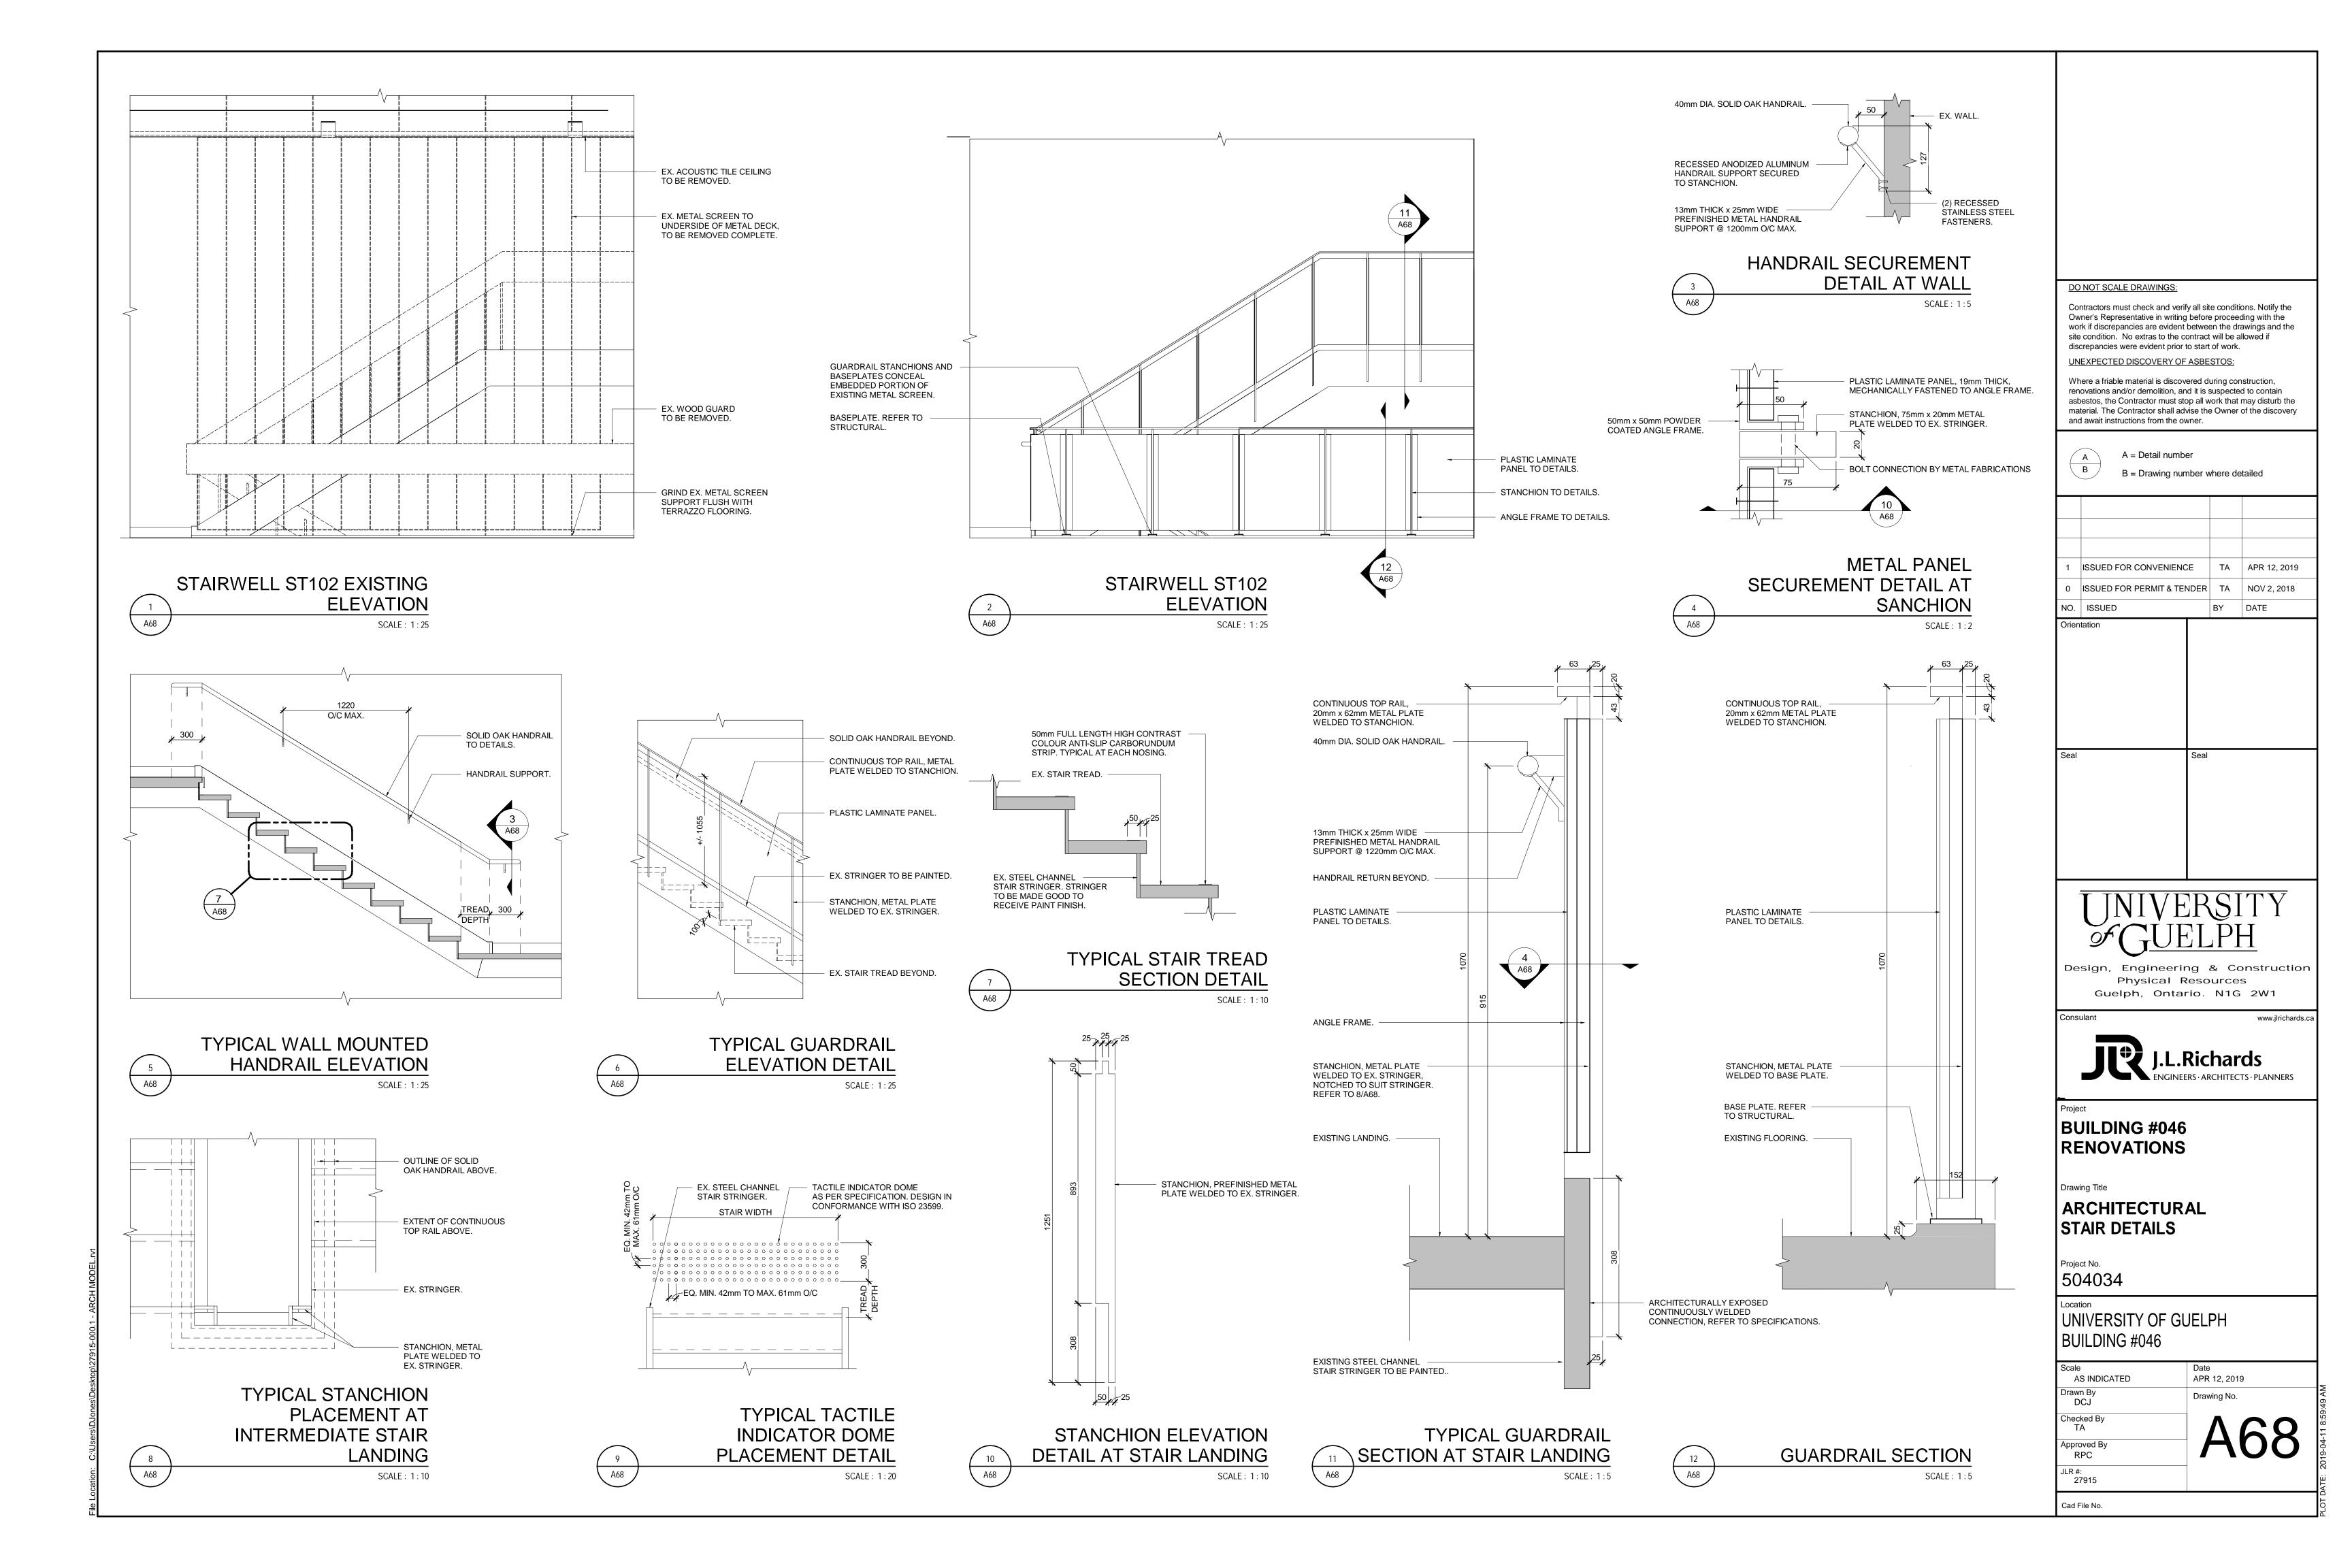
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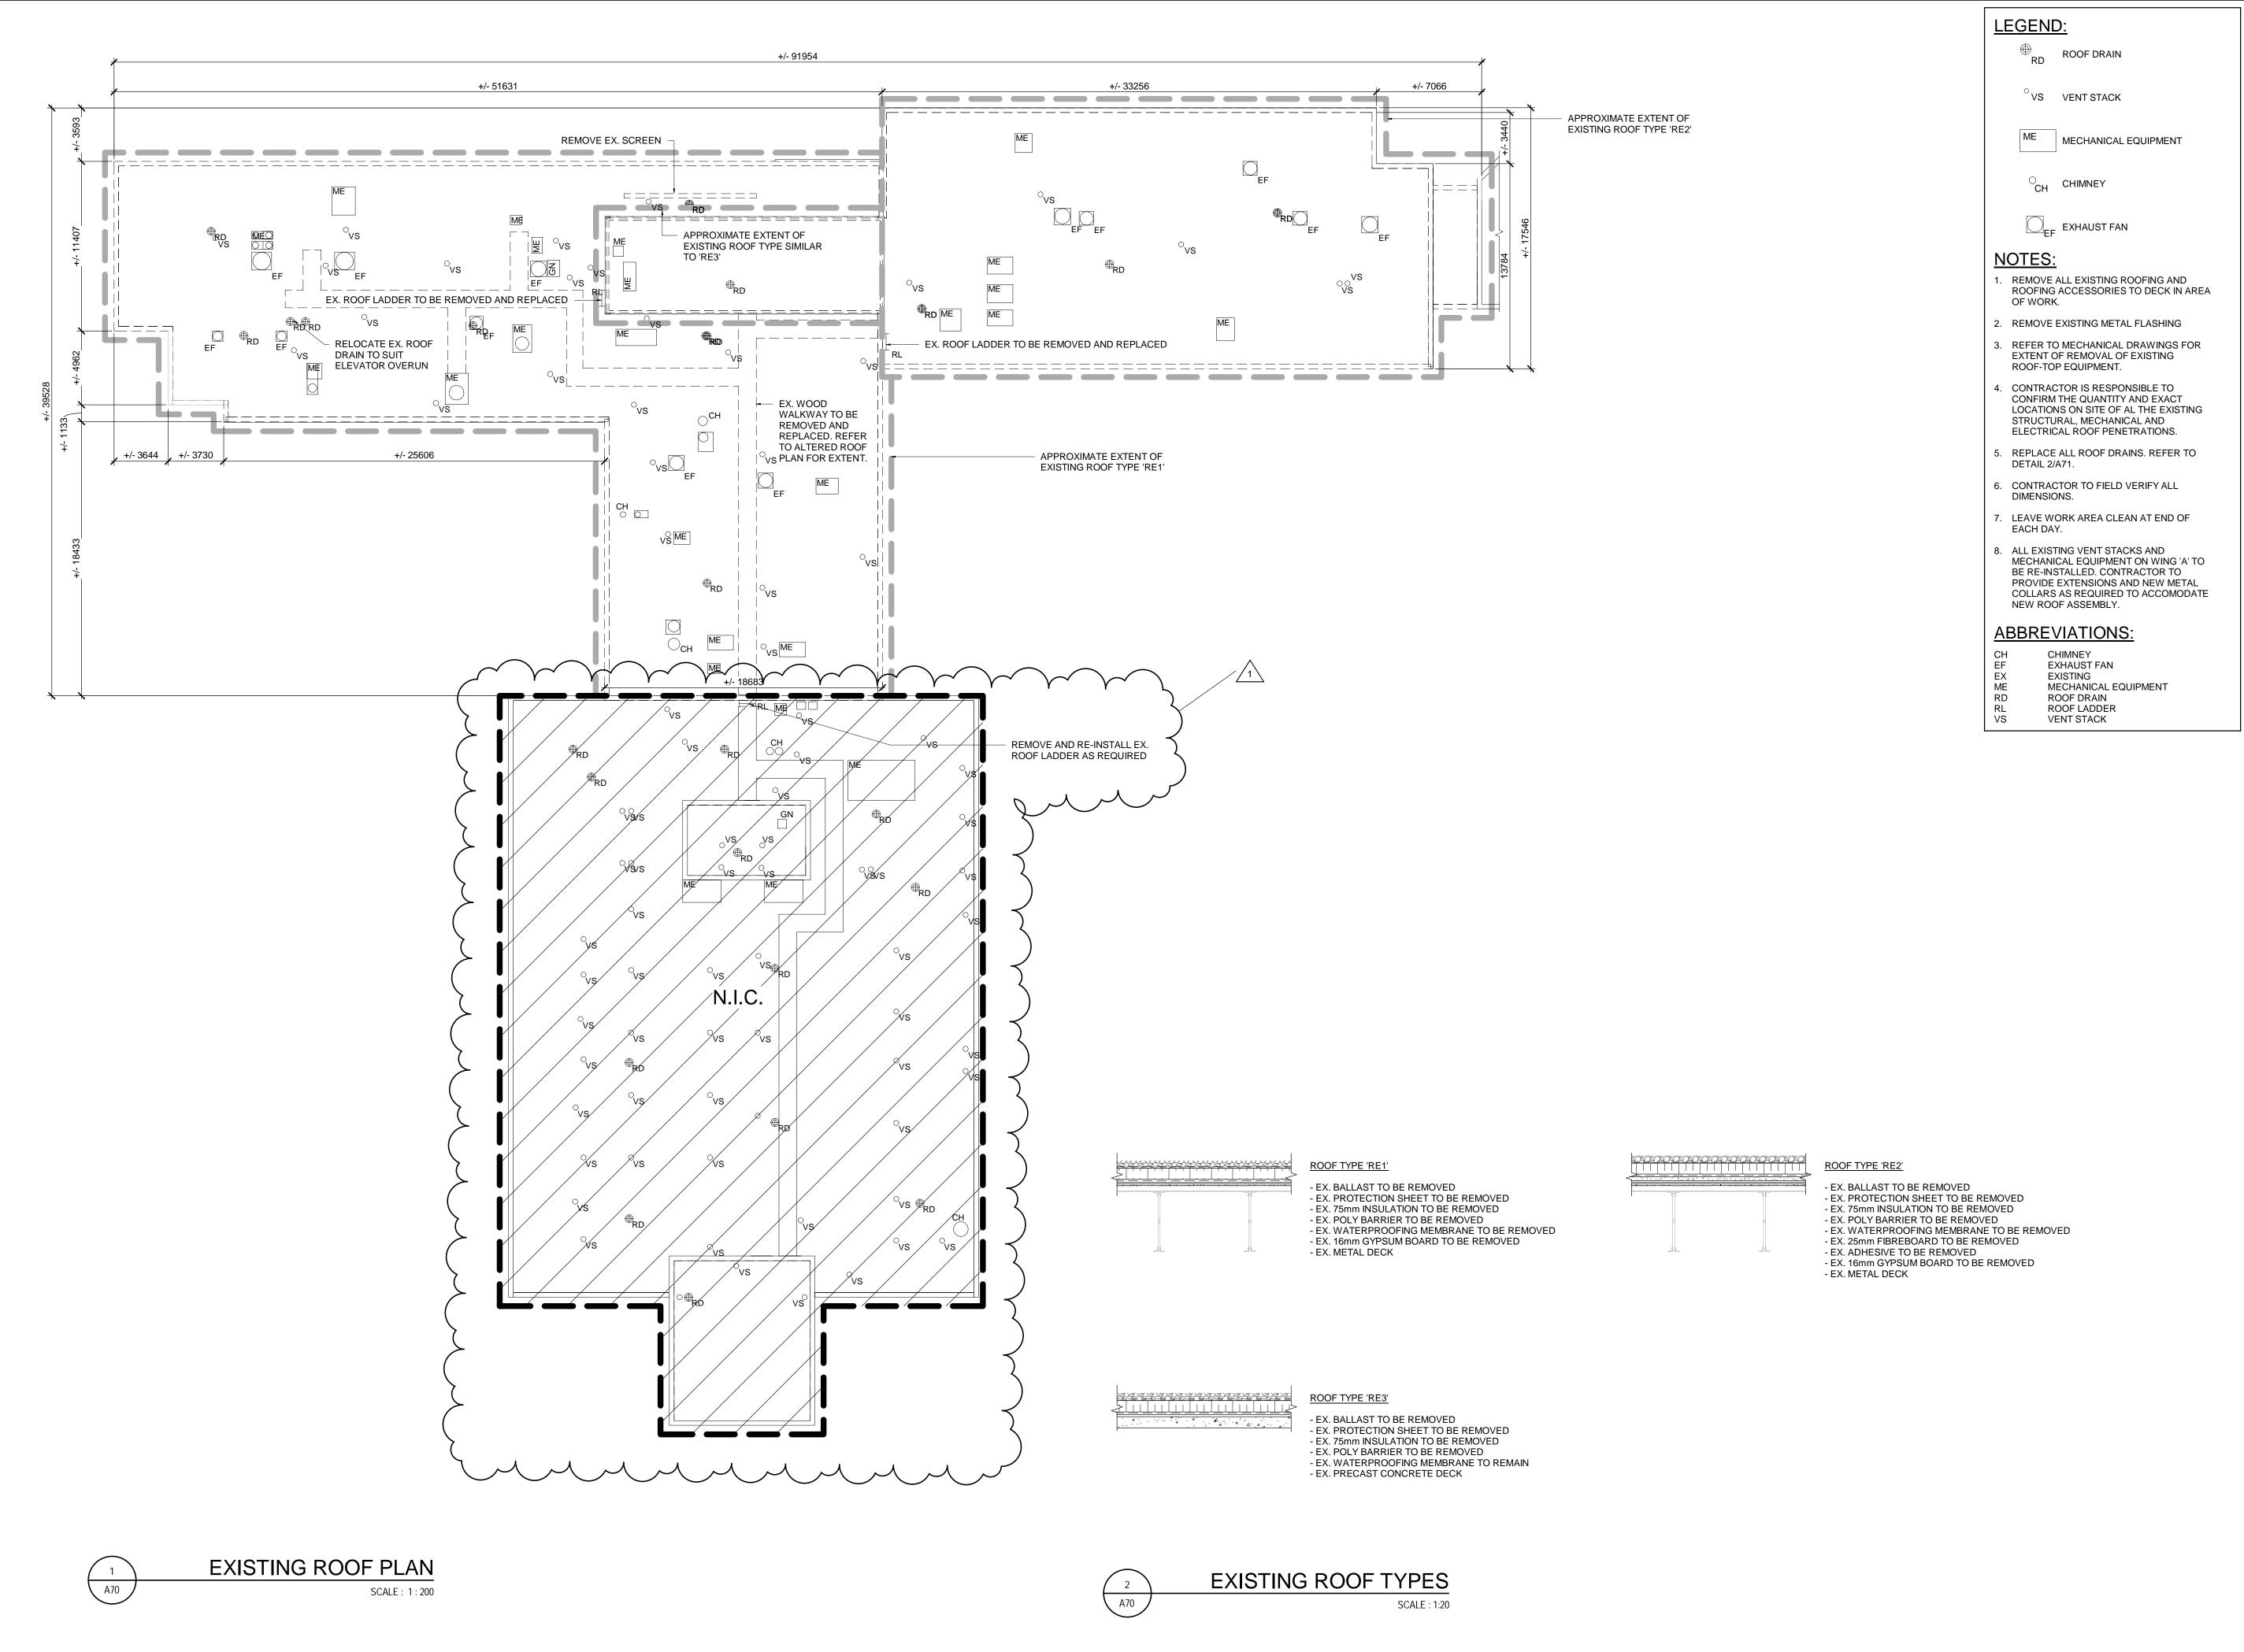






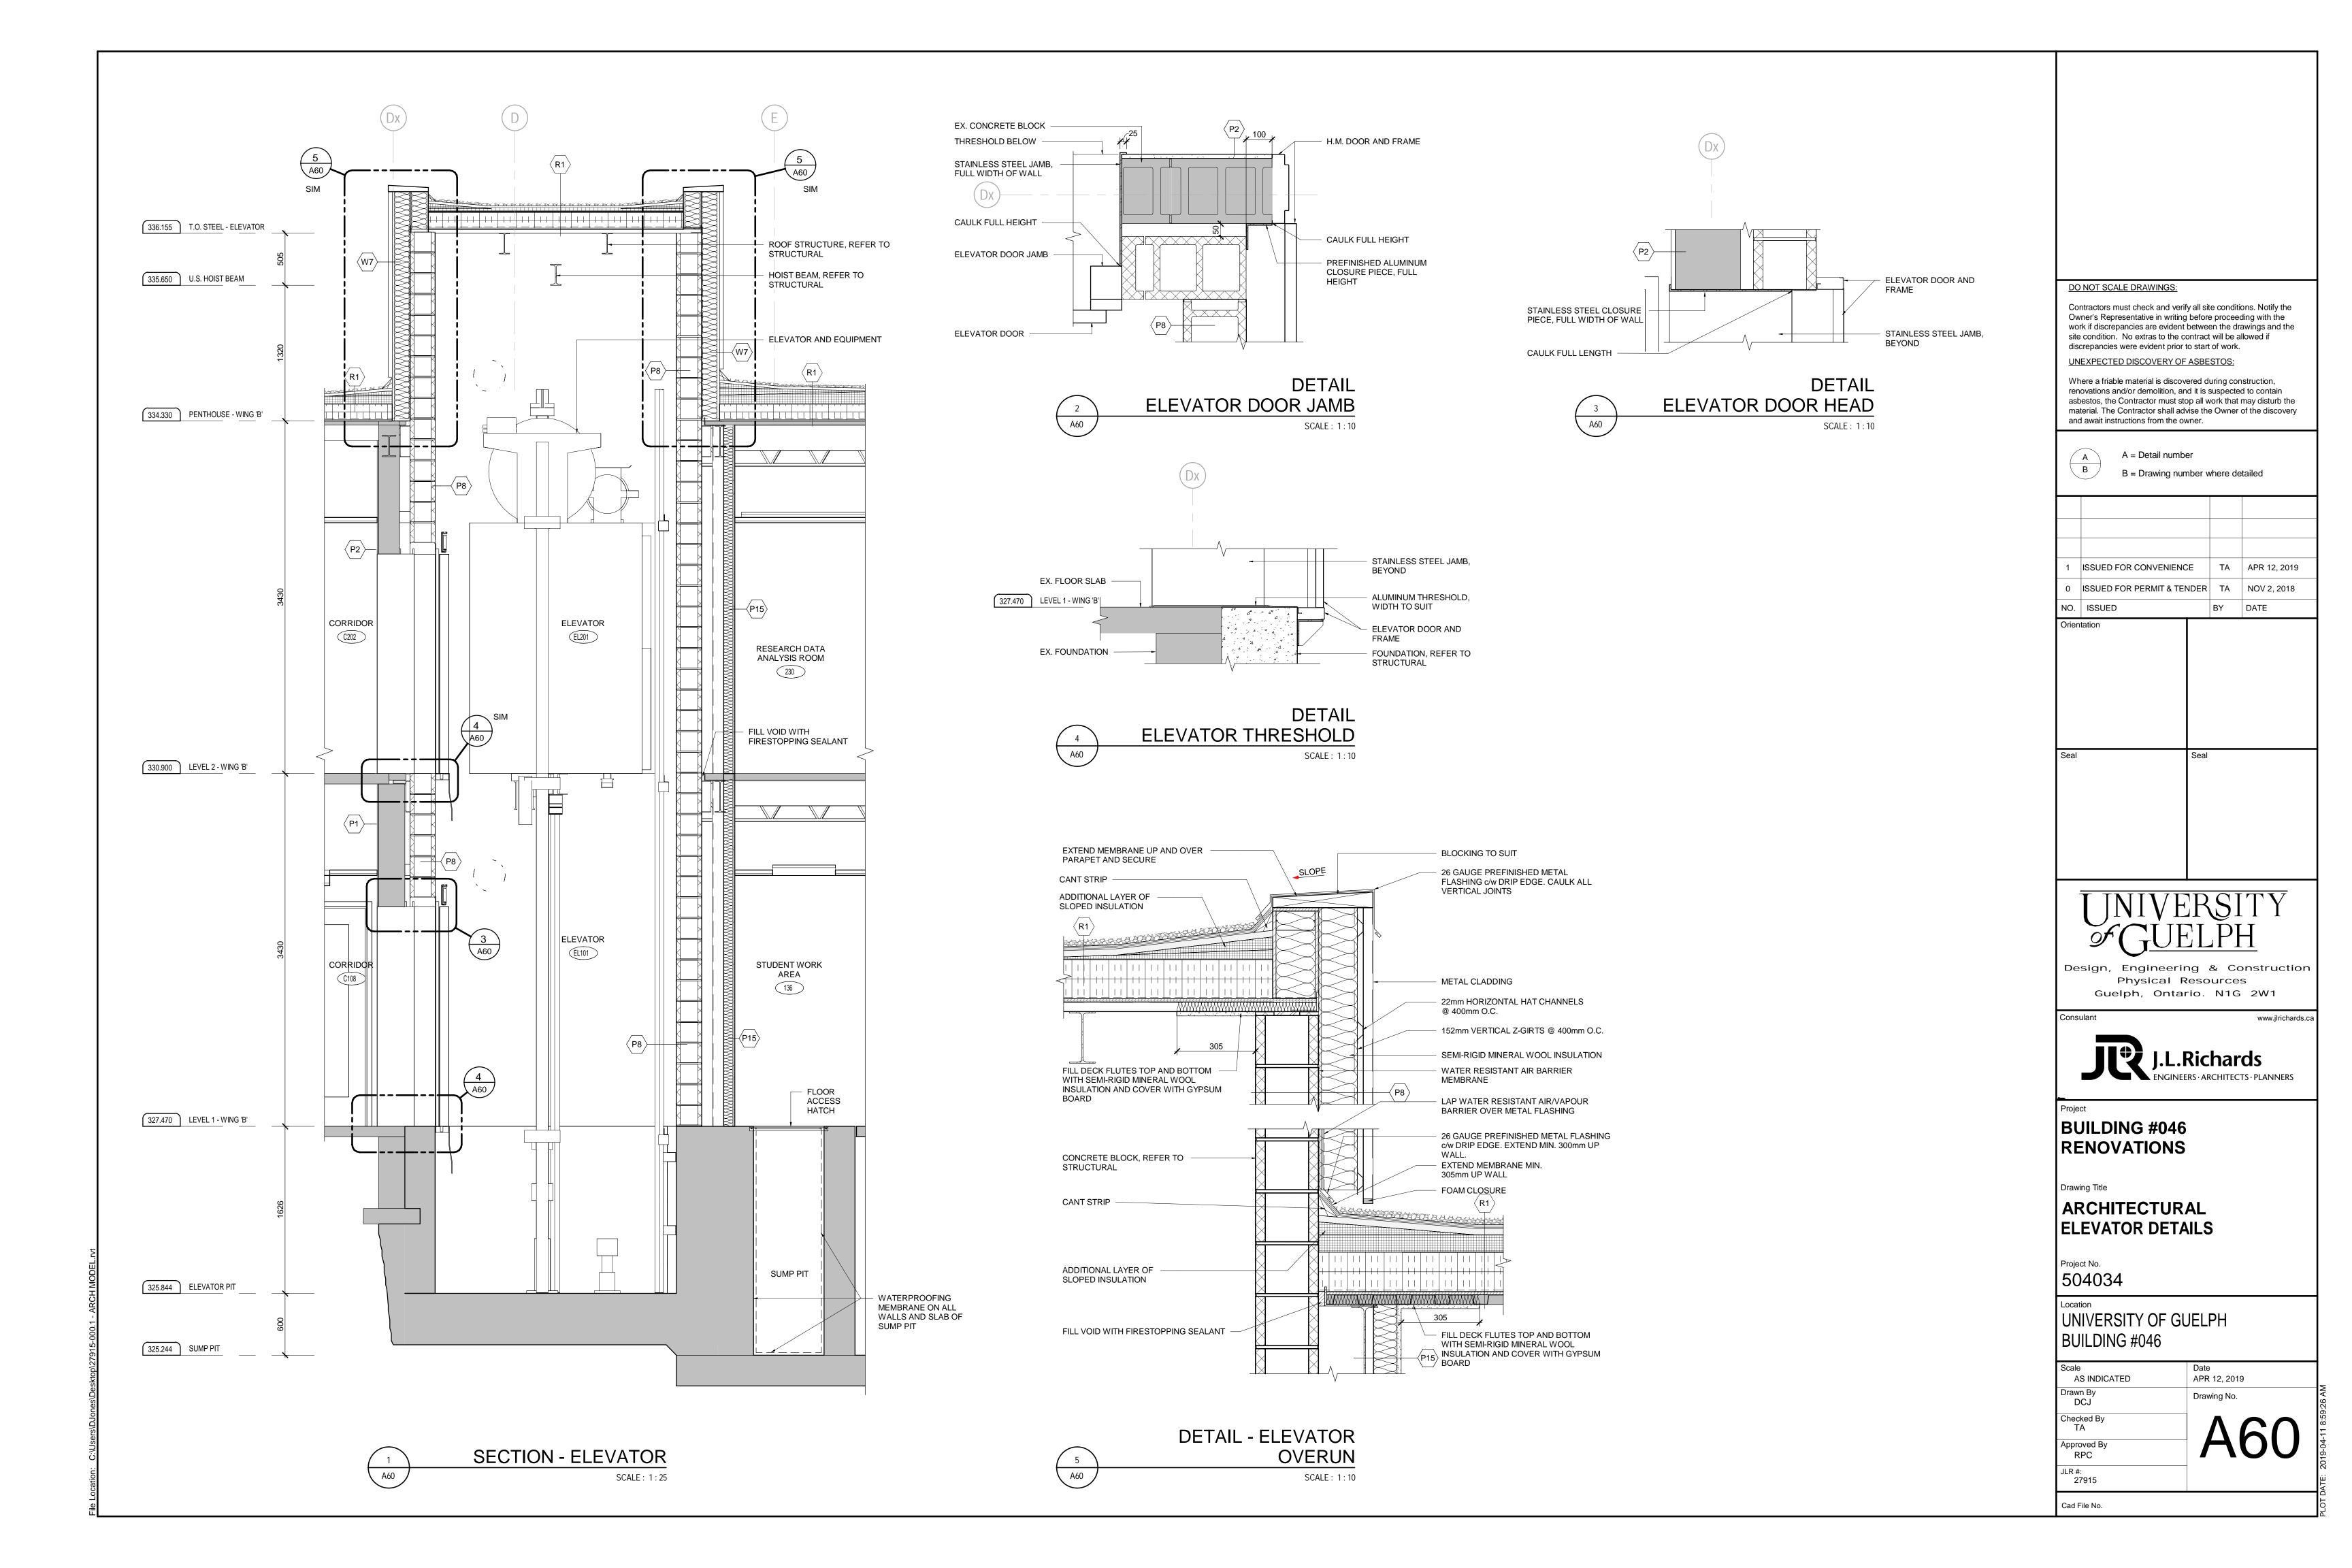

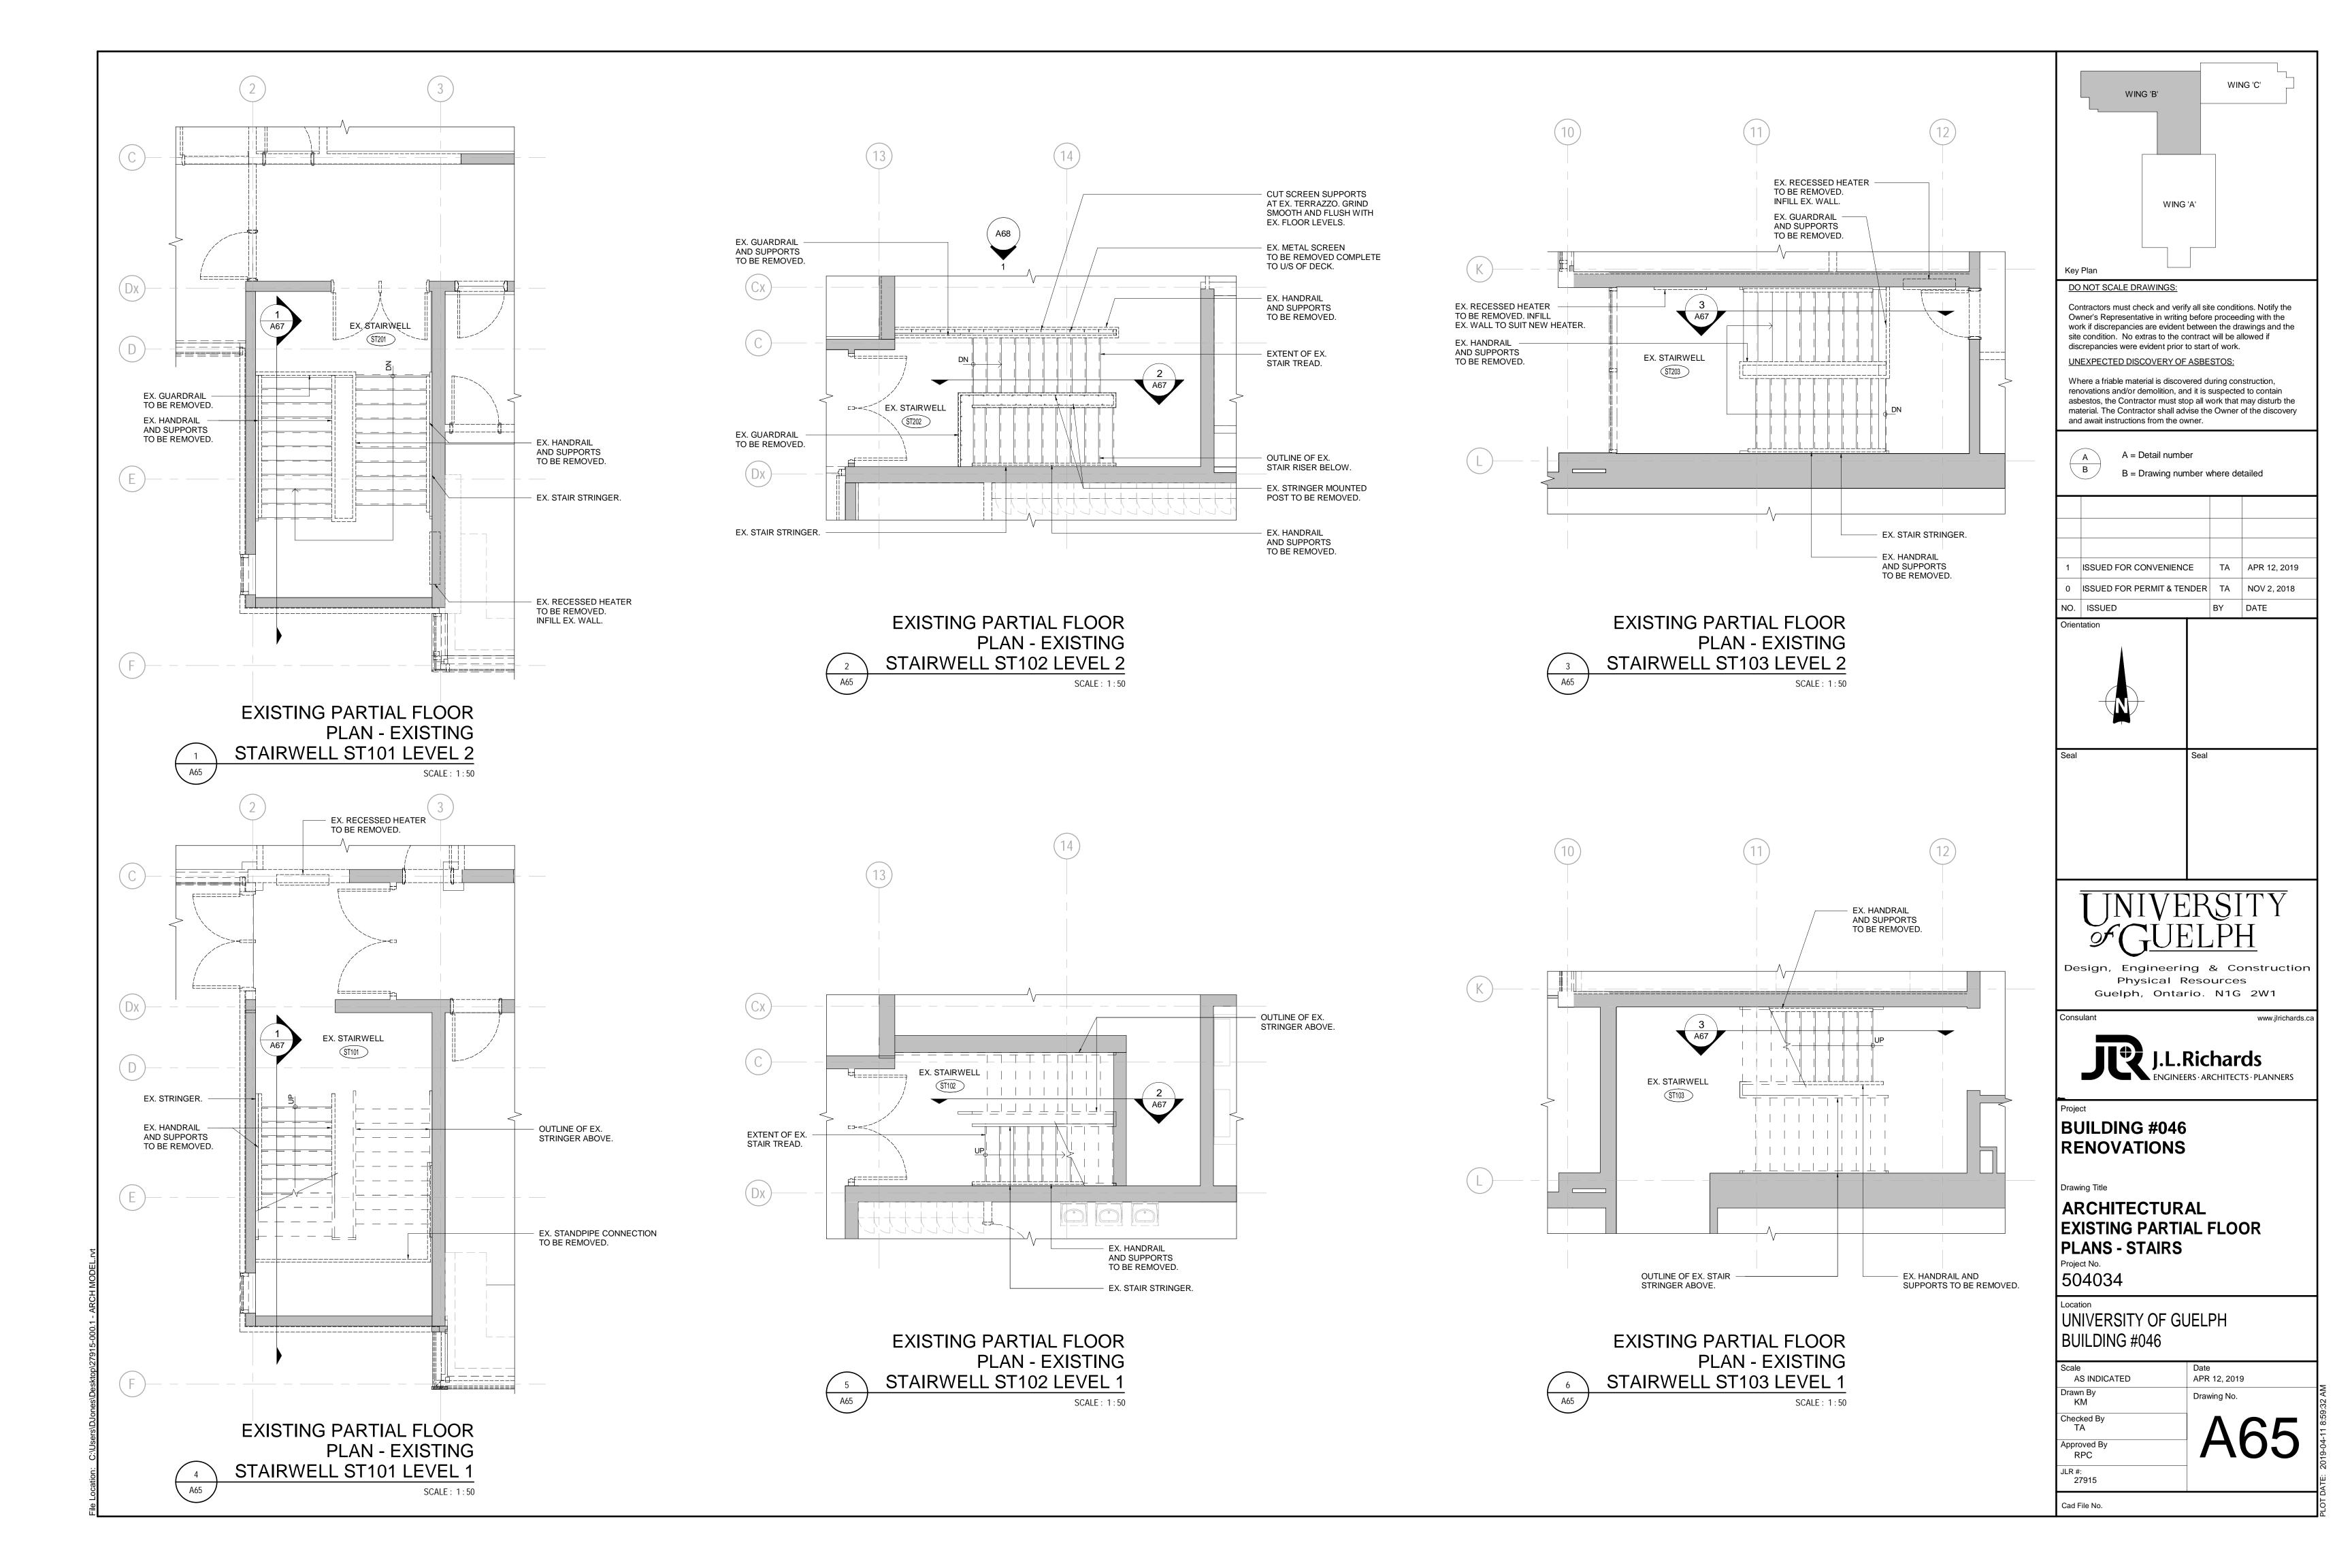

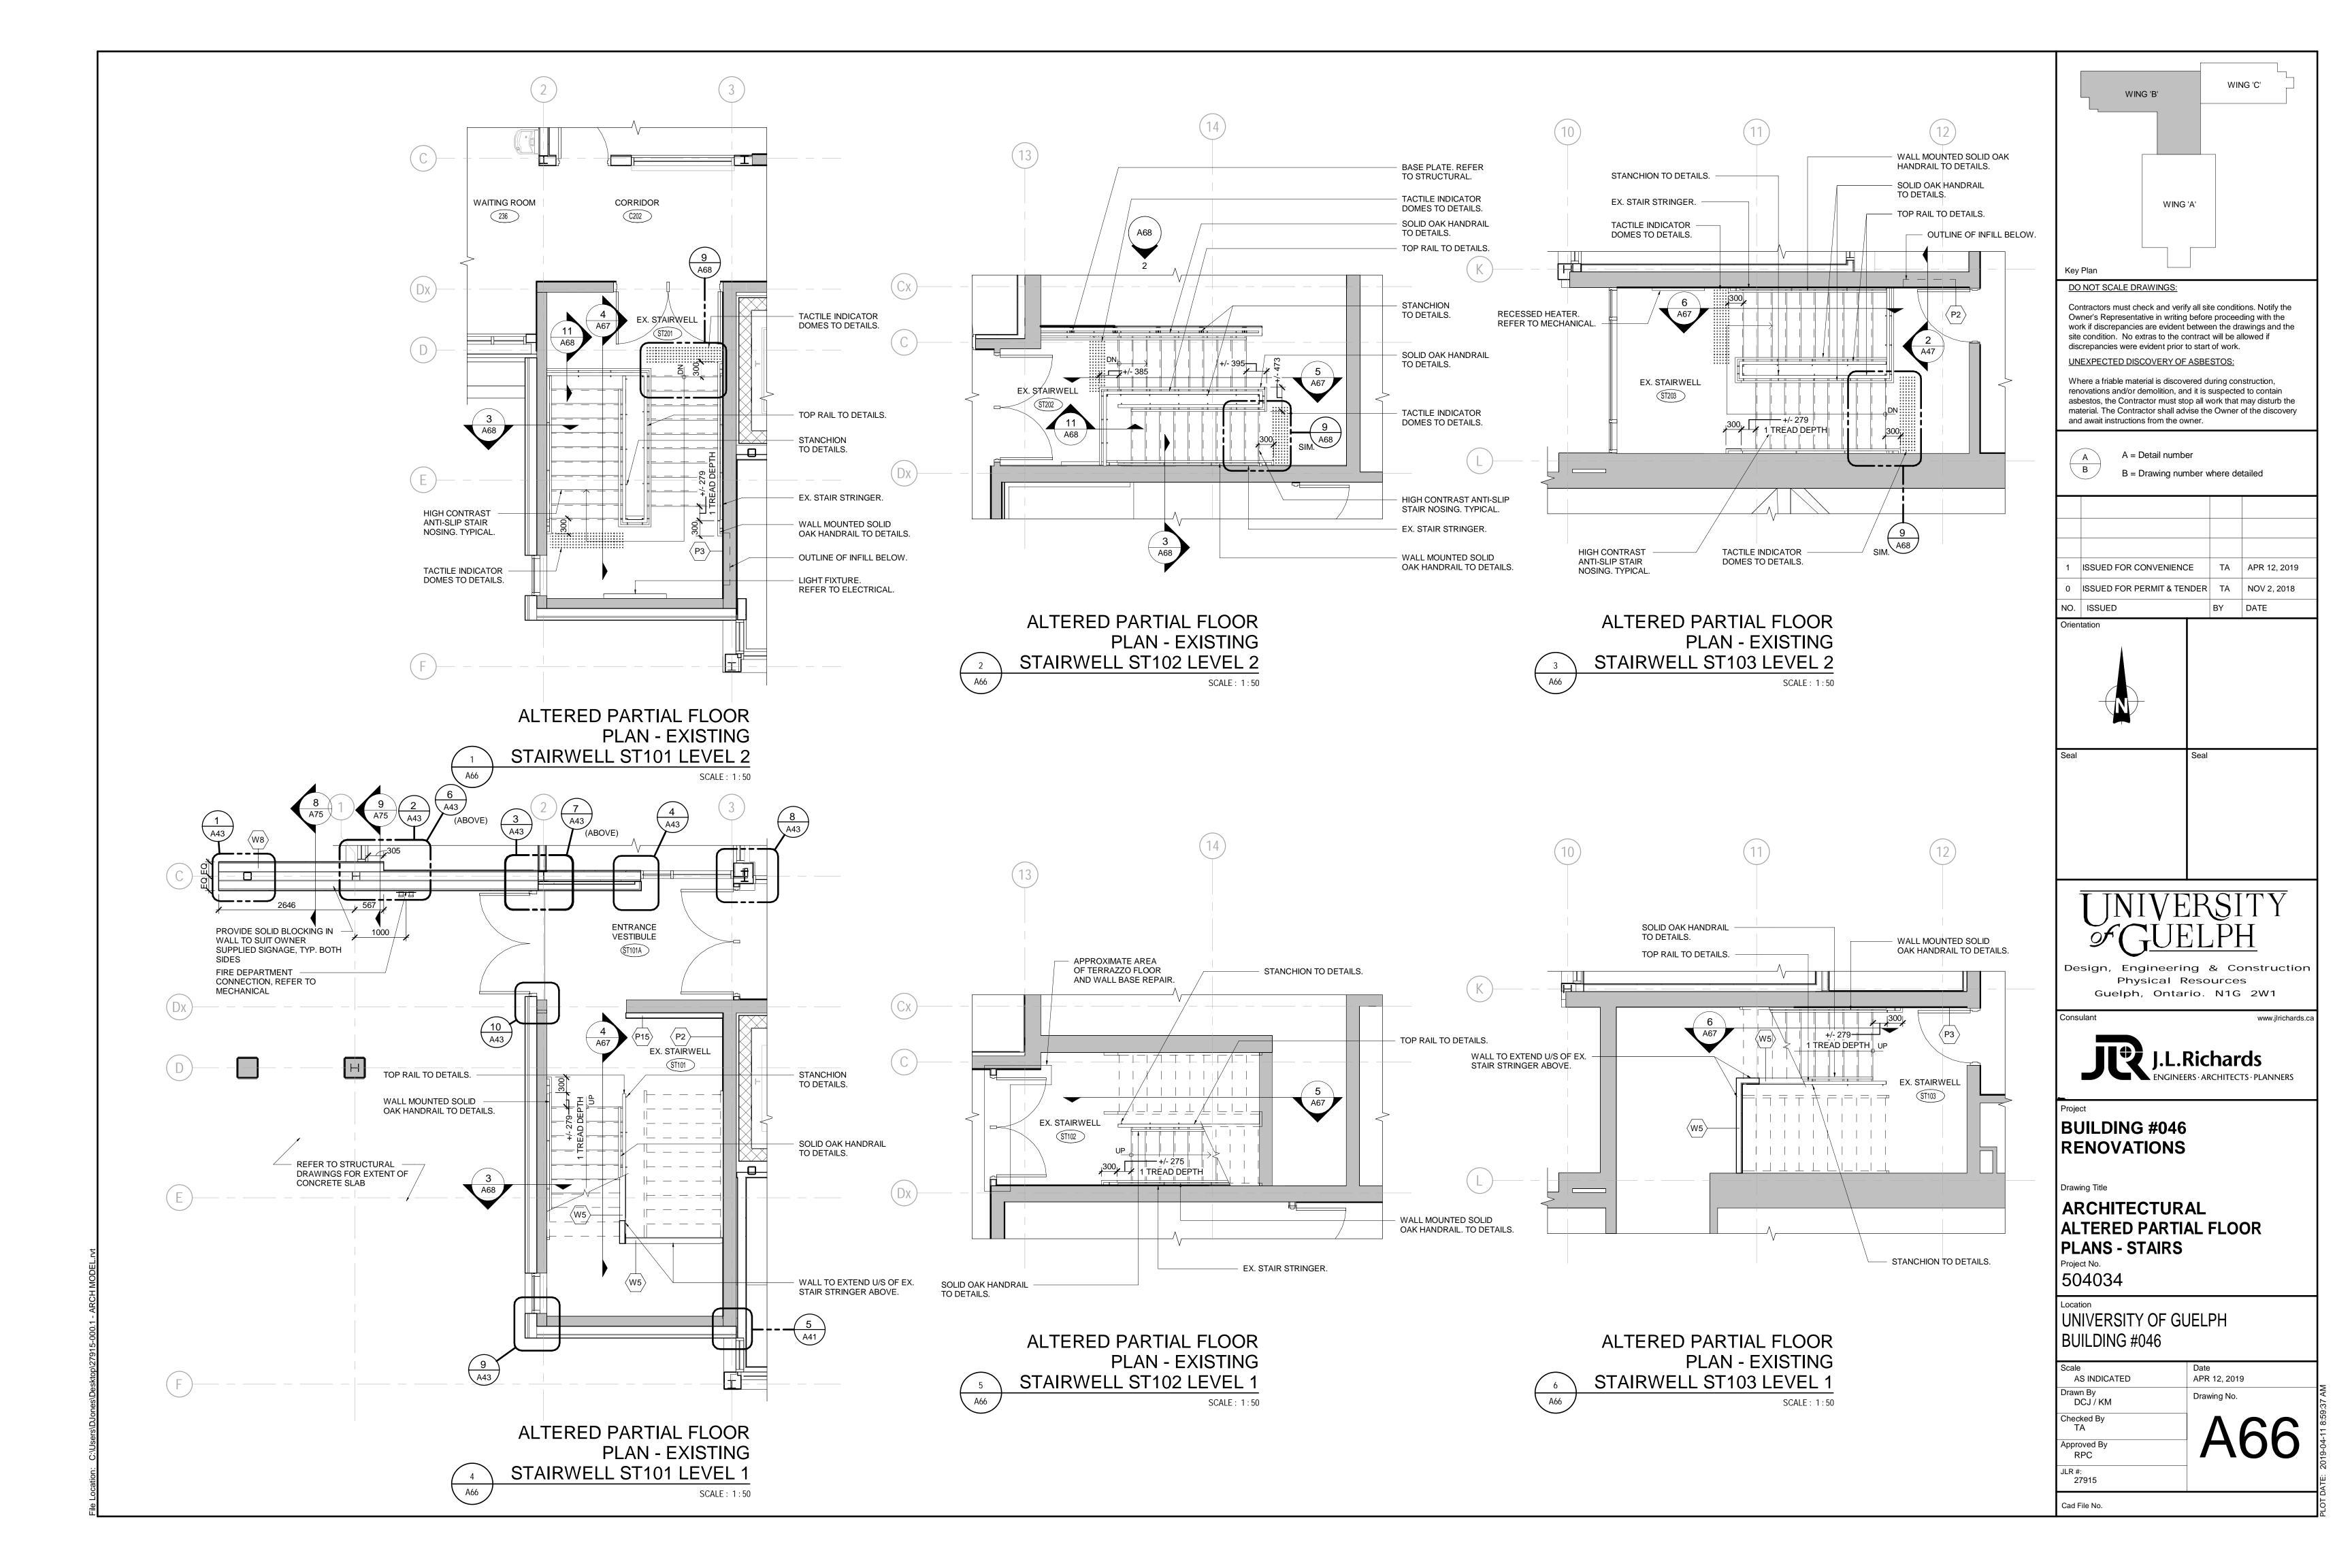

WING 'C' WING 'B' WING 'A' Key Plan

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BUILDING #046 RENOVATIONS


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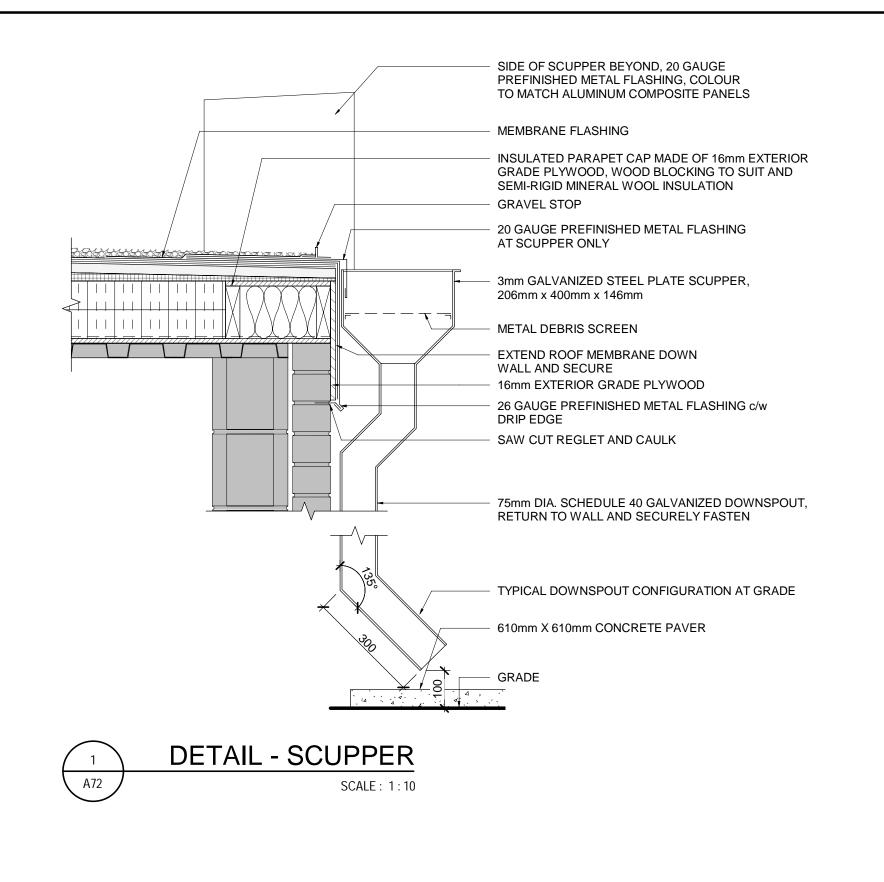
ARCHITECTURAL **EXISTING ROOF PLAN**


Project No. 504034

UNIVERSITY OF GUELPH BUILDING #046


AS INDICATED APR 12, 2019 Drawn By Drawing No. Checked By Approved By RPC JLR #: 27915 Cad File No.



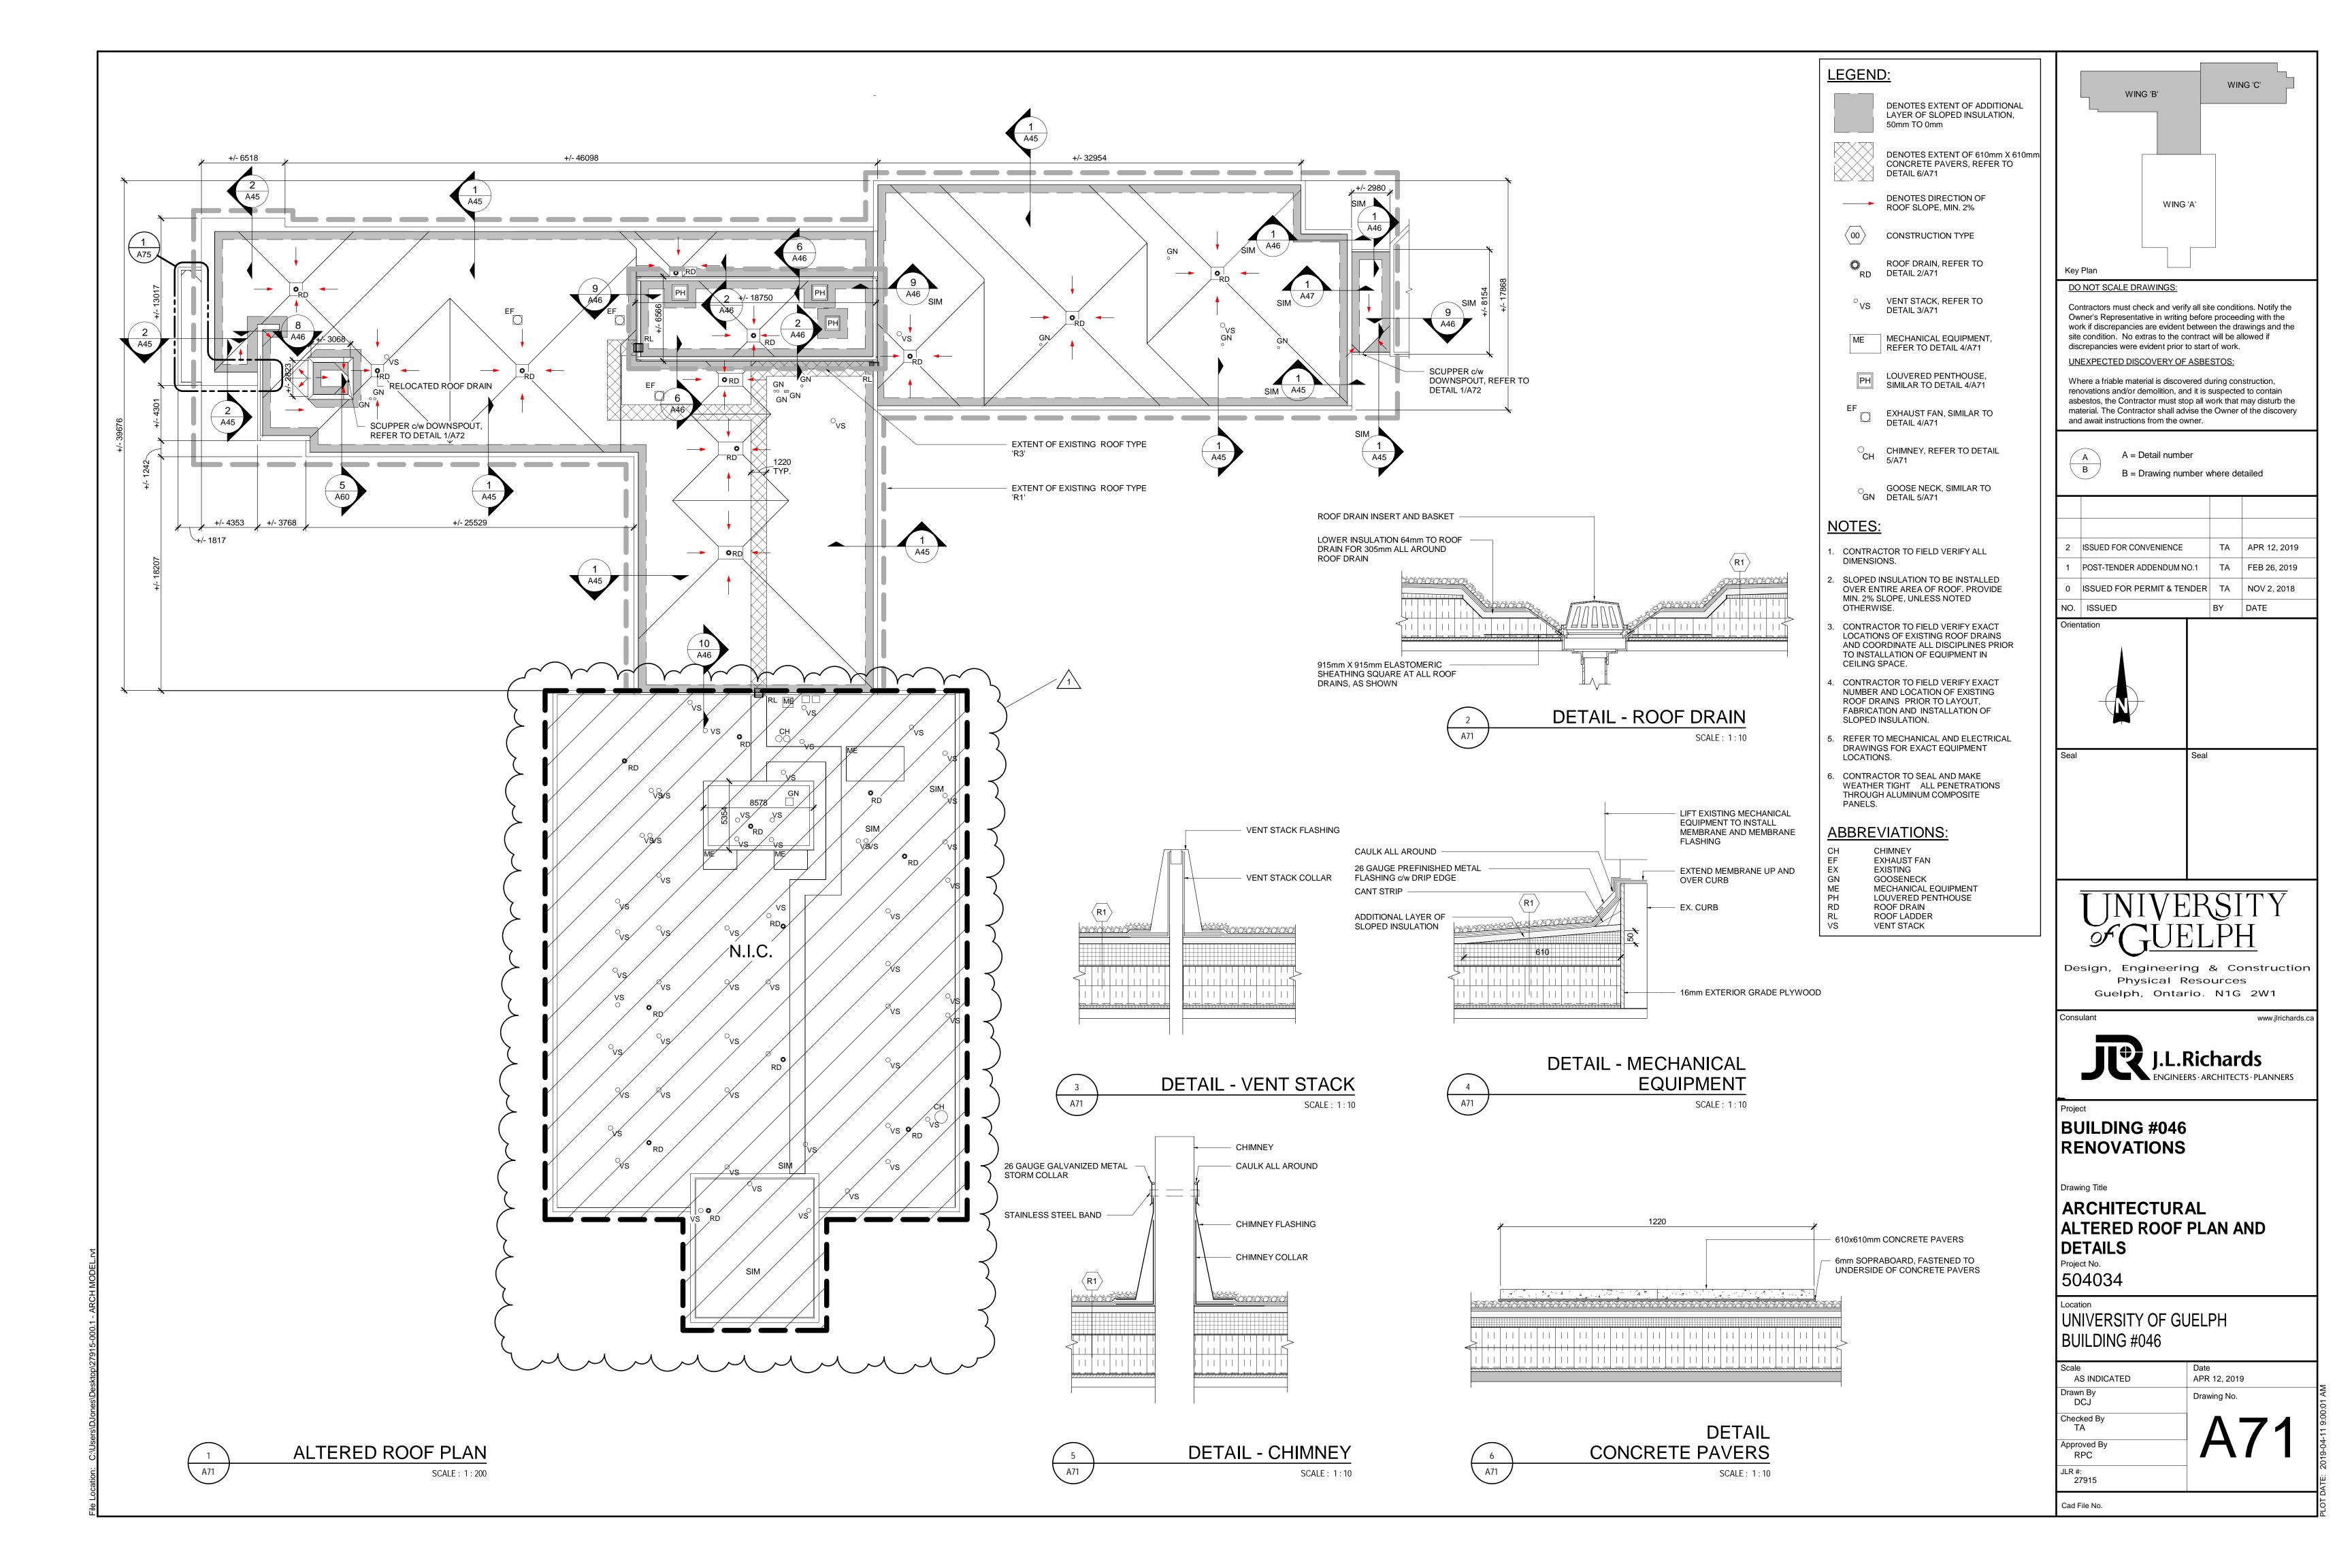


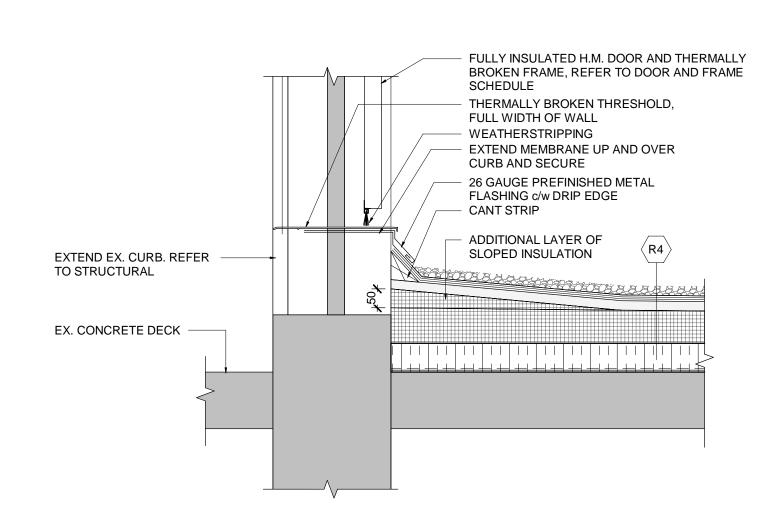



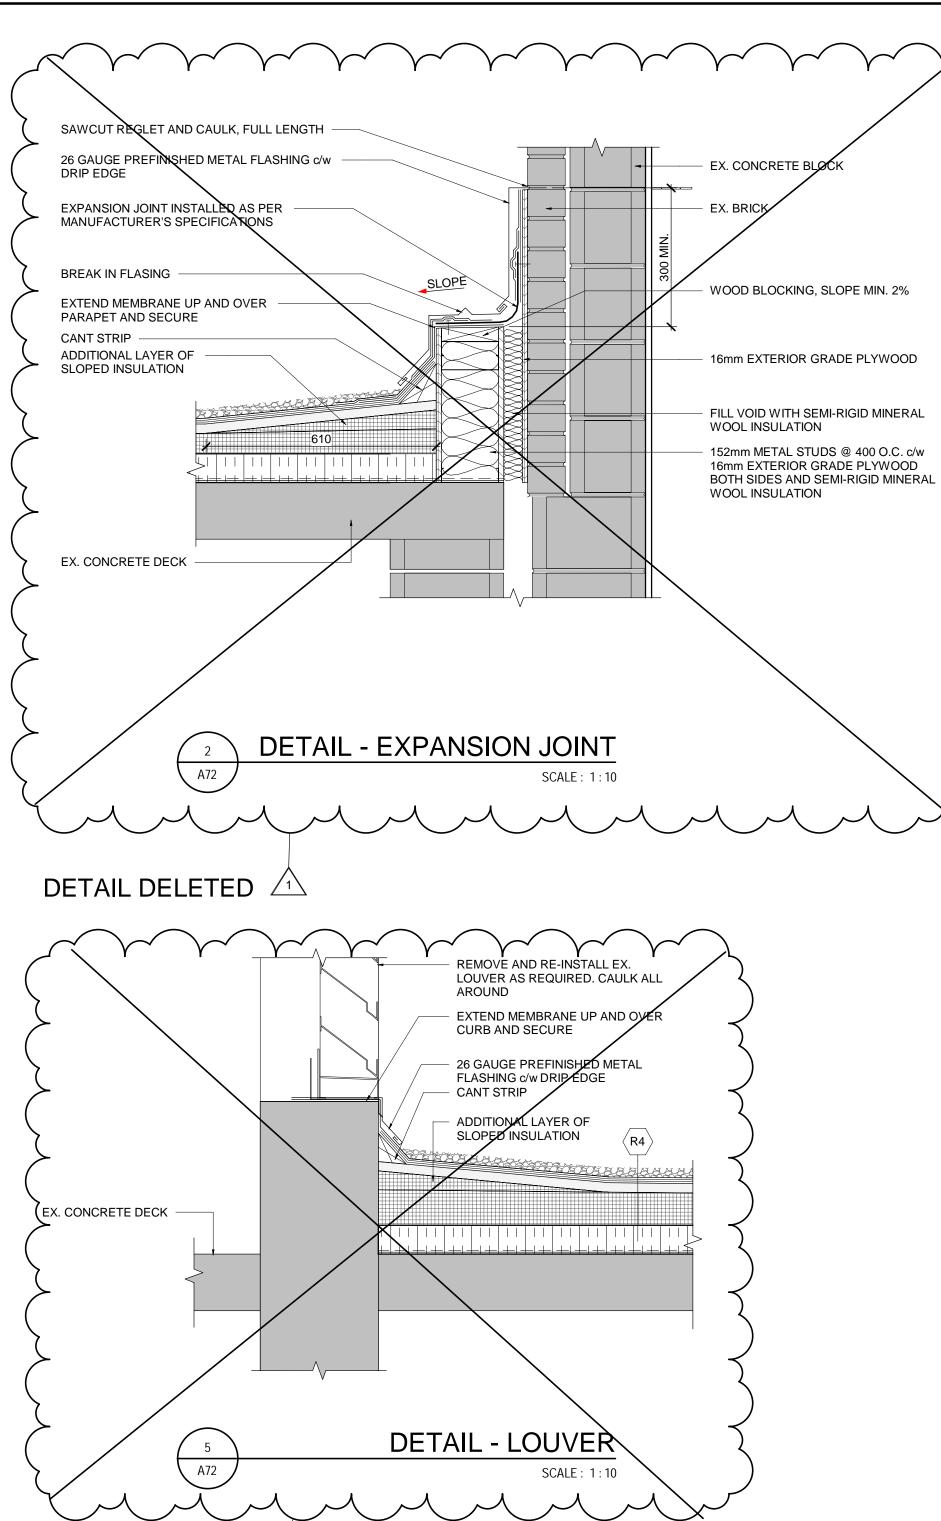

DETAIL DELETED 🗥

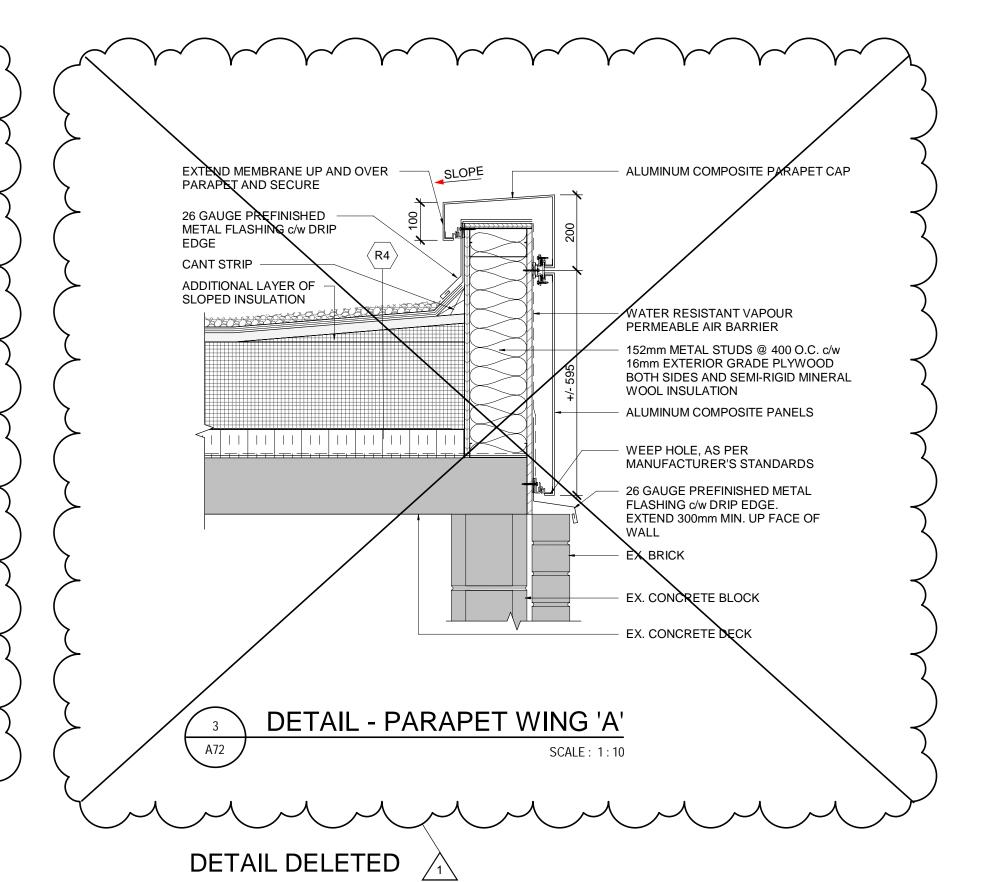

NOTES:

CONTRACTOR TO SEAL AND MAKE WEATHER TIGHT
 ALL PENETRATIONS THROUGH ALUMINUM COMPOSITE
 PANELS

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Consulant

J.L.Richards
ENGINEERS · ARCHITECTS · PLANNERS

Project

BUILDING #046 RENOVATIONS

Drawing Title

ARCHITECTURAL ROOF DETAILS

Project No. 504034

UNIVERSITY OF GUELPH BUILDING #046

AS INDICATED


Drawn By
DCJ


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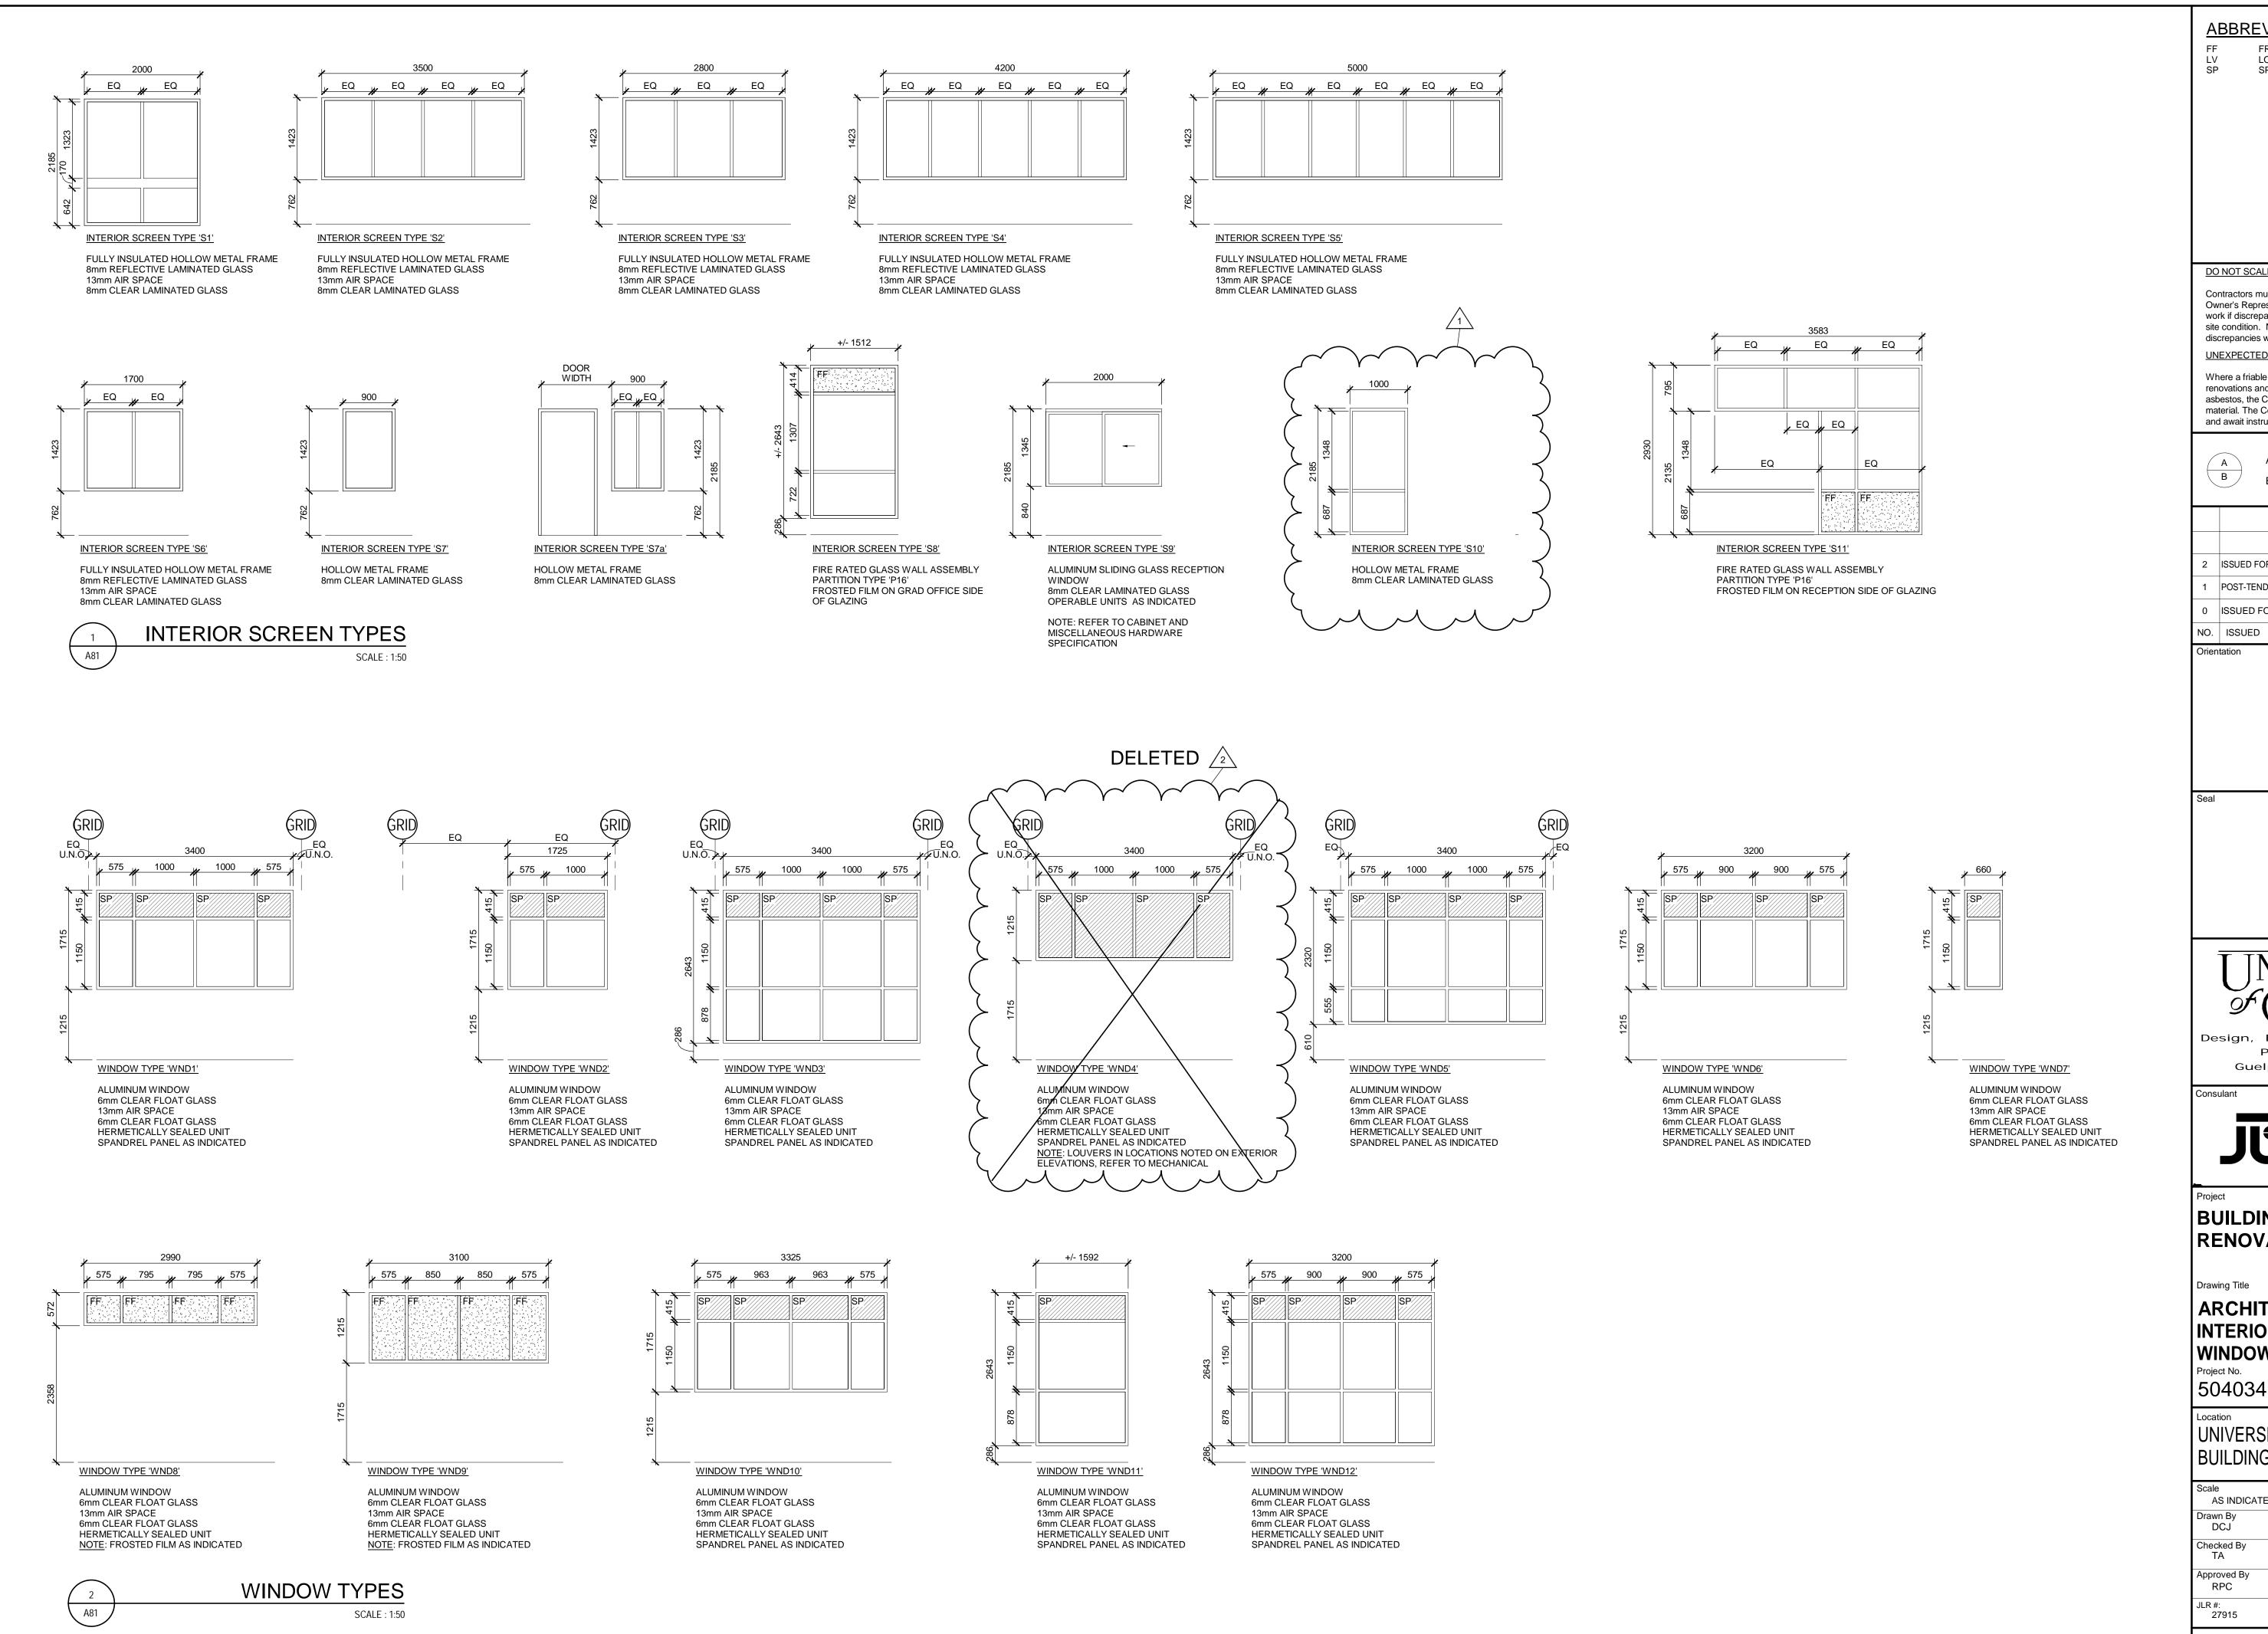
Approved By
RPC

JLR #:
27915

Cad File No.



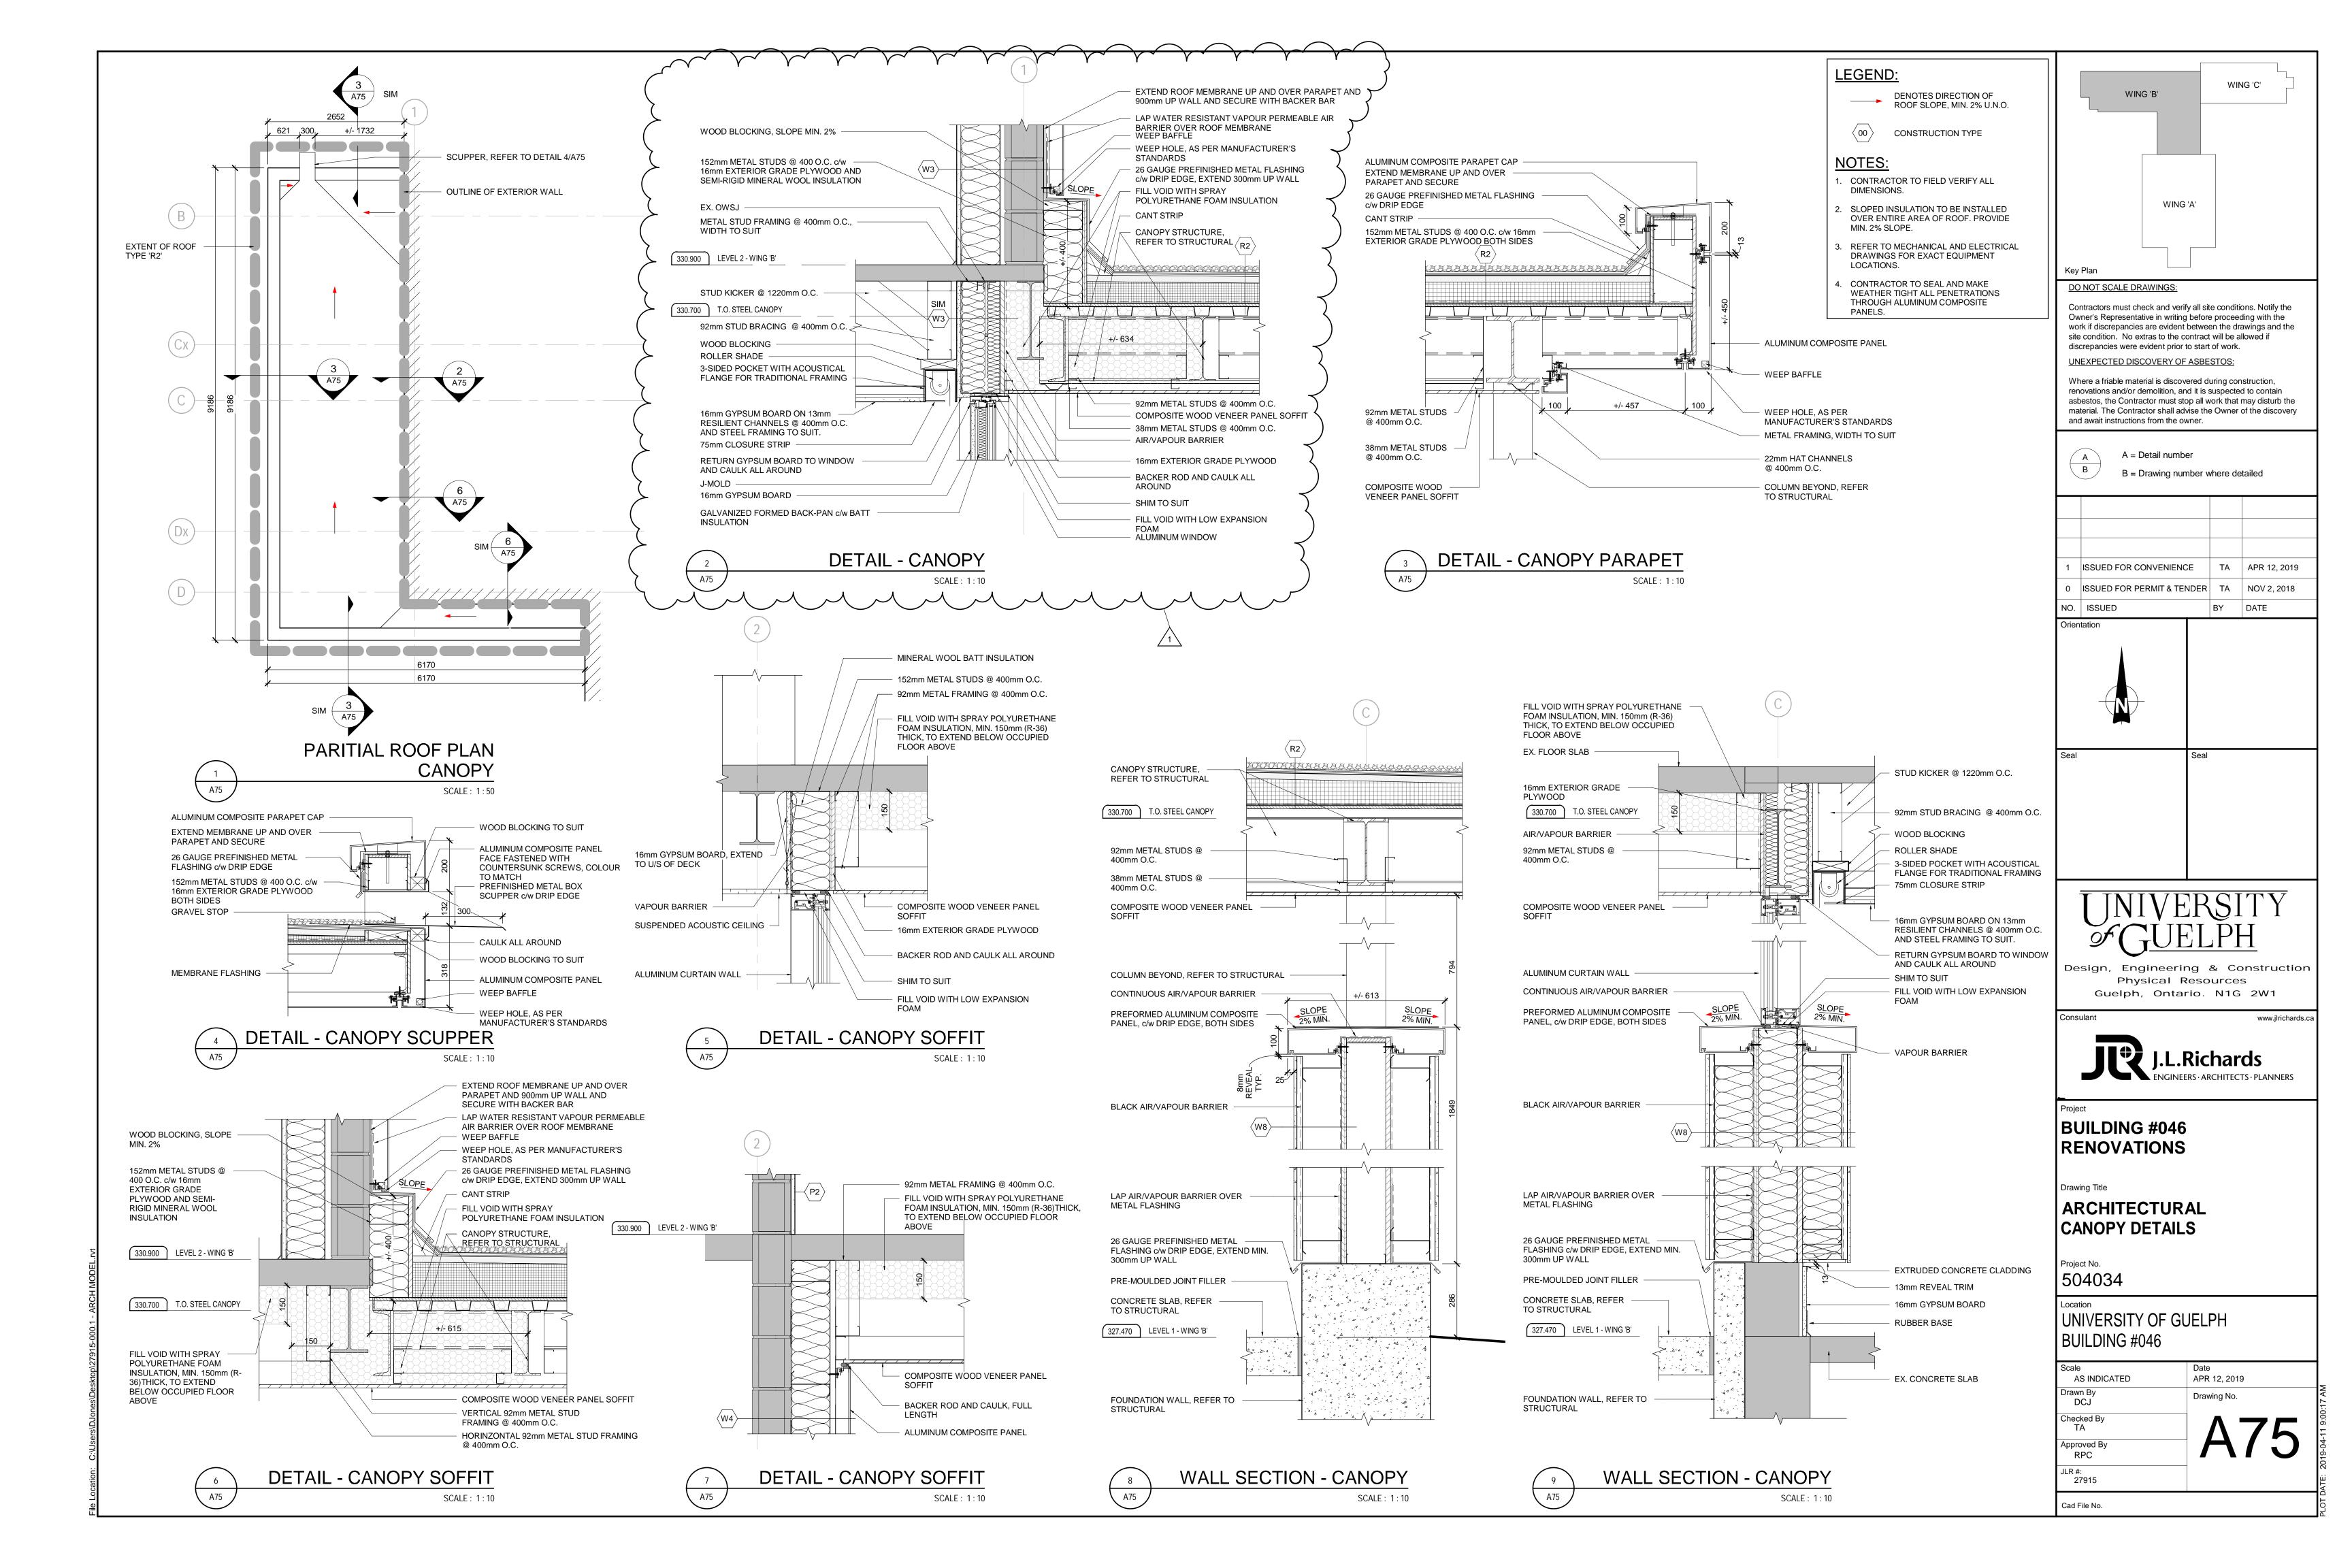

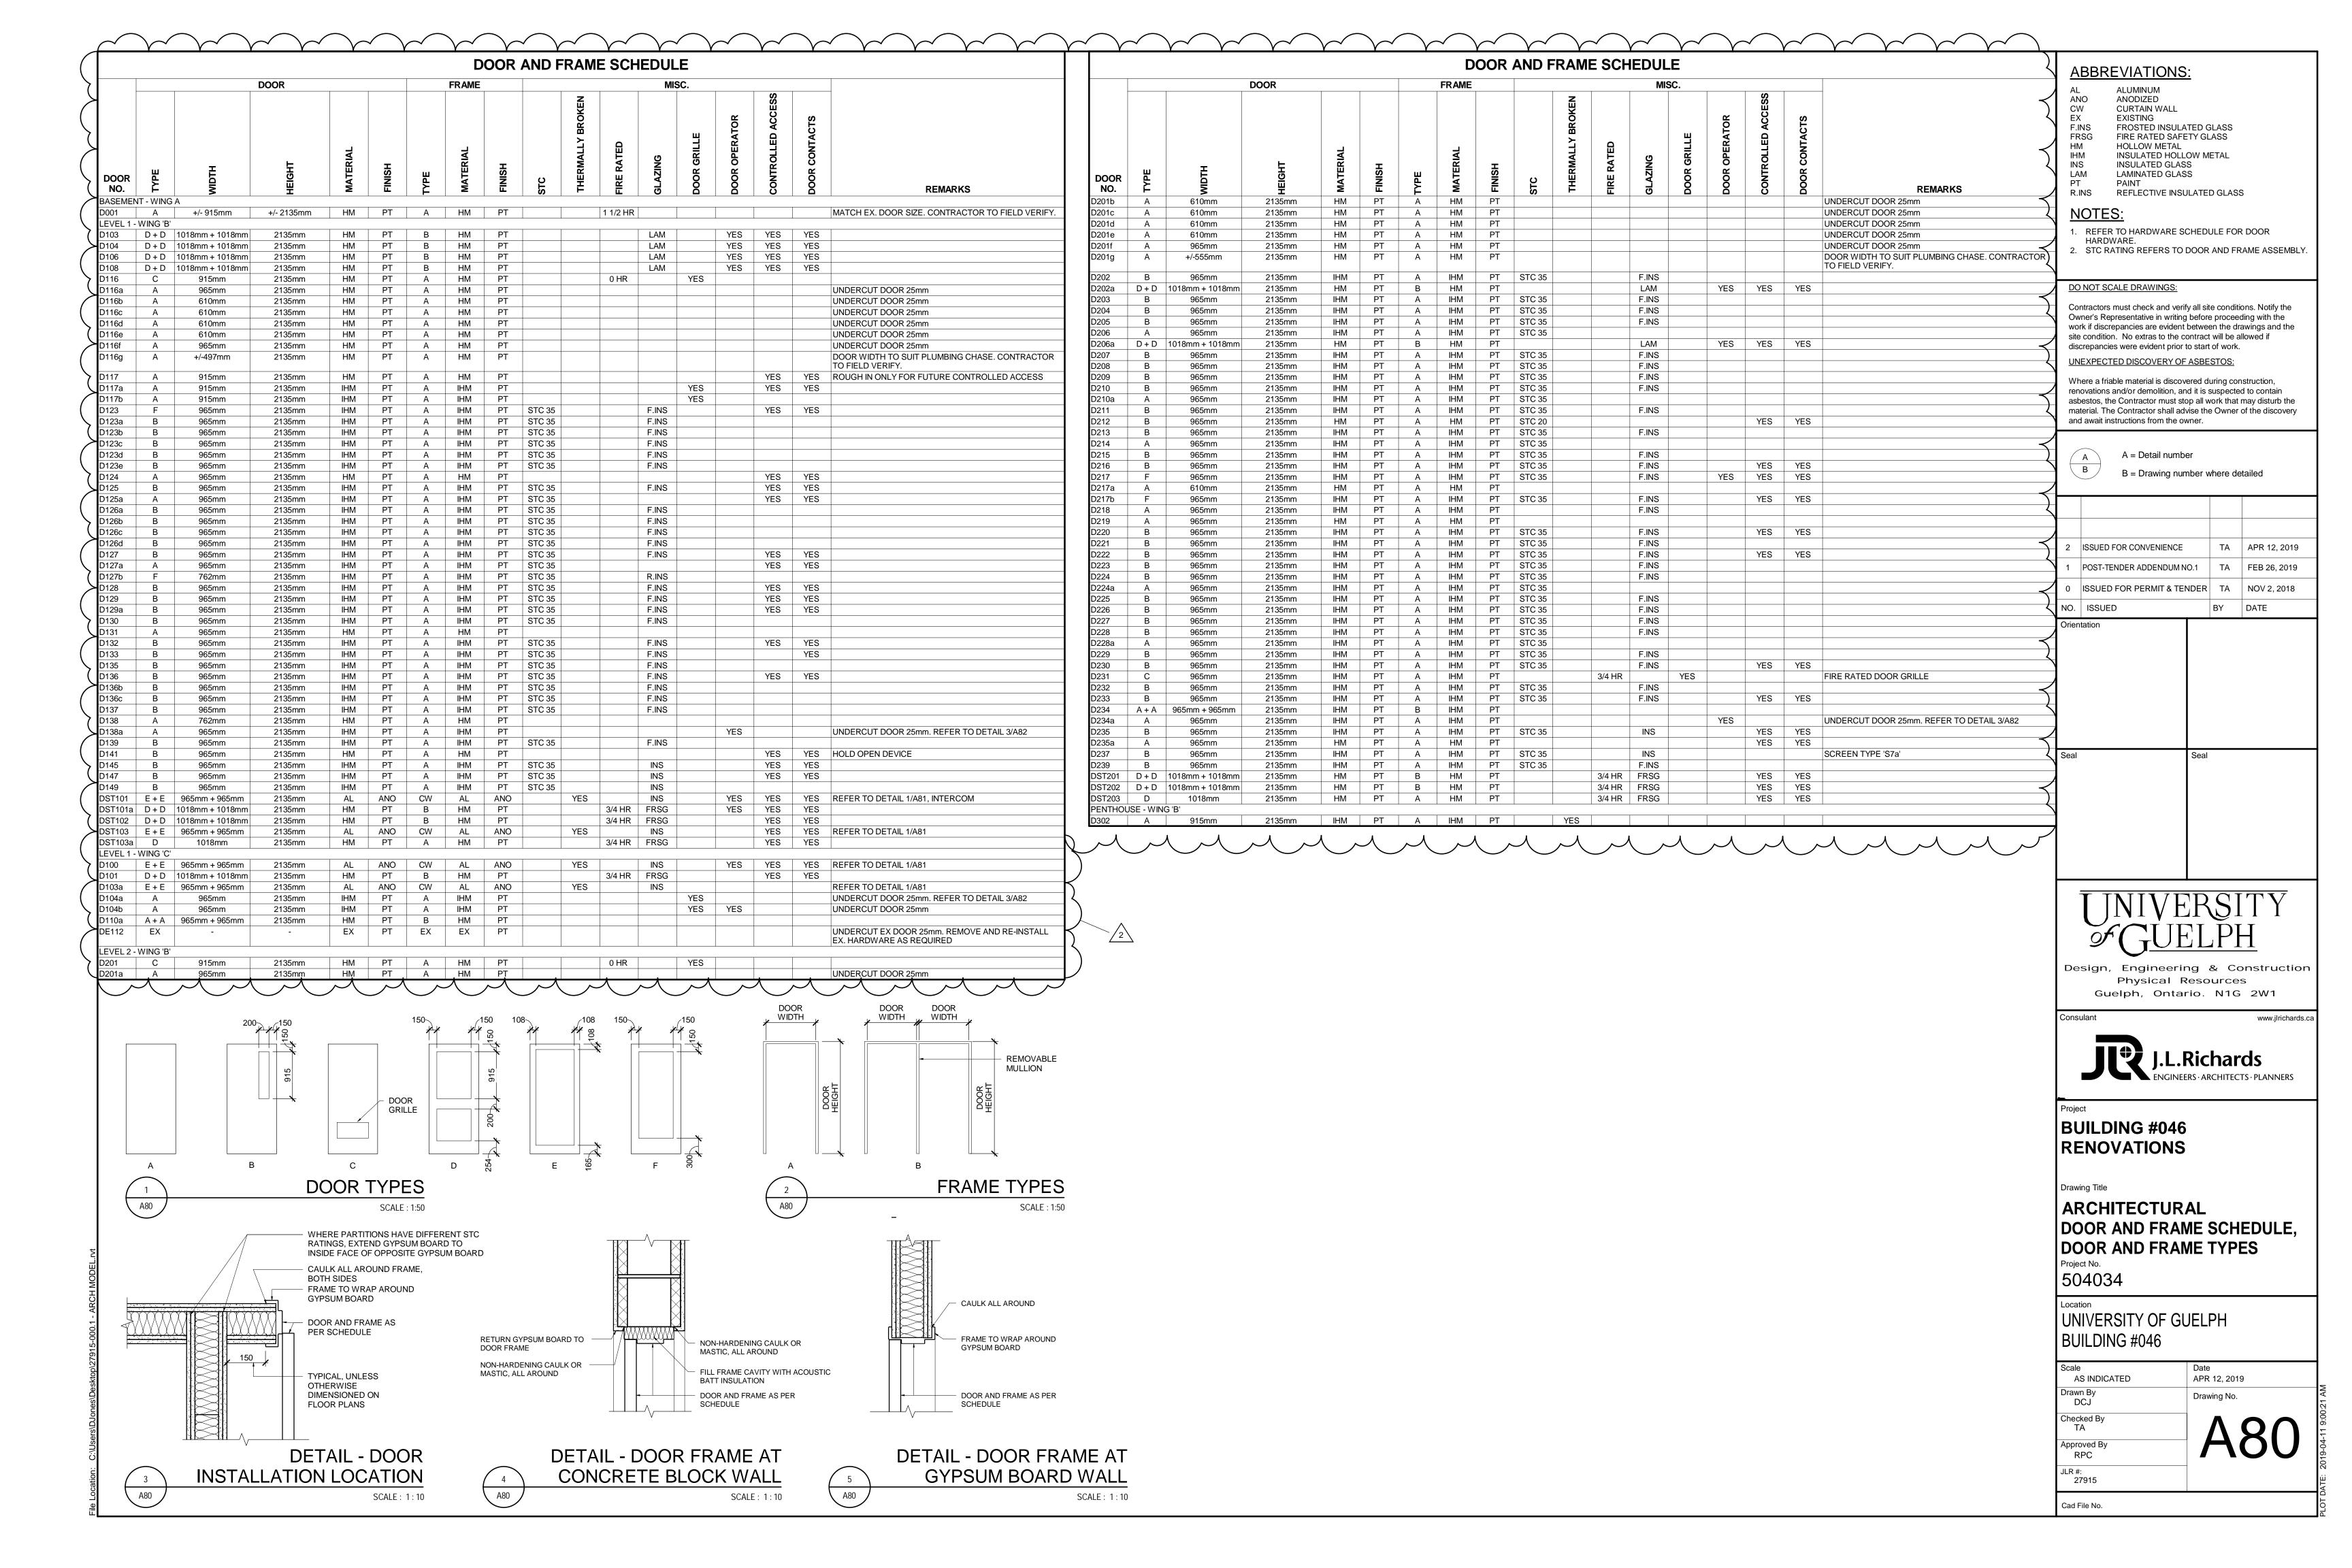

ABBREVIATIONS: FROSTED FILM

LOUVER SPANDREL PANEL

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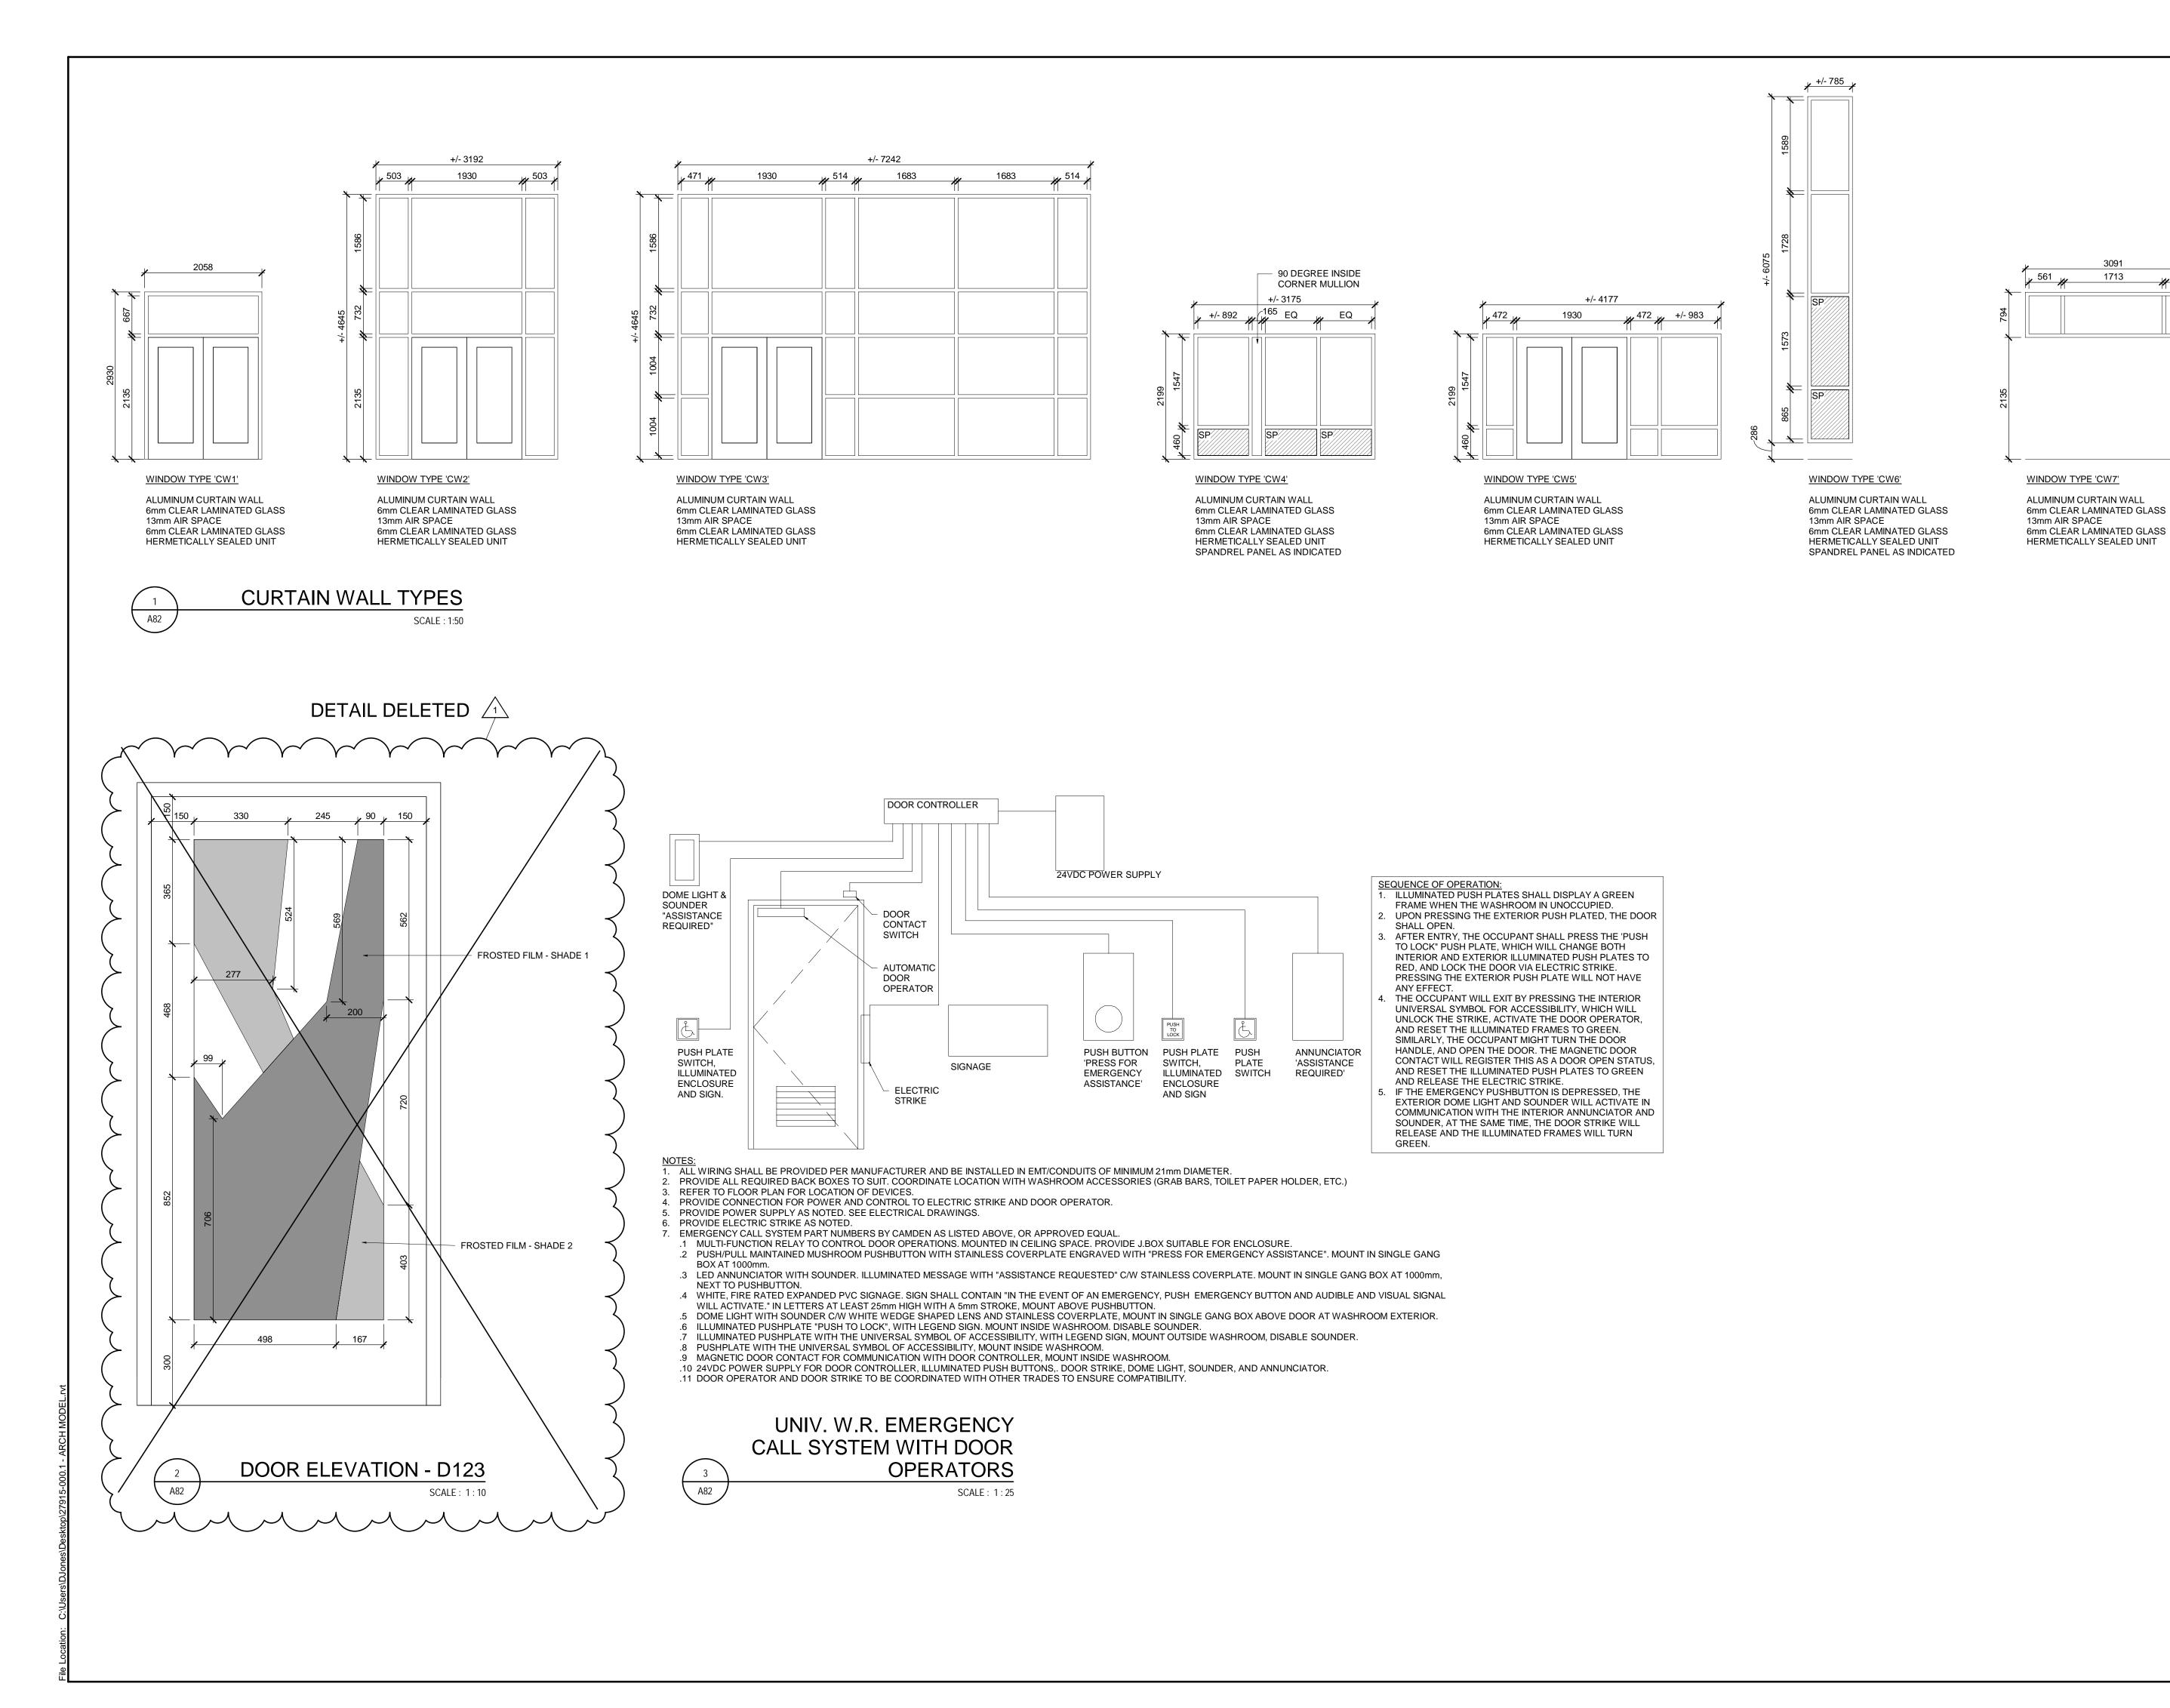
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BUILDING #046 RENOVATIONS

ARCHITECTURAL INTERIOR SCREEN AND WINDOW TYPES

UNIVERSITY OF GUELPH BUILDING #046

AS INDICATED APR 12, 2019 Drawing No. Checked By \pproved By JLR #: 27915 Cad File No.



ABBREVIATIONS:
FF FROSTED FILM

FF FROSTED FILM LV LOUVER SP SPANDREL PANEL

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Contractors must check and verify all site conditions. Notify the Owner's Representative in writing before proceeding with the work if discrepancies are evident between the drawings and the site condition. No extras to the contract will be allowed if discrepancies were evident prior to start of work.

UNEXPECTED DISCOVERY OF ASBESTOS:

Where a friable material is discovered during construction, renovations and/or demolition, and it is suspected to contain asbestos, the Contractor must stop all work that may disturb the material. The Contractor shall advise the Owner of the discovery and await instructions from the owner.

A B E

Orientation

A = Detail number

B = Drawing number where detailed

B = Drawii

1 ISSUED FOR CONVENIENCE TA APR 12, 2019
0 ISSUED FOR PERMIT & TENDER TA NOV 2, 2018
NO. ISSUED BY DATE

UNIVERSITY &GUELPH

Design, Engineering & Construction Physical Resources Guelph, Ontario. N1G 2W1

Consulant

J.L.Richards

ENGINEERS · ARCHITECTS · PLANNERS

Projec

BUILDING #046 RENOVATIONS

Drawing Title

ARCHITECTURAL
CURTAIN WALL TYPES AND
DETAILS

Project No. 504034

UNIVERSITY OF GUELPH BUILDING #046

Scale
AS INDICATED

Drawn By
DCJ

Checked By
TA

Approved By
RPC

JLR #:
27915

Cad File No.

SWB	ILS
ROOM NO. ROOM NAME FINISH BASE MATERIAL FINISH MATERIAL FINISH HEIGHT	ACKSPLASH AT MOP SINK ILS ILS
The color of the	ILS ILS
SWB	ILS ILS
117A SERVER	ILS
118 EX. ELECTRICAL EX CONC - EX EX.ST. PT 119 SVO STORAGE RSF RB EX PT ACT1 - 2440mm 120 EX. MECHANICAL EX CONC - EX EX.ST. PT 121 EX. MAINTENANCE EX TERR EX TERR EX PT ACT1 - 2440mm 123 RECEPTION RSF RB GWB PT ACT1 - 2440mm 123A WAITING RSF RB GWB PT ACT1 - 2440mm 123B OFFICE CPT RB GWB PT ACT1 - 2440mm 123C OFFICE CPT RB GWB PT ACT1 - 2440mm 123D OFFICE CPT RB GWB PT ACT1 - 2440mm 123E MEETING CPT RB GWB PT ACT1 -	ILS
119 SVO STORAGE RSF RB EX PT ACT1 - 2440mm 120 EX. MECHANICAL EX CONC - EX EX.ST. PT 121 EX. MAINTENANCE EX TERR EX TERR EX PT ACT1 - 2440mm 123 RECEPTION RSF RB GWB PT ACT1 - 2440mm 123A WAITING RSF RB GWB PT ACT1 - 2440mm 123B OFFICE CPT RB GWB PT ACT1 - 2440mm 123C OFFICE CPT RB GWB PT ACT1 - 2440mm 123D OFFICE CPT RB GWB PT ACT1 - 2440mm 123E MEETING CPT RB GWB PT ACT1 - 2440mm 123F COFFEE / COPY RSF RB GWB PT	ILS
121 EX. MAINTENANCE EX TERR EX TERR EX PT ACT1 - 2440mm 123 RECEPTION RSF RB GWB PT ACT1 - 2440mm 123A WAITING RSF RB GWB PT ACT1 - 2440mm 123B OFFICE CPT RB GWB PT ACT1 - 2440mm 123C OFFICE CPT RB GWB PT ACT1 - 2440mm 123D OFFICE CPT RB GWB PT ACT1 - 2440mm 123E MEETING CPT RB GWB PT ACT1 - 2440mm 123F COFFEE / COPY RSF RB GWB PT ACT1 - 2440mm MILLWORK TO DETAIL 124 CLOSED FILE STORAGE RSF RB EX, GWB PT ACT1 - 2440mm MILLWORK TO DETAIL	ILS
123 RECEPTION RSF RB GWB PT ACT1 - 2440mm 123A WAITING RSF RB GWB PT ACT1 - 2440mm 123B OFFICE CPT RB GWB PT ACT1 - 2440mm 123C OFFICE CPT RB GWB PT ACT1 - 2440mm 123D OFFICE CPT RB GWB PT ACT1 - 2440mm 123E MEETING CPT RB GWB PT ACT1 - 2440mm 123F COFFEE / COPY RSF RB GWB PT ACT1 - 2440mm MILLWORK TO DETAIL 124 CLOSED FILE STORAGE RSF RB EX, GWB PT ACT1 - 2440mm MILLWORK TO DETAIL 125 FAMILY THERAPY ROOM CPT RB GWB PT ACT1 - 2440mm	ILS
123B OFFICE CPT RB GWB PT ACT1 - 2440mm 123C OFFICE CPT RB GWB PT ACT1 - 2440mm 123D OFFICE CPT RB GWB PT ACT1 - 2440mm 123E MEETING CPT RB GWB PT ACT1 - 2440mm 123F COFFEE / COPY RSF RB GWB PT ACT1 - 2440mm MILLWORK TO DETAIL 124 CLOSED FILE STORAGE RSF RB EX, GWB PT ACT1 - 2440mm MILLWORK TO DETAIL 125 FAMILY THERAPY ROOM CPT RB GWB PT ACT1 - 2440mm	ILS
123C OFFICE CPT RB GWB PT ACT1 - 2440mm 123D OFFICE CPT RB GWB PT ACT1 - 2440mm 123E MEETING CPT RB GWB PT ACT1 - 2440mm 123F COFFEE / COPY RSF RB GWB PT ACT1 - 2440mm MILLWORK TO DETAIL 124 CLOSED FILE STORAGE RSF RB EX, GWB PT ACT1 - 2440mm MILLWORK TO DETAIL 125 FAMILY THERAPY ROOM CPT RB GWB PT ACT1 - 2440mm	ILS
123E MEETING CPT RB GWB PT ACT1 - 2440mm 123F COFFEE / COPY RSF RB GWB PT ACT1 - 2440mm MILLWORK TO DETAIL 124 CLOSED FILE STORAGE RSF RB EX, GWB PT ACT1 - 2440mm MILLWORK TO DETAIL 125 FAMILY THERAPY ROOM CPT RB GWB PT ACT1 - 2440mm	ILS
123F COFFEE / COPY RSF RB GWB PT ACT1 - 2440mm MILLWORK TO DETAIL 124 CLOSED FILE STORAGE RSF RB EX, GWB PT ACT1 - 2440mm MILLWORK TO DETAIL 125 FAMILY THERAPY ROOM CPT RB GWB PT ACT1 - 2440mm	ILS
125 FAMILY THERAPY ROOM CPT RB GWB PT ACT1 - 2440mm	
	ILS
125A VIEWING ROOM CPT RB GWB PT ACT1 - 2440mm MILLWORK TO DETAIL	
126A COUPLE / INDIVIDUAL ROOM CPT RB GWB PT ACT1 - 2440mm 126B COUPLE / INDIVIDUAL ROOM CPT RB GWB PT ACT1 - 2440mm	
126C COUPLE / INDIVIDUAL ROOM CPT RB GWB PT ACT1 - 2440mm	
126D COUPLE / INDIVIDUAL ROOM CPT RB GWB PT ACT1 - 2440mm 127 FAMILY THERAPY ROOM CPT RB GWB PT ACT1 - 2440mm	
127A VIEWING / CHILD CARE CPT RB GWB PT ACT1 - 2440mm MILLWORK TO DETAIL 128 MULTI-PURPOSE ROOM CPT RB GWB PT ACT1 - 2440mm	ILS
129 LARGE GROUP ROOM CPT RB GWB PT GWB, ACT1 PT 2440mm	
130 SESSIONAL OFFICE CPT RB GWB PT ACT1 - 2440mm 131 STORAGE RSF RB EX, GWB PT ACT1 - 2440mm	
131 STORAGE RSF RB EX, GWB PT ACT1 - 2440mm 132 RESEARCH SPACE RSF RB GWB PT ACT1 - 2440mm	
133 OFFICE / SUPERVISION CPT RB GWB PT ACT1 - 2440mm 135 OFFICE / SUPERVISION CPT RB GWB PT ACT1 - 2440mm	
136B TELEPHONE CPT RB GWB PT ACT1 - 2440mm	
136C BREAKOUT ROOM CPT RB GWB PT ACT1 - 2440mm 137 OFFICE / SUPERVISION CPT RB GWB PT ACT1 - 2440mm	
138 SPRINKLER CONC RB EX, GWB PT EX.ST. PT	
139 OFFICE / SUPERVISION CPT RB GWB PT ACT1 - 2440mm 141 MAIL RSF RB EX, GWB PT ACT1 - 2440mm MILLWORK TO DETAIL	II S
145 RECEPTION CPT RB GWB PT GWB, ACT1 PT VARIES BULKHEAD TO DETAIL	ILS
145A COPY / MAIL CPT RB GWB PT ACT1 - 2440mm MILLWORK TO DETAIL 147 ADMIN. OFFICE CPT RB GWB PT GWB, ACT1 PT VARIES BULKHEAD TO DETAIL	
149 OFFICE / SUPERVISION CPT RB GWB PT GWB, ACT1 PT VARIES BULKHEAD TO DETAIL	ILS
C102 CORRIDOR EX TERR EX TERR GWB PT ACT2 - 2440mm PATCH AND REPAIR EACTE - 2440mm PATCH AND REPAIR EACTE - AND/OR INFILL	EX. TERRAZZO FLOORING AND BASE IN AREAS OF WALL REMOVAL
C103 CORRIDOR EX TERR EX TERR GWB PT ACT2 - 2440mm PATCH AND REPAIR EACH AND/OR INFILL	EX. TERRAZZO FLOORING AND BASE IN AREAS OF WALL REMOVAL
C104 CORRIDOR EX TERR EX TERR GWB, WD PT ACT2, WD - 2440mm PATCH AND REPAIR E	EX. TERRAZZO FLOORING AND BASE IN AREAS OF WALL REMOVAL
AND/OR INFILL, REFER TO INTERIOR	ELEVATIONS
C104A CORRIDOR RSF RB GWB PT ACT2 - 2440mm C105 CORRIDOR RSF RB GWB PT GWB, ACT1 PT 2440mm BULKHEAD TO DETAI	II S
C106 CORRIDOR EX TERR EX TERR GWB, WD PT ACT2, WD - 2440mm PATCH AND REPAIR E	EX. TERRAZZO FLOORING AND BASE IN AREAS OF WALL REMOVAL
AND/OR INFILL, REFER TO INTERIOR	ELEVATIONS
C107 CORRIDOR RSF RB GWB PT GWB, ACT1 PT 2440mm MILLWORK TO DETAI BULKHEAD TO DETAI	
C108 CORRIDOR EX TERR EX TERR GWB PT ACT2, WD - 2440mm PATCH AND REPAIR E	EX. TERRAZZO FLOORING AND BASE IN AREAS OF WALL REMOVAL
C123 CORRIDOR RSF RB GWB PT ACT1 - 2440mm	
EL101 ELEVATOR CFT CBT	EV TERRAZZO EL CORINC AND RACE IN AREAC OF WALL REMOVAL
AND/OR INFILL,	EX. TERRAZZO FLOORING AND BASE IN AREAS OF WALL REMOVAL
ST101A ENTRANCE VESTIBULE EX TERR EX TERR EX, GWB PT ACT2 - 2930mm PATCH AND REPAIR EX TERR EX	EX. TERRAZZO FLOORING AND BASE IN AREAS OF WALL REMOVAL
AND/OR INFILL	EX. TERRAZZO FLOORING AND BASE IN AREAS OF WALL REMOVAL
AND/OR INFILL	EX. TERRAZZO FLOORING AND BASE IN AREAS OF WALL REMOVAL
ST103 EX. STAIRWELL EX TERR EX TERR EX PT - <t< td=""><td>ELEVATIONS.</td></t<>	ELEVATIONS.
CWT-3 MILLWORK TO DETAIL	ILS
WR138 UNIV. W.R. CFT CBT EX, CWT-1, PT GWB PT 2440mm REFER TO INTERIOR CWT-3	ELEVATIONS
LEVEL 1 - WING 'C' 101 EX. GRAD OFFICE EX EX, RB EX, GWB PT ACT3 - 2440mm PAINT WALL TO EXTE	ENT SHOWN ON 1/A88
102 EX. STORAGE RSF RB EX, GWB PT ACT3 - 2440mm PAINT WALL TO EXTE	ENT SHOWN ON 1/A88.
103 EX. MEDICAL RECORDS RSF RB EX, GWB PT ACT3 - 2440mm PAINT WALL TO EXTE 103A EX. RESTRICTED RECORDS RSF RB EX ACT3 - 2440mm	ENT SHOWN ON 1/A88.
105 EX. ELECTRICAL EX EX EX EX.ST.	
106 EX. VESTIBULE CPT RB EX ACT3 - 2440mm 106A EX. COPY ROOM CPT RB EX ACT3 - 2440mm	
106B EX. OFFICE CPT RB EX, GWB PT ACT3 - 2440mm PAINT WALL TO EXTE	
107 EX. OFFICE CPT RB EX, GWB PT ACT3 - 2440mm PAINT WALL TO EXTE 108 EX. OFFICE EX EX, RB EX, GWB PT ACT3 - 2440mm PAINT WALL TO EXTE	
109 EX. OFFICE EX EX EX ACT3 - 2440mm	TAIT OLIOWAL ON 4/A CO
109A EX. OFFICE EX EX, RB EX, GWB PT ACT3 - 2440mm PAINT WALL TO EXTE 109B EX. OFFICE EX EX, RB EX, GWB PT ACT3 - 2440mm PAINT WALL TO EXTE	
110 EX. CLASSROOM RSF RB EX, GWB PT ACT3 - 2440mm PAINT WALL TO EXTE	ENT SHOWN ON 1/A88.
110A CLOSET RSF RB EX, GWB PT ACT3 - 2440mm 111 EX. CLASSROOM RSF RB EX, GWB PT ACT3 - 2440mm PAINT WALL TO EXTERNATION	ENT SHOWN ON 1/A88.
112 EX. HSKP RSF RB EX EX.ST.	
113 EX. OFFICE RSF RB EX ACT3 - 2440mm 113A EX. CLASSROOM RSF RB EX, GWB PT ACT3 - 2440mm PAINT WALL TO EXTE	
114 EX. CLASSROOM RSF RB EX, GWB PT ACT3 - 2440mm PAINT WALL TO EXTE	ENT SHOWN ON 1/A88.
115 EX. KITCHEN RSF RB EX ACT3 - 2235mm C100 EX. VESTIBULE EX TERR EX TERR EX PT GWB, ACT3 PT VARIES BULKHEAD TO DETAIL C101 EX. CORRIDOR EX TERR EX TERR EX PT ACT3 - 2440mm PATCH AND REPAIR EX P	ILS EX. TERRAZZO FLOORING AND BASE IN AREAS OF WALL REMOVAL
┃	ENT SHOWN ON 1/A88.
C101A EX. VESTIBULE EX EX EX, GWB PT EX PT 2440mm PAINT WALL TO EXTE	ENT SHOWN ON 1/A88. ENT SHOWN ON 1/A88. PATCH AND REPAIR EX. CEILING AS REQUIRED
WR104 UNIV. W.R. CFT CBT EX, CWT-3 PT GWB PT 2440mm REFER TO INTERIOR	ELEVATIONS
WR104A W.R. CFT CBT EX, CWT-3 PT GWB PT 2440mm REFER TO INTERIOR	
LEVEL 2 - WING 'B' 201 CUST RSF RB EX, GWB PT ACT1 - 2440mm	
202 ASSESSMENT ROOM CPT RB GWB PT ACT1 - 2440mm	

ROOM FINISH SCHEDULE							ABBREVIA	ABBREVIATIONS:					
			OOR	WALL			CEILING	I			STIC CEILING TILE	: - TYPE	
ROOM NO.	ROOM NAME	FINISH CPT	BASE	MATERIAL GWB	FINISH	MATERIAL ACT1	FINISH	HEIGHT	REMARKS		RETE BLOCK MIC BASE TILE - T	YPF	
203	COUPLE / INDIVIDUAL ROOM ASSESSMENT ROOM	CPT	RB RB	GWB	PT PT	ACT1	-	2440mm 2440mm		CFT CERAM	MIC FLOOR TILE		
205	COUPLE / INDIVIDUAL ROOM	CPT	RB	GWB	PT	ACT1	-	2440mm		CONC SEALE CPT CARPE	ED CONCRETE		
206	VIEWING ROOM	CPT	RB	GWB	PT	ACT1	-	2440mm	MILLWORK TO DETAILS		ET TILE MIC WALL TILE - T	YPE	
207	COUPLE / INDIVIDUAL ROOM	CPT	RB	GWB	PT	ACT1	-	2440mm		EX EXISTI	ING TO REMAIN		
208	ASSESSMENT ROOM	CPT	RB	GWB	PT	ACT1	-	2440mm		EX CONC EXISTI EX TERR EXISTI	ING CONCRETE TO ING TERRAZZO TO	O REMAIN	N
209	PLAYROOM	RSF	RB	GWB	PT	ACT1	-	2440mm			SED STRUCTURE	REWAIN	V
210	PLAYROOM	RSF	RB	GWB	PT	ACT1	-	2440mm	MILLIMORY TO DETAIL O	GWB GYPS	YM BOARD		
210A 211	VIEWING ROOM FAMILY THERAPY ROOM	CPT CPT	RB RB	GWB GWB	PT PT	ACT1 ACT1	-	2440mm 2440mm	MILLWORK TO DETAILS	PT PAINT RB RUBBE	ER BASE		
212	TEST LIBRARY	RSF	RB	GWB	PT	ACT1	-	2440mm	MILLWORK TO DETAILS		ER BASE IENT SHEET FLOC	RING	
213	FAMILY THERAPY ROOM	CPT	RB	GWB	PT	ACT1	-	2440mm	INILEW ONE TO BE TALES	SDF STATIC	C DISSIPATIVE FLO		
214	VIEWING ROOM	CPT	RB	GWB	PT	ACT1	-	2440mm	MILLWORK TO DETAILS	WD WOOD)		
215	FAMILY THERAPY ROOM	CPT	RB	GWB	PT	ACT1	-	2440mm					
216	WELLNESS ROOM	RSF	RB	GWB	PT	ACT1	-	2440mm	MILLWORK TO DETAILS				
217	LOUNGE	RSF	RB	GWB, CWT-2	PT	GWB, ACT2,	PT	2440mm	REFER TO INTERIOR ELEVATIONS,				
						WD			MILLWORK TO DETAILS, BULKHEAD TO DETAILS	DO NOT SCALE D	RAWINGS:		
217A	STOR.	CFT	CBT	GWB	PT	GWB	PT	VARIES	BOERNIE/B TO BETTILLO	-			
218	STORAGE	RSF	RB	GWB	PT	ACT1	-	2440mm		Contractors must cOwner's Represent			
219	STORAGE	RSF	RB	EX, GWB	PT	GWB, ACT1	PT	2440mm	MILLWORK TO DETAILS,	work if discrepancie			
				,					BULKHEAD TO DETAILS	site condition. No			
220	PRAYER ROOM	CPT	RB	GWB	PT	ACT1	-	2440mm	MILLWORK TO DETAILS	discrepancies were	e evident prior to sta	rt of work.	
221	OFFICE / SUPERVISION	CPT	RB	GWB	PT	ACT1	-	2440mm		UNEXPECTED DIS	SCOVERY OF ASB	ESTOS:	
222	CONFIDENTIAL STUDENT WORK ROOM	RSF	RB	GWB	PT	ACT1	-	2440mm					
223 224	OFFICE / SUPERVISION RESEARCH THERAPY / ASSESSMENT	CPT CPT	RB RB	GWB GWB	PT PT	ACT1 ACT1	-	2440mm 2440mm		Where a friable ma			
224	ROOM	CFI	KD	GWB	FI	ACTI	-	244011111		renovations and/or asbestos, the Cont			
224a	VIEWING ROOM	CPT	RB	GWB	PT	ACT1	-	2440mm	MILLWORK TO DETAILS	material. The Contr			
225	OFFICE / SUPERVISION	CPT	RB	GWB	PT	ACT1	-	2440mm		and await instructio			,
226	OFFICE	CPT	RB	GWB	PT	ACT1	-	2440mm					
227	OFFICE / SUPERVISION	CPT	RB	GWB	PT	ACT1	-	2440mm					
228	RESEARCH THERAPY / ASSESSMENT	CPT	RB	GWB	PT	ACT1	-	2440mm		A A =	Detail number		
2204	ROOM	CDT	DD	CMD	DT	A OT4		0.4.40	MILLIMORY TO DETAIL C	B	Drawing number	where do	atailed
228A	VIEWING ROOM OFFICE / SUPERVISION	CPT CPT	RB	GWB GWB	PT PT	ACT1 ACT1	-	2440mm 2440mm	MILLWORK TO DETAILS	1	Drawing number	wilele de	stalleu
229	RESEARCH DATA ANALYSIS ROOM	RSF	RB RB	GWB	PT	ACT1	-	2440mm		_			
231	ELEV. MACHINE ROOM	RSF	RB	EX, GWB	PT	EX.ST.	PT	2440mm		-			
232	OFFICE	CPT	RB	GWB	PT	ACT1	-	2440mm					
233	LARGE GROUP ROOM	CPT	RB	GWB	PT	GWB, ACT1	PT		BULKHEAD TO DETAILS				
234	IT	RSF	RB	GWB	PT	EX.ST.	PT					+	
235	RECEPTION / COPY	CPT	RB	GWB	PT	ACT1	-	2440mm	MILLWORK TO DETAILS				
235A	ACTIVE STORAGE	CPT	RB	GWB	PT	ACT1	-	2440mm		1 ISSUED FOR (CONVENIENCE	TA	APR 12, 2019
236	WAITING ROOM	RSF	RB	GWB	PT	ACT2, WD	-	2440mm					·
237	ADMIN. OFFICE	CPT	RB	GWB	PT	ACT1	-	2440mm		0 ISSUED FOR F	PERMIT & TENDER	R TA	NOV 2, 2018
239	SEMINAR	CPT	RB	GWB	PT	ACT3 WD	-	2440mm	DATCH AND DEDAID BY TERRATZO ELOODINO AND DACE IN ADEAC OF WALL DEMOVAL	NO. ISSUED		BY	DATE
C201	CORRIDOR	EXTERR	EX TERR	GWB, WD	PT	ACT2, WD	-	2440mm	PATCH AND REPAIR EX. TERRAZZO FLOORING AND BASE IN AREAS OF WALL REMOVAL AND/OR INFILL	NO. ISSUED		BY	DATE
C202	CORRIDOR	EX TERR	EX TERR	GWB, WD	PT	ACT2, WD	-	2440mm	PATCH AND REPAIR EX. TERRAZZO FLOORING AND BASE IN AREAS OF WALL REMOVAL	Orientation			
				,		,			AND/OR INFILL				
C203	CORRIDOR	RSF	RB	GWB	PT	GWB, ACT1	PT	2440mm	MILLWORK TO DETAILS,				
0004	0000000	505	5.5	CVVD	D.T.	OUND ACT		0.4.40	BULKHEAD TO DETAILS	_			
C204	CORRIDOR CORRIDOR	RSF RSF	RB	GWB	PT	GWB, ACT1	PT	2440mm					
C205 C206	CORRIDOR	EX TERR	RB EX TERR	GWB GWB, WD	PT PT	GWB, ACT1 ACT2, WD	PT -	2440mm 2440mm	PATCH AND REPAIR EX. TERRAZZO FLOORING AND BASE IN AREAS OF WALL REMOVAL	_			
C200	CORRIDOR	EXIERK	EXIERK	GVVB, VVD	FI	AC12, VVD	_	244011111	AND/OR INFILL				
C207	CORRIDOR	RSF	RB	GWB	PT	ACT2	-	2440mm		_			
C208	CORRIDOR	RSF	RB	GWB	PT	ACT2	-	2440mm					
EL201	ELEVATOR	CFT	CBT	-	-	-	-						
ST201	EX. STAIRWELL		EX TERR	GWB, EX	PT	GWB	PT	2875mm					
ST202	EX. STAIRWELL		EX TERR	EX	PT	ACT2	-	3900mm		Seal	Sea	.1	
ST203	EX. STAIRWELL		EX TERR		PT	GWB	PT	2875mm					
ST205	EX. STAIRWELL	EX	EX	EX	EX	EX	EX	\/A.D.IE.O	DEFED TO INTERIOR ELEVATIONS	_			
WR201	W.R.	CFT	CBT	EX, CWT-1, CWT-3	PT	GWB	PT	VARIES	REFER TO INTERIOR ELEVATIONS, MILLWORK TO DETAILS				
WR234	UNIV. W.R.	CFT	CBT	EX, CWT-1,	PT	GWB	PT	2440mm	REFER TO INTERIOR ELEVATIONS	\dashv			
VVI\254	Ordiv. W.ix.	011	ODI	CWT-3		OVVB		2440111111	THE EN TO INTERIOR ELEVATIONS				
PENTHOUSE - V	VING 'A'	<u> </u>											
303	EX. PENTHOUSE	EX	EX	EX	-	EX	-						
	EX. PENTHOUSE	EX	EX	EX	-	EX	-			_			
PENTHOUSE - V			EV	Ev.		FV.				4			
	EX. MECHANICAL ROOM	EX	EX	EX	-	EX	-						
ST302	EX. STAIRWELL	EX	-	EX	-	EX	-			→ →	TT 7171	$\overline{}$	
											$\overline{\text{IMED}}$	2 U	l'I' V

UNIVERSITY & GUELPH

Design, Engineering & Construction Physical Resources Guelph, Ontario. N1G 2W1

onsulant

J.L.Richards

ENGINEERS · ARCHITECTS · PLANNERS

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BUILDING #046 RENOVATIONS


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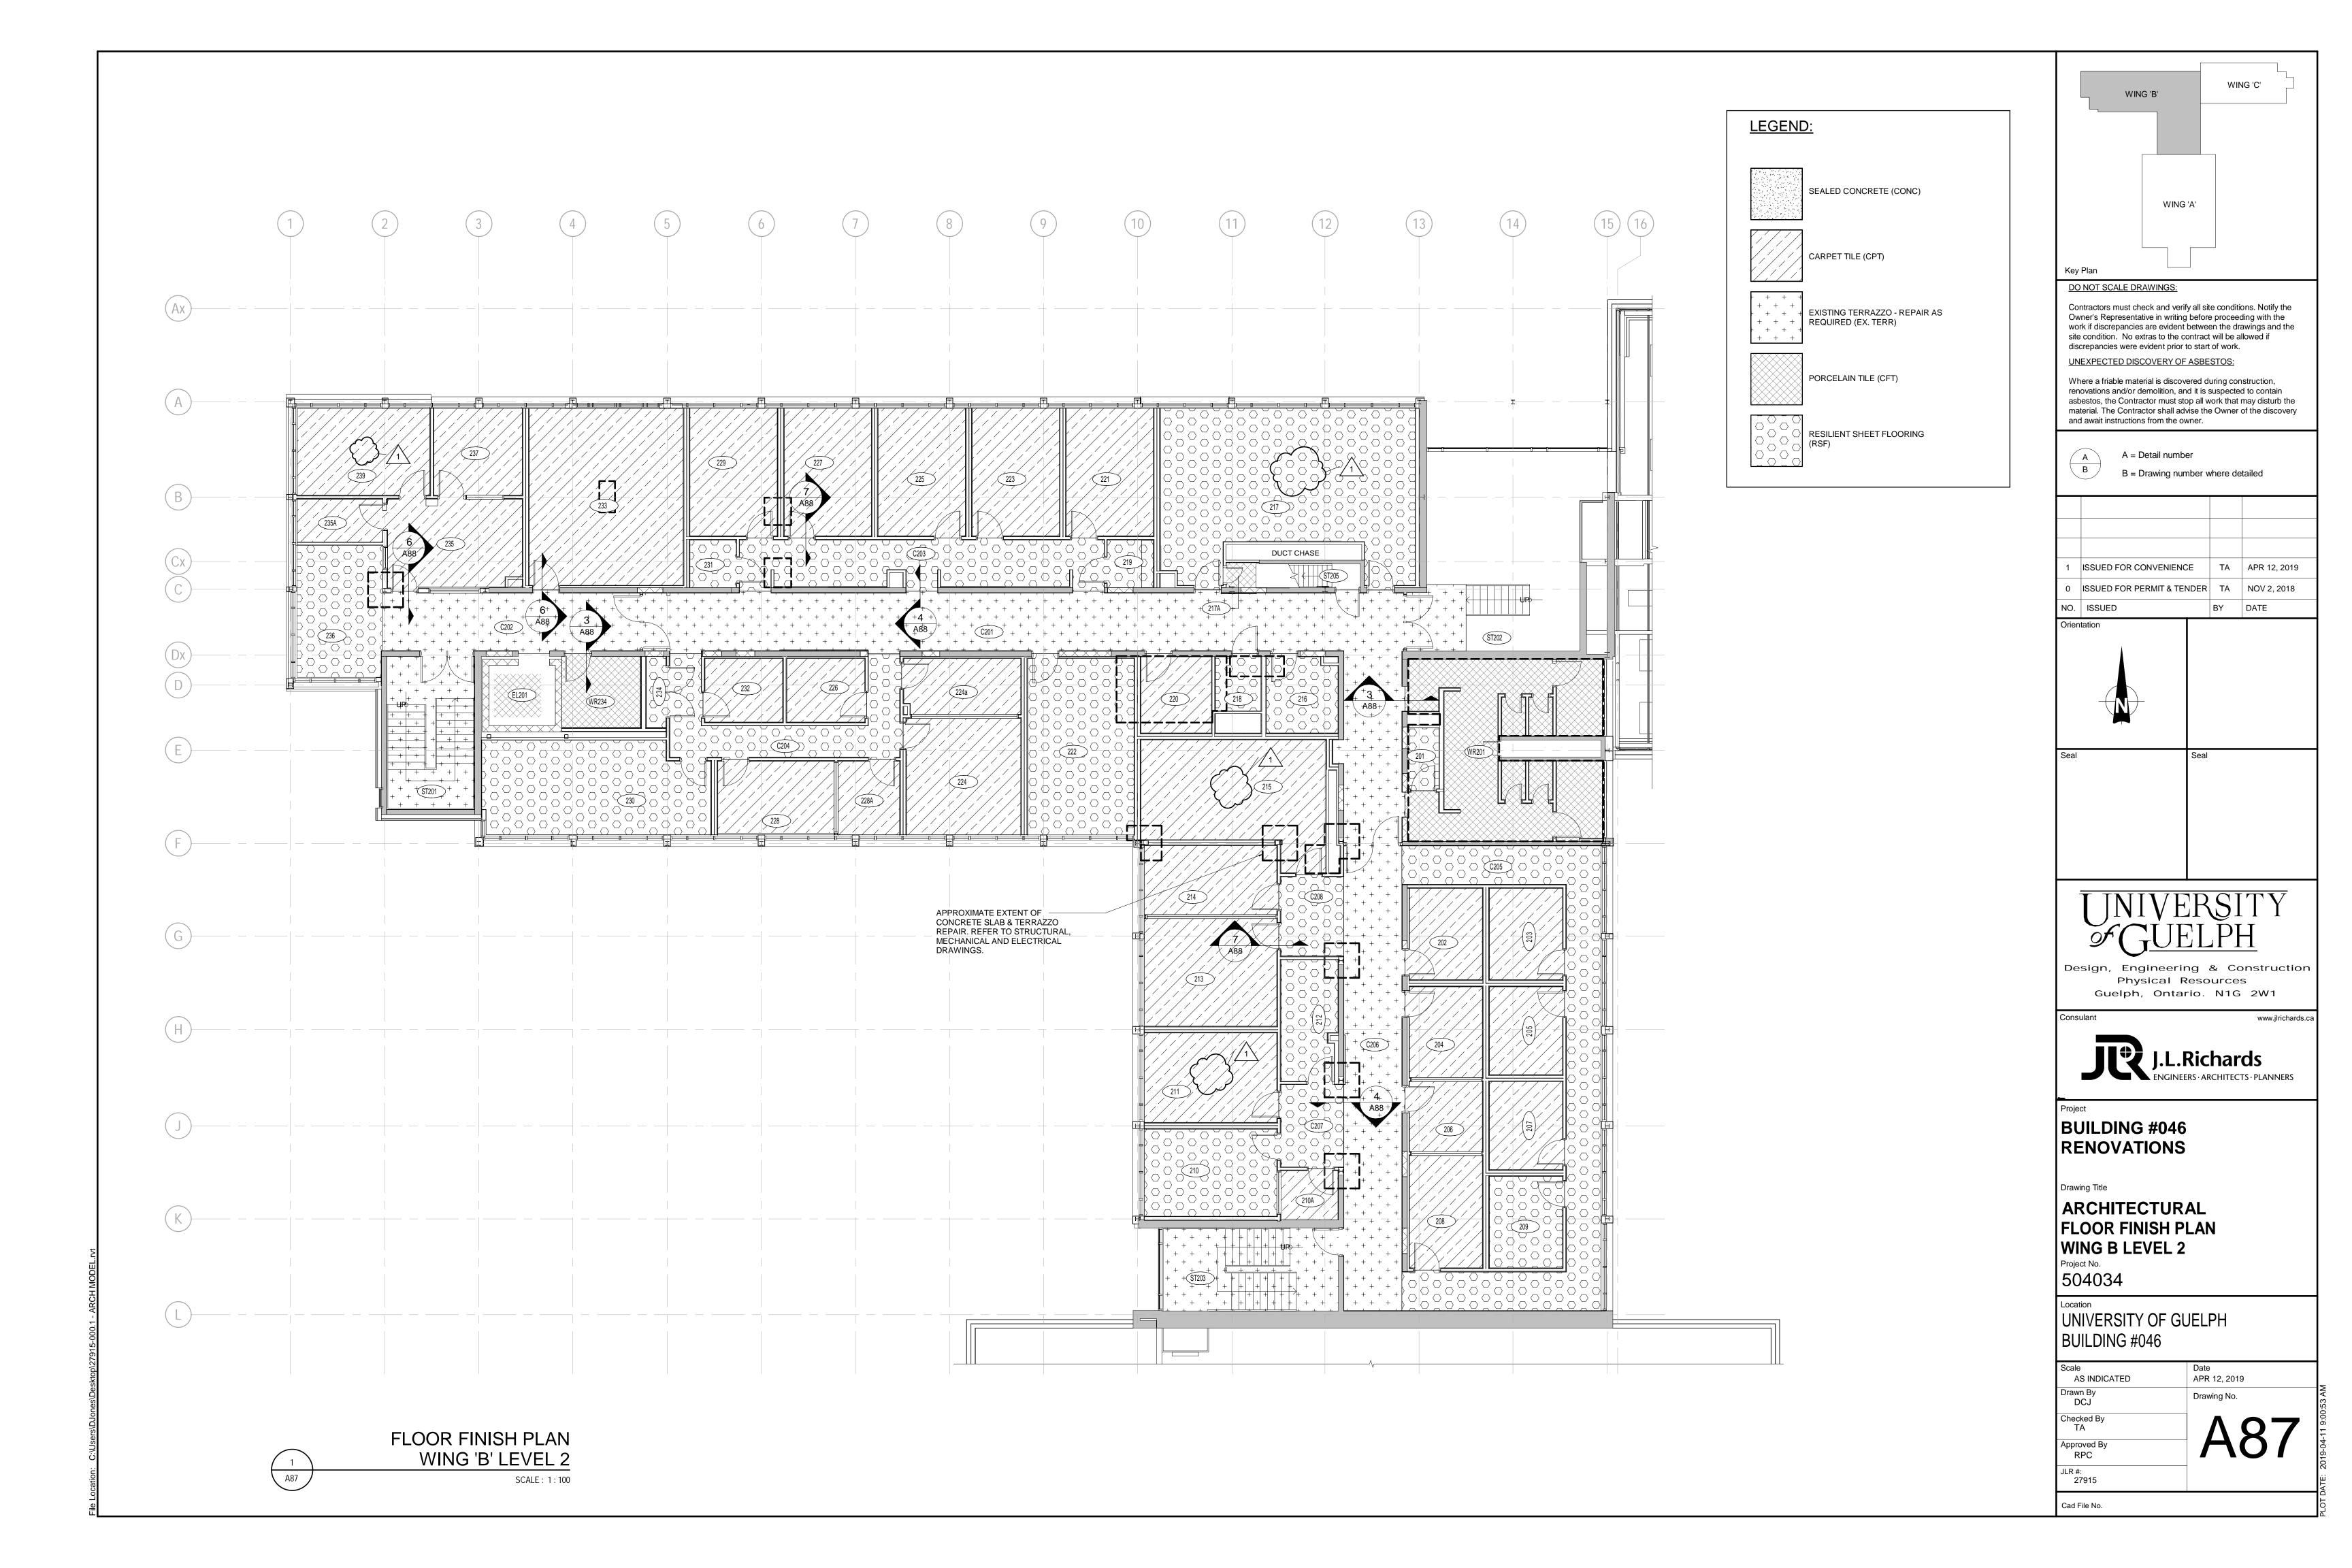
ARCHITECTURAL ROOM FINISH SCHEDULE


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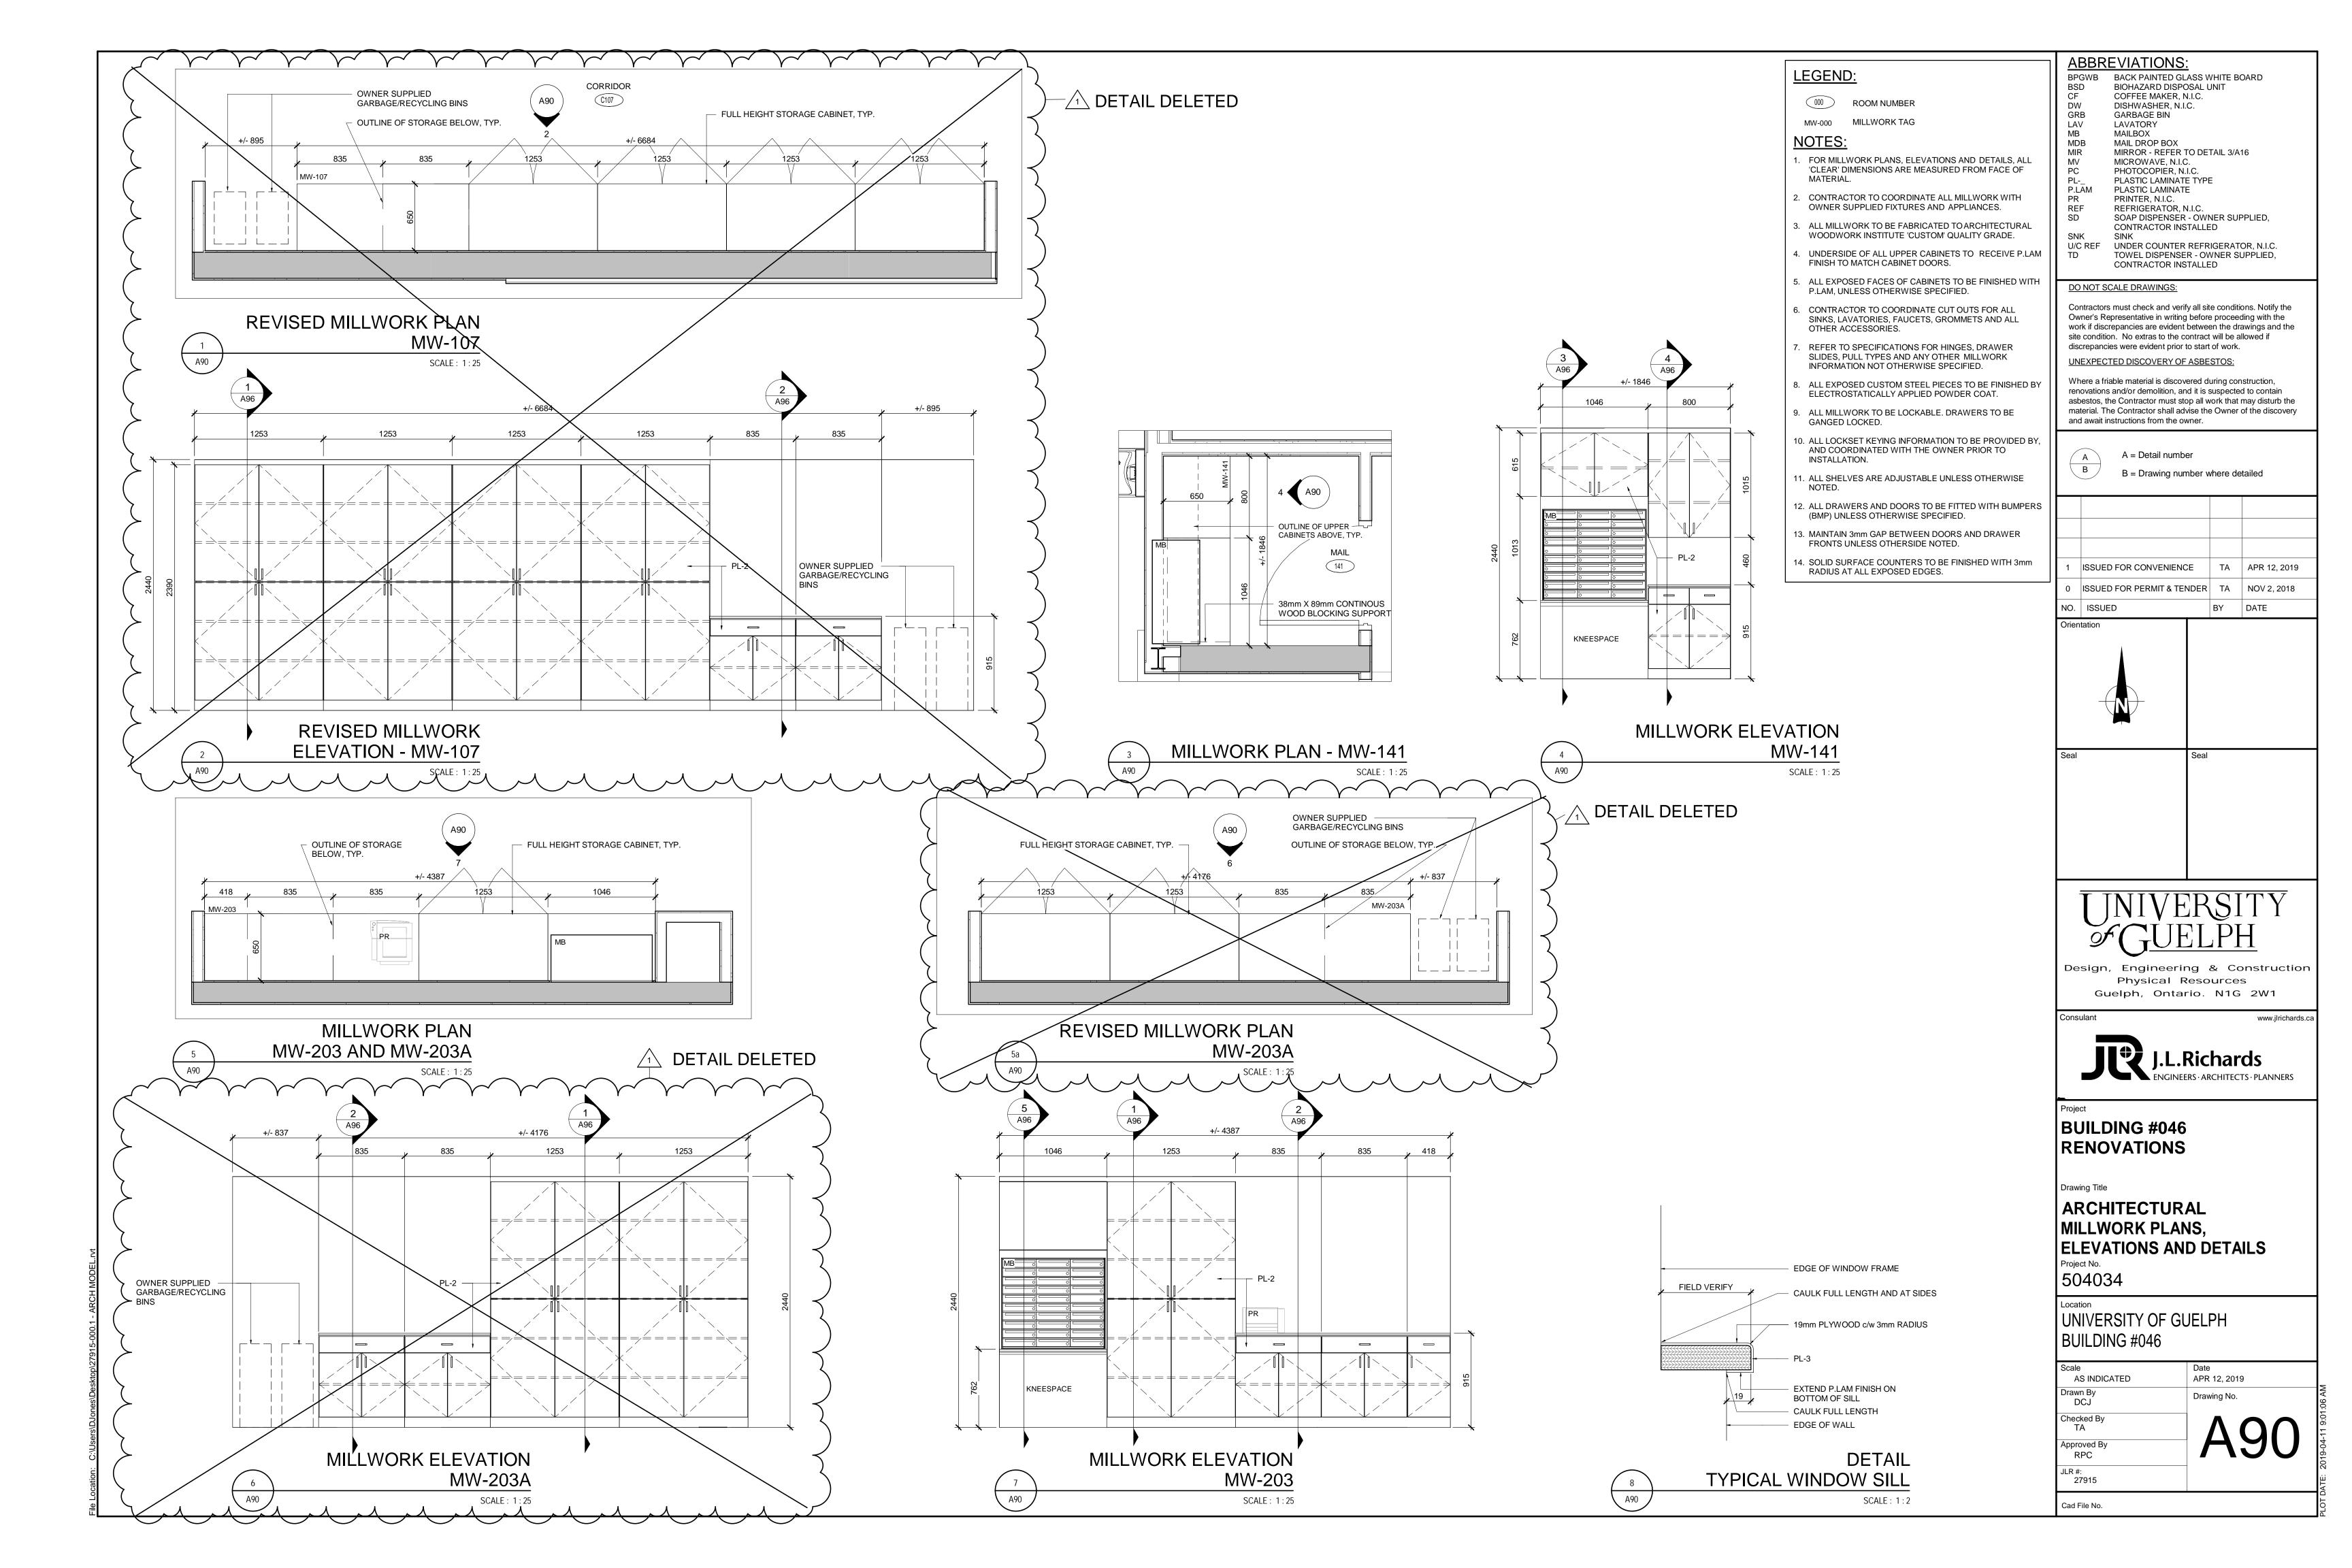
UNIVERSITY OF GUELPH BUILDING #046


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Drawn By DCJ	Drawing No.	9:00:27 AM
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Approved By RPC	HOU	2019-04-11
JLR #: 27915		DATE: 2
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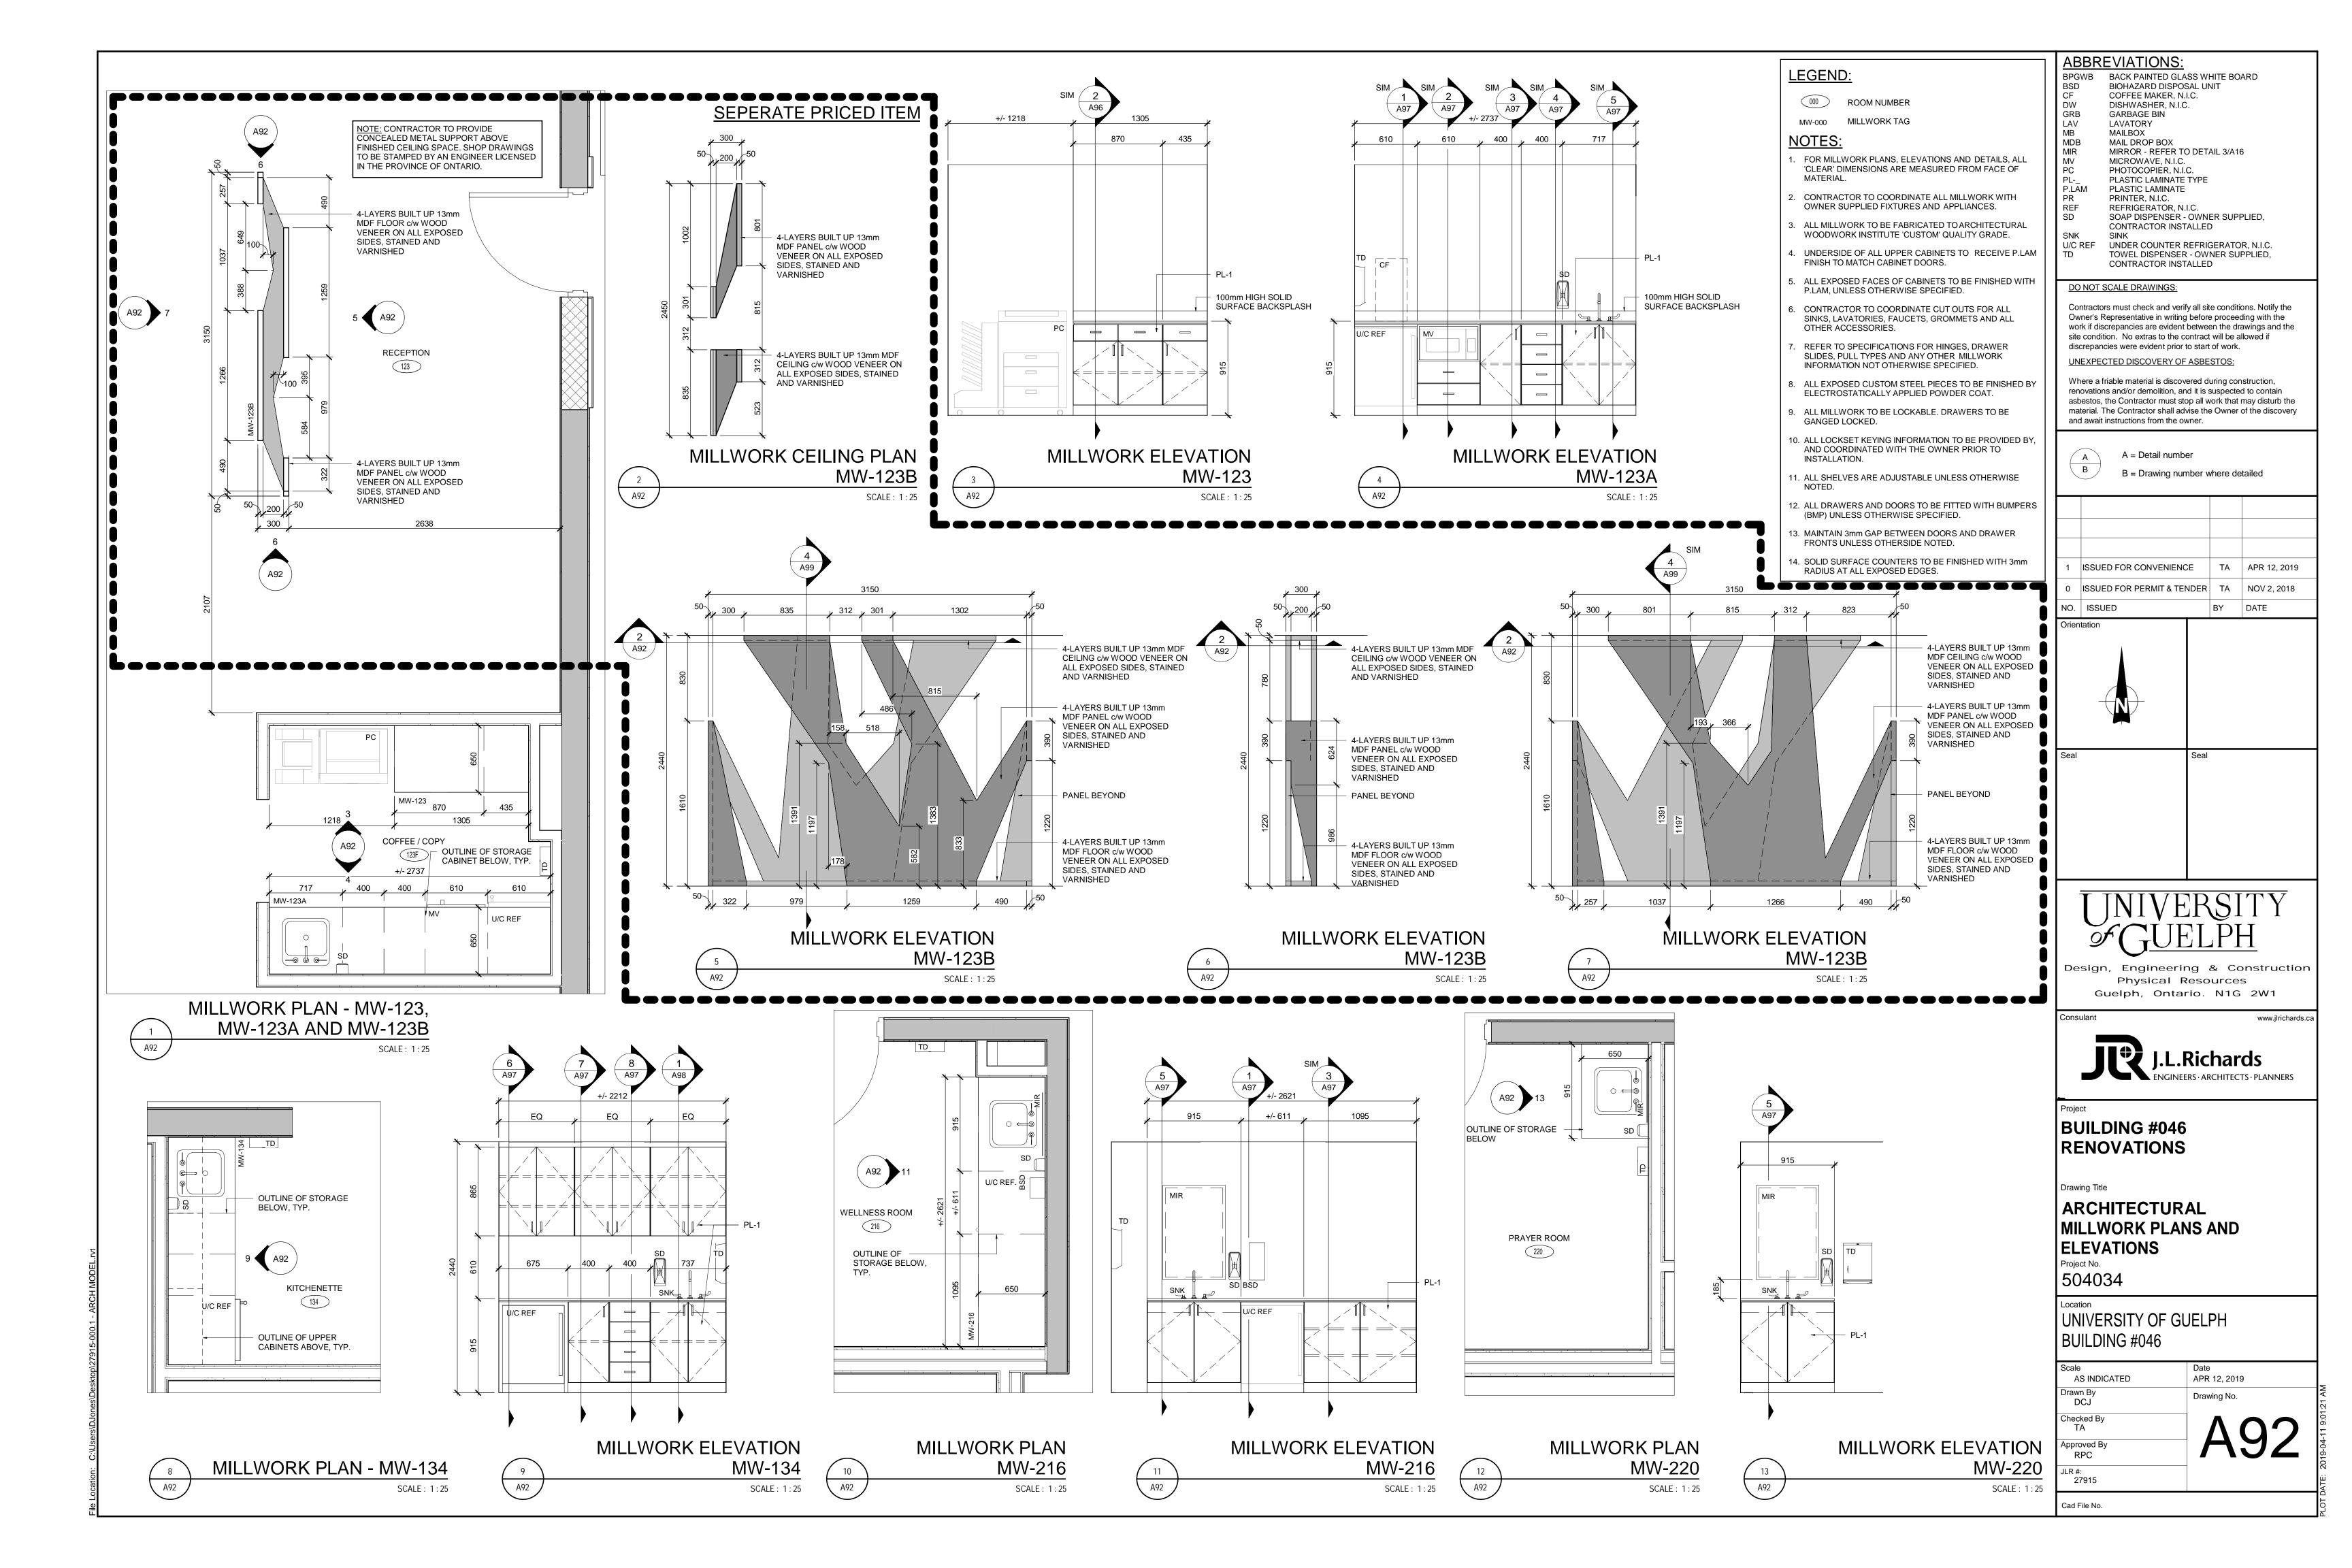








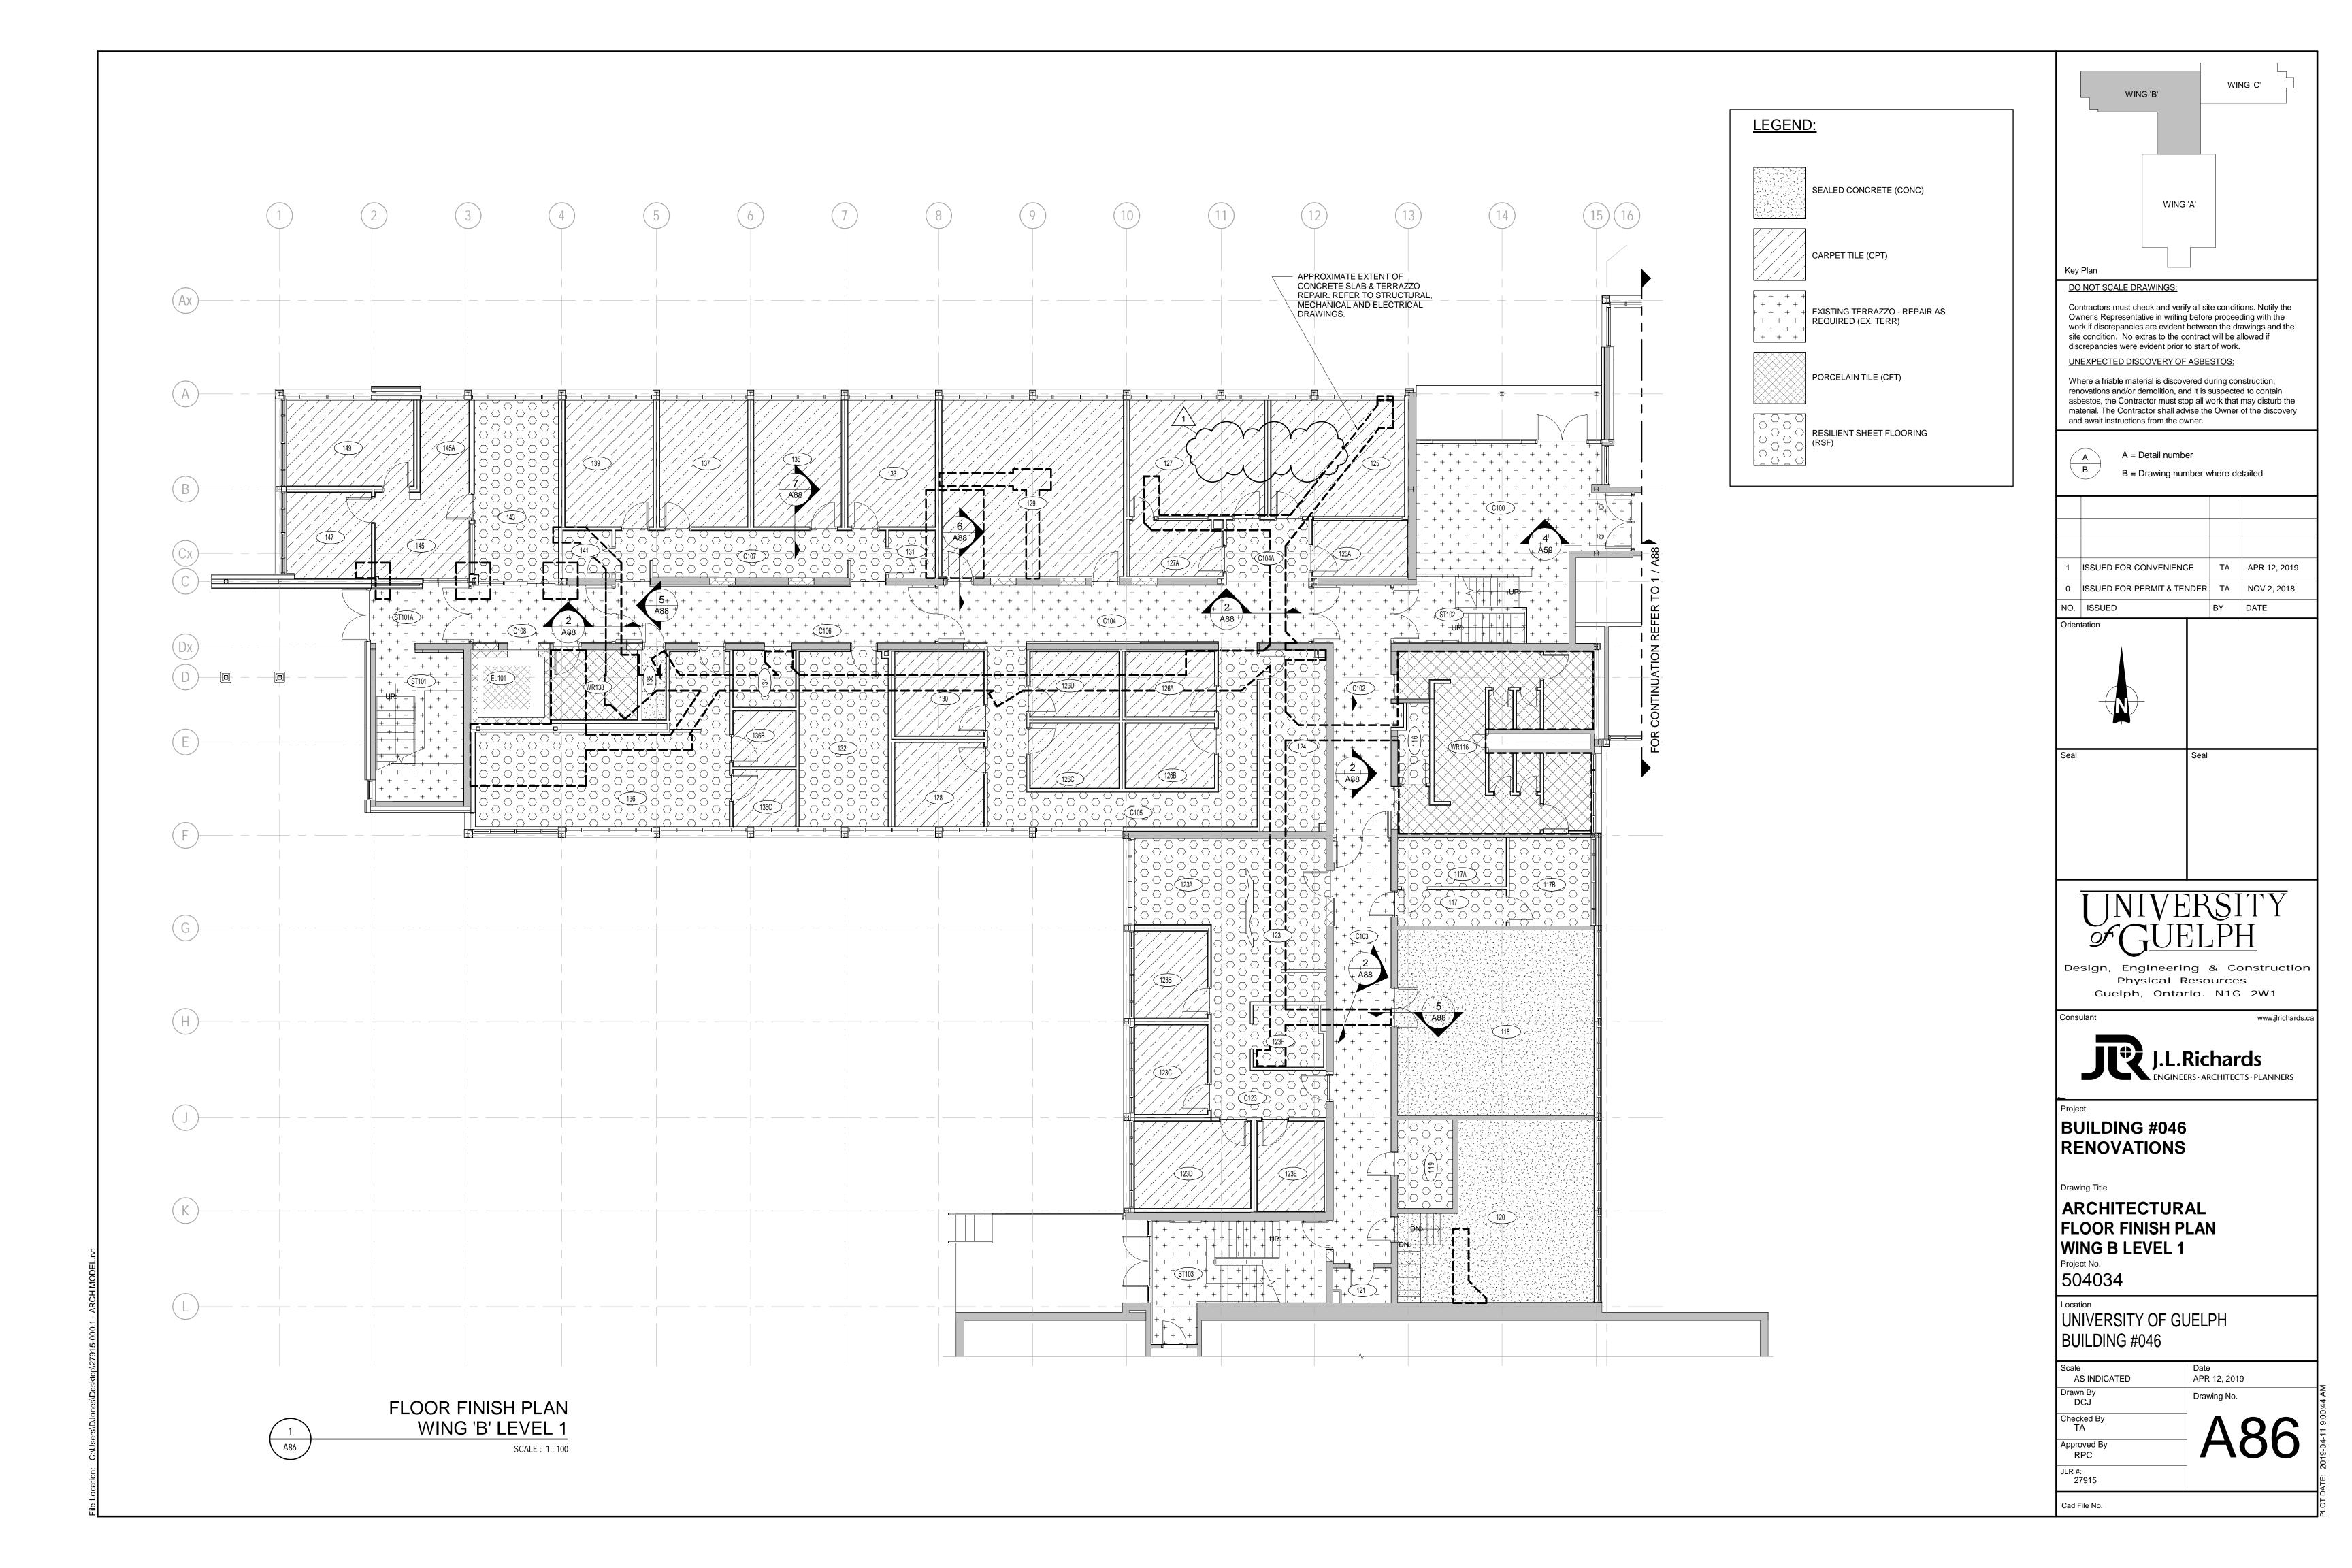


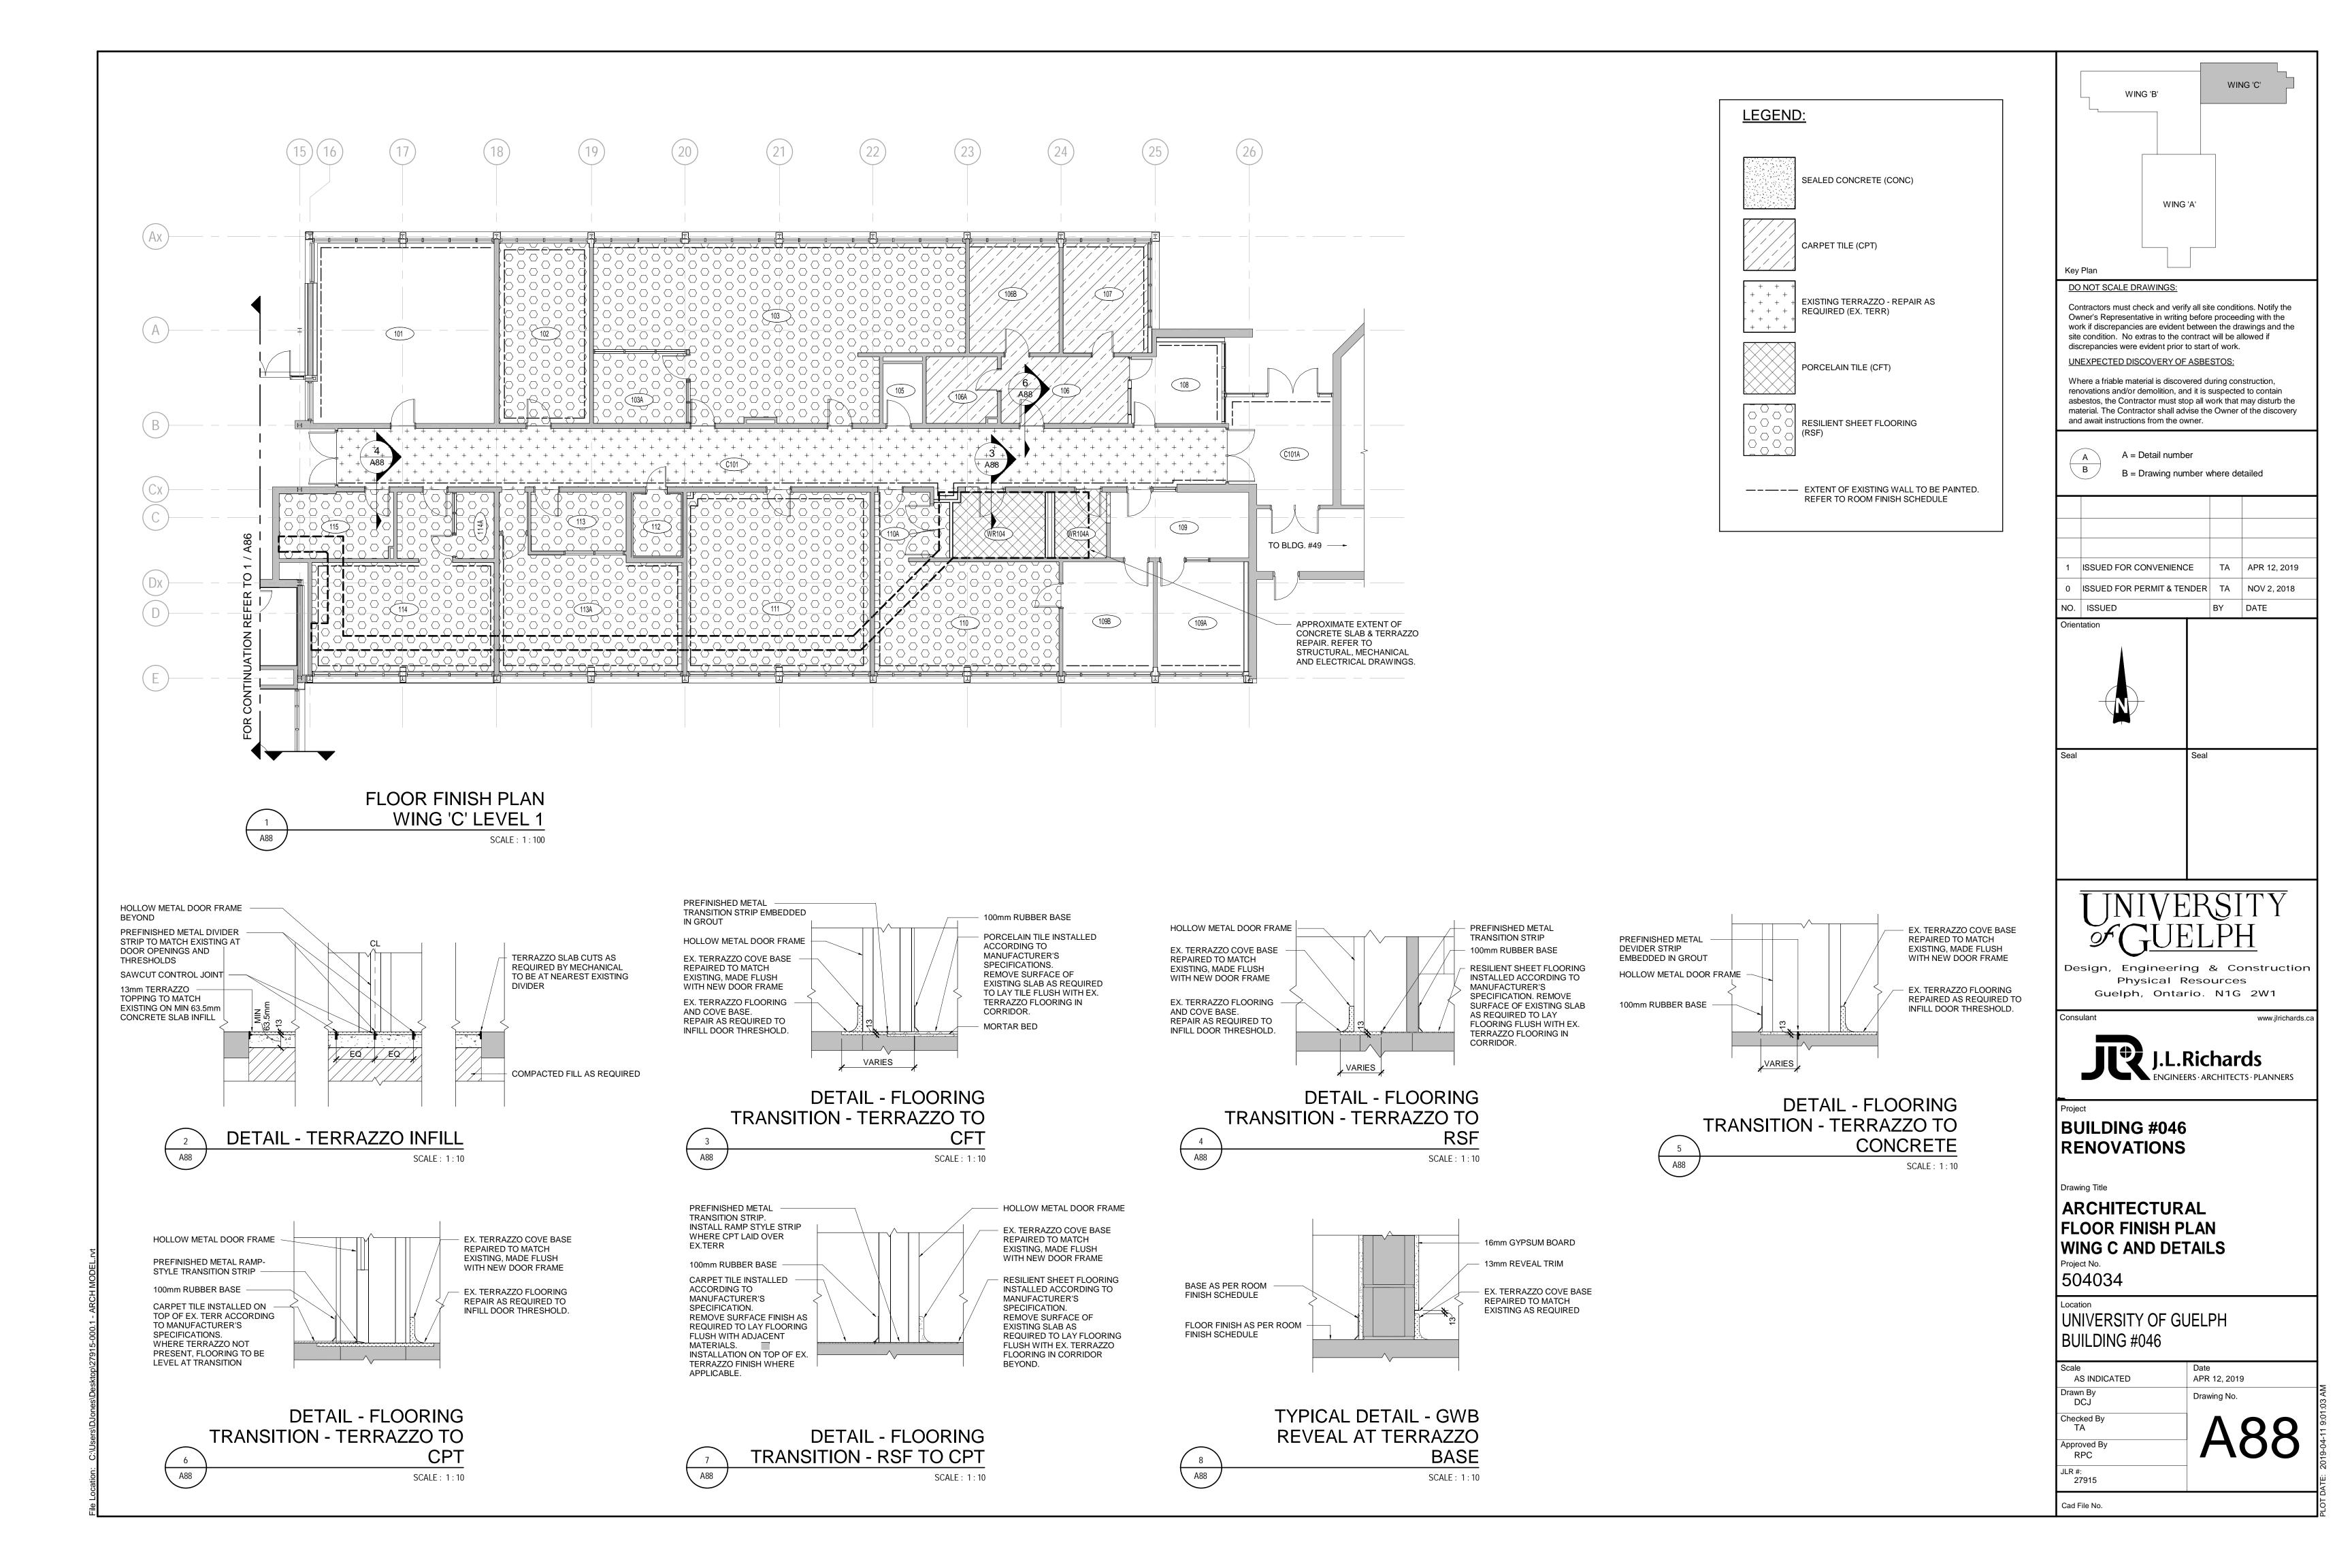

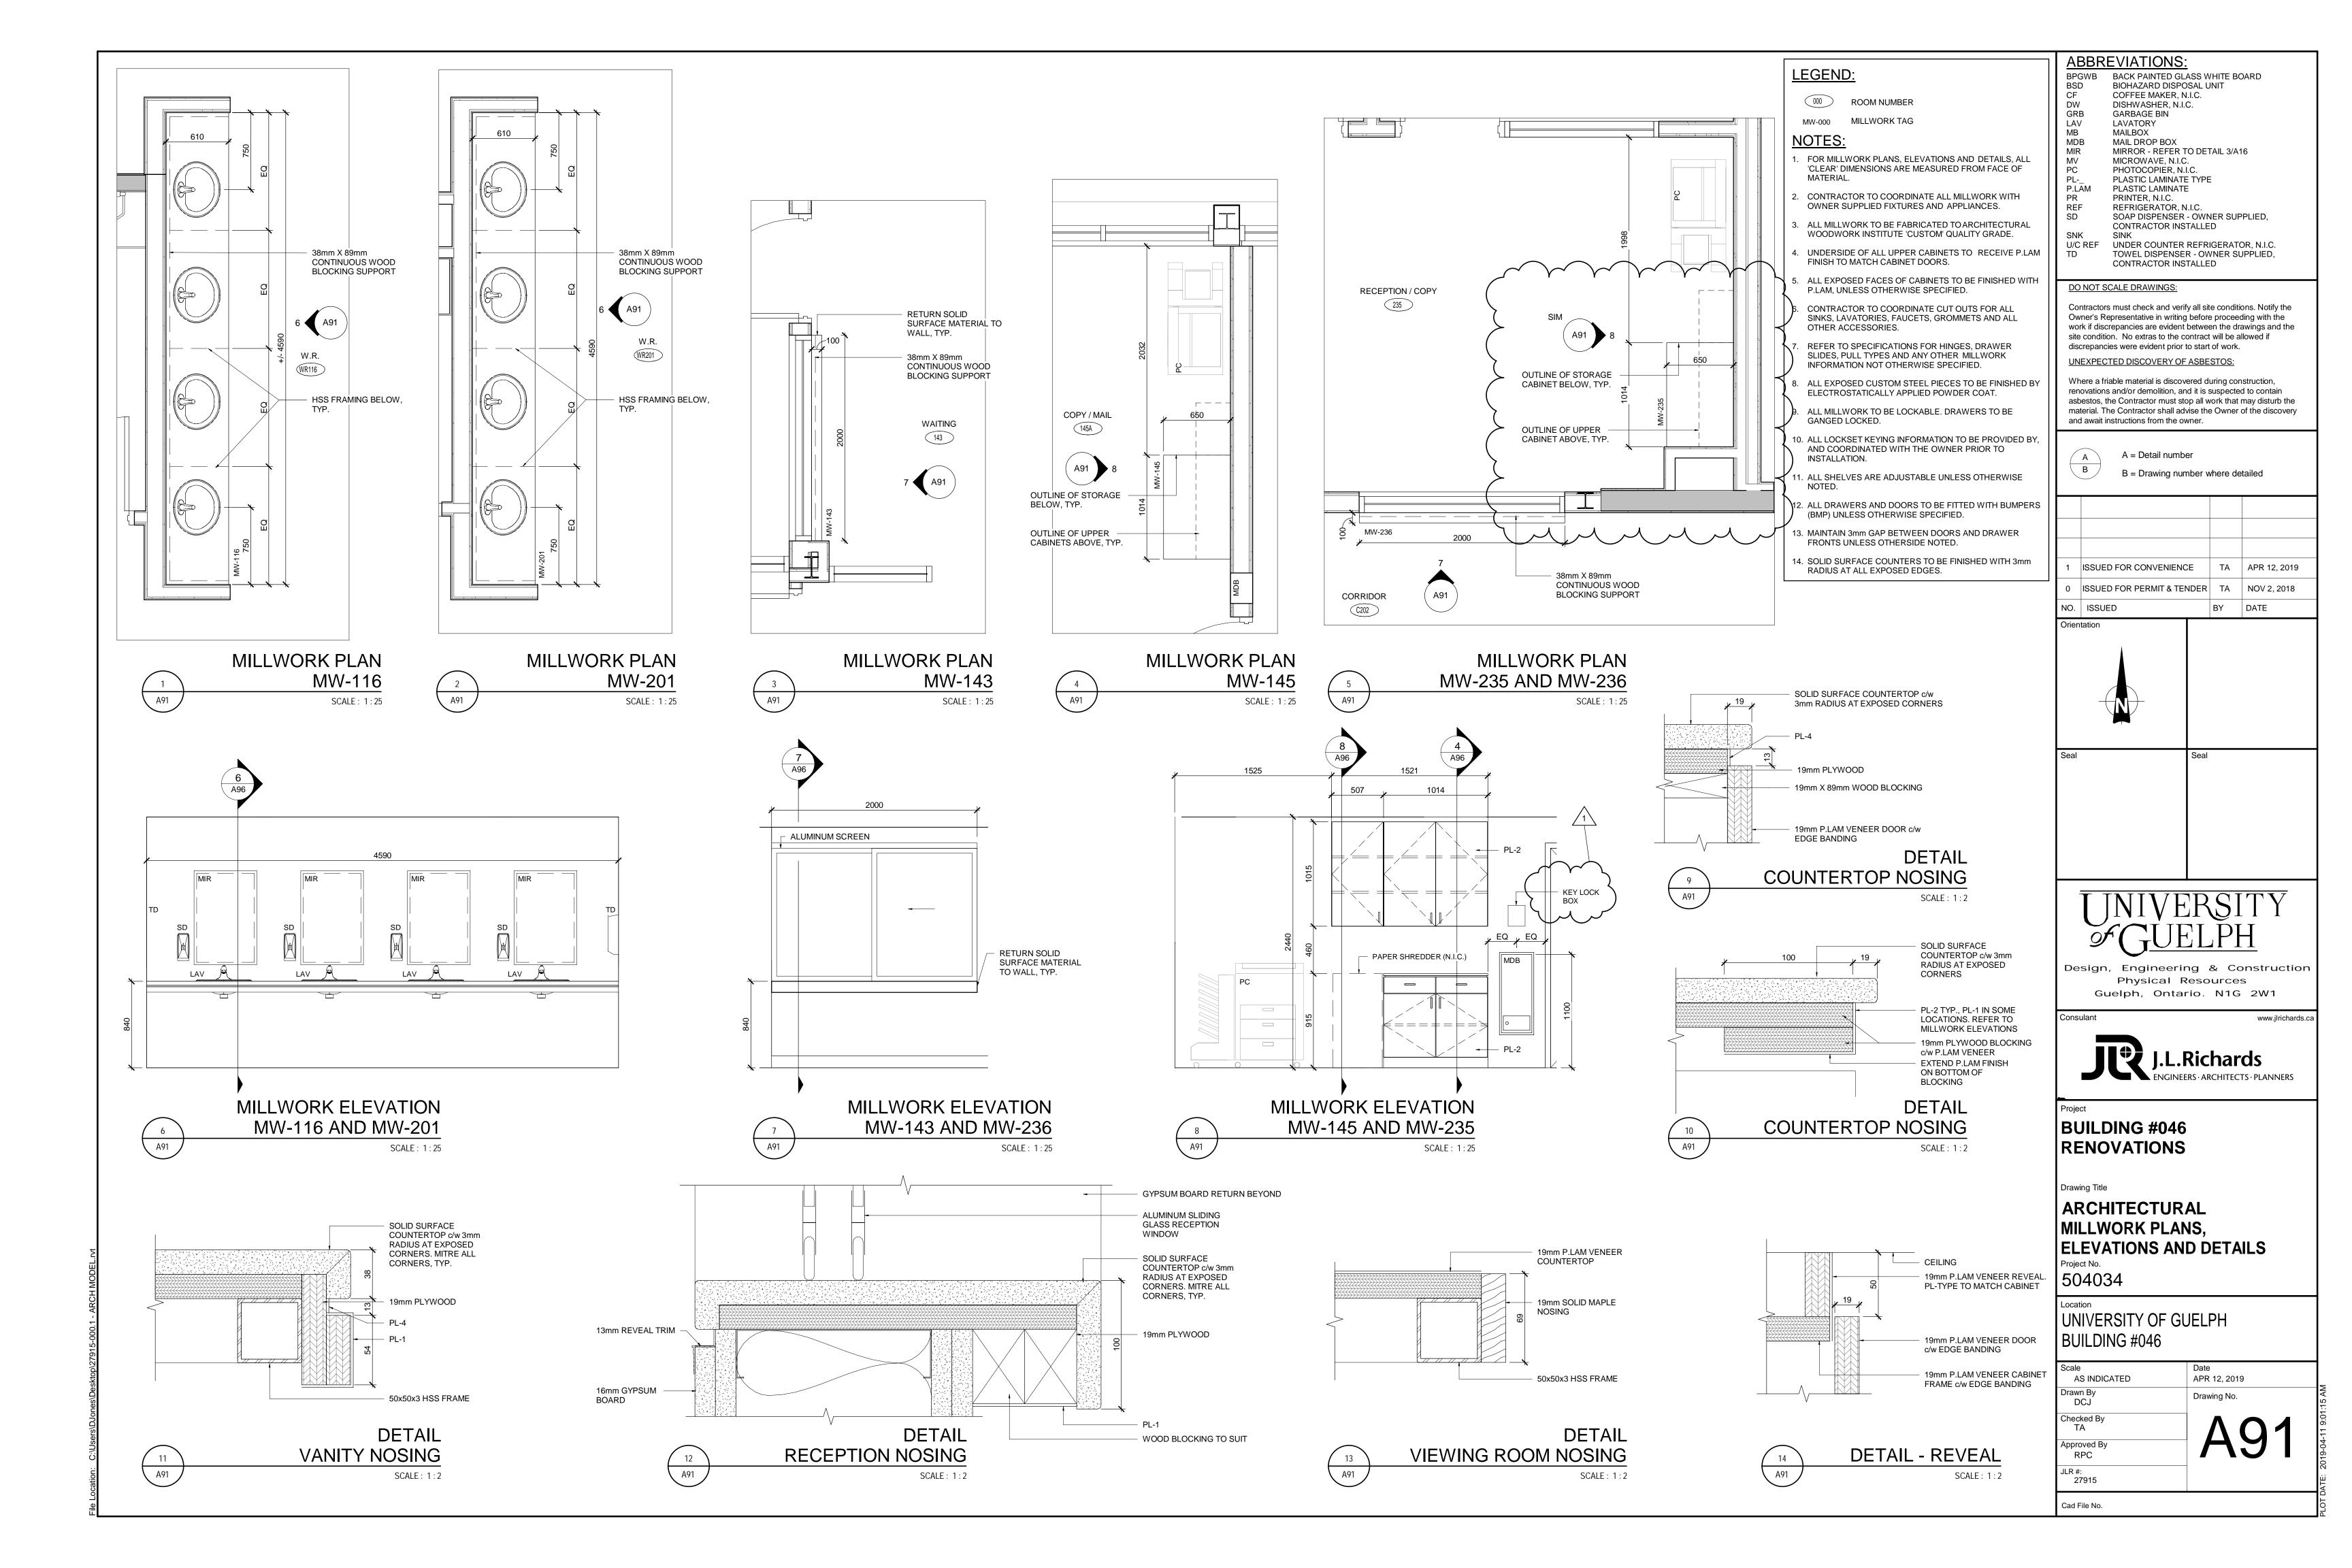

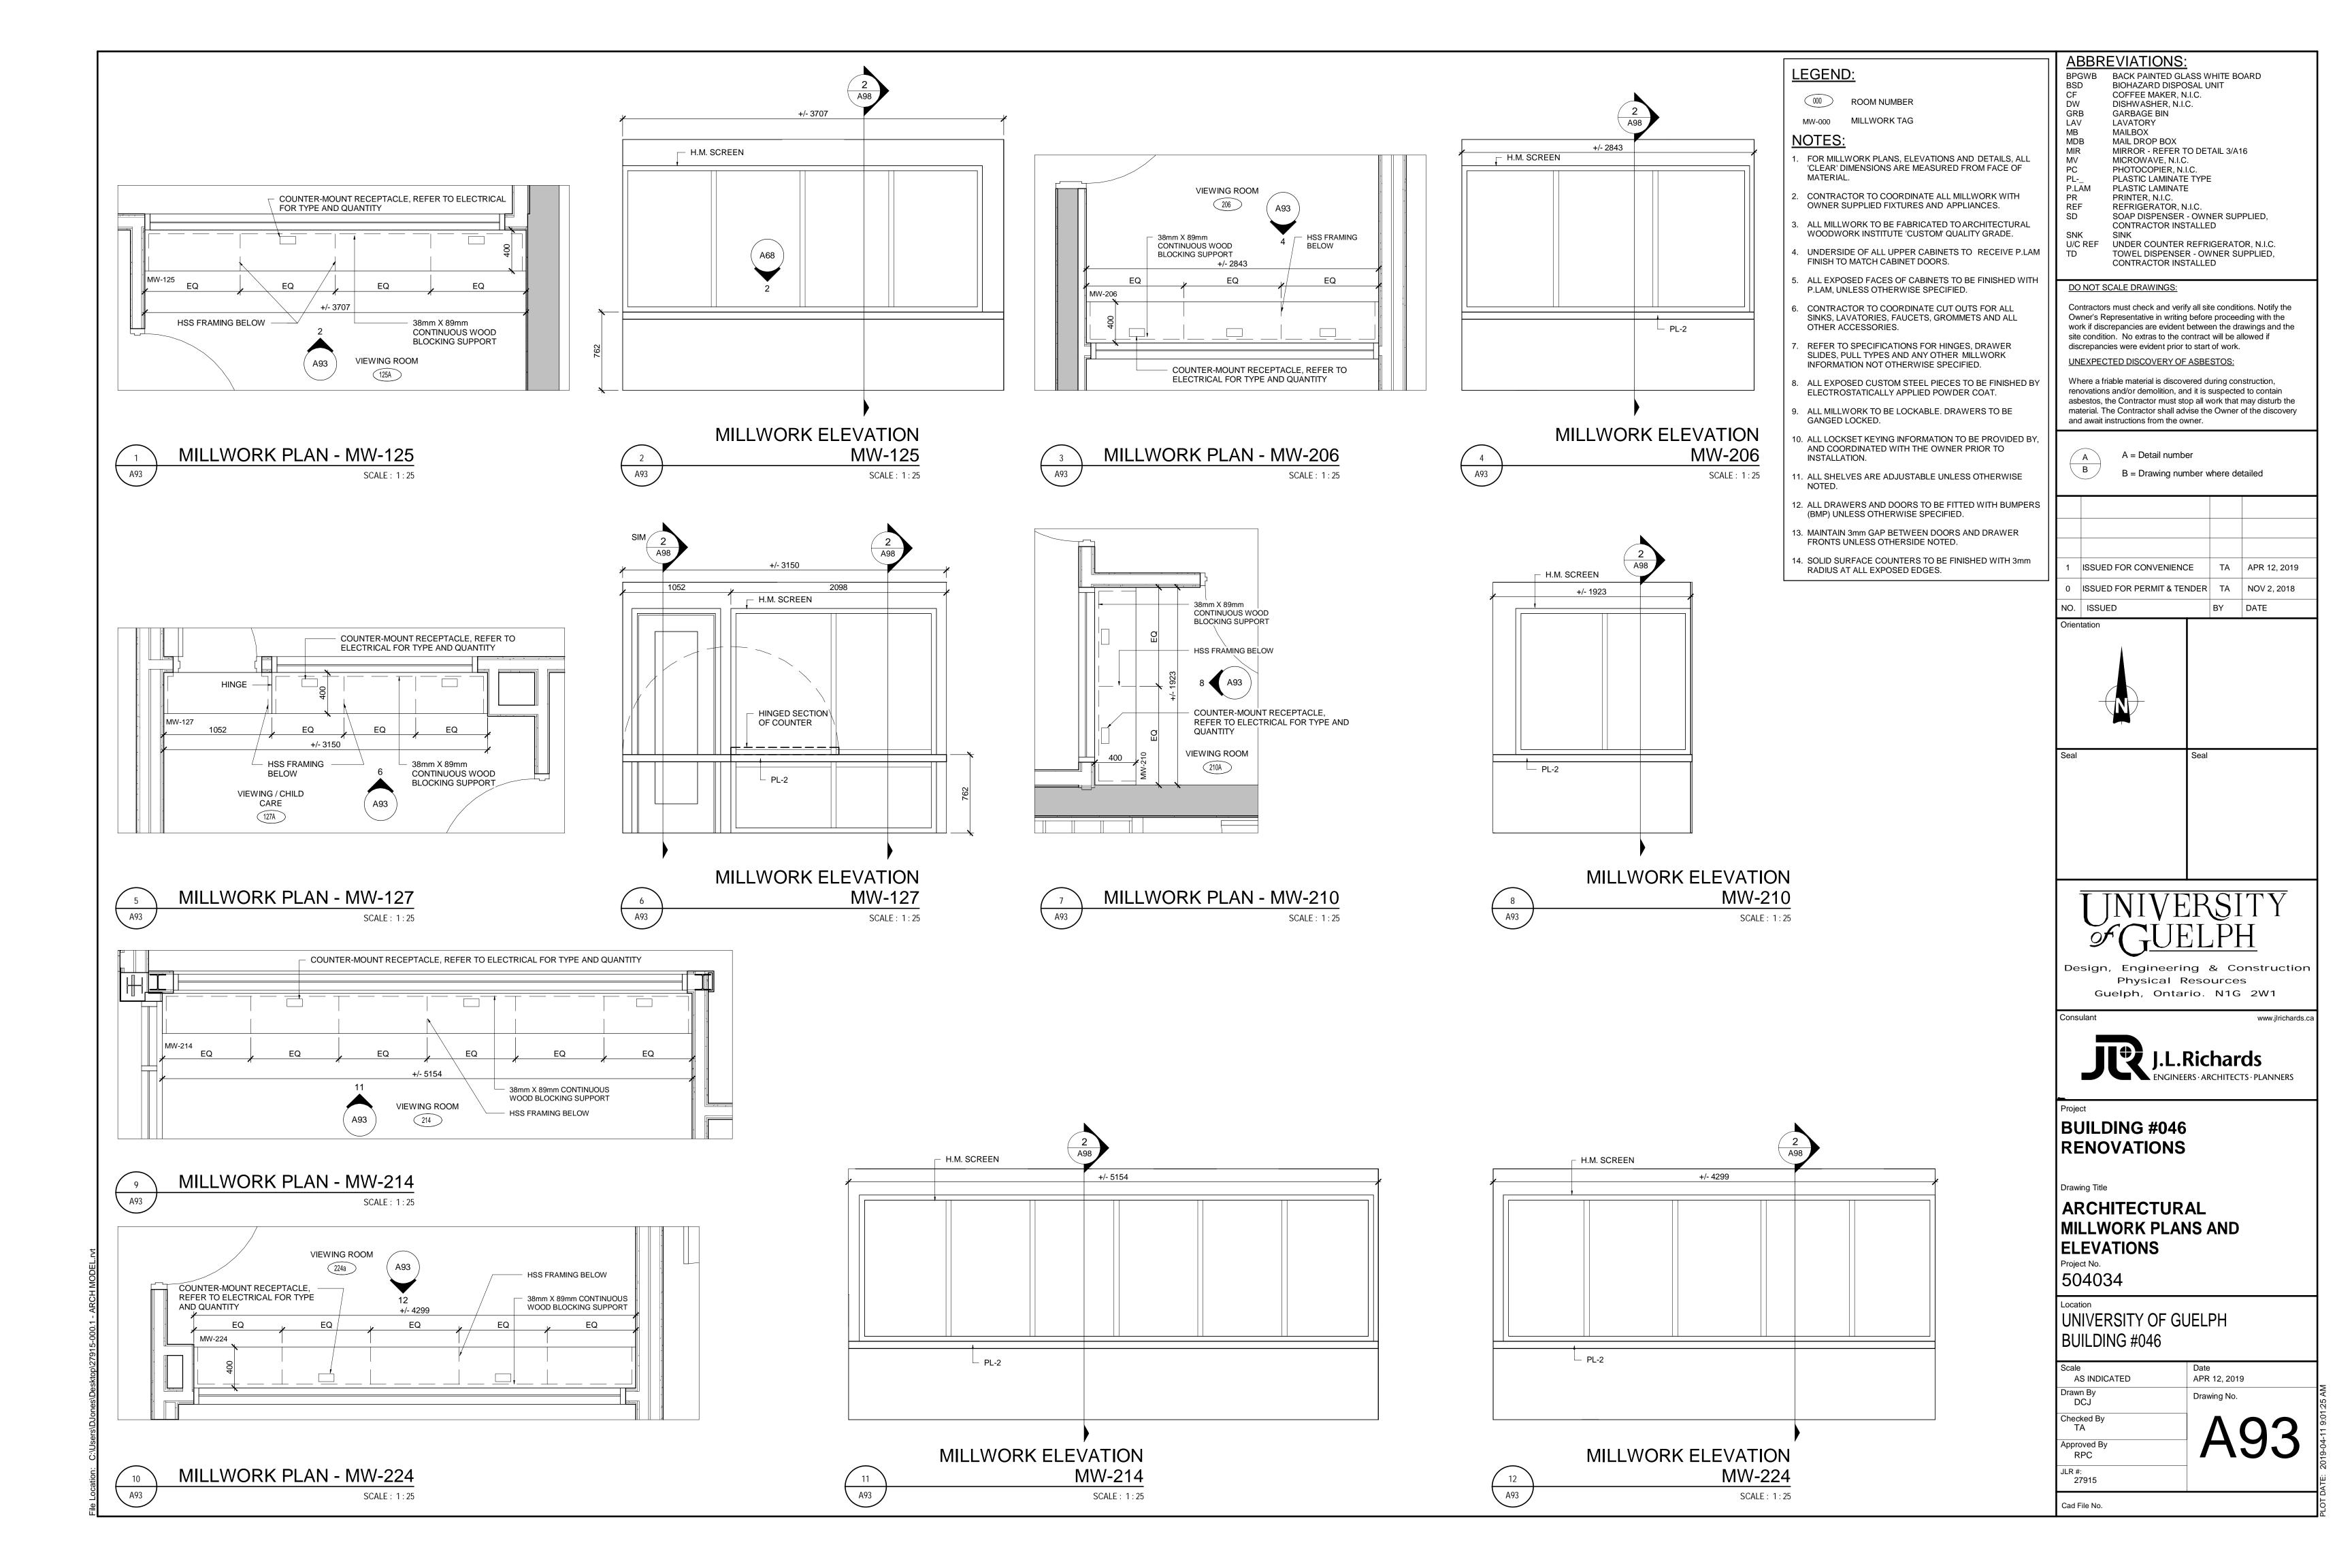

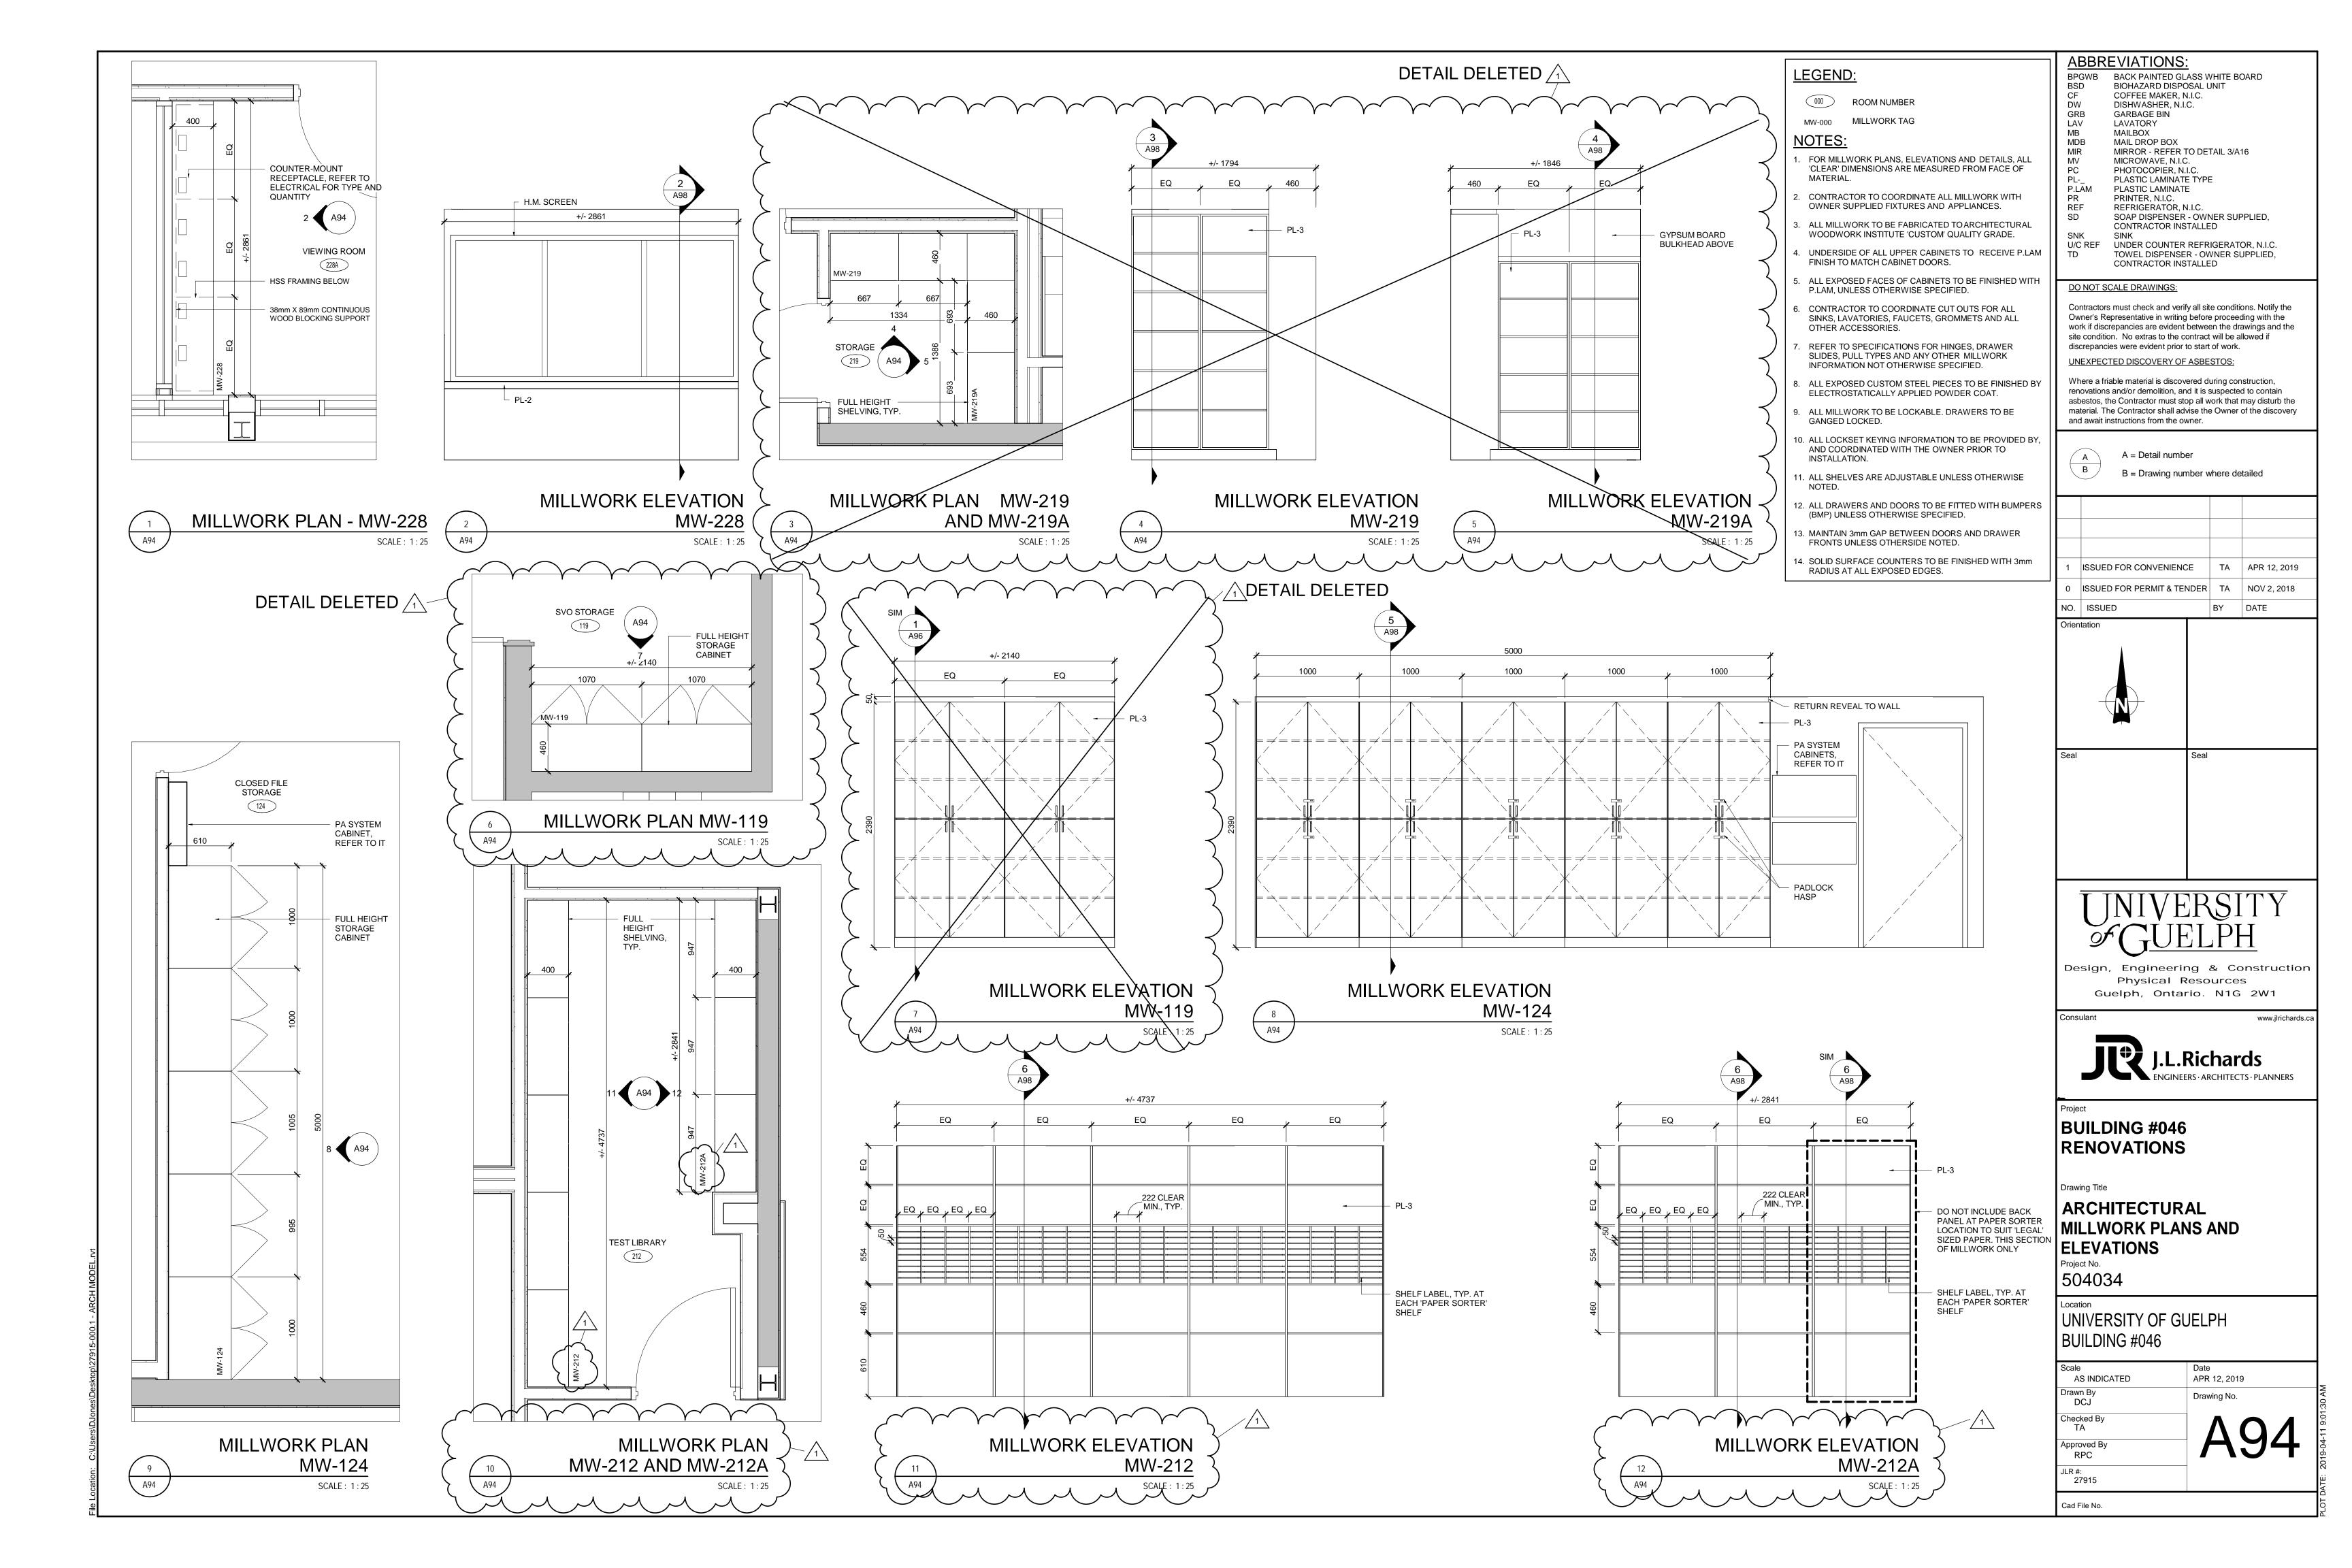

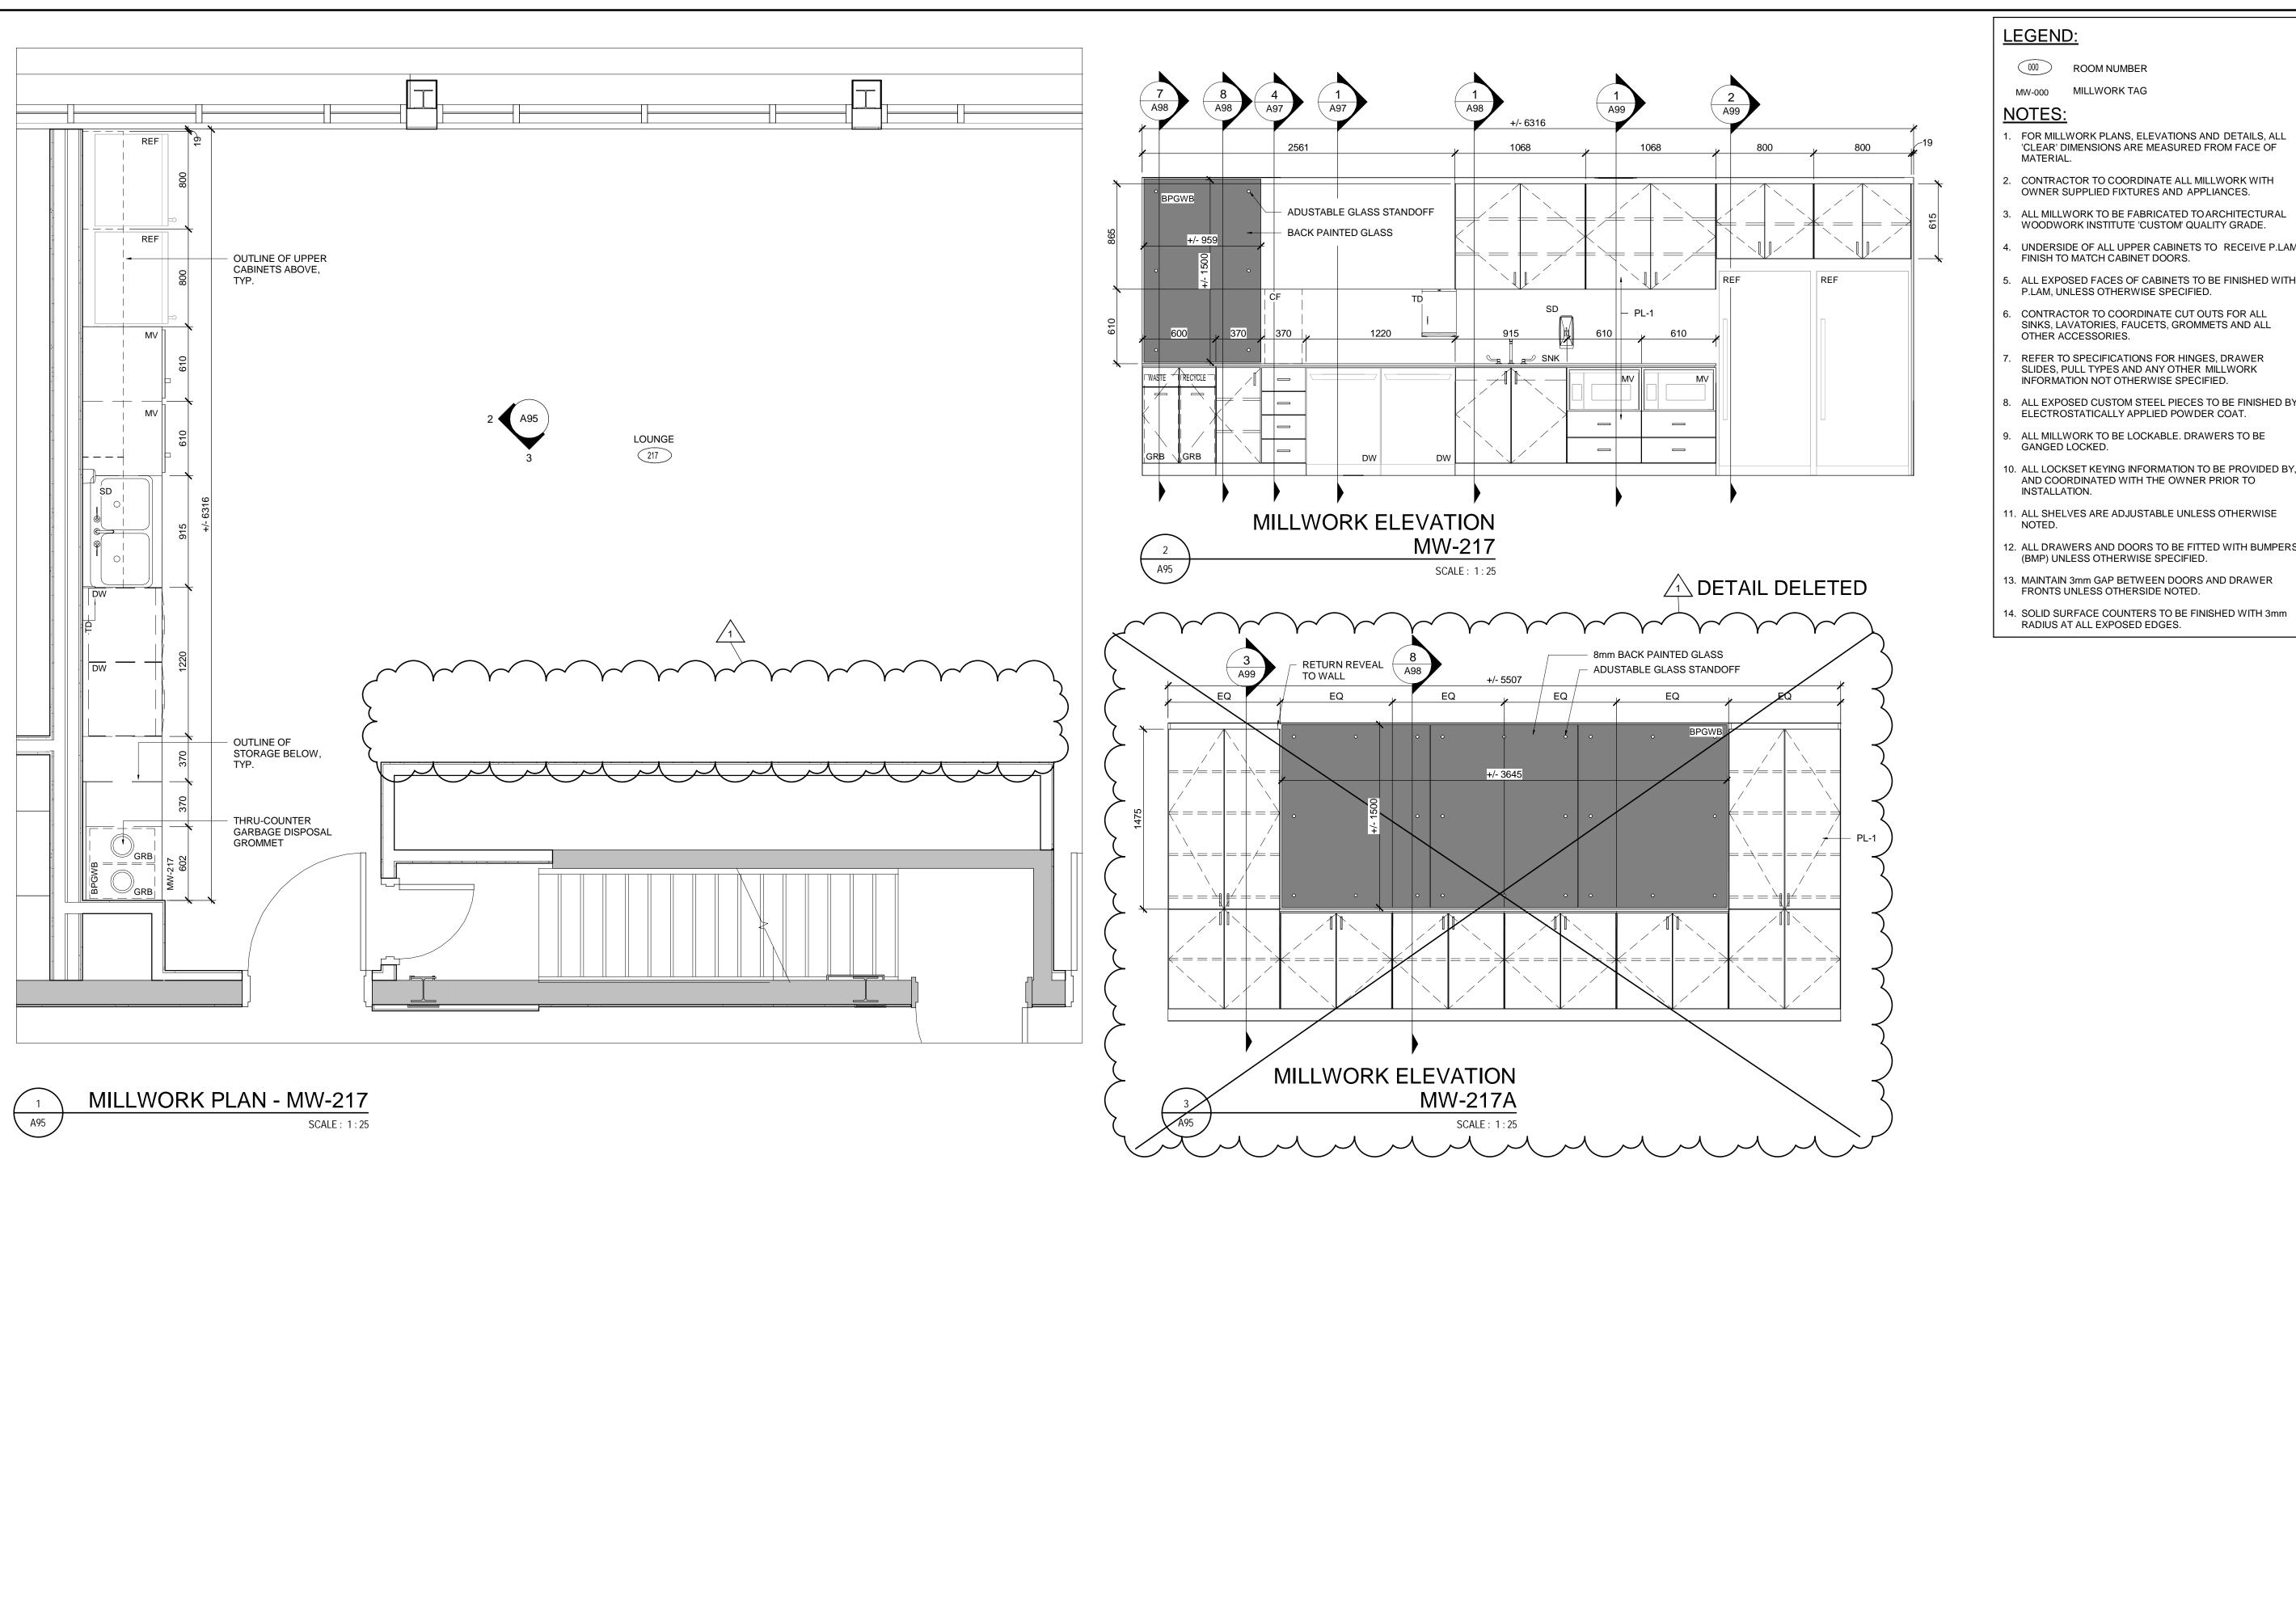

MW-000 MILLWORK TAG

FOR MILLWORK PLANS, ELEVATIONS AND DETAILS, ALL 'CLEAR' DIMENSIONS ARE MEASURED FROM FACE OF

. CONTRACTOR TO COORDINATE ALL MILLWORK WITH OWNER SUPPLIED FIXTURES AND APPLIANCES.

ALL MILLWORK TO BE FABRICATED TO ARCHITECTURAL WOODWORK INSTITUTE 'CUSTOM' QUALITY GRADE.

UNDERSIDE OF ALL UPPER CABINETS TO RECEIVE P.LAM

. ALL EXPOSED FACES OF CABINETS TO BE FINISHED WITH

CONTRACTOR TO COORDINATE CUT OUTS FOR ALL SINKS, LAVATORIES, FAUCETS, GROMMETS AND ALL

REFER TO SPECIFICATIONS FOR HINGES, DRAWER SLIDES, PULL TYPES AND ANY OTHER MILLWORK

8. ALL EXPOSED CUSTOM STEEL PIECES TO BE FINISHED BY ELECTROSTATICALLY APPLIED POWDER COAT.

9. ALL MILLWORK TO BE LOCKABLE. DRAWERS TO BE

11. ALL SHELVES ARE ADJUSTABLE UNLESS OTHERWISE

12. ALL DRAWERS AND DOORS TO BE FITTED WITH BUMPERS

13. MAINTAIN 3mm GAP BETWEEN DOORS AND DRAWER

14. SOLID SURFACE COUNTERS TO BE FINISHED WITH 3mm

GRB LAV MDB

CF DW

MAILBOX MAIL DROP BOX MIRROR - REFER TO DETAIL 3/A16 MIR MV PC MICROWAVE, N.I.C.

GARBAGE BIN

LAVATORY

BPGWB BACK PAINTED GLASS WHITE BOARD BIOHAZARD DISPOSAL UNIT

COFFEE MAKER, N.I.C.

DISHWASHER, N.I.C.

ABBREVIATIONS:

PHOTOCOPIER, N.I.C. PLASTIC LAMINATE TYPE PLASTIC LAMINATE PRINTER, N.I.C. REF

SOAP DISPENSER - OWNER SUPPLIED, SD CONTRACTOR INSTALLED SNK U/C REF UNDER COUNTER REFRIGERATOR, N.I.C.
TD TOWEL DISPENSER - OWNER SUPPLIED,

REFRIGERATOR, N.I.C.

DO NOT SCALE DRAWINGS:

UNEXPECTED DISCOVERY OF ASBESTOS:

Contractors must check and verify all site conditions. Notify the Owner's Representative in writing before proceeding with the work if discrepancies are evident between the drawings and the site condition. No extras to the contract will be allowed if discrepancies were evident prior to start of work.

CONTRACTOR INSTALLED

Where a friable material is discovered during construction, renovations and/or demolition, and it is suspected to contain asbestos, the Contractor must stop all work that may disturb the material. The Contractor shall advise the Owner of the discovery and await instructions from the owner.

A = Detail number

B = Drawing number where detailed

1	ISSUED FOR CONVENIENCE	TA	APR 12, 2019
0	ISSUED FOR PERMIT & TENDER	TA	NOV 2, 2018
NO.	ISSUED	BY	DATE

Design, Engineering & Construction Physical Resources Guelph, Ontario. N1G 2W1

.L.Richards

www.jlrichards.ca

BUILDING #046 RENOVATIONS

Drawing Title

ARCHITECTURAL MILLWORK PLANS AND **ELEVATIONS**

Project No. 504034

UNIVERSITY OF GUELPH BUILDING #046

AS INDICATED APR 12, 2019 Drawn By Drawing No. Checked By Approved By RPC JLR #: 27915 Cad File No.

