COVER	S AND DRAWING LISTS	MECHA	ANICAI
00 00	COVER SHEET	DM10	DEMOLITION PLUMBING - WING B LEVEL 1
CIVIL		DM11 DM12	DEMOLITION PLUMBING - WING B LEVEL 2 DEMOLITION PLUMBING - WING C LEVEL 1
C01	SITE SERVICING PLAN	DM13	DEMOLITION HVAC - WING B LEVEL 1
C02	CIVIL DETAILS	DM14 DM15	DEMOLITION HVAC - WING B LEVEL 2 DEMOLITION HVAC - WING C LEVEL 1
ARCHIT	ECTURAL	DM16 M10	DEMOLITION MECHANICAL - RM 120 AND PENTHOUSE 302 PLUMBING - WING B LEVEL 1
A01 A02	OBC REVIEW OBC DATA	M11	PLUMBING - WING B LEVEL 2
A05	CONSTRUCTION TYPES	M12 M20	PLUMBING - WING C LEVEL 1 HEATING - WING B LEVEL 1
A10 A11	EXISTING FLOOR PLAN - WING B LEVEL 1 EXISTING FLOOR PLAN - WING B LEVEL 2	M21	HEATING - WING B LEVEL 2
A12 A13	EXISTING FLOOR PLAN - PENTHOUSES AND WING C ALTERED FLOOR PLAN - WING B LEVEL 1	M22 M30	HEATING - WING C LEVEL 1 VENTILATION - WING B LEVEL 1
A14	ALTERED FLOOR PLAN - WING B LEVEL 2	M31 M32	VENTILATION - WING B LEVEL 2 VENTILATION - WING C LEVEL 1
A15 A16	ALTERED FLOOR PLAN - PENTHOUSES AND WING C PARTIAL ALTERED FLOOR PLANS	M40	FIRE SUPPRESSION - WING B AND C
A17	ALTERATIONS TO DIGESTER ROOM	M50 M51	MECHANICAL ROOM - WING B PENTHOUSE - WING B
A20 A21	EXISTING EXTERIOR ELEVATIONS ALTERED EXTERIOR ELEVATIONS	M52	ROOF PLAN
A22 A25	PARTIAL ALTERED EXTERIOR ELEVATIONS INTERIOR ELEVATIONS	M53 M54	MECHANICAL SECTIONS MECHANICAL STANDARD DETAILS
A26	INTERIOR ELEVATIONS	M60 M61	STEAM DISTRIBUTION SCHEMATICS HOT WATER HEATING SCHEMATICS
A27 A28	INTERIOR ELEVATIONS AND DETAILS INTERIOR ELEVATIONS AND DETAILS	M62	CHILLED WATER AND GLYCOL SCHEMATIC
A30	BUILDING SECTIONS	M63 M64	VENTILATION SCHEMATICS PLUMBING SCHEDULE AND SCHEMATICS
A31 A32	BUILDING SECTIONS EXISTING WALL SECTIONS	M66	HEATING SCHEDULES
A33	EXISTING WALL SECTIONS EXISTING WALL SECTIONS	M67 M68	VENTILATION SCHEDULES 1 OF 2 VENTILATION SCHEDULES 2 OF 2
A34 A35	ALTERED WALL SECTIONS	M70 M71	CONTROLS SCHEMATIC 1 OF 3 CONTROLS SCHEMATIC 2 OF 3
A36 A37	ALTERED WALL SECTIONS ALTERED WALL SECTIONS	M72	CONTROLS SCHEMATIC 3 OF 3
A40	PLAN DETAILS	M73 M80	CONTROLS PLAN MSCL
A41 A42	PLAN DETAILS PLAN DETAILS		
A43 A44	PLAN DETAILS PLAN DETAILS	ELECTI	
A45	SECTION DETAILS	DE10 DE11	EXISTING POWER AND FIRE ALARM - WING B LEVEL 1 EXISTING POWER AND FIRE ALARM - WING B LEVEL 2
A46 A47	SECTION DETAILS SECTION DETAILS	DE12 DE13	EXISTING ELECTRICAL SYSTEMS - WING C EXISTING LIGHTING - WING B LEVEL 1
A50	EXISTING RCP - WING B LEVEL 1	DE14	EXISTING LIGHTING - WING B LEVEL 2
A51 A52	EXISTING RCP - WING B LEVEL 2 EXISTING RCP - PENTHOUSE AND WING C	DE15 E01	SINGLE LINE DEMOLITION ELECTRICAL COVER SHEET & LUMINAIRE SCHEDULE
A53	ALTERED RCP - WING B LEVEL 1	E02	SINGLE LINE DIAGRAM
A54 A55	ALTERED RCP - WING B LEVEL 2 ALTERED RCP - PENTHOUSE AND WING C	E03 E09	ELECTRICAL SITE PLAN STAIR SECTIONS - WING B
A56 A57	PARTIAL REFLECTED CEILING PLANS AND DETAILS PARTIAL REFLECTED CEILING PLANS AND DETAILS	E10 E11	LIGHTING LAYOUT - WING B LEVEL 1 LIGHTING LAYOUT - WING B LEVEL 2
A58	PARTIAL REFLECTED CEILING PLANS AND DETAILS	E12	LIGHTING LAYOUT - WING C
A59 A60	CEILING AND BULKHEAD DETAILS ELEVATOR DETAILS	E15 E16	LIGHTING CONTROL SCHEMATICS SHEET No.1 LIGHTING CONTROL SCHEMATICS SHEET No.2
A65 A66	EXISTING PARTIAL FLOOR PLANS - STAIRS ALTERED PARTIAL FLOOR PLANS - STAIRS	E17	LIGHTING CONTROL SCHEMATICS SHEET No.3
A67	STAIR SECTIONS	E18 E20	LIGHTING CONTROL SCHEMATICS SHEET No.4 POWER LAYOUT - WING B LEVEL 1
A68 A70	STAIR DETAILS EXISTING ROOF PLAN	E21 E22	FIRE ALARM LAYOUT - WING B LEVEL 1 MECHANICAL EQUIPMENT - WING B LEVEL 1
A71	ALTERED ROOF PLAN AND DETAILS	E23	POWER LAYOUT - WING B LEVEL 2
A72 A75	ROOF DETAILS CANOPY DETAILS	E24 E25	FIRE ALARM LAYOUT - WING B LEVEL 2 MECHANICAL EQUIPMENT - WING B LEVEL 2
A80 A81	DOOR AND FRAME SCHEDULE, DOOR AND FRAME TYPES INTERIOR SCREEN AND WINDOW TYPES	E26	ELECTRICAL LAYOUT - WING B MECHANICAL PENTHOUSE
A82	CURTAIN WALL TYPES AND DETAILS	E27 E28	POWER AND FIRE ALARM LAYOUT - WING C MECHANICAL EQUIPMENT - WING C
A85 A86	ROOM FINISH SCHEDULE FLOOR FINISH PLAN - WING B LEVEL 1	E29 E30	ROOF LAYOUT LIGHTING CONTROL SCHEDULE AND DETAILS
A87	FLOOR FINISH PLAN - WING C LEVEL 2	E31	MOTOR STARTER AND CONTROL LIST
A88 A90	FLOOR FINISH PLAN - WING C AND DETAILS MILLWORK PLANS, ELEVATIONS AND DETAILS	E32 E33	FIRE ALARM RISER DIAGRAM PANEL SCHEDULES - 1 OF 4
A91 A92	MILLWORK PLANS, ELEVATIONS AND DETAILS MILLWORK PLANS AND ELEVATIONS	E34	PANEL SCHEDULES - 2 OF 4
A93	MILLWORK PLANS AND ELEVATIONS	E35 E36	PANEL SCHEDULES - 3 OF 4 PANEL SCHEDULES - 4 OF 4
A94 A95	MILLWORK PLANS AND ELEVATIONS MILLWORK PLANS AND ELEVATIONS		
A96	MILLWORK SECTIONS		JNICATIONS
A97 A98	MILLWORK SECTIONS MILLWORK SECTIONS	T100 T101	TITLE PAGE SCHEMATICS
A99	MILLWORK SECTIONS AND DETAILS	T102 T103	B-WING FLOOR 1 LAYOUT B-WING FLOOR 2 LAYOUT
STRUC [*]	<u>TURAL</u>	T104	PATHWAYS DETAILS
S00	GENERAL NOTES SCHEDULES AND STANDARD DETAILS	T105 T106	INSTALLATION DETAILS GROUNDING AND BONDING DETAILS
S01 S02	STANDARD DETAILS	T107	RACK ELEVATIONS
S10 S11	EXISTING FOUNDATION PLAN - WING B AND C LEVEL 1 EXISTING FRAMING PLAN - WING B LEVEL 2	T108 T109	AV ELEVATIONS WING B LEVEL 1 AV LAYOUT AND RISERS
S12	EXISTING FRAMING PLAN - WING B ROOF	T110	AV ELEVATIONS WING B LEVEL 2
S13 S14	EXISTING FRAMING PLANS - WING B AND C ROOF ALTERED FRAMING PLAN - WING B LEVEL 2		
S15 S16	ALTERED FRAMING PLAN - WING B ROOF ALTERED FRAMING PLAN - WING C ROOF		
S20	ENLARGED FRAMING PLANS - WING B		
S21	ENLARGED FRAMING PLANS - WING B		

PLAN DETAILS

FRAMING ELEVATIONS FRAMING ELEVATIONS

SECTIONS AND DETAILS

GFDGD



Design, Engineering & Construction Physical Resources Guelph, Ontario. N1G 2W1

BUILDING #046 RENOVATIONS

JLR JOB NO. 27915 ISSUED FOR PERMIT & TENDER NOVEMBER 2, 2018

ARCHITECTURAL DRAWING SET



Ontario Building Code Review University of Guelph Building 046 - Renovations

1.1 Ontario Building Code Analysis

1.1.1 General

The purpose of this review is to identify the Ontario Building Code (OBC) requirements and summarize JLR's approach with regard to fire and life safety applicable for the extensive renovation to Building 046 for the University of Guelph, located at 50 College Avenue West in Guelph, Ontario. This document is based on the requirements of the 2012 OBC, Ontario Regulation 332/12. [] indicates an OBC article reference. All references are to Division B unless otherwise noted.

The scope of this project involves extensive renovation [11.3.3.2.] to wings B and C of Building 046. As described in OBC Appendix A, when an existing building undergoes an extensive renovation, it should generally conform to the requirements of Part 3 once the renovations are complete.

Wings B and C will be occupied by separate tenants, both under the same occupancy classification. The project is organized to accommodate program spaces as noted below:

Ground Floor

Ground Floor		
 Entrance foyer 	 Mechanical room 	 Storage rooms
 Vestibule 	 Washrooms 	 Elevator
Therapy rooms	 Custodian room 	 Electrical rooms
Viewing rooms	Research rooms	 IT Server rooms
Large group room	 Student Work area 	Exits
Offices	Kitchenette	 Exit stairs
Administration spaces	 Closed file storage 	 Corridor
Waiting area	 Medical records room 	
Second Floor		
• Lounge	• Therapy rooms	 Classrooms
Compe	Viewing rooms	 Playrooms

Second Floor			
• Lounge	 Therapy rooms 		Classrooms
Offices	 Viewing rooms 	and Alignet	Playrooms
Large group room	 Washrooms 		 Storage rooms
Administration spaces	 Custodian room 	and the second	 IT server rooms
Waiting area	 Wellness room 		 Exit stairs
Elevator	 Prayer room 		 Corridor
• Elevator	i em Nage pharacter		

Wings B and C will be considered separate suites. Roof, floors, walls and ceilings are being removed and replaced in Wing B. All ceilings are removed and replaced in Wing C. Therefore, the renovation must comply

.1 All structural and fire-resistance elements shall be constructed in compliance with all other Parts [11.3.3.2 (1)].

.2 Wing B must comply to [3.8] Barrier-Free Design [11.3.3.2.(2)(a)].

The remainder of this section will relate to Part 3 of the OBC.

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- The building is served by an elevator. [3.3.1.7]
- Corridors are greater than 1,100 mm. [3.3.1.9]
- No obstructions within the corridor will project more than 100 mm between 680 mm and 1,980 mm above the floor.
- No doors open into access to exits. [3.3.1.10]
- Capacity of access to exits are as follows (6.1mm/person [3.3.1.16(2)]):
- Doors (narrowest door DST203) = 158 people (965 mm) (2nd fl)
- Corridor (typical width location) = 375 people (2,275 mm) (2nd fl) Corridor (narrowest width location) = 150 people (1,200 mm) (2nd fl)
- Guards are required in the following locations:
- .1 At stairs and landings
- No transparent panels are used that could be mistaken as a means of egress. [3.3.1.18.(3)]
- No obstructions exist within means of egress. Owner is required to comply with this requirement. [3.3.1.22]
- No welding or cutting is planned within the building. [3.3.1.24]
- Classrooms have occupancy loads less than 200. [3.3.2.2.(8)] The building is sprinklered; no fire rating is required at the corridor. [3.3.2.5.(3)]

- 1.1.5 Exits [3.4] • Each floor area is served by two exits. [3.4.2.1.(1)]
- The travel distance within the building is less than 45 m. [3.4,2.5.(1).(c)]
- Capacity of existing exits are as follows [3.4.3.2]:

Area	Wing B – Level 1	Wing B – Level 2	Wing C
Occupant Load	258	333	65
Occupant Load Contributing to each Exit Stair	129	167	33
Required Width of Exit Doors (6.1 mm/person)	787 mm	1,019 mm	201 mm
Provided Width of Exit Doors (smallest represented)	965 mm	1,930 mm	1,930 mm
Required Width of Exit Stair (8 mm/person)	1,032 mm	1,336 mm	N/A
Provided Width of Exit Stair	1,400 mm	1,400 mm	N/A
Required Exit Door Width to the Exterior (6.1 mm/person)	787 mm	1,019 mm	201 mm
Provided Exit Door Width to the Exterior	1,930 mm	1,930 mm	1,930 mm

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Building 046 - Renovations

1.1.2 General [3.1] Rating of Firewall [3.1.10]

The rating of the existing firewall separating Wing A and Wing B shall be constructed from masonry or and shall have a fire-resistance rating of not less than 2hrs

Occupant Load [3.1.17]

The occupant load of Building 046 is as follows:

- Ground Floor Wing B = 258 persons
- Second Floor Wing B = 333 persons Wing C = 65

1.1.3 Building Fire Safety [3.2]

- Occupancy Classification College and schools - Assembly - Group A, Division 2 Major occupancy: 1,858.1 sq.m
- Building area: Two (2) Storeys Building height: 1,844.7 sq.m (19,856 sq.ft.)
- Ground floor area: 1,151 sq.m (12,389 sq.ft.) Second floor area:
- Mezzanine area: 2,995.7 (32,245 sq.ft.) Gross building area:
- # of streets facing: Group A, Division 2, up to 2 storeys, increased area, sprinklered 2012 OBC classification: [3.2.2.26]

Max permitted building area: 2,400 sq.m [3.2.2.26]

Building Size and Construction Relative to Occupancy

Construction Required: Combustible or non-combustible construction shall be used singly, and,

- .1 Floor assemblies shall be fire separations with a 0hr fire resistance rating (frr).
- .2 Loadbearing walls, columns and arches shall be of non-combustible construction. [3.2.2.26]

Proposed Construction:

- Non-combustible Construction: No rating Roof assembly Required Sprinklers:
- No mezzanine is proposed within the building Floor assembly: Load bearing components: frr 0hr

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- Building 046 Renovations Headroom clearance for stairs are more than 2,050 mm; doorways are more than 2,050 mm; door
- closers will not reduce headroom to less than 1,980 mm. [3.4.3.5] Exits' openings shall conform to OBC 3.4.4.1 – exit stairs to have a fir 45 mins.

Door Release Hardware [3.4.6.16]

- To achieve required security of the facility, electromagnetic locks will be installed on one leaf of the following doors which provide access to exit:
- D108, D106, D103, D202a, D206a
- Electromagnetic locks will not incorporate latches, pins or other similar devices to keep the door in the closed position and are designed in conformance with [3:4.6.16(4)]

1.1.6 Vertical Transportation [3.5]

- The elevator hoistway is separated from the remainder of the building by a fire separation having an
- frr of 45 min. [3.5.3.1] • The elevator machine room is separated from the remainder of the building by a fire separation having an frr of 45 min. [3.5.3.3]

1.1.7 Service Facilities [3.6]

- Access to the roof is for personnel servicing roof top equipment and general maintenance only.
- Access to roof top is by stairway. [3.3.1.3.(10)] Mechanical rooms shall be separated from the remainder of the building by a fire separation having
- an frr of 1 hour. [3.6.2.1.(1)] • All other service rooms shall be separated from the remainder of the building by a fire separation having an frr of 1 hour. [3.5.3.3]
- Vertical services spaces to be separated from the remainder of the building by a fire separation having an frr of 0 hour. [3.6.3.1]

1.1.8 Health Requirements [3.7]

Toilet fixtures required for the building are as follows [3.7.4.3.(15)]:

Wing	Level	Occupant Load	Ratio	Fixtures Required	Fixtures Provided
В	1	258 = 129 male 129 female	1/100 Person 1/75 Person	2 2	7
В	2	333 = 167 male 167 female	1/100 Person 1/75 Person	3 3	7
¢	3	65 = 33 male 33 female	1/100 Person 1/75 Person	<u>1</u> 1	2

• There are barrier free washrooms provided on all floors of the building, and universal washrooms provided on all floors of each wing (three (3) universal washrooms total).

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Spatial Separation and Exposure Protection [3.2.3]

- Exterior walls of exit enclosures will not be exposed to fire from:
- Openings in the exterior walls of the building. [3.2.3:13]
- No openings in exterior wall of a fire compartment will be exposed to openings in the exterior walls of another fire compartment.
- Based on the limiting distances in [Table 3.2.3.1.D], the areas of unprotected openings permitted in the exposing building faces are as follows:

Proposed Building Face	Area (sq.m)	Limiting Distance	%Unprotected openings permitted	% Openings
Face			ent 1 (Wing C)	
North	> 137.1	> 9 m	100 %	< 46.6%
South	> 127.8	> 9 m	100 %	< 49.5%
East	> 22.4	> 4 m	90 %	< 38.2%
West	> 19.2	> 7.2 m	100 %	< 27.5%
7700.		ompartment	2 (Vestibule C100)	
North	> 573.8	> 9 m	100 %	< 90.3%
South	N/A	N/A	N/A	N/A
East	N/A	N/A	N/A	N/A
West	N/A	N/A	N/A	N/A
		e Compartr	ment 3 (Wing B)	
North	> 304.5	>9 m	100 %	< 58.1%
South	> 200.1	> 9 m	100 %	< 50.4%
East -1	> 10.2	> 7.2 m	100 %	< 0%
East -2	>113,19	>9 m	100 %	< 56.9%
West	> 153.7	> 9 m	100 %	< 54.0%
- R # 1707-10	Fi	re Compart	ment 4 (Wing B)	
North	N/A	N/A	N/A	N/A
South	N/A	N/A	N/A	N/A
East	N/A	N/A	N/A	N/A
West	> 16.5	> 9 m	100 %	< 90.0%
E. F. F	F	re Compart	ment 5 (Wing B)	
North	N/A	N/A	N/A	N/A
South	> 26.3	> 9 m	100 %	< 0%
East	N/A	N/A	N/A	N/A
	> 61.7	> 9 m	100 %	< 8.0%
West	201.1	~ ~ III	(m.e.; 55	,,,,,,,,,,,,,,,,,,,,,,,,,,,,,,,,,,,,,,,

Construction of Exposing Building face [3.2.3.7]

 Building faces where the permitted % of unprotected openings is greater than 25% and less that 100% shall have a fire-resistance rating of 45 min and are permitted to be of combustible or non-combustible construction.

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1.1.9 Barrier Free Design [3.8]

- There are four (4) pedestrian entrances, requiring two (2) to be barrier free. This project
- will look to upgrading the west and north elevations to be barrier free. [3.8.1.2] The approach to the main entrance from the sidewalk is designed in conformance with OBC 3.8.3.2 "exterior walks".
- Door from exterior to vestibule will be equipped with power door operators. [3.8.3.3]
- Barrier free washrooms are designed in accordance with OBC 3.8.3.8 to 3.8.3.11. Universal washrooms are designed in accordance with OBC 3.8.3.12.

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Building 046 - Renovations

 As per 3.2.3.1(3) for determination of the construction of the assembly, the limiting distance shall be taken as the project of the exterior wall onto a vertical plane located so that no portion of the exterior wall of the building or of a fire compartment is beyond that vertical plane. This impacts one elevation listed below.

Proposed Building Face	Area (sq.m)	Limiting Distance	%Unprotected openings permitted	Required Rating of Exposed Building Face
1	Fi	e Compartn	ent 1 (Wing C)	
East	> 22.4	> 3.0 m	60 %	45 min

Fire Alarm [3.2.4]

- A fire alarm is required for the building. [3.2.4.1 (2) (f)]
- Manual pull stations are required as per [3.2.4.18]

Provisions for Fire Fighting [3.2.5]

- The building is sprinklered. Openings for access to above grade storeys are not required. [3.2.5.1]
- Roof access is not required. [3.2.5.3]
- A sprinkler fire department connection is being added. No revisions to the existing fire-route
- will be required. Portable fire extinguishers will be provided as per part 6 of the fire code. [3.2.5.17]
- Emergency lighting will be provided. [3.2.7.3] There are no mezzanines or openings through floor assemblies. [3.2.8]
- The building does not contain an interconnected floor space. [3.2.8.1] As per [3.2.8.2.(6)], Articles [3.2.8.3] to [3.2.8.11] do not apply to the building.

- Removal of Existing Standpipe [3,2.9] A standpipe system is not required.[3:2.9.1 (1) to (6)]
- An existing standpipe system exists within the building.
- Through the removal of the standpipe and installation of a sprinkler system, the performance level of fire protective equipment is not being decreased.
- Correspondence with the City of Guelph officials established this approach is acceptable. (Becky Montyro, CBCO, Plans Examiner III, Building Services, Infrastructure, Development and Enterprise City of Guelph - August 28, 2018).

1.1.4 Safety Within Floor Areas [3.3]

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- There are two suites within the building. A fire separation with a fire-resistance rating of 45 min
- will be required between suites. [3.3.1.1(2)] There is no storage of hazardous substances within the building. [3.3.1.2]
- Access to the roof is for personnel servicing roof top equipment and general maintenance only.
- Access to roof top is by stairway and access ladders. [3.3.1.3.(10)] There is no public corridor within the building, [1.4.1.2], [3.3.1.4]

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(2 <u>11</u>)	امتدائا وتتميوني التمر عبيدا الأبار يباري والرارا	he arounded from	n each. [3.3.1.5]
 Two edit 	ess doors are to	be provided from	reacit. [0.0, 1.0]
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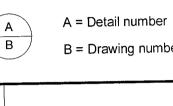
November 2018

Contractors must check and verify all site conditions. Notify the Owner's Representative in writing before proceeding with the work if discrepancies are evident between the drawings and the site condition. No extras to the contract will be allowed if discrepancies were evident prior to start of work.

UNEXPECTED DISCOVERY OF ASBESTOS:

DO NOT SCALE DRAWINGS:

Where a friable material is discovered during construction, renovations and/or demolition, and it is suspected to contain asbestos, the Contractor must stop all work that may disturb the material. The Contractor shall advise the Owner of the discovery and await instructions from the owner.



B = Drawing number where detailed

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BUILDING #046

RENOVATIONS



Drawing Title ARCHITECTURAL **OBC REVIEW**

504034

Cad File No.

UNIVERSITY OF GUELPH BUILDING #046


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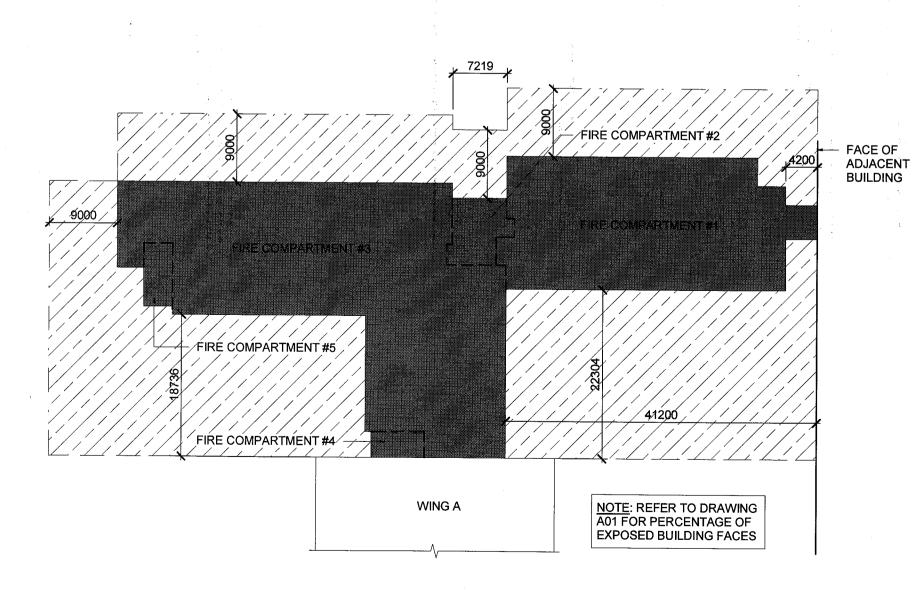
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November 2018


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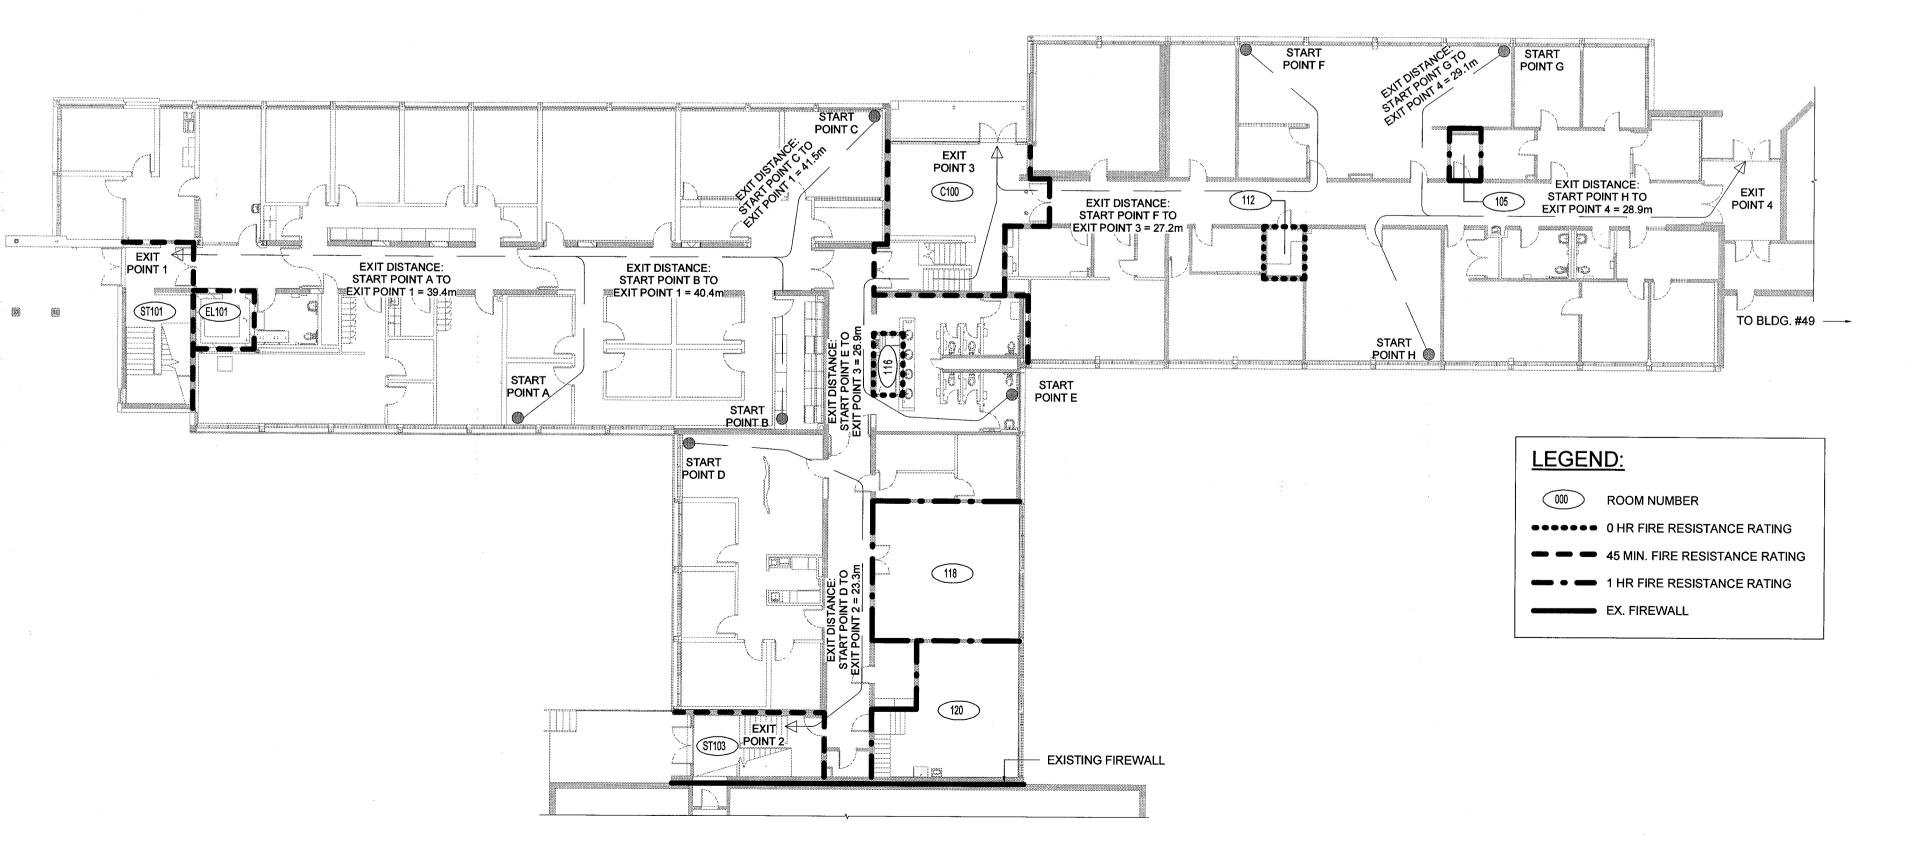







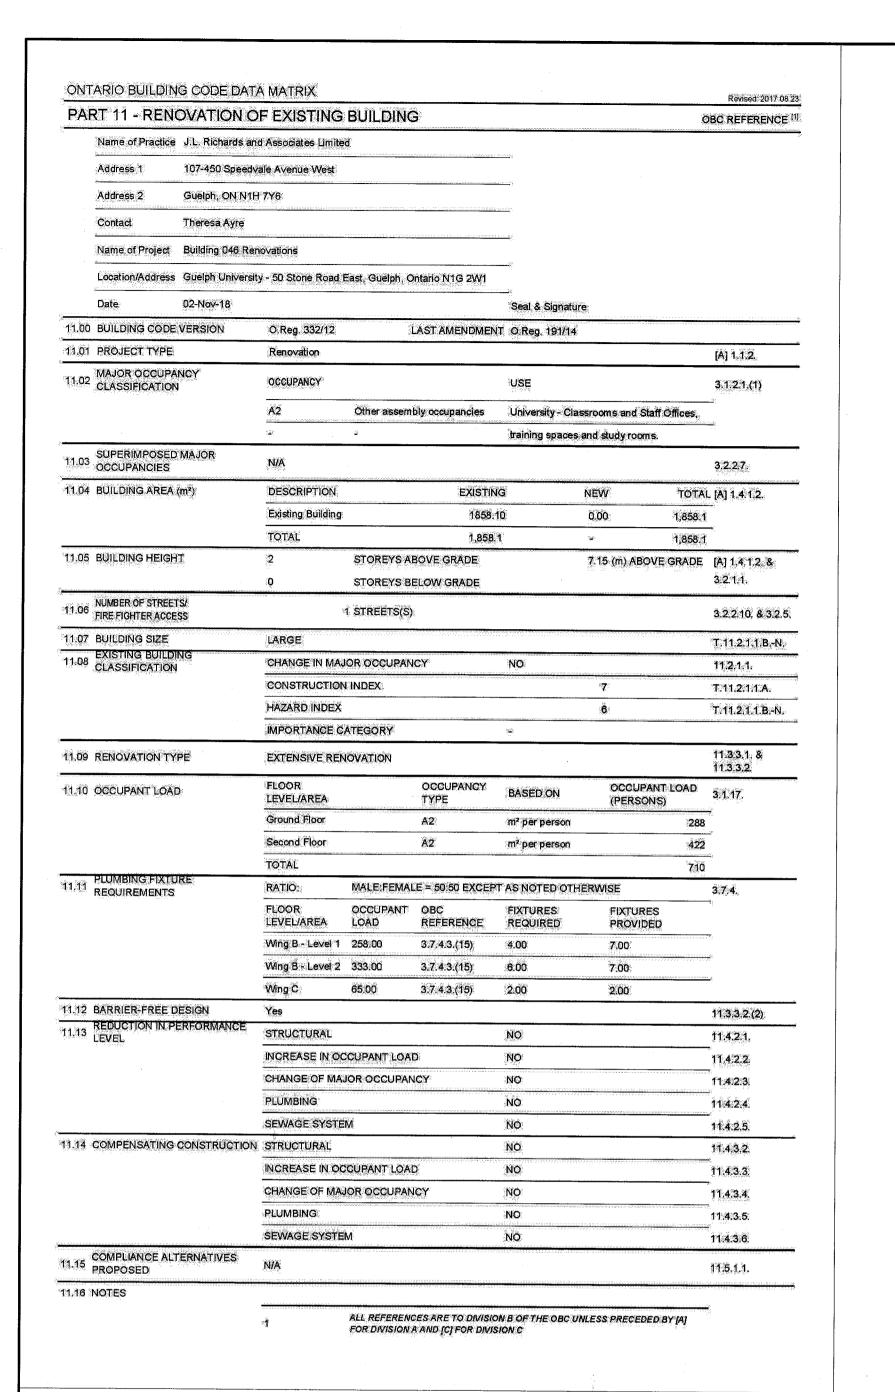

FIRE SEPARATION PLAN SCALE: 1:200

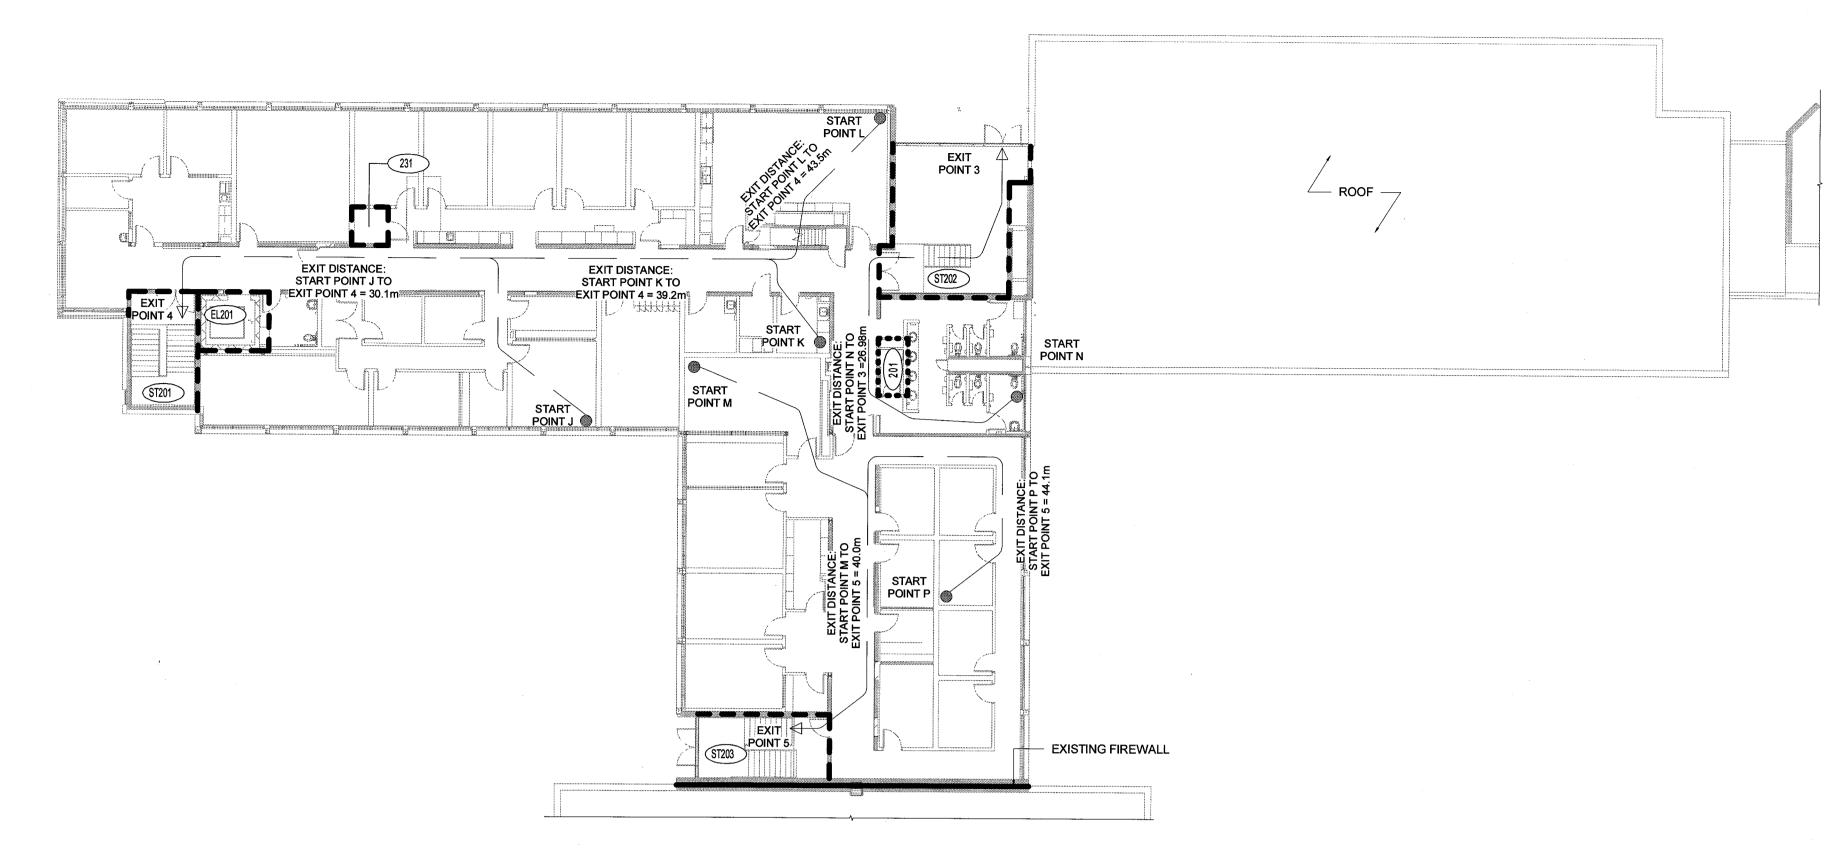

FIRE SEPARATION PLAN LEVEL 1 SCALE: 1:200

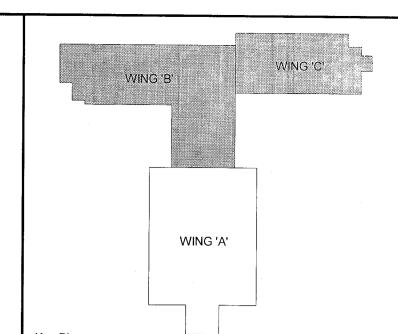

Key Plan

DO NOT SCALE DRAWINGS:

Contractors must check and verify all site conditions. Notify the Owner's Representative in writing before proceeding with the work if discrepancies are evident between the drawings and the site condition. No extras to the contract will be allowed if discrepancies were evident prior to start of work.

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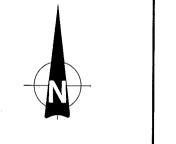
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A = Detail number


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BUILDING #046 RENOVATIONS

Drawing Title

ARCHITECTURAL OBC DATA


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UNIVERSITY OF GUELPH BUILDING #046

AS INDICATED NOV 2, 2018 Drawn By Drawing No. Checked By TA Approved By RPC

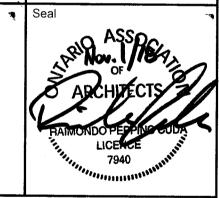of 170


JLR#: 27915 Cad File No.

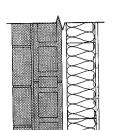

WALL TYPE 'W1'


FX BRICK EX. CONCRETE BLOCK - 25mm AIR SPACE 152mm METAL STUDS @ 400mm O.C. - R-24 MINERAL WOOL INSULATION - VAPOUR BARRIER

16mm GYPSUM BOARD

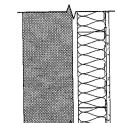


WALL TYPE 'W2'

EX. FOUNDATION WALL - 25mm AIR SPACE 152mm METAL STUDS @ 400mm O.C. - R-24 MINERAL WOOL INSULATION - VAPOUR BARRIER - 16mm GYPSUM BOARD

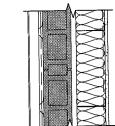

WALL TYPE 'W3'

COMPOSITE ALUMINUM PANELS - 22mm VERTICAL HAT CHANNELS @ 400mm O.C. - WATER RESISTANT VAPOUR PERMEABLE AIR BARRIER MEMBRANE - EX. CONCRETE BLOCK

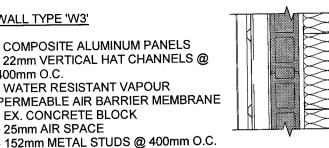

WALL TYPE 'W3a' COMPOSITE AI UMINUM PANELS - 22mm VERTICAL HAT CHANNELS @ 400mm O.C.


- WATER RESISTANT VAPOUR

- EX. CONCRETE BLOCK

- 25mm AIR SPACE


- VAPOUR BARRIER - 16mm GYPSUM BOARD

ALUMINUM COMPOSITE PANELS - 22mm VERTICAL HAT CHANNELS @ 400mm O.C. - 152mm THERMALLY BROKEN - 127mm HORIZONTAL Z-GIRTS @ 400mm HORIZONTAL Z-GIRTS @ 400mm O.C. - 152mm SEMI-RIGID MINERAL WOOL INSULATION PERMEABLE AIR BARRIER MEMBRANE - AIR/VAPOUR BARRIER - EX. CONCRETE BLOCK

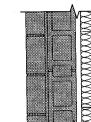

WALL TYPE 'W5'

- EX. BRICK - EX. CONCRETE BLOCK - 25mm AIR SPACE - 92mm METAL STUDS @ 400mm O.C. - R-14 MINERAL WOOL INSULATION - VAPOUR BARRIER 16mm GYPSUM BOARD MORTAR BED AND METAL LATHE - PORCELAIN TILE

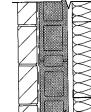

WALL TYPE 'W6'

SALVAGED BRICK, COURSING TO MATCH EXISTING - 25mm AIR SPACE - WATER RESISTANT VAPOUR PERMEABLE AIR BARRIER MEMBRANE - EX. CONCRETE BLOCK - 25mm AIR SPACE - 152mm METAL STUDS @ 400mm O.C. - R-24 MINERAL WOOL INSULATION - VAPOUR BARRIER

- 16mm GYPSUM BOARD

NOTES:

1. ALL PARTITIONS TO EXTEND TO UNDERSIDE OF FLOOR OR ROOF DECK ABOVE.

2. ALL DIMENSIONS ARE SHOWN TO THE CENTERLINE OF METAL STUD PARTITIONS AND TO THE FACE OF CONCRETE BLOCK WALLS UNLESS NOTED OTHERWISE.

DIMENSION TO PARTITION TYPE 'P14' SHOWN TO CENTERLINE OF FIRST STUD IN ASSEMBLY. . TYPE 'X' GYPSUM BOARD, IN LOCATIONS AS REQUIRED

WALL TYPE 'W7'

- HORIZONTAL METAL CLADDING - 22mm VERTICAL HAT CHANNELS @ 400mm O.C. - 152mm HORIZONTAL Z-GIRTS @ 400mm O.C.

WOOL INSULATION

- AIR/VAPOUR BARRIER

- 245mm CONCRETE BLOCK



WALL TYPE 'W8'

EXTRUDED CONCRETE CLADDING - 22mm VERTICAL HAT CHANNELS @ 400mm O.C. - BLACK AIR BARRIER · 152mm HORIZONTAL Z-GIRTS @ 400mm


- 152mm SEMI-RIGID MINERAL WOOL INSULATION - AIR/VAPOUR BARRIER - 16mm EXTERIOR GRADE PLYWOOD - 152mm STRUCTURAL METAL STUDS @ 400mm O.C. - 16mm EXTERIOR GRADE PLYWOOD

- AIR/VAPOUR BARRIER - 152mm SEMI-RIGID MINERAL WOOL INSULATION

- BLACK AIR BARRIER

- 152mm HORIZONTAL Z-GIRTS @ 400mm

- 22mm VERTICAL HAT CHANNELS @ - EXTRUDED CONCRETE CLADDING

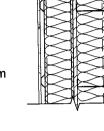

WALL TYPE 'W8a'

- VAPOUR BARRIER

- 19mm STRAPPING

- 16mm GYPSUM BOARD


- 25mm AIR SPACE

- VAPOUR BARRIER

- 16mm GYPSUM BOARD

- EXTRUDED CONCRETE CLADDING - 22mm VERTICAL HAT CHANNELS @ 400mm O.C. - 152mm HORIZONTAL Z-GIRTS @ 400mm O.C. - 152mm SEMI-RIGID MINERAL WOOL INSULATION - AIR/VAPOUR BARRIER - 16mm EXTERIOR GRADE PLYWOOD - 152mm METAL STUDS @ 400mm

- R-24 MINERAL WOOL INSULATION

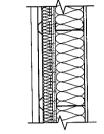

- HORIZONTAL METAL CLADDING - 22mm VERTICAL HAT CHANNELS @ 400mm O.C.

- 50mm SEMI-RIGID INSULATION - WATER RESISTANT VAPOUR - 152mm METAL STUDS @ 400mm O.C. - R-24 MINERAL WOOL INSULATION - METAL LINER, SEAL ALL JOINTS

PERMEABLE AIR BARRIER MEMBRANE

- 50mm HORIZONTAL Z-GIRTS @ 400mm

WALL TYPE 'W4'

- 152mm METAL STUDS @ 400mm O.C.

- R-24 MINERAL WOOL INSULATION

WALL TYPE 'W9

- 16mm EXTERIOR GRADE SHEATHING

DO NOT SCALE DRAWINGS:

BY FIRE RATING.

Contractors must check and verify all site conditions. Notify the Owner's Representative in writing before proceeding with the work if discrepancies are evident between the drawings and the site condition. No extras to the contract will be allowed if discrepancies were evident prior to start of work.

UNEXPECTED DISCOVERY OF ASBESTOS: Where a friable material is discovered during construction, renovations and/or demolition, and it is suspected to contain asbestos, the Contractor must stop all work that may disturb the material. The Contractor shall advise the Owner of the discovery



and await instructions from the owner.

A = Detail number

B = Drawing number where detailed

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A05

PARTITION TYPE 'P1'

- EX. CONCRETE BLOCK OR CONCRETE BLOCK, WIDTH TO MATCH EXISTING SEAL CONCRETE BLOCK WITH

MINIMUM TWO COATS LATEX

PAINT. 1.5 HR FRR WHERE APPLICABLE STC 50

OBC DESIGN NO. B1b

PARTITION TYPE 'P7'

- 245mm CONCRETE BLOCK

BOARD, TO ASTM C840

PARTITION TYPE 'P12'

OBC DESIGN NO. S5b

PARTITION TYPE 'P15a'

- 16mm GYPSUM BOARD

- MORTAR BED AND METAL LATHE

- 92mm METAL STUDS @ 400mm O.C.

- ACOUSTIC BATT INSULATION

- PORCELAIN TILE

STC 52

- 16mm GYPSUM BOARD

- 92mm METAL STUDS @ 400mm O.C.

- 2-LAYERS 16mm GYPSUM BOARD


- ACOUSTIC BATT INSULATION

1.5 HR FRR WHERE APPLICABLE

I AMINATED 16mm GYPSUM

1.5 HR FRR WHERE APPLICABLE

SIMILAR TO OBC DESIGN NO. B1b

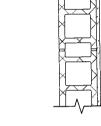

WALL TYPES

SCALE: 1:20

PARTITION TYPE 'P2'

- EX. CONCRETE BLOCK OR CONCRETE BLOCK, WIDTH TO MATCH EXISTING - LAMINATED 16mm GYPSUM BOARD, TO ASTM C840

1.5 HR FRR WHERE APPLICABLE SIMILAR TO OBC DESIGN NO. B1b

PARTITION TYPE 'P8'

- 245mm CONCRETE BLOCK

1.5 HR FRR WHERE APPLICABLE

SIMILAR TO OBC DESIGN NO. B1b

PARTITION TYPE 'P12a'

OBC DESIGN NO. S5b

STC 52

PARTITION TYPE 'P16'

16mm GYPSUM BOARD

- ACOUSTIC BATT INSULATION

- 2-LAYERS 16mm GYPSUM BOARD

1.5 HR FRR WHERE APPLICABLE

- 152mm METAL STUDS @ 400mm O.C.



- LAMINATED 16mm GYPSUM BOARD, TO ASTM C840 - EX. CONCRETE BLOCK OR CONCRETE BLOCK, WIDTH TO MATCH EXISTING - LAMINATED 16mm GYPSUM BOARD, TO ASTM C840

OBC DESIGN NO. B2e

PARTITION TYPE 'P9'

STC 47

- 16mm GYPSUM BOARD

- 16mm GYPSUM BOARD

OBC DESIGN NO. S4b

STC 55

PARTITION TYPE 'P17'

- 92mm METAL STUDS @ 400mm O.C.

ACOUSTIC BATT INSULATION

1 HR FRR WHERE APPLICABLE

PARTITION TYPE 'P13'

OBC DESIGN NO. S6b

- 2-LAYERS 16mm GYPSUM BOARD

- ACOUSTIC BATT INSULATION

2 HR FRR WHERE APPLICABLE

- 92mm METAL STUDS @ 400mm O.C.

- 2-LAYERS 16mm GYPSUM BOARD

3 HR FRR WHERE APPLICABLE

PARTITION TYPE 'P4'

- EX. CONCRETE BLOCK OR CONCRETE BLOCK, WIDTH TO MATCH EXISTING - MORTAR BED AND METAL LATHE - PORCELAIN TILE 1.5 HR FRR WHERE APPLICABLE

PARTITION TYPE 'P9a'

- 16mm GYPSUM BOARD

- 16mm GYPSUM BOARD

OBC DESIGN NO. S4b

ACOUSTIC BATT INSULATION

1 HR FRR WHERE APPLICABLE

PARTITION TYPE 'P13a'

- PORCELAIN TILE

OBC DESIGN NO. S6b

- 2-LAYERS 16mm GYPSUM BOARD

- 2-LAYERS 16mm GYPSUM BOARD

MORTAR BED AND METAL LATHE

- ACOUSTIC BATT INSULATION

2 HR FRR WHERE APPLICABLE

- 92mm METAL STUDS @ 400mm O.C.

- 152mm METAL STUDS @ 400mm O.C.



PARTITION TYPE 'P5'

- LAMINATED 16mm GYPSUM BOARD, TO ASTM C840 - EX. CONCRETE BLOCK OR CONCRETE BLOCK, WIDTH TO MATCH EXISTING - MORTAR BED AND METAL LATHE - PORCELAIN TILE

1.5 HR FRR WHERE APPLICABLE SIMILAR TO OBC DESIGN NO. B1b

PARTITION TYPE 'P10'

- 16mm GYPSUM BOARD

- 16mm GYPSUM BOARD

- PORCELAIN TILE

STC 55

STC 47

- 92mm METAL STUDS @ 400mm O.C.

- MORTAR BED AND METAL LATHE

ACQUISTIC BATT INSULATION

1 HR FRR WHERE APPLICABLE

SIMILAR TO OBC DESIGN NO. S4b

PARTITION TYPE 'P13b'

OBC DESIGN NO. S6b

- 2-LAYERS 16mm GYPSUM BOARD

- 2-LAYERS 16mm GYPSUM BOARD

- ACOUSTIC BATT INSULATION

2 HR FRR WHERE APPLICABLE

- 152mm METAL STUDS @ 400mm O.C.

PARTITION TYPE 'P5a'

- LAMINATED 16mm GYPSUM BOARD, TO ASTM C840 - EX. CONCRETE BLOCK OR CONCRETE BLOCK, WIDTH TO MATCH EXISTING - 92mm METAL STUDS @ 400mm O.C. - ACOUSTIC BATT INSULATION - 16mm GYPSUM BOARD - MORTAR BED AND METAL LATHE

- PORCELAIN TILE 3 HR FRR WHERE APPLICABLE

- 152mm METAL STUDS @ 400mm O.C.

ACOUSTIC BATT INSULATION

1 HR FRR WHERE APPLICABLE

SIMILAR TO OBC DESIGN NO. S7a

PARTITION TYPE 'P13c'

BATTENS @ 400mm O.C.,

FULLY ADHERED

OBC DESIGN NO. S6b

2-LAYERS 16mm GYPSUM BOARD

- ACOUSTIC BATT INSULATION

- 38mm VERTICAL SOLID WOOD

2 HR FRR WHERE APPLICABLE

- 2-LAYERS 16mm GYPSUM BOARD

PAINT/PRIMED BLACK ON EXPOSED

- COMPOSITE WOOD VENEER PANELS,

- 152mm METAL STUDS @ 400mm O.C.

- MORTAR BED AND METAL LATHE

SIMILAR TO OBC DESIGN NO. B5a

PARTITION TYPE 'P10a'

- 16mm GYPSUM BOARD

16mm GYPSUM BOARD

- PORCELAIN TILE

- 64mm METAL STUDS @ 400mm O.C. - ACOUSTIC BATT INSULATION - 16mm GYPSUM BOARD

STUD 111, STUD

3 HR FRR WHERE APPLICABLE SIMILAR TO OBC DESIGN NO. B5a

- EX. CONCRETE BLOCK OR

CONCRETE BLOCK, WIDTH TO

PARTITION TYPE 'P6'

TO ASTM C840

MATCH EXISTING

- LAMINATED 16mm GYPSUM BOARD,

PARTITION TYPE 'P11' - PORCELAIN TILE - MORTAR BED AND METAL LATHE - 16mm GYPSUM BOARD 92mm METAL STUDS @ 400mm O.C - ACOUSTIC BATT INSULATION - 16mm GYPSUM BOARD - MORTAR BED AND METAL LATHE

- PORCELAIN TILE 1 HR FRR WHERE APPLICABLE

SIMILAR TO OBC DESIGN NO. S4b

PARTITION TYPE 'P14'

- 19mm AIR SPACE

STAGGERED

STC 68

- 2-LAYERS 16mm GYPSUM BOARD

- ACOUSTIC BATT INSULATION

- ACOUSTIC BATT INSULATION

1 HR FRR WHERE APPLICABLE

NOTE: METAL STUDS TO BE

OBC DESIGN NO. S15a

- 92mm METAL STUDS @ 400mm O.C.

92mm METAL STUDS @ 400mm O.C.

- 2-LAYERS 16mm GYPSUM BOARD

- PORCELAIN TILE - MORTAR BED AND METAL LATHE - 16mm GYPSUM BOARD - 152mm METAL STUDS @ 400mm O.C. - ACOUSTIC BATT INSULATION - 16mm GYPSUM BOARD - MORTAR BED AND METAL LATHE

- PORCELAIN TILE 1 HR FRR WHERE APPLICABLE

PARTITION TYPE 'P15'

- 16mm GYPSUM BOARD

- 92mm METAL STUDS @ 400mm O.C.

- ACOUSTIC BATT INSULATION

PARTITION TYPE 'P6a'

WIDTH TO MATCH EXISTING

- 16mm GYPSUM BOARD

PARTITION TYPE 'P11a

- ACOUSTIC BATT INSULATION

3 HR FRR WHERE APPLICABLE

SIMILAR TO OBC DESIGN NO. B5a

- 64mm METAL STUDS @ 400mm O.C.

ADHERED

C840

- COMPOSITE WOOD VENEER PANELS, FULLY

400mm O.C., PAINT/PRIMED BLACK ON EXPOSED

- LAMINATED 16mm GYPSUM BOARD, TO ASTM

- EX. CONCRETE BLOCK OR CONCRETE BLOCK,

- 38mm VERTICAL SOLID WOOD BATTENS @

OBC DESIGN NO. S7a

Design, Engineering & Construction Physical Resources Guelph, Ontario. N1G 2W1

7940

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8137



BUILDING #046 RENOVATIONS

Drawing Title

ARCHITECTURAL CONSTRUCTION TYPES

Project No. 504034

Cad File No.

UNIVERSITY OF GUELPH BUILDING #046

NOV 2, 2018 AS INDICATED Drawn By Drawing No. DCJ hecked By TA pproved B RPC JLR#: 27915

A05

ROOF TYPES

VAPOUR BARRIER


- DECK SHEATHING

- EXISTING ROOF DECK

SCALE: 1:20

1 HR FRR WHERE APPLICABLE

- FIRE RATED GLASS WALL ASSEMBLY

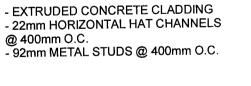



PARTITION TYPE 'P18' - COMPOSITE WOOD VENEER PANELS - 38mm VERTICAL SOLID WOOD BATTENS @ 400mm O.C., PAINT/PRIMED BLACK ON EXPOSED FACE - EX. CONCRETE BLOCK OR CONCRETE BLOCK, WIDTH TO


MATCH EXISTING

- LAMINATED 16mm GYPSUM

1.5 HR FRR WHERE APPLICABLE


SIMILAR TO OBC DESIGN NO. B1b


BOARD, TO ASTM C840

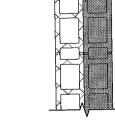


PARTITION TYPE 'P19' - 140mm CONCRETE BLOCK - EX. CONCRETE BLOCK 2 HR FRR WHERE APPLICABLE

- EX. CONCRETE BLOCK - 25mm AIR SPACE - ACOUSTIC BATT INSULATION 16mm GYPSUM BOARD

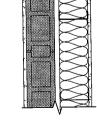

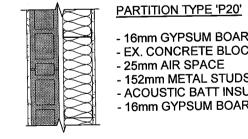


16mm GYPSUM BOARD · 152mm METAL STUDS @ 400mm O.C.

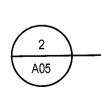

PARTITION TYPES


ROOF TYPE 'R1' - TOP POUR - 3-PLY COLD APPLIED BUILT UP ROOFING 25mm OVERLAY BOARD SLOPED POLYISOCYANURATE INSULATION R-35 (152mm) POLYISOCYANURATE INSULATION

SCALE: 1:20

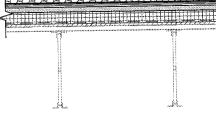


ROOF TYPE 'R2

GRAVEL TOP POUR - 3-PLY COLD APPLIED BUILT UP ROOFING - 25mm OVERLAY BOARD - SLOPED POLYISOCYANURATE INSULATION - PROTECTION BOARD - VAPOUR BARRIER - DECK SHEATHING - ROOF DECK, REFER TO STRUCTURAL

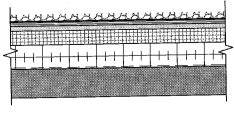


ROOF TYPE 'R3'

TOP POUR 3-PLY COLD APPLIED BUILT UP ROOFING - 25mm OVERLAY BOARD SLOPED POLYISOCYANURATE INSULATION R-35 (152mm) POLYISOCYANURATE INSULATION - VAPOUR BARRIER - EXISTING CONCRETE DECK

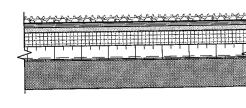



3-PLY COLD APPLIED BUILT UP ROOFING - 25mm OVERLAY BOARD - SLOPED POLYISOCYANURATE INSULATION (R-19.5 AVERAGE) - R-17 (75mm) POLYISOCYANURATE INSULATION - VAPOUR BARRIER - EXISTING ROOF MEMBRANE - EXISTING CONCRETE DECK

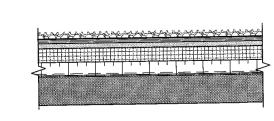


ROOF TYPE 'R4'


TOP POUR

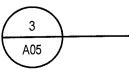


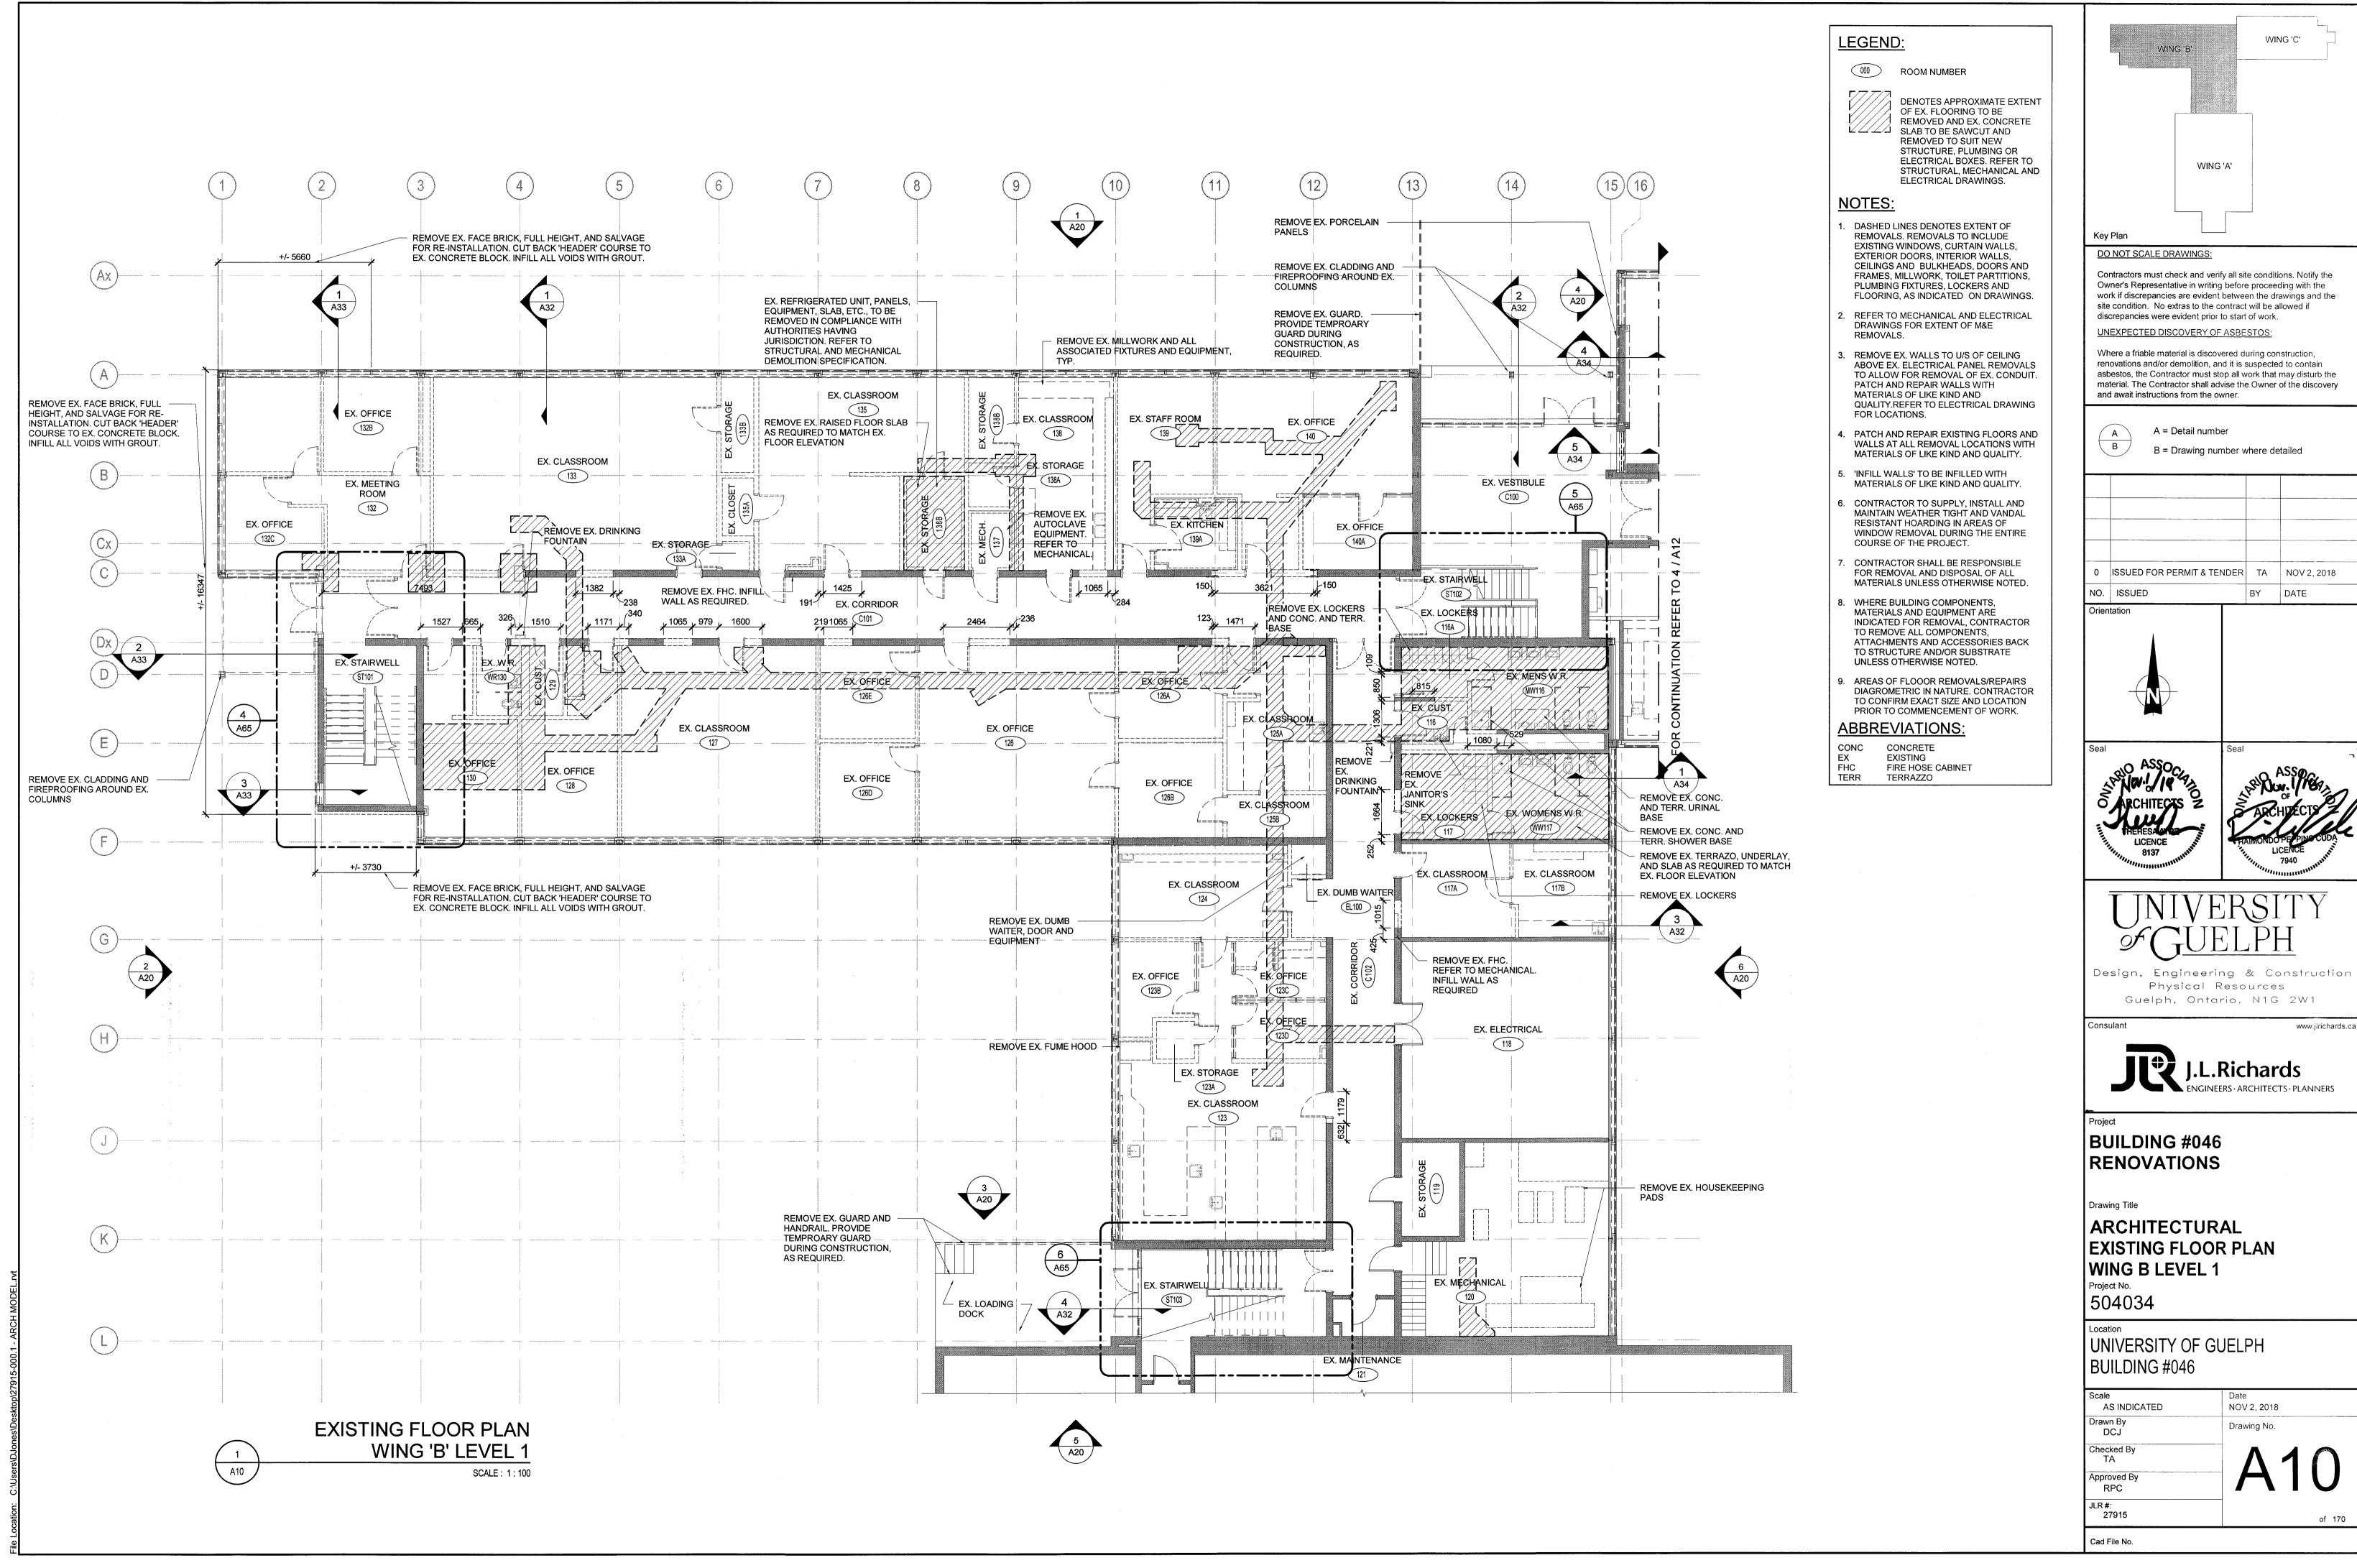

Scale	Date
AS INDICATED	NOV 2, 2018
Drawn By DCJ	Drawing No.
Checked By TA	10
Approved By RPC	AIU
JLR #: 27915	of 170

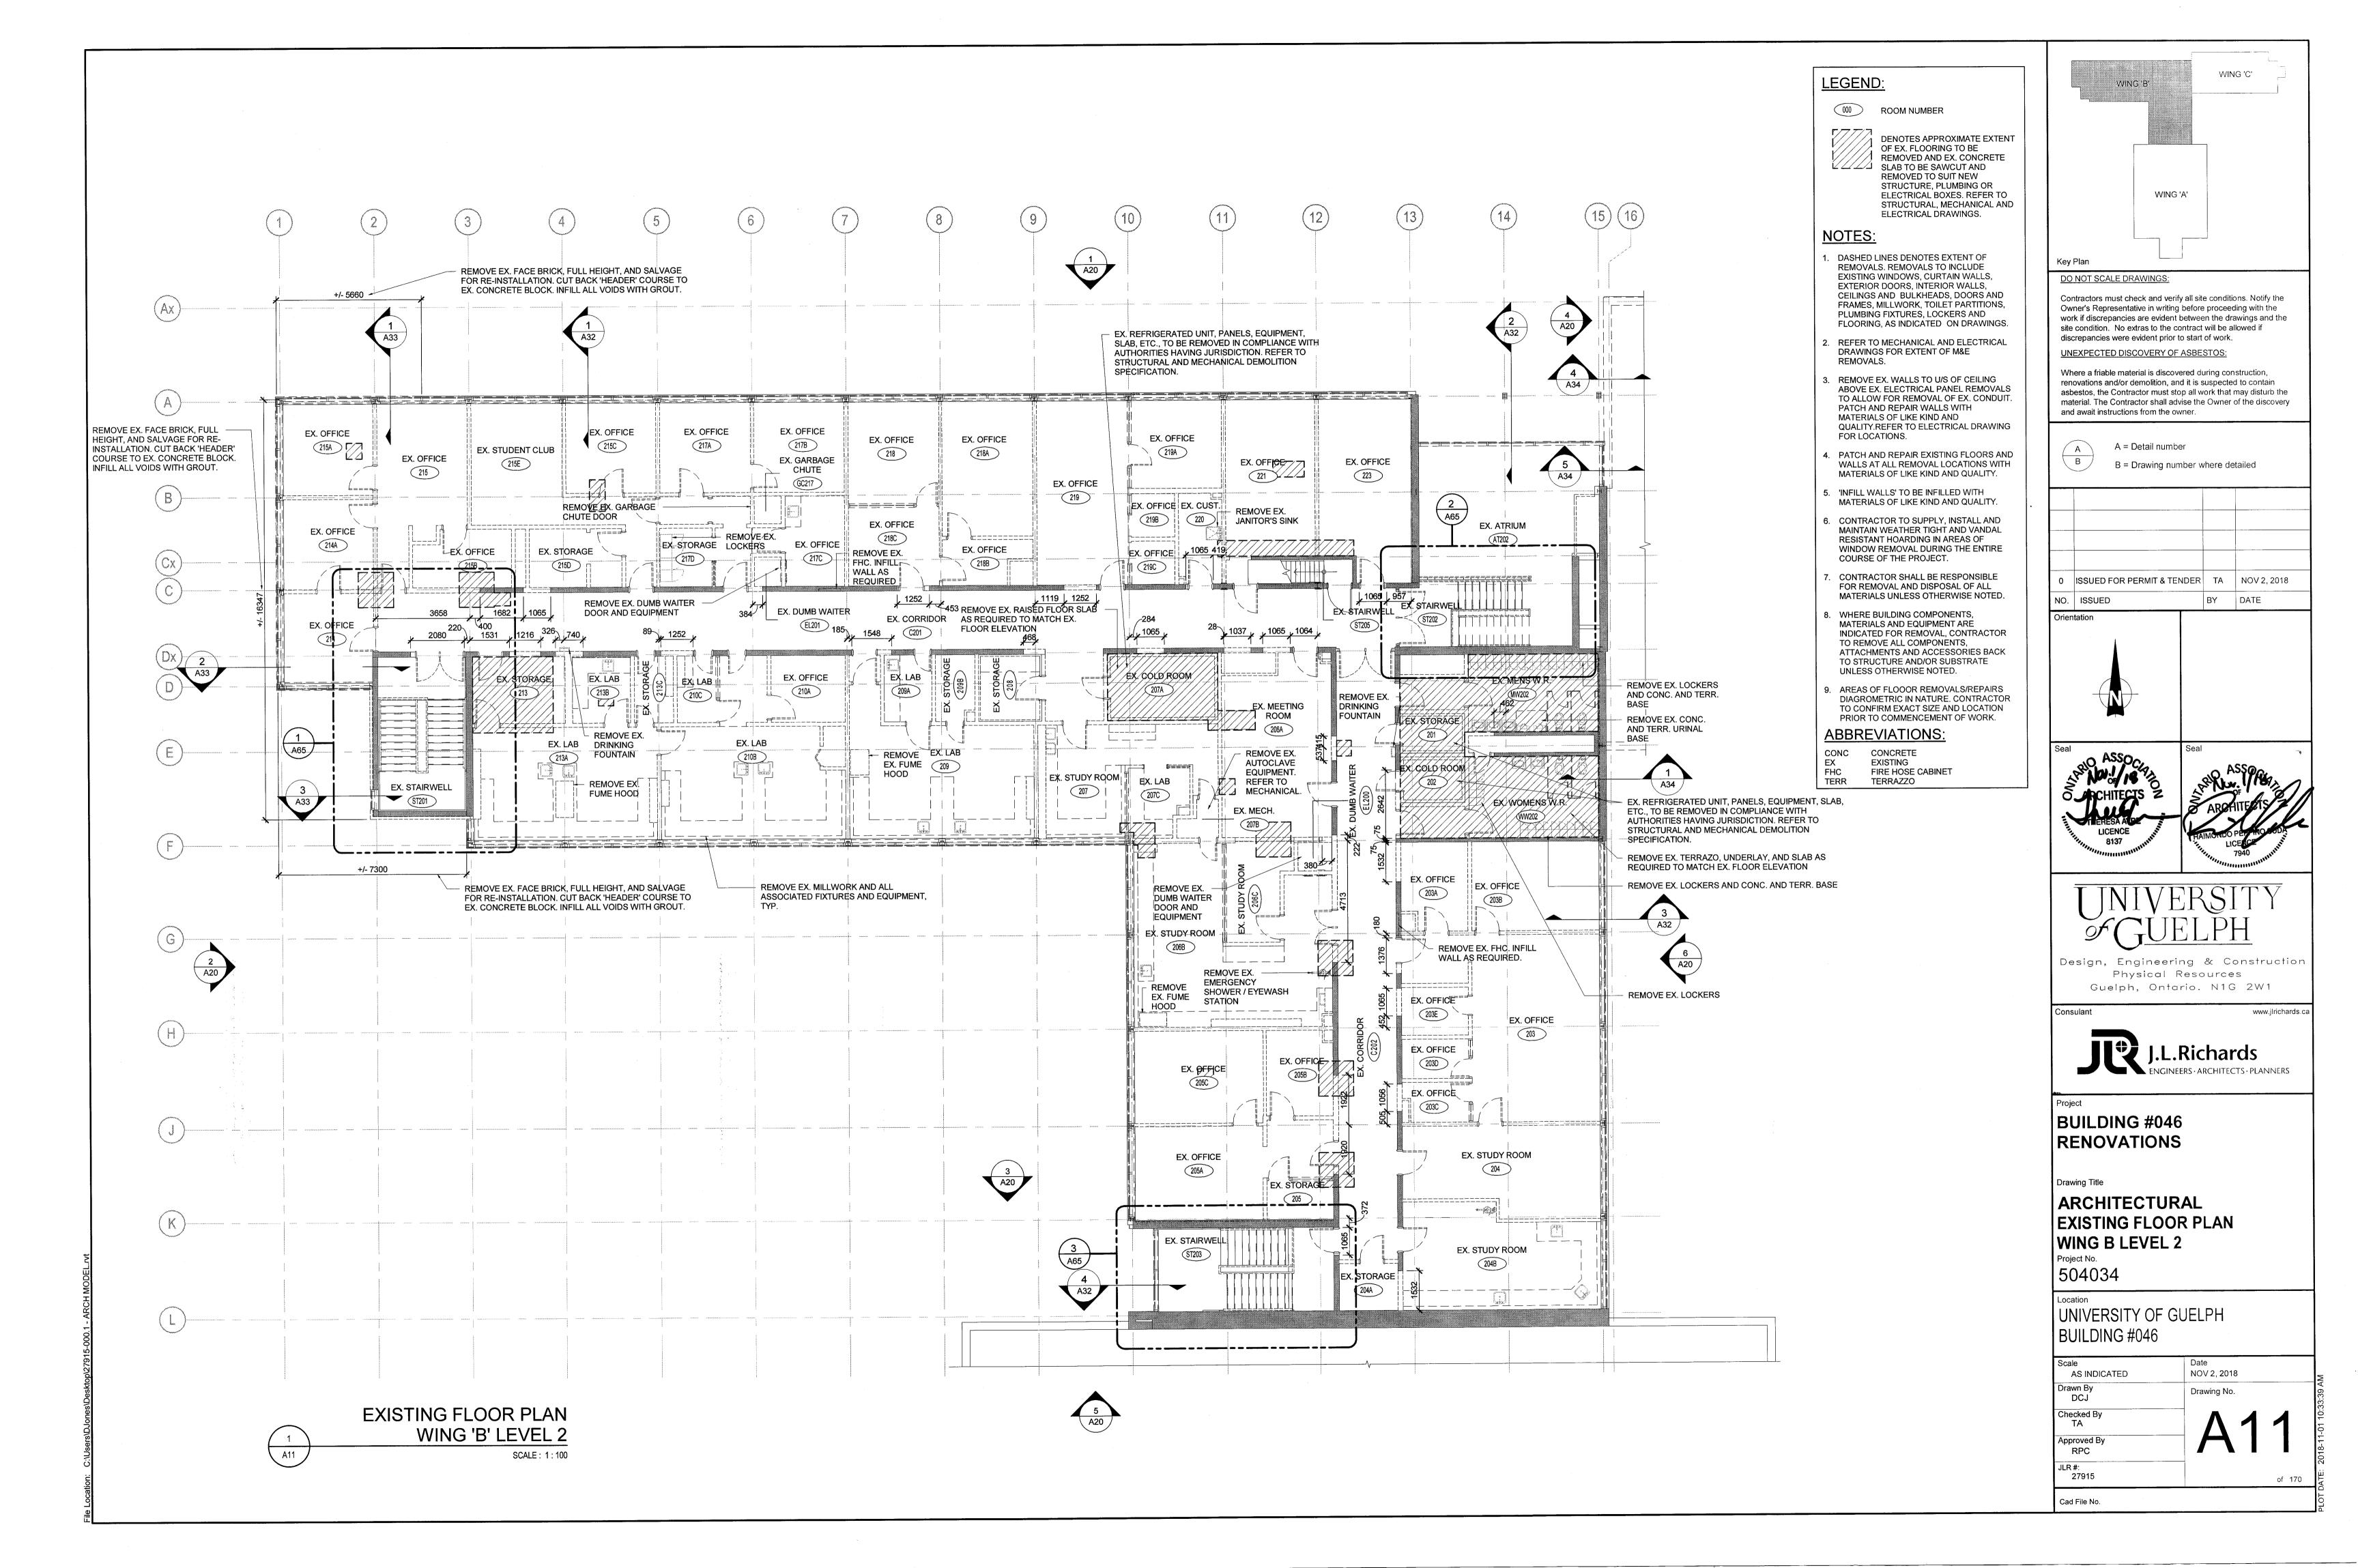

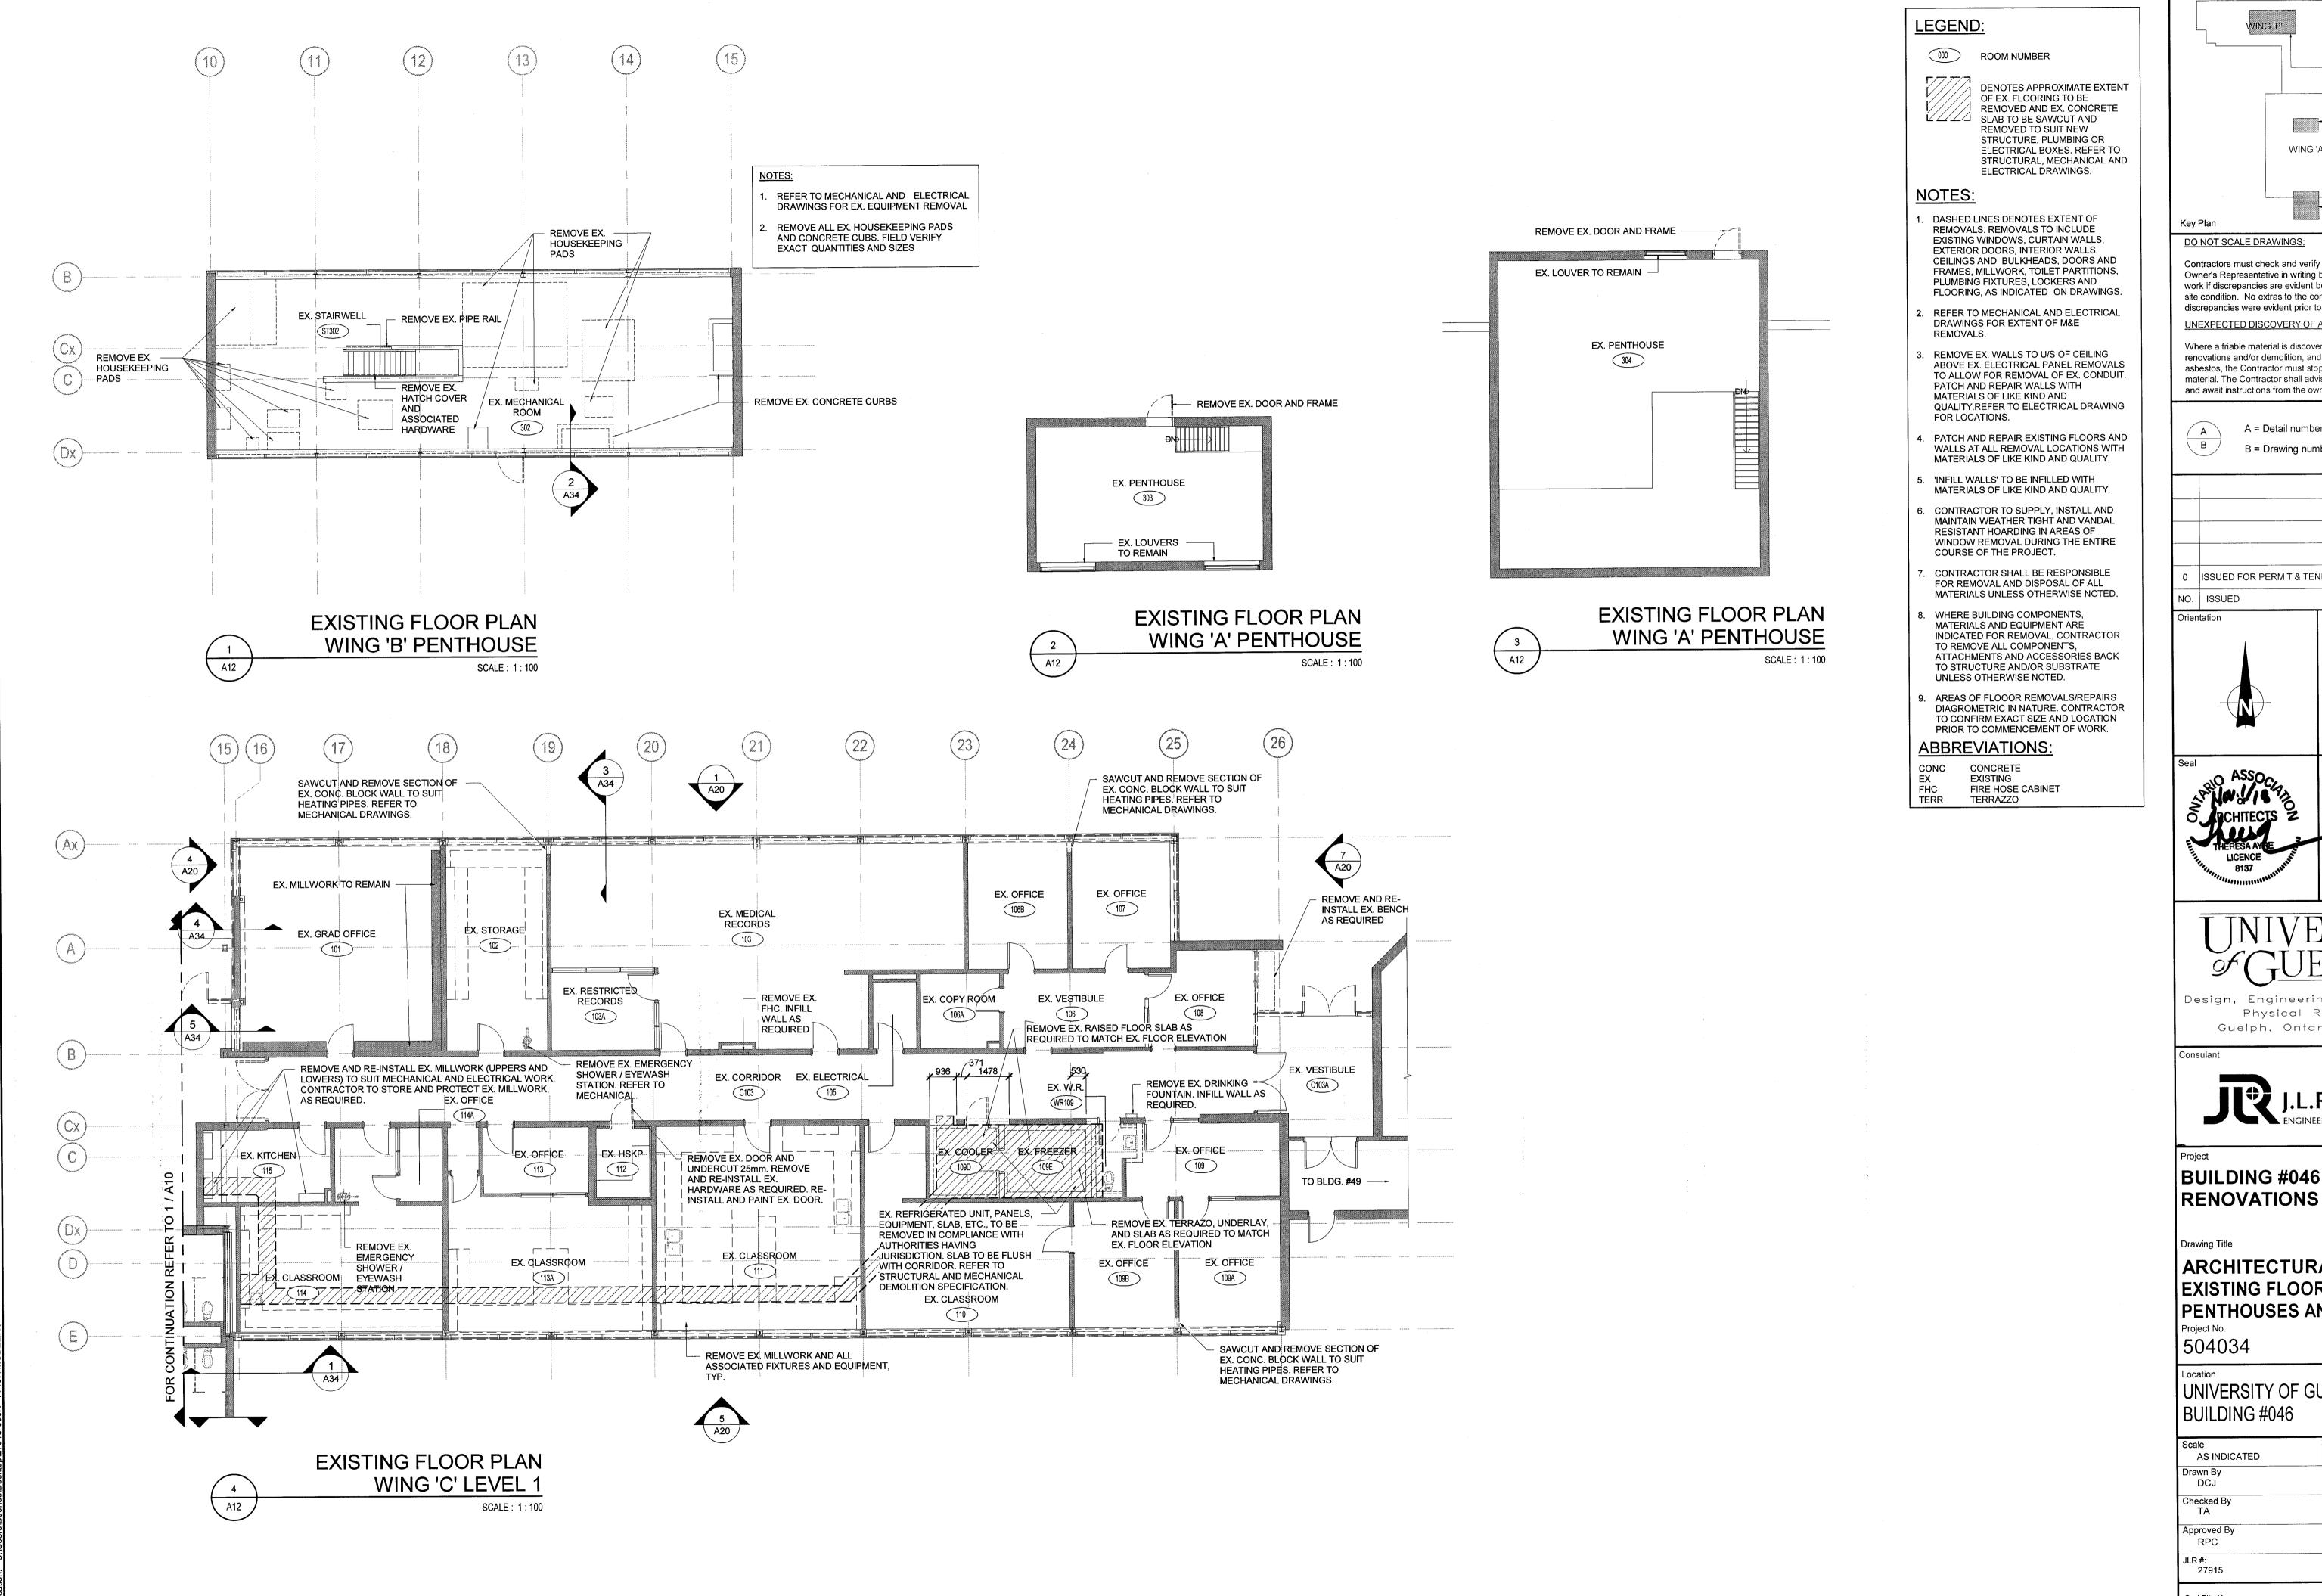

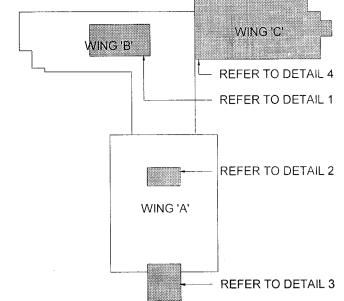

DO NOT SCALE DRAWINGS:

Contractors must check and verify all site conditions. Notify the Owner's Representative in writing before proceeding with the work if discrepancies are evident between the drawings and the site condition. No extras to the contract will be allowed if discrepancies were evident prior to start of work.

UNEXPECTED DISCOVERY OF ASBESTOS:

Where a friable material is discovered during construction, renovations and/or demolition, and it is suspected to contain asbestos, the Contractor must stop all work that may disturb the material. The Contractor shall advise the Owner of the discovery and await instructions from the owner.

A = Detail number

B = Drawing number where detailed

ISSUED FOR PERMIT & TENDER TA NOV 2, 2018

BY DATE

LICENCE

Design, Engineering & Construction Physical Resources Guelph, Ontario. N1G 2W1


BUILDING #046

ARCHITECTURAL **EXISTING FLOOR PLAN** PENTHOUSES AND WING C

UNIVERSITY OF GUELPH BUILDING #046

AS INDICATED

NOV 2, 2018 Drawing No.

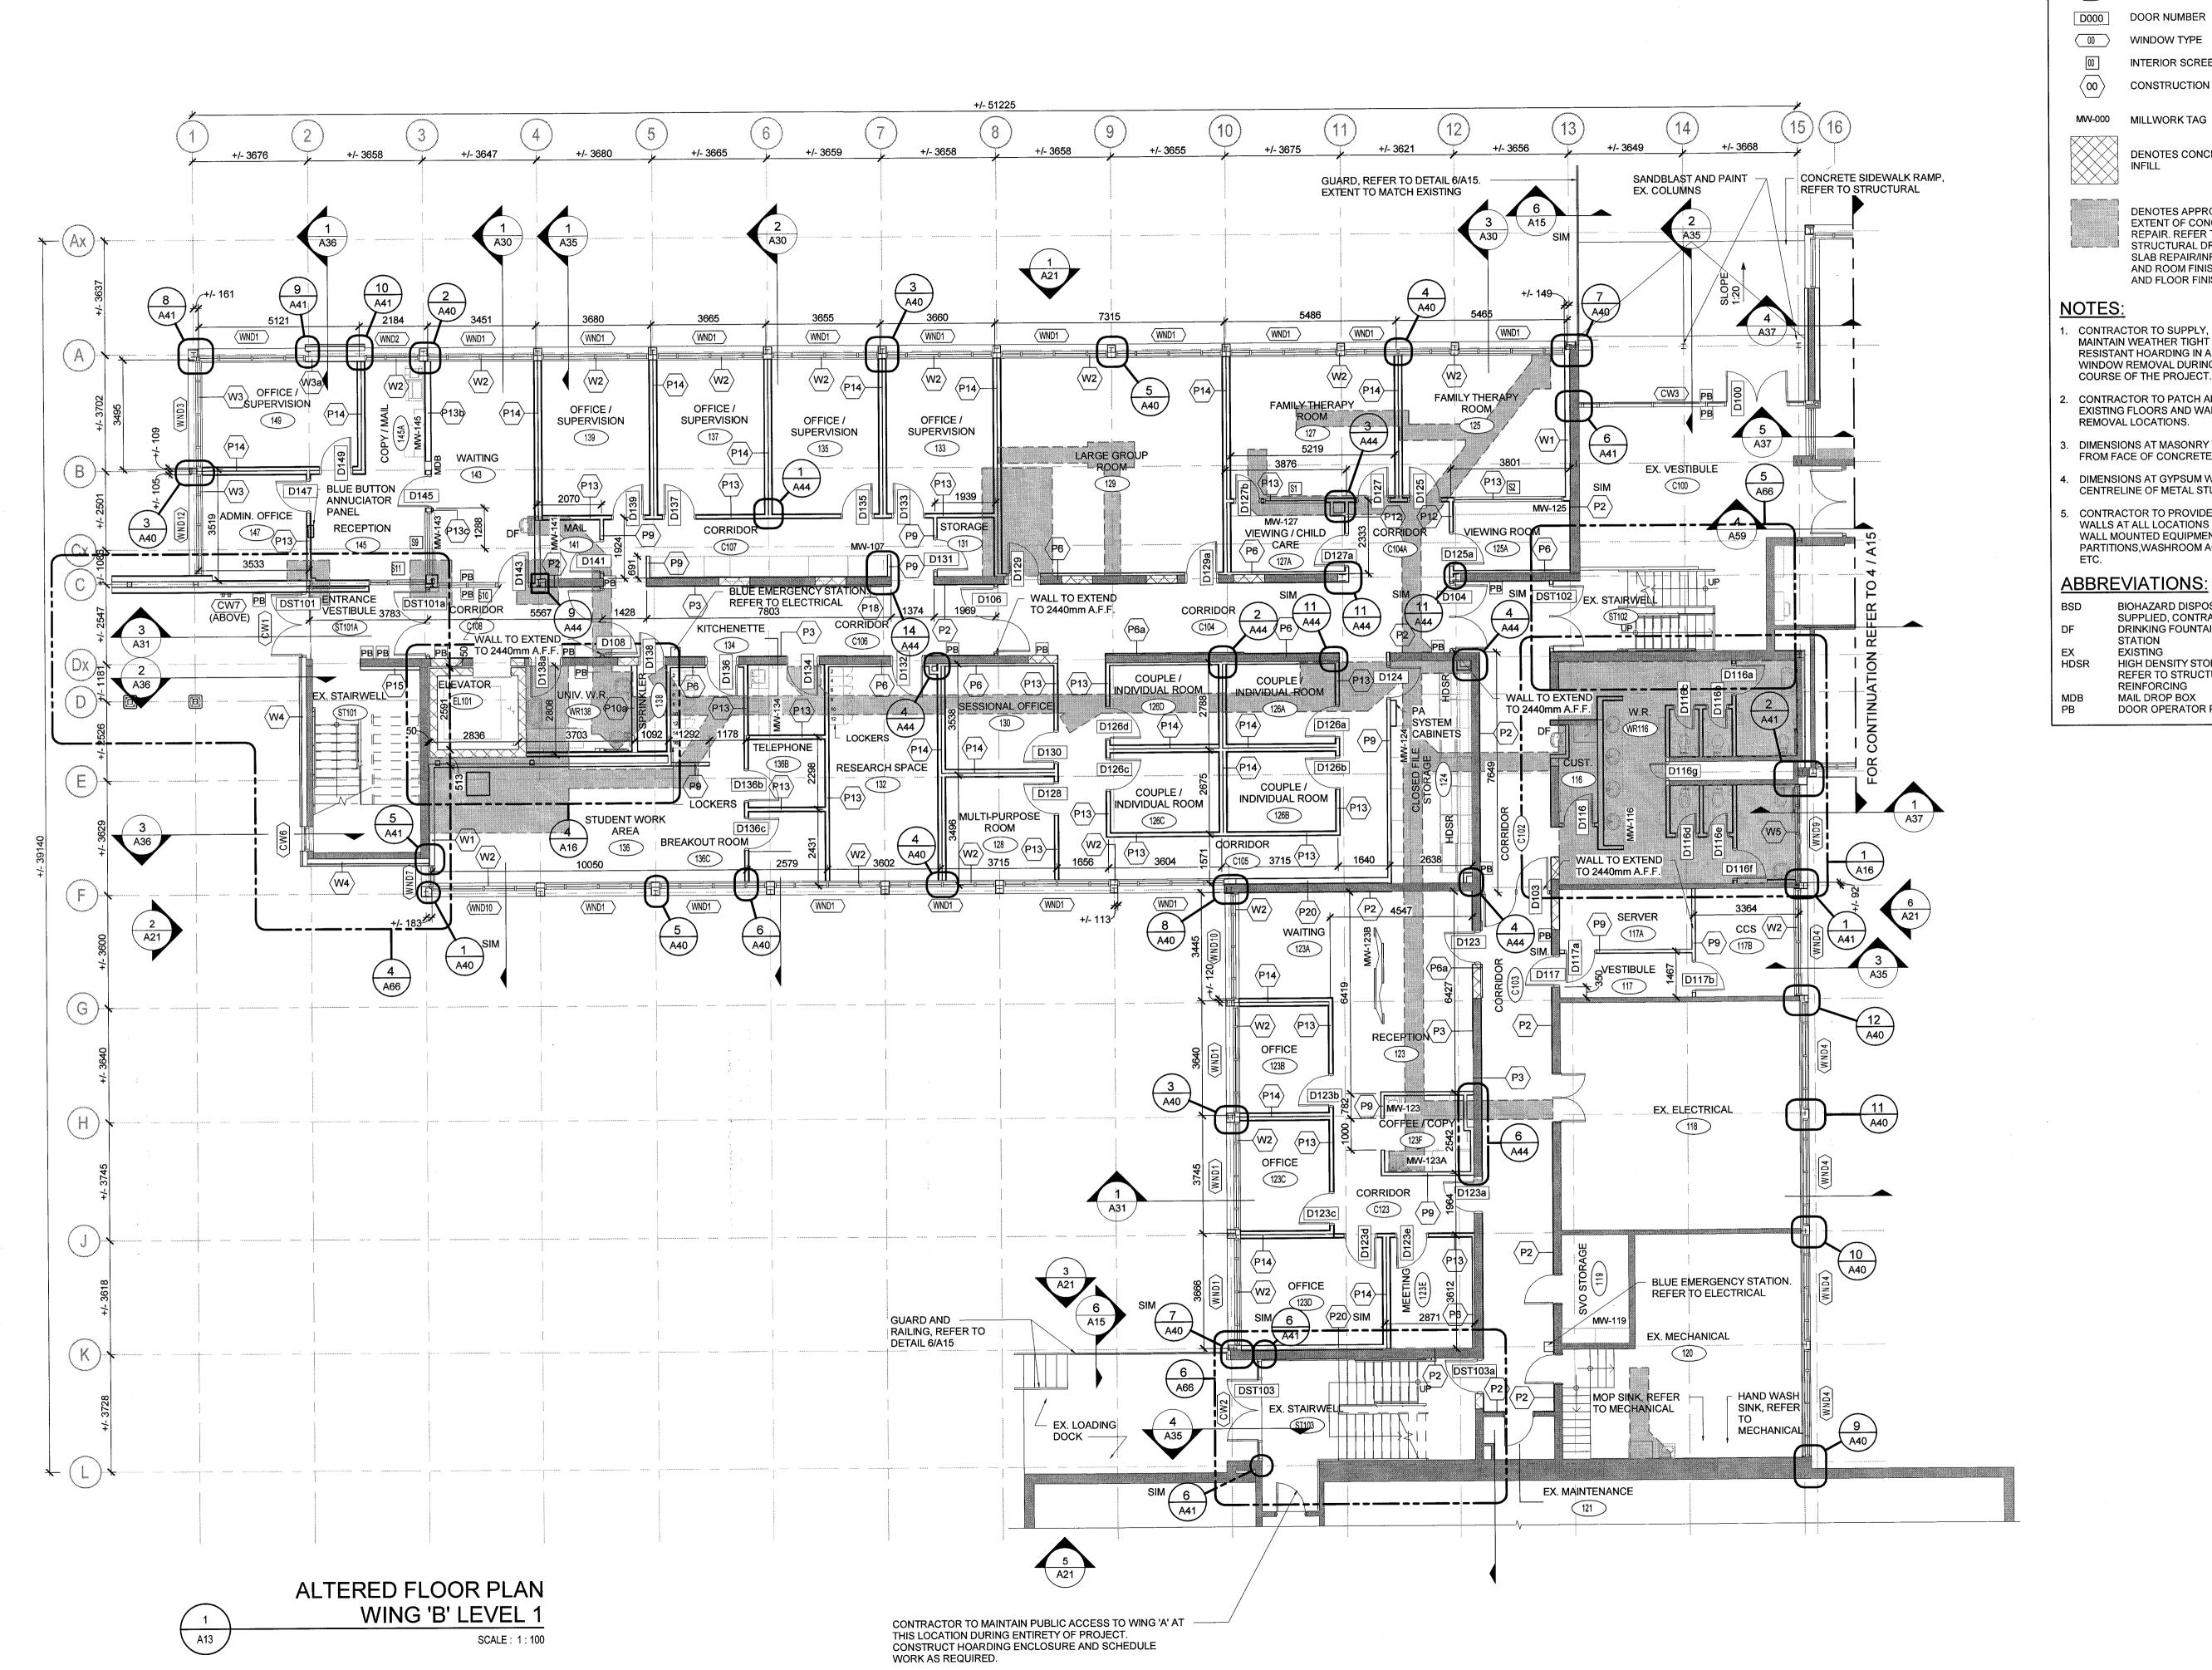

000 ROOM NUMBER

DOOR NUMBER

00 WINDOW TYPE

INTERIOR SCREEN TYPE CONSTRUCTION TYPE

DENOTES CONCRETE BLOCK INFILL

DENOTES APPROXIMATE EXTENT OF CONCRETE SLAB REPAIR. REFER TO STRUCTURAL DRAWINGS FOR SLAB REPAIR/INFILL DETAILS AND ROOM FINISH SCHEDULE AND FLOOR FINISH PLANS.


- CONTRACTOR TO SUPPLY, INSTALL AND MAINTAIN WEATHER TIGHT AND VANDAL RESISTANT HOARDING IN AREAS OF WINDOW REMOVAL DURING THE ENTIRE COURSE OF THE PROJECT.
- 2. CONTRACTOR TO PATCH AND REPAIR EXISTING FLOORS AND WALLS AT ALL REMOVAL LOCATIONS.
- DIMENSIONS AT MASONRY WALLS ARE FROM FACE OF CONCRETE BLOCK.
- DIMENSIONS AT GYPSUM WALLS ARE FROM CENTRELINE OF METAL STUD.
- CONTRACTOR TO PROVIDE BLOCKING IN WALLS AT ALL LOCATIONS OF MILLWORK, WALL MOUNTED EQUIPMENT, WASHROOM PARTITIONS, WASHROOM ACCESSORIES,

ABBREVIATIONS:

BIOHAZARD DISPOSAL UNIT - OWNER SUPPLIED, CONTRACTOR INSTALLED. DRINKING FOUNTAIN / BOTTLE FILLING

EXISTING HIGH DENSITY STORAGE RACK (N.I.C.), REFER TO STRUCTURAL FOR SLAB REINFORCING

MAIL DROP BOX DOOR OPERATOR PUSH BUTTON

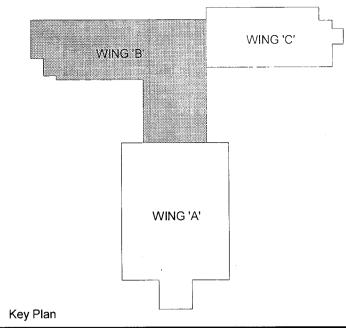


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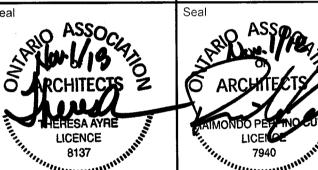


B = Drawing number where detailed

0 ISSUED FOR PERMIT & TENDER TA NOV 2, 2018

BY DATE NO. ISSUED Orientation

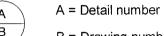





Design, Engineering & Construction Physical Resources Guelph, Ontario. N1G 2W1

J.L.Richards


BUILDING #046 RENOVATIONS

Drawing Title ARCHITECTURAL ALTERED FLOOR PLAN WING B LEVEL 1

504034

UNIVERSITY OF GUELPH BUILDING #046

NOV 2, 2018 AS INDICATED Drawing No. Checked By Approved By RPC

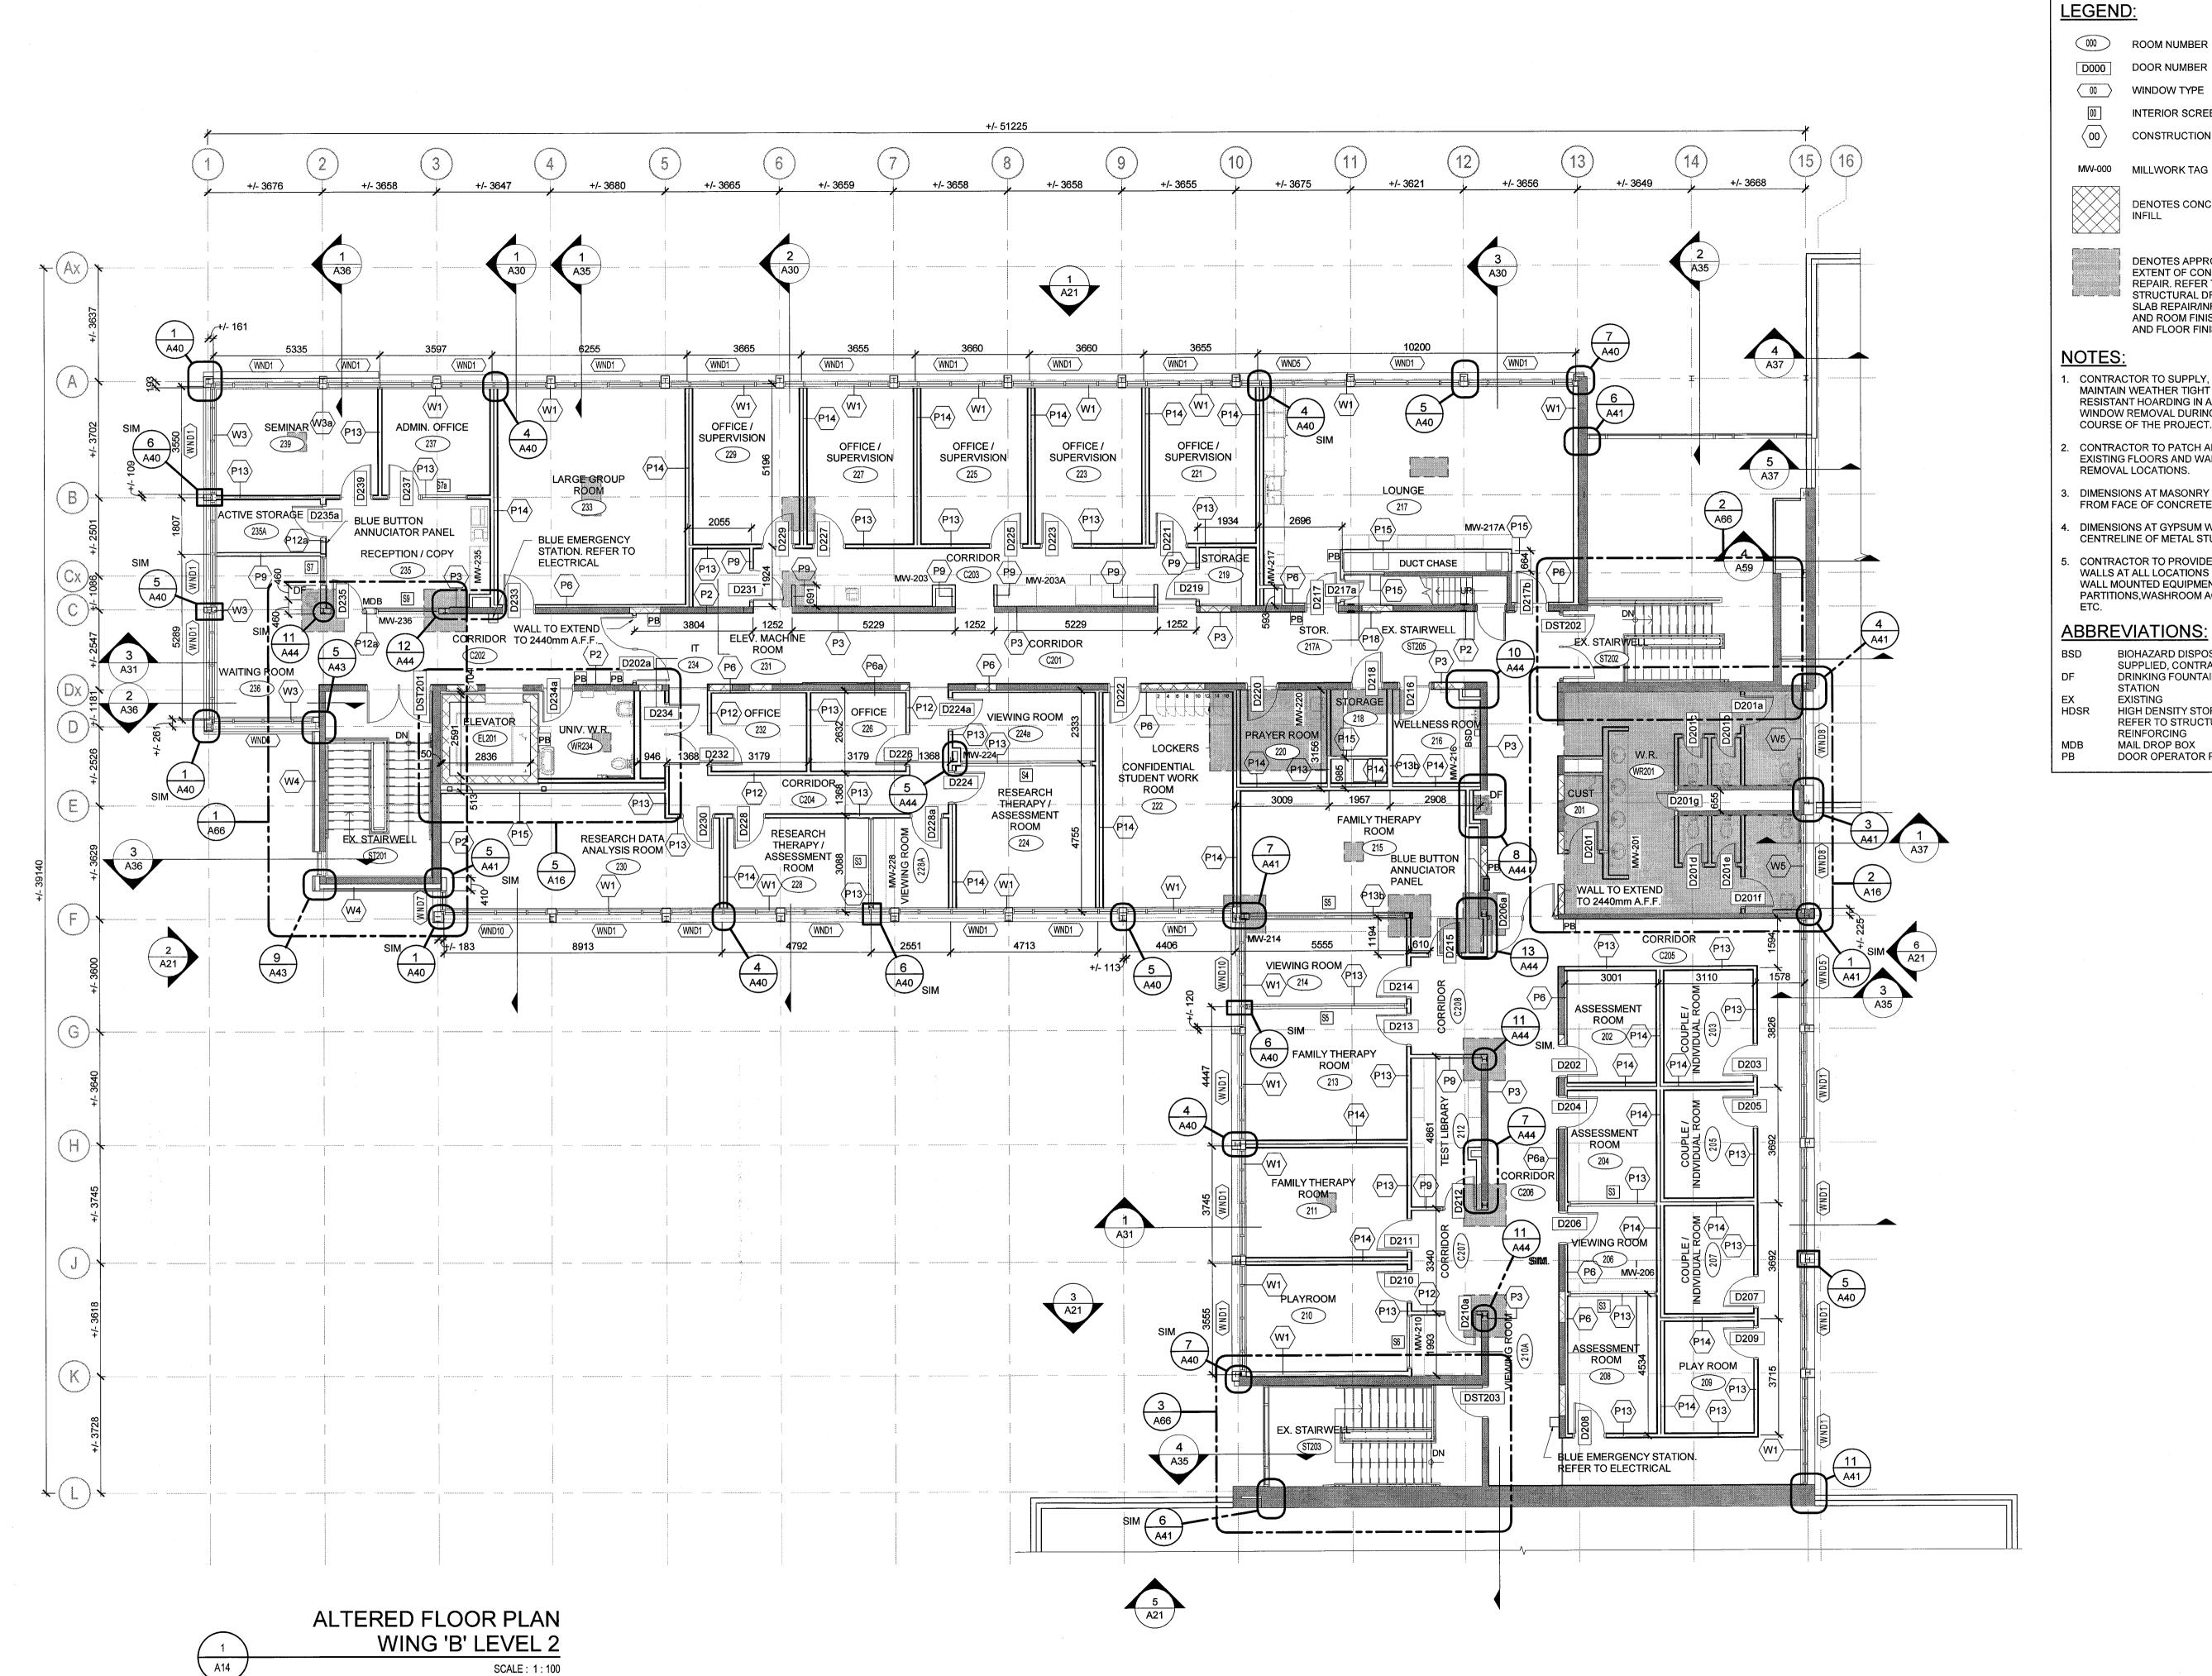

000 ROOM NUMBER



00 WINDOW TYPE INTERIOR SCREEN TYPE

CONSTRUCTION TYPE

MW-000 MILLWORK TAG

DENOTES CONCRETE BLOCK



DENOTES APPROXIMATE EXTENT OF CONCRETE SLAB REPAIR, REFER TO STRUCTURAL DRAWINGS FOR SLAB REPAIR/INFILL DETAILS AND ROOM FINISH SCHEDULE AND FLOOR FINISH PLANS.


- CONTRACTOR TO SUPPLY, INSTALL AND MAINTAIN WEATHER TIGHT AND VANDAL RESISTANT HOARDING IN AREAS OF WINDOW REMOVAL DURING THE ENTIRE COURSE OF THE PROJECT.
- CONTRACTOR TO PATCH AND REPAIR EXISTING FLOORS AND WALLS AT ALL REMOVAL LOCATIONS.
- DIMENSIONS AT MASONRY WALLS ARE FROM FACE OF CONCRETE BLOCK.
- . DIMENSIONS AT GYPSUM WALLS ARE FROM CENTRELINE OF METAL STUD.
- CONTRACTOR TO PROVIDE BLOCKING IN WALLS AT ALL LOCATIONS OF MILLWORK, WALL MOUNTED EQUIPMENT, WASHROOM PARTITIONS, WASHROOM ACCESSORIES,

ABBREVIATIONS:

BIOHAZARD DISPOSAL UNIT - OWNER SUPPLIED, CONTRACTOR INSTALLED. DRINKING FOUNTAIN / BOTTLE FILLING STATION

EXISTING HIGH DENSITY STORAGE RACK (N.I.C.), REFER TO STRUCTURAL FOR SLAB REINFORCING

MAIL DROP BOX

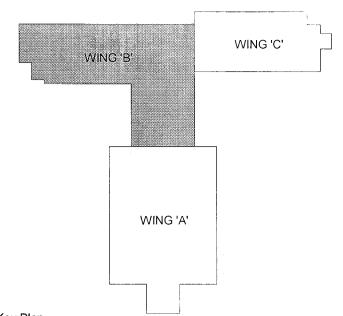

Key Plan

DO NOT SCALE DRAWINGS:


Contractors must check and verify all site conditions. Notify the Owner's Representative in writing before proceeding with the work if discrepancies are evident between the drawings and the site condition. No extras to the contract will be allowed if discrepancies were evident prior to start of work.

UNEXPECTED DISCOVERY OF ASBESTOS:

and await instructions from the owner.

Where a friable material is discovered during construction, renovations and/or demolition, and it is suspected to contain asbestos, the Contractor must stop all work that may disturb the


material. The Contractor shall advise the Owner of the discovery

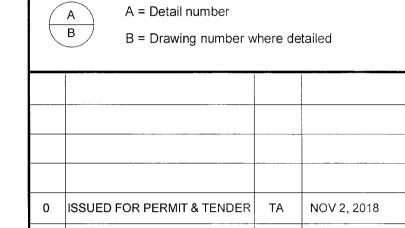

DOOR OPERATOR PUSH BUTTON



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Design, Engineering & Construction Physical Resources Guelph, Ontario. N1G 2W1

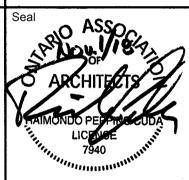

BUILDING #046 RENOVATIONS


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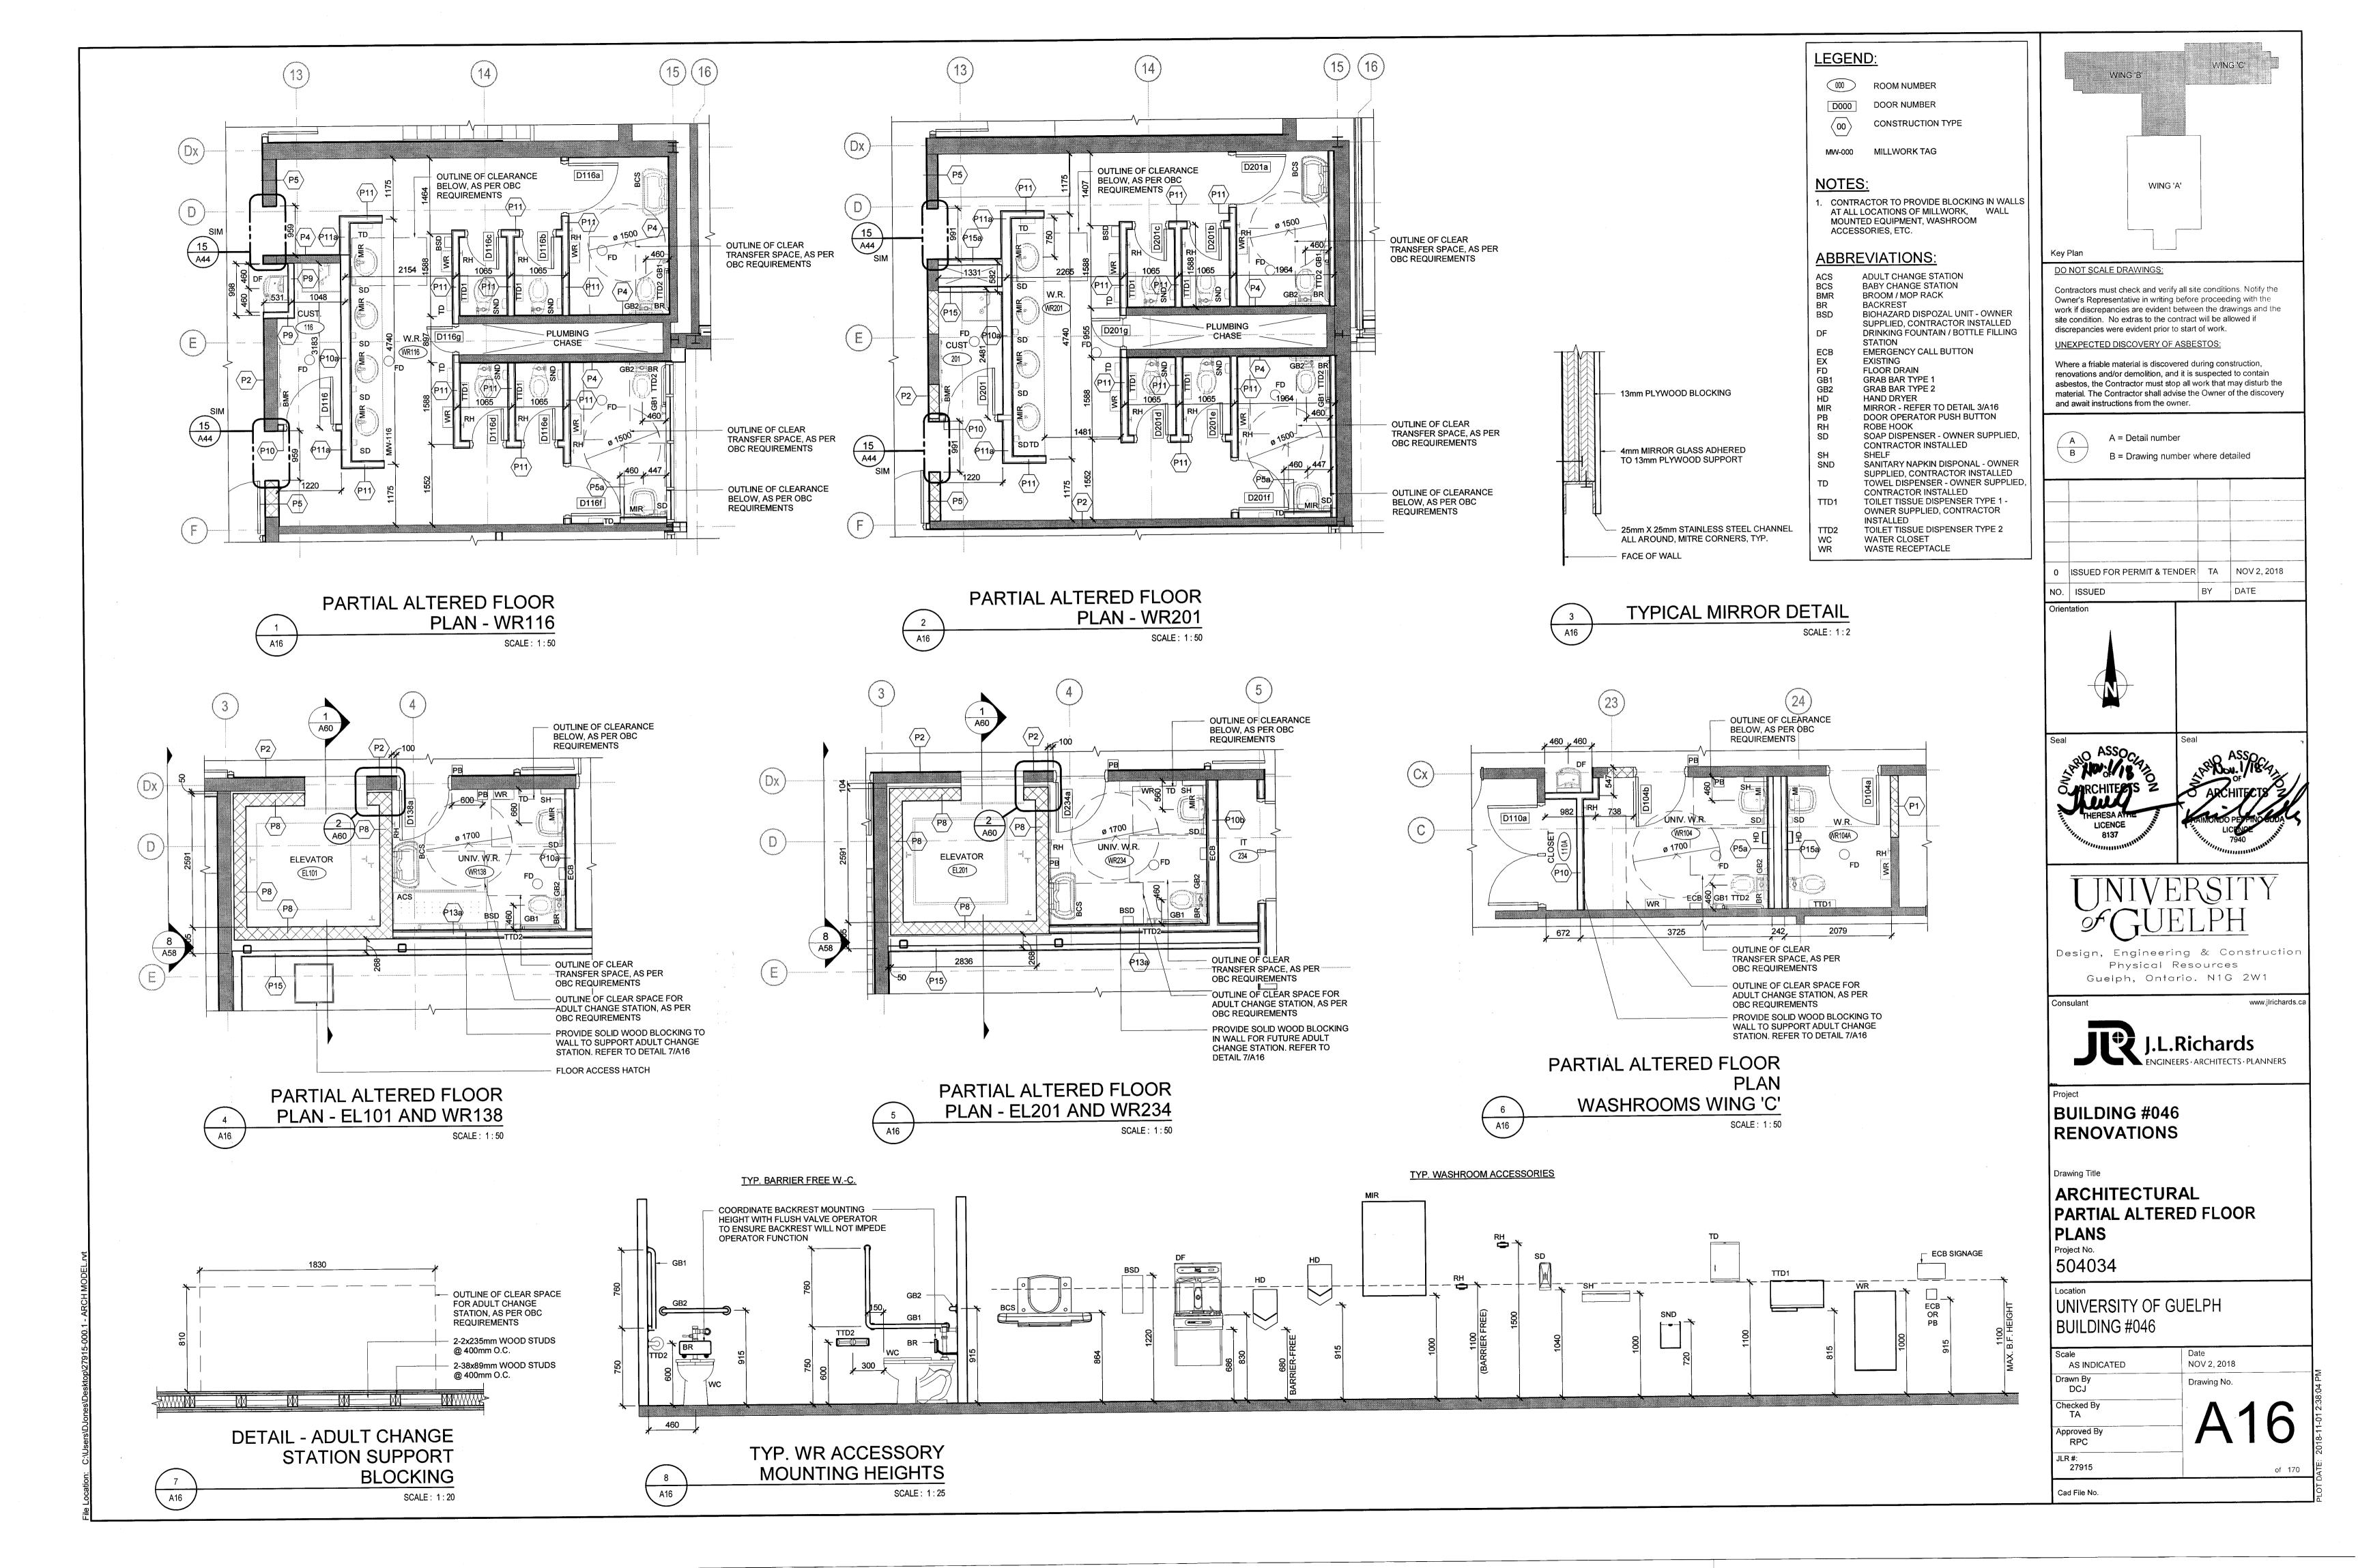
ARCHITECTURAL ALTERED FLOOR PLAN WING B LEVEL 2


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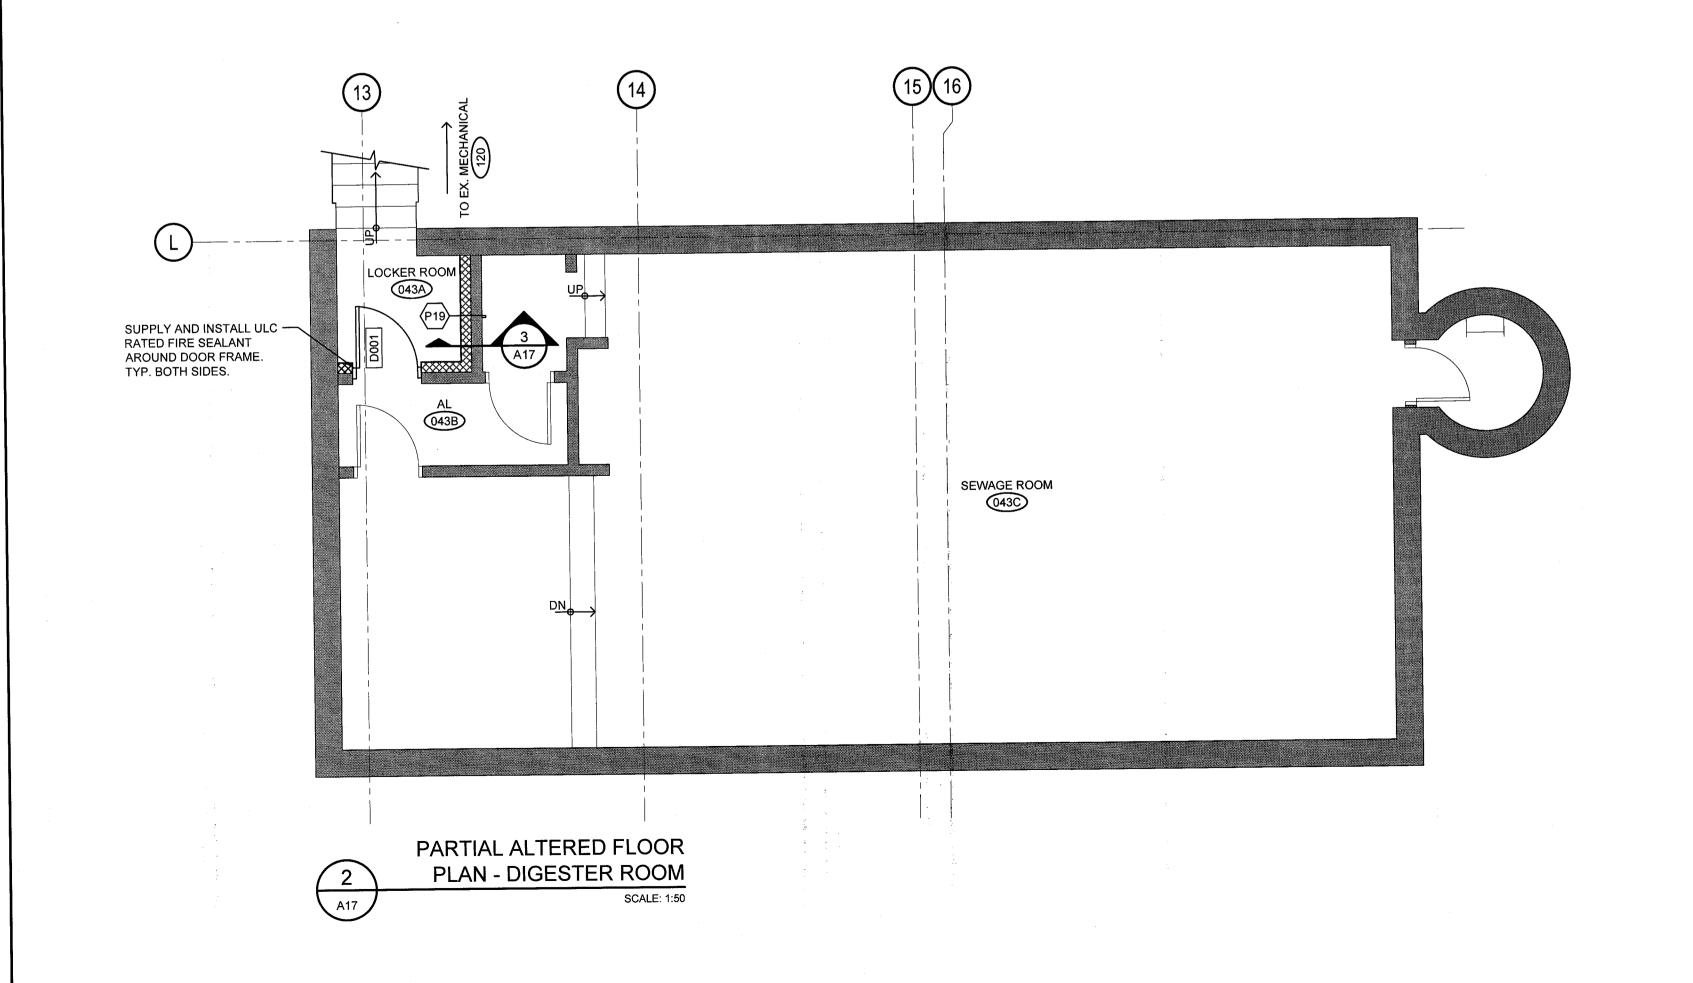
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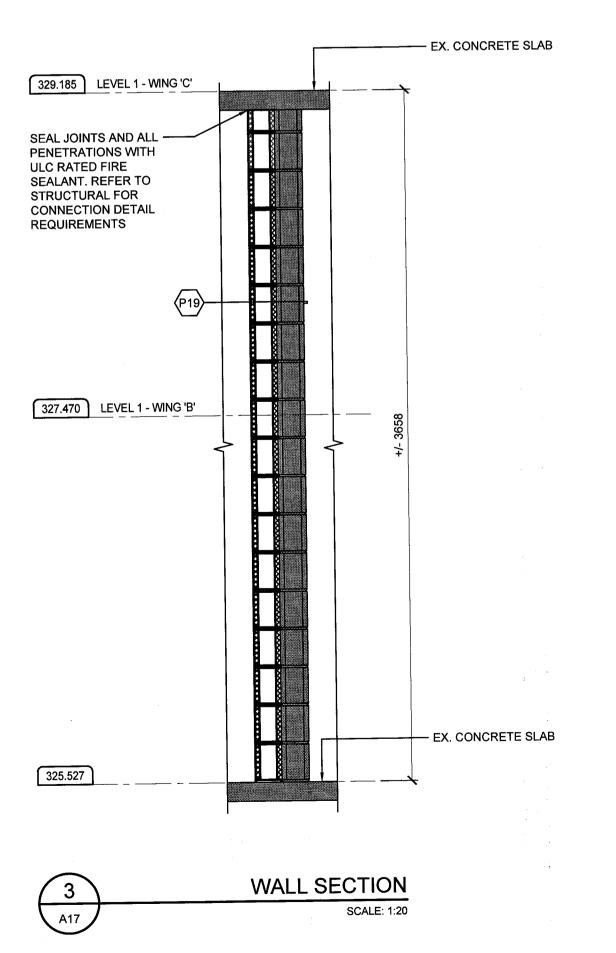
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AS INDICATED	NOV 2, 2018
Drawn By DCJ	Drawing No.
Checked By TA	Λ11
Approved By RPC	14
JLR #: 27915	of 17







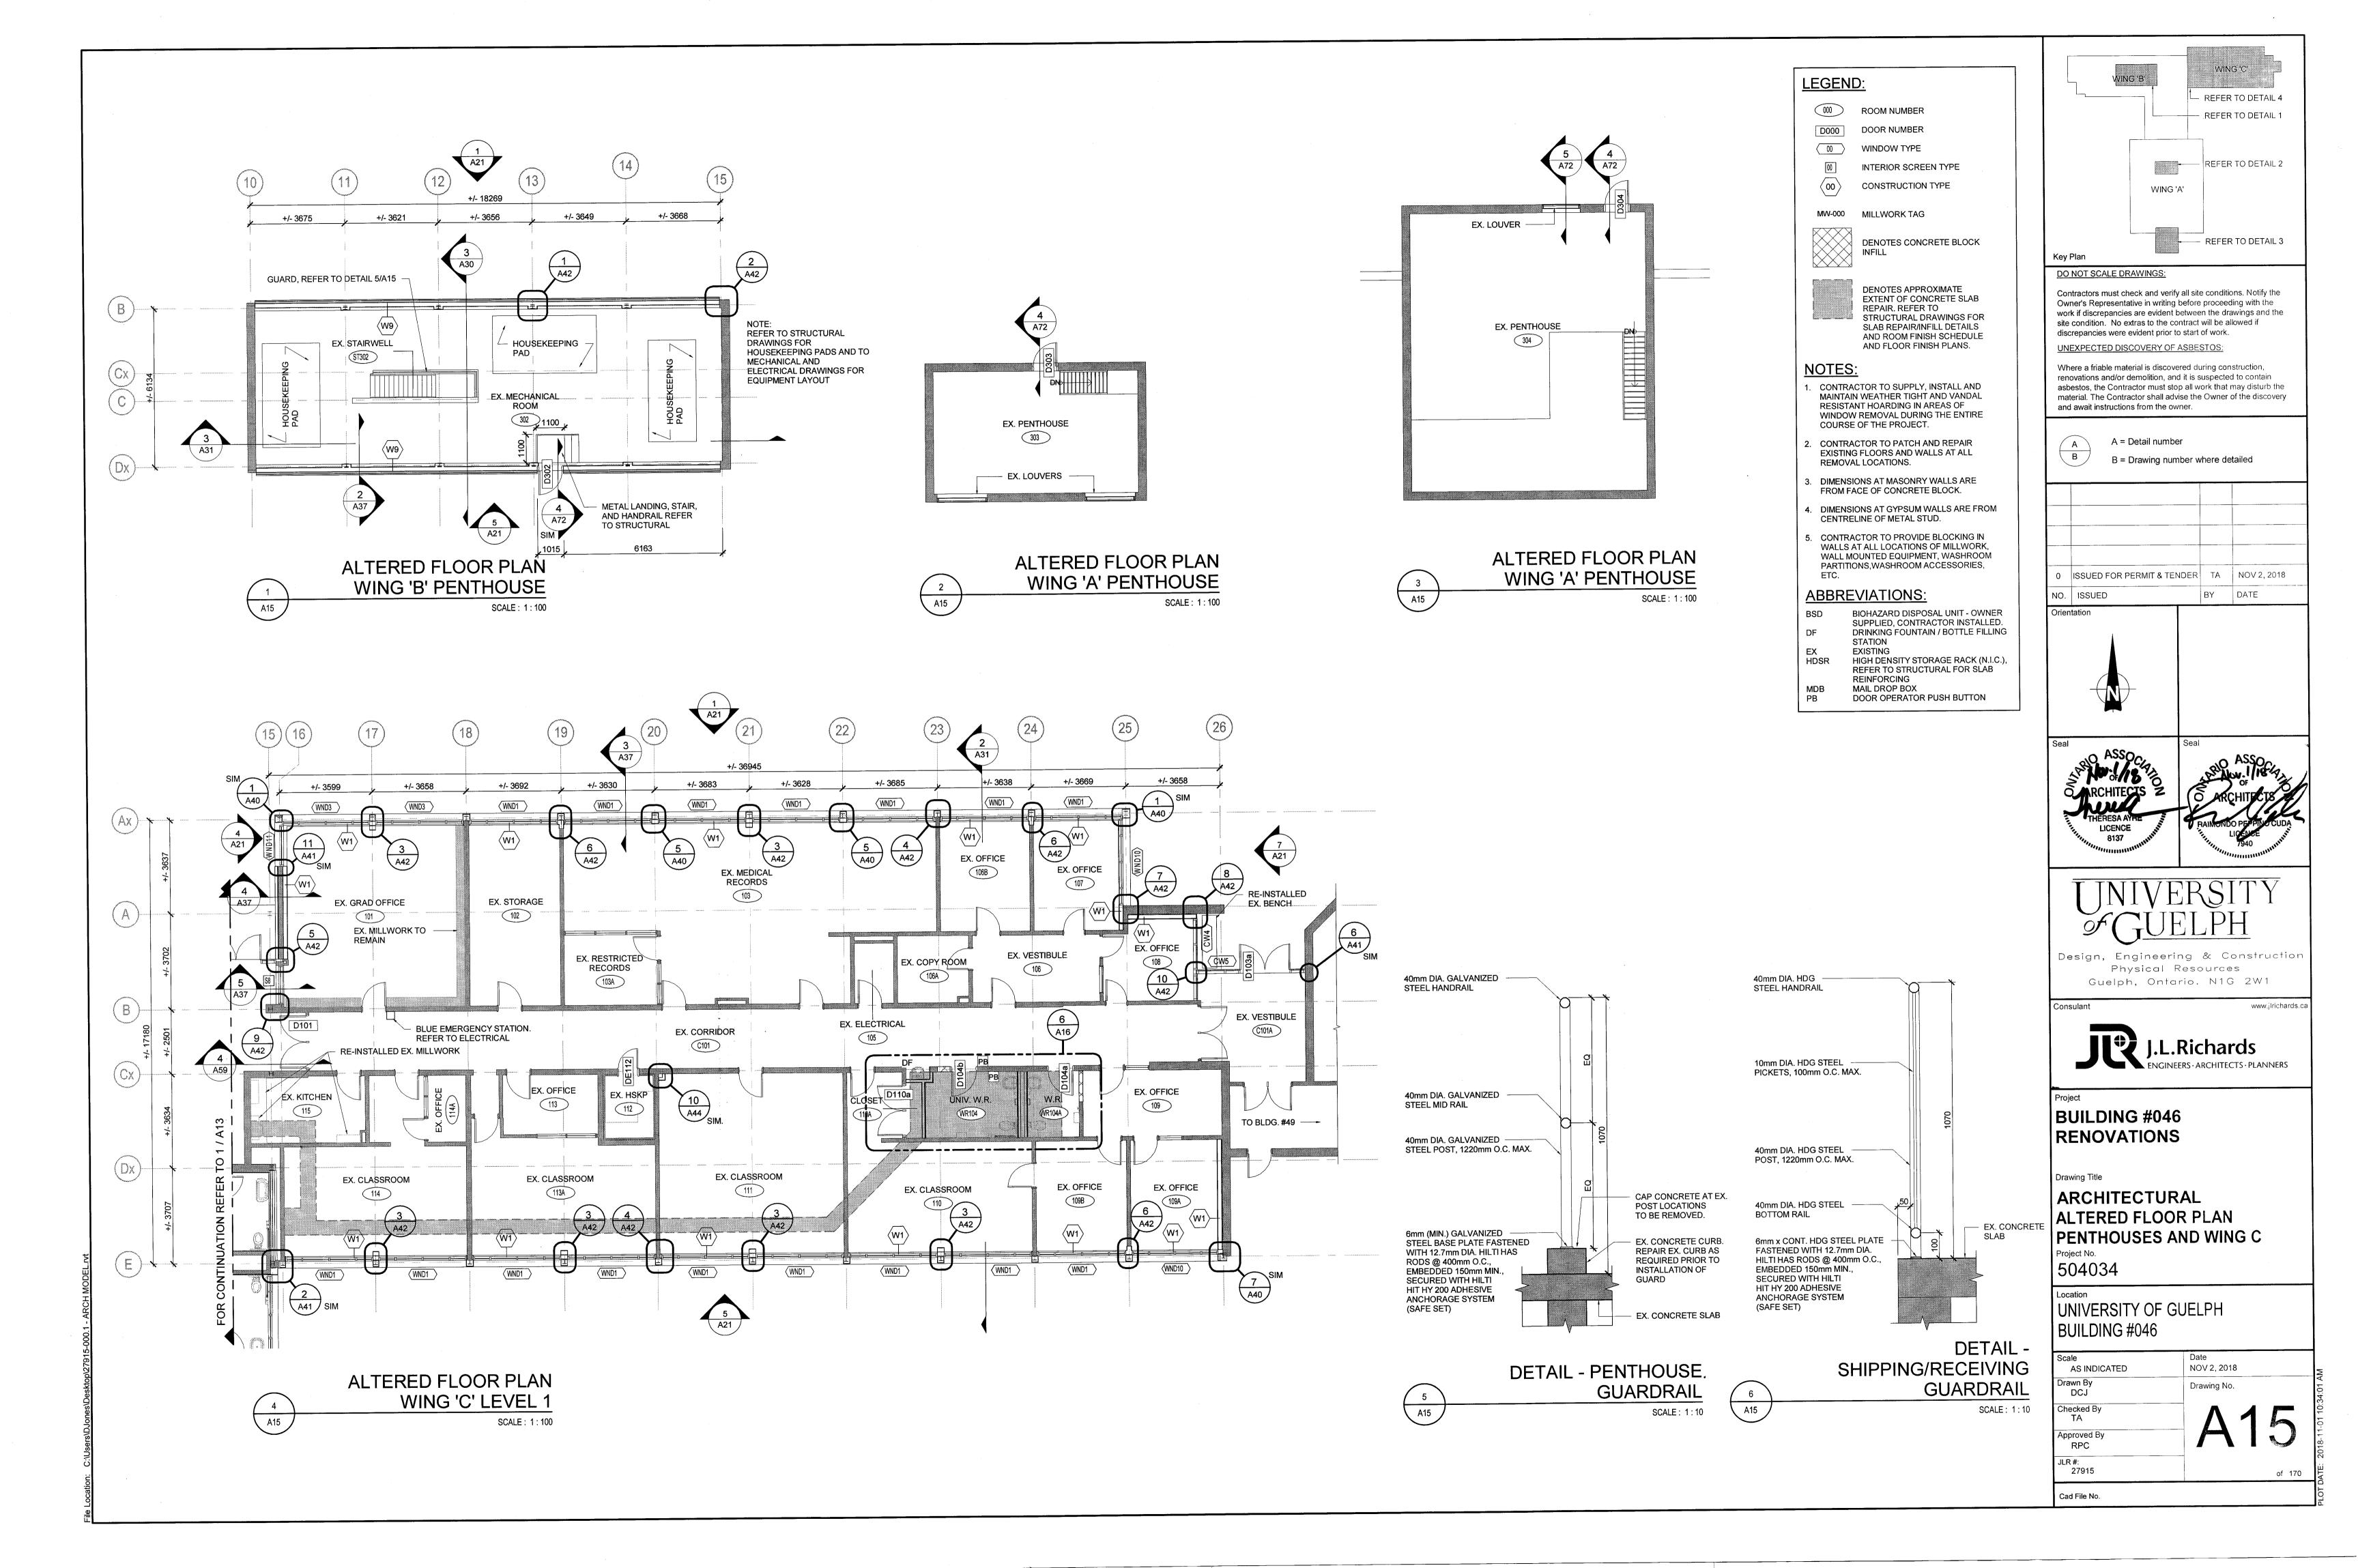

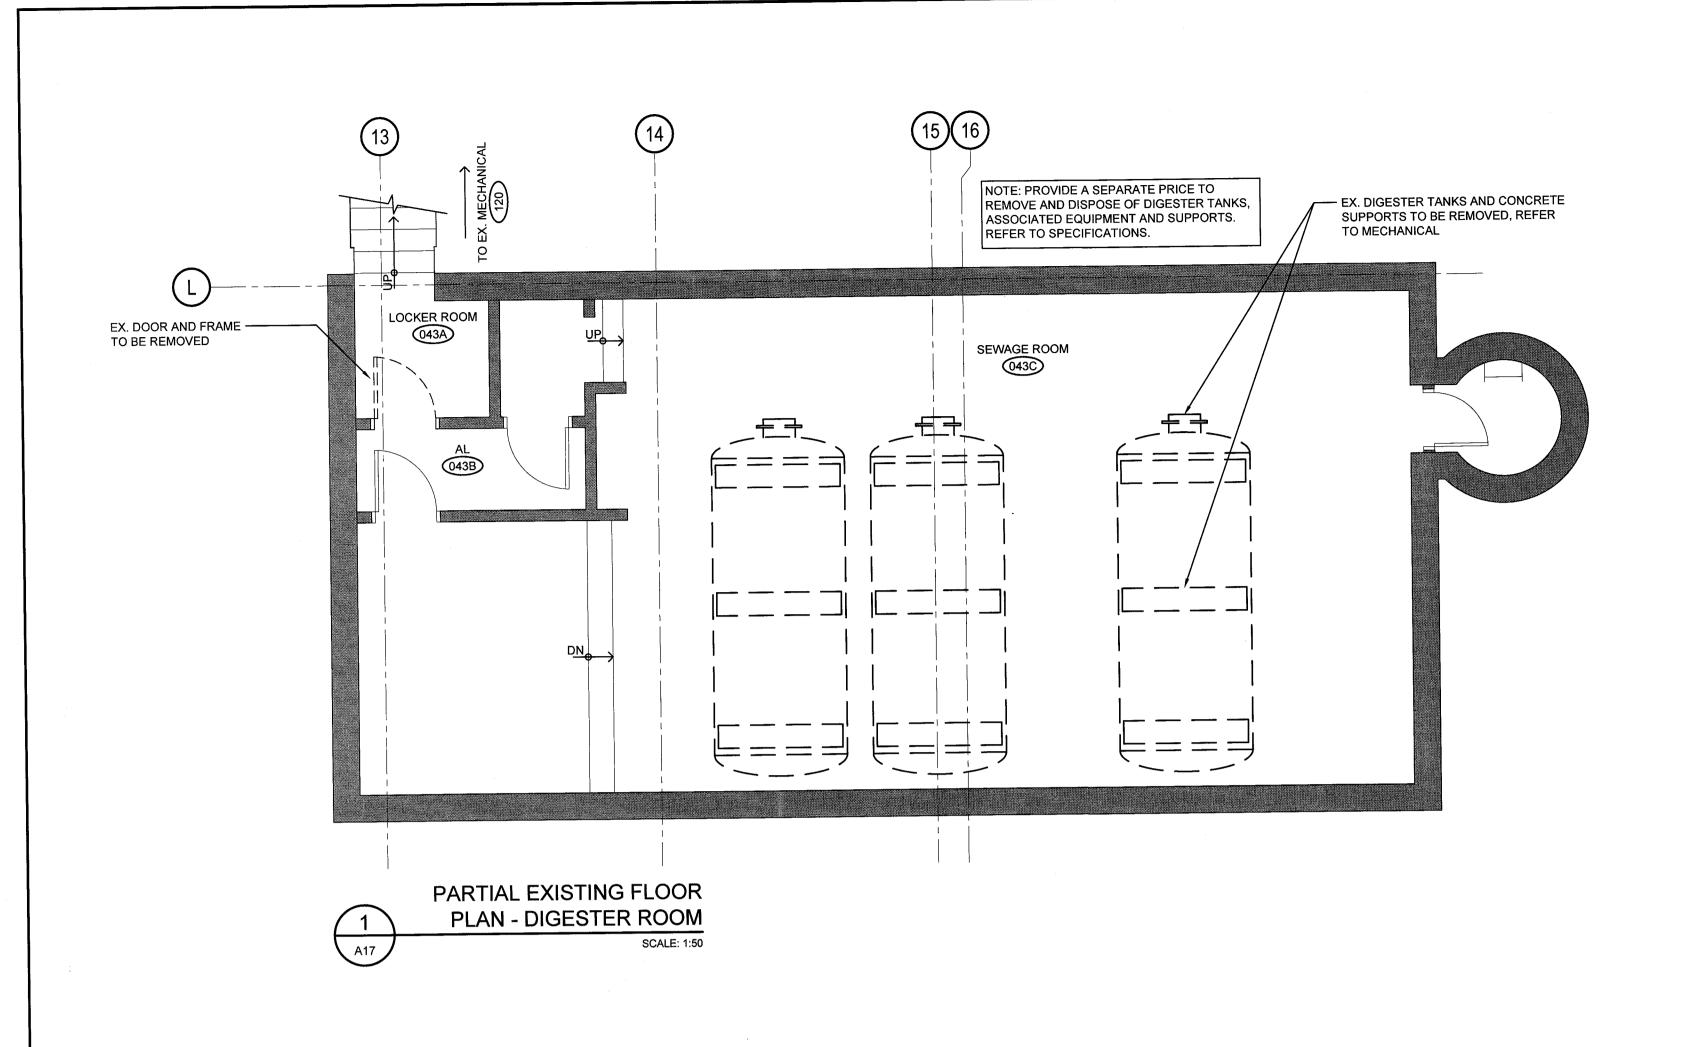

000 ROOM NUMBER




D000 DOOR NUMBER



DENOTES CONCRETE BLOCK

CONSTRUCTION TYPE

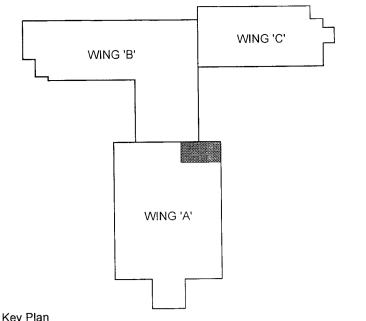

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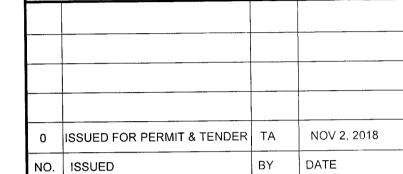
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A = Detail number

B = Drawing number where detailed



Orientation





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BUILDING #046 RENOVATIONS


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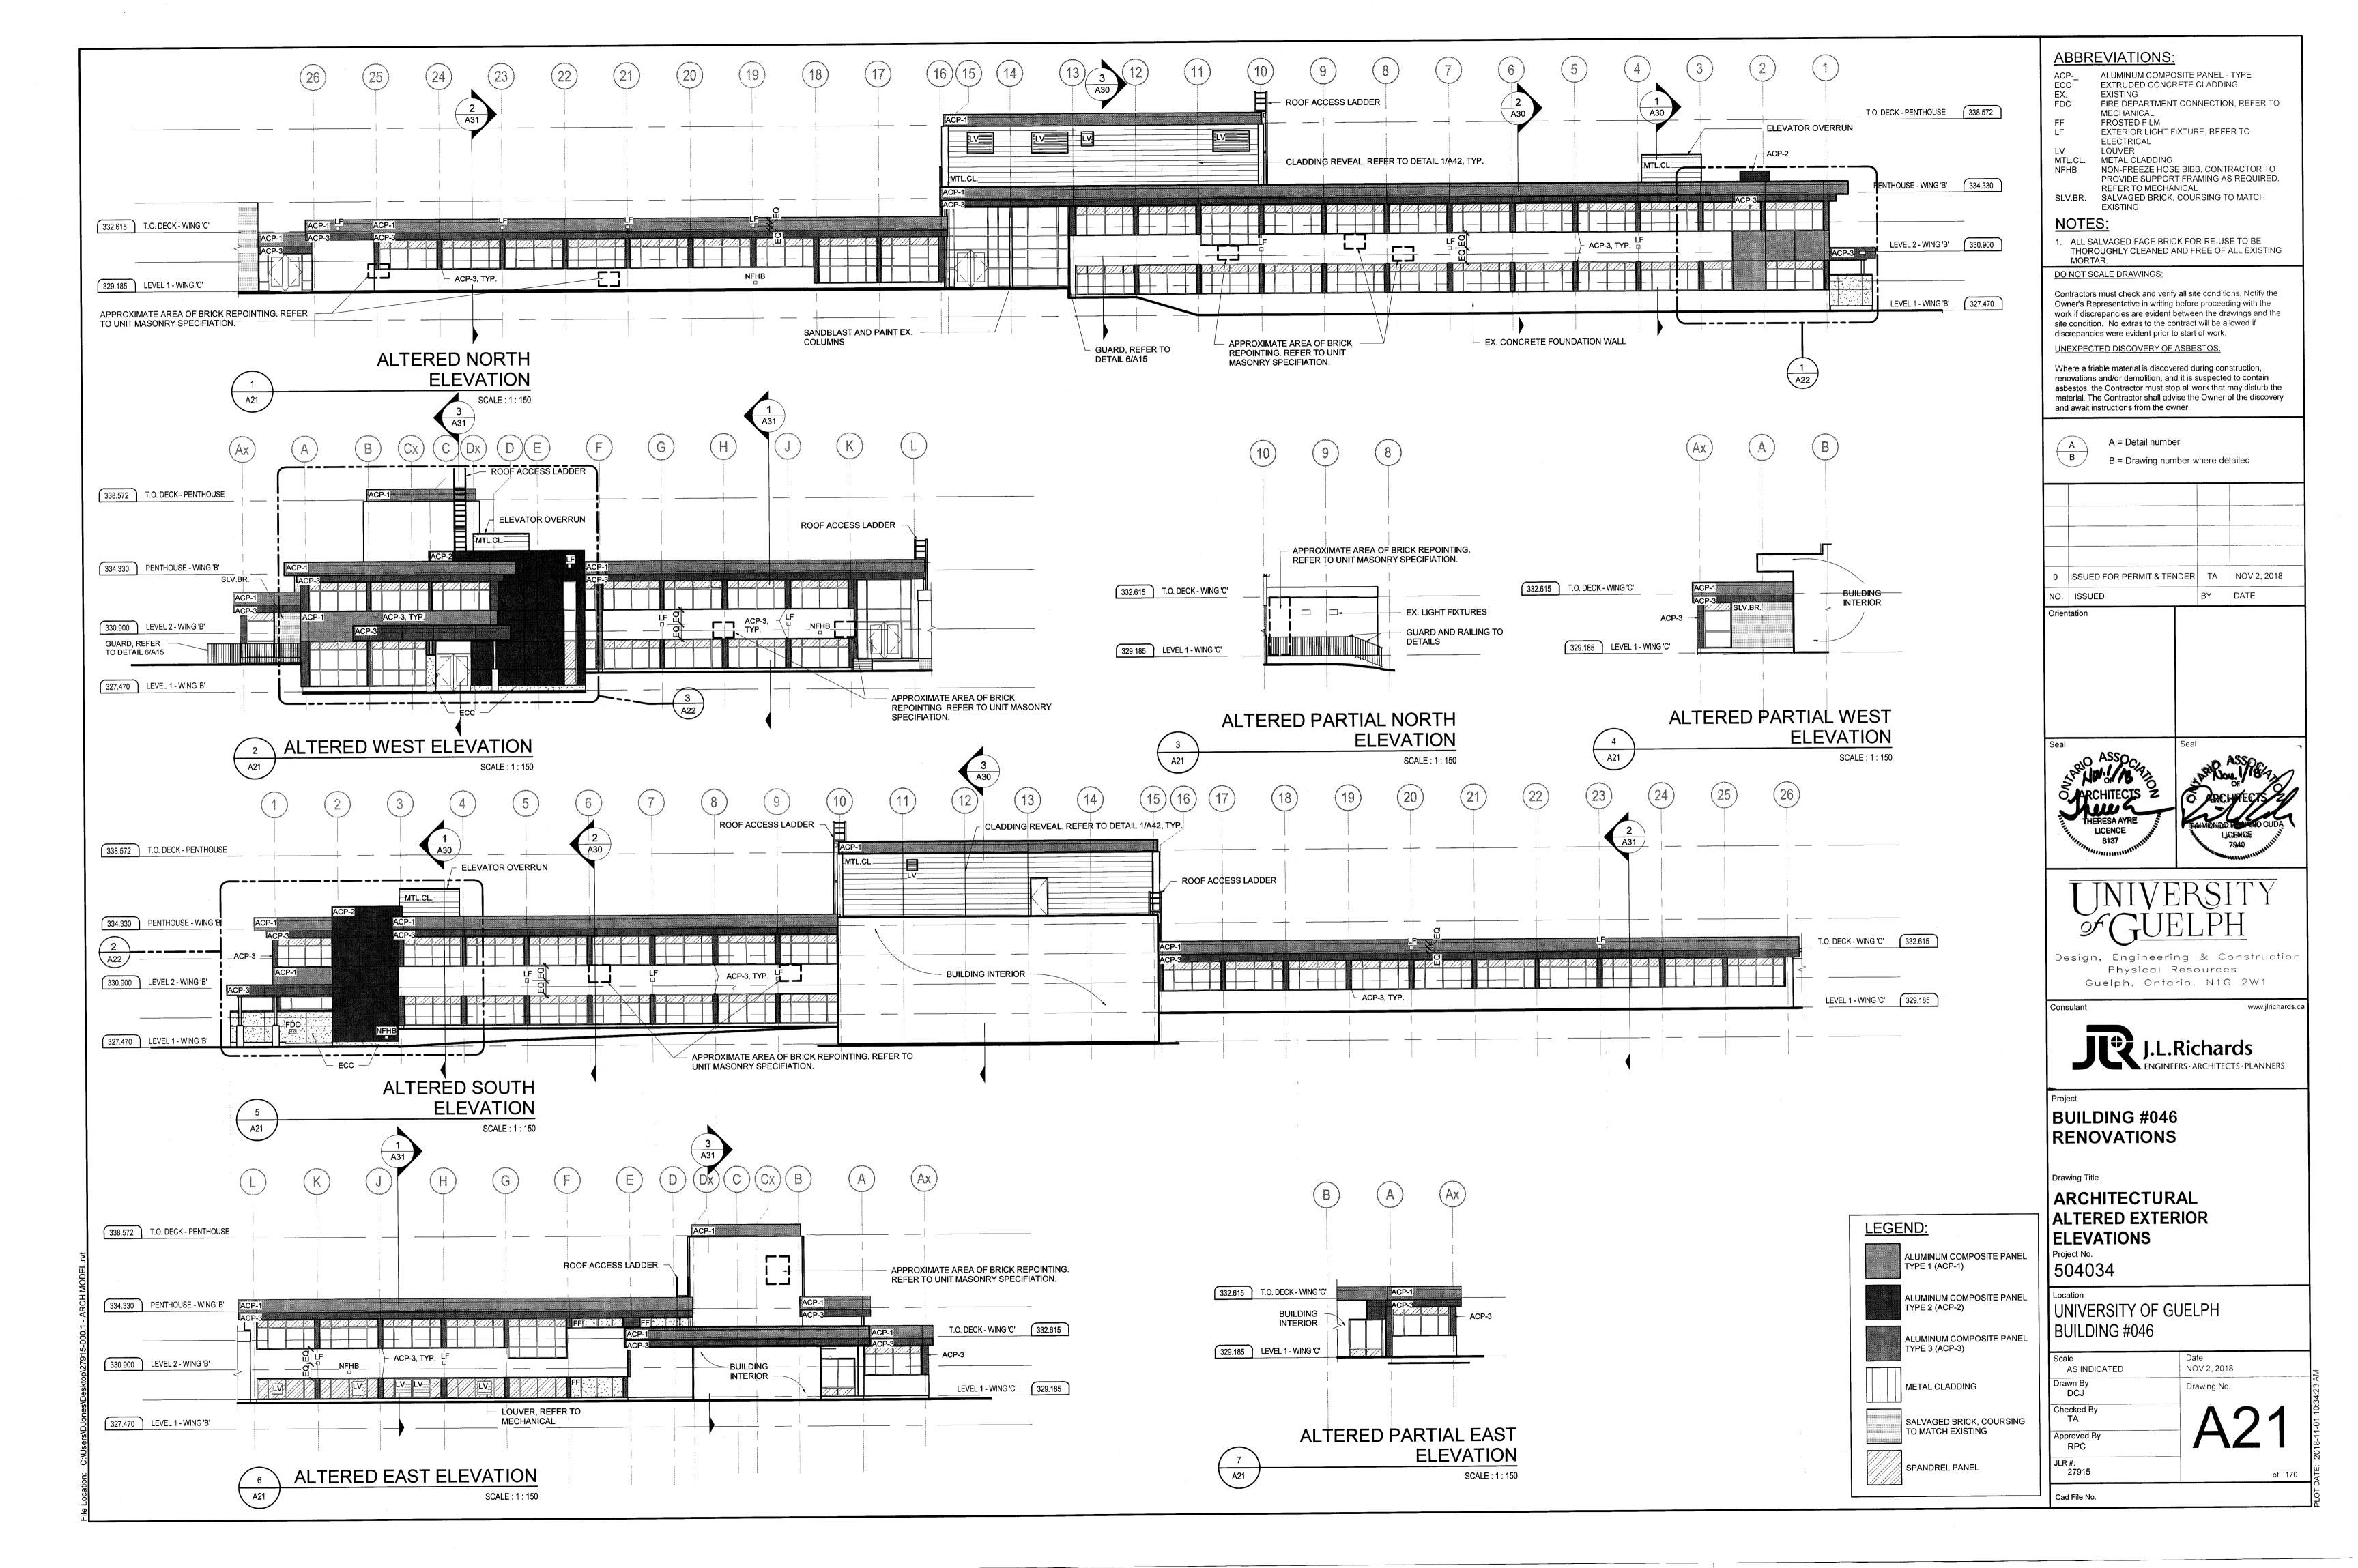
ALTERATIONS TO DIGESTER ROOM Project No.


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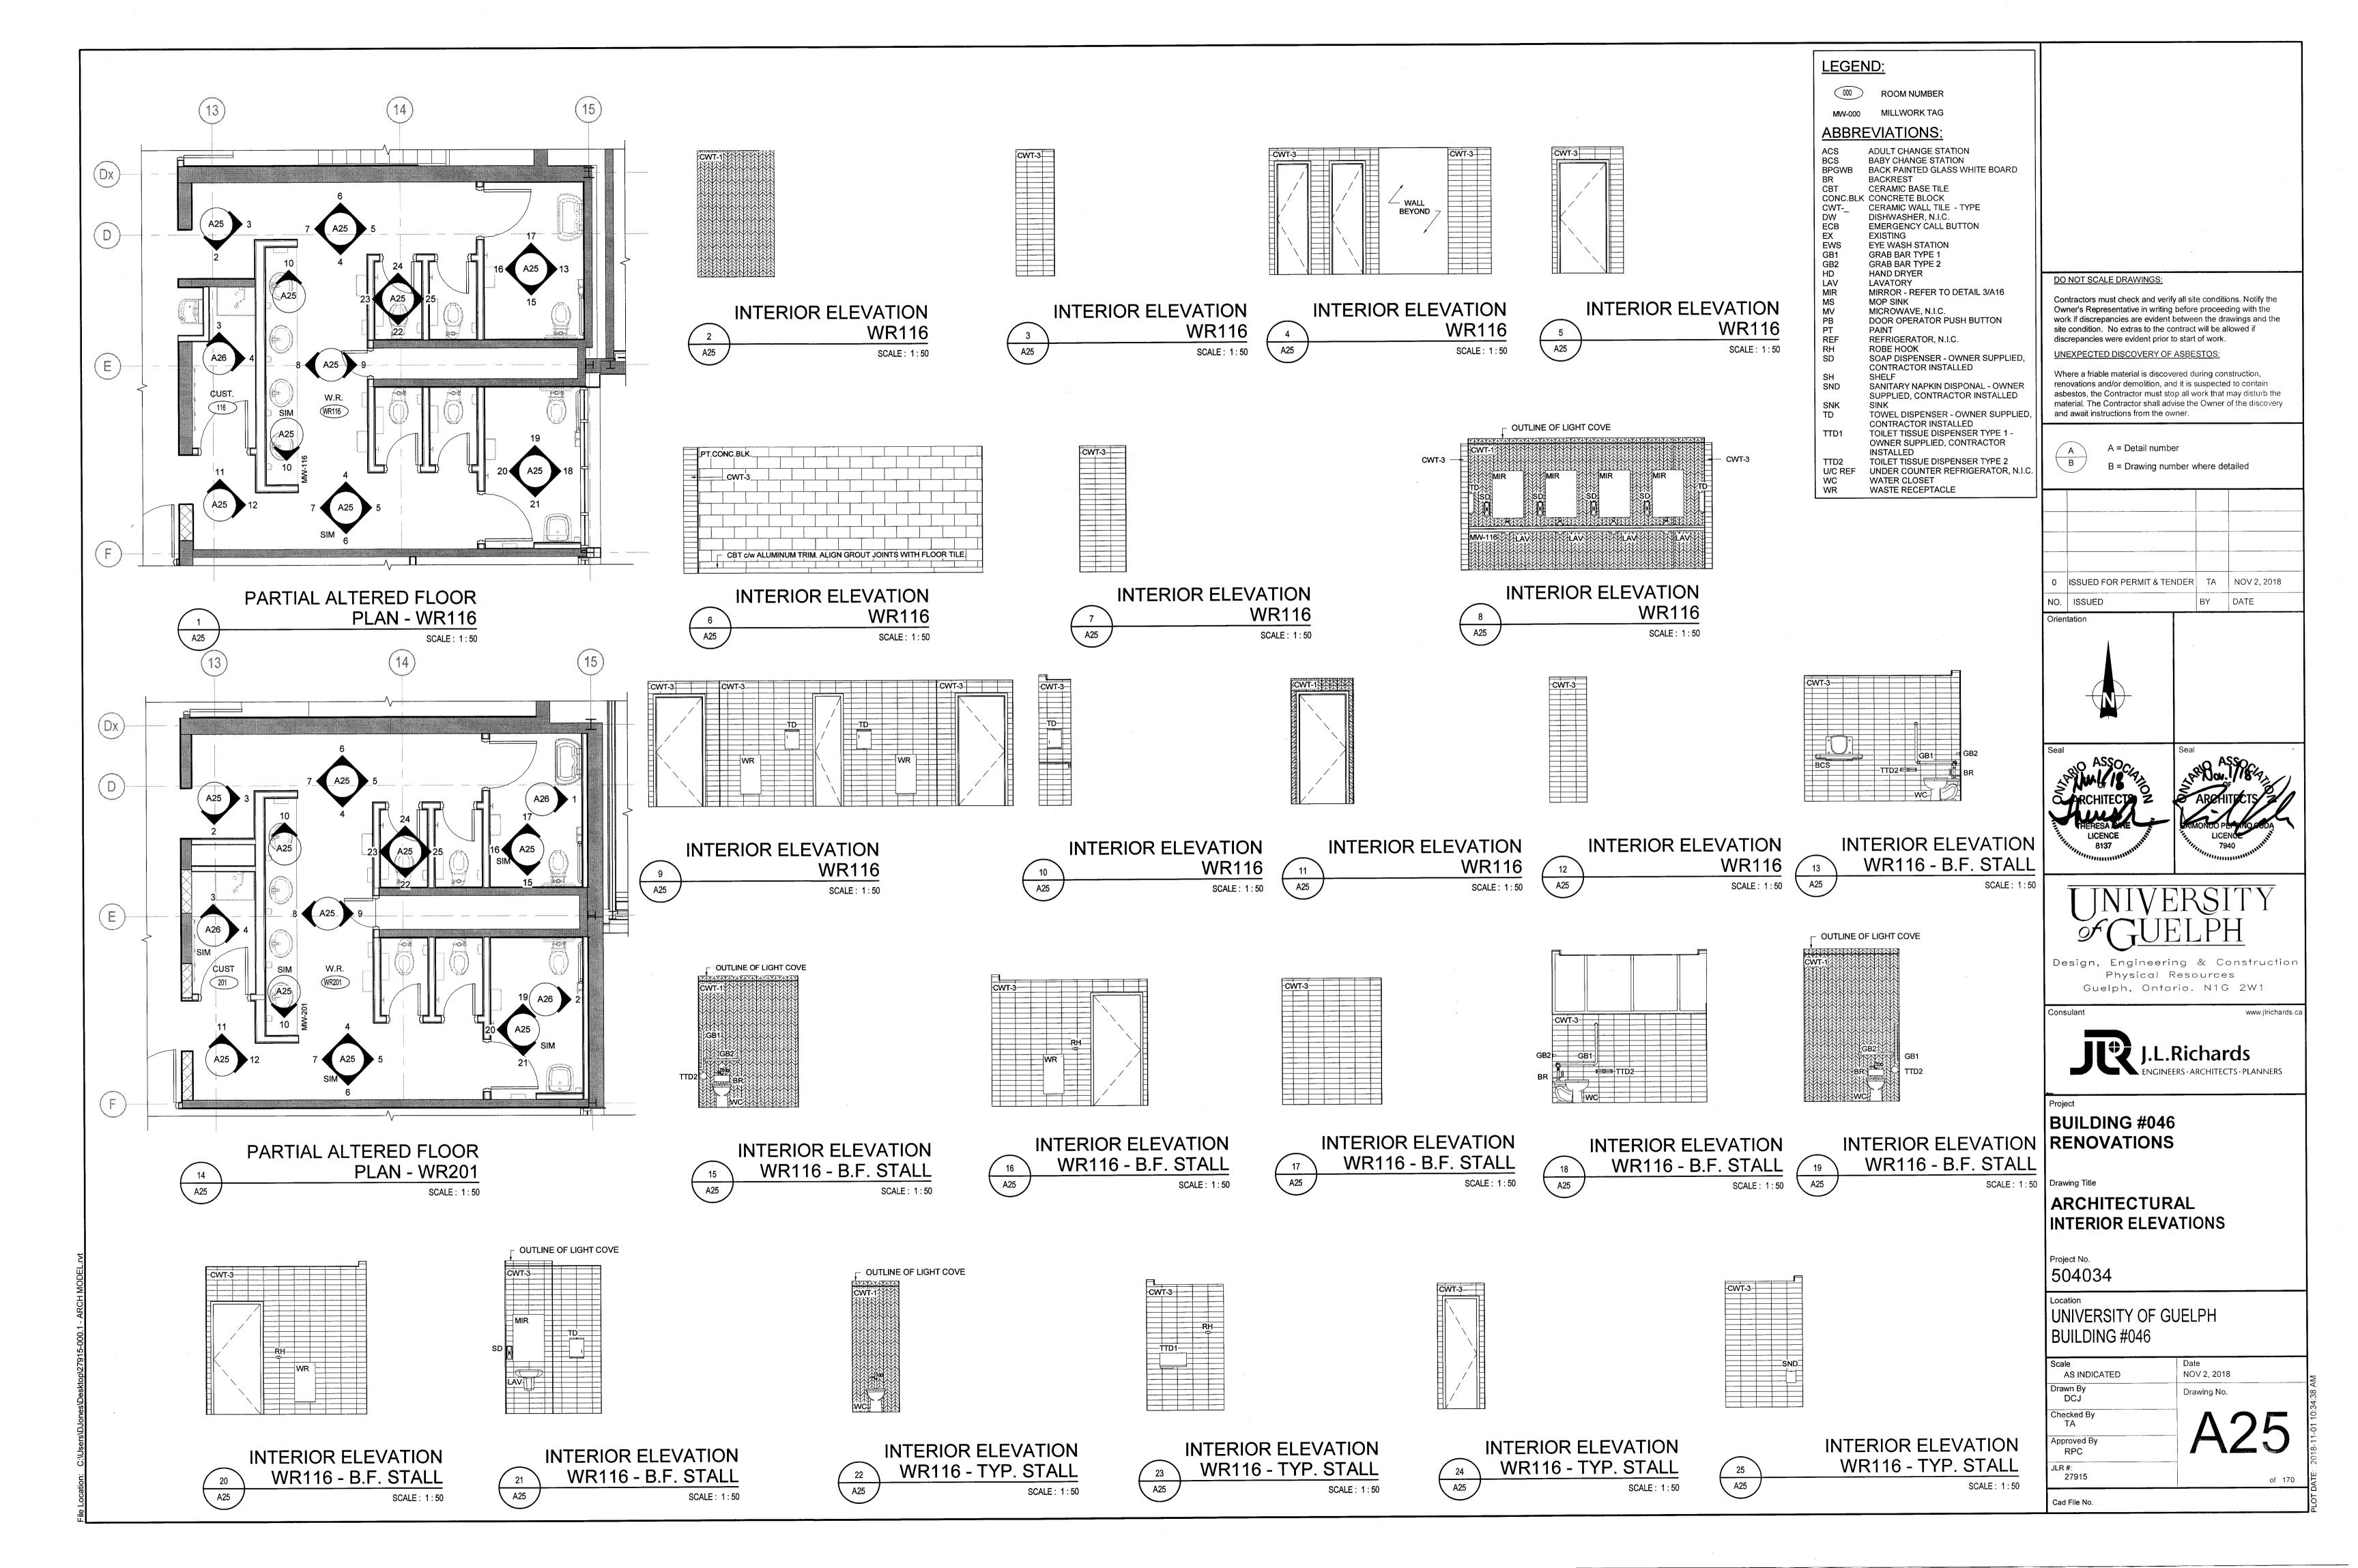
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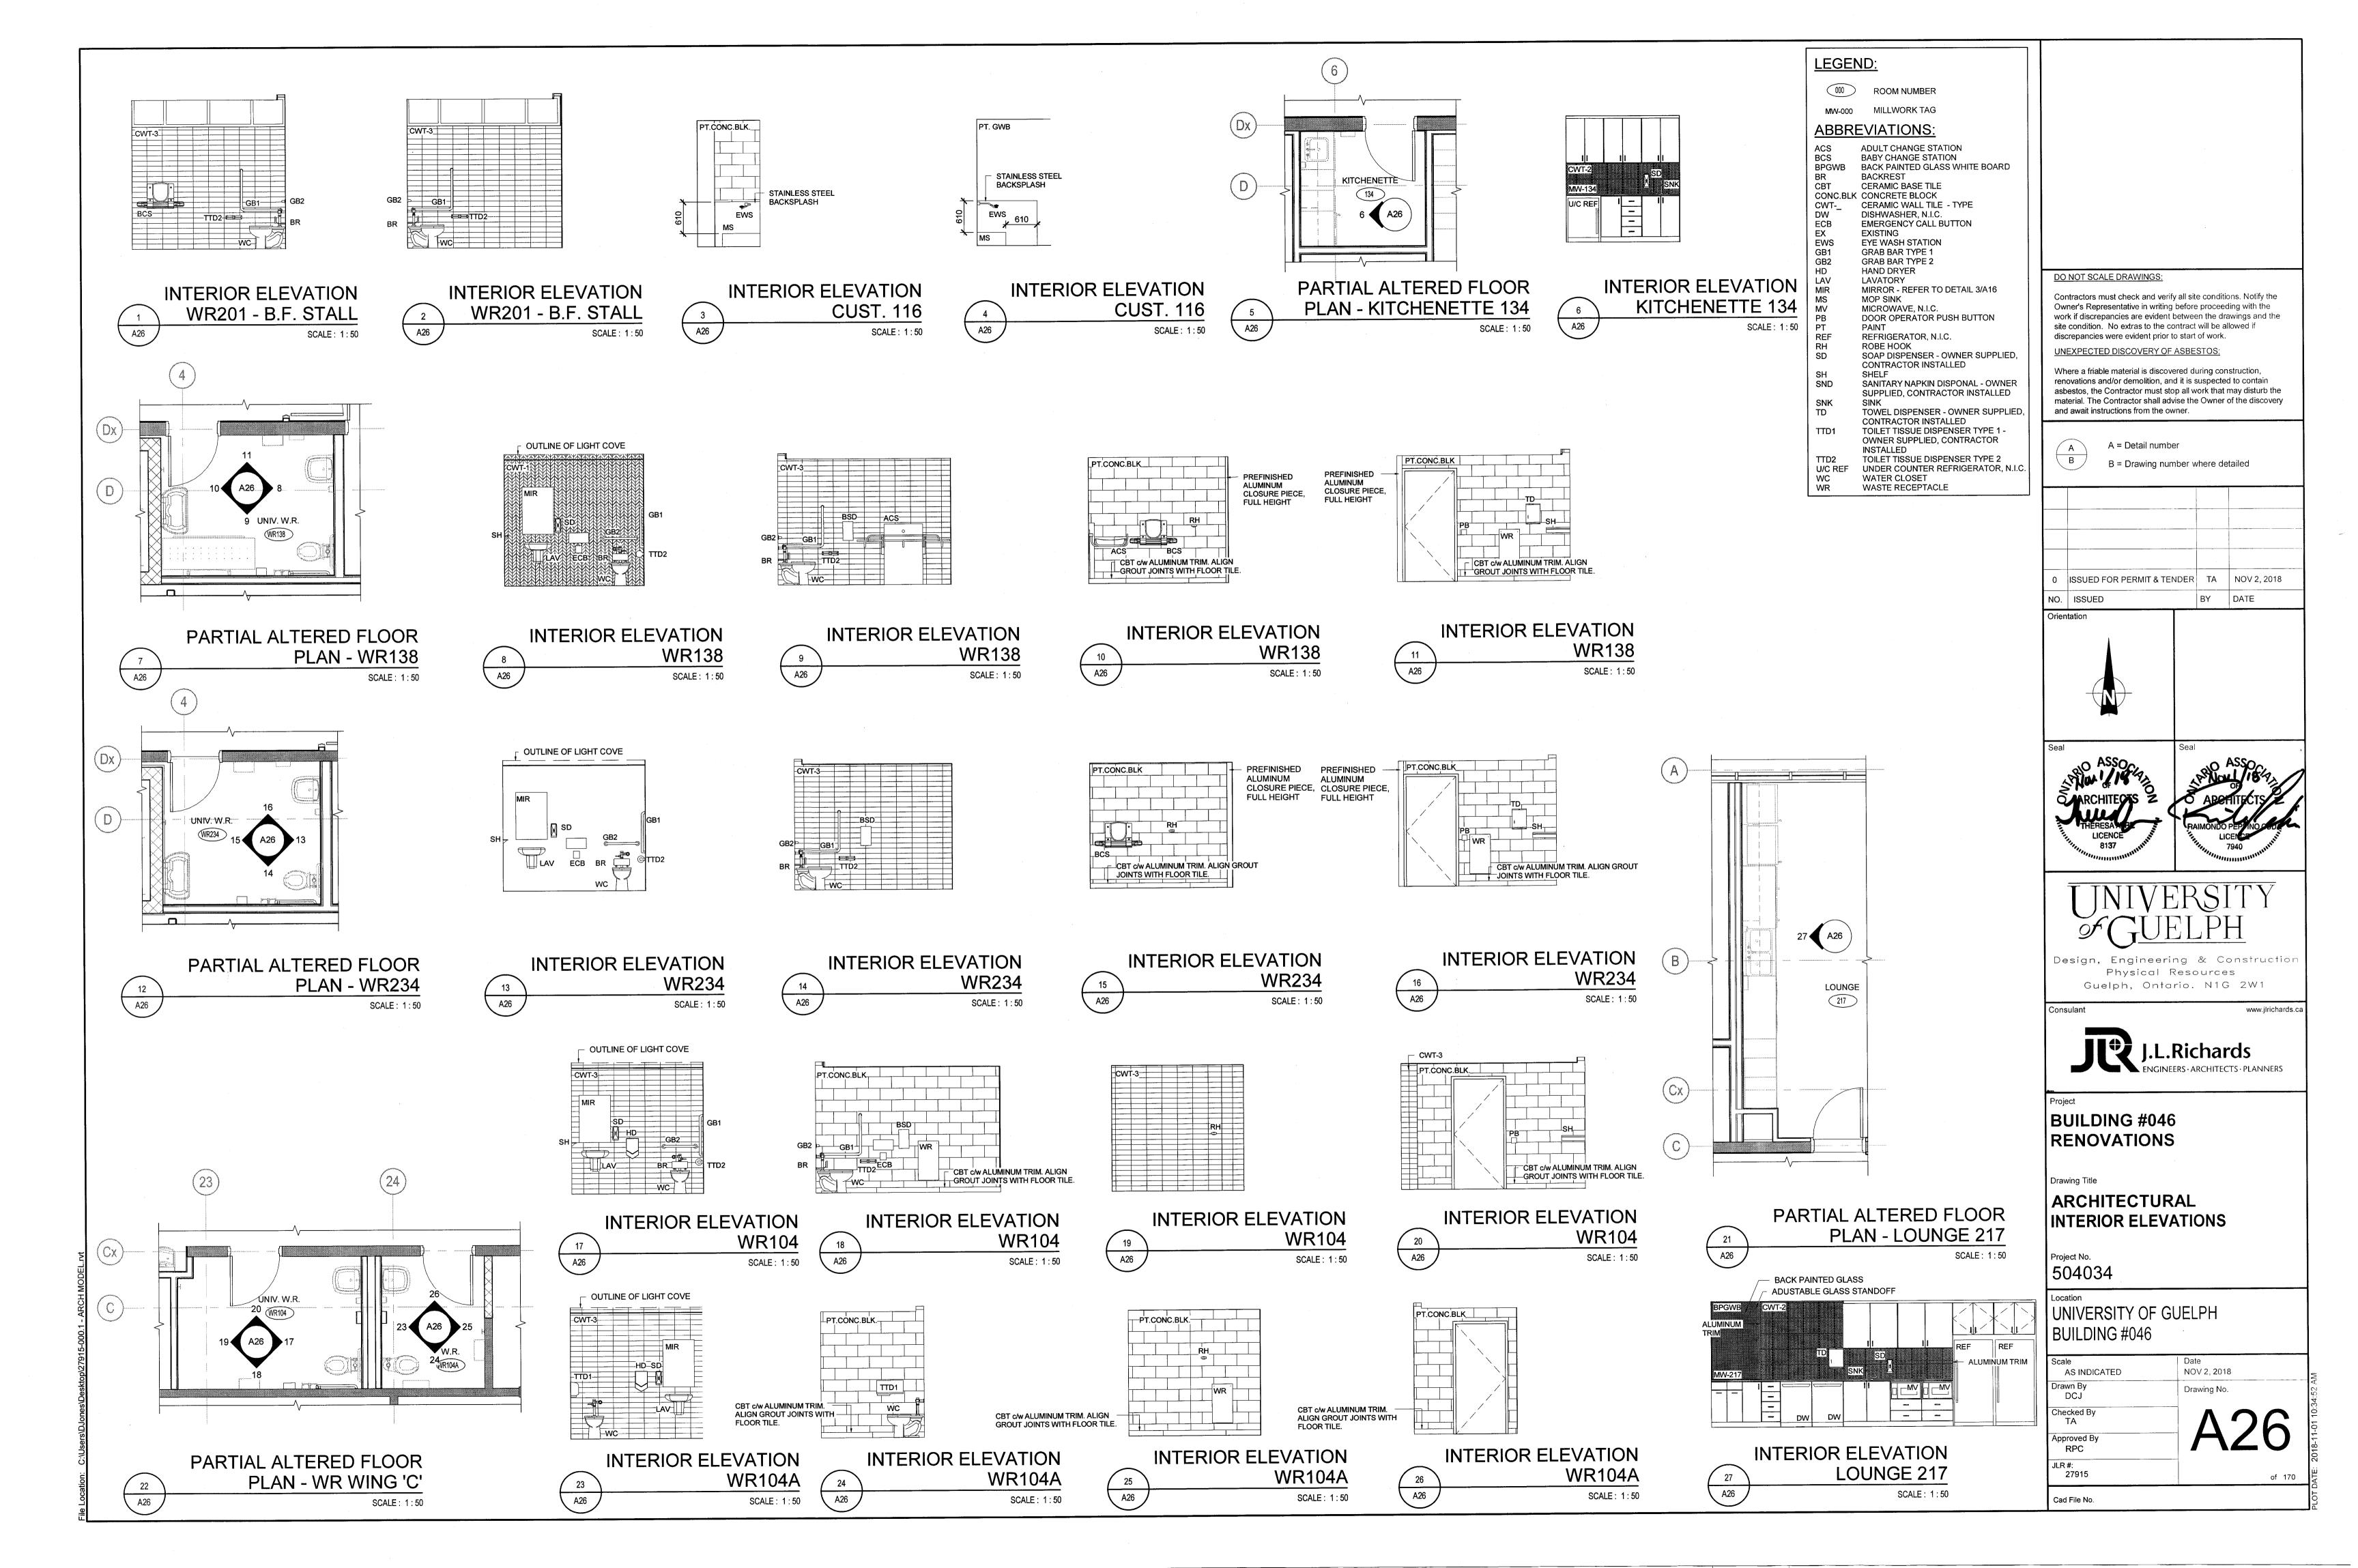
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Approved By	\boldsymbol{A}	
RPC		
JLR#		
27915		of 171
		










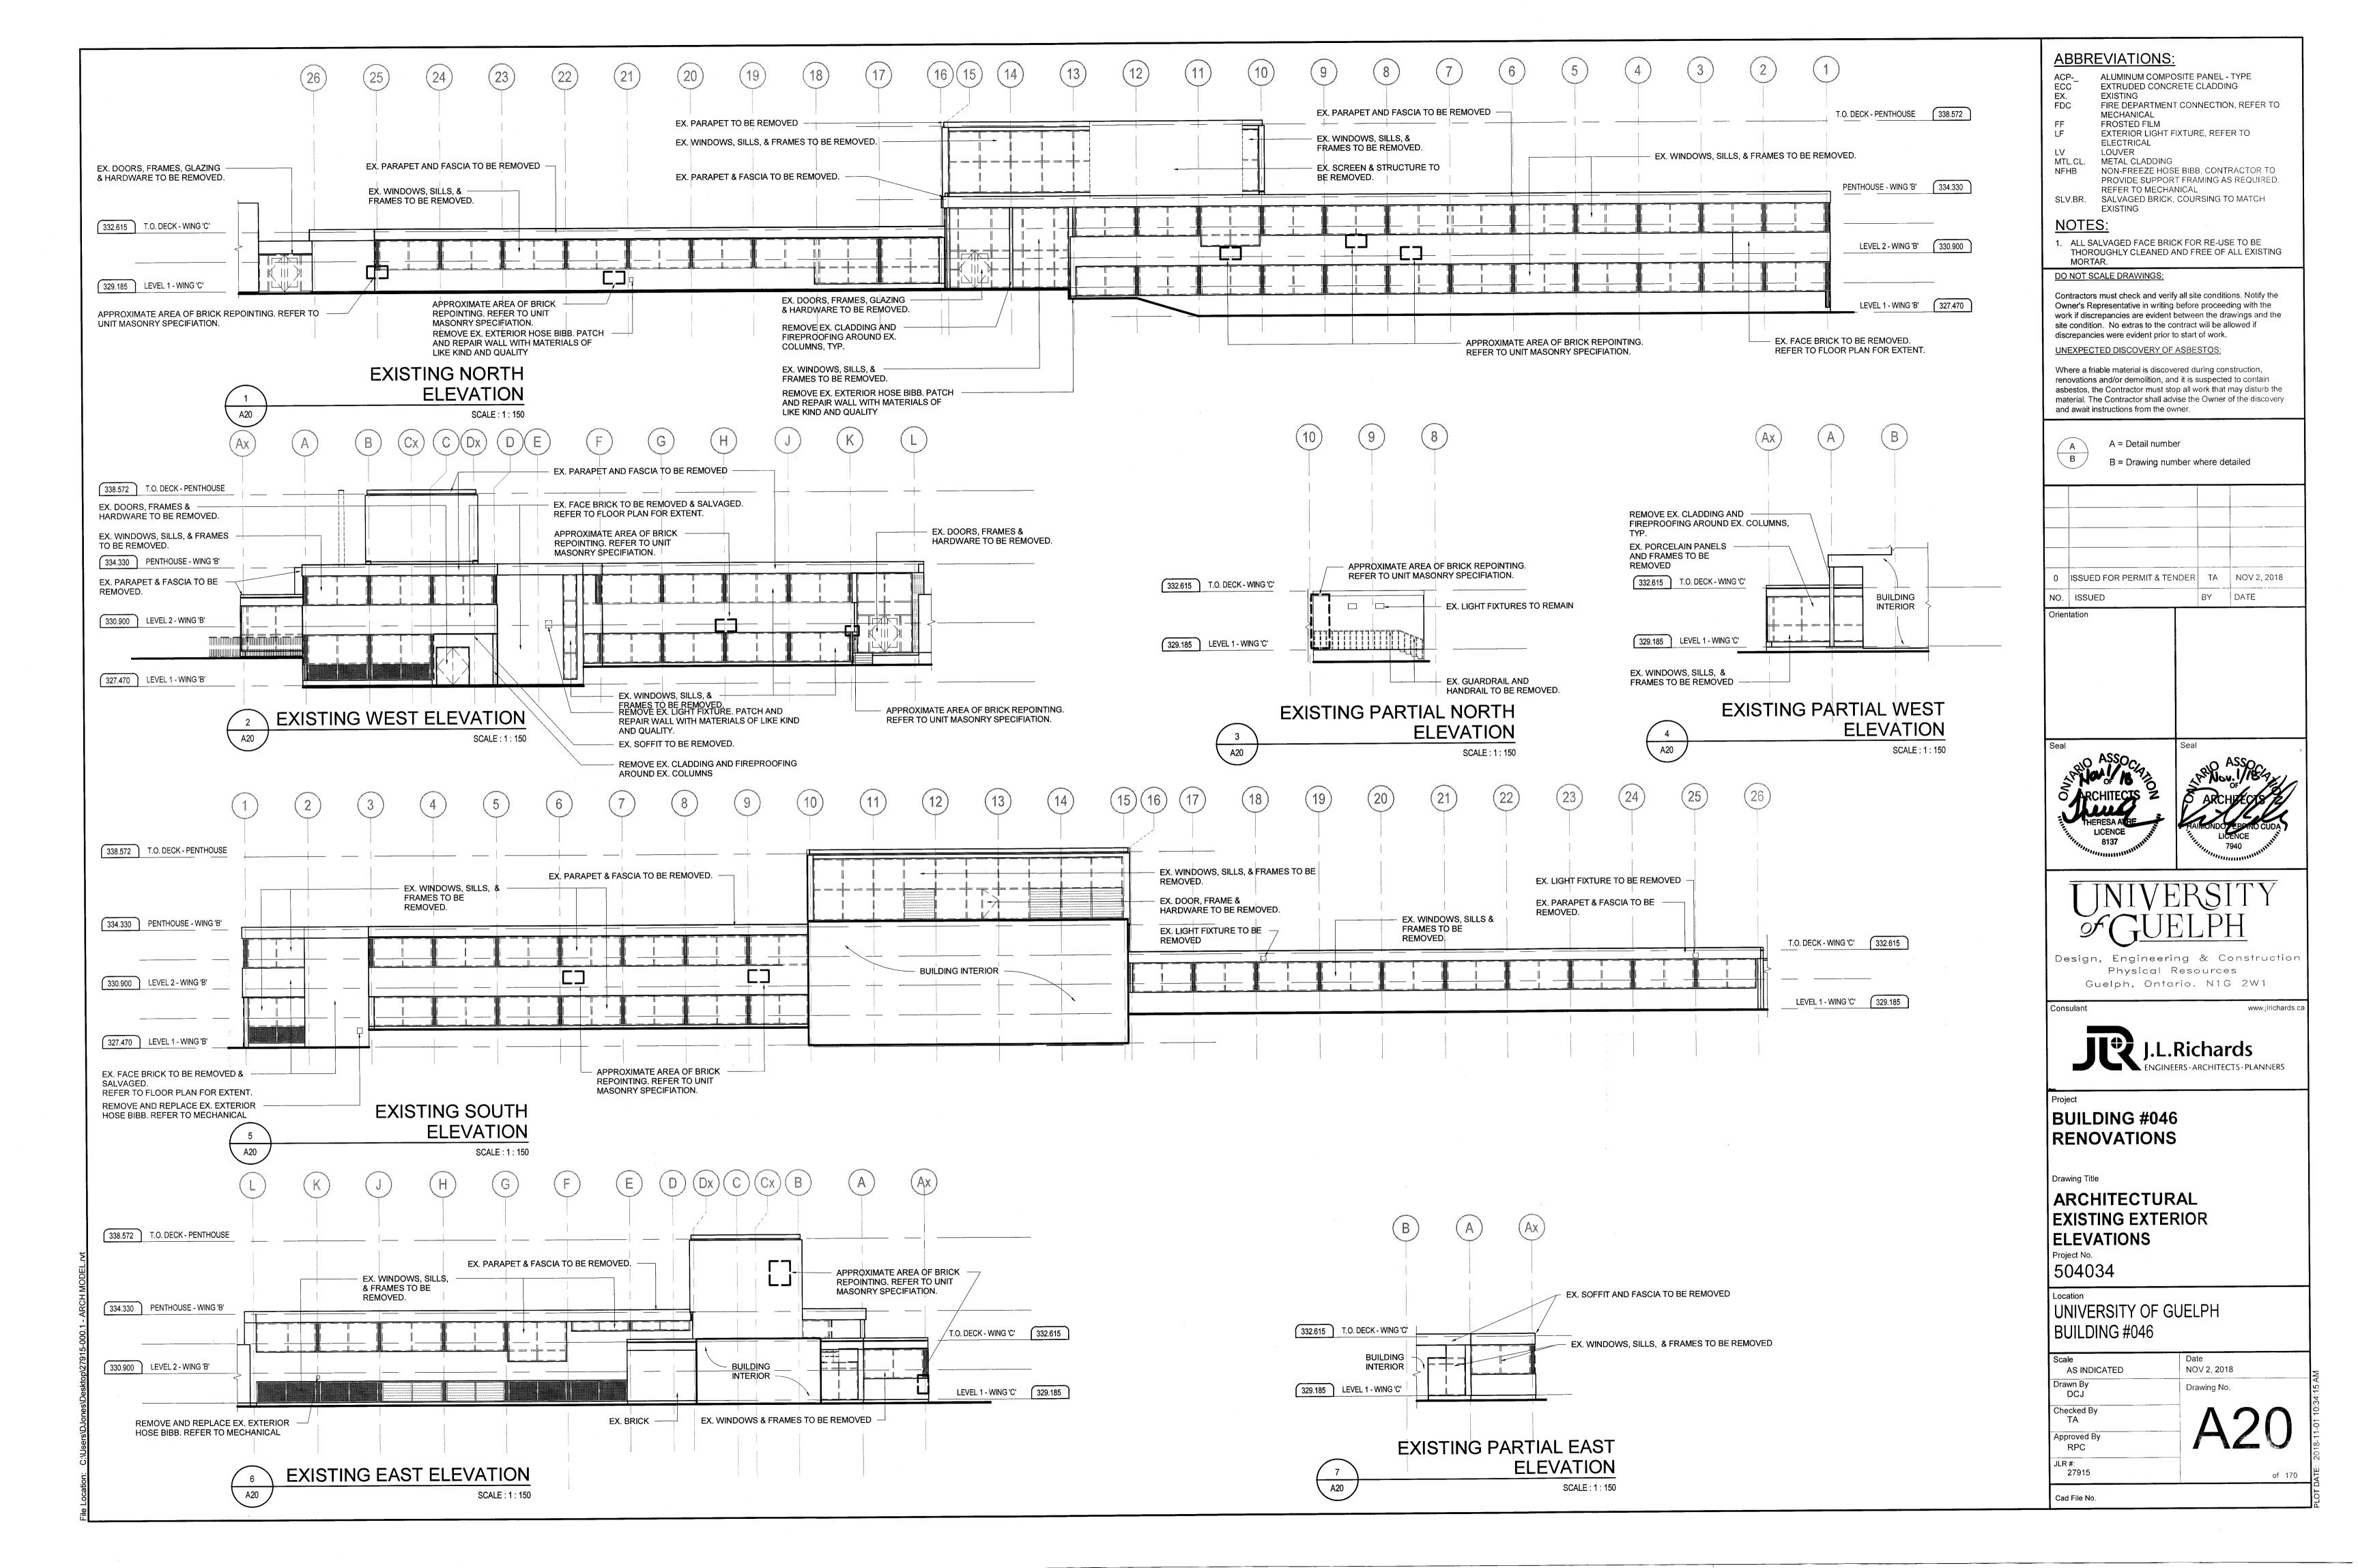


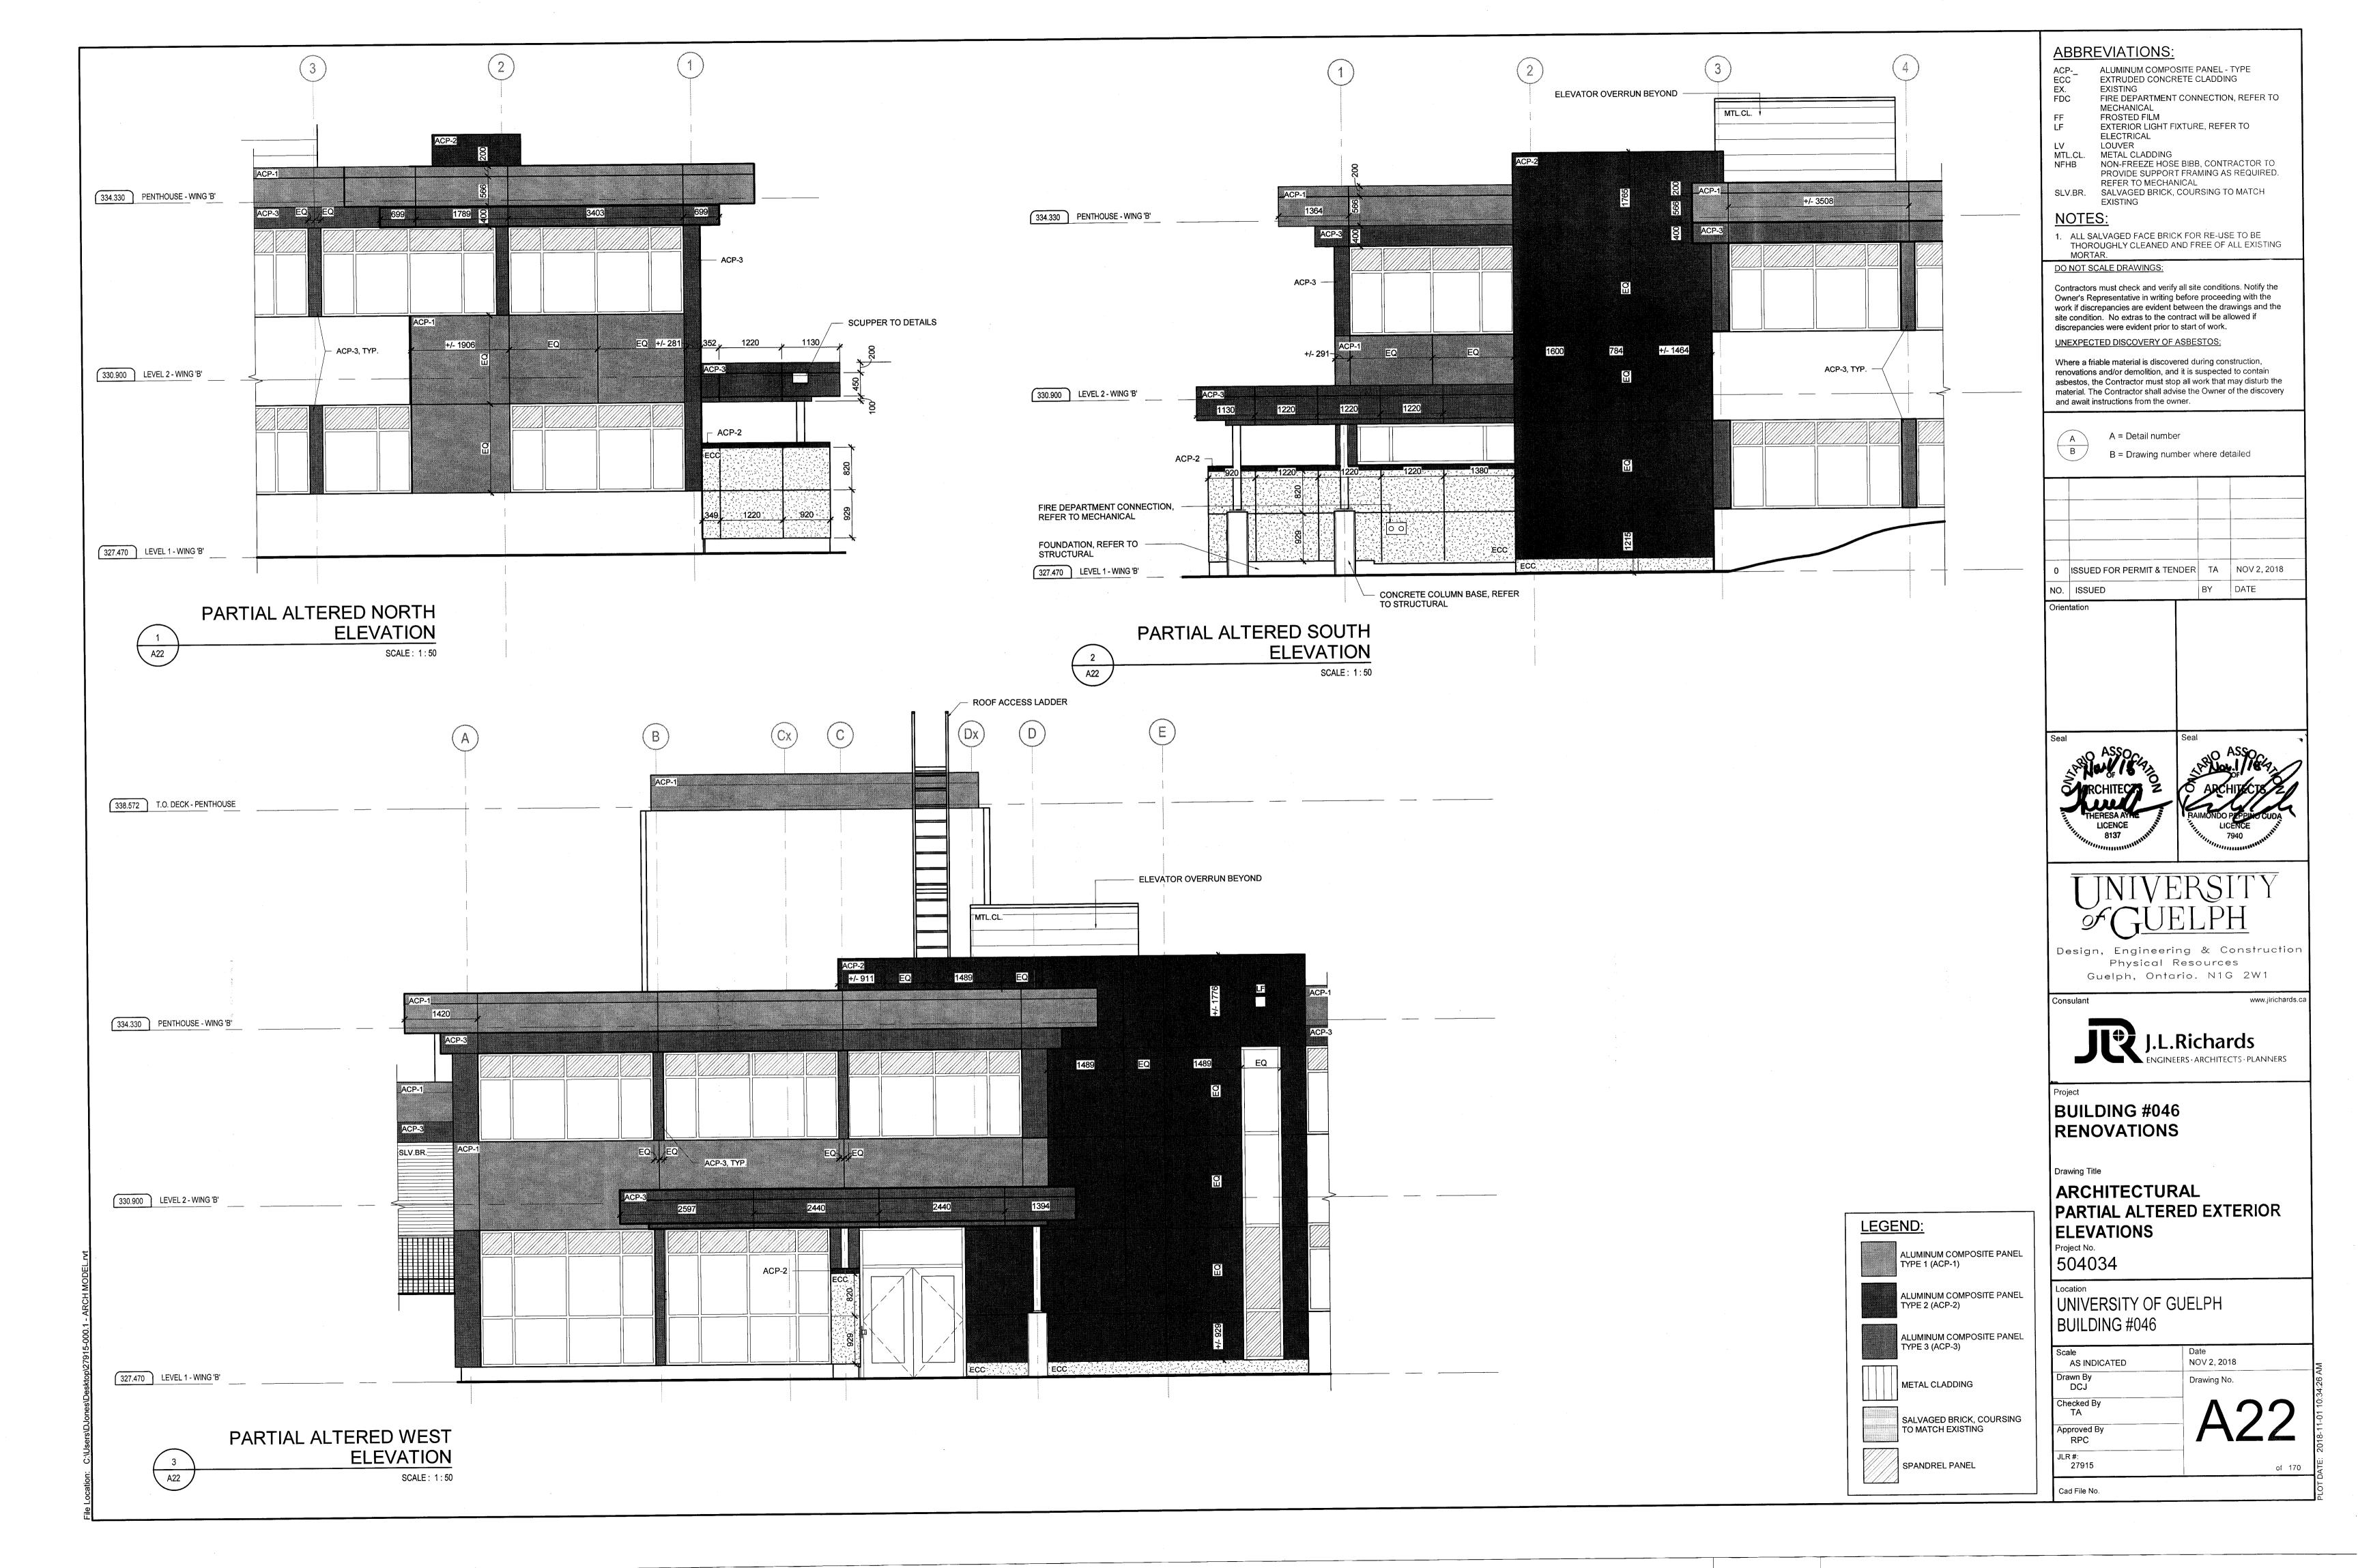

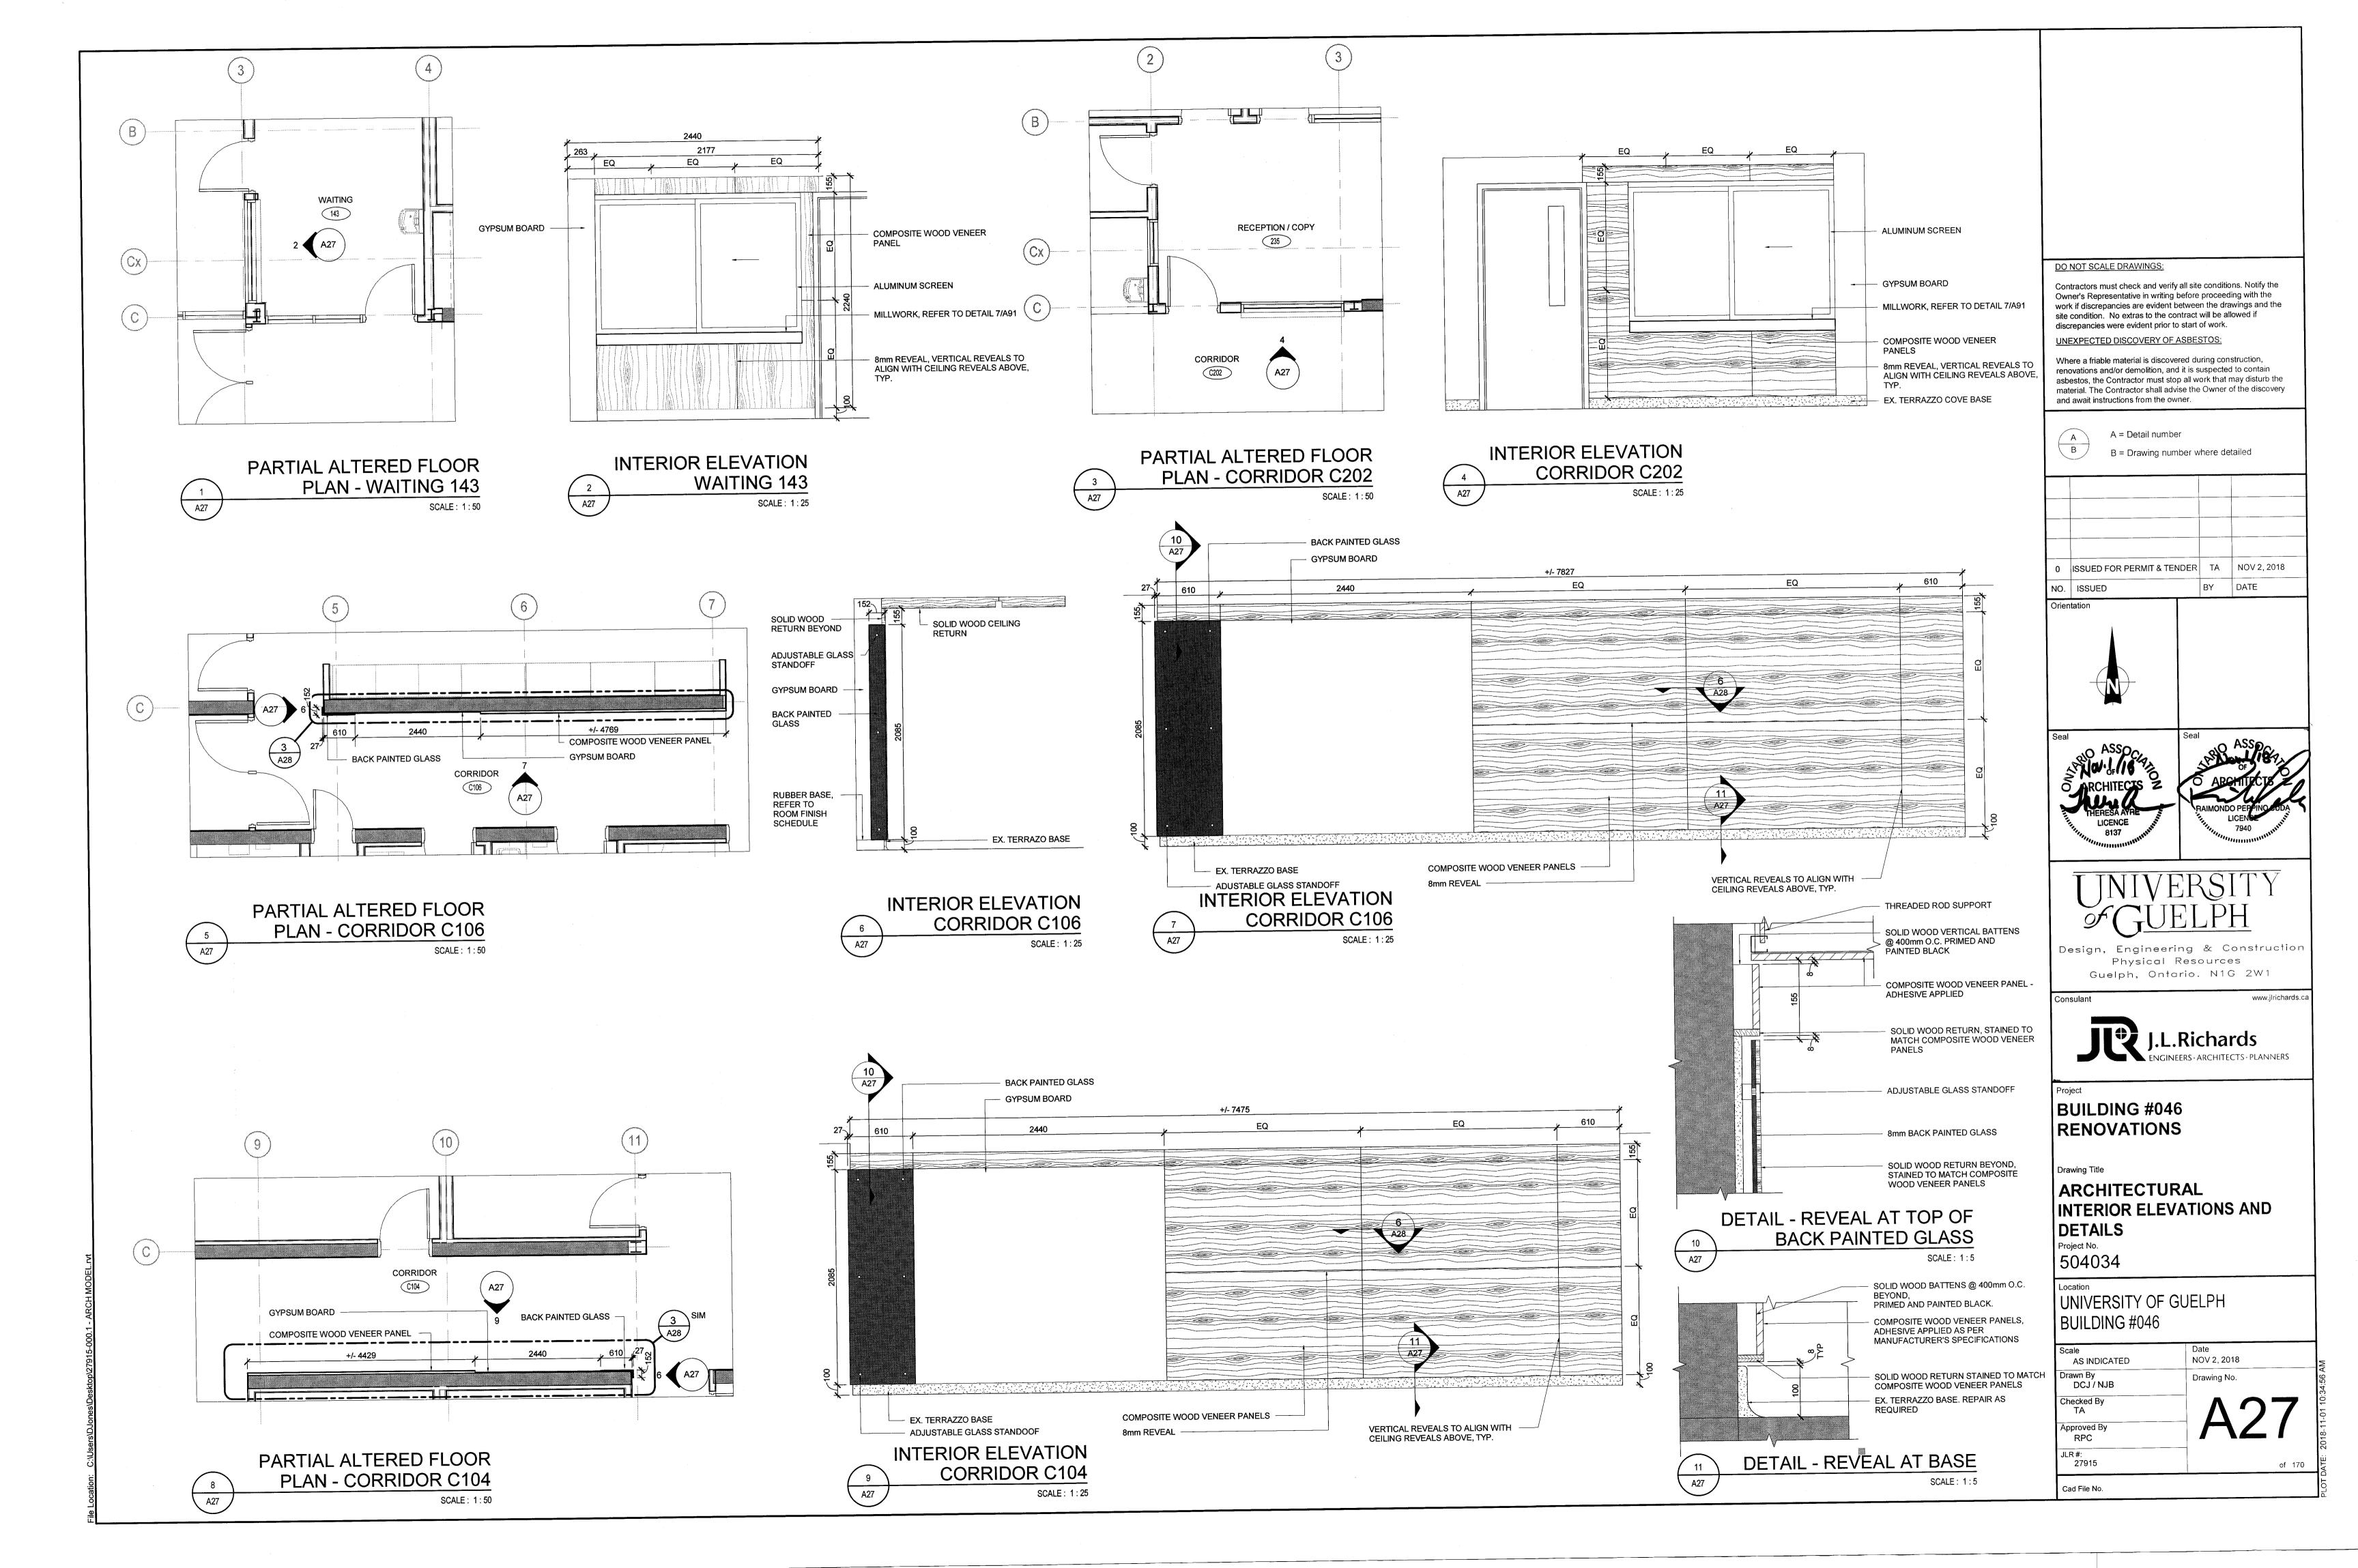

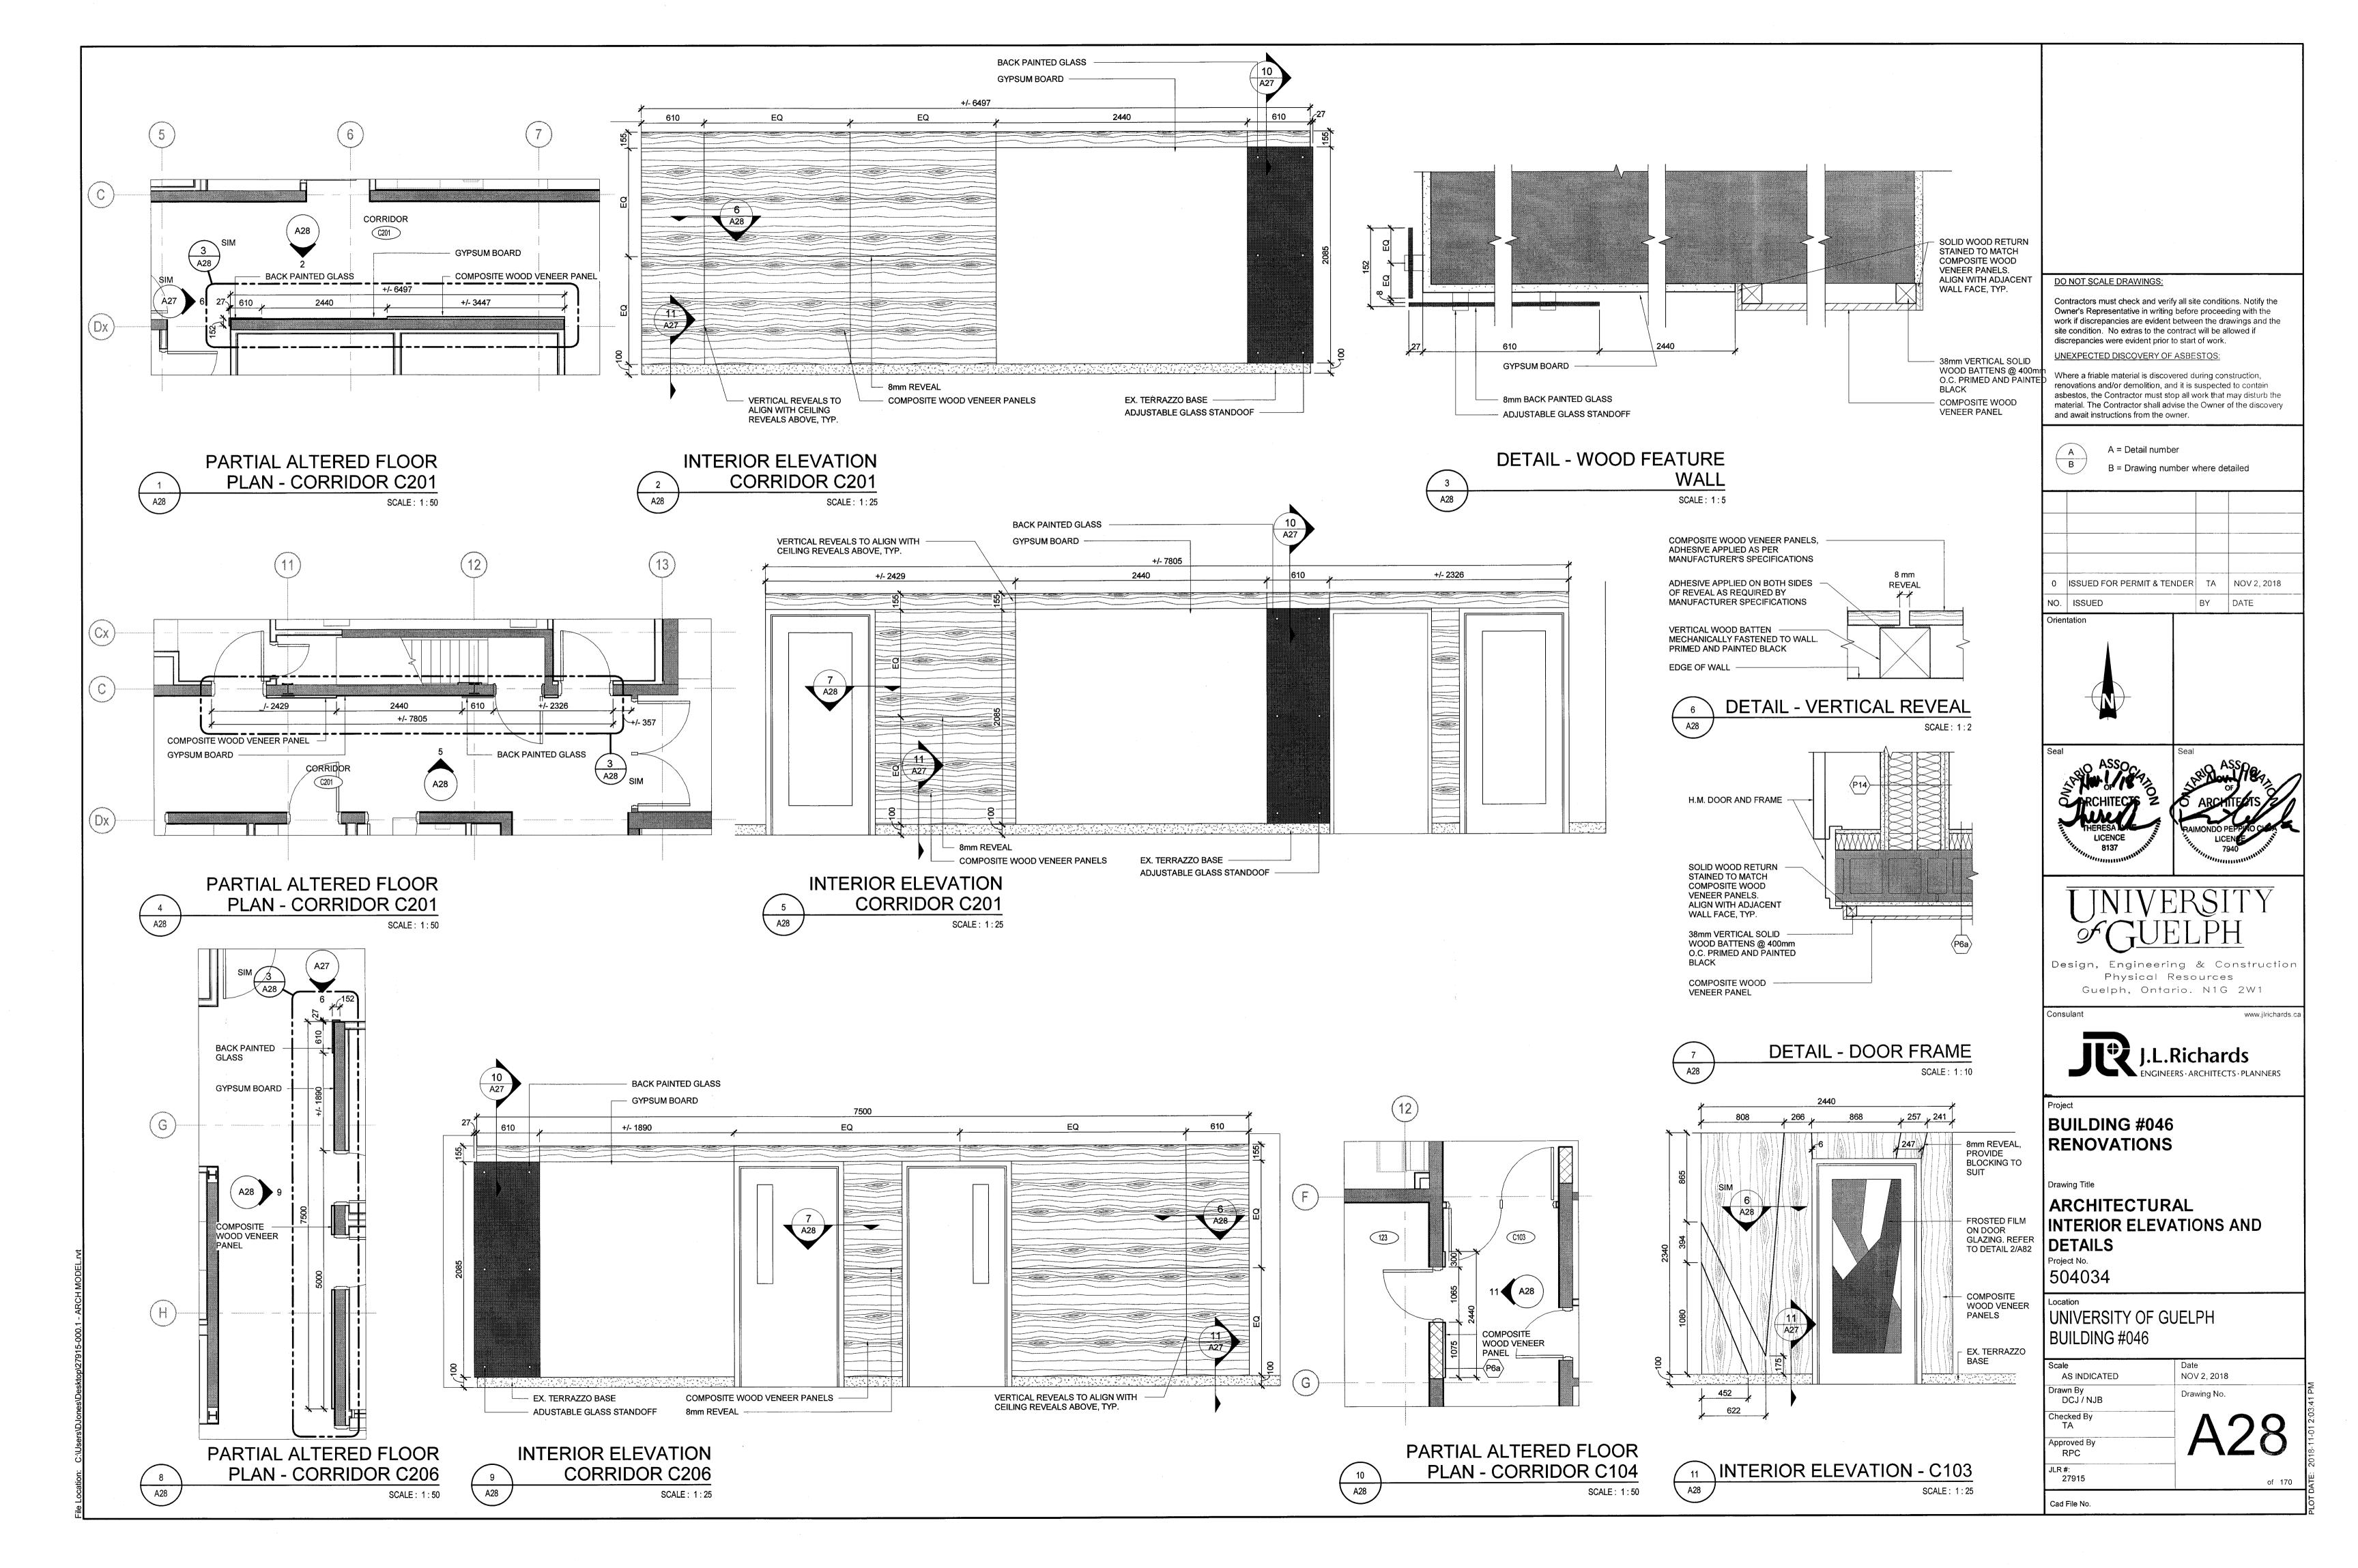

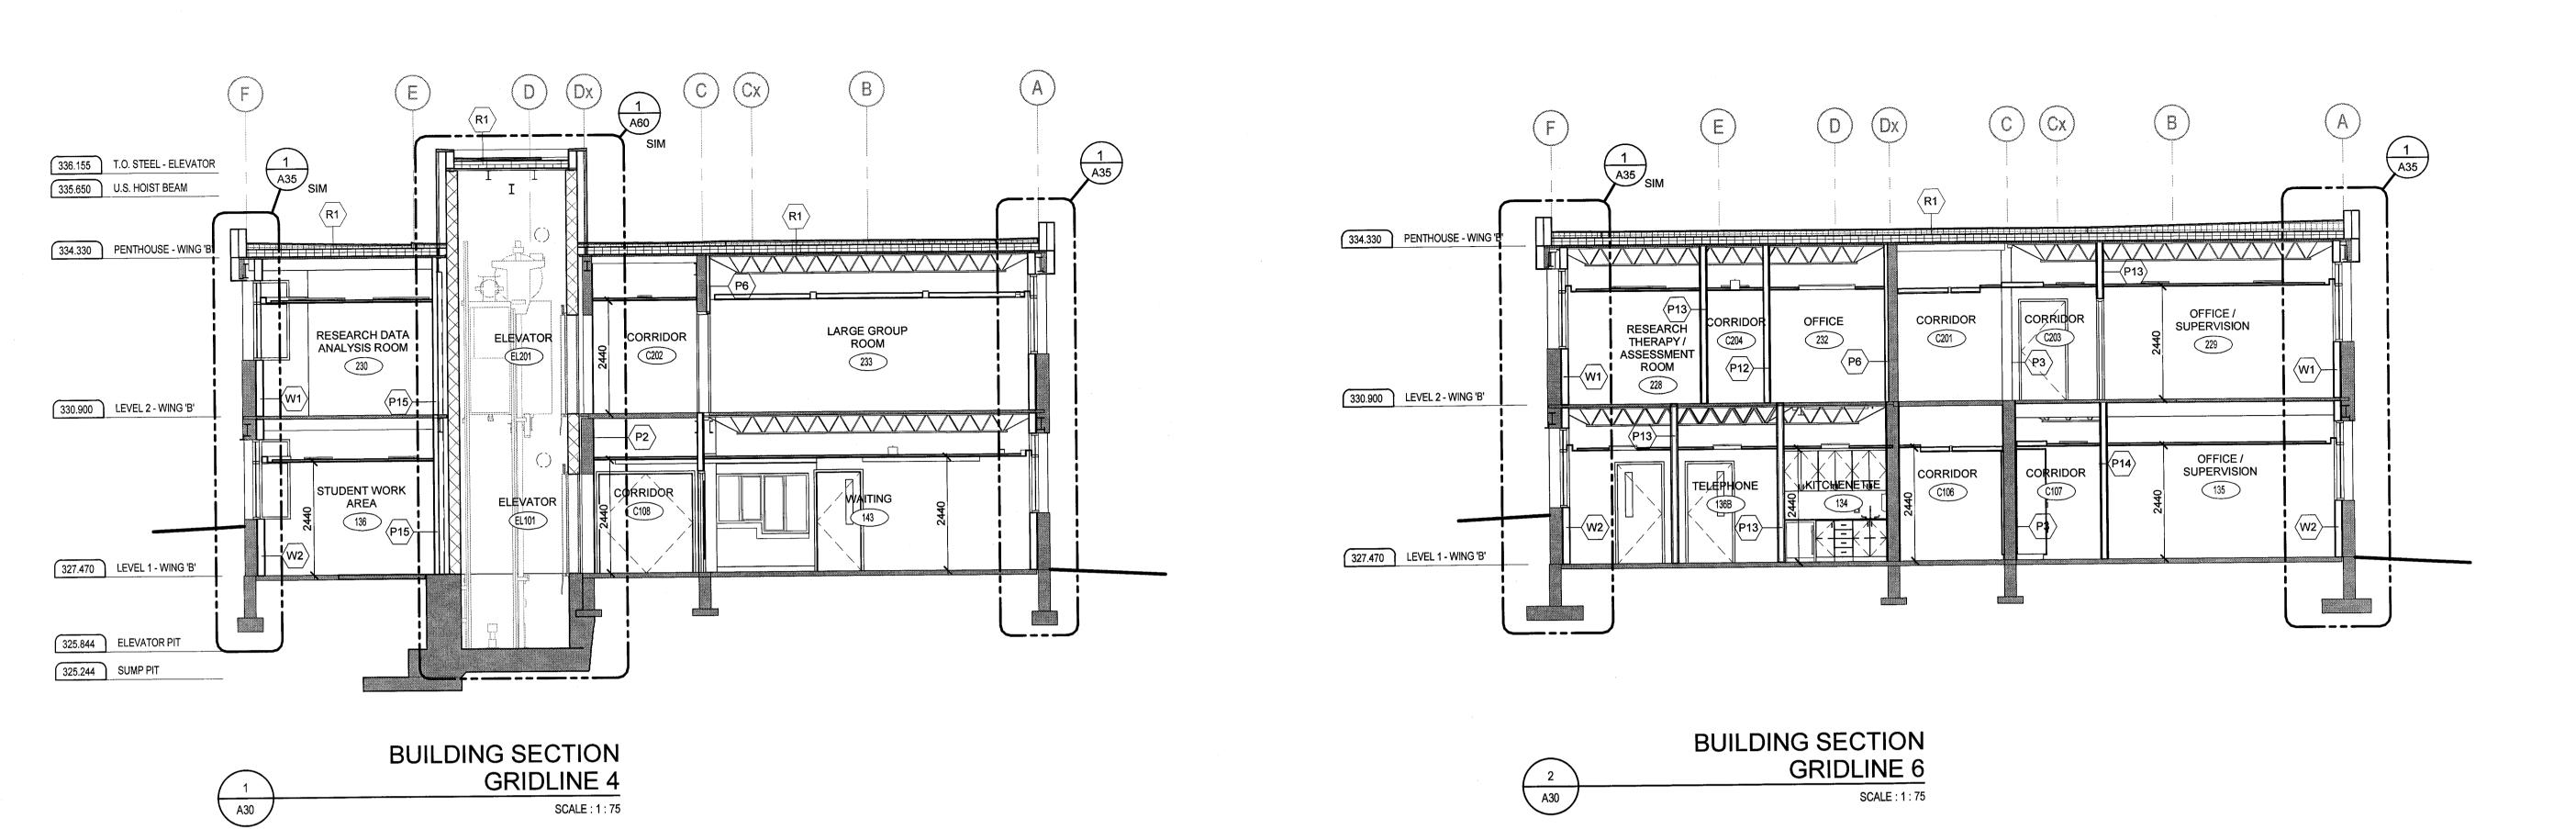

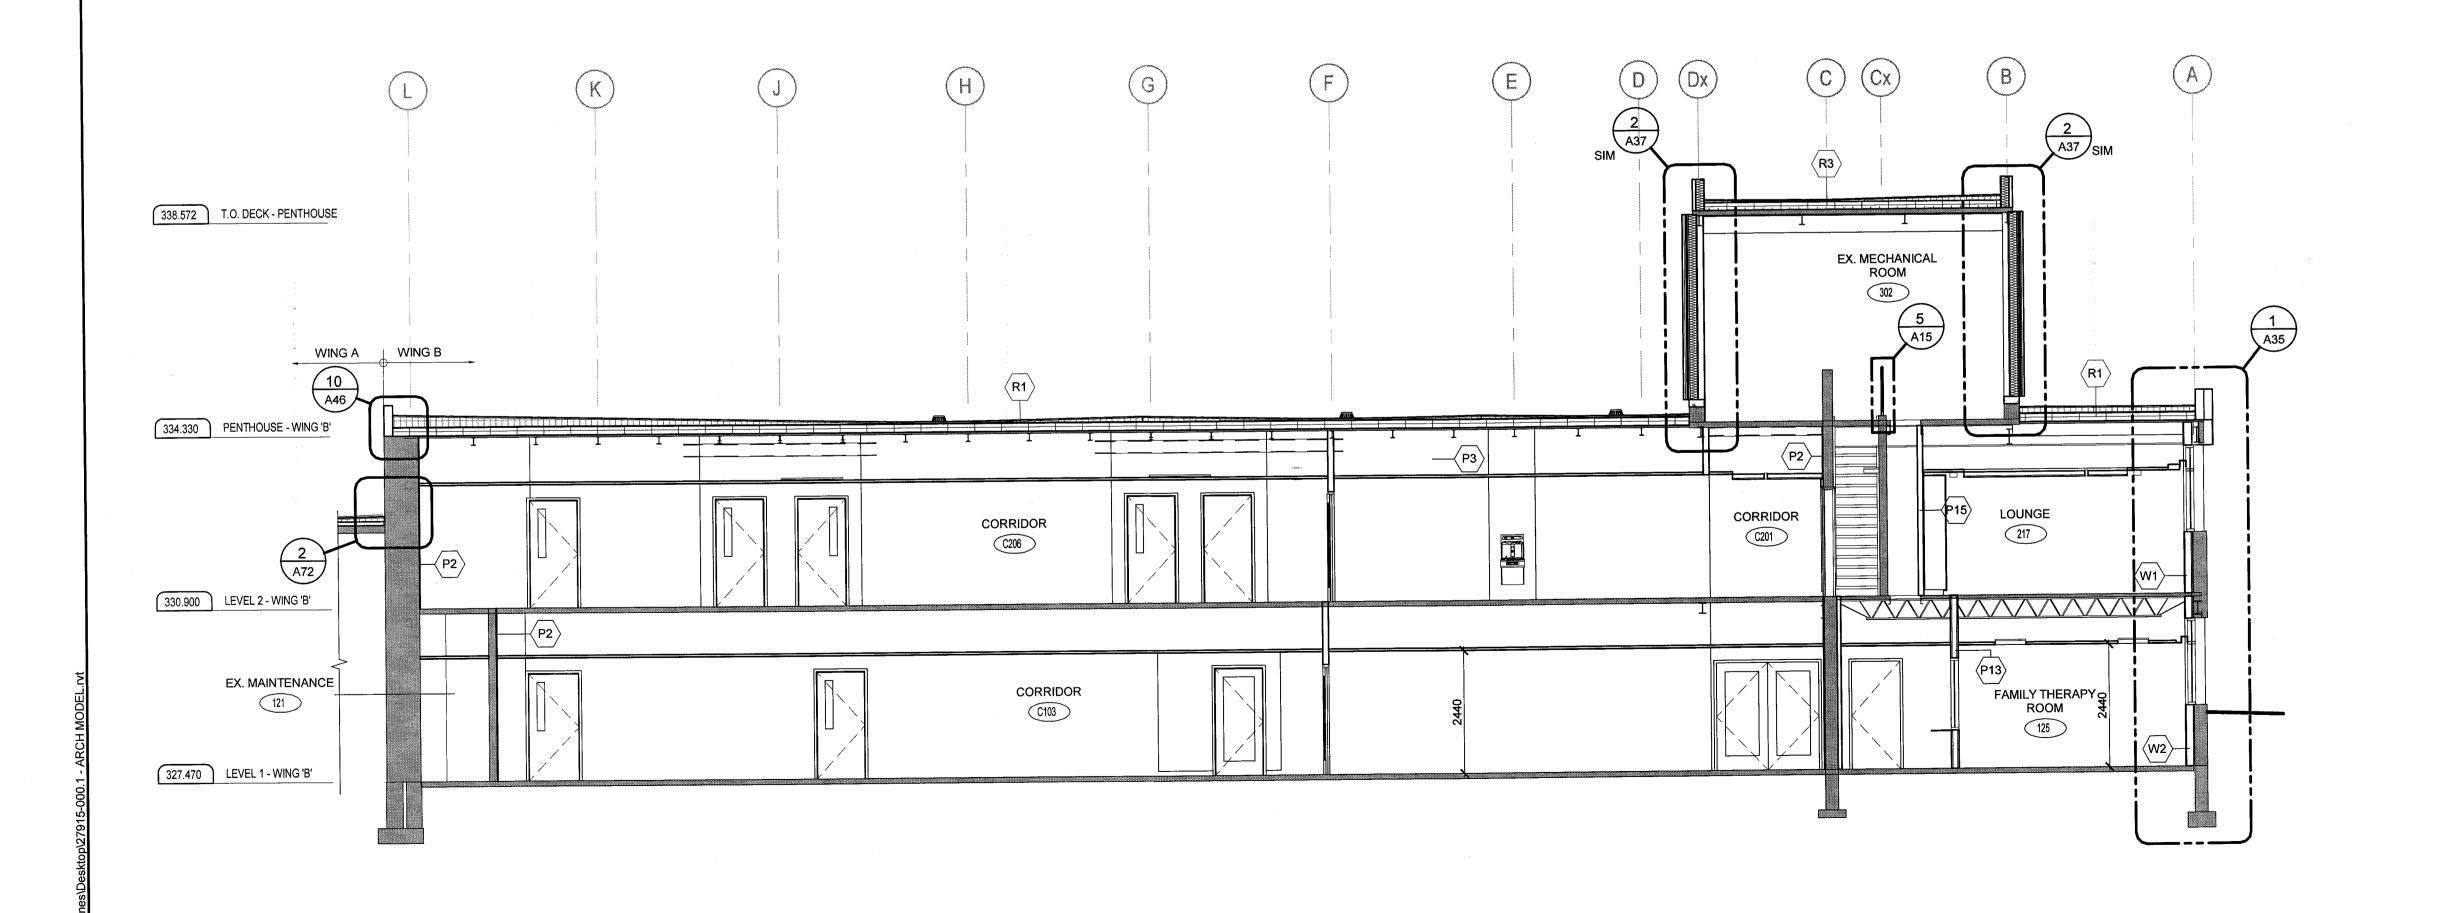


BUILDING SECTION

A30

GRIDLINE 12

SCALE: 1:75

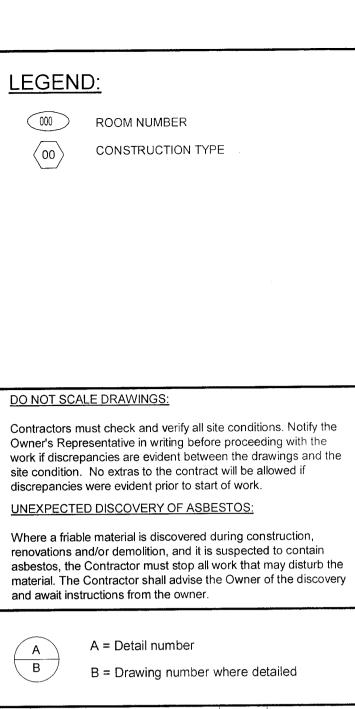

A = Detail number
B = Drawing number where detailed

O ISSUED FOR PERMIT & TENDER TA NOV 2, 2018

NO. ISSUED

Orientation

ASSOCIATION OF ASSOCIATION OF ASSOCIATION OF ARCHITECTS ARCHITECTS

UNIVERSITY of GUELPH

Design, Engineering & Construction
Physical Resources
Guelph, Ontario. N1G 2W1

Consulant


J.L.Richards


BUILDING #046 RENOVATIONS

ARCHITECTURAL
BUILDING SECTIONS

Project No. 504034


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Checked By TA	V 3 ()
Approved By RPC	AJU
JLR #: 27915	of 170

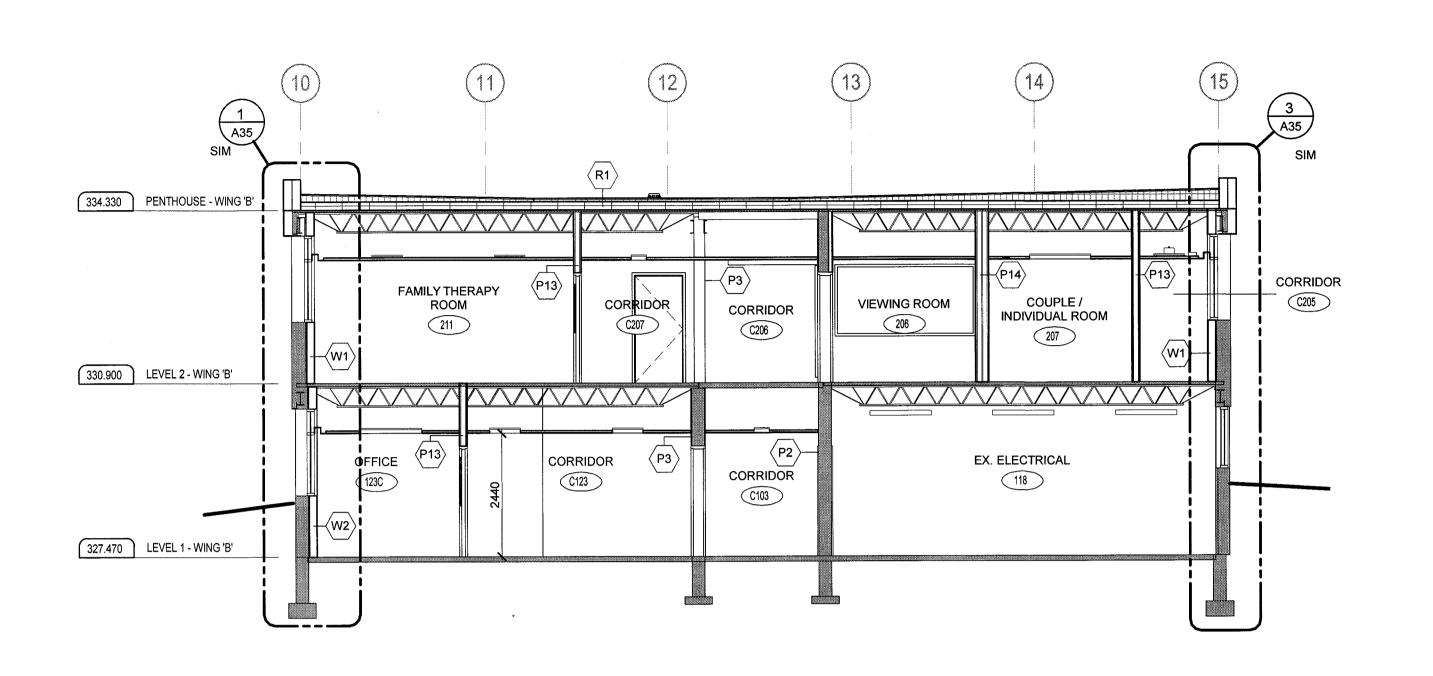

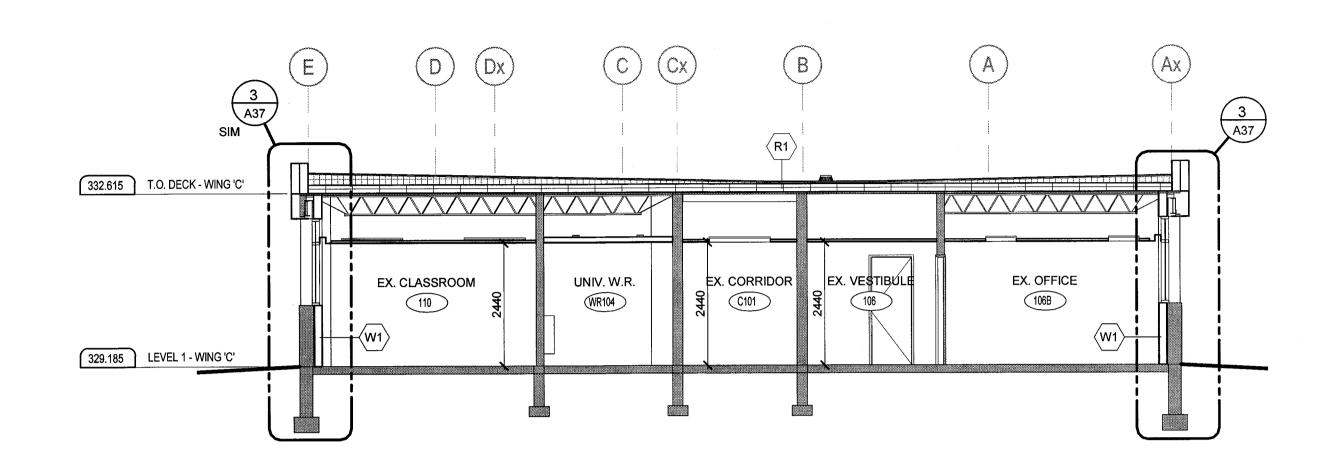


BUILDING SECTION GRIDLINE J A31 SCALE: 1:75

BUILDING SECTION GRIDLINE 23 SCALE: 1:75

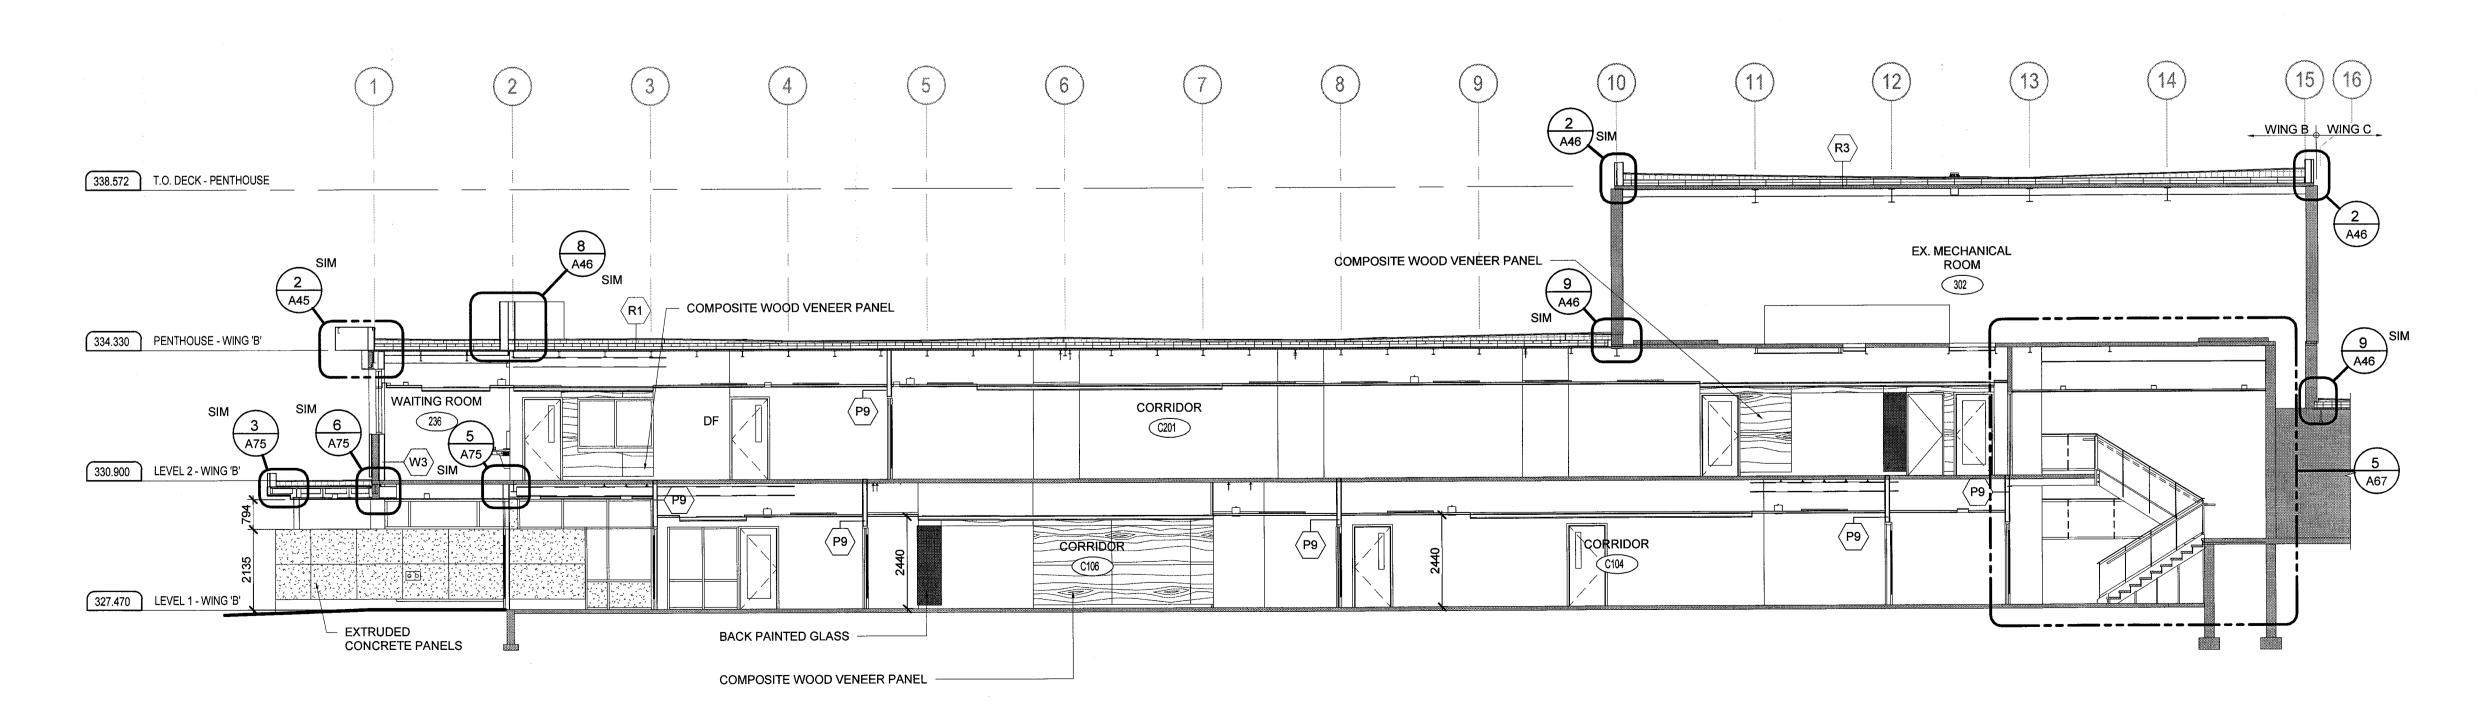

BUILDING SECTION GRIDLINE Dx SCALE: 1:100

LEGEND:

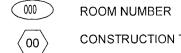

CONSTRUCTION TYPE

DO NOT SCALE DRAWINGS:

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A = Detail number

B = Drawing number where detailed

0 ISSUED FOR PERMIT & TENDER TA NOV 2, 2018

BY DATE NO. ISSUED





Physical Resources Guelph, Ontario. N1G 2W1

J.L.Richards

BUILDING #046 RENOVATIONS

Drawing Title

ARCHITECTURAL **BUILDING SECTIONS**


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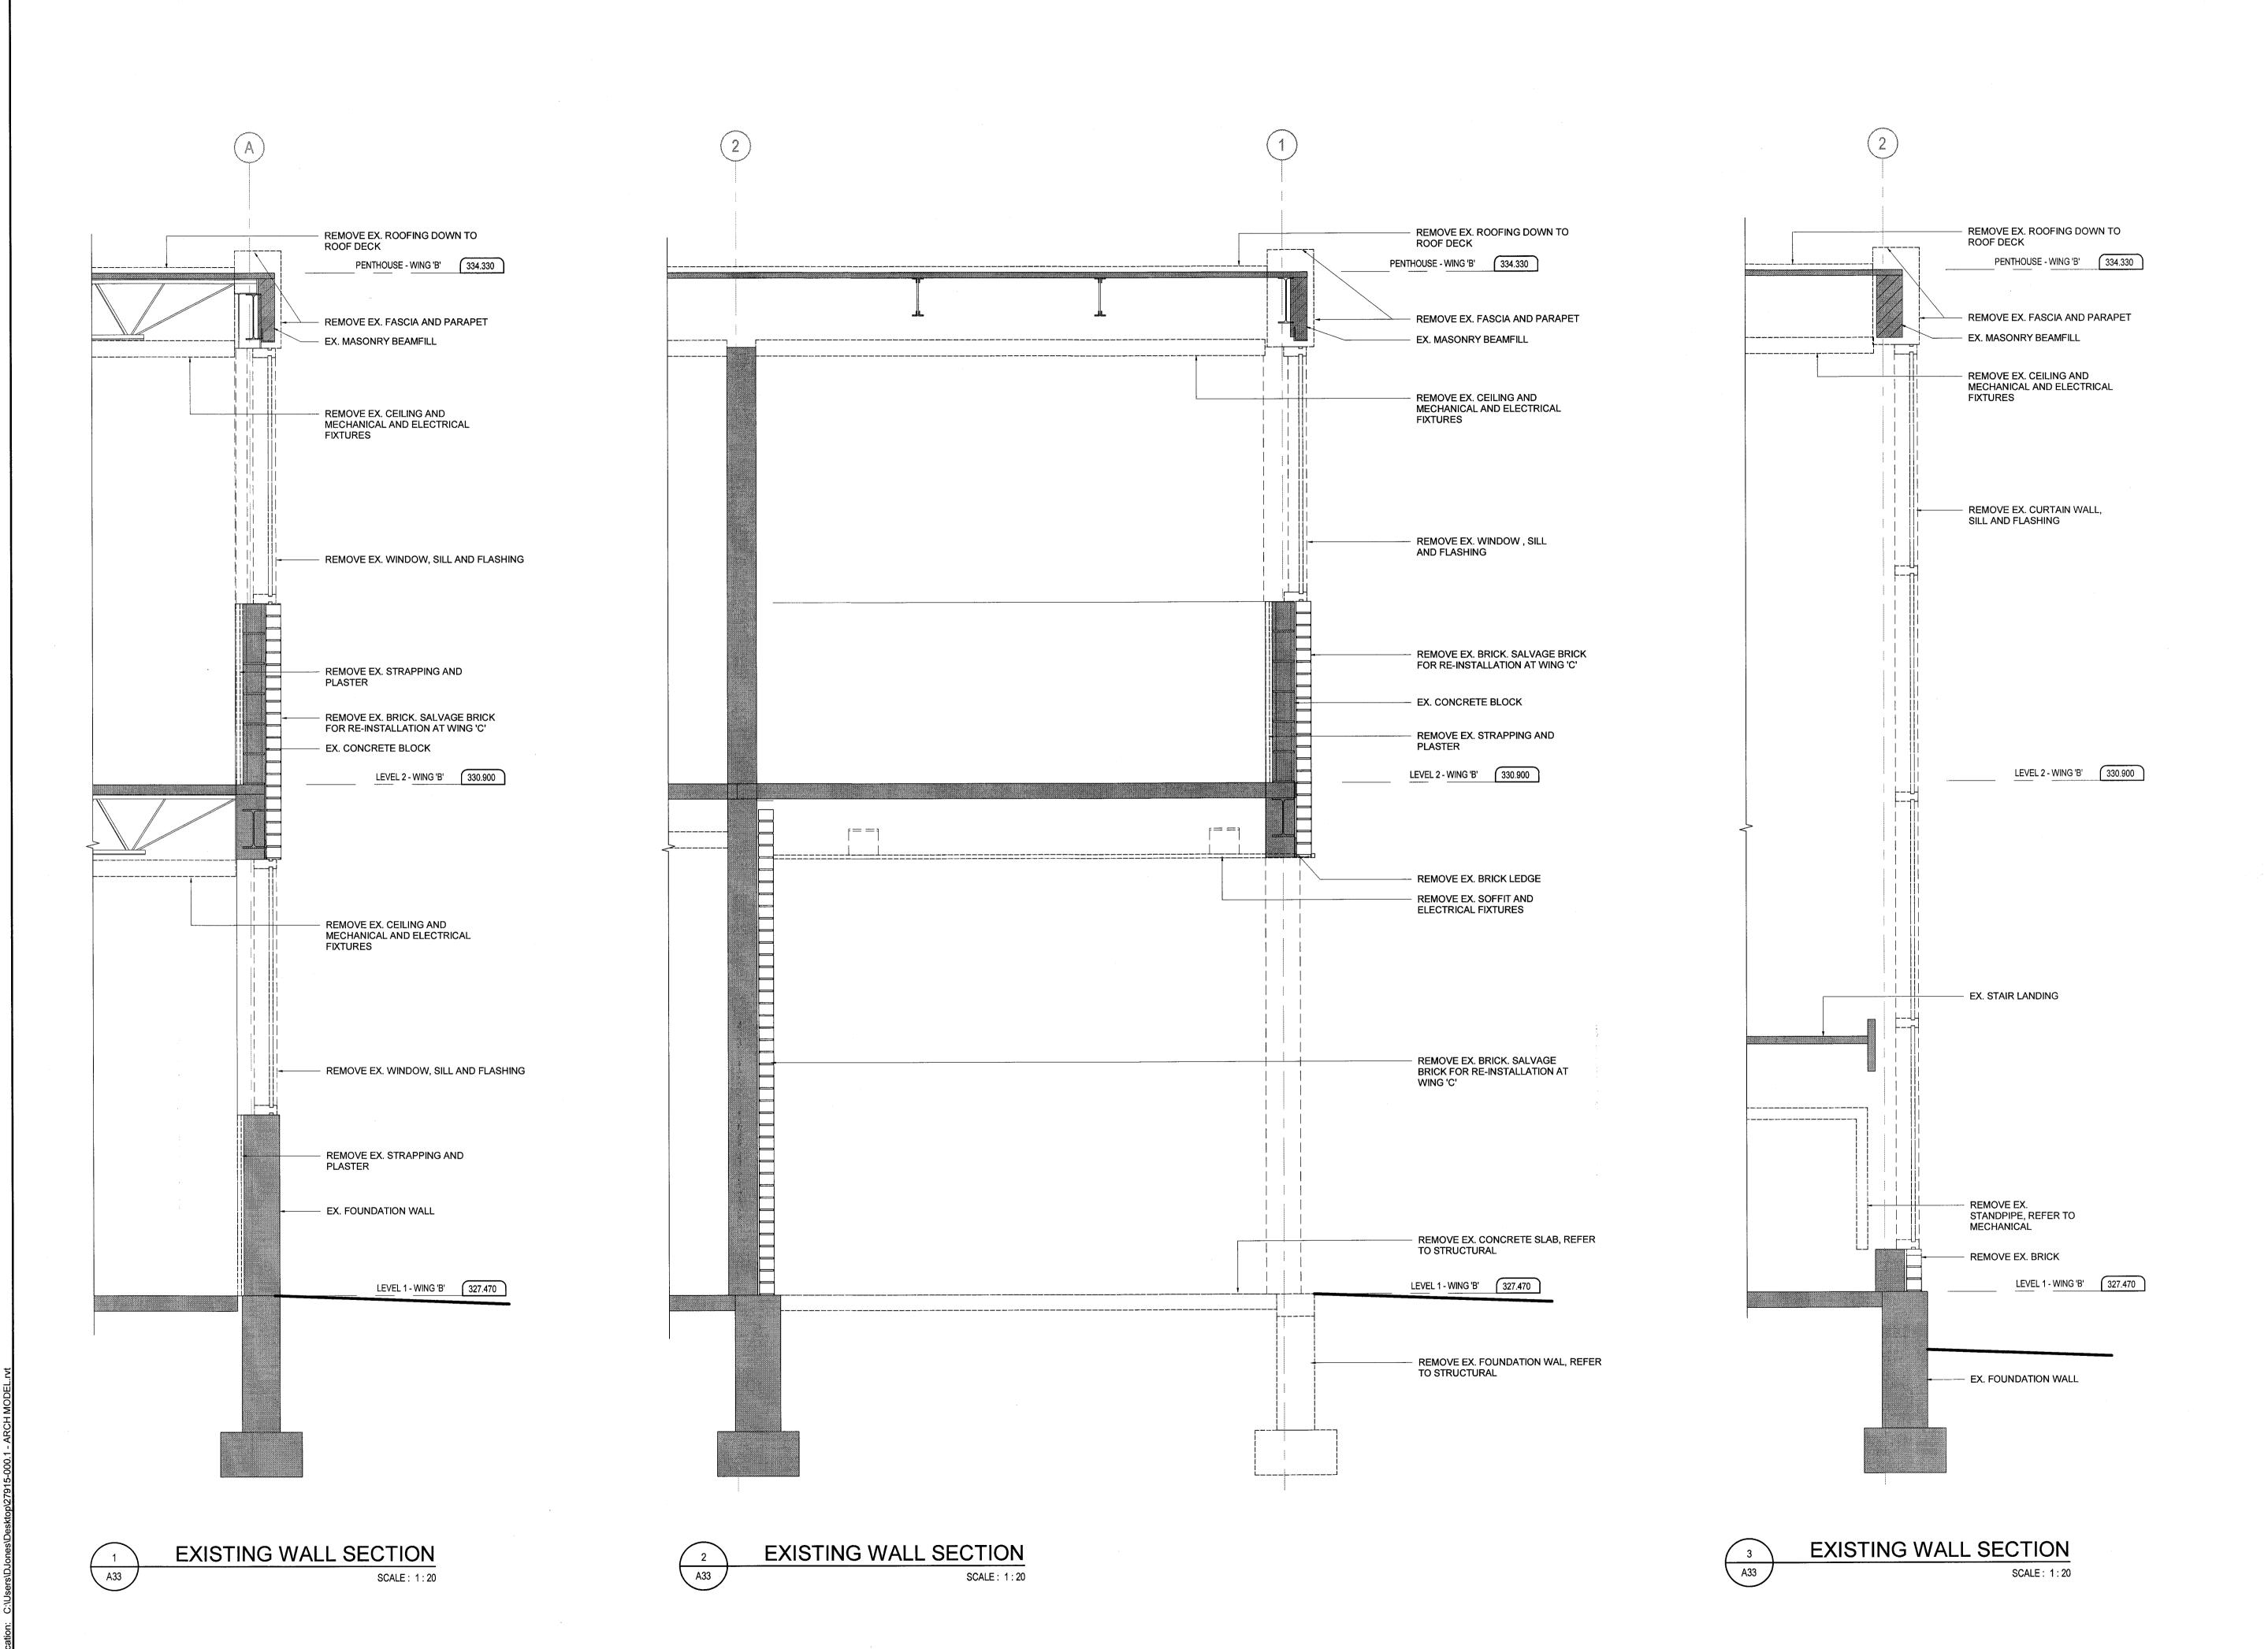
UNIVERSITY OF GUELPH BUILDING #046

Date NOV 2, 2018 AS INDICATED Drawing No. Checked By TA Approved By RPC

of 170

27915



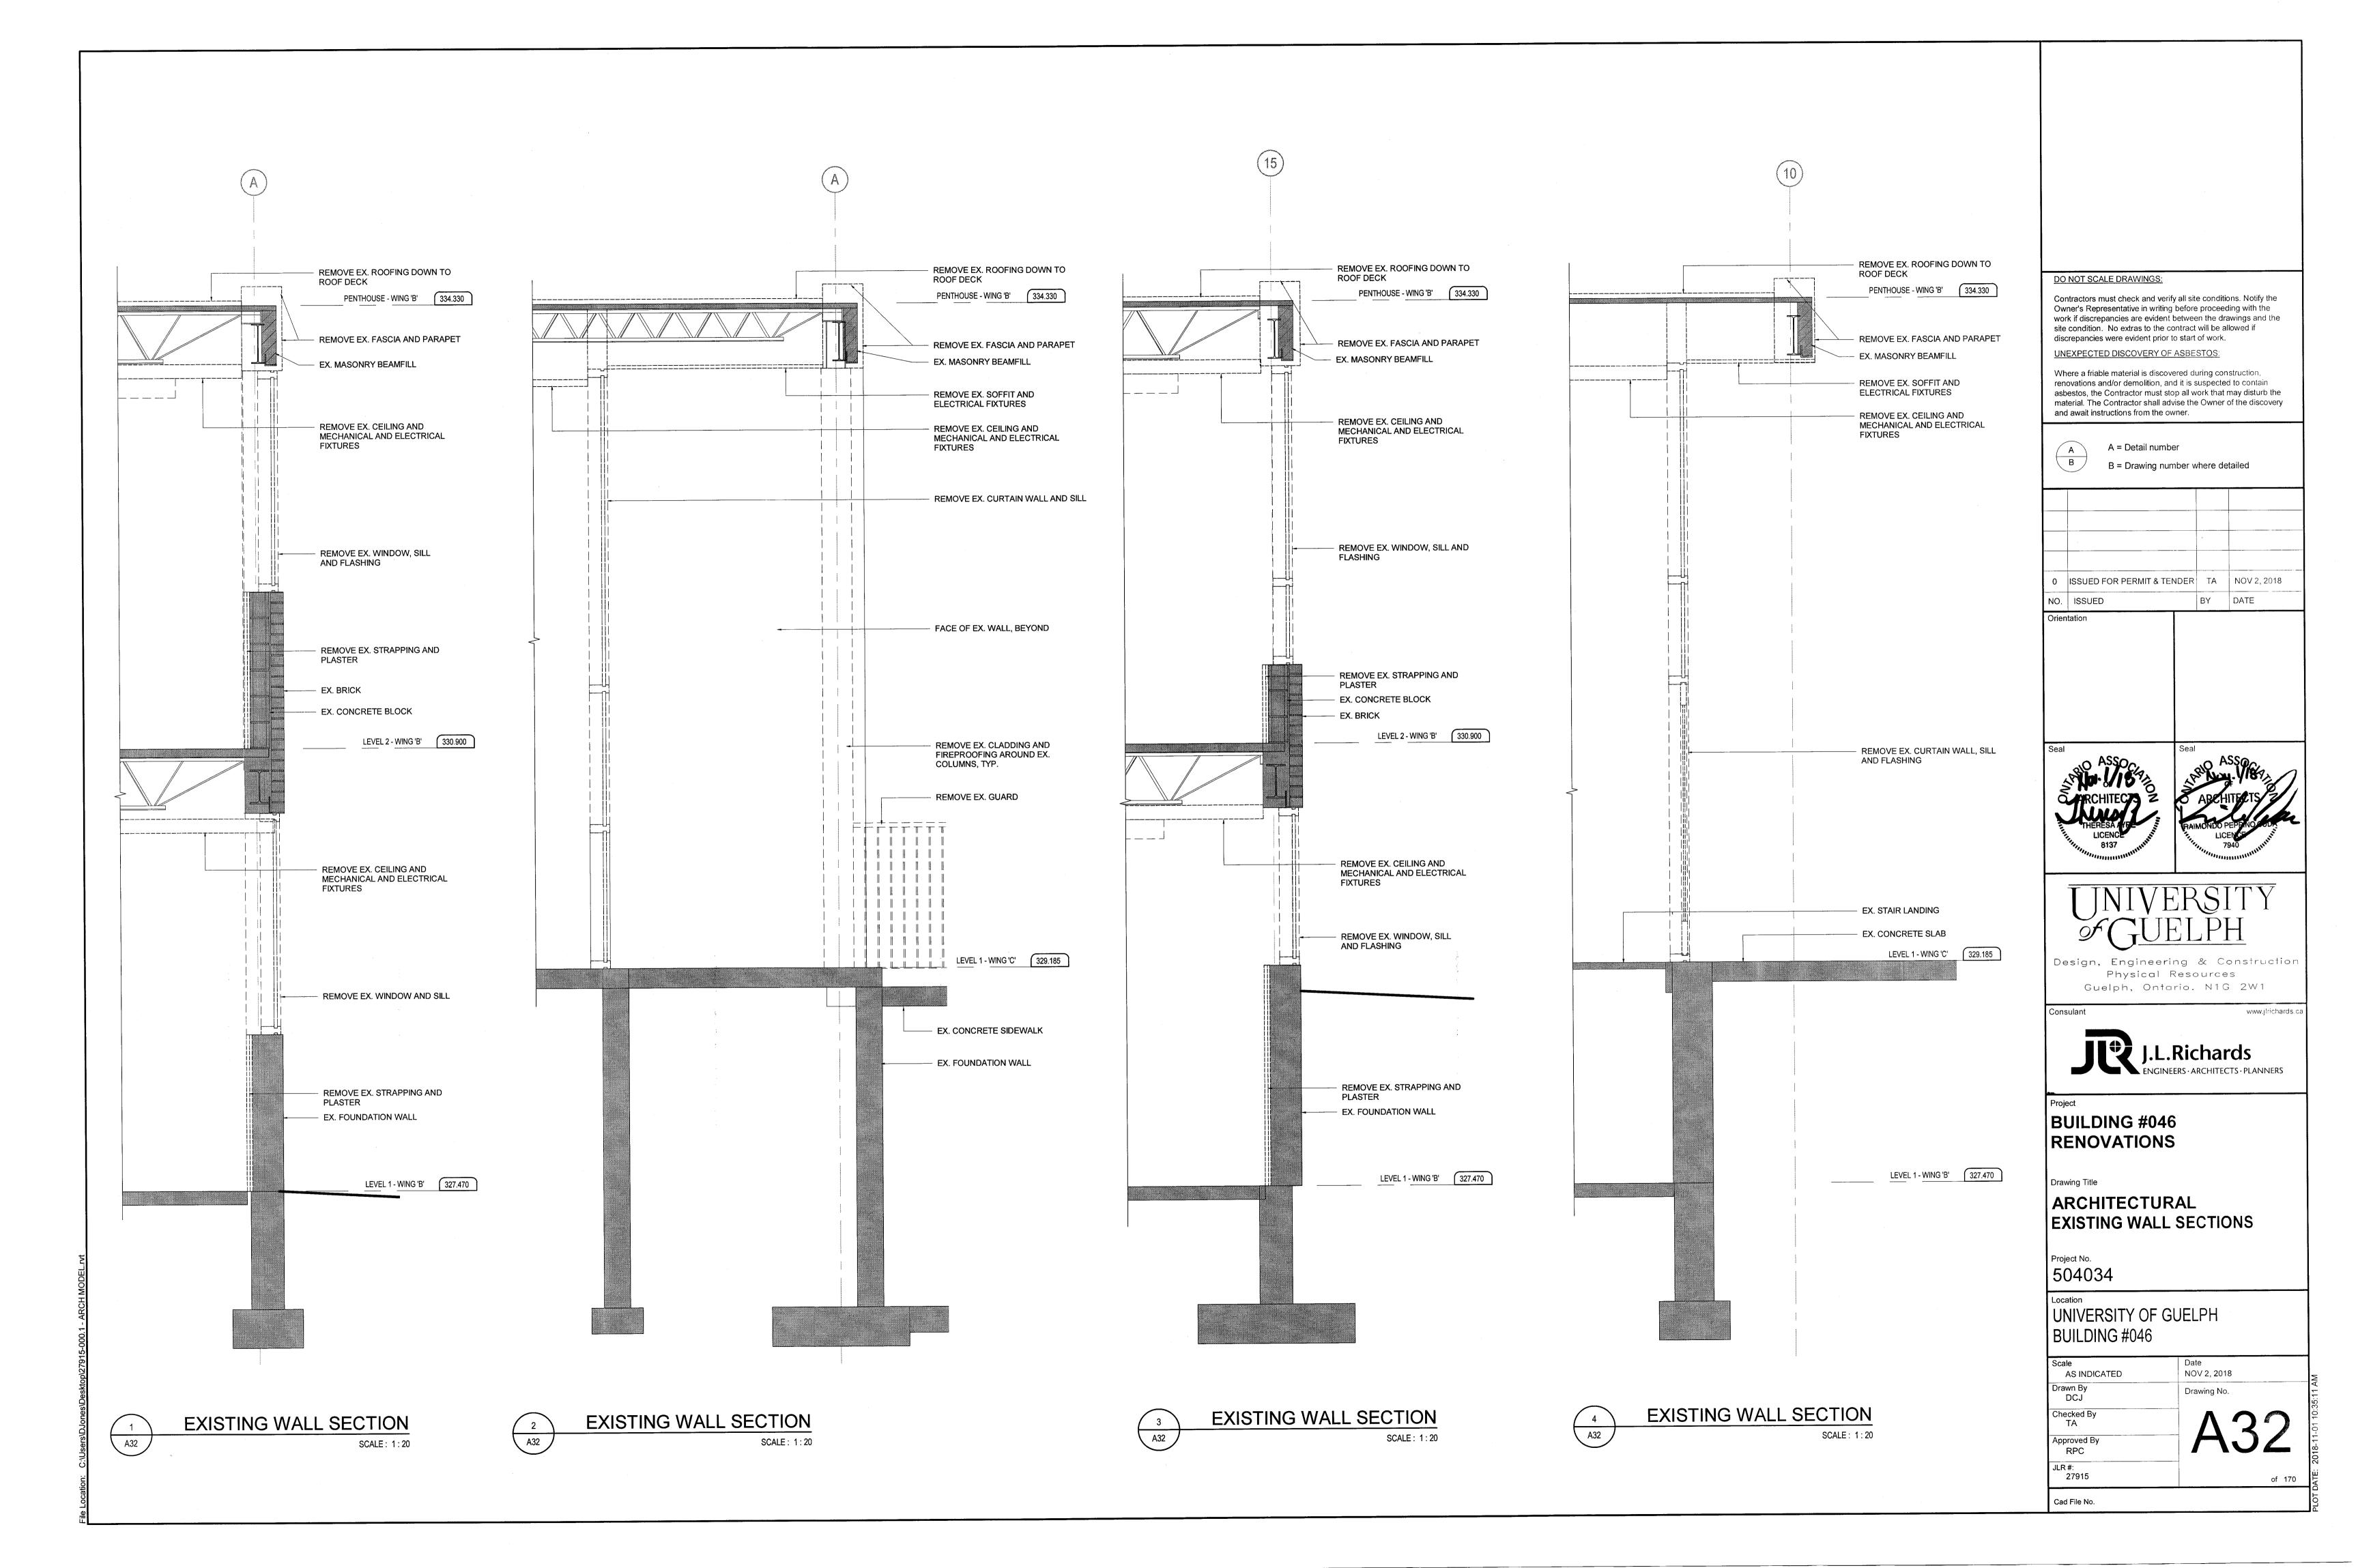

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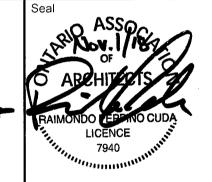
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0 ISSUED FOR PERMIT & TENDER TA NOV 2, 2018



BY DATE

Design, Engineering & Construction Physical Resources Guelph, Ontario. N1G 2W1

BUILDING #046 RENOVATIONS


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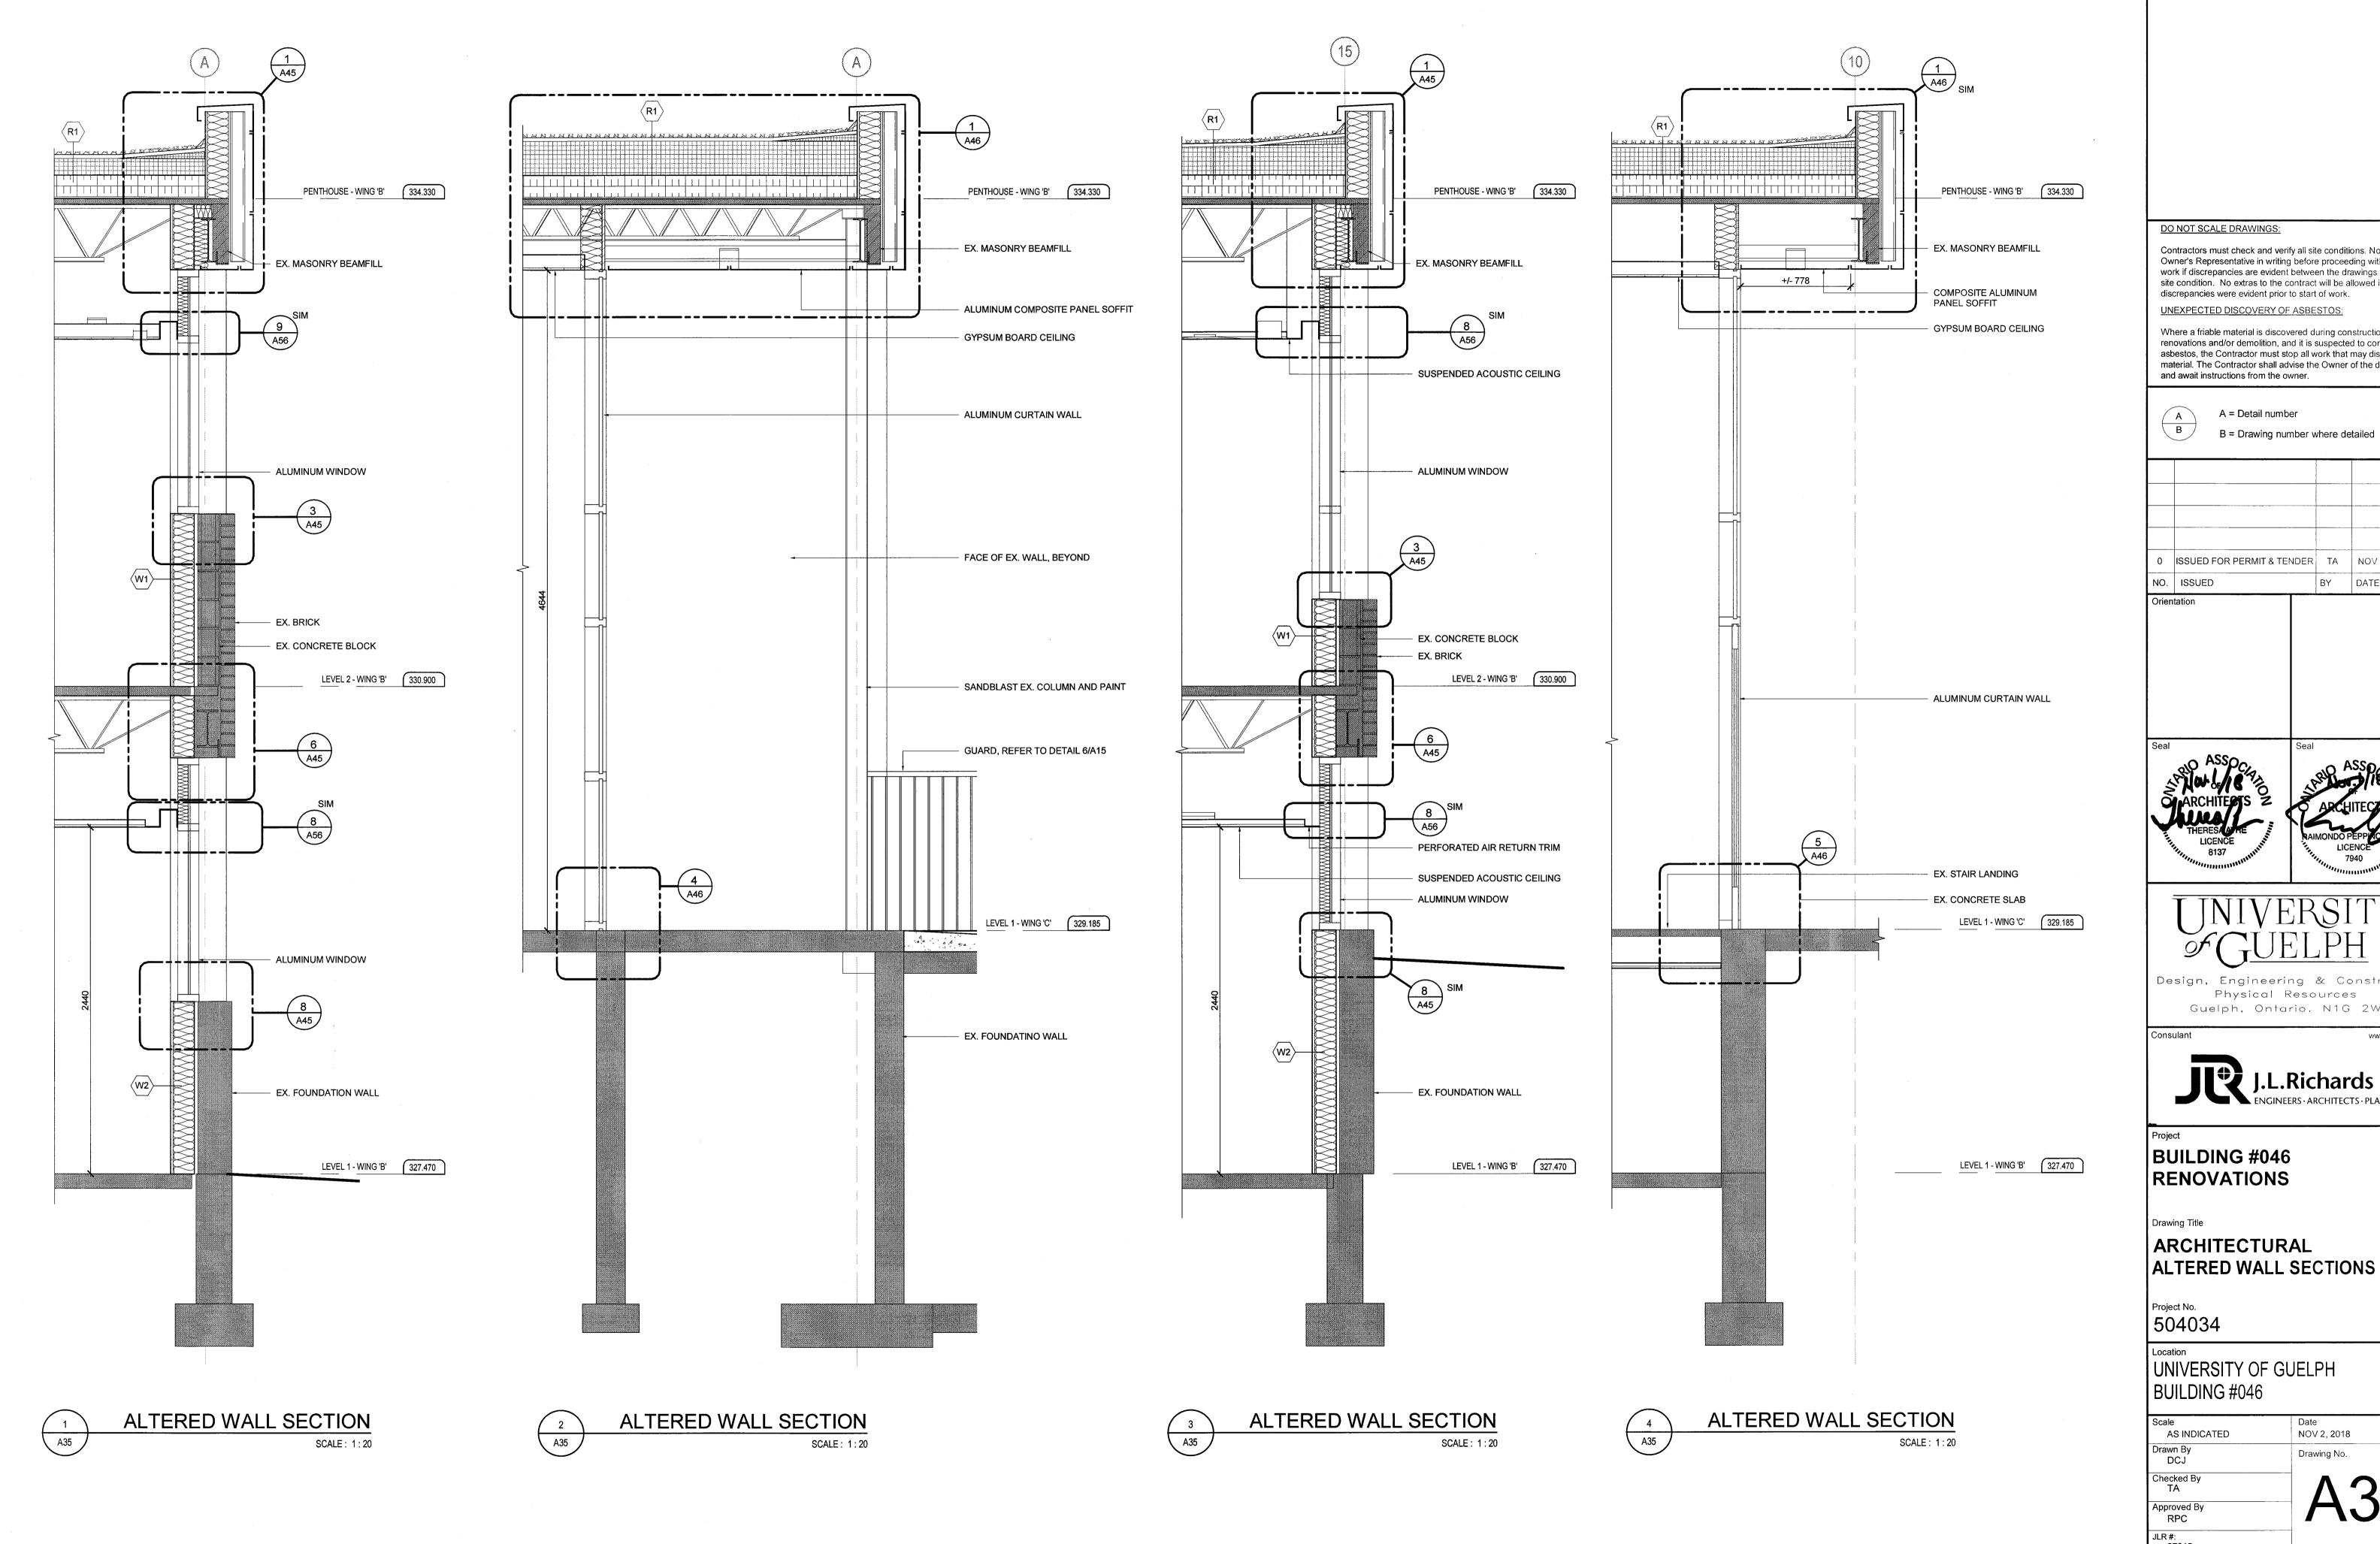
ARCHITECTURAL **EXISTING WALL SECTIONS**

504034

UNIVERSITY OF GUELPH BUILDING #046

NOV 2, 2018 AS INDICATED Checked By TA Approved By RPC



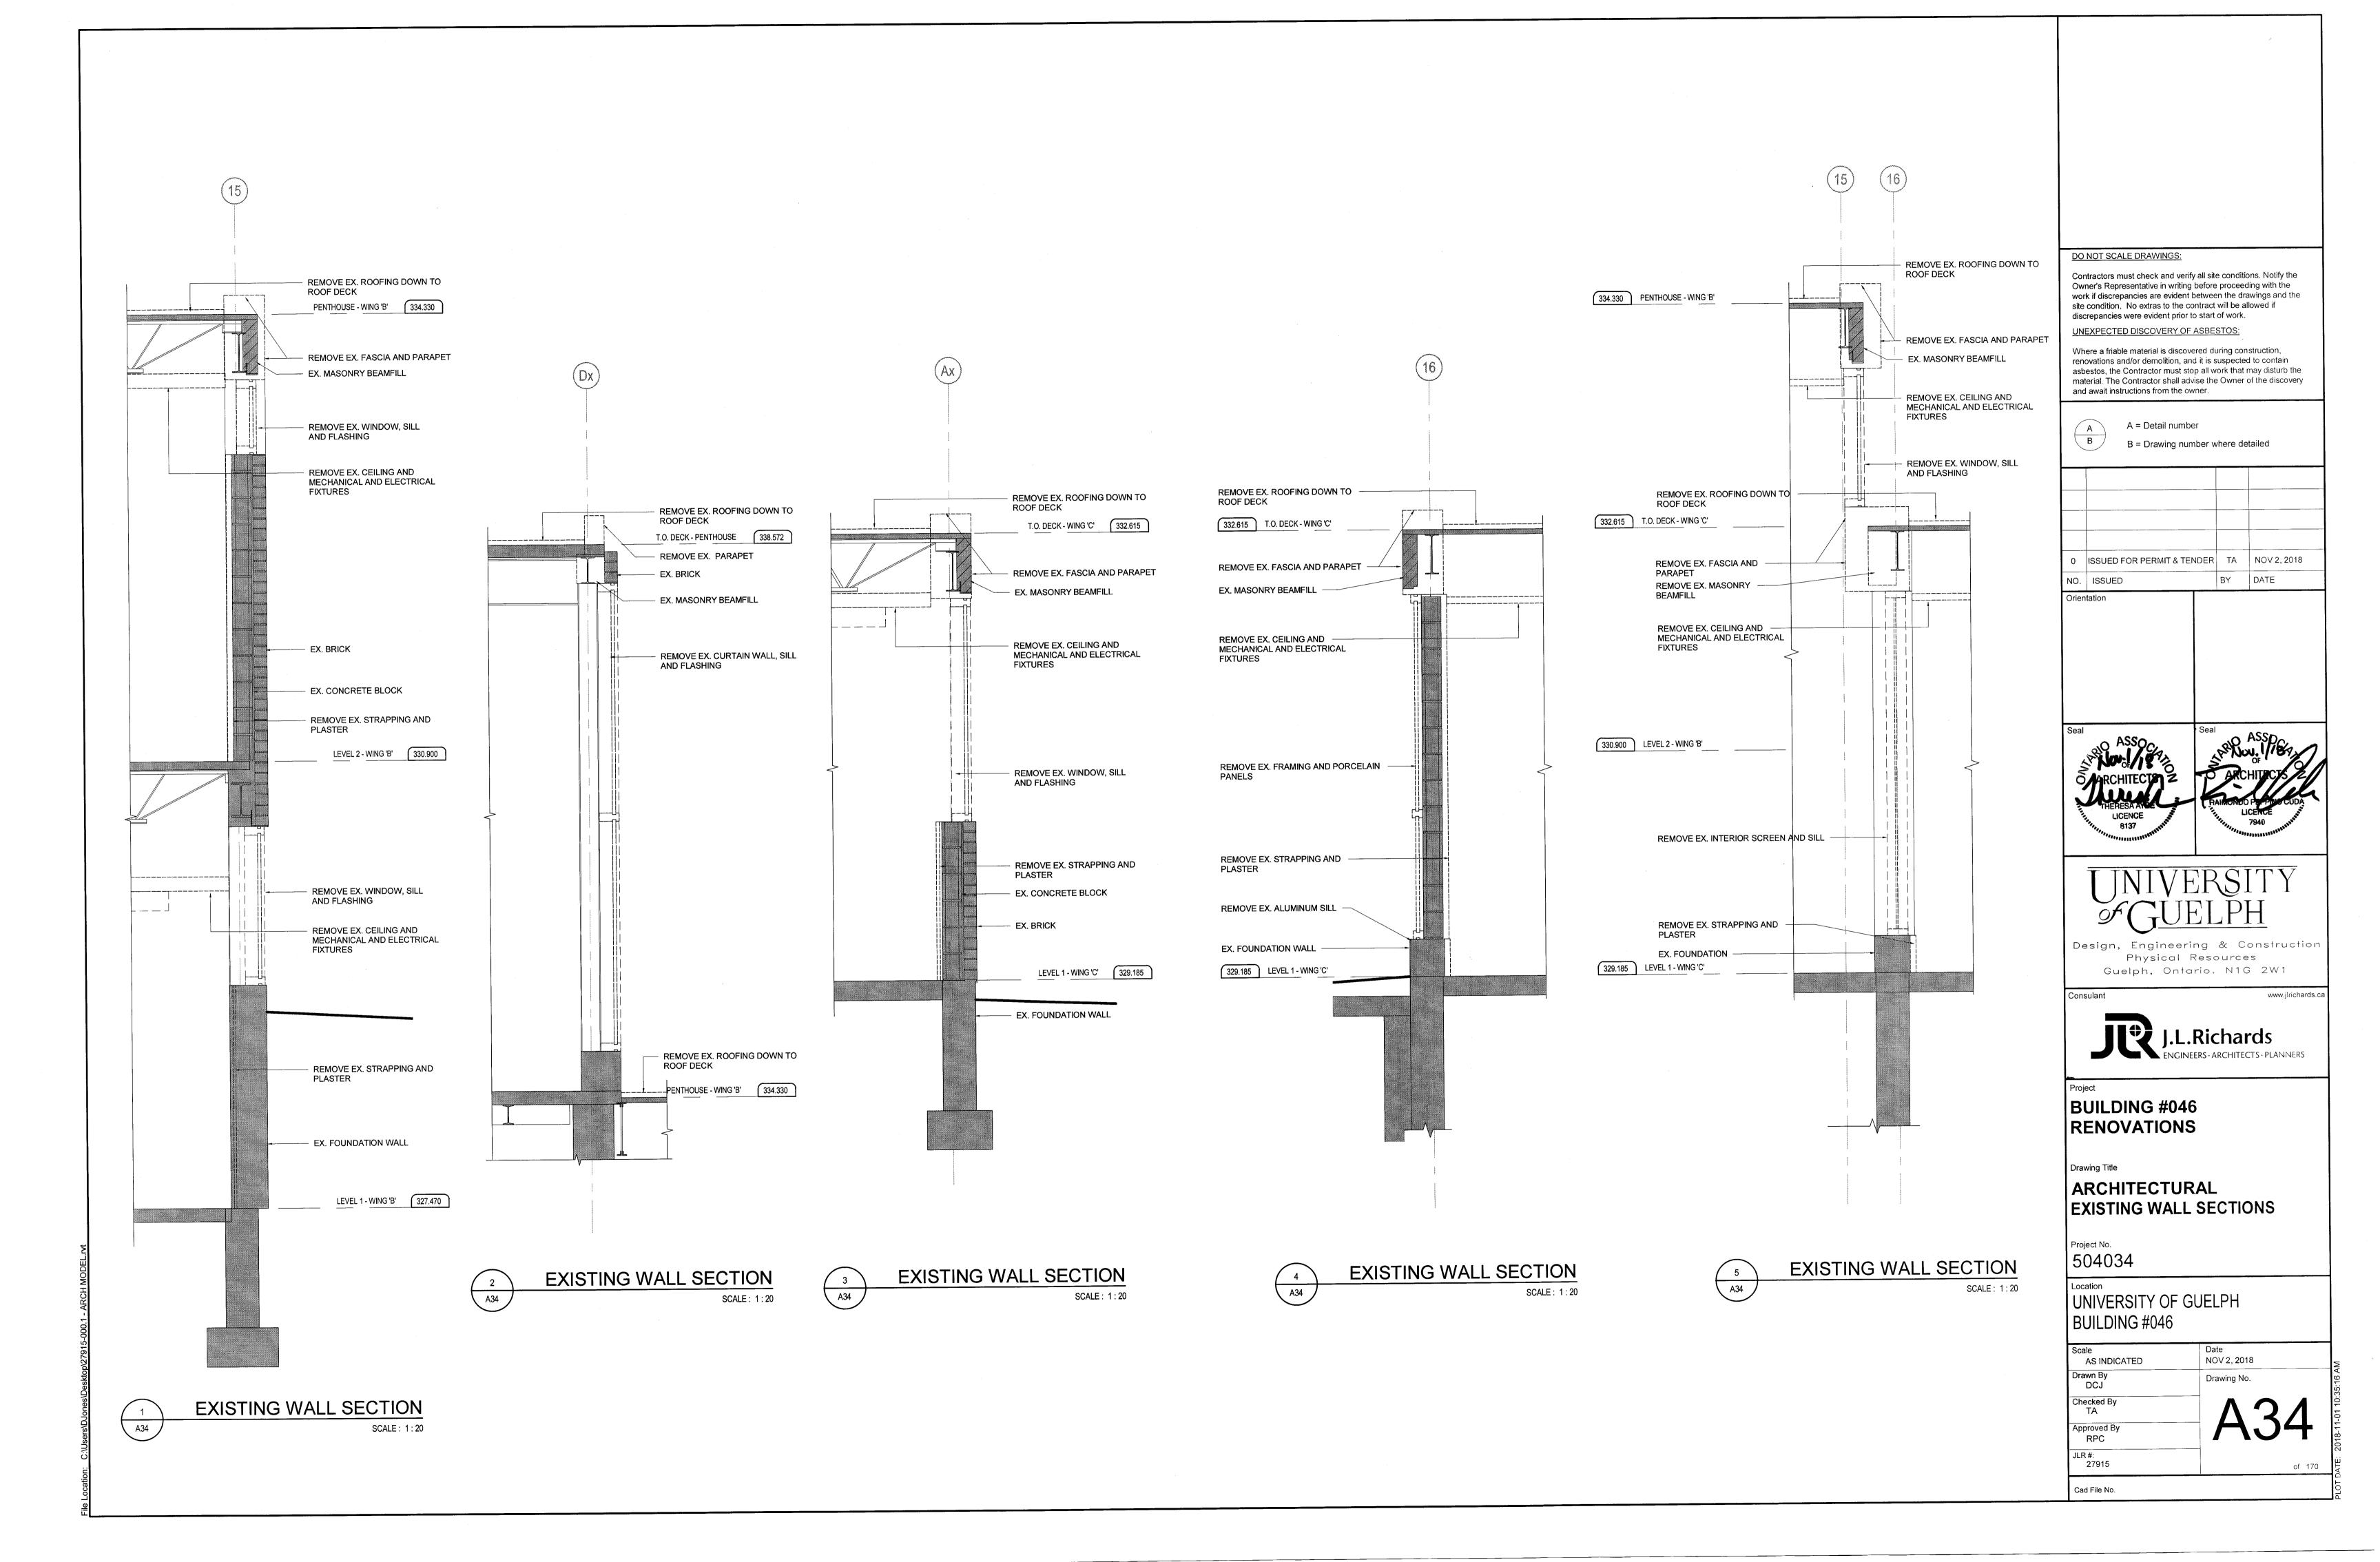

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0 ISSUED FOR PERMIT & TENDER TA NOV 2, 2018 BY DATE



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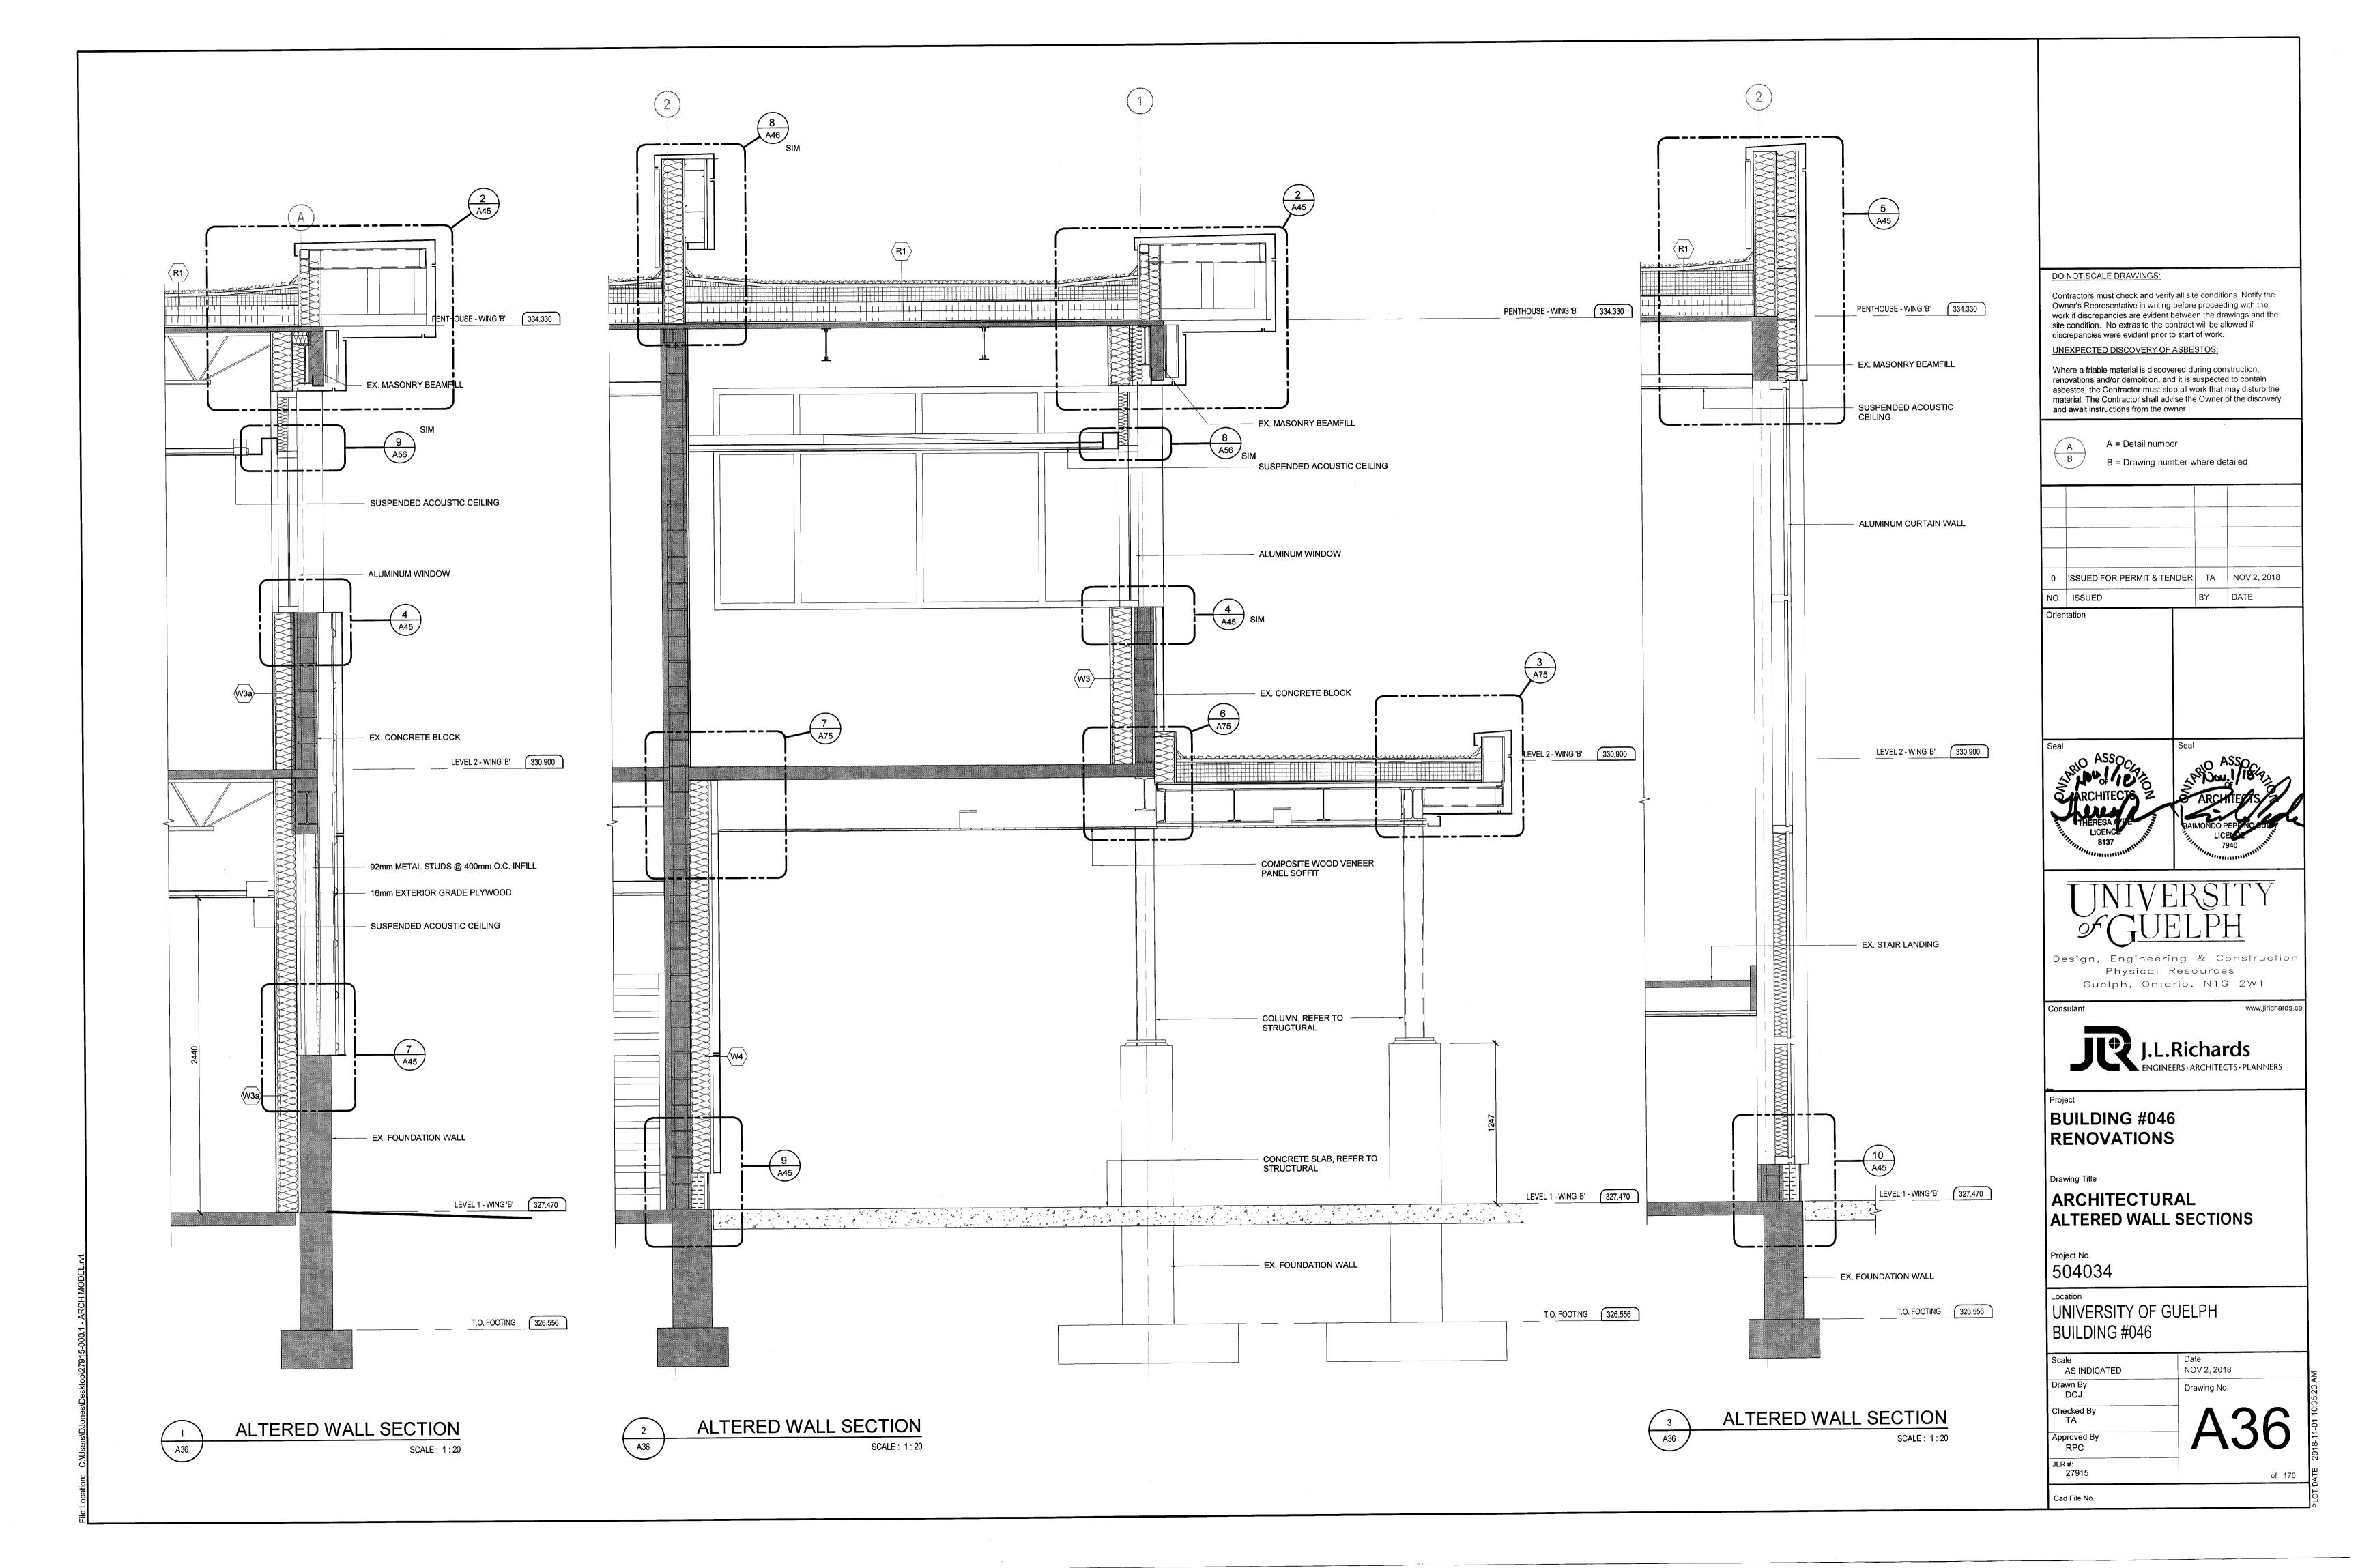
Design, Engineering & Construction


Guelph, Ontario. N1G 2W1


J.L.Richards


ALTERED WALL SECTIONS


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Drawn By DCJ	Drawing No.	10:35:19 AM
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Approved By RPC	AJJ	2018-11-01
JLR #: 27915	of 170	DATE: 2
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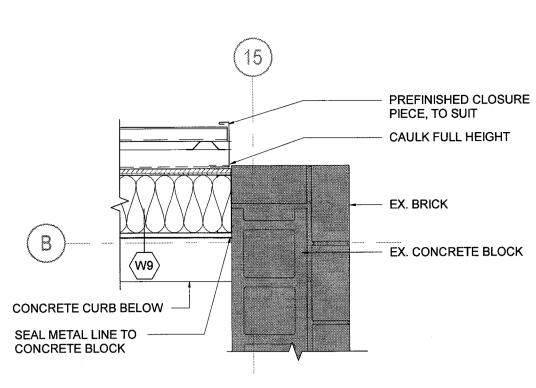




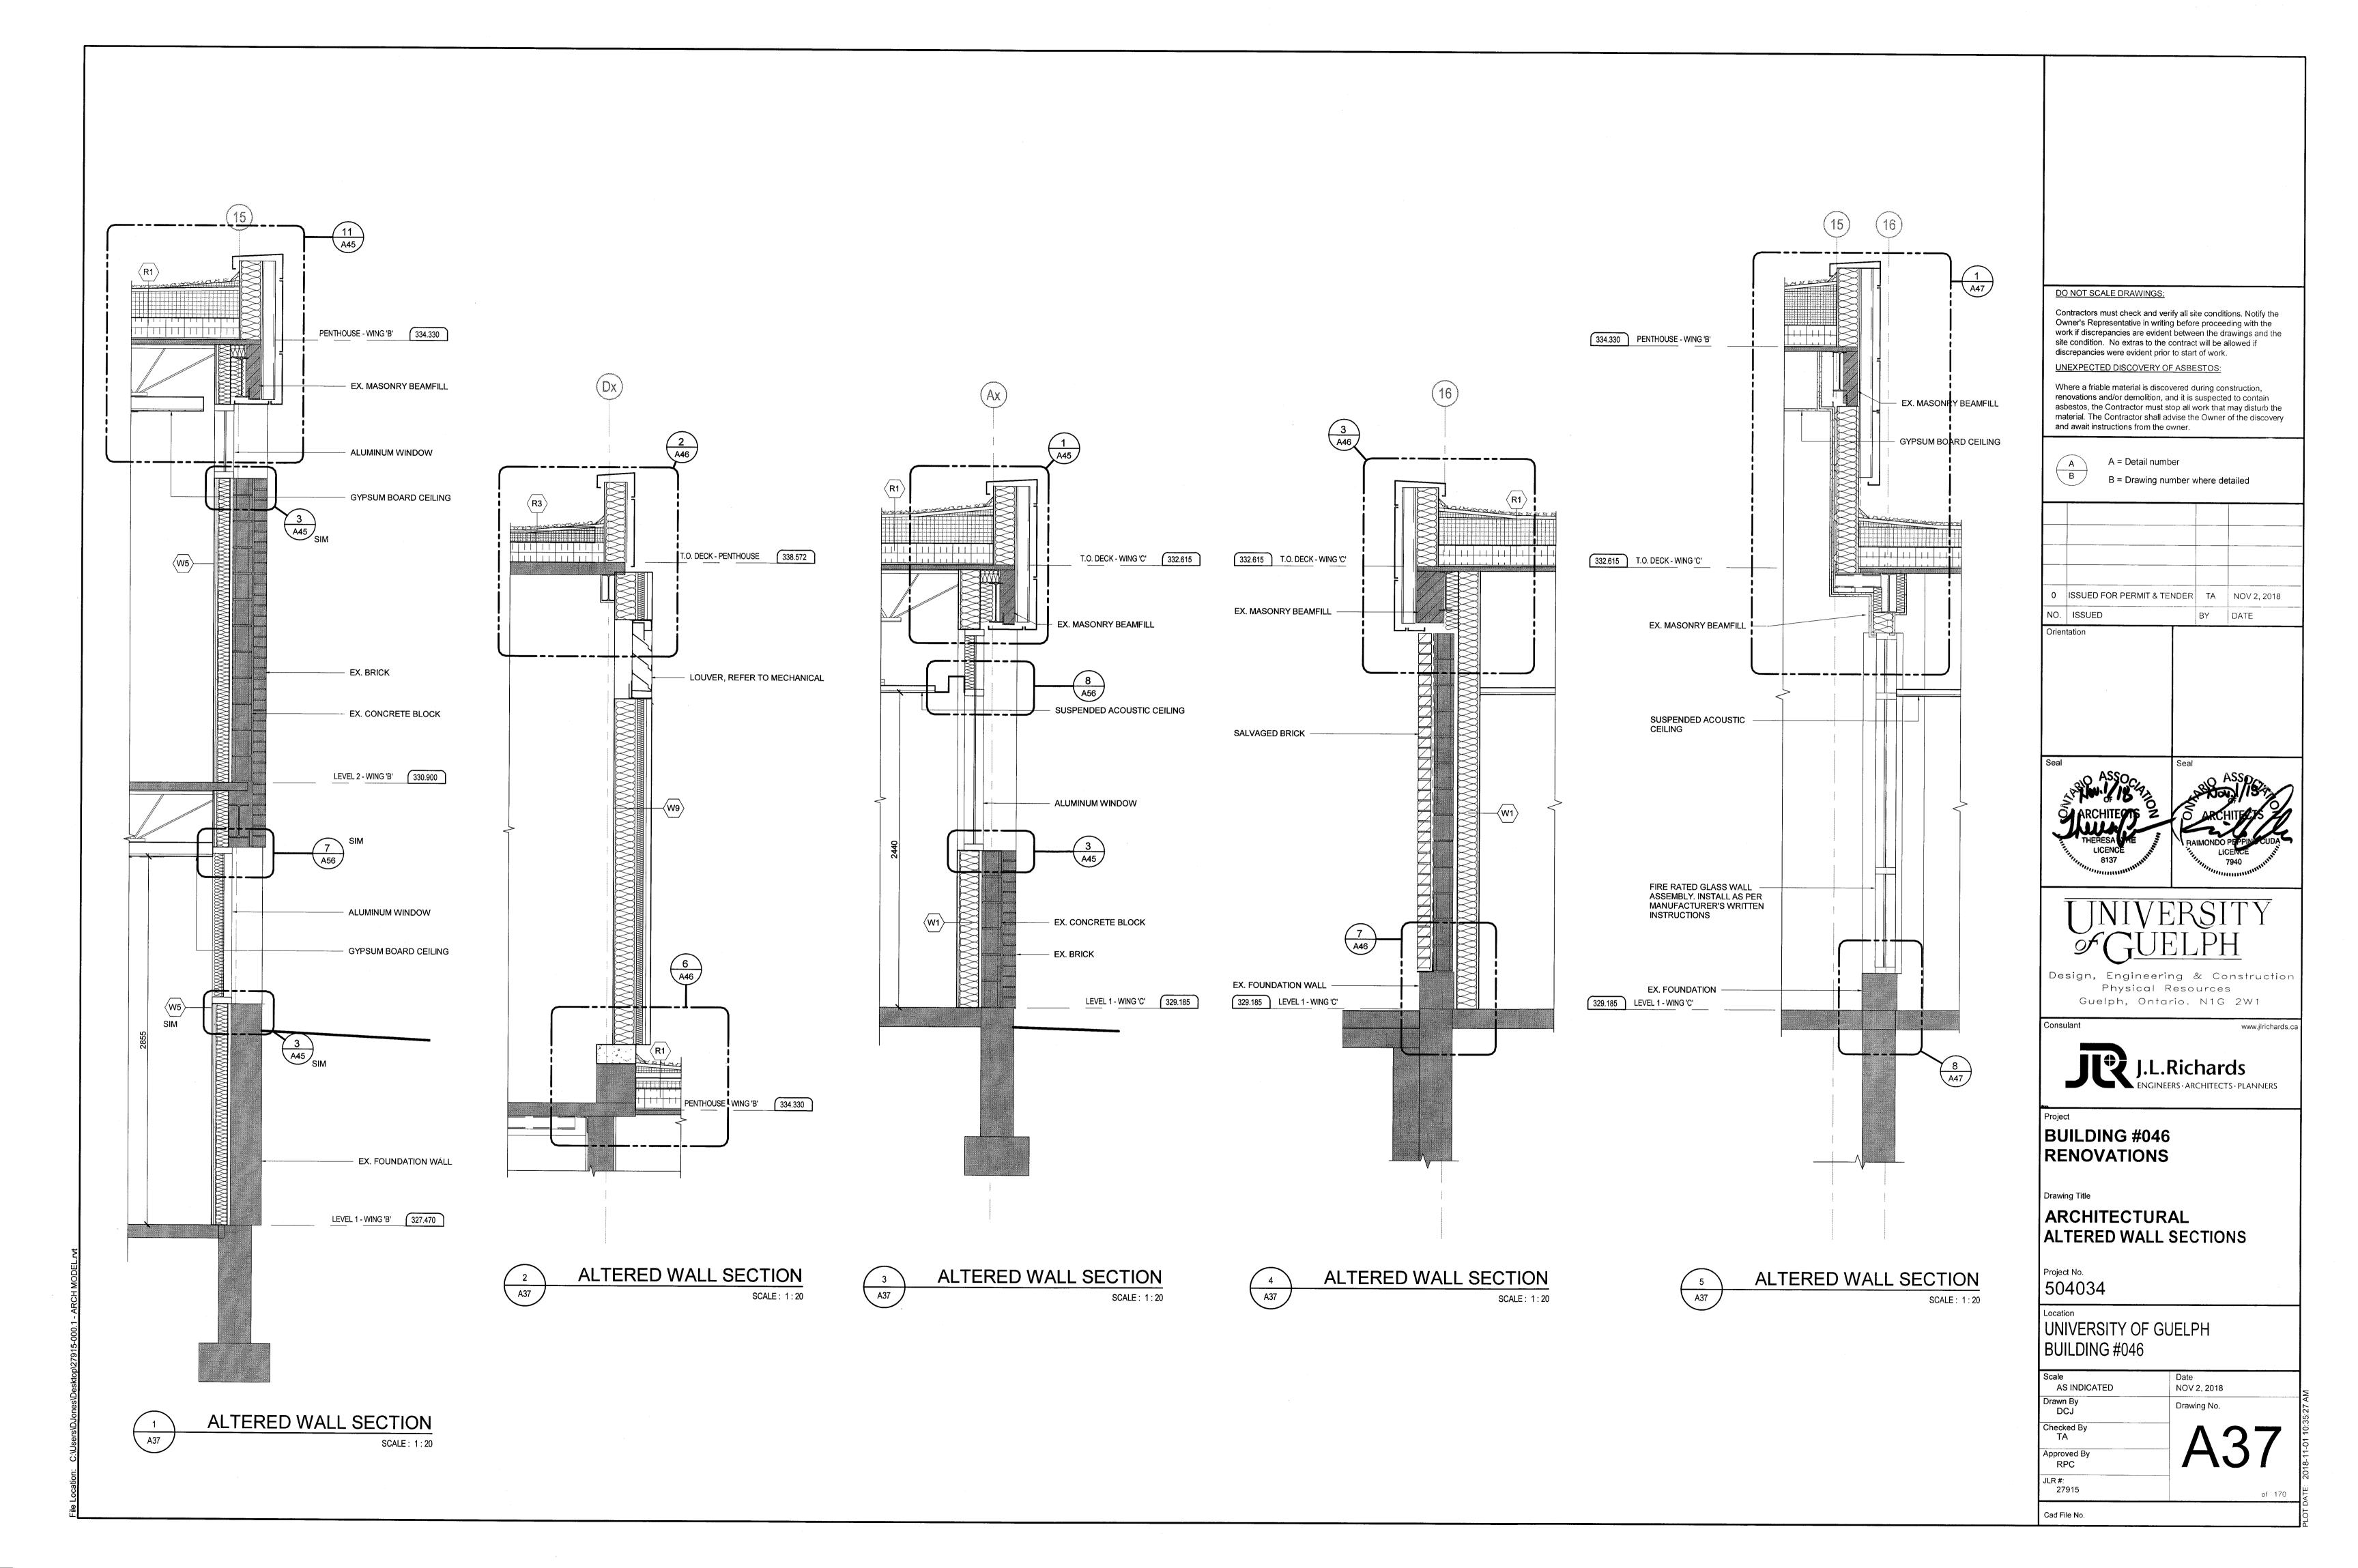

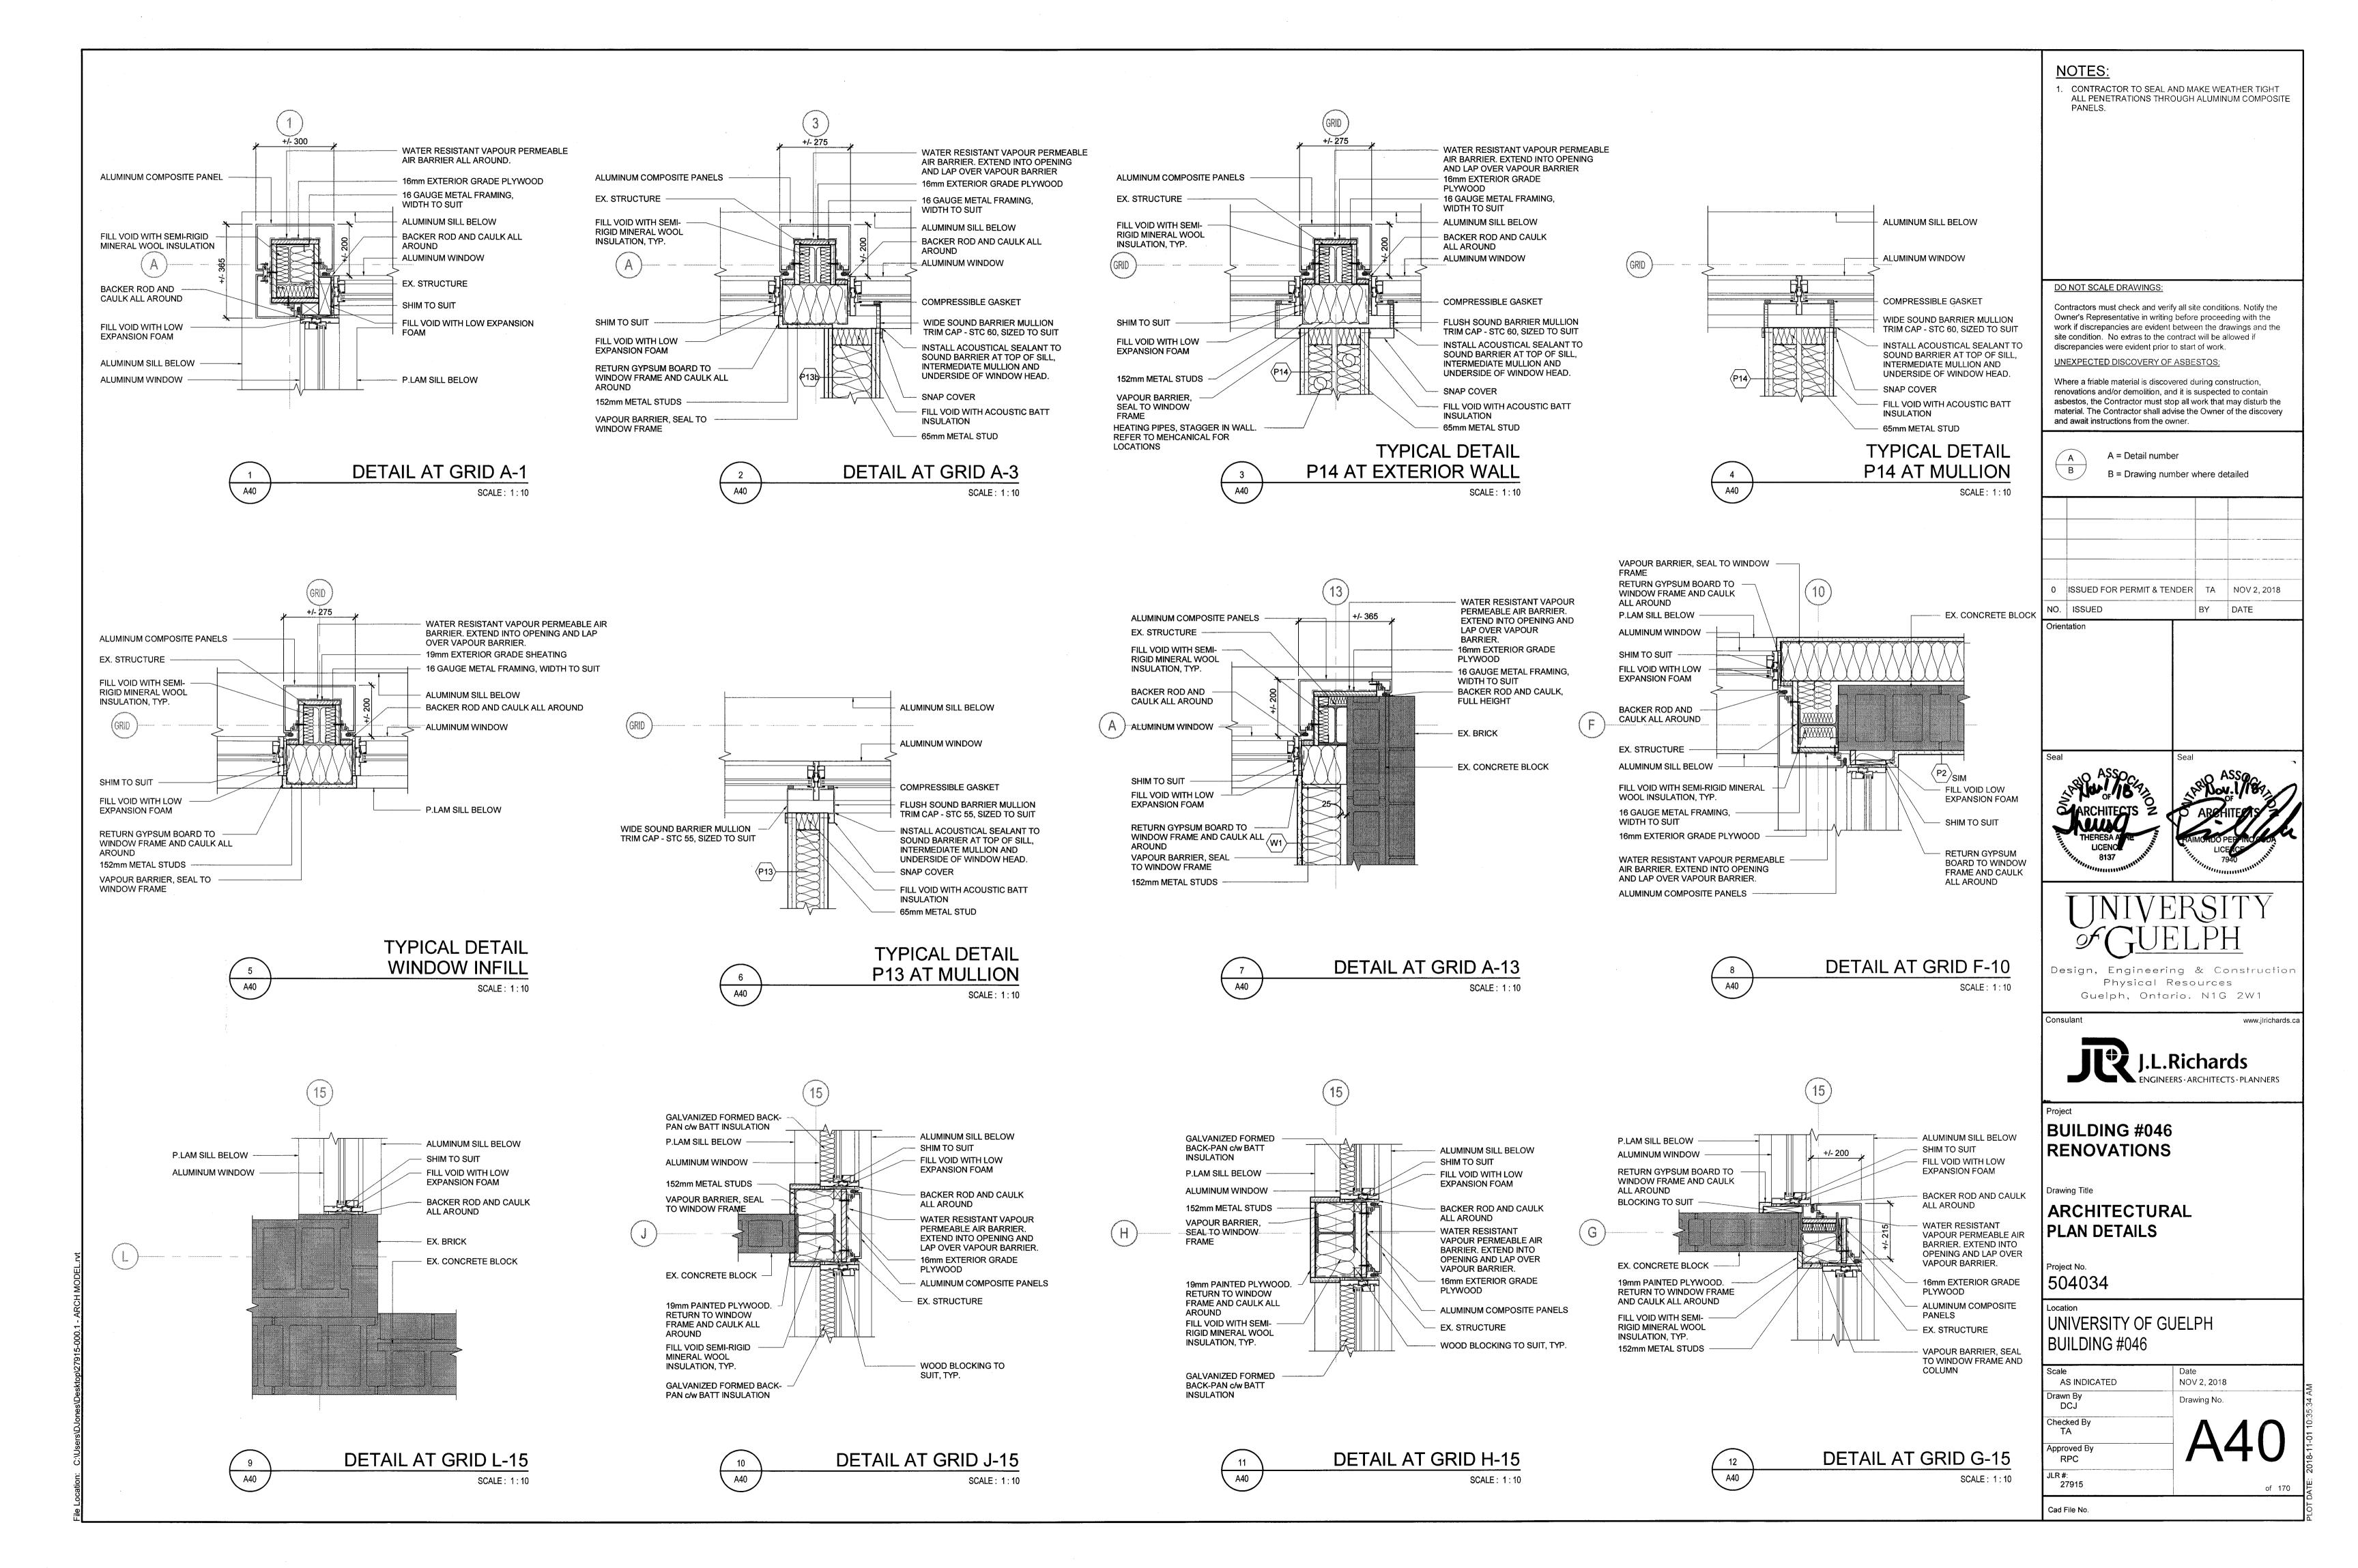


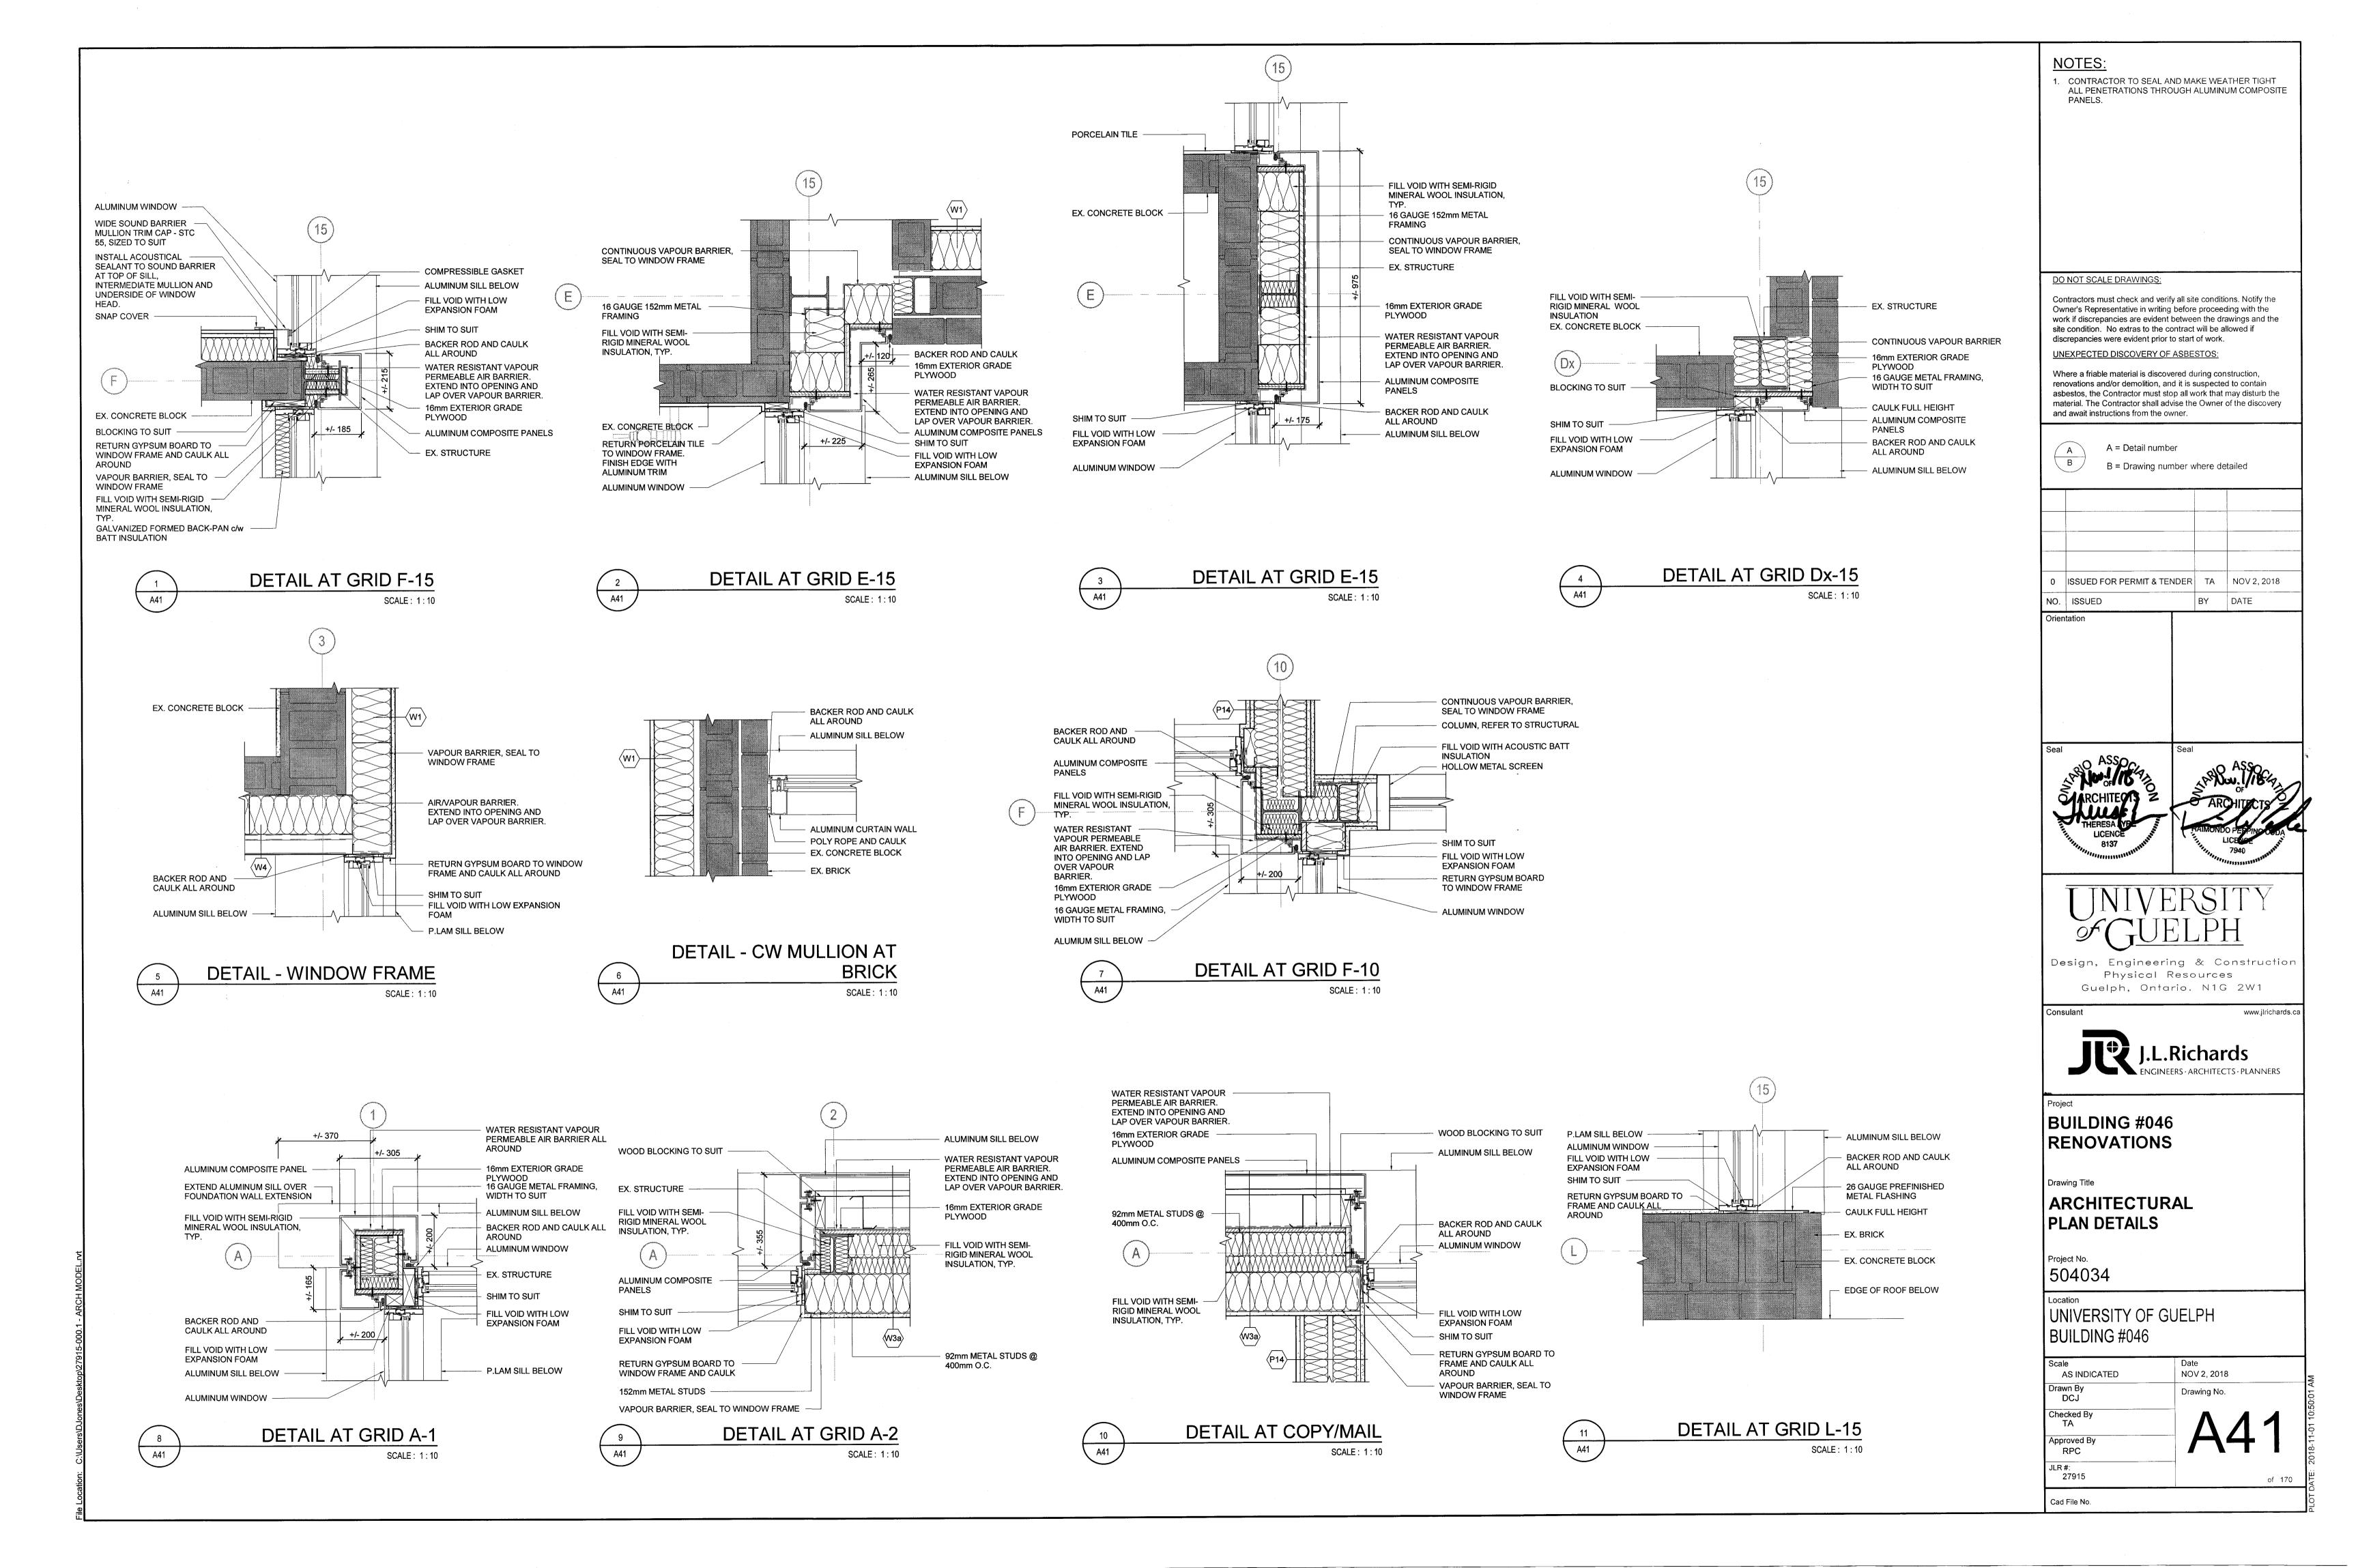

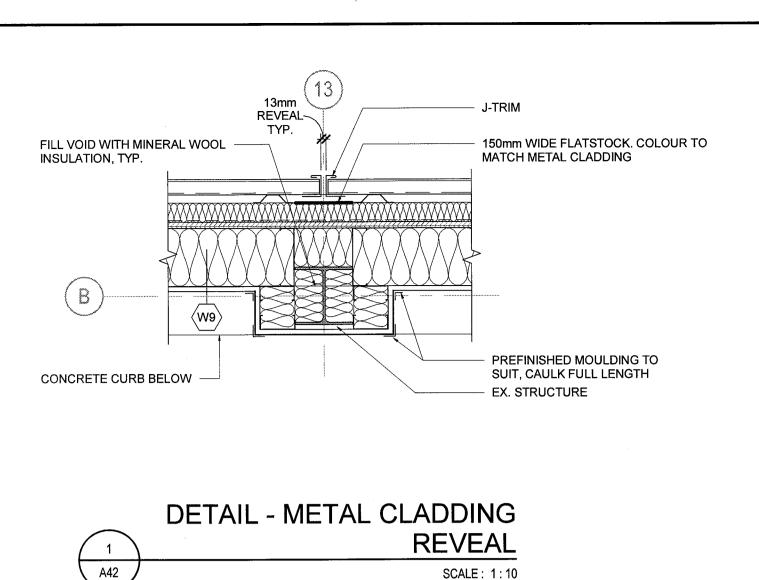


DETAIL - METAL CLADDING

SCALE: 1:10

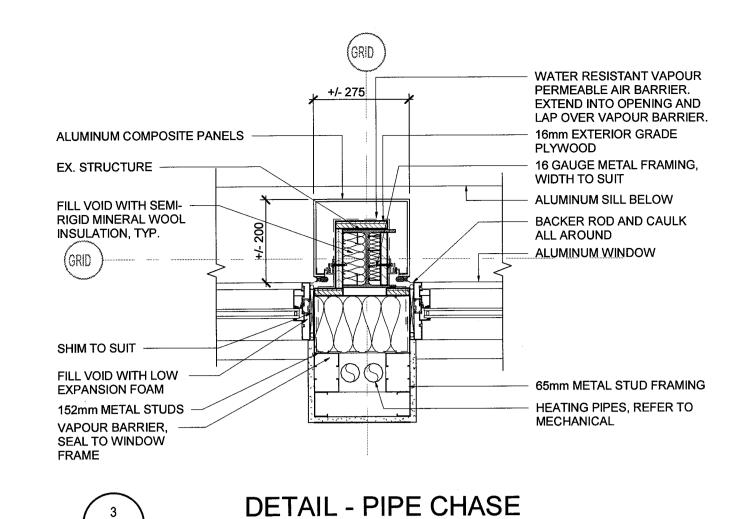


SCALE: 1:10

A42

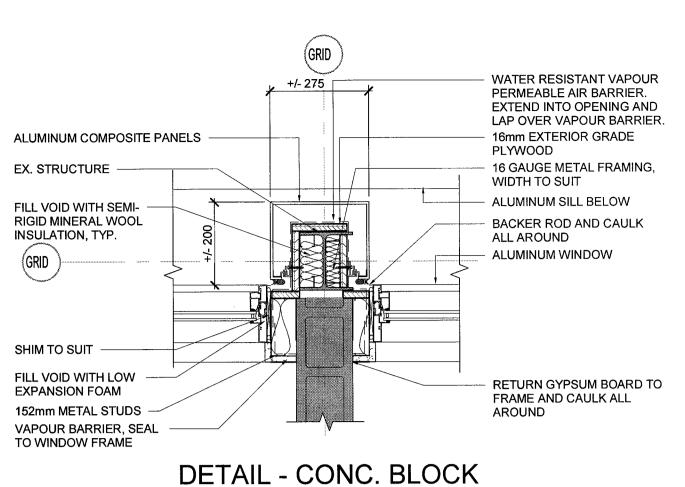

PARTITION

SCALE: 1:10

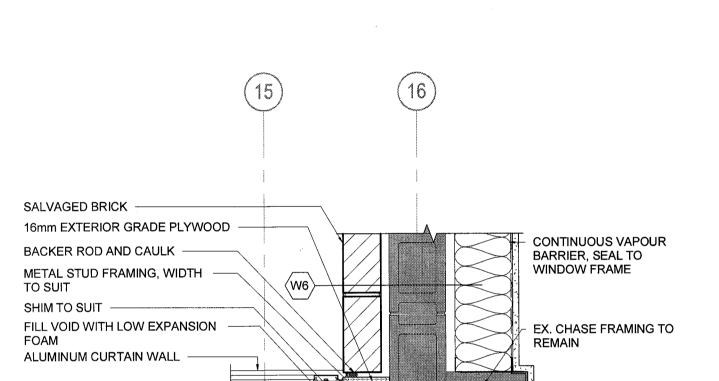



P.LAM SILL BELOW


AROUND

RETURN GYPSUM BOARD

TO FRAME AND CAULK ALL

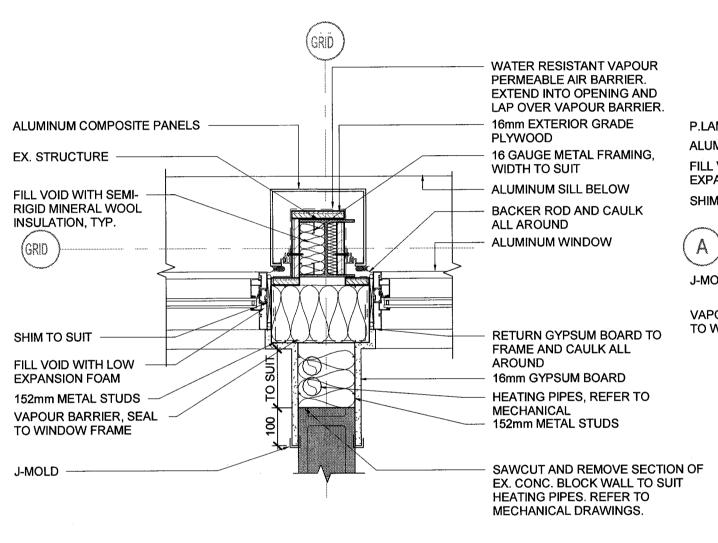

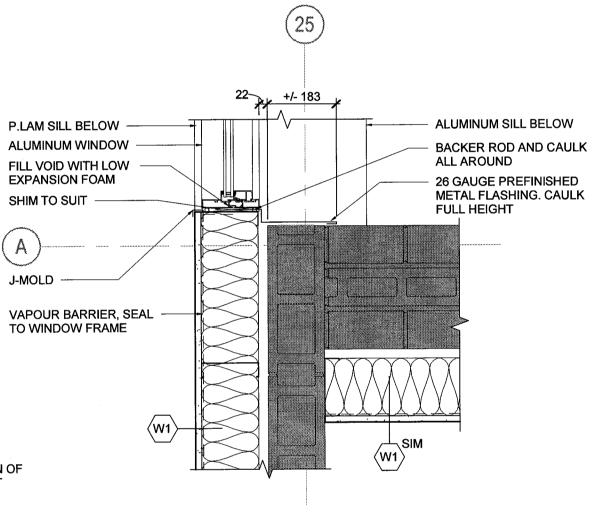

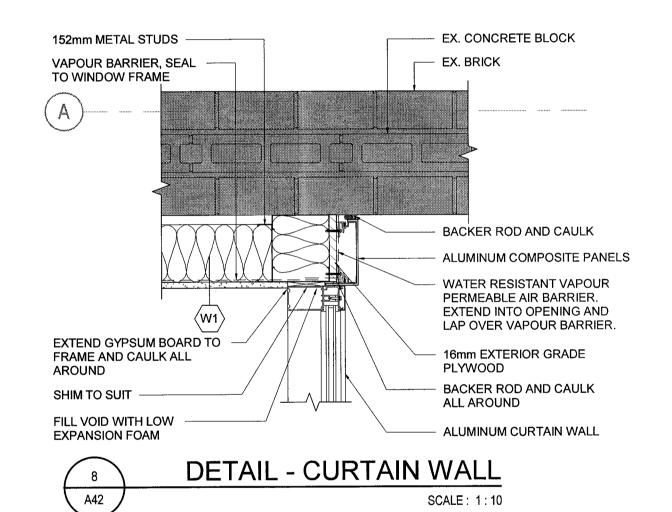



RETURN GYPSUM BOARD TO FRAME AND

INSULATION, TYP.


P.LAM SILL BELOW


ALUMINUM SCREEN

CAULK ALL AROUND
FILL VOID WITH SEMI-RIGID MINERAL WOOL





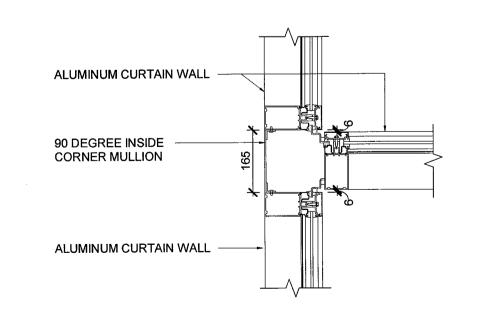

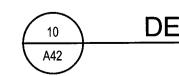

A42 /

DETAIL - CURTAIN WALL

SCALE: 1:10

NOTES:


CONTRACTOR TO SEAL AND MAKE WEATHER TIGHT
 ALL PENETRATIONS THROUGH ALUMINUM COMPOSITE
 PANELS.


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Design, Engineering & Construction Physical Resources Guelph, Ontario. N1G 2W1

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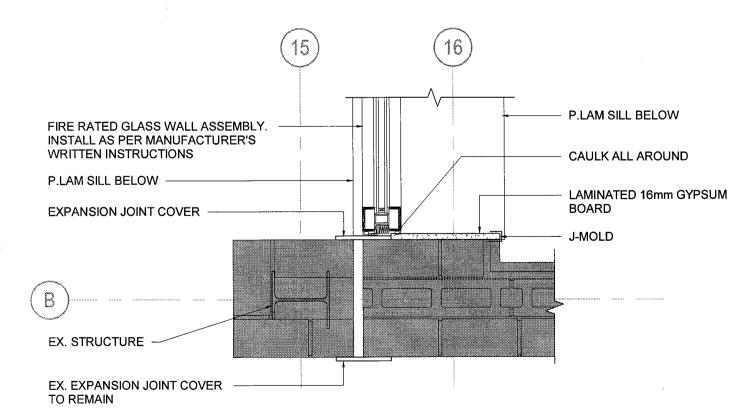
BUILDING #046 RENOVATIONS

Drawing Title


ARCHITECTURAL PLAN DETAILS

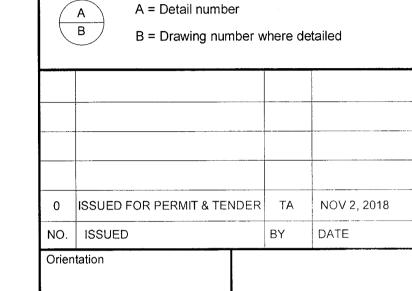Project No. 504034

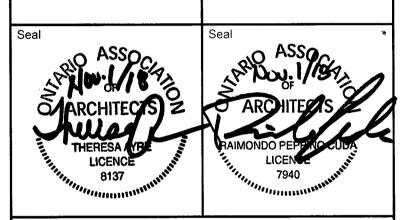Scale	Date
AS INDICATED	NOV 2, 2018
Drawn By DCJ	Drawing No.
Checked By TA	$\Lambda \Lambda \Omega$
Approved By	
RPC	
JLR #:	
27915	of 170





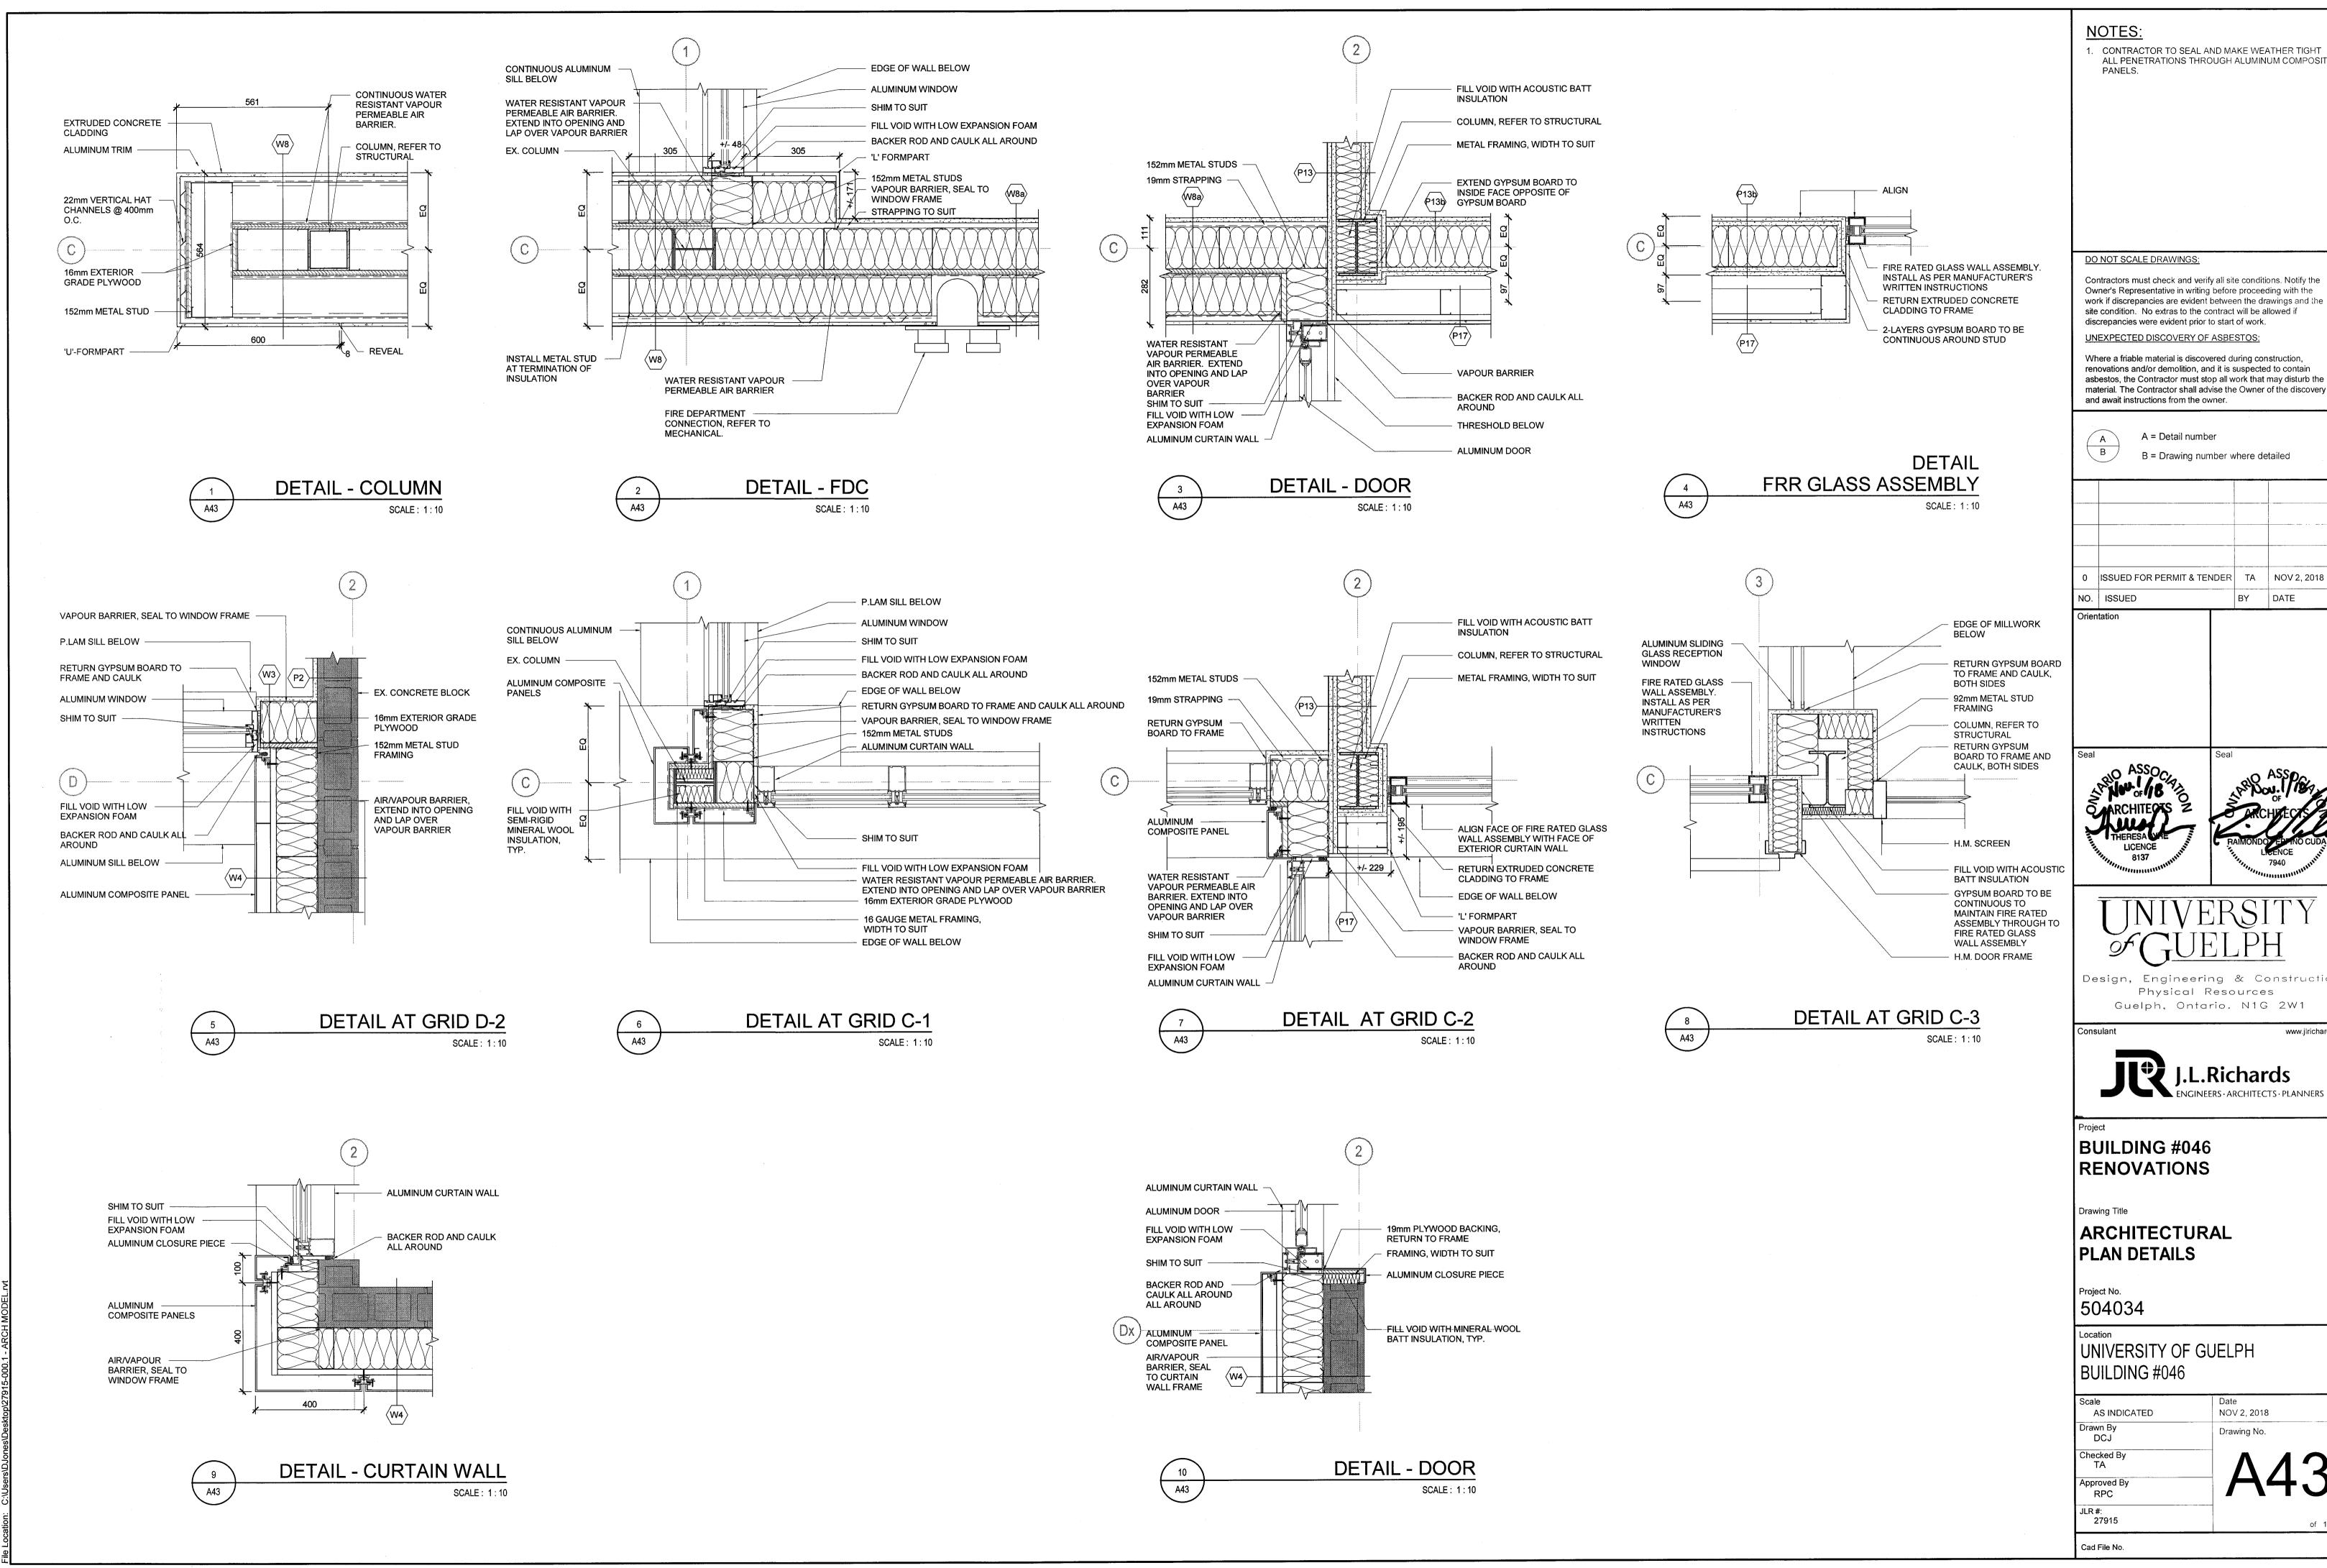

1. CONTRACTOR TO SEAL AND MAKE WEATHER TIGHT ALL PENETRATIONS THROUGH ALUMINUM COMPOSITE

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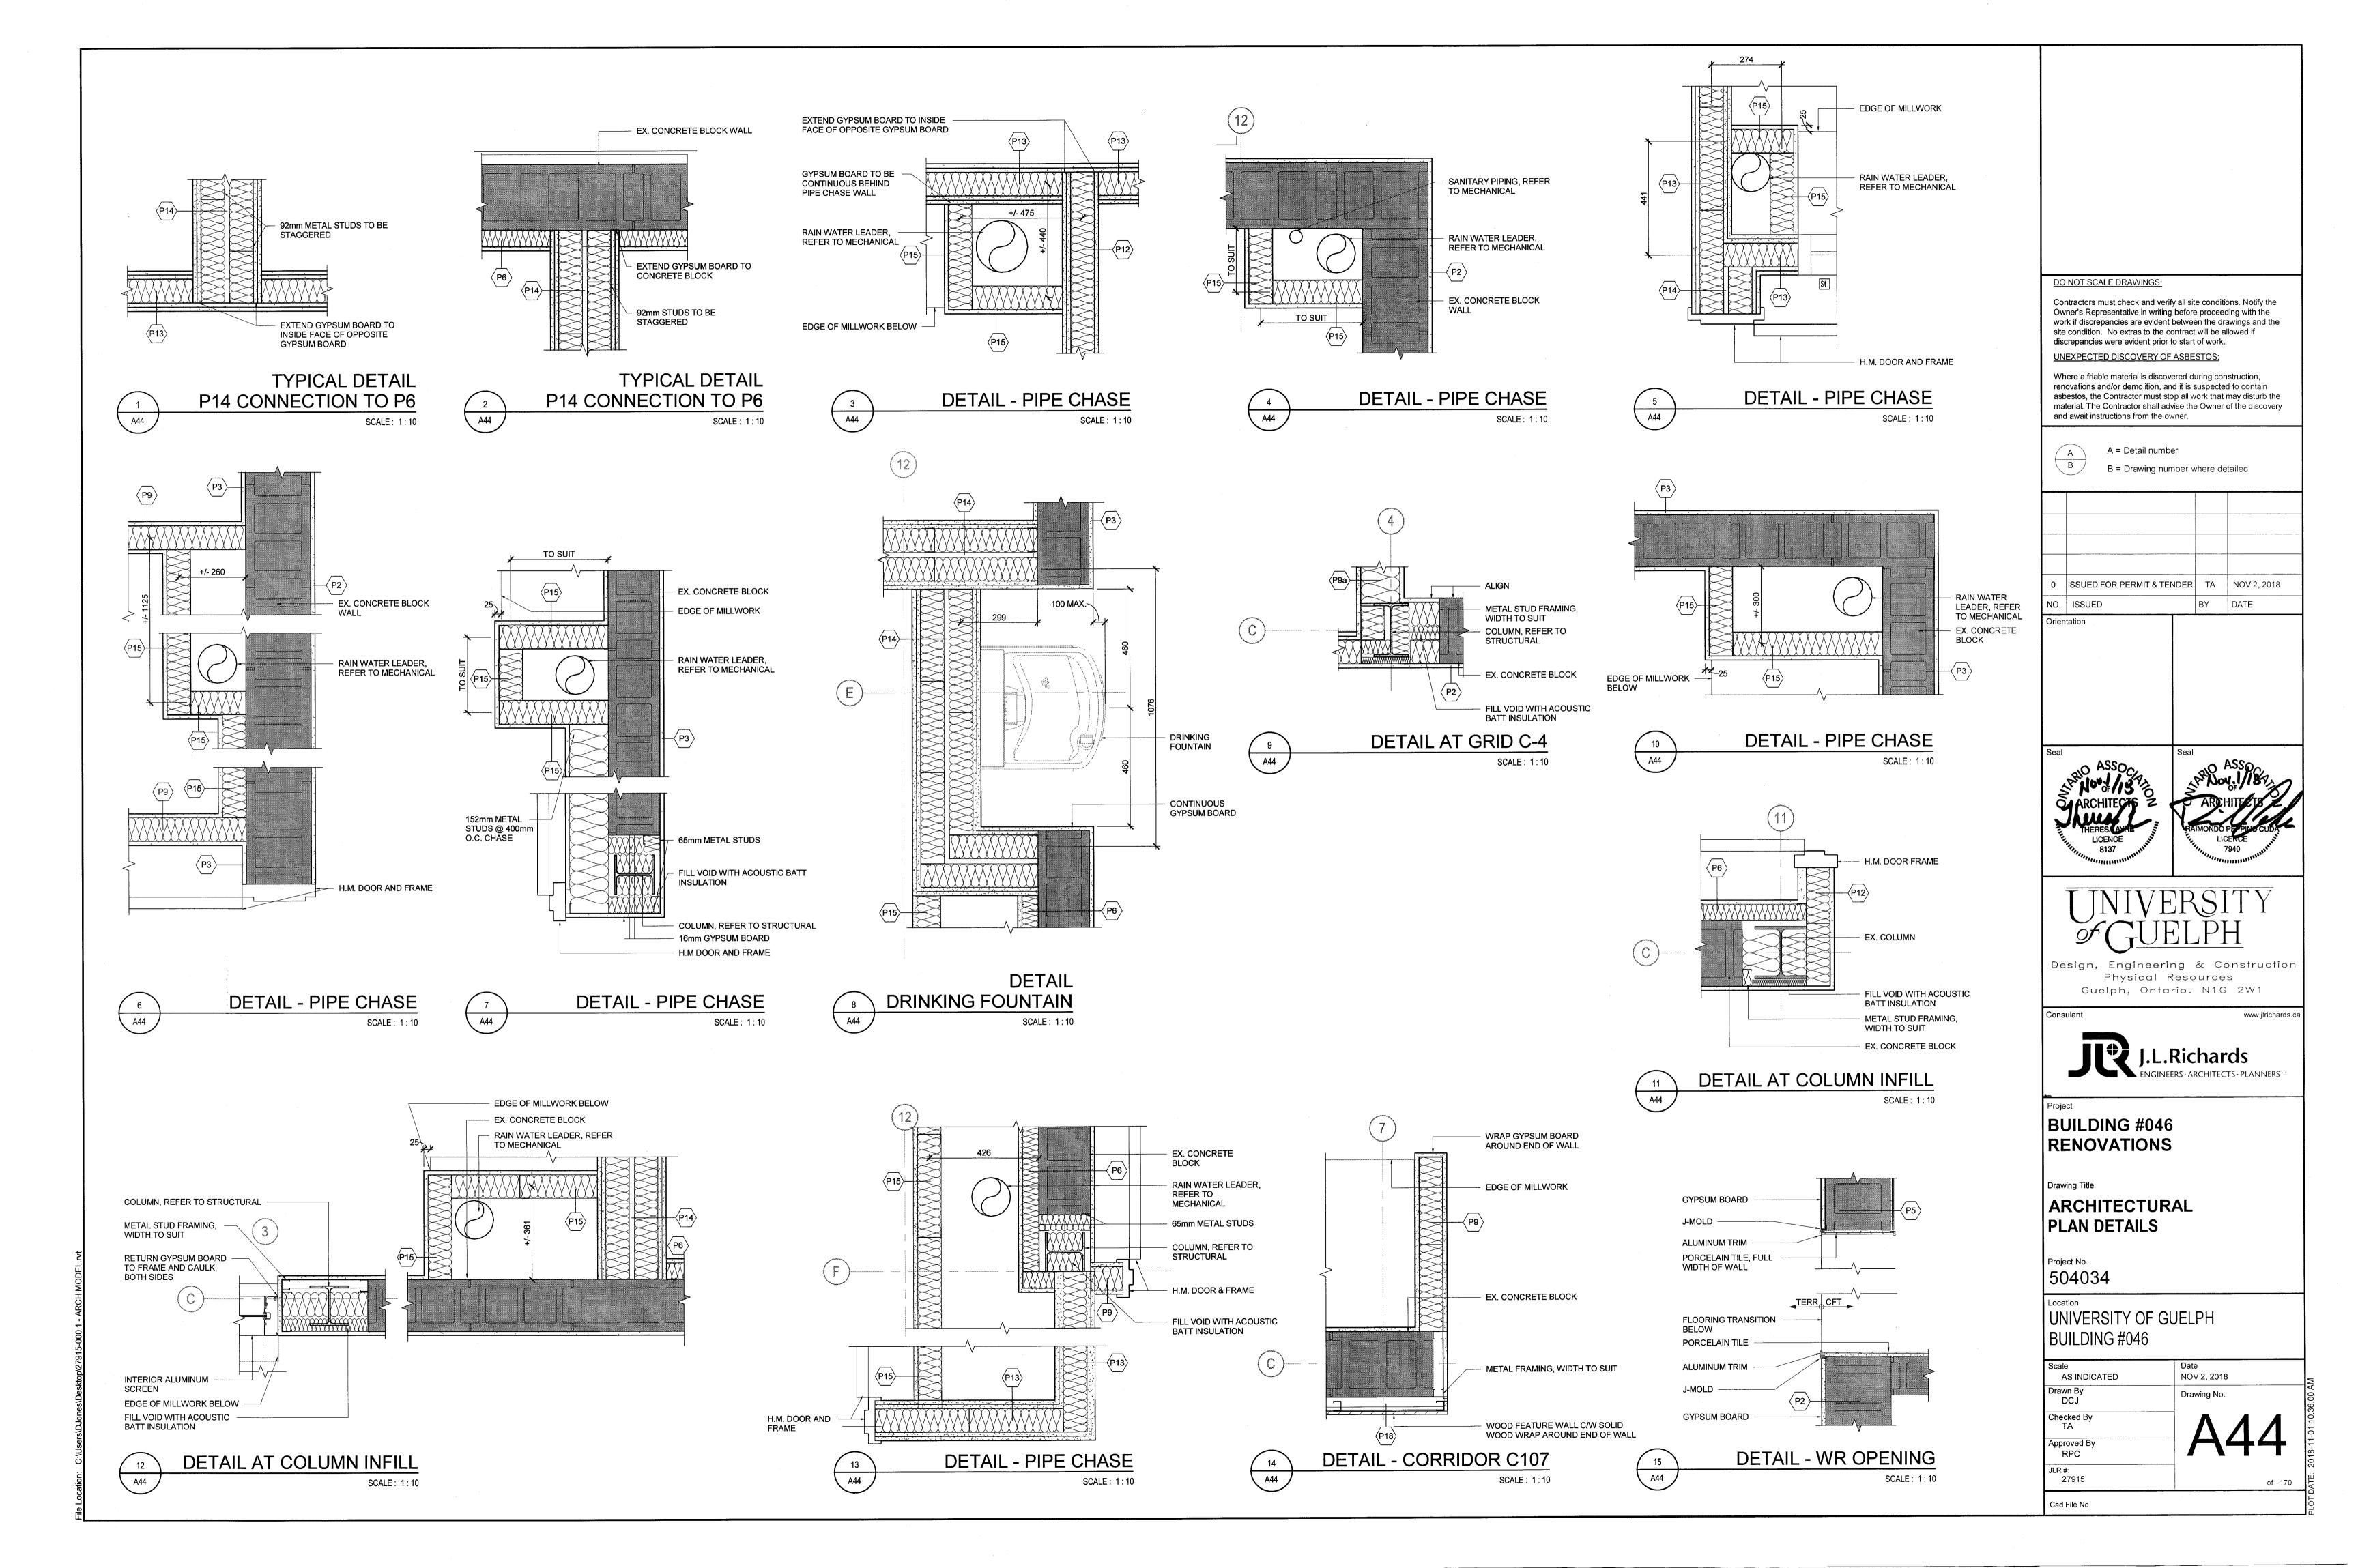
B = Drawing number where detailed





Design, Engineering & Construction Physical Resources


www.jlrichards.ca


NOV 2, 2018 of 170



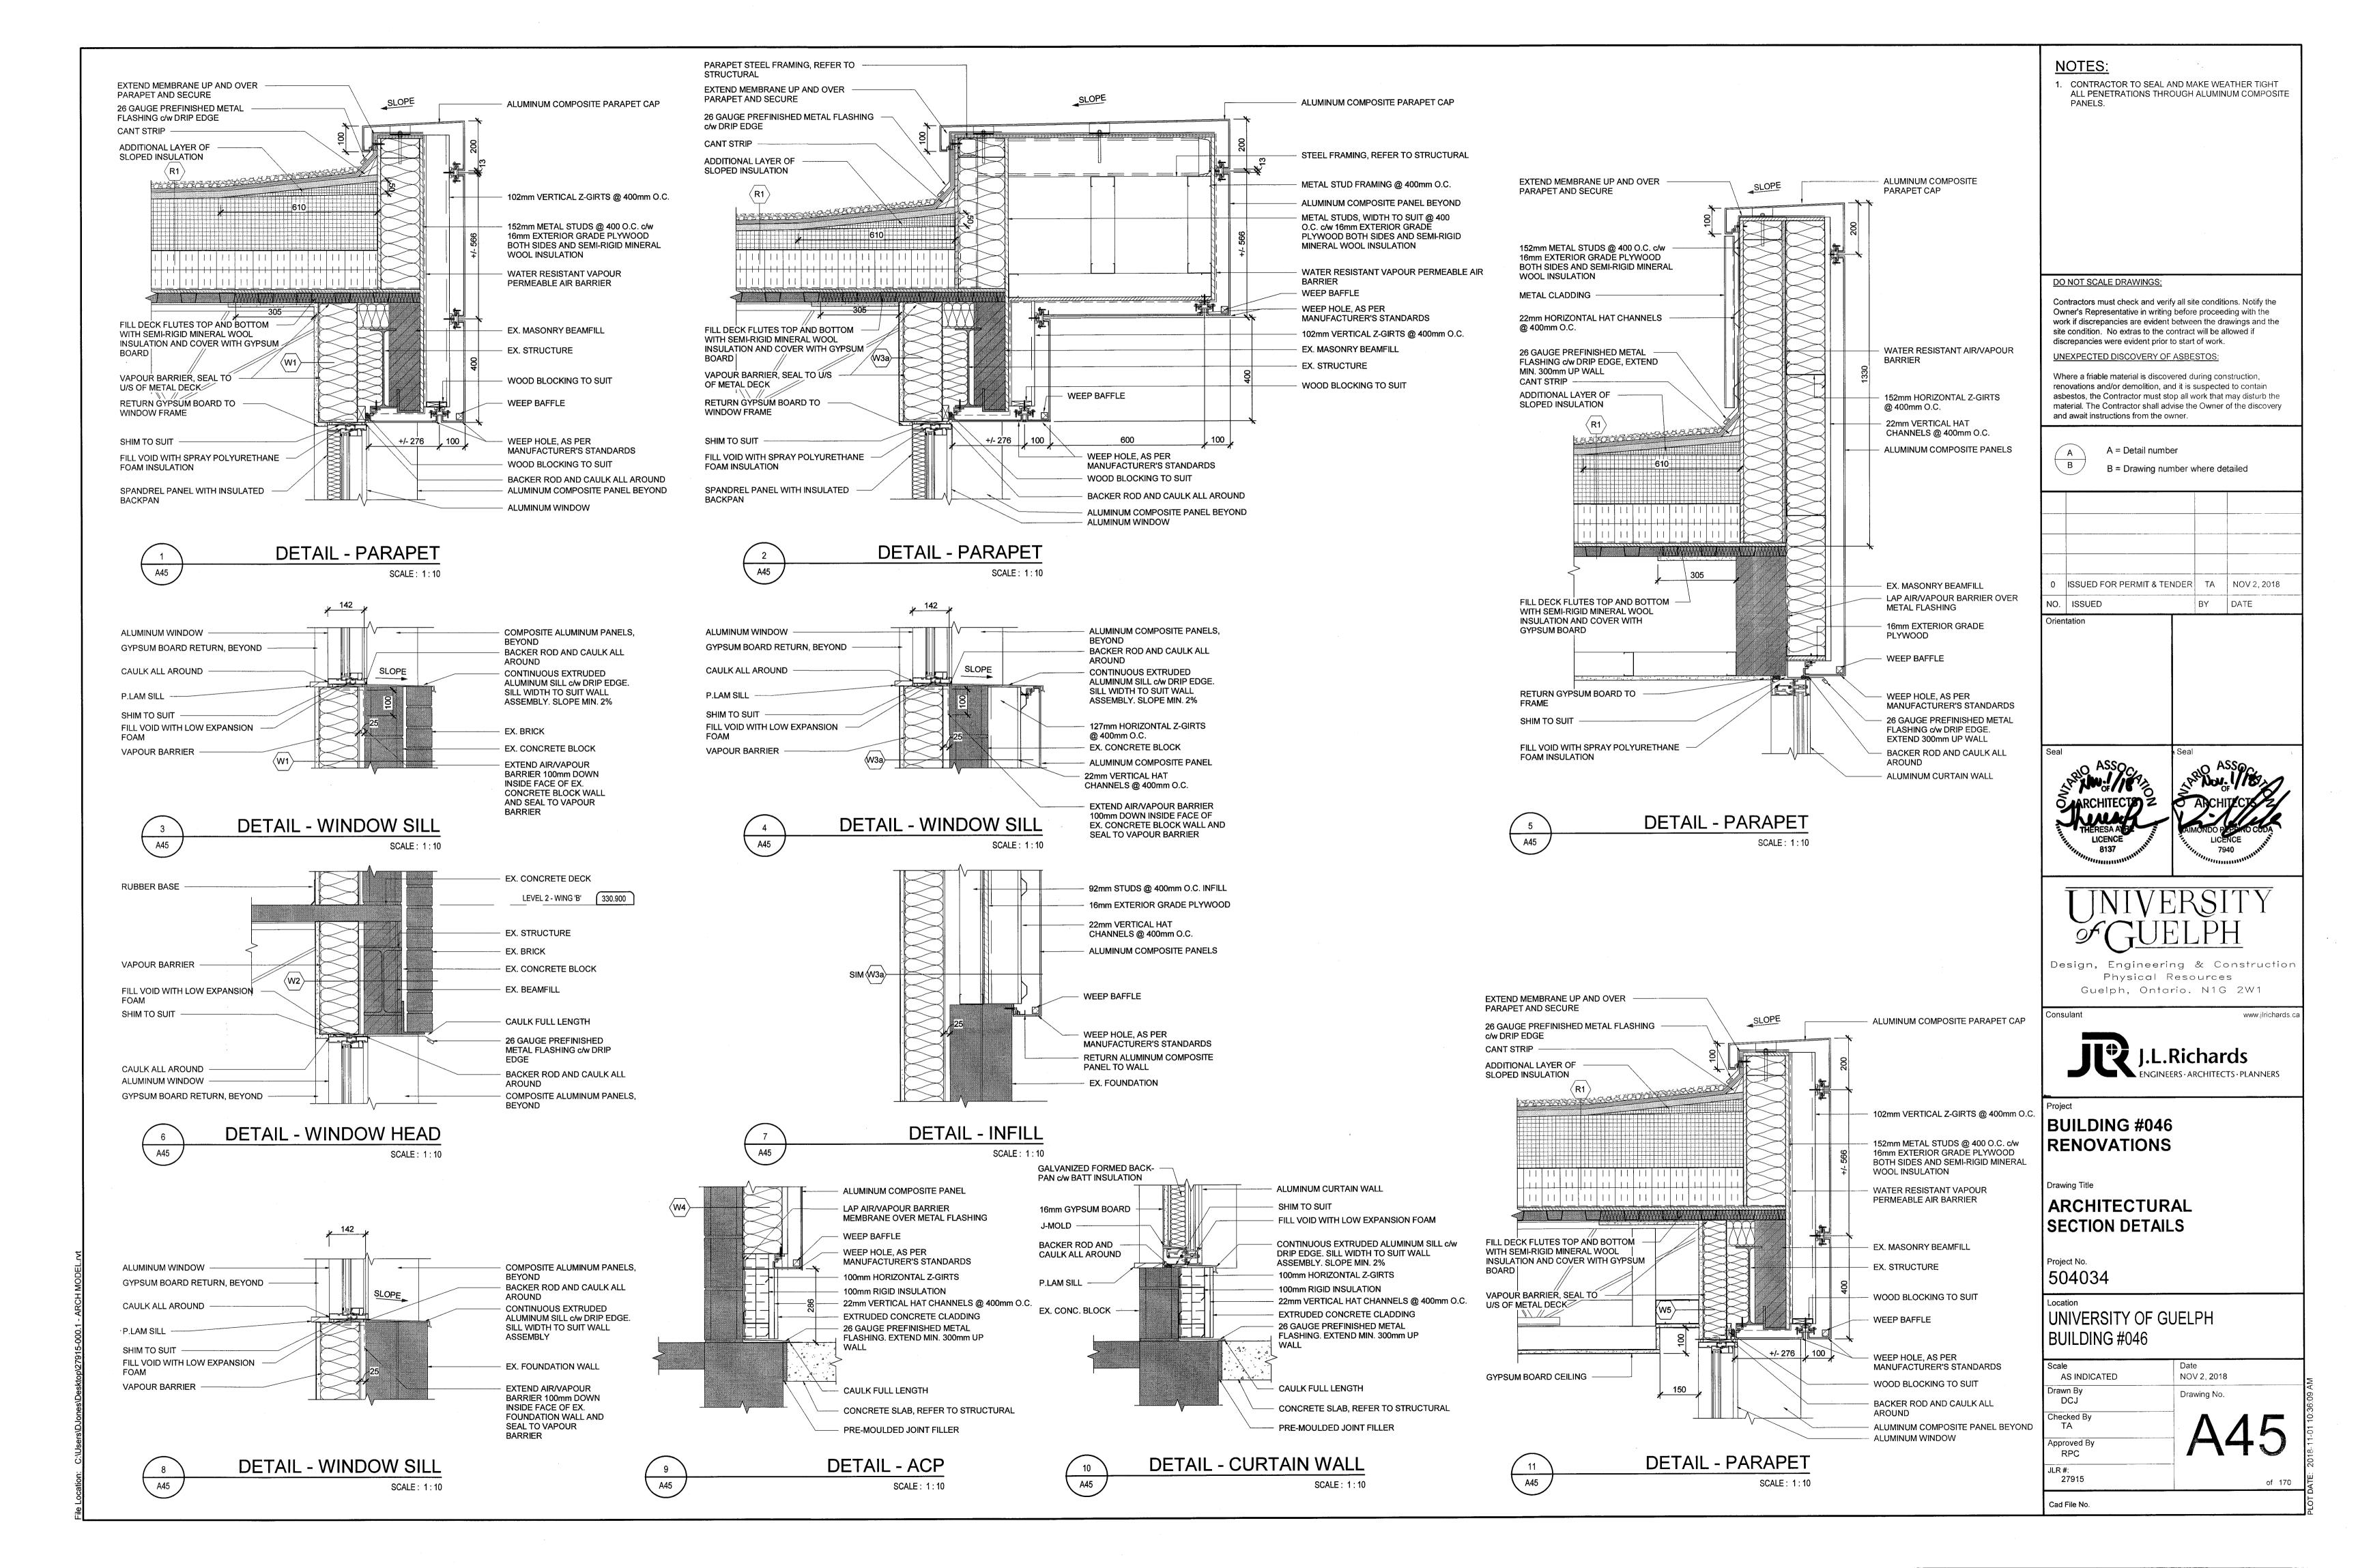

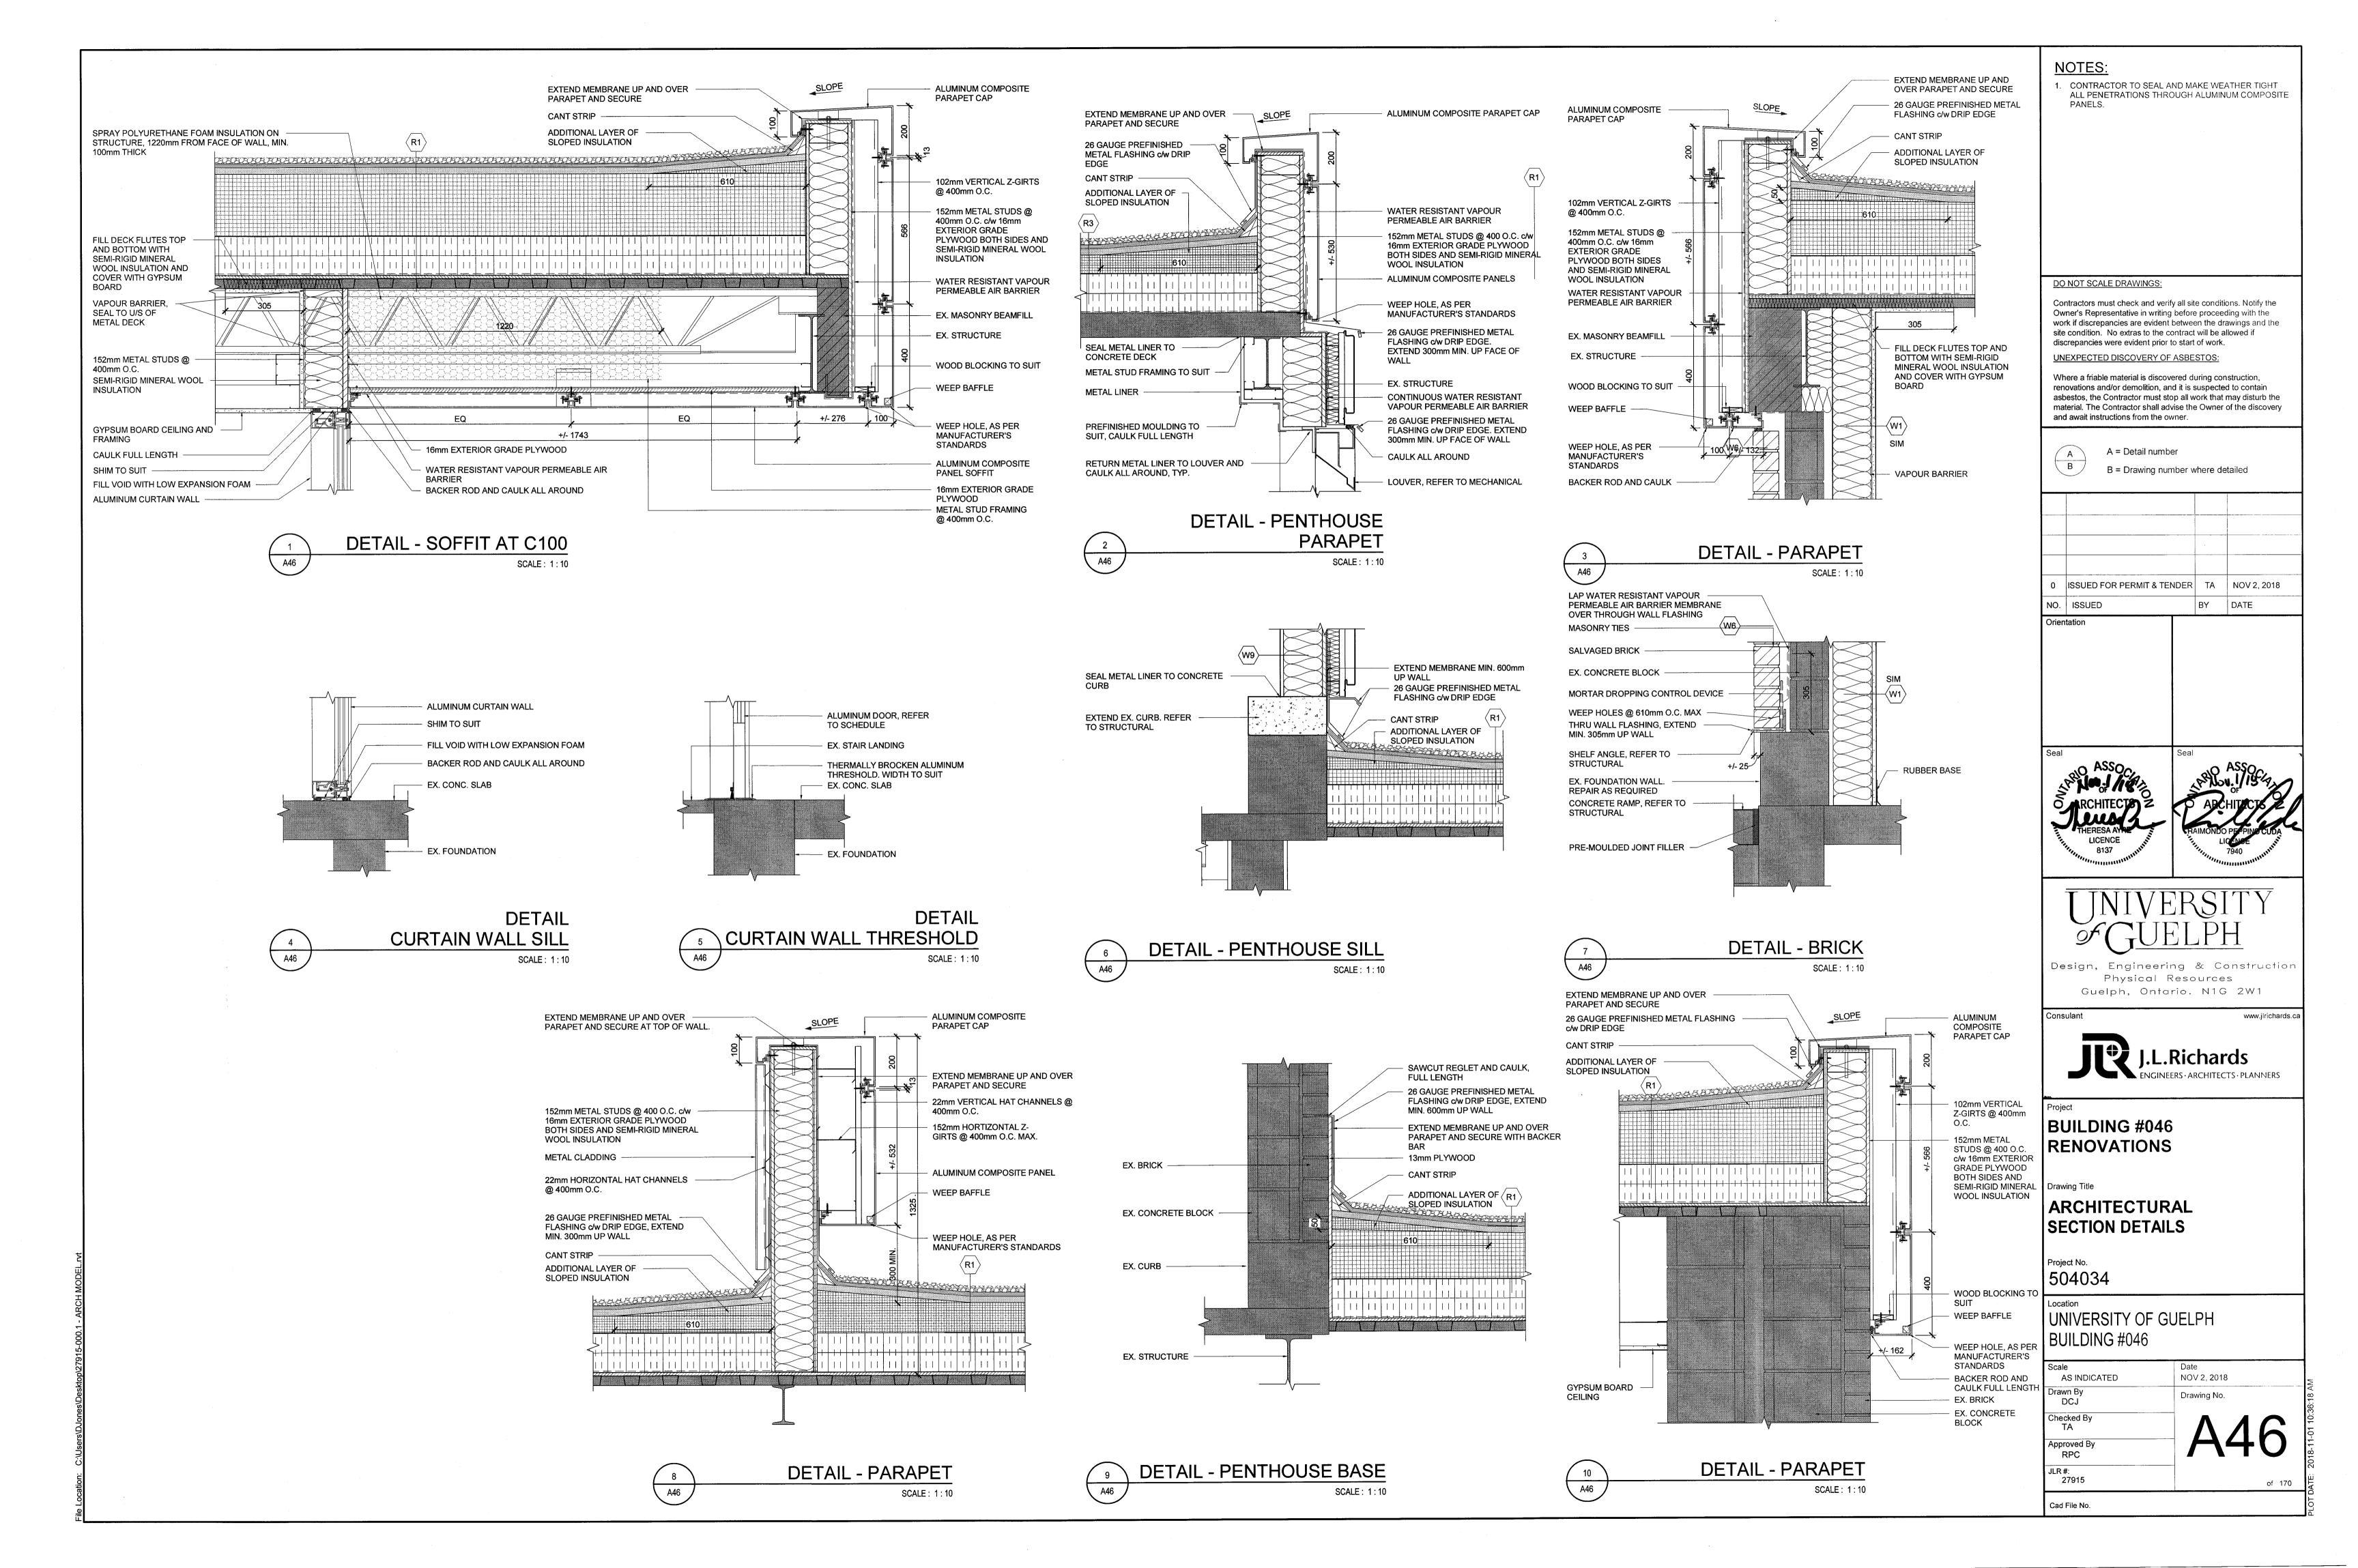


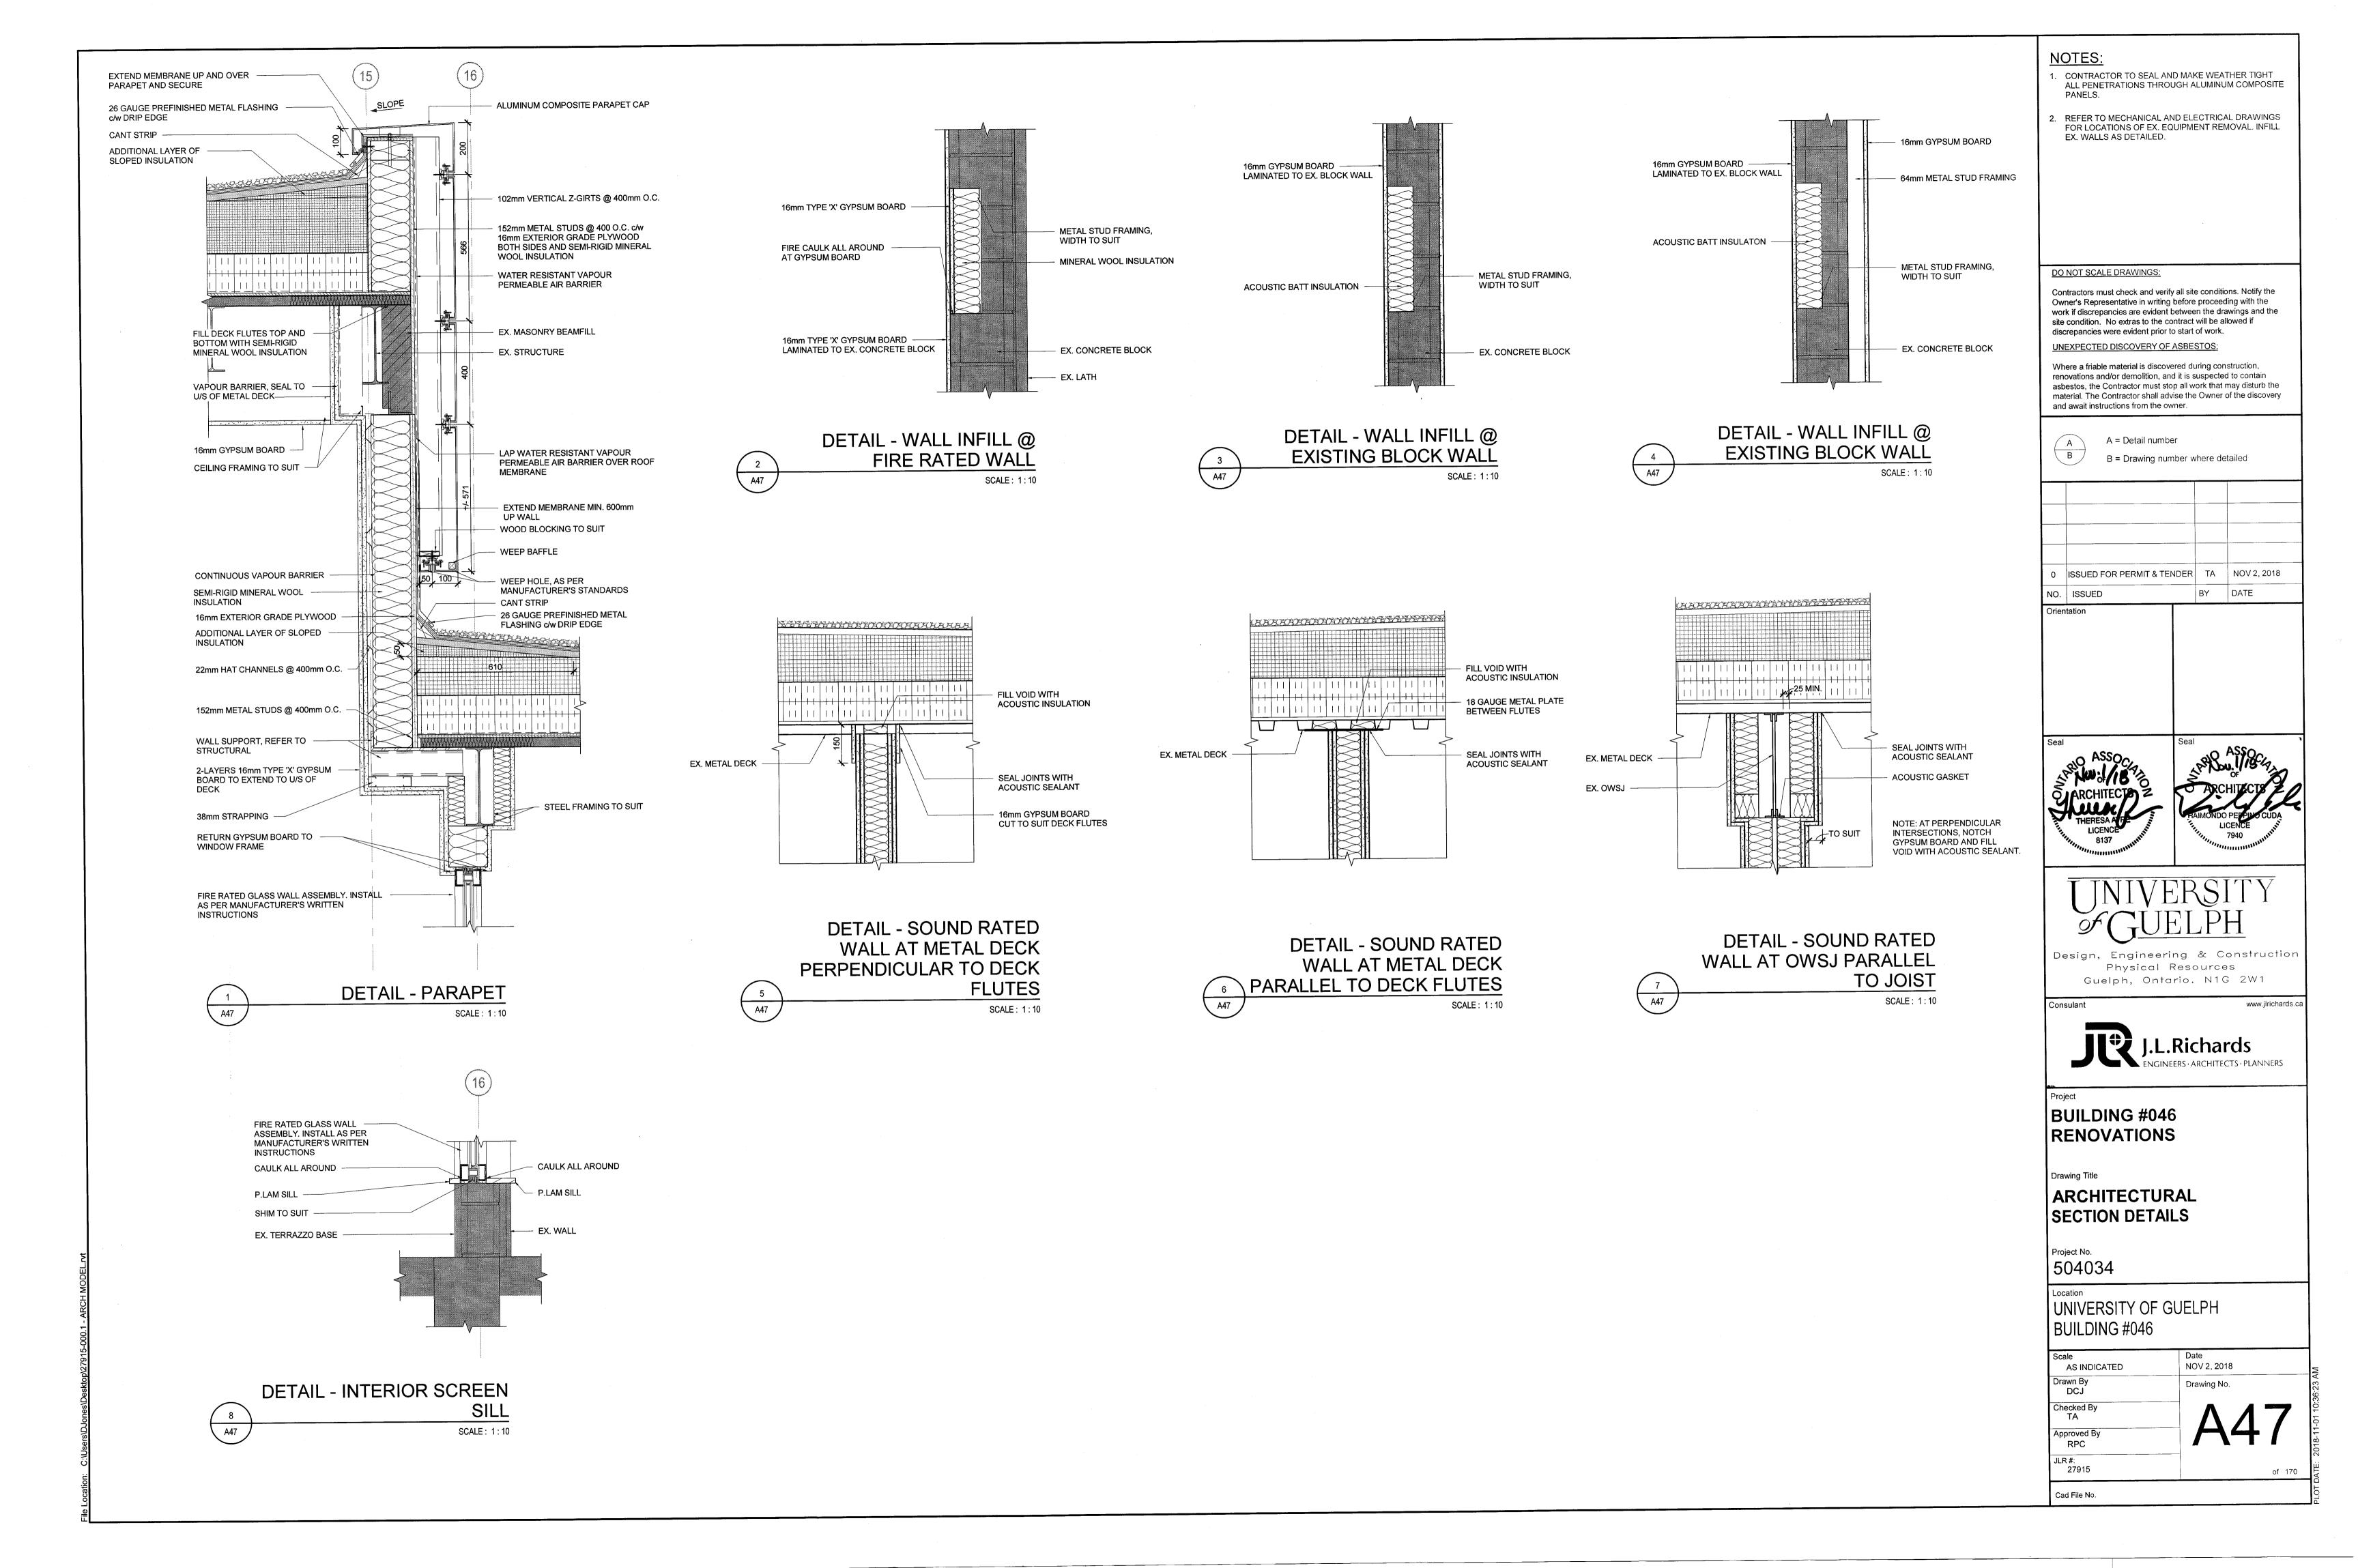

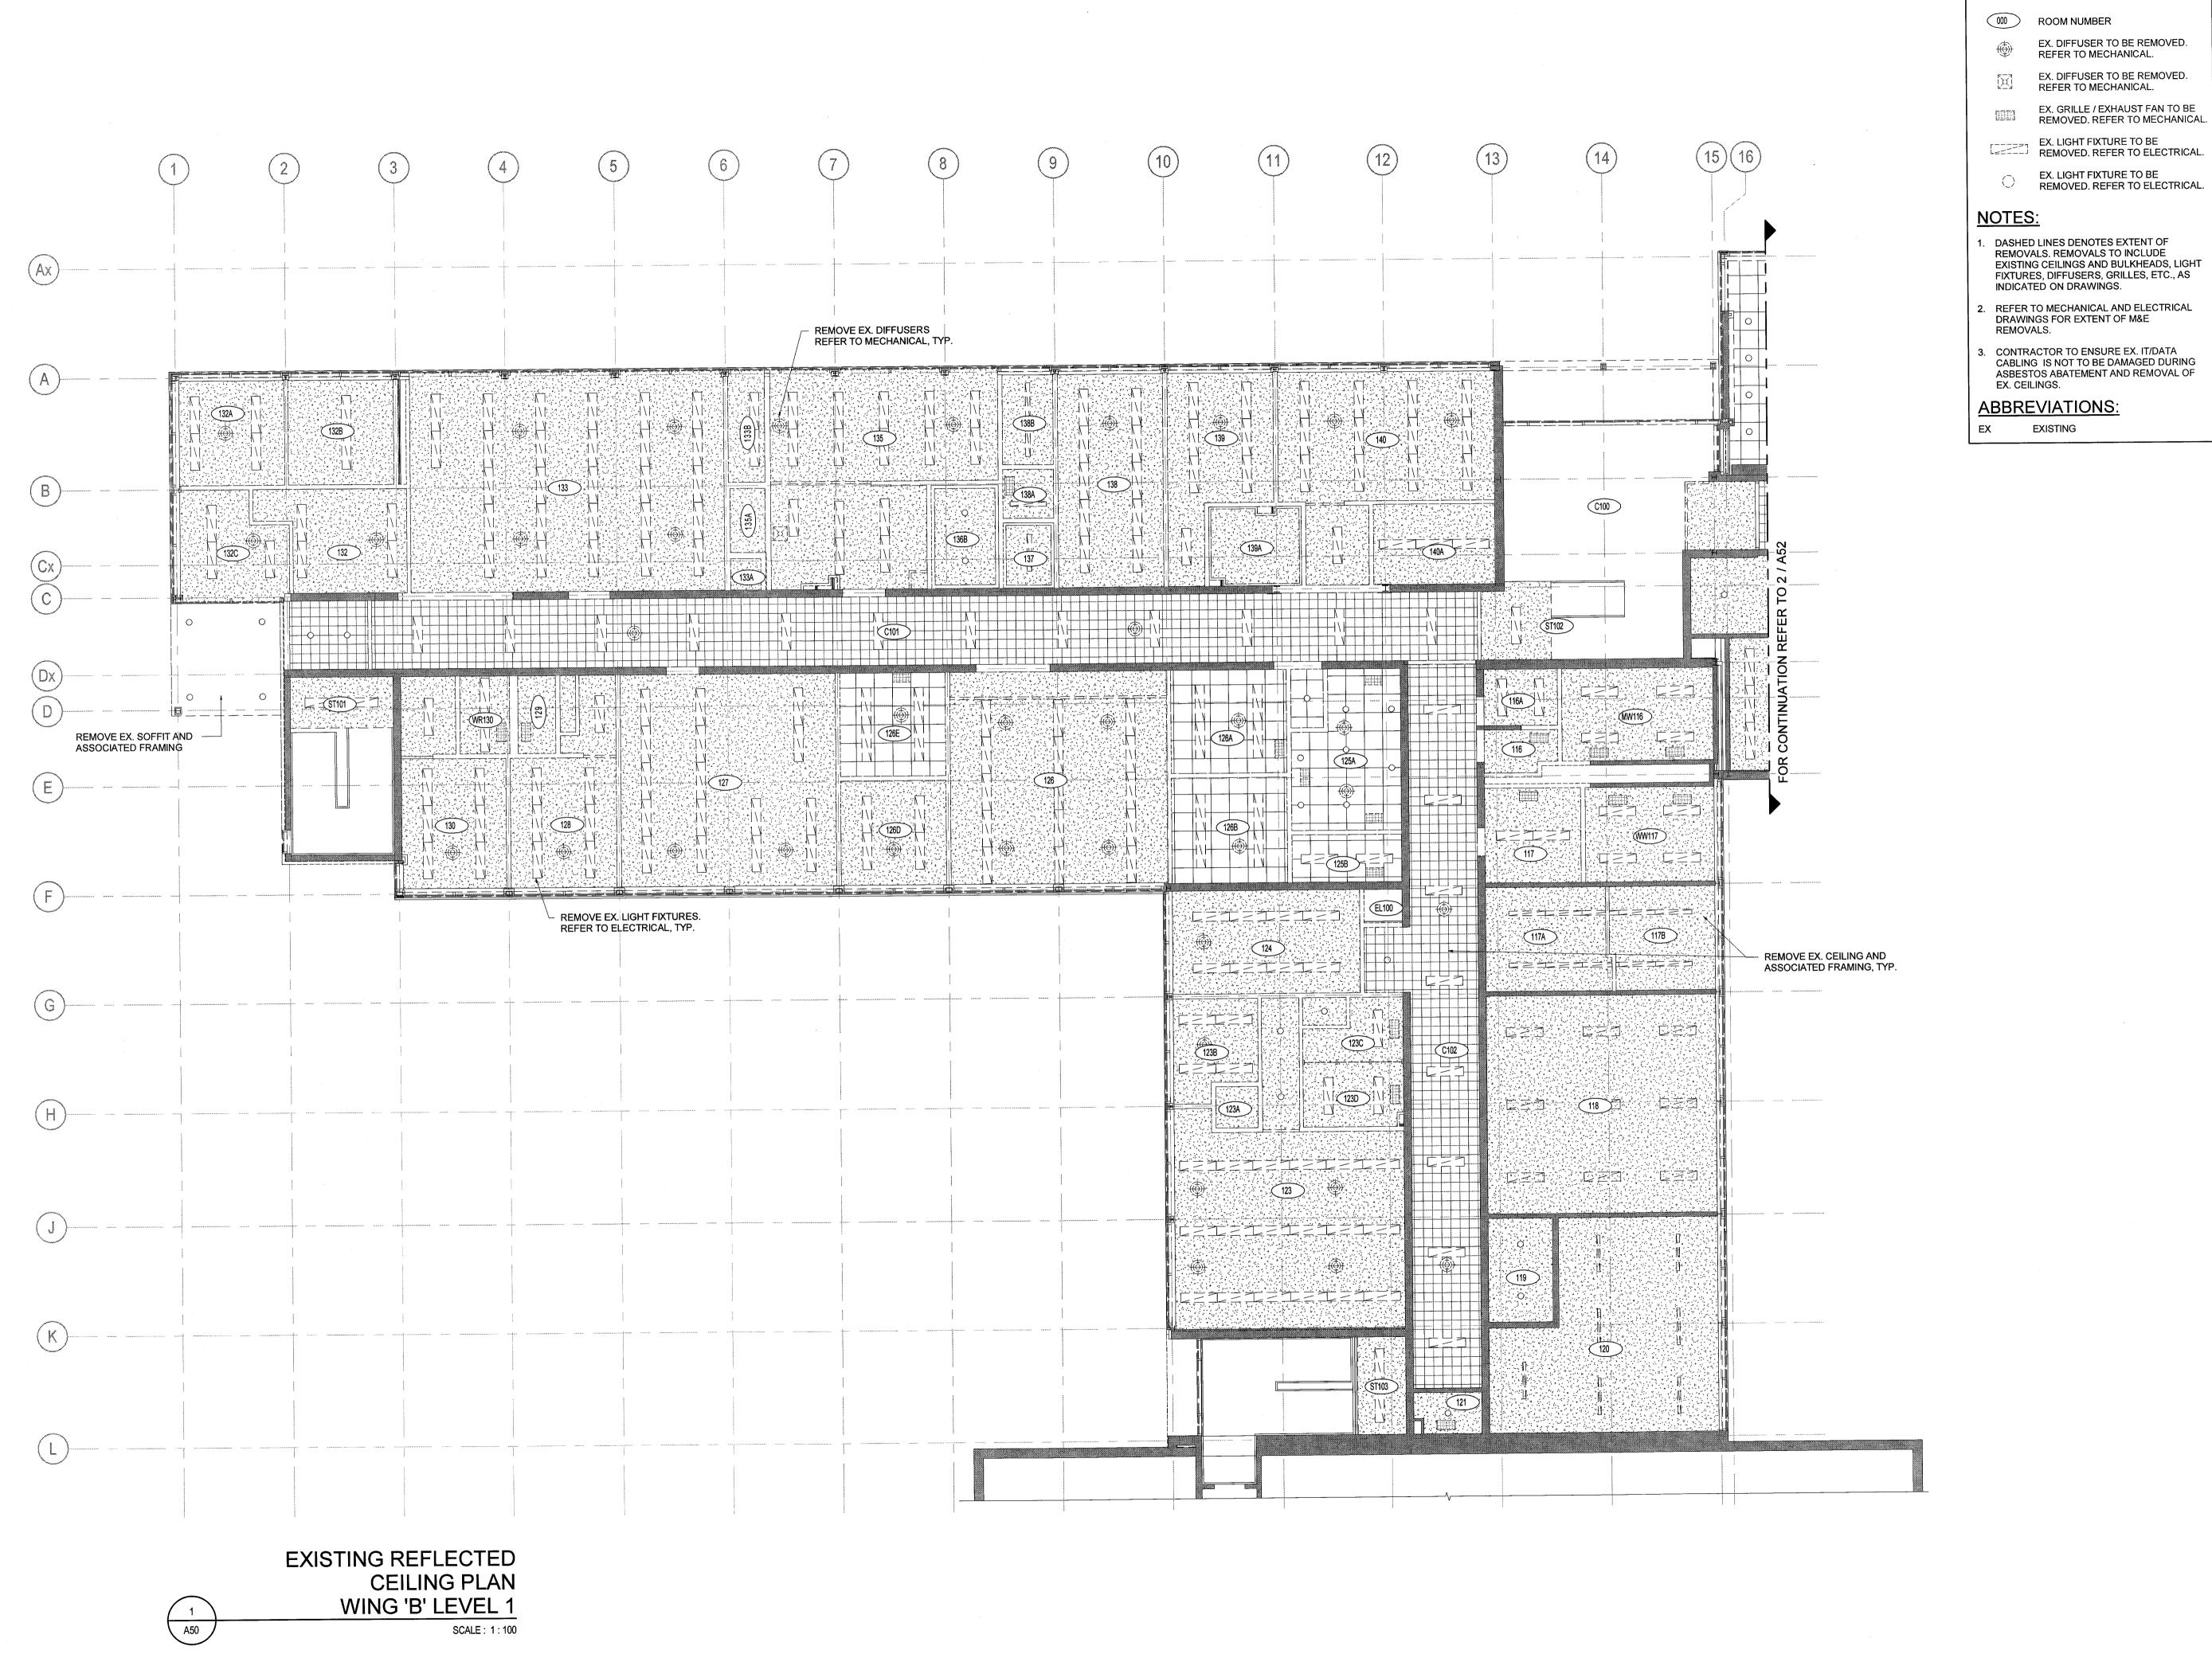

DASHED LINES DENOTES EXTENT OF EXISTING CEILINGS AND BULKHEADS, LIGHT FIXTURES, DIFFUSERS, GRILLES, ETC., AS

CABLING IS NOT TO BE DAMAGED DURING ASBESTOS ABATEMENT AND REMOVAL OF

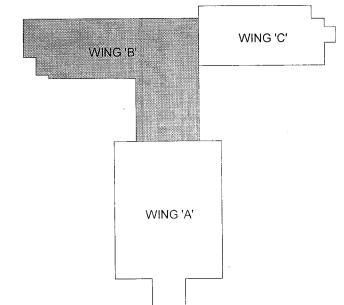

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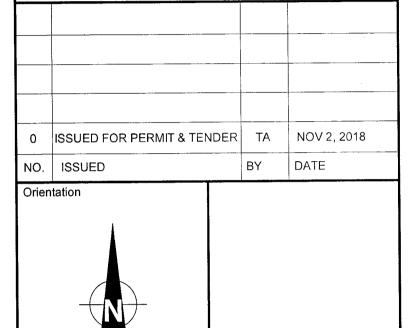
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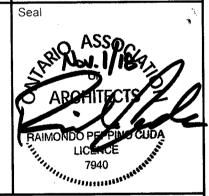


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Design, Engineering & Construction Physical Resources Guelph, Ontario. N1G 2W1

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BUILDING #046 RENOVATIONS


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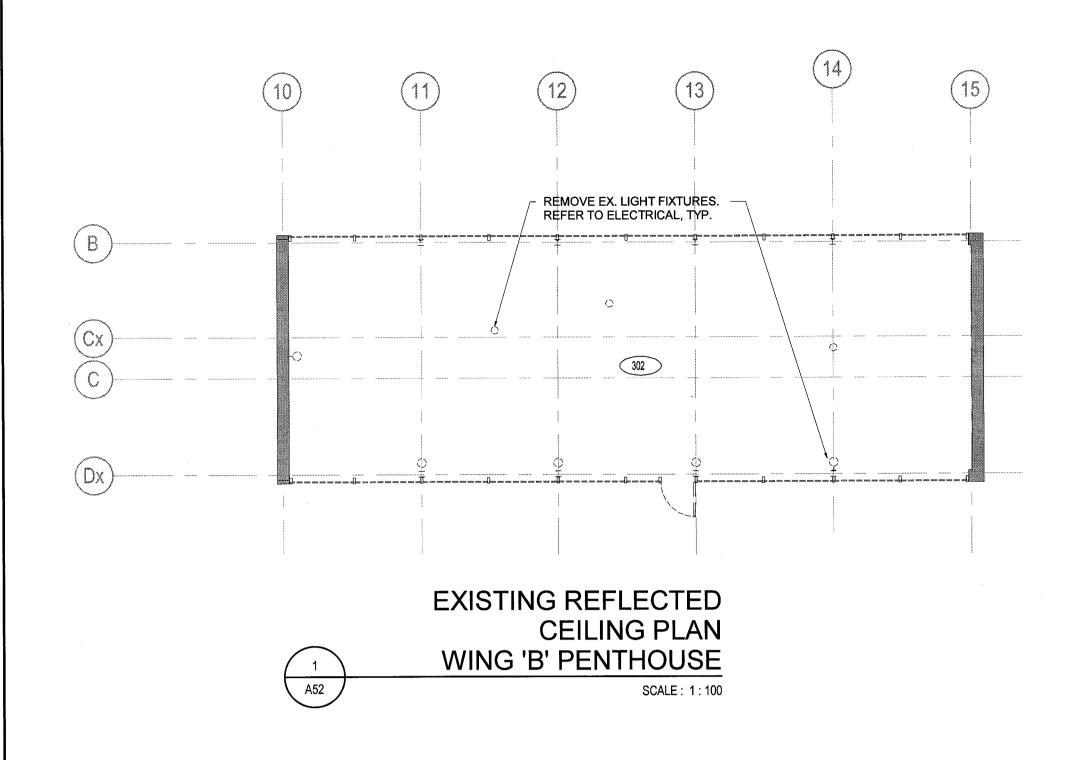
ARCHITECTURAL **EXISTING RCP** WING B LEVEL 1


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Cad File No.

Scale AS INDICATED	Date NOV 2, 2018
Drawn By DCJ	Drawing No.
Checked By TA	1 1 5 0
Approved By RPC	AJU
JLR #: 27915	of 170





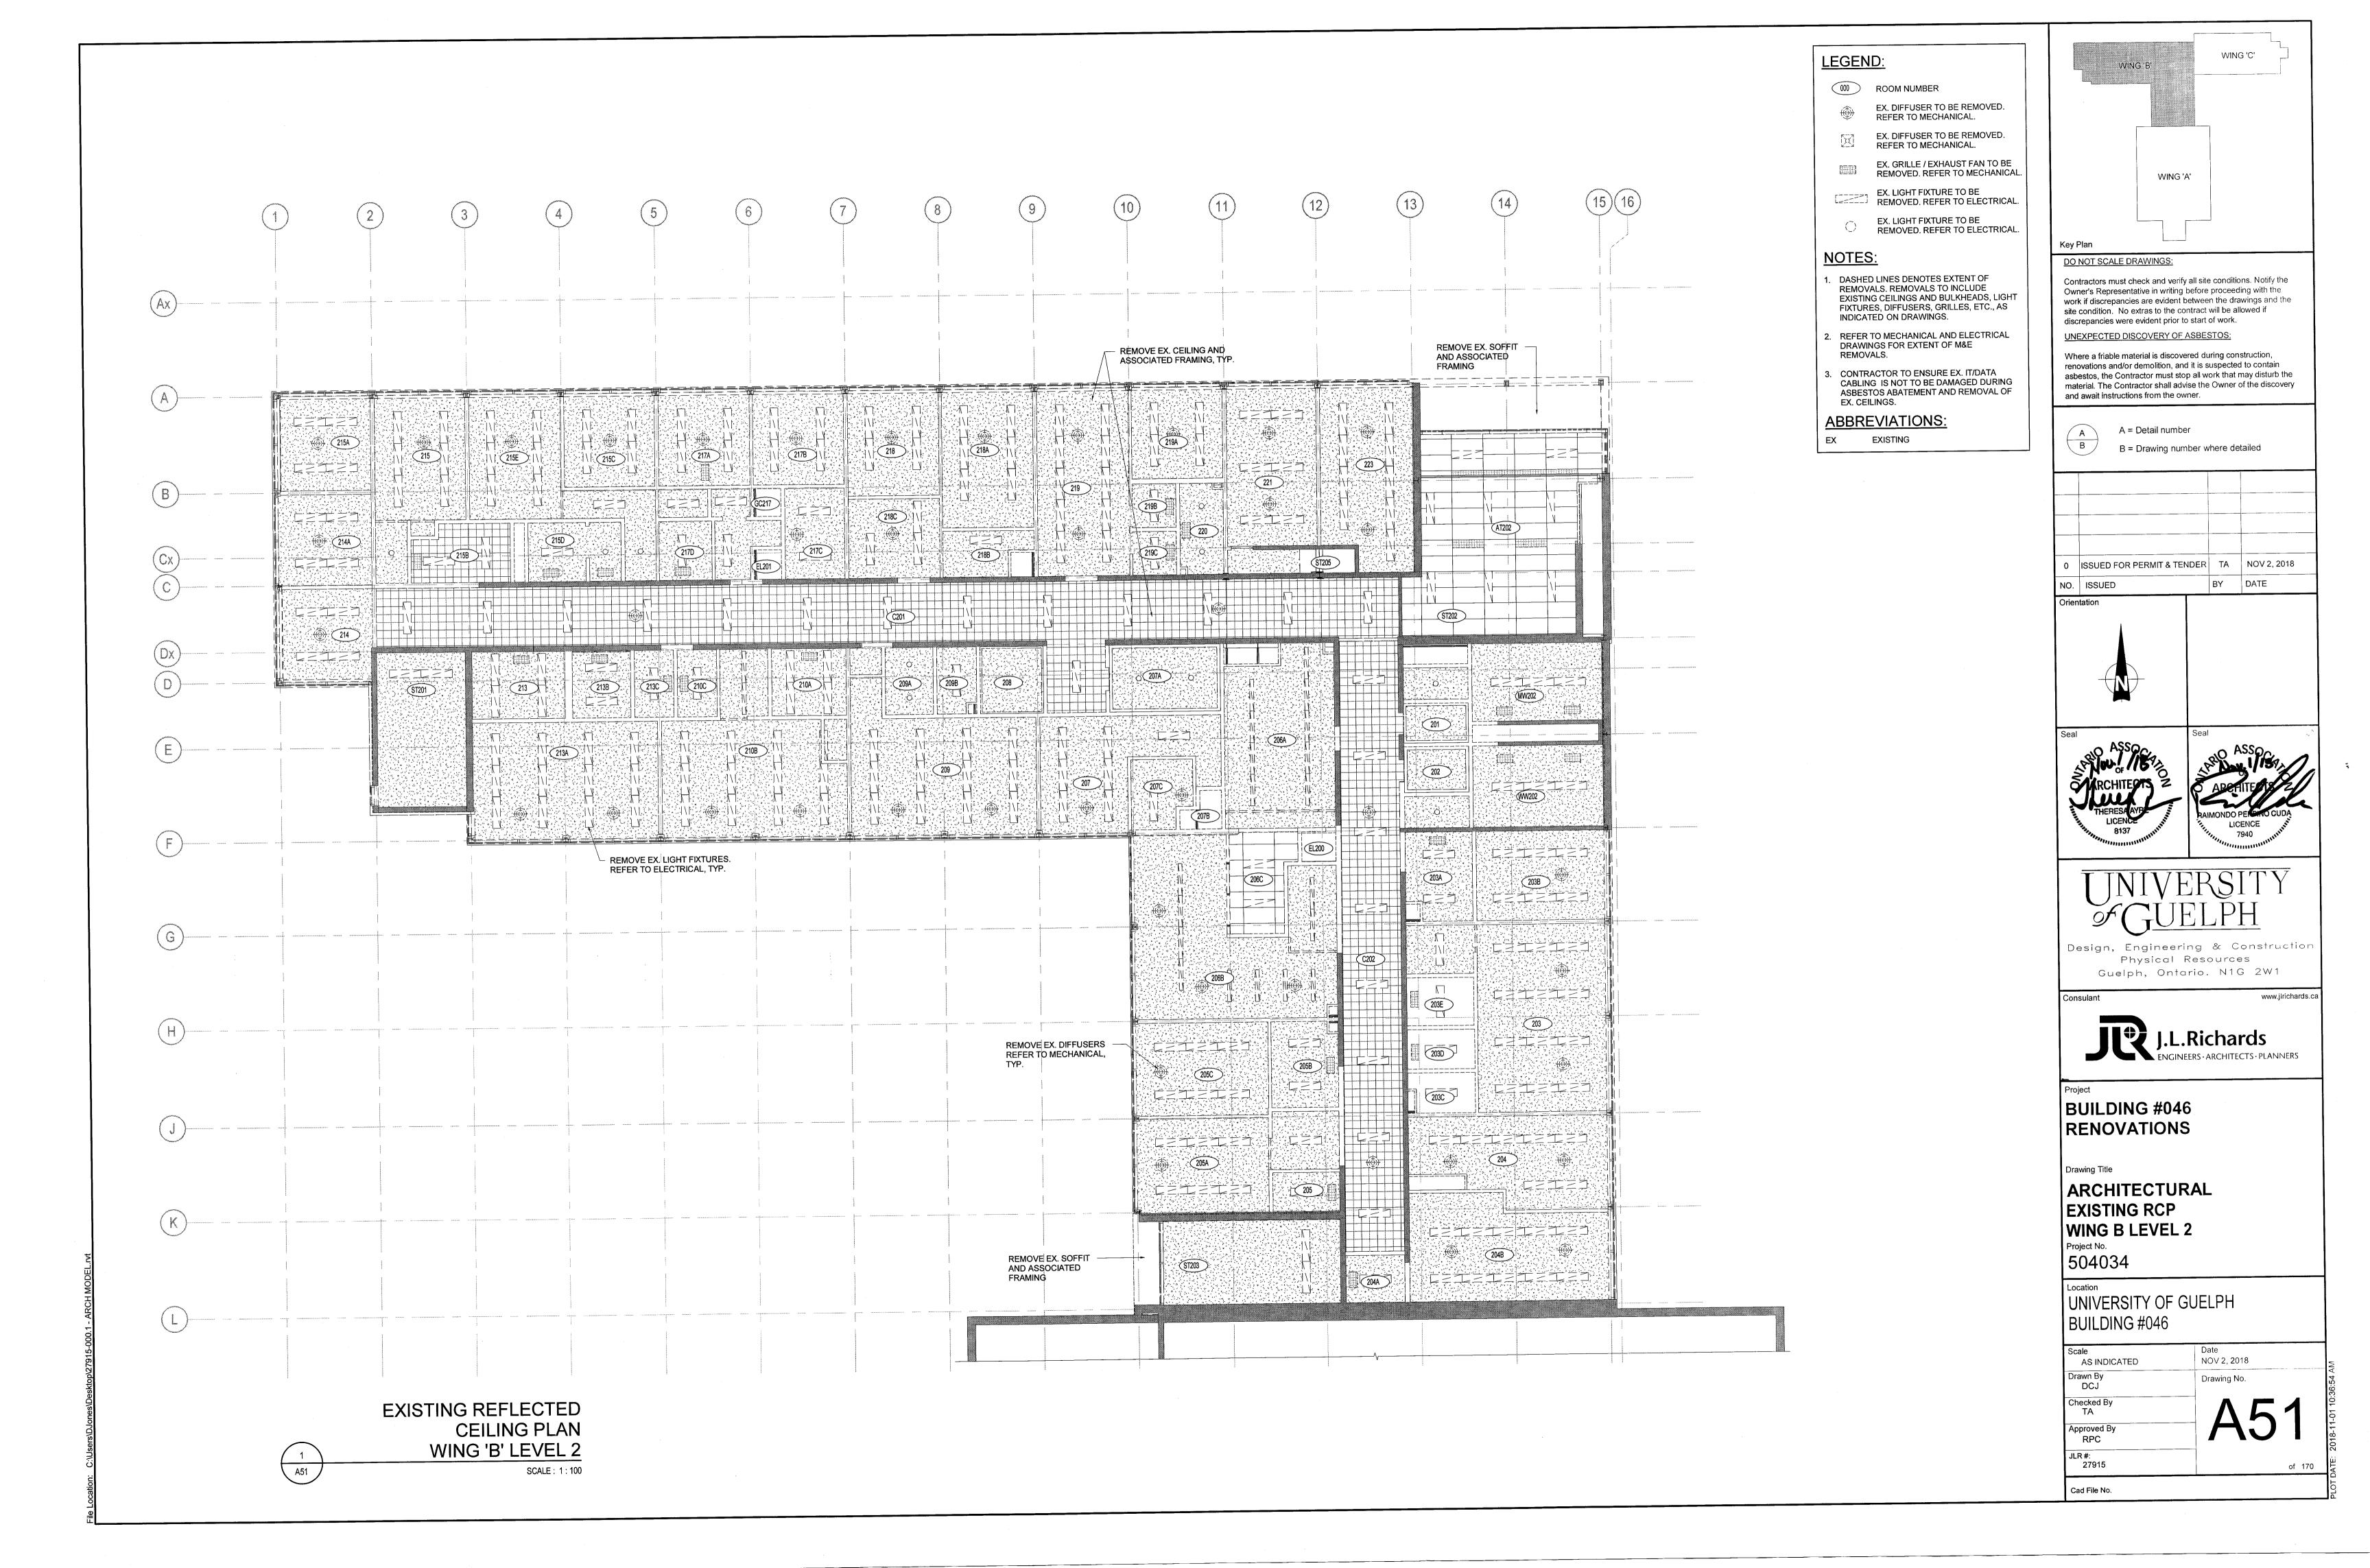

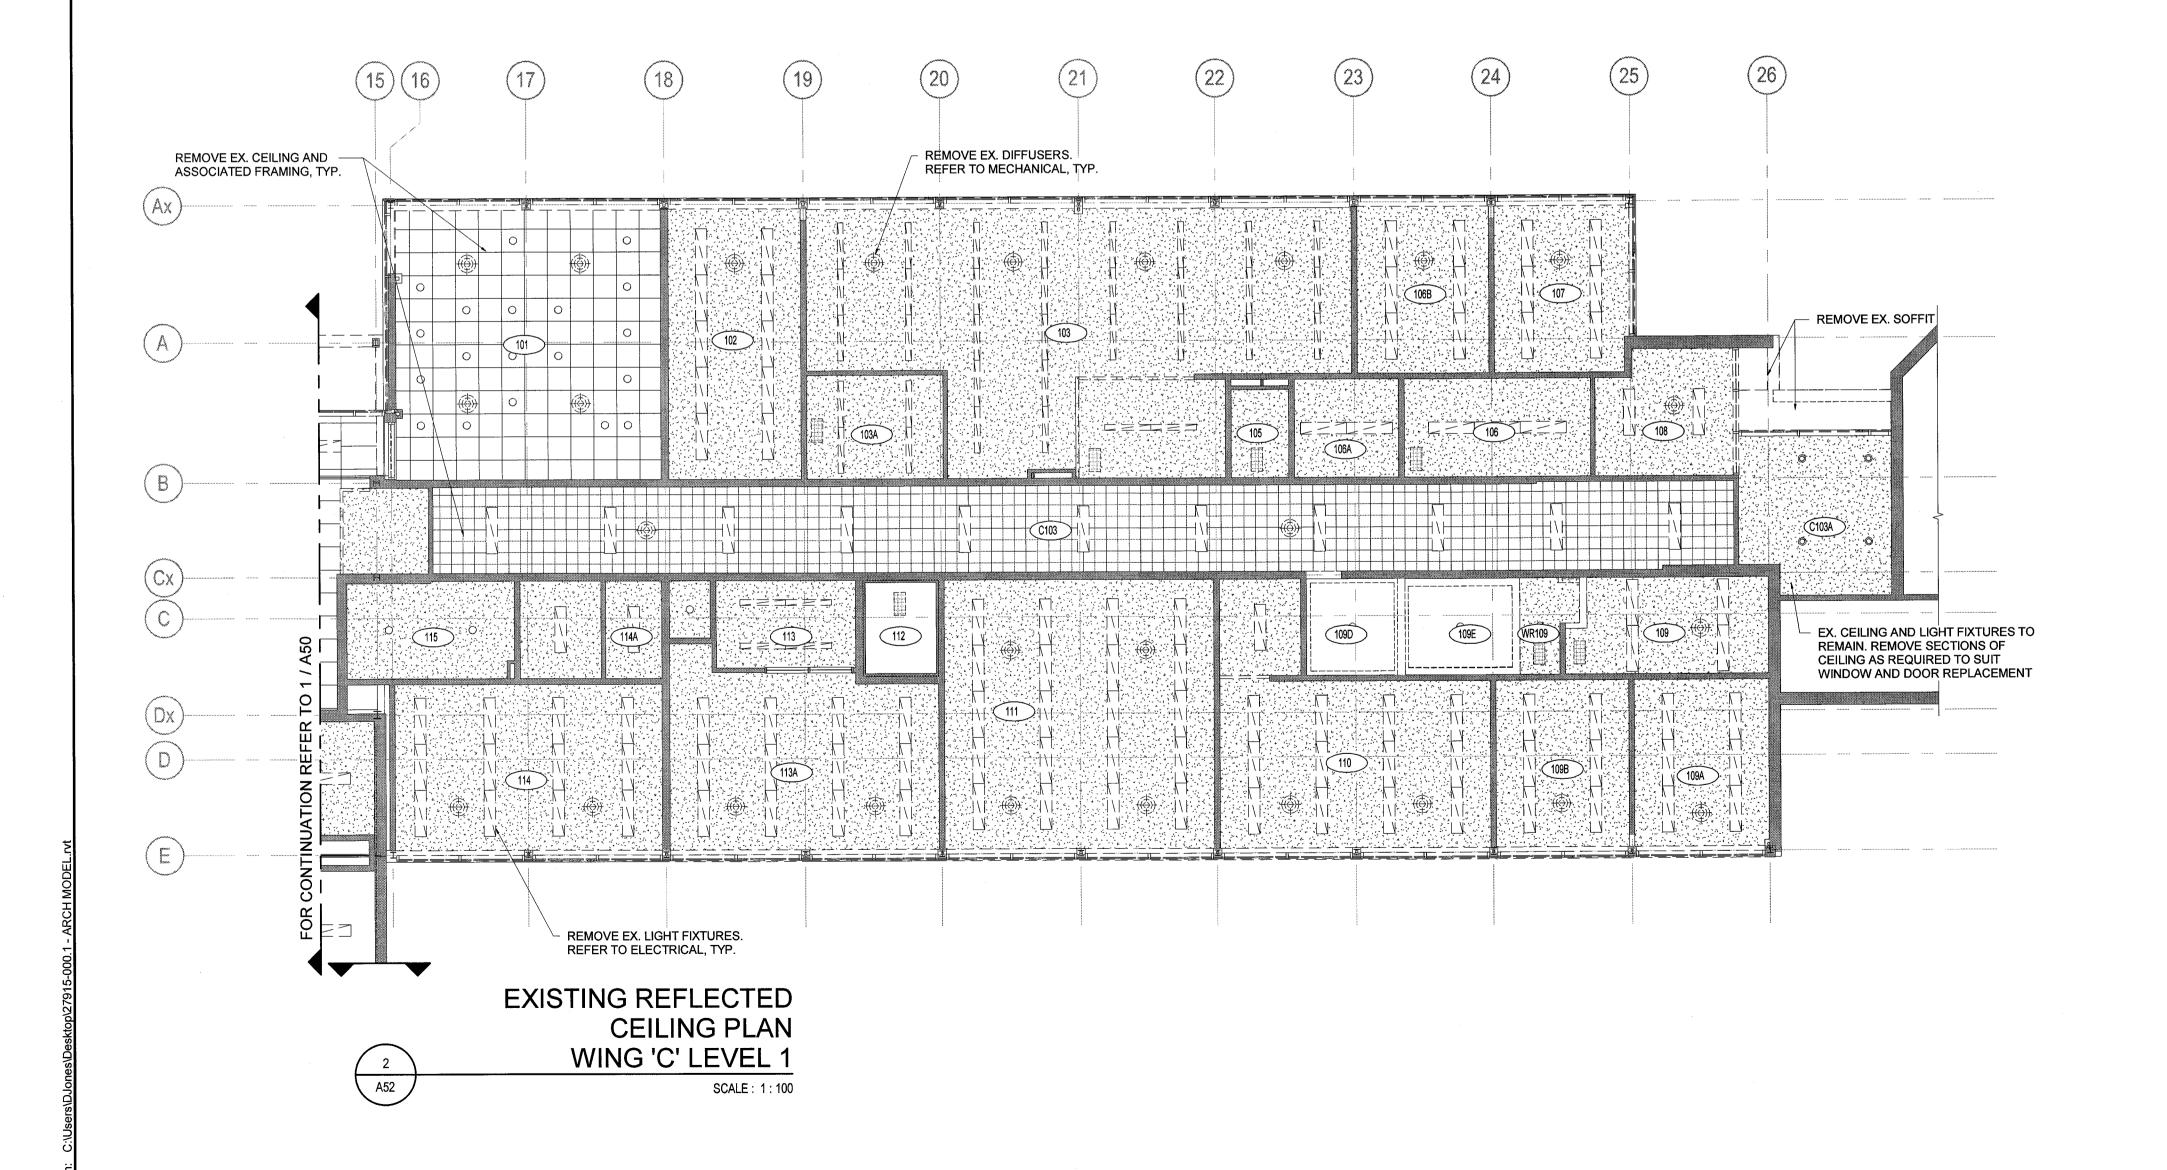LEGEND:

000 ROOM NUMBER

EX. DIFFUSER TO BE REMOVED. REFER TO MECHANICAL.

EX. DIFFUSER TO BE REMOVED.

REFER TO MECHANICAL.

EX. GRILLE / EXHAUST FAN TO BE REMOVED. REFER TO MECHANICAL

EX. LIGHT FIXTURE TO BE REMOVED. REFER TO ELECTRICAL.

EX. LIGHT FIXTURE TO BE REMOVED. REFER TO ELECTRICAL.

NOTES: . DASHED LINES DENOTES EXTENT OF

REMOVALS. REMOVALS TO INCLUDE EXISTING CEILINGS AND BULKHEADS, LIGHT FIXTURES, DIFFUSERS, GRILLES, ETC., AS INDICATED ON DRAWINGS.


. REFER TO MECHANICAL AND ELECTRICAL

DRAWINGS FOR EXTENT OF M&E REMOVALS.

. CONTRACTOR TO ENSURE EX. IT/DATA CABLING IS NOT TO BE DAMAGED DURING ASBESTOS ABATEMENT AND REMOVAL OF EX. CEILINGS.

ABBREVIATIONS:

EX EXISTING

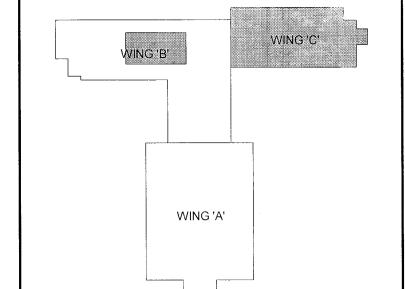

DO NOT SCALE DRAWINGS:

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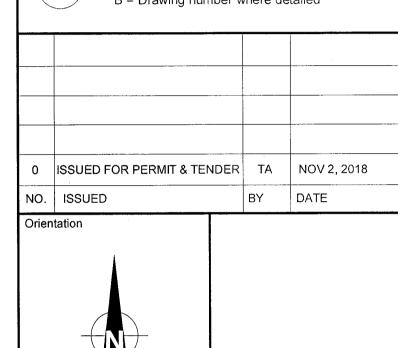
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Design, Engineering & Construction Physical Resources Guelph, Ontario. N1G 2W1

J.L.Richards

ENGINEERS · ARCHITECTS · PLANNERS

BUILDING #046 RENOVATIONS

Drawing Title


ARCHITECTURAL **EXISTING RCP** PENTHOUSE AND WING C


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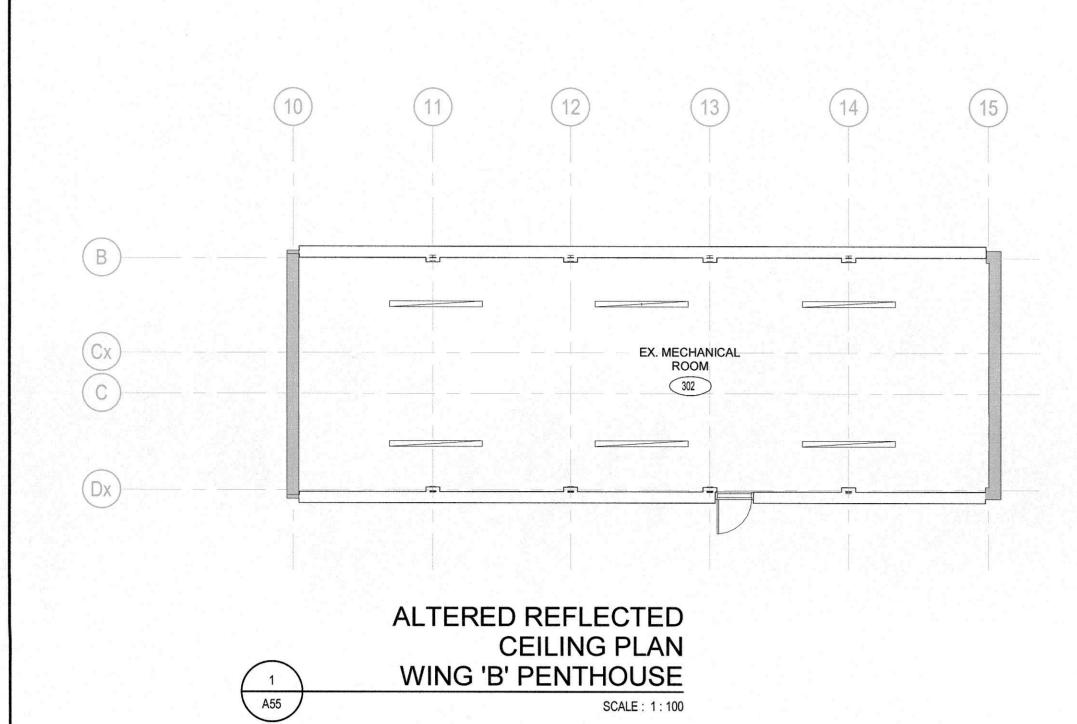
UNIVERSITY OF GUELPH BUILDING #046

Date
NOV 2, 2018
Drawing No.
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JLR#: 27915 of 170 Cad File No.






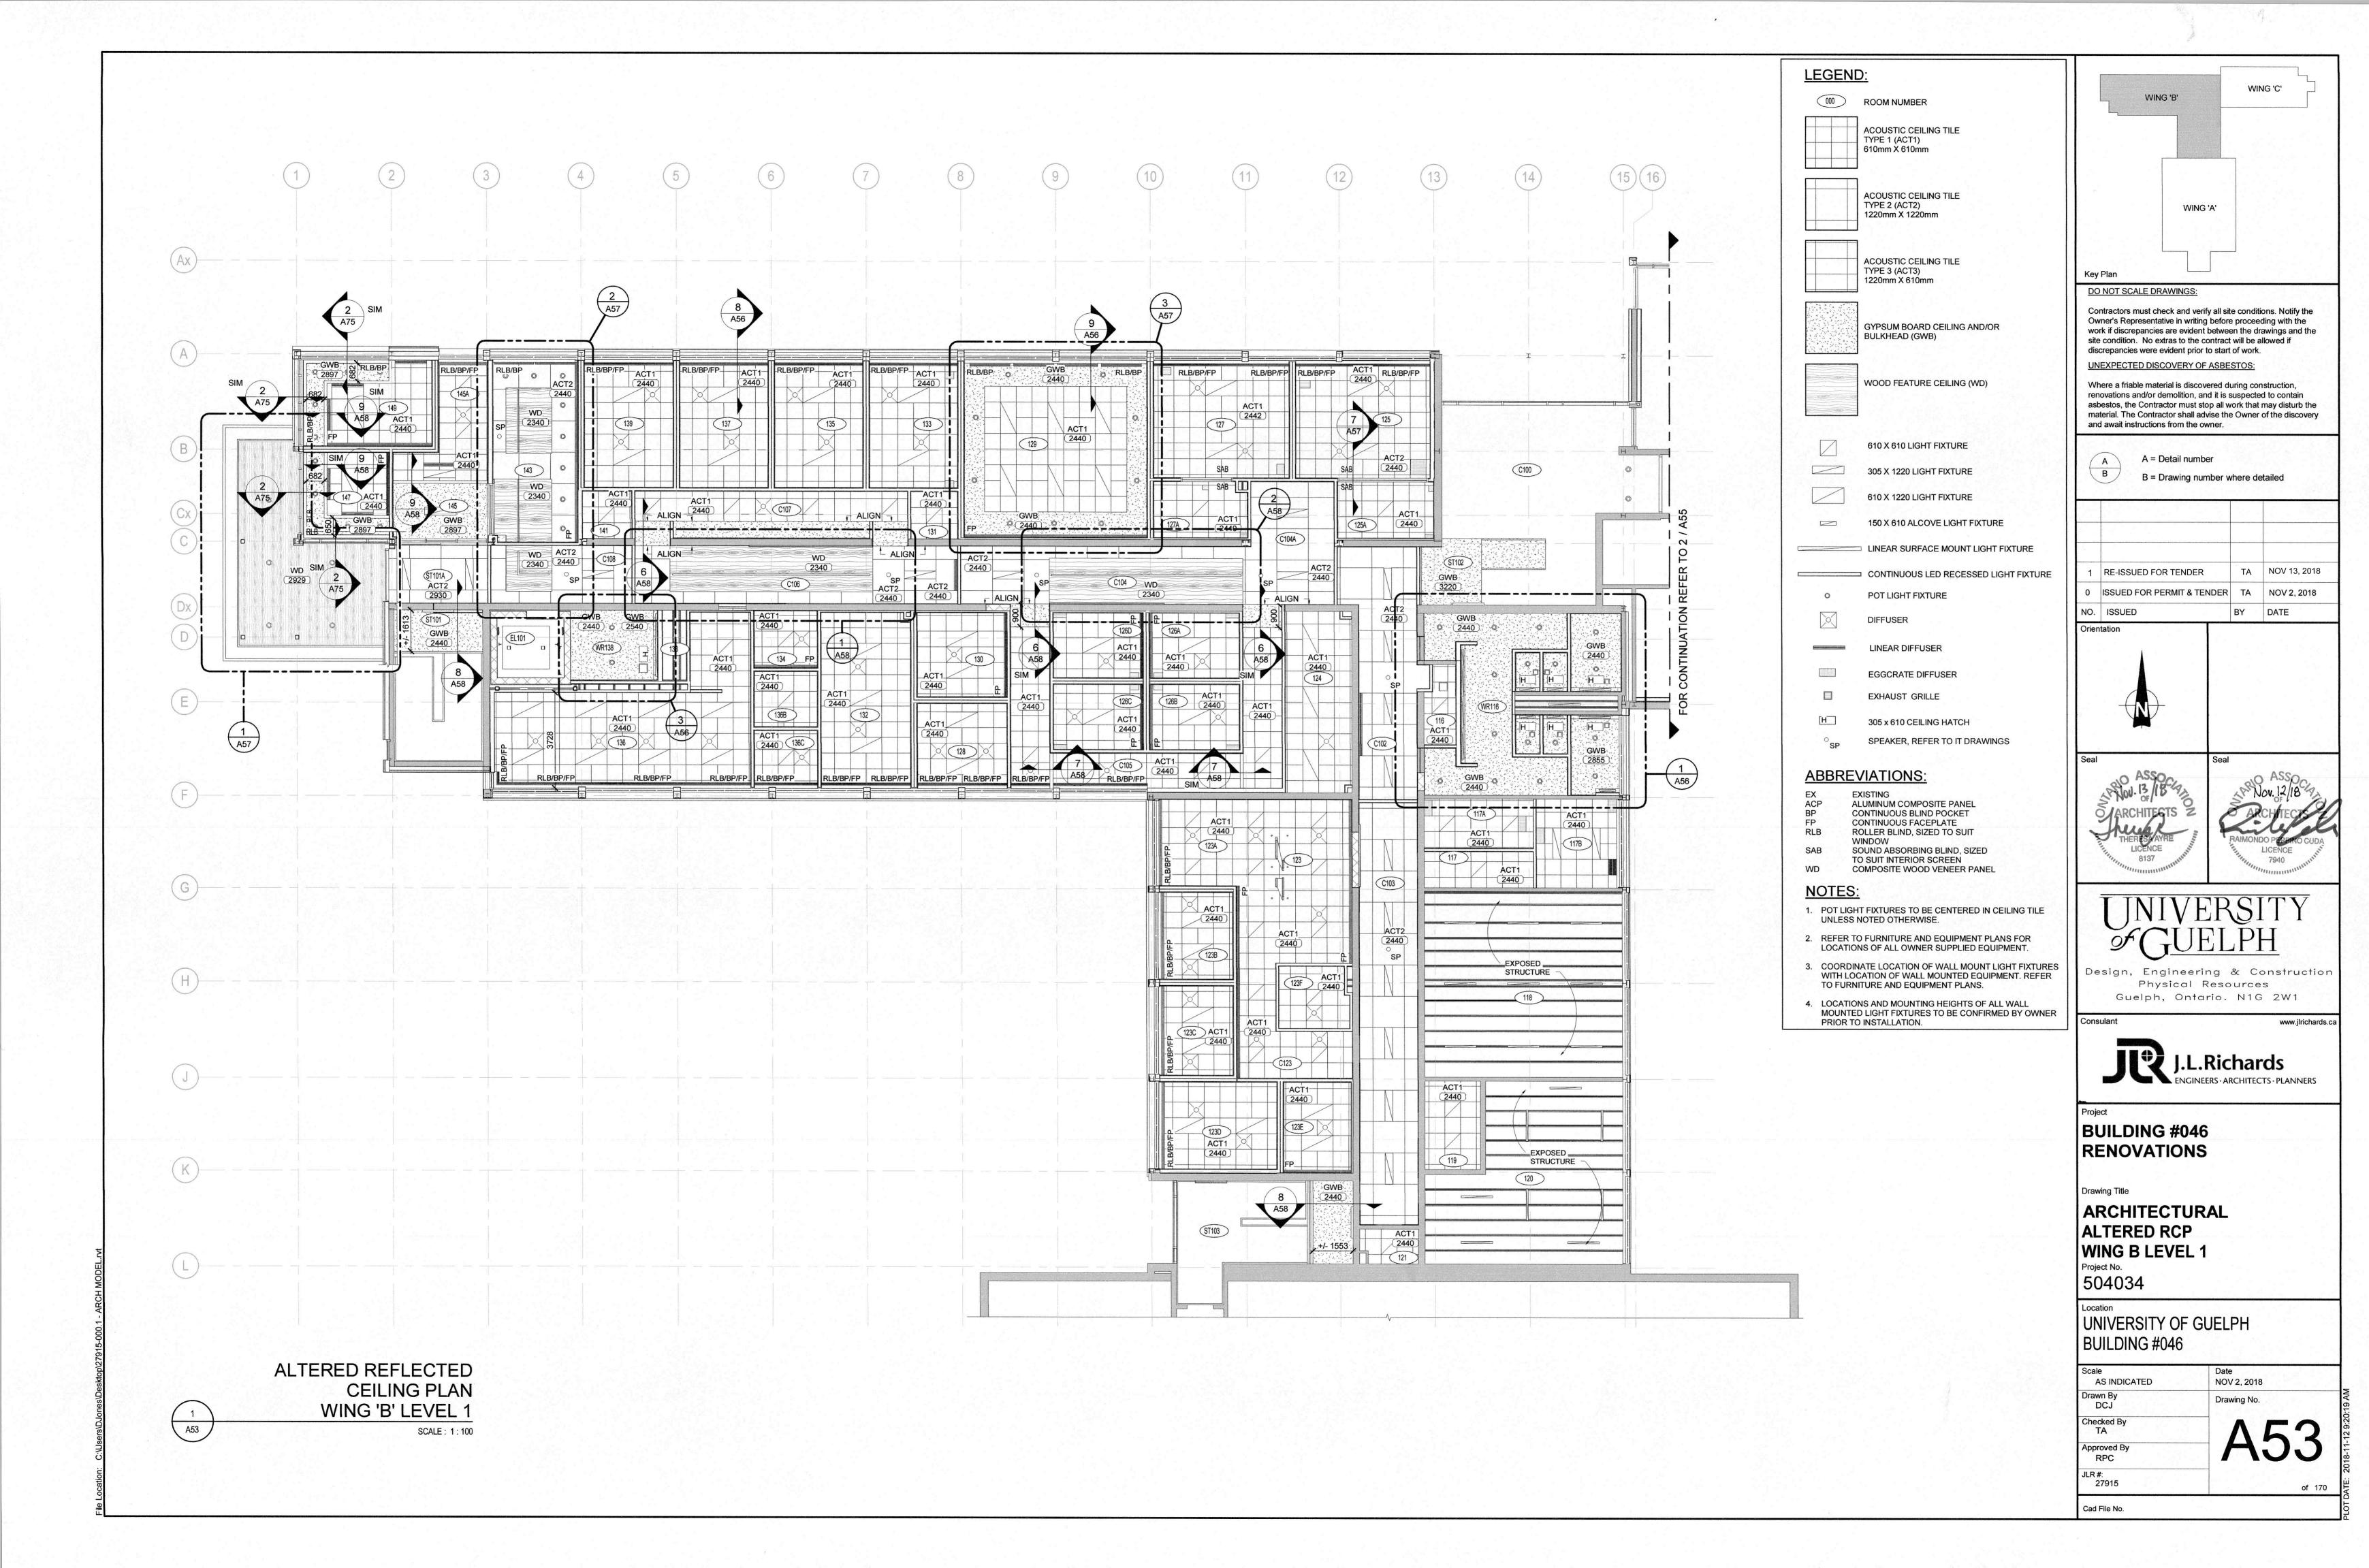


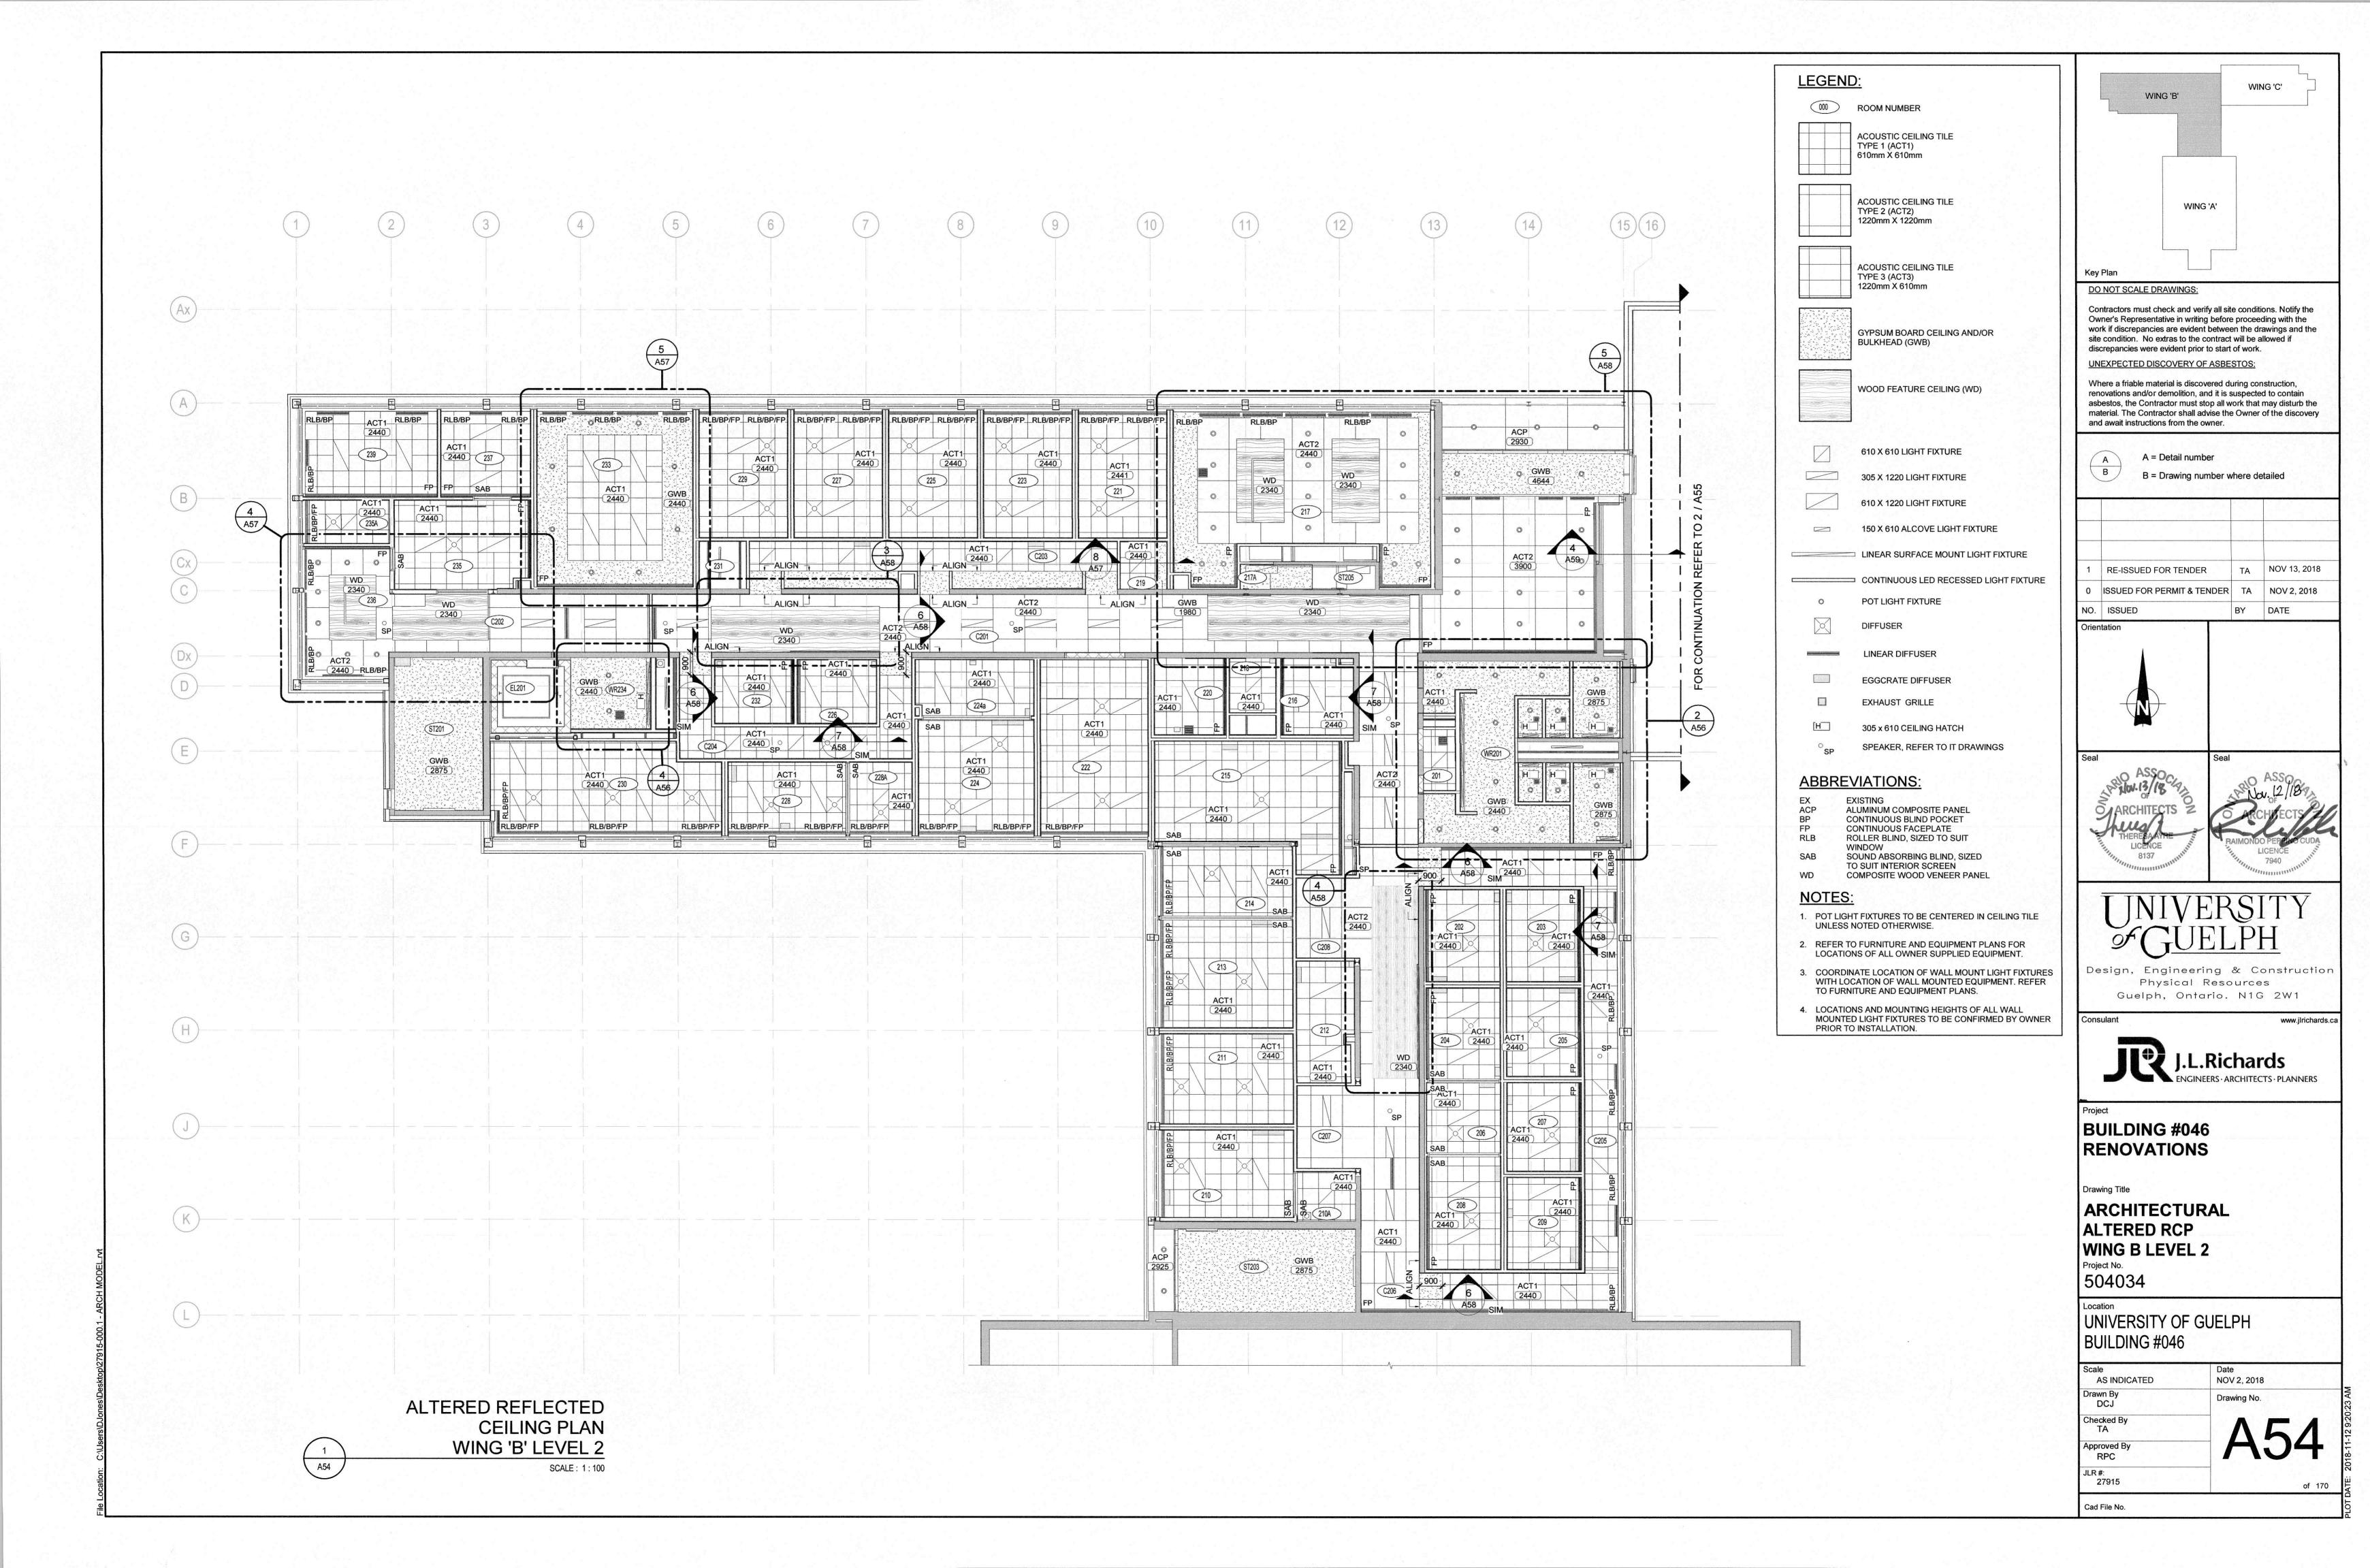
WING 'C' LEVEL 1


SCALE: 1:100


2 A55

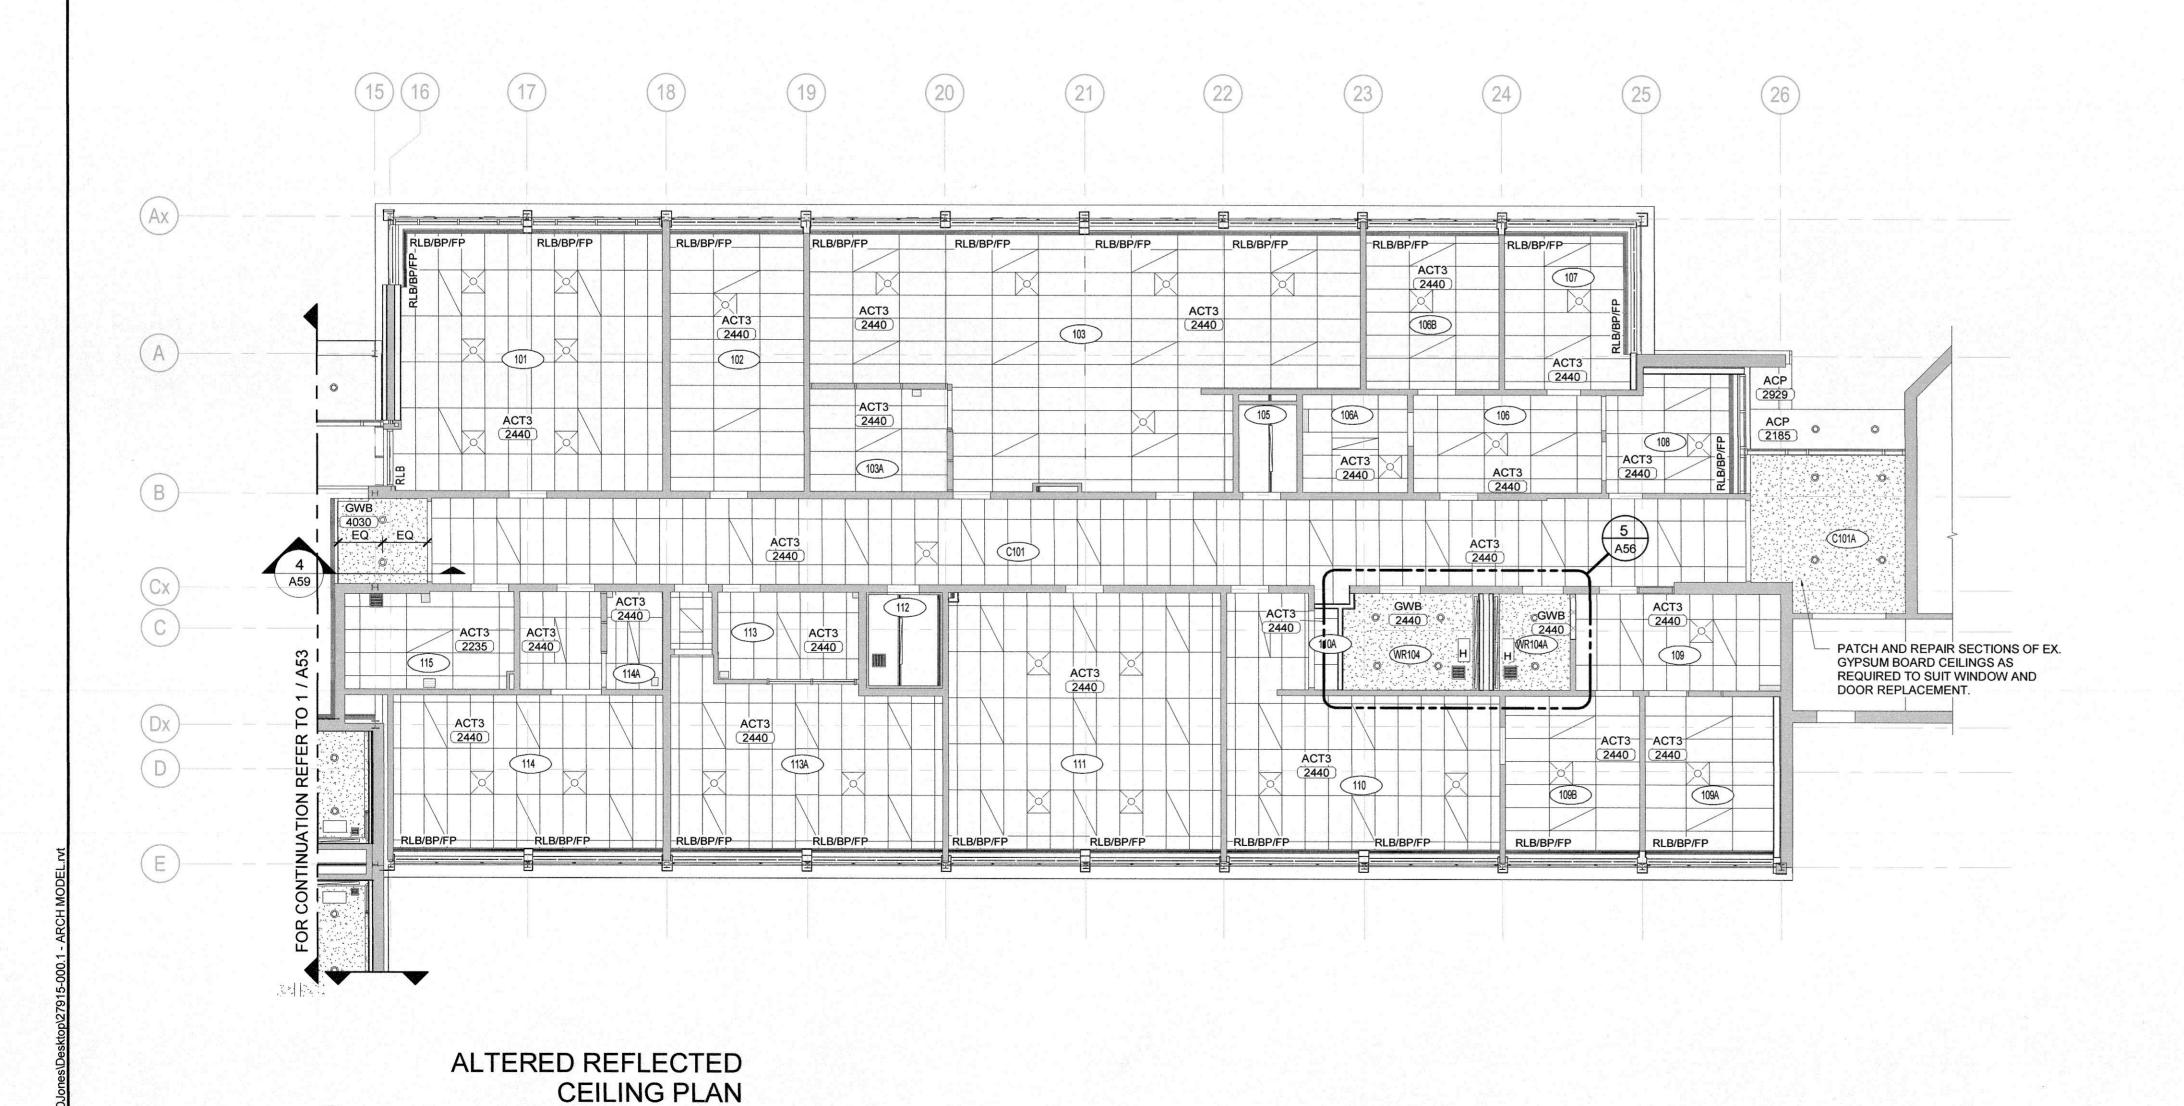


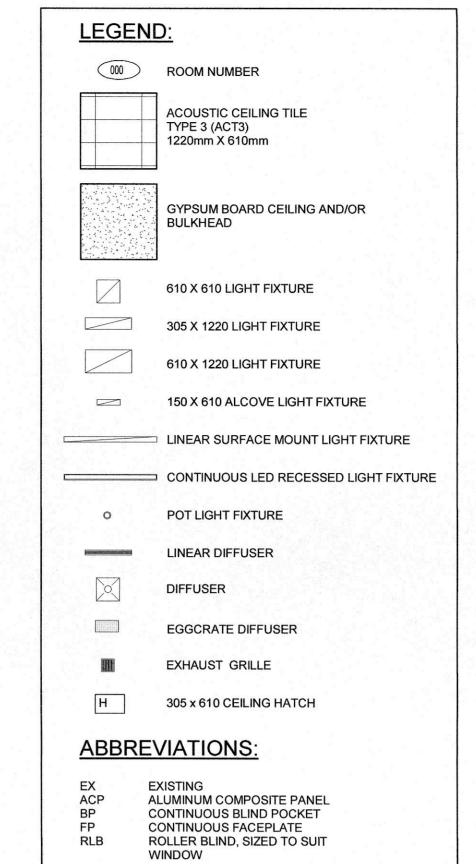

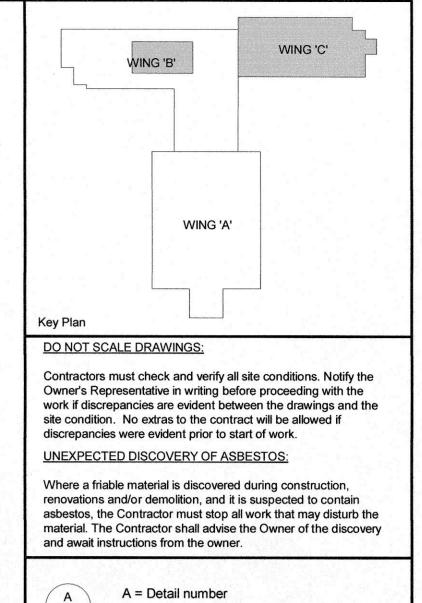

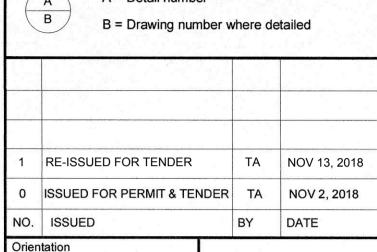

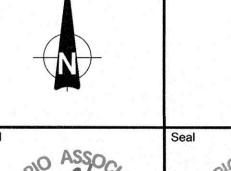

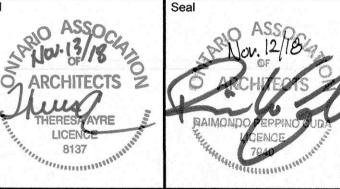



Guelph, Ontario. N1G 2W1

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ENGINEERS · ARCHITECTS · PLANNERS

Project

BUILDING #046 RENOVATIONS


Drawing Title


ARCHITECTURAL
ALTERED RCP
PENTHOUSE AND WING C


Project No. 504034


UNIVERSITY OF GUELPH BUILDING #046

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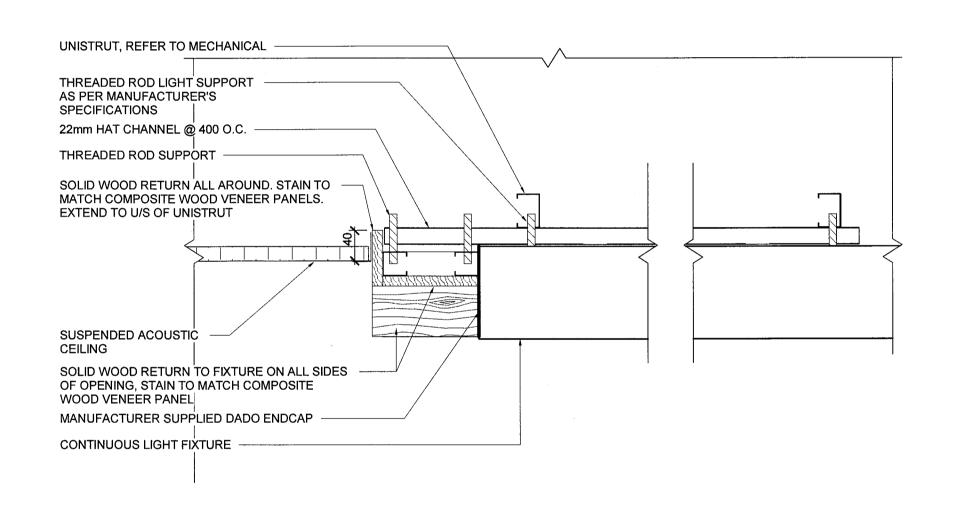


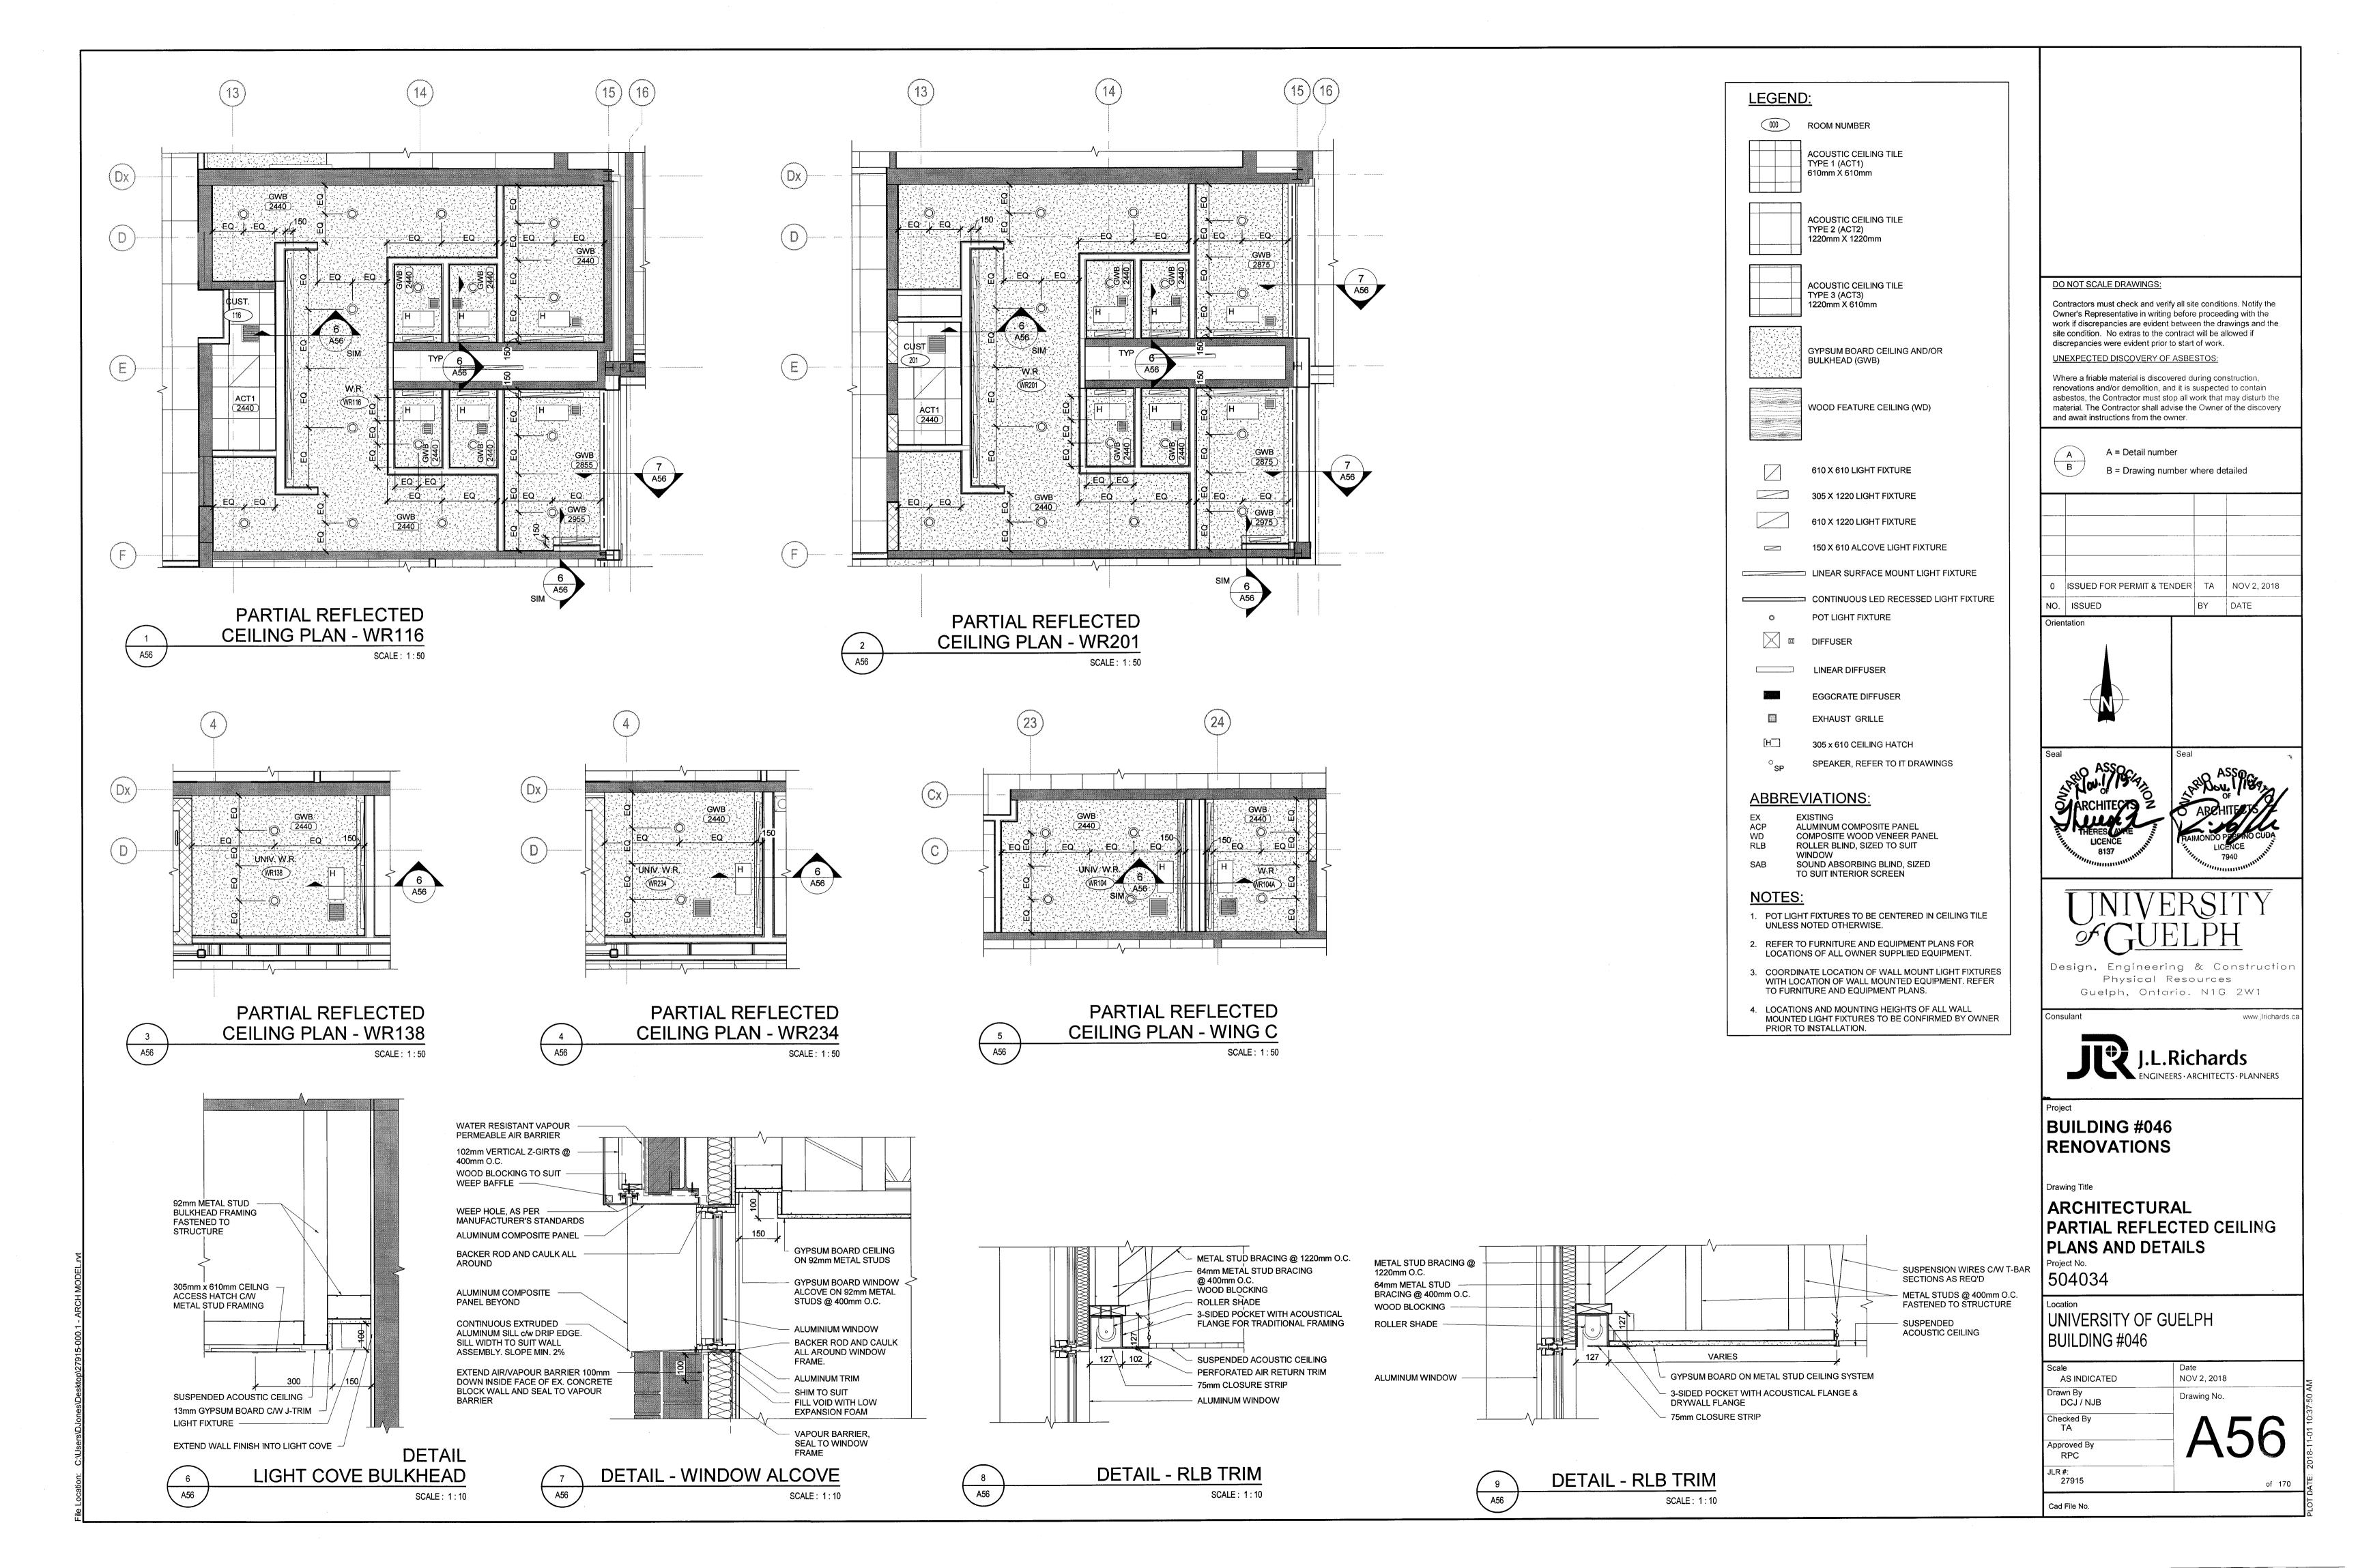

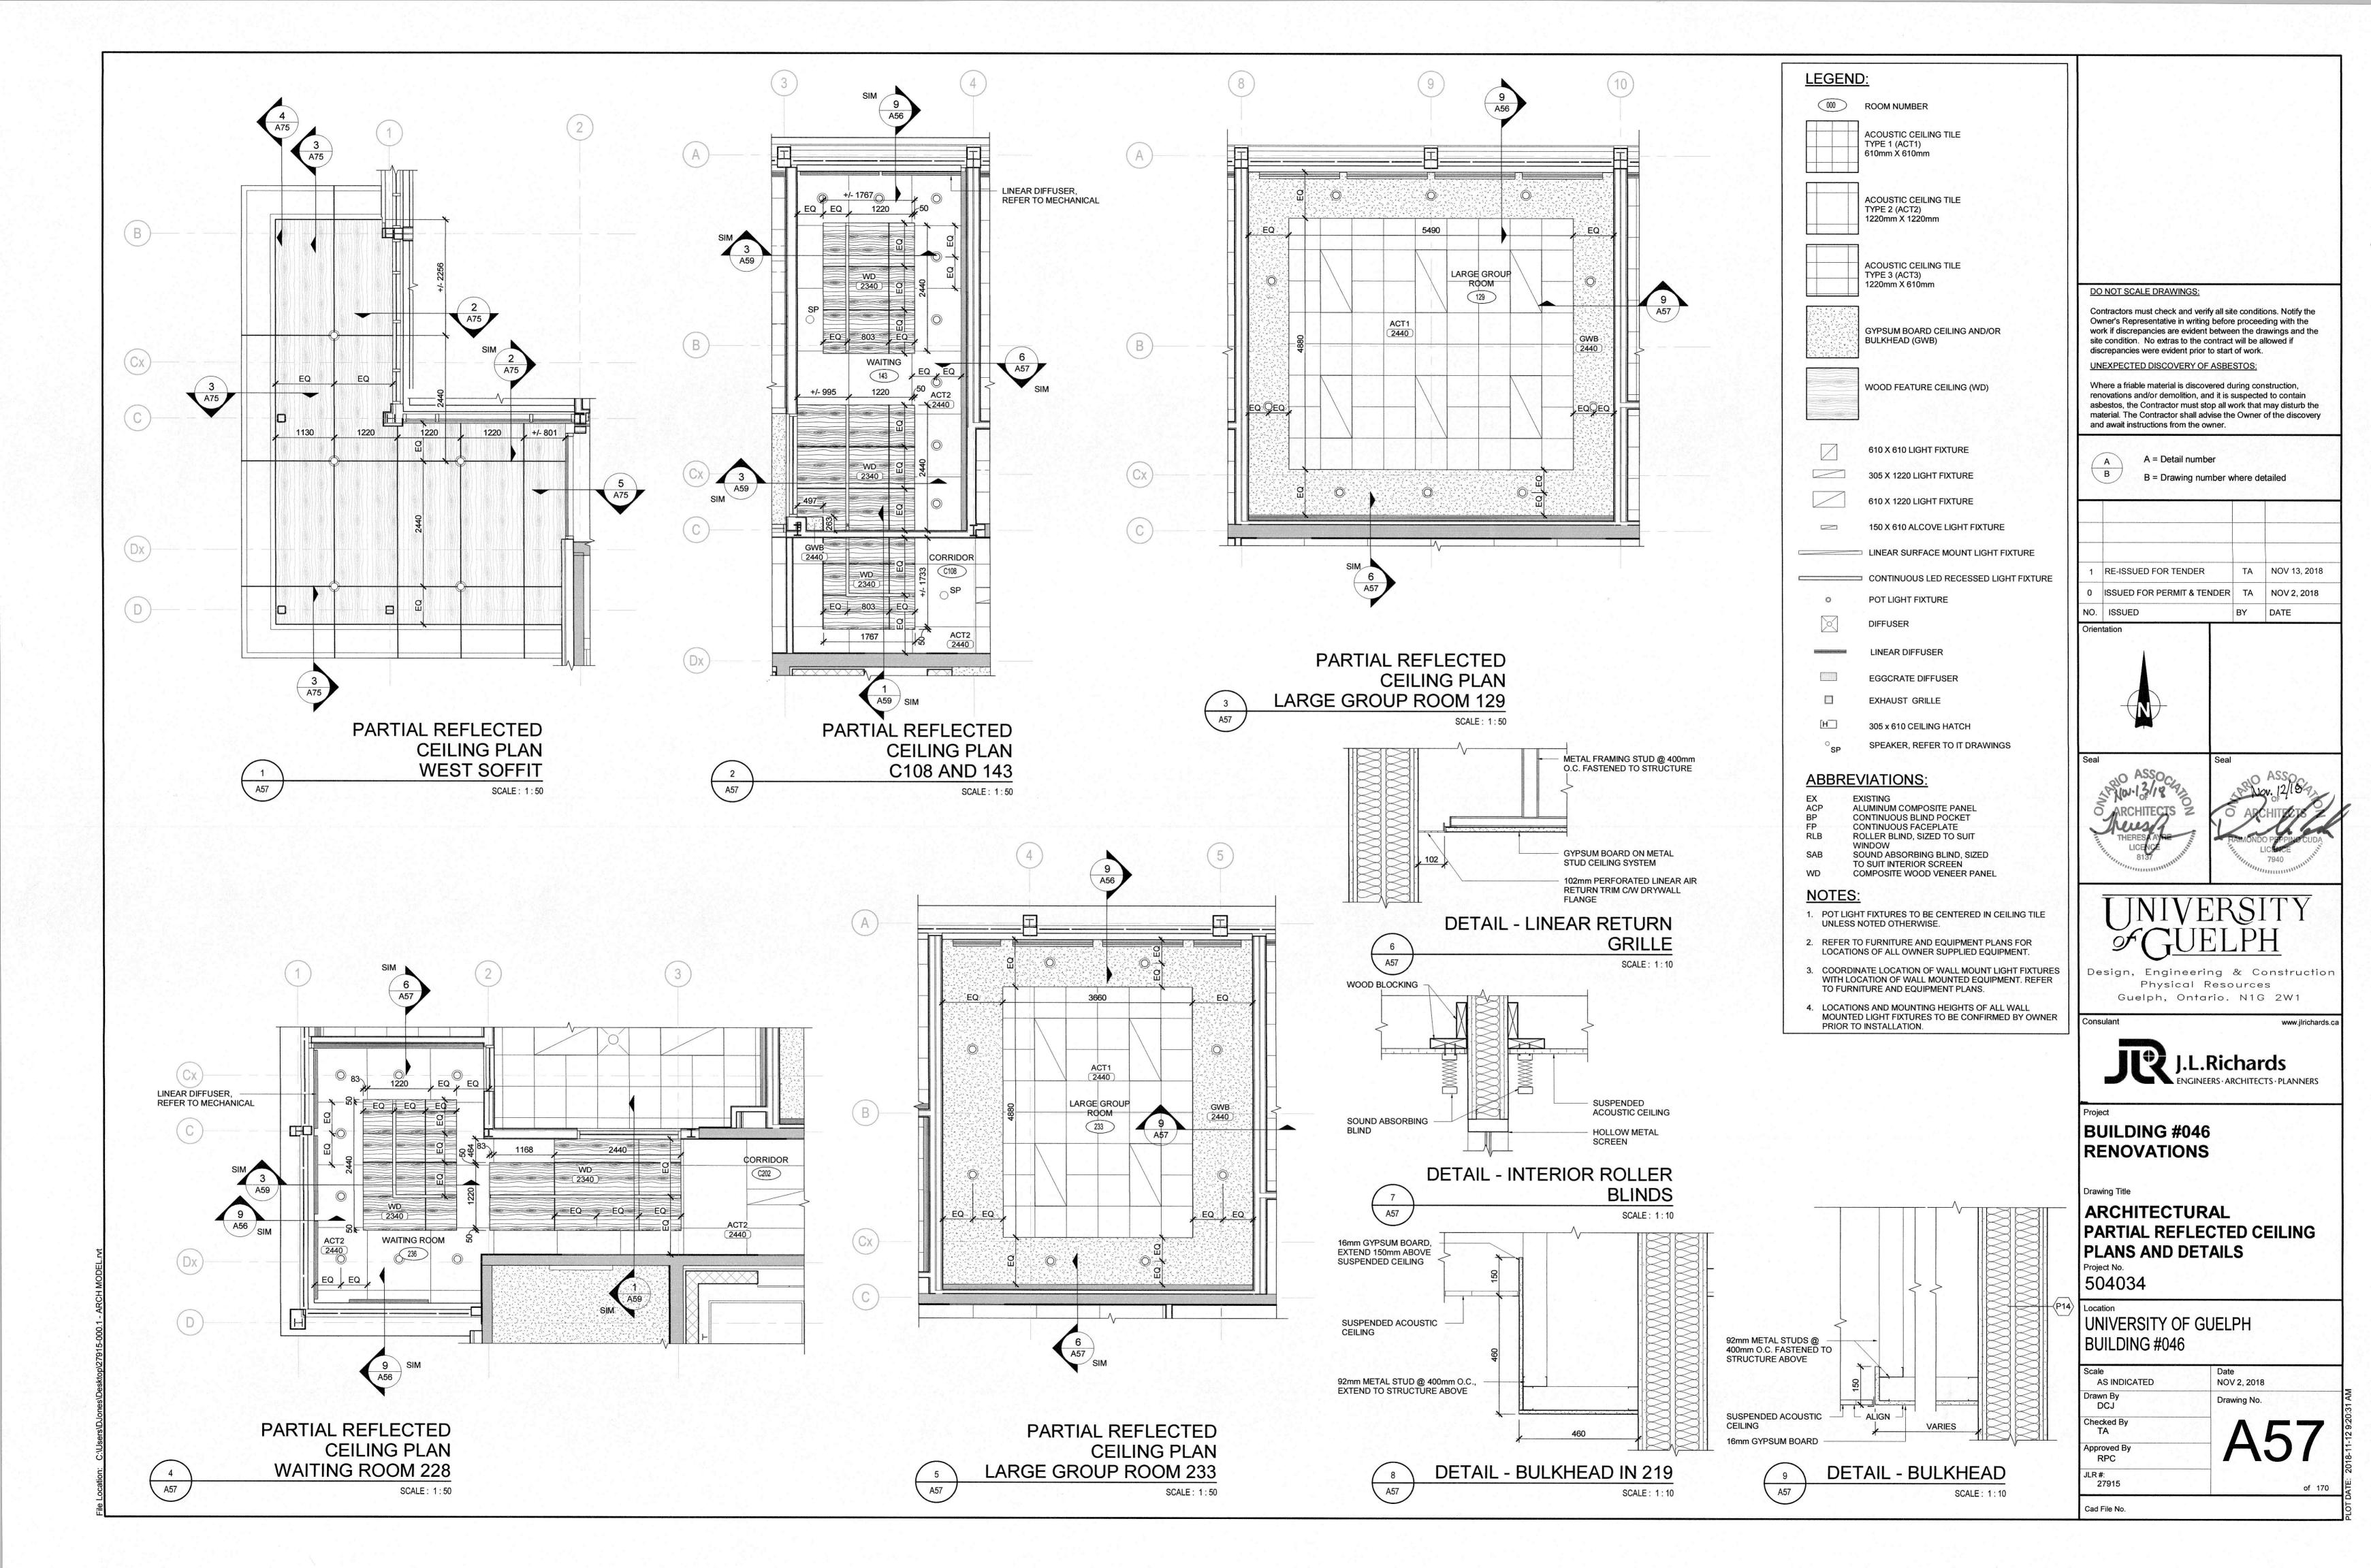

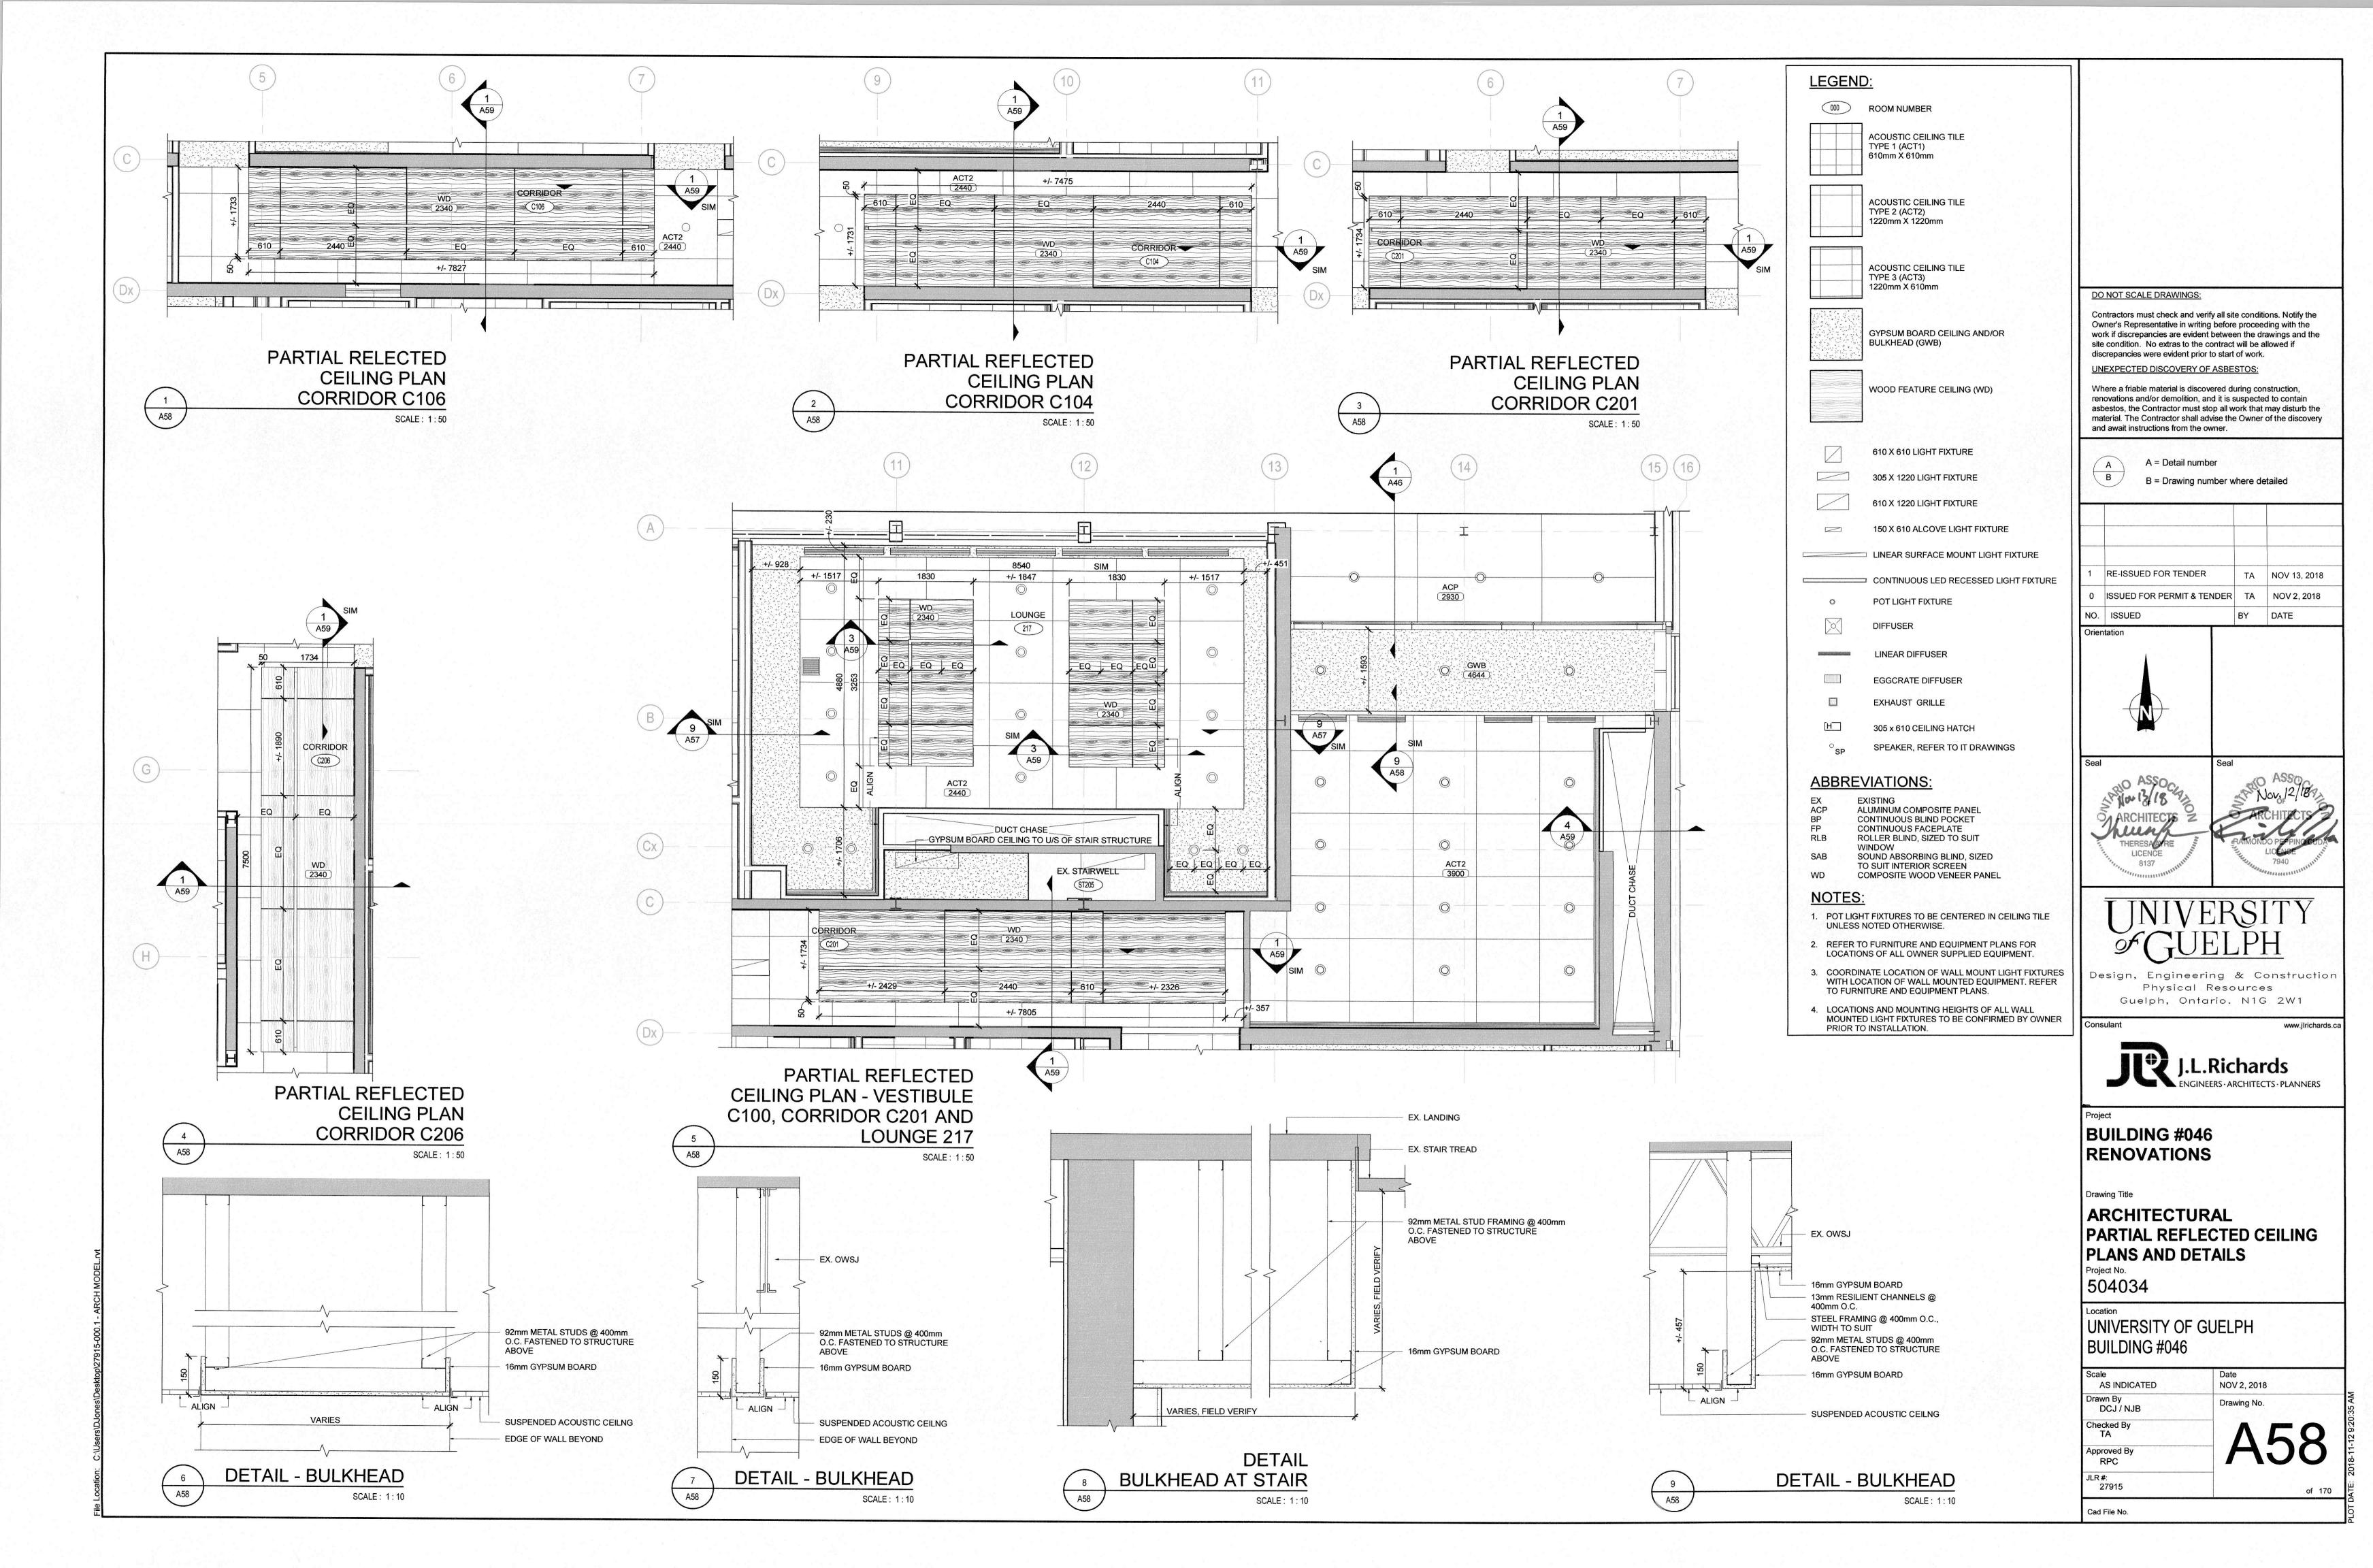


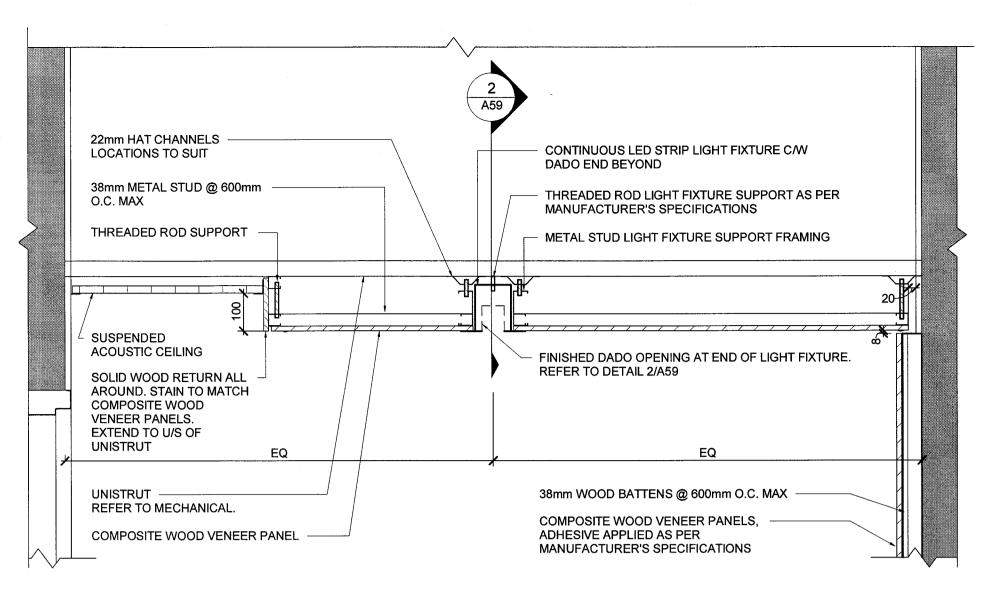
DETAIL - BULKHEAD & LIGHT FIXTURE AT CORRIDOR C104 A59 SCALE: 1:10







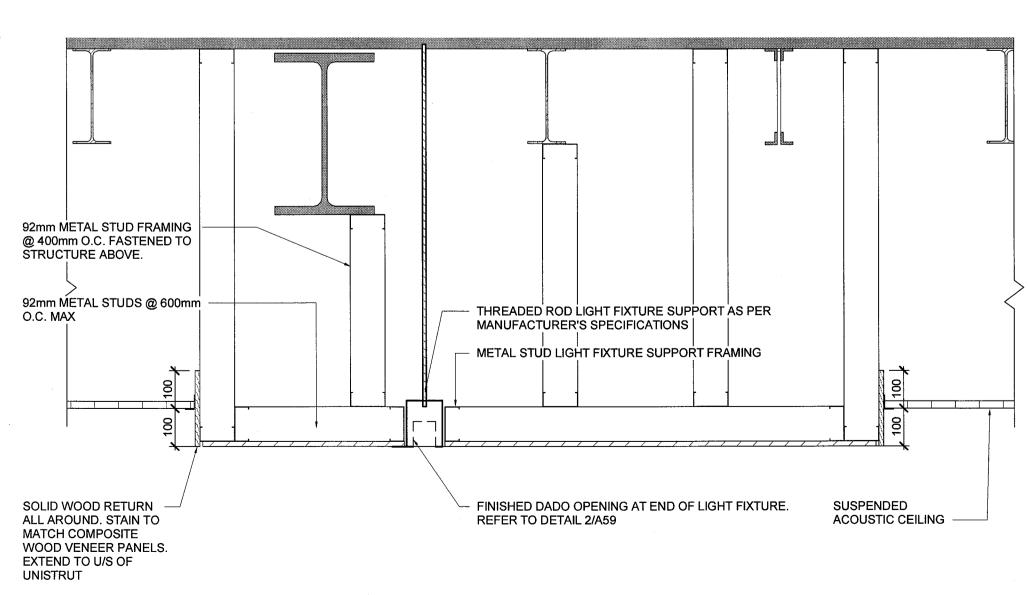

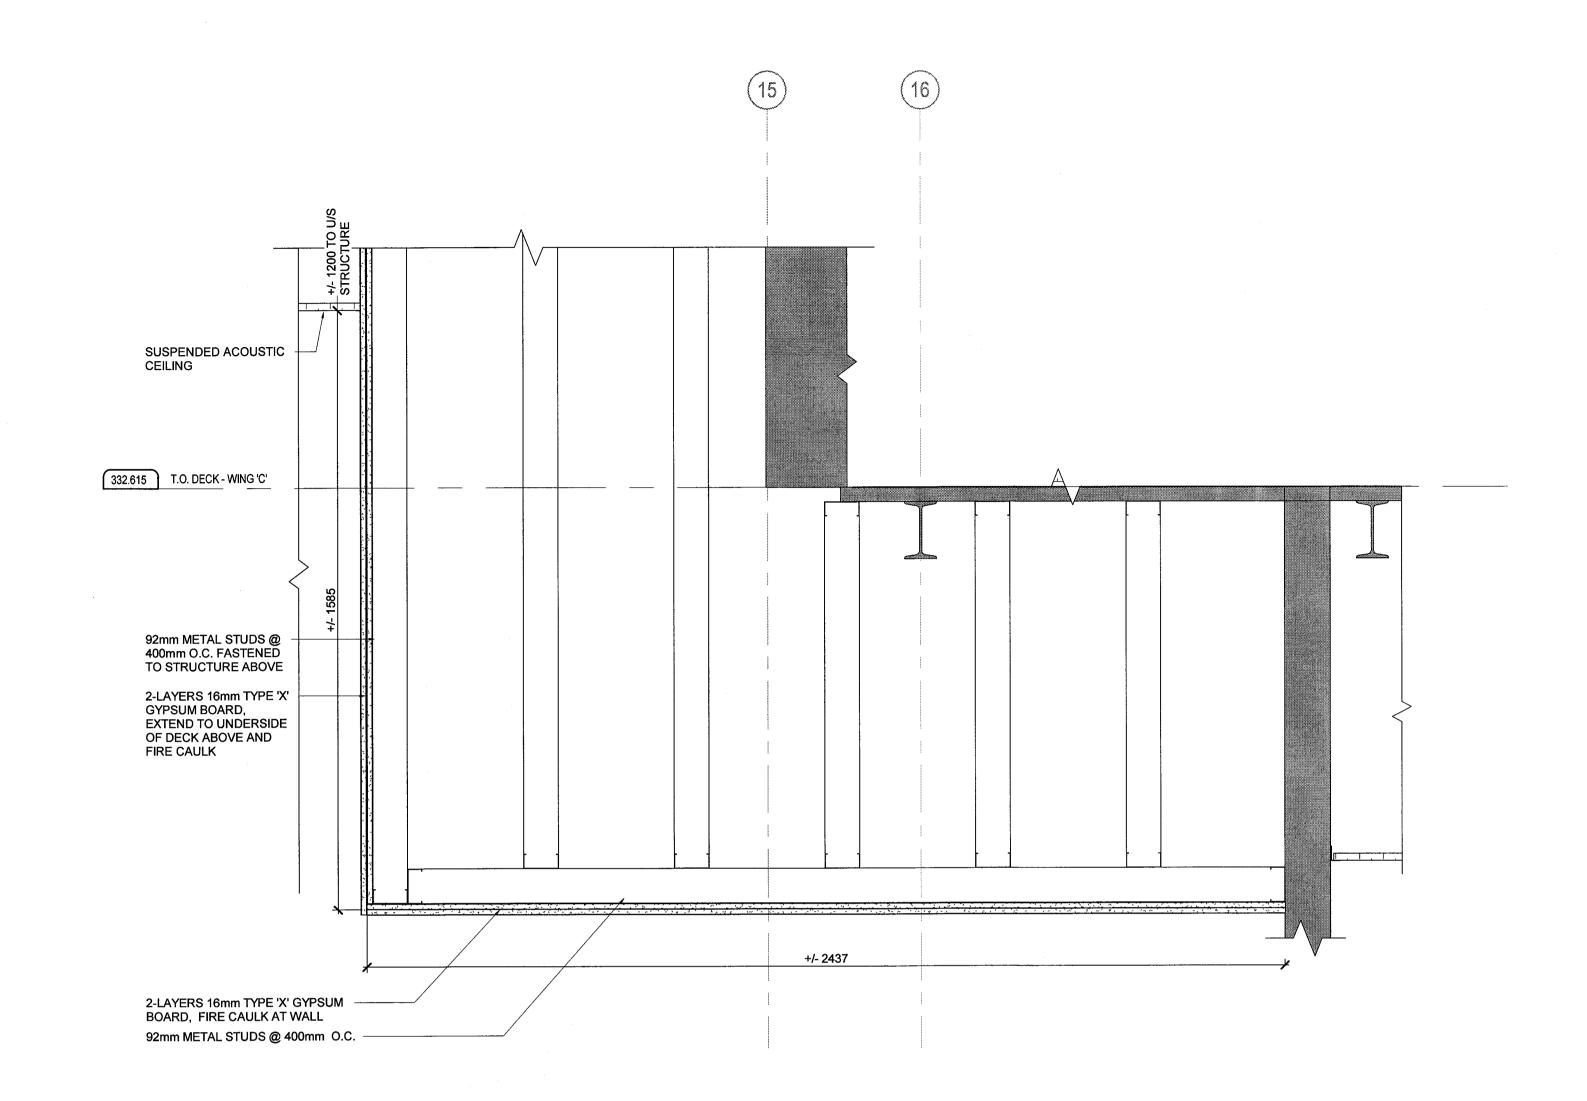

Contractors must check and verify all site conditions. Notify the Owner's Representative in writing before proceeding with the work if discrepancies are evident between the drawings and the site condition. No extras to the contract will be allowed if discrepancies were evident prior to start of work.

UNEXPECTED DISCOVERY OF ASBESTOS:

DO NOT SCALE DRAWINGS:

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ASSOPHITECTS

RAIMONDO PERMILE CUDA

LICENCE

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Design, Engineering & Construction Physical Resources Guelph, Ontario. N1G 2W1

Consulant

www.jiiiGiiaiG



Project

BUILDING #046 RENOVATIONS

Drawing Title

ARCHITECTURAL
CEILING AND BULKHEAD
DETAILS

Project No. 504034

UNIVERSITY OF GUELPH BUILDING #046

Scale
AS INDICATED
Drawn By
DCJ / NJB
Checked By
TA
Approved By
RPC


AJ3
of 170

Cad File No.

27915

DETAIL - WOOD CEILING @
ACT

SCALE: 1:10

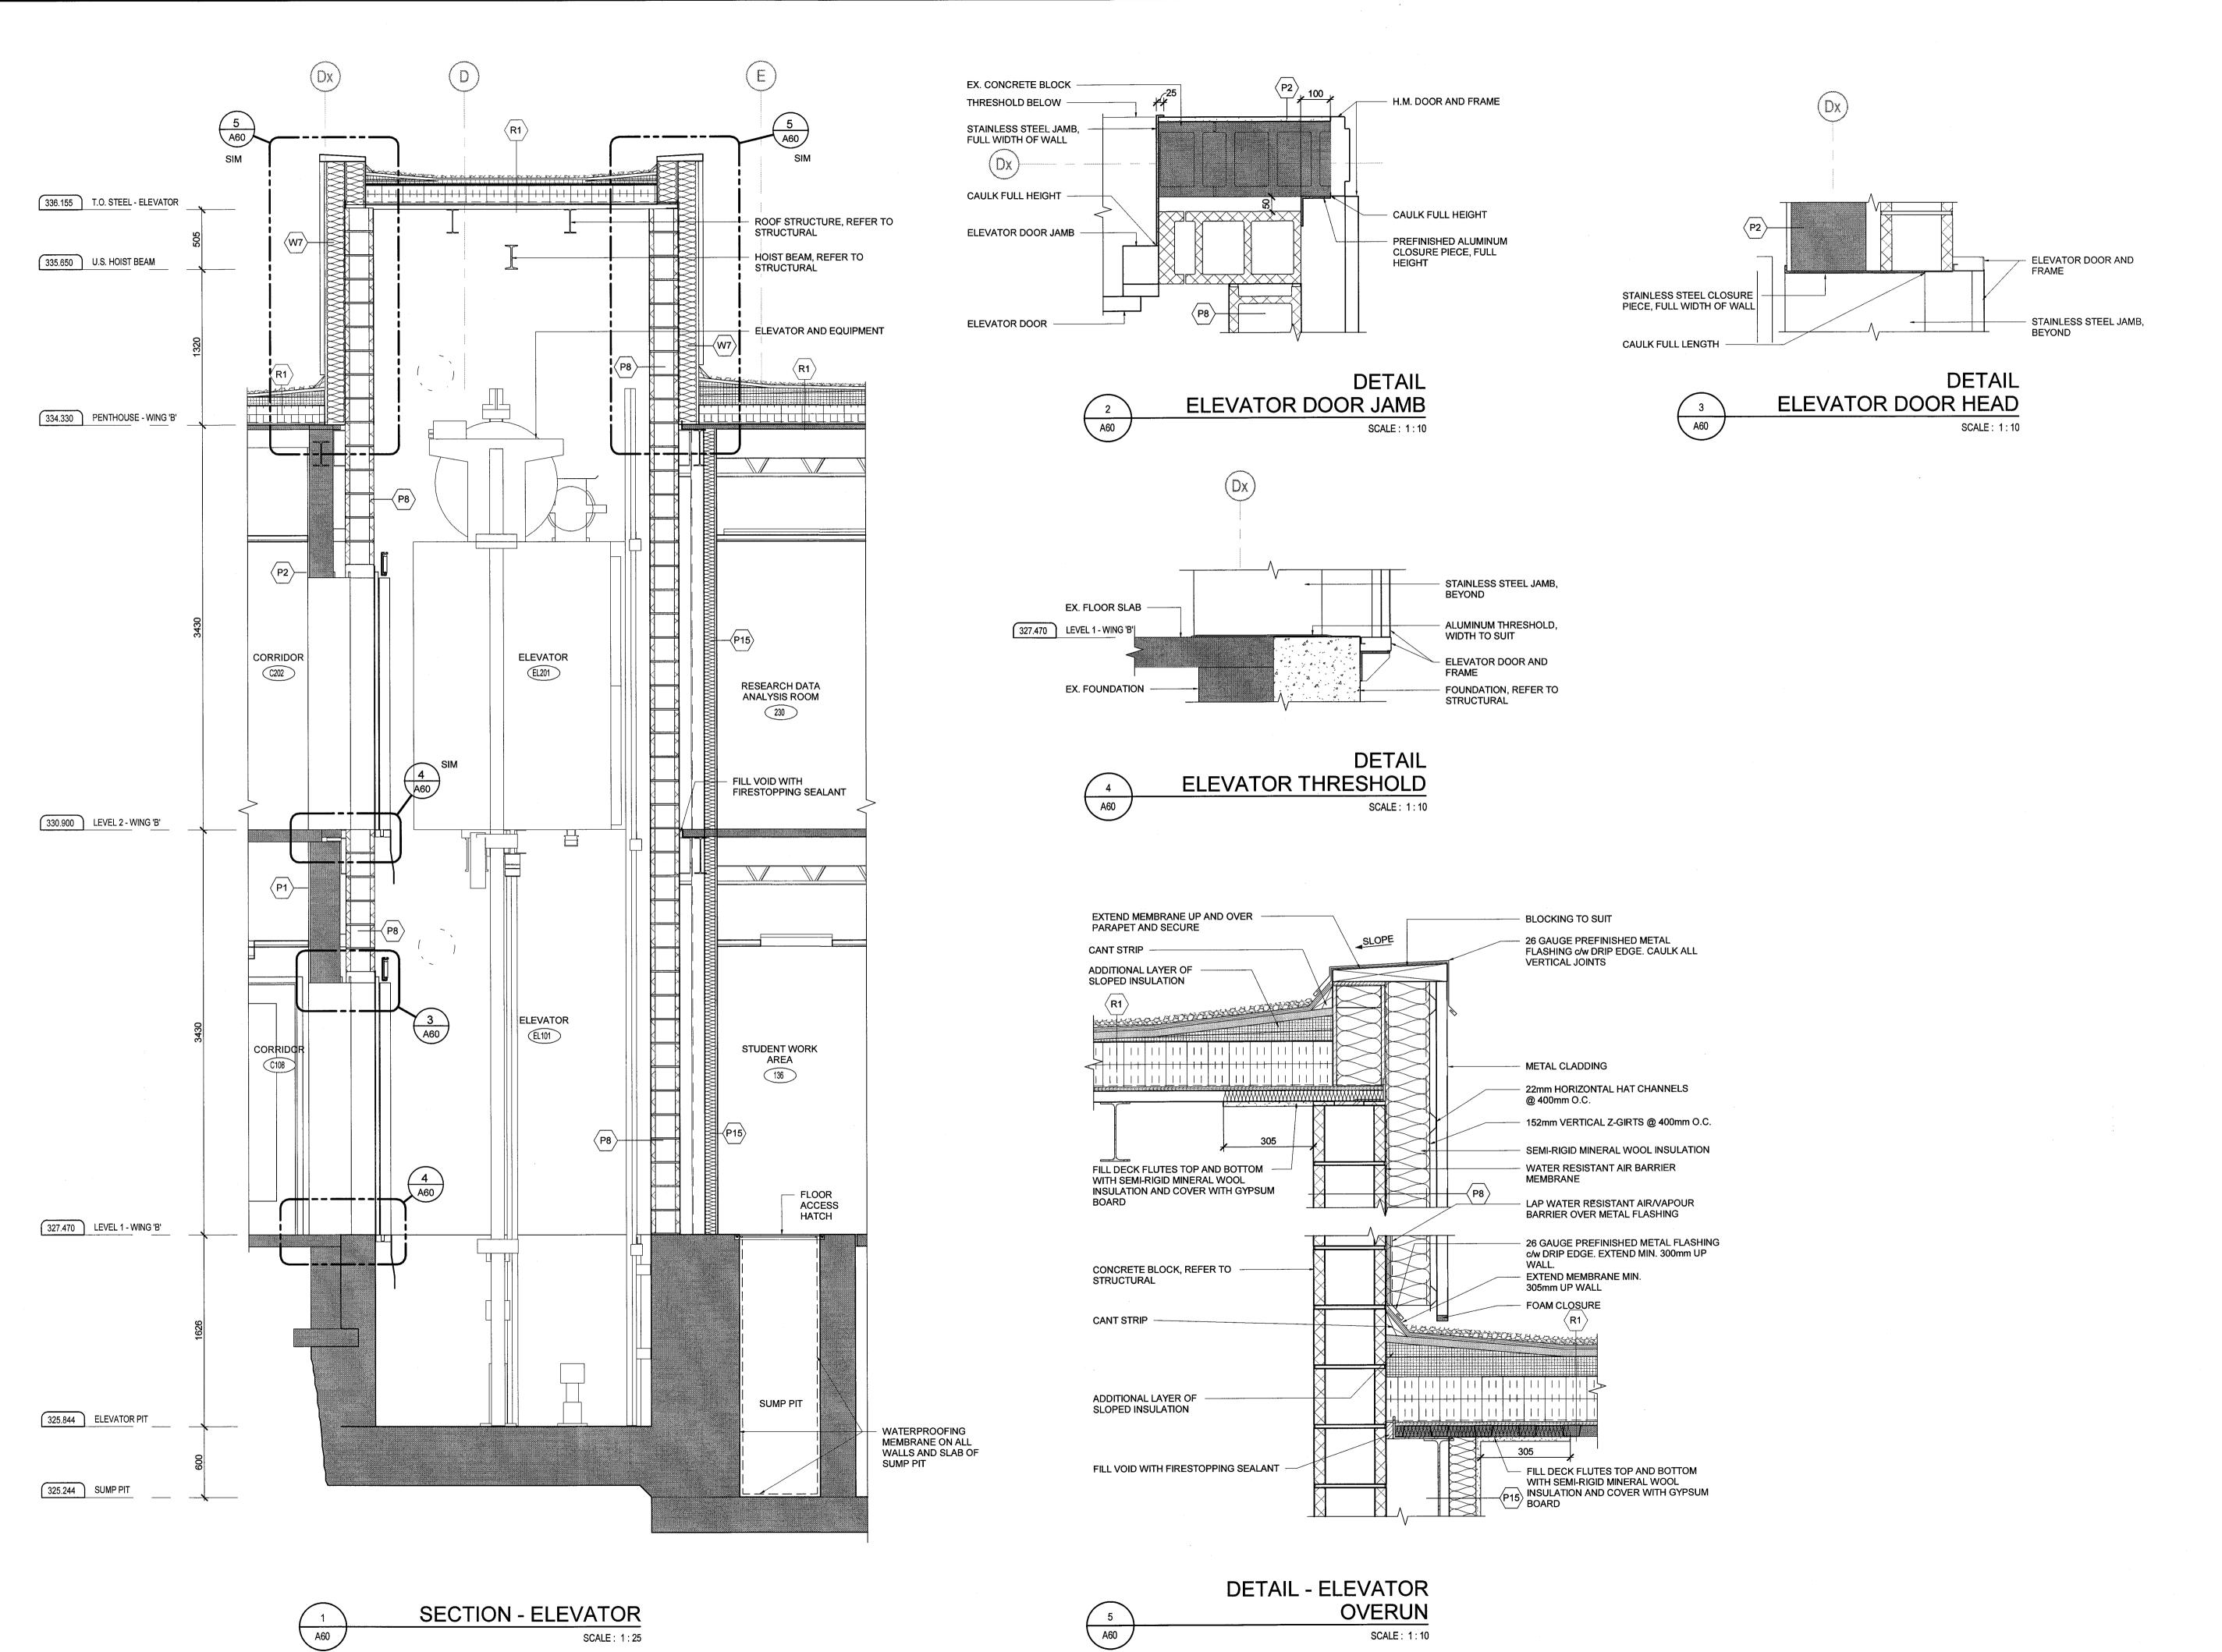

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Orientation

ASSOCIATION ASSOCI

ASSOCIATION OF ARCHITECTS

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LICENCE
7940

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BUILDING #046 RENOVATIONS

Drawing Title

ARCHITECTURAL ELEVATOR DETAILS

Project No. 504034

Cad File No.

UNIVERSITY OF GUELPH BUILDING #046

Scale
AS INDICATED
Date
NOV 2, 2018


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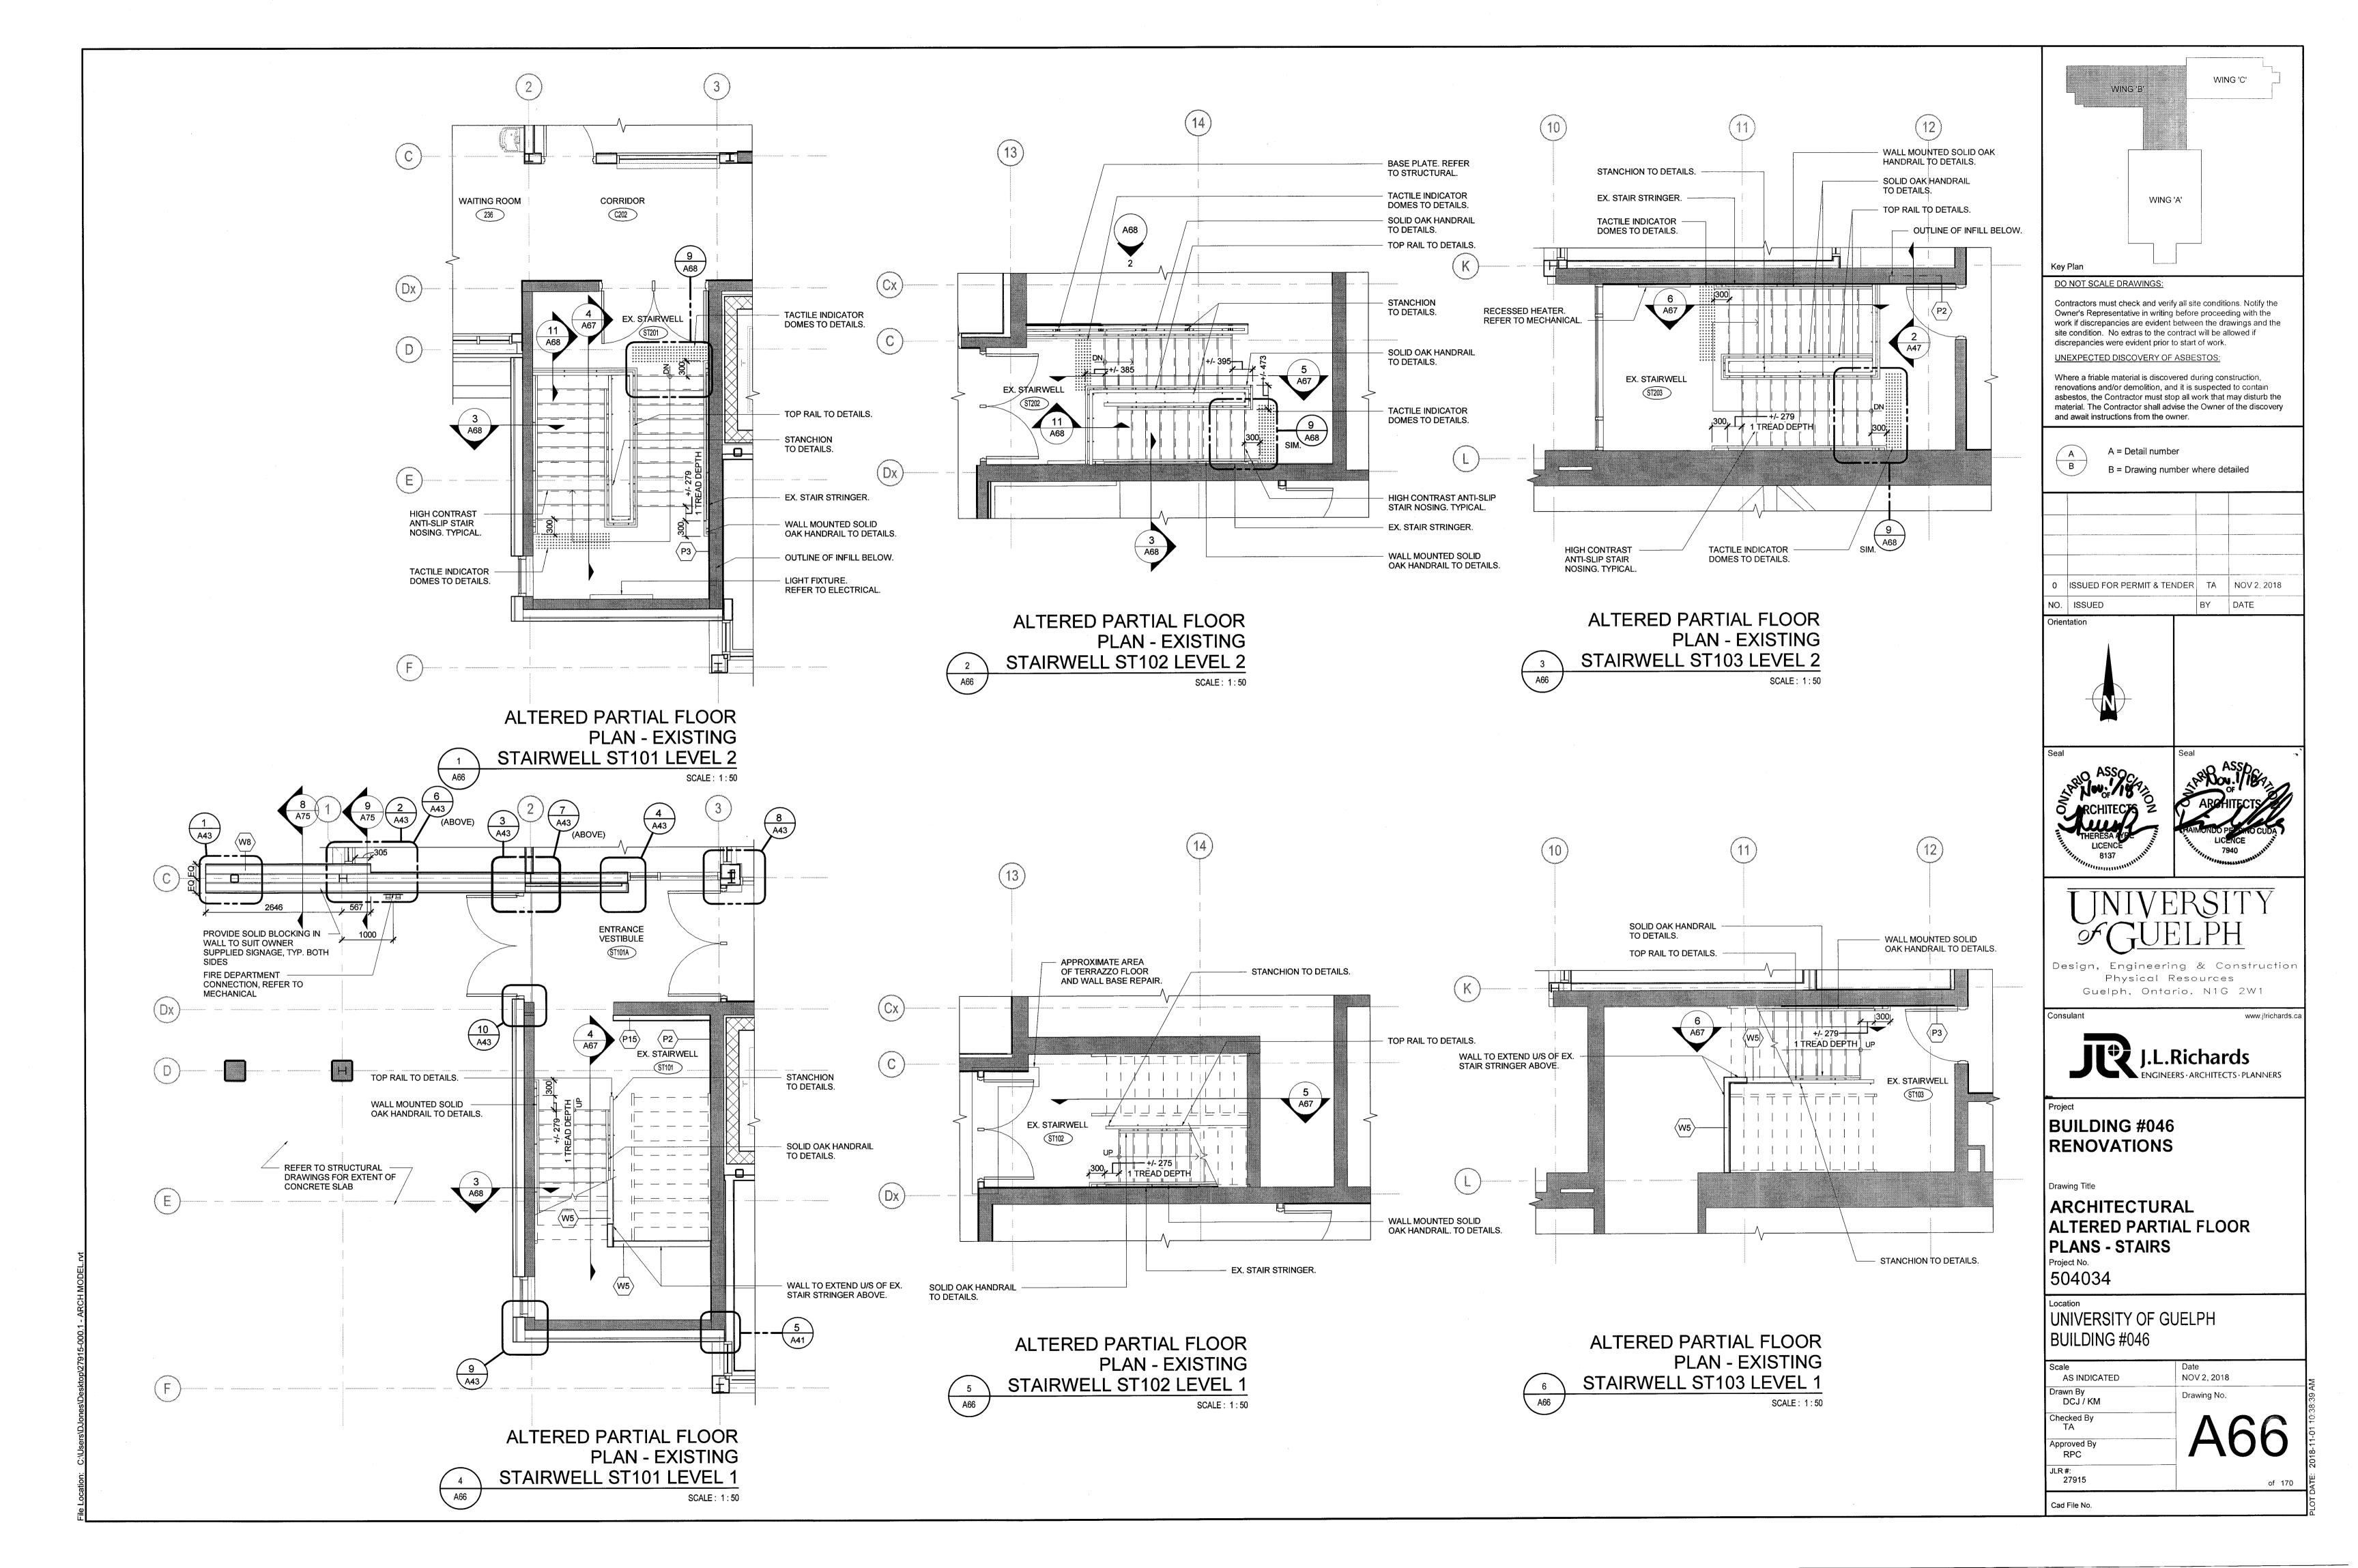
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TA


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RPC


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27915


Of 170



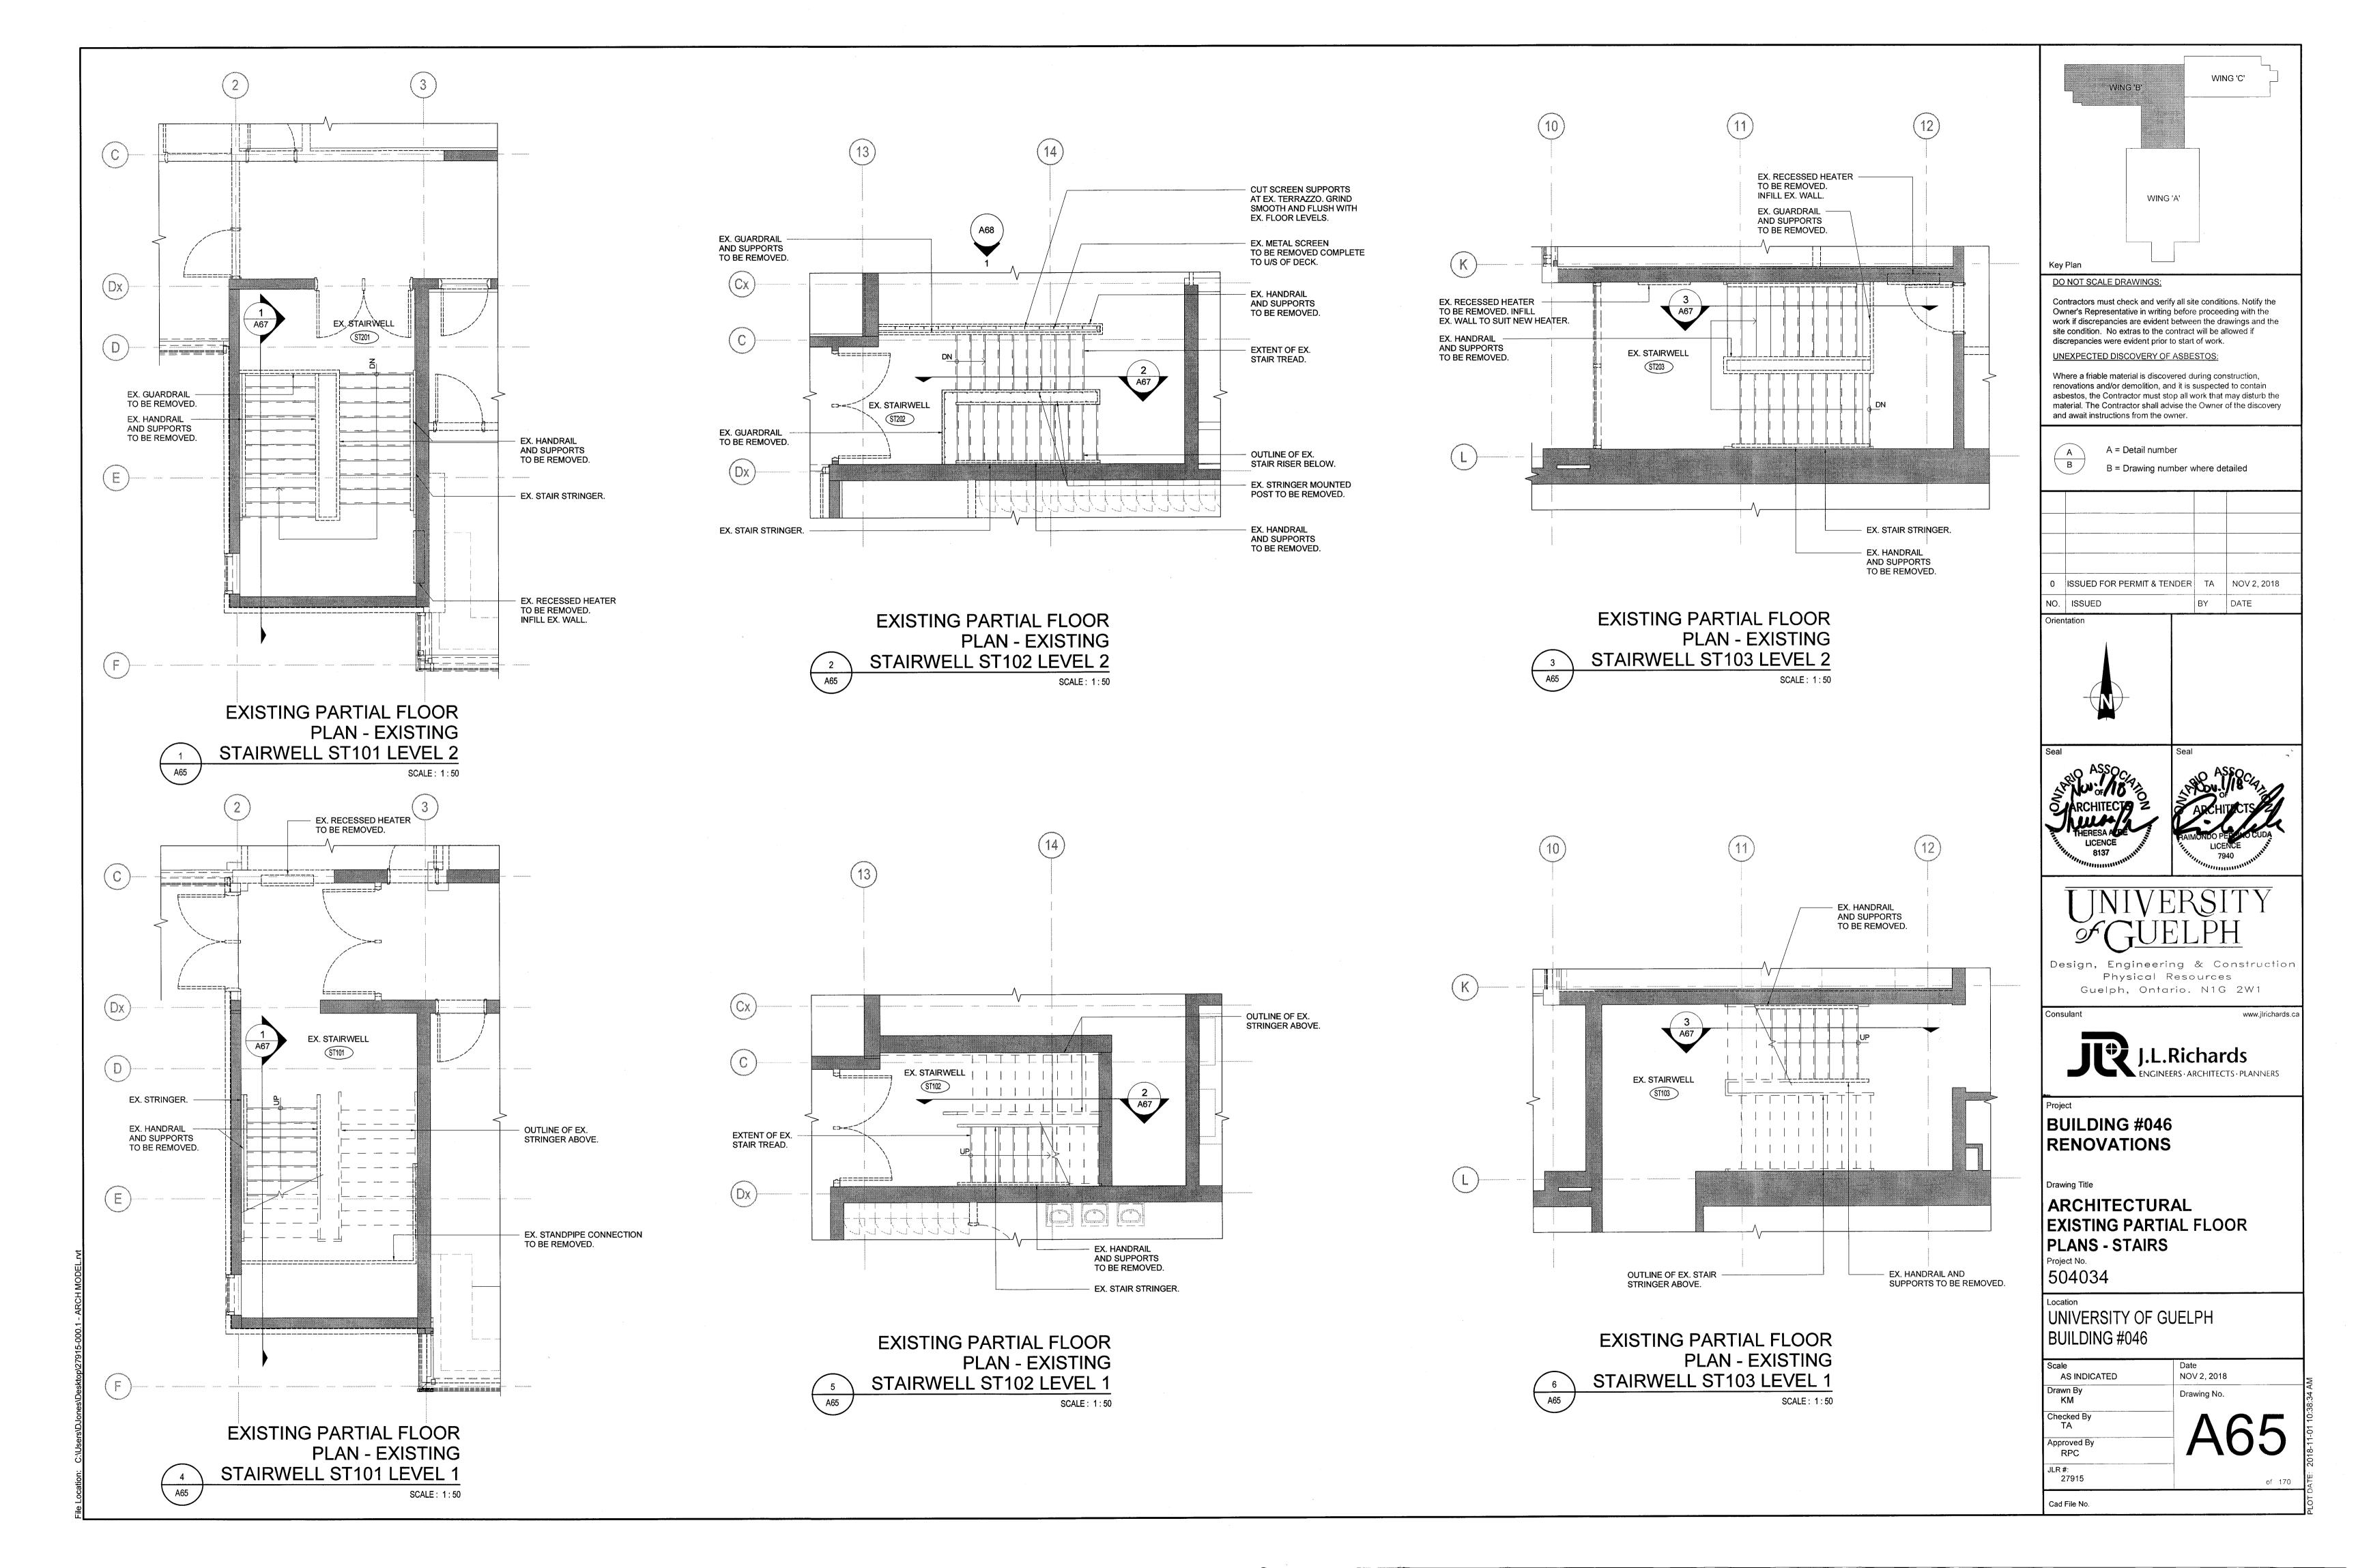

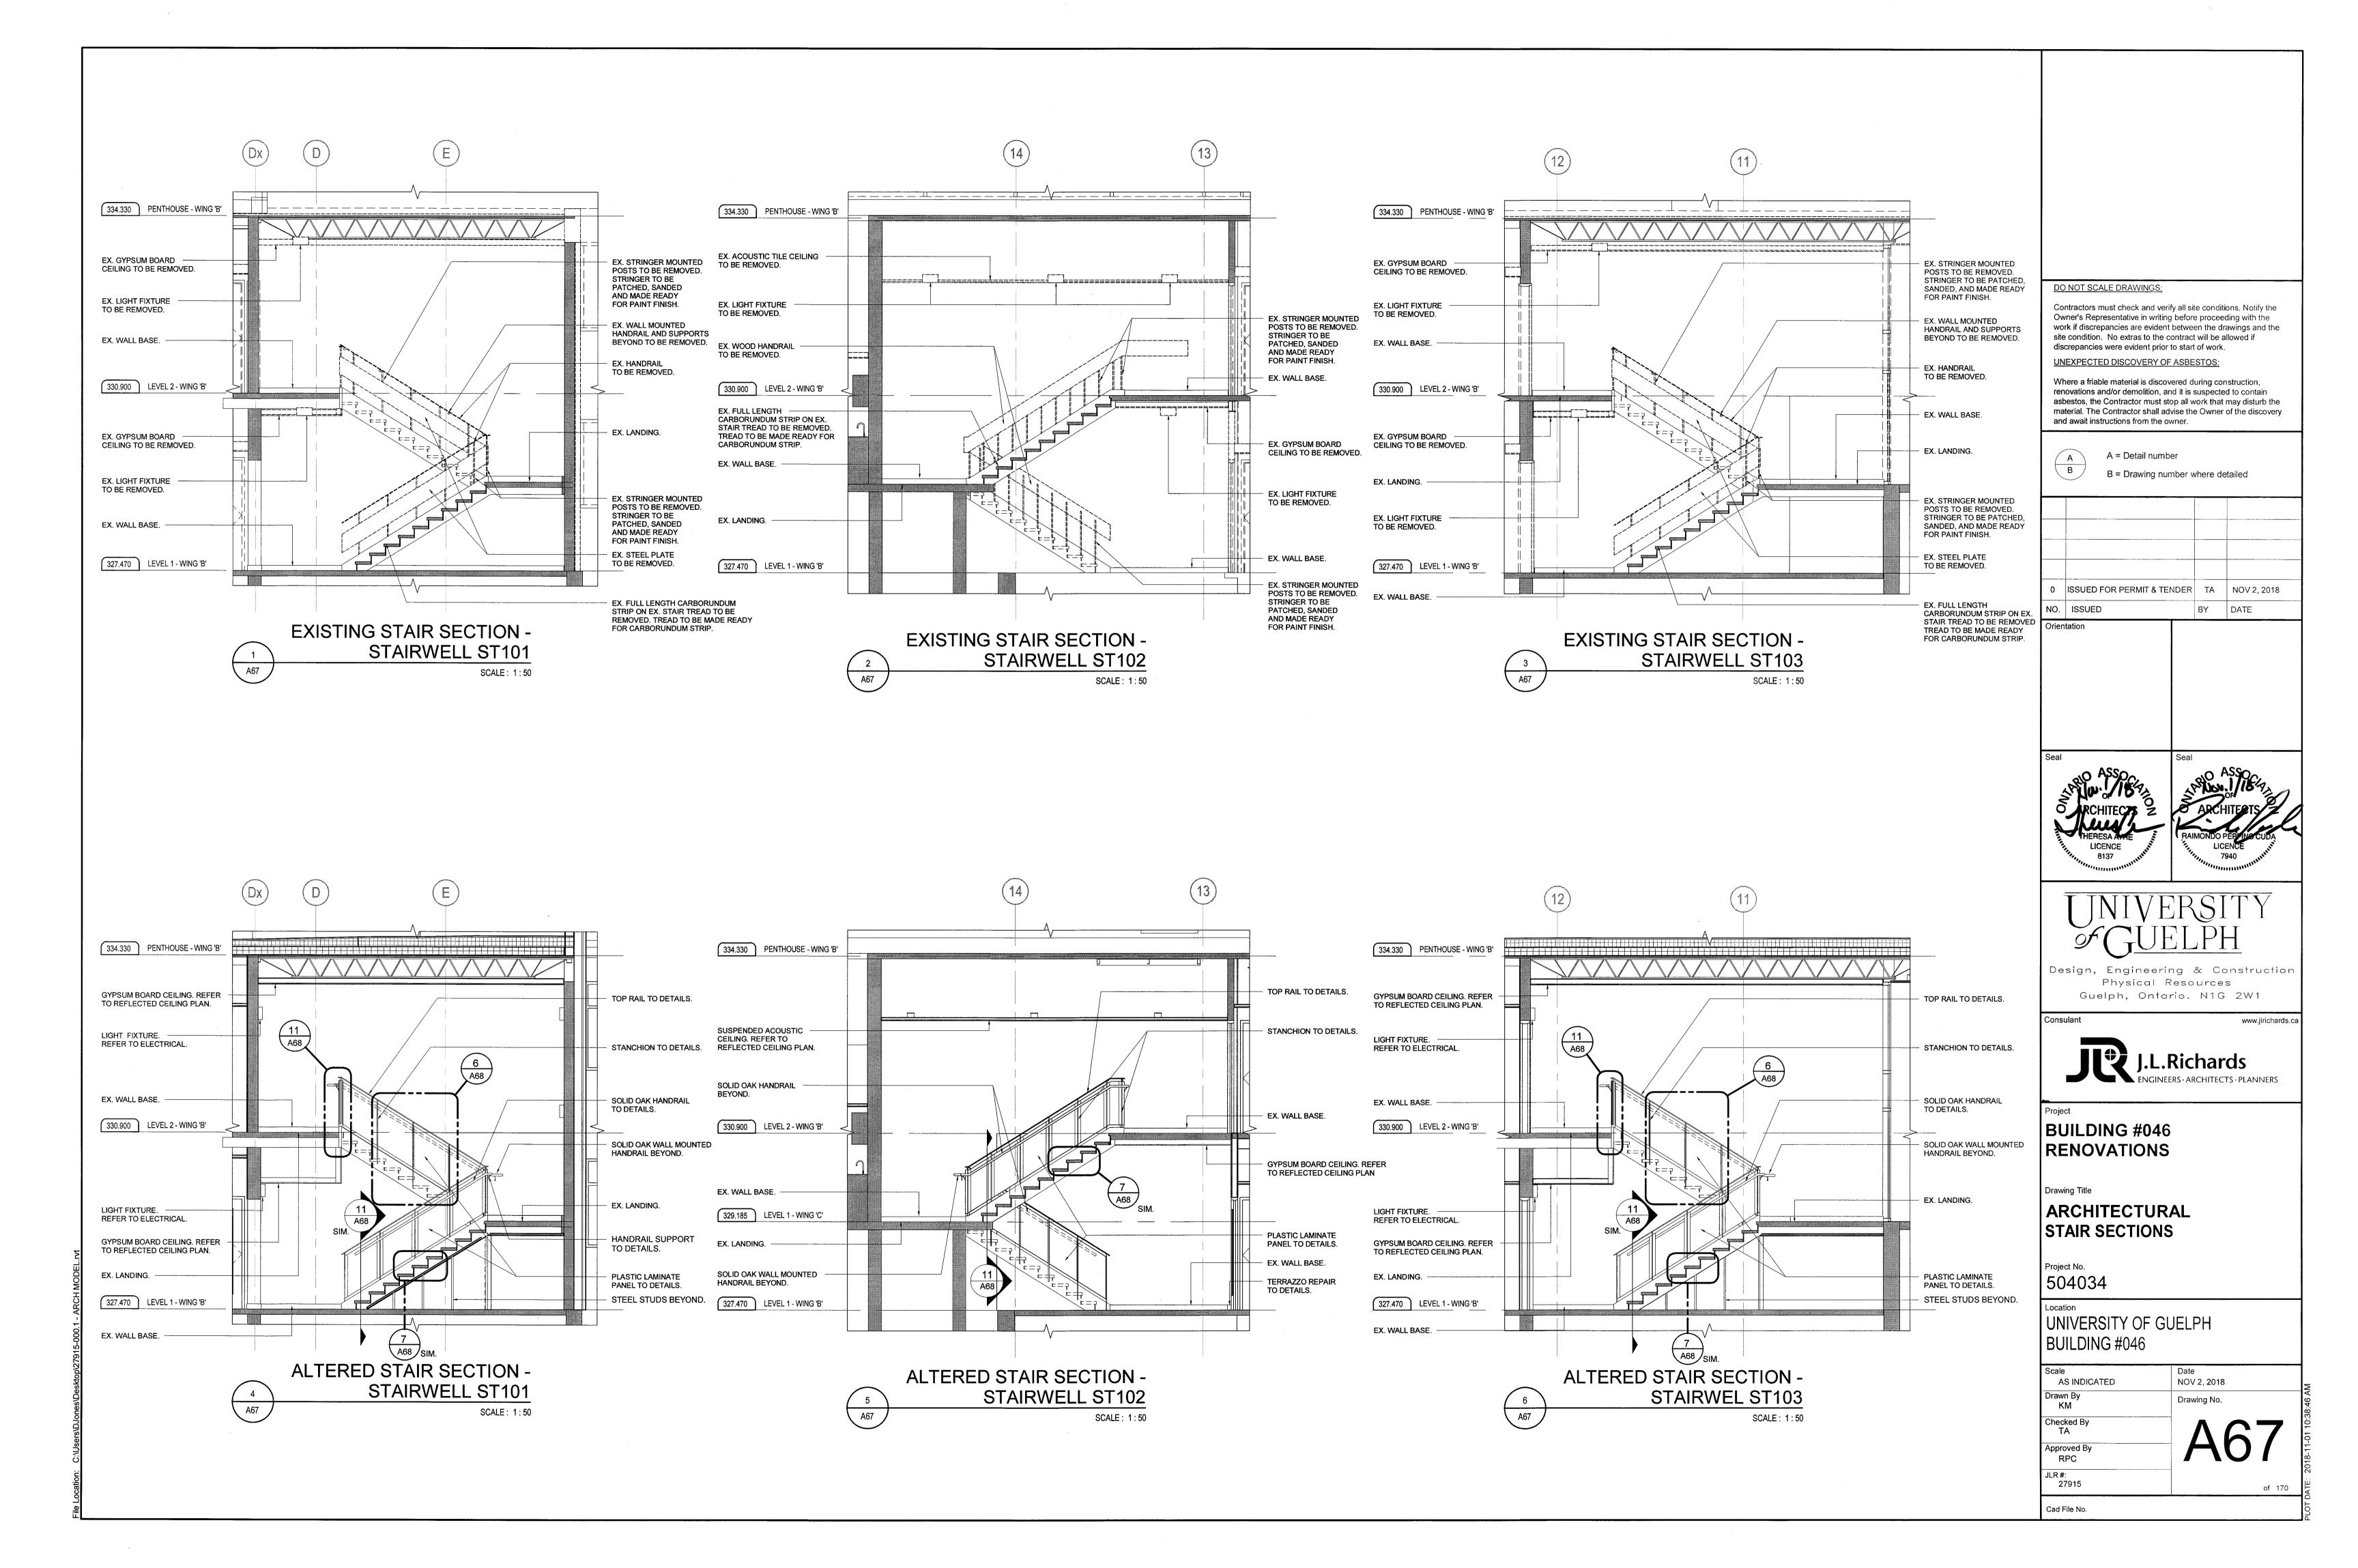

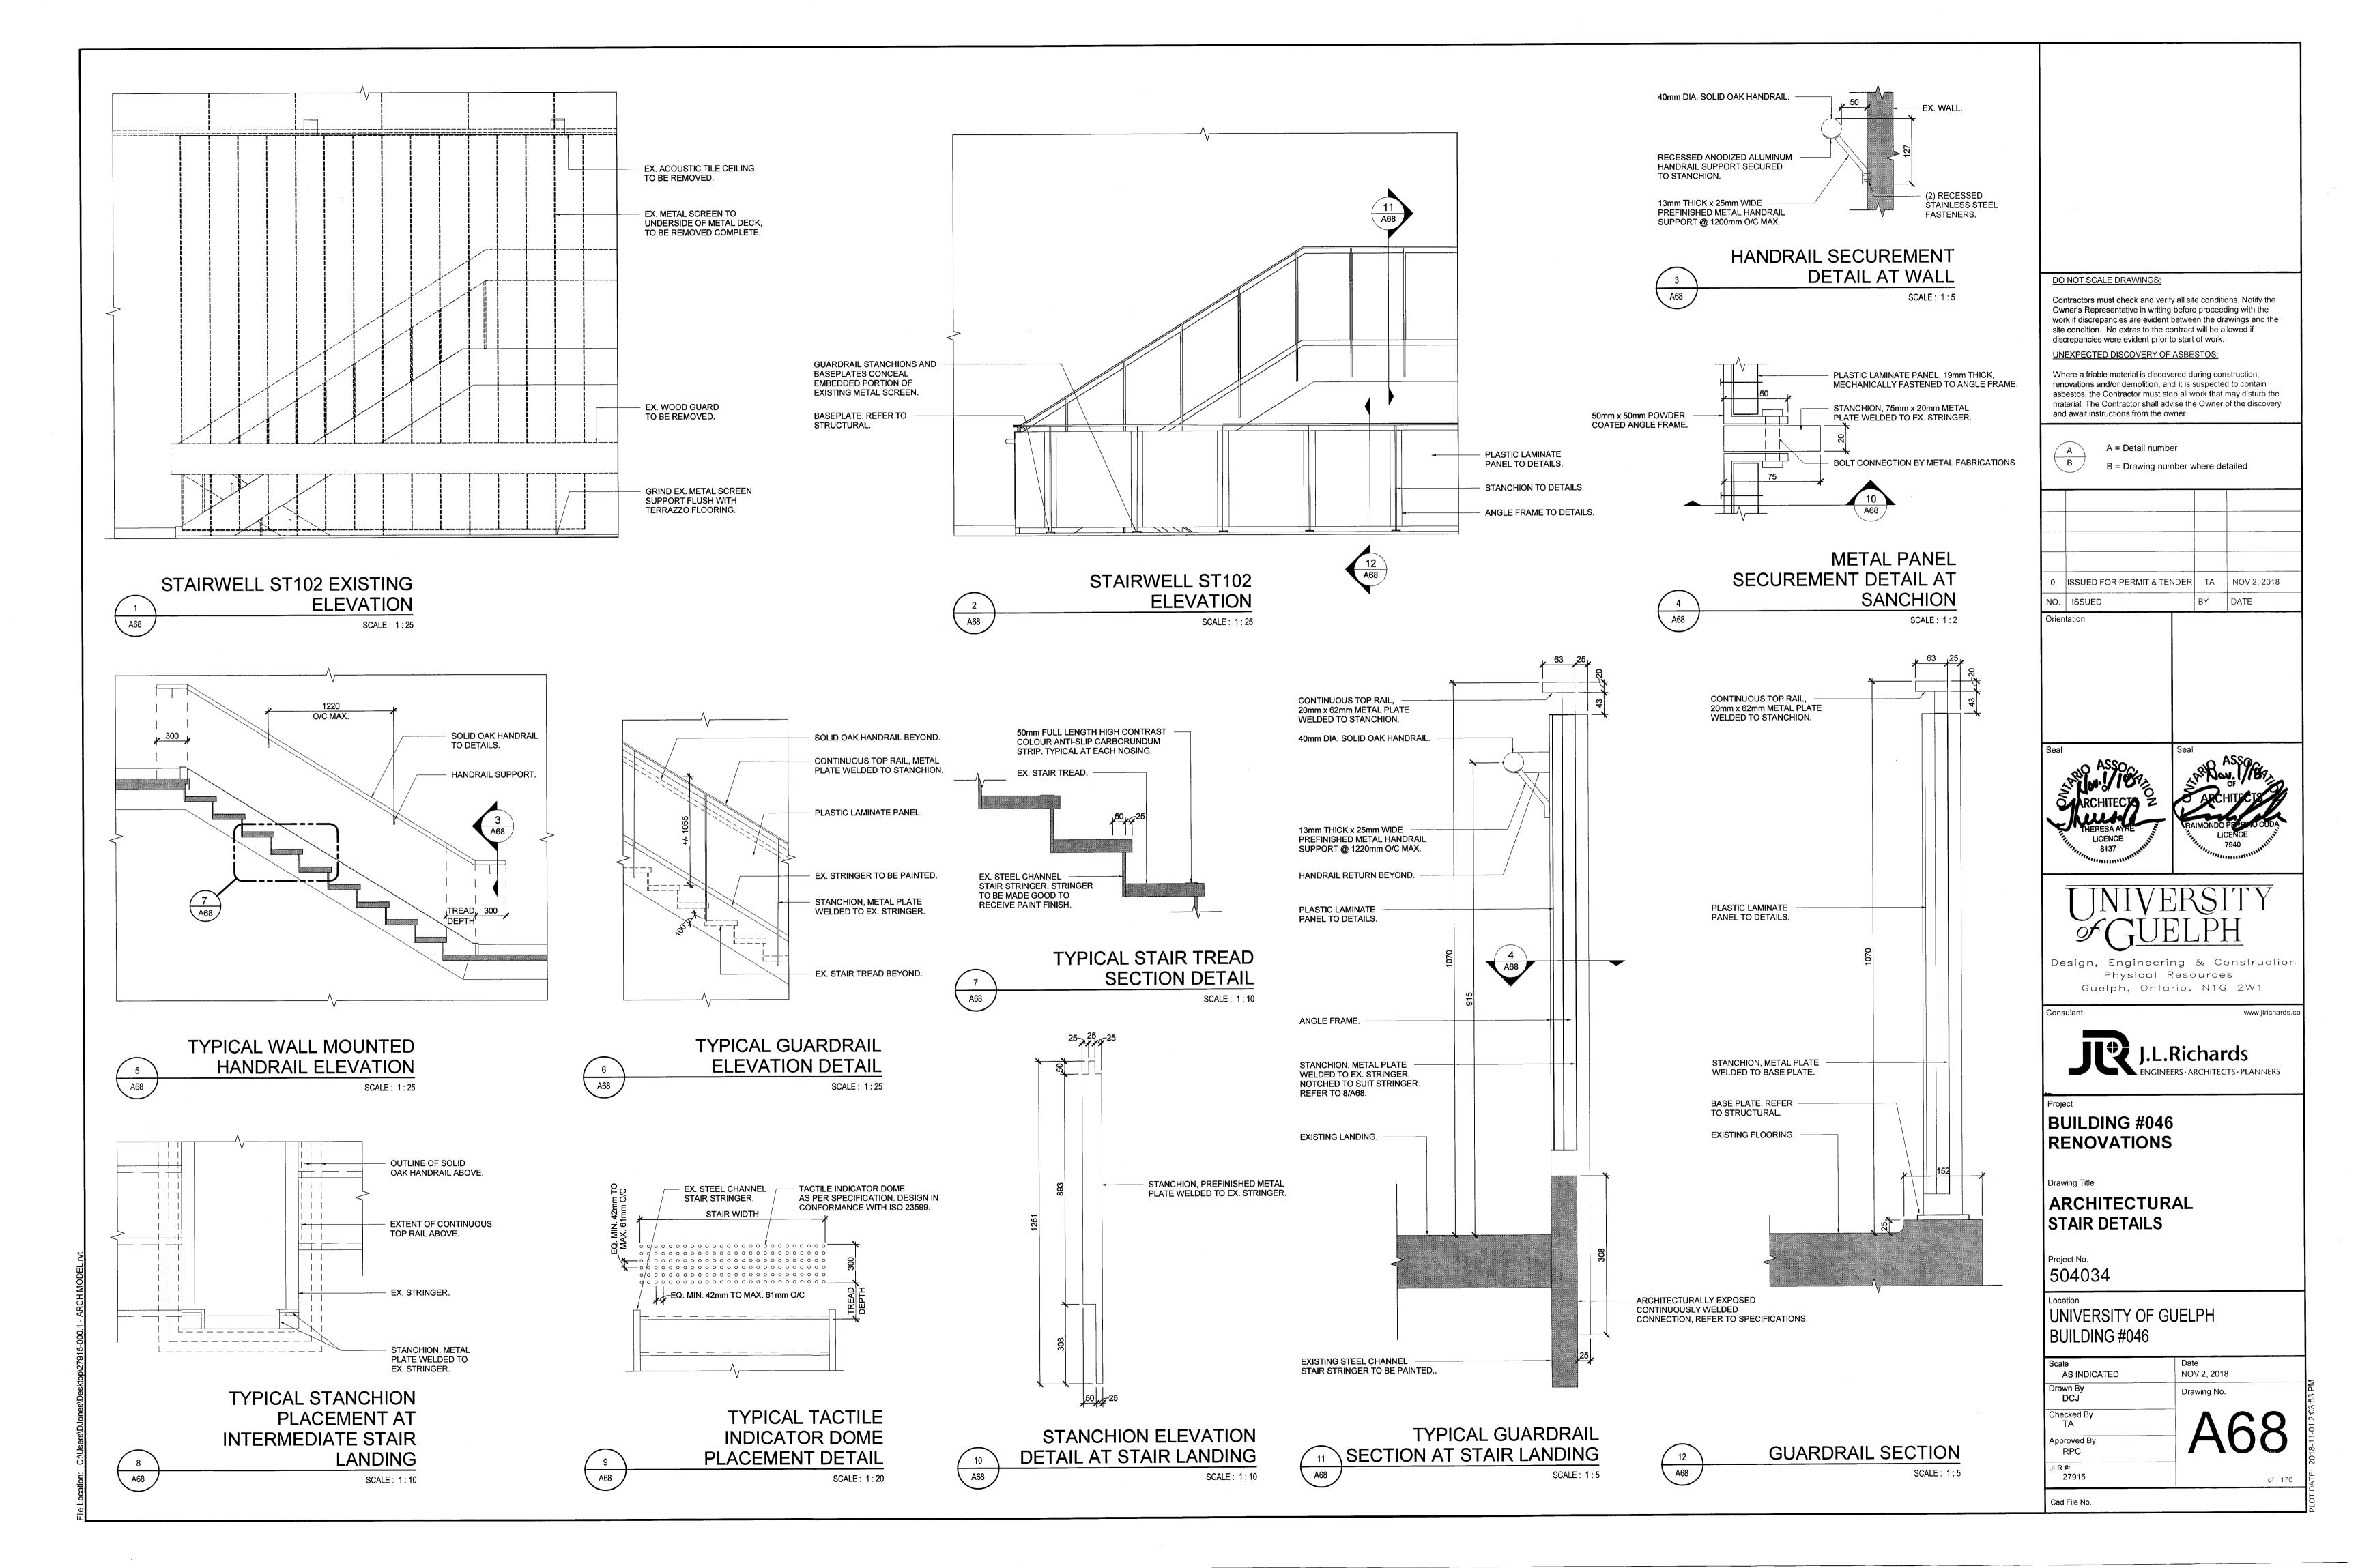

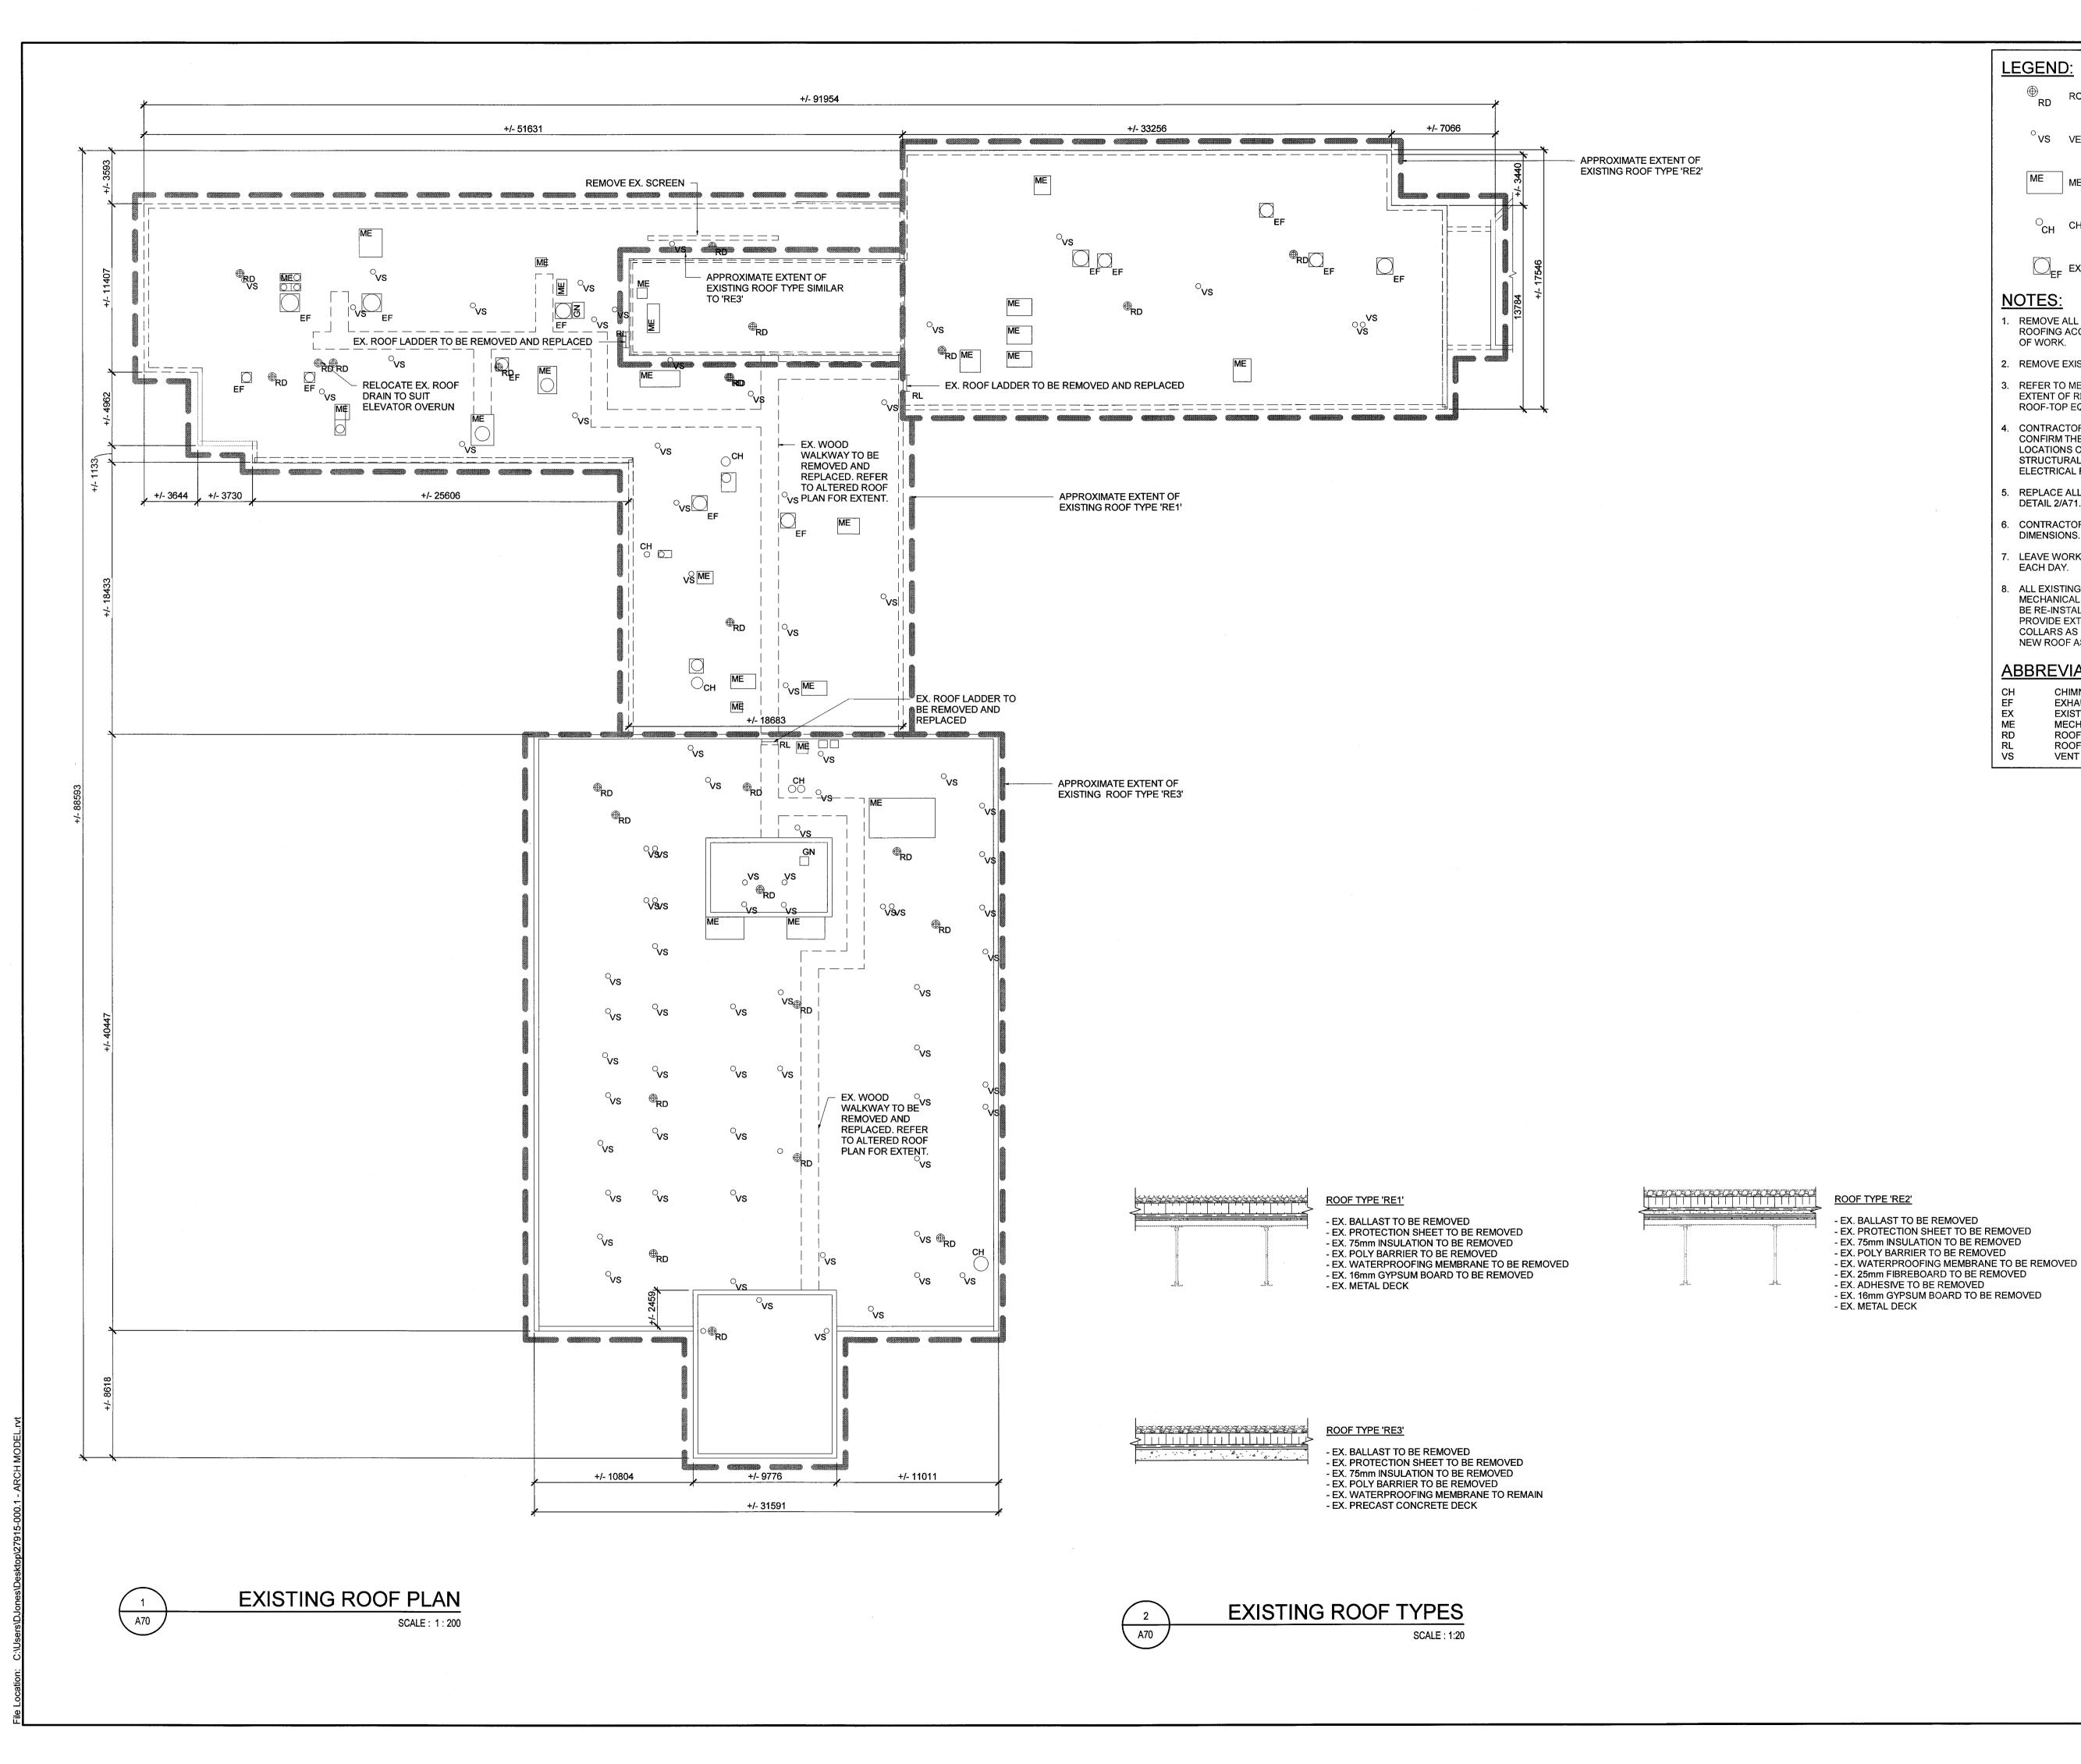



® ROOF DRAIN

[○]VS VENT STACK



CH CHIMNEY

EXHAUST FAN


NOTES:

- REMOVE ALL EXISTING ROOFING AND ROOFING ACCESSORIES TO DECK IN AREA
- 2. REMOVE EXISTING METAL FLASHING
- 3. REFER TO MECHANICAL DRAWINGS FOR EXTENT OF REMOVAL OF EXISTING ROOF-TOP EQUIPMENT.
- . CONTRACTOR IS RESPONSIBLE TO CONFIRM THE QUANTITY AND EXACT LOCATIONS ON SITE OF AL THE EXISTING STRUCTURAL, MECHANICAL AND ELECTRICAL ROOF PENETRATIONS.
- 5. REPLACE ALL ROOF DRAINS. REFER TO DETAIL 2/A71.
- 6. CONTRACTOR TO FIELD VERIFY ALL DIMENSIONS.
- 7. LEAVE WORK AREA CLEAN AT END OF EACH DAY.
- 8. ALL EXISTING VENT STACKS AND MECHANICAL EQUIPMENT ON WING 'A' TO BE RE-INSTALLED. CONTRACTOR TO PROVIDE EXTENSIONS AND NEW METAL COLLARS AS REQUIRED TO ACCOMODATE NEW ROOF ASSEMBLY.

ABBREVIATIONS:

ROOF DRAIN ROOF LADDER VENT STACK

CHIMNEY **EXHAUST FAN** EX ME RD EXISTING MECHANICAL EQUIPMENT

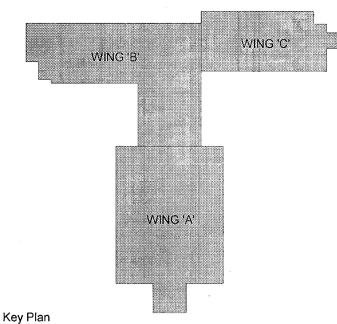

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BUILDING #046 RENOVATIONS


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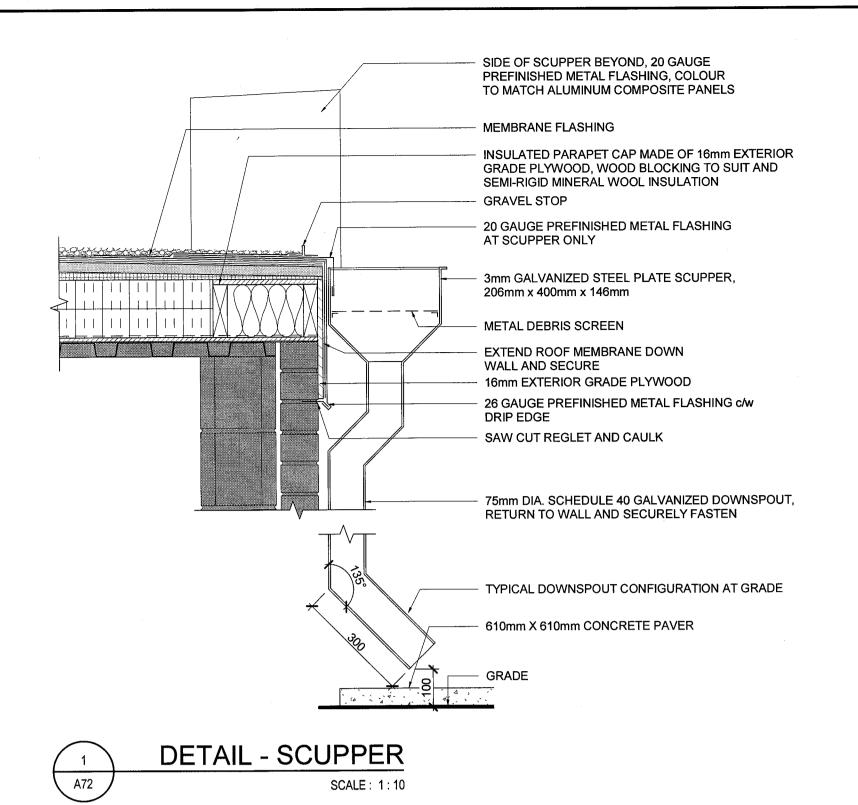
ARCHITECTURAL **EXISTING ROOF PLAN**

Project No. 504034

UNIVERSITY OF GUELPH BUILDING #046

NOV 2, 2018 AS INDICATED Drawing No. DCJ Checked By TA Approved By RPC 27915 Cad File No.



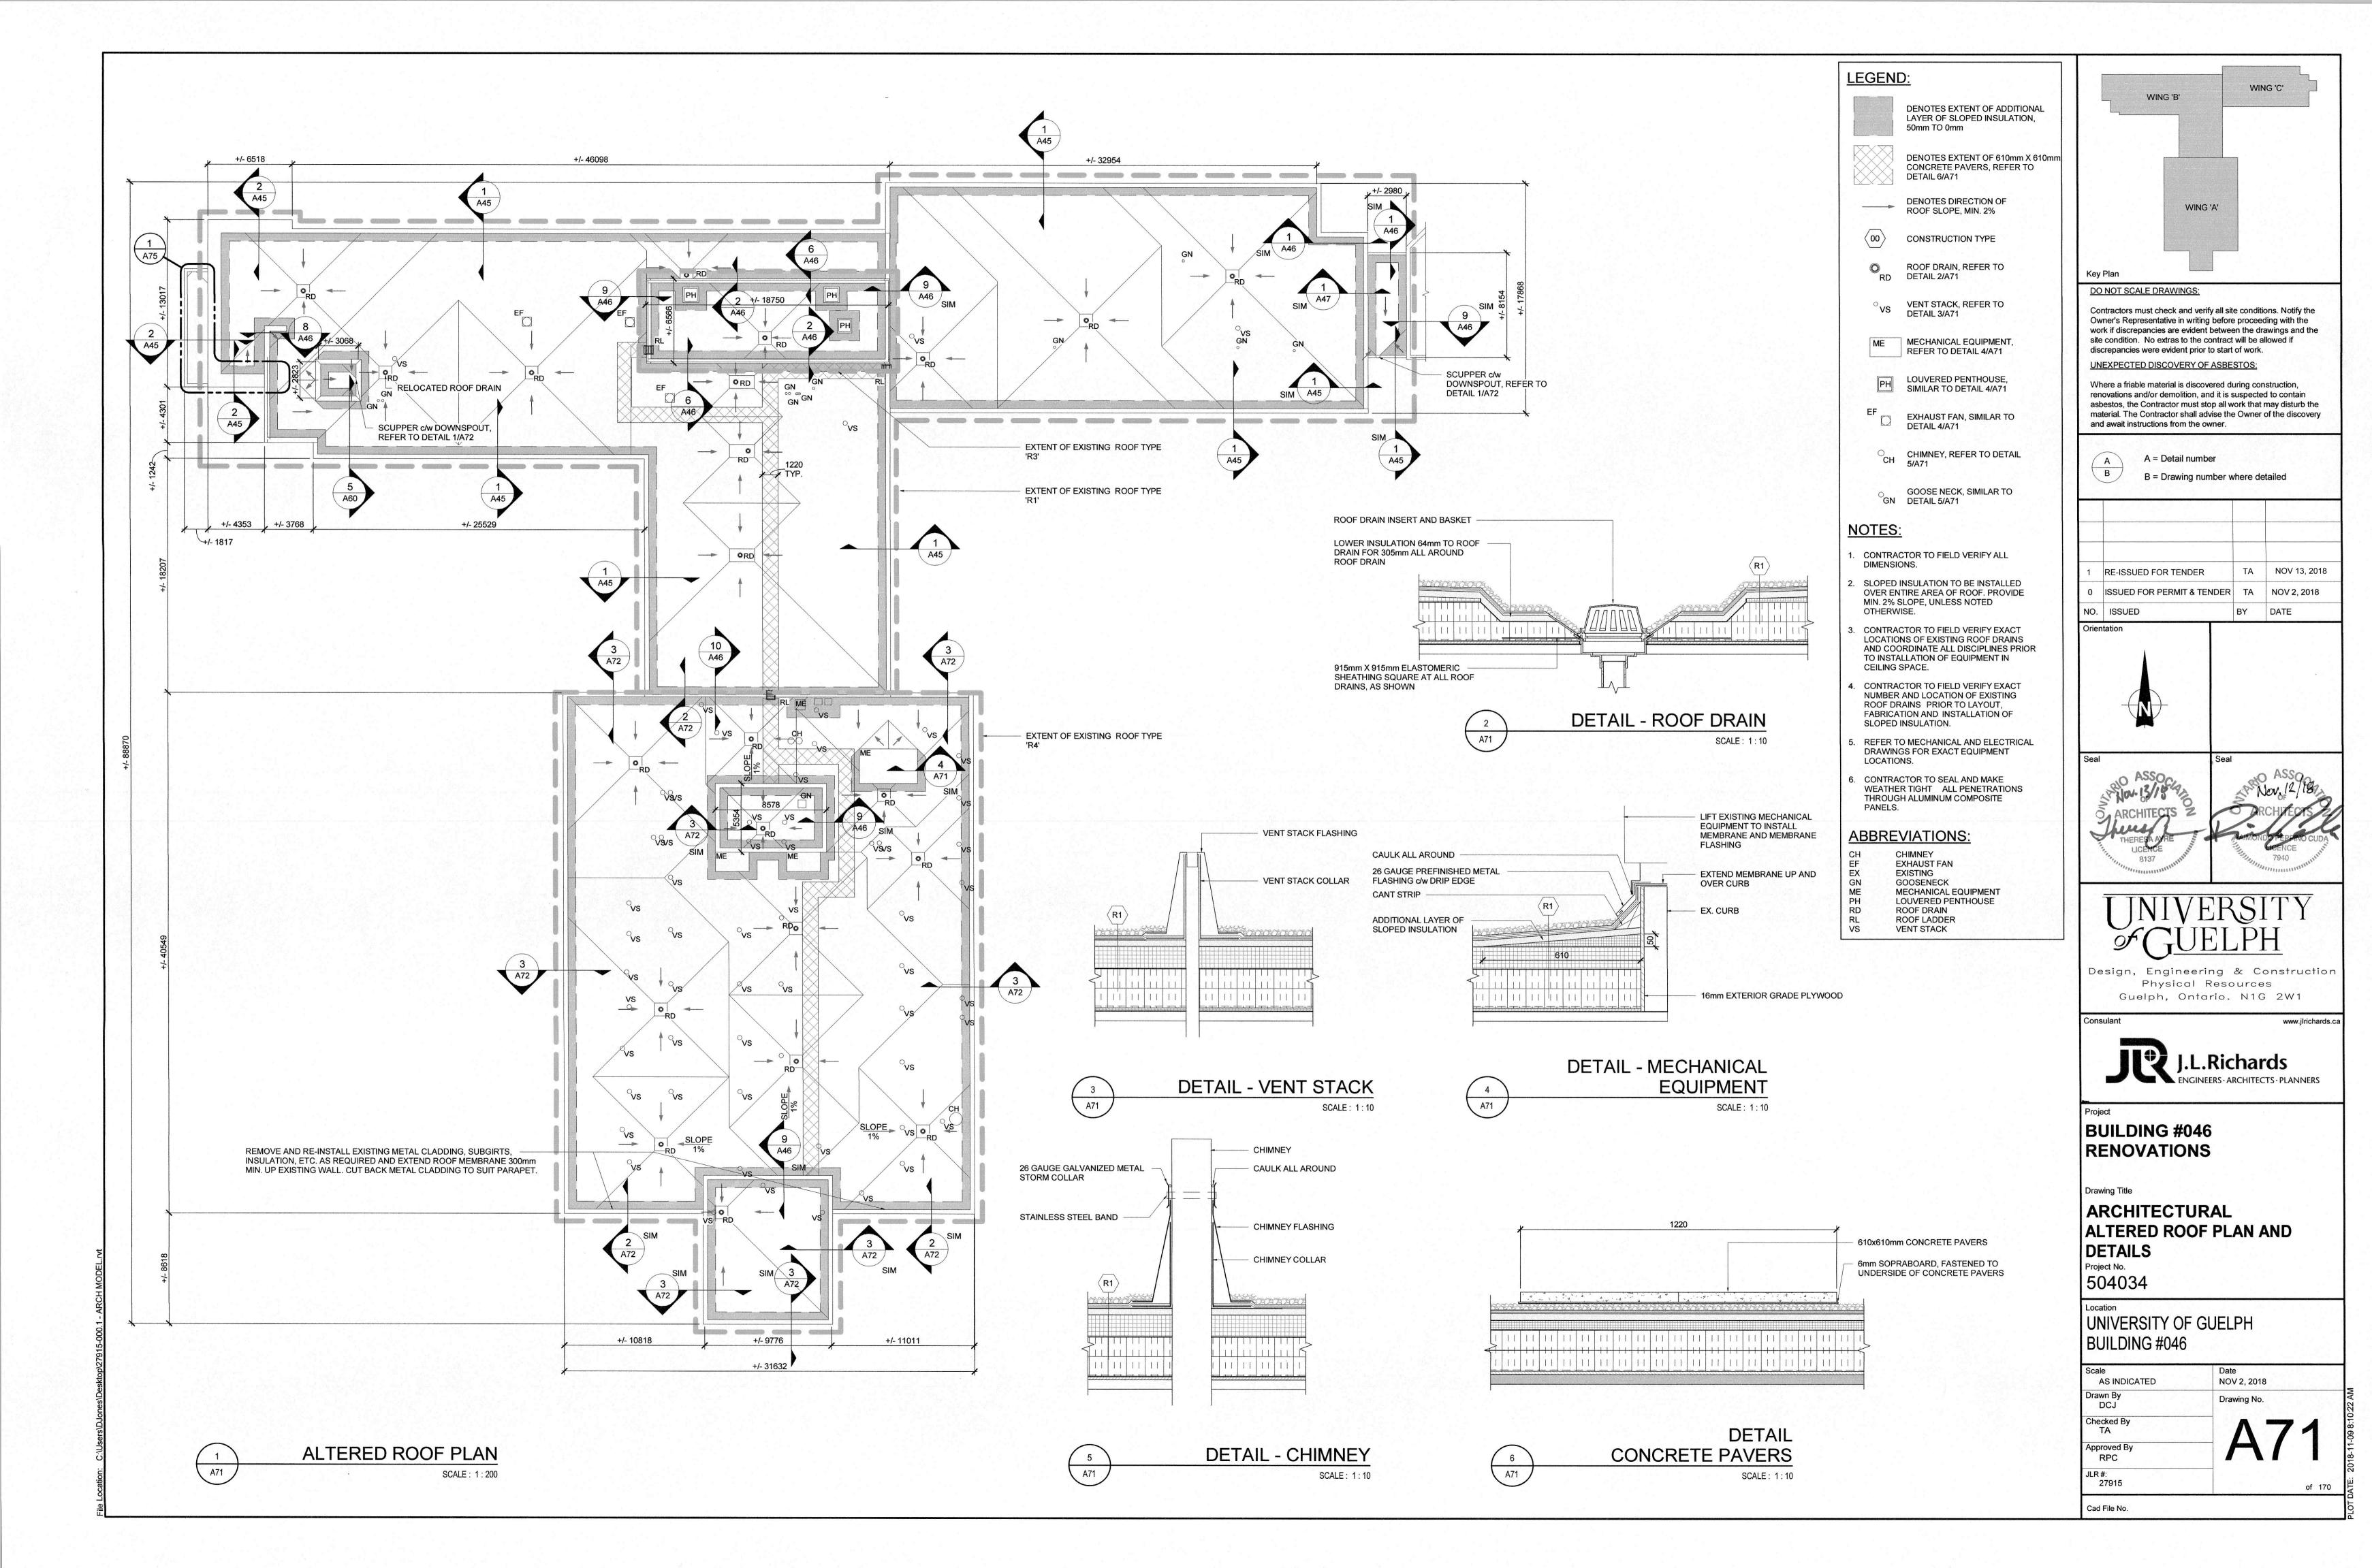

FULLY INSULATED H.M. DOOR AND THERMALLY BROKEN FRAME, REFER TO DOOR AND FRAME

THERMALLY BROKEN THRESHOLD,

EXTEND MEMBRANE UP AND OVER

26 GAUGE PREFINISHED METAL

FLASHING c/w DRIP EDGE

ADDITIONAL LAYER OF

SLOPED INSULATION


SCHEDULE

- CANT STRIP


FULL WIDTH OF WALL

WEATHERSTRIPPING


CURB AND SECURE

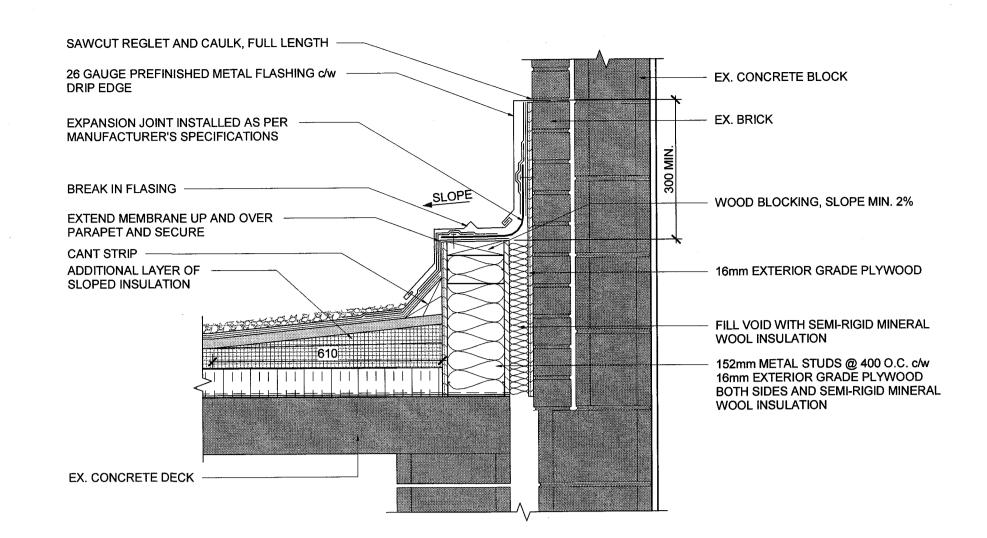



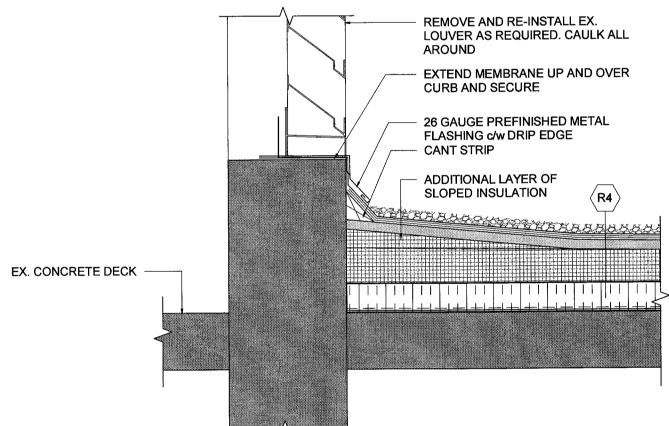



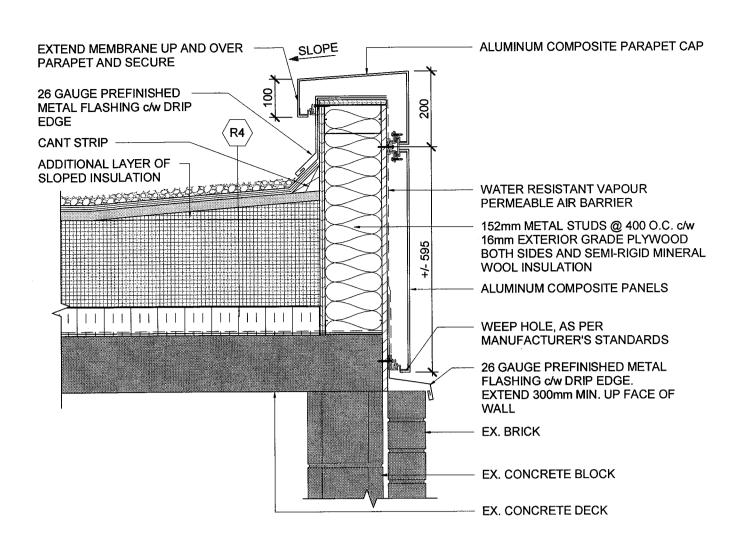





1. CONTRACTOR TO SEAL AND MAKE WEATHER TIGHT ALL PENETRATIONS THROUGH ALUMINUM COMPOSITE

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BUILDING #046 RENOVATIONS

Drawing Title

ARCHITECTURAL **ROOF DETAILS**

504034

UNIVERSITY OF GUELPH BUILDING #046

NOV 2, 2018 AS INDICATED Drawn By DCJ Checked By TA Approved By RPC

27915


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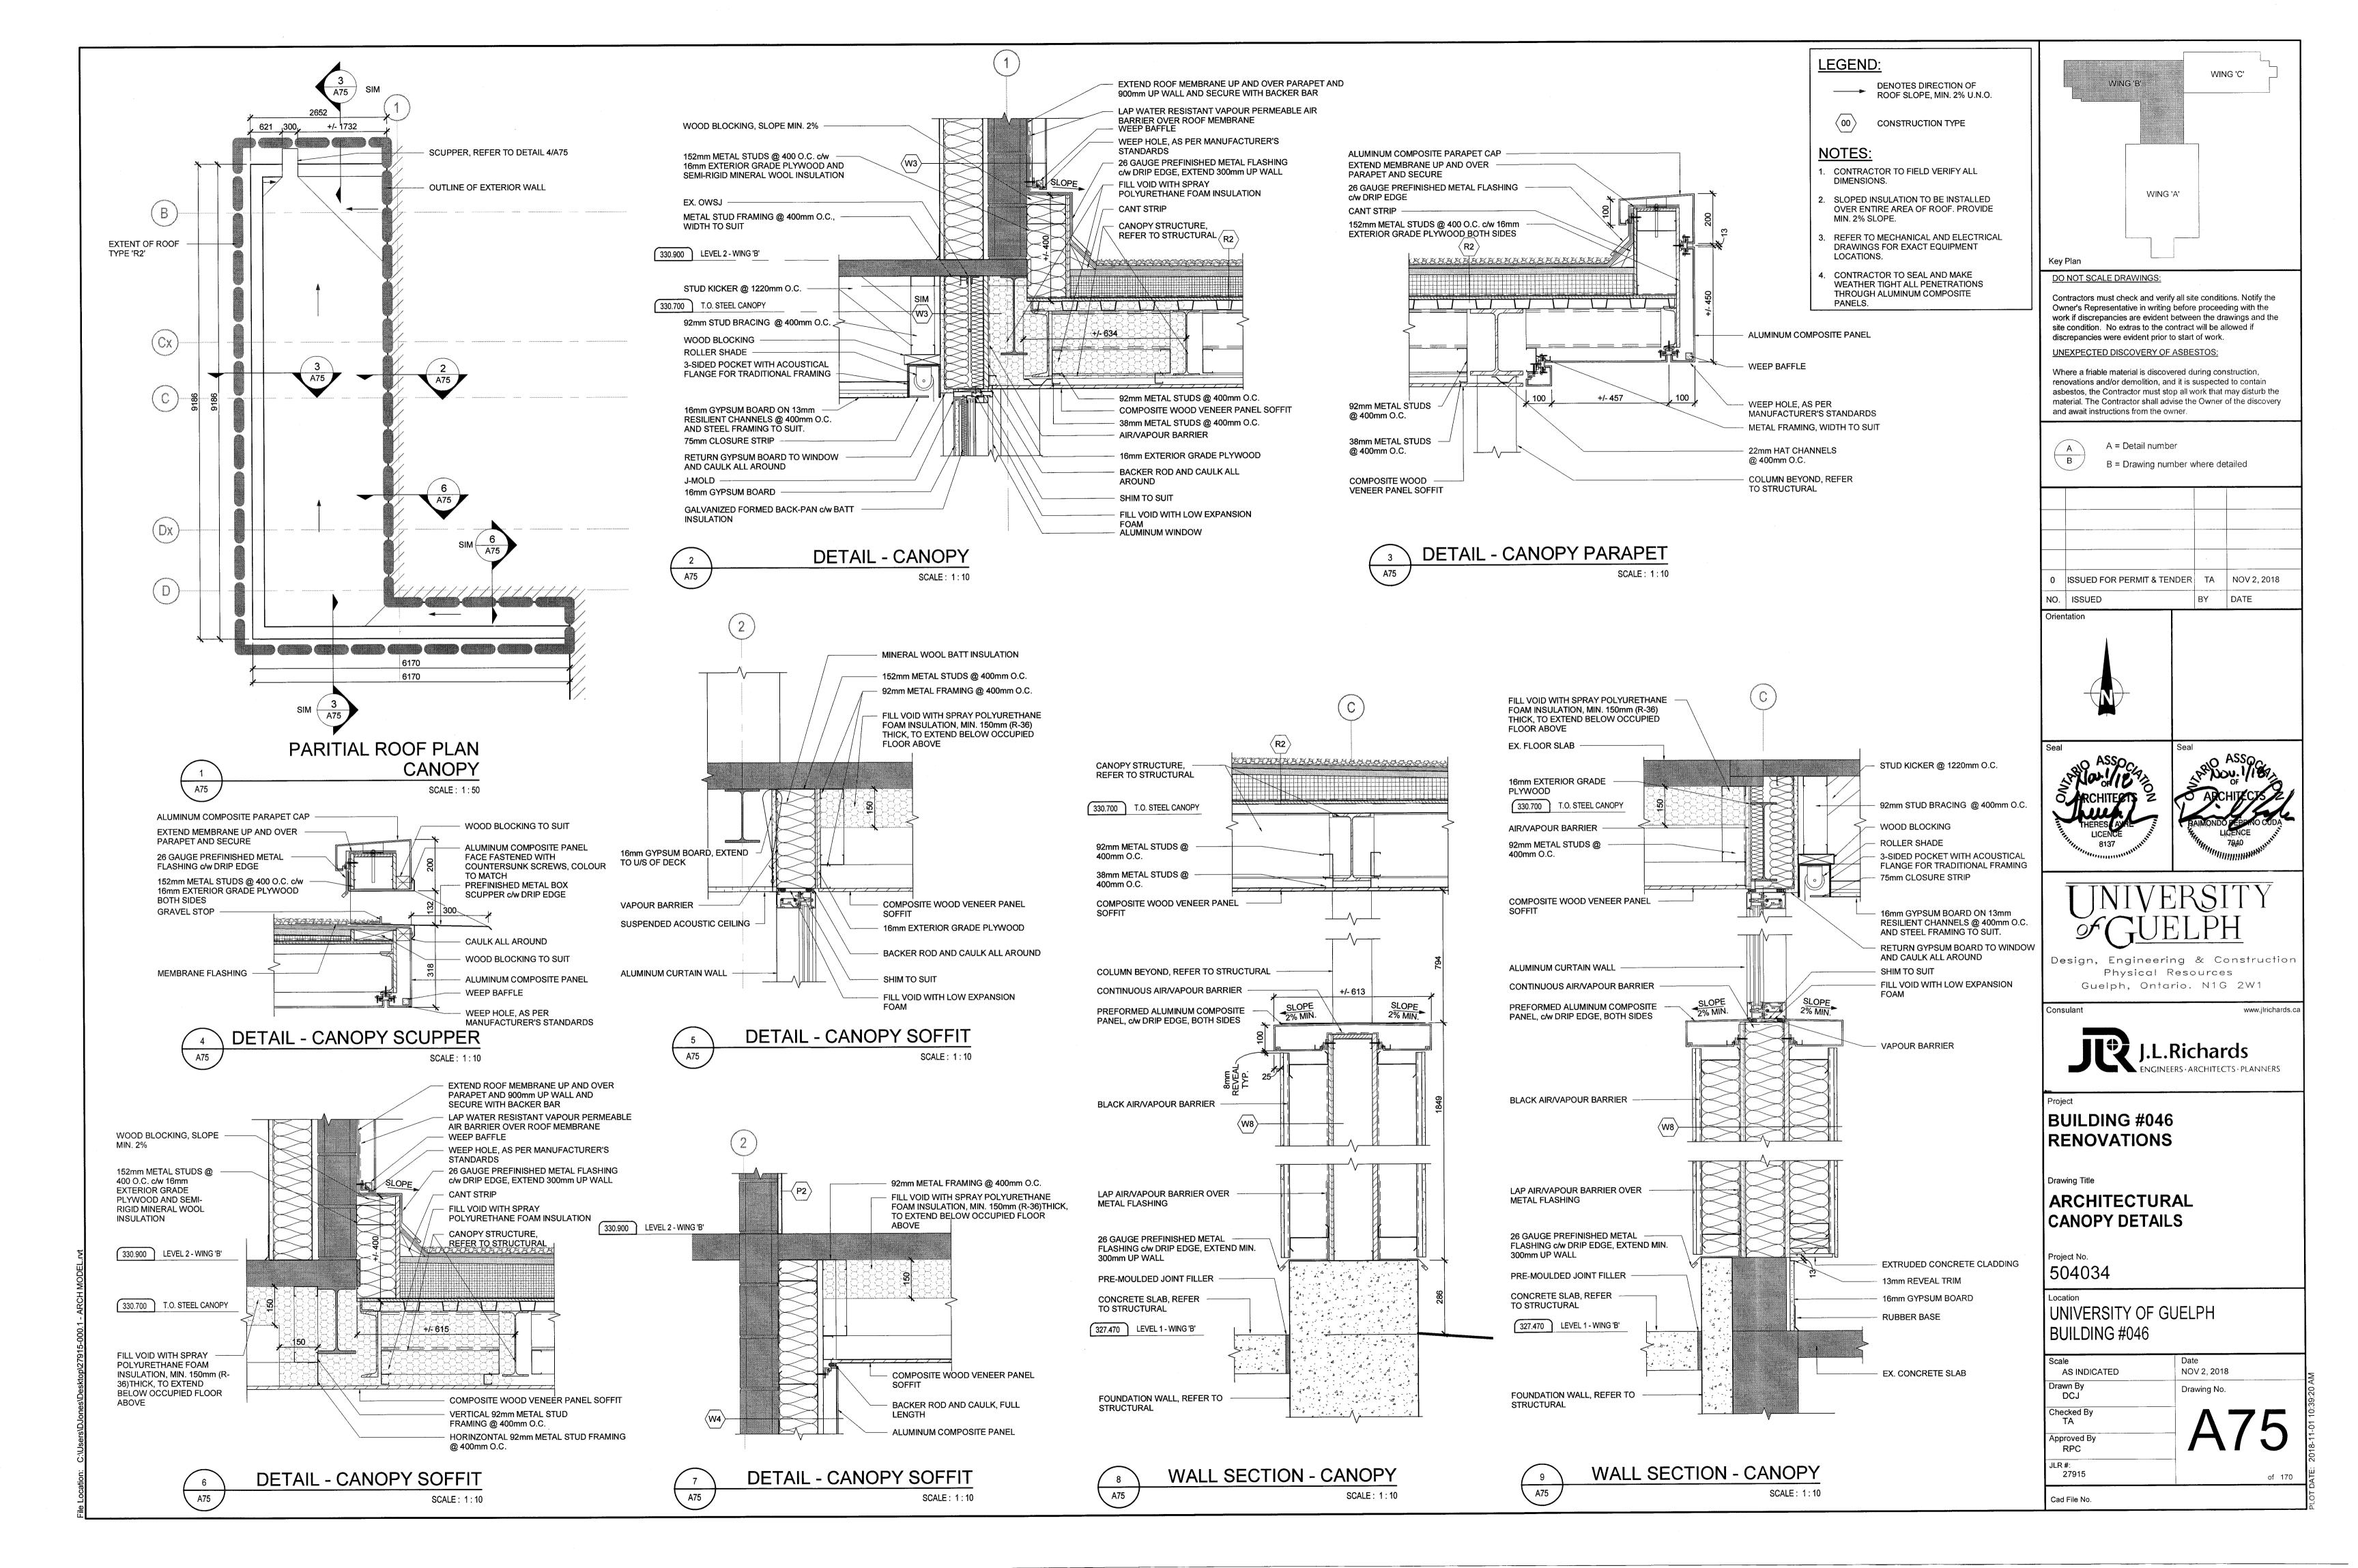
DETAIL - PENTHOUSE CURB SCALE: 1:10


EXTEND EX. CURB. REFER

EX. CONCRETE DECK -

TO STRUCTURAL



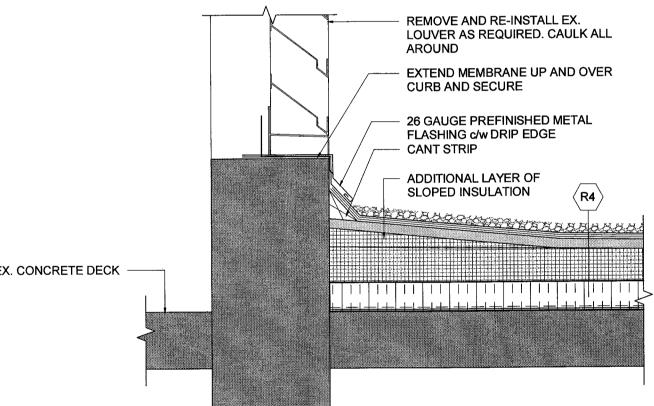

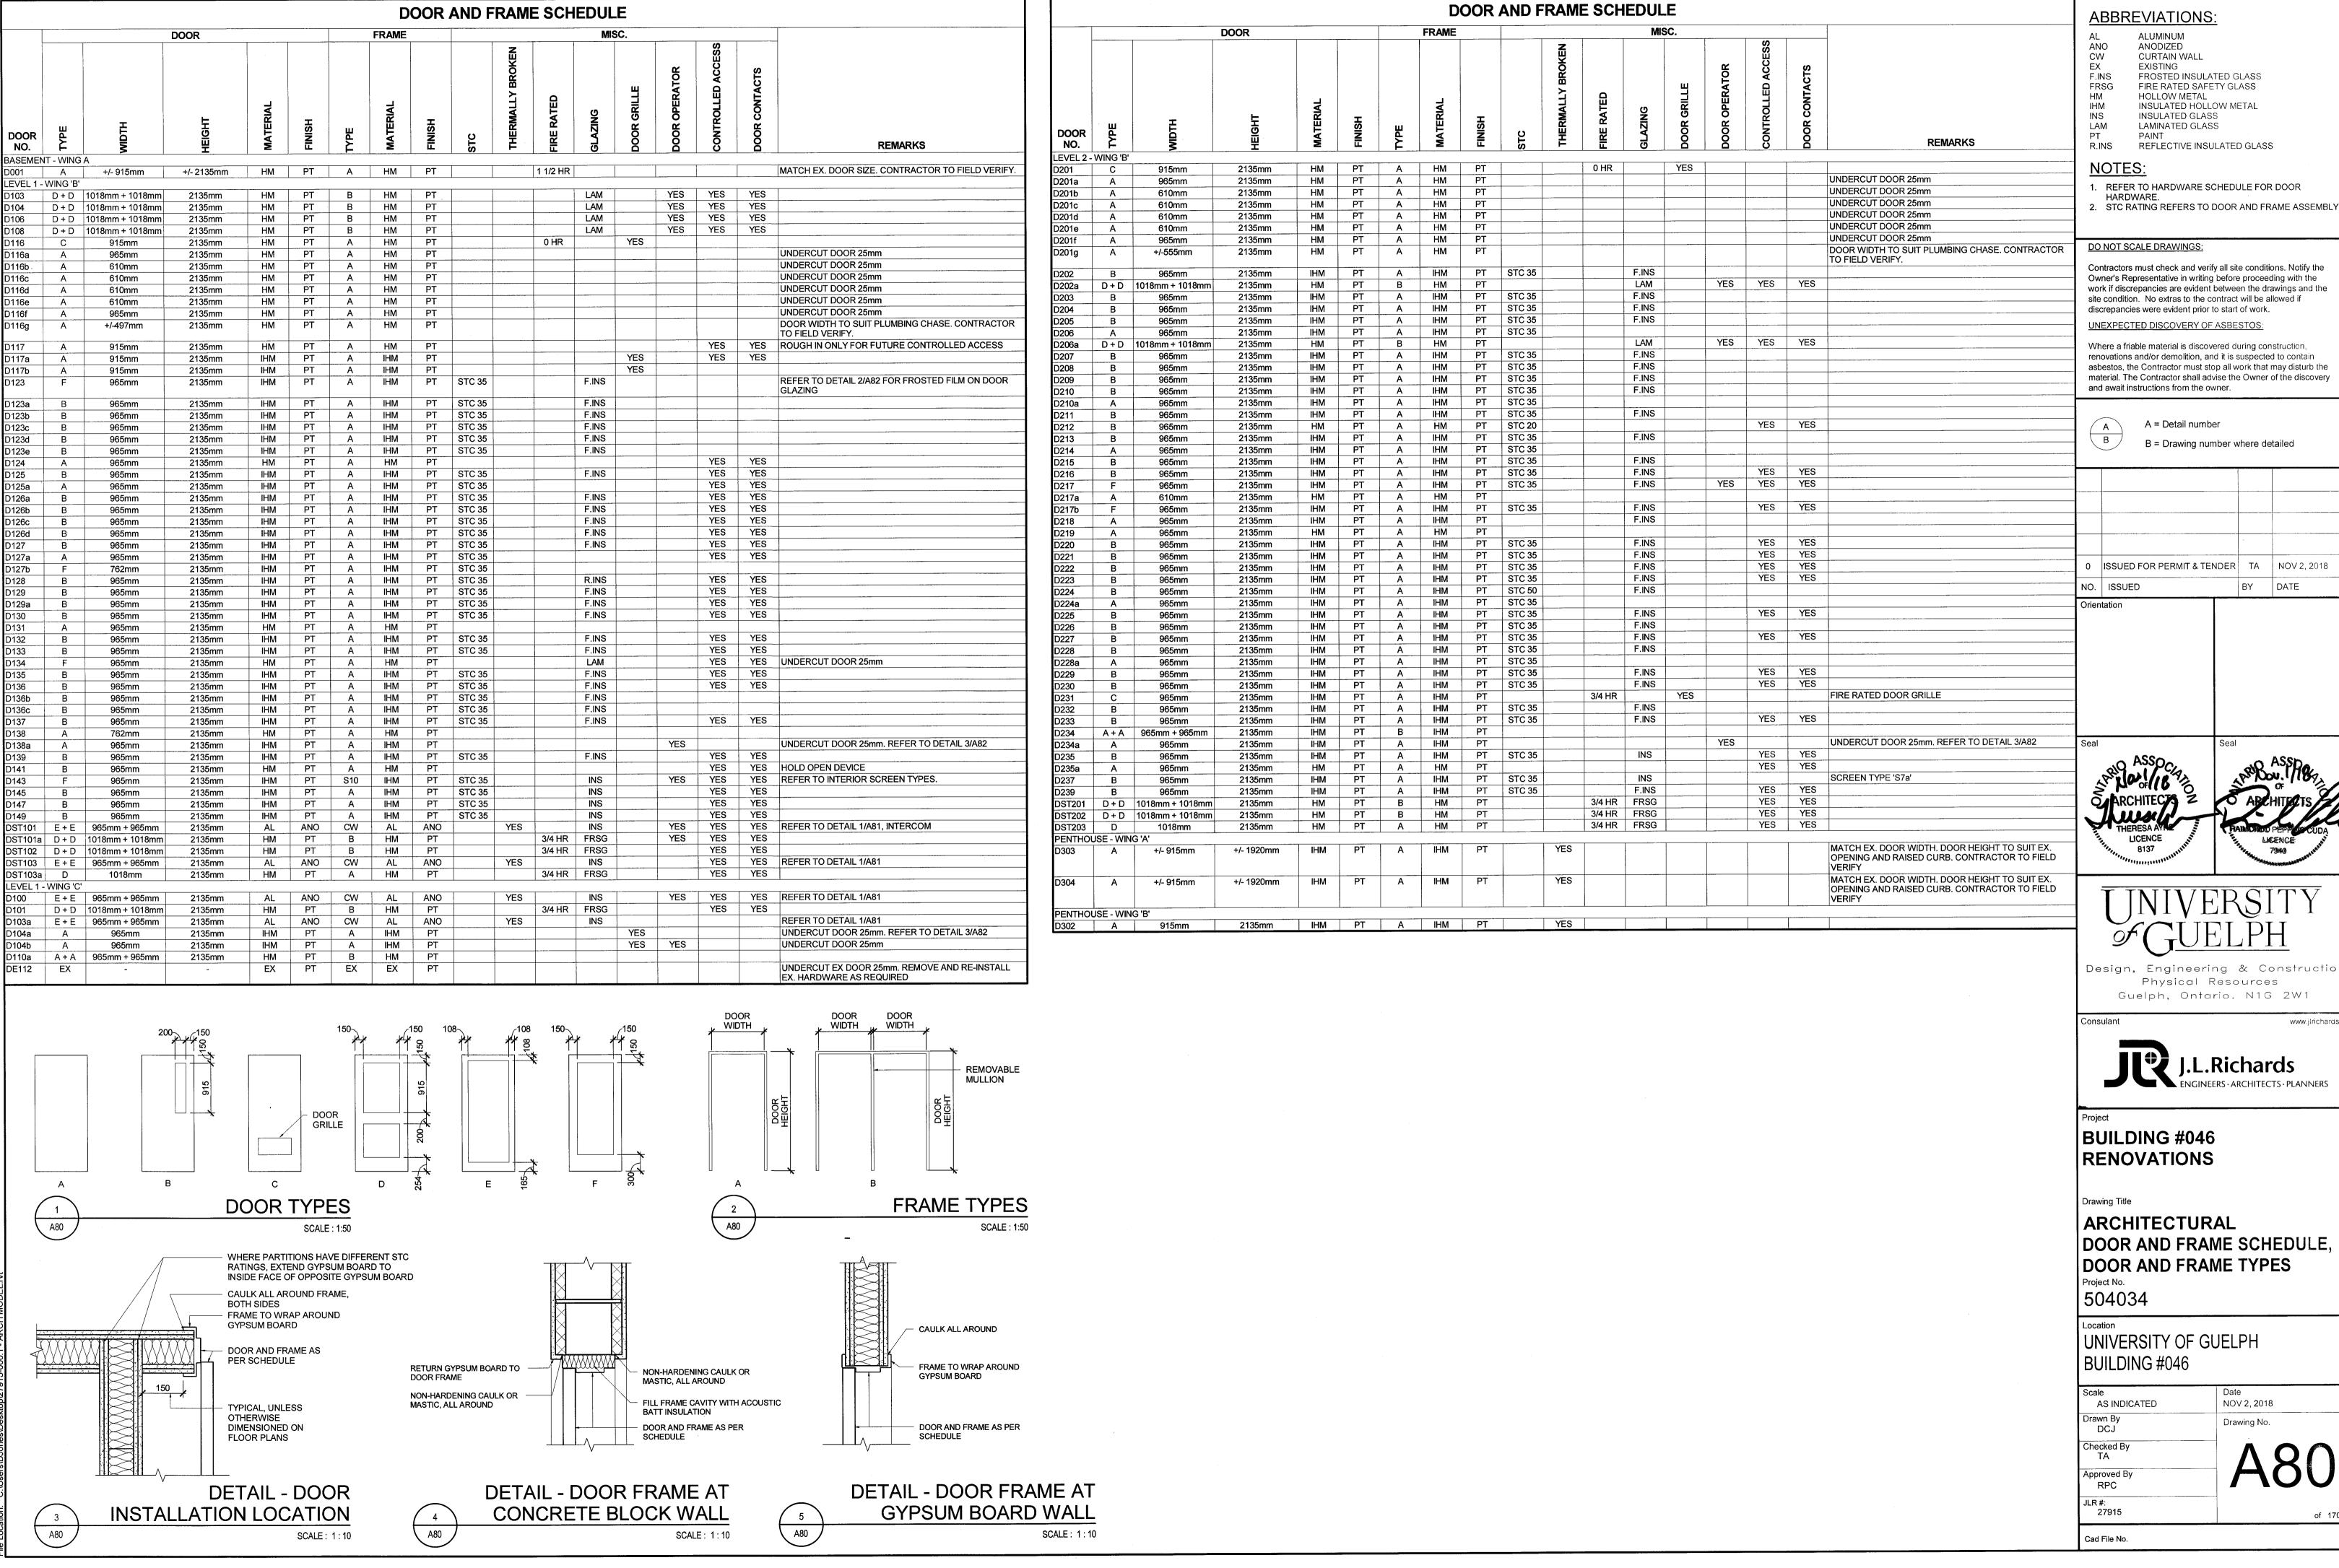

ABBREVIATIONS:

ALUMINUM ANODIZED

CURTAIN WALL EXISTING FROSTED INSULATED GLASS

FIRE RATED SAFETY GLASS HOLLOW METAL **INSULATED HOLLOW METAL INSULATED GLASS**

LAMINATED GLASS REFLECTIVE INSULATED GLASS

1. REFER TO HARDWARE SCHEDULE FOR DOOR

Contractors must check and verify all site conditions. Notify the Owner's Representative in writing before proceeding with the work if discrepancies are evident between the drawings and the site condition. No extras to the contract will be allowed if


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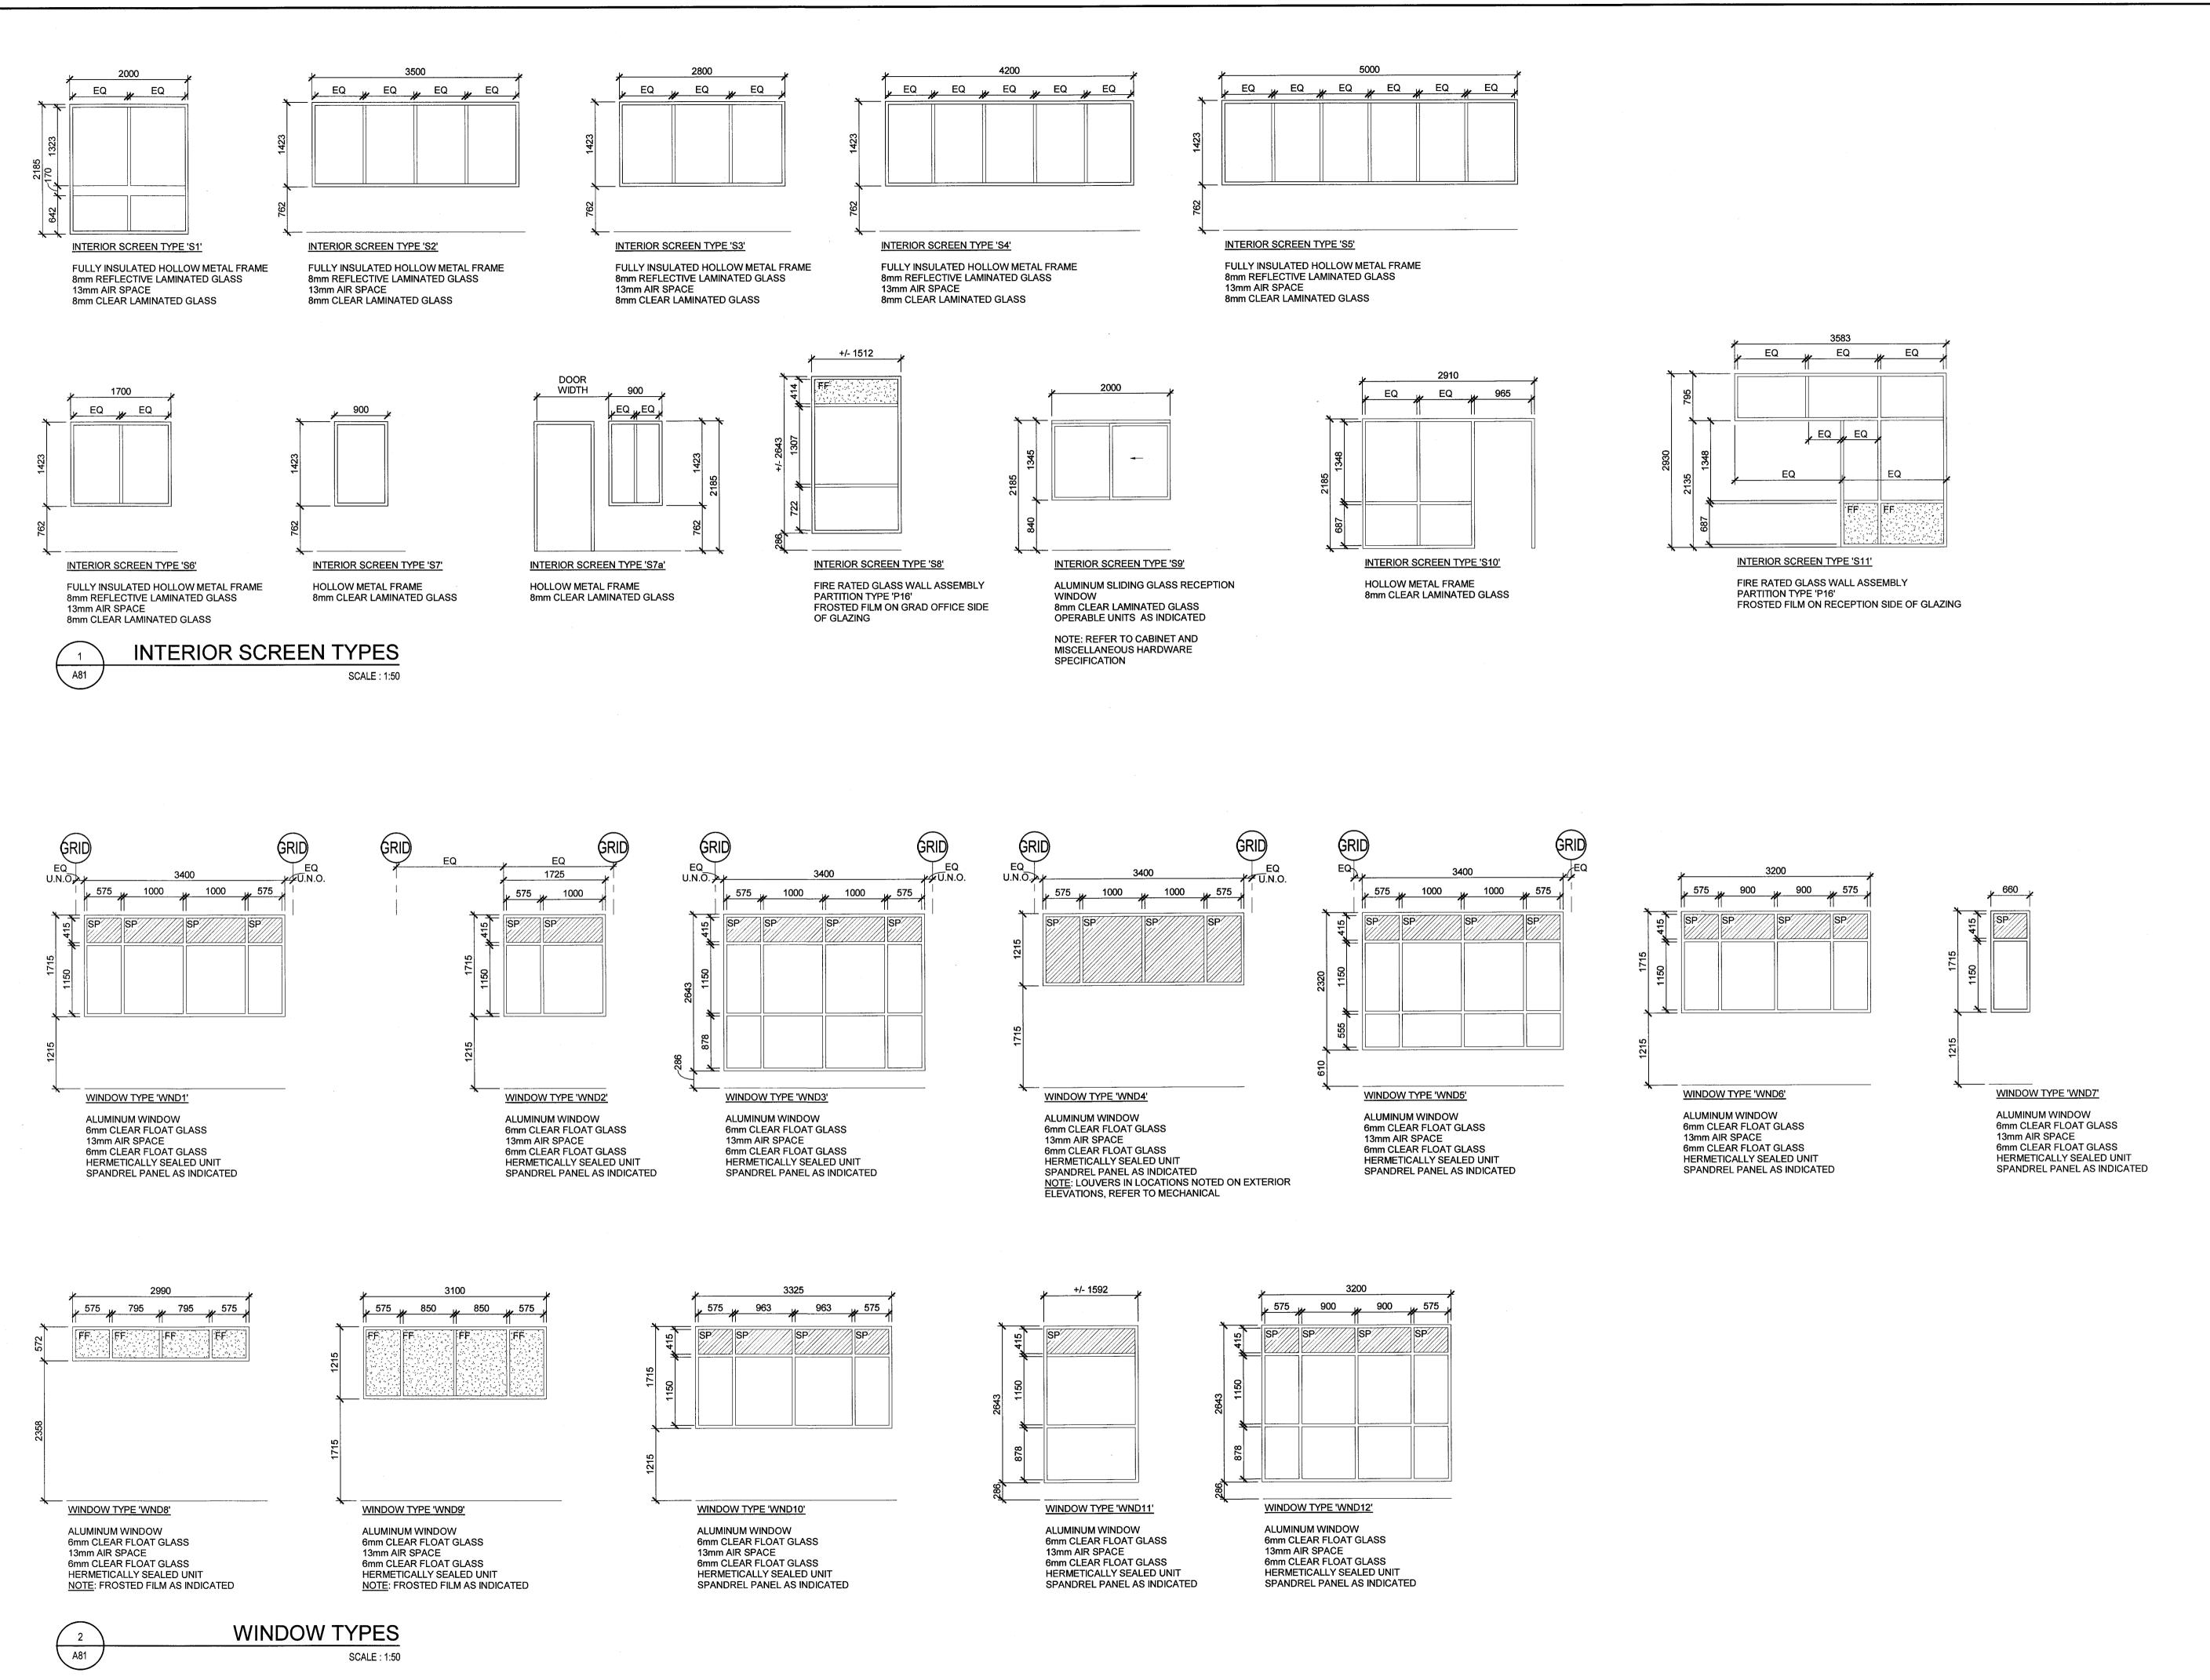
BUILDING #046

ARCHITECTURAL DOOR AND FRAME SCHEDULE, DOOR AND FRAME TYPES

UNIVERSITY OF GUELPH BUILDING #046

NOV 2, 2018 Drawing No.

of 170

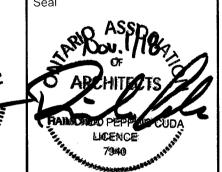

ABBREVIATIONS:

FROSTED FILM LOUVER SPANDREL PANEL

DO NOT SCALE DRAWINGS:

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Orientation

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Guelph, Ontario. N1G 2W1

BUILDING #046 RENOVATIONS

Drawing Title


ARCHITECTURAL INTERIOR SCREEN AND WINDOW TYPES


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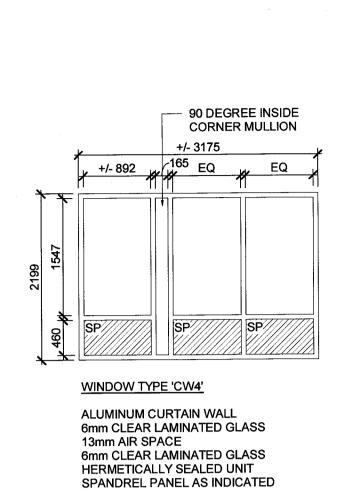
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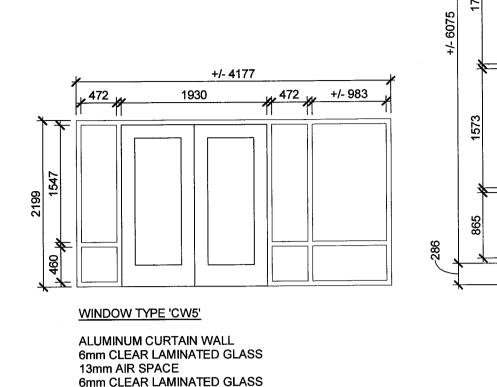
UNIVERSITY OF GUELPH BUILDING #046

AS INDICATED NOV 2, 2018 Drawn By Drawing No. DCJ Checked By Approved By RPC JLR#: 27915 of 170






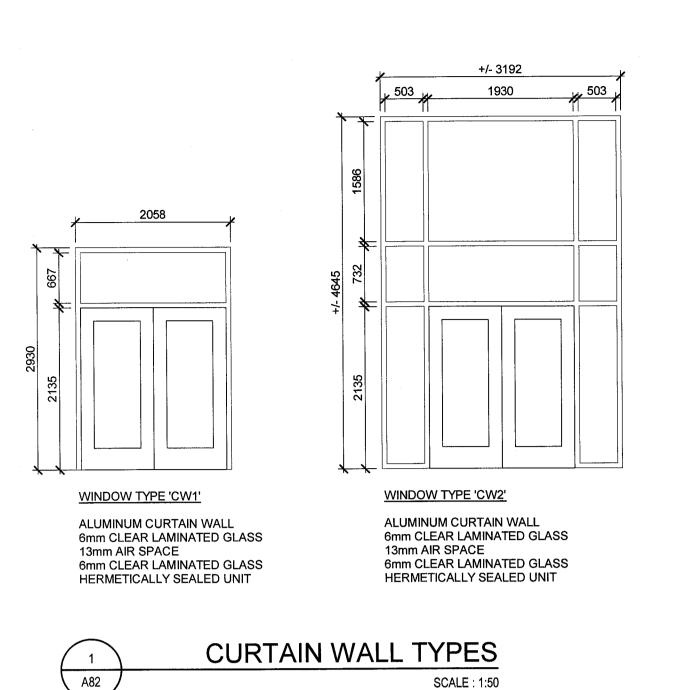

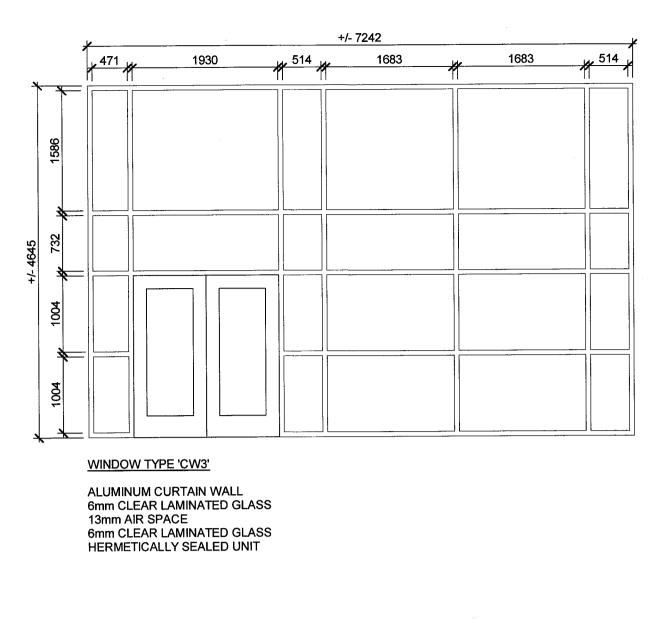

HERMETICALLY SEALED UNIT

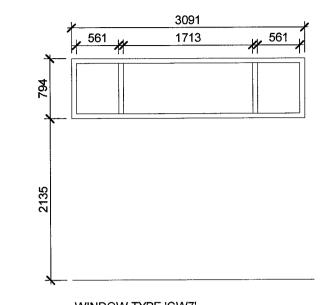

ALUMINUM CURTAIN WALL 6mm CLEAR LAMINATED GLASS 13mm AIR SPACE

WINDOW TYPE 'CW7'

WINDOW TYPE 'CW6'

13mm AIR SPACE

ALUMINUM CURTAIN WALL


6mm CLEAR LAMINATED GLASS

6mm CLEAR LAMINATED GLASS

SPANDREL PANEL AS INDICATED

HERMETICALLY SEALED UNIT

A = Detail number 6mm CLEAR LAMINATED GLASS HERMETICALLY SEALED UNIT

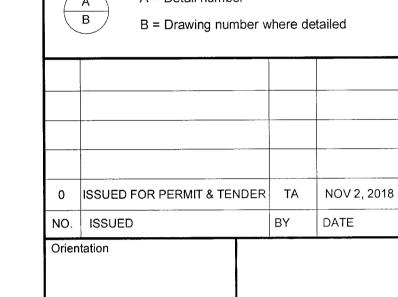

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and await instructions from the owner.

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FROSTED FILM LOUVER

SPANDREL PANEL





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BUILDING #046 RENOVATIONS


Drawing Title

ARCHITECTURAL **CURTAIN WALL TYPES AND** DETAILS

504034

UNIVERSITY OF GUELPH BUILDING #046

AS INDICATED	NOV 2, 2018
Drawn By DCJ	Drawing No.
Checked By TA	100
Approved By RPC	AOZ
JLR #: 27915	of 170
Cad File No.	

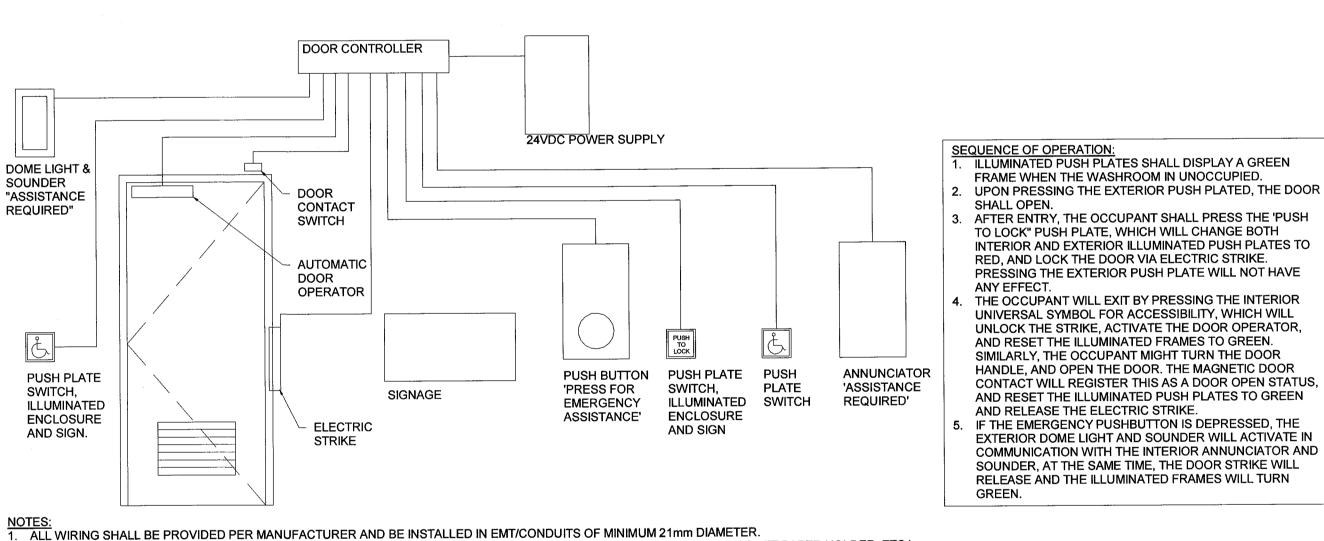

NOTES:

1. ALL WIRING SHALL BE PROVIDED PER MANUFACTURER AND BE INSTALLED IN EMT/CONDUITS OF MINIMUM 21mm DIAMETER.

2. PROVIDE ALL REQUIRED BACK BOXES TO SUIT. COORDINATE LOCATION WITH WASHROOM ACCESSORIES (GRAB BARS, TOILET PAPER HOLDER, ETC.)

. REFER TO FLOOR PLAN FOR LOCATION OF DEVICES. 4. PROVIDE CONNECTION FOR POWER AND CONTROL TO ELECTRIC STRIKE AND DOOR OPERATOR.

PROVIDE POWER SUPPLY AS NOTED. SEE ELECTRICAL DRAWINGS. PROVIDE ELECTRIC STRIKE AS NOTED.

7. EMERGENCY CALL SYSTEM PART NUMBERS BY CAMDEN AS LISTED ABOVE, OR APPROVED EQUAL.

1. MULTI-FUNCTION RELAY TO CONTROL DOOR OPERATIONS. MOUNTED IN CEILING SPACE. PROVIDE J.BOX SUITABLE FOR ENCLOSURE.

.2 PUSH/PULL MAINTAINED MUSHROOM PUSHBUTTON WITH STAINLESS COVERPLATE ENGRAVED WITH "PRESS FOR EMERGENCY ASSISTANCE". MOUNT IN SINGLE GANG .3 LED ANNUNCIATOR WITH SOUNDER. ILLUMINATED MESSAGE WITH "ASSISTANCE REQUESTED" C/W STAINLESS COVERPLATE. MOUNT IN SINGLE GANG BOX AT 1000mm,

NEXT TO PUSHBUTTON. .4 WHITE, FIRE RATED EXPANDED PVC SIGNAGE. SIGN SHALL CONTAIN "IN THE EVENT OF AN EMERGENCY, PUSH EMERGENCY BUTTON AND AUDIBLE AND VISUAL SIGNAL


WILL ACTIVATE." IN LETTERS AT LEAST 25mm HIGH WITH A 5mm STROKE, MOUNT ABOVE PUSHBUTTON. .5 DOME LIGHT WITH SOUNDER C/W WHITE WEDGE SHAPED LENS AND STAINLESS COVERPLATE, MOUNT IN SINGLE GANG BOX ABOVE DOOR AT WASHROOM EXTERIOR.

.6 ILLUMINATED PUSHPLATE "PUSH TO LOCK", WITH LEGEND SIGN. MOUNT INSIDE WASHROOM. DISABLE SOUNDER. .7 ILLUMINATED PUSHPLATE WITH THE UNIVERSAL SYMBOL OF ACCESSIBILITY, WITH LEGEND SIGN, MOUNT OUTSIDE WASHROOM, DISABLE SOUNDER.

.8 PUSHPLATE WITH THE UNIVERSAL SYMBOL OF ACCESSIBILITY, MOUNT INSIDE WASHROOM. .9 MAGNETIC DOOR CONTACT FOR COMMUNICATION WITH DOOR CONTROLLER, MOUNT INSIDE WASHROOM.

.10 24VDC POWER SUPPLY FOR DOOR CONTROLLER, ILLUMINATED PUSH BUTTONS,. DOOR STRIKE, DOME LIGHT, SOUNDER, AND ANNUNCIATOR. .11 DOOR OPERATOR AND DOOR STRIKE TO BE COORDINATED WITH OTHER TRADES TO ENSURE COMPATIBILITY.

UNIV. W.R. EMERGENCY CALL SYSTEM WITH DOOR **OPERATORS** SCALE: 1:25

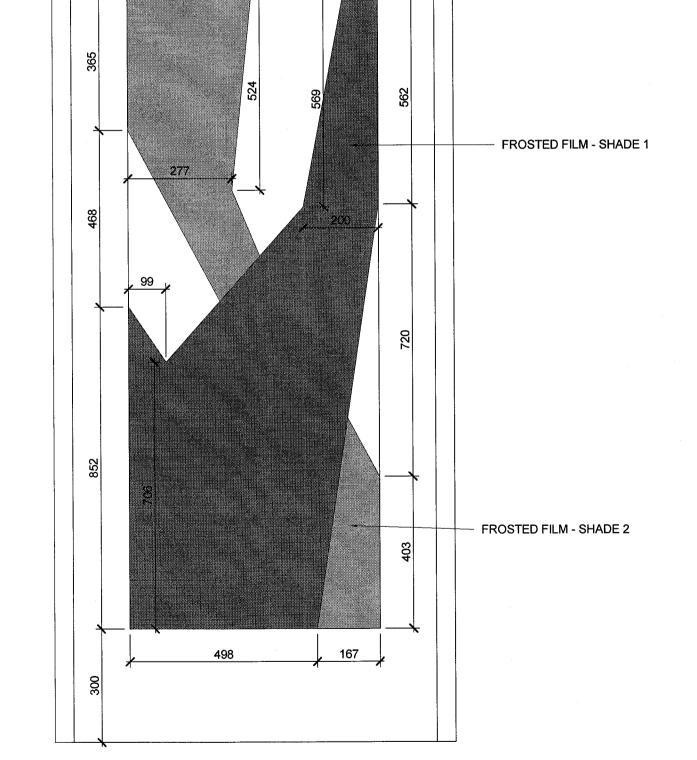

DOOR ELEVATION - D123

				ROOM	I FINISH	SCHED	ULE	
001110	DOOM NAME	FLOOR FINISH BAS	WAL E MATERIAL	LS FINISH	MATERIAL	CEILING	HEIGHT	REMARKS
OOM NO. EL 1 - WING '	ROOM NAME					1 1111011		OTAINI FOO OTESI, DAGKODI ACI LAT MOD CINIZ
116	CUST.	RSF RB	EX, C.BLK, GWB	PT	ACT1	-	2440mm	STAINLESS STEEL BACKSPLASH AT MOP SINK
117	VESTIBULE	RSF RB	EX, GWB	PT	ACT1	-	2440mm	
	SERVER	RSF RB		PT PT	ACT1	-	2440mm 2440mm	
	EX. ELECTRICAL	EX CONC -	EX EX		EX.ST.	PT		
119	SVO STORAGE	RSF RB		PT	ACT1	- DT	2440mm	
	EX. MECHANICAL EX. MAINTENANCE	EX CONC - EX TERR EX TE	RR EX	PT	EX.ST. ACT1	PT -	2440mm	
121 123	RECEPTION	RSF RB		PT	ACT1	_	2440mm	
123A	WAITING	RSF RB		PT	ACT1	-	2440mm 2440mm	
	OFFICE OFFICE	CPT RB		PT PT	ACT1	-	2440mm	
123C 123D	OFFICE	CPT RB		PT	ACT1	-	2440mm	
123E	MEETING	CPT RB		PT	ACT1	-	2440mm	MILLWORK TO DETAILS
	COFFEE / COPY CLOSED FILE STORAGE	RSF RB		PT PT	ACT1	-	2440mm 2440mm	MILLWORK TO DETAILS
124 125	FAMILY THERAPY ROOM	CPT RB		PT	ACT1	-	2440mm	
125A	VIEWING ROOM	CPT RB		PT	ACT1	-	2440mm	MILLWORK TO DETAILS
126A	COUPLE / INDIVIDUAL ROOM COUPLE / INDIVIDUAL ROOM	CPT RB		PT PT	ACT1		2440mm 2440mm	
126B 126C	COUPLE / INDIVIDUAL ROOM	CPT RE		PT	ACT1		2440mm	
126D	COUPLE / INDIVIDUAL ROOM	CPT RE		PT	ACT1	-	2440mm	
127	FAMILY THERAPY ROOM	CPT RE		PT PT	ACT1	-	2440mm 2440mm	MILLWORK TO DETAILS
127A 128	VIEWING / CHILD CARE MULTI-PURPOSE ROOM	CPT RE		PT	ACT1	-	2440mm	
129	LARGE GROUP ROOM	CPT RE	GWB	PT	GWB, ACT1	PT	2440mm	
130	SESSIONAL OFFICE	CPT RE		PT PT	ACT1	-	2440mm 2440mm	
131 132	STORAGE RESEARCH SPACE	RSF RE		PT	ACT1	-	2440mm	
133	OFFICE / SUPERVISION	CPT RE	GWB	PT	ACT1	-	2440mm	DESERT TO INTERIOR SI SVATIONS
134	KITCHENETTE	RSF RE	GWB, CWT-2	PT	ACT1	-	2440mm	REFER TO INTERIOR ELEVATIONS, MILLWORK TO DETAILS
135	OFFICE / SUPERVISION	CPT RE	GWB	PT	ACT1	_	2440mm	
136B	TELEPHONE	CPT RE	GWB	PT	ACT1	-	2440mm	
136C	BREAKOUT ROOM	CPT RE		PT PT	ACT1 ACT1	-	2440mm 2440mm	
137 138	OFFICE / SUPERVISION SPRINKLER	CONC		PT	EX.ST.	PT	2.11011111	
139	OFFICE / SUPERVISION	CPT RE		PT	ACT1	-	2440mm	AMILIMORY TO DETAIL O
141	MAIL	RSF RE		PT PT	ACT1 ACT1, WD	-	2440mm 2440mm	MILLWORK TO DETAILS REFER TO INTERIOR ELEVATIONS,
143	WAITING	RSF R	GVVB, VVD	F1	ACT 1, VVD			MILLWORK TO DETAILS
145	RECEPTION	CPT RE		PT	GWB, ACT1	PT	VARIES	BULKHEAD TO DETAILS MILLWORK TO DETAILS
145A	COPY / MAIL ADMIN. OFFICE	CPT RE		PT PT	ACT1 GWB, ACT1	PT	2440mm VARIES	BULKHEAD TO DETAILS
147 149	OFFICE / SUPERVISION	CPT RE		PT	GWB, ACT1	PT	VARIES	BULKHEAD TO DETAILS
C102	CORRIDOR	EX TERR EX TE	RR GWB	PT	ACT2	-	2440mm	PATCH AND REPAIR EX. TERRAZZO FLOORING AND BASE IN AREAS OF WALL REMOVAL AND/OR INFILL
C103	CORRIDOR	EX TERR EX TE	RR GWB	PT	ACT2	-	2440mm	PATCH AND REPAIR EX. TERRAZZO FLOORING AND BASE IN AREAS OF WALL REMOVAL
C103	CORRIDOR							AND/OR INFILL
C104	CORRIDOR	EX TERR EX T	RR GWB, WD	PT	ACT2, WD	-	2440mm	PATCH AND REPAIR EX. TERRAZZO FLOORING AND BASE IN AREAS OF WALL REMOVAL AND/OR INFILL,
								REFER TO INTERIOR ELEVATIONS
C104A	CORRIDOR	RSF RI		PT PT	ACT2 GWB, ACT1	PT	2440mm 2440mm	BULKHEAD TO DETAILS
C105 C106	CORRIDOR	EX TERR EX T		PT	ACT2, WD	-	2440mm	PATCH AND REPAIR EX. TERRAZZO FLOORING AND BASE IN AREAS OF WALL REMOVAL
0.100								AND/OR INFILL, REFER TO INTERIOR ELEVATIONS
C107	CORRIDOR	RSF R	3 GWB	PT	GWB, ACT1	PT	2440mm	MILLWORK TO DETAILS,
		EV TERRI EV T	-DD CM/D	DT	ACT2, WD		2440mm	BULKHEAD TO DETAILS PATCH AND REPAIR EX. TERRAZZO FLOORING AND BASE IN AREAS OF WALL REMOVAL
C108	CORRIDOR	EX TERR EX T	ERR GWB	PT	AC12, WD	-	244011111	AND/OR INFILL
C123	CORRIDOR	RSF R		PT	ACT1	-	2440mm	
EL101	ELEVATOR	CFT CE		- PT	- GWB	PT	2440mm	PATCH AND REPAIR EX. TERRAZZO FLOORING AND BASE IN AREAS OF WALL REMOVAL
ST101	EX. STAIRWELL	EX TERR EX II	ERR GVVB, EX		GVVB		244011111	AND/OR INFILL,
		EV TERR EV T	EN CMB	DT	ACT2		2930mm	BULKHEAD TO DETAILS PATCH AND REPAIR EX. TERRAZZO FLOORING AND BASE IN AREAS OF WALL REMOVA
ST101A	ENTRANCE VESTIBULE	EX TERR EX T	ERR EX, GWB	PT	ACT2	-	293011111	AND/OR INFILL
ST102	EX. STAIRWELL	EX TERR EX T	ERR EX	EX	GWB	-	2440mm	PATCH AND REPAIR EX. TERRAZZO FLOORING AND BASE IN AREAS OF WALL REMOVA AND/OR INFILL
ST103	EX. STAIRWELL	EX TERR EX T	ERR EX	PT	-	_		
WR116	W.R.	CFT CE	BT EX, CWT-1,	PT	GWB	PT	2440mm	REFER TO INTERIOR ELEVATIONS, MILLWORK TO DETAILS
		CFT CE	CWT-3 BT EX, CWT-1,	PT	GWB	PT	2440mm	REFER TO INTERIOR ELEVATIONS
WR138	UNIV. W.R.	GFT CE	CWT-3	F- 1	OVVB			
EL 1 - WINC	The state of the s		DD EV CV	5-	A 0.T0		2440mm	PAINT WALL TO EXTENT SHOWN ON 1/A88.
101 102	EX. GRAD OFFICE EX. STORAGE	EX EX,		PT PT	ACT3		2440mm	MAIN ST. 187. MILE 187. MI
102	EX. STORAGE EX. MEDICAL RECORDS	RSF R	B EX, GWB	PT	ACT3	-	2440mm	
103A	EX. RESTRICTED RECORDS	RSF R			ACT3	_	2440mm	
105 106	EX. ELECTRICAL EX. VESTIBULE	EX E	X EX B EX		EX.ST. ACT3	-	2440mm	
106 106A	EX. COPY ROOM		B EX		ACT3	-	2440mm	
106B	EX. OFFICE	CPT R	B EX, GWB	PT	ACT3		2440mm	PAINT WALL TO EXTENT SHOWN ON 1/A88. PAINT WALL TO EXTENT SHOWN ON 1/A88.
107	EX. OFFICE EX. OFFICE		B EX, GWB RB EX, GWB	PT PT	ACT3	<u>-</u>	2440mm 2440mm	PAINT WALL TO EXTENT SHOWN ON 1/A88. PAINT WALL TO EXTENT SHOWN ON 1/A88.
108 109	EX. OFFICE		X EX		ACT3	_	2440mm	
109A	EX. OFFICE	EX EX.	RB EX, GWB	PT	ACT3	-	2440mm	
109B	EX. OFFICE	. 1	RB EX, GWB B EX, GWB	PT PT	ACT3	-	2440mm 2440mm	
110 110A	EX. CLASSROOM CLOSET		B EX, GWB	PT	ACT3	-	2440mm	
111	EX. CLASSROOM	RSF R	B EX, GWB	PT	ACT3	_	2440mm	PAINT WALL TO EXTENT SHOWN ON 1/A88.
112	EX. HSKP		B EX		EX.ST.		2440mm	
113 113A	EX. OFFICE EX. CLASSROOM		B EX EX, GWB	PT	ACT3	-	2440mm 2440mm	
113A 114	EX. CLASSROOM EX. CLASSROOM	RSF F	B EX, GWB	PT	ACT3		2440mm	PAINT WALL TO EXTENT SHOWN ON 1/A88.
114A	EX. OFFICE		B EX		ACT3	-	2440mm 2235mm	
115	EX. KITCHEN EX. VESTIBULE	RSF F	B EX	PT	ACT3 GWB, ACT	- 2 PT	VARIES	BULKHEAD TO DETAILS
C100 C101	EX. CORRIDOR	EX TERR EX 1		PT	ACT3	_	2440mm	PATCH AND REPAIR EX. TERRAZZO FLOORING AND BASE IN AREAS OF WALL REMOVA
								AND/OR INFILL. PAINT WALL TO EXTENT SHOWN ON 1/A88.
	EX. VESTIBULE	EX E	X EX, GWB	PT	EX	PT	2440mm	PAINT WALL TO EXTENT SHOWN ON 1/A88. PATCH AND REPAIR EX. CEILING AS REQUI
C1014	,	, -				1	1	AND PAINT
C101A	UNIV. W.R.	CFT C	BT EX, CWT-3	PT	GWB	PT		REFER TO INTERIOR ELEVATIONS

						I FINISH S		ULE	
ROOM NO.	ROOM NAME	FINISH	OR BASE	WALI MATERIAL	_S FINISH	MATERIAL	CEILING FINISH	HEIGHT	REMARKS
VEL 2 - WING '		DOE	DD I	EV CMD	DT	ACT1	_	2440mm	
	CUST	RSF	RB	EX, GWB	PT	ACT1		2440mm	
	ASSESSMENT ROOM	CPT	RB	GWB	PT				
203	COUPLE / INDIVIDUAL ROOM	CPT	RB	GWB	PT	ACT1		2440mm	
	ASSESSMENT ROOM	CPT	RB	GWB	PT	ACT1		2440mm	
205	COUPLE / INDIVIDUAL ROOM	CPT	RB	GWB	PT	ACT1		2440mm	LAW LAW OF LAW O
206	VIEWING ROOM	CPT	RB	GWB	PT	ACT1	-	2440mm	MILLWORK TO DETAILS
	COUPLE / INDIVIDUAL ROOM	CPT	RB	GWB	PT	ACT1	-	2440mm	
	ASSESSMENT ROOM	CPT	RB	GWB	PT	ACT1		2440mm	
	PLAY ROOM	RSF	RB	GWB	PT	ACT1	-	2440mm	
	The state of the s	RSF	RB	GWB	PT	ACT1	-	2440mm	
210	PLAYROOM	CPT	RB	GWB	PT	ACT1	-	2440mm	MILLWORK TO DETAILS
210A	VIEWING ROOM		RB	GWB	PT	ACT1		2440mm	
211	FAMILY THERAPY ROOM	CPT			PT	ACT1	_	2440mm	MILLWORK TO DETAILS
212	TEST LIBRARY	RSF	RB	GWB				2440mm	WILLEVOIN TO BETTILLO
213	FAMILY THERAPY ROOM	CPT	RB	GWB	PT	ACT1			MILLWORK TO DETAILS
214	VIEWING ROOM	CPT	RB	GWB	PT	ACT1		2440mm	MILLWORK TO DETAILS
215	FAMILY THERAPY ROOM	CPT	RB	GWB	PT	ACT1	-	2440mm	
216	WELLNESS ROOM	RSF	RB	GWB	PT	ACT1		2440mm	MILLWORK TO DETAILS
217	LOUNGE	RSF	RB	GWB, CWT-2	PT	GWB, ACT2, WD	PT	2440mm	REFER TO INTERIOR ELEVATIONS, MILLWORK TO DETAILS, BULKHEAD TO DETAILS
			OPT	OVAC	DT.	CIMP	PT	VARIES	
217A	STOR.	CFT	CBT	GWB	PT	GWB			
218	STORAGE	RSF	RB	GWB	PT	ACT1		2440mm	LAW LAW O DICTOR TO DETAIL O
219	STORAGE	RSF	RB	EX, GWB	PT	GWB, ACT1	PT	2440mm	MILLWORK TO DETAILS,
									BULKHEAD TO DETAILS
220	PRAYER ROOM	CPT	RB	GWB	PT	ACT1		2440mm	MILLWORK TO DETAILS
221	OFFICE / SUPERVISION	CPT	RB	GWB	PT	ACT1	-	2440mm	
	CONFIDENTIAL STUDENT WORK ROOM	RSF	RB	GWB	PT	ACT1	-	2440mm	
222		CPT	RB	GWB	PT	ACT1	-	2440mm	
223	OFFICE / SUPERVISION	CPT	RB	GWB	PT	ACT1	_	2440mm	
224	RESEARCH THERAPY / ASSESSMENT	CPI	KB	GVVB	F 1	7011		2-1-10111111	
	ROOM	ODT	DD	GWB	PT	ACT1		2440mm	MILLWORK TO DETAILS
224a	VIEWING ROOM	CPT	RB			ACT1		2440mm	
225	OFFICE / SUPERVISION	CPT	RB	GWB	PT			2440mm	
226	OFFICE	CPT	RB	GWB	PT	ACT1	-		
227	OFFICE / SUPERVISION	CPT	RB	GWB	PT	ACT1	-	2440mm	
228	RESEARCH THERAPY / ASSESSMENT	CPT	RB	GWB	PT	ACT1	-	2440mm	
	ROOM								A THE DESTANCE OF THE PERSON O
228A	VIEWING ROOM	CPT	RB	GWB	PT	ACT1	_	2440mm	MILLWORK TO DETAILS
229	OFFICE / SUPERVISION	CPT	RB	GWB	PT	ACT1	-	2440mm	
230	RESEARCH DATA ANALYSIS ROOM	RSF	RB	GWB	PT	ACT1	-	2440mm	
231	ELEV. MACHINE ROOM	RSF	RB	EX, GWB	PT	EX.ST.	PT	2440mm	
		CPT	RB	GWB	PT	ACT1		2440mm	
232	OFFICE			GWB	PT	GWB, ACT1	PT	2440mm	BULKHEAD TO DETAILS
233	LARGE GROUP ROOM	CPT	RB				PT	244011111	
234	IT	RSF	RB	GWB	PT	EX.ST.		0.440	ANILLIMODIC TO DETAIL C
235	RECEPTION / COPY	CPT	RB_	GWB	PT	ACT1	-	2440mm	MILLWORK TO DETAILS
235A	ACTIVE STORAGE	CPT	RB	GWB	PT	ACT1		2440mm	
236	WAITING ROOM	RSF	RB	GWB	PT	ACT2, WD	-	2440mm	
237	ADMIN. OFFICE	CPT	RB	GWB	PT	ACT1	-	2440mm	
		CPT	RB	GWB	PT	ACT1	-	2440mm	
239	SEMINAR		EX TERR	GWB, WD	PT	ACT2, WD	_	2440mm	PATCH AND REPAIR EX. TERRAZZO FLOORING AND BASE IN AREAS OF WALL REMOVAL
C201	CORRIDOR	EA TERR	EV IEKK	3000,000		, (0.2, 110			AND/OR INFILL
****	CORPUSCO	EV TERR	EX TERR	GWB, WD	PT	ACT2, WD		2440mm	PATCH AND REPAIR EX. TERRAZZO FLOORING AND BASE IN AREAS OF WALL REMOVAL
C202	CORRIDOR	EVIERK	- IERR	GVVB, VVD	FI	7012, 700	_	2.1-10.11111	AND/OR INFILL
0000	CORRIDOS	RSF	RB	GWB	PT	GWB, ACT1	PT	2440mm	MILLWORK TO DETAILS,
C203	CORRIDOR	KOF	L/D	GVVB		3415,7011	''		BULKHEAD TO DETAILS
				CMB	PT	GWB, ACT1	PT	2440mm	
C204	CORRIDOR	RSF	RB	GWB			PT	2440mm	
C205	CORRIDOR	RSF	RB	GWB	PT	GWB, ACT1			PATCH AND REPAIR EX. TERRAZZO FLOORING AND BASE IN AREAS OF WALL REMOVAL
C206	CORRIDOR	EX TERR	EX TERR	GWB, WD	PT	ACT2, WD	-	2440mm	AND/OR INFILL
0200								0.4.40	ANDIONINIEL
0200	CORRIDOR	RSF	RB	GWB	PT	ACT2	-	2440mm	
C207		RSF	RB	GWB	PT	ACT2	-	2440mm	
	CORRIDOR	CFT	CBT	-	-	-	-		
C207 C208		CFI	EV TEDD	GWB, EX	PT	GWB	PT	2875mm	
C207 C208 EL201	CORRIDOR ELEVATOR	EX TERR			PT	ACT2	-	3900mm	
C207 C208 EL201 ST201	CORRIDOR ELEVATOR EX. STAIRWELL	EX TERR		^		GWB	PT	2875mm	
C207 C208 EL201 ST201 ST202	CORRIDOR ELEVATOR EX. STAIRWELL EX. STAIRWELL	EX TERR	EX TERR		PT		EX		
C207 C208 EL201 ST201 ST202 ST203	CORRIDOR ELEVATOR EX. STAIRWELL EX. STAIRWELL EX. STAIRWELL	EX TERR EX TERR EX TERR	EX TERR EX TERR	EX	PT FX	FX			
C207 C208 EL201 ST201 ST202 ST203 ST205	CORRIDOR ELEVATOR EX. STAIRWELL EX. STAIRWELL EX. STAIRWELL EX. STAIRWELL EX. STAIRWELL	EX TERR EX TERR EX TERR EX	EX TERR EX TERR EX	EX EX	EX	EX		VARIES	REFER TO INTERIOR ELEVATIONS.
C207 C208 EL201 ST201 ST202 ST203	CORRIDOR ELEVATOR EX. STAIRWELL EX. STAIRWELL EX. STAIRWELL	EX TERR EX TERR EX TERR	EX TERR EX TERR	EX EX EX, CWT-1,		EX GWB	PT	VARIES	REFER TO INTERIOR ELEVATIONS, MILLWORK TO DETAILS
C207 C208 EL201 ST201 ST202 ST203 ST205 WR201	CORRIDOR ELEVATOR EX. STAIRWELL EX. STAIRWELL EX. STAIRWELL EX. STAIRWELL W.R.	EX TERR EX TERR EX TERR EX CFT	EX TERR EX TERR EX CBT	EX EX EX, CWT-1, CWT-3	EX PT	GWB	PT		MILLWORK TO DETAILS
C207 C208 EL201 ST201 ST202 ST203 ST205	CORRIDOR ELEVATOR EX. STAIRWELL EX. STAIRWELL EX. STAIRWELL EX. STAIRWELL EX. STAIRWELL	EX TERR EX TERR EX TERR EX	EX TERR EX TERR EX	EX EX, CWT-1, CWT-3 EX, CWT-1,	EX			VARIES 2440mm	REFER TO INTERIOR ELEVATIONS, MILLWORK TO DETAILS REFER TO INTERIOR ELEVATIONS
C207 C208 EL201 ST201 ST202 ST203 ST205 WR201	CORRIDOR ELEVATOR EX. STAIRWELL EX. STAIRWELL EX. STAIRWELL EX. STAIRWELL W.R. UNIV. W.R.	EX TERR EX TERR EX TERR EX CFT	EX TERR EX TERR EX CBT	EX EX EX, CWT-1, CWT-3	EX PT	GWB	PT		MILLWORK TO DETAILS
C207 C208 EL201 ST201 ST202 ST203 ST205 WR201	CORRIDOR ELEVATOR EX. STAIRWELL EX. STAIRWELL EX. STAIRWELL EX. STAIRWELL W.R. UNIV. W.R.	EX TERR EX TERR EX TERR EX CFT	EX TERR EX TERR CBT CBT	EX EX, CWT-1, CWT-3 EX, CWT-1, CWT-3	EX PT	GWB	PT		MILLWORK TO DETAILS
C207 C208 EL201 ST201 ST202 ST203 ST205 WR201 WR234	CORRIDOR ELEVATOR EX. STAIRWELL EX. STAIRWELL EX. STAIRWELL EX. STAIRWELL W.R. UNIV. W.R.	EX TERR EX TERR EX TERR EX CFT	EX TERR EX TERR EX CBT	EX EX, CWT-1, CWT-3 EX, CWT-1,	EX PT	GWB GWB	PT		MILLWORK TO DETAILS
C207 C208 EL201 ST201 ST202 ST203 ST205 WR201 WR234 ENTHOUSE - V	CORRIDOR ELEVATOR EX. STAIRWELL EX. STAIRWELL EX. STAIRWELL W.R. UNIV. W.R. WING 'A' EX. PENTHOUSE	EX TERR EX TERR EX TERR EX CFT	EX TERR EX TERR CBT CBT	EX EX, CWT-1, CWT-3 EX, CWT-1, CWT-3	EX PT	GWB	PT PT		MILLWORK TO DETAILS
C207 C208 EL201 ST201 ST202 ST203 ST205 WR201 WR234 ENTHOUSE - V	CORRIDOR ELEVATOR EX. STAIRWELL EX. STAIRWELL EX. STAIRWELL EX. STAIRWELL W.R. UNIV. W.R. WING 'A' EX. PENTHOUSE EX. PENTHOUSE	EX TERR EX TERR EX TERR EX CFT CFT	EX TERR EX TERR CBT CBT EX	EX EX, CWT-1, CWT-3 EX, CWT-1, CWT-3	EX PT	GWB GWB	PT PT -		MILLWORK TO DETAILS
C207 C208 EL201 ST201 ST202 ST203 ST205 WR201 WR234 ENTHOUSE - \frac{1}{303}	CORRIDOR ELEVATOR EX. STAIRWELL EX. STAIRWELL EX. STAIRWELL EX. STAIRWELL W.R. UNIV. W.R. WING 'A' EX. PENTHOUSE EX. PENTHOUSE	EX TERR EX TERR EX TERR EX CFT CFT	EX TERR EX TERR CBT CBT EX	EX EX, CWT-1, CWT-3 EX, CWT-1, CWT-3	EX PT	GWB GWB	PT PT -		MILLWORK TO DETAILS

ABBREVIATIONS:

ACT-_ ACOUSTIC CEILING TILE - TYPE
C.BLK CONCRETE BLOCK
CBT-_ CERAMIC BASE TILE - TYPE
CFT CERAMIC FLOOR TILE
CONC SEALED CONCRETE
CPT CARPET TILE
CWT-_ CERAMIC WALL TILE - TYPE
EX EXISTING TO REMAIN
EX CONC EXISTING CONCRETE TO REMAIN
EX TERR EXISTING TERRAZZO TO REMAIN
EX.ST. EXPOSED STRUCTURE
GWB GYPSYM BOARD
PT PAINT
RB RUBBER BASE
RSF RESILIENT SHEET FLOORING
SDF STATIC DISSIPATIVE FLOORING
WD WOOD

DO NOT SCALE DRAWINGS:

Contractors must check and verify all site conditions. Notify the Owner's Representative in writing before proceeding with the work if discrepancies are evident between the drawings and the site condition. No extras to the contract will be allowed if discrepancies were evident prior to start of work.

UNEXPECTED DISCOVERY OF ASBESTOS:

Where a friable material is discovered during construction, renovations and/or demolition, and it is suspected to contain asbestos, the Contractor must stop all work that may disturb the material. The Contractor shall advise the Owner of the discovery and await instructions from the owner.



A = Detail number

B = Drawing number where detailed

D. ISSUED FOR PERMIT & TENDER TA NOV 2, 2018

BY DATE

Orientation

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UNIVERSITY & GUELPH

Design, Engineering & Construction
Physical Resources
Guelph, Ontario. N1G 2W1

Consulant

J.L.Richards
ENGINEERS · ARCHITECTS · PLANNERS

Project

BUILDING #046 RENOVATIONS

Drawing Title


ARCHITECTURAL ROOM FINISH SCHEDULE


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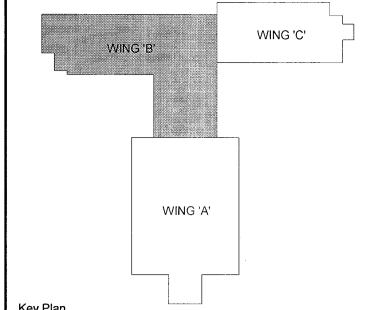
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UNIVERSITY OF GUELPH BUILDING #046

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Approved By RPC	HOU
JLR #: 27915	of 170






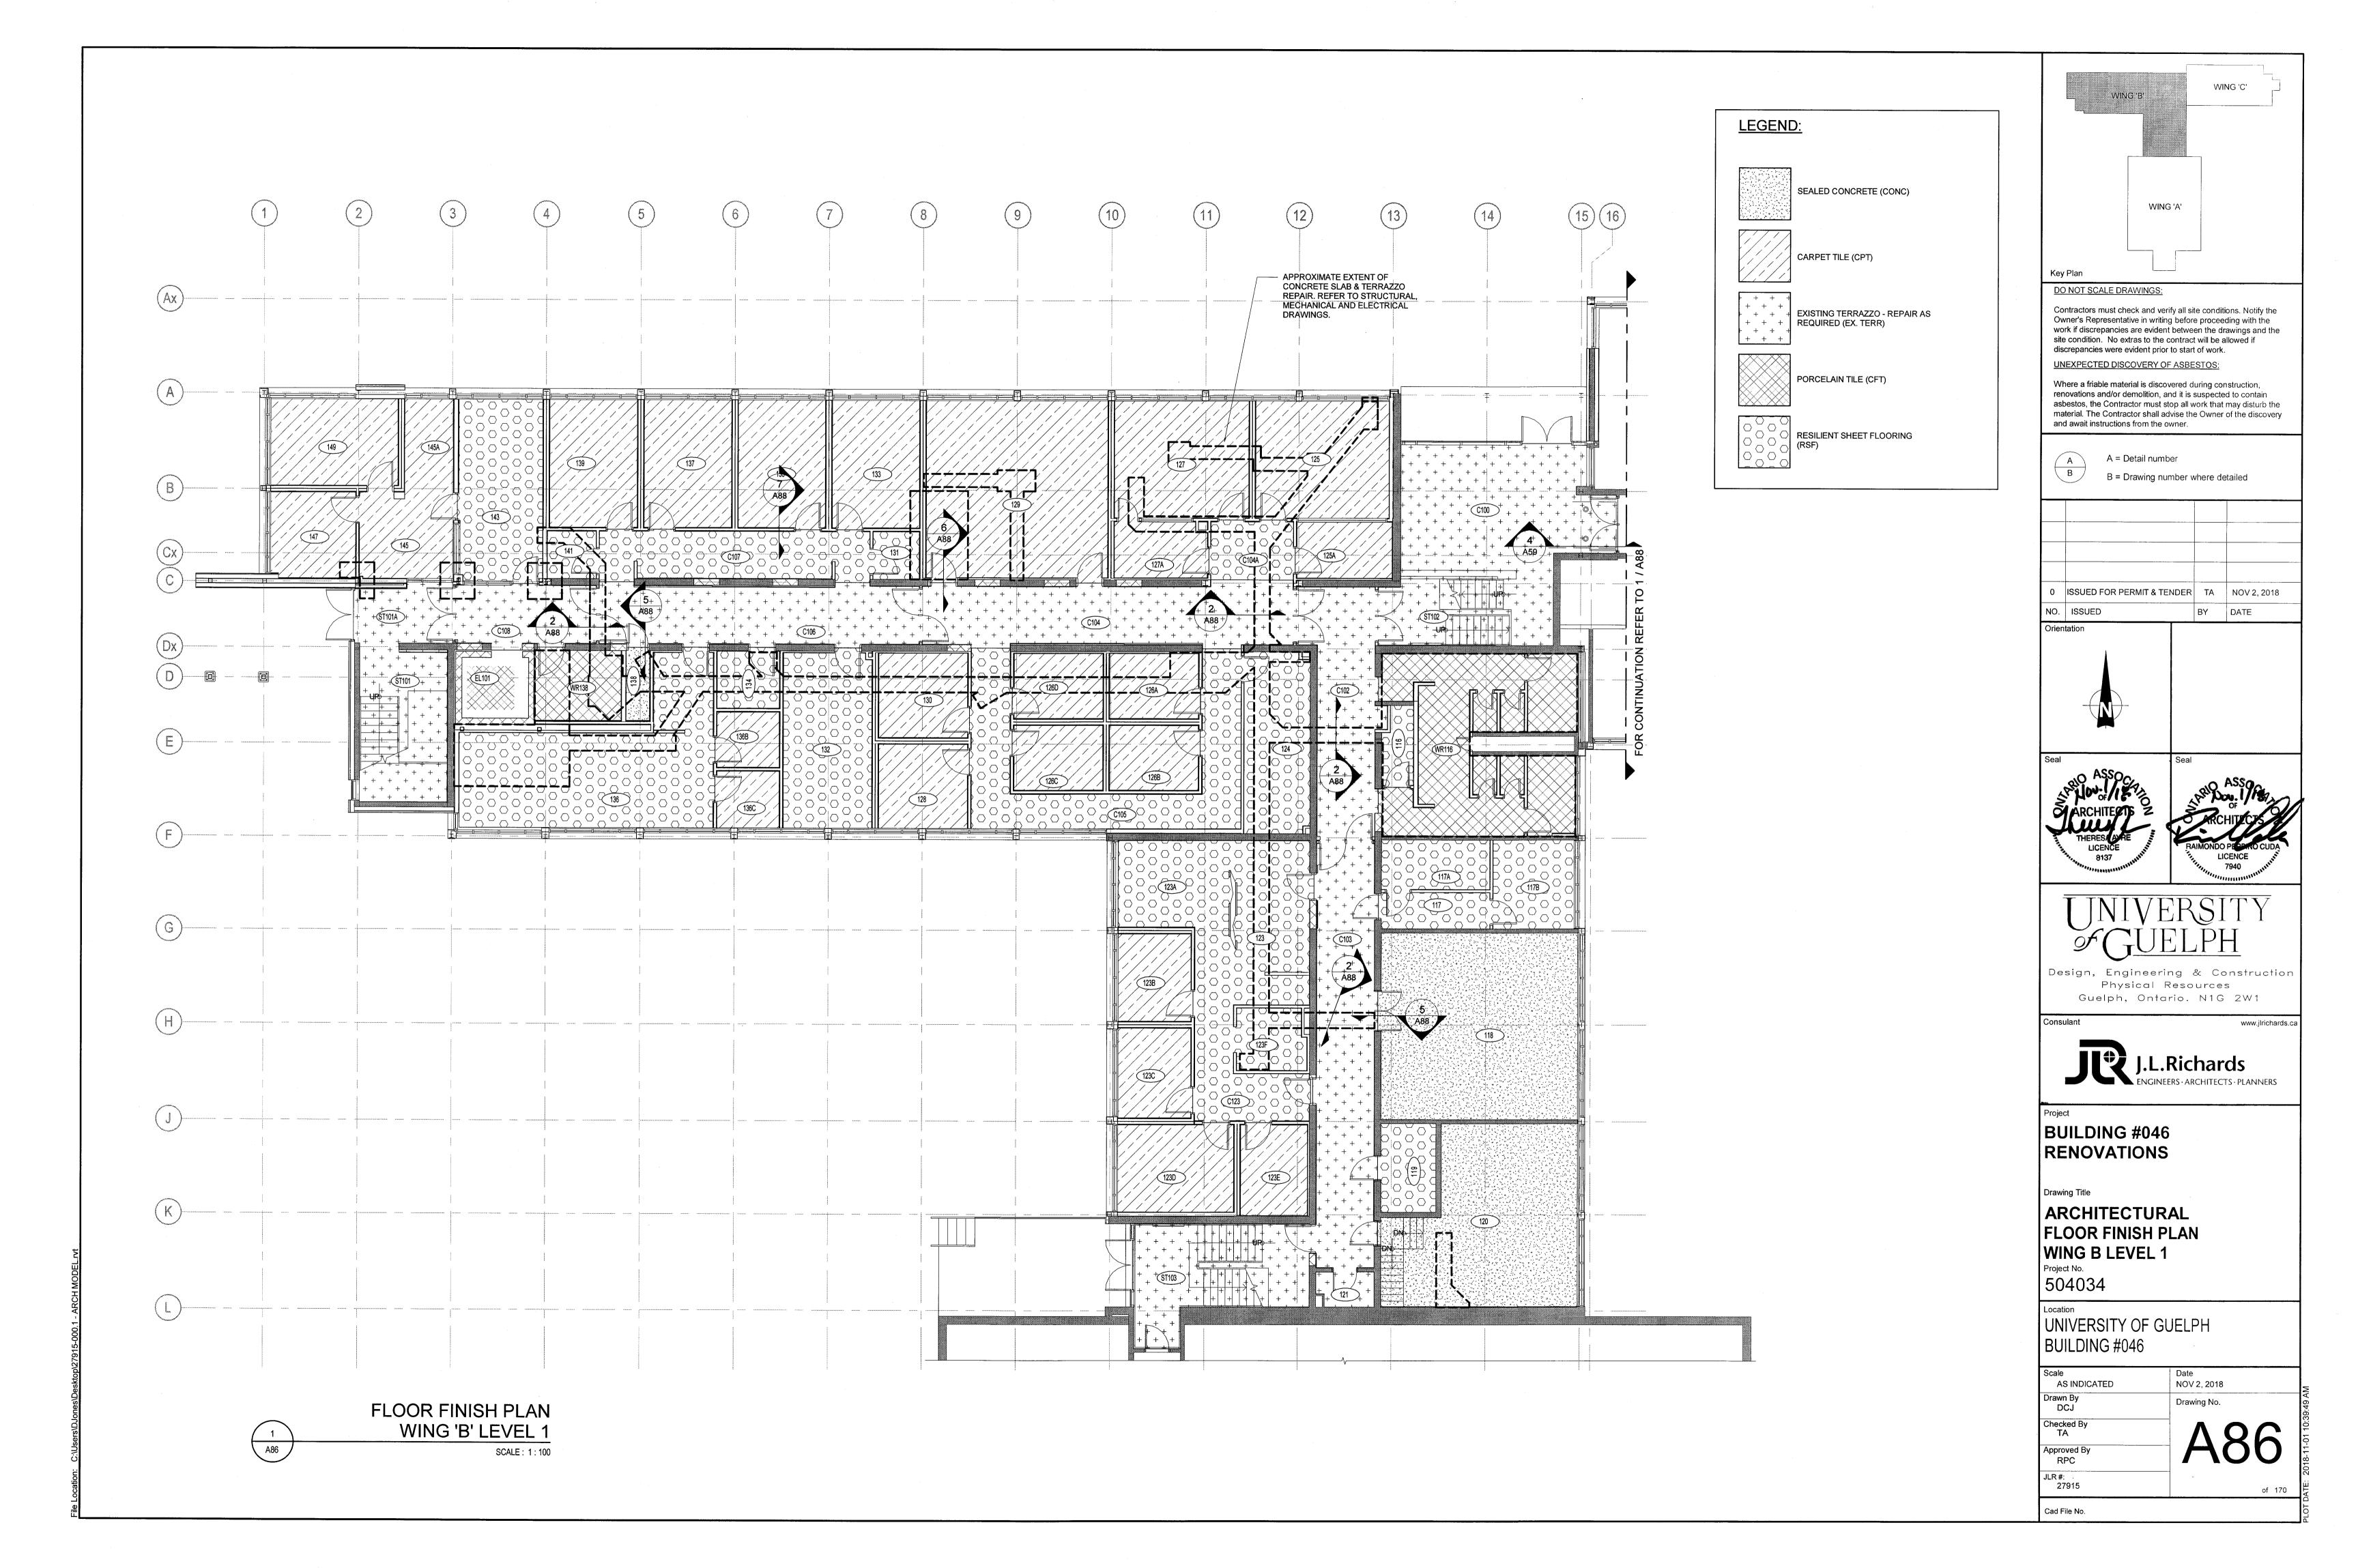
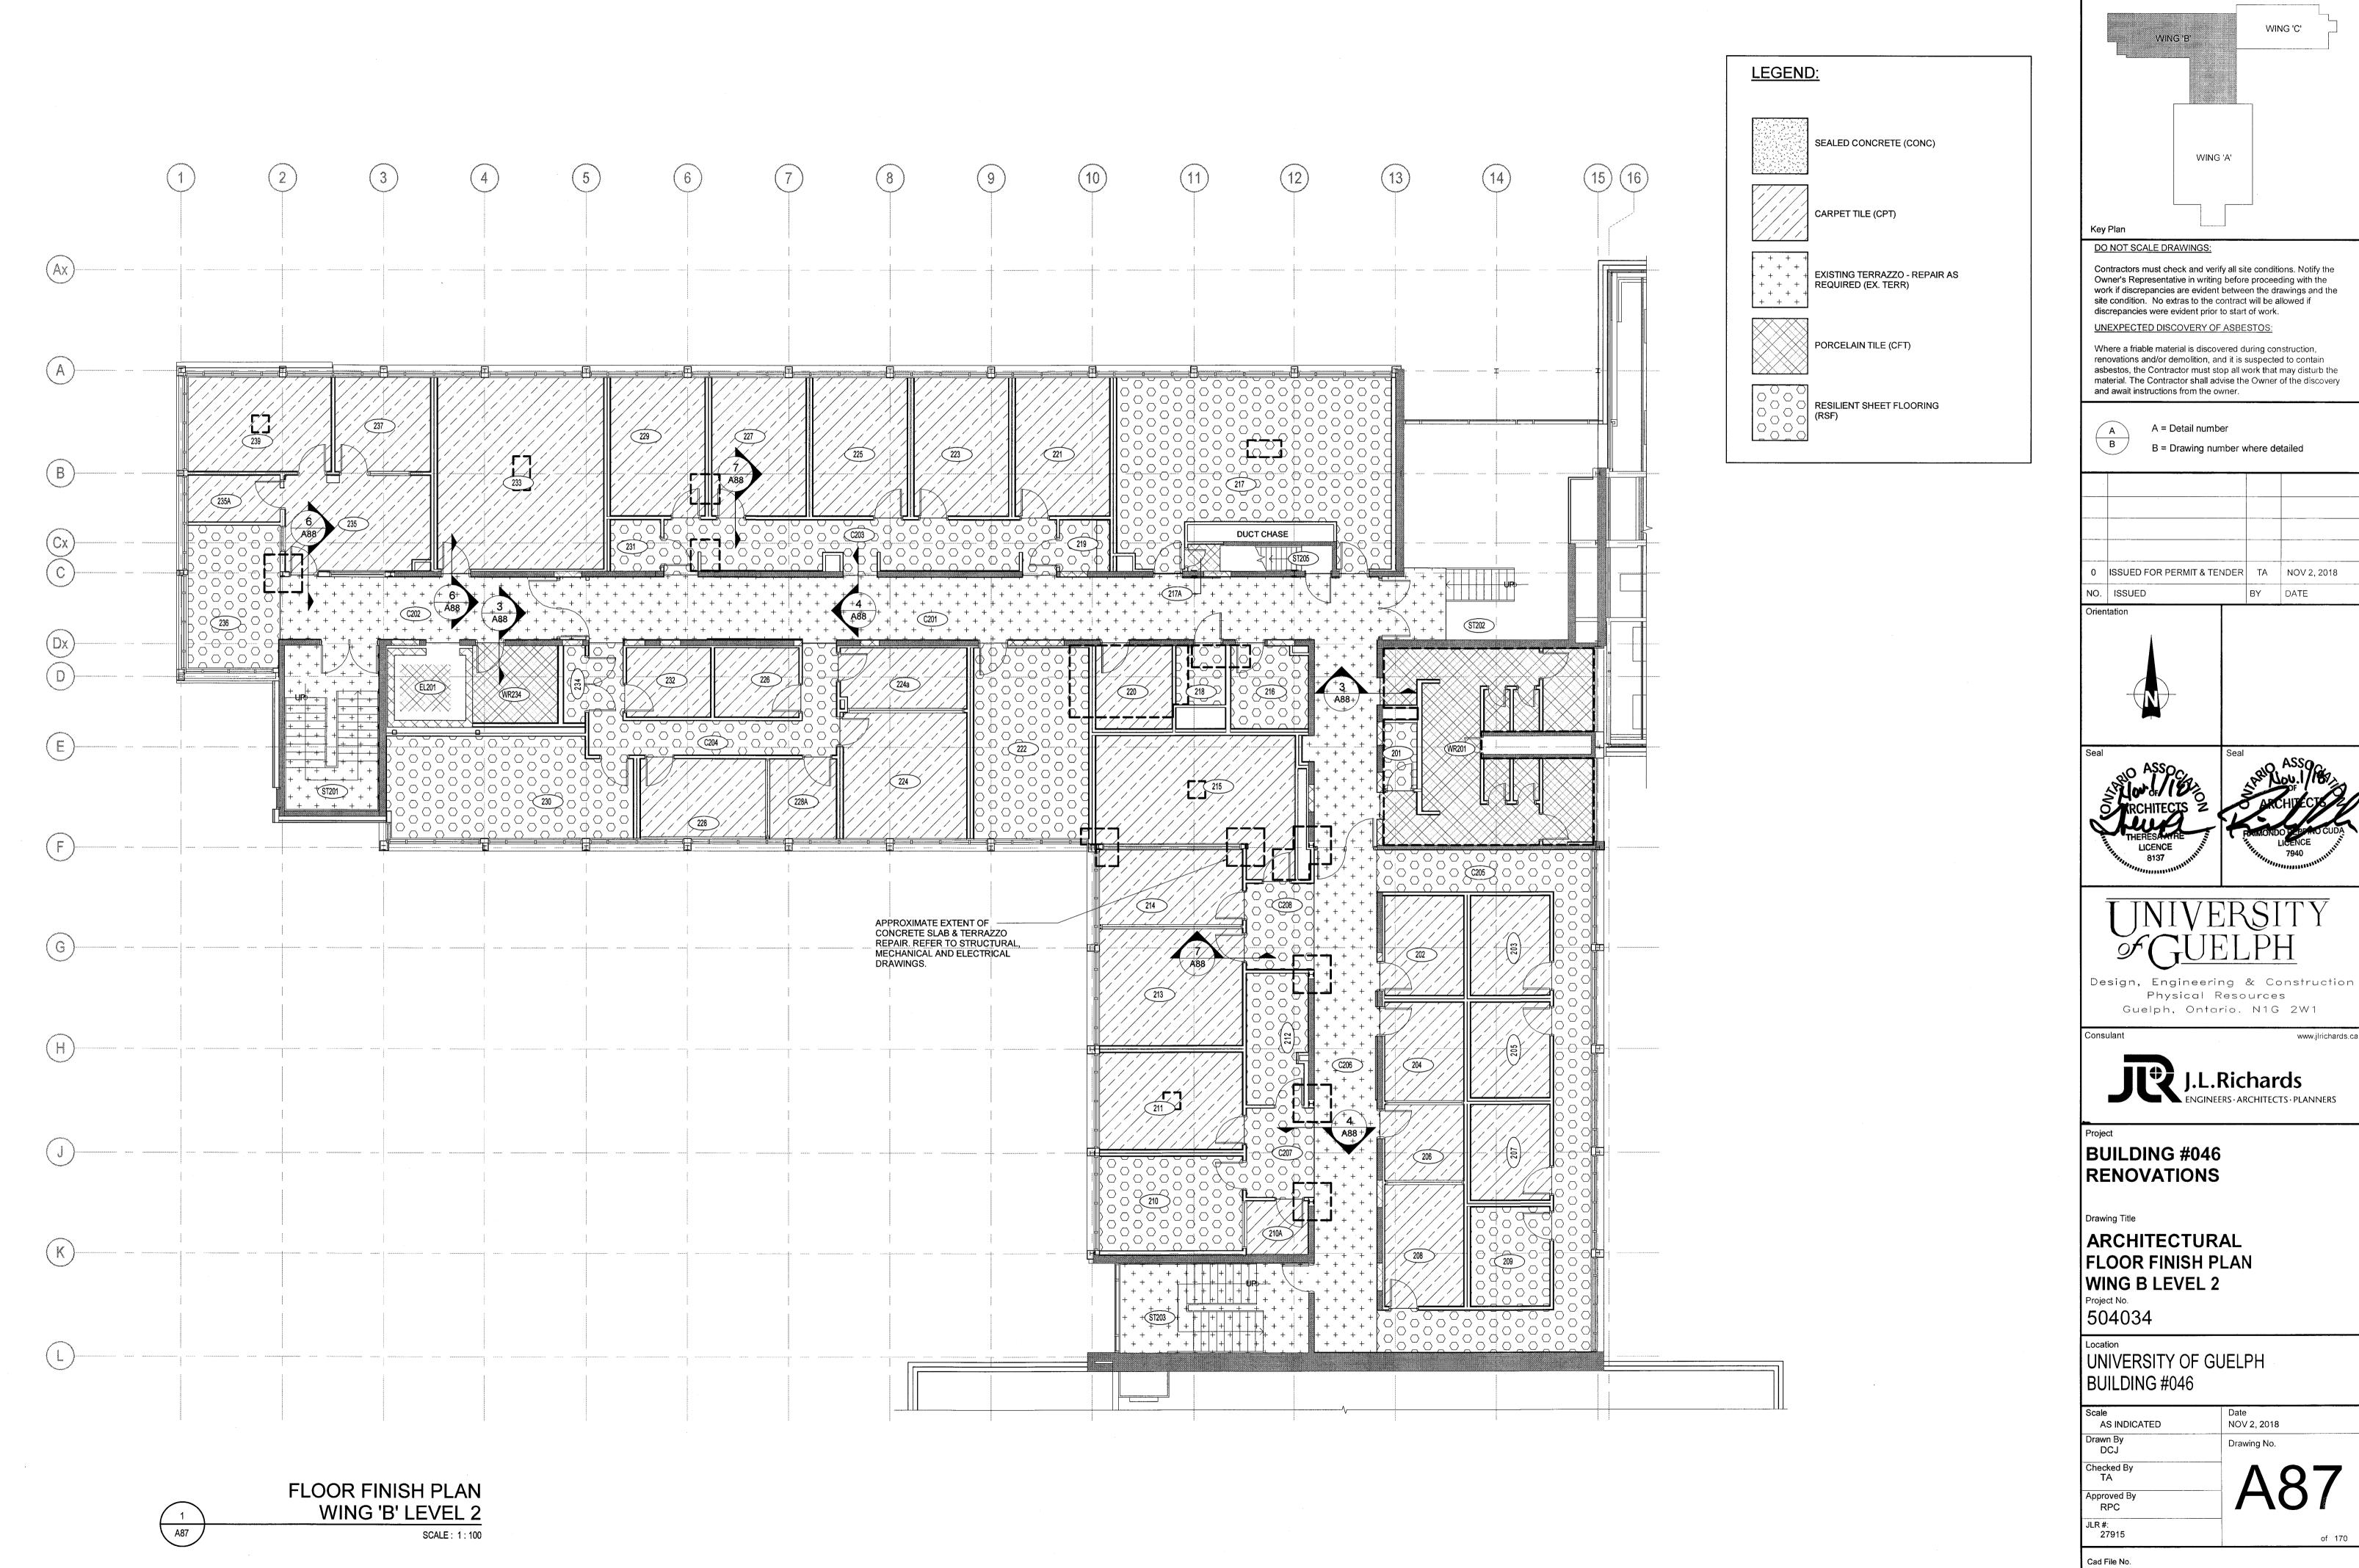
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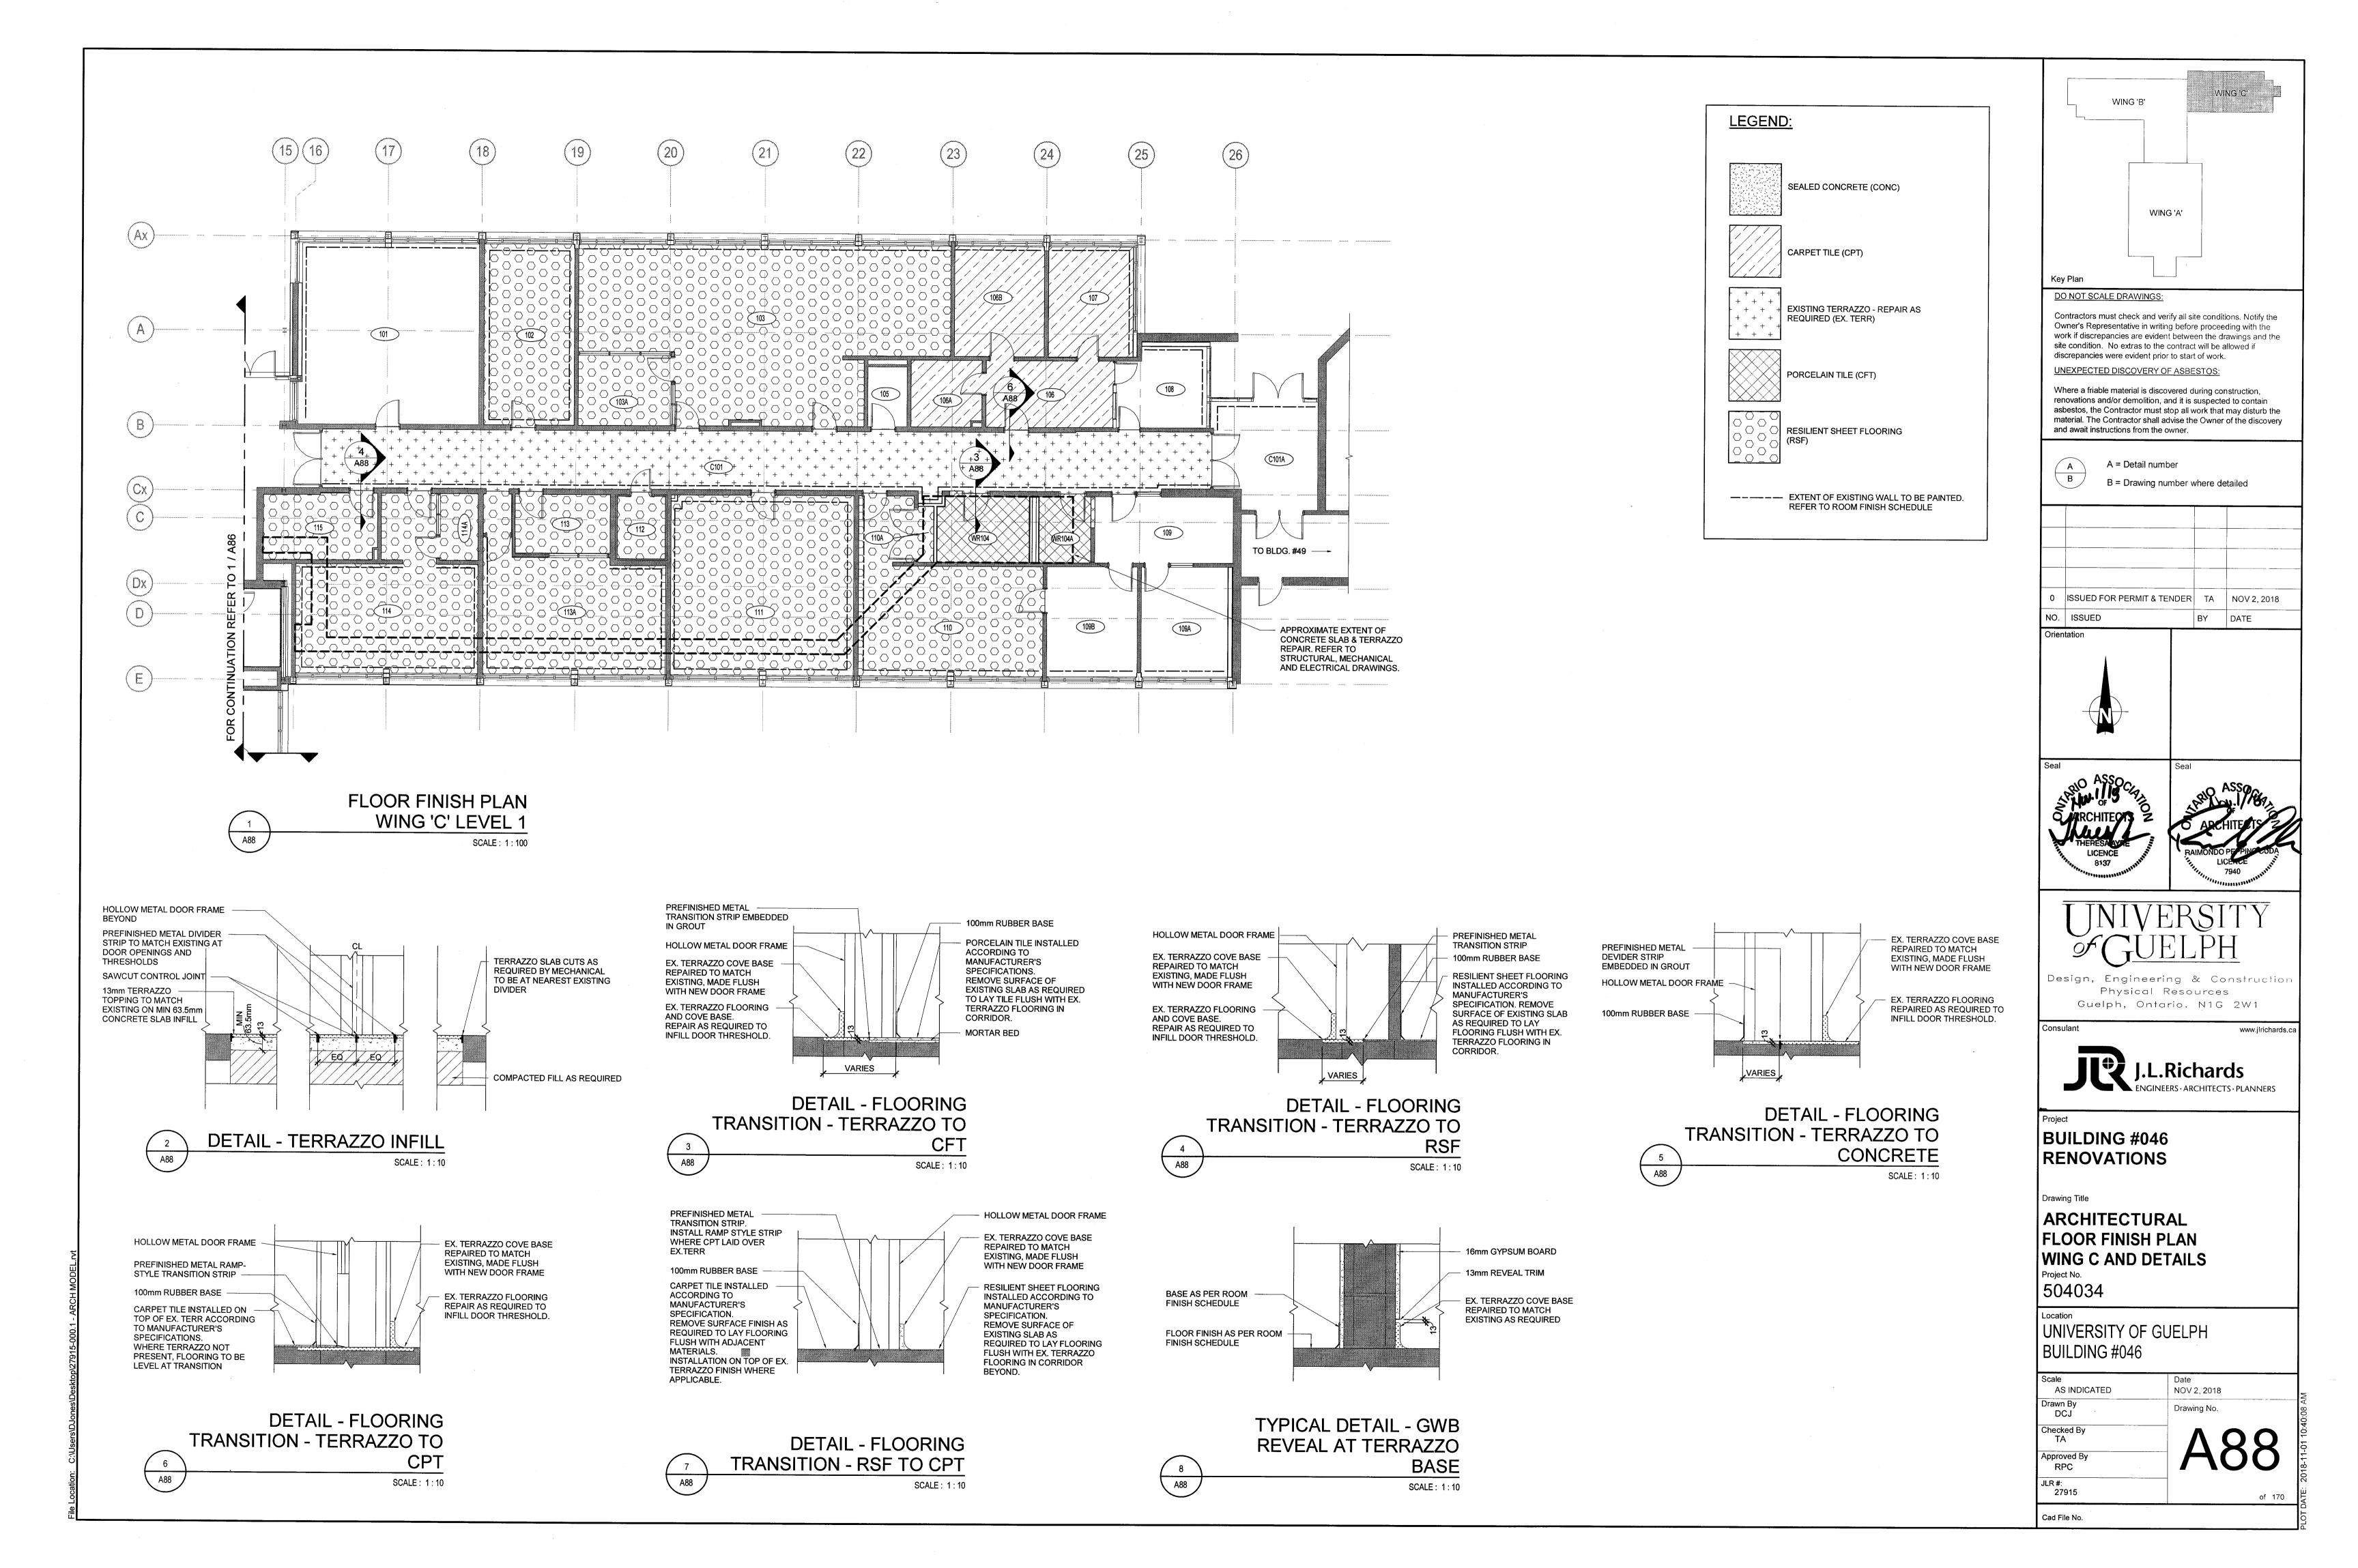






Guelph, Ontario. N1G 2W1

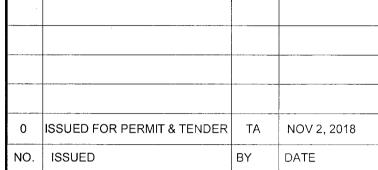
J.L.Richards
ENGINEERS · ARCHITECTS · PLANNERS


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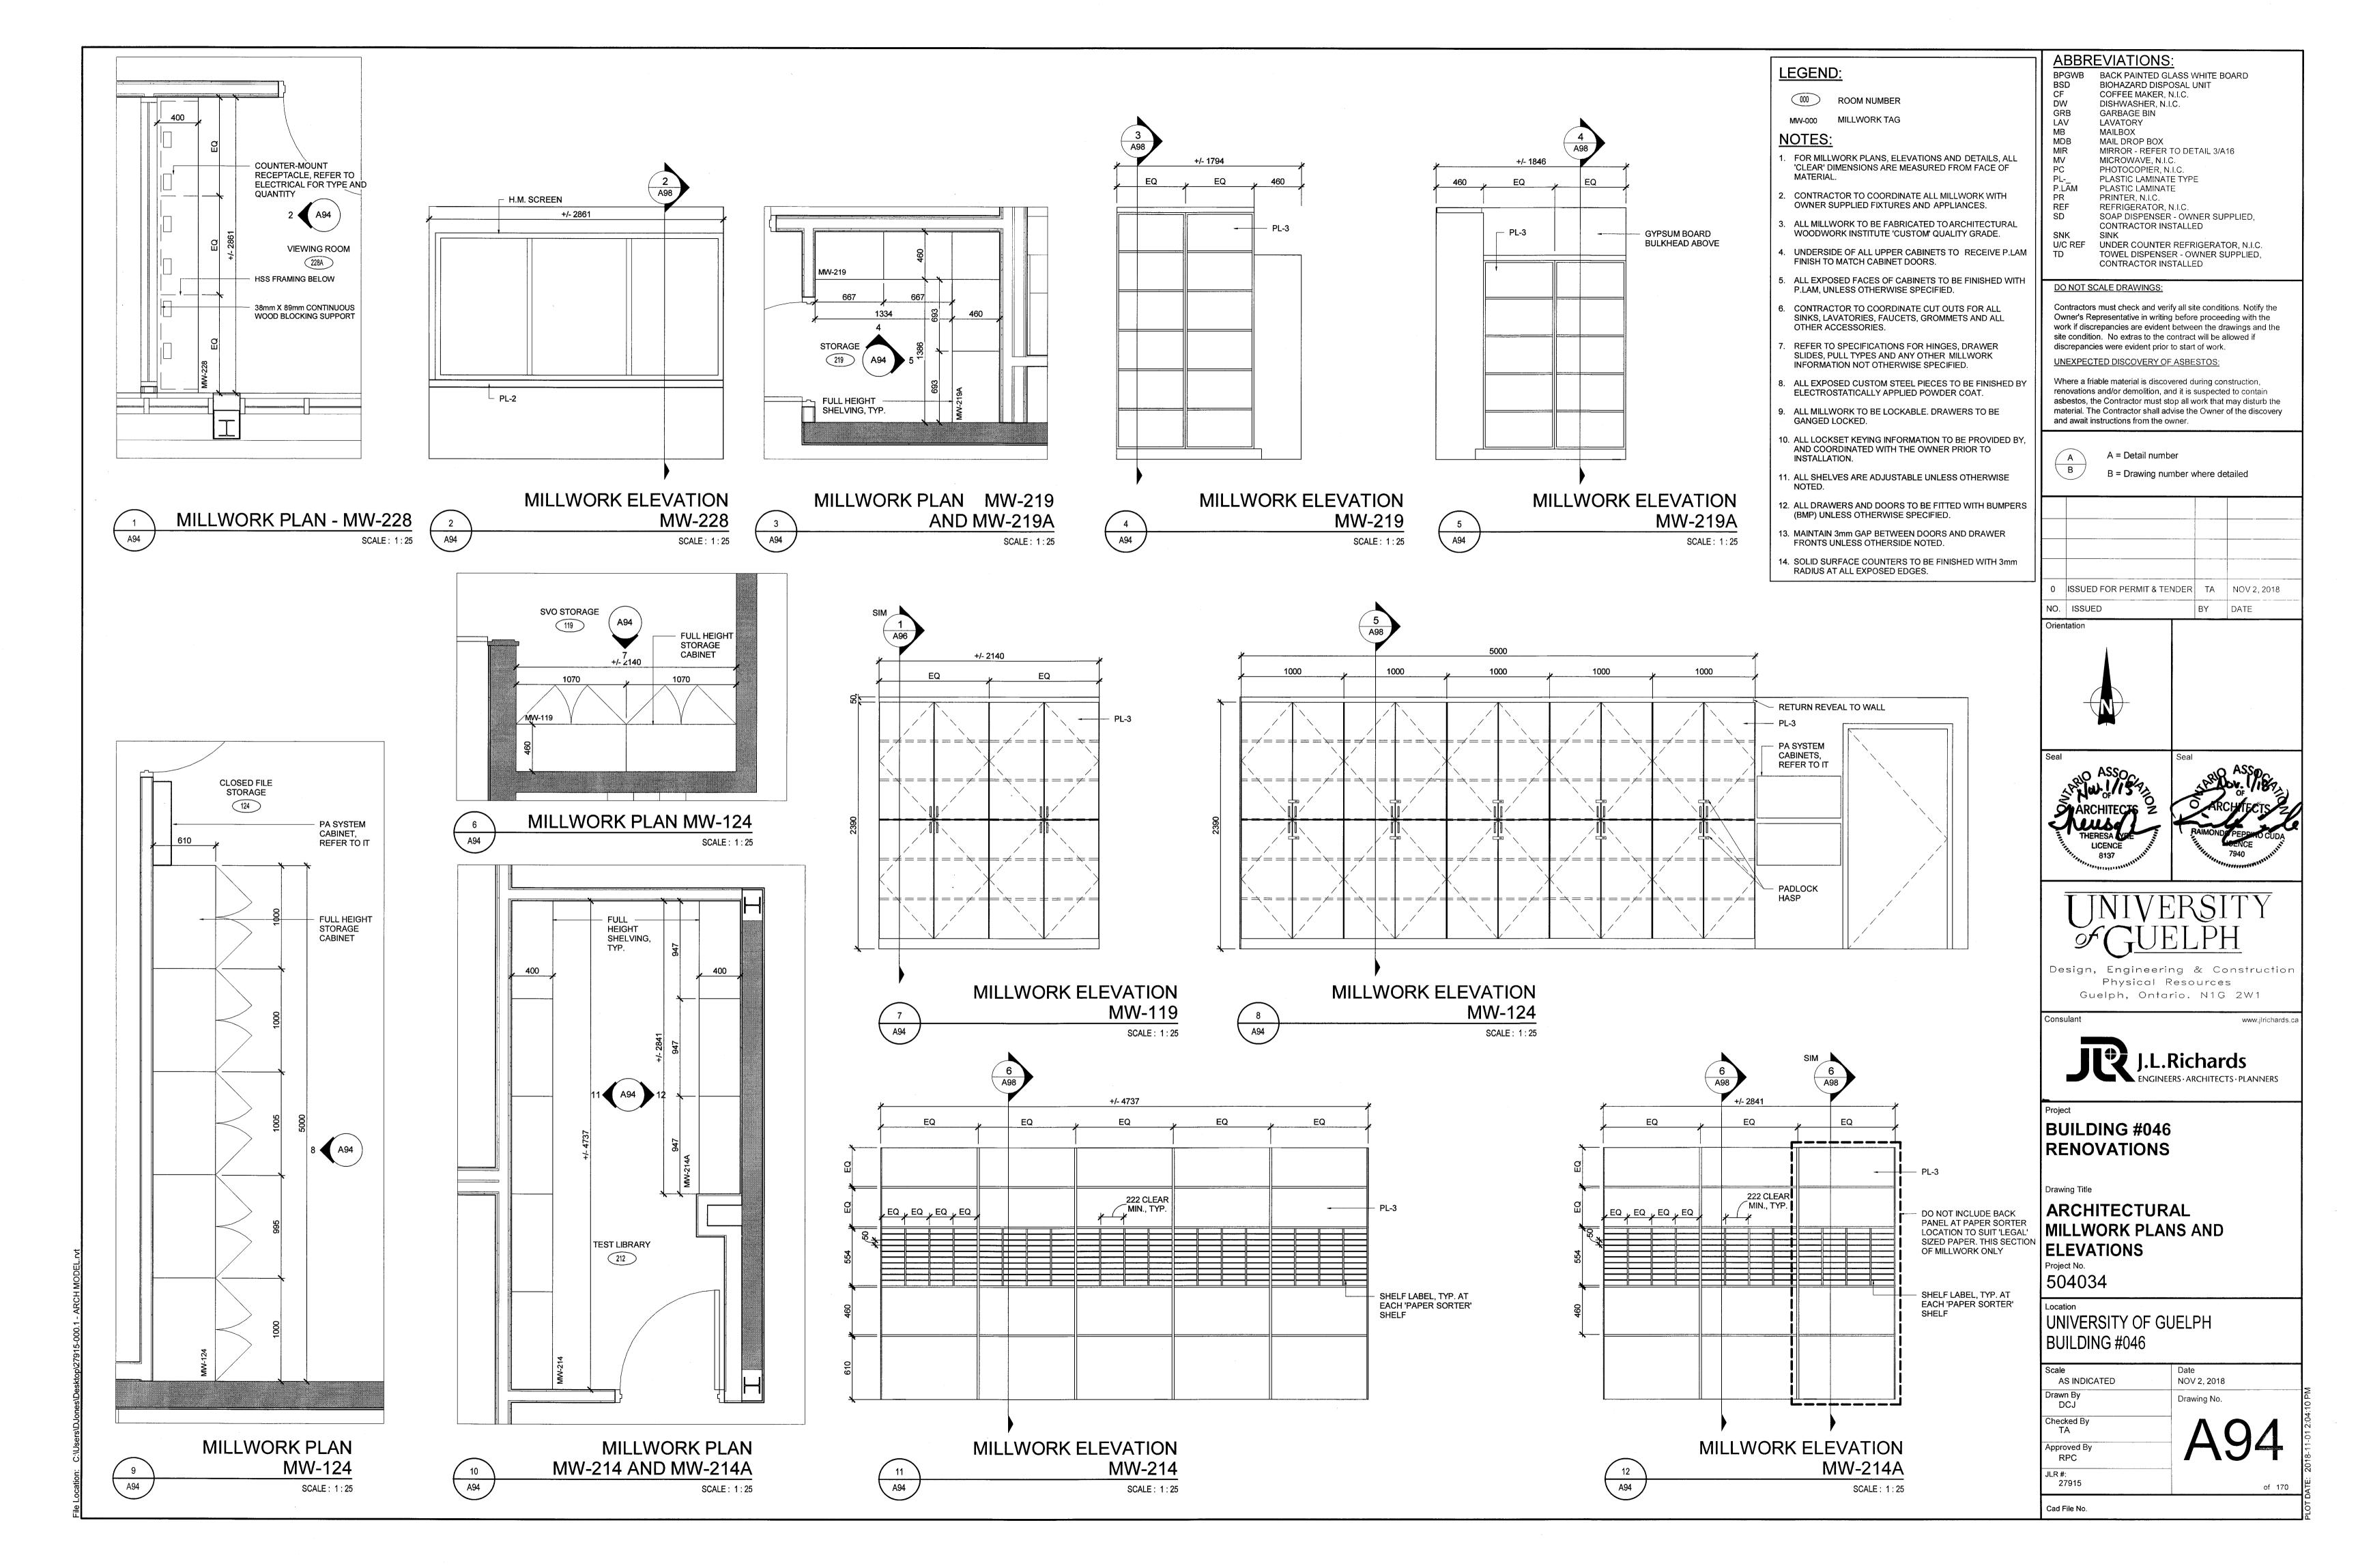





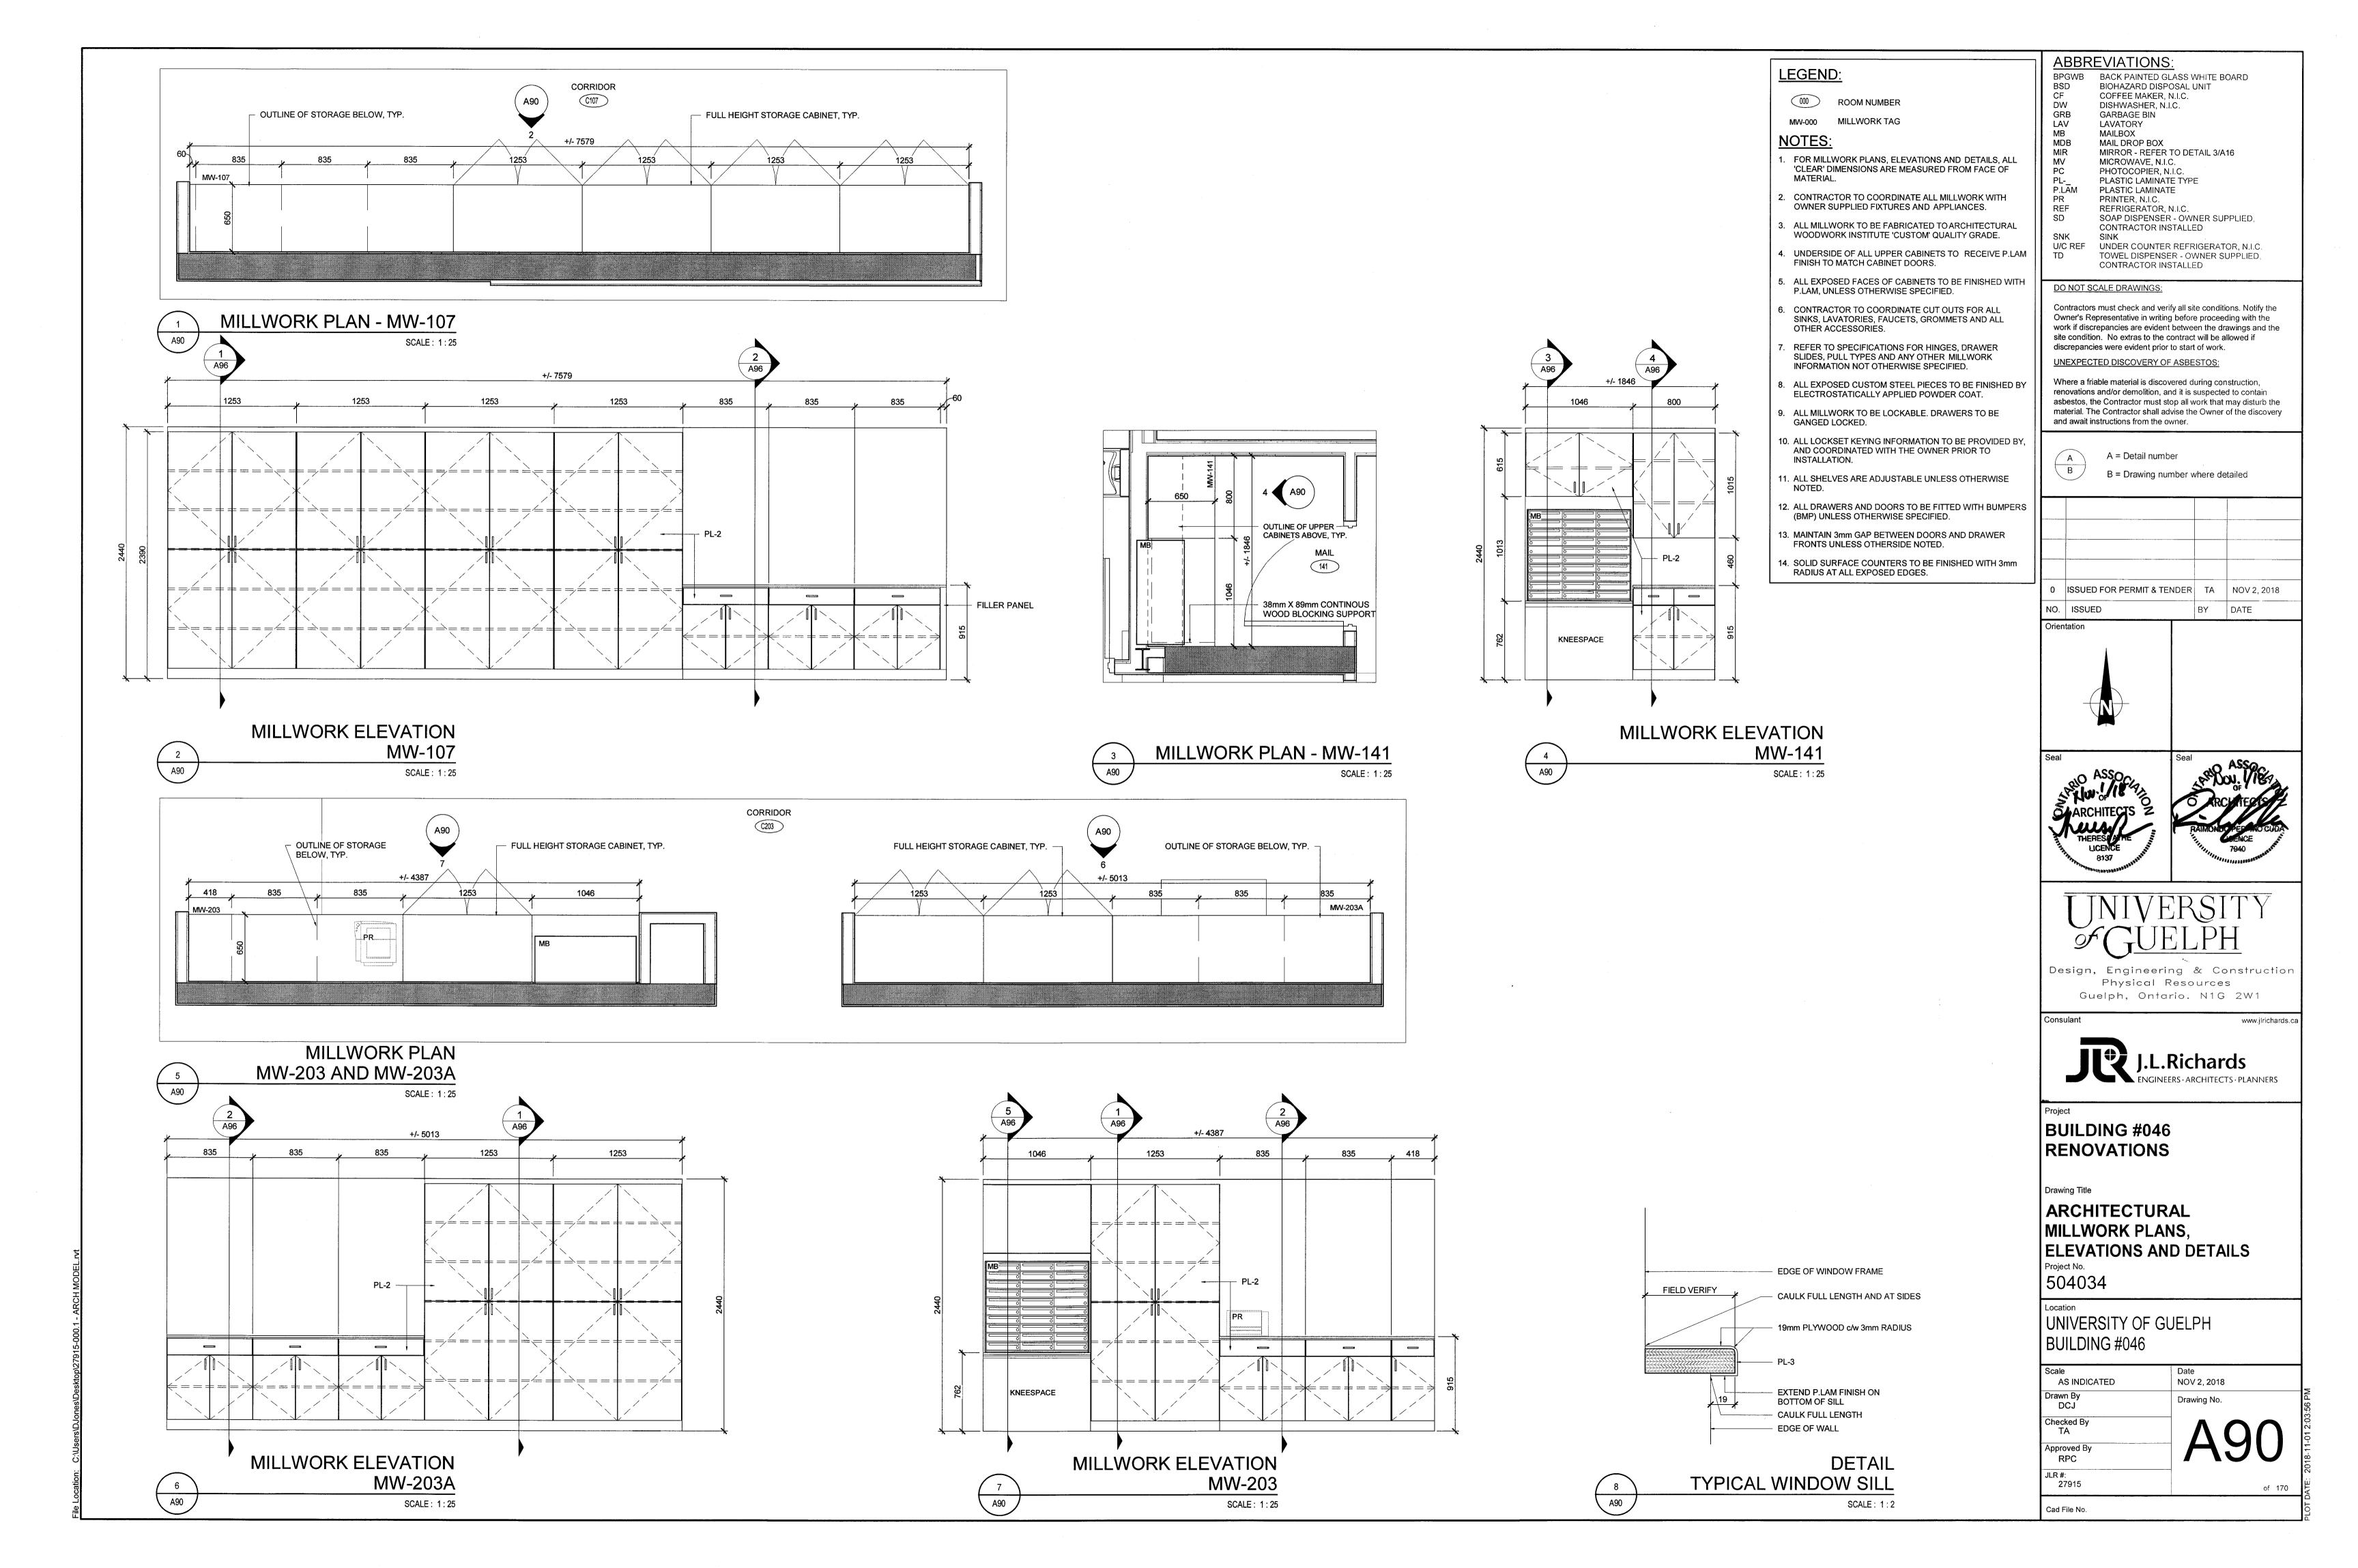

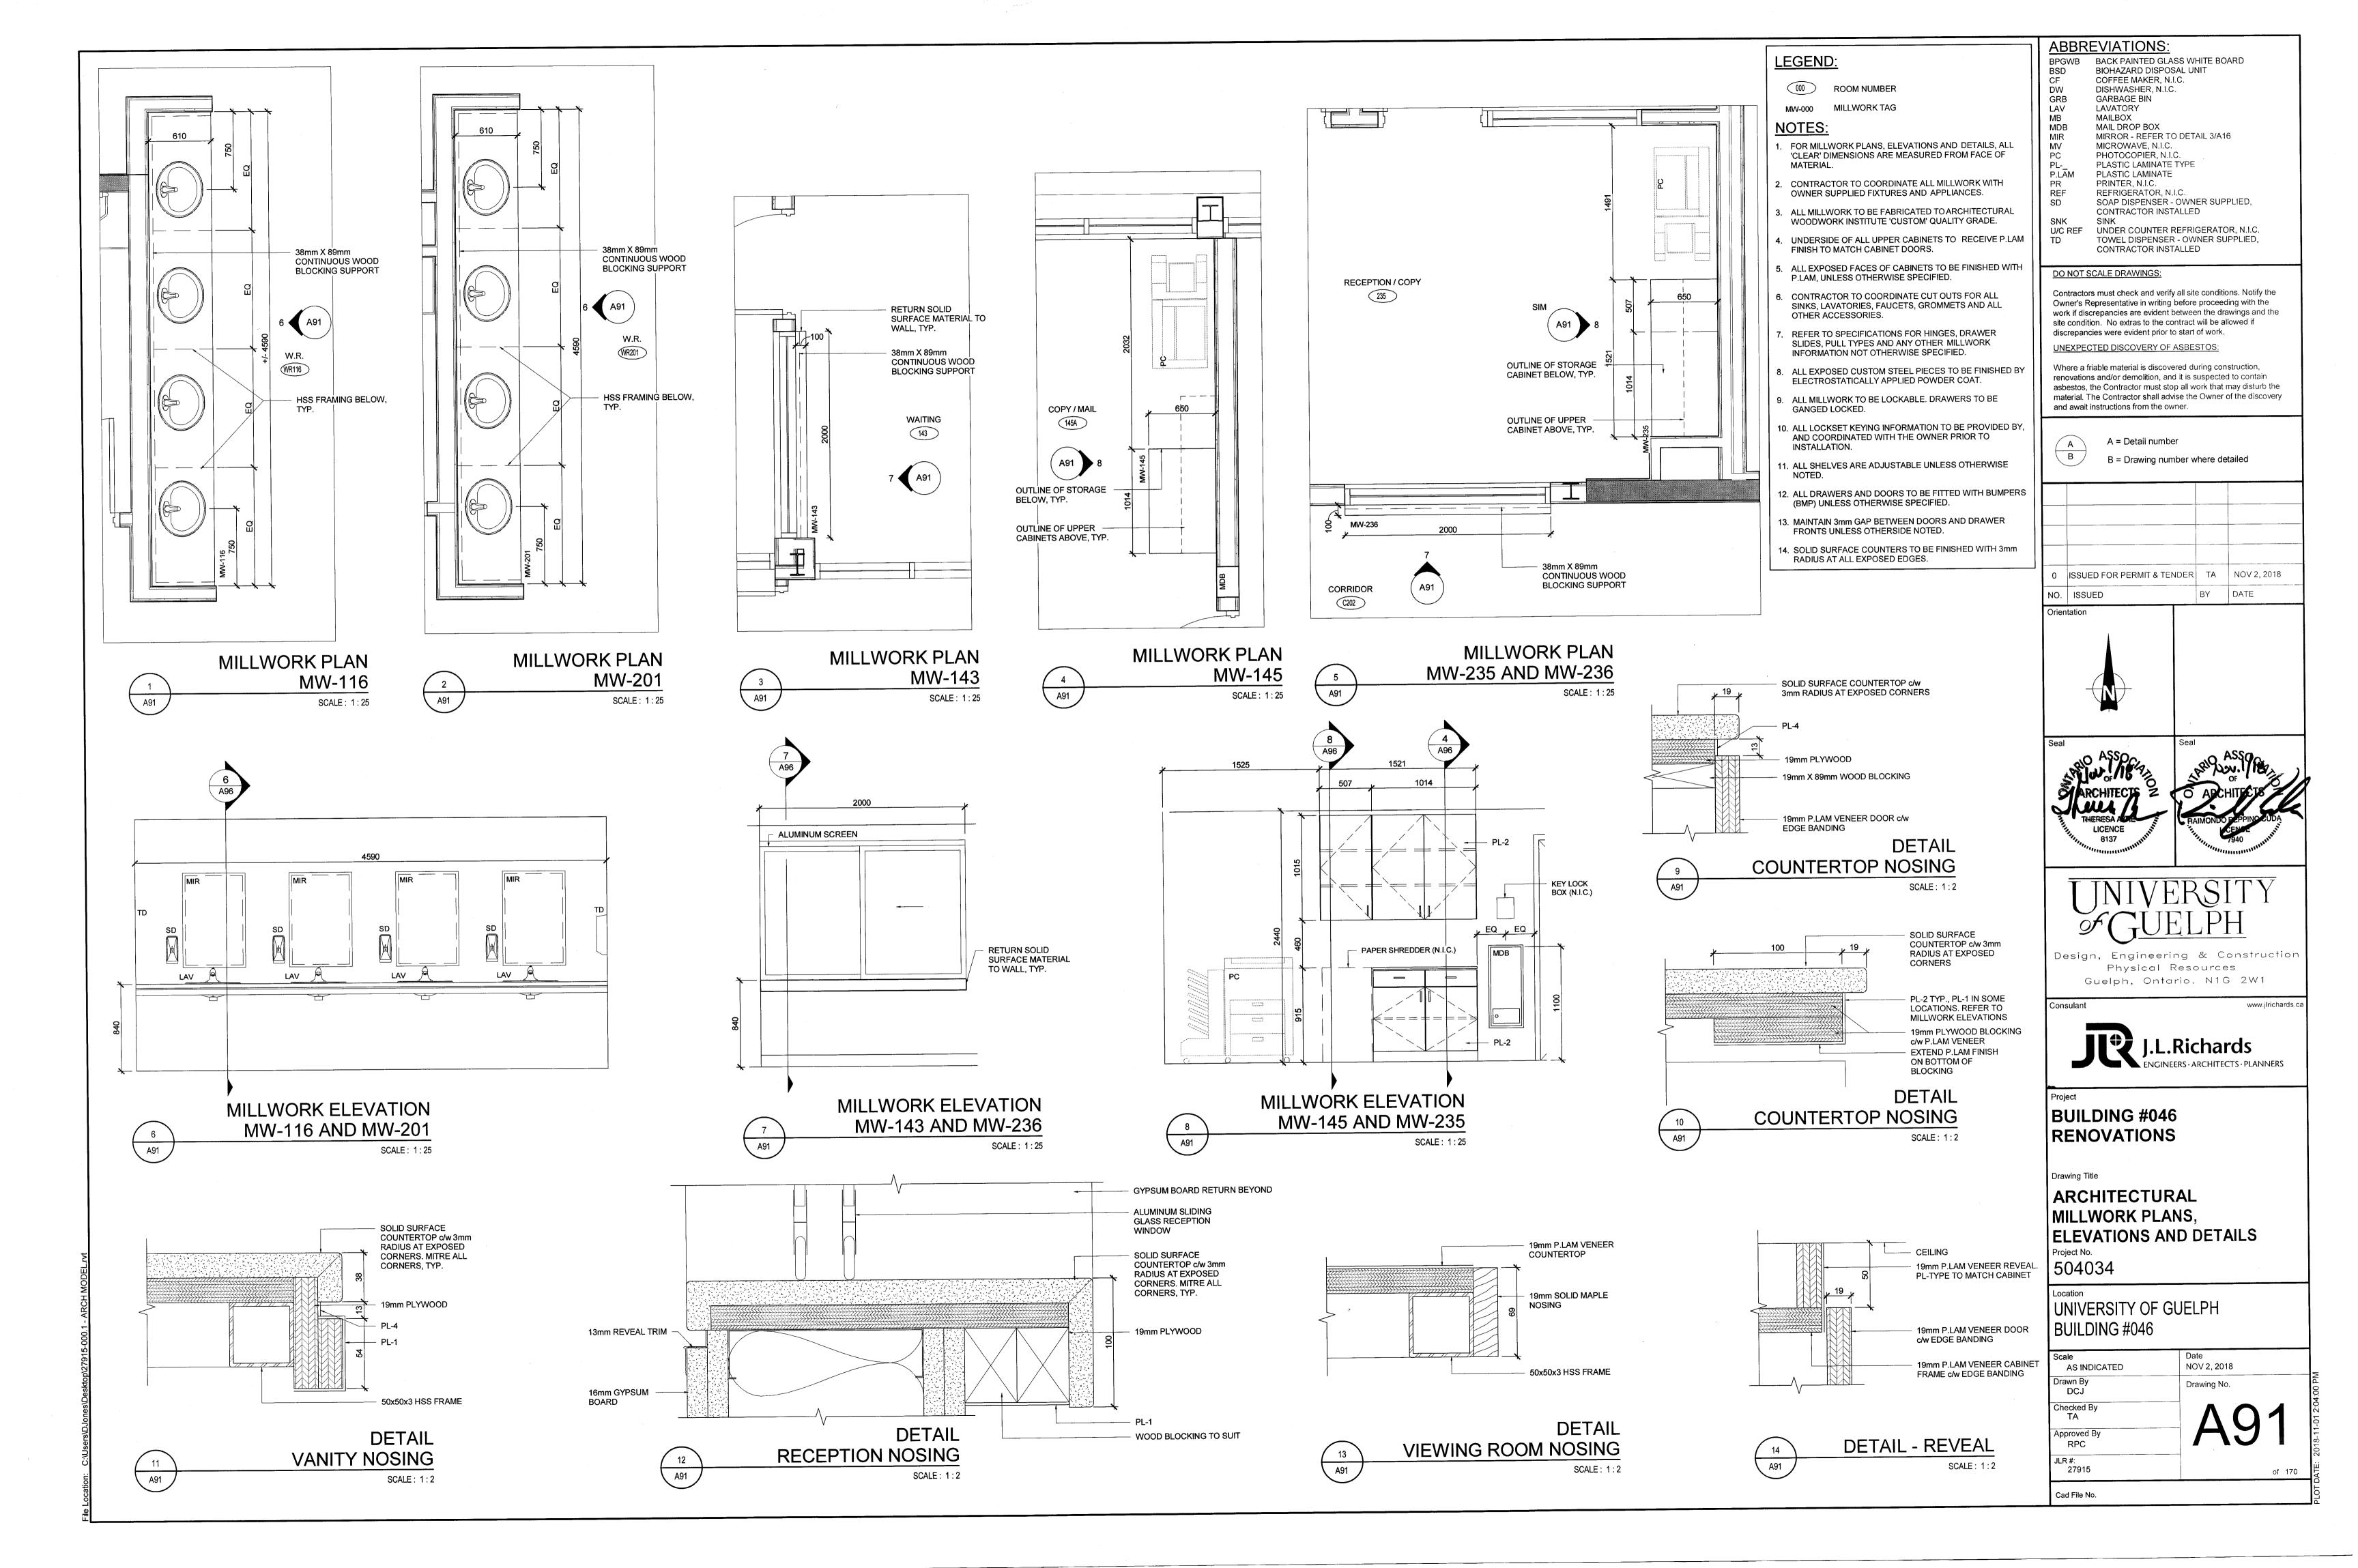

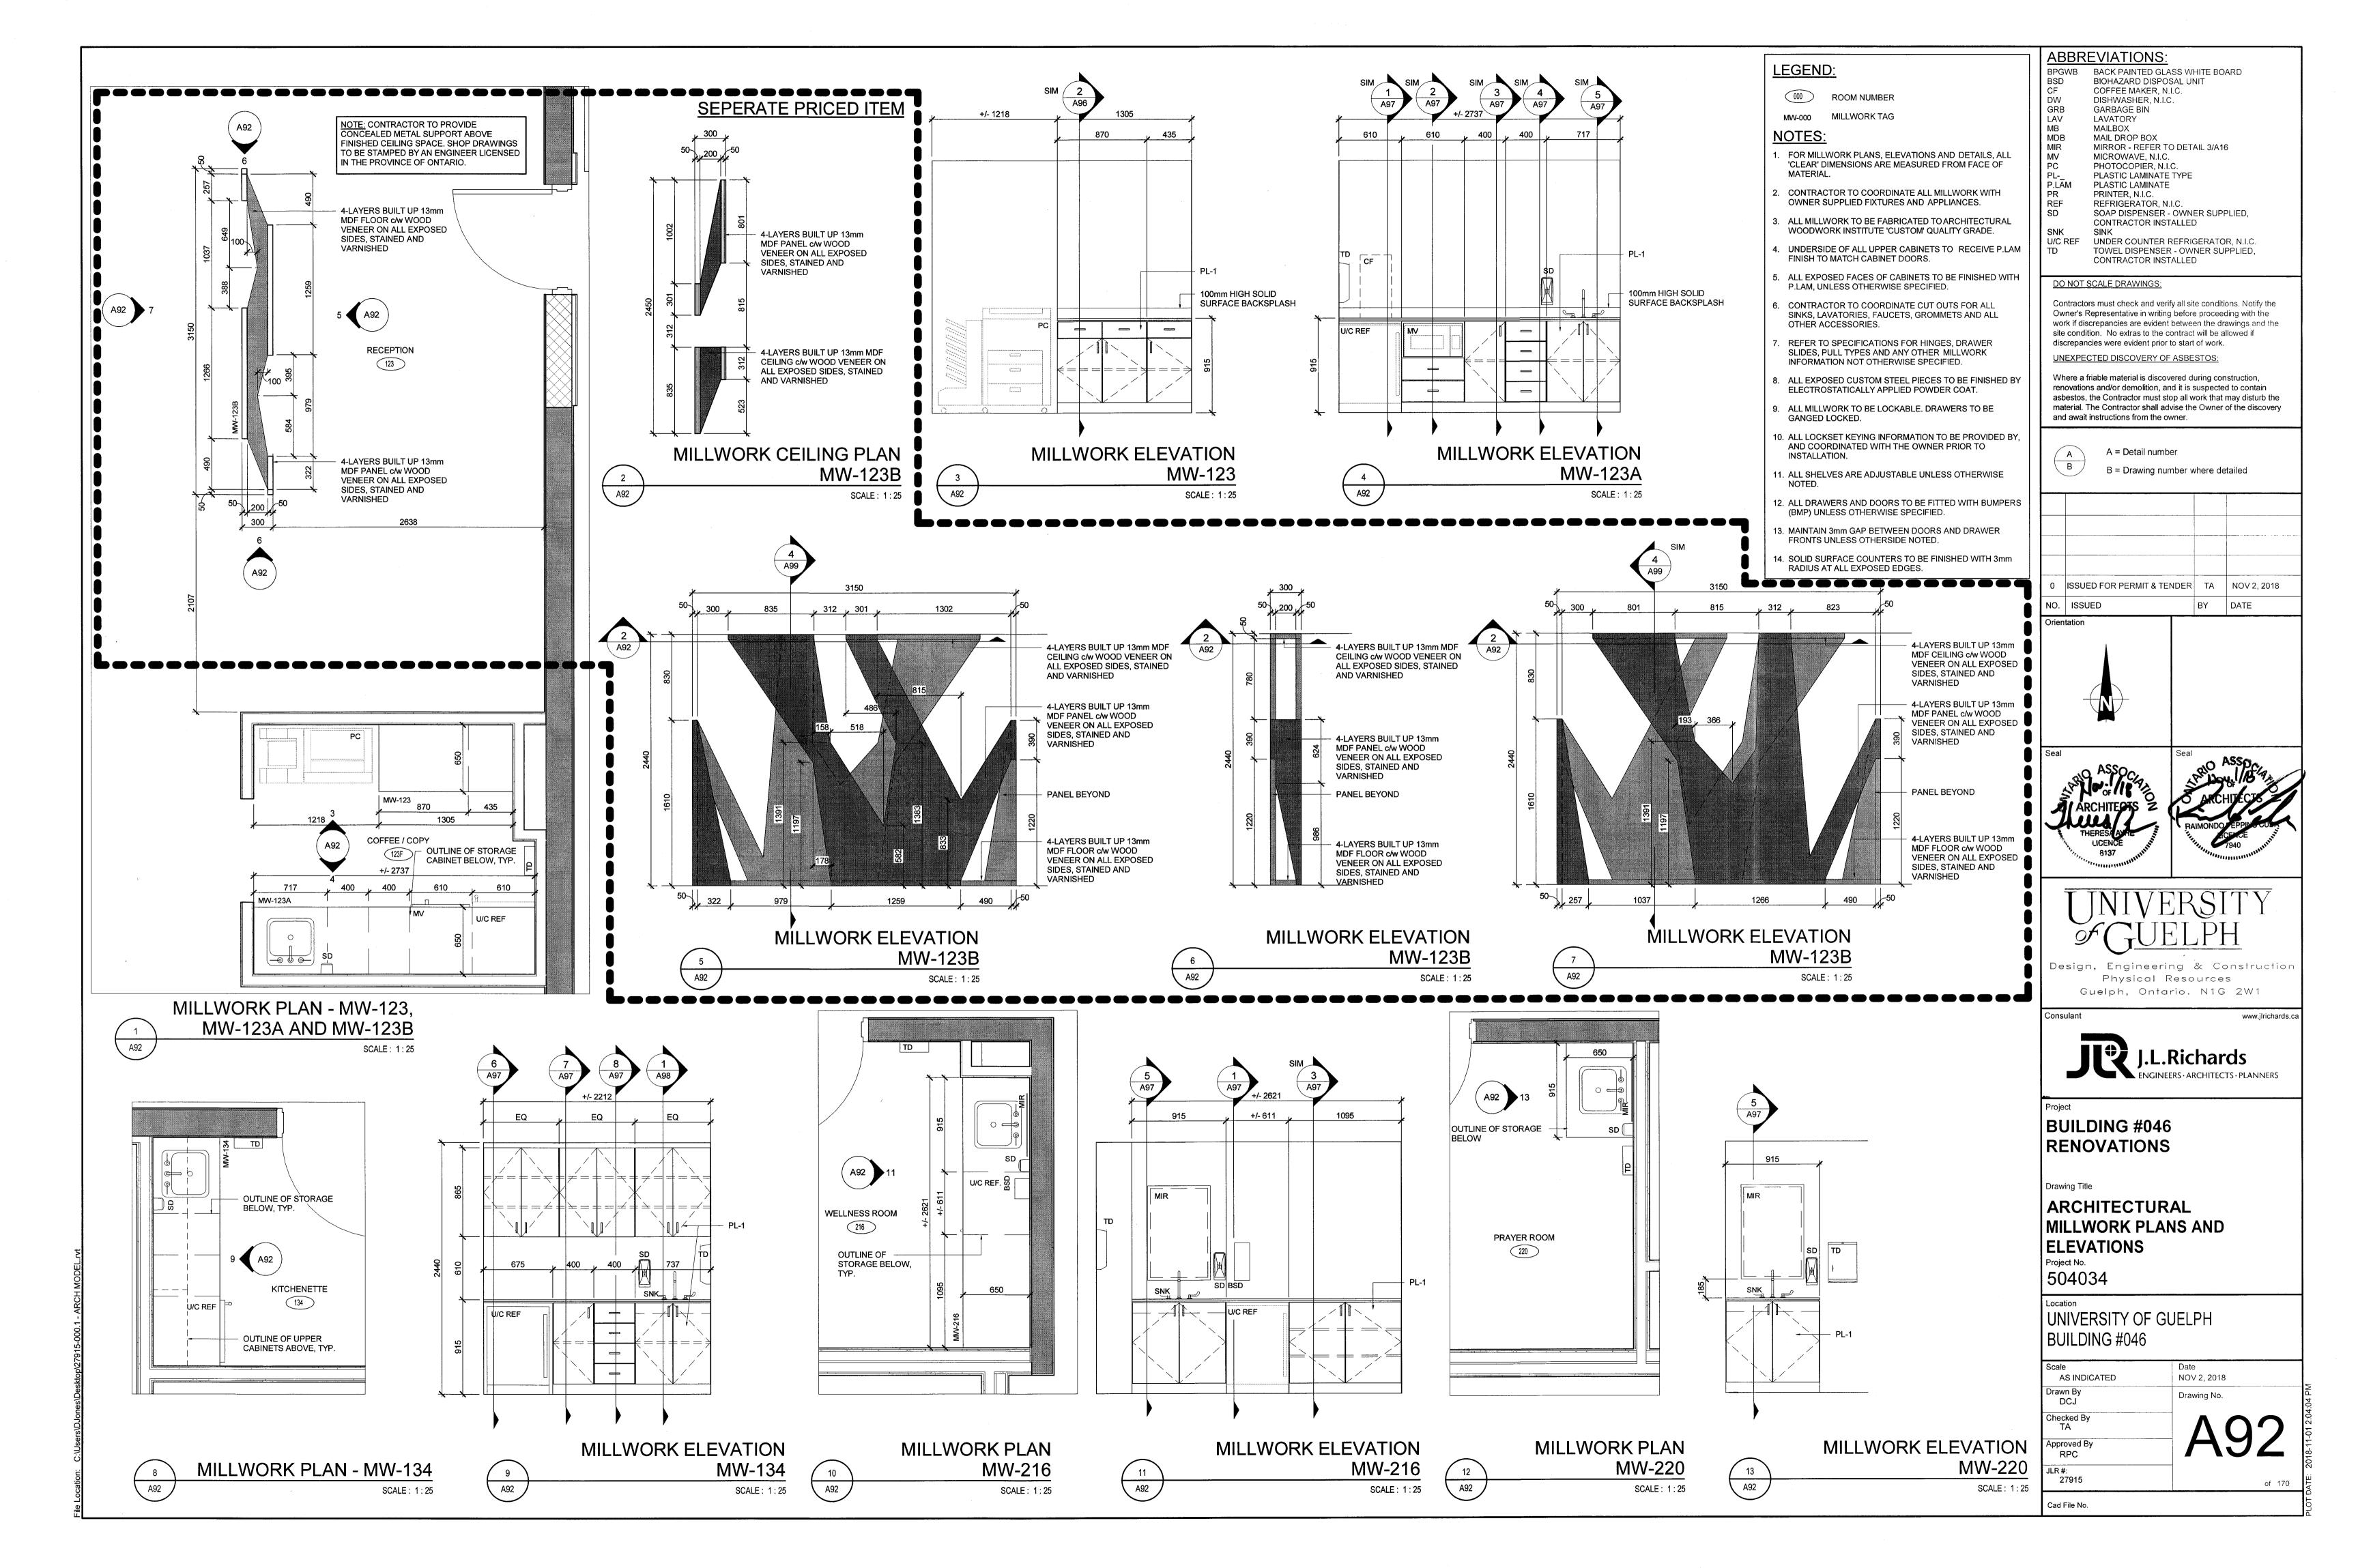

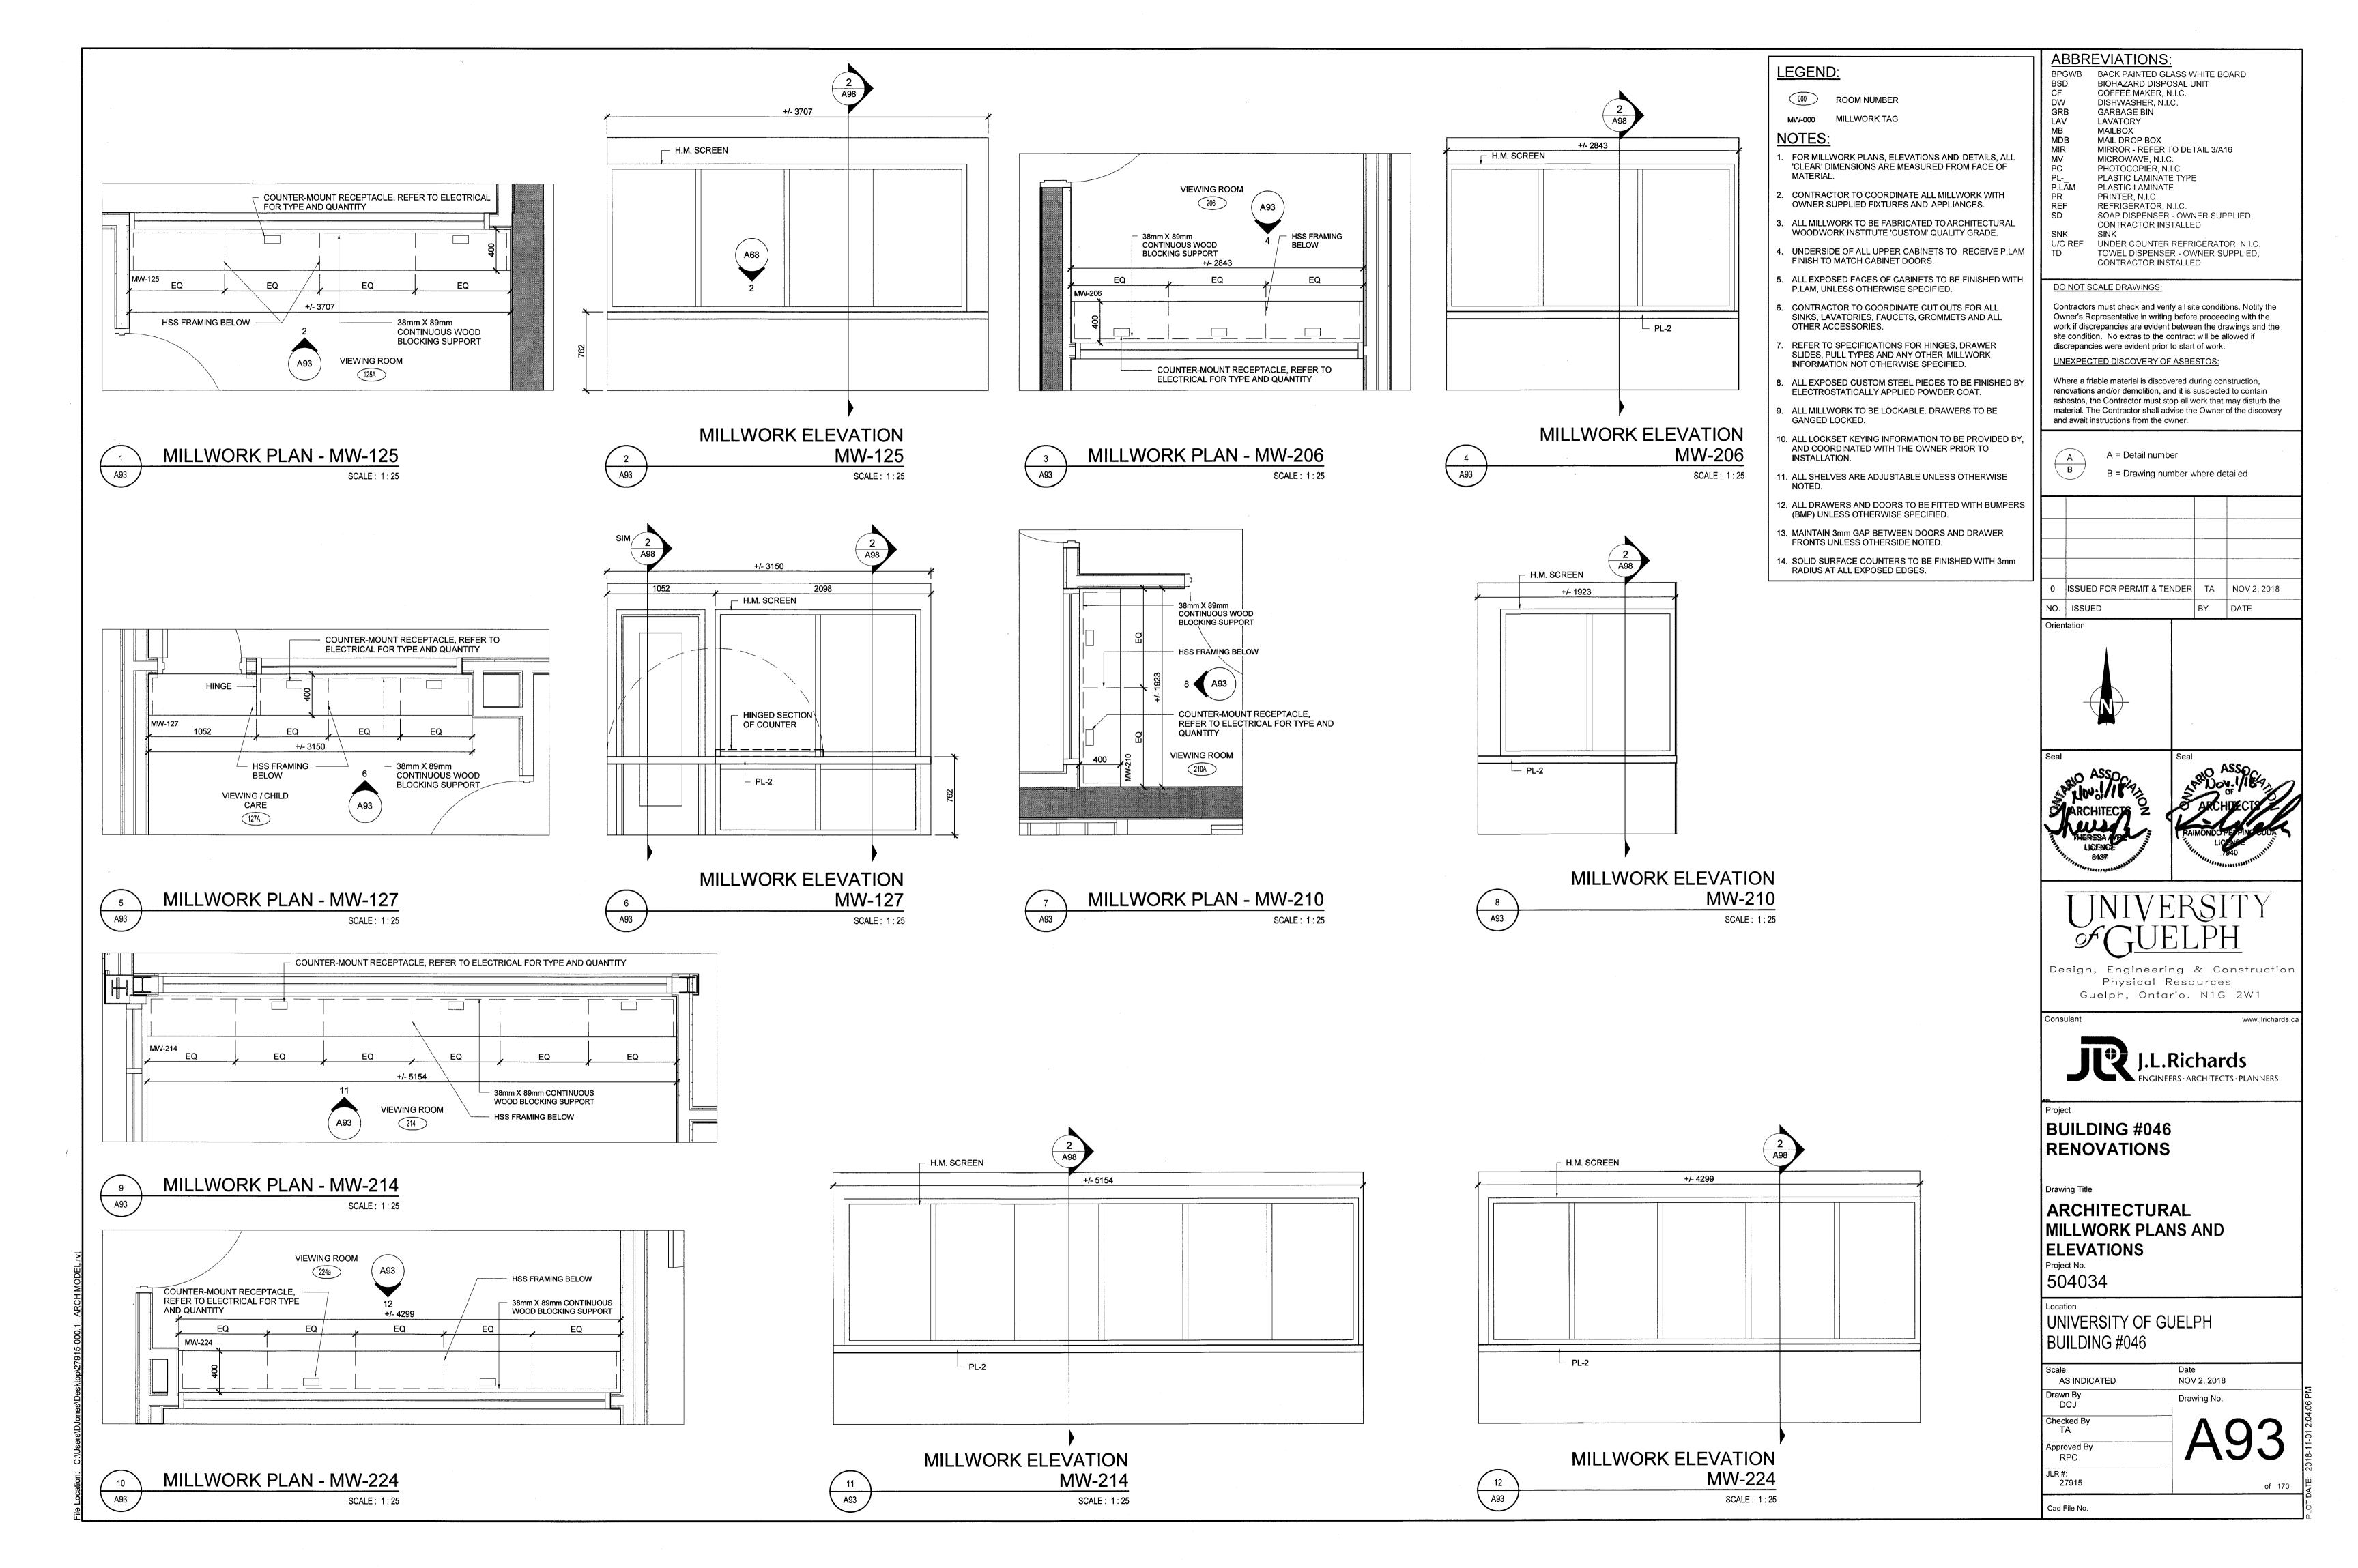

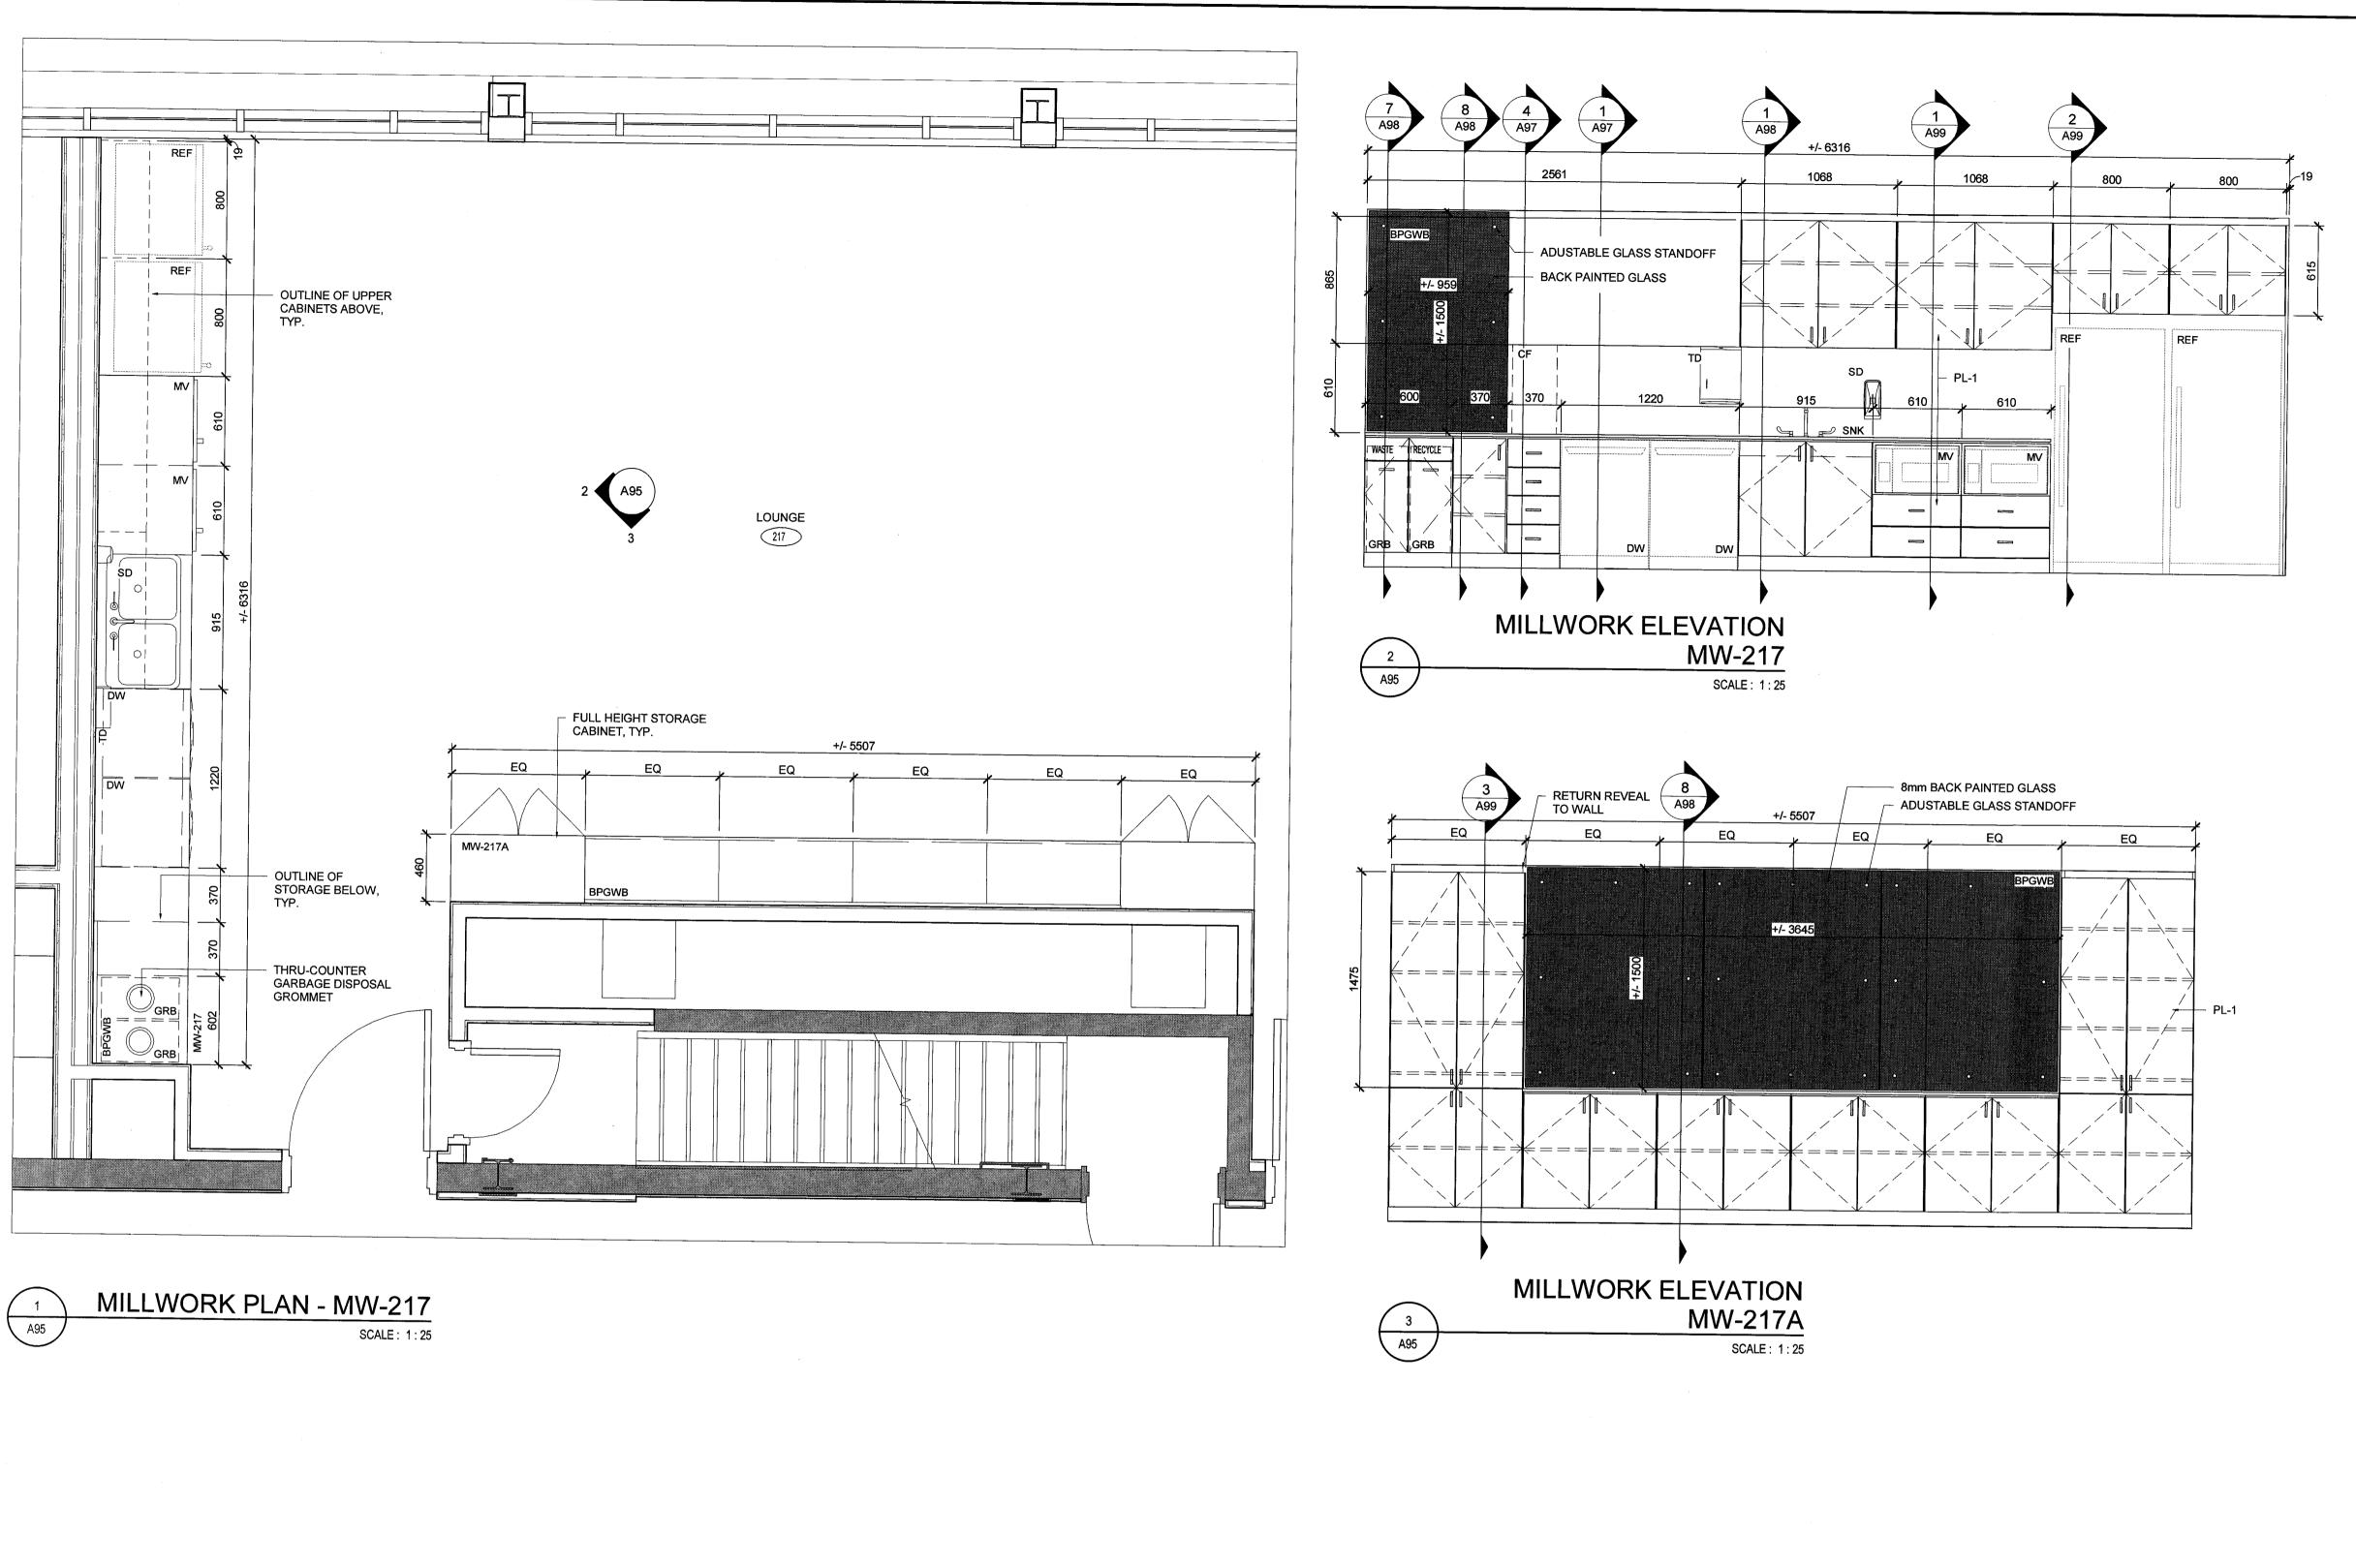

LEGEND:

MW-000 MILLWORK TAG

- - OWNER SUPPLIED FIXTURES AND APPLIANCES.
- UNDERSIDE OF ALL UPPER CABINETS TO RECEIVE P.LAM FINISH TO MATCH CABINET DOORS.
- . CONTRACTOR TO COORDINATE CUT OUTS FOR ALL SINKS, LAVATORIES, FAUCETS, GROMMETS AND ALL
- REFER TO SPECIFICATIONS FOR HINGES, DRAWER SLIDES, PULL TYPES AND ANY OTHER MILLWORK
- 3. ALL EXPOSED CUSTOM STEEL PIECES TO BE FINISHED BY
- 9. ALL MILLWORK TO BE LOCKABLE. DRAWERS TO BE GANGED LOCKED.
- AND COORDINATED WITH THE OWNER PRIOR TO INSTALLATION.
- (BMP) UNLESS OTHERWISE SPECIFIED. 13. MAINTAIN 3mm GAP BETWEEN DOORS AND DRAWER
- 14. SOLID SURFACE COUNTERS TO BE FINISHED WITH 3mm

<u>(000)</u> ROOM NUMBER

NOTES:

- . FOR MILLWORK PLANS, ELEVATIONS AND DETAILS, ALL 'CLEAR' DIMENSIONS ARE MEASURED FROM FACE OF
- CONTRACTOR TO COORDINATE ALL MILLWORK WITH
 - . ALL MILLWORK TO BE FABRICATED TO ARCHITECTURAL WOODWORK INSTITUTE 'CUSTOM' QUALITY GRADE.

 - 5. ALL EXPOSED FACES OF CABINETS TO BE FINISHED WITH P.LAM, UNLESS OTHERWISE SPECIFIED.
- OTHER ACCESSORIES.
- INFORMATION NOT OTHERWISE SPECIFIED.
- ELECTROSTATICALLY APPLIED POWDER COAT.
- 10. ALL LOCKSET KEYING INFORMATION TO BE PROVIDED BY
- 11. ALL SHELVES ARE ADJUSTABLE UNLESS OTHERWISE
- 12. ALL DRAWERS AND DOORS TO BE FITTED WITH BUMPERS
- FRONTS UNLESS OTHERSIDE NOTED.
- RADIUS AT ALL EXPOSED EDGES.

ABBREVIATIONS:

BPGWB BACK PAINTED GLASS WHITE BOARD BSD CF DW GRB LAV MB BIOHAZARD DISPOSAL UNIT COFFEE MAKER, N.I.C. DISHWASHER, N.I.C. GARBAGE BIN LAVATORY MAILBOX MAIL DROP BOX MIRROR - REFER TO DETAIL 3/A16 MICROWAVE, N.I.C. PHOTOCOPIER, N.I.C. PLASTIC LAMINATE TYPE PLASTIC LAMINATE PRINTER, N.I.C. REFRIGERATOR, N.I.C. SOAP DISPENSER - OWNER SUPPLIED, CONTRACTOR INSTALLED

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U/C REF UNDER COUNTER REFRIGERATOR, N.I.C.

CONTRACTOR INSTALLED

TOWEL DISPENSER - OWNER SUPPLIED,

UNEXPECTED DISCOVERY OF ASBESTOS:

Where a friable material is discovered during construction, renovations and/or demolition, and it is suspected to contain asbestos, the Contractor must stop all work that may disturb the material. The Contractor shall advise the Owner of the discovery and await instructions from the owner.



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Design, Engineering & Construction Physical Resources Guelph, Ontario. N1G 2W1

J.L.Richards

BUILDING #046 RENOVATIONS

Drawing Title


ARCHITECTURAL MILLWORK PLANS AND **ELEVATIONS**


504034


Cad File No.


UNIVERSITY OF GUELPH BUILDING #046


AS INDICATED NOV 2, 2018 Drawing No. JLR #: 27915

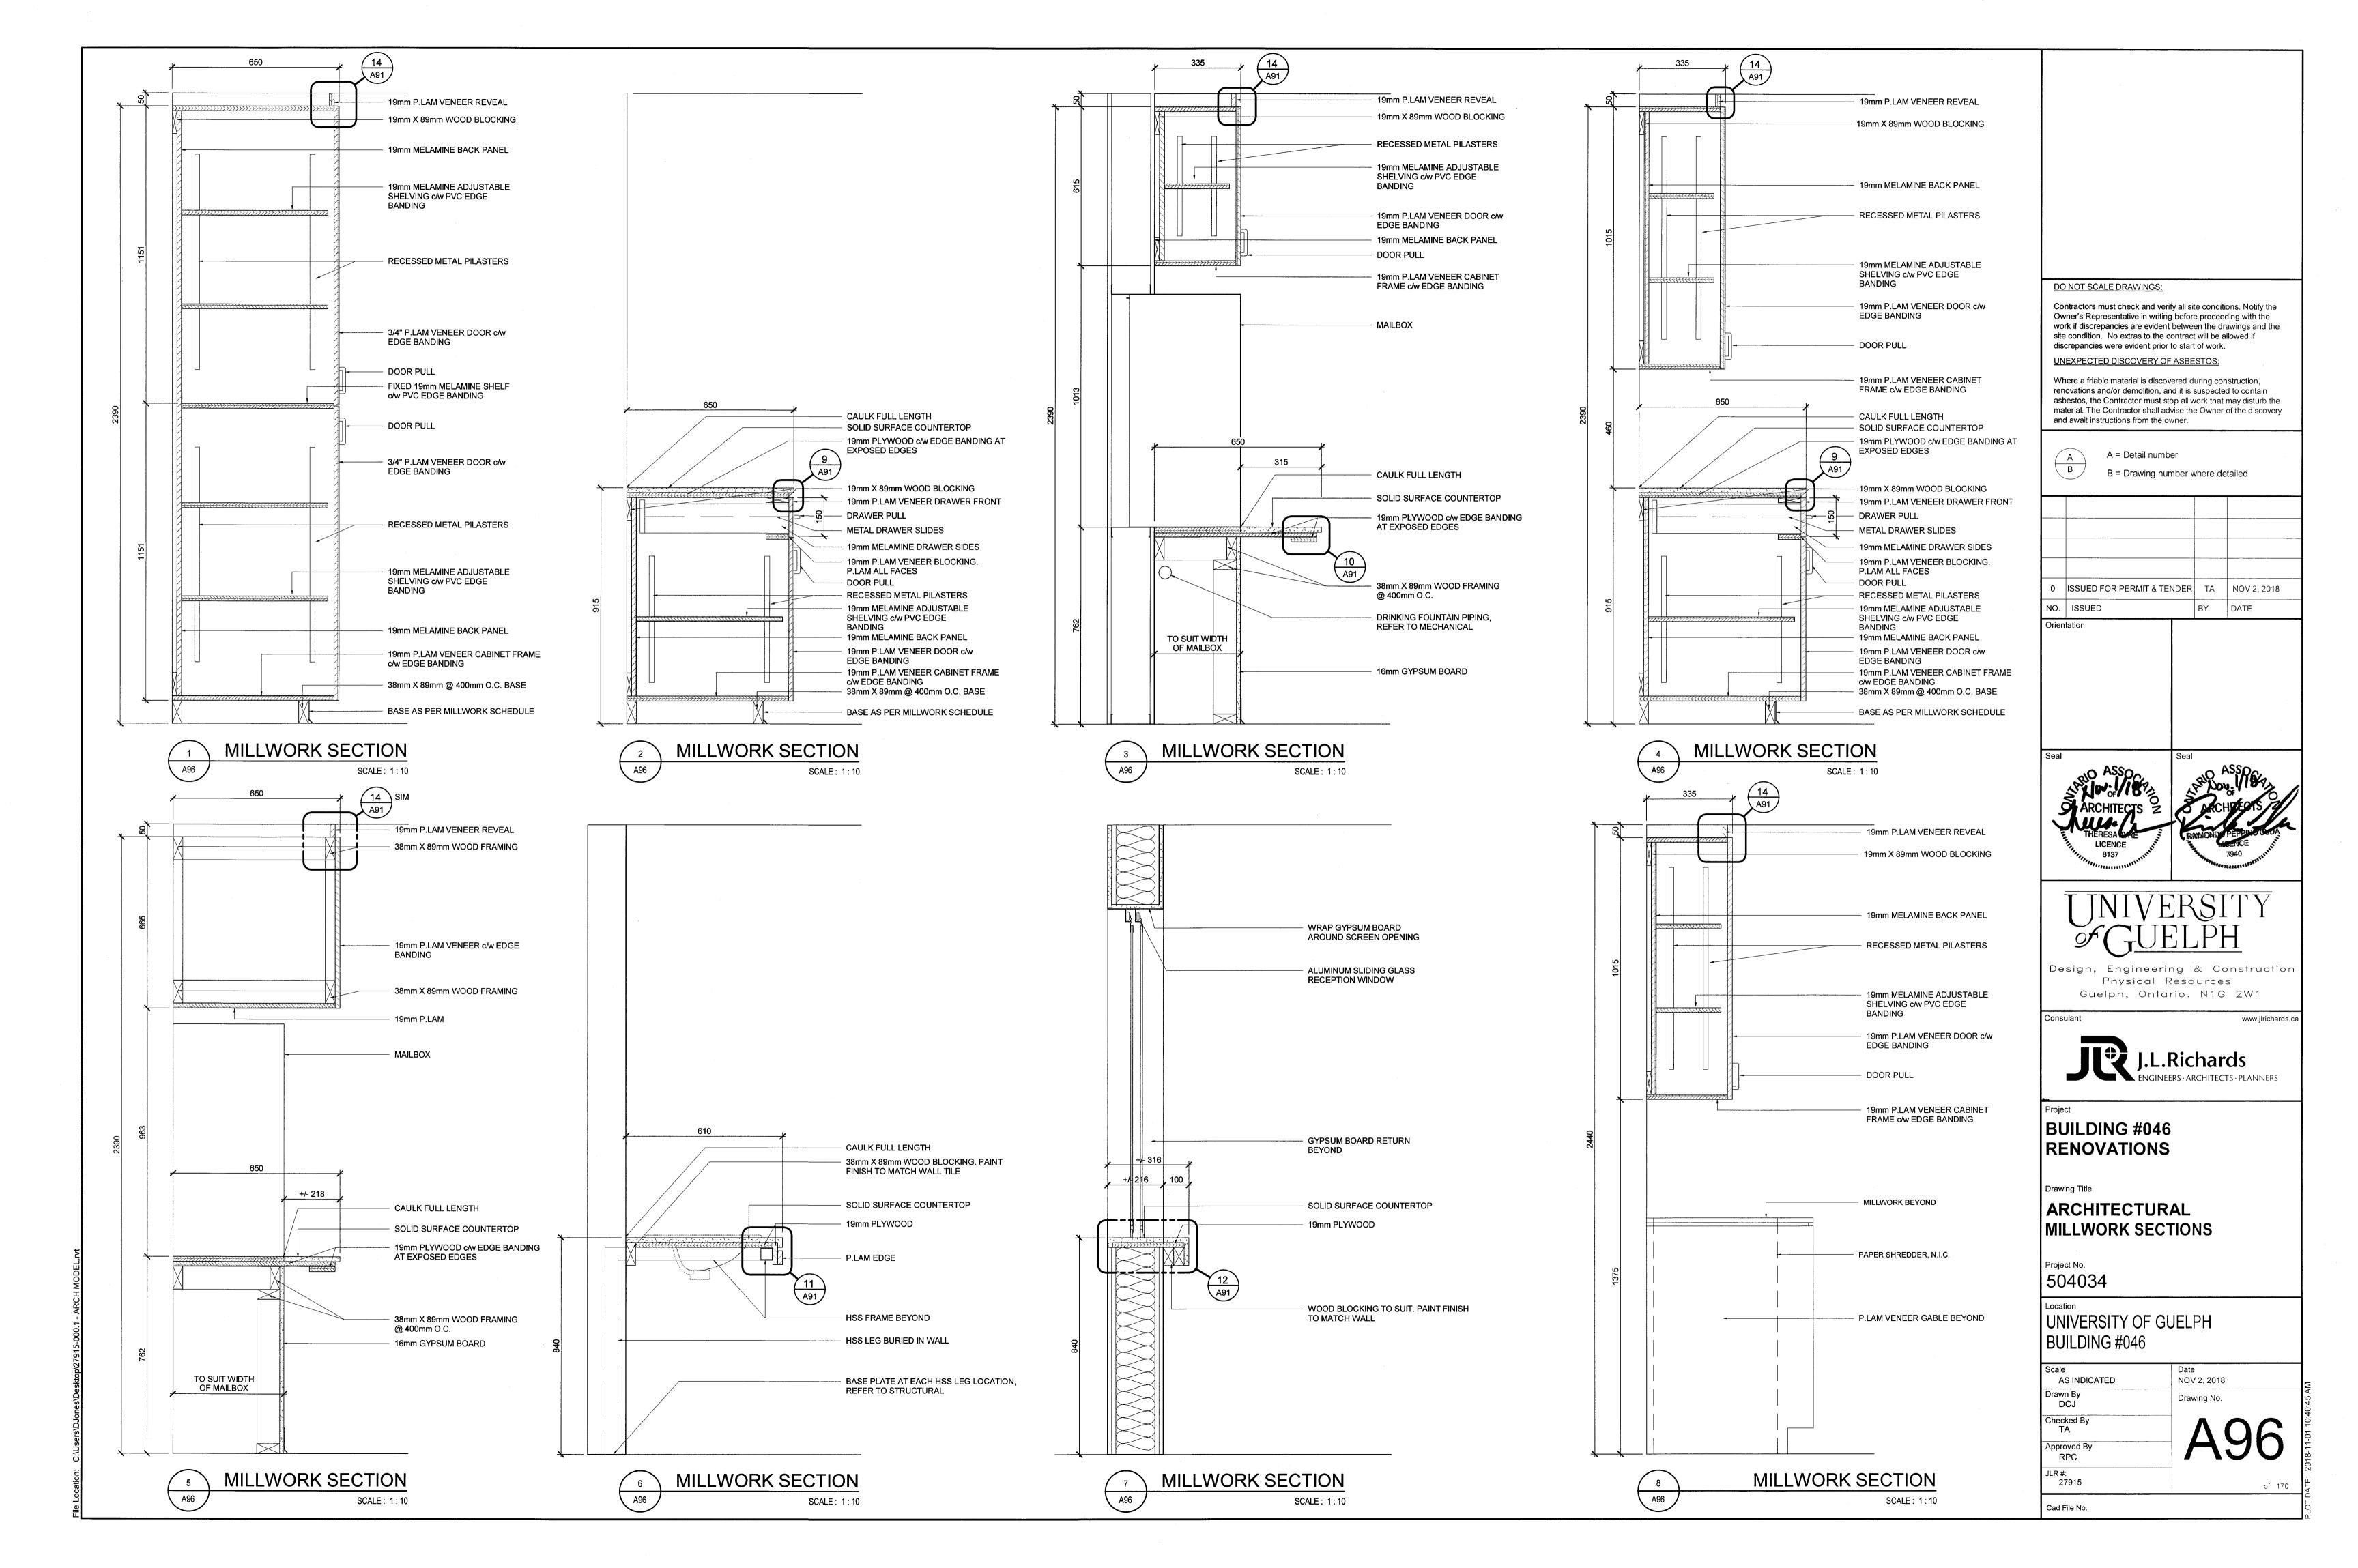

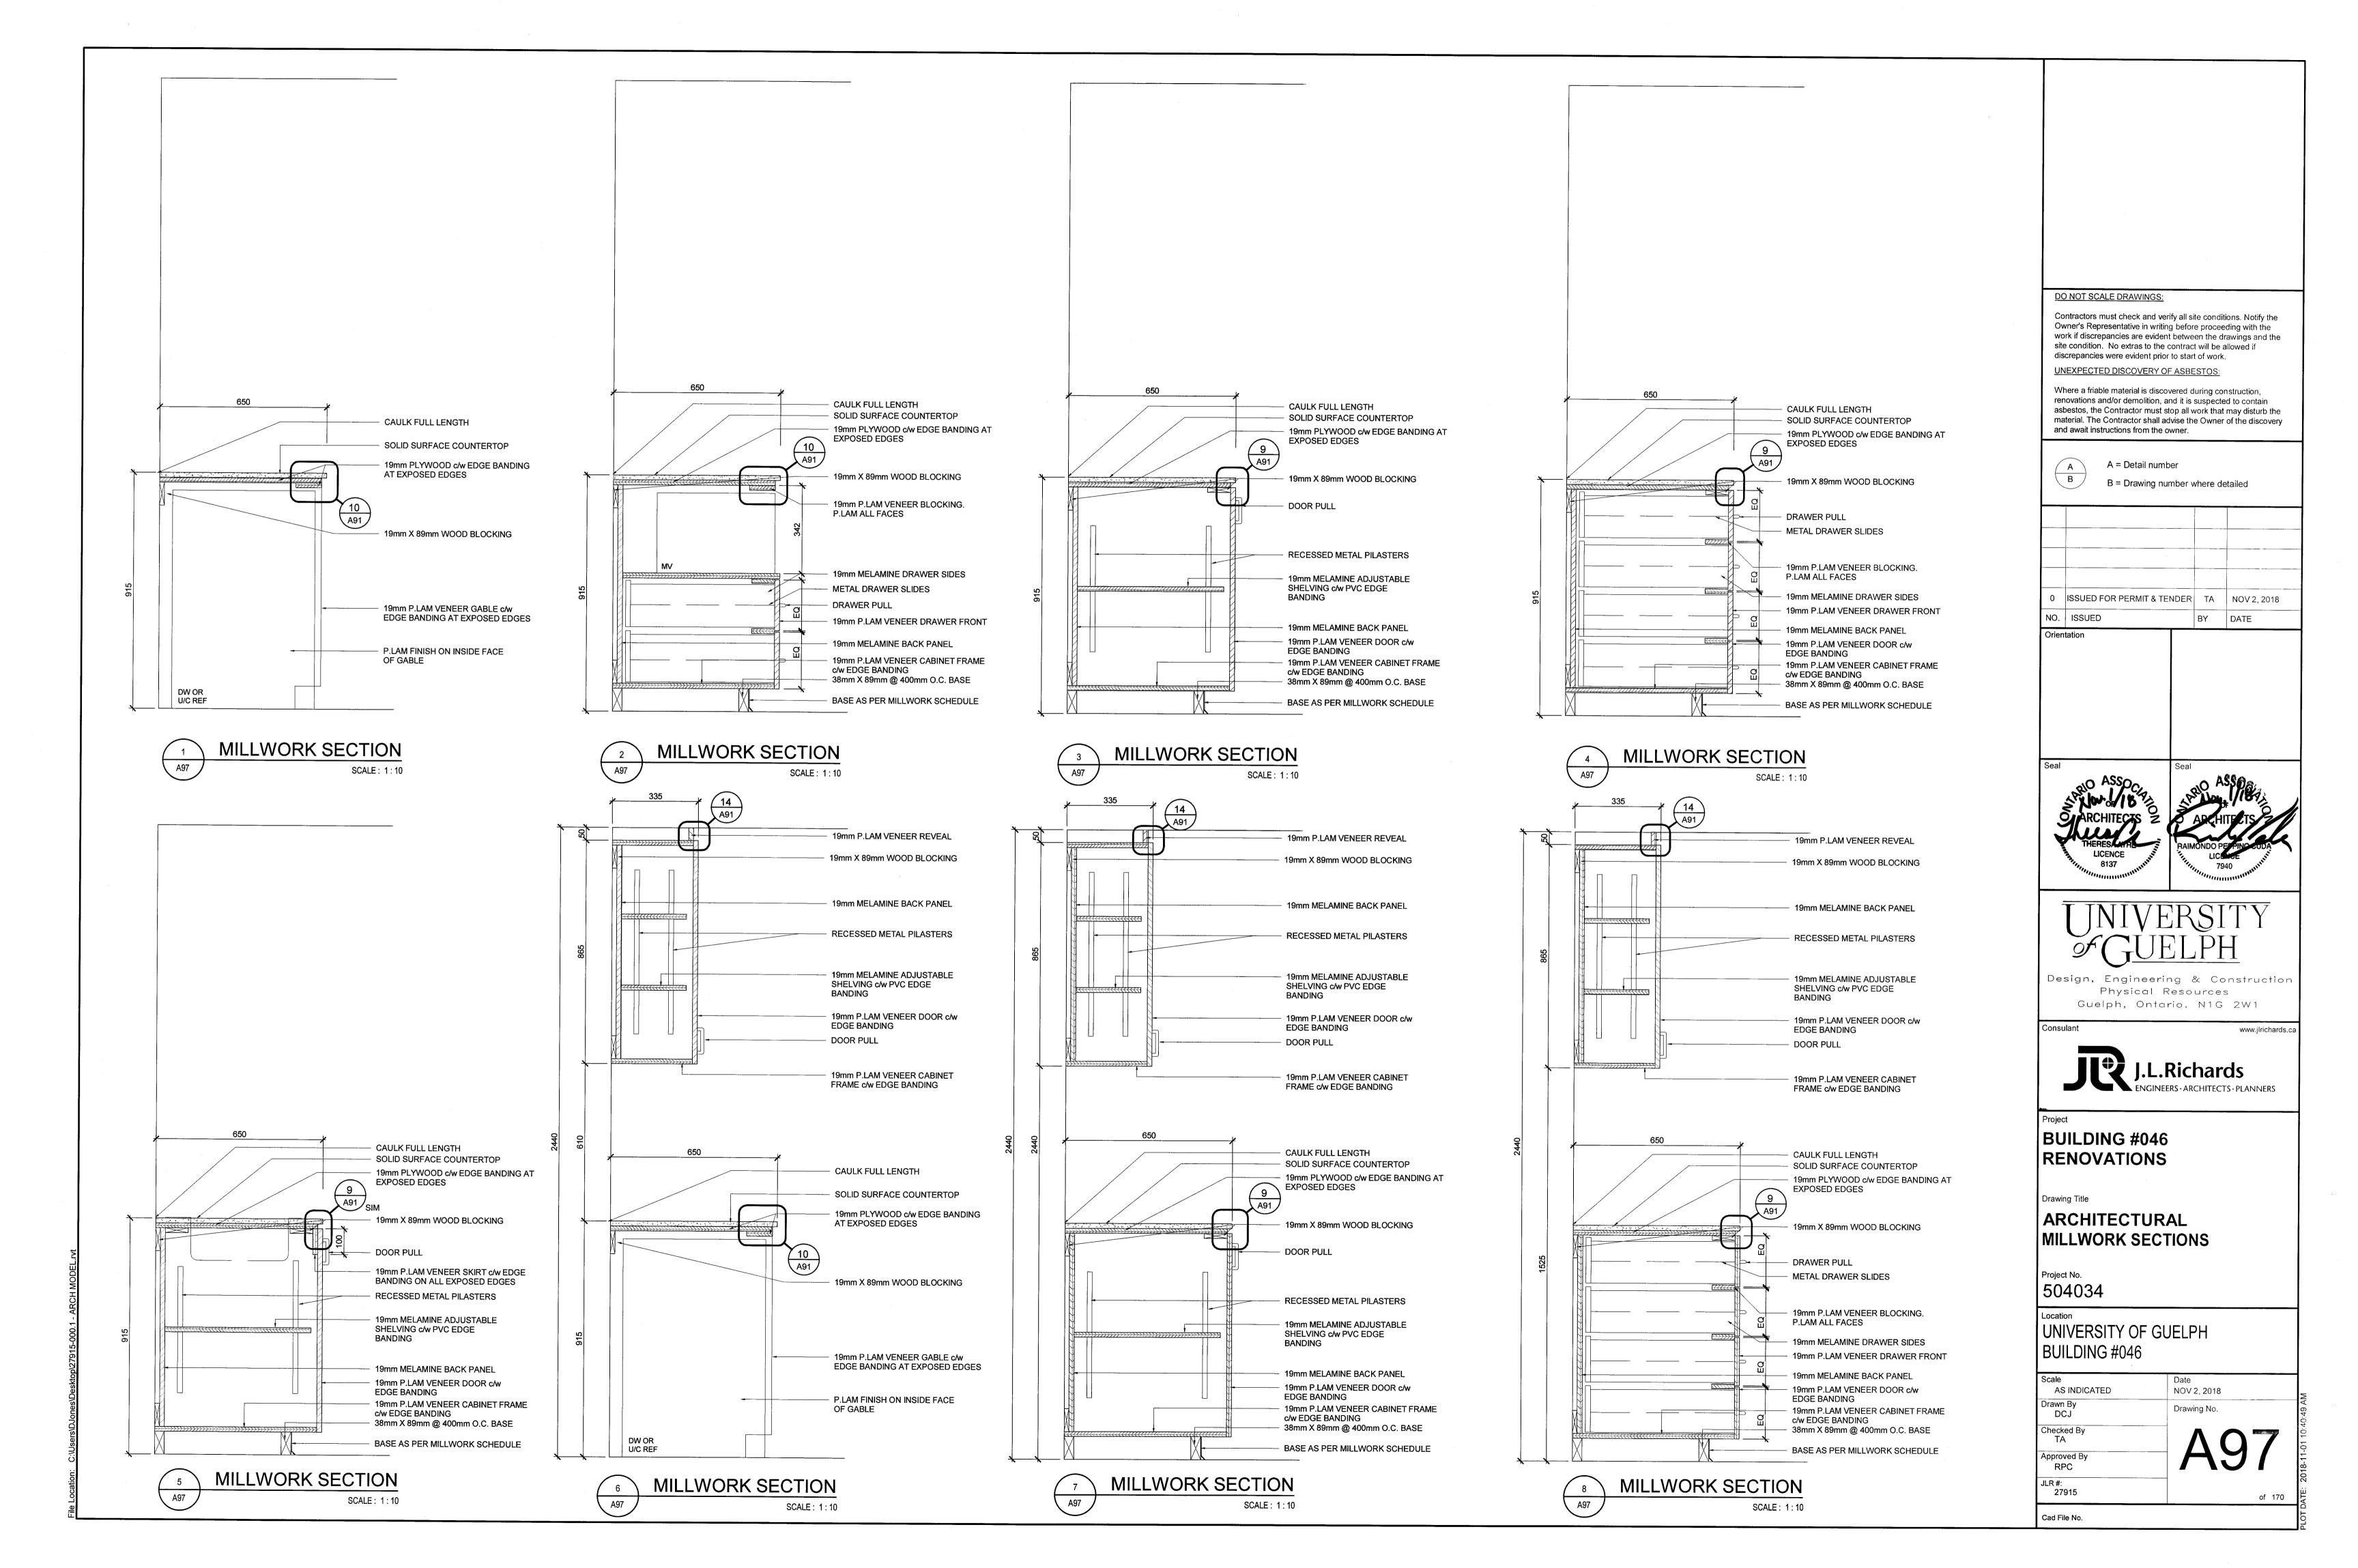

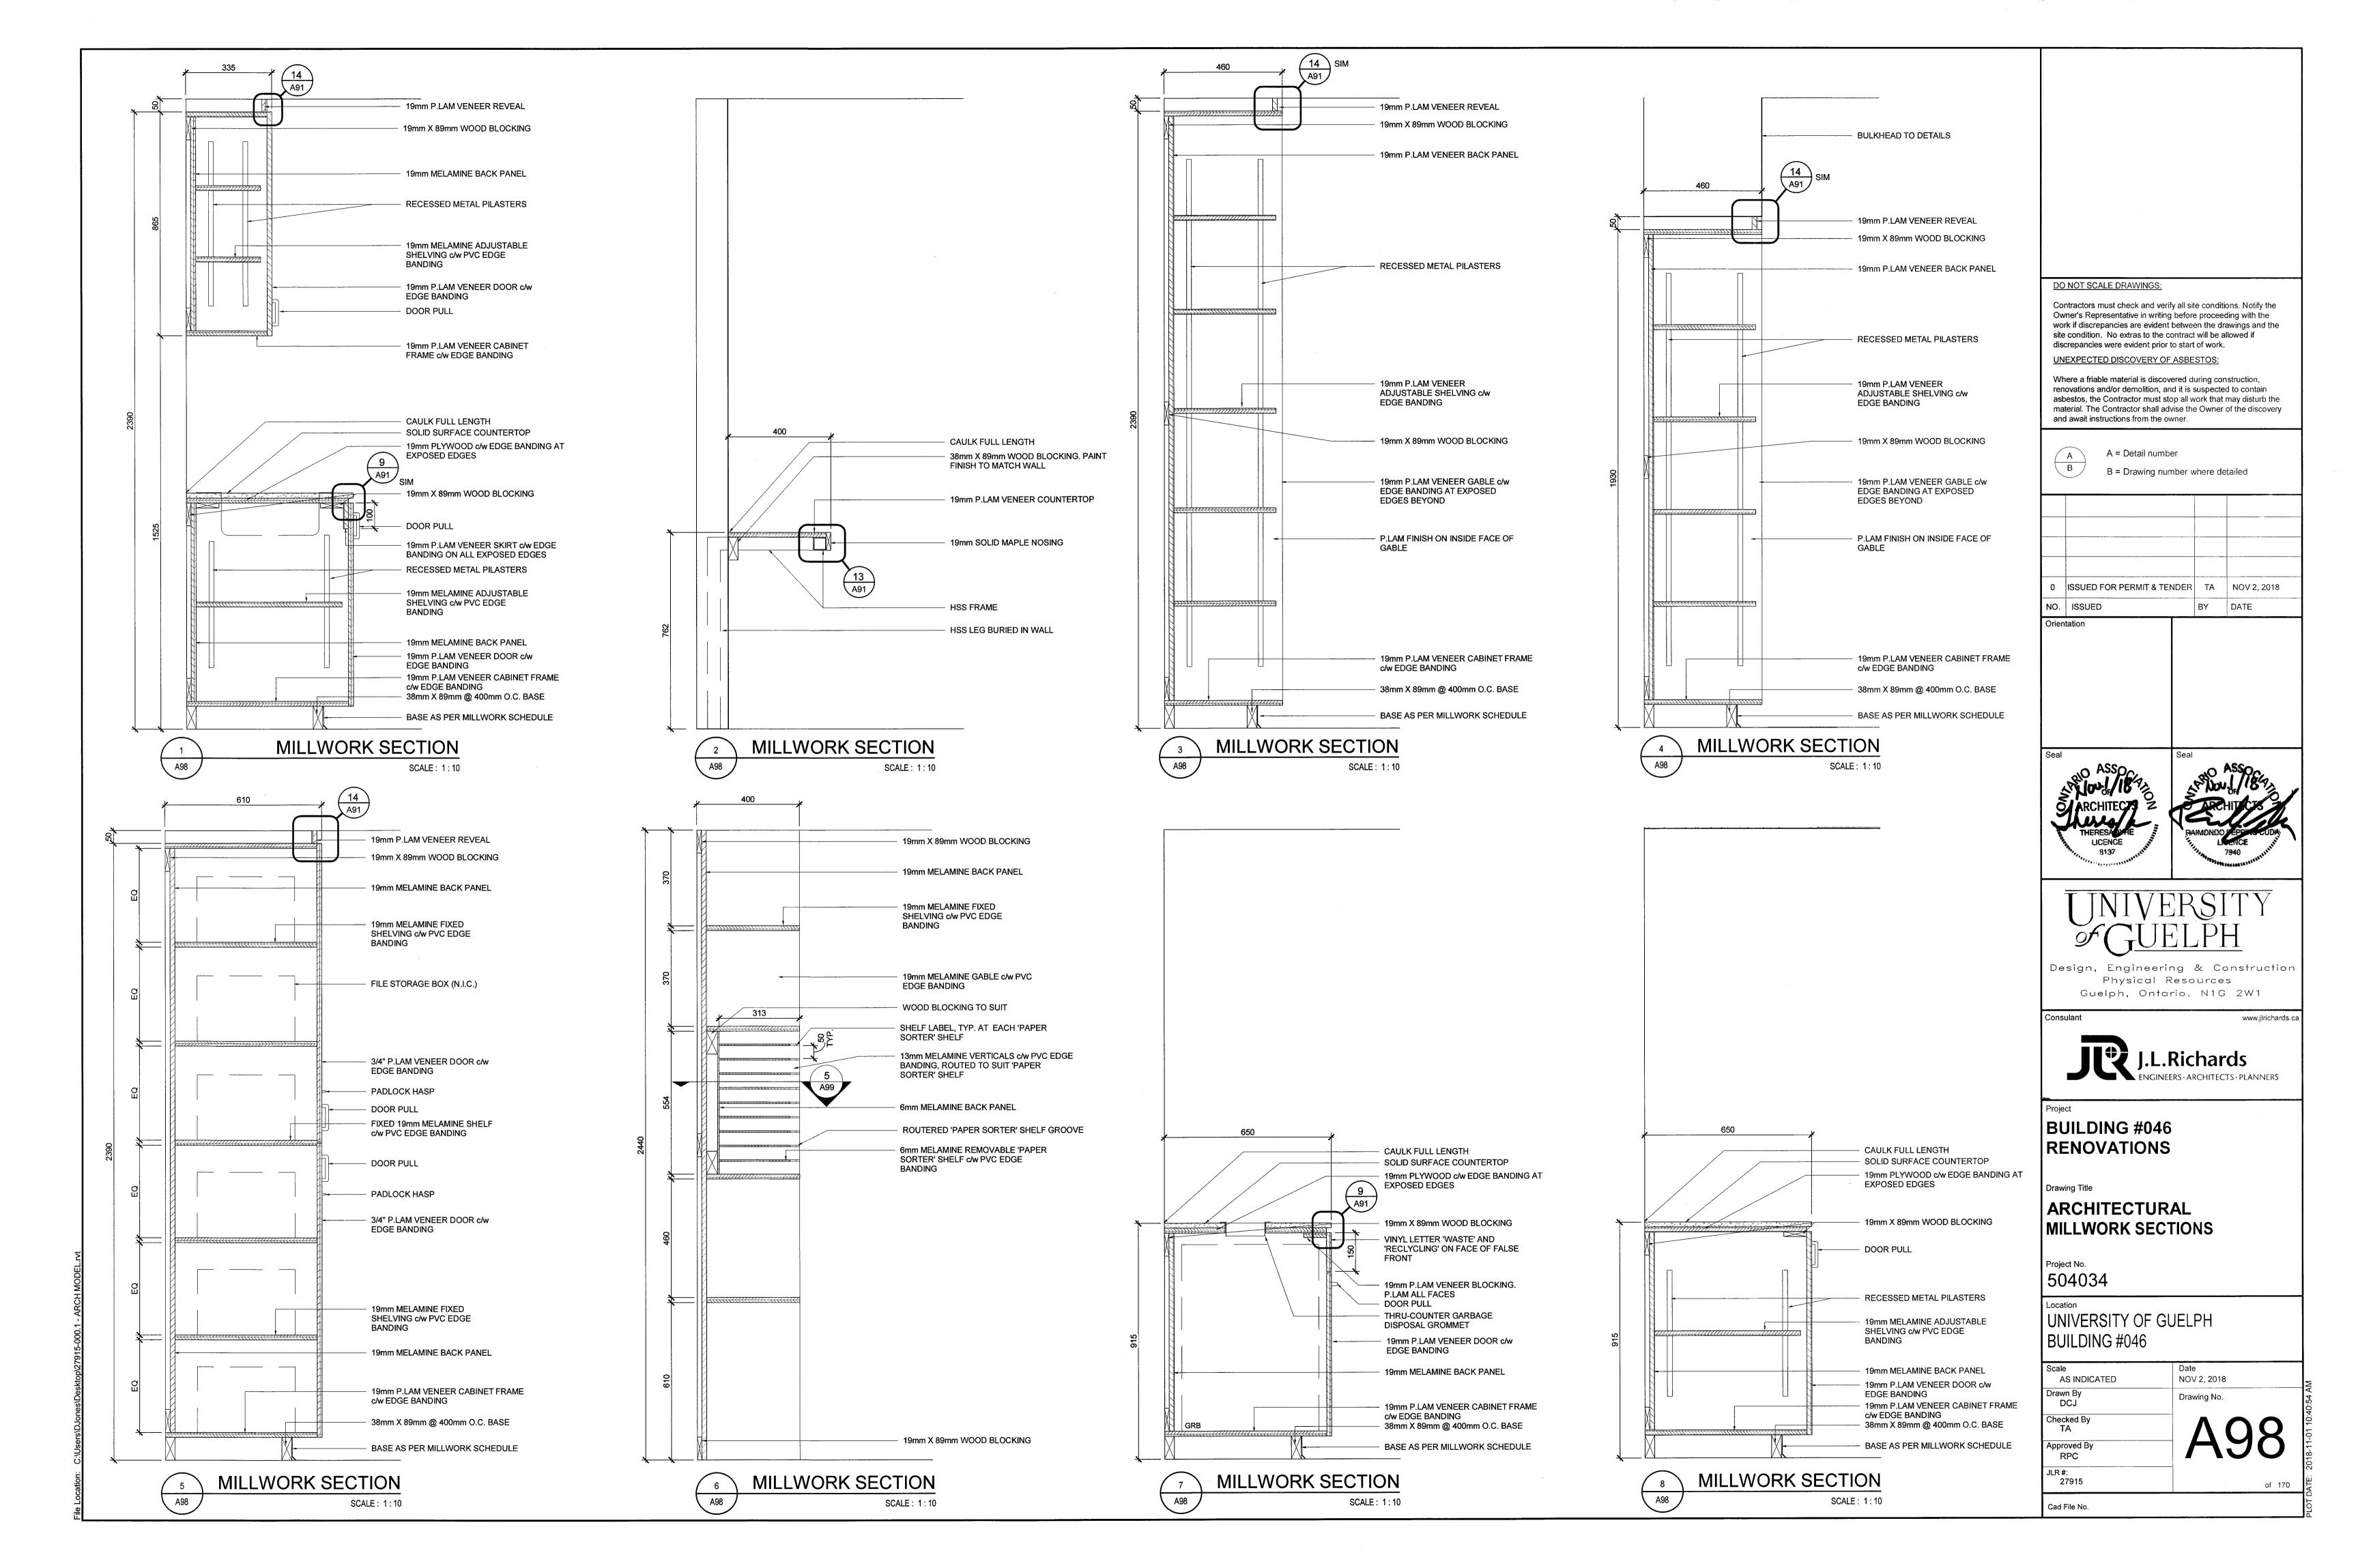

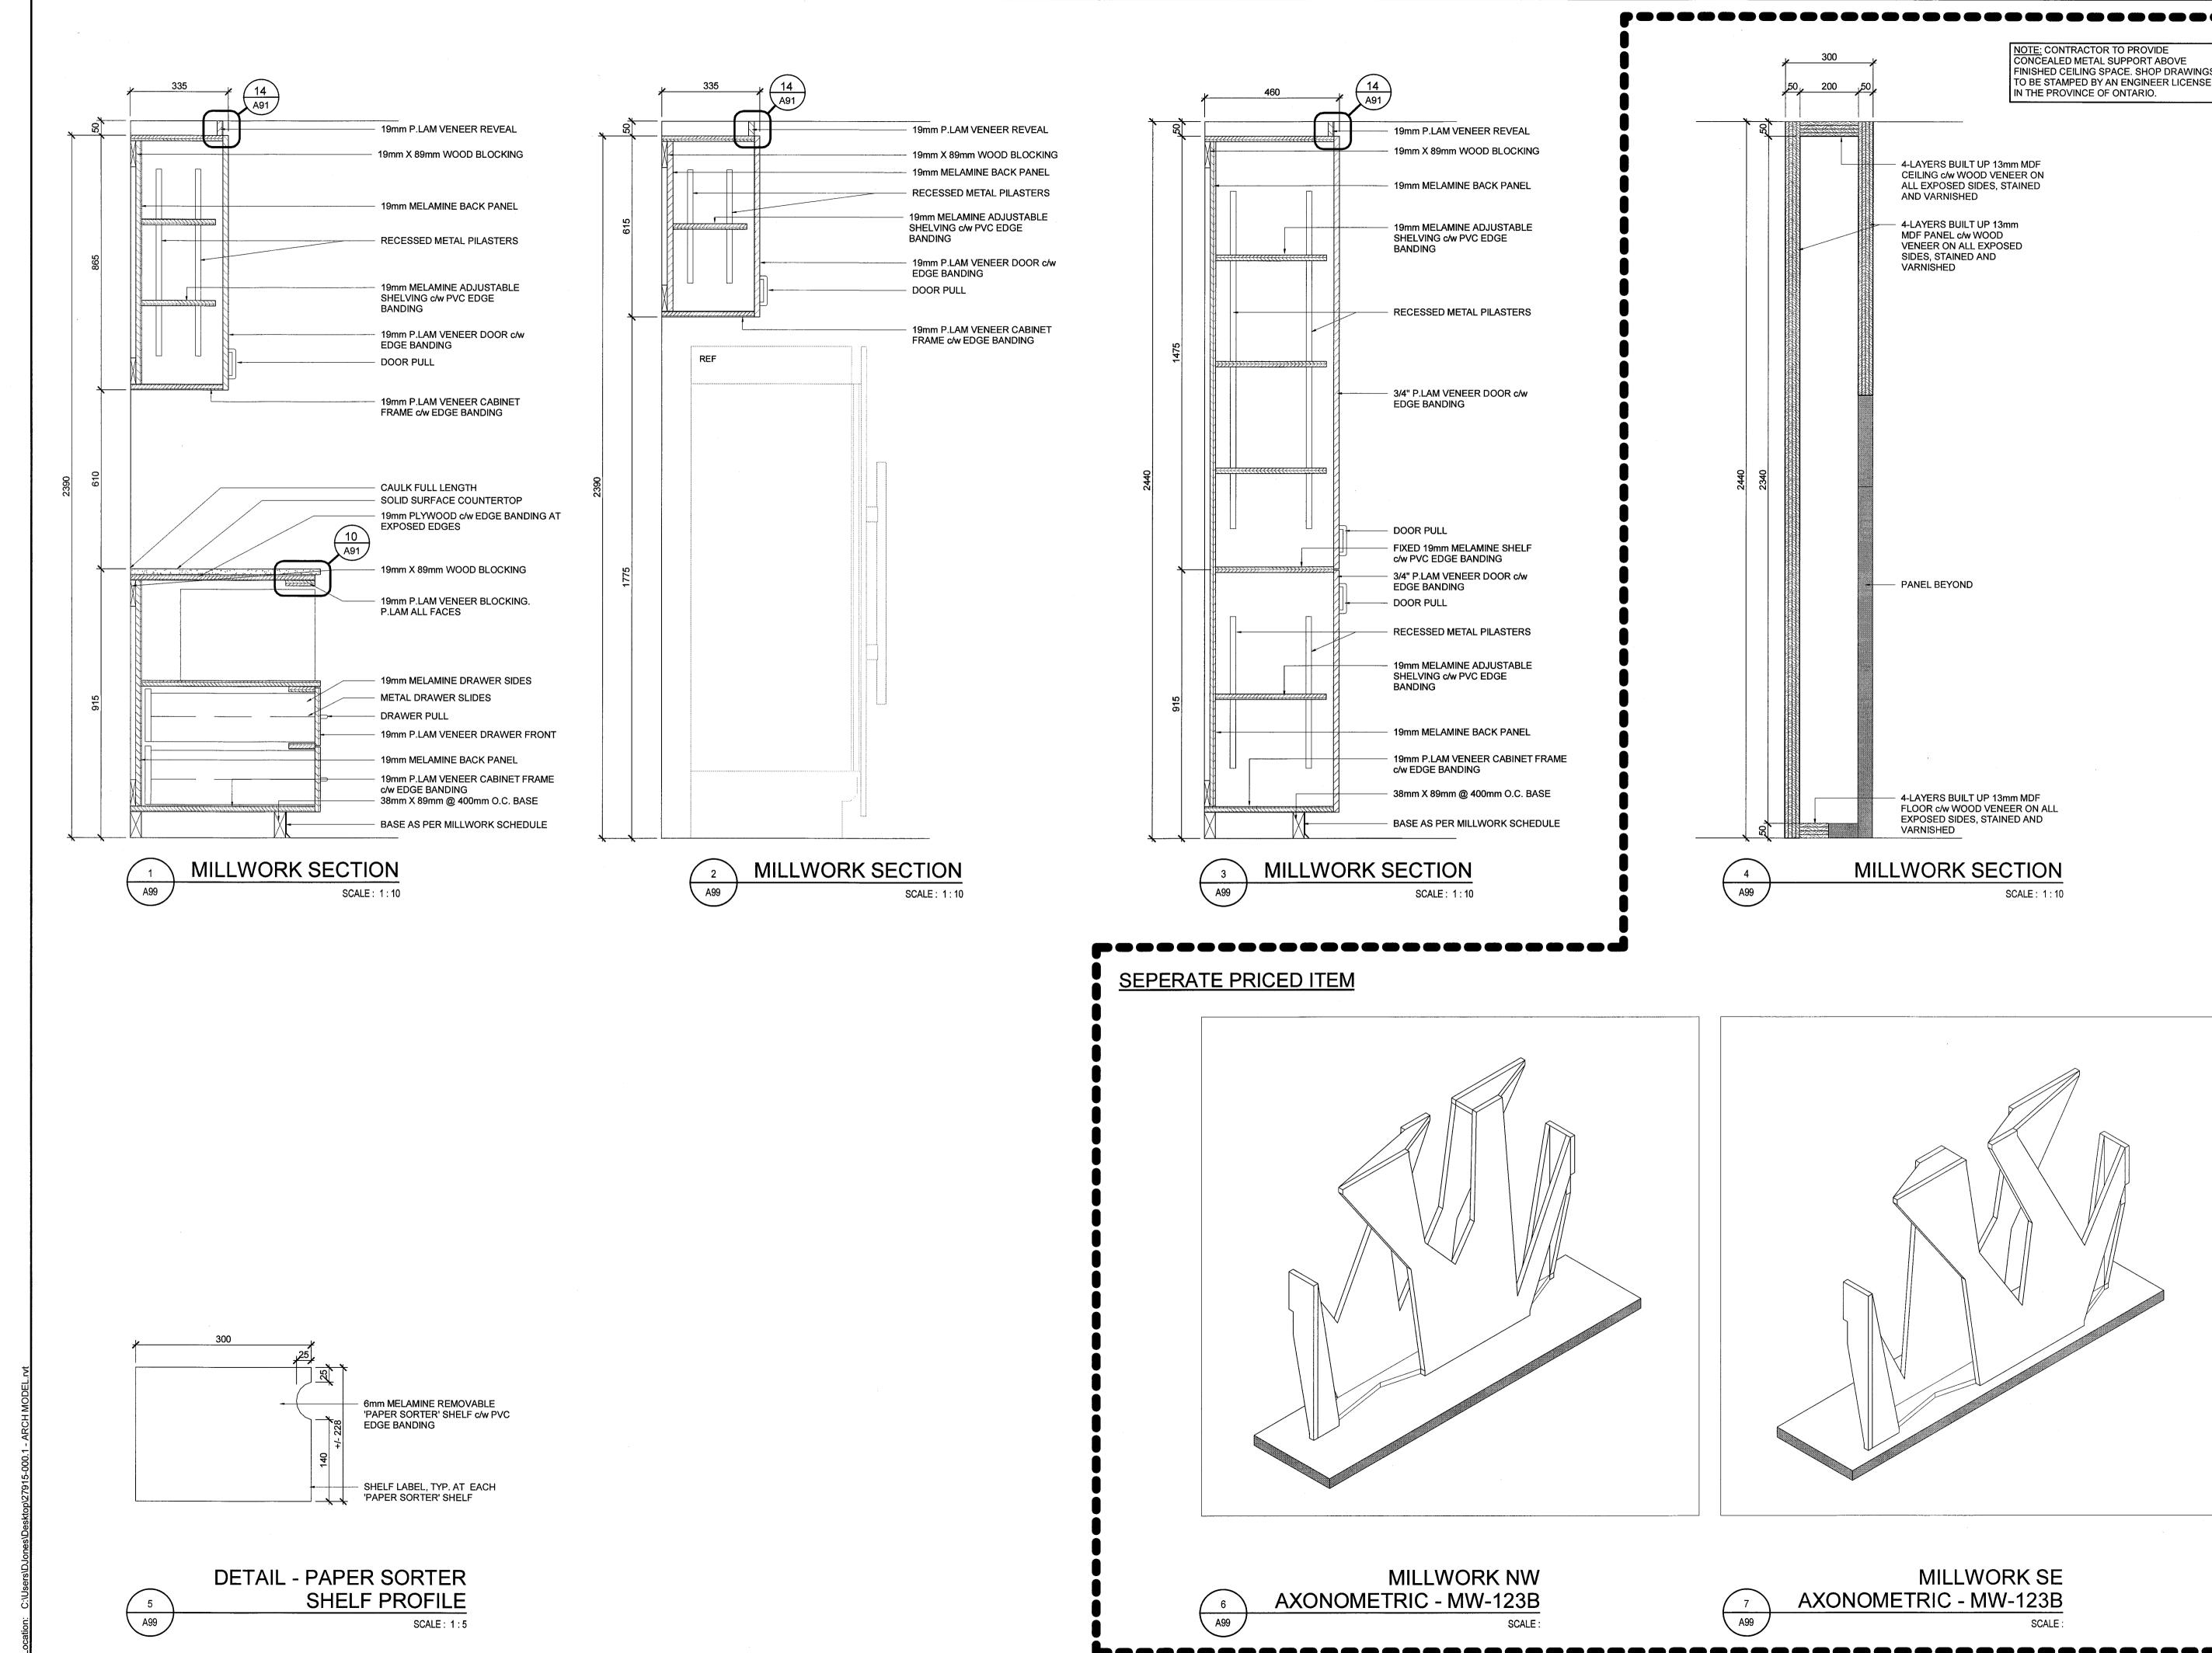

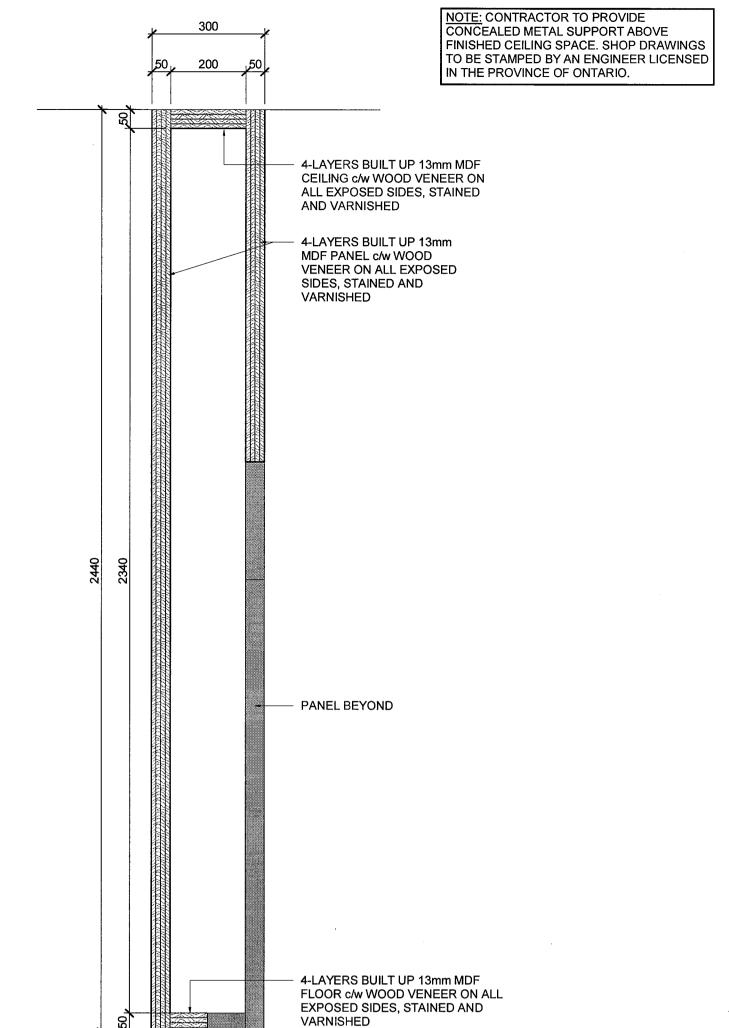

DO NOT SCALE DRAWINGS:

Contractors must check and verify all site conditions. Notify the Owner's Representative in writing before proceeding with the work if discrepancies are evident between the drawings and the site condition. No extras to the contract will be allowed if discrepancies were evident prior to start of work. **UNEXPECTED DISCOVERY OF ASBESTOS:**

Where a friable material is discovered during construction, renovations and/or demolition, and it is suspected to contain asbestos, the Contractor must stop all work that may disturb the material. The Contractor shall advise the Owner of the discovery and await instructions from the owner.



A = Detail number

B = Drawing number where detailed

ISSUED FOR PERMIT & TENDER TA NOV 2, 2018 BY DATE



Physical Resources Guelph, Ontario. N1G 2W1



BUILDING #046 RENOVATIONS

ARCHITECTURAL MILLWORK SECTIONS AND DETAILS

504034

UNIVERSITY OF GUELPH BUILDING #046

Scale AS INDICATED	Date NOV 2, 2018
Drawn By DCJ	Drawing No.
Checked By TA	$\Lambda \Omega \Omega$
Approved By RPC	ASS
JLR#: 27915	of 170